

In response to the City of Hollywood's request for: A narrative of the Design changes; the previous elevations (from February) did not have such ornate columns where the arch windows have been added. In addition, the railings now proposed on that façade seem more ornate and are not in line with the contemporary design. The narrative should explain how the latest version came to be.

Response

As part of our compromise with the Historical Group we have incorporated a Historical looking facade for the original bank building. The submittal in February drew on the scale and overall massing of the original building. As we developed the building elevations we determined that the lack of ornamentation left the facade confusing and did not clearly portray the intent of paying homage to the original design by Joseph Young.

Our team provided some additional layers of historical details, which we feel are more inline with the narrative of the history of the original building. The new articulated "Historical" facade provides a clearer juxtaposition between the new Modern Streamline design of the main structure. While we did not try to replicate the original building's design, we provided specific details that tell a better story, these include raised Ionic column pilasters with decorative capital accentuated bases; window & glazing scaled to resemble the original four panel look of the original facade, raised stucco low wall banding at window base for scale and texture, arches with raised banding, relief eave element with decorative brackets. The paint scheme for the "historic" portion of the facade is proposed to be painted primarily in white with grey color to accentuate some of the more decorative elements. We believe this will allow the facade to be more integrated to the overall elevation and give the appearance that the new building was built around the original structure.

Sincerely,


Ivo Fernandez, Jr., LEED AP Principal



Modis Architects LLC



SOLESTE HOLLYWOOD BLVD.

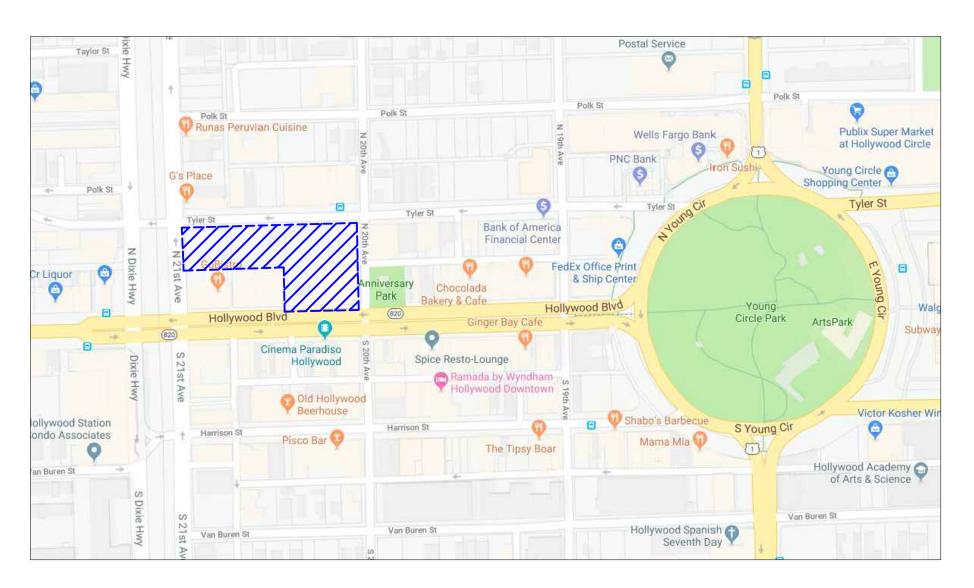

LOCATION MAP (N.T.S.)







Contact: Ivo Fernandez E. IvoF@modisarchitects.com

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LANDSCAPE ARCHITECT


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PRELIMINARY TECHNICAL ADVISORY COMMITTEE JANUARY 13, 2020


FINAL TECHNICAL ADVISORY COMMITTEE FEBRUARY 18, 2020


PLANNING AND HISTORIAL BOARD



Final TAC

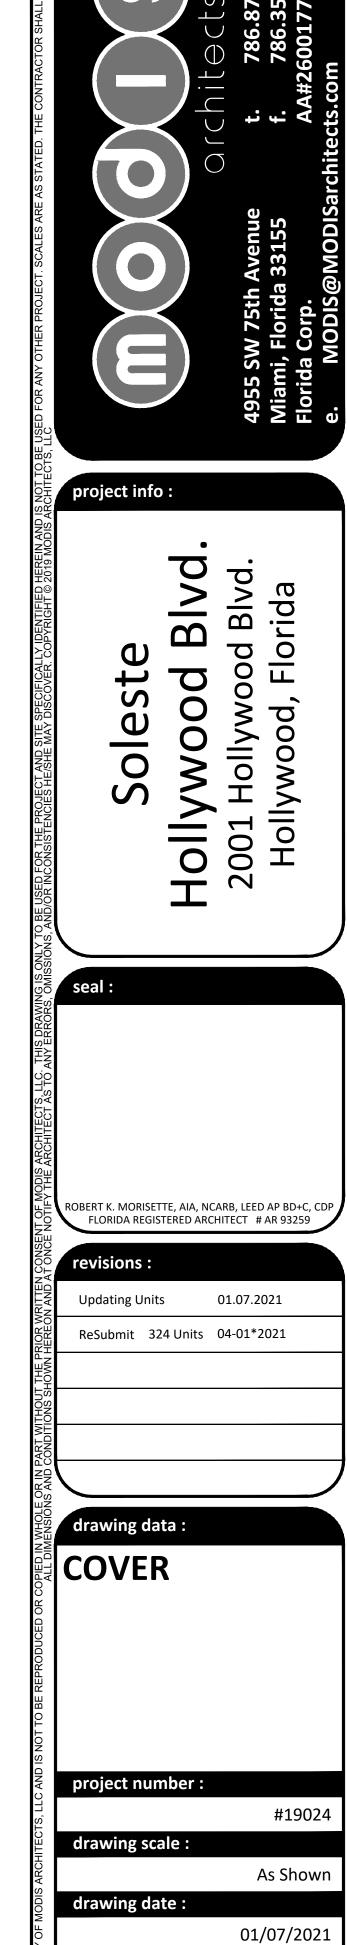sheet number:

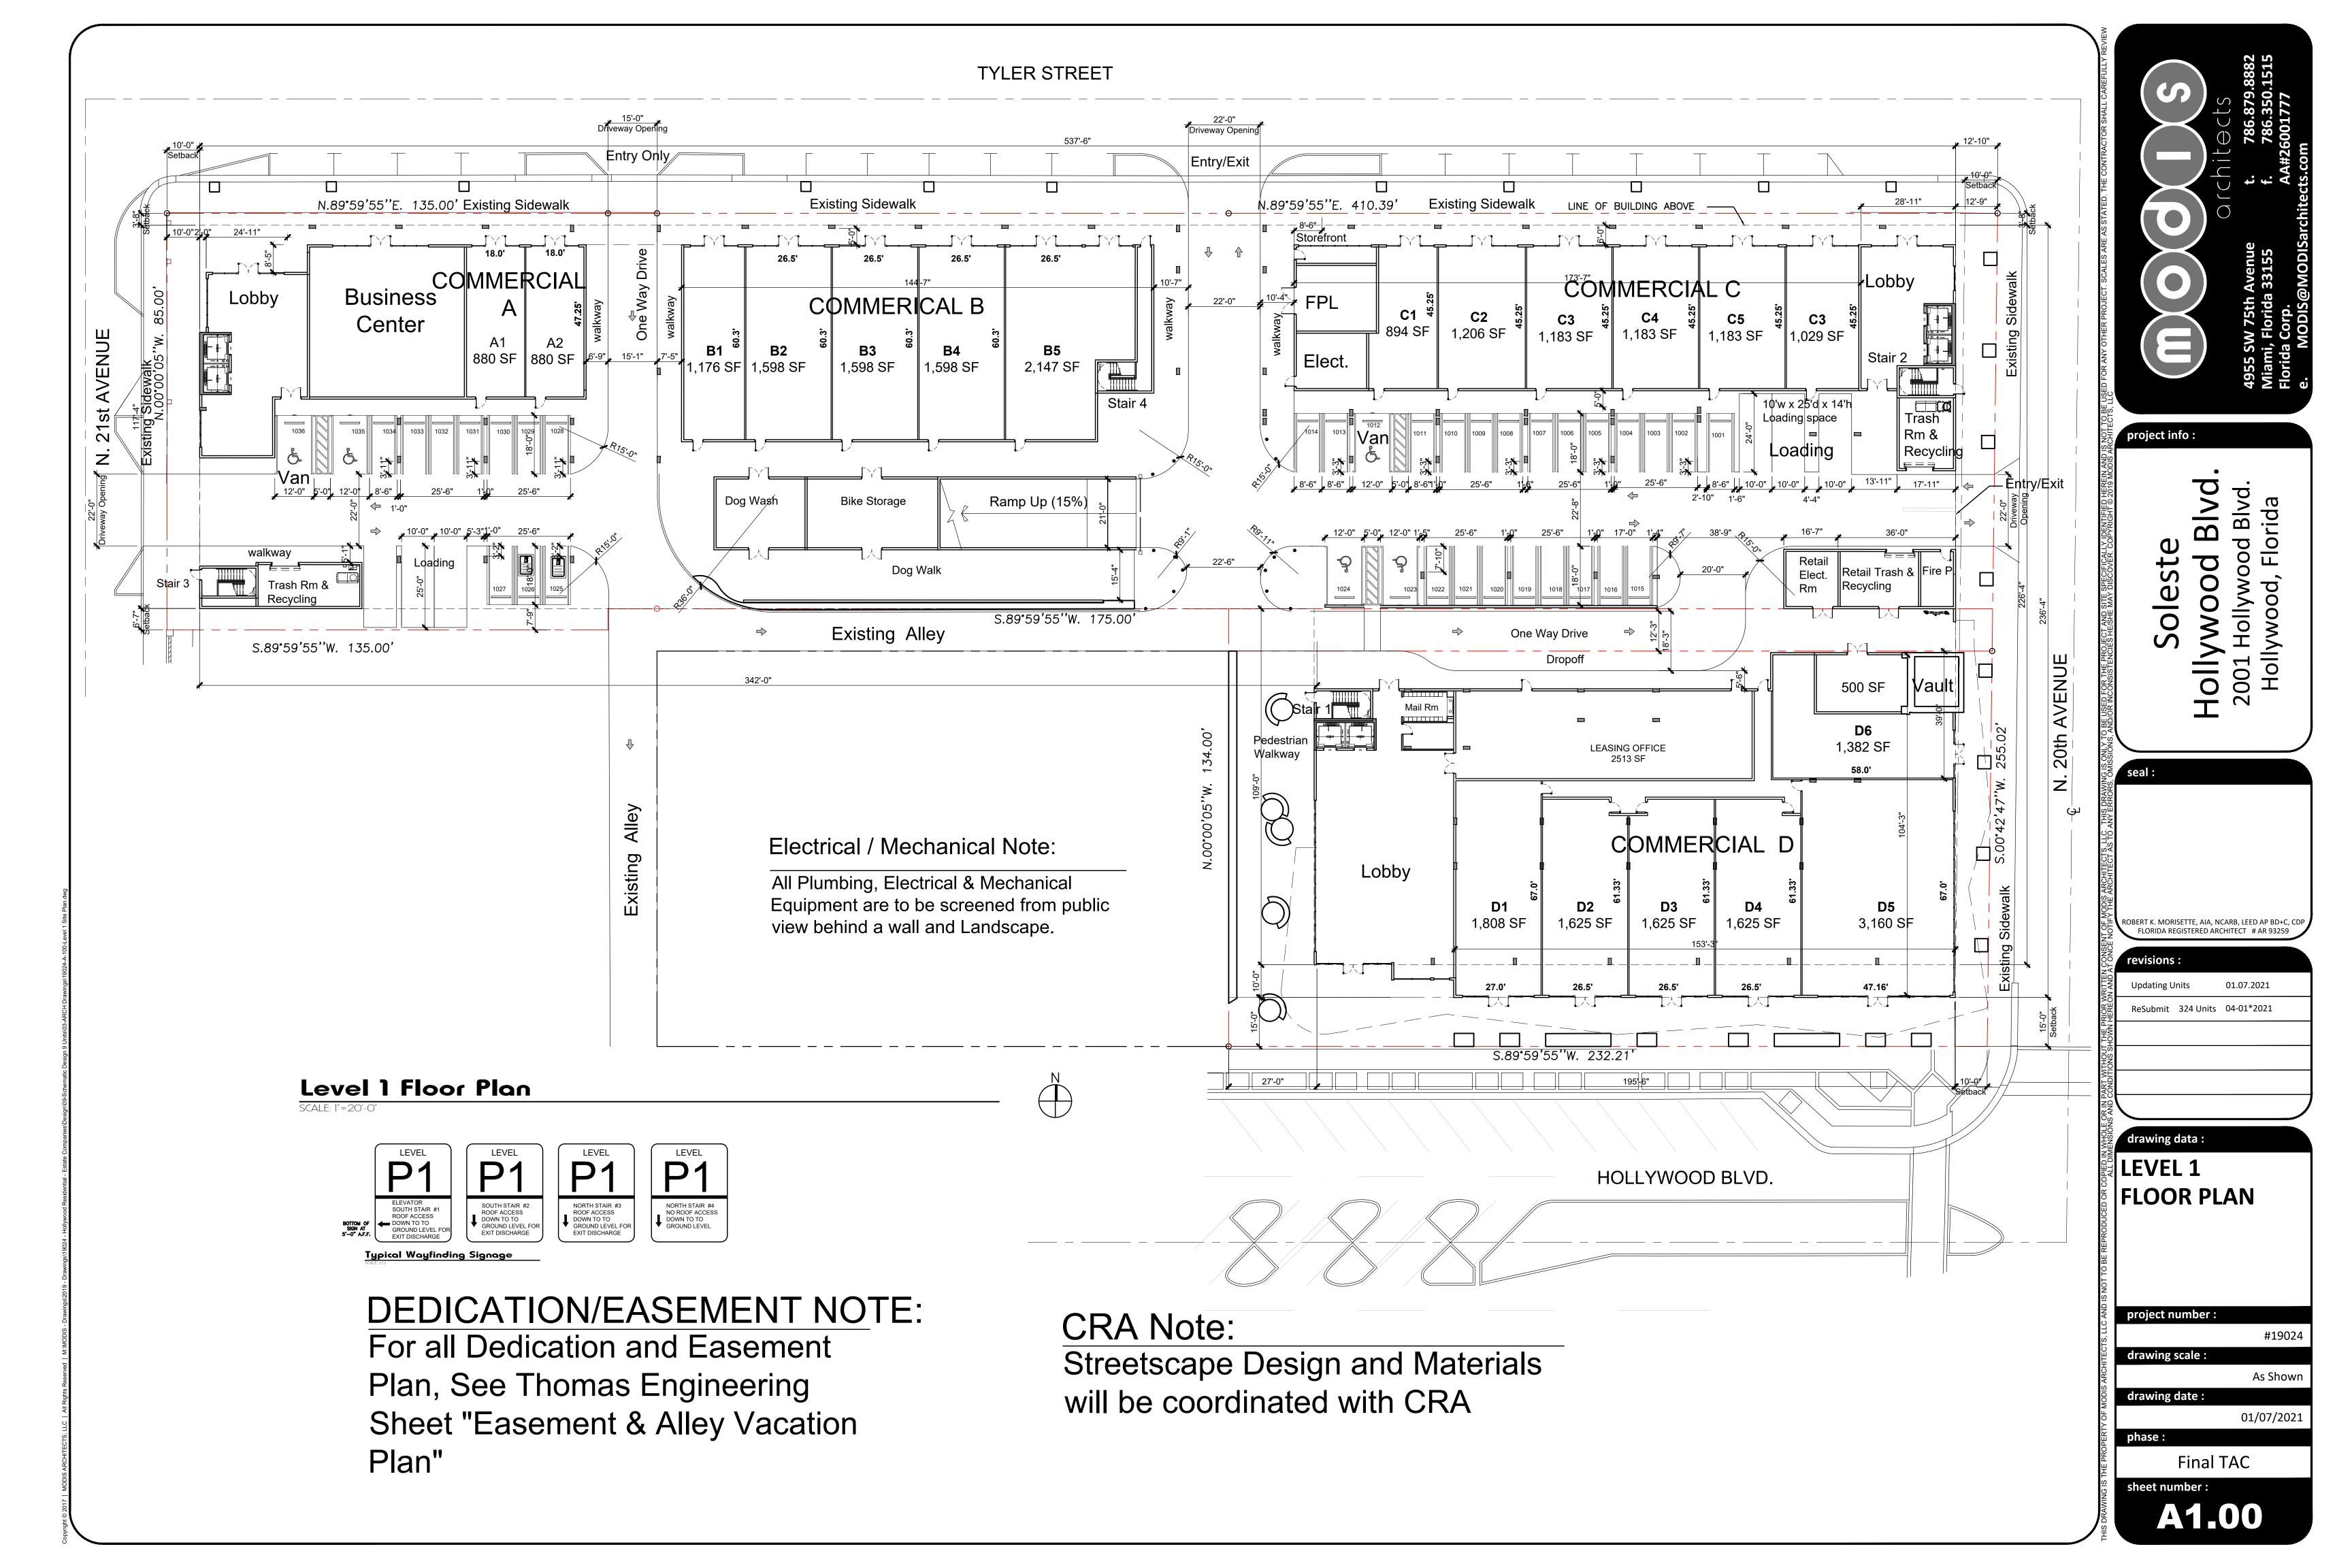

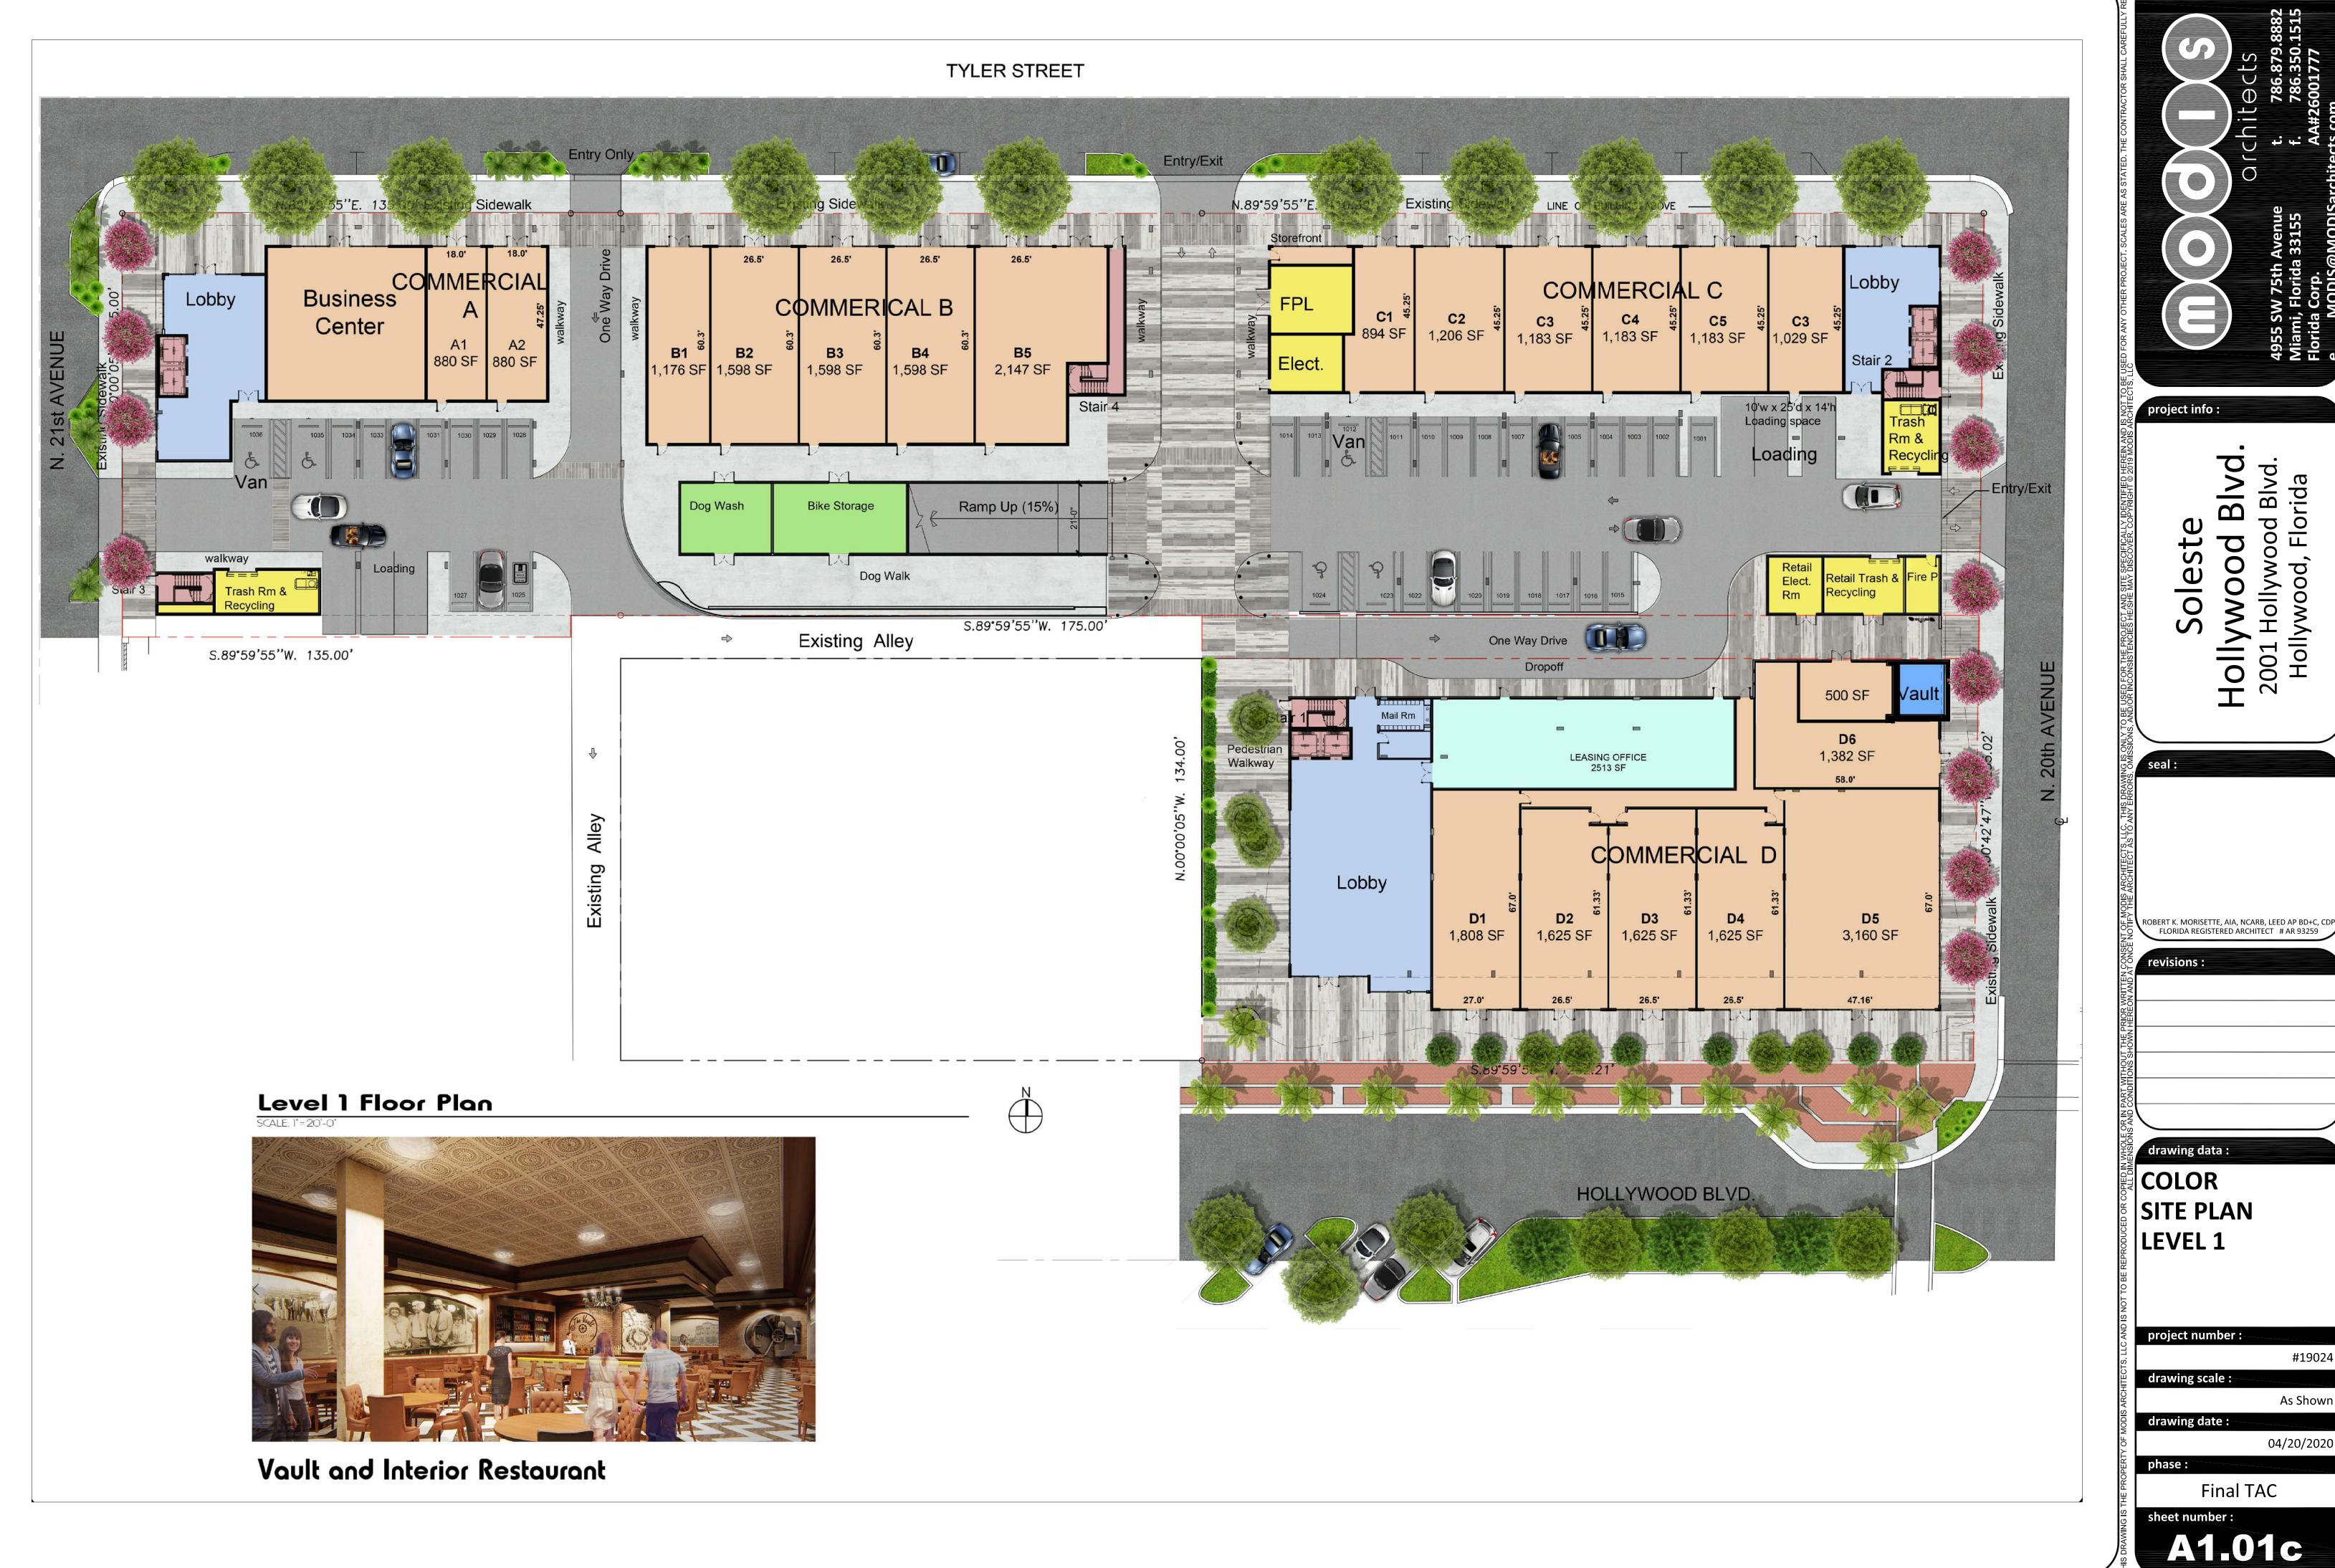

ROBERT K. MORISETTE, AIA, NCARB, LEED AP BD+C, CDP FLORIDA REGISTERED ARCHITECT # AR 93259 #19024 As Shown

| Descr | ription | | Required/ Permitted | Proposed | | |
|--|-----------------------|----------------|------------------------|-----------|--|--|
| Permitted Permitted Permitted Property Zoning: ND-3 & RC-2 | | | | | | |
| | | | ND-3 & RC-2 | | | |
| Future Land Use | ' | | | | | |
| | | Re | gional Activity Center | | | |
| Lot Area | | | | | | |
| Gross Lot Area | 147,399 sf | 3.38 Acres | | | | |
| Net Lot Area | 99,822 sf | 2.29 Acres | | | | |
| | | | | | | |
| Density | 147,399 sf | | | 324 Units | | |
| FAR | | | | | | |
| | Gross Lot Area | | Permitted | Proposed | | |
| ND-3 | 120,233 sf | Max F.A.R. (3) | 360,699 | | | |
| RC-2 | 27,166 sf | Max F.A.R. (3) | 81,498 | | | |
| Total | | | 442,197 | 349,331 | | |
| Impervious & Pervious | | | | | | |
| Impervious | | 55,278 sf | | 37.50% | | |
| Pervious | | 8,978 sf | | 6.09% | | |
| Building Area | | 83,143 sf | | 56.41% | | |
| Total Gross Lot Area | | 147,399 sf | | 100.00% | | |
| Building Height | | | | | | |
| | Max Height | | 140'-0" | 74'-0" | | |
| | Number of Stories | | 10 Story | 8 Story | | |
| Setbacks | | | | | | |
| Hollywood Blvd | | | 10'-0" | 15'-0" | | |
| 20th Ave | | | 10'-0" | 10'-0" | | |
| Tyler Street | | | 10'-0" | 3'-8" | | |
| N. 21st Avenue | | | 10'-0" | 10'-0" | | |
| Side Interior | | | 0'-0" | 26'-6" | | |
| Alley | | | 5'-0" | 0'-0" | | |

| | | Parking R | equirements | | |
|---------------------------|--------------------------|-------------------------|----------------------|------------------------|--------------------|
| | Units | | | Required | Provided |
| Total Units | 324 DU | 1.0 SP/DU | | 324 spaces | 347 spaces |
| Visitor | | 1 sp / 10 Units | | 32 spaces | 35 spaces |
| Retail | | .0 SP/DU | | 0 spaces | spaces |
| Extra Spaces | assign to 2 BD Units | | | spaces | 87 spaces |
| | Total P | arking | | 356 spaces | 469 spaces |
| | Max. Parking S | Space per Unit | | 2.5 Space per Unit | 1.45 Space per Uni |
| | | | | | |
| | | Parking | Per Level | | |
| | Standard | НС | Tandem | | |
| Level 1 | 31 | 5 (2 Van) | 0 | | 36 |
| Level 2 | 167 | 2 | 28 | | 197 |
| Level 3 | 215 | 2 | 19 | | 236 |
| Total Parking Provided | 413 | 9 | 47 | | |
| | Total Parkir | g Provided | | | 469 spaces |
| | | Require | d Loading | | |
| | Off Street Loadi | ng Space Requireme | nts - 10'w x 25'L x | 14' Vertical Clearance | |
| Retail | 25,00 | 0 - 59,999 sf = (2) 10' | w x 25'L x 14' clear | height | |
| Units | Tower: 50-1 | 00 Units + 1 for each | add'l 100 Units or ı | major Fraction | |
| Provided: | Retail Space - 29,838 sf | = (2)10'w x 25'L x 14 | ' clear height | | 2 spaces |
| | Towe | r - 347 units - (4)10'v | v x 25'L x 14' clear | height) | 4 spaces |
| | | Tota | Loading space | nrovided | 6 spaces |

| tal Building Area | | | | | | | | | | | |
|-------------------|------------|----------------------|--------------|---------------|-----------|-------------|-------------|-----------|-----------|------------|------------------|
| | | Non-FAR | | Total Non-FAR | FAR | | | | | Total FAR | Total Gross Area |
| Levels | Garage | FPL, Elect.Rm, Trash | Amenity Deck | | Unit Area | Circulation | Mech/Elect. | Amenities | Retail | Total | |
| Level 1 | 27,167 sf | 4,505 sf | | 31,672 sf | 0 sf | 22,268 sf | 0 sf | 0 sf | 29,203 sf | 51,471 sf | 83,143 sf |
| Level 2 | 69,967 sf | 0 sf | | 69,967 sf | 9,696 sf | 4,623 sf | 110 sf | 0 sf | 0 sf | 14,429 sf | 84,396 sf |
| Level 3 | 69,967 sf | 0 sf | | 69,967 sf | 9,696 sf | 4,623 sf | 110 sf | 0 sf | 0 sf | 14,429 sf | 84,396 sf |
| Level 4 | 0 sf | 0 sf | 30,389 sf | 30,389 sf | 35,723 sf | 8,690 sf | 785 sf | 8,809 sf | 0 sf | 54,007 sf | 84,396 sf |
| Level 5 | 0 sf | 0 sf | | 0 sf | 44,442 sf | 8,690 sf | 1,090 sf | 0 sf | 0 sf | 54,222 sf | 54,185 sf |
| Level 6 | 0 sf | 0 sf | | 0 sf | 44,442 sf | 8,690 sf | 1,090 sf | 0 sf | 0 sf | 54,222 sf | 54,185 sf |
| Level 7 | 0 sf | 0 sf | | 0 sf | 44,442 sf | 8,690 sf | 1,090 sf | 0 sf | 0 sf | 54,222 sf | 54,185 sf |
| Level 8 | 0 sf | 0 sf | 1,856 sf | 1,856 sf | 42,549 sf | 8,690 sf | 1,090 sf | 0 sf | 0 sf | 52,329 sf | 54,185 sf |
| Total | 167,101 sf | 4,505 sf | | 203,851 sf | 99,557 sf | 74,964 sf | 2,095 sf | 8,809 sf | 29,203 sf | 349,331 sf | 553,071 sf |

| | | | | Tower 1 Unit Ar | ea Calculation | | | | | |
|---------------|----------|----------|----------|-----------------|----------------|---------------|-----------|---------------|-----------------------|---------------------------------------|
| | Studio | A1 (1bd) | A3 (1bd) | A4 (1-bd+Den) | B1 (2-bd) | B2 (2-bd+Den) | B3 (2-bd) | B4 (2 bd+Den) | Total Units per Floor | Total Area Floor Plate Above 55'0" |
| Leasable Area | 399 sf | 591 sf | 606 sf | 753 sf | 828 sf | 1,232 sf | 957 sf | 1,074 sf | | |
| Balc./Terr. | 27 sf | 30 sf | 42 sf | 53 sf | 30 sf | 84 sf | 75 sf | 75 sf | | |
| Level 1 | 0 | 0 | 0 | 0 | 0 | 0 | 0 | 0 | 0 | |
| Level 2 | 0 | 8 | 0 | 0 | 6 | 0 | 0 | 0 | 14 | |
| Level 3 | 0 | 8 | 0 | 0 | 6 | 0 | 0 | 0 | 14 | |
| Level 4 | 2 | 14 | 4 | 2 | 14 | 1 | 0 | 0 | 37 | 33,320 sf |
| Level 5 | 2 | 16 | 4 | 2 | 14 | 1 | 0 | 0 | 39 | 33,320 sf |
| Level 6 | 2 | 16 | 4 | 2 | 14 | 1 | 0 | 0 | 39 | 33,320 sf |
| Level 7 | 2 | 16 | 4 | 2 | 14 | 1 | 0 | 0 | 39 | 33,320 sf |
| Level 8 | 2 | 17 | 4 | 2 | 11 | 1 | 0 | 0 | 37 | 31,272 sf |
| Sub Total | 10 Units | 95 Units | 20 Units | 10 Units | 79 Units | 5 Units | 0 Units | 0 Units | | |
| | | | | | | | Total Uni | ts in Tower 1 | 219 Units | |

| | | | Т | ower 2 Unit Are | ea Calculatio | n | | | | |
|---------------|---------|----------|----------|-----------------|---------------|---------------|-------------|---------------|--------------------------|---|
| | Studio | A1 (1bd) | A3 (1bd) | A4 (1-bd+Den) | B1 (2-bd) | B2 (2-bd+Den) | B3 (2-bd) | B4 (2 bd+Den) | Total Units per Floor | Total Area Floor Plate Above 55'0 |
| Leasable Area | 414 sf | 621 sf | 606 sf | 753 sf | 828 sf | 1,210 sf | 957 sf | 1,074 sf | | |
| Balc./Terr. | 27 sf | 30 sf | 30 sf | 53 sf | 30 sf | 80 sf | 75 sf | 75 sf | | |
| Level 1 | 0 | 0 | 0 | 0 | 0 | 0 | 0 | 0 | 0 | |
| Level 2 | 0 | 0 | 0 | 0 | 0 | 0 | 0 | 0 | 0 | |
| Level 3 | 0 | 0 | 0 | 0 | 0 | 0 | 0 | 0 | 0 | |
| Level 4 | 1 | 4 | 0 | 0 | 6 | 0 | 1 | 1 | 13 | 20,865 sf |
| Level 5 | 2 | 6 | 1 | 1 | 10 | 1 | 1 | 1 | 23 | 20,865 sf |
| Level 6 | 2 | 6 | 1 | 1 | 10 | 1 | 1 | 1 | 23 | 20,865 sf |
| Level 7 | 2 | 6 | 1 | 1 | 10 | 1 | 1 | 1 | 23 | 20,865 sf |
| Level 8 | 2 | 6 | 1 | 1 | 10 | 1 | 1 | 1 | 23 | 20,865 sf |
| Sub Total | 9 Units | 28 Units | 4 Units | 4 Units | 46 Units | 4 Units | 5 Units | 5 Units | | |
| | | | | | | | Total Units | For Tower 2 | 105 | |

| | Required | Proposed |
|----------------------|----------|----------|
| Tyler Street Setback | 10'-0" | 3'-8" |
| Alley Setback | 5'-0" | 0'-0" |
| | | |
| | | |
| | | |

Variance

ROBERT K. MORISETTE, AIA, NCARB, LEED AP BD+C, CDP FLORIDA REGISTERED ARCHITECT # AR 93259 Updating Units 01.07.2021 ReSubmit 324 Units 04-01*2021 drawing data: **ZONING DATA** project number: #19024 drawing scale: As Shown drawing date: 01/07/2021 Final TAC

sheet number :

Total Units for Tower 1 & Tower 2 324 DU

GENERAL NOTES:

- 1. SEE ENLARGED PLANS FOR FURTHER
- DIMS AND NOTES. 2. ALL MECHANICAL EQUIPMENT SHALL BE SCREENED FROM PUBLIC VIEW.
- 3. ALL SIGNAGE UNDER SEPARATE PERMIT AND WILL MEET ZONING AND LAND DEVELOPMENT REGULATIONS
- 4. ALL MECHANICAL EQUIPMENT SHALL BE SCREENED FROM PUBLIC VIEW.
- 5. SEE CIVIL DRAWINGS FOR ON-STREET PARKING AND PAVING INFORMATION.
- 6. SEE LANDSCAPE DRAWINGS FOR SIDEWALK AND PLANTING INFORMATION.

7. ALL BUILDING WILL COMPLY WITH NFPA

TWO-WAY RADIO COMMUNICATION SIGNAL

1, 11.10 TO MEET THE MINIMUM

REQUIREMENTS. 8. FINISHED FLOOR OF GROUND FLOOR COMMERCIAL AND RETAIL USES SHALL BE FLUSH WITH SIDEWALK ELEVATION.

SITE LIGHTING NOTE:

- 1. SITE LIGHTING LEVELS SHALL NOT EXCEED 0.5 FC AT THE PROPERTY LINE ADJACENT TO RESIDENTIALLY ZONED OR RESIDENTIALLY USED AREA. EXTERNAL LIGHTS TO BE SHEILDED TO PREVENT LIGHT POLLUTION TO ADJACENT SITES AND UP INTO THE NIGHT SKY.
- 2. TURTLE LIGHTING ORDINANCE N/A 3. THE MAXIMUM FOOT-CANDLE LEVEL AT ALL PROPERTY LINES (MAXIMUM 0.5)

Existing Alley to remained

access to remain

Alley previously vacated and existing

GREEN BUILDING PRACTICES:


- 1. PROJECT TO ACHIEVE LEED CERTIFICATION OR GREEN GLOBE
- CERTIFICATION. 2. ENERGY EFFICIENT LOW E WINDOW . DOORS: INSULATED AND FIRE RATED
- 4. PROGRAMABLE THERMOSTATS. 5. ENERGY STAR APPLIANCES.
- 6. MERV 8 A/C FILTERS ON ALL A/C UNITS. . DUAL FLUSH TOILETS
- 8. ALL ENERGY EFFICIENT OUTDOOR LIGHTING. 9. ALL HOT WATER PIPE INSULATED.
- 10. ONE LOW FLOW SHOWERHEAD
- 11. BICYCLE ROOM STORAGE AND RESTROOM/CHANGING ROOM.
- 12. DEDICATED RECYCLING ROOM.

PAINTS, COATINGS AND SEALANTS

- 13. ELECTRIC VEHICLE CHARGING STATION
- 14. ROOFING MATERIAL IS ENERGY STAR (COOL ROOF). 15. LOW VOC MATERIALS WILL BE TO THE GREATEST EXTENT POSSIBLE. 901.9 & 901.10 - THE USE OF LOW-VOC
- 16. SUSTAINABLE BUILDING MATERIALS WILL BE USED TO THE GREATEST EXTENT POSSIBLE. RECYCLE MATERIALS FROM DEMOLITION OF EXISTING STRUCTURES TO THE GREATEST EXTENT POSSBILE. RECYCLE WASTE MATERIALS FROM CONSTRUCTION AS WELL. 605.1, 605.2 & 605.3 - RECYCLING THE C&D WASTE SHOULD BE SPECED AND REQUIRED BY THE BUILDER. NGBS PRACTICE WE WILL TRACK IT AS REQUIRED BY THE THAT
- COVERS C&D WASTE MANAGEMENT. 17. KITCHENS WILL PROVIDE SPACE UNDER SINK FOR RECYCLE

ELECTRIC VEHICULE CHARGING STATION:

- 1. IN COMPLIANCE WITH CITY ORDINANCES, ELECTRIC VEHICULE CHARGING STATION INFRASTRUCTURE IS PROVIDED AT BOTH GARAGES OF EAST TOWER AND
- SOUTH/WEST TOWER. 2. MINIMALLY THE FOLLOWING SHALL BE INSTALLED: EMPTY 3" RACEWAY FROM BRANCH CIRCUIT PANEL BOARD TO A LOCATION IN THE GARAGE OR PARKING AREA, WITH TWO GANG JUNCTION BOX WITH A BLANK PLATE OR FULLY FUNCTIONAL ELECTRIC VEHICULE CHARGING STATION
- MAY BE INSTALLED. 3. SEE SHEET A1.02

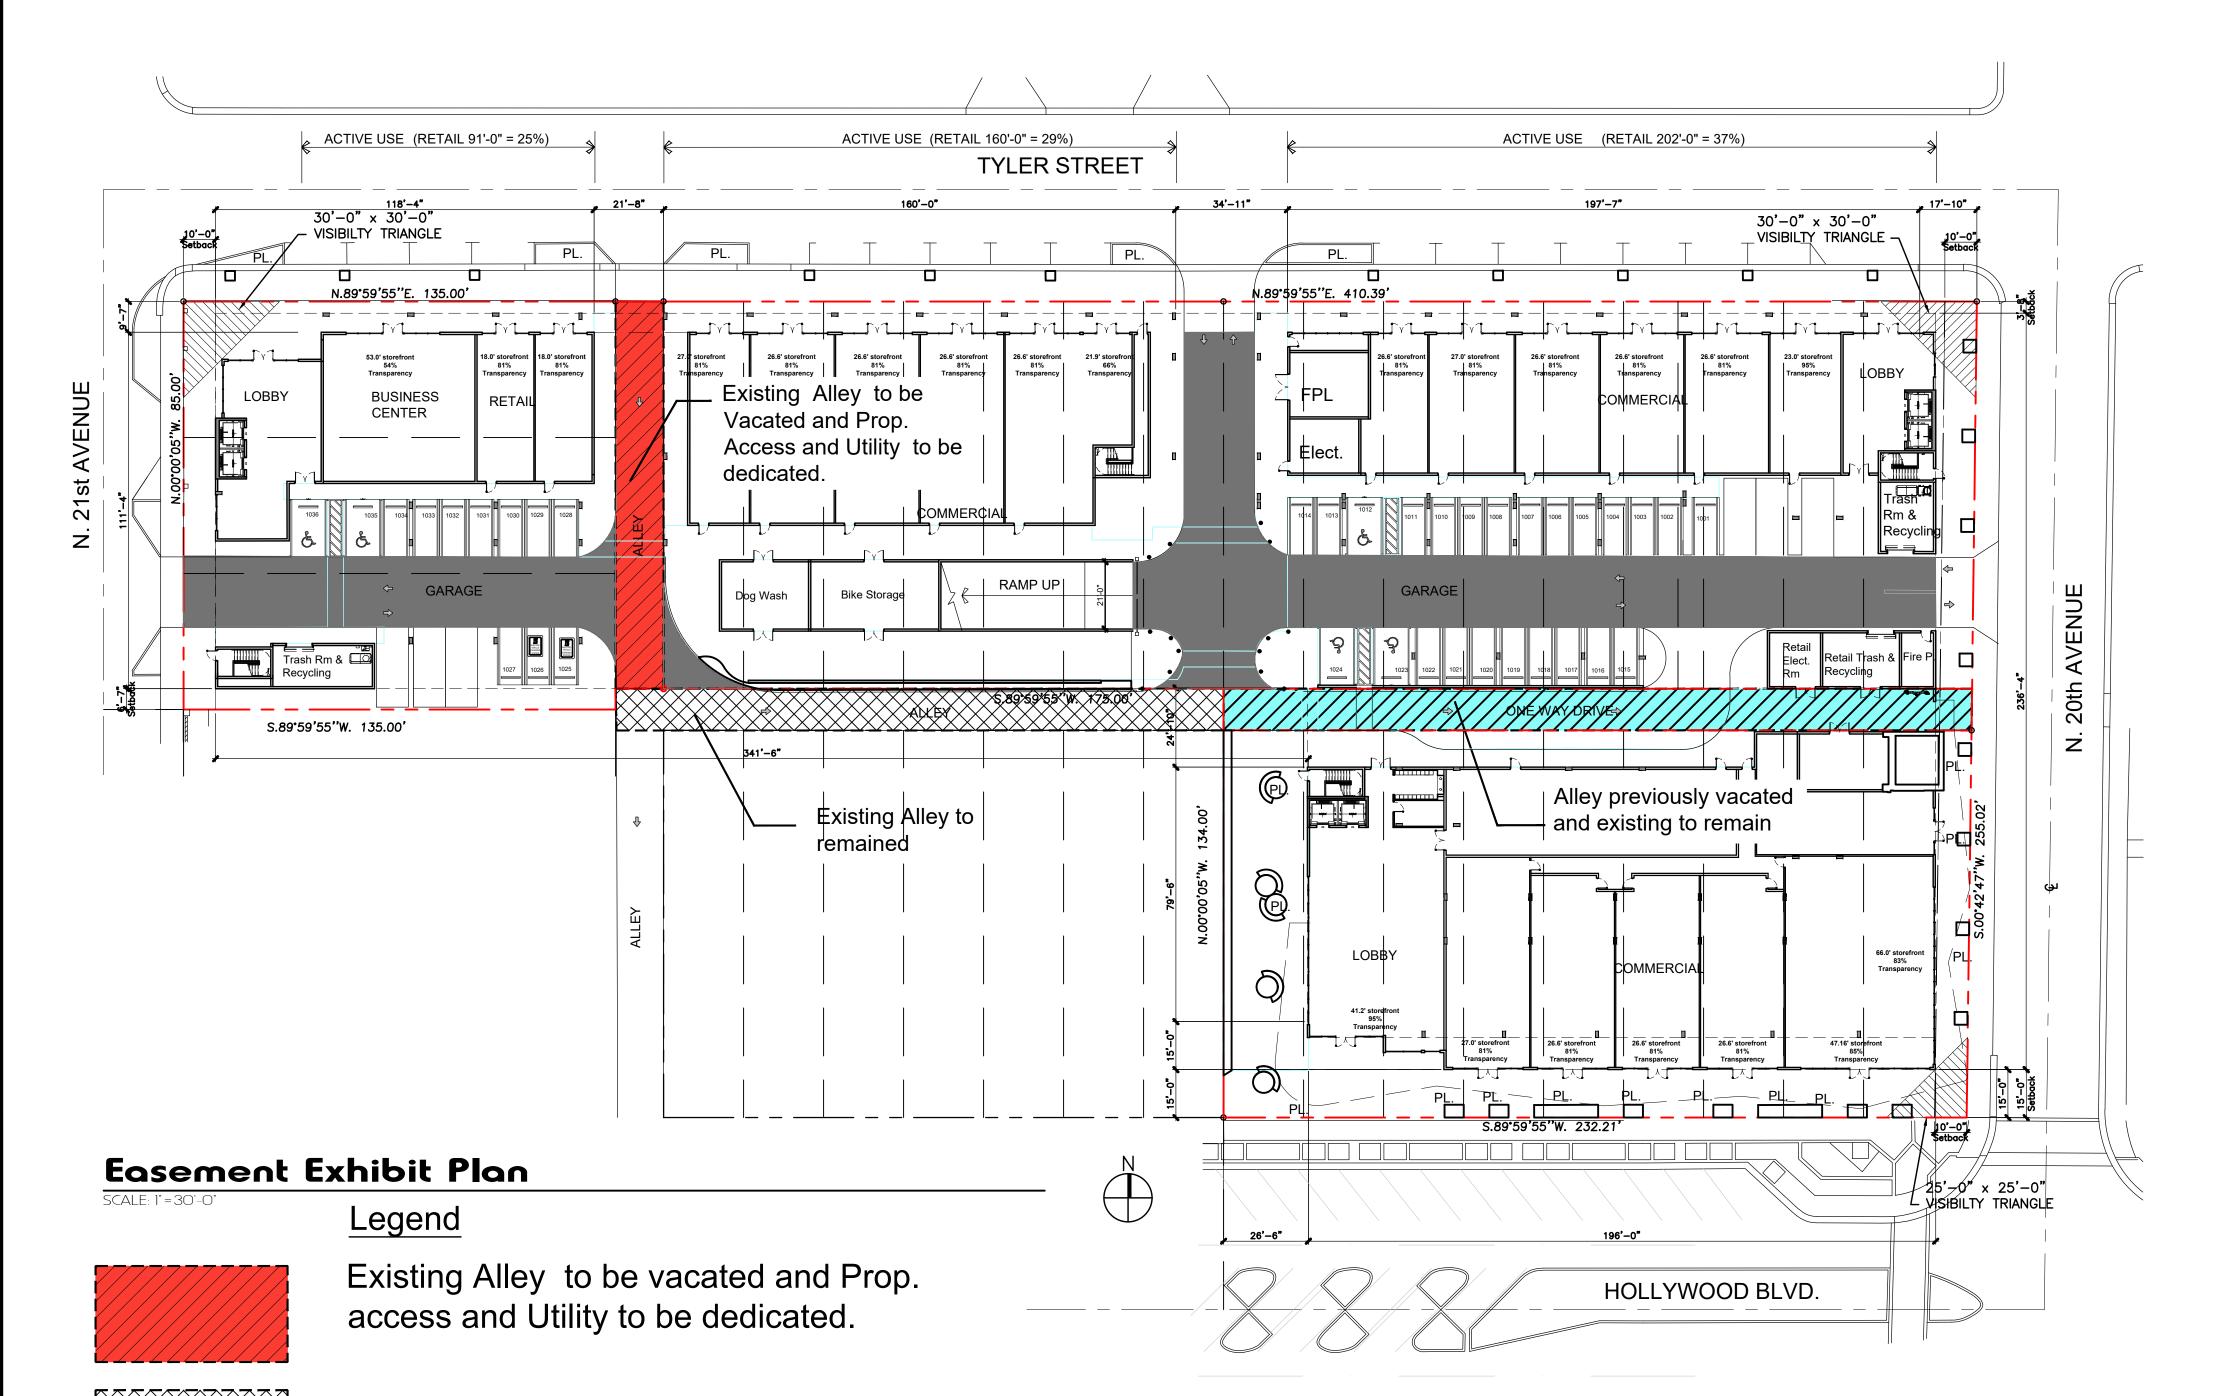

Property Access to be

Dedicated

LEGAL DESCRIPTION

LOTS 14, 15, 16, 17, 18, 23, 24, 26, LESS THE EAST 8 FEET THEREOF, AND LOTS 27, 28, 29, 30 AND 31, BLOCK 9, HOLLYWOOD, ACCORDING TO THE PLAT THEREOF, AS RECORDED IN PLAT BOOK 1. PAGE 21, PUBLIC RECORDS OF BROWARD COUNTY, FLORIDA, TOGETHER WITH A PORTION OF THE VACATED VALLEY SITUATED BETWEEN LOTS 14 THROUGH 22, AND LOTS 23 THROUGH 31, AND MORE PARTICULARLY DESCRIBED AS FOLLOWS:

BEGIN AT THE NORTHWEST CORNER OF SAID LOT 31, BLOCK 9; THENCE EASTERLY ALONG THE NORTH LINE OF SAID BLOCK 9, A DISTANCE OF 142.00 FEET TO A POINT LOCATED ALONG THE NORTHERN BOUNDARY LINE OF LOT 26 AND BEING 8 FEET WEST OF THE NORTHWEST CORNER OF LOT 25; THENCE LEAVING THE NORTH LINE OF SAID BLOCK 9 AND RUNNING PARALLEL TO AND 8 FEET TO THE WEST OF SAID WEST LINE OF LOT 25. BLOCK 9 (SAID LINE BEING THE WESTERN BOUNDARY LINE OF THE PROPERTY NOW OR FORMERLY OWNED BY RALPH W. ZIMMERMAN) RUN IN A SOUTHERLY DIRECTION A DISTANCE OF 121 FEET TO A POINT: THENCE, CONTINUING ALONG THE BOUNDARY LINE OF SAID LAND NOW OR FORMERLY OWNED BY RALPH W. ZIMMERMAN, RUN THE FOLLOWING 2 COURSES AND DISTANCES: WITH AN INCLUDED ANGLE TO THE RIGHT OF 90°00'00", RUN EASTERLY A DISTANCE OF 33 FEET TO A POINT; THENCE WITH AN INCLUDED ANGLE TO THE RIGHT OF 90°00'00", RUN NORTHERLY A DISTANCE OF 121 FEET TO A POINT SAID POINT BEING ALONG THE NORTH LINE OF SAID BLOCK 9; THENCE LEAVING THE LANDS NOW OR FORMERLY OWNED BY RALPH W. ZIMMERMAN AND CONTINUING ALONG THE NORTH LINE OF BLOCK 9 RUN IN AN EASTERLY DIRECTION A DISTANCE OF 60.39 FEET TO A POINT; THENCE WITH AN INCLUDED ANGLE TO THE LEFT OF 89°17'08", RUN SOUTHERLY ALONG THE EAST LINE OF SAID BLOCK 9, A DISTANCE OF 134.01 FEET TO THE NORTHEAST CORNER OF LOT 22; THENCE WITH AN INCLUDED ANGLE TO THE LEFT OF 90°40'52", RUN WESTERLY ALONG THE NORTH LINE OF LOTS 19 THROUGH 22. BLOCK 9, A DISTANCE OF 108.88 FEET TO THE NORTHWEST CORNER OF SAID LOT 19; THENCE WITH AN INCLUDED ANGLE TO THE RIGHT OF 90'00'00". RUN SOUTHERLY ALONG THE WEST LINE OF SAID LOT 19, A DISTANCE OF 134.00 FEET TO THE SOUTHWEST CORNER OF SAID LOT 19; THENCE WITH AN INCLUDED ANGLE TO THE LEFT OF 90°00'00", RUN WESTERLY ALONG THE SOUTH LINE OF SAID LOTS 14 THROUGH 18, A DISTANCE OF 125.00 FEET TO THE SOUTHWEST CORNER OF SAID LOT 14; THENCE WITH AN INCLUDED ANGLE TO THE LEFT OF 90°00'00", RUN NORTHERLY ALONG THE WEST LINE OF SAID LOTS 14 AND 31, A DISTANCE OF 255.00 FEET TO THE POINT OF BEGINNING.

TOGETHER WITH:

LOT 25 AND THE EAST 8 FEET OF LOT 26, BLOCK 9, OF HOLLYWOOD, ACCORDING TO THE PLAT THEREOF AS RECORDED IN PLAT BOOK 1. PAGE 21, PUBLIC RECORDS OF BROWARD COUNTY, FLORIDA, AND BEING MORE PARTICULARLY DESCRIBED AS FOLLOWS:

COMMENCE AT THE NORTHWEST CORNER OF SAID LOT 38, BLOCK 9; THENCE EASTERLY ALONG THE NORTH LINE OF SAID BLOCK 9, A DISTANCE OF 317.00 FEET TO THE POINT OF BEGINNING: THENCE CONTINUE ALONG THE AFOREMENTIONED COURSE, A DISTANCE OF 33.00 FEET; THENCE WITH AN INCLUDED ANGLE TO THE LEFT OF 90°, RUN SOUTHERLY A DISTANCE OF 121.00 FEET; THENCE WITH AN INCLUDED ANGLE TO THE LEFT OF 90°, RUN WESTERLY A DISTANCE OF 33.00 FEET; THENCE WITH AN INCLUDED ANGLE TO THE LEFT OF 90°, RUN NORTHERLY A DISTANCE OF 121.00 FEET TO THE POINT OF BEGINNING.

PARCEL 2:

LOTS 19, 20, 21, 22, 32, 33, 34, 35, 36, 37 AND 38, BLOCK 9, HOLLYWOOD, ACCORDING TO THE PLAT THEREOF, AS RECORDED IN PLAT BOOK 1, PAGE 21, PUBLIC RECORDS OF BROWARD COUNTY, FLORIDA, TOGETHER WITH A PORTION OF THE VACATED VALLEY SITUATED BETWEEN LOTS 14 THROUGH 22, AND LOTS 23 THROUGH 31, AND MORE PARTICULARLY DESCRIBED AS FOLLOWS:

BEGIN AT THE NORTHWEST CORNER OF SAID LOT 38, BLOCK 9; THENCE EASTERLY ALONG THE NORTH LINE OF SAID BLOCK 9, A DISTANCE OF 317.00 FEET TO A POINT LOCATED ALONG THE NORTHERN BOUNDARY LINE OF LOT 26 AND BEING 8 FEET WEST OF THE NORTHWEST CORNER OF LOT 25; THENCE LEAVING THE NORTH LINE OF SAID BLOCK 9 AND RUNNING PARALLEL TO AND 8 FEET TO THE WEST OF SAID WEST LINE OF LOT 25, BLOCK 9 (SAID LINE BEING THE WESTERN BOUNDARY LINE OF THE PROPERTY NOW OR FORMERLY OWNED BY RALPH W. ZIMMERMAN) RUN IN A SOUTHERLY DIRECTION A DISTANCE OF 121 FEET TO A POINT; THENCE, CONTINUING ALONG THE BOUNDARY LINE OF SAID LAND NOW OR FORMERLY OWNED BY RALPH W. ZIMMERMAN, RUN THE FOLLOWING 2 COURSES AND DISTANCES: WITH AN INCLUDED ANGLE TO THE RIGHT OF 90°00'00". RUN ANGLE TO THE RIGHT OF 90°00'00", RUN NORTHERLY A DISTANCE OF 121 FEET TO A POINT SAID POINT BEING ALONG THE NORTH LINE OF SAID BLOCK 9; THENCE LEAVING THE LANDS NOW OR FORMERLY OWNED BY RALPH W. ZIMMERMAN AND CONTINUING ALONG THE NORTH LINE OF BLOCK 9 RUN IN AN EASTERLY DIRECTION A DISTANCE OF 60.39 FEET TO A POINT; THENCE WITH AN INCLUDED ANGLE TO THE LEFT OF 89°17'08", RUN SOUTHERLY ALONG THE EAST LINE OF SAID BLOCK 9, A DISTANCE OF 255.02 FEET TO THE SOUTHEAST CORNER OF SAID LOT 22; THENCE WITH AN INCLUDED ANGLE TO THE LEFT O 90°42'52", RUN WESTERLY ALONG THE SOUTH LINE OF SAID BLOCK 9, A DISTANCE OF 232.21 FEET TO THE SOUTHWEST CORNER OF SAID LOT 14; THENCE WITH AN INCLUDED ANGLE TO THE LEFT OF 90°00'00", RUN NORTHERLY ALONG THE WEST LINE OF SAID LOT 14, A DISTANCE OF 134.00 FEET TO THE SOUTHWEST CORNER OF SAID LOT 31; THENCE WITH AN INCLUDED ANGLE TO TH RIGHT OF 90°00'00", RUN WESTERLY ALONG THE SOUTH LINE OF SAID LOTS 32 THROUGH 38, A DISTANCE OF 175.00 FEET TO THE SOUTHWEST CORNER OF SAID LOT 38; THENCE WITH AN INCLUDED ANGLE TO THE LEFT OF 90°00'00", RUN NORTHERLY ALONG THE WEST LINE OF SAID LOT 38, A DISTANCE OF 121.00 FEET

PARCEL 3:

LOTS 1 AND 2. BLOCK 9. HOLLYWOOD, ACCORDING TO THE PLAT THEREOF AS RECORDED IN PLAT BOOK 1. PAGE 21, PUBLIC RECORDS OF BROWARD COUNTY

PARCEL 4:

LOT 3, BLOCK 9, HOLLYWOOD, ACCORDING TO THE PLAT THEREOF AS RECORDED IN PLAT BOOK 1. PAGE 21, PUBLIC RECORDS OF BROWARD COUNTY, FLORIDA.

project info:

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OBERT K. MORISETTE, AIA, NCARB, LEED AP BD+C, CDP FLORIDA REGISTERED ARCHITECT # AR 93259

evisions: 01.07.2021 Updating Units ReSubmit 324 Units 04-01*2021

2020-09-04

drawing data:

EASEMENT **EXHIBIT &** SITE PLAN NOTES

project number:

drawing scale:

drawing date: 01/07/2021


#19024

As Shown

Final TAC

sheet number: A1.03

CRA Note: Streetscape Design and Materials will be coordinated with CRA

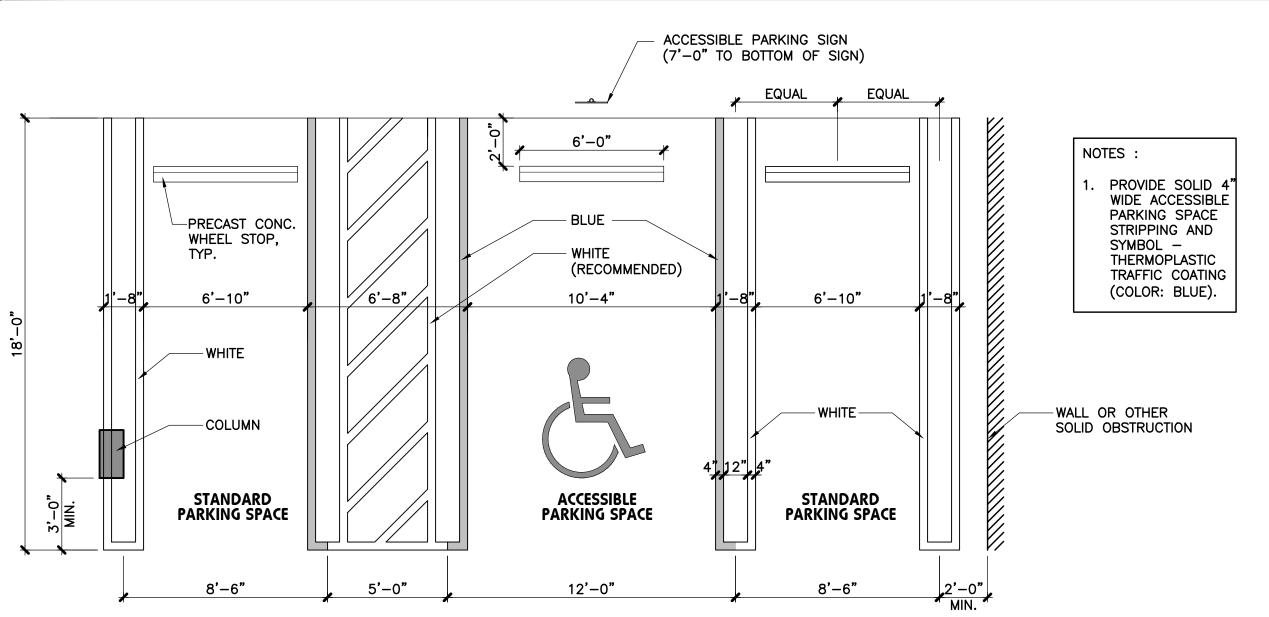

1½" GALVINIZED METAL STRAP W/ CARRIAGE THRU BOLTS FOR SIGN MOUNTING WHITE ACCESSIBLE SIGN ON BLUE BACKGROUND BLACK LETTERS 1" PARKING E HIGH ON WHITE DISABLED BACKGROUND PERMIT BLACK BORDER ON WHITE BACKGROUND ONLY - 1−3/4" DIA. GALV. MTL PIPE PAINT COLOR AS SELECTED BY ARCHITECT **ASPHALT** WELDED #3 BARS 4" LONG 6"X18" DEEP NON-SHRINK EPOXY GROUT FOOTING

ALL LETTERS TO BE 1" SERIES "C" SPACED 1" BETWEEN TEXT

TOP SIGN SHALL HAVE A REFLECTORIZED BLUE BACKGROUND WITH WHITE

REFLECTORIZED H.C. SIGN. BOTTOM SIGNS SHALL HAVE A REFLECTORIZED WHITE BACKGROUND WITH BLACK OPAQUE


LETTERS AND BORDER.

SIGN SHALL BE LOCATED IN A MANNER THAT THE LOWEST SIGN DOES NOT PROTRUDE INTO THE REQUIRED HEADROOM CLEARANCE ALONG THE ACCESSIBLE ROUTE SERVING THE PARKING AREAS.

COORDINATE SPECIFIC SIGNAGE REQUIREMENTS WITH LOCAL AUTHORITY HAVING JURISDICTION PRIOR TO ORDERING, FABRICATION AND INSTALLATION OF SIGNS.

03 Typical Accessible Parking Sign Det.

COMPACTED FILL

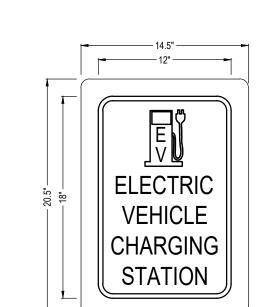

THICKNESS/DEPTH: 1/2" FRAME COLOR: AVAILABLE IN 18 COLOR COMBOS, CONTACT PUBLIC SAFETY INDUSTRIES FOR INFO.

Electric Vehicule Charging Station Signage

SITE ACCESSIBILITY NOTES

ANY PART OF AN ACCESSIBLE ROUTE WITH A SLOPE GREATER THAN 1:20 SHALL BE CONSIDERED A RAMP AND SHALL COMPLY WITH FOLLOWING:

SLOPE AND RISE

THE LEAST POSSIBLE SLOPE SHALL BE USED FOR ANY RAMP. THE MAXIMUM SLOPE OF A RAMP IN NEW CONSTRUCTION SHALL 1:12. THE MAXIMUM RISE FOR ANY RUN SHALL BE 30 IN.

CLEAR WIDTH

1 - MINIMUM CLEAR WIDTH OF A RAMP SHALL BE 44" CLEAR. 2 - RAMPS THAT ARE PART OF A REQUIRED MEANS OF EGRESS SHALL BE NOT LESS THAN 44 INCHES CLEAR.

<u>LANDINGS</u>

RAMPS SHALL HAVE LEVEL LANDINGS AT THE BOTTOM AND TOP OF EACH RAMP AND AT EACH RAMP RUN. 1 - LANDING SHALL HAVE THE FOLLOWING FEATURES. 2 - IF RAMPS CHANGE DIRECTION AT LANDINGS, THE MINIMUM LANDING SIZE

3 — IF A DOORWAY IS LOCATED AT A LANDING, THEN THE AREA IN FRONT OF THE DOORWAY SHALL COMPLY FBC ACCESSIBILITY 2014.

<u>HANDRAILS</u>

IF A RAMP RUN HAS A RISE GREATER THAN 6 IN. OR A HORIZONTAL PROJECTION GREATER THAN 72 IN. THEN IT SHALL HAVE HANDRAILS ON BOTH SIDES. HANDRAILS ARE NOT REQUIRED ON CURB RAMPS OR ADJACENT TO SEATING IN ASSEMBLY AREAS. HANDRAILS SHALL COMPLY WITH 4.26 OF THE ADA CODE AND SHALL HAVE THE FOLLOWING FEATURES: 1 - HANDRAILS SHALL BE PROVIDED ALONG BOTH SIDES OF RAMP SEGMENTS.

THE INSIDE HANDRAIL ON SWITCHBACK OR DOGLEG RAMPS SHALL ALWAYS

BE CONTINUOUS. 2 - HANDRAILS ON RAMPS WHICH ARE NOT CONTINUOUS SHALL EXTEND NOT LESS THAN 18" BEYOND THE SLOPED SEGMENT AT BOTH THE TOP AND BOTTOM, AND SHALL BE PARALLEL TO THE FLOOR OR GROUND SURFACE. 3 - THE CLEAR SPACE BETWEEN THE HANDRAIL AND THE WALL SHALL 1-1/2

4 - GRIPPING SURFACES SHALL BE CONTINUOUS. 5 - TOP OF HANDRAIL GRIPPING SURFACES SHALL BE MOUNTED BETWEEN 34

IN. AND 38 IN. ABOVE RAMP SURFACES. 6 - ENDS OF HANDRAILS SHALL BE EITHER ROUNDED OR RETURNED SMOOTHLY TO FLOOR, WALL OR POST.


CROSS SLOPE SURFACES THE CROSS SLOPE SURFACES SHALL BE NO GREATER THAN 1:50. RAMP SURFACES SHALL COMPLY W/ CHAPTER 4 OF THE FBC 2010 ACCESSIBILTY

7 - HANDRAILS SHALL NOT ROTATE WITHIN THEIR FITTINGS.

EDGE PROTECTION

RAMPS AND LANDINGS WITH DROP-OFFS SHALL HAVE CURBS, RAILINGS OR PROJECTING SURFACES THAT PREVENT PEOPLE FROM SLIPPING OF THE RAMP. CURBS SHALL BE A MINIMUM OF 2 IN. HIGH.

OUTDOOR RAMPS AND THEIR APPROACHES SHALL BE DESIGNED SO THAT WATER WILL NOT ACCUMULATE ON WALKING SURFACES.

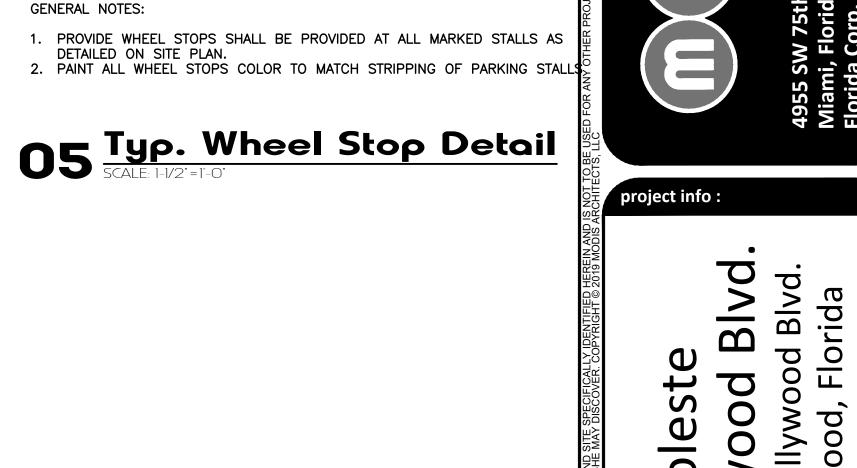

2'-8" TO EDGE OF PARKING SPACE

(2) #4 BARS, CONT.

TOP OF ASPHALT PAVEMENT



1601 LIFT GATE $\frac{1}{2}$ HP 15"W x 18"H x 15"D


CALL BOX DETAIL 15.25"W x 19"H X 4"D

Life Gate Detail





AE200PLUS TELEPHONE ENTRY

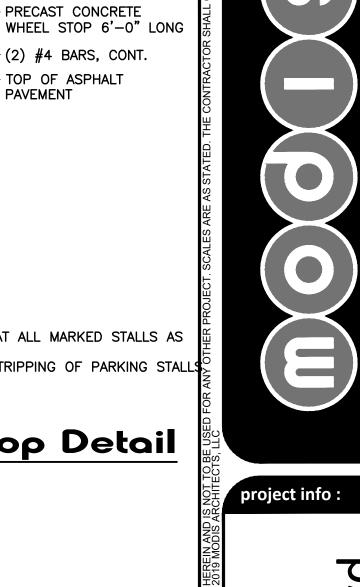

ROBERT K. MORISETTE, AIA, NCARB, LEED AP BD+C, CDP FLORIDA REGISTERED ARCHITECT # AR 93259

01.07.2021 Updating Units ReSubmit 324 Units 04-01*2021

drawing data: SITE PLAN DETAILS


project number: #19024


drawing scale: As Shown drawing date:


> 01/07/2021 Final TAC

sheet number:


A1.04

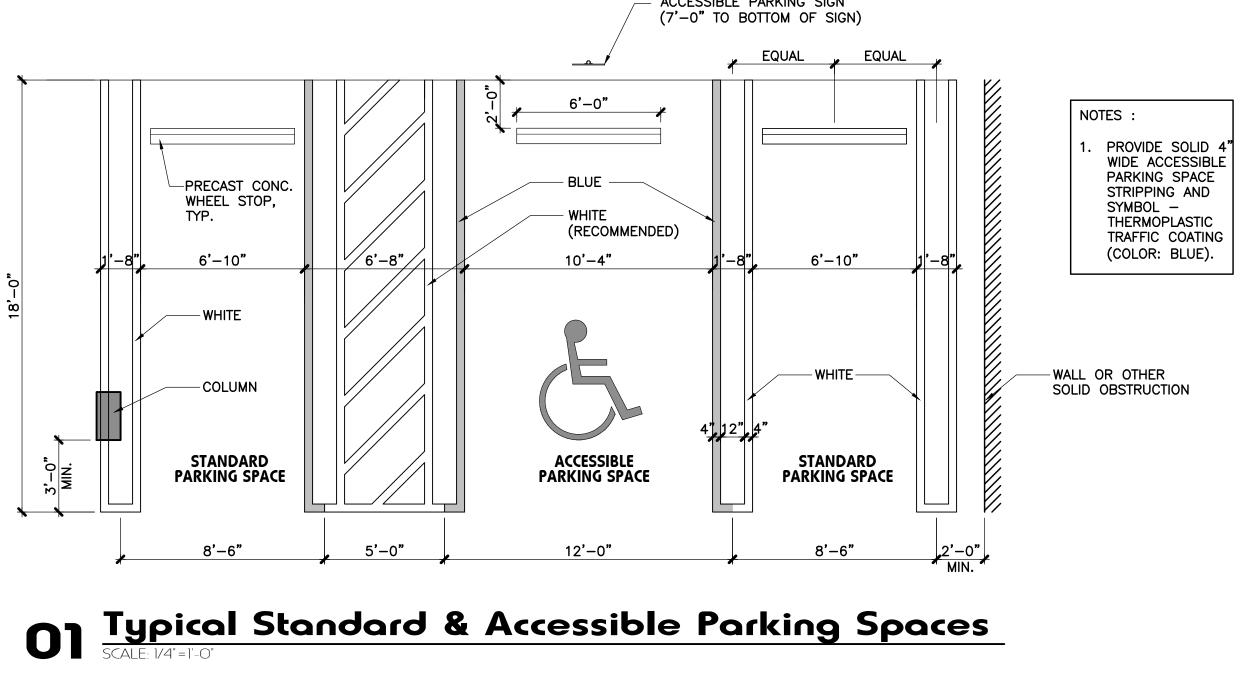

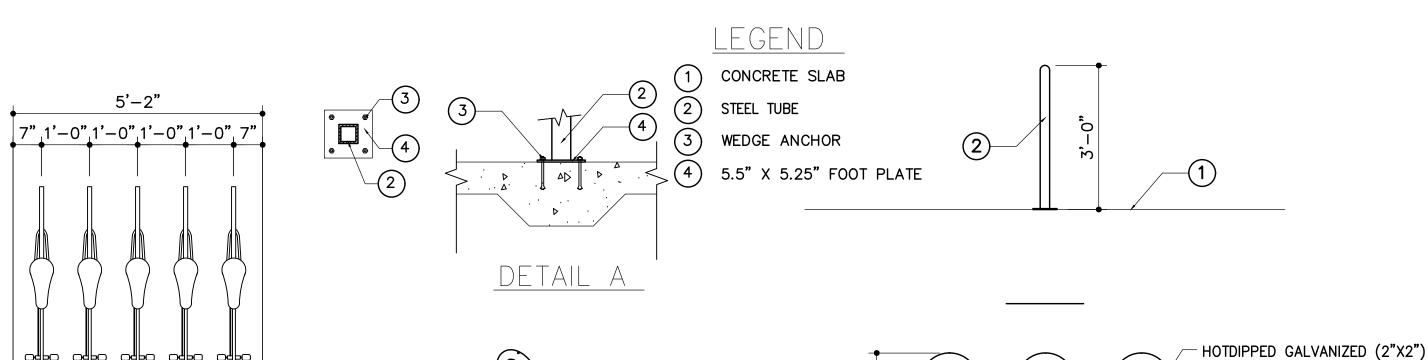

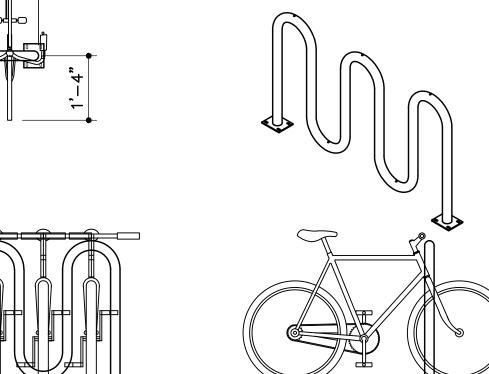


Bicycle Rack Detail SCALE: N.T.S.

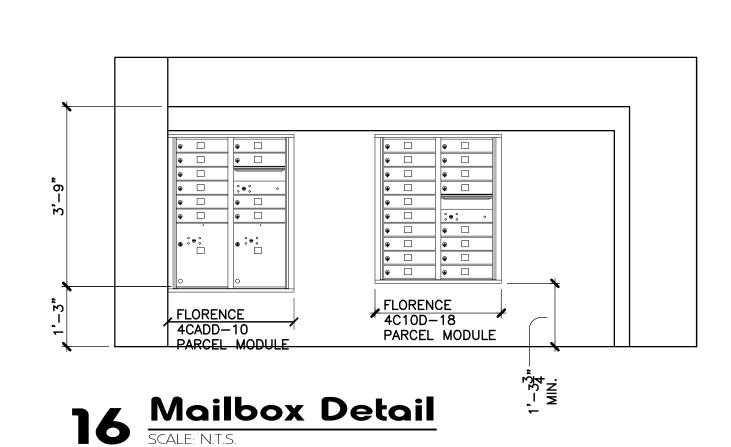

ALL MAILBOXES TO COMPLY WITH AMERICANS

WITH DISABILITIES ACT ACCESSIBILITY

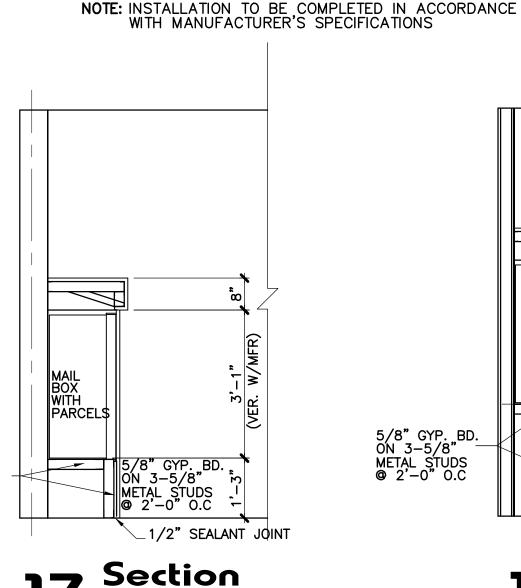

ALL BICYCLE PARKING SPACES SHALL BE POSTED

ABOVE GROUND SIGN WHICH SHALL CONFORM TO

THE FIGURE ENTITLED "SECURED BICYCLE PARKING"

WITH A PERMANENT & PROPERTY MAINTAINED

THE BOTTOM OF THE SIGN MUST BE AT LEAST

FIVE (5) FEET ABOVE GRADE WHEN ATTACHED

IN THE COUNTY MAINTAINED RIGHT-OF-WAY.

TO THE BUILDING, WHICH MAY NOT BE INSTALLED

NOT PERMIT SHOULD BE REQUIRED FOR SUCH SIGN.

BICYCLE RACKS

4CADD-10


PARCEL MODULE

SIGNAGE & MARKING

MAIL BOX UNIT

X 3/16" SQUARE STEEL TUBE

Section 4C10D-18 PARCEL MODULE

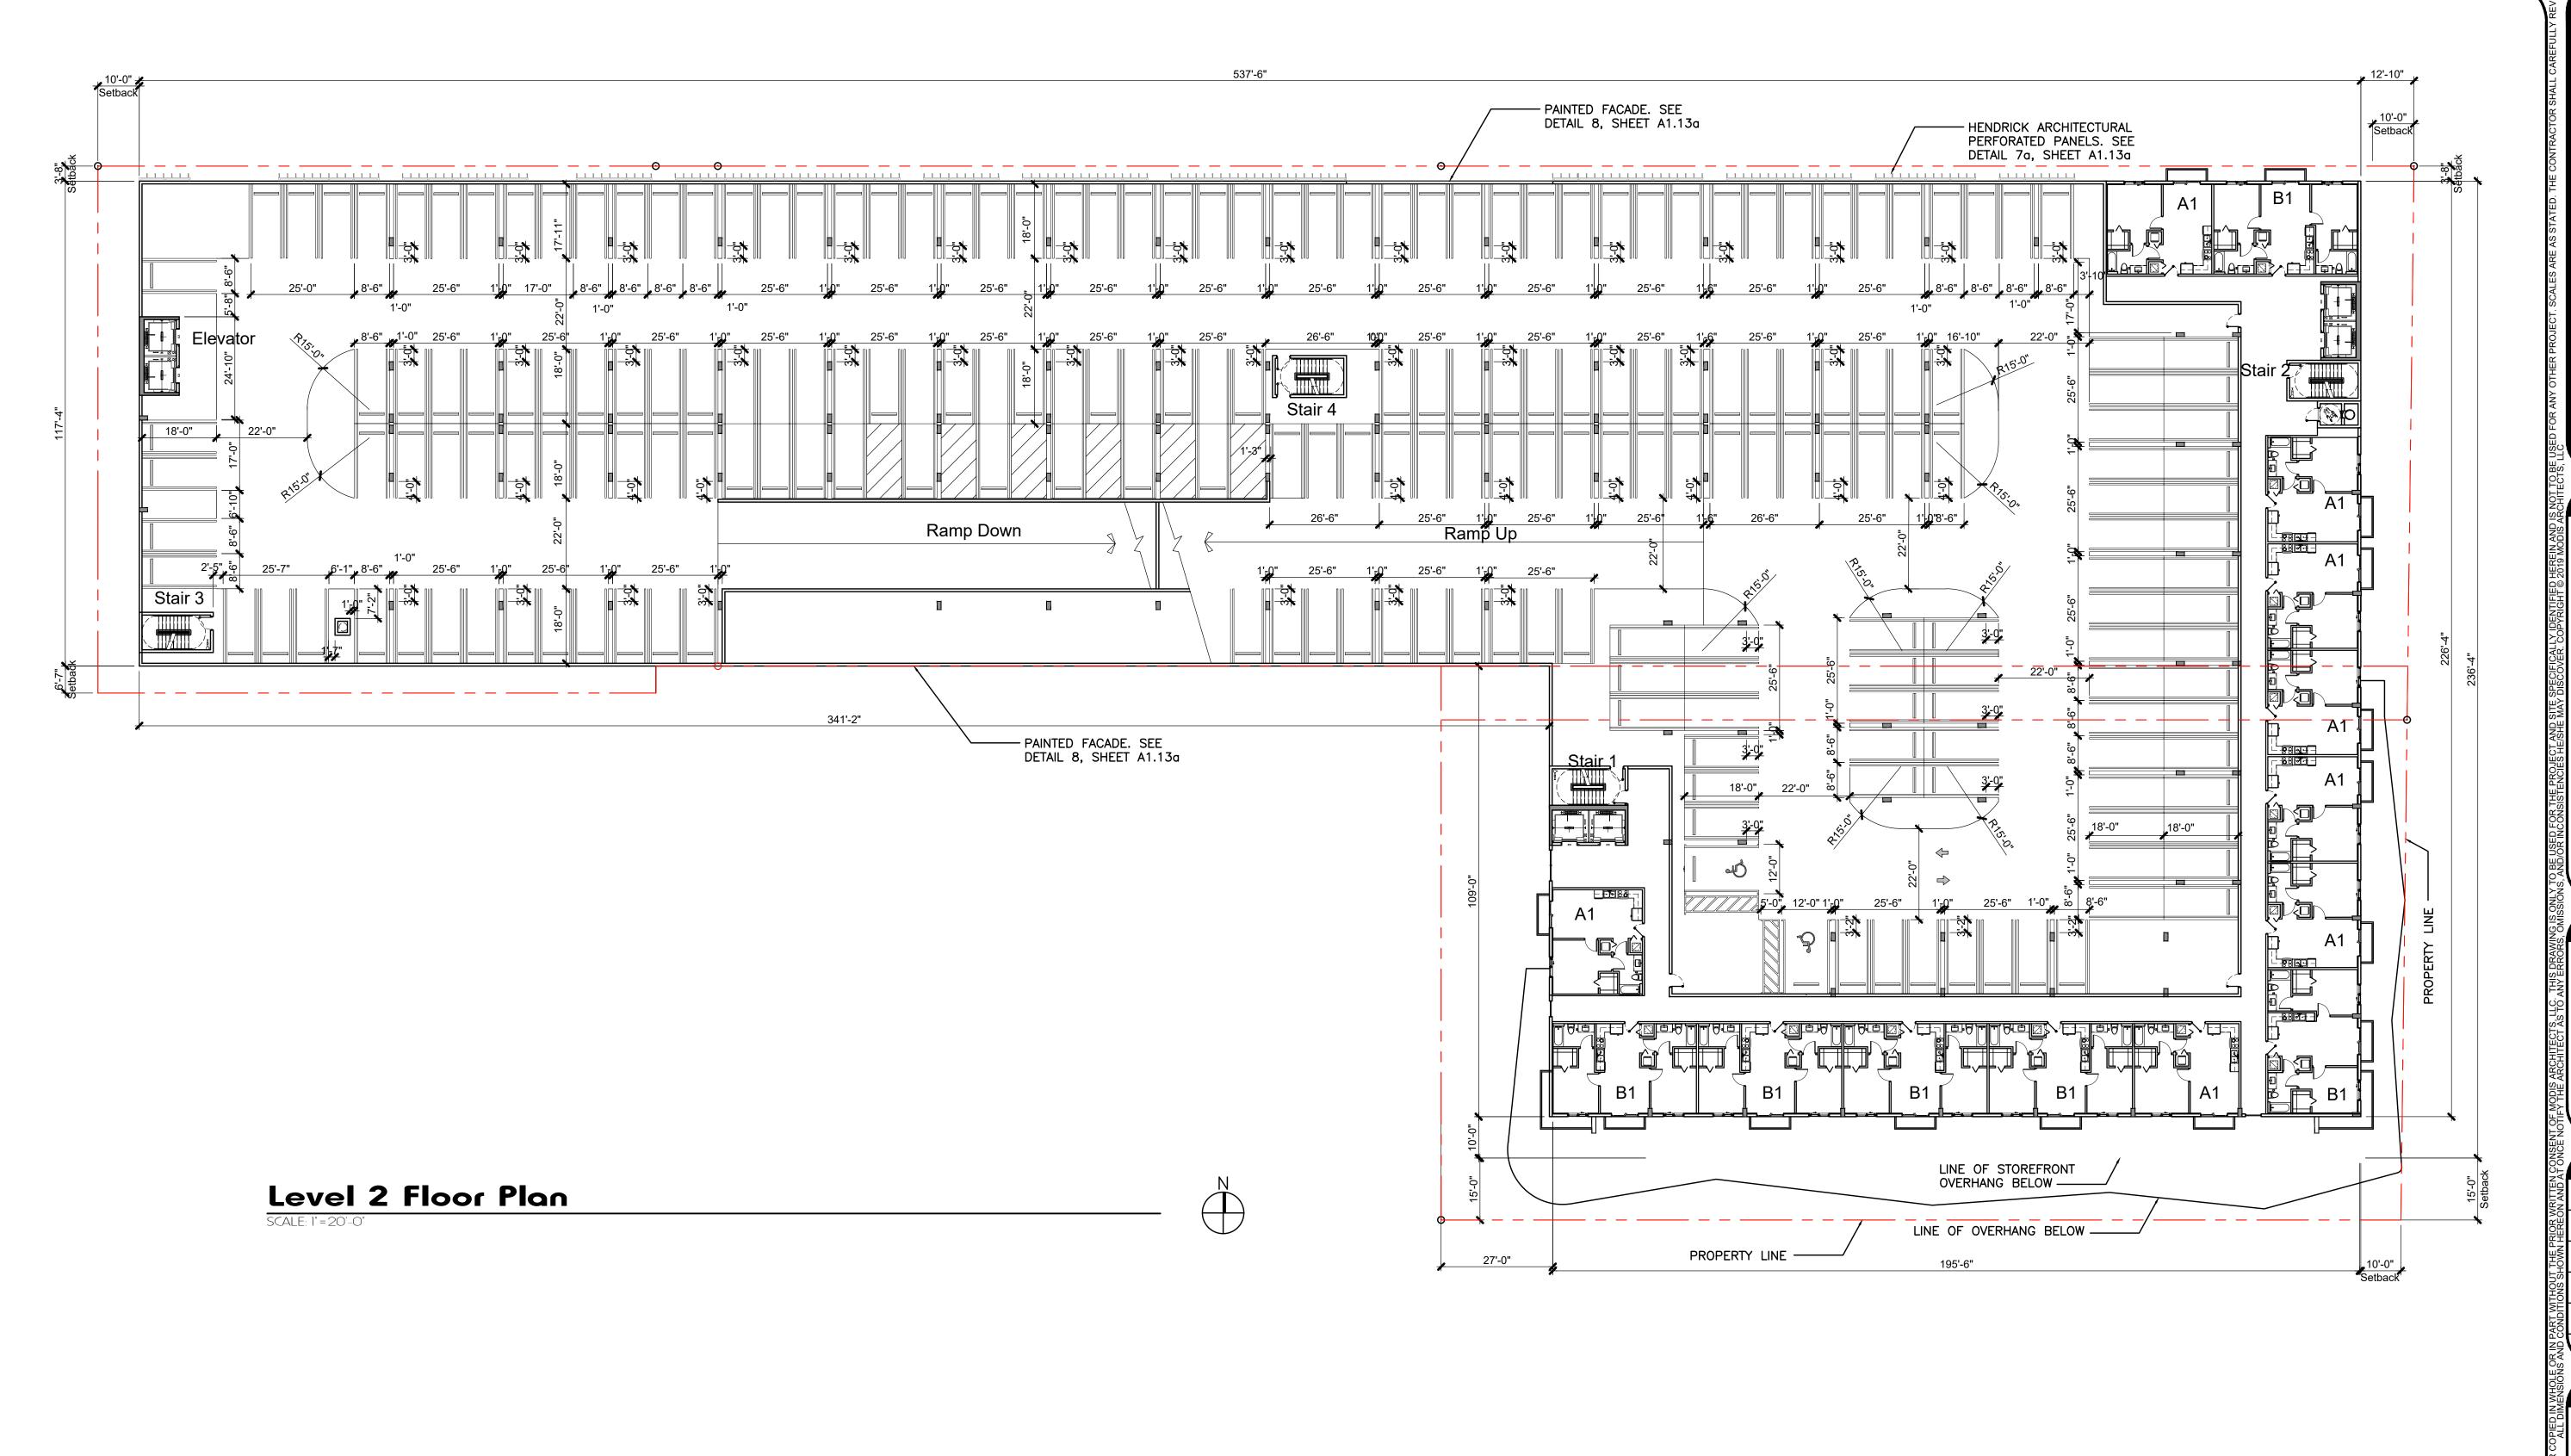

| | | | | | Tower 1 Unit A | rea Calculation | | | | | | | | | ٦ | Tower 2 Unit Ar | ea Calculatio | n | | | | |
|---------------|-------|----------|----------|----------|----------------|-----------------|---------------|-----------|---------------|-----------------------|---|---------------|---------|----------|---------------|-----------------|---------------|---------------|-------------|---------------|--------------------------|------------------------------------|
| | | Studio | A1 (1bd) | A3 (1bd) | A4 (1-bd+Den) | B1 (2-bd) | B2 (2-bd+Den) | B3 (2-bd) | B4 (2 bd+Den) | Total Units per Floor | . Total Area Floor Plate Above 55'0" | | Studio | A1 (1bd) | A3 (1bd) | A4 (1-bd+Den) | B1 (2-bd) | B2 (2-bd+Den) | B3 (2-bd) | B4 (2 bd+Den) | Total Units per Floor | Total Are Floor Pla Above 55 |
| Leasable Area | | 399 sf | 591 sf | 606 sf | 753 sf | 828 sf | 1,232 sf | 957 sf | 1,074 sf | | | Leasable Area | 414 sf | 621 sf | 606 sf | 753 sf | 828 sf | 1,210 sf | 957 sf | 1,074 sf | | |
| Balc./Terr. | | 27 sf | 30 sf | 42 sf | 53 sf | 30 sf | 84 sf | 75 sf | 75 sf | | | Balc./Terr. | 27 sf | 30 sf | 30 sf | 53 sf | 30 sf | 80 sf | 75 sf | 75 sf | | |
| Level 1 | | 0 | 0 | 0 | 0 | 0 | 0 | 0 | 0 | 0 | | Level 1 | 0 | 0 | 0 | 0 | 0 | 0 | 0 | 0 | 0 | |
| Level 2 | | 0 | 8 | 0 | 0 | 6 | 0 | 0 | 0 | 14 | | Level 2 | 0 | 0 | 0 | 0 | 0 | 0 | 0 | 0 | 0 | |
| Level 3 | | 0 | 8 | 0 | 0 | 6 | 0 | 0 | 0 | 14 | | Level 3 | 0 | 0 | 0 | 0 | 0 | 0 | 0 | 0 | 0 | |
| Level 4 | | 2 | 14 | 4 | 2 | 14 | 1 | 0 | 0 | 37 | 33,320 sf | Level 4 | 1 | 4 | 0 | 0 | 6 | 0 | 1 | 1 | 13 | 20,865 \$ |
| Level 5 | | 2 | 16 | 4 | 2 | 14 | 1 | 0 | 0 | 39 | 33,320 sf | Level 5 | 2 | 6 | 1 | 1 | 10 | 1 | 1 | 1 | 23 | 20,865 |
| Level 6 | | 2 | 16 | 4 | 2 | 14 | 1 | 0 | 0 | 39 | 33,320 sf | Level 6 | 2 | 6 | 1 | 1 | 10 | 1 | 1 | 1 | 23 | 20,865 s |
| Level 7 | | 2 | 16 | 4 | 2 | 14 | 1 | 0 | 0 | 39 | 33,320 sf | Level 7 | 2 | 6 | 1 | 1 | 10 | 1 | 1 | 1 | 23 | 20,865 s |
| Level 8 | 0 | 2 | 17 | 4 | 2 | 11 | 1 | 0 | 0 | 37 | 31,272 sf | Level 8 | 2 | 6 | 1 | 1 | 10 | 1 | 1 | 1 | 23 | 20,865 s |
| Sub Total | Units | 10 Units | 95 Units | 20 Units | 10 Units | 79 Units | 5 Units | 0 Units | 0 Units | | | Sub Total | 9 Units | 28 Units | 4 Units | 4 Units | 46 Units | 4 Units | 5 Units | 5 Units | | |
| | | | | | | | | Total Uni | s in Tower 1 | 219 Units | | | | | | | | | Total Units | s For Tower 2 | 105 | |
| · | | | | | | | | | | | | | | То | tal Units for | Tower 1 & Towe | er 2 | 324 DU | | | | |



project info :

Soleste
Hollywood Blvd

ROBERT K. MORISETTE, AIA, NCARB, LEED AP BD+C, CDP FLORIDA REGISTERED ARCHITECT # AR 93259

drawing data:

LEVEL 2
FLOOR PLAN

project number :

drawing scale :


As Shown
drawing date :

#19024


01/07/2021

phase:
Final TAC

sheet number :

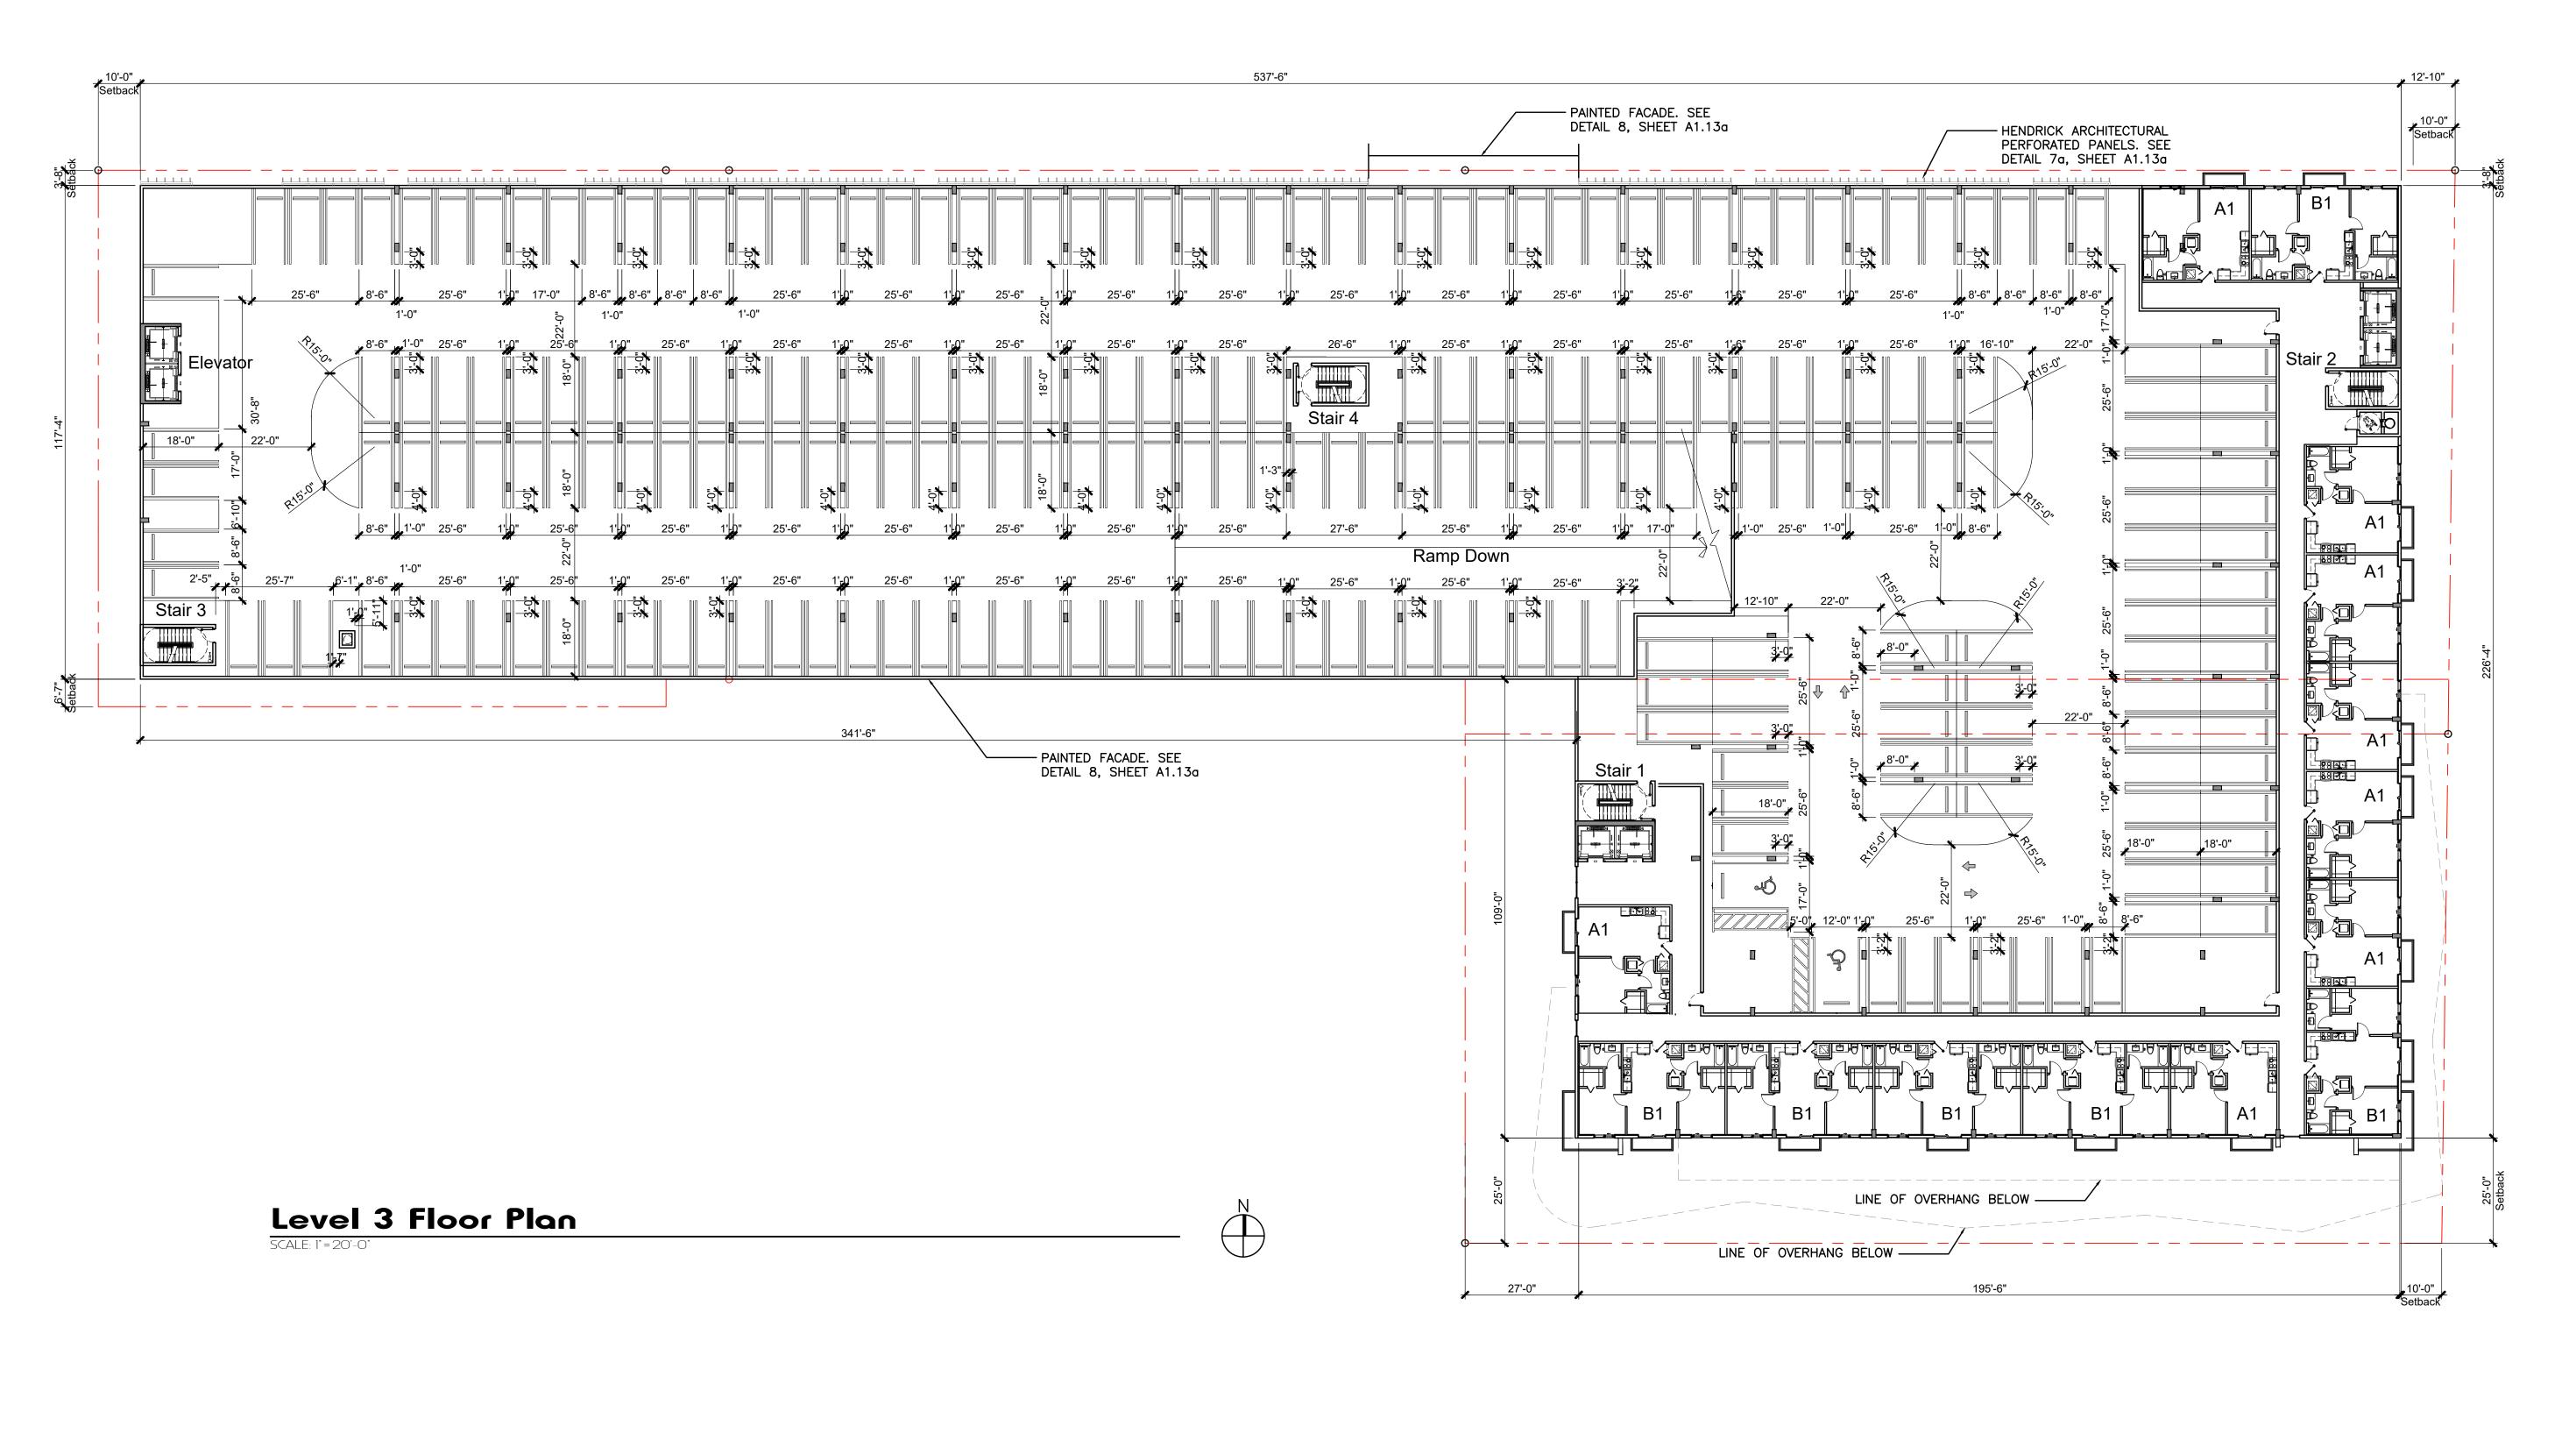

| | | | | | Tower 1 Unit A | rea Calculation | | | | | | | | | | Tower 2 Unit A | rea Calculation | on | | | | |
|--------------|-------|----------|----------|----------|----------------|-----------------|---------------|-----------|---------------|----------------------|---------------------------------------|---------------|---------|----------|----------------|----------------|-----------------|---------------|------------|---------------|--------------------------|--|
| | | Studio | A1 (1bd) | A3 (1bd) | A4 (1-bd+Den) | B1 (2-bd) | B2 (2-bd+Den) | B3 (2-bd) | B4 (2 bd+Den) | Total Units per Floo | Total Area Floor Plate Above 55'0" | | Studio | A1 (1bd) | A3 (1bd) | A4 (1-bd+Den) | B1 (2-bd) | B2 (2-bd+Den) | B3 (2-bd) | B4 (2 bd+Den) | Total Units per Floor | Total Area Floor Plate Above 55'0" |
| easable Area | | 399 sf | 591 sf | 606 sf | 753 sf | 828 sf | 1,232 sf | 957 sf | 1,074 sf | | | Leasable Area | 414 sf | 621 sf | 606 sf | 753 sf | 828 sf | 1,210 sf | 957 sf | 1,074 sf | | |
| Balc./Terr. | | 27 sf | 30 sf | 42 sf | 53 sf | 30 sf | 84 sf | 75 sf | 75 sf | | | Balc./Terr. | 27 sf | 30 sf | 30 sf | 53 sf | 30 sf | 80 sf | 75 sf | 75 sf | | |
| Level 1 | | 0 | 0 | 0 | 0 | 0 | 0 | 0 | 0 | 0 | | Level 1 | 0 | 0 | 0 | 0 | 0 | 0 | 0 | 0 | 0 | |
| Level 2 | | 0 | 8 | 0 | 0 | 6 | 0 | 0 | 0 | 14 | | Level 2 | 0 | 0 | 0 | 0 | 0 | 0 | 0 | 0 | 0 | |
| Level 3 | | 0 | 8 | 0 | 0 | 6 | 0 | 0 | 0 | 14 | | Level 3 | 0 | 0 | 0 | 0 | 0 | 0 | 0 | 0 | 0 | |
| Level 4 | | 2 | 14 | 4 | 2 | 14 | 1 | 0 | 0 | 37 | 33,320 sf | Level 4 | 1 | 4 | 0 | 0 | 6 | 0 | 1 | 1 | 13 | 20,865 sf |
| Level 5 | | 2 | 16 | 4 | 2 | 14 | 1 | 0 | 0 | 39 | 33,320 sf | Level 5 | 2 | 6 | 1 | 1 | 10 | 1 | 1 | 1 | 23 | 20,865 sf |
| Level 6 | | 2 | 16 | 4 | 2 | 14 | 1 | 0 | 0 | 39 | 33,320 sf | Level 6 | 2 | 6 | 1 | 1 | 10 | 1 | 1 | 1 | 23 | 20,865 sf |
| Level 7 | | 2 | 16 | 4 | 2 | 14 | 1 | 0 | 0 | 39 | 33,320 sf | Level 7 | 2 | 6 | 1 | 1 | 10 | 1 | 1 | 1 | 23 | 20,865 sf |
| Level 8 | 0 | 2 | 17 | 4 | 2 | 11 | 1 | 0 | 0 | 37 | 31,272 sf | Level 8 | 2 | 6 | 1 | 1 | 10 | 1 | 1 | 1 | 23 | 20,865 sf |
| Sub Total | Units | 10 Units | 95 Units | 20 Units | 10 Units | 79 Units | 5 Units | 0 Units | 0 Units | | | Sub Total | 9 Units | 28 Units | 4 Units | 4 Units | 46 Units | 4 Units | 5 Units | 5 Units | | |
| | | | | | | | | Total Uni | ts in Tower 1 | 219 Units | | | | | | | | | Total Unit | s For Tower 2 | 105 | |
| | | | | | | | | | | | | | | To | otal Units for | Tower 1 & Tow | er 2 | 324 DU | | | | |

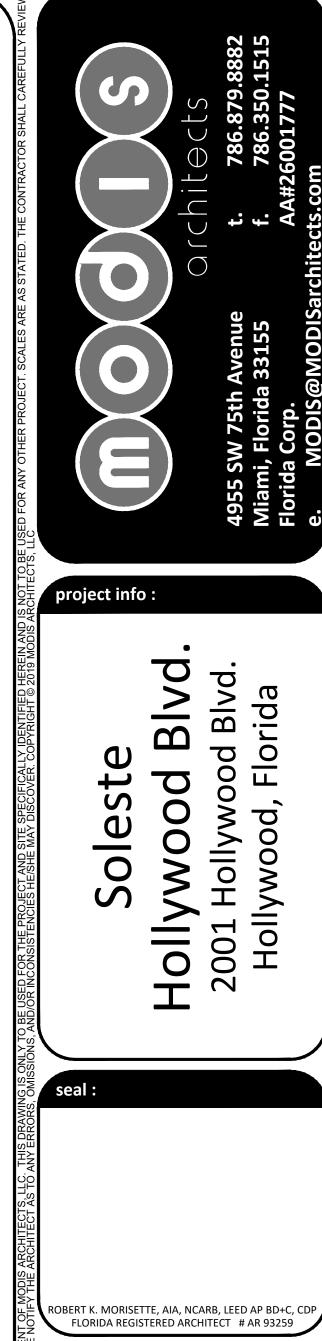

revisions:

Updating Units 01.07.2021

ReSubmit 324 Units 04-01*2021

drawing data:

LEVEL 3

FLOOR PLAN

project number :

#19024

drawing scale:


As Shown

drawing date:

01/07/2021

Final TAC

sheet number:
A1.06

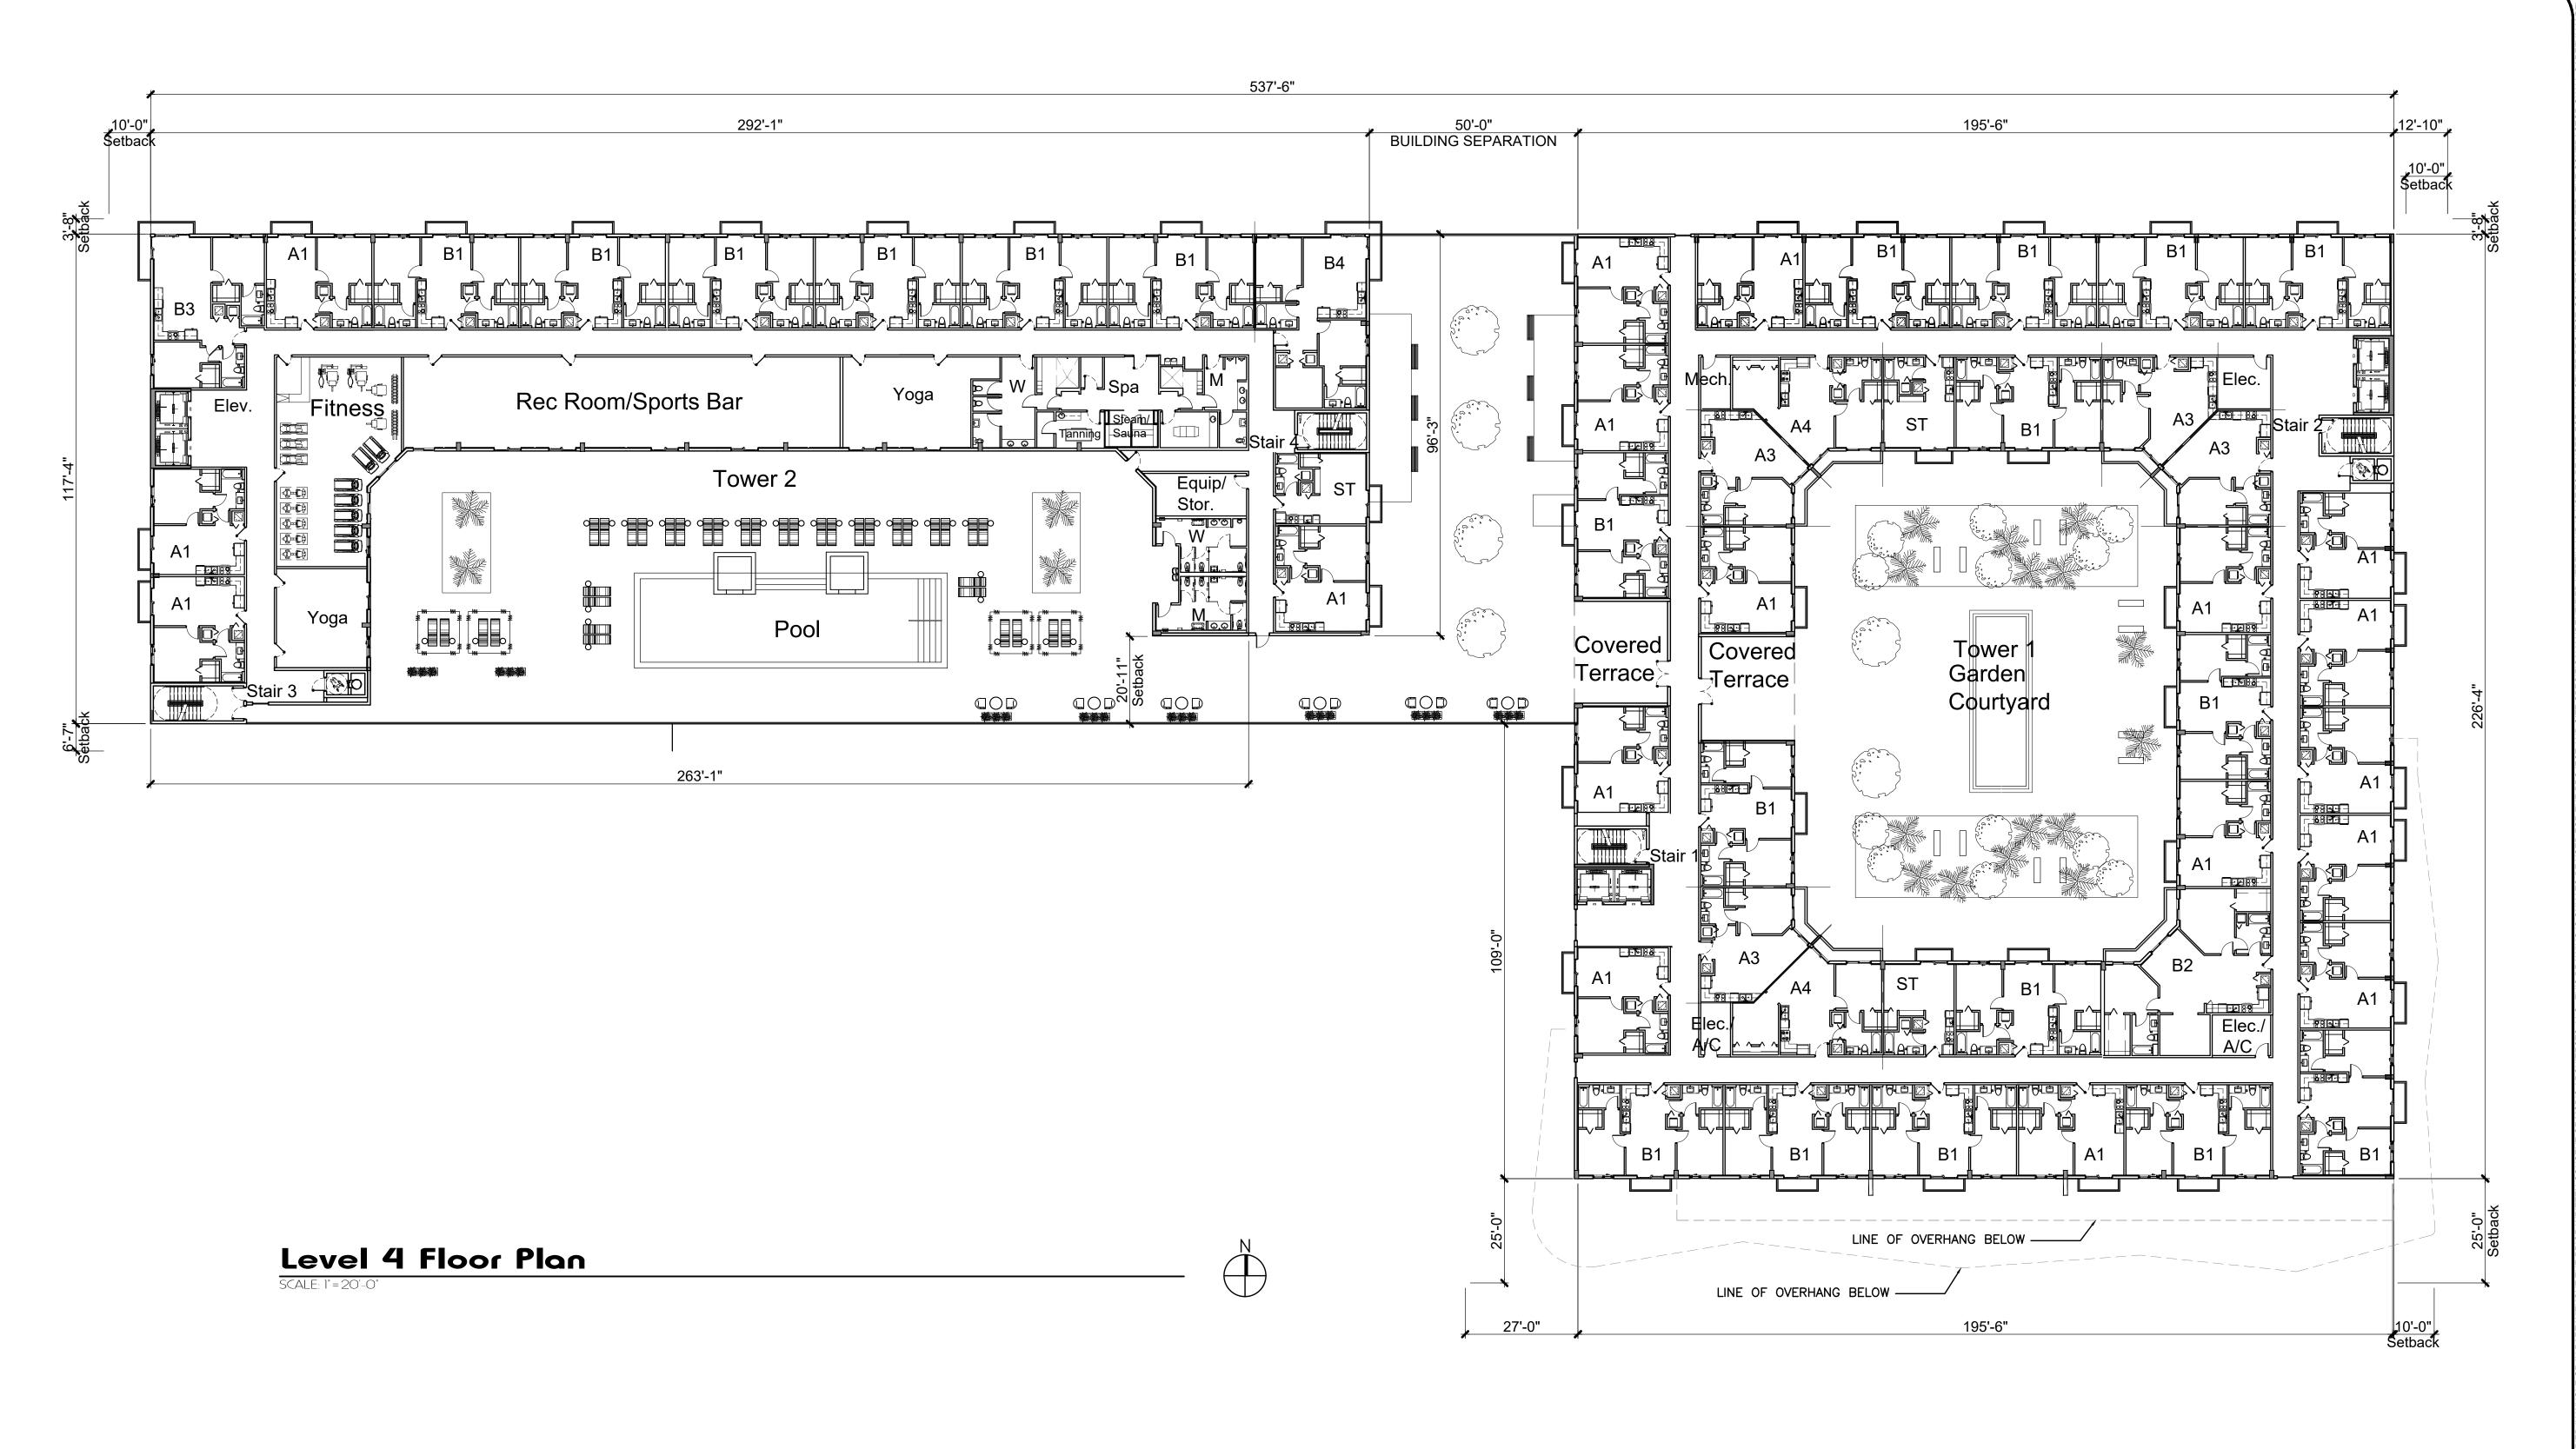

| | | | | | Tower 1 Unit A | rea Calculation | | | | | | | | | 1 | Tower 2 Unit A | rea Calculatio | n | | | | |
|--------------|-------|----------|----------|----------|----------------|-----------------|---------------|-----------|----------------|---------------------|--|---------------|---------|----------|---------------|----------------|----------------|---------------|-------------|---------------|----------------|--|
| | | Studio | A1 (1bd) | A3 (1bd) | A4 (1-bd+Den) | B1 (2-bd) | B2 (2-bd+Den) | B3 (2-bd) | B4 (2 bd+Den) | Total Units per Flo | or Total Area Floor Plate Above 55'0" | | Studio | A1 (1bd) | A3 (1bd) | A4 (1-bd+Den) | B1 (2-bd) | B2 (2-bd+Den) | B3 (2-bd) | B4 (2 bd+Den) | Total Units pe | Total Area Floor Plate Above 55'0' |
| easable Area | | 399 sf | 591 sf | 606 sf | 753 sf | 828 sf | 1,232 sf | 957 sf | 1,074 sf | | | Leasable Area | 414 sf | 621 sf | 606 sf | 753 sf | 828 sf | 1,210 sf | 957 sf | 1,074 sf | | |
| Balc./Terr. | | 27 sf | 30 sf | 42 sf | 53 sf | 30 sf | 84 sf | 75 sf | 75 sf | | | Balc./Terr. | 27 sf | 30 sf | 30 sf | 53 sf | 30 sf | 80 sf | 75 sf | 75 sf | | |
| Level 1 | | 0 | 0 | 0 | 0 | 0 | 0 | 0 | 0 | 0 | | Level 1 | 0 | 0 | 0 | 0 | 0 | 0 | 0 | 0 | 0 | |
| Level 2 | | 0 | 8 | 0 | 0 | 6 | 0 | 0 | 0 | 14 | | Level 2 | 0 | 0 | 0 | 0 | 0 | 0 | 0 | 0 | 0 | |
| Level 3 | | 0 | 8 | 0 | 0 | 6 | 0 | 0 | 0 | 14 | | Level 3 | 0 | 0 | 0 | 0 | 0 | 0 | 0 | 0 | 0 | |
| Level 4 | | 2 | 14 | 4 | 2 | 14 | 1 | 0 | 0 | 37 | 33,320 sf | Level 4 | 1 | 4 | 0 | 0 | 6 | 0 | 1 | 1 | 13 | 20,865 sf |
| Level 5 | | 2 | 16 | 4 | 2 | 14 | 1 | 0 | 0 | 39 | 33,320 sf | Level 5 | 2 | 6 | 1 | 1 | 10 | 1 | 1 | 1 | 23 | 20,865 sf |
| Level 6 | | 2 | 16 | 4 | 2 | 14 | 1 | 0 | 0 | 39 | 33,320 sf | Level 6 | 2 | 6 | 1 | 1 | 10 | 1 | 1 | 1 | 23 | 20,865 sf |
| Level 7 | | 2 | 16 | 4 | 2 | 14 | 1 | 0 | 0 | 39 | 33,320 sf | Level 7 | 2 | 6 | 1 | 1 | 10 | 1 | 1 | 1 | 23 | 20,865 sf |
| Level 8 | 0 | 2 | 17 | 4 | 2 | 11 | 1 | 0 | 0 | 37 | 31,272 sf | Level 8 | 2 | 6 | 1 | 1 | 10 | 1 | 1 | 1 | 23 | 20,865 sf |
| Sub Total | Units | 10 Units | 95 Units | 20 Units | 10 Units | 79 Units | 5 Units | 0 Units | 0 Units | | | Sub Total | 9 Units | 28 Units | 4 Units | 4 Units | 46 Units | 4 Units | 5 Units | 5 Units | | |
| | | | | | | | | Total Un | its in Tower 1 | 219 Units | | | | | | | | | Total Units | For Tower 2 | 105 | |
| • | | | | | | | | | | | | | | To | tal Units for | Tower 1 & Tow | er 2 | 324 DU | | | | |

AA#26001777

leste vood Blvc

project info:

Hollywo

ROBERT K. MORISETTE, AIA, NCARB, LEED AP BD+C, CDP FLORIDA REGISTERED ARCHITECT # AR 93259

Updating Units 01.07.2021

ReSubmit 324 Units 04-01*2021

drawing data:

LEVEL 4
FLOOR PLAN

project number :


drawing scale :

As Shown
drawing date :


#19024

01/07/2021

Final TAC sheet number:

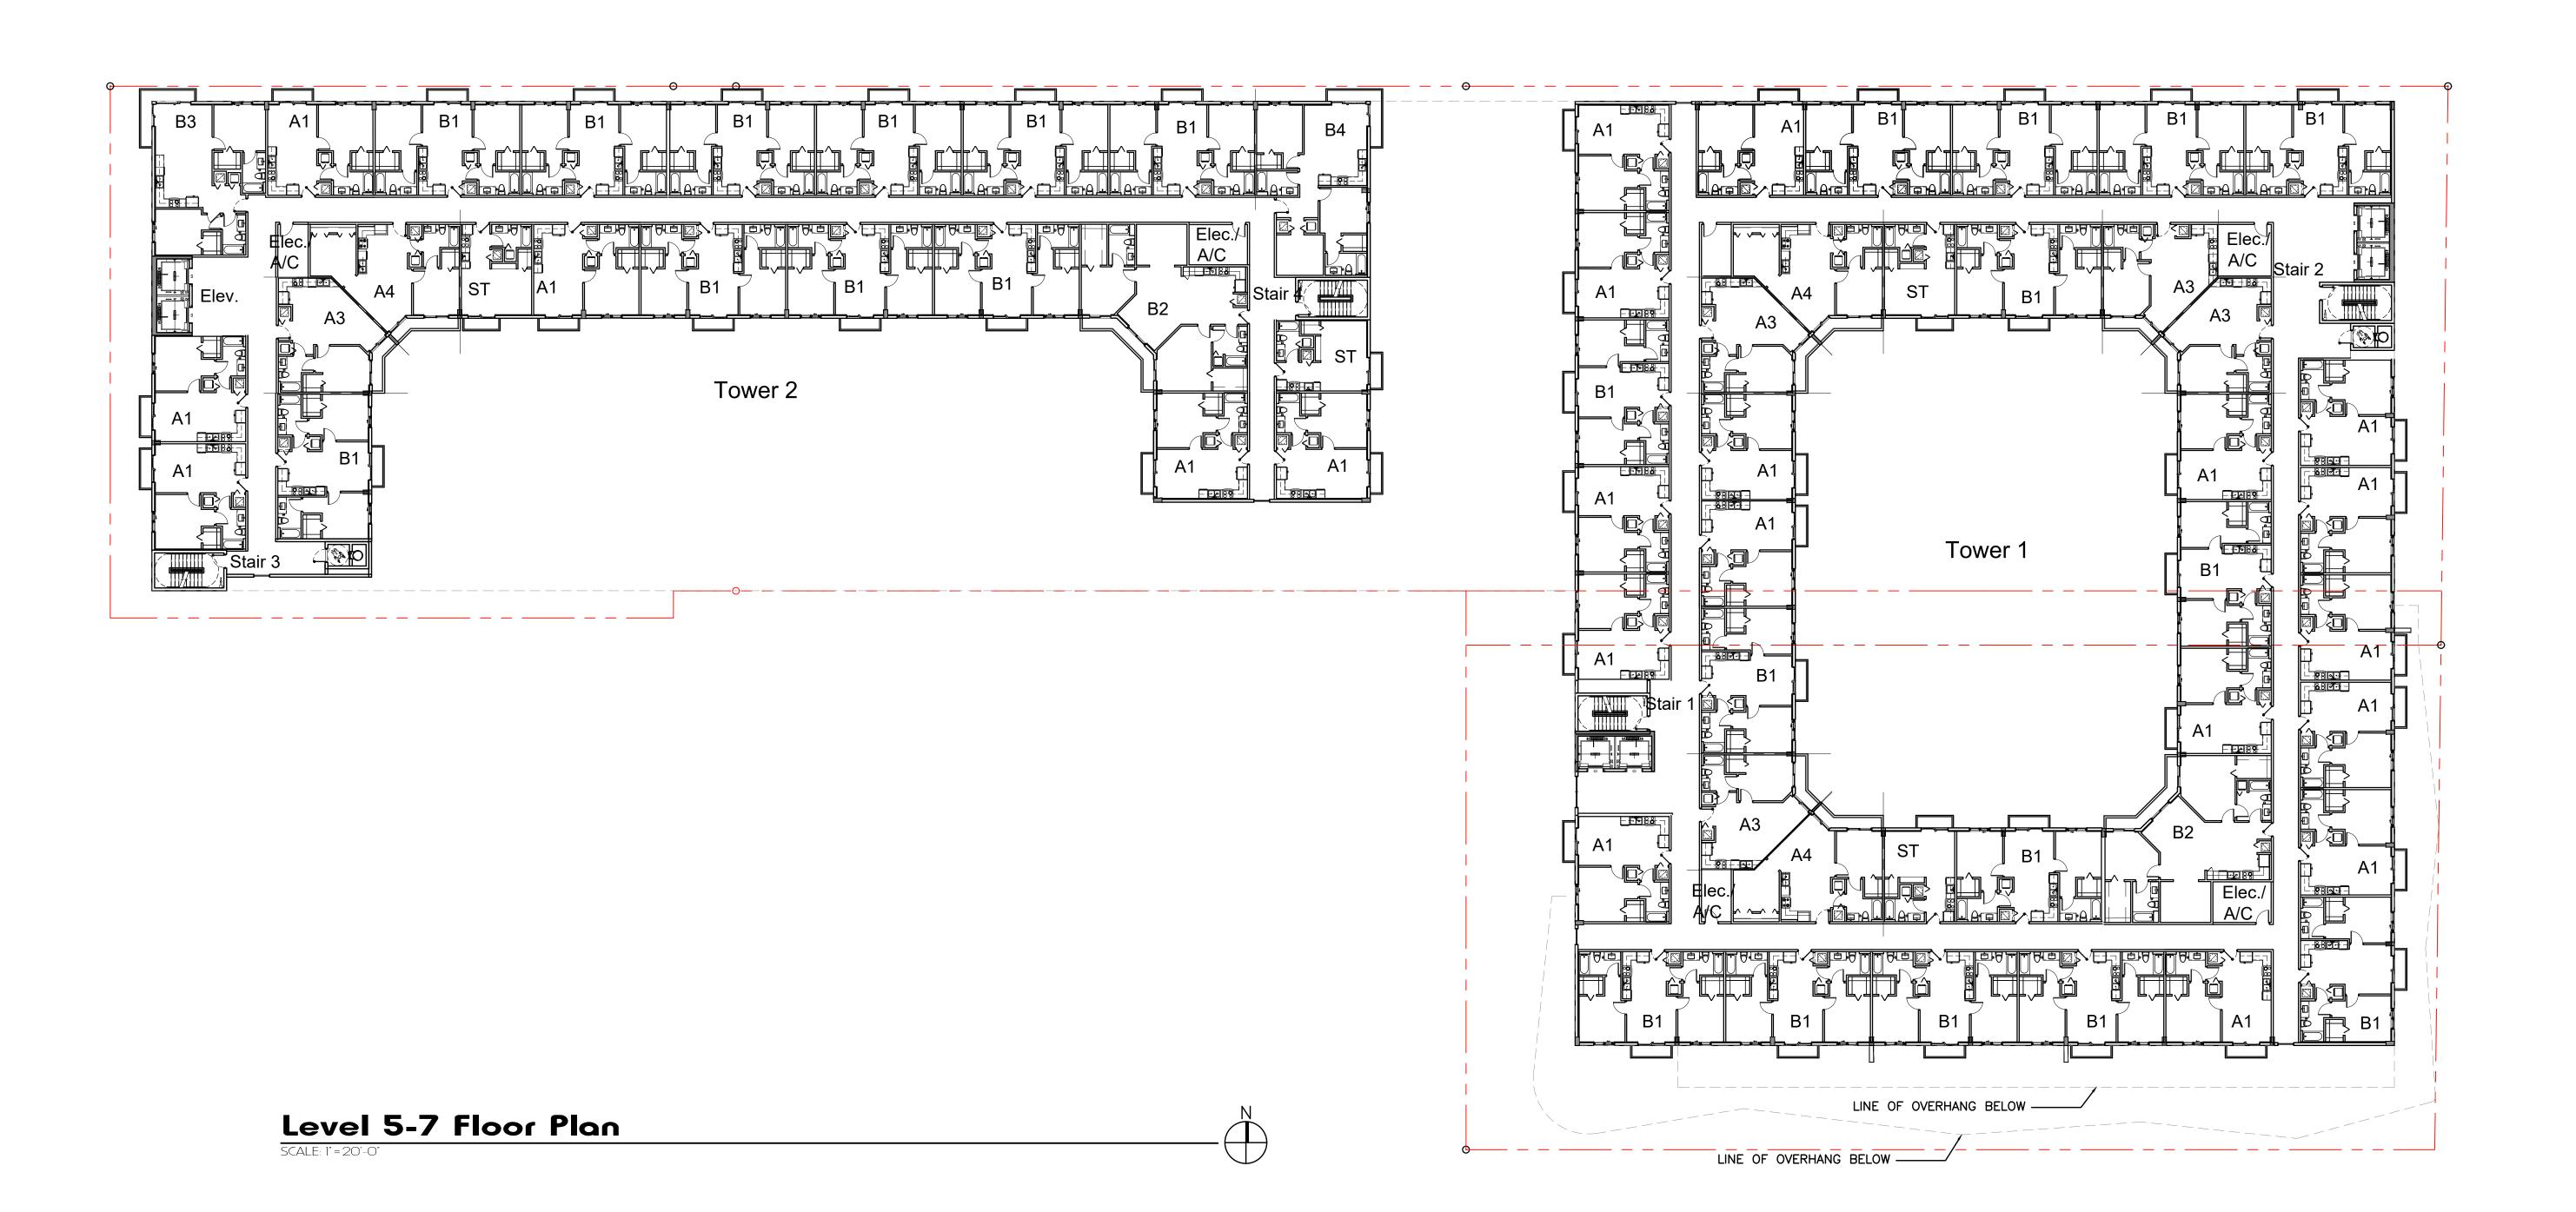

| | | | | Tower 1 U | Init Area Calcu | lation | | | | | | | | ٦ | Tower 2 Unit Aı | rea Calculatio | n | | | | |
|---------------|----------|----------|----------|---------------|-----------------|---------------|-----------|---------------|-----------------------|------------------------------------|---------------|---------|----------|---------------|-----------------|----------------|---------------|------------|---------------|---------------|------------------------------------|
| | Studio | A1 (1bd) | A3 (1bd) | A4 (1-bd+Den) | B1 (2-bd) | B2 (2-bd+Den) | B3 (2-bd) | B4 (2 bd+Den) | Total Units per Floor | Total Area Floor Plate Above 55'0" | | Studio | A1 (1bd) | A3 (1bd) | A4 (1-bd+Den) | B1 (2-bd) | B2 (2-bd+Den) | B3 (2-bd) | B4 (2 bd+Den) | Total Units p | Total Are Floor Pla Above 55 |
| _easable Area | 399 sf | 591 sf | 606 sf | 753 sf | 828 sf | 1,232 sf | 957 sf | 1,074 sf | | | Leasable Area | 414 sf | 621 sf | 606 sf | 753 sf | 828 sf | 1,210 sf | 957 sf | 1,074 sf | | |
| Balc./Terr. | 27 sf | 30 sf | 42 sf | 53 sf | 30 sf | 84 sf | 75 sf | 75 sf | | | Balc./Terr. | 27 sf | 30 sf | 30 sf | 53 sf | 30 sf | 80 sf | 75 sf | 75 sf | | |
| Level 1 | 0 | 0 | 0 | 0 | 0 | 0 | 0 | 0 | 0 | | Level 1 | 0 | 0 | 0 | 0 | 0 | 0 | 0 | 0 | 0 | |
| Level 2 | 0 | 8 | 0 | 0 | 6 | 0 | 0 | 0 | 14 | | Level 2 | 0 | 0 | 0 | 0 | 0 | 0 | 0 | 0 | 0 | |
| Level 3 | 0 | 8 | 0 | 0 | 6 | 0 | 0 | 0 | 14 | | Level 3 | 0 | 0 | 0 | 0 | 0 | 0 | 0 | 0 | 0 | |
| Level 4 | 2 | 14 | 4 | 2 | 14 | 1 | 0 | 0 | 37 | 33,320 sf | Level 4 | 1 | 4 | 0 | 0 | 6 | 0 | 1 | 1 | 13 | 20,865 s |
| Level 5 | 2 | 16 | 4 | 2 | 14 | 1 | 0 | 0 | 39 | 33,320 sf | Level 5 | 2 | 6 | 1 | 1 | 10 | 1 | 1 | 1 | 23 | 20,865 s |
| Level 6 | 2 | 16 | 4 | 2 | 14 | 1 | 0 | 0 | 39 | 33,320 sf | Level 6 | 2 | 6 | 1 | 1 | 10 | 1 | 1 | 1 | 23 | 20,865 s |
| Level 7 | 2 | 16 | 4 | 2 | 14 | 1 | 0 | 0 | 39 | 33,320 sf | Level 7 | 2 | 6 | 1 | 1 | 10 | 1 | 1 | 1 | 23 | 20,865 s |
| Level 8 | 2 | 17 | 4 | 2 | 11 | 1 | 0 | 0 | 37 | 31,272 sf | Level 8 | 2 | 6 | 1 | 1 | 10 | 1 | 1 | 1 | 23 | 20,865 s |
| Sub Total | 10 Units | 95 Units | 20 Units | 10 Units | 79 Units | 5 Units | 0 Units | 0 Units | | | Sub Total | 9 Units | 28 Units | 4 Units | 4 Units | 46 Units | 4 Units | 5 Units | 5 Units | | |
| | | | | | | | Total Uni | ts in Tower 1 | 219 Units | | | | | | | | | Total Unit | s For Tower 2 | 105 | |
| - | | | | | | | | | | | | | To | tal Units for | Tower 1 & Tow | er 2 | 324 DU | | | | |

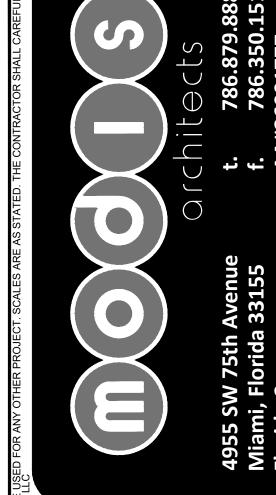

project info

Soleste Hollywood Blv

eal:

ROBERT K. MORISETTE, AIA, NCARB, LEED AP BD+C, CDP FLORIDA REGISTERED ARCHITECT # AR 93259

Updating Units 01.07.2021

ReSubmit 324 Units 04-01*2021

drawing data:

LEVEL 5-7
FLOOR PLAN

project number :

drawing scale:

drawing date :


01/07/2021

#19024

As Shown

Final TAC

sheet number:
A1.08

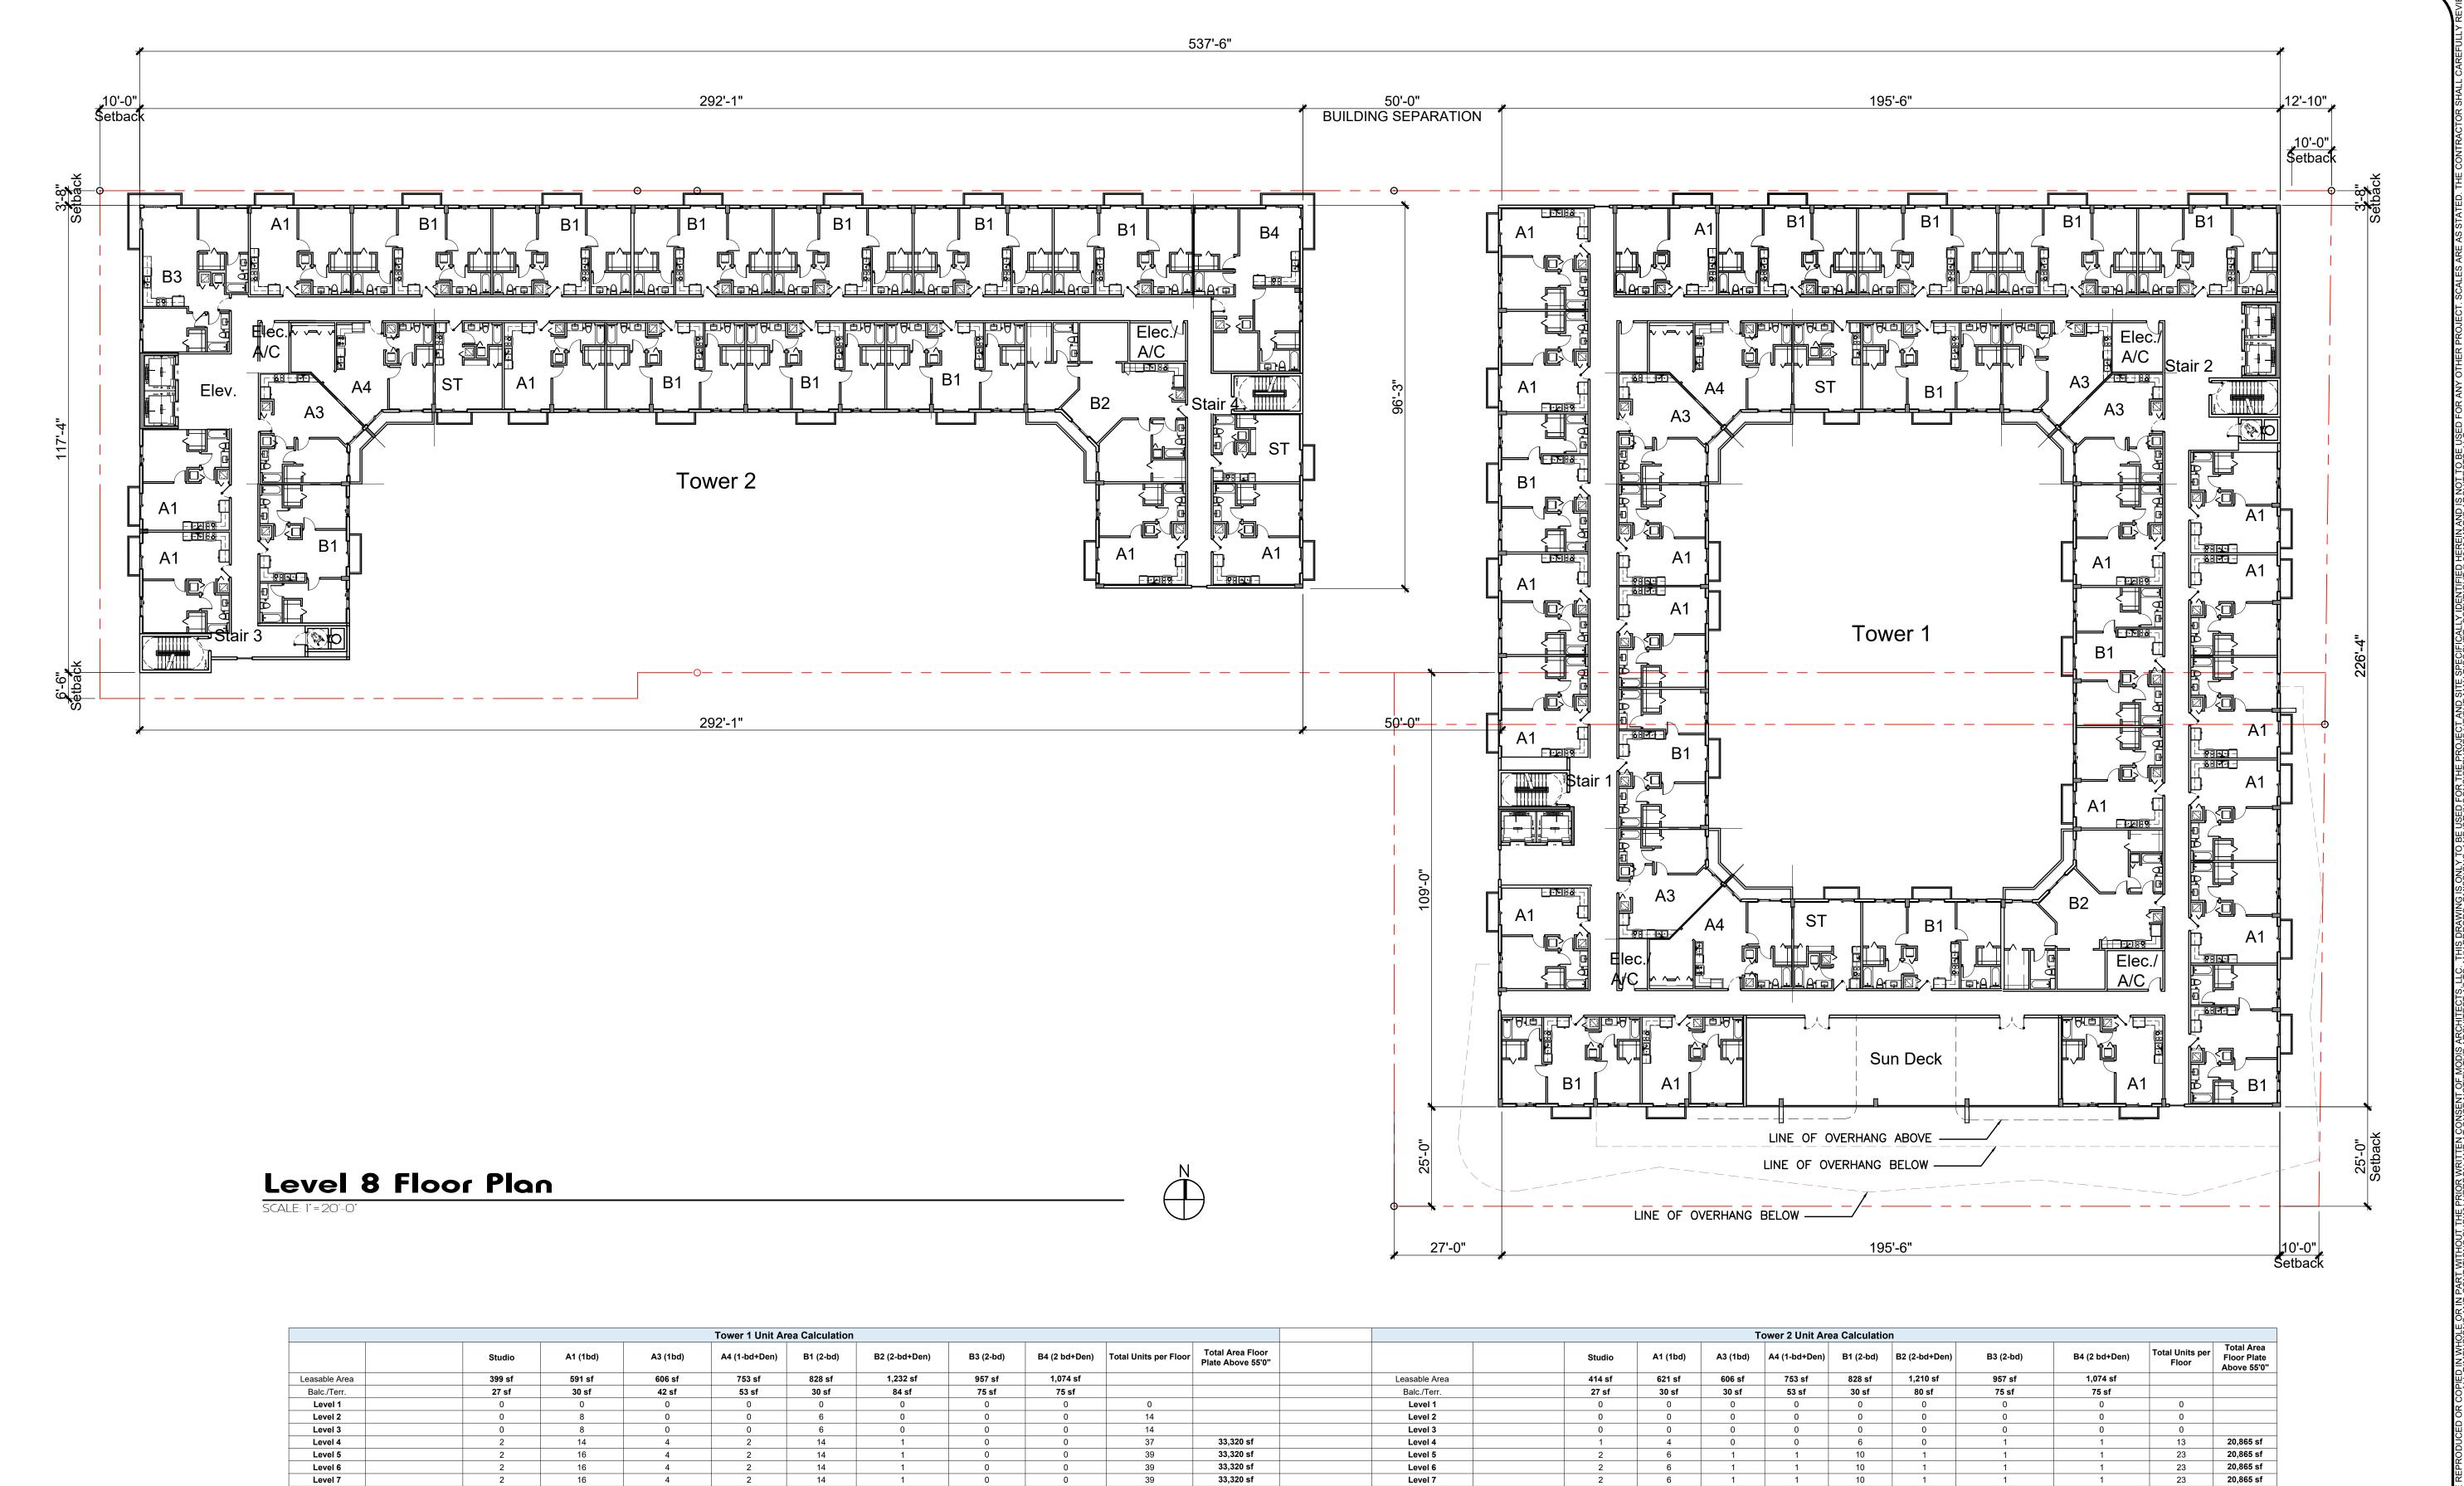

31,272 sf

Sub Total

0 Units 0 Units
Total Units in Tower 1

Level 8

project info: ROBERT K. MORISETTE, AIA, NCARB, LEED AP BD+C, CDP FLORIDA REGISTERED ARCHITECT # AR 93259 revisions: 01.07.2021 **Updating Units** ReSubmit 324 Units 04-01*2021 drawing data: LEVEL 8 FLOOR PLAN project number : #19024 drawing scale: As Shown drawing date: 01/07/2021 Final TAC sheet number:


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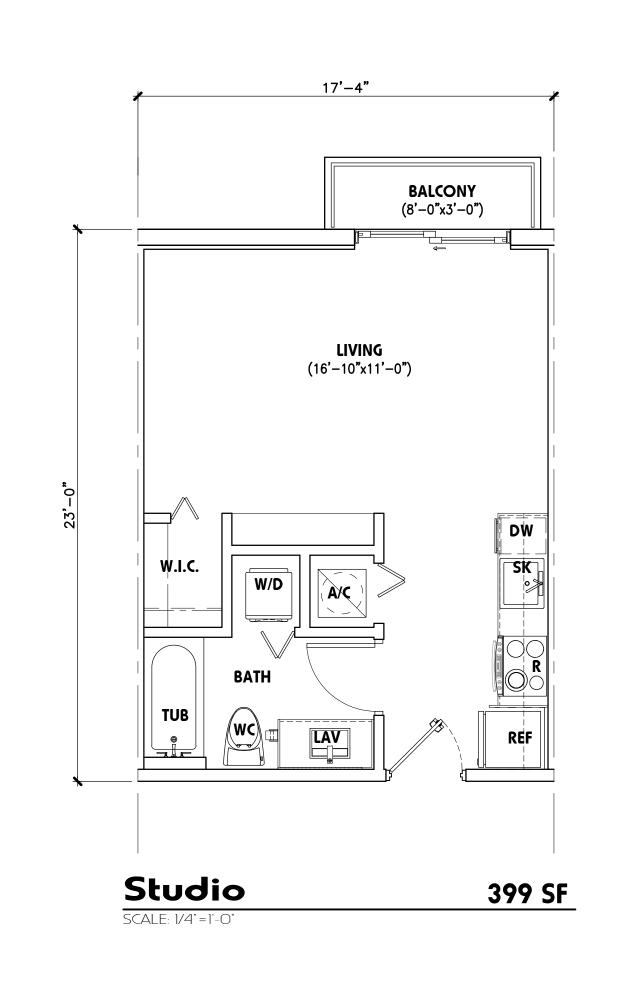
20,865 sf


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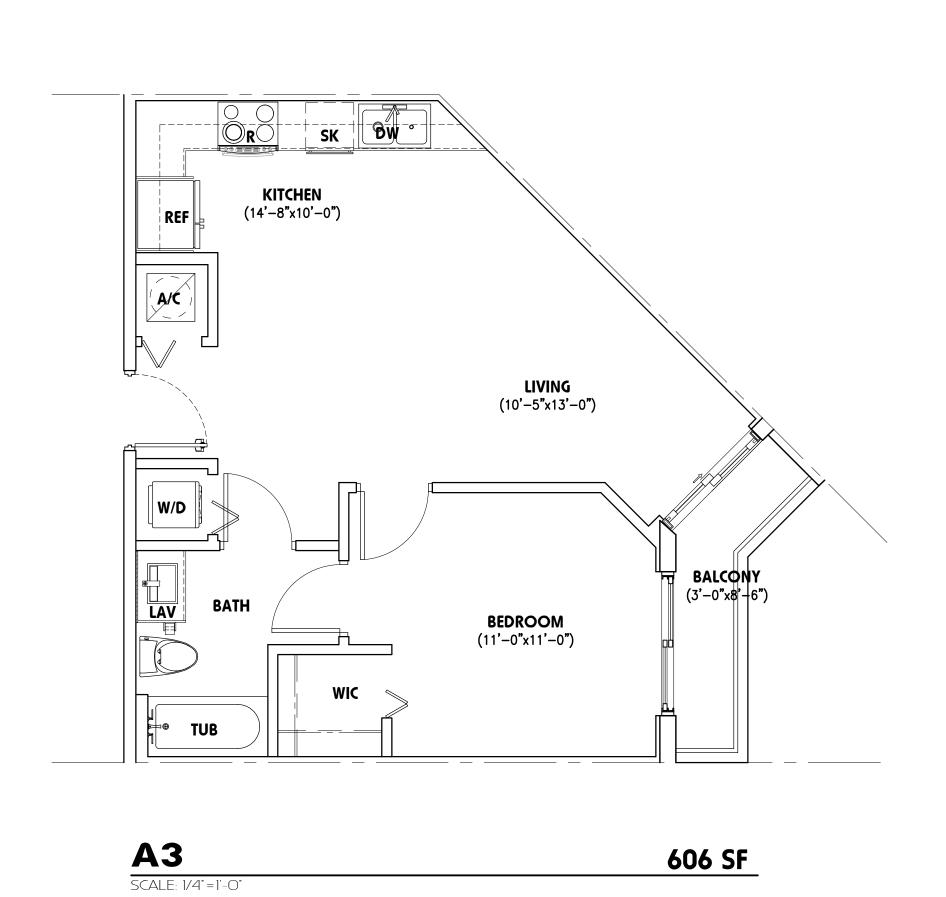
Total Units For Tower 2

Total Units for Tower 1 & Tower 2





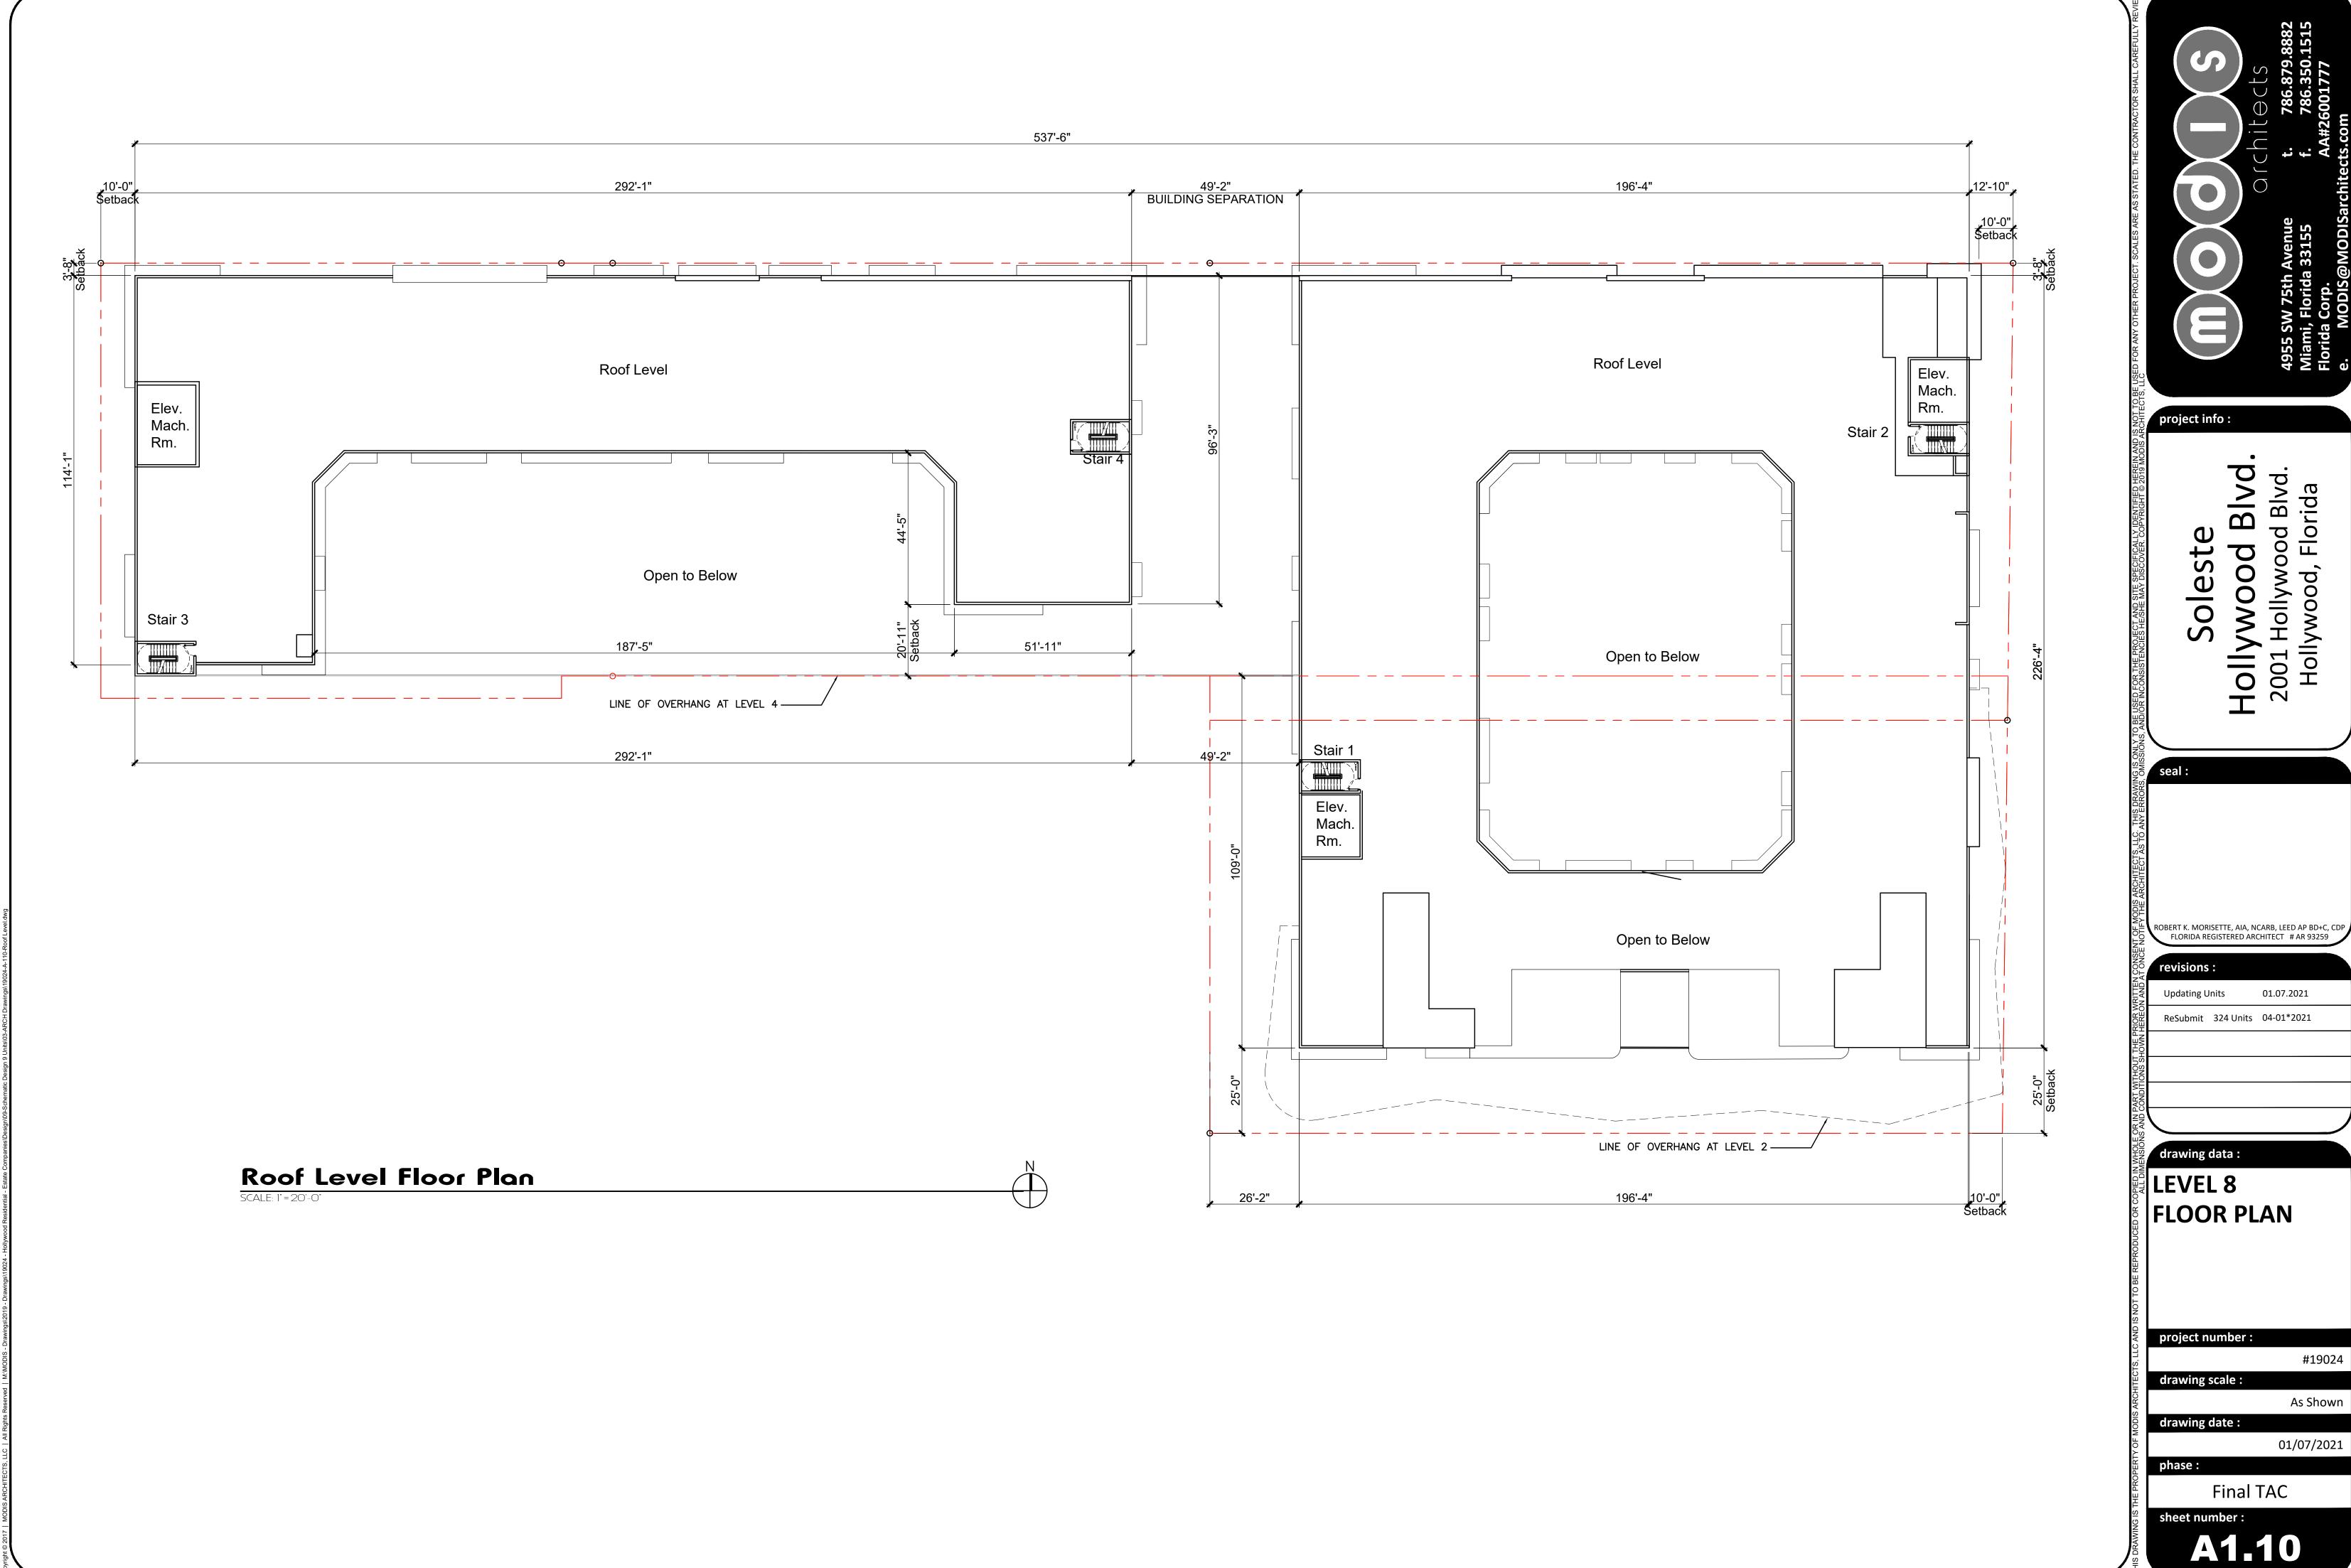

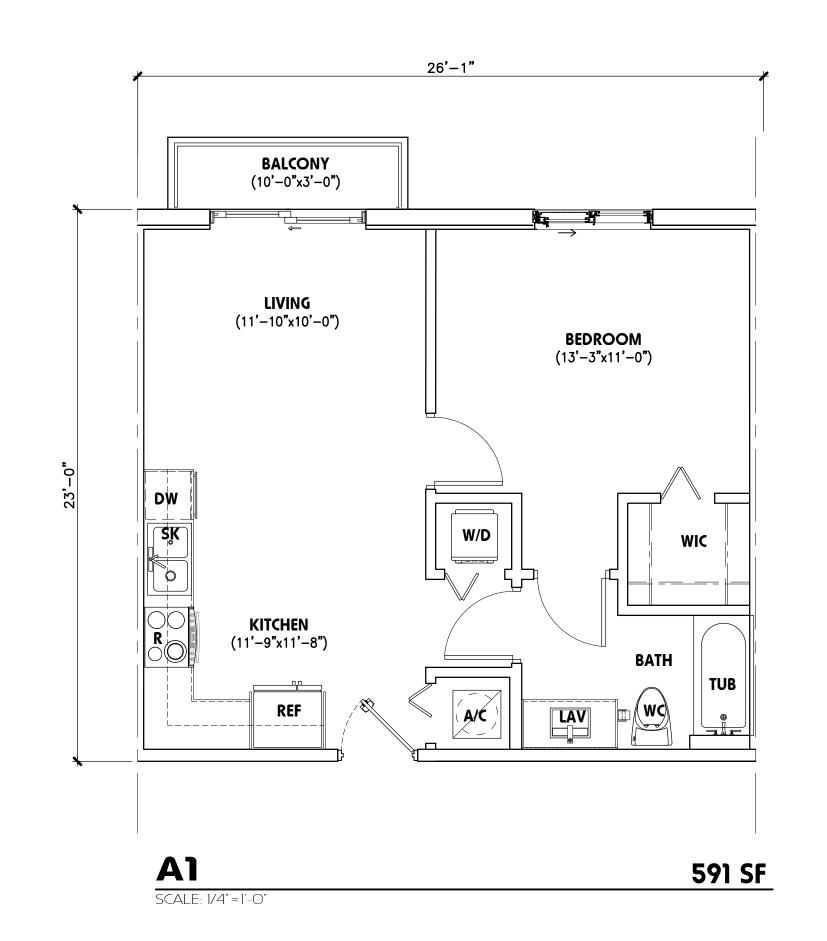


| Note |


project info: ROBERT K. MORISETTE, AIA, NCARB, LEED AP BD+C, CDP FLORIDA REGISTERED ARCHITECT # AR 93259 Updating Units 01.07.2021 ReSubmit 324 Units 04-01*2021 drawing data: UNITS project number : #19024 drawing scale: As Shown drawing date: 01/07/2021

Final TAC

A1.11


sheet number:

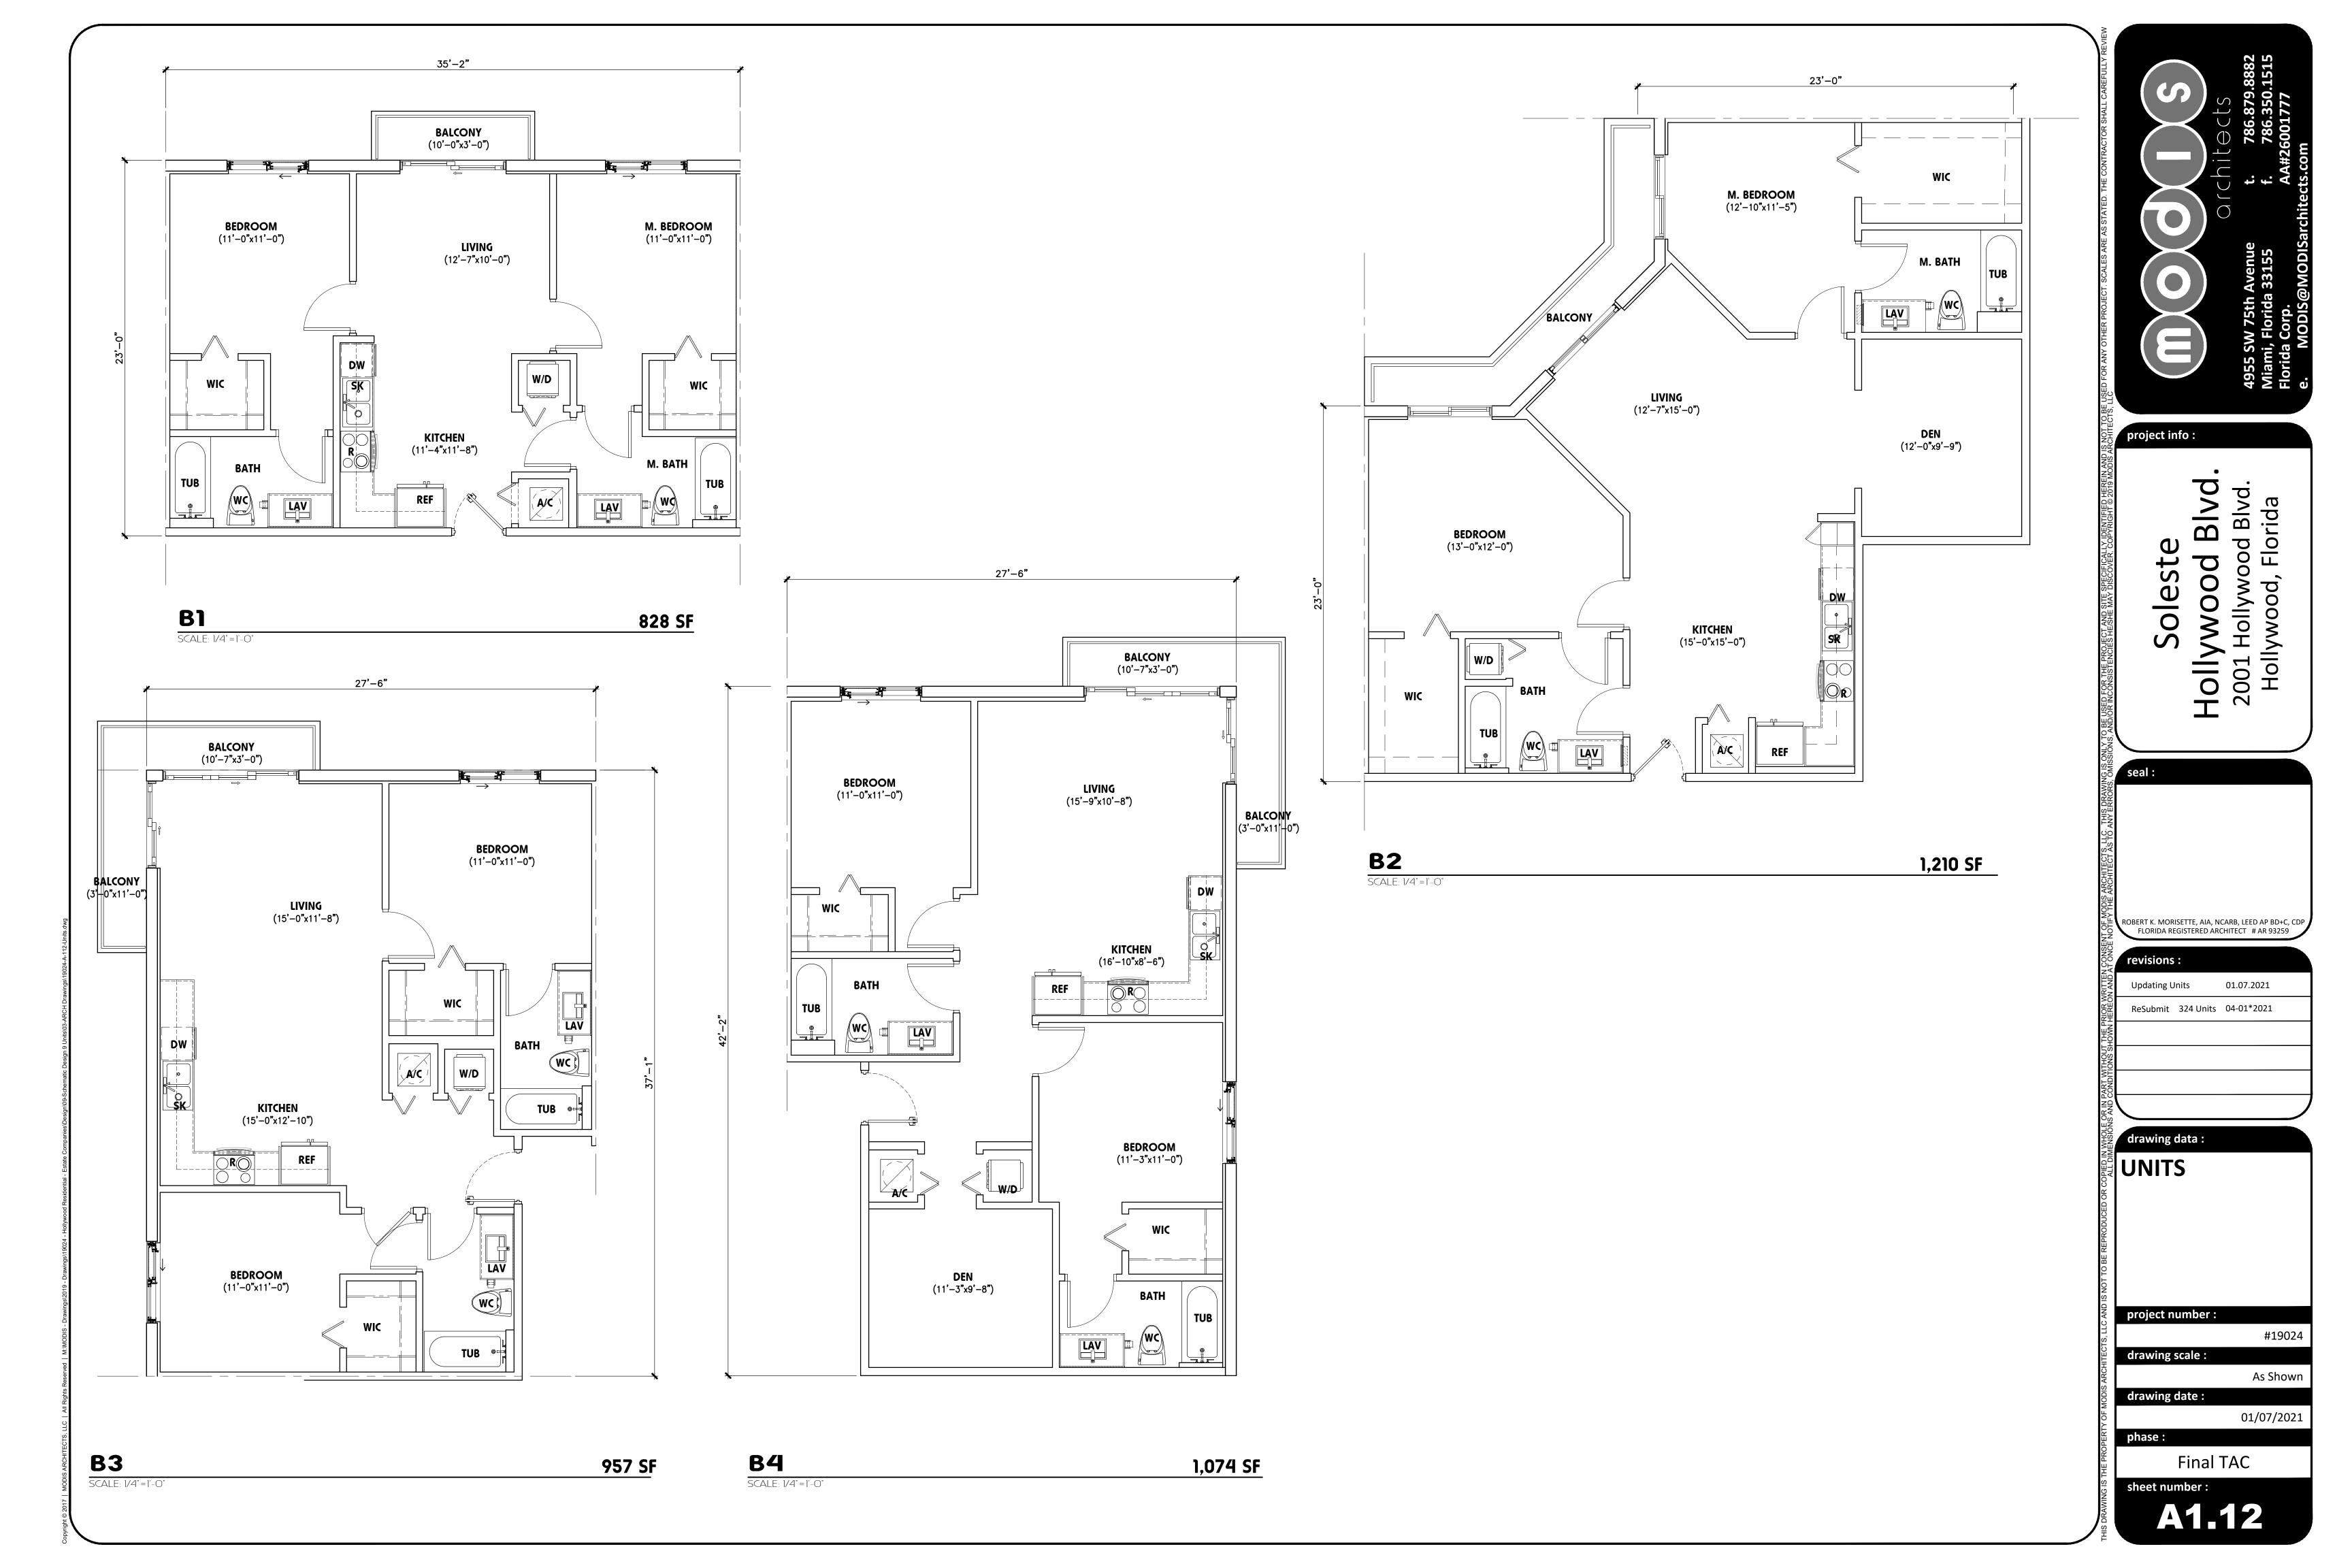

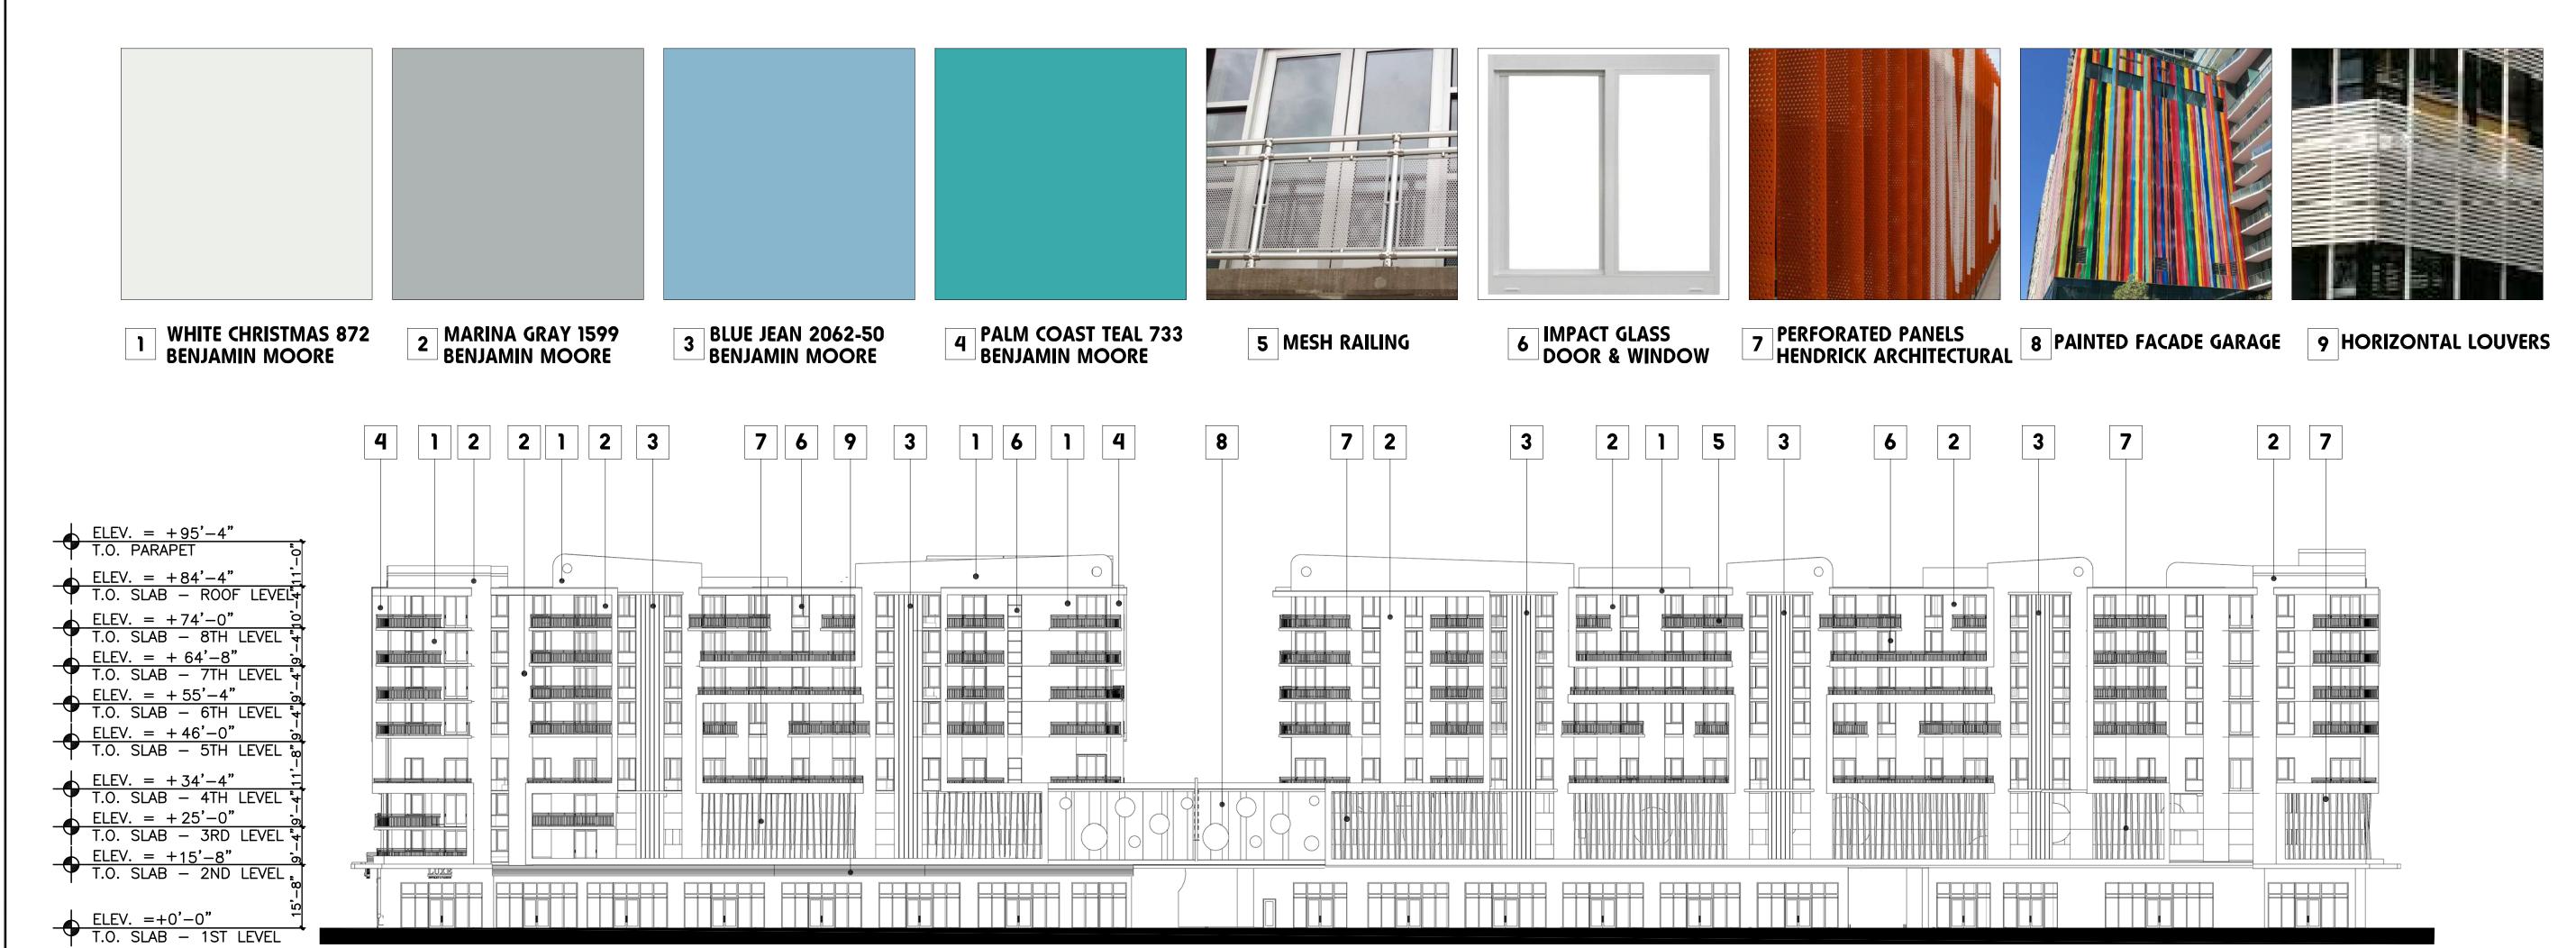



O2 Proposed East Elevation SCALE: 1/32"=1'-0"

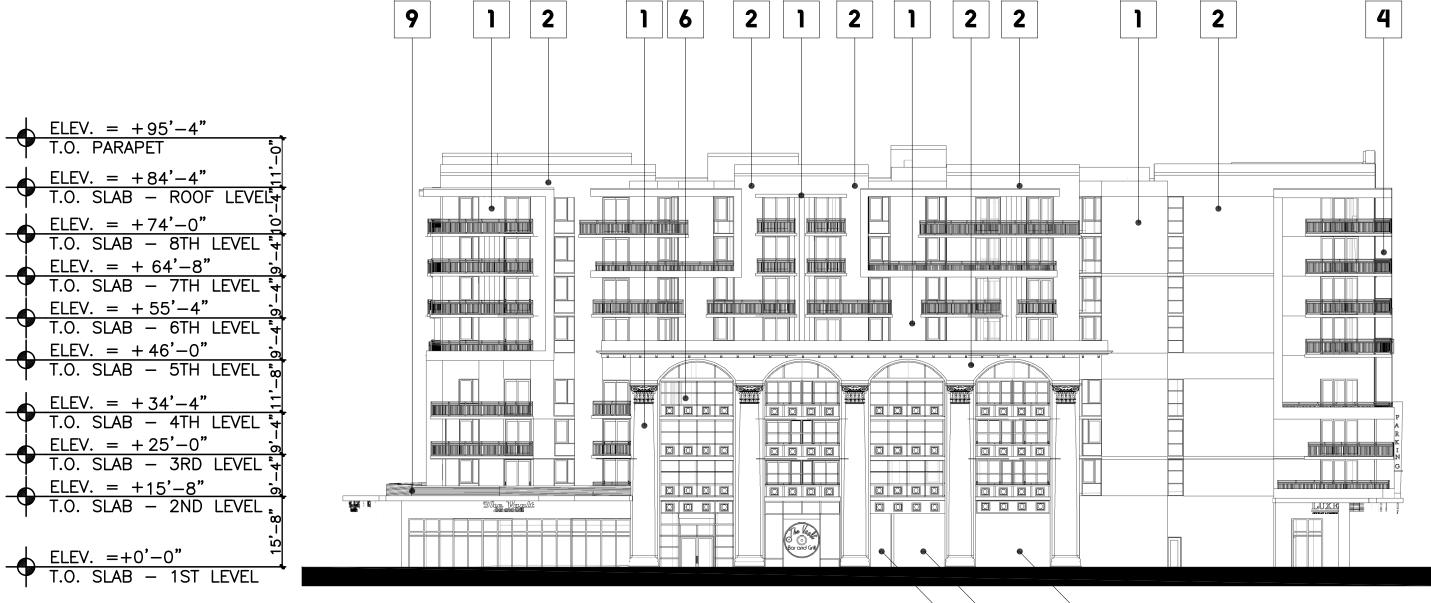

• Aluminum panel thickness of .125" or .190"

Standard panel widths of 36", 42" or 48"
Standard panel lengths of 72", 96" or 120"

12 standard round perforated patterns with open

areas ranging from 23% to 77%

Designed to withstand sustained winds up to 165 mph (Category 5)

Multiple finish options offered to ensure the highest


quality finish for your project

PERFORATED PANELS
HENDRICK ARCHITECTURAL

• Finish warranty options are available up to 20 years

Concealed fastener panel system design

• All hardware supplied is solid stainless steel

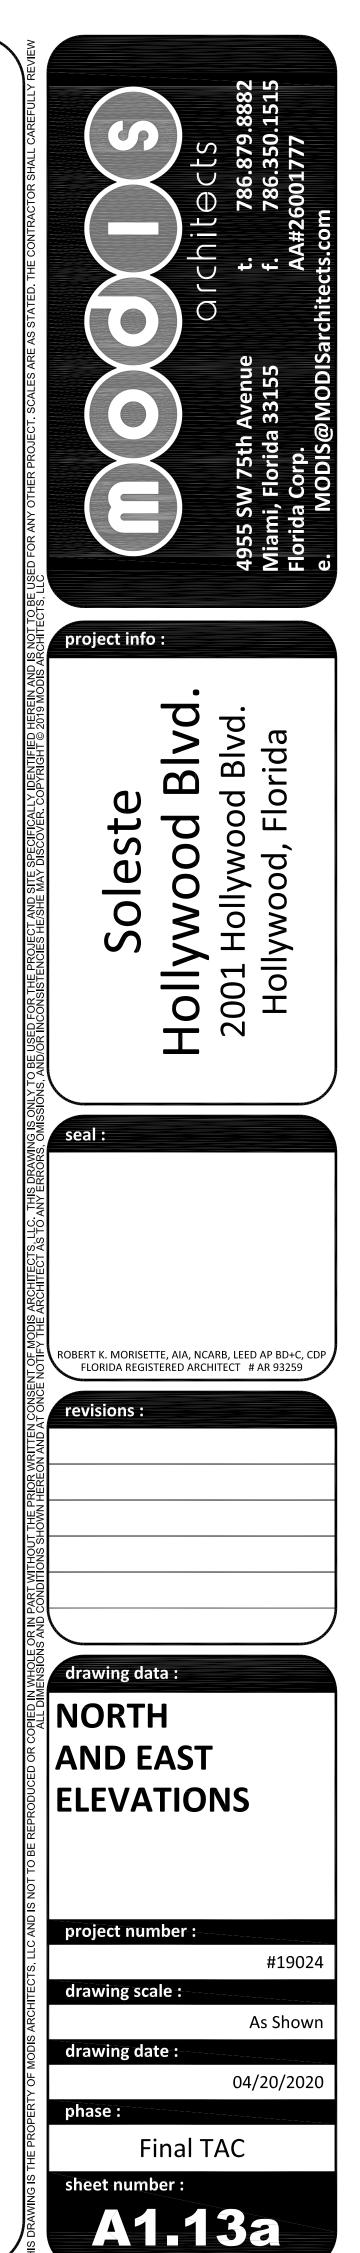

GARAGE ENTRY/EXIT


MECHANICAL/ELECTRICAL
BEHIND WALL


PEDESTRIAN WALKWAY



Ol Proposed North Elevation SCALE: 1/32"=1'-0"




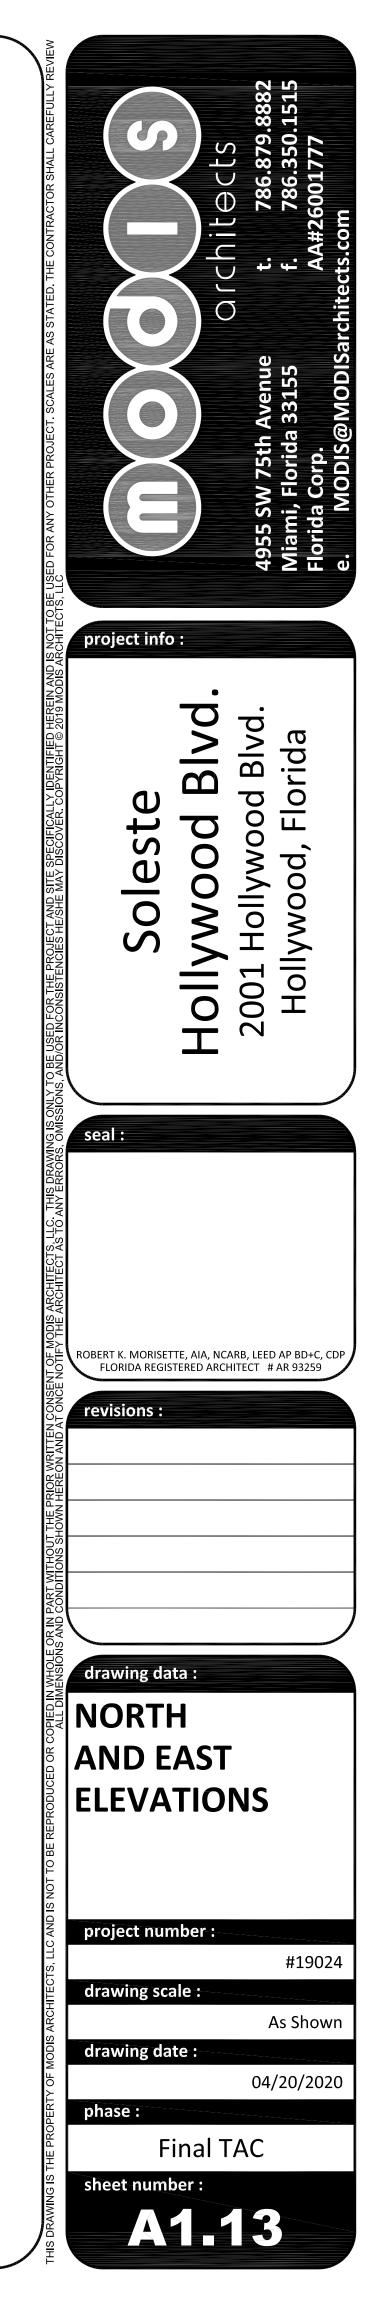

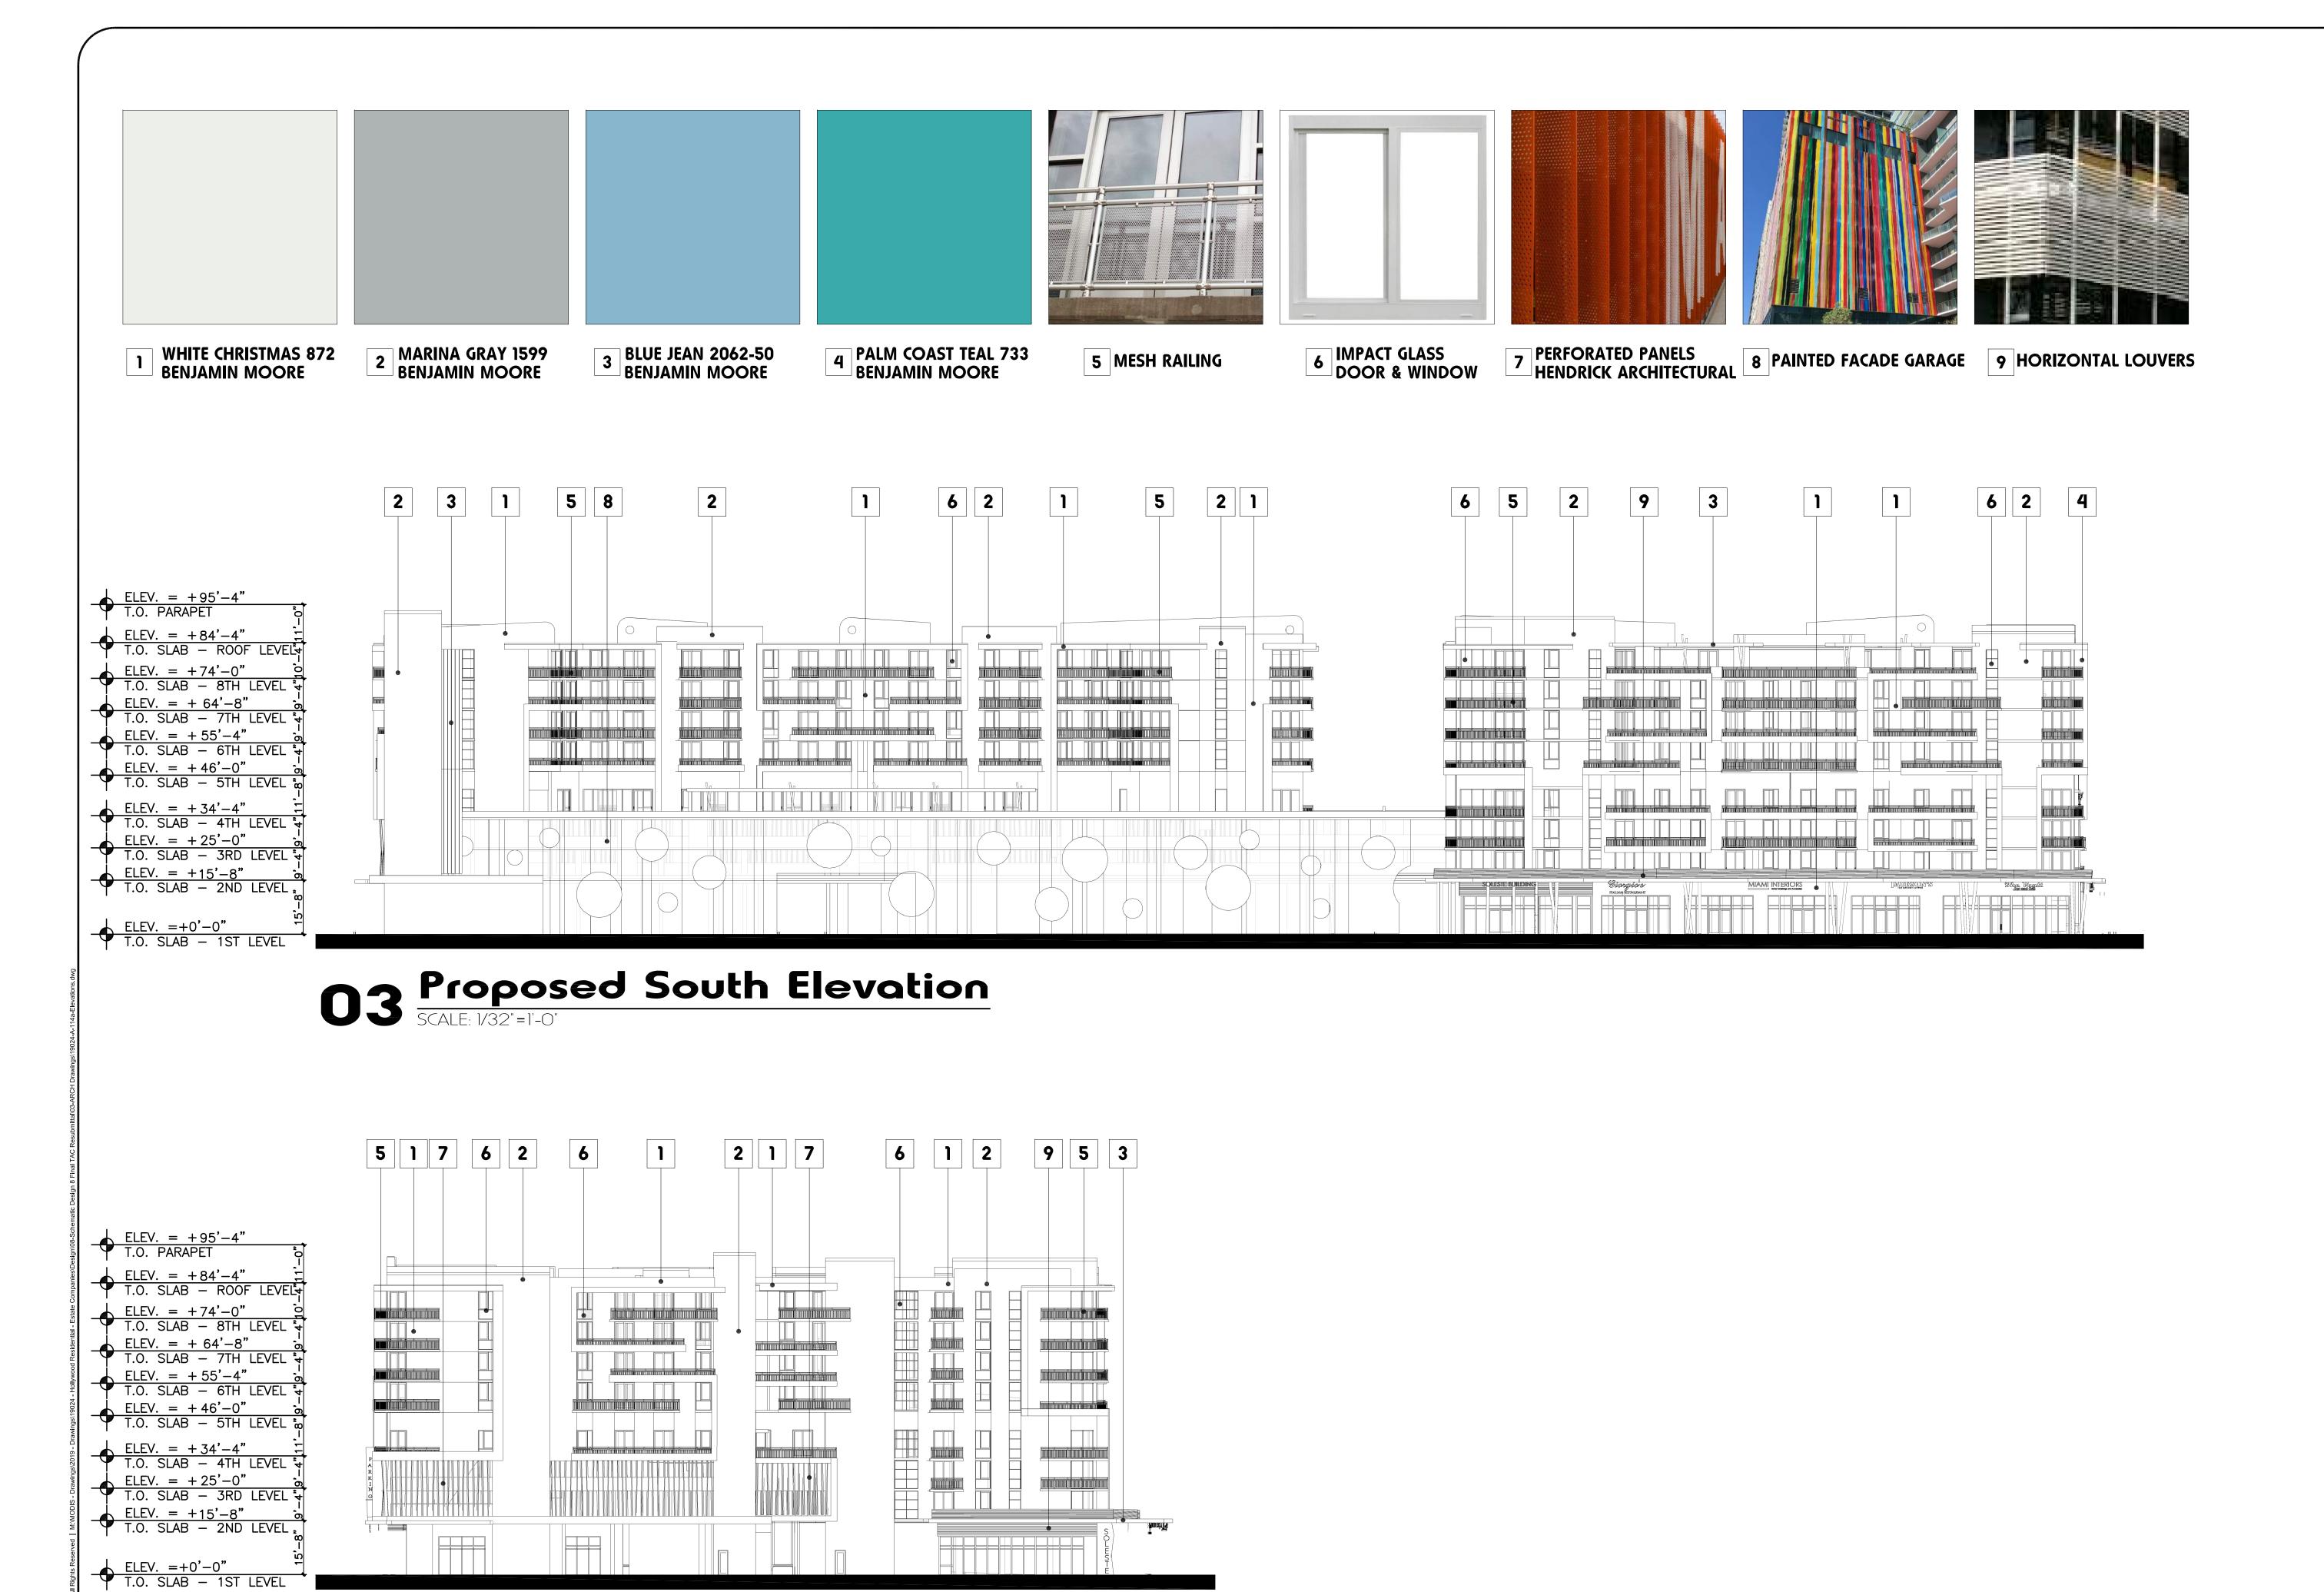


O4 Proposed West Elevation SCALE: 1/32"=1'-0"

project info: Blvd od, ROBERT K. MORISETTE, AIA, NCARB, LEED AP BD+C, CDP FLORIDA REGISTERED ARCHITECT # AR 93259 drawing data: SOUTH AND WEST **ELEVATIONS** project number: #19024 drawing scale: As Shown drawing date: 04/20/2020 Final TAC sheet number: A1.14a

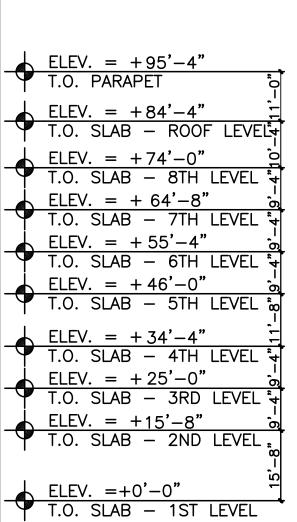




O3 Proposed South Elevation SCALE: 1/32"=1'-0"

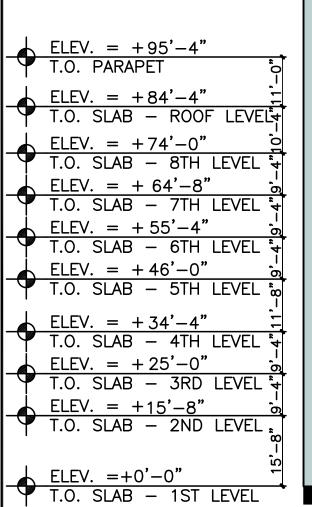




O4 Proposed West Elevation SCALE: 1/32"=1'-0"

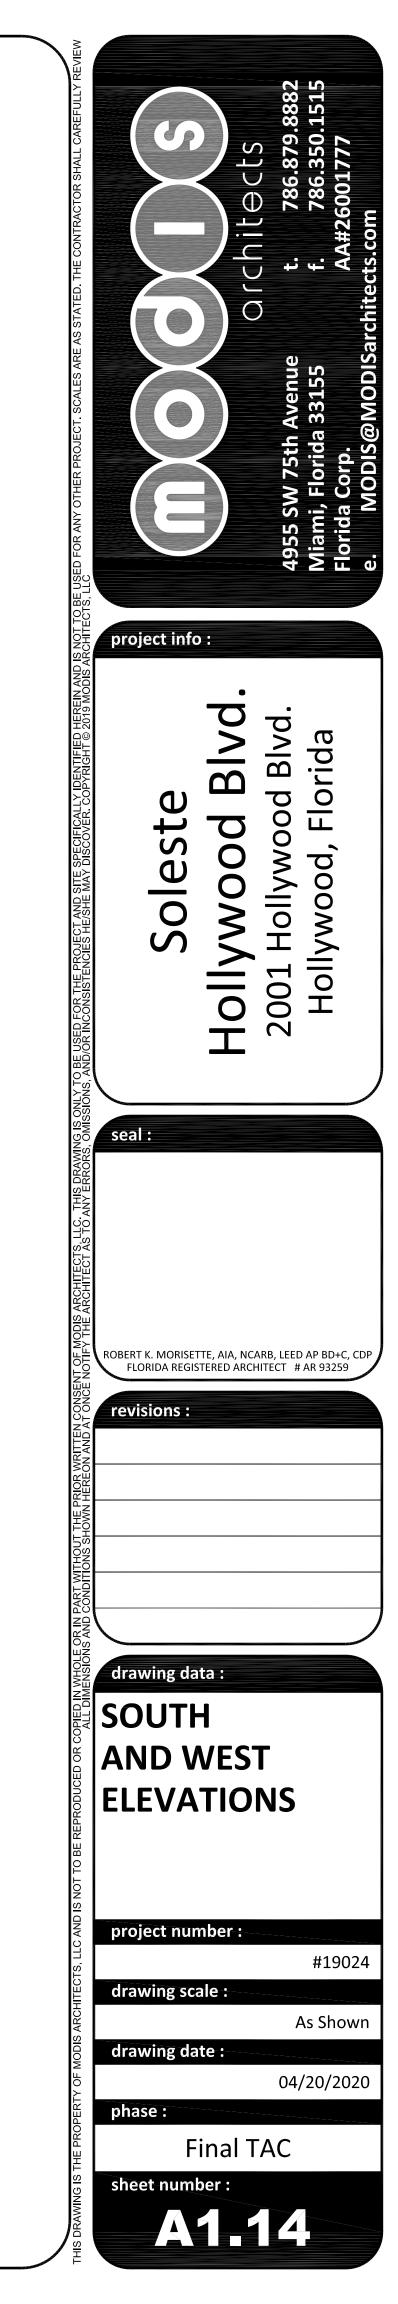




Ol View from Hollywood Blvd. Walkway

SCALE: 1/32"=1'-0"

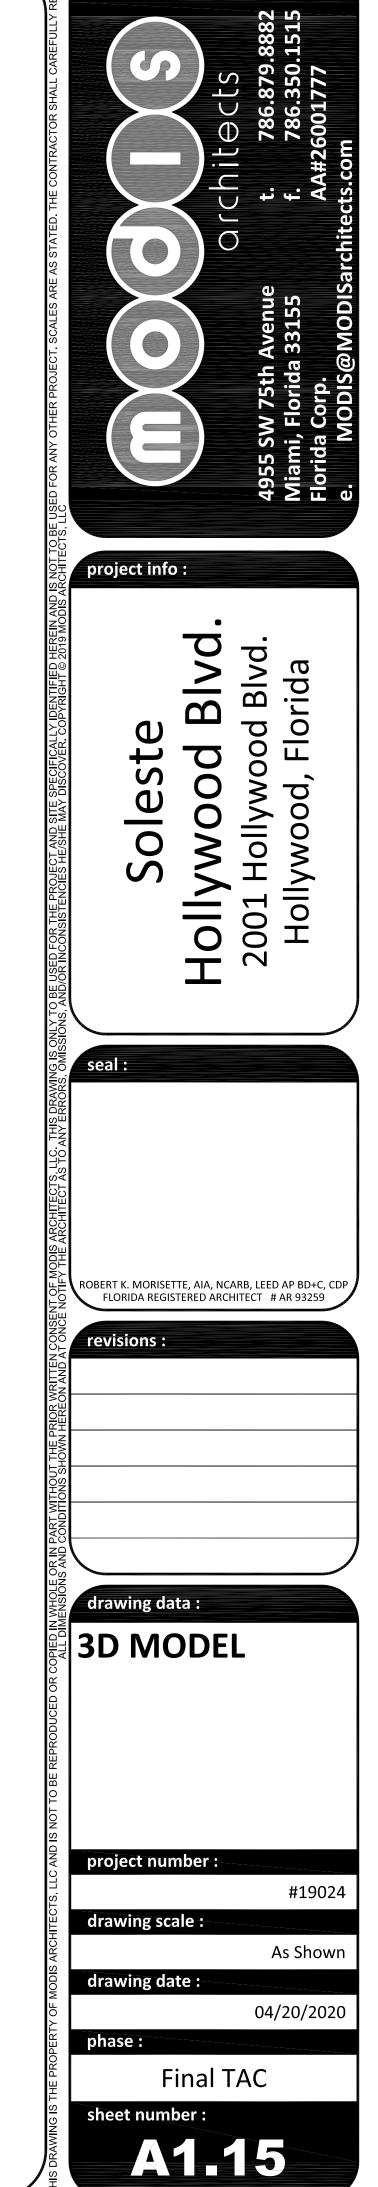



O2 View from Hollywood Blvd. & N. 20th Avenue

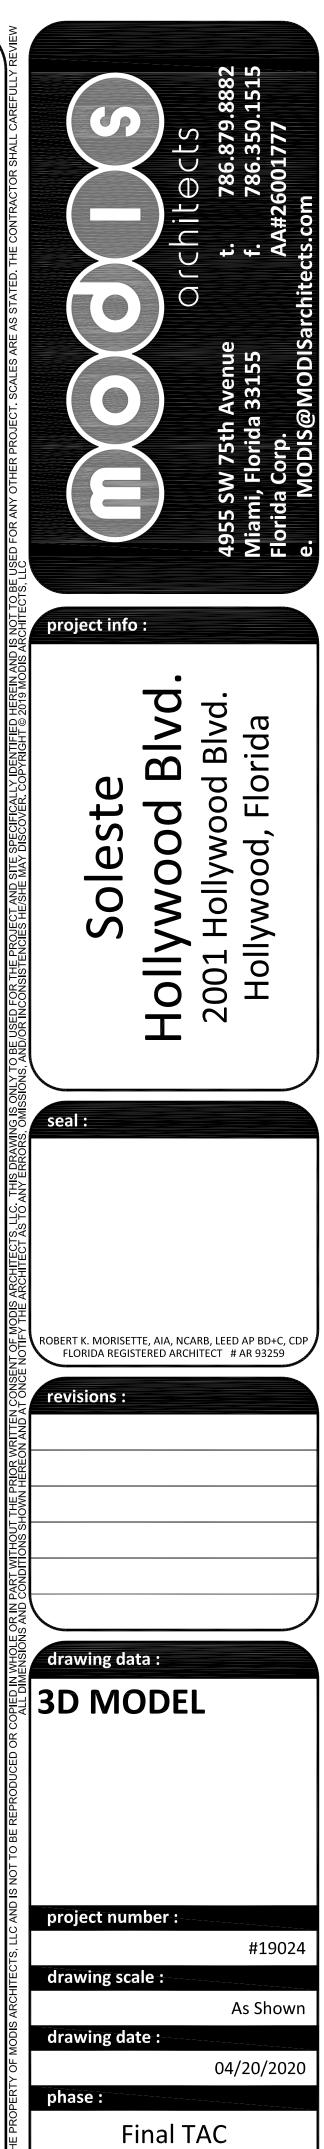




O3 View from Tyler Street
SCALE: 1/32"=1'-0"





O4 View from Hollywood Blvd. SCALE: 1/32"=1'-0"

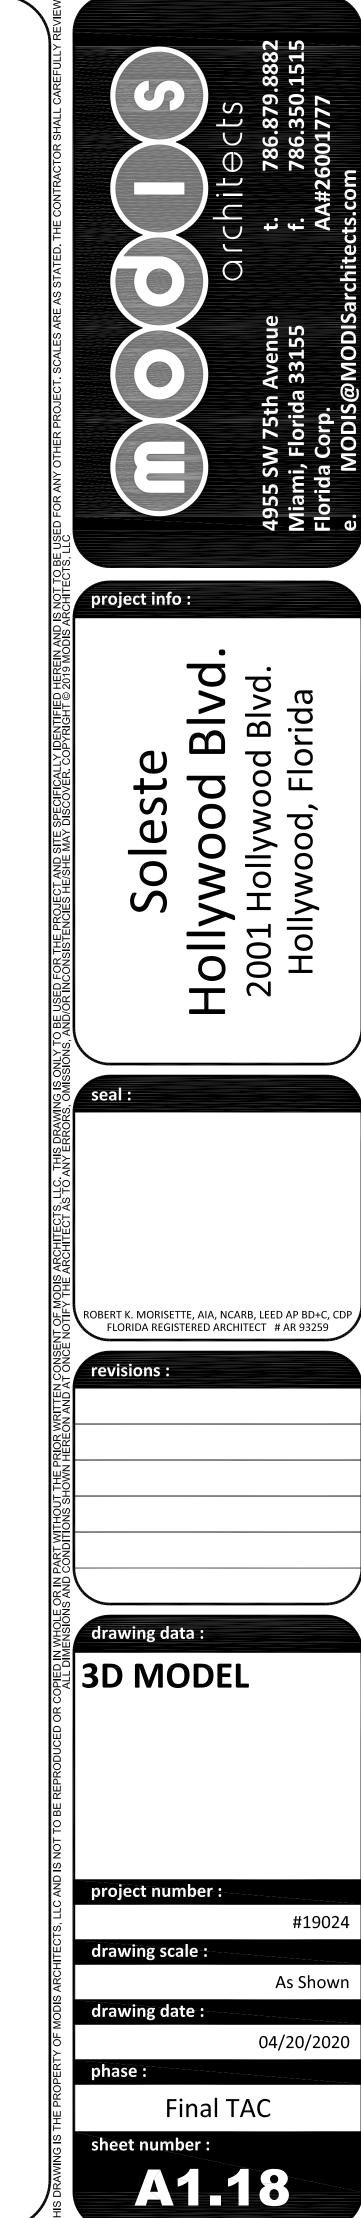



05 East Facade (Historic Facade)
SCALE: 1/32"=1'-0"





ROBERT K. MORISETTE, AIA, NCARB, LEED AP BD+C, CDP FLORIDA REGISTERED ARCHITECT # AR 93259 drawing data: 3D MODEL #19024 drawing scale: As Shown drawing date: 04/20/2020

Final TAC

A1.20

O6 Pedestrian Walk


SCALE: 1/32"=1'-0"



O1 South Elevation
STREET PROFILE



02 North Elevation
STREET PROFILE

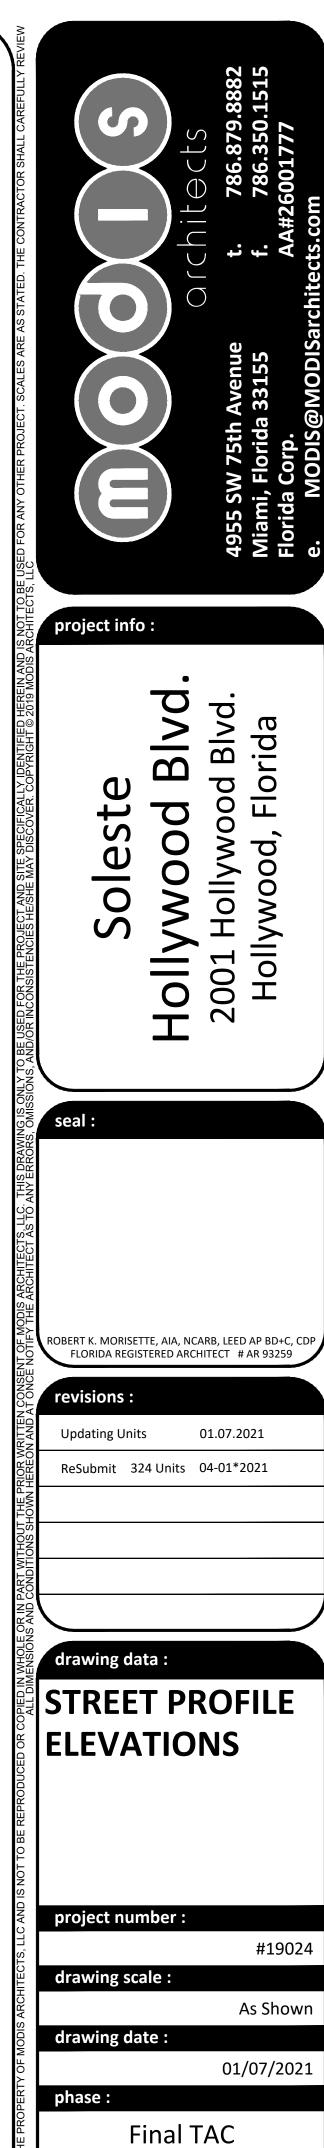


sheet number:



03 West Elevation
STREET PROFILE



04 East Elevation
STREET PROFILE

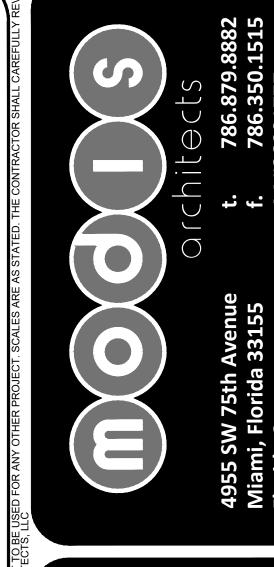

oject info:

Soleste Hollywood Blvc

seal:

ROBERT K. MORISETTE, AIA, NCARB, LEED AP BD+C, CDP FLORIDA REGISTERED ARCHITECT # AR 93259

revisions:

Updating Units 01.07.2021

ReSubmit 324 Units 04-01*2021

drawing data:

STREET PROFILE ELEVATIONS

project number :

drawing scale :

drawing date:

01/07/2021

#19024

As Shown

Final TAC

sheet number :