

PLANNING DIVISION



File No. (internal use only):

2600 Hollywood Boulevard Room 315 Hollywood, FL 33022

GENERAL APPLICATION

	APPLICATION TYPE (CHECK ONE):
Highlywood FLORIDA	☐ Technical Advisory Committee ☐ City Commission ☐ Planning and Development Board ☐ Date of Application: 12/12/19
Tel: (954) 921-3471	Location Address: 1134 JEFFERSON SMOKET
Fax: (954) 921-3347	Lot(s): 1/2 of lot 22 1 Au 23 Block(s): 34 Subdivision: Harywood "By THE STEA"
1 dx. (354) 321-3541	Folio Number(s): 5142 14 01 5742
This application must be completed in full and submitted with all documents to be placed on a Board or Committee's agenda.	Zoning Classification: ICS-b Land Use Classification: LCES Existing Property Use: STC Sq Ft/Number of Units: 1.772 / I Is the request the result of a violation notice? () Yes (x) No If yes, attach a copy of violation. Has this property been presented to the City before? If yes, check all that apply and provide File Number(s) and Resolution(s):
The applicant is responsible for obtaining the appropriate checklist for each type of application.	☐ Economic Roundtable ☐ Technical Advisory Committee ☐ Historic Preservation Board ☐ City Commission ☐ Planning and Development Explanation of Request: New construction Afthorne
Applicant(s) or their authorized legal agent must be present at all Board or Committee meetings.	Number of units/rooms: SINGLE FAMILY HOSE Sq Ft: Value of Improvement: \$500,000 Estimated Date of Completion: DEC 12020 Will Project be Phased? () Yes (No If Phased, Estimated Completion of Each Phase
At least one set of the submitted plans for each application must be signed and sealed (i.e. Architect or Engineer).	Name of Current Property Owner: JEFFRY ONVESTO Address of Property Owner: 1134 JEFFRESON STATES Telephone: 954-564-9434 Fax: Email Address: BURGE HARTHENIES. W
Documents and forms can be accessed on the City's website at	Name of Consultant/Representative/Tenant (circle one): Address:Telephone: Fax: Email Address:
http://www.hollywoodfl.org/Do	Date of Purchase:



List Anyone Else Who Should Receive Notice of the Hearing: _

HANDT HOMES Address: 470 SE 12M ST., FTL, FL 33316
Email Address: BLAKE CHART HOMES. US

If Yes, Attach Copy of the Contract.

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CERTIFICATION OF COMPLIANCE WITH APPLICABLE REGULATIONS

The applicant/owner(s) signature certifies that he/she has been made aware of the criteria, regulations and guidelines applicable to the request. This information can be obtained in Room 315 of City Hall or on our website at www.hollywoodfl.org. The owner(s) further certifies that when required by applicable law, including but not limited to the City's Zoning and Land Development Regulations, they will post the site with a sign provided by the Office of Planning and Development Services. The owner(s) will photograph the sign the day of posting and submit photographs to the Office of Planning and Development Services as required by applicable law. Failure to post the sign will result in violation of State and Municipal Notification Requirements and Laws.

(I)(We) certify that (I) (we) understand and will comply with the provisions and regulations of the City's Zoning and Land Development Regulations, Design Guidelines, Design Guidelines for Historic Properties and City's Comprehensive Plan as they apply to this project. (I)(We) further certify

that the above statements and drawings made on any paper or plans submitted herewith are true to the best of (my)(our) knowledge. (I)(We) understand that the application and attachments become part of the official public records of the City and are not returnable. Signature of Current Owner PRINT NAME: Date: Signature of Consultant/Representative: PRINT NAME: BLAKE SCHMIDT - HARDY HOMES. Date: Signature of Tenant: Date: PRINT NAME: Date: Current Owner Power of Attorney I am the current owner of the described real property and that I am aware of the nature and effect the request for CENTRICATE OF APPROPRIATESS to my property, which is hereby made by me or I am hereby authorizing to be my legal representative before the Historic Presewman (Board and/or Committee) relative to all matters concerning this application. Sworn to and subscribed before me eture of Current Owner day of LISA HART MY COMMISSION # GG231670 EXPIRES: August 20, 2022 State of Florida My Commission Expires: 8 20 12 (Check One) ___Personally known to me; OR $\sqrt{\ }$ Produced Identification __



OLIVERIO RESIDENCE

Project Owner: Jeffrey Oliverio

Project Address: 1134 Jefferson Street, Hollywood, FL 33019





LEGAL DESCRIPTION AND PROJECT INFORMATION:

Project Owner: Jeffrey Oliverio

Project Address: 1134 Jefferson Street, Hollywood, FL 33019

Folio: 5142 14 01 5742

Legal Description: Hollywood Lakes Section 1-32 B Lot 22 W1/2, 23 BLK 34

Zoning Classification: RS-6

Land Use: Low Residential (LRES)

Historic Designation: HMPRLOD-1

Site Square Footage: 10,225 S.F.



FINANCIAL FEASIBILITY STUDY (for DEMOLITION only)

Analysis:

The existing residence located at 1134 Jefferson Street within the Hollywood Lakes historic district is a one story single family residential building built in the 1950's and originally designed by Gamble, Powell, & Gilroy Architects.

In our analysis of the original structure, it has been determined that the rehabilitation of the existing structure is not a financially feasible project. The existing structure's current Finished Floor Elevation (F.F.E.) is 4.45' which is 3.55' below the required FEMA NAVD88 F.F.E of 8.0'. When estimating the cost to raise the slab, tie beams, windows, remove and replace roof, extend wall heights, all while working with original wood frame construction, the cost analysis would exceed the cost of a new home, not including unforeseen conditions.

Within this flood zone it is highly unlikely that the current elevation of the home would not be compromised by a flood event and/or sea level rise. When reviewing the Hollywood Lakes flood maps and outlines on encroaching water from past storm events, it is clear that rehabilitating this current structure at its current elevation is highly discouraged.

In the Broward County, City of Hollywood Vulnerability Report (hollywd_slr.pdf), it is estimated that by year 2030 alone, the Sea Level is projected to rise approximately 3-7 inches and by year 2060 approximately 9-24 inches. With a current F.F.E. of the existing home at 4.45' it is highly unadvisable to rehabilitate the current structure without raising the F.F.E. of the home. With the costs of rehabilitation and resizing the slab to F.F.E. codes, the owner Jeffrey Oliverio, has decided to demolish the existing home and to build a completely new home adhering to all state and municipal codes and regulations.



CERTIFICATE OF APPROPRIATENESS FOR DESIGN FOR HISTORIC PRESERVATION BOARD

Introduction:

The proposed project located at 1134 Jefferson Street within the Hollywood Lakes historic district is a new one story single family residential building of Modern / Minimalist style. The layout and geometry of the structure was inspired by the historical Martin L. Hampton Hollywood Casino courtyard layout. The delineation of hierarchy of the architectural horizontality, verticality, and materiality pull inspiration from Frank Lloyd Wright, Donald Singer, and Claus R. Moberg's minimalist approaches. The medley of Mediterranean and Modern structures within the Hollywood Lakes historic district create a framework for our project's design that complements our composition, materials and details.

Integrity:

The Modern / Minimalist typology of our proposed new single family residence respects all of the zoning setbacks and heights, while creating a clear balance of the comprehensive structure giving the entry hierarchy over the front elevation. The communal courtyard layout lends an inviting presence to Jefferson Street with clean lines and orthogonal geometry that update the entire property and remove the presence of the original 1950 decaying structure.

Design:

The 75' wide lot creates the opportunity for a split plan that allows for privacy for the living space wings on each side of the structure. The split plan also allows the front entry to be centrally located giving it the primary hierarchy and giving the secondary presence to the functional living spaces on each side of the home.

Vertical and horizontal elements were designed to blend the structure into a balance of spatial geometry while also being mindful of the transparency and versatility that shading enhances the design and quality of life for the owner.

The rear design of the home is also meant to enhance and cater to the family lifestyle of the owner. The singular asymmetrical vertical architectural element draws your eye to the height of the design while also doubling as a sliding glass door pocket to allow for a large opening to open the home for entertaining and uninterrupted air flow from front to back.

Setting:

The design and massing relates to the medley of Contemporary-Mediterranean and Modern neighboring residences within the Hollywood Lakes historic district.

Materials:

The materiality of the structure will create a cool color palette with darker accent colors to further establish hierarchy of architectural elements. Matching and complimenting stone and pavers will be used to blend and accent in color and establish the introduction of subtle textural differences.

Workmanship:

The details, structural architectural elements, and material selections are consistent with the proposed style and will be built and installed by experienced contractors.

Association:

The design utilizes Modern-Minimalist styling elements such as horizontal and vertical elements, materiality, color, and materiality creating a balanced composition of geometric rhythm. The tropical landscaping, inviting courtyard layout, and comprehensive property update contribute to the overall streetscape quality and building scale of Jefferson Street and the Hollywood Lakes historic district.



PHOTOGRAPHS OF SUBJECT SITE AND ADJACENT PROPERTIES

Oliverio Residence:

1134 Jefferson Street Hollywood, FL 33019



Since 1987



Since 1987



Since 1987



GRIFFIN RESIDENCE: 1124 Jefferson Street Hollywood, FL 33019



Since 1987

LIPOVCHENKO & TASHLITSKAYA RESIDENCE:

1140 Jefferson Street Hollywood, FL 33019



Since 1987

PROPRIETARY INFORMATION: THIS DOCUMENT IS SUBJECT TO COPYRIGHT LAWS. NEITHER THE DOCUMENT NOR ANY INFORMATION HEREIN MAY BE RELEASED WITHOUT WRITTEN PERMISSION OF HART LUXURY HOMES, INC. @2019

OLIVERIO RESIDENCE





THESE PLANS HAVE BEEN PREPARED IN ACCORDANCE WITH: FLORIDA RESIDENTIAL BUILDING CODE 2017 EDITION W/ SUPPLEMENTS NATIONAL ELECTRIC CODE - LATEST EDITION ALL APPLICABLE AMENDMENTS

CONTRACTOR'S PERMIT SET

THESE DRAWINGS ARE TO BE CONSIDERED A "CONTRACTOR'S PERMIT SET" AND ARE NOT INTENDED TO COVER ALL AREAS OF CONTRACTUAL AGREEMENTS BETWEEN OWNER AND CONTRACTOR. SPECIFIC MATERIALS, PAINT COLORS, FURNITURE, FINISHES, FIXTURES, ALLOWANCES, ETC. NOT COVERED BY THESE PLANS SHOULD BE INCLUDED IN THE WRITTEN AGREEMENT BETWEEN THE OWNER AND THE CONTRACTOR. IF APPLICABLE, THE CONTRACTOR IS TO COORDINATE EXACT CABINETRY LAYOUT W/ CABINETRY SHOP DRAWINGS.

DRAV	WING INDEX:	A3	FRONT & REAR ELEVATIONS	M1	TBD
T1	TITLE SHEET PLOT PLAN SURVEY - TBD	A4	RIGHT & LEFT ELEVATIONS	S1-8	TBD
	BOUNDARY SURVEY	A5	STREET PROFILE ELEVATION	S2-8	TBD
C1 C2	GRADING AND DRAINAGE PLAN PAVING, GRADING & DRAINAGE	A6	TBD	S3-8	TBD
90	PLAN	A7	TBD	S4-8	TBD
СЗ	SEPTIC & DRAINFIELD PLAN	A8	TBD		
L1	TREE DISPOSITION PLAN	A9	TBD	S5-8	TBD
L2 L3	LANDSCAPE PLAN LANDSCAPE DETAILS	A10	TBD	S6-8	TBD
L4	IRRIGATION PLAN - TBD	A11	TBD	S7-8	TBD
AO	SITE & ROOF PLAN			S8-8	TBD
A1	FIRST FLOOR PLAN & RCP	A12	TBD	50-0	עעו
		A13	TBD		
A2.	DIMENSION PLAN				


SOFFIT ABOVE, SEE PLAN FOR HEIGHT

WALL OPENING

SYMBOLS LEGEND:	
TYPICAL MASONRY CONSTRUCTION	
GROUT FILLED CELL W/ REBAR. SEE STRUCTURAL	•
POURED CONCRETE COLUMN. SEE STRUCTURAL	
NON-BEARING FRAME CONSTRUCTION	
INFILL MASONRY CONSTRUCTION. SEE STRUCTURAL	
FRAME CONSTRUCTION ABOVE OR BELOW SEE PLAN FOR HEIGHT	

1 HOUR FIRERATED WALL DETAIL CALLOUT W/ SHEET NO. NOTED WALL SECTION CALLOUT

AS NOTED ON PLANS

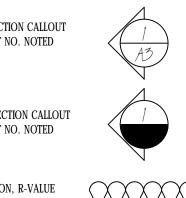

BLDG. SECTION CALLOUT W/ SHEET NO. NOTED INSULATION, R-VALUE AS NOTED ON PLANS 3" SOUND BLANKETS

ABBREVIATIONS:

F.R. FIRE RATED

FIN. FINISHED

G.E. GABLE END

G.T. GIRDER TRUSS

HGT. HEIGHT

HPS. HOOPES

LG. LONG

INS.

GWB GYPSUM WALLBOARD

GYP. BD. GYPSUM WALLBOARD

HS HORIZONTAL SLIDING

INSULATION

INTERIOR

FLR.

FR FRENCH DOOR

FLOOR

GAUGE

GFCI GROUND FAULT CIRCUIT INTERRUPT

HVHZ HIGH VELOCITY HURRICANE ZONE

ABOVE	LIN.	LINEN
ARC FAULT CIRCUIT INTERRUPT	LT.	LIGHT
ABOVE FINISHED FLOOR	L.T.	LAUNDRY TUB
AIR HANDLER UNIT	M.C.	MEDICINE CABINET
BI FOLD	M.R.H.	MEAN ROOF HEIGHT
BI PASS	M.T.	METAL THRESHOLD
BLOCK	MAX.	MAXIMUM
BELOW	MFR.	MANUFACTURER
BEARING	MICRO.	MICROWAVE
BOTTOM	MIN.	MINIMUM
CEILING	M.O.	MASONRY OPENING
CONCRETE MASONRY UNIT	MONO	MONOLITHIC
COLUMN	MTL.	METAL
CONCRETE	N.E.C.	NATIONAL ELECTRIC CODE
CONTINUOUS	O.H.D.	OVER HEAD DOOR
CASEMENT		OVERHANG
DOUBLE	O/C	ON CENTER
DIAMETER	P.L.F.	POUNDS PER LINEAR FOOT
DISPOSAL	P.S.F.	POUNDS PER SQUARE FOOT
DESIGN PRESSURE	P.S.I.	POUNDS PER SQUARE INCH
DOOR	P.T.	PRESSURE TREATED
DISH WASHER	PART.	PARTITION
EACH END	PKT.	POCKET
ELECTRICAL	PLYWD.	PLYWOOD
ELEVATION	R.O.	ROUGH OPENING
EACH SIDE	S.C.	SOLID CORE
EACH WAY	SD	SMOKE DETECTOR
EXISTING	S.G.D.	SLIDING GLASS DOOR
EXTERIOR	SF	SQUARE FOOT
FLORIDA BUILDING CODE	SH	SINGLE HUNG
FINISHED FLOOR	SMS	SHEET METAL SCREWS

STIRRUPS

TEMPERED

T.O.B. TOP OF BEARING

T.O.T.B. TOP OF TIE BEAM

V.I.F. VERIFY IN FIELD

WITH

WC WATER CLOSET

W.A. WEDGE ANCHORS

TYP. TYPICAL

THROUGH BOLT

THROUGH OUT

T.O.PL. TOP OF WOOD PLATE

U.N.O. UNLESS NOTED OTHERWISE

UNDERWRITERS LABORATORIES

T.O.B.B. TOP OF MASONRY BOND BEAM

STL. STEEL

SW SWITCH

TEMP.

MECHANICAL NOTES:

1. SEE MECHANICAL PLANS BY OTHERS FOR ALL UNIT SIZES, DUCT LAYOUTS, EXHAUST REQUIREMENTS, ENERGY CALCULATIONS, UNIT MOUNTING & CLEARANCE DETAILS, ACCESS REQUIREMENTS, ETC. REQUIRED TO BE SHOWN AND NOTED BY CODE.

2. THIS HOME IS DESIGNED TO COMPLY WITH THE NATURAL VENTILATION REQUIREMENTS OF SECTION 402 OF THE FLORIDA BUILDING CODE 2017, MECHANICAL.

3. PROVIDE SCREENED VENTS AT FLOOR LEVEL IN GARAGE MIN. 60 SQUARE INCHES (100 CFM) PER VEHICLE OR EXHAUST FAN (SEE MECH. PLAN) PER F.B.C. MECH. CODE TABLE 403.3. TWO CARE GARAGE = 120 SQUARE INCHES OF SCREENED VENTS.

4. CLOTHES DRYER EXHAUST DUCTS SHALL BE A MINIMUM OF 4" ROUND 26 GA. METAL PIPE. DRYER DUCTS SHALL HAVE A SMOOTH INTERIOR SURFACE, AND MUST NOT EXCEED THE MAXIMUM ALLOWABLE

5. SUFFICIENT SPACE SHALL BE PROVIDED ADJACENT TO ALL MECHANICAL COMPONENTS LOCATED IN OR FORMING A PART OF THE AIR DISTRIBUTION SYSTEM TO ASSURE ADEQUATE ACCESS FOR SEALING, INSPECTION, CLEANING, AND MAINTENANCE. A MINIMUM OF 4" IS CONSIDERED SUFFICIENT SPACE AROUND AIR HANDING UNITS. PER 610.1.ABC.3. SEE F.M.C. 306.1.1 FOR OTHER RESTRICTIONS AND

6. EXTERIOR CONCRETE ACCESSORY AND EQUIPMENT PADS SHALL BE A MINIMUM OF 4" THICK.

7. WHEN AN AUXILIARY DRAIN PAN CANNOT BE INSTALLED UNDER UNITS CONTAINING COOLING COILS, A DRAIN PIPE SHALL BE CONNECTED TO THE SECONDARY DRAIN (OVERFLOW) CONNECTION SO THAT THE OVERFLOWING CONDENSATE RESULTING FROM FLOW RESTRICTIONS IN THE PRIMARY DRAIN PIPE WILL BE CARRIED AWAY WITHOUT CAUSING DAMAGE TO THE UNIT OR ITS SURROUNDINGS. AS AN ALTERNATIVE TO A SECONDARY DRAIN LINE, AN APPROVED WATER LEVEL DETECTOR OR FLOAT SWITCH DEVICE SHALL BE USED TO CONTROL OVERFLOW BY AUTOMATICALLY SHUTTING DOWN THE EQUIPMENT THAT PRODUCES THE CONDENSATE.

8. PIPING THROUGH MASONRY SLABS AND/OR WALLS MUST BE PROPERLY SLEEVED. ALL HORIZONTAL PRIMARY CONDENSATE DRAINS WITHIN UNCONDITIONED AREAS SHALL BE INSULATED PER F.M.C.

9. HVAC SYSTEM IS TO BE DESIGNED TO KEEP RELATIVE HUMIDITY BELOW 50% IN ORDER TO HELP PREVENT THE GROWTH OF TOXINS.

10. CONDENSATE DRAINS ARE 3/4" PVC WITH 1/2" T-CELL INSULATION, OUTLET MINIMUM 1`2" OFF

11. BYPASS RETURNS TO MEET FLORIDA MECHANICAL CODE 601.4.

12. DRYER NOTE: UL 2158 FOR TRANSMISSIONS, NO MORE THAN 200 CFM PER MANUFACTURER'S SPECS. ALL DRYERS MUST HAVE DAMPERS.

13. PER F.M.C. 401.5 AIR EXHAUST AND INTAKE OPENINGS THAT TERMINATE OUTDOORS SHALL BE PROTECTED WITH CORROSION RESISTANT SCREENS, LOUVERS OR GRILLES. OPENINGS IN LOUVERS, GRILLES AND SCREENS SHALL BE SIZED IN ACCORDANCE WITH TABLE 401.5 AND SHALL BE PROTECTED AGAINST LOCAL WEATHER CONDITIONS. OPENINGS LOCATED IN EXTERIOR WALLS SHALL MEET THE PROVISIONS FOR EXTERIOR WALL OPENING PROTECTIVES IN ACCORDANCE WITH THE F.B.C.

ALL ELECTRICAL FIXTURES. APPLIANCES, EQUIPMENT AND MECHANICAL EQUIPMENT UL LISTED AND MARKED.

CONTRACTOR SHALL ENFORCE STRICT DISCIPLINE AND GOOD ORDER AMONG DO NOT EMPLOY ON WORK UNFIT PERSONS OR PERSONS NOT SKILLED IN ASSIGNED

CONTRACTOR SHALL ASSUME FULL RESPONSIBILITY FOR PROTECTION OF OWNER'S CONTRACTOR WILL REPAIR OR REPLACE ALL DAMAGE ITEMS WITHOUT COST TO THE

PLAN NOTES:

1. PROVIDE 1x2 P.T. FIRESTOP HORIZONTAL @ CEILING & WALL INTERSECTIONS OR 8'-0" O/C VERT. MAX AND ALL OTHER LOCATIONS PER F.B.C. SECTION 705

2. DRYWALL ATTACHMENTS MUST COMPLY WITH R441.4.6. GYPSUM WALLBOARD SHALL BE ATTACHED TO METAL MEMBERS BY SELF-DRILLING, SELF TAPPING SHEET METAL SCREWS. THE SPACING OF SCREWS ATTACHING TO GYPSUM WALLBOARD TO METAL STUDS AND RUNNERS, SHALL NOT BE MORE THAN 12 INCHES (305 MM) ON CENTER. SCREW FOR ATTACHING GYPSUM TO METAL STUDS SHALL NOT BE LESS THAN 7/8 INCH (22.2 MM) LONG FOR 1/2 INCH (17.7 MM) WALLBOARD OR 1 INCH (25.4 MM) LONG FOR 5/8 INCH (17.1 MM) WALLBOARD. SCREWS ATTACHING GYPSUM WALLBOARD SHALL BE DRIVEN BELOW THE SURFACE AND SPOTTED WITH FINISHING COMPOUND. RUNNERS SHALL BE FASTENED TO THE CEILING, CONTIGUOUS WALLS AND PARTITIONS AND TO THE FLOOR AT INTERVALS NOT EXCEEDING 24 INCHES (610 MM) ON CENTER. SUCH ATTACHMENT MAY BE BY NAILS PENETRATING THE BASE MATERIAL NOT LESS THAN 5/8 INCH (17.1 MM) OR BY SELF-DRIVING, SELF-TAPPING SHEET METAL SCREWS ATTACHING METAL TO METAL.

3. WALL TILE MUST COMPLY WITH R4411.7.2.1. CERAMIC AND PORTLAND CEMENT WALL TILE USED IN AREAS SUBJECT TO FREQUENT WEARING SHALL BE BACKED WITH MASONRY, STUCCO ON WIRE LATH OR APPROVED TILE BACKER BOARD.

4. PENETRATIONS THROUGH THE SEPARATIONS REQUIRED IN SECTION R309.2 SHALL BE PROTECTED BY FILLING THE OPENING AROUND THE PENETRATING ITEM WITH APPROVED MATERIAL TO RESIST THE FREE PASSAGE OF FLAME AND PRODUCTS OF

5. ALL DIMENSIONS ARE TO FRAMING AND STRUCTURE, NOT FINISHED SURFACES.

6. ALL SLEEPING ROOMS MUST COMPLY WITH R314. ALL ROOMS WILL HAVE (!) SMOKE DETECTOR INSIDE AND ONE IN THE IMMEDIATE VICINITY OUTSIDE.

GENERAL NOTES:

1. CONSTRUCTION SHALL FOLLOW THE 2017 FLORIDA BUILDING CODE AS ADAPTED BY THE COUNTY AND ALL APPLICABLE CODES, AMENDMENTS, LAWS AND STATUTES. STRICTLY ADHERE TO

2. ALL CONSTRUCTION IN BROWARD AND DADE COUNTIES SHALL COMPLY WITH THE HIGH VELOCITY HURRICANE ZONE (HVHZ) SECTIONS OF THE F.B.C.

4. BUILDER SHALL REVIEW DRAWINGS AND VERIFY DIMENSIONS AND DESIGN INTENT BEFORE BEGINING DISCREPANCIES OR MISSING DIMENSIONAL REQUIREMENTS NOT REPORTED IMMEDIATELY IN WRITING TO THE ARCHITECT/ENGINEER. BACKCHARGES WILL NOT BE ACCEPTED. DO NOT SCALE OR MEASURE ANY

5. BUILDER IS RESPONSIBLE FOR ADEQUATE BRACING AND SHORING OF STRUCTURAL AND

6. THESE PLANS, AS DRAWN AND NOTED, COMPLY WITH THE BUILDING ENVELOPE ENERGY REQUIREMENTS OF THE F.B.C. CHAPTER 13 ENERGY EFFICIENCY SECTION.

7. ALL WINDOWS AND DOORS SHALL BE CAULKED, AND WEATHER STRIPPED. WINDOW UNITS SHALL

DISPLAY LABELS SHOWING COMPLIANCE WITH F.B.C. CHAPTER 13 ENERGY EFFICIENCY SECTION.

8. CABINET, WINDOW, AND DOOR SUPPLIERS SHALL PROVIDE SHOP DRAWINGS TO THE BUILDER.

9. ALL MATERIALS, EQUIPMENT, APPLIANCES, ETC. SHALL BE INSTALLED IN STRICT ACCORDANCE WITH THE MANUFACTURER'S PRINTED INSTRUCTIONS.

10. PROVIDE POSITIVE DRAINAGE AWAY FROM BUILDING PERIMETER.

11. HANDLE AND DISPOSE OF SOLID WASTE IN SUCH A MANNER THAT WILL PREVENT THE CONTAMINATION OF THE ENVIRONMENT. TRANSPORT ALL SOLID WASTE OFF PROPERTY AND DISPOSE

12. CONTRACTOR SHALL NOT USE ANY MATERIALS CONTAINING ASBESTOS OR LEAD BASED PAINT FOR ANY PART OF THE WORK.

13. STORE CHEMICAL WASTE AWAY FROM THE WORK AREA IN CORROSION RESISTANT CONTAINERS AND DISPOSE OF CHEMICAL WASTE IN ACCORDANCE WITH FEDERAL, STATE, AND LOCAL

ENVIRONMENTAL CONSIDERATIONS:

1. BUILDER SHALL FAMILIARIZE HIMSELF WITH THE EPA GUIDELINES FOR THE PREVENTION OF MOLD AND

2. MANAGE CONSTRUCTION ACTIVITIES TO AVOID POLLUTION OF SURFACE AND GROUND WATERS AND SEWER SYSTEMS. DO NOT ALLOW WASTE WATER FROM CONSTRUCTION ACTIVITIES TO ENTER WATER

GASEOUS BY PRODUCTS FROM ALL CONSTRUCTION ACTIVITIES. PROCESSING. AND PREPARATION OF MATERIALS AT ALL TIMES. SPRINKLE OR USE OTHER METHODS THAT ARE PERMITTED TO CONTROL PARTICULATES IN THE WORK AREA.

MOISTURE CONTROL

2. IF THE BUILDER OBSERVES WATER INFILTRATION (UNINTENDED) INTO THE BUILDING, HE SHALL IMMEDIATELY TAKE STEPS TO INVESTIGATE THE SOURCE OF THE WATER INFILTRATION AND DEVISE A PROCEDURE TO PROMPTLY ELIMINATE WATER INFILTRATION INTO THE BUILDING.

3. THE BUILDER SHALL INSPECT ALL MATERIALS DELIVERED TO THE SITE FOR PRE-EXISTING WATER DAMAGE, AS WELL AS EXISTING MOLD GROWTH.

4. IF IN-PLACE CONSTRUCTION BECOMES WET, CONTACT THE MANUFACTURER AND DETERMINE WETHER OR NOT THE WORK SHALL BE REMOVED AND REPLACED, OR IF THE TYPE OF MATERIAL CAN BE

5. UNDER NO CIRCUMSTANCES SHALL NEW OR ADDITIONAL CONSTRUCTION BE PLACES OVER, OR OTHERWISE ENCLOSE, WET BUILDING MATERIALS.

THERMAL ENVELOPE:

1. THE BUILDING THERMAL ENVELOPE SHALL BE COMPLETELY SEALED AGAINST MOISTURE AROUND ALL PENETRATIONS AND AGAINST AIR LEAKAGE IN ACCORDANCE WITH F.B.C. TABLE R402.4.1.1.

COPIES FURNISHED AND OWNERSHIP

THE ORIGINAL DRAWINGS AND SPECIFICATIONS AND ALL SETS REPRODUCED FROM SUCH ARE THE PROPERTY OF THE ARCHITECT. THE DRAWINGS SHALL NOT BE DUPLICATED OR REPRODUCED IN ANY PORTION WITHOUT PRIOR WRITTEN CONSENT FROM THE ARCHITECT OR OWNER.

GENERAL CONTRACTOR IS RESPONSIBLE FOR CONFIRMING AND COORDINATING ALL FIELD DIMENSIONS.

WHERE THE CONTRACTOR IS REQUESTING TO PROVIDE A PRODUCT SUBSTITUTION OR EQUAL, THE CONTRACTOR SHALL SUBMIT TO THE ARCHITECT AND OWNER SUFFICIENT PRODUCT DATA, SPECIFICATIONS AND SAMPLES AS DETERMINED BY THE ARCHITECT FOR SUBSTITUTION.


REQUESTS FOR SUBSTITUTIONS OR EQUALS SHALL BE SUBMITTED FOR REVIEW TO THE ARCHITECT NO LATER THAN 10 DAYS PRIOR TO THE BID DATE. NO SUBSTITUTION OR EQUAL WILL BE ALLOWED WITHOUT THE WRITTEN APPROVAL OF THE ARCHITECT OR OWNER.

STANDARDS OF QUALITY:

ANY MATERIAL, ARTICLE OR PIECE OF EQUIPMENT FROM OTHER MANUFACTURERS OR VENDORS WHICH SHALL PERFORM ADEQUATELY THE DUTIES IMPOSED BY THE GENERAL DESIGN SHALL BE CONSIDERED EQUALLY ACCEPTABLE PROVIDED THE MATERIAL, ARTICLE, OR PIECE OF EQUIPMENT SO PROPOSED IS, IN THE OPINION OF THE ARCHITECT. OF EQUAL SUBSTANCE. APPEARANCE AND FUNCTION. IT SHALL NOT BE PURCHASED OR INSTALLED BY THE CONTRACTOR WITHOUT THE ARCHITECT'S PRIOR WRITTEN APPROVAL.

ALL ELECTRICAL FIXTURES. APPLIANCES, EQUIPMENT AND MECHANICAL EQUIPMENT ARE TO BE UL LISTED AND MARKED.

CONTRACTOR SHALL ENFORCE STRICT DISCIPLINE AND GOOD ORDER AMONG EMPLOYEES. DO NOT EMPLOY ON WORK UNFIT PERSONS OR PERSONS NOT SKILLED IN ASSIGNED TASKS. CONTRACTOR SHALL ASSUME FULL RESPONSIBILITY FOR PROTECTION OF OWNER'S PROPERTY. CONTRACTOR WILL REPAIR OR REPLACE ALL DAMAGE ITEMS WITHOUT COST TO THE OWNER.

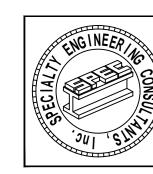

L. CA. #009217

OLIVERIO

PROJECT OWNER: JEFFRET OLIVERIO 1134 JEFFERSON STREET HOLLYWOOD, FL 33013

PROJECT LOCATION: 1134 JEFFERSON STREET HOLLYWOOD, FL 33013

PROJECT DATA

5142 14 01 5742

LEGAL DESCRIPTION: HOLLYWOOD LAKES SECTION 1-32 B LOT 22 W1/2, 23 BLK 34

ZONING CLASIFICATION:

LOW RESIDENTIAL (LRES)

HISTORIC DESIGNATION:

SITE SQUARE FOOTAGE:

GARY McDOUGLE, PE FL #56214

PROJECT # | HART1134 SCALE 1/4'' = 1'-0'' U.N.O.


DRAWN BY | BAS

REVISION SCHEDULE DESCRIPTION

1 |12.12.19 | PERMIT SUBMITTAL

TITLE SHEET


SHEET TITLE

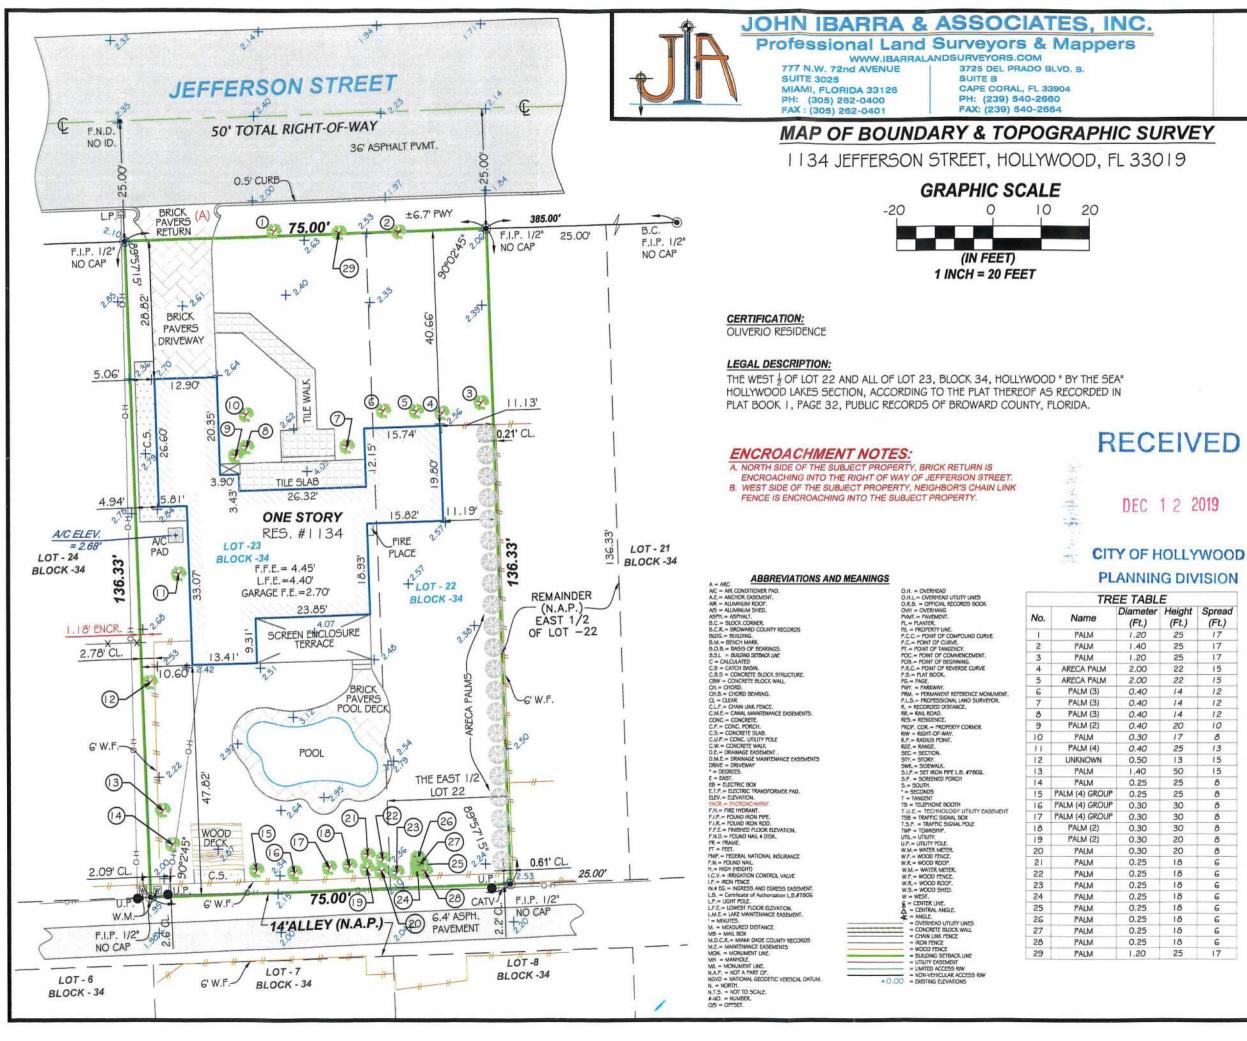

MAP OF BOUNDARY & TOPOGRAPHIC SURVEY

PLANNING DIVISION

TREE TABLE				
No.	Name	Diameter (Ft.)	Height (Ft.)	Spread (Ft.)
1	PALM	1.20	25	17
2	PALM	1.40	25	17
3	PALM	1.20	25	17
4	ARECA PALM	2.00	22	15
5	ARECA PALM	2.00	22	15
6	PALM (3)	0.40	14	12
7	PALM (3)	0.40	14	12
8	PALM (3)	0.40	14	12
9	PALM (2)	0.40	20	10
10	PALM	0.30	17	8
11	PALM (4)	0.40	25	13
12	UNKNOWN	0.50	13	15
13	PALM	1.40	50	15
14	PALM	0.25	25	8
15	PALM (4) GROUP	0.25	25	8
16	PALM (4) GROUP	0.30	30	8
17	PALM (4) GROUP	0.30	30	8
18	PALM (2)	0.30	30	8
19	PALM (2)	0.30	20	8
20	PALM	0.30	20	8
21	PALM	0.25	18	6
22	PALM	0.25	18	6
23	PALM	0.25	18	6
24	PALM	0.25	18	6
25	PALM	0.25	18	6
26	PALM	0.25	18	6
27	PALM	0.25	18	6
28	PALM	0.25	18	6
20	DALLA	1.20	25	17

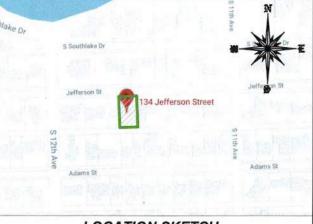

LOCATION SKETCH

LEGAL NOTES TO ACCOMPANY SKETCH OF SURVEY:

THERE MAY BE EASEMENTS RECORDED IN THE PUBLIC RECORDS NOT SHOWN ON THE SURVEY

- THE PURPOSE OF THIS SURVEY IS FOR USE IN OBTAINING TITLE INSURANCE AND FINANCING
- AND SHOULD NOT BE USED FOR CONSTRUCTION PURPOSES.
- EXAMINATIONS OF THE ABSTRACT OF TITLE WILL HAVE TO BE MADE TO DETERMINE RECORDED INSTRUMENTS. IF ANY, AFFECTING THE PROPERTY.
- THIS SURVEY IS SUBJECT TO DEDICATIONS, LIMITATIONS, RESTRICTIONS, RESERVATIONS OR EASEMENTS OF RECORD.
- LEGAL DESCRIPTIONS PROVIDED BY CLIENT OR ATTESTING TITLE COMPANY
- BOUNDARY SURVEY MEANS A DRAWING AND/ OR A GRAPHIC REPRESENTATION OF THE SURVEY WORK PERFORMED IN THE FIELD, COULD BE DRAWN AT A SHOWN SCALE AND/OR NOT TO SCALE; THE WALLS OR FENCES MAY BE EXAGGERATED FOR CLARITY PURPOSES.
- FASEMENTS AS SHOWN ARE PER PLAT BOOK. UNLESS DEPICTED OTHERWISE
- THE TERM "ENCROACHMENT" MEANS VISIBLE AND ABOVE GROUND ENCROACHMENTS.
- · ARCHITECTS SHALL VERIFY ZONING REGULATIONS, RESTRICTIONS, SETBACKS AND WILL BE
- RESPONSIBLE FOR SUBMITTING

 PLOT PLANS WITH CORRECT INFORMATION FOR "APPROVAL FOR AUTHORIZATION" TO THE
- PROPER AUTHORITIES IN NEW CONSTRUCTION.

 UNLESS OTHERWISE NOTED, THIS FIRM HAS NOT ATTEMPTED TO LOCATE FOOTING AND/OR
- FOUNDATIONS.
- FENCE OWNERSHIP NOT DETERMINED.
 THIS FILAN OF SURVEY, HAS BEEN PREPARED FOR THE EXCLUSIVE USE OF THE ENTITIES.
- NAMED HEREON, THE CERTIFICATE

 DOES NOT EXTEND TO ANY UNNAMED PARTY.

FLOOD ZONE INFORMATION:

THE NEIP ELOOD MAPS HAVE DESIGNATED THE HEREIN DESCRIBED LAND TO BE SITUATED IN: BASE FLOOD FLEVATION: 7 FT DATE OF FIRM: 08/18/2014
THE SUBJECT PROPERTY DOES LIE IN A SPECIAL FLOOD HAZARD AREA.

SURVEYOR'S NOTES:

. IF SHOWN, BEARINGS ARE REFERRED TO AN ASSUMED MERIDIAN, BY SAID PLAT IN THE DESCRIPTION OF

- THE PROPERTY, IF NOT, BEARINGS ARE THEN REFERRED TO COUNTY, TOWNSHIP MAPS.
- 2. THE CLOSURE IN THE BOUNDARY SURVEY IS ABOVE 1:7500 FT.
- 3. CERTIFICATE OF AUTHORIZATION LB # 7806.
- 4. ALL ELEVATIONS SHOWN ARE REFERRED TO NORTH AMERICAN VERTICAL DATUM OF 1988, NGS BENCH MARK PID# AD2430. DESIGNATION: B 3 | 1; ELEVATION IS 1.68 FEET OF N.A.V.D. OF 1988.

SURVEYOR'S CERTIFICATION:

I HEREBY CERTIFY: THIS 'BOUNDARY & TOPOGRAPHIC SURVEY' OF THE PROPERTY DESCRIBED HEREON, HAS RECENTLY BEEN SUBVEYED AND DRAWN UNDER MY SUPERVISION, AND COMPLIES WITH THE STANDARDS OF PRACTICE AS SET PORTH BY THE FLORIDA BOARD OF PROFESSIONAL LAND SURVEYORS IN CHAPTER 5.J. I. 7. FLORIDA ADMINISTRATIVE CODEMURSUANT TO 472.027. FLORIDA STATUTES.

11/12/2019

JOHN IBARRA (DATE OF FIELD WORK)

PROFESSIONAL LAND SURVEYOR NO.: 5204 STATE OF FLORIDA (NOT VALID WITHOUT THE SIGNATURE AND THE ORIGINAL RAISED SEAL OF A FLORIDA LICENSED SURVEYOR

REVISED ON: REVISED ON:

DRAWN BY: DA FIELD DATE: 11/12/2019 19-005447-1 SURVEY NO: SHEET: 1 OF 1



PROPRIETARY INFORMATION: THIS DOCUMENT IS SUBJECT TO COPYRIGHT LAWS. NEITHER THE DOCUMENT NOR ANY INFORMATION HEREIN MAY BE RELEASED WITHOUT WRITTEN PERMISSION OF HART LUXURY HOMES, INC. @2019

OLIVERIO RESIDENCE





THESE PLANS HAVE BEEN PREPARED IN ACCORDANCE WITH: FLORIDA RESIDENTIAL BUILDING CODE 2017 EDITION W/ SUPPLEMENTS NATIONAL ELECTRIC CODE - LATEST EDITION ALL APPLICABLE AMENDMENTS

CONTRACTOR'S PERMIT SET:

THESE DRAWINGS ARE TO BE CONSIDERED A "CONTRACTOR'S PERMIT SET" AND ARE NOT INTENDED TO COVER ALL AREAS OF CONTRACTUAL AGREEMENTS BETWEEN OWNER AND CONTRACTOR. SPECIFIC MATERIALS, PAINT COLORS, FURNITURE, FINISHES, FIXTURES, ALLOWANCES, ETC. NOT COVERED BY THESE PLANS SHOULD BE INCLUDED IN THE WRITTEN AGREEMENT BETWEEN THE OWNER AND THE CONTRACTOR. IF APPLICABLE, THE CONTRACTOR IS TO COORDINATE EXACT CABINETRY LAYOUT W/ CABINETRY SHOP DRAWINGS.

DRAV	WING INDEX:	A3	FRONT & REAR ELEVATIONS	M1	TBD
T1	TITLE SHEET PLOT PLAN SURVEY - TBD	A4	RIGHT & LEFT ELEVATIONS	S1-8	TBD
	BOUNDARY SURVEY	A5	STREET PROFILE ELEVATION	S2-8	TBD
C1 C2	GRADING AND DRAINAGE PLAN PAVING, GRADING & DRAINAGE	A6	TBD	S3-8	TBD
90	PLAN	A7	TBD	S4-8	TBD
СЗ	SEPTIC & DRAINFIELD PLAN	A8	TBD		
L1	TREE DISPOSITION PLAN	A9	TBD	S5-8	TBD
L2 L3	LANDSCAPE PLAN LANDSCAPE DETAILS	A10	TBD	S6-8	TBD
L4	IRRIGATION PLAN - TBD	A11	TBD	S7-8	TBD
AO	SITE & ROOF PLAN			S8-8	TBD
A1	FIRST FLOOR PLAN & RCP	A12	TBD	50-0	עעו
		A13	TBD		
A2.	DIMENSION PLAN				


SOFFIT ABOVE, SEE PLAN FOR HEIGHT

WALL OPENING

SYMBOLS LEGEND:	
TYPICAL MASONRY CONSTRUCTION	
GROUT FILLED CELL W/ REBAR. SEE STRUCTURAL	•
POURED CONCRETE COLUMN. SEE STRUCTURAL	
NON-BEARING FRAME CONSTRUCTION	
INFILL MASONRY CONSTRUCTION. SEE STRUCTURAL	
FRAME CONSTRUCTION ABOVE OR BELOW SEE PLAN FOR HEIGHT	

1 HOUR FIRERATED WALL DETAIL CALLOUT W/ SHEET NO. NOTED WALL SECTION CALLOUT

AS NOTED ON PLANS

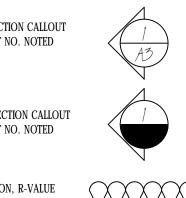

BLDG. SECTION CALLOUT W/ SHEET NO. NOTED INSULATION, R-VALUE AS NOTED ON PLANS 3" SOUND BLANKETS

ABBREVIATIONS:

F.R. FIRE RATED

FIN. FINISHED

G.E. GABLE END

G.T. GIRDER TRUSS

HGT. HEIGHT

HPS. HOOPES

LG. LONG

INS.

GWB GYPSUM WALLBOARD

GYP. BD. GYPSUM WALLBOARD

HS HORIZONTAL SLIDING

INSULATION

INTERIOR

FLR.

FR FRENCH DOOR

FLOOR

GAUGE

GFCI GROUND FAULT CIRCUIT INTERRUPT

HVHZ HIGH VELOCITY HURRICANE ZONE

ABOVE	LIN.	LINEN
ARC FAULT CIRCUIT INTERRUPT	LT.	LIGHT
ABOVE FINISHED FLOOR	L.T.	LAUNDRY TUB
AIR HANDLER UNIT	M.C.	MEDICINE CABINET
BI FOLD	M.R.H.	MEAN ROOF HEIGHT
BI PASS	M.T.	METAL THRESHOLD
BLOCK	MAX.	MAXIMUM
BELOW	MFR.	MANUFACTURER
BEARING	MICRO.	MICROWAVE
BOTTOM	MIN.	MINIMUM
CEILING	M.O.	MASONRY OPENING
CONCRETE MASONRY UNIT	MONO	MONOLITHIC
COLUMN	MTL.	
CONCRETE	N.E.C.	NATIONAL ELECTRIC CODE
CONTINUOUS	O.H.D.	OVER HEAD DOOR
CASEMENT	O.H.	OVERHANG
DOUBLE	O/C	ON CENTER
DIAMETER	P.L.F.	
DISPOSAL	P.S.F.	POUNDS PER SQUARE FOOT
DESIGN PRESSURE	P.S.I.	POUNDS PER SQUARE INCH
DOOR	P.T.	PRESSURE TREATED
DISH WASHER	PART.	PARTITION
EACH END	PKT.	POCKET
ELECTRICAL	PLYWD.	PLYWOOD
ELEVATION	R.O.	ROUGH OPENING
EACH SIDE	S.C.	SOLID CORE
EACH WAY	SD	SMOKE DETECTOR
EXISTING	S.G.D.	SLIDING GLASS DOOR
EXTERIOR	SF	SQUARE FOOT
FLORIDA BUILDING CODE	SH	SINGLE HUNG
FINISHED FLOOR	SMS	SHEET METAL SCREWS

STIRRUPS

TEMPERED

T.O.B. TOP OF BEARING

T.O.T.B. TOP OF TIE BEAM

V.I.F. VERIFY IN FIELD

WITH

WC WATER CLOSET

W.A. WEDGE ANCHORS

TYP. TYPICAL

THROUGH BOLT

THROUGH OUT

T.O.PL. TOP OF WOOD PLATE

U.N.O. UNLESS NOTED OTHERWISE

UNDERWRITERS LABORATORIES

T.O.B.B. TOP OF MASONRY BOND BEAM

STL. STEEL

SW SWITCH

MECHANICAL NOTES:

1. SEE MECHANICAL PLANS BY OTHERS FOR ALL UNIT SIZES, DUCT LAYOUTS, EXHAUST REQUIREMENTS, ENERGY CALCULATIONS, UNIT MOUNTING & CLEARANCE DETAILS, ACCESS REQUIREMENTS, ETC. REQUIRED TO BE SHOWN AND NOTED BY CODE.

2. THIS HOME IS DESIGNED TO COMPLY WITH THE NATURAL VENTILATION REQUIREMENTS OF SECTION 402 OF THE FLORIDA BUILDING CODE 2017, MECHANICAL.

3. PROVIDE SCREENED VENTS AT FLOOR LEVEL IN GARAGE MIN. 60 SQUARE INCHES (100 CFM) PER VEHICLE OR EXHAUST FAN (SEE MECH. PLAN) PER F.B.C. MECH. CODE TABLE 403.3. TWO CARE GARAGE = 120 SQUARE INCHES OF SCREENED VENTS.

4. CLOTHES DRYER EXHAUST DUCTS SHALL BE A MINIMUM OF 4" ROUND 26 GA. METAL PIPE. DRYER DUCTS SHALL HAVE A SMOOTH INTERIOR SURFACE, AND MUST NOT EXCEED THE MAXIMUM ALLOWABLE

5. SUFFICIENT SPACE SHALL BE PROVIDED ADJACENT TO ALL MECHANICAL COMPONENTS LOCATED IN OR FORMING A PART OF THE AIR DISTRIBUTION SYSTEM TO ASSURE ADEQUATE ACCESS FOR SEALING, INSPECTION, CLEANING, AND MAINTENANCE. A MINIMUM OF 4" IS CONSIDERED SUFFICIENT SPACE AROUND AIR HANDING UNITS. PER 610.1.ABC.3. SEE F.M.C. 306.1.1 FOR OTHER RESTRICTIONS AND

6. EXTERIOR CONCRETE ACCESSORY AND EQUIPMENT PADS SHALL BE A MINIMUM OF 4" THICK.

7. WHEN AN AUXILIARY DRAIN PAN CANNOT BE INSTALLED UNDER UNITS CONTAINING COOLING COILS, A DRAIN PIPE SHALL BE CONNECTED TO THE SECONDARY DRAIN (OVERFLOW) CONNECTION SO THAT THE OVERFLOWING CONDENSATE RESULTING FROM FLOW RESTRICTIONS IN THE PRIMARY DRAIN PIPE WILL BE CARRIED AWAY WITHOUT CAUSING DAMAGE TO THE UNIT OR IT'S SURROUNDINGS. AS AN ALTERNATIVE TO A SECONDARY DRAIN LINE, AN APPROVED WATER LEVEL DETECTOR OR FLOAT SWITCH DEVICE SHALL BE USED TO CONTROL OVERFLOW BY AUTOMATICALLY SHUTTING DOWN THE EQUIPMENT THAT PRODUCES THE CONDENSATE.

8. PIPING THROUGH MASONRY SLABS AND/OR WALLS MUST BE PROPERLY SLEEVED. ALL HORIZONTAL PRIMARY CONDENSATE DRAINS WITHIN UNCONDITIONED AREAS SHALL BE INSULATED PER F.M.C.

9. HVAC SYSTEM IS TO BE DESIGNED TO KEEP RELATIVE HUMIDITY BELOW 50% IN ORDER TO HELP PREVENT THE GROWTH OF TOXINS.

10. CONDENSATE DRAINS ARE 3/4" PVC WITH 1/2" T-CELL INSULATION, OUTLET MINIMUM 1`2" OFF

11. BYPASS RETURNS TO MEET FLORIDA MECHANICAL CODE 601.4.

12. DRYER NOTE: UL 2158 FOR TRANSMISSIONS, NO MORE THAN 200 CFM PER MANUFACTURER'S SPECS. ALL DRYERS MUST HAVE DAMPERS.

13. PER F.M.C. 401.5 AIR EXHAUST AND INTAKE OPENINGS THAT TERMINATE OUTDOORS SHALL BE PROTECTED WITH CORROSION RESISTANT SCREENS, LOUVERS OR GRILLES. OPENINGS IN LOUVERS, GRILLES AND SCREENS SHALL BE SIZED IN ACCORDANCE WITH TABLE 401.5 AND SHALL BE PROTECTED AGAINST LOCAL WEATHER CONDITIONS. OPENINGS LOCATED IN EXTERIOR WALLS SHALL MEET THE PROVISIONS FOR EXTERIOR WALL OPENING PROTECTIVES IN ACCORDANCE WITH THE F.B.C.

ALL ELECTRICAL FIXTURES. APPLIANCES, EQUIPMENT AND MECHANICAL EQUIPMENT UL LISTED AND MARKED.

CONTRACTOR SHALL ENFORCE STRICT DISCIPLINE AND GOOD ORDER AMONG DO NOT EMPLOY ON WORK UNFIT PERSONS OR PERSONS NOT SKILLED IN ASSIGNED

CONTRACTOR SHALL ASSUME FULL RESPONSIBILITY FOR PROTECTION OF OWNER'S CONTRACTOR WILL REPAIR OR REPLACE ALL DAMAGE ITEMS WITHOUT COST TO THE

PLAN NOTES:

1. PROVIDE 1x2 P.T. FIRESTOP HORIZONTAL @ CEILING & WALL INTERSECTIONS OR 8'-0" O/C VERT. MAX AND ALL OTHER LOCATIONS PER F.B.C. SECTION 705

2. DRYWALL ATTACHMENTS MUST COMPLY WITH R441.4.6. GYPSUM WALLBOARD SHALL BE ATTACHED TO METAL MEMBERS BY SELF-DRILLING, SELF TAPPING SHEET METAL SCREWS. THE SPACING OF SCREWS ATTACHING TO GYPSUM WALLBOARD TO METAL STUDS AND RUNNERS, SHALL NOT BE MORE THAN 12 INCHES (305 MM) ON CENTER. SCREW FOR ATTACHING GYPSUM TO METAL STUDS SHALL NOT BE LESS THAN 7/8 INCH (22.2 MM) LONG FOR 1/2 INCH (17.7 MM) WALLBOARD OR 1 INCH (25.4 MM) LONG FOR 5/8 INCH (17.1 MM) WALLBOARD. SCREWS ATTACHING GYPSUM WALLBOARD SHALL BE DRIVEN BELOW THE SURFACE AND SPOTTED WITH FINISHING COMPOUND. RUNNERS SHALL BE FASTENED TO THE CEILING, CONTIGUOUS WALLS AND PARTITIONS AND TO THE FLOOR AT INTERVALS NOT EXCEEDING 24 INCHES (610 MM) ON CENTER. SUCH ATTACHMENT MAY BE BY NAILS PENETRATING THE BASE MATERIAL NOT LESS THAN 5/8 INCH (17.1 MM) OR BY SELF-DRIVING, SELF-TAPPING SHEET METAL SCREWS ATTACHING METAL TO METAL.

3. WALL TILE MUST COMPLY WITH R4411.7.2.1. CERAMIC AND PORTLAND CEMENT WALL TILE USED IN AREAS SUBJECT TO FREQUENT WEARING SHALL BE BACKED WITH MASONRY, STUCCO ON WIRE LATH OR APPROVED TILE BACKER BOARD.

4. PENETRATIONS THROUGH THE SEPARATIONS REQUIRED IN SECTION R309.2 SHALL BE PROTECTED BY FILLING THE OPENING AROUND THE PENETRATING ITEM WITH APPROVED MATERIAL TO RESIST THE FREE PASSAGE OF FLAME AND PRODUCTS OF

5. ALL DIMENSIONS ARE TO FRAMING AND STRUCTURE, NOT FINISHED SURFACES.

6. ALL SLEEPING ROOMS MUST COMPLY WITH R314. ALL ROOMS WILL HAVE (!) SMOKE DETECTOR INSIDE AND ONE IN THE IMMEDIATE VICINITY OUTSIDE.

GENERAL NOTES:

1. CONSTRUCTION SHALL FOLLOW THE 2017 FLORIDA BUILDING CODE AS ADAPTED BY THE COUNTY AND ALL APPLICABLE CODES, AMENDMENTS, LAWS AND STATUTES. STRICTLY ADHERE TO

2. ALL CONSTRUCTION IN BROWARD AND DADE COUNTIES SHALL COMPLY WITH THE HIGH VELOCITY HURRICANE ZONE (HVHZ) SECTIONS OF THE F.B.C.

4. BUILDER SHALL REVIEW DRAWINGS AND VERIFY DIMENSIONS AND DESIGN INTENT BEFORE BEGINING DISCREPANCIES OR MISSING DIMENSIONAL REQUIREMENTS NOT REPORTED IMMEDIATELY IN WRITING TO THE ARCHITECT/ENGINEER. BACKCHARGES WILL NOT BE ACCEPTED. DO NOT SCALE OR MEASURE ANY

5. BUILDER IS RESPONSIBLE FOR ADEQUATE BRACING AND SHORING OF STRUCTURAL AND

6. THESE PLANS, AS DRAWN AND NOTED, COMPLY WITH THE BUILDING ENVELOPE ENERGY REQUIREMENTS OF THE F.B.C. CHAPTER 13 ENERGY EFFICIENCY SECTION.

7. ALL WINDOWS AND DOORS SHALL BE CAULKED, AND WEATHER STRIPPED. WINDOW UNITS SHALL

DISPLAY LABELS SHOWING COMPLIANCE WITH F.B.C. CHAPTER 13 ENERGY EFFICIENCY SECTION.

8. CABINET, WINDOW, AND DOOR SUPPLIERS SHALL PROVIDE SHOP DRAWINGS TO THE BUILDER.

9. ALL MATERIALS, EQUIPMENT, APPLIANCES, ETC. SHALL BE INSTALLED IN STRICT ACCORDANCE WITH THE MANUFACTURER'S PRINTED INSTRUCTIONS.

10. PROVIDE POSITIVE DRAINAGE AWAY FROM BUILDING PERIMETER.

11. HANDLE AND DISPOSE OF SOLID WASTE IN SUCH A MANNER THAT WILL PREVENT THE CONTAMINATION OF THE ENVIRONMENT. TRANSPORT ALL SOLID WASTE OFF PROPERTY AND DISPOSE

12. CONTRACTOR SHALL NOT USE ANY MATERIALS CONTAINING ASBESTOS OR LEAD BASED PAINT FOR ANY PART OF THE WORK.

13. STORE CHEMICAL WASTE AWAY FROM THE WORK AREA IN CORROSION RESISTANT CONTAINERS AND DISPOSE OF CHEMICAL WASTE IN ACCORDANCE WITH FEDERAL, STATE, AND LOCAL

ENVIRONMENTAL CONSIDERATIONS:

1. BUILDER SHALL FAMILIARIZE HIMSELF WITH THE EPA GUIDELINES FOR THE PREVENTION OF MOLD AND

2. MANAGE CONSTRUCTION ACTIVITIES TO AVOID POLLUTION OF SURFACE AND GROUND WATERS AND SEWER SYSTEMS. DO NOT ALLOW WASTE WATER FROM CONSTRUCTION ACTIVITIES TO ENTER WATER

GASEOUS BY PRODUCTS FROM ALL CONSTRUCTION ACTIVITIES. PROCESSING. AND PREPARATION OF MATERIALS AT ALL TIMES. SPRINKLE OR USE OTHER METHODS THAT ARE PERMITTED TO CONTROL PARTICULATES IN THE WORK AREA.

MOISTURE CONTROL

2. IF THE BUILDER OBSERVES WATER INFILTRATION (UNINTENDED) INTO THE BUILDING, HE SHALL IMMEDIATELY TAKE STEPS TO INVESTIGATE THE SOURCE OF THE WATER INFILTRATION AND DEVISE A PROCEDURE TO PROMPTLY ELIMINATE WATER INFILTRATION INTO THE BUILDING.

3. THE BUILDER SHALL INSPECT ALL MATERIALS DELIVERED TO THE SITE FOR PRE-EXISTING WATER DAMAGE, AS WELL AS EXISTING MOLD GROWTH.

4. IF IN-PLACE CONSTRUCTION BECOMES WET, CONTACT THE MANUFACTURER AND DETERMINE WETHER OR NOT THE WORK SHALL BE REMOVED AND REPLACED, OR IF THE TYPE OF MATERIAL CAN BE

5. UNDER NO CIRCUMSTANCES SHALL NEW OR ADDITIONAL CONSTRUCTION BE PLACES OVER, OR OTHERWISE ENCLOSE, WET BUILDING MATERIALS.

THERMAL ENVELOPE:

1. THE BUILDING THERMAL ENVELOPE SHALL BE COMPLETELY SEALED AGAINST MOISTURE AROUND ALL PENETRATIONS AND AGAINST AIR LEAKAGE IN ACCORDANCE WITH F.B.C. TABLE R402.4.1.1.

COPIES FURNISHED AND OWNERSHIP

THE ORIGINAL DRAWINGS AND SPECIFICATIONS AND ALL SETS REPRODUCED FROM SUCH ARE THE PROPERTY OF THE ARCHITECT. THE DRAWINGS SHALL NOT BE DUPLICATED OR REPRODUCED IN ANY PORTION WITHOUT PRIOR WRITTEN CONSENT FROM THE ARCHITECT OR OWNER.

GENERAL CONTRACTOR IS RESPONSIBLE FOR CONFIRMING AND COORDINATING ALL FIELD DIMENSIONS.

WHERE THE CONTRACTOR IS REQUESTING TO PROVIDE A PRODUCT SUBSTITUTION OR EQUAL, THE CONTRACTOR SHALL SUBMIT TO THE ARCHITECT AND OWNER SUFFICIENT PRODUCT DATA, SPECIFICATIONS AND SAMPLES AS DETERMINED BY THE ARCHITECT FOR SUBSTITUTION.

REQUESTS FOR SUBSTITUTIONS OR EQUALS SHALL BE SUBMITTED FOR REVIEW TO THE ARCHITECT NO LATER THAN 10 DAYS PRIOR TO THE BID DATE. NO SUBSTITUTION OR EQUAL WILL BE ALLOWED WITHOUT THE WRITTEN APPROVAL


STANDARDS OF QUALITY:

OF THE ARCHITECT OR OWNER.

ANY MATERIAL, ARTICLE OR PIECE OF EQUIPMENT FROM OTHER MANUFACTURERS OR VENDORS WHICH SHALL PERFORM ADEQUATELY THE DUTIES IMPOSED BY THE GENERAL DESIGN SHALL BE CONSIDERED EQUALLY ACCEPTABLE PROVIDED THE MATERIAL, ARTICLE, OR PIECE OF EQUIPMENT SO PROPOSED IS, IN THE OPINION OF THE ARCHITECT. OF EQUAL SUBSTANCE. APPEARANCE AND FUNCTION. IT SHALL NOT BE PURCHASED OR INSTALLED BY THE CONTRACTOR WITHOUT THE ARCHITECT'S PRIOR WRITTEN APPROVAL.

ALL ELECTRICAL FIXTURES. APPLIANCES, EQUIPMENT AND MECHANICAL EQUIPMENT ARE TO BE UL LISTED AND MARKED.

CONTRACTOR SHALL ENFORCE STRICT DISCIPLINE AND GOOD ORDER AMONG EMPLOYEES. DO NOT EMPLOY ON WORK UNFIT PERSONS OR PERSONS NOT SKILLED IN ASSIGNED TASKS. CONTRACTOR SHALL ASSUME FULL RESPONSIBILITY FOR PROTECTION OF OWNER'S PROPERTY. CONTRACTOR WILL REPAIR OR REPLACE ALL DAMAGE ITEMS WITHOUT COST TO THE OWNER.

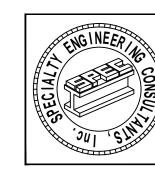

L. CA. #009217



OLIVERIO

PROJECT OWNER: JEFFRET OLIVERIO 1134 JEFFERSON STREET HOLLYWOOD, FL 33013

PROJECT LOCATION: 1134 JEFFERSON STREET HOLLYWOOD, FL 33013

PROJECT DATA

5142 14 01 5742

LEGAL DESCRIPTION: HOLLYWOOD LAKES SECTION 1-32 B LOT 22 W1/2, 23 BLK 34

ZONING CLASIFICATION:

LOW RESIDENTIAL (LRES)

HISTORIC DESIGNATION:

SITE SQUARE FOOTAGE:

GARY McDOUGLE, PE FL #56214

/////	
PROJECT #	HART1134
SCALE	1/4" = 1'-0" II N O


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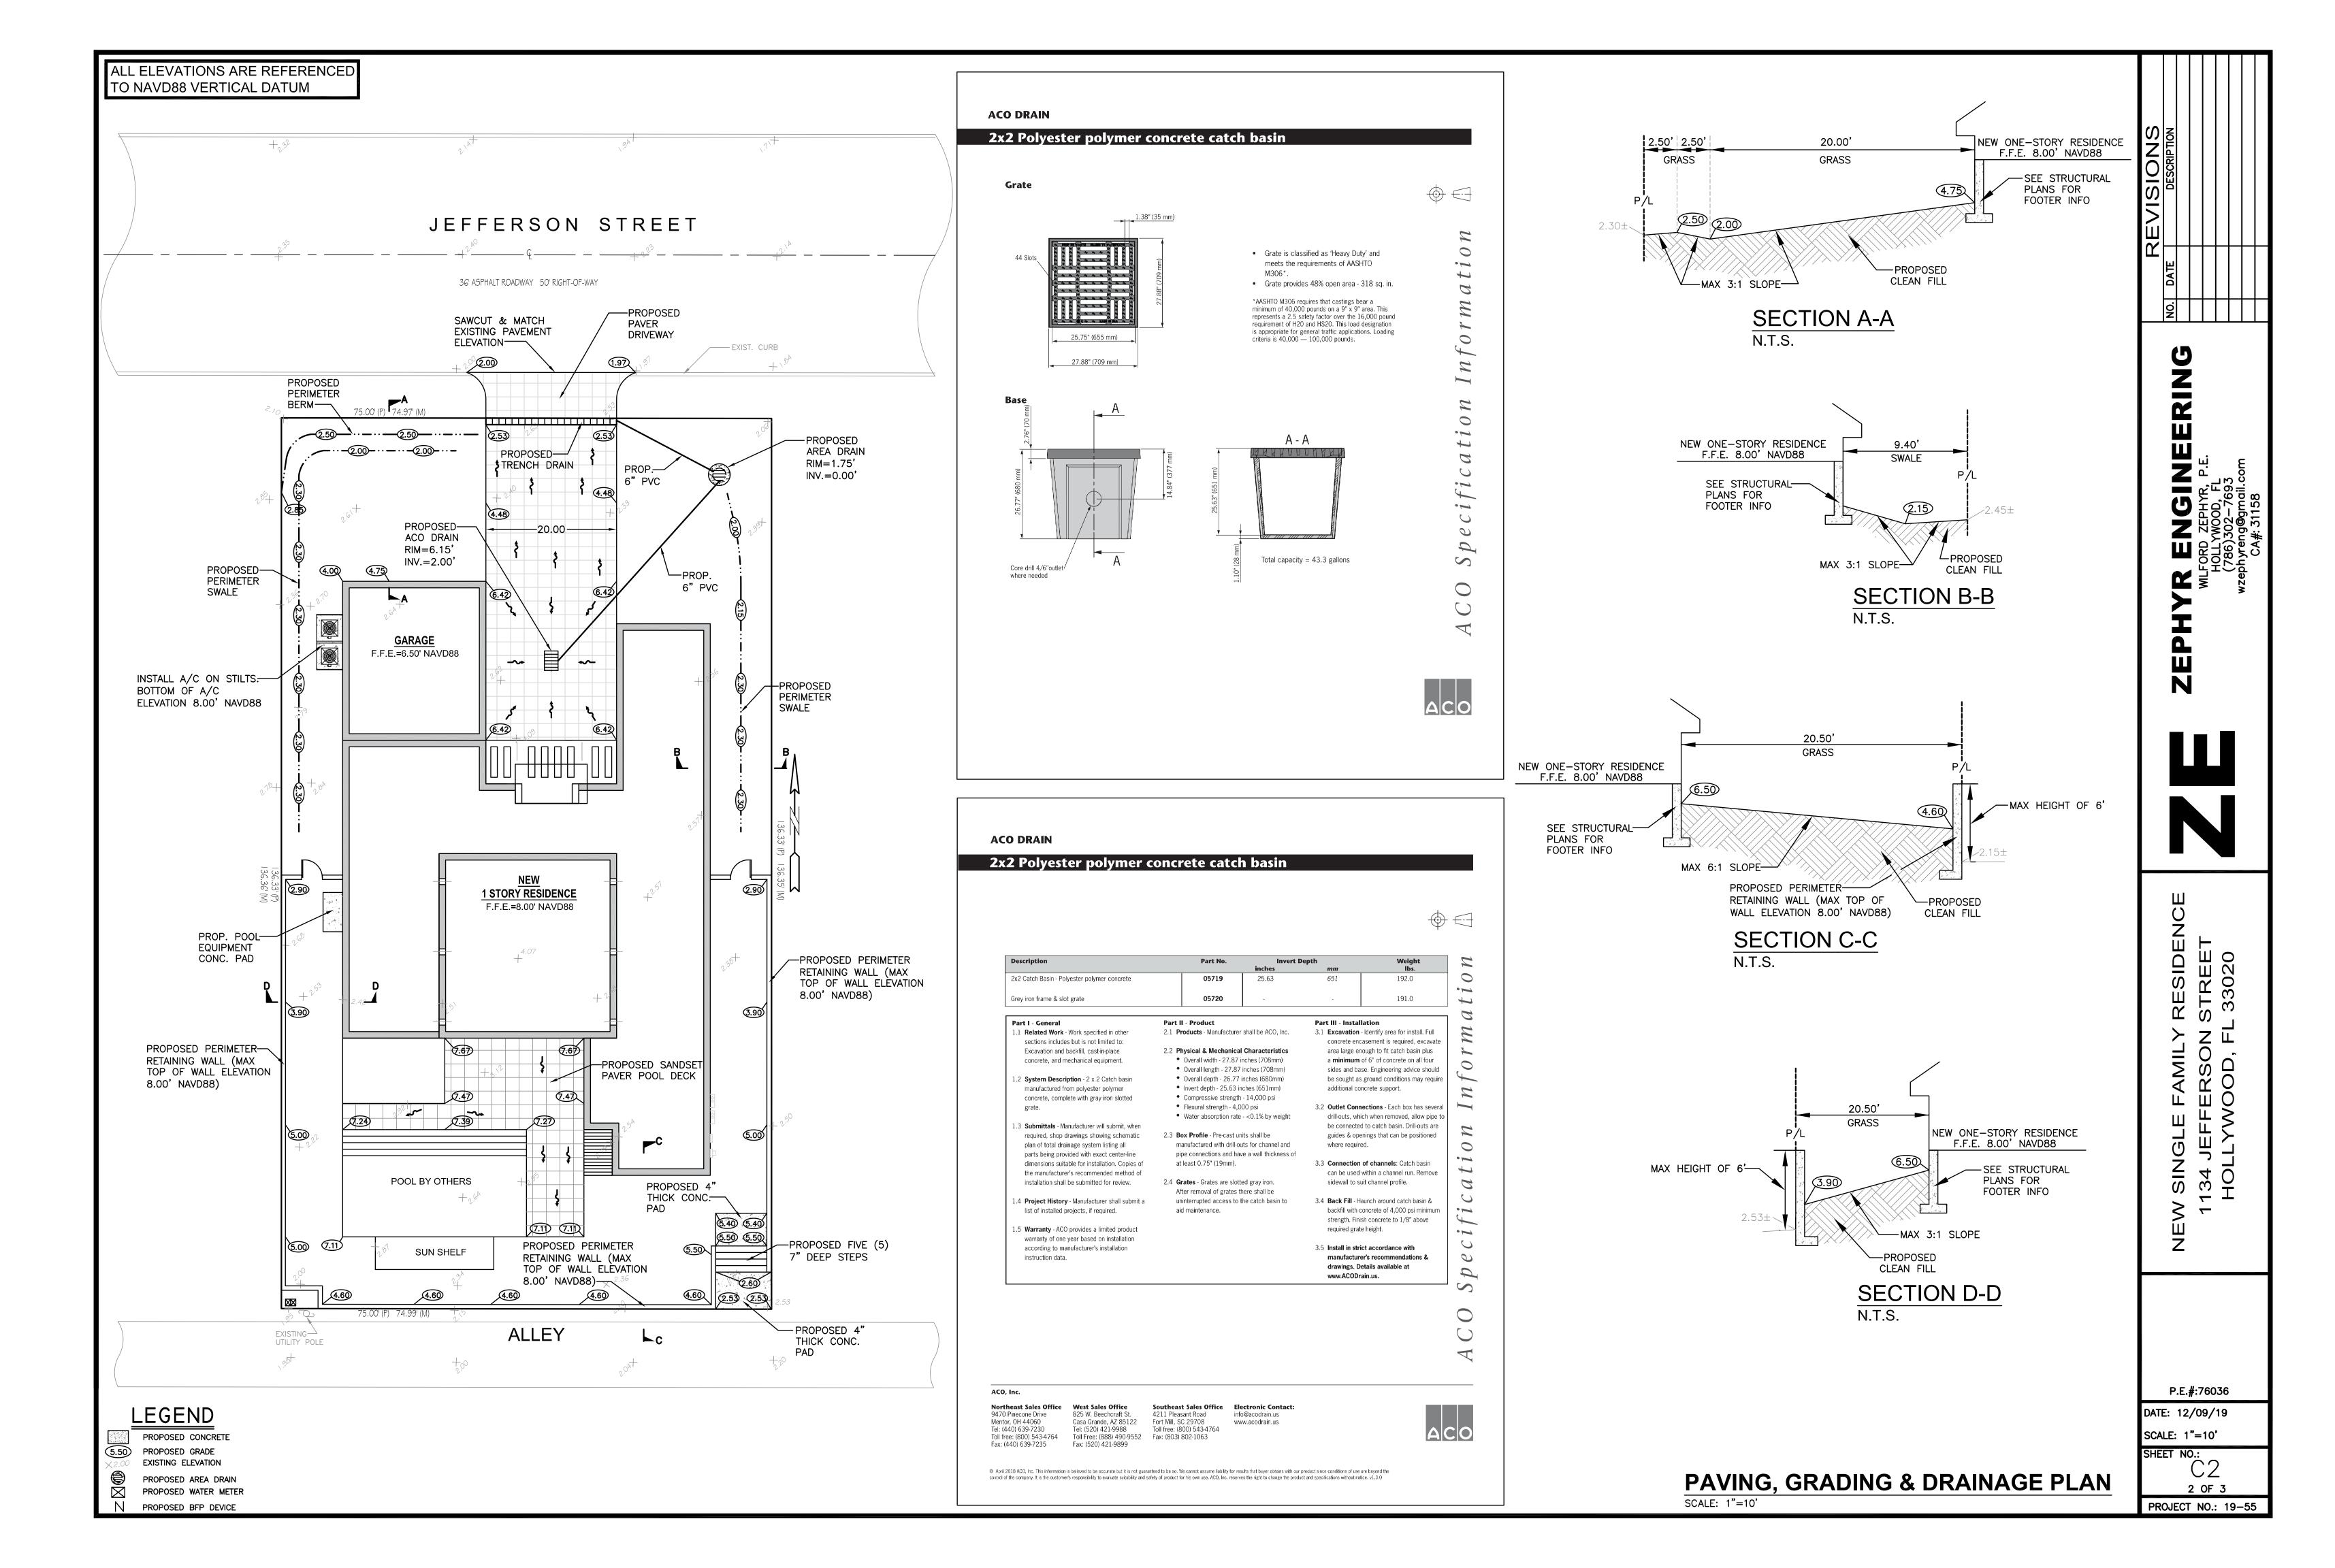
REVISION SCHEDULE DESCRIPTION


1 |12.12.19 | PERMIT SUBMITTAL


TITLE SHEET

SHEET TITLE



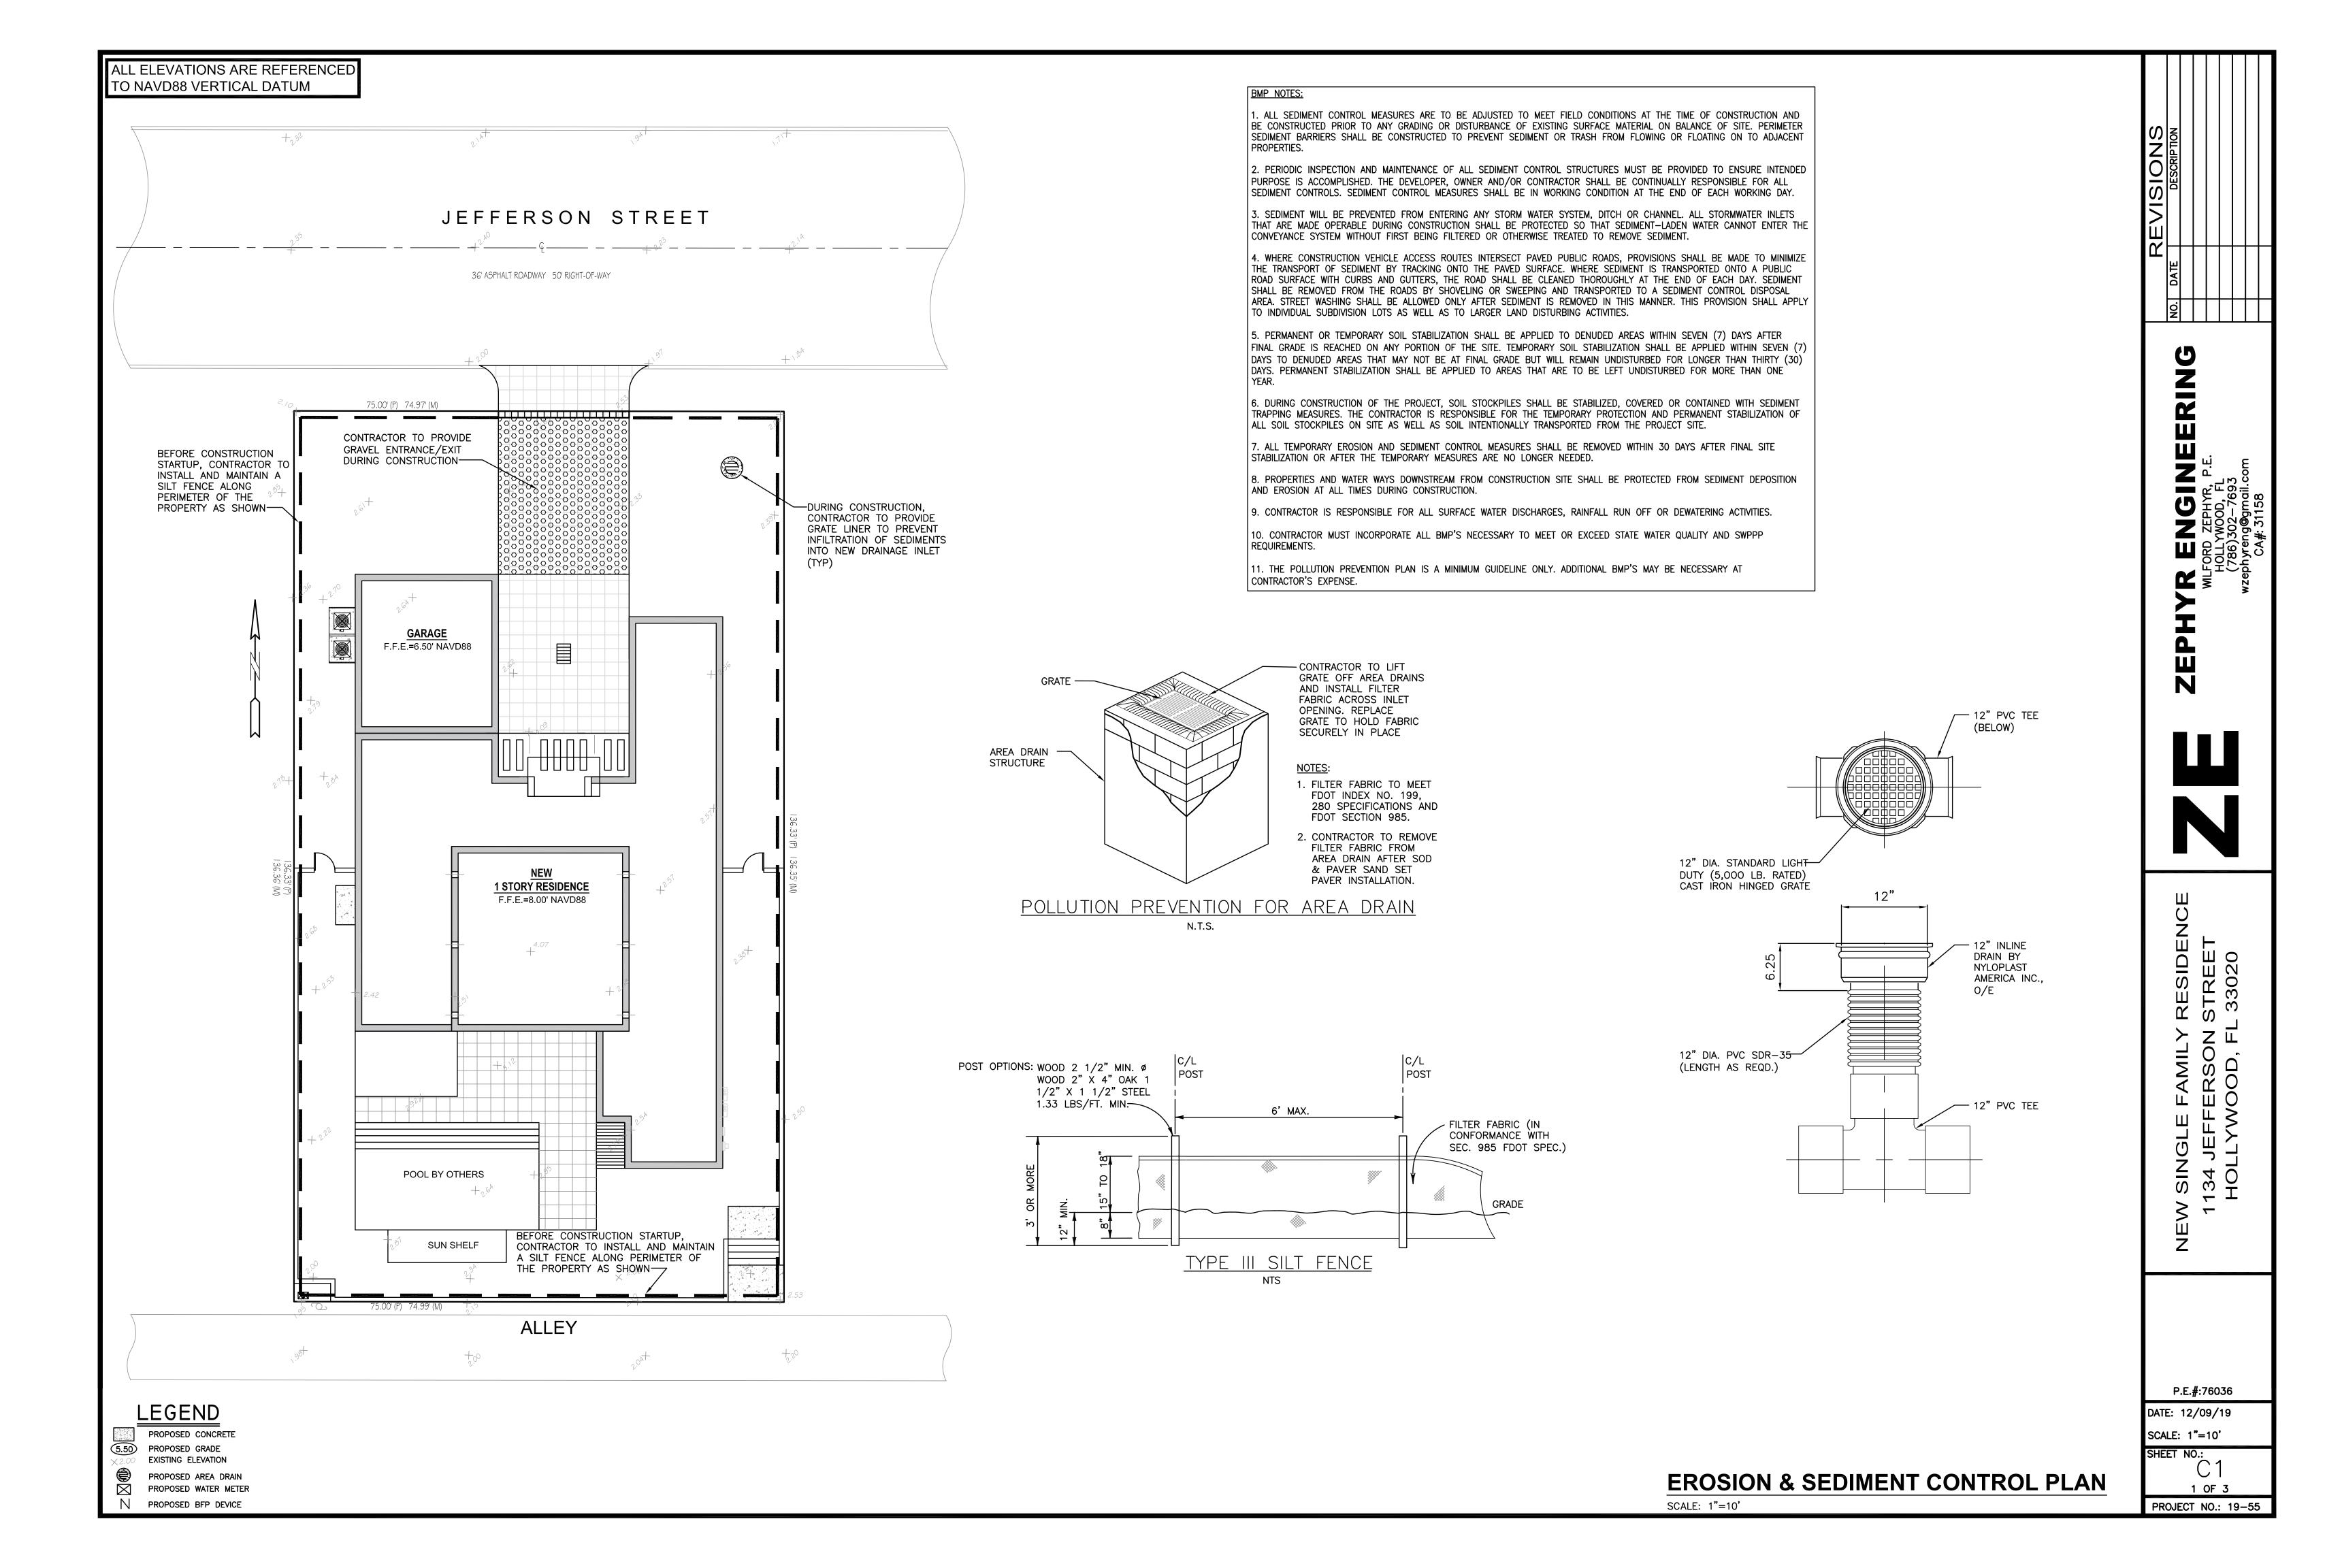

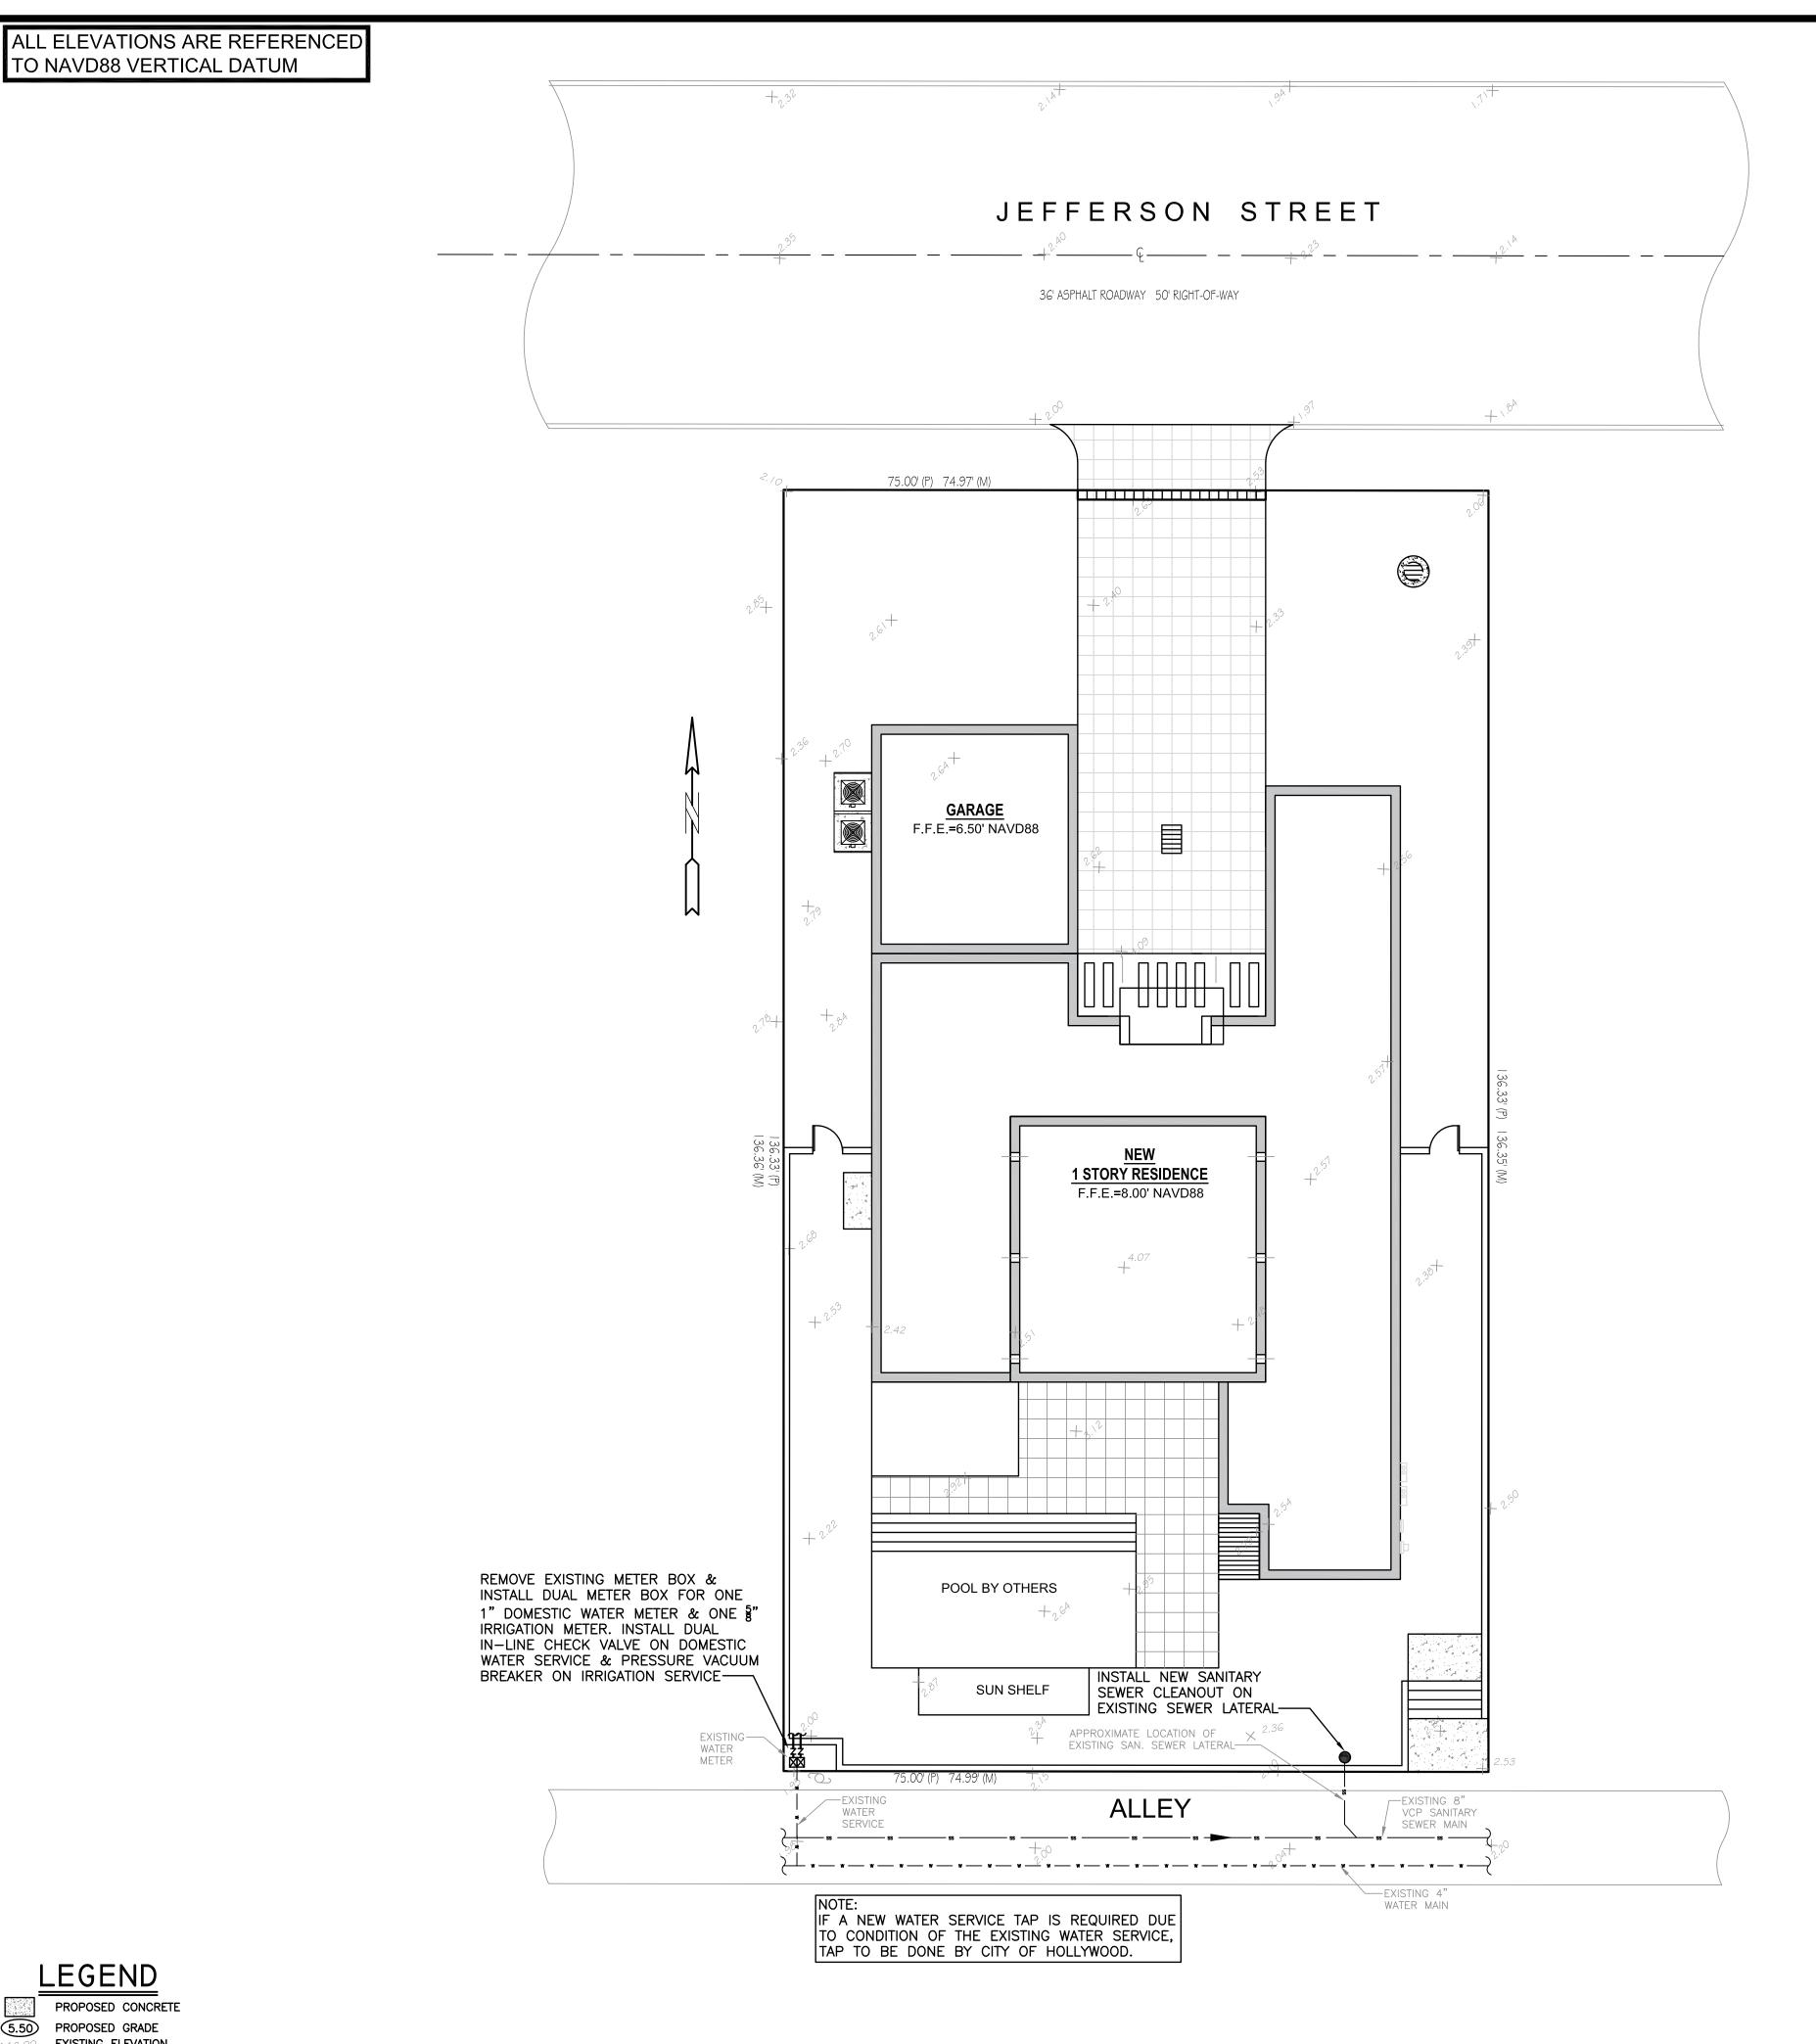

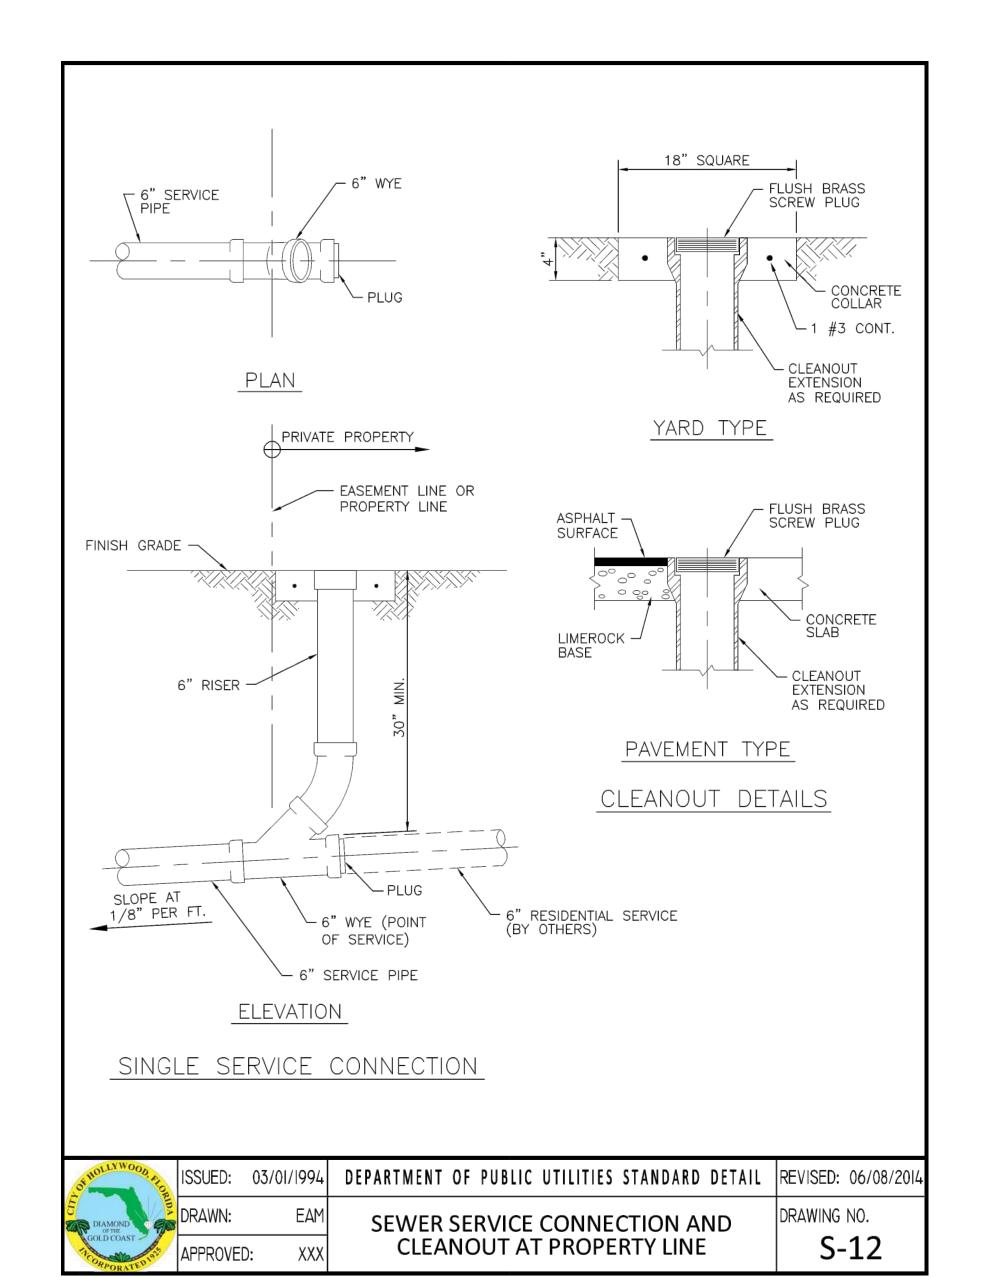

GINEERING PHYR, P.E. ZEPHY

P.E.#:76036

DATE: 12/09/19 SCALE: 1"=10'


3 OF 3 PROJECT NO.: 19-55

WATER & SEWER PLAN & DETAILS

SCALE: 1"=10'

PROPOSED WATER METER

PROPOSED BFP DEVICE

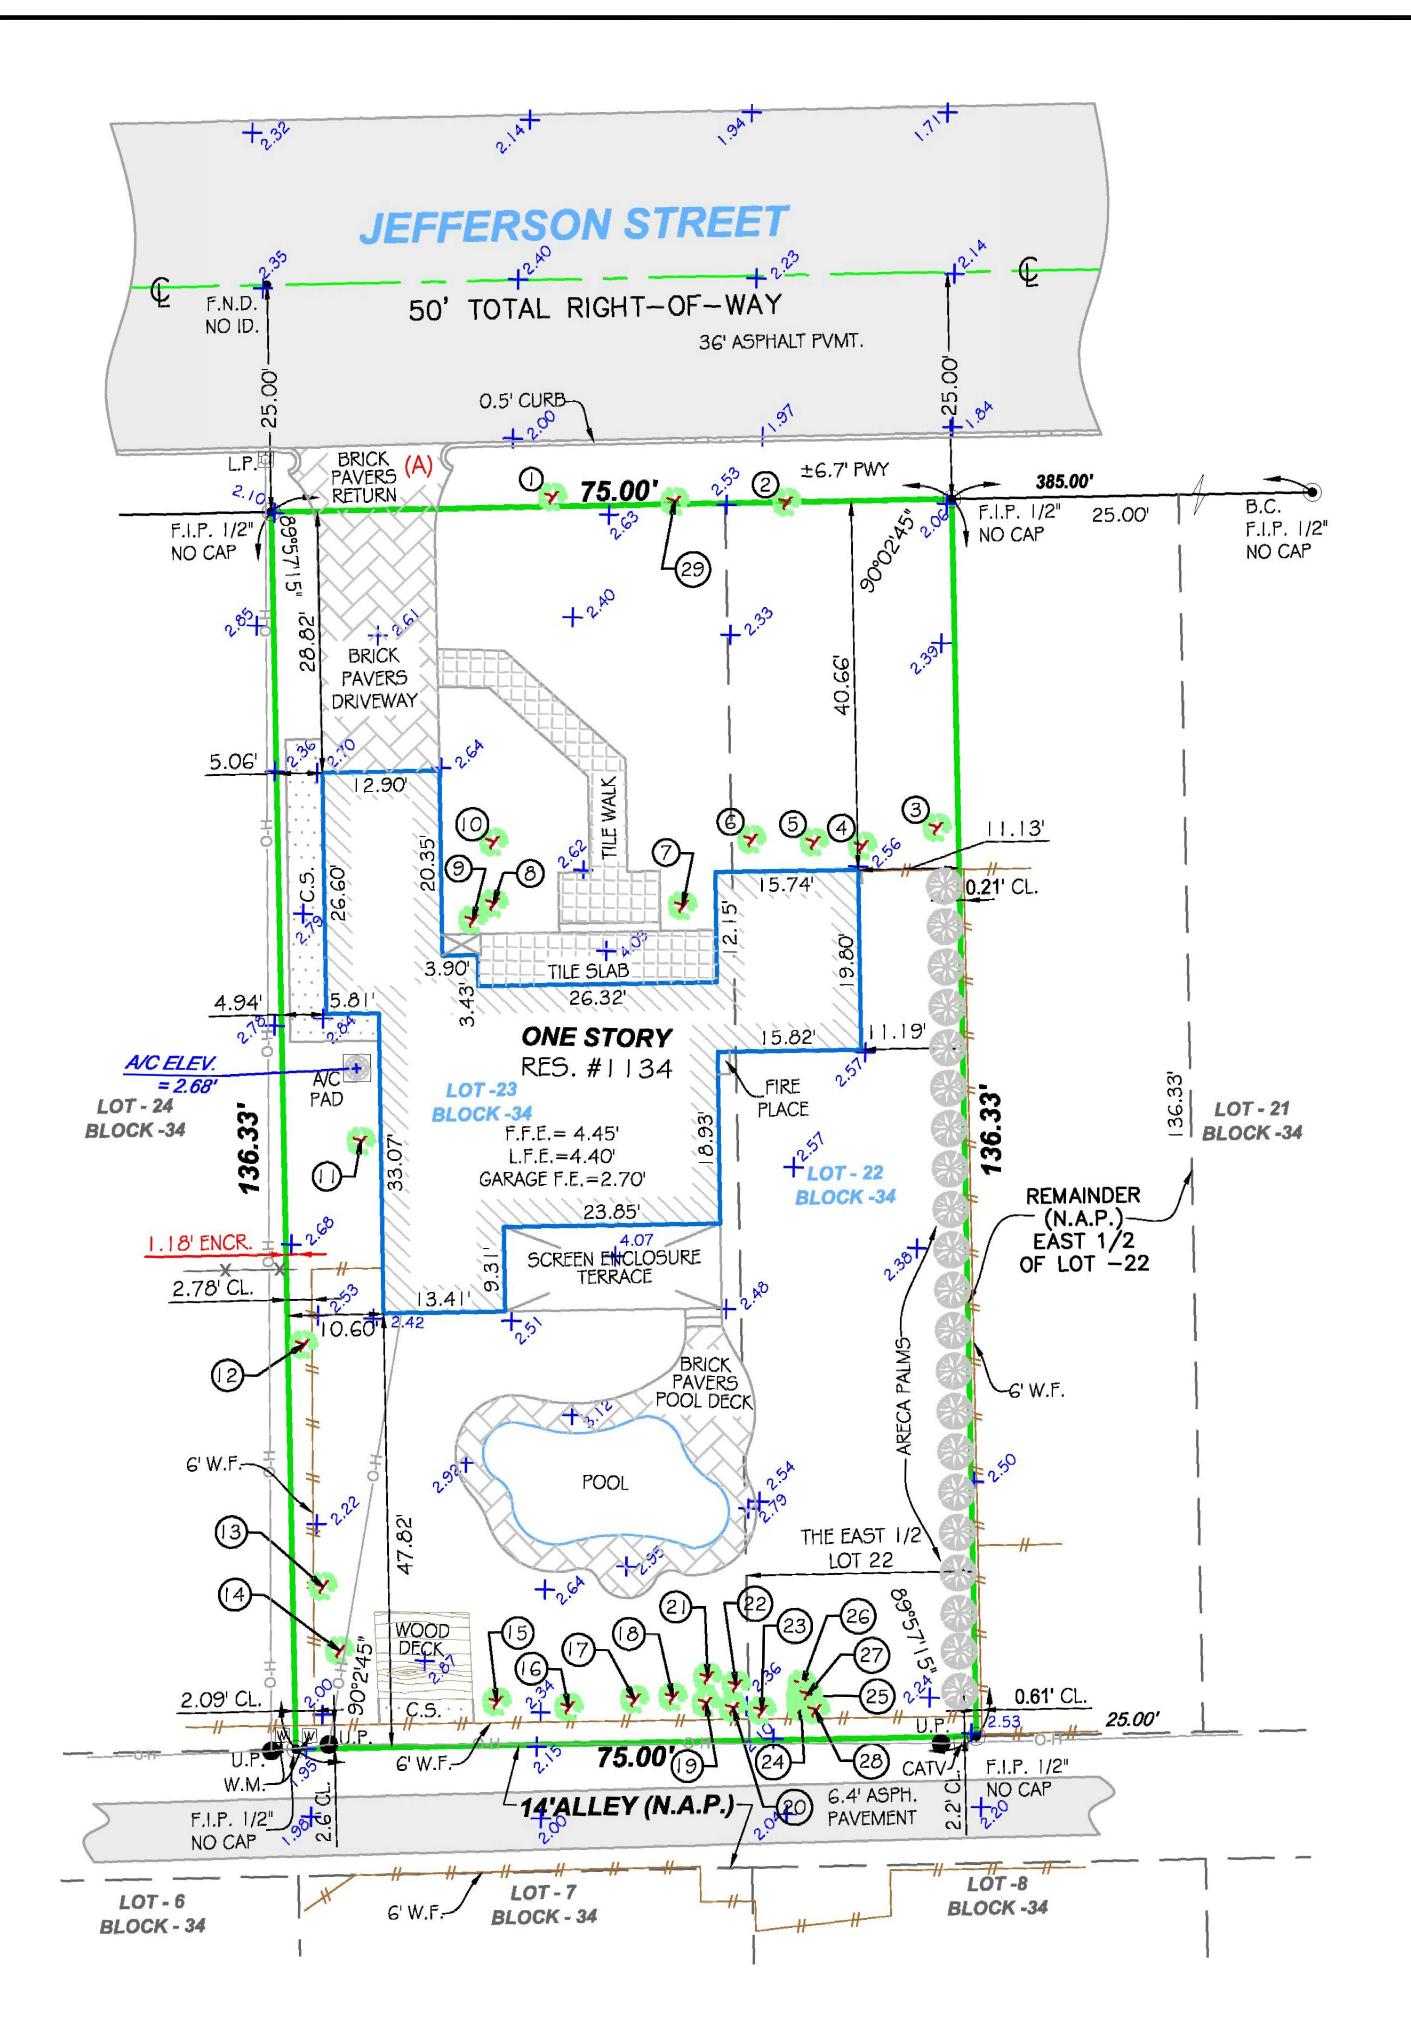

TREE TABLE					
No.	Name	Diameter (Ft.)	Height (Ft.)	Spread (Ft.)	
Ţ	PALM	1.20	25	17	RELOCATED
2	PALM	1.40	25	17	RELOCATED
3	PALM	1.20	25	17	REMOVE
4	ARECA PALM	2.00	22	15	REMOVE
5	ARECA PALM	2.00	22	15	REMOVE
6	PALM (3)	0.40	14	12	REMOVE
7	PALM (3)	0.40	14	12	REMOVE
රි	PALM (3)	0.40	14	12	REMOVE
9	PALM (2)	0.40	20	10	REMOVE
10	PALM	0.30	17	8	REMOVE
11	PALM (4)	0.40	25	13	REMOVE
12	UNKNOWN	0.50	13	15	REMOVE
13	PALM	1.40	50	15	REMOVE
14	PALM	0.25	25	8	REMOVE
15	PALM (4) GROUP	0.25	25	8	REMOVE
16	PALM (4) GROUP	0.30	30	8	REMOVE
17	PALM (4) GROUP	0.30	30	8	REMOVE
18	PALM (2)	0.30	30	8	REMOVE
19	PALM (2)	0.30	20	8	REMOVE
20	PALM	0.30	20	8	REMOVE
21	PALM	0.25	18	6	REMOVE
22	PALM	0.25	18	6	REMOVE
23	PALM	0.25	18	6	REMOVE
24	PALM	0.25	18	6	REMOVE
25	PALM	0.25	18	6	REMOVE
26	PALM	0.25	18	6	REMOVE
27	PALM	0.25	18	6	REMOVE
28	PALM	0.25	18	6	REMOVE
29	PALM	1.20	25	17	RELOCATED

TREE RELOCATION NOTES:

- 1. The contractor shall not unnecessarily damage any other tree or trees remaining on-site while relocating a tree.
- 2. Relocated trees shall not interfere with existing or proposed utilities, both above or below ground. Relocated trees shall not be planted within twenty (20) feet of overhead powerlines.
- 3. The area to receive the relocated tree must have adequate space for root and canopy development.
- 4. Ant tree being relocated shall not be unnecessarily damaged during excavation, transporting, or replanting of that tree.
- 5. If a particular tree species has a dormant period it should be transplanted during the time. Do not transplant any trees during periods of strong dry winter winds, or during periods of drought.
- 6. Prior to transplanting, all trres shall be root and canopy pruned according to sound arboricultural standards. All pruning shall be done in accordance with A.N.S.I. standards.
- 7. The root ball and trunk shall be protected during the relocation process. The root ball shall be kept moist at all times.
- 8. All relocated trees shall be braced for a period of not less than one (1) year.
- 9. All transplanted trees should be fertilized with an appropriate type of fertilizer mix to encourage new root growth (i.e) low in nitrogen and high in other nutrients.
- 10. All transplanted trees shall be watered on a daily basis until tree growth is re-established. This shall include tree saucer two or three times a day. If possible, mist irrigation should also be placed up in the canopy of the trees.
- 11. A tree relocation permit as well as a bond shall be required from the City of Hollywood or Broward County


LANDSCAPE PLANS FOR:

HOLLYWOOD, FLORIDA 33019








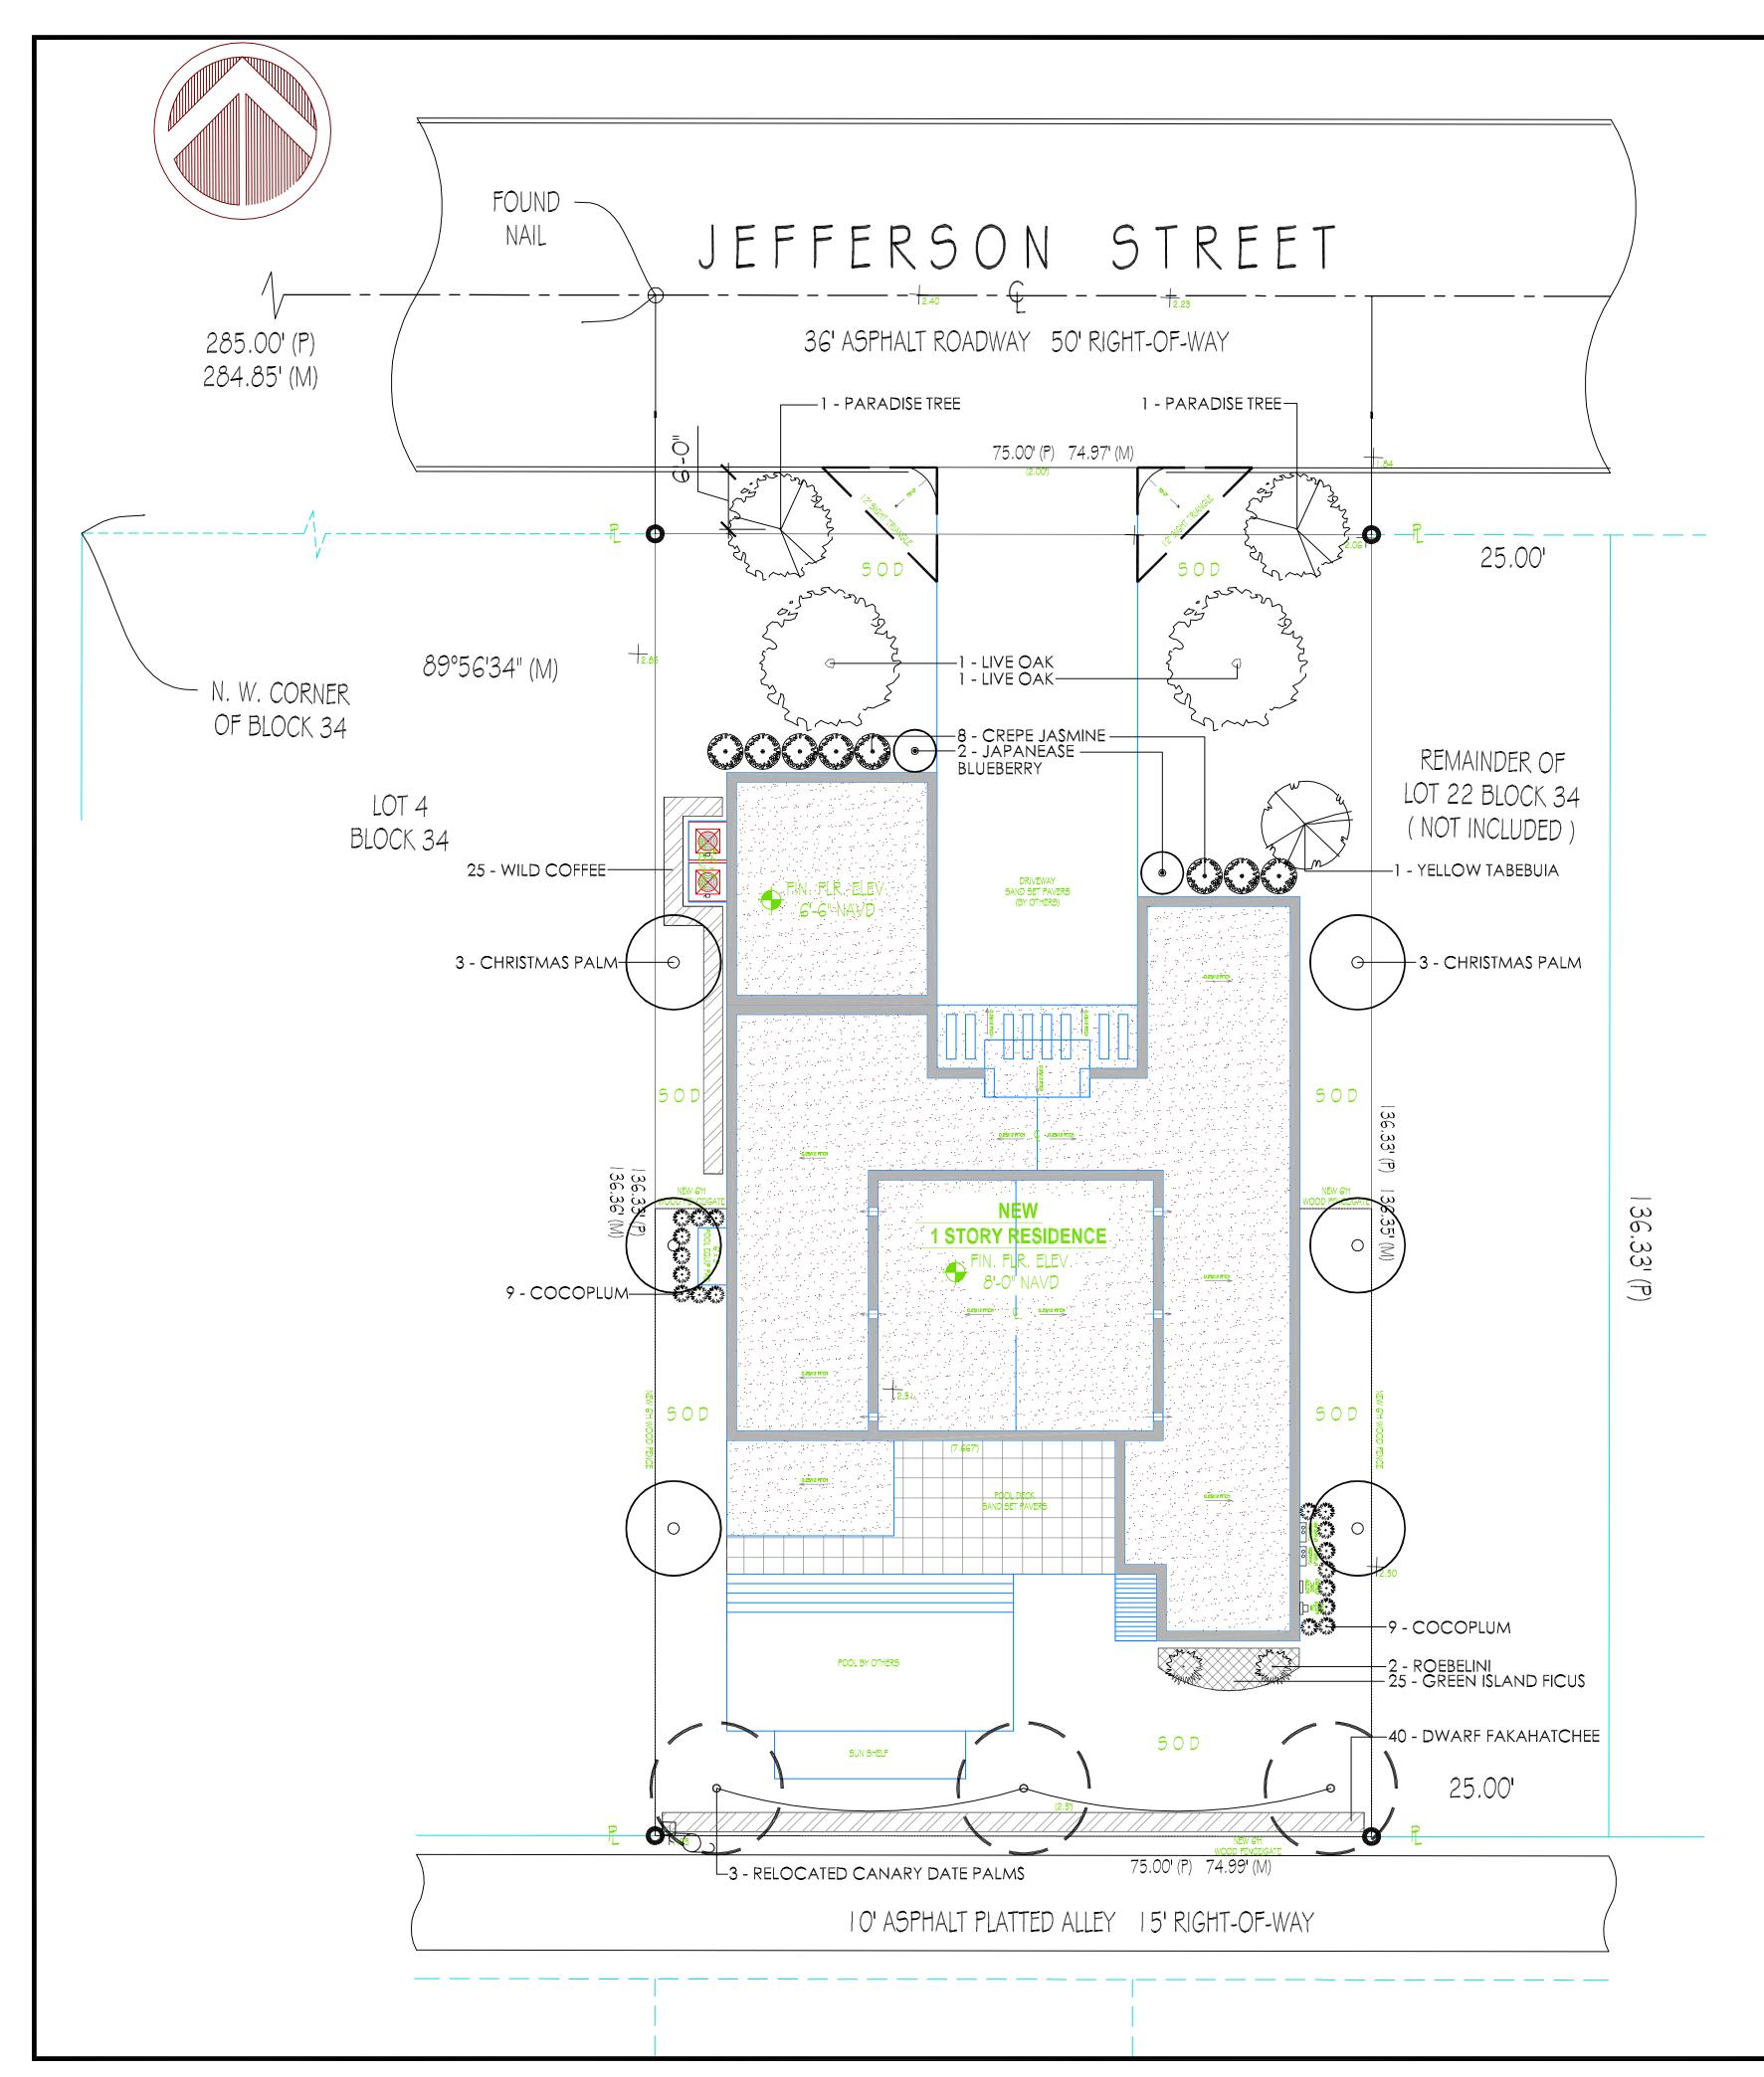

	PLANT LIST				
			** DENOTES NATIVE / DROUGHT TOLERANT		
QTY	BOTANICAL NAME	COMMON NAME	SPECIFICATION		
	TREES				
2	Querceus virginiana **	Live Oak	14' ht. x 7' spr. 3" Cal.		
1	Tabebuia caraiba	Yellow Tabebuia	12' ht. x 6' spr.		
2	Phoenix roebelenii	Pygmy Date Palm	4-5' oa ht, Triple Trunk		
6	Adonidia merrillii	Christmas Palm	6' ct ht., Double Trunk		
2	Simarouba glauca **	Paradise Tree	12' ht. x 6' spr Street/Swale Tree		
3	Phoenix canariensis	Canary Island Date Palm	5' ct ht - Existing to be relocated on site		
	SHRUBS & GROUNDCOVERS				
2	Elaeocarpus decipiens	Japanese Blueberry	7g., 3-4' oa ht., Topiary / Pyramid Full to Base		
40	Tripsacum floridanum **	Dwarf Fakahatchee Grass	3g, 36" o.c.		
8	Tabernaemontana divaricata	Crepe Jasmine	7g., 36" o.c.		
25	Psychotria nervosa **	Wild Coffee	3g., 24" o.c.		
18	Chrysobalanus icaco **	Cocoplum	3g., 24" o.c.		
25	Ficus microcarpa	Green Island Ficus	3g., 24" o.c.		
SOD - 3,258 SF	Stenotaphrum secundatum 'Palmetto'	Palmetto Sod	Weed free, stagger joints		
	7 Trees - 4 Native/Drought Tolerant = 57% Native/Drought Tolerant				
	118 Shrubs/Groundcovers - 83 Native/Drought Tolerant = 70% Native/Drought Tolerant				

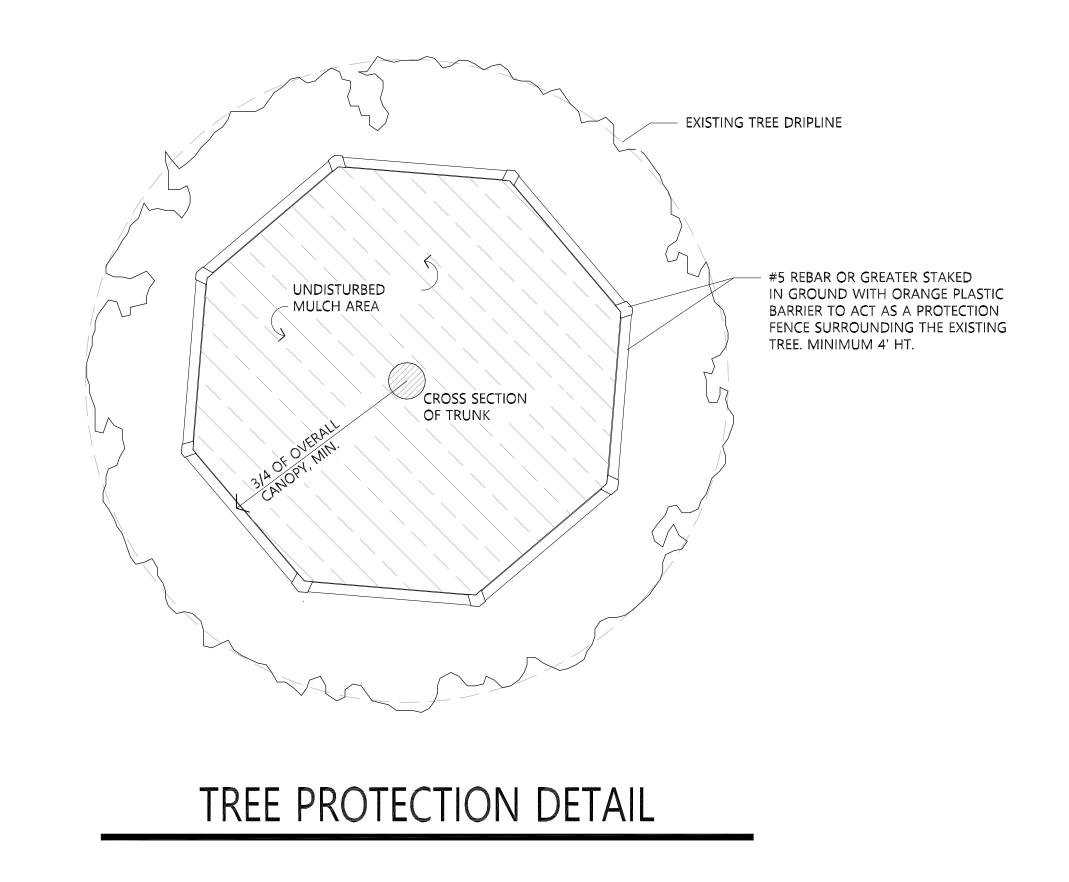



Palmetto Sod 3,258 sf = 79% of 4,105 sf Green Space



LANDSCAPE PLANS FOR: 134 JEFFERSON STREET-


HOLLYWOOD, FLORIDA 33019

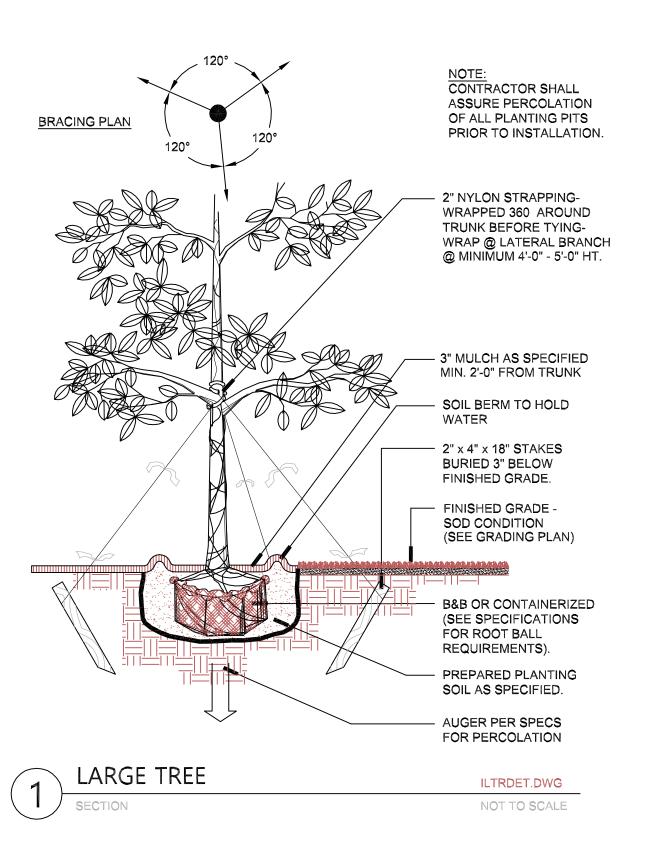

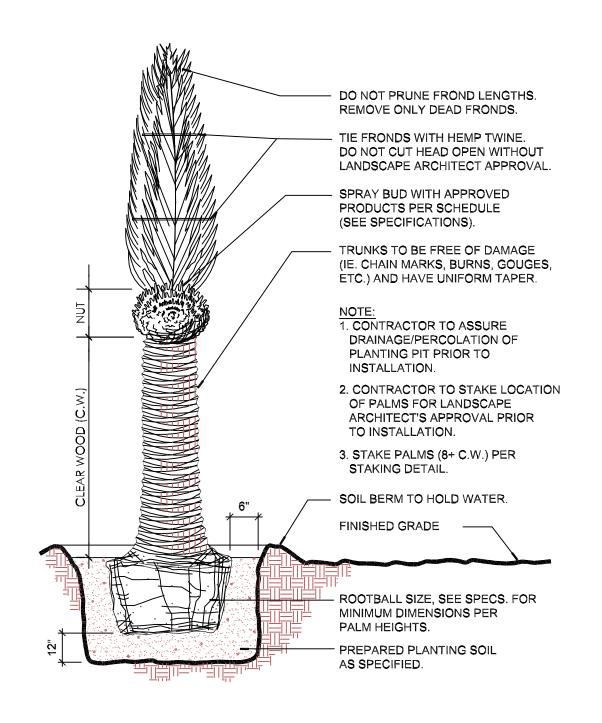

C102A132.DWG

SCALE: 1"=1'-0'

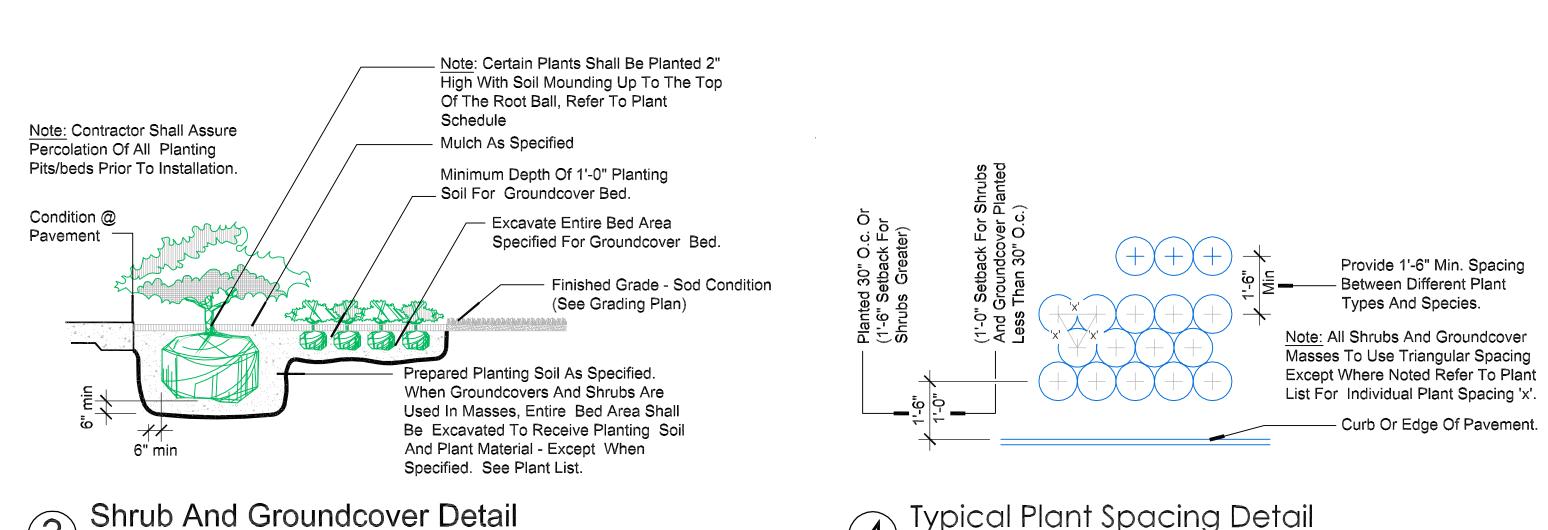

Not To Scale

DATE PALM

LANDSCAPE PLANTING NOTES

- 1. Contractor shall field verify all information prior to initiating planting installation. All existing planting shall remain intact and undisturbed unless otherwise noted on the plans.
- Prior to construction, the Contractor is responsible for locating all underground utilities and shall avoid damage to all utilities during construction. Should the Contractor cause damage to any utilities, he/she shall make necessary repairs as quickly as practicable.
- 3. The Contractor is responsible for maintaining in full all planting areas (including watering, spraying, mulching, mowing, fertilizing, etc.) until the job is accepted, in full, by the Owner and Landscape Architect.
- All plants must be healthy, vigorous material, free of pests and Disease. All plant material shall be in full and strict accordance to Florida No. 1 grade, according to the "Grades and Standards for Nursery Plants", published by the Florida Department of Agriculture and Consumer Services. Plant materials shall in some instances exceed No. 1 grade in order to meet the minimum requirements of this project.
- Contractor shall be responsible for plants meeting specification as noted prior to installation. Contractor shall immediately remove all plant material that does not conform to specifications.
- 6. All container sizes noted on plant list are minimum. Increase size if necessary to conform to plant size and specifications.
- 7. All rootballs shall conform to the size standards set forth in "American Standards for Nursery Stock".
- Contractor to submit to the Landscape Architect the Grower's and/or state inspection certificate for plant material one week before commencement of work.
- Landscape Contractor shall field stake the location of all plant material prior to initiating installation for the review and approval of the Landscape Architect.
- O. Any substitutions in size and/or plant material must be approved by the Landscape Architect. All plants will be subject to approval by Landscape Architect and/or Owner's Representative before planting can begin.
- 11. Contractor shall refer to the landscape planting details, plant list, general notes and the specifications for complete landscape planting instructions.
- 12. Guying / staking practices shall not permit nails, screws, wires etc., to penetrate outer surface of tree or palm. Trees or palms rejected due to this practice shall be replaced with inspector on site.
- 3. Burlap material, wire cages, plastic straps, etc., must be cut and removed from top one half (1/2) of root ball.
- 14. Trees grown in grow bags or grow bag type material must have the grow bag REMOVED ENTIRELY prior to planting.
- 15. All plant material shall be protected during transport and delivery to job site with shade cloth or other acceptable means of windburn prevention.

- 16. All trees must be straight trunked, full headed, and meet all requirements specified.
- 17. All trees must be guyed or staked as shown in the details.
- All plant material shall be installed in a sound, workman-like manner and according to accepted good planting procedures with the quality of plant materials as hereinafter described. All elements of landscaping shall be installed so as to meet all applicable ordinances and code requirements.
- 19. Contractor shall mulch all plant material throughout and completely to a 3" depth with clean, weed free Eucalyptus mulch.
- 20. Contractor shall assure drainage and percolation of all planting pits prior to installation of plant material. Contractor shall fill all tree pits with water before planting to assure that proper drainage and percolation is available. Correct if required to assure percolation. Contractor is responsible for replacement of all plants lost due to inadequate drain- age conditions.
- 21. Contractor to guarantee plant material for a period of 12 months after date of substantial completion. The guarantee begins over for plants replaced during the original guarantee.
- 22. Contractor to request inspection of project in writing. If all work is satisfactory and complete in accordance with conditions of contract documents, then the Owner and Landscape Architect shall declare the project Substantially complete constitutes the beginning of guarantee period.
- 3. Contractor to replace rejected plant material within two(2) weeks of notice.
- 24. Contractor shall remove all staking of trees after 12 months from time of installation.
- 25. Typically, shrub and groundcover plantings are shown as mass planting beds. Plants shall be placed on a triangular spacing configuration (staggered spacing). Plant center to center dimensions (O.C.) are listed under "Specifications" on the plant list.
- 26. Fertilization: All plantings shall be properly fertilized at installation with at least a minimum of 25% organic 6-6-6, time release, with trace elements or better.
- 27. Landscaping shall be maintained in a good condition so as to present a healthy, neat and orderly appearance at least equal to the original installation and shall be mowed or trimmed in a manner and at a frequency so as not to detract from the appearance of the general area.
- 28. Irrigation system shall be automatic with water from municipal or reclaimed source. System shall deliver 100% coverage with 50% overlap, and shall be equipped with an automatic rain shut-off switch, unless otherwise instructed.

SOIL PREPARATION AND SOIL MIX

- 1. Apply Roundup (manufactured by Monsanto Corp.) according to manufacturer's rate and specification within limits of all areas to be planted. Protect existing plants to remain from overspray or spray within root zone. Contractor to ensure total weed oradication.
- 2. Before replacing topsoil, rake subsoil surface clear of stones (1" diameter and larger), debris, rubbish, and remaining roots from removed plant material.
- 3. Scarify subsoil to a depth of three inches(3")
- 4. Contractor to apply "Surflan" or approved pre-emergent herbicide in accordance with manufacturer's rate and specifications.
- Lanscape Contractor shall be responsible for confirming all planting soil types and specifications with Landscape Architect prior to bid. Contractor to submit laboratory soil tests of the soil mixture for approval by Landscape Architect.
- 6. Florida peat shall be free of deleterious materials that would be harmful to plant growth, shall be free of nematodes, shall be of uniform quality and shall have a pH value between 5.3 and 6.5 (as determined in accordance with ASTM E70). Florida peat shall be sterilized to make free of all viable nut grass and other undesirable weeds.
- 7. Topsoil shall be natural, fertile, agricultural soil capable of sustaining vigorous plant growth. It shall be of uniform composition throughout, with admixture of subsoil. It shall be free of stones, lumps, live plants an their roots, sticks, and other extraneous matter. Spread topsoil mixture to minimum depth of 2" through- out all sod areas and 12" in all shrub and groundcover beds. Remove all rocks and other objects over 1" in diameter.
- Smooth all soil mixture to four inches(4") below top of surrounding pavement edges.
- Smooth topsoil mixture to two inches(2") below finish grade in areas to be sodded.
- 10. Topsoil shall not be extremely acid or alkaline, nor contain toxic substances which may be harmful to plant growth. The topsoil pH shall be in the range of pH 5.5 to 6.5. If necessary, the Contractor shall apply the appropriate soil amendments adjusting soil pH to assure a pH range of 5.5 to 6.5.
- 11. Finish grade all topsoil areas to a smooth, even surface, assuring positive drainage away from the structures and eliminate any low areas which may collect water.
- 12. Contractor to remove debris and excess material immediately from iob site.
- 13. Minimum topsoil (approved plant mix) for shrubs and groundcover is 12" depth.
- 14. The contractor shall bear all costs of testing of soils, amendments, etc. associated with the work and the specifications. Prior to commencement of the landscape planting work the Contractor shall provide complete soil tests to be submitted to the Landscape Architect for approval.

note-no-cuts

48 HOURS BEFORE DIGGING
BROWARD PALM BEACH INDIAN RIVER
ST LUCIE MIAMI-DADE COUNTIES
CALL TOLL FREE

1-800-432-4770
SUNSHINE STATE 1 CALL
UNDERGROUND UTILITIES
NOTIFICATION CENTER



1421 CORAL RIDGE DRIVE FORT LAUDERDALE, FL 33304 954-461-6191 PHONE




Not To Scale

ZONING DATA TABLE 1134 JEFFERSON STREET ADDRESS OF PROPERTY: HOLLYWOOD, FL 33019 ZONED RS-6 ZONING CLASIFICATION: LAND USE: LOW RESIDENTIAL (LRES) HISTORIC DESIGNATION: HMPRLOD-1 TOTAL LOT AREA 10,225 SQ. FT. = 0.23 ACRESNET LOT AREA 10,225 SQ. FT. = 0.23 ACRESSETBACKS: FRONT YARD 25 FT. 7.5 FT. SIDE YARD 15% OF LOT DEPTH REAR YARD 20.45 FT. NOT TO EXCEED 2 STORIES MAX. BUILDING HEIGHT 30 FT. PERVIOUS AREA: REQUIRED 375 SQ. FT. FRONT YARD 20% OF SETBACK TOTAL YARD 4,090 SQ. FT. 40% OF NET SITE PROVIDED 1,375.63 SQ. FT. 73.36% OF SETBACK OK FRONT YARD 4,203.32 SQ. FT. 41.11% OF NET SITE $\overline{\text{OK}}$ TOTAL YARD BUILDING HEIGHT: MAXIMUM NOT TO EXCEED 2 STORIES **BUILDING HEIGHT** 30 FT. PROVIDED BUILDING HEIGHT 20 FT. OK PARKING REQUIREMENTS: 2 / 1ST 2,000 S.F. + 1 / 500 ADDITIONAL W//MAX OF 5 REQUIRED 3,008.75 SQ. FT. 4 SPACES @ 8.5' X 19' / SPACE PROVIDED 4 SPACES @ 8.5' X 19' / SPACE 3,008.75 SQ. FT. SQUARE FOOTAGE: UNDER A/C FIRST FLOOR 3,008.75 SQ. FT. NON - A/C 535.3 SQ. FT. GARAGE 160.4 SQ. FT. COVERED ENTRY EXT. STORAGE 31.7 SQ. FT. FRONT DRIVEWAY 1,132.6 SQ. FT. 506.6 SQ. FT. POOL DECK 30.3 SQ. FT. EXT. SHOWER DECK **EQUIPMENT PADS** 52.0 SQ. FT. 156.7 SQ. FT. COVERED LANAI FINISHED FLOOR ELEVATION: 7 FT. ZONE 'AE' NAVD BFE FLOOD PANEL XXX PER 4-126 LOWEST FLOOR ELEVATION SHALL BE B.F.E. + 1 FOOT 8 FT. THIS ELEVATION GOVERNS B.F.E. = 7' + 1' =

GENERAL NOTES

- CONSTRUCTION SHALL FOLLOW THE FLORIDA BUILDING CODE, LATEST EDITION, AS ADOPTED BY THE COUNTY AS APPLICABLE AND ALL APPLICABLE AMENDMENTS.
- BUILDER SHALL COORDINATE ALL THE WORK OF TRADES
- BUILDER SHALL VERIFY ALL DIMENSIONS AND CONDITIONS AT JOBSITE PRIOR TO STARTING ANY WORK, IN WRITING, IMMEDIATELY OR THE BUILDER SHALL ACCEPT FULL RESPONSIBILITY FOR ANY ERRORS, WHETHER ERRORS OR COMMISSIONS OR OMISSION. DO NOT SCALE DRAWINGS.
- SUBMIT A MINIMUM OF THREE (3) COPIES OF SHOP DRAWINGS AS REQUIRED BELOW.
- THESE PLANS, AS DRAWN AND NOTED, COMPLY WITH THE BUILDING ENVELOPE ENERGY REQUIREMENTS OF THE FLORIDA MODEL ENERGY GOVERNING CODE. CONTRACTOR SHALL FAMILIARIZE HIMSELF WITH THE GOVERNING CODE, IN ITS ENTIRETY, AND BUILD IN ACCORDANCE WITH ALL PROVISIONS OF THIS CODE WHICH MAY SPECIFICALLY ADDRESSED ON THE PLANS AND NOTES.
- BUILDER IS RESPONSIBLE FOR ADEQUATE BRACING OF STRUCTURAL OR NON-STRUCTURAL MEMBERS DURING CONSTRUCTION.
- CABINET SUPPLIER TO PROVIDE SHOP DRAWINGS TO THE BUILDER.
- 8. WINDOW AND DOOR SUPPLIER TO PROVIDE SHOP DRAWINGS TO THE BUILDER.
- ALL STRUCTURAL LUMBER TO HAVE FIBER STRESS CAPACITY OF 1200 P.S.I. MINIMUM.
- 10. SHOP DRAWINGS AND DESIGN CALCULATIONS FOR ROOF TRUSSES BEARING THE SIGNATURE AND SEAL OF A FLORIDA REGISTERED ENGINEER SHALL BE SUBMITTED TO THE ARCHITECT FOR APPROVAL PRIOR TO FABRICATION.
- 11. ARCHITECT ACCEPTS NO RESPONSIBILITY FOR STRUCTURAL BEAMS, COLUMNS, AND FOOTINGS UNTIL REVIEW OF APPROVED TRUSS DRAWINGS, SIGNED AND SEALED BY A FLORIDA REGISTERED ENGINEER.

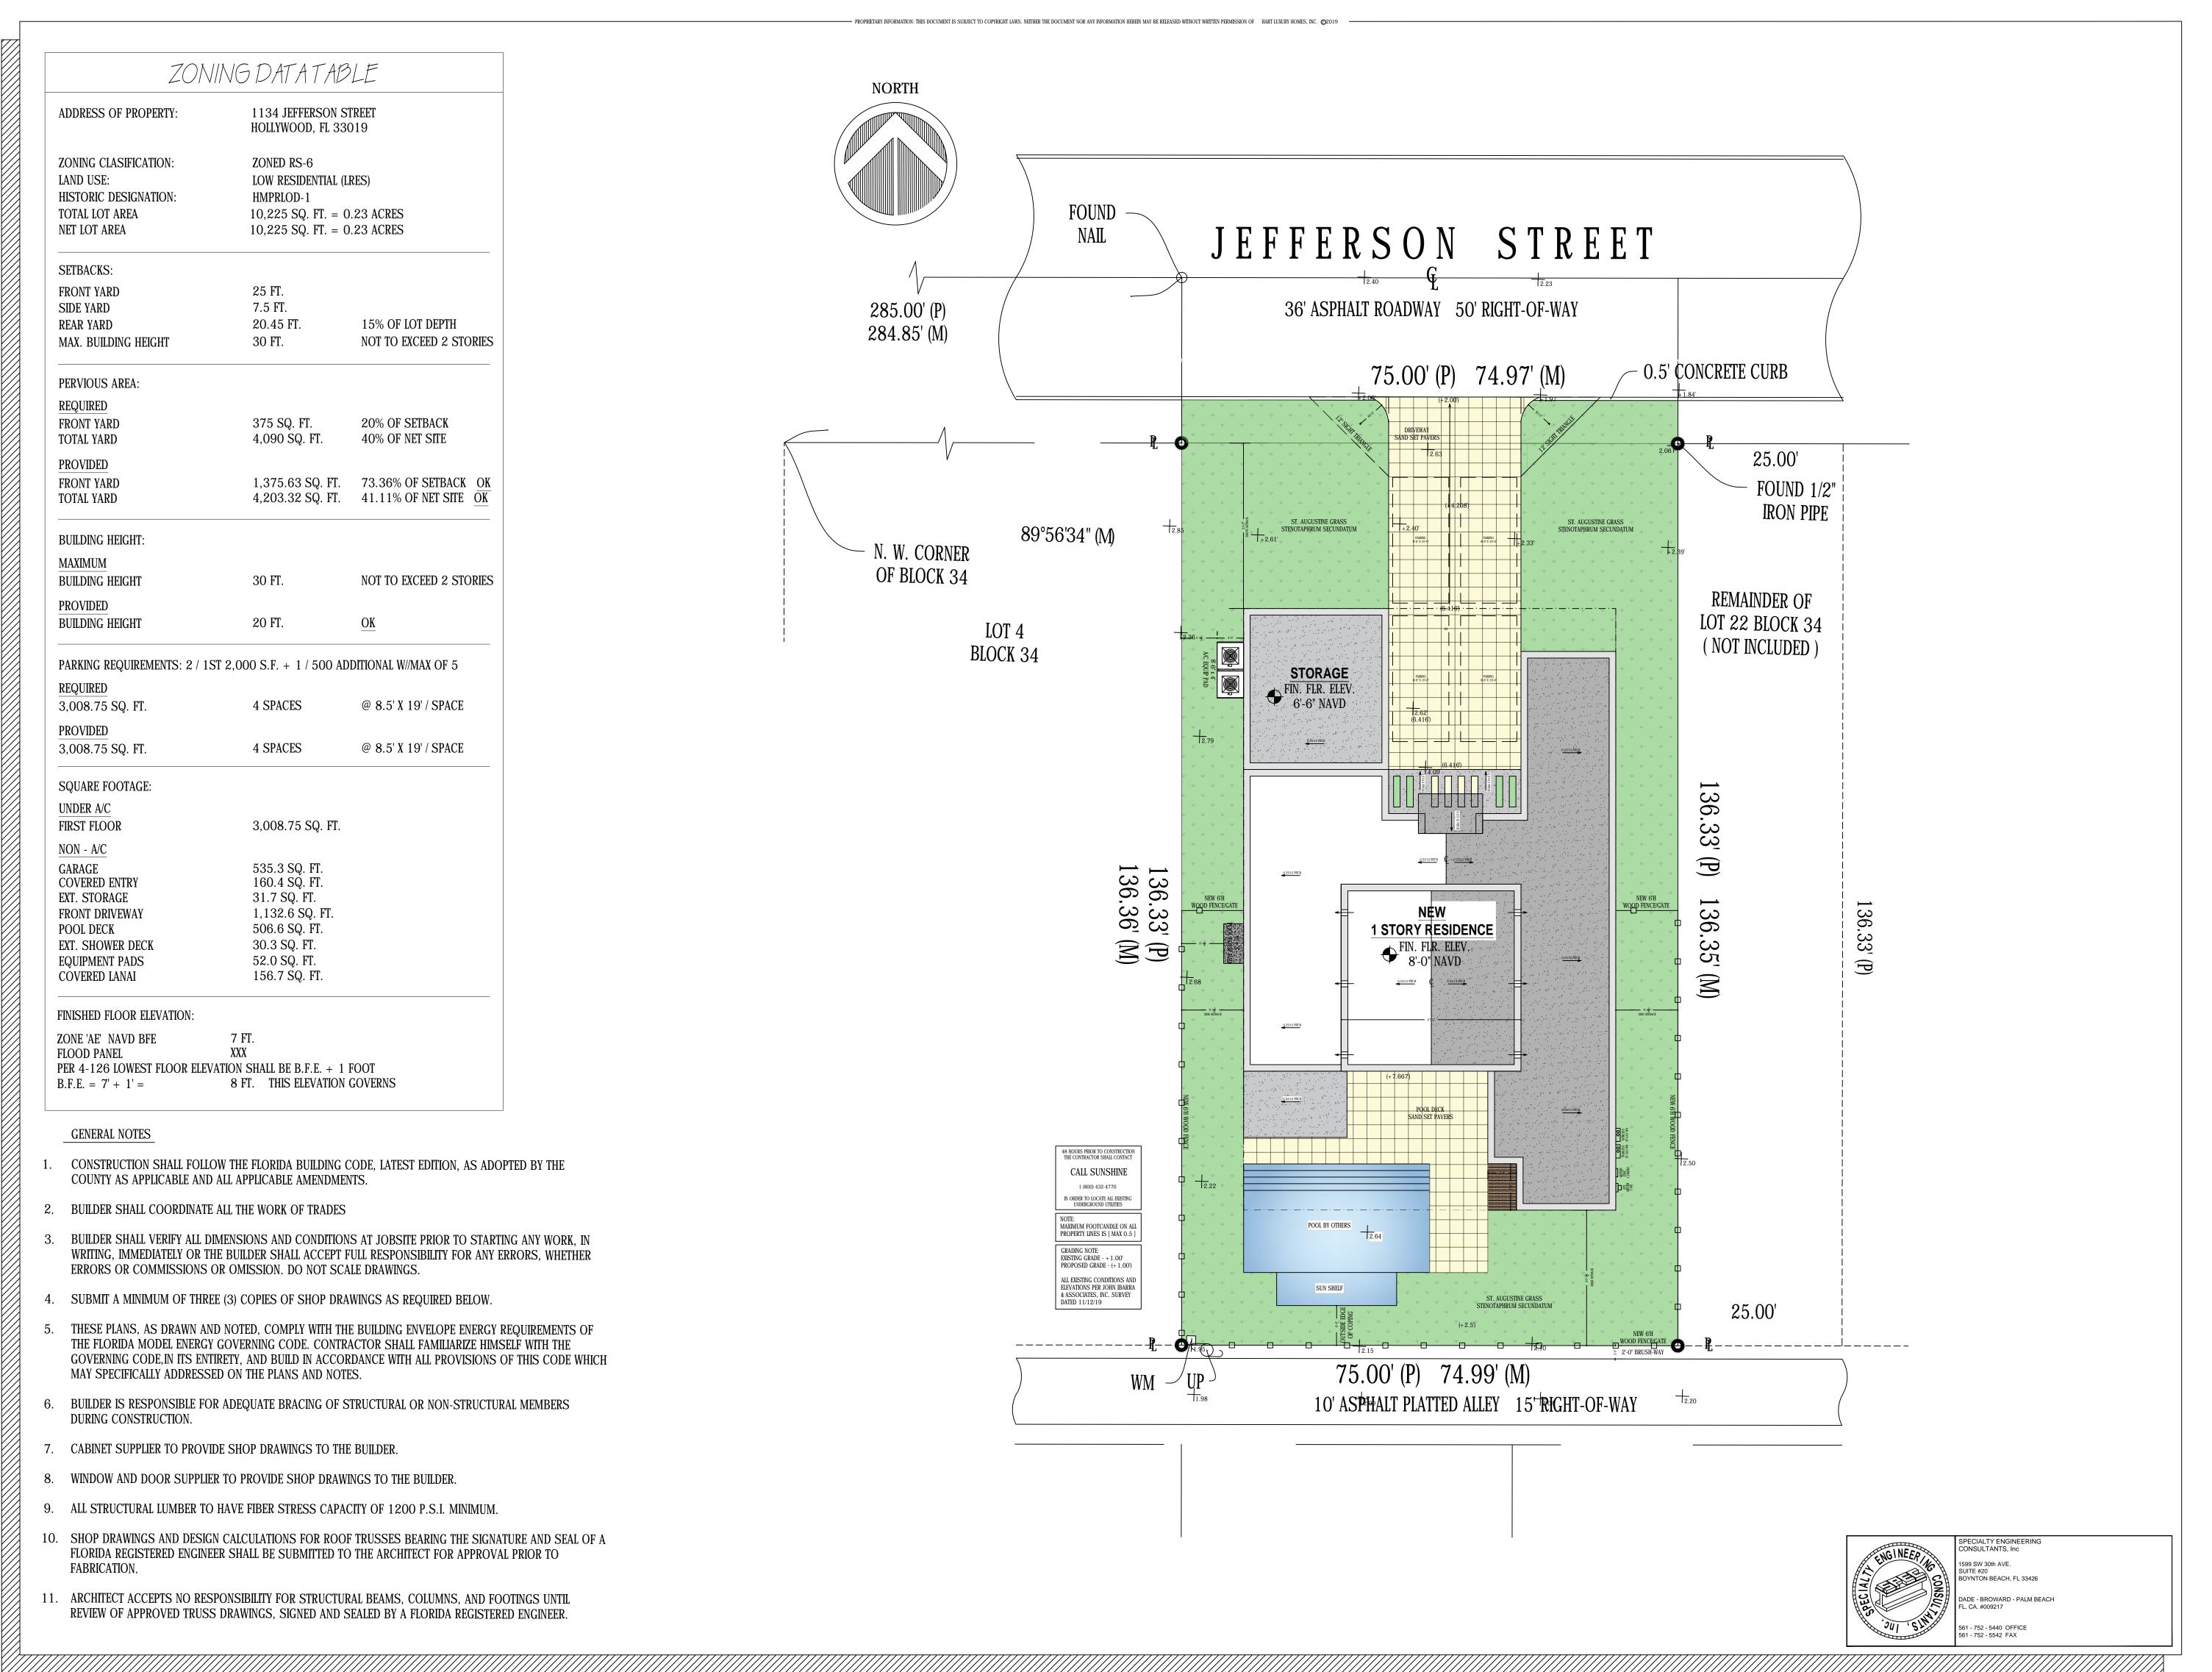



OLIVERIO RESIDENCE

> PROJECT OWNER: JEFFREY OLIVERIO 1134 JEFFERSON STREET HOLLYWOOD, FL 33019

PROJECT LOCATION: 1134 JEFFERSON STREET HOLLYWOOD, FL 33019

PROJECT DATA

5142 14 01 5742

LEGAL DESCRIPTION: HOLLYWOOD LAKES SECTION 1-32 B LOT 22

ZONING CLASIFICATION:

W1/2, 23 BLK 34

LOW RESIDENTIAL (LRES)

HISTORIC DESIGNATION:

SITE SQUARE FOOTAGE: 10,225 S.F.


GARY McDOUGLE, PE FL #56214

PROJECT # | HART1134 3/32'' = 1'-0'' U.N.O.

DRAWN BY | BAS REVISION SCHEDULE DESCRIPTION PERMIT SUBMITTAL 1 |12.12.19

SITE & ROOF PLAN

SHEET TITLE

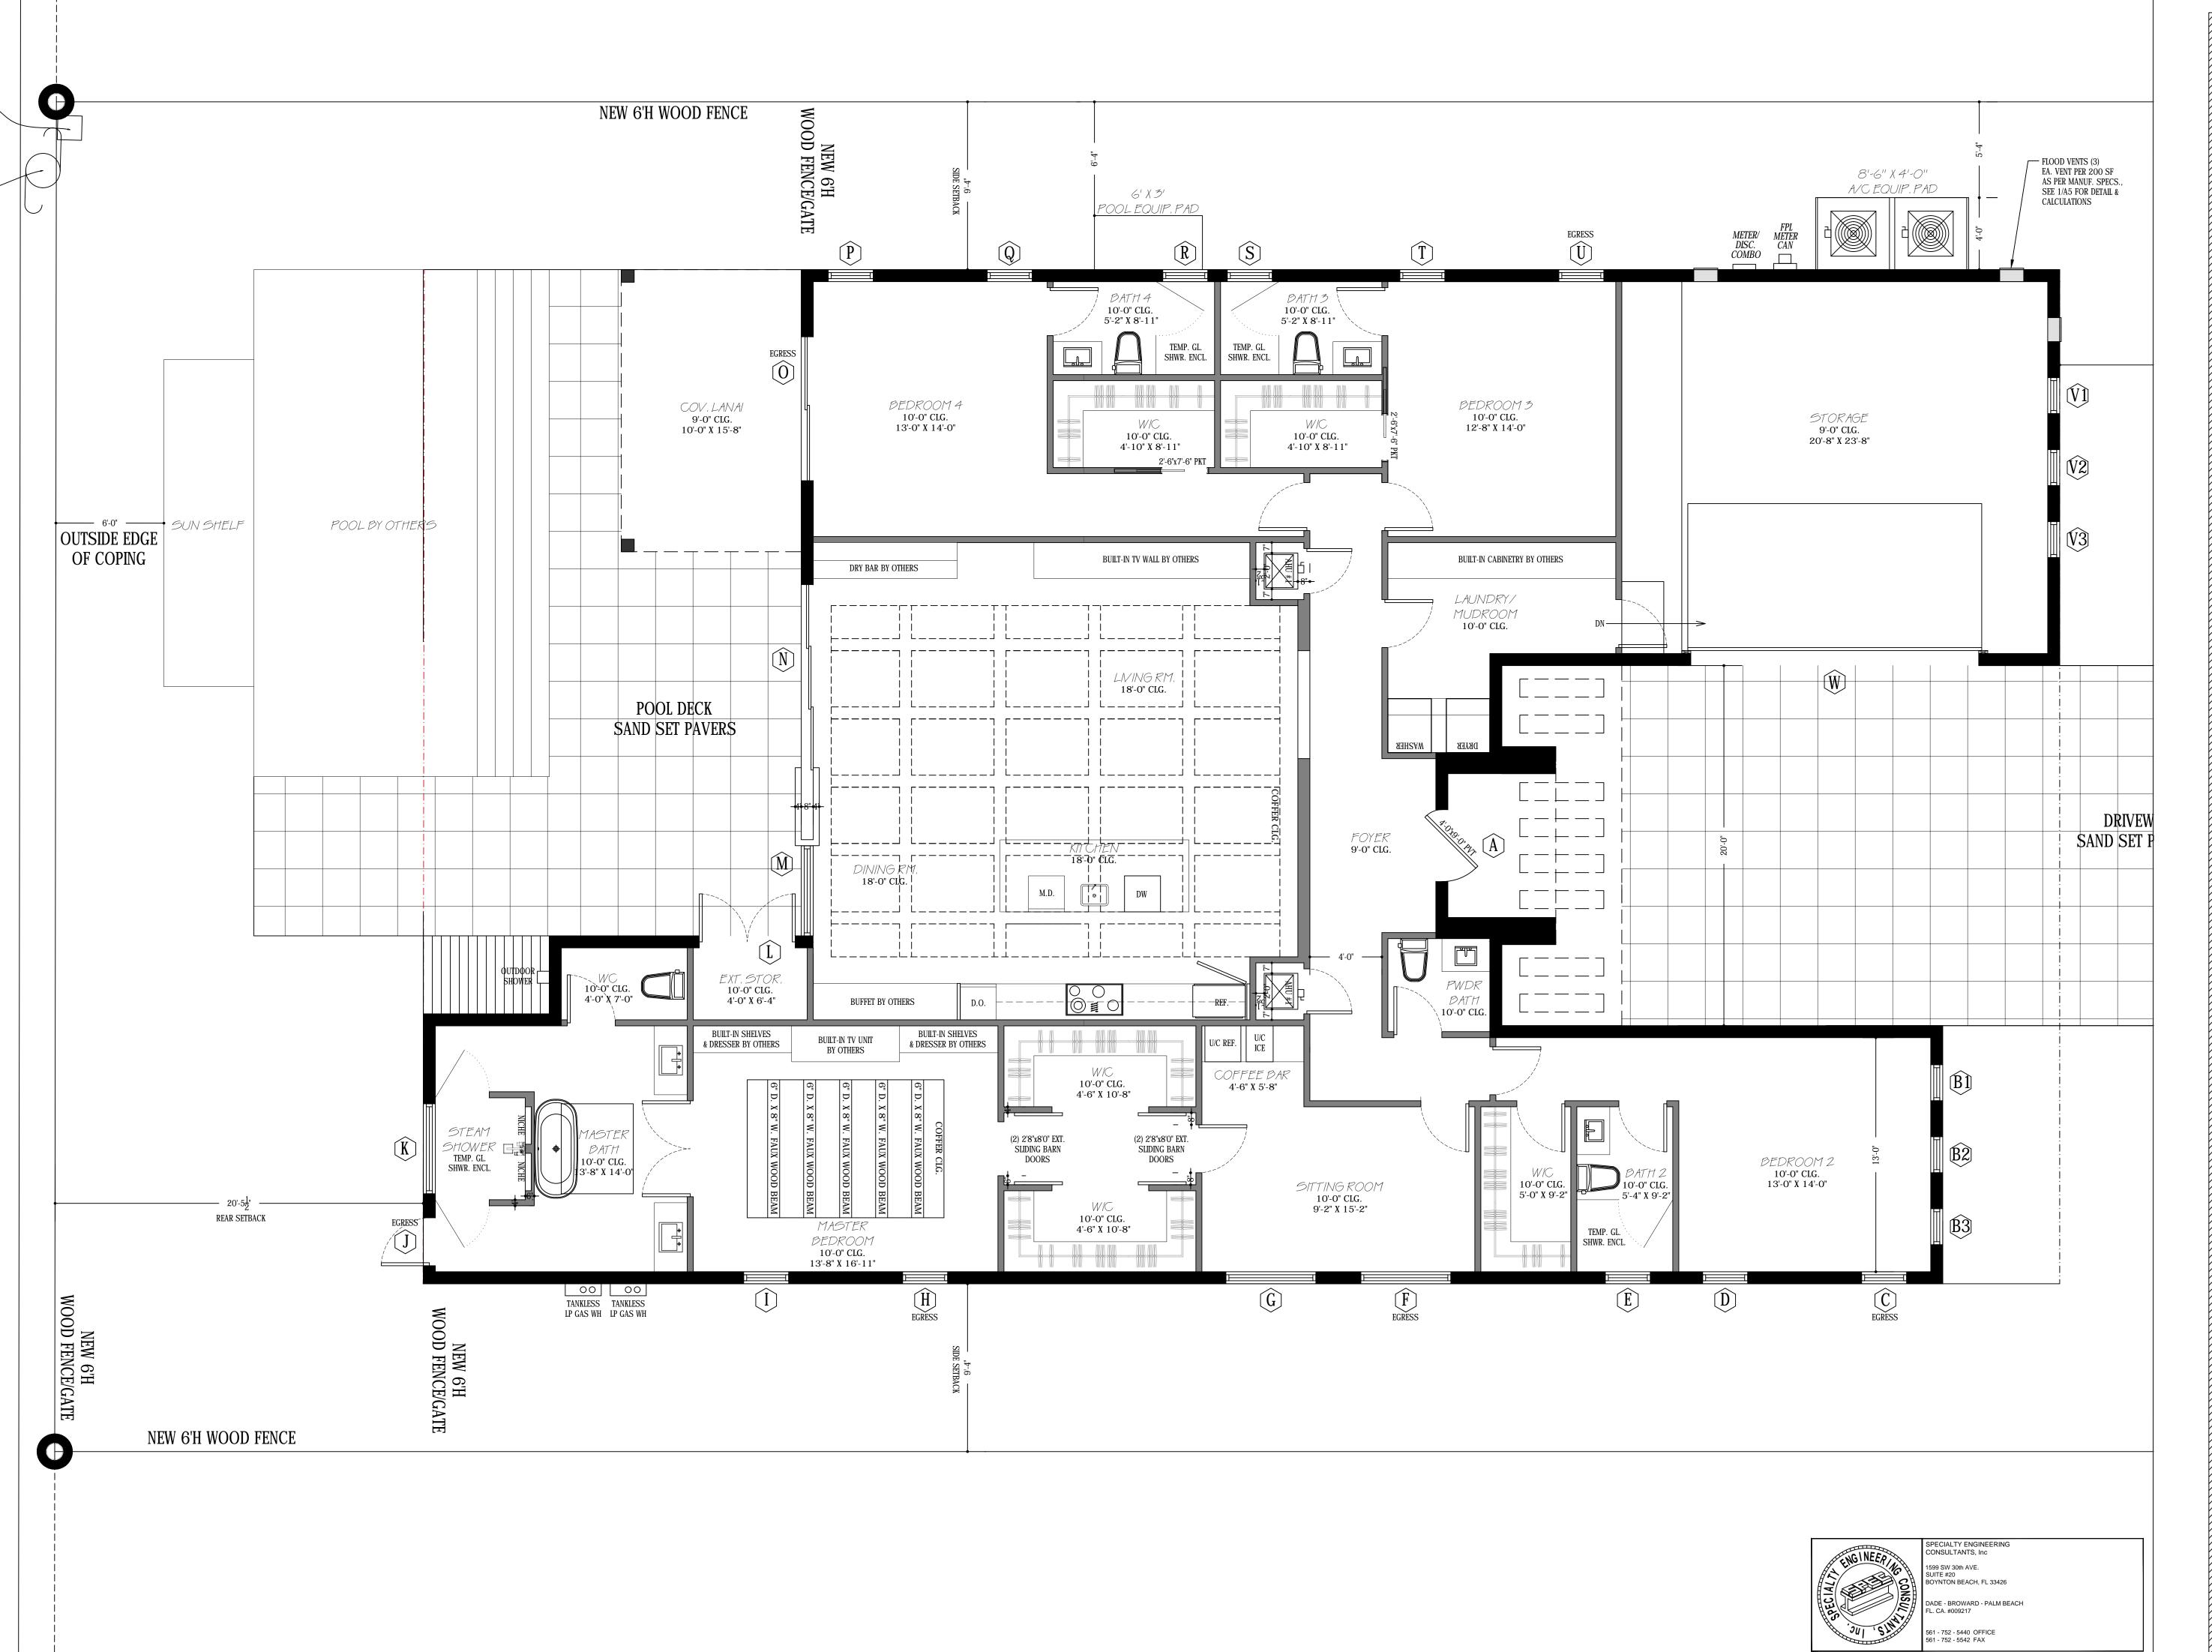

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OLIVERIO RESIDENCE

PROJECT OWNER: JEFFREY OLIVERIO 1134 JEFFERSON STREET HOLLYWOOD, FL 33019

PROJECT LOCATION: 1134 JEFFERSON STREET HOLLYWOOD, FL 33019

PROJECT DATA

FOLIO: 5142 14 01 5742

LEGAL DESCRIPTION: HOLLYWOOD LAKES SECTION 1-32 B LOT 22

ZONING CLASSIFICATION: RS-6

W1/2, 23 BLK 34

LOW RESIDENTIAL (LRES)

HISTORICAL DESIGNATION:

MPRLOD-1

SITE SQUARE FOOTAGE: 10,225 S.F.

SEAL GARY McDOUGLE, PE FL #56214

PROJECT # HART1134 SCALE 1/4" = 1'-0" U.N.O.

DRAWN BY BAS

REVISION SCHEDULE


NO. DATE DESCRIPTION

1 12.12.19 PERMIT SUBMITTAL

FIRST FLOOR & RCP PLAN

SHEET TITLE

A 1
SHEET TITLE

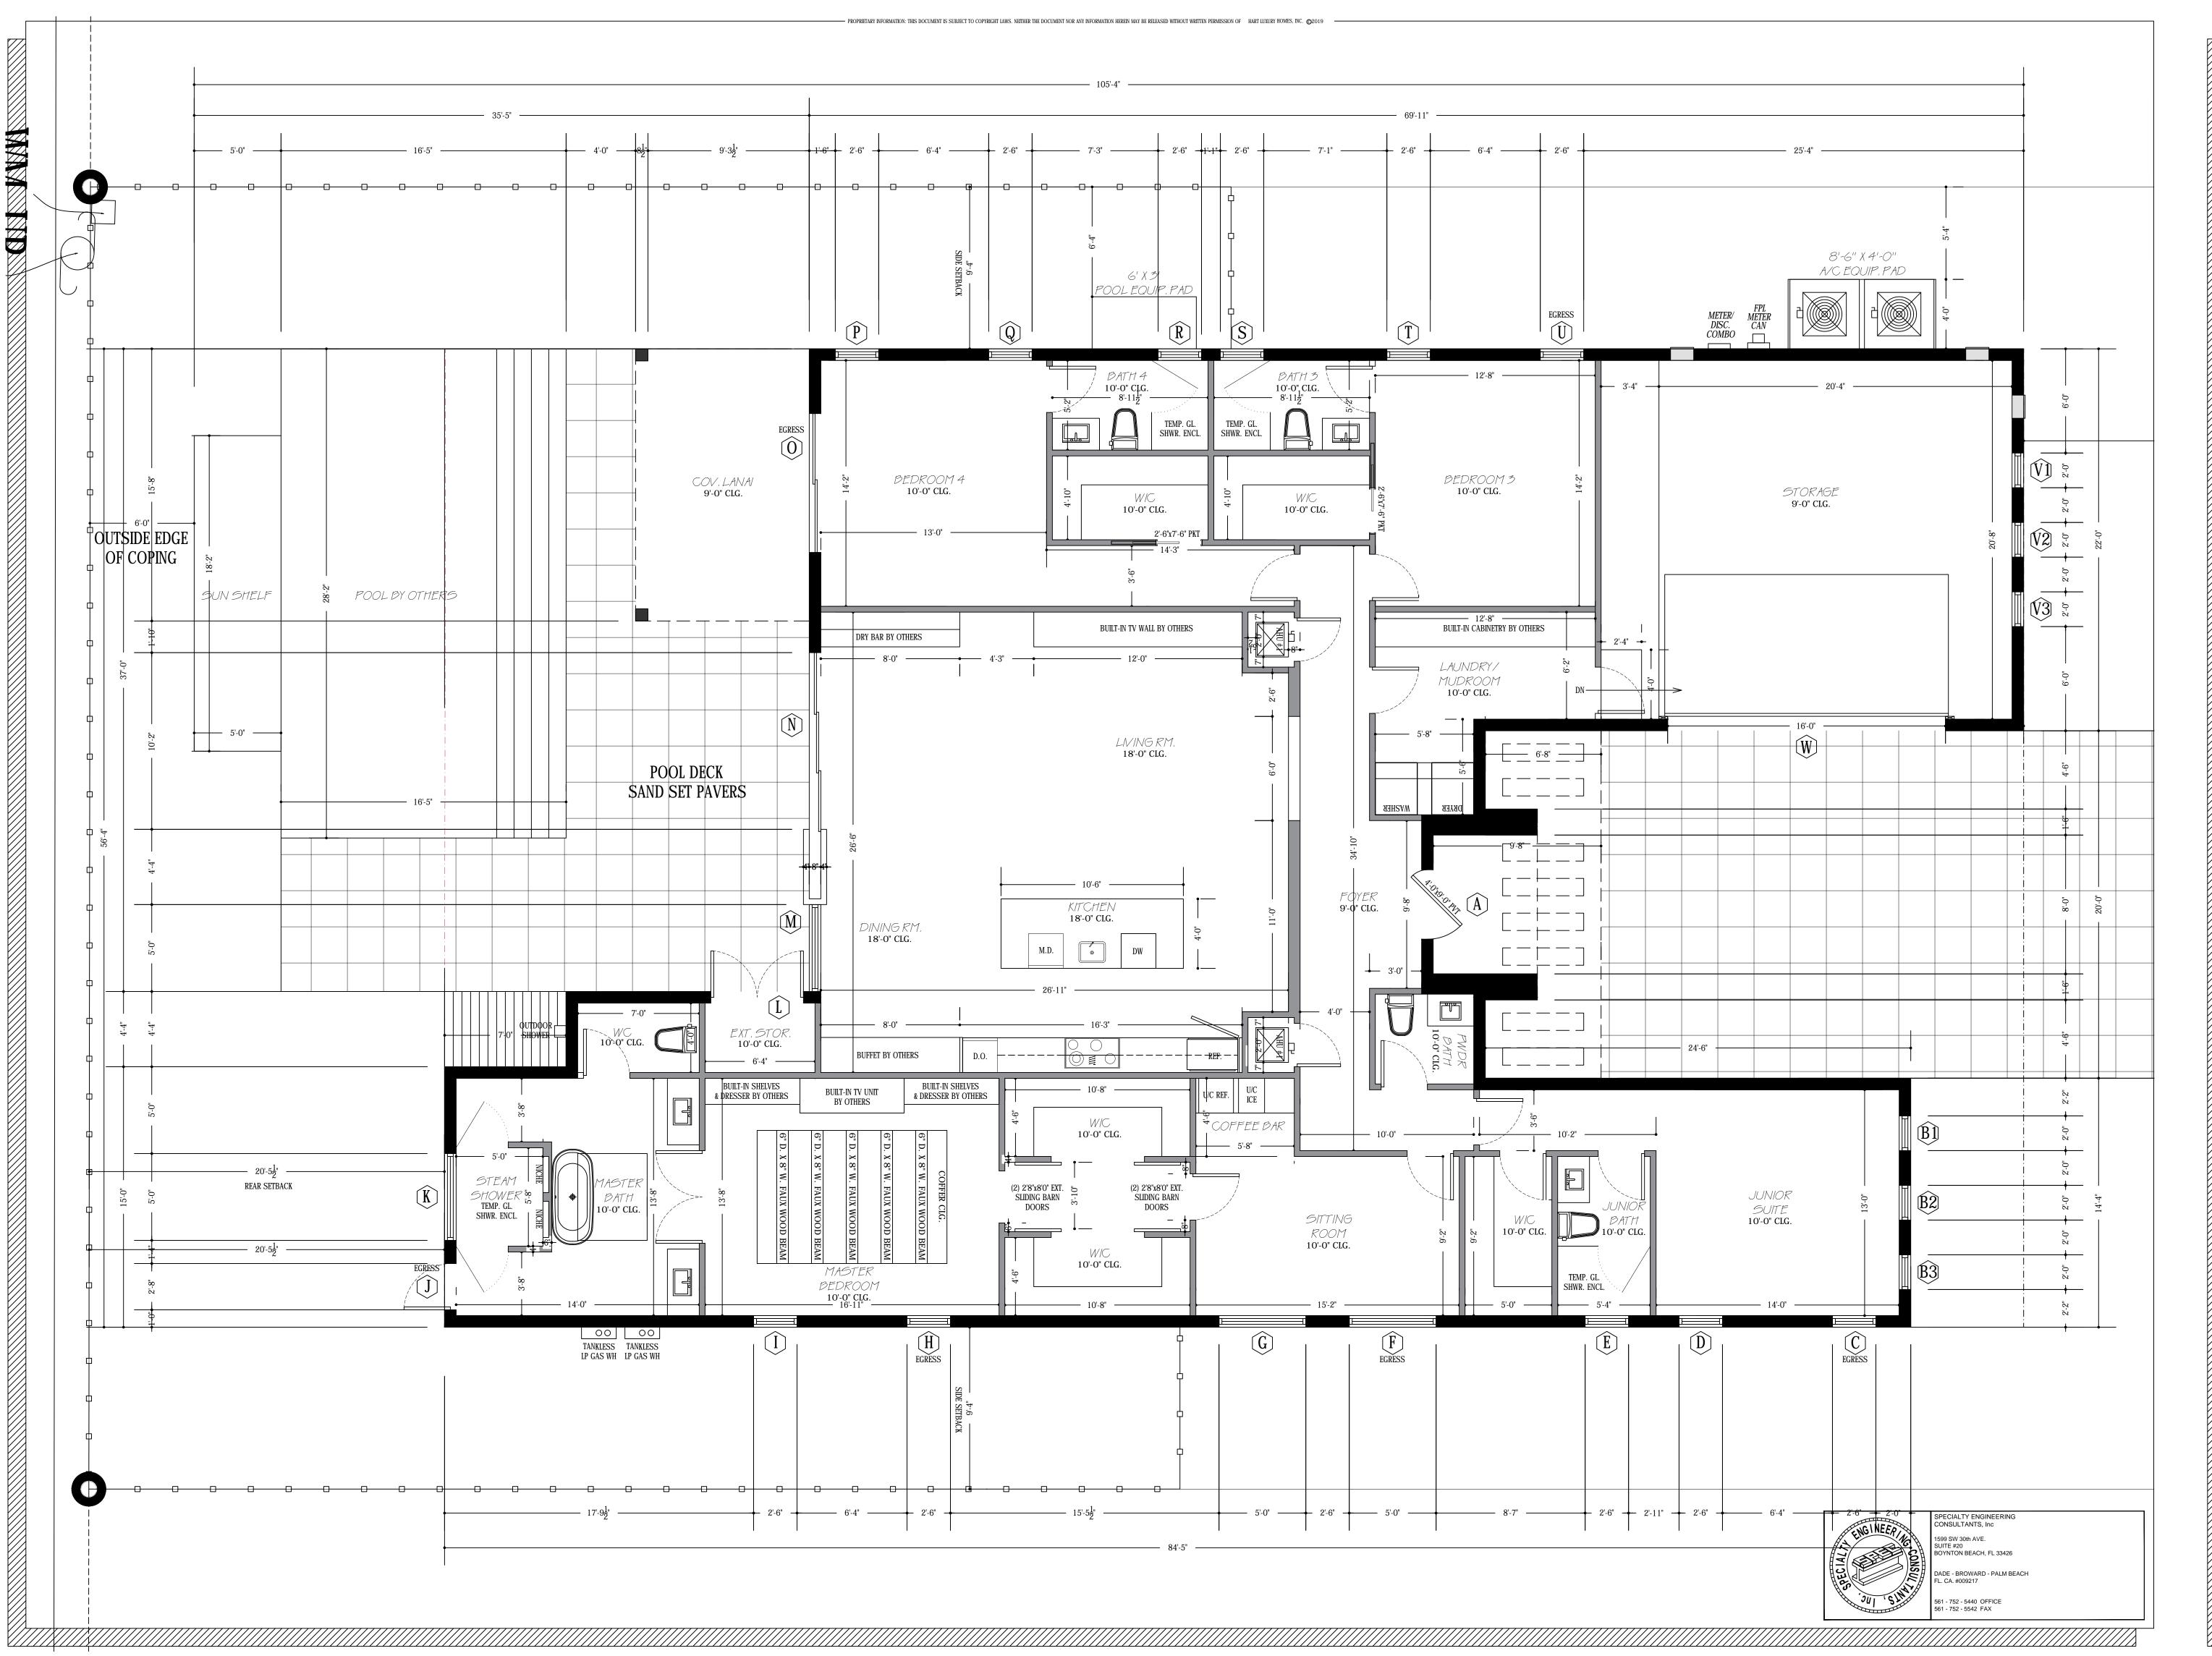



OLIVERIO

RESIDENCE
PROJECT OWNER:
JEFFREY OLIVERIO
1134 JEFFERSON STREET
HOLLYWOOD, FL 33019

PROJECT LOCATION: 1134 JEFFERSON STREET HOLLYWOOD, FL 33019

PROJECT DATA

FOLIO: 5142 14 01 5742

LEGAL DESCRIPTION:

HOLLYWOOD LAKES SECTION 1-32 B LOT 22 W1/2, 23 BLK 34

ZONING CLASSIFICATION: RS-6

LOW RESIDENTIAL (LRES)

HISTORICAL DESIGNATION: HMPRLOD-1

SITE SQUARE FOOTAGE: 10,225 S.F.

SEAL GARY McDOUGLE, PE FL #56214

PROJECT # HART1134 SCALE 1/4" = 1'-0" U.N.O.

DRAWN BY BAS

REVISION SCHEDULE


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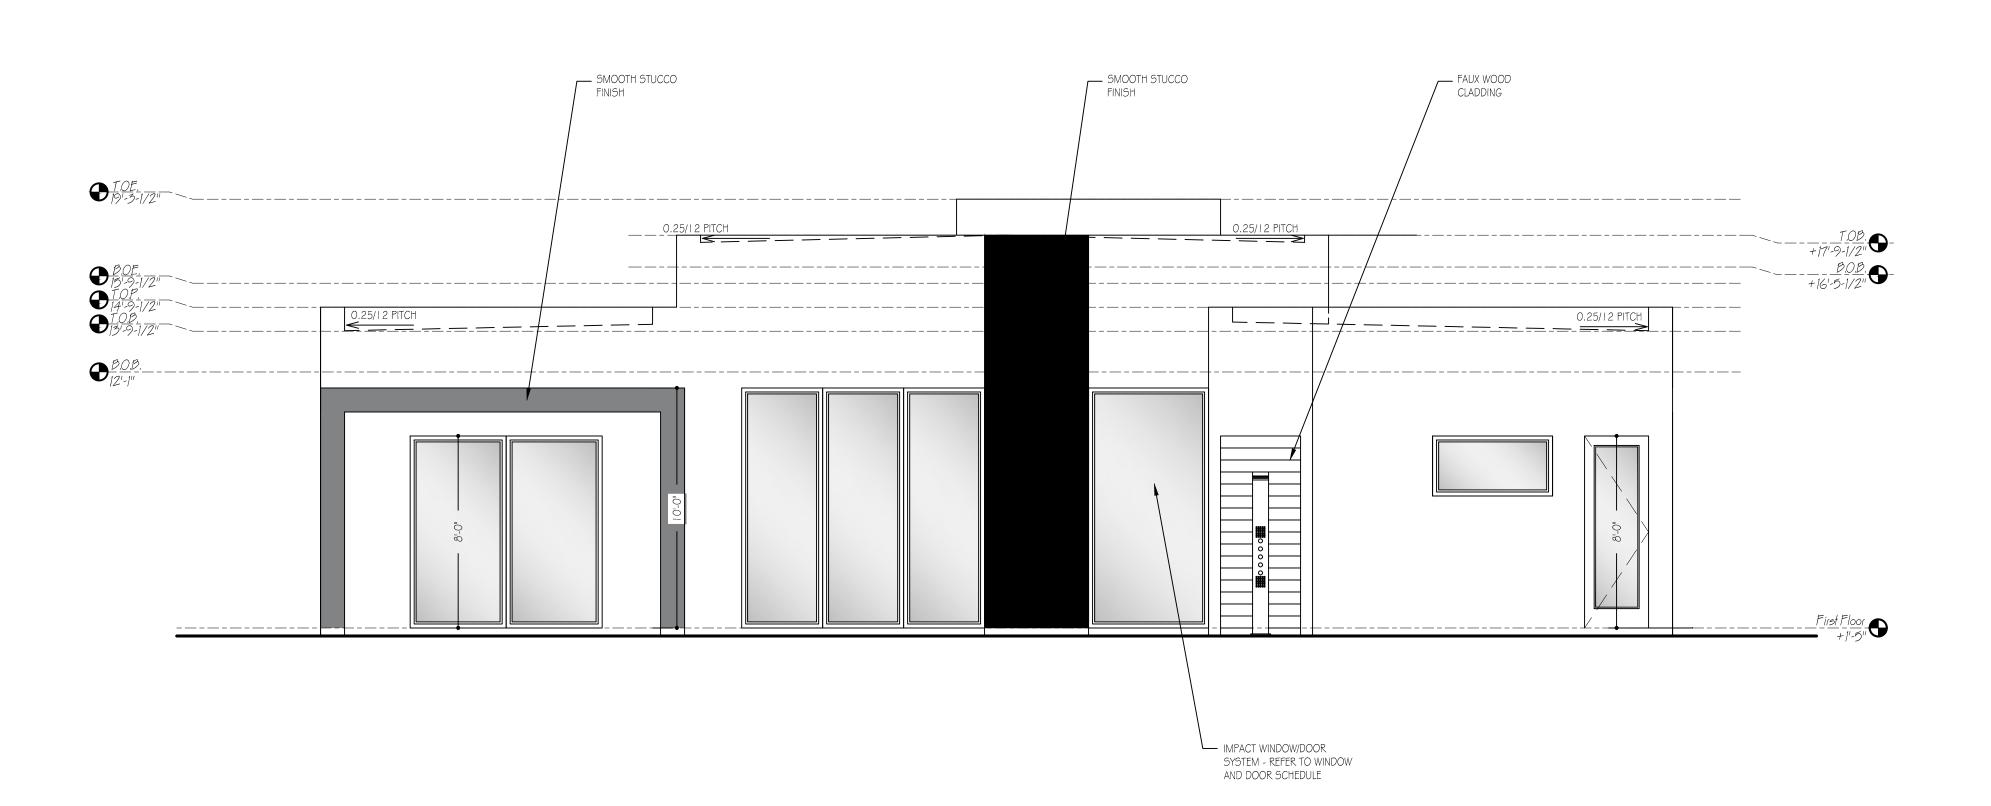
1 12.12.19 PERMIT SUBMITTAL

DIMENSION PLAN

SHEET TITLE

A2
SHEET TITLE



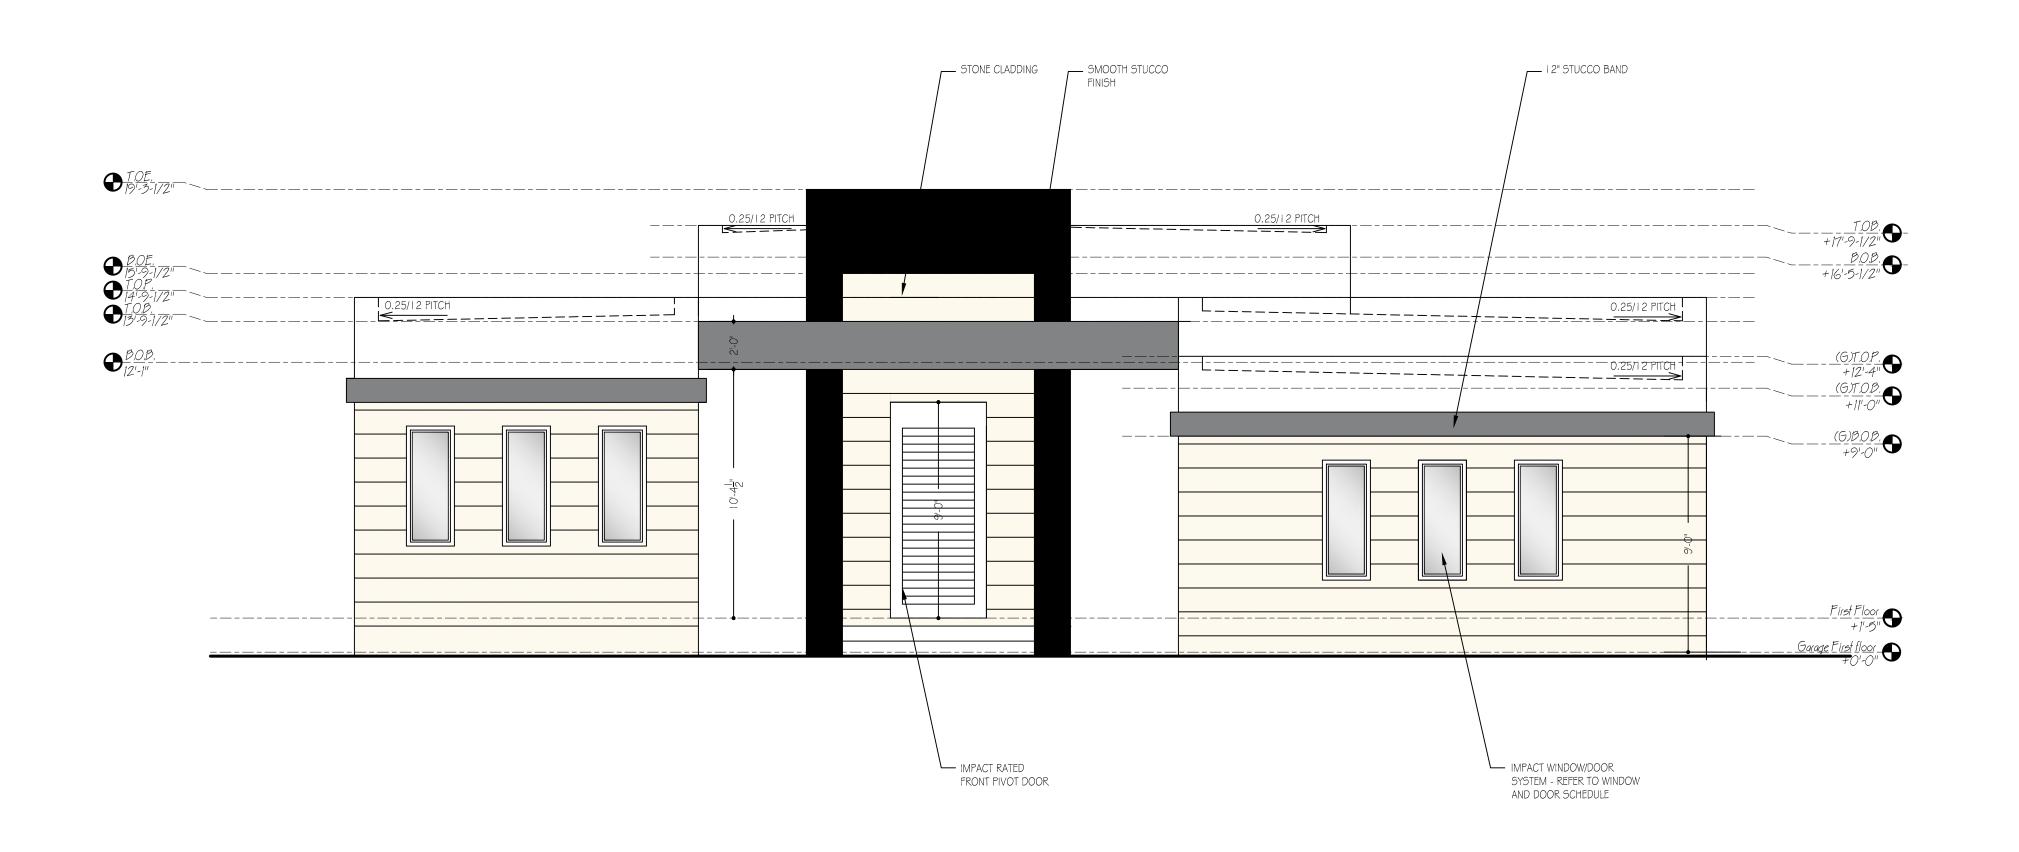





OLIVERIO

RESIDEN

PROJECT OWNER:

JEFFREY OLIVERIO

1134 JEFFERSON STREET

HOLLYWOOD, FL 33019

PROJECT LOCATION: 1134 JEFFERSON STREET HOLLYWOOD, FL 33019

PROJECT DATA

FOLIO: 5142 14 01 5742

W1/2, 23 BLK 34

LEGAL DESCRIPTION: HOLLYWOOD LAKES SECTION 1-32 B LOT 22

ZONING CLASSIFICATION:

LOW RESIDENTIAL (LRES)

HISTORICAL DESIGNATION:

MPRLOD-1

SITE SQUARE FOOTAGE: 10,225 S.F.

SEAL

GARY McDOUGLE, PE FL #56214

PROJECT # HART1134

SCALE 1/4" = 1'-0" U.N.O.

DRAWN BY BAS

REVISION SCHEDULE


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1 12.12.19 PERMIT SUBMITTAL


FRONT & REAR ELEVATIONS

SHEET TITLE

A3

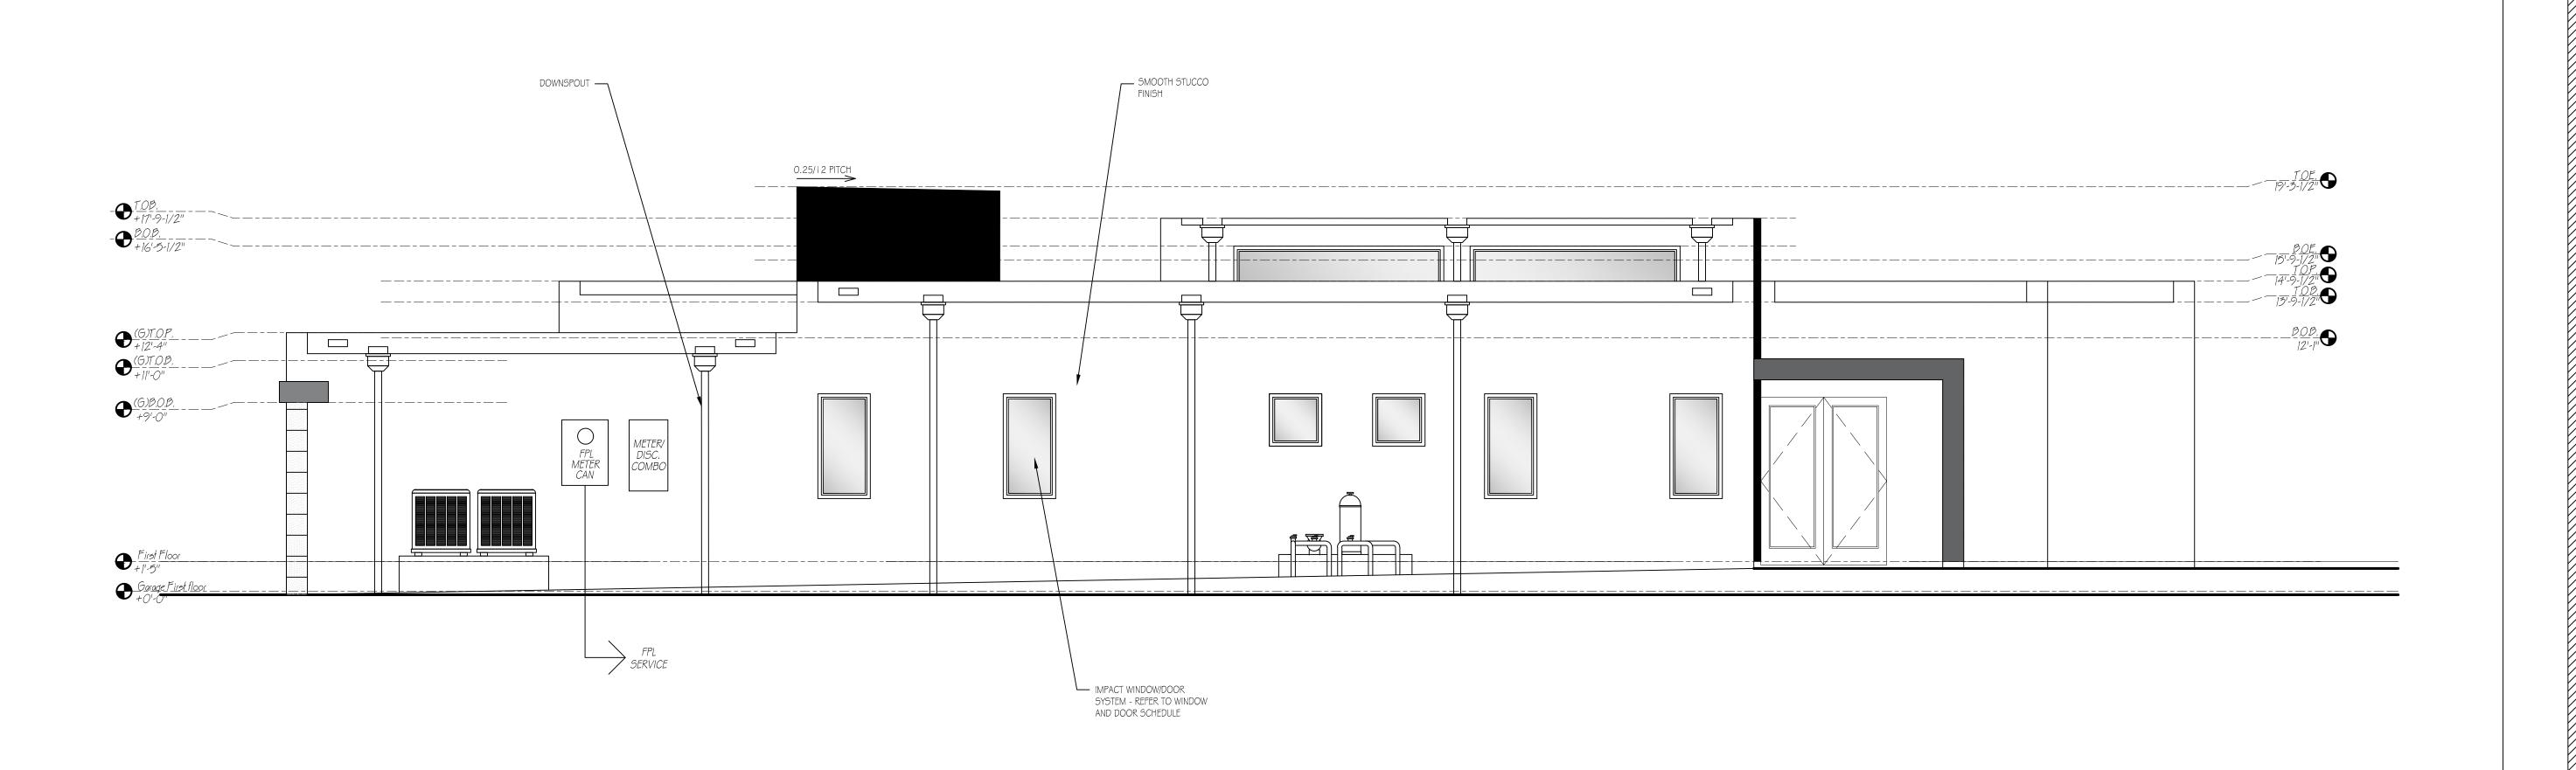

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OLIVERIO

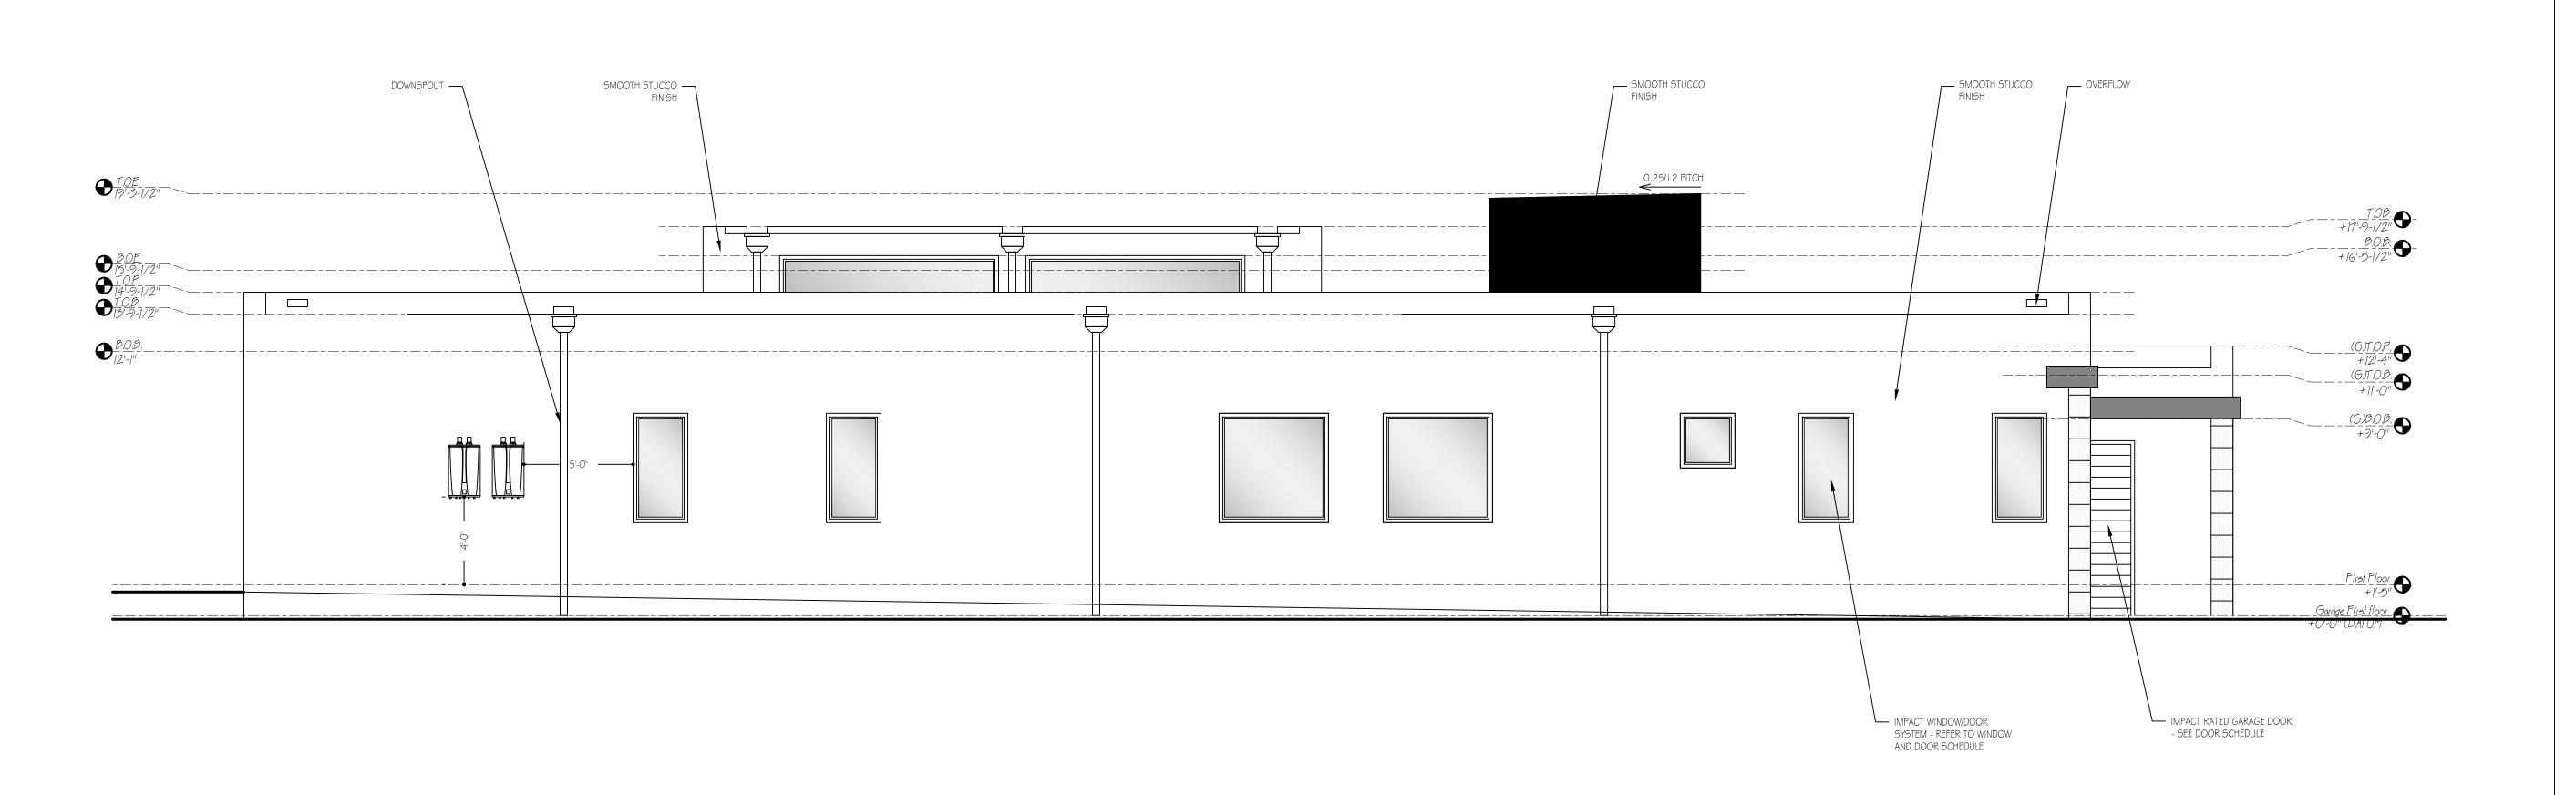RESIDENCE PROJECT OWNER:

JEFFREY OLIVERIO
1134 JEFFERSON STREET
HOLLYWOOD, FL 33019
PROJECT LOCATION:

1134 JEFFERSON STREET

HOLLYWOOD, FL 33019

PROJECT DATA

FOLIO:

5142 14 01 5742

LEGAL DESCRIPTION:

HOLLYWOOD LAKES SECTION 1-32 B LOT 22 W1/2, 23 BLK 34

ZONING CLASSIFICATION: RS-6

LOW RESIDENTIAL (LRES)

HISTORICAL DESIGNATION:

HMPRLOD-1

SITE SQUARE FOOTAGE: 10,225 S.F.

SEAL GARY McDOUGLE, PE FL #56214

PROJECT # HART1134

SCALE 1/4" = 1'-0" U.N.O.

DRAWN BY BAS

REVISION SCHEDULE


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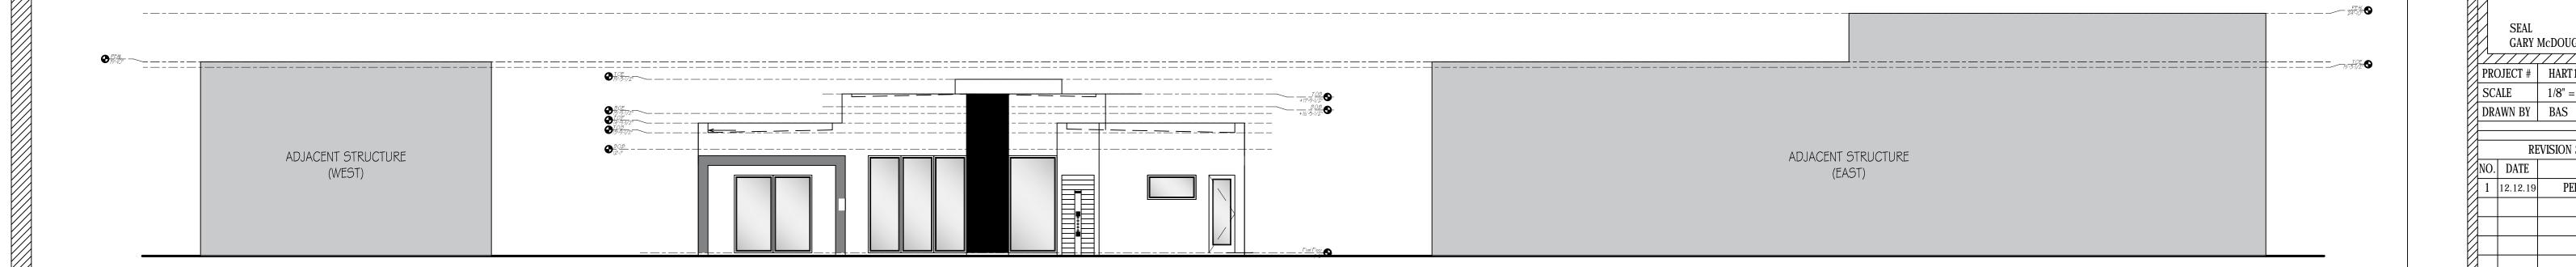
1 12.12.19 PERMIT SUBMITTAL

RIGHT & LEFT ELEVATIONS

SHEET TITLE

A4
SHEET TITLE



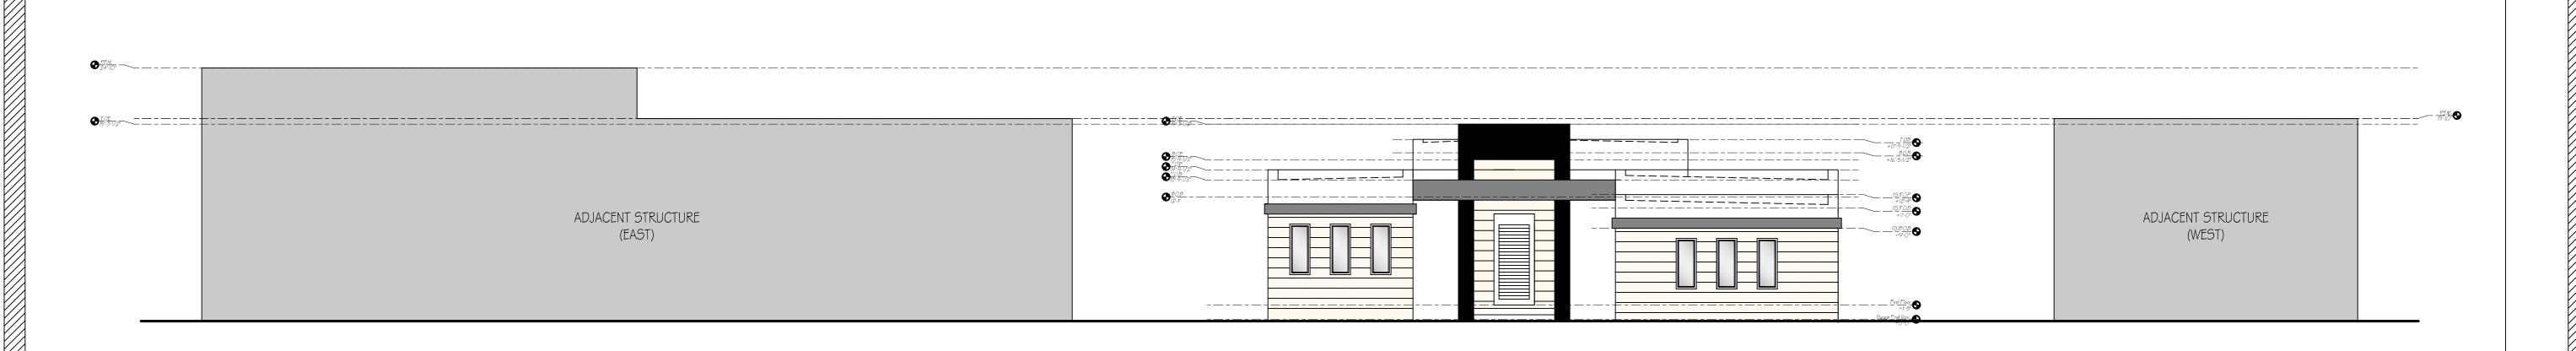





OLIVERIO

PROJECT OWNER: JEFFREY OLIVERIO

> PROJECT LOCATION: 1134 JEFFERSON STREET HOLLYWOOD, FL 33019

> 1134 JEFFERSON STREET HOLLYWOOD, FL 33019

PROJECT DATA

5142 14 01 5742

W1/2, 23 BLK 34

LEGAL DESCRIPTION: HOLLYWOOD LAKES SECTION 1-32 B LOT 22

ZONING CLASSIFICATION:

LOW RESIDENTIAL (LRES)

HISTORICAL DESIGNATION:

SITE SQUARE FOOTAGE: 10,225 S.F.

GARY McDOUGLE, PE FL #56214

PROJECT # HART1134 SCALE 1/8" = 1'-0" U.N.O.

REVISION SCHEDULE DESCRIPTION NO. DATE 1 12.12.19 PERMIT SUBMITTAL

STREET PROFILE **ELEVATION**









