

#### **PLANNING DIVISION**



2600 Hollywood Boulevard Room 315 Hollywood, FL 33022 File No. (internal use only):\_

# **GENERAL APPLICATION**

	APPLICATION TYPE (CHECK ONE)	:
CITY OF	☐ Technical Advisory Committee	☐ Historic Preservation Board
	☐ City Commission	☑ Planning and Development Board
FLORIDA	Date of Application:	
Tel: (954) 921-3471	Location Address: 1700 North SR 7	
Fax: (954) 921-3347	Lot(s): 28,29,30,31 Block(s): 22	A-2B Subdivision: BENDLES TOWNSITE
	Folio Number(s): 514112030110	
		Land Use Classification:TOC
This application must be		Sq Ft/Number of Units:6,890 S.F.
completed in full and submitted with all documents	Is the request the result of a violation notice	? ( ) Yes (X) No If yes, attach a copy of violation.
to be placed on a Board or		y before? If yes, check al that apply and provide File
Committee's agenda.	Number(s) and Resolution(s): 19-DP-27	
	☐ Economic Roundtable ☐ Technical Ad	lvisory Committee
The applicant is responsible for obtaining the appropriate	☐ City Commission ☐ Planning and	d Development
checklist for each type of	TING BUILDING AND CONSTRUCT A NEW	
application.	RETAIL BUILDI	NG AND PARKING LOT
Applicant(s) or their authorized legal agent must be	Number of units/rooms: N/A	Sq Ft:3,910 S.F
present at all Board or		Estimated Date of Completion:JUNE 2021
Committee meetings.	Will Project be Phased? ( ) Yes (X)No	If Phased, Estimated Completion of Each Phase
	Will Project be Phased? ( ) Tes (A)(40	II Thased, Estimated Completion of Education
At least one set of the submitted plans for each		
application must be signed		ORTH FEDERAL HIGHWAY, INC
and sealed (i.e. Architect or Engineer).	Address of Property Owner: 1700 NORTH	S.R.7, HOLLYWOOD, FL 33021
		A Email Address: NICK. ROTUNNO@ALSFLORIST. CO
Documents and forms can be		(circle one): SALTZ MICHELSON ARCHITECTS
accessed on the City's website		AUD, 33312 Telephone: 954-266-2700
at	Fax: _954-266-2701 Email Address:	
http://www.hollywoodfl.org/Do cumentCenter/Home/View/21	Date of Purchase: JUNE 29, 2007 Is there	an option to purchase the Property? Yes ( ) No ( $\times$ )
	If Yes, Attach Copy of the Contract.	
	List Anyone Else Who Should Receive Notice	
at the	A	Address: N/A
		Email Address:N/A

#### PLANNING DIVISION



File No. (internal use only):\_\_\_

2600 Hollywood Boulevard Room 315 Hollywood, FL 33022

My Commission Expires:

#### GENERAL APPLICATION

#### **CERTIFICATION OF COMPLIANCE WITH APPLICABLE REGULATIONS**

The applicant/owner(s) signature certifies that he/she has been made aware of the criteria, regulations and guidelines applicable to the request. This information can be obtained in Room 315 of City Hall or on our website at <a href="www.hollywoodfl.org">www.hollywoodfl.org</a>. The owner(s) further certifies that when required by applicable law, including but not limited to the City's Zoning and Land Development Regulations, they will post the site with a sign provided by the Office of Planning and Development Services. The owner(s) will photograph the sign the day of posting and submit photographs to the Office of Planning and Development Services as required by applicable law. Failure to post the sign will result in violation of State and Municipal Notification Requirements and Laws.

(I)(We) certify that (I) (we) understand and will comply with the provisions and regulations of the City's Zoning and Land Development Regulations, Design Guidelines, Design Guidelines for Historic Properties and City's Comprehensive Plan as they apply to this project. (I)(We) further certify

that the above statements and drawings made on any paper or plans submitted herewith are true to the best of (my)(our) knowledge. (I)(We) understand that the application and attachments become part of the official public records of the City and are not returnable. Signature of Current Owner: PRINT NAME: NICK ROTUNNO Signature of Consultant/Representative: PRINT NAME: CHARLES MICHELSON N/A \_\_\_\_\_ Date: Signature of Tenant: \_\_\_\_\_ N/A Date: PRINT NAME: **Current Owner Power of Attorney** I am the current owner of the described real property and that I am aware of the nature and effect the request for NEW CONSTRUCTION to my property, which is hereby made by me or I am hereby authorizing SALTZ MICHELSON ARCHITECTS to be my legal representative before the (Board and/or Committee) relative to all matters concerning this application. Sworn to and subscribed before me Signature of Current Owner Martin Diaz Nick Rotunn **NOTARY PUBLIC** STATE OF FLORIDA Notary Public Comm# GG158679 Expires 1/16/2022 State of Florida

(Check One) Personally known to me; OR \_\_\_\_ Produced Identification \_\_\_\_\_



August 15th, 2019

City of Hollywood Development Services Planning Division 2600 Hollywood Boulevard Hollywood, Florida 33020 Attn: Planning and Development Board

**RE:** Site Plan Review for a new commercial building (Al's Florist)

File # 19-DP-27

SMA Project No. 2017-186

#### **Project Information**

Project site is located on the northwest corner of Taft Street and US 441. The site was substantially reduced during the US 441 widening, leaving the existing retail building without any available parking area. The project proposes to demolish the existing building in its entirety and build a new one-story retail structure and parking area.

#### Legal Description

Lots 28 and 29, less the south 20.00 feet thereof, Lot 30, less the South 20.00 feet thereof, and less the East 38.00 feet thereof, all of the Townsite in Bendle's Subdivision of the N.W. 1/4 of Section 12, Township 51 South, Range 41 east, according to the plat thereof recorded in Plat Book 2 at page 2 of the Public Records of Broward County, Florida, and less that portion thereof described as follows;

Commence at the center of Section 12, Township 51 South, Range 41 East;

Thence run on an assumed bearing of South 88.10'07" West along the south line of the N.W 1/4 of said Section 12 for 191.17 feet to an intersection with the southerly extension of the West line of the aforementioned Lot 28;

Thence, run North 2.06'05' West along the last described southerly extension for 35.00 feet to the point of beginning of the herein described parcel;

Thence, continued North 2.06'05" West along the West line of Lot 28 for 6.00 feet;

Thence run North 88.10'07" East for 36.04 feet.

City of Hollywood Page 2 of 2

Thence run North 61.36'13" East for 24.60 feet.

Thence run North 88.10'07" East for 45.01 feet to the point of curvature of a circular curve concave to the Northwest:

Thence run easterly, northeasterly, and northerly along the arc of said curve having for its elements a radius of 35.00 feet and a central angle of 90,12'36', for 55.11.feet;

Thence run South 2.02'29" East along the westerly right-of-way line of U.S. 441 per Official Records Book 3442, Page 273, of the Public Records of Broward County, Florida, (the same being a line 53.00 feet westerly of and parallel to the east line of the said N.W. 1/4 of section 12) for 52.13 feet:

Thence run South 88.10'07" West along a line 35.00 feet northerly of and parallel to the south line of the N.W. 1/4 of section 12 for 138.21 feet to the point of beginning.

Also less order of taking per instrument # 112476379, Broward County, Florida Records.

Situate, lying and being in the city of Hollywood, Broward County, Florida.





August 15th, 2019

City of Hollywood Development Services Planning Division 2600 Hollywood Boulevard Hollywood, Florida 33020

Attn: Plans Reviewers

RE: Site Plan Review for a 4,000 sq. ft. commercial building (Al's Florist)

File # 19-DP-27

SMA Project No. 2017-186

#### To Whom It May Concern:

This letter is to confirm that this project is not requesting any Variances or Special Exceptions as described in Article 5 of the City of Hollywood's Zoning and Land Development Regulations Code.

To the best of our understanding, the proposed project complies with the Design Criteria outlined in the Zoning and Land Development Regulations Code, Article 5, Section 5.3.I.4.a.1-4, as follows:

(1) Architectural and Design components. Architecture refers to the architectural elements of exterior building surfaces. Architectural details should be commensurate with the building mass. The use of traditional materials for new architectural details is recommended. Design of the building(s) shall consider aesthetics and functionality, including the relationship of the pedestrian with the built environment.

The proposed building provides decorative detailing on all four elevations considering its corner location at a major intersection. The intent is to build the structure of concrete block with a stucco and paint finish, varying parapet heights and floor to ceiling windows in an aluminum frame. Paint colors have been carefully selected in earthly tones to harmonize with Al's Florist brand and nature of business and to complement the surrounding area. A concrete walk at each building entry connects the public sidewalk to the project and metal awnings will provide shade and shelter to pedestrians.

City of Hollywood Page 2 of 2

(2) Compatibility. The relationship between existing architectural styles and proposed construction, including how each building along the street relates to the whole and the pattern created with adjacent structures and the surrounding neighborhood. Buildings should contain architectural details that are characteristic of the surrounding neighborhood.

Detailing is provided with stucco banding, decorative metal panels and premanufactured metal awnings. The design also includes large glass windows and designed landscaping.

(3) Scale/Massing. Buildings shall be proportionate in scale, with a height which is consistent with the surrounding structures. Building mass shall reflect a simple composition of basic architectural details in relation to its length, width, height lot coverage, and setting of the structure in context with adjacent buildings. Architectural details include, but are not limited to, banding, molding, and fenestration.

The design intent of the project is to fit seamlessly with the existing adjacent properties. Similar to its neighbors, the proposed building is a one-story structure, of moderate scale. It is intended for commercial use similar to the buildings surrounding it.

(4) Landscaping. Landscaped areas should contain a variety of native and other compatible plant types and forms, and be carefully integrated with existing buildings and paved areas. Existing mature trees and other significant plants on the site should be preserved.

New trees and landscape areas have been incorporated into the design. Native species are proposed above and beyond what's required.

If you have any questions regarding the above, please do not hesitate to contact me.

Very truly yours, Saltz Michelson Architects

Maday Gutierrez

Maday Gutierrez

Project Manager










# **AL'S FLORIST**

# 1700 NORTH SR 7 HOLLYWOOD, FL

# T.A.C. SUBMITTAL

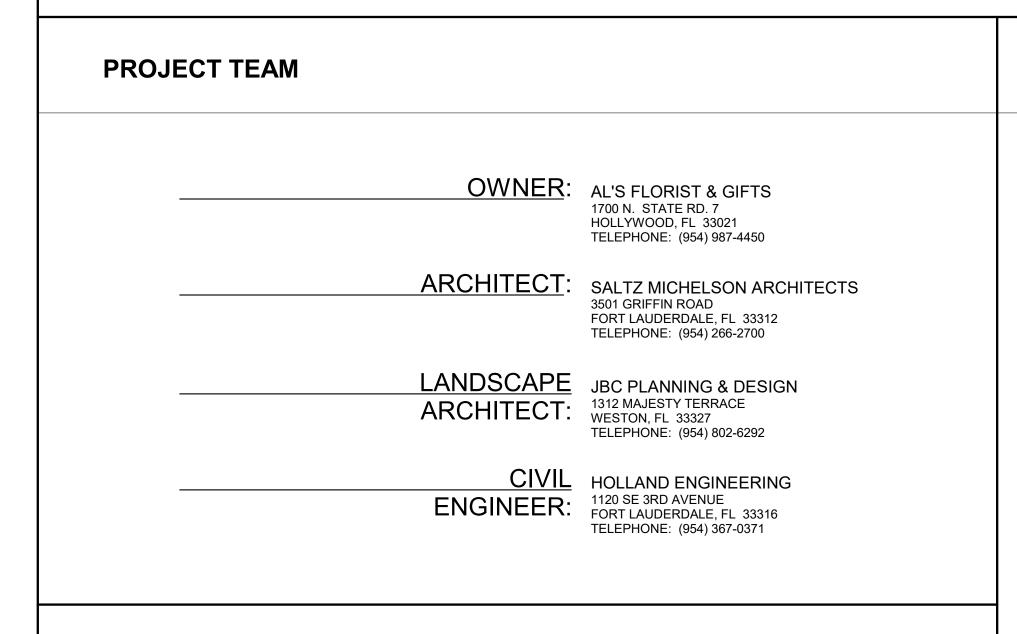

#### **GENERAL NOTES**

1. THE CONTRACTOR SHALL VISIT THE SITE OF THE WORK AND EXAMINE THE PLANS AND IT WILL BE ASSUMED THAT THE CONTRACTOR HAS INVESTIGATED AND IS FULLY INFORMED AS TO THE CONDITIONS AND MATERIALS TO BE ENCOUNTERED AS TO CHARACTER, QUALITY AND QUANTITIES OF WORK TO BE PERFORMED AND MATERIALS TO BE FURNISHED AND AS TO THE REQUIREMENTS OF THE PLANS.

2. CONTRACTOR SHALL VERIFY ALL DIMENSIONS AND CONDITIONS IN THE FINAL PLANS AND ON THE JOB SITE PRIOR TO EXECUTION OF ANY WORK AND SHALL IMMEDIATELY NOTIFY THE ARCHITECT OF ANY DISCREPANCIES. THE CONTRACTOR WILL BE RESPONSIBLE FOR ALL COSTS ARISING FROM A FAILURE TO PERFORM A VERIFICATION AND TO MAKE TIMELY NOTIFICATION OF DISCREPANCIES. THE ARCHITECT WILL, IN AN EXPEDIENT MANNER, PROVIDE THE OWNER WITH REVISED DRAWINGS REFLECTING ANY OF THESE DISCREPANCIES AND RELATED MITIGATION FOR REVIEW AND APPROVAL

3. DO NOT SCALE DRAWING.

4. CONTRACTOR WILL GUARANTEE IN WRITING ALL MATERIALS AND WORKMANSHIP FOR A PERIOD OF ONE YEAR FROM THE DATE OF FINAL ACCEPTANCE BY THE OWNER AND WILL, AT HIS OWN COST, REPAIR OR REPLACE ALL WORK OR DAMAGE CAUSED BY WORK OF SUBCONTRACTORS WHICH BECOMES DEFECTIVE DURING THE TERM OF THE

5. CONTRACTOR SHALL COORDINATE AND SUPERVISE HIS WORK AND WORK BY SUBCONTRACTORS.

6. THESE PLANS ARE THE PROPERTY OF THE ARCHITECT AND SHALL NOT BE USED, REPRODUCED, OR CHANGED IN ANY WAY WITHOUT THE EXPRESSED WRITTEN CONSENT OF THE ARCHITECT.

7. GENERAL CONTRACTOR SHALL DO ALL CUTTING AND PATCHING OF CONCRETE SLABS, PARTITIONS, ETC...AS MAY BE REQUIRED FOR ALL TRADES TO ACCOMPLISH ALL WORK REQUIRED BY THESE CONTRACT DOCUMENTS. PATCH &

8. IT IS THE CONTRACTORS RESPONSIBILITIES FOR FEES AND COSTS FOR LICENSES, PERMITS, CERTIFICATES, SERVICE CHARGES, ETC., ASSESSED BY ANY GOVERNMENTAL AGENCY OR UTILITY COMPANY. CONTRACTOR'S INSTALLATION OF ALL UTILITIES AND SUBSEQUENT HOOKUP SHALL BE AS NECESSARY TO ASSURE CONFORMANCE

JURISDICTION OVER THIS TYPE OF WORK AND OCCUPANCY. ALL CONTRACTORS SHALL DO THEIR WORK IN COMPLIANCE WITH THE FLORIDA BUILDING CODE, NATIONAL ELECTRIC CODE, NFPA, OSHA AND OTHER APPLICABLE CODES AND REGULATIONS.

9. IT IS THE INTENT OF THE ARCHITECT THAT THIS WORK BE IN CONFORMANCE WITH BUILDING AUTHORITIES HAVING

10. IT IS NOT THE INTENT OF THESE PLANS TO SHOW EVERY MINOR DETAIL OF CONSTRUCTION. THE CONTRACTOR IS EXPECTED TO FURNISH AND INSTALL ALL CONSTRUCTION. THE CONTRACTOR IS EXPECTED TO FURNISH AND INSTALL ALL ITEMS REQUIRED TO COMPLETE THE WORK WITH GOOD WORKMANSHIP AND ASSURE PROPER WORKING ORDER.

11. CONTRACTOR SHALL BE RESPONSIBLE FOR OBTAINING AND PAYING FOR THE COST OF ALL INSPECTIONS AND TESTS REQUIRED TO IMPLEMENT THE PLANS AND/OR REQUIRED BY ANY GOVERNMENT AGENCY.

12. AFTER APPROVAL OF THE FINAL PLANS, ALL REVISIONS MUST PROCEED THROUGH THE ARCHITECT FOR APPROVAL. ANY REVISIONS MADE WITHOUT THE WRITTEN APPROVAL OF THE ARCHITECT MAY BE CONSIDERED INVALID AND, AT THE SOLE DISCRETION OF THE ARCHITECT, THE WORK REJECTED AND REQUIRED TO BE MODIFIED AT

13. OWNER'S SUBCONTRACTORS SHALL BE ALLOWED TO DO WORK PRIOR TO SUBSTANTIAL COMPLETION SUBJECT ONLY TO THE APPROPRIATE PROGRESS OF THE WORK AND A SEVEN (7) DAY PRIOR NOTICE OF INTENT BY OWNER TO

14. CONTRACTOR SHALL PROVIDE PUBLIC PROTECTION AS NECESSARY PER CITY AND LOCAL CODE REQUIREMENTS.

15. ALL MATERIALS AND WORK TO CONFORM TO LATEST GOVERNING BUILDING CODES AND REGULATIONS. SUBMIT FOR REVIEW NO LESS THAN (6) SETS OF SHOP DRAWINGS WHERE REQUIRED AND/OR INDICATED.

16. CONTRACTOR SHALL PROVIDE ACCESS PANELS AS REQUIRED BY PLUMBING, AIR CONDITIONING AND OTHER TRADES, AND AS REQUIRED BY CODES, LOCATIONS AND TYPE OF PANEL TO BE REVIEWED AND APPROVED BY THE

17. THE GENERAL CONDITIONS OF THE CONTRACT FOR CONSTRUCTION, AIA DOCUMENT A201, LATEST EDITION, SHALL BE MADE PART OF THESE CONTRACT DOCUMENTS.

#### **INDEX OF DRAWINGS**

A0.0

A1.0

A3.0

A3.1

PH-1

#### **ARCHITECTURE SURVEY** SITE DETAILS FLOOR PLANS

PAVING, GRADING PLAN & DRAINAGE PLAN

STREET PROFILE/ ELEVATIONS

EXTERIOR ELEVATIONS

PHOTOMETRICS PLAN

UTILITY DETAILS

C2 WATER & SWER PLAN PAVING MARKING & SIGNAGE PLAN STORMWATER POLLUTION PREVENTION PLAN C5 CIVIL DETAILS & SECTION PLAN C6

#### **LANDSCAPE**

TREE DISPOSITION PLAN LANDSCAPE PLAN LP-3 PLANT LIST & CODE DATA LANDSCAPE DETAILS & NOTES

#### **MEETING DATES**


1. PRE-APPLICATION CONCEPTUAL OVERVIEW: 2. PRELIMINARY TECHNICAL ADVISORY COMMITTEE: 05.06.19 3. FINAL TECHNICAL ADVISORY COMMITTEE: 4. PLANNING & DEVELOPMENT BOARD:

# SALTZ MICHELSON ARCHITECTS

3501 Griffin Road Ft. Lauderdale, FL 33312 (954) 266-2700 Fx:(954) 266-2701 sma@saltzmichelson.com

AA-0002897

# **LOCATION MAP**

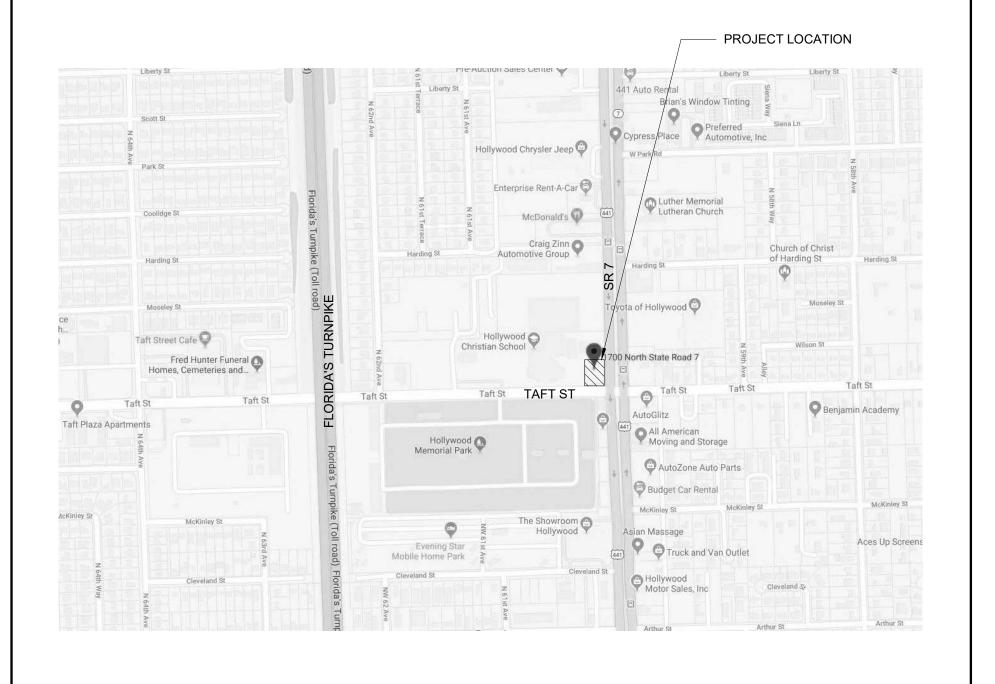


Charles Michelson AR0009976


Project No. 2017-186 Drawn By: Checked By

**REVISIONS** 

07.01.19

1\ 07.01.19 TAC COMMENTS 2 08.15.19 TAC COMMENTS

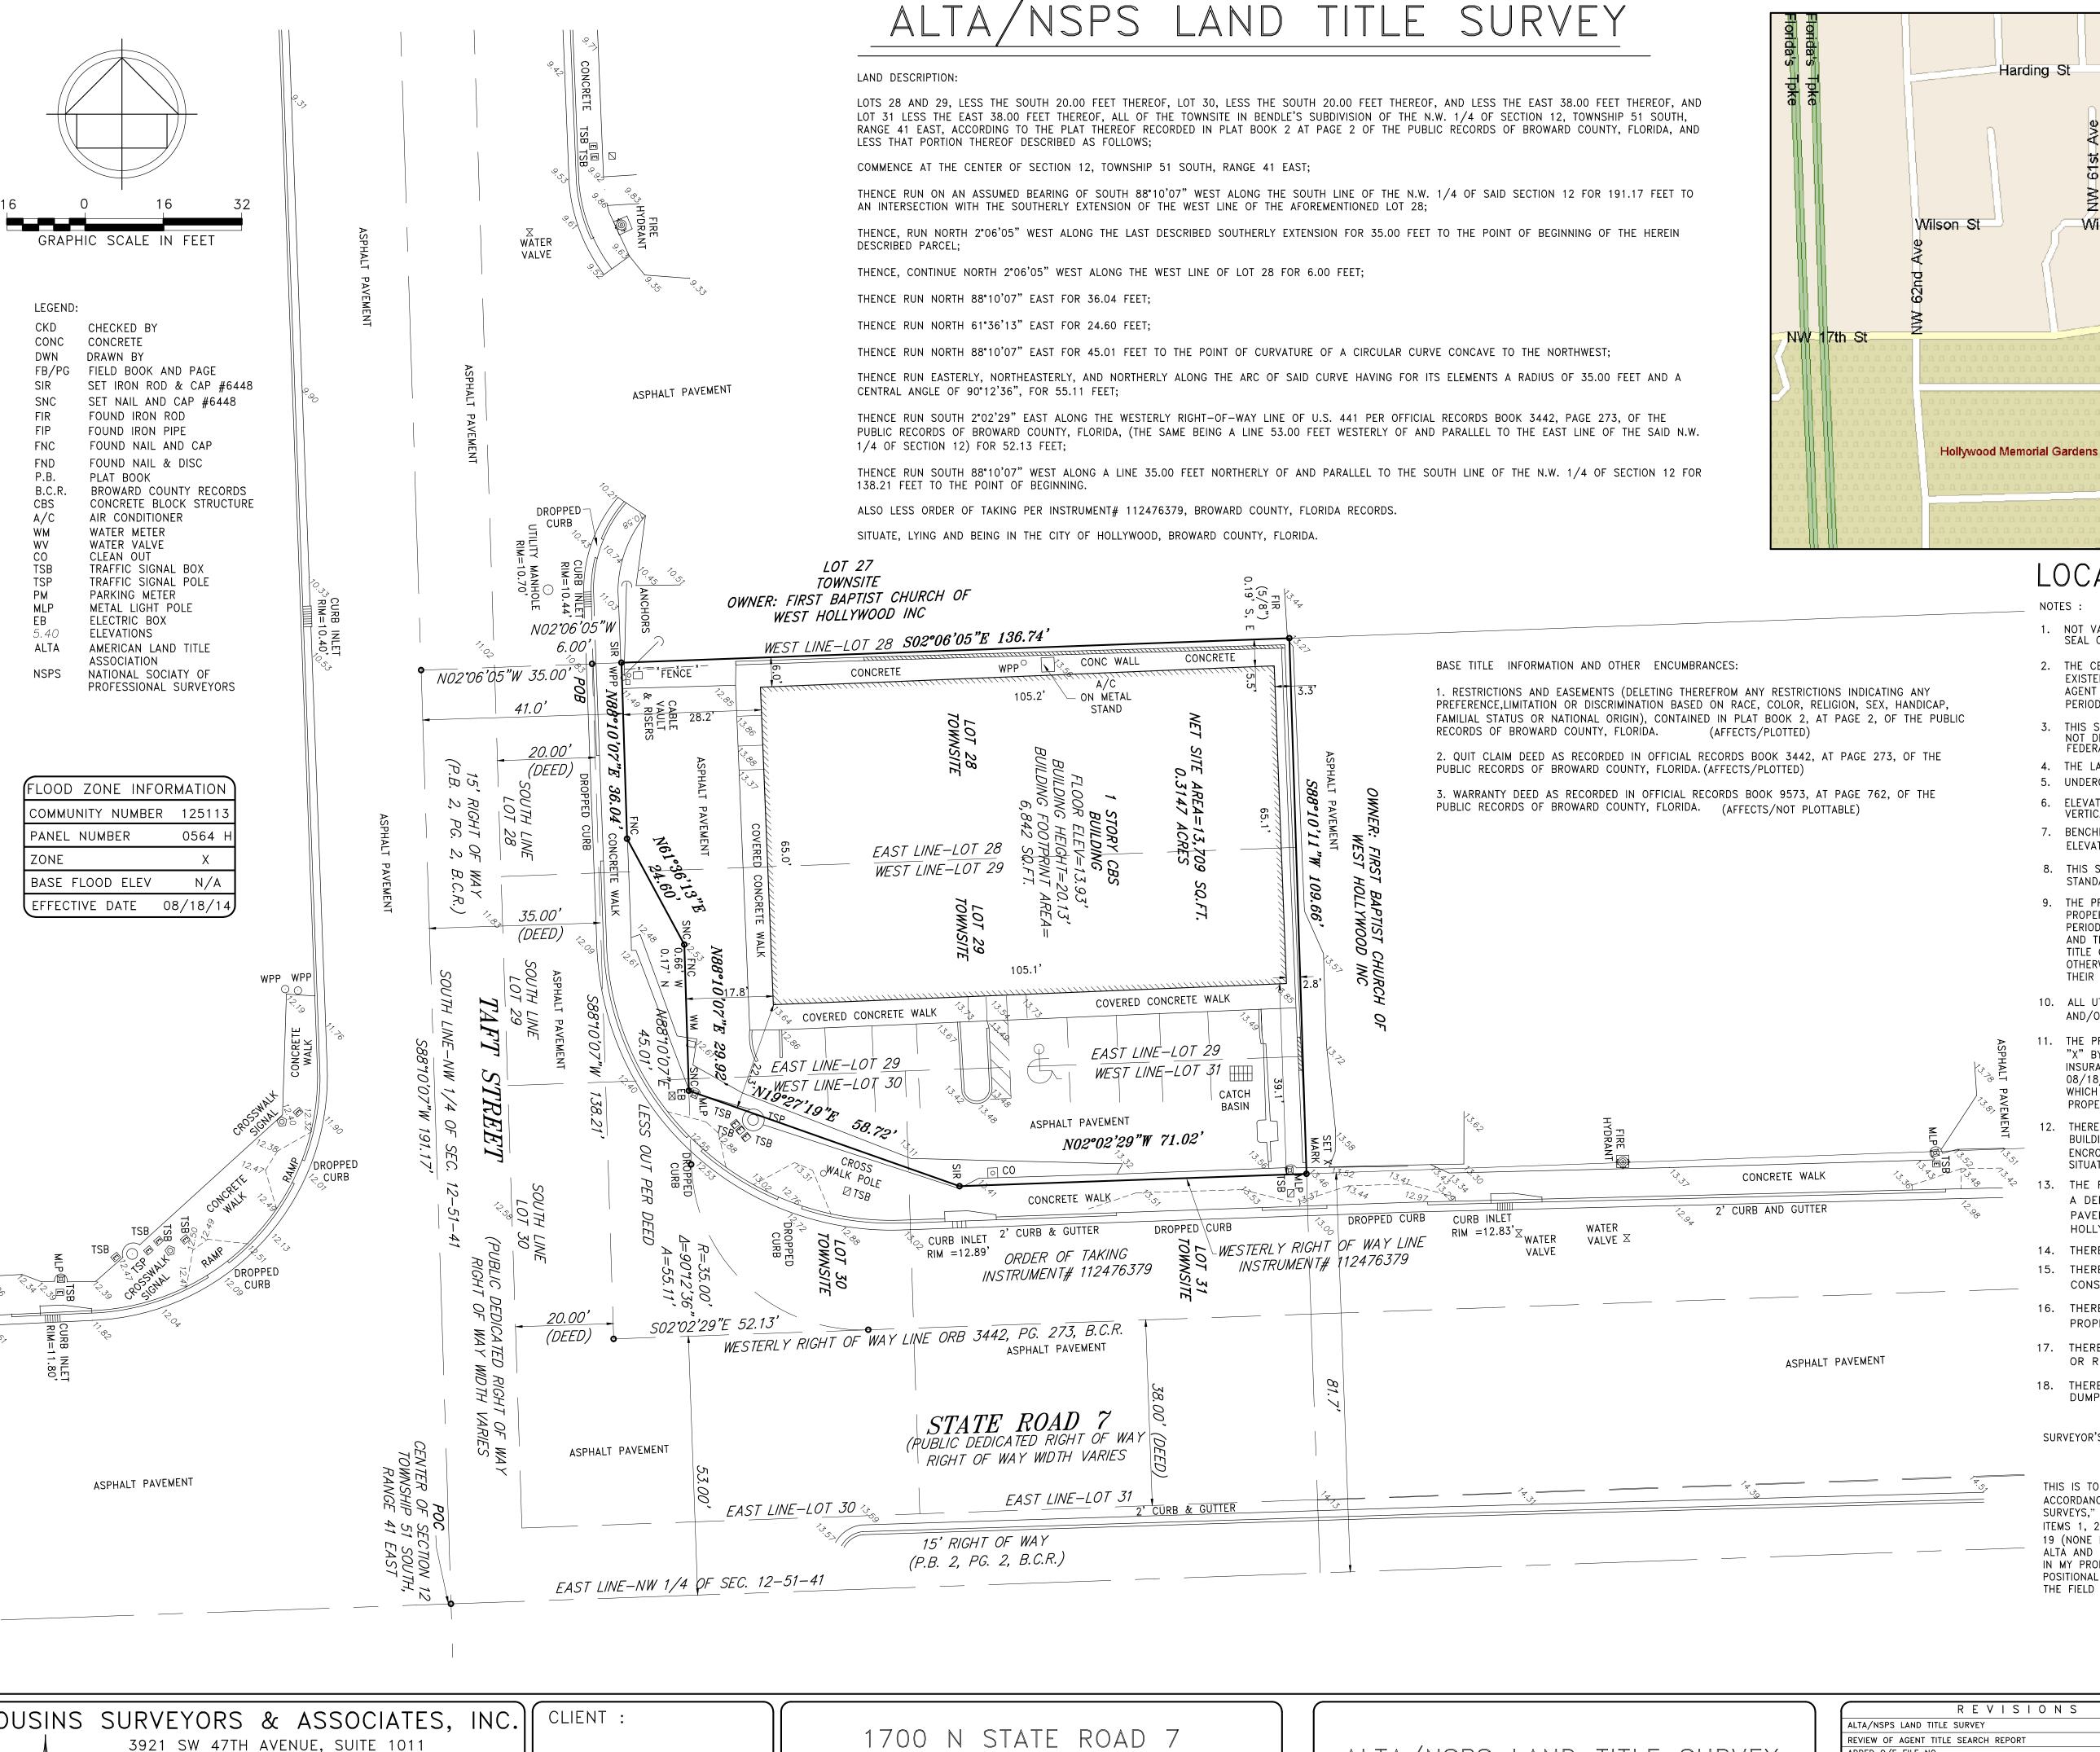

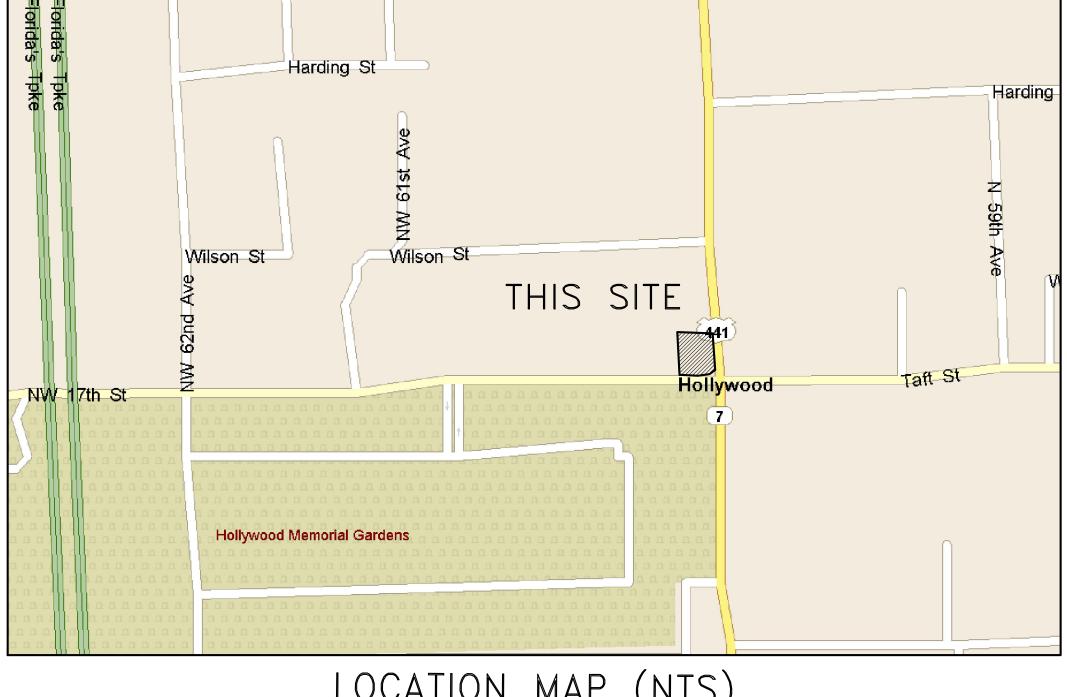

# LOCATION MAP (NTS)

- 1. NOT VALID WITHOUT THE SIGNATURE AND THE ORIGINAL RAISED SEAL OF A FLORIDA LICENSED SURVEYOR AND MAPPER.
- 2. THE CERTIFICATION SHOWN HEREON TO THE EXTENT RELATING TO THE EXISTENCE OF EASEMENTS AND/OR RIGHTS-OF-WAY OF RECORD IS BASED UPON AGENT TITLE SEARCH REPORT PREPARED BY L&V ABSTRACT & TITLE SERVICES PERIOD SEARCHED FROM JANUARY 1, 1953 THROUGH MARCH 25, 2019. FILE NO. 19-536645.
- 3. THIS SURVEY WAS DONE SOLELY FOR BOUNDARY PURPOSES AND DOES NOT DEPICT THE JURISDICTION OF ANY MUNICIPAL, STATE, FEDERAL OR OTHER ENTITIES.
- 4. THE LAND DESCRIPTION SHOWN HEREON WAS PROVIDED BY THE CLIENT.
- 5. UNDERGROUND IMPROVEMENTS NOT SHOWN.
- 6. ELEVATIONS SHOWN HEREON ARE BASED ON THE NORTH AMERICAN VERTICAL DATUM OF 1988.
- 7. BENCHMARK REFERENCE : BROWARD COUNTY BENCHMARK # 2065 ELEVATION= 13.87' (NAVD88)
- 8. THIS SURVEY WAS MADE IN ACCORDANCE WITH LAWS AND/OR MINIMUM STANDARDS OF THE STATE OF FLORIDA.
- 9. THE PROPERTY DESCRIBED HEREON (THE "PROPERTY") IS THE SAME AS THE PROPERTY DESCRIBED IN AGENT TITLE SEARCH REPORT PREPARED BY L&V ABSTRACT & TITLE SERVICES PERIOD SEARCHED FROM JANUARY 1, 1953 THROUGH MARCH 25, 2019, FILE NO. 19-536645 AND THAT ALL EASEMENTS, COVENANTS AND RESTRICTIONS REFERENCED IN SAID TITLE COMMITMENT OR APPARENT FROM A PHYSICAL INSPECTION OF THE PROPERTY OR OTHERWISE KNOWN TO ME HAVE BEEN PLOTTED HEREON OR OTHERWISE NOTED AS TO THEIR EFFECT ON THE PROPERTY
- 10. ALL UTILITIES SERVING THE PROPERTY ENTER THROUGH ADJOINING PUBLIC STREETS AND/OR EASEMENTS OF RECORD.
- 11. THE PROPERTY IS LOCATED WITHIN AN AREA HAVING A ZONE DESIGNATION "X" BY THE FEDERAL EMERGENCY MANAGEMENT AGENCY (FEMA), ON FLOOD INSURANCE RATE MAP NO. 0564 H, WITH A DATE OF IDENTIFICATION OF 08/18/14, FOR COMMUNITY NO. 125113, IN BROWARD COUNTY, STATE OF FLORIDA WHICH IS THE CURRENT FLOOD INSURANCE RATE MAP FOR THE COMMUNITY IN WHICH THE PROPERTY IS SITUATED.
- 12. THERE ARE NO ENCROACHMENTS ONTO ADJOINING PREMISES, STREETS OR ALLEYS BY ANY BUILDINGS, STRUCTURES OR OTHER IMPROVEMENTS LOCATED ON THE PROPERTY, AND NO ENCROACHMENTS ONTO THE PROPERTY BY BUILDINGS, STRUCTURES OR OTHER IMPROVEMENTS SITUATED ON ADJOINING PREMISES.
- THE PROPERTY HAS DIRECT ACCESS TO TAFT STREET AND STATE ROAD NO. 7 A DEDICATED PUBLIC STREET AS SHOWN ON PLAT BOOK 2, PAGE 2, SAME BEING PAVED AND DEDICATED PUBLIC ROADWAYS MAINTAINED BY THE CITY OF HOLLYWOOD, BROWARD COUNTY, FLORIDA.
- 14. THERE ARE 9 STRIPED PARKING SPACES INCLUDING 1 HANDICAP SPACE ON THE PROPERTY.
- 15. THERE IS NO OBSERVED EVIDENCE OF CURRENT EARTH MOVING WORK, BUILDING CONSTRUCTION OR BUILDING ADDITIONS AT THE PROPERTY.
- 16. THERE IS NO PROPOSED CHANGES IN STREET RIGHT OF WAY LINES AFFECTING THE PROPERTY, ACCORDING TO BROWARD COUNTY, FLORIDA.
- 17. THERE IS NO OBSERVED EVIDENCE OF RECENT STREET OR SIDEWALK CONSTRUCTION OR REPAIRS AFFECTING THE PROPERTY.
- 18. THERE IS NO OBSERVED EVIDENCE OF USE OF THE PROPERTY AS A SOLID WASTE DUMP, SUMP OR SANITARY LANDFILL.

SURVEYOR'S CERTIFICATION

THIS IS TO CERTIFY THAT THIS MAP OR PLAT AND THE SURVEY ON WHICH IT IS BASED WERE MADE IN ACCORDANCE WITH THE "2016 MINIMUM STANDARD DETAIL REQUIREMENTS FOR ALTA/NSPS LAND TITLE SURVEYS," JOINTLY ESTABLISHED AND ADOPTED BY ALTA AND NSPS, AND INCLUDES ITEMS 1, 2, 3, 4, 6(A), 6(B) (NONE SUPPLIED), 7(A), 7(B), 7(C), 8, 9, 10(A), 11, 13, 14, 16, 17, 18 AND 19 (NONE DISCLOSED) OF TABLE A THEREOF. PURSUANT TO THE ACCURACY STANDARDS AS ADOPTED BY ALTA AND NSPS AND IN EFFECT ON THE DATE OF THIS CERTIFICATION, UNDERSIGNED FURTHER CERTIFIES THAT IN MY PROFESSIONAL OPINION, AS A LAND SURVEYOR REGISTERED IN THE STATE OF FLORIDA, THE RELATIVE POSITIONAL ACCURACY OF THIS SURVEY DOES NOT EXCEED THAT WHICH IS SPECIFIED THEREIN. THE FIELD WORK WAS COMPLETED ON APRIL 12, 2019.

PROFESSIONAL SURVEYOR AND MAPPER

COUSINS SURVEYORS & ASSOCIATES, INC.

DAVIE, FLORIDA 33314 CERTIFICATE OF AUTHORIZATION: LB # 6448

PHONE (954) 689-7766 FAX (954) 689-7799

NICK ROTUNNO

HOLLYWOOD, FLORIDA 33021

ALTA/NSPS LAND TITLE SURVEY

DATE | FB/PG | DWN | CKD 04/12/19 SKETCH AM REC 05/28/19 SKETCH AM REC ADDED O/E FILE NO.

PROJECT NUMBER: 8954-1

SCALE : 1" = 16'


FLORIDA REGISTRATION No. 4188.

## **NOTES**

- 1. METHOD OF MAIL DELIVERY U.S. POSTAL SERVICE HAND DELIVERED.
- 2. MAXIMUM FOOT CANDLE LEVEL AT ALL PROPERTY LINES TO BE 0.5.
- 3. THIS PROJECT SHALL INCORPORATE THE FOLLOWING GREEN PRACTICES:
- A. ELECTRIC CAR CHARGING STATIONS
- B. BIKE RACK C. CENTRAL AIR CONDITIONER 18 SEER OR HIGHER
- D. ENERGY STAR APPROVED DOORS
  E. PROGRAMMABLE THERMOSTATS
- F. OCCUPANCY / VACANCY SENSORS
- F. OCCUPANCY / VACANCY SENSORS
  G. ENERGY STAR APPROVED ROOFING
- H. DUAL FLUSH TOILETS
  I. ENERGY EFFICIENT OUTDOOR LIGHTING, FULLY SHIELDED AND MEETING THE REQUIREMENTS
- OF THE INTERNATIONAL DARK SKY ASSOCIATION.

  J. RECYCLING CONTAINERS.
- 4. MATERIALS FROM DEMOLITION OF EXISTING STRUCTURES AND FROM CONSTRUCTION WASTE SHALL BE RECYCLED.
- 5. AN EFFORT SHALL BE MADE TO INCORPORATE SUSTAINABLE BUILDING
- MATERIALS TO THE PROJECT.

  6. LOW VOC MATERIALS SHALL BE SELECTED.
- 7. ENERGY EFFICIENT LIGHT FIXTURES, ENERGY STAR OR WATER SENSE CERTIFIED APPLIANCES AND
- PROGRAMMABLE THERMOSTATS SHALL BE INSTALLED AS APPLICABLE.

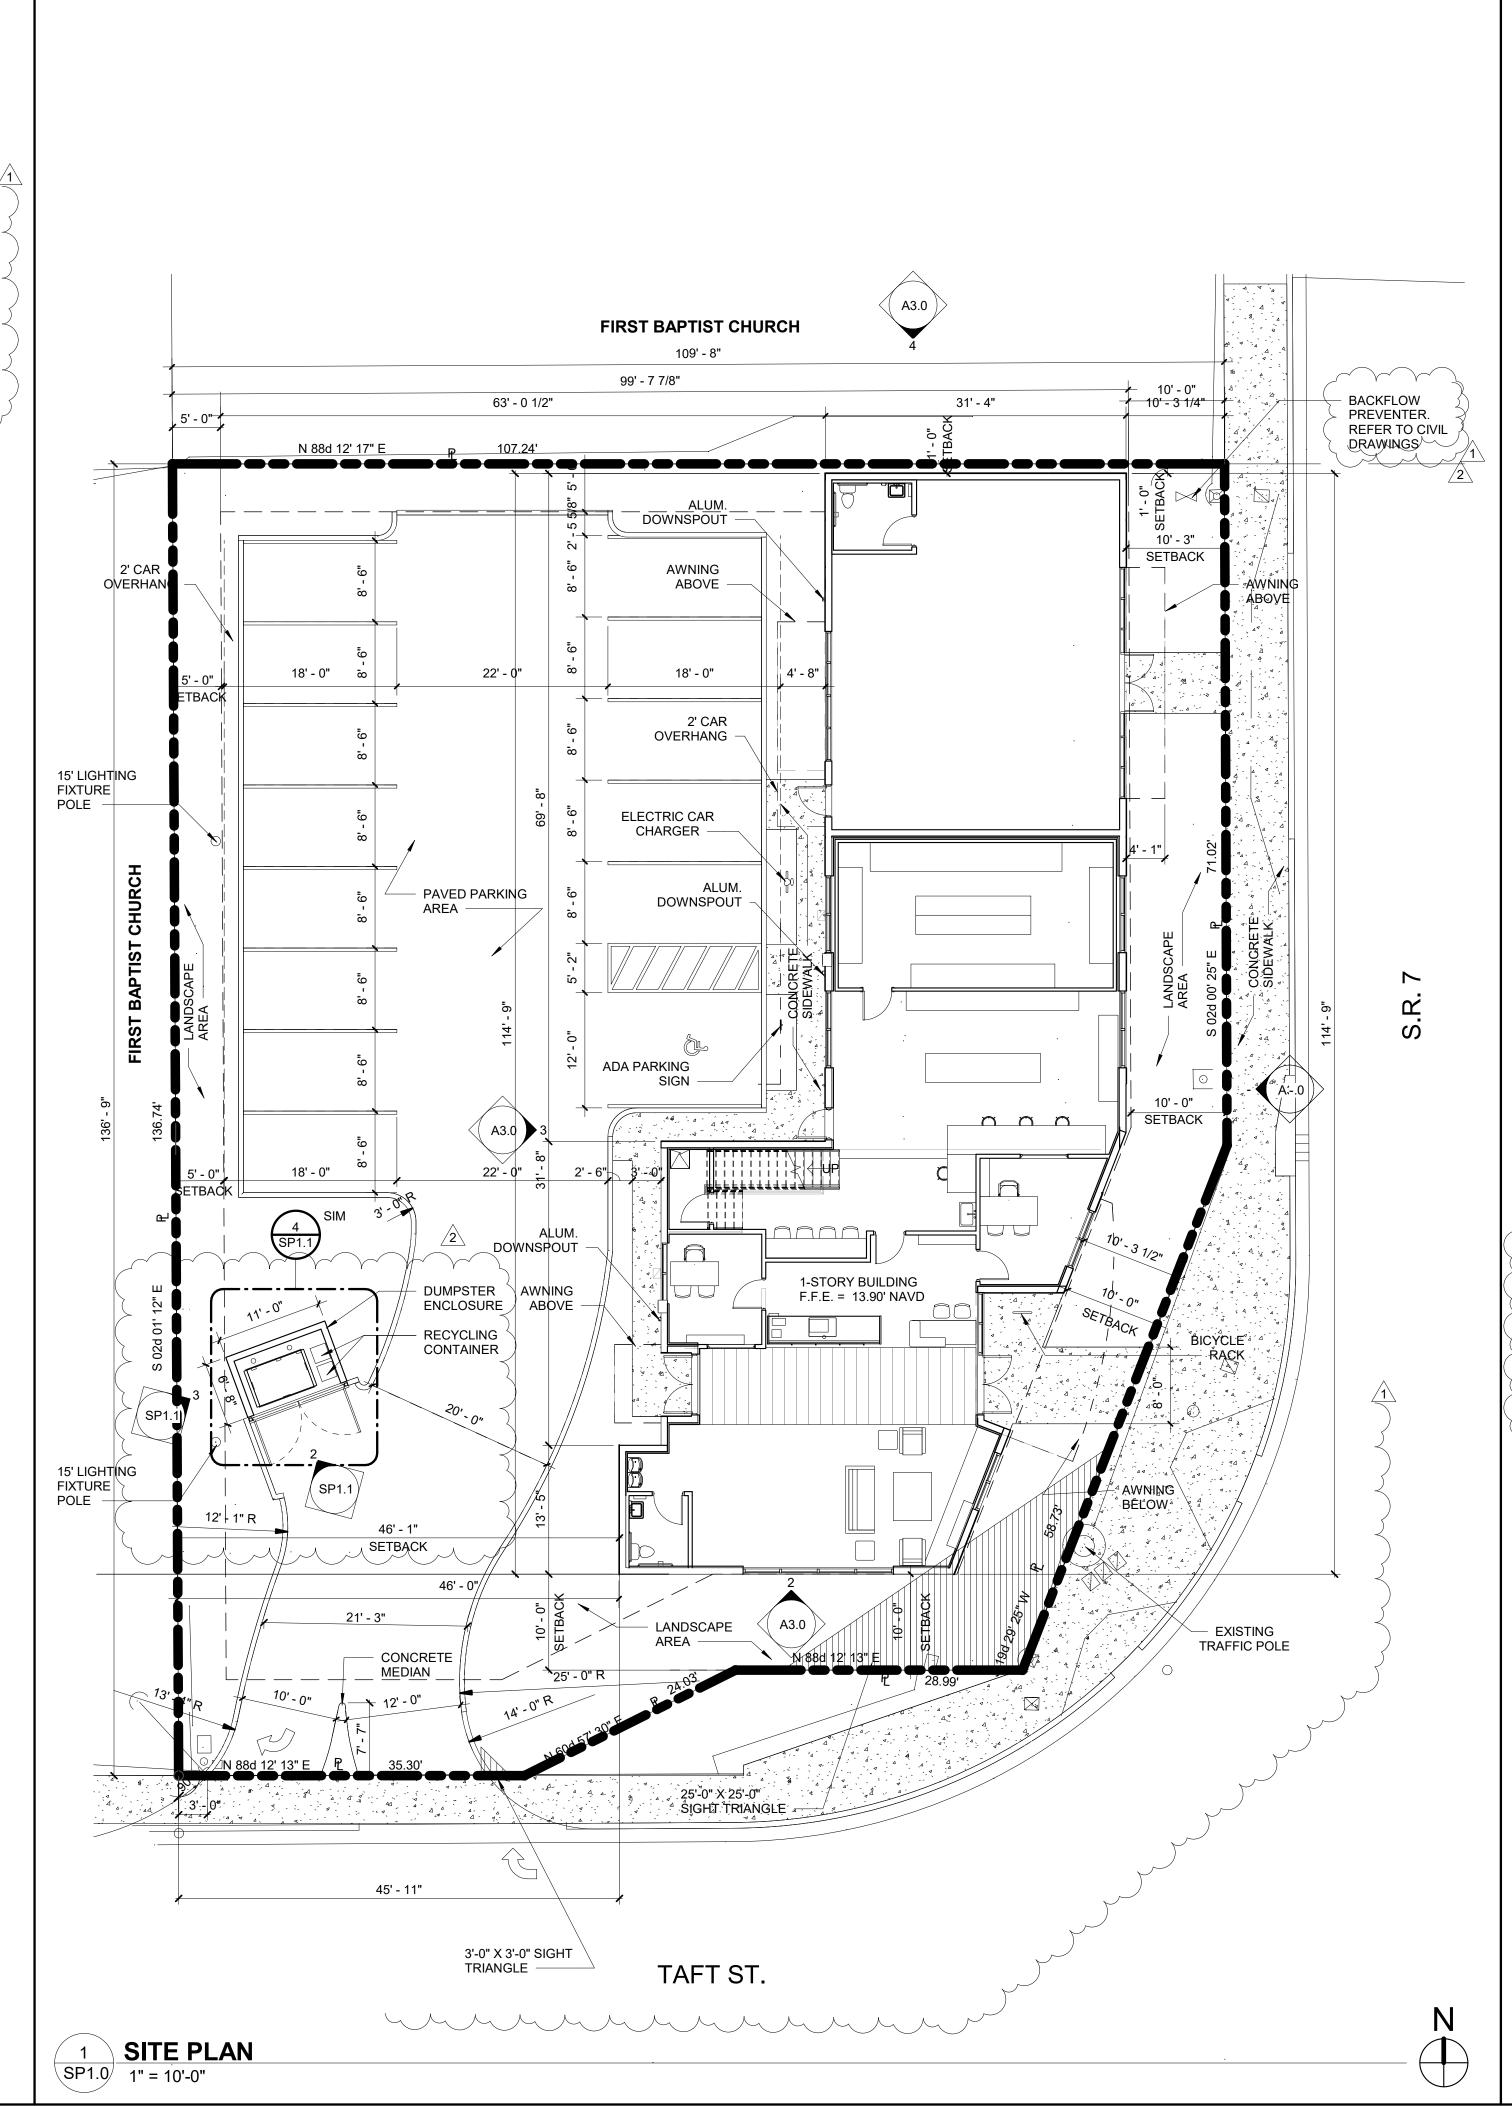

## SITE DATA

#### **LEGAL DESCRIPTION**

LOTS 28 AND 29, LESS THE SOUTH 20.00 FEET THEREOF, LOT 30, LESS THE SOUTH 20.00 FEET THEREOF, AND LESS THE EAST 38.00 FEET THEREOF, ALL OF THE TOWNSITE IN BENDLE'S SUBDIVISION OF THE N.W. 1/4 OF SECTION 12, TOWNSHIP 51 SOUTH, RANGE 41 EAST, ACCORDING TO THE PLAT THEREOF RECORDED IN PLAT BOOK 2 AT PAGE 2 OF THE PUBLIC RECORDS OF BROWARD COUNTY, FLORIDA, AND LESS THAT PORTION THEREOF DESCRIBED AS FOLLOWS;

COMMENCE AT THE CENTER OF SECTION 12, TOWNSHIP 51 SOUTH, RANGE 41 EAST;

THENCE RUN ON AN ASSUMED BEARING OF SOUTH 88.10'07" WEST ALONG THE SOUTH LINE OF THE N.W 1/4 OF SAID SECTION 12 FOR 191.17 FEET TO AN INTERSECTION WITH THE SOUTHERLY EXTENSION OF THE WEST LINE OF THE AFOREMENTIONED LOT 28:

THENCE, RUN NORTH 2.06'05' WEST ALONG THE LAST DESCRIBED SOUTHERLY EXTENSION FOR 35.00 FEET TO THE POINT OF BEGINNING OF THE HEREIN DESCRIBED PARCEL;

THENCE, CONTINUED NORTH 2.06'05" WEST ALONG THE WEST LINE OF LOT 28 FOR 6.00 FEET;

THENCE RUN NORTH 88.10'07" EAST FOR 36.04 FEET.

THENCE RUN NORTH 61.36'13" EAST FOR 24.60 FEET.

THENCE RUN NORTH 88.10'07" EAST FOR 45.01 FEET TO THE POINT OF CURVATURE OF A CIRCULAR CURVE CONCAVE TO THE NORTHWEST:

THENCE RUN EASTERLY, NORTHEASTERLY, AND NORTHERLY ALONG THE ARC OF SAID CURVE HAVING FOR ITS ELEMENTS A RADIUS OF 35.00 FEET AND A CENTRAL ANGLE OF 90,12'36', FOR 55.11.FEET;

THENCE RUN SOUTH 2.02'29" EAST ALONG THE WESTERLY RIGHT-OF-WAY LINE OF U.S. 441 PER OFFICIAL RECORDS BOOK 3442, PAGE 273, OF THE PUBLIC RECORDS OF BROWARD COUNTY, FLORIDA, (THE SAME BEING A LINE 53.00 FEET WESTERLY OF AND PARALLEL TO THE EAST LINE OF THE SAID N.W. 1/4 OF SECTION 12) FOR 52.13 FEET:

THENCE RUN SOUTH 88.10'07" WEST ALONG A LINE 35.00 FEET NORTHERLY OF AND PARALLEL TO THE SOUTH LINE OF THE N.W. 1/4 OF SECTION 12 FOR 138.21 FEET TO THE POINT OF BEGINNING.

ALSO LESS ORDER OF TAKING PER INSTRUMENT # 112476379, BROWARD COUNTY, FLORIDA RECORDS.

SITUATE, LYING AND BEING IN THE CITY OF HOLLYWOOD, BROWARD COUNTY, FLORIDA

LAND USE	TOC
ZONING	C-MU
<u>USE</u>	COMMERCIAL/RETAIL BUILDING
SETBACKS	

#### <u>SETBACKS</u>

FOR VEHICULAR USE AREAS:

	REQUIRED	PROVIDED
FRONT	10'-0"	N/A
INTERIOR	5'-0"	5'-0"
REAR	5'-0"	5'-0"

% REQ.

#### FOR STRUCTURES:

	REQUIRED	PROVIDED
FRONT (EAST)	10'-0"	10'-3"
FRONT (SOUTH)	10'-0"	10'-0"
INTERIOR (NORTH)	0'-0"	1'-0"
INTERIOR (WEST)	5'-0"	46'-1"
•		Ź

#### TOTAL SITE AREA

SITE AREAS

EXISTING BUILDING			
EXISTING BUILDING	6,842	0.16	50%
EXISTING V.U.A.	4,458	0.10	33%
EXSTING SIDEWALKS	1,628	0.04	12%
EXISTING IMPERVIOUS	12,928	0.30	95% _
EXISTING PERVIOUS	781	0.01	<b>5</b> %
PROPOSED BUILDING			Ś

# BUILDING FOOTPRINT 3,914 0.09 29% ASPHALT AREA 5,256 0.14 38%

ASPHALT AREA SIDEWALKS		5,256 569	0.14 0.01	38% 4%
TOTAL IMPERVIOUS		9,739	0.24	71%
VEHICULAR USE AREA (V.UA)		6,020		
V.U.A LANDSCAPE AREA (EXC. PERIMETER) NON V.U.A LANDS.	25% OF VUA 1,505	1,505 559	0.03	25% OF VUA 11% 4%

TOTAL PERVIOUS
MIN 5% OF SITE

(EXC. PERIMETER)
5' PERIMETER LANDS

<b>ACTIVE USE</b>	1	1
	REQUIRED	PROVIDED
S.R. 7 GROUND FL.	60%	99%
TAFT ST. GROUND FL.	40%	43%

#### **BUILDING HEIGHT**

## PARKING CALCULATIONS

#### PARKING REQUIRED

NEW BUILDING

I ARRIVO REGUITED	and the second s	1
AL'S FLORIST		
GROUND FLOOR - RETAIL 1/250	2,173 NET SQ. FT./250	9
MEZZANINE / COOLER - STORAGE	1,152 NET SQ. FT./1,000	1
VACANT RETAIL BAY	1,174 NET SQ. FT./250	4
TOTAL PARKING	SPACES REQUIRED	14
REGULAR PARKING SPACES PROVID	DED	13

# ACCESSIBLE PARKING SPACES PROVIDED TOTAL PARKING SPACES PROVIDED

**BREAKDOWN OF COMMON AREAS** 

RESTROOMS/JANITOR	195 GROSS SQ. FT.
COMMERCIAL AREA	3,719 GROSS SQ. FT.

TOTAL GROSS 3,914 GROSS SQ. FT.

# SALTZ MICHELSON ARCHITECTS

**FLORIST** 

3501 Griffin Road Ft. Lauderdale, FL 33312 (954) 266-2700 Fx:(954) 266-2701 sma@saltzmichelson.com

AA-0002897

Charles Michelson AR0009976

Project No. : 2017-186 Drawn By :


Checked By MG

Date 07.01.19

REVISIONS

1 07.01.19 TAC COMMENTS 2 08.15.19 TAC COMMENTS

SP1.0

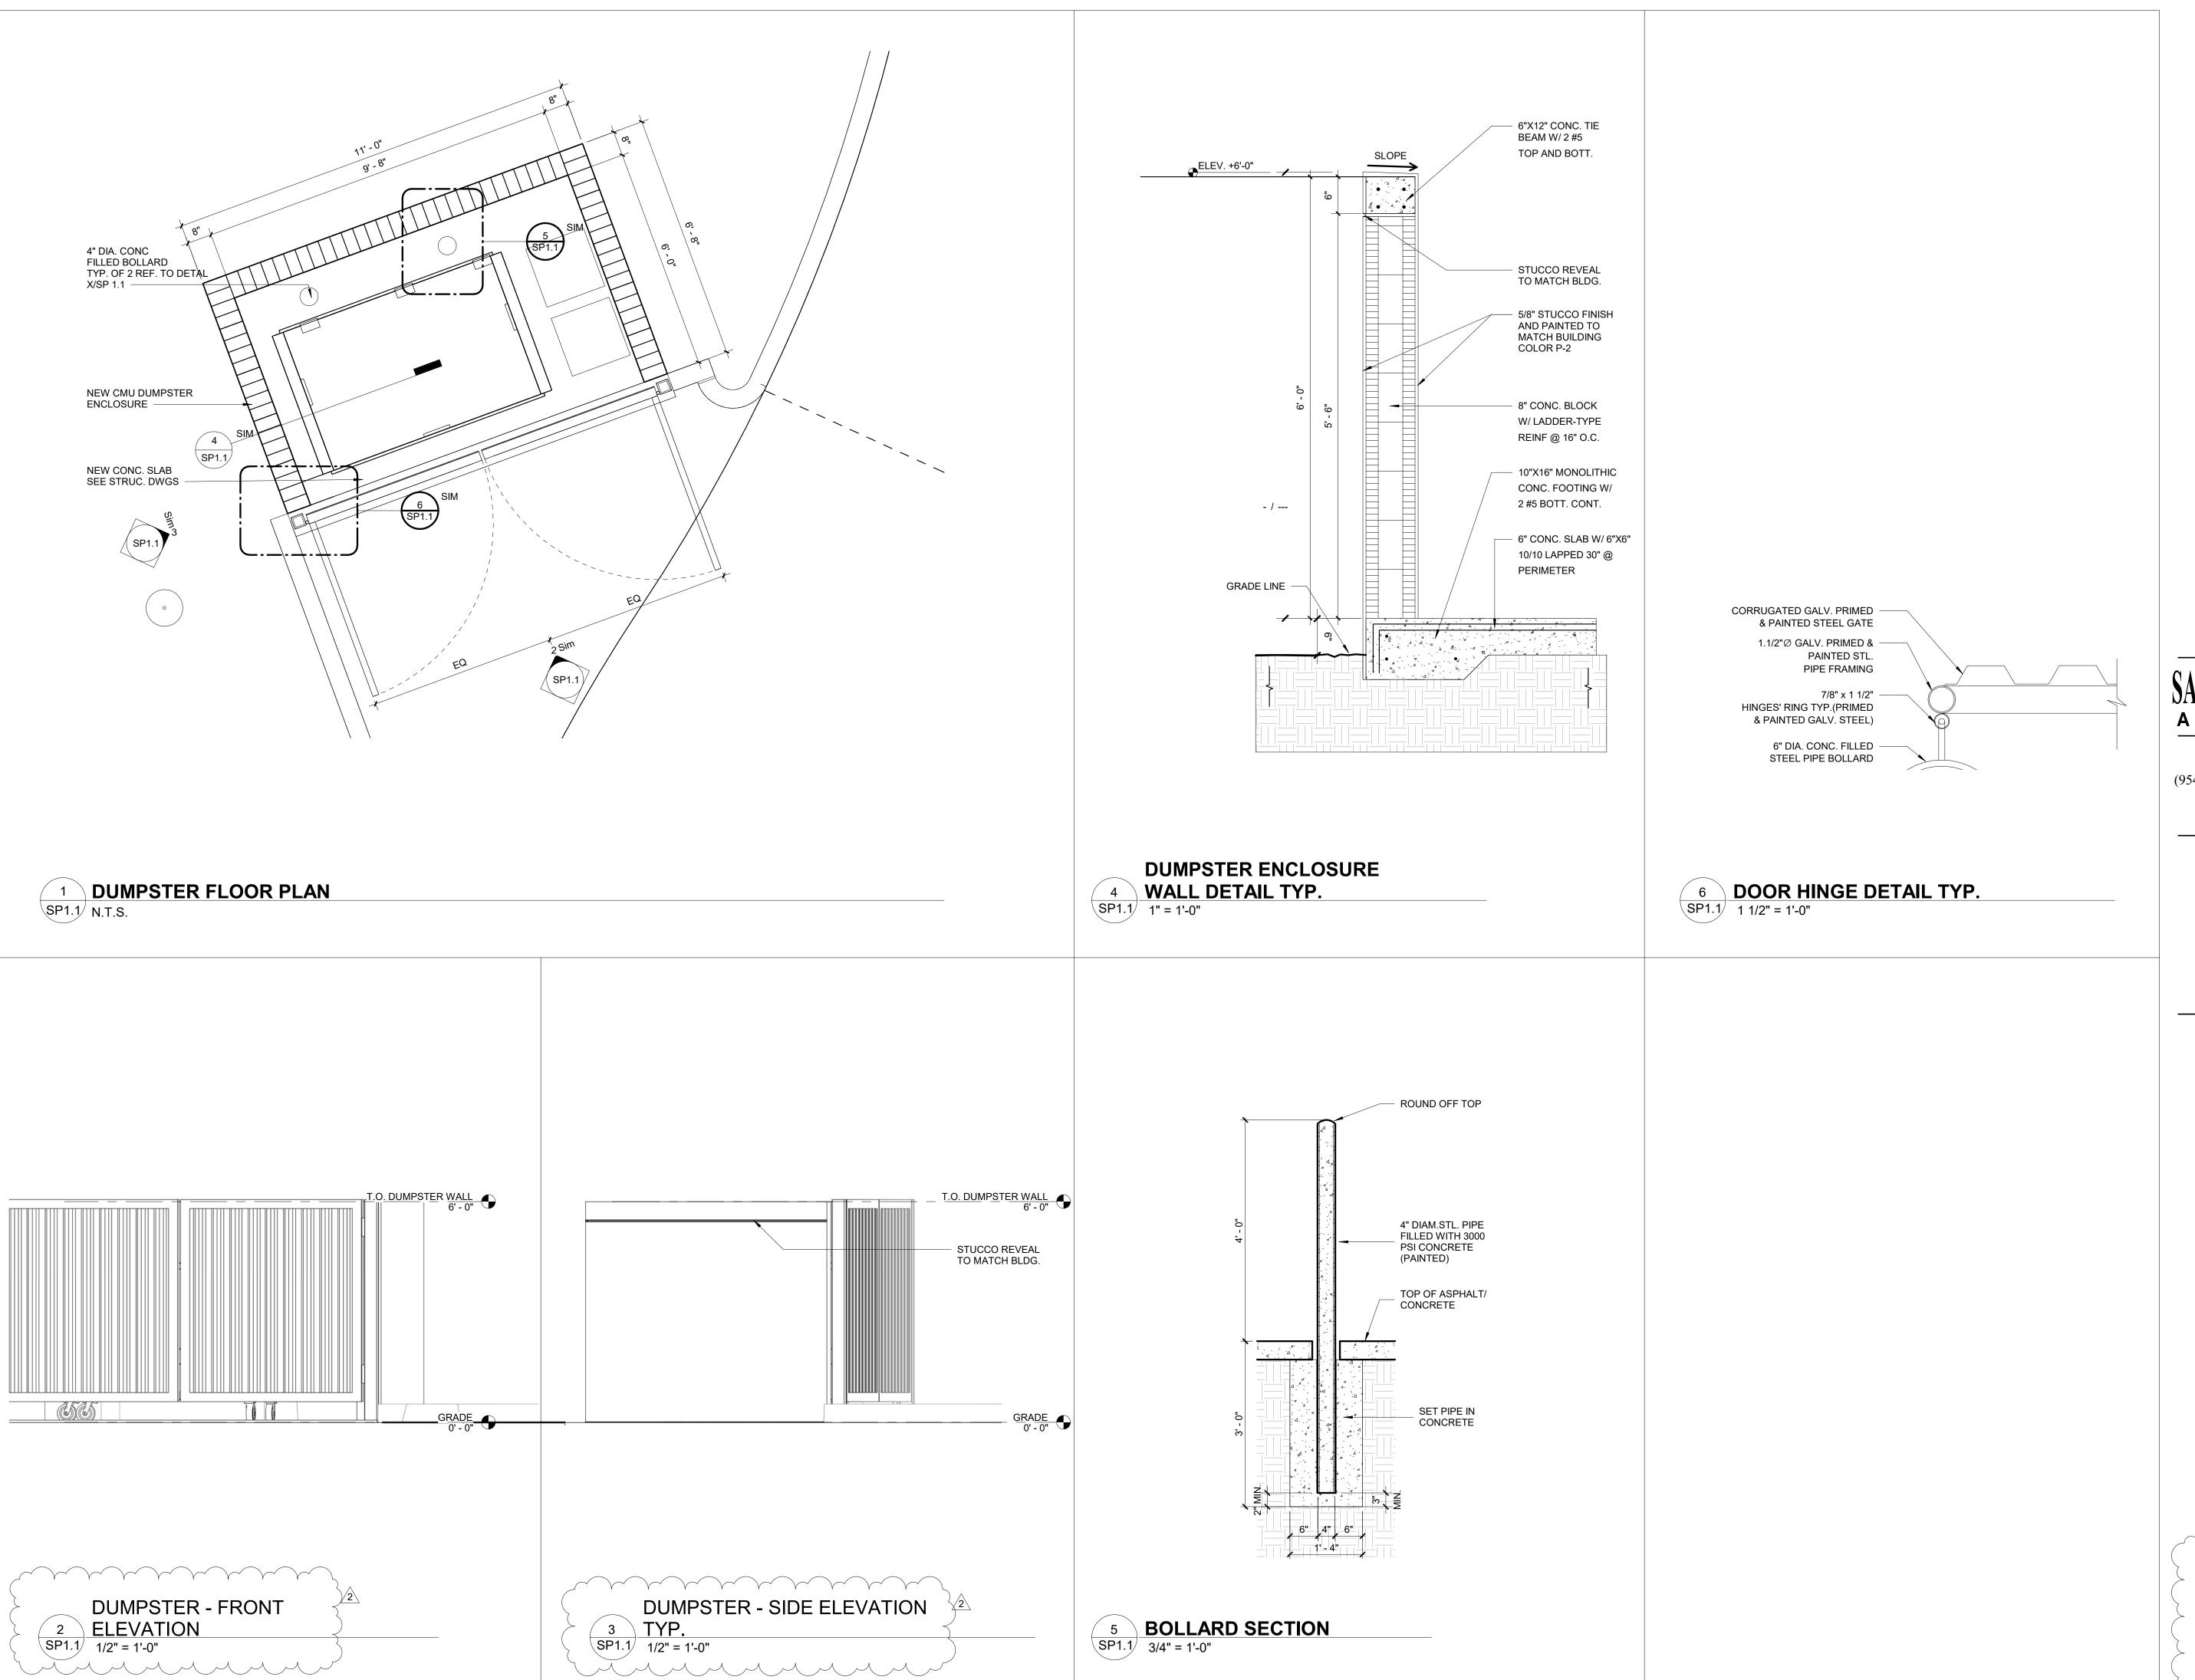

IL'S PLORISI

SALTZ MICHELSON ARCHITECTS

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Project No. : 2017-186

Drawn By : AA Checked By : CM

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REVISIONS

1 07.01.19 TAC COMMENTS 2 08.15.19 TAC COMMENTS

-186\_RETAIL BUILDING AT


**SP1.1** 

#### PLANT SCHEDULE

TREES	CODE	<u>aty</u>	BOTANICAL NAME	COMMON NAME
(·)	ВА	6	Bulnesia arborea	Veranood
Market Market State of the Stat	ED	4	Elaeocarpus decipiens	Japanese Blueberry
	LN	9	Lagerstroemia 'Natchez'	White Crape Myrtle
PALMS	CODE	<u>aty</u>	BOTANICAL NAME	COMMON NAME
*	SP	6	Sabal palmetto	Sabal Palm
SHRUBS	CODE	<u>aty</u>	BOTANICAL NAME	COMMON NAME
•	ACA	17	Acalypha wilkesiana	Red Copperleaf
AND TO STATE OF THE PERSON OF	CAP2	4	Capparis cynophallophora	Jamaica Caper
<u>VINES</u>	CODE	<u>aty</u>	BOTANICAL NAME	COMMON NAME
$\triangle$	FP	3	Ficus pumila	Creeping Fig
$\triangle$	LT	6	Trachelospermum jasminoides 'Confederate'	Confederate Jasmine
SHRUB AREAS	CODE	<u>aty</u>	BOTANICAL NAME	COMMON NAME
	HAP	35	Hamelia patens 'Compacta'	Dwarf Fire Bush
	MUC	<i>6</i> 5	Muhlenbergia capillaris	Pink Muhly
	POD	16	Podocarpus macrophyllus maki	Maki Podocarpus
	SCH	39	Schefflera arboricola	Green Schefflera
GROUND COVERS	CODE	<u>aty</u>	BOTANICAL NAME	COMMON NAME
	FIM	383	Ficus microcarpa 'Green Island'	Green Island Ficus
	SOD	1,772 sf	Stenotaphrum secundatum	St. Augustine Grass

#### NOTES

- I. SEE SHEET LP-3 FOR A DETAILED PLANT LIST AND LANDSCAPE CODE REQUIREMENTS & CALCULATIONS.
- 2. IRRIGATION SYSTEM SHALL PROVIDE 100% COVER WITH 50% OVERLAP.
- 3. ALL ROAD ROCK, CONCRETE, ASPHALT AND OTHER NON-NATURAL MATERIALS TO BE REMOVED FROM ALL PLANTING AREAS PRIOR TO LANDSCAPE INSTALLATION.
- 4. SEE SHEET LP-2 FOR LANDSCAPE INSTALLATION DETAILS & ADDITIONAL NOTES.
- 5. MITIGATION FOR 3 CHRISTMAS PALMS TO BE REMOVED SHALL BE PROVIDED ON SITE SEE LANDSCAPE DATA TABLE ON SHEET LP-3.

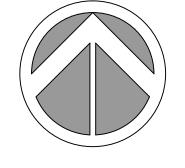

0 5 10 20 SCALE: 1" = 10' 1700 S.R. 7

Sheet Title
LANDSCAPE
PLAN

Revision Dates 8.14.19 REVISED PER STAFF COMMENTS


Date
JUNE 2019

Sheet Number

JILL COHEN 8.14.19 LA1600

19-0524

# (2" cal. and over) LARGE TREE PLANTING DETAIL

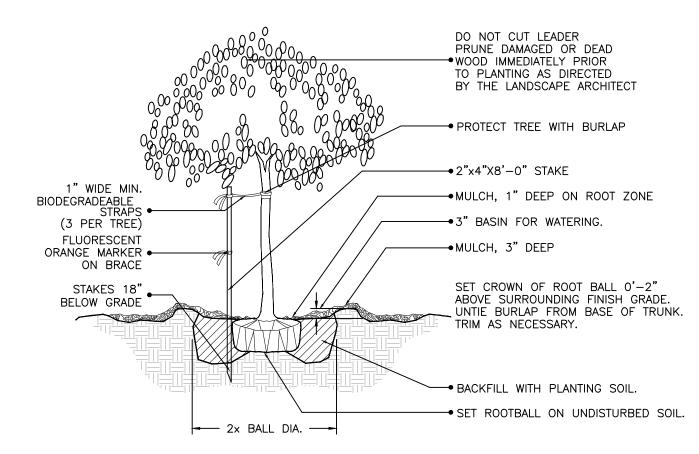

# (2" cal. and under) SMALL TREE PLANTING DETAIL

#### **GENERAL NOTES:**

I. PLANT MATERIAL: <u>All plant material shall be Florida #1 or better</u> as established by "Grades and Standards for Nursery Plants" of the state of Florida, Department of Agriculture.

2. All trees, shrubs and groundcovers shall be of the sizes as specified in the Plant List.

3. Quantities listed on the the Plant List are for estimating purposes. Contractor shall verify all quantities. Mulch, topsoil, fertilizer, etc. shall be included in the unit cost of the plants.

4. Where there is a discrepancy either in quantities, plant names, sizes or specifications between the plan or plant list, the plan takes precedence.

5. All planting beds and water basins for trees shall be covered with a 3" minimum depth of shredded

eucalyptus or florimulch grade 'B' or better.

6. The Planting Plan shall be installed in compliance with all existing codes and applicable deed restrictions.

7. SOD: All areas not used for buildings, vehicular use areas, walks or planting beds shall be grassed.

Grassing shall extend to any abutting street pavement edge and to the mean waterline of any abutting canal, lake or material.

8. PLANTING SOIL: All trees and shrubs shall be planted with a minimum of 12" topsoil around and beneath the rootball. Minimum topsoil shall be 6" for groundcover areas and 2" for sodded grass areas.

9. Planting soil to be a weed-free mixture of 50% sand, 40% muck, and 10% Canadian peat. All plant material to receive planting soil as per details.

10. Contractor is responsible for determining all utility locations and installing facilities so as to not conflict.

All damage to existing utilities or improvements caused by Contractor shall be repaired at no additional

II. Contractor to notify "Sunshine State One Call of Florida, Inc." at 1-800-432-4770 Two Full Business Days prior to diaging for underground utility locations.

prior to digging for underground utility locations.

12. Contractor shall be responsible for providing final grading of all associated planting areas.

13. After final grade, area to be raked to 6" depth and all rock and foreign inorganic materials removed and disposed of properly off-site.

14. All planting holes to be hand dug except where machine dug holes will not adversely affect or damage utilities or improvements (see note 8).


15. No plunging of any tree or palm will be accepted. All plants to be planted at the nursery grade or slightly higher.

l6. Contractor shall stake 4 guy all trees and palms at time of planting as per the appropriate detail.


Contractor is responsible for the maintenance and/or repair of all staking and guying during warranty period and removal 4 disposal of staking after establishment period.

17. Fertilizer for grass areas shall be NPK 16-4-8 @ 12.5 lbs/1000 s.f. or 545 lbs/acre. Nitrogen 50% slow release form & fertilizer to include secondary micronutrients.

18. SUBSTITUTIONS AND CHANGES: All substitutions and changes shall be approved in writing prior to installation. Any discrepancies between plans, site and specifications shall be brought to the immediate attention of the Landscape Architect, the owner and governing municipality.

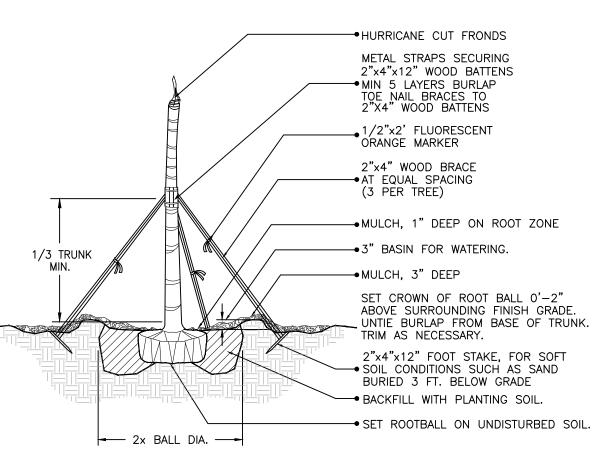

# CIGARED SABAL PALM PLANTING DETAIL

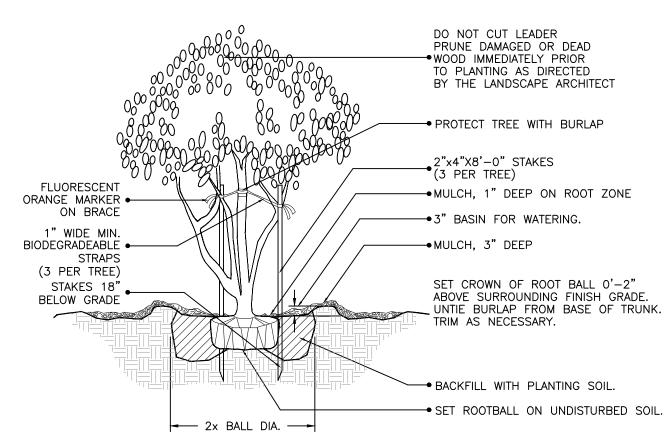

# MULTI- TRUNK AND SMALL TREE (2" cal. and under) PLANTING DETAIL

19. WATERING: All plant material shall be watered in at time of planting in accordance with standard nursery practices. In addition, Contractor will continue watering of plant material until substantial completion and as needed thereafter for a period of 2 months.

20. All new plant material shall be guaranteed for I year from time of final acceptance of project. Any plant material not in a healthy growing condition will be replaced by the Contractor at no additional cost to the Owner within IO days of notification. For all replacement plant material, the warranty period shall be extended an additional 45 days beyond the original warranty period. All trees that lean or are blown over, caused by winds less than 15 mph, will be re-set and braced by the Contractor at no additional cost to the Owner.

21. The successful bidder shall furnish to the Owner a unit price breakdown for all materials. The Owner may, at its discretion, add or delete from the materials utilizing the unit price breakdown submitted.

22. No plant material will be accepted showing evidence of cable, chain marks, equipment scars, or otherwise damaged.

23. Plant material will not be accepted when the ball of earth surrounding its roots has been cracked, broken

or otherwise damaged.

24. Root-prune all trees a minimum of (8) weeks prior to planting.

25. All landscaped areas will be irrigated by an underground, automatic, rust-free irrigation system providing 100% coverage and 100% spray overlap. The system shall be maintained in good working order and designed to minimize water on impervious services and not overspray walkways. A rain sensor device shall be installed to override the irrigation cycle of the system when adequate rainfall has occurred.

26. All plant material planted within the sight distance triangle areas (see plan) shall provide unobstructed cross-visibility at a horizontal level between 30 inches and 8 feet above adjacent street grade.

27. No canopy trees shall be planted within 12 feet of a light pole. No palm species shall be planted within 6 feet of a light pole.

28. Ground cover plantings shall provide not less than 50 percent coverage immediately upon planting and 100 percent coverage within 6 months after planting.

29. Tree protection barricades shall be provided by Landscape Contractor around existing trees that may be impacted by the proposed construction. Prior to any construction a tree protection barricade inspection shall be conducted by the landscape architect, owner or governing municipality. Refer to landscape detail for tree preservation barricade fencing.

30. In all pedestrian areas, all trees and palms shall be maintained to allow for clear passage at an 8 foot


31. All landscape material shall be setback a minimum of 10' from any Fire Hydrant.

32. All exotic invasive trees to be removed from site prior to installation of new plantings.

33. All hedges abutting City right-of way to be maintained at height no greater than 24".

34. For all container-grown trees, shave periphery of rootball and correct any circling roots with radial slices.

35. All strapping materials attached to trunk of tree to be biodegradable.

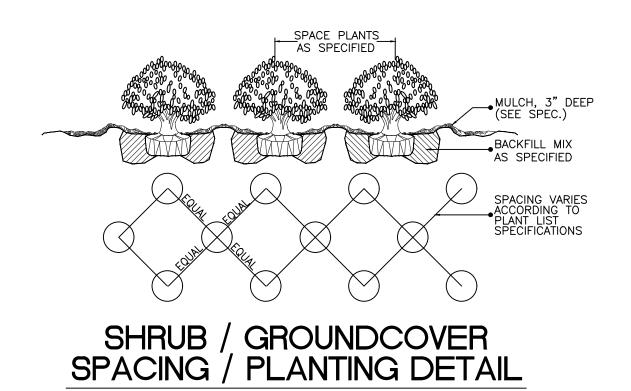

MULCH, 1" DEEP ON ROOT ZONE

3" BASIN FOR WATERING.

MULCH, 3" DEEP

SET CROWN OF ROOT BALL 0'-1"
ABOVE SURROUNDING FINISH GRADE.

PLANT MATERIAL SHALL NOT BE
PRUNED PRIOR TO INSTALLATION.
AFTER PLANTS HAVE BEEN INSTALLED,
EACH PLANT SHALL BE PRUNED
FOR UNIFORMITY.

BACKFILL WITH PLANTING SOIL.

SET ROOTBALL ON UNDISTURBED SOIL.

SHRUB PLANTING DETAIL

**H**1700 S.R. 7

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LANDSCAPE
DETAILS &
NOTES

NOTES

Revision Dates

Date
JUNE 2019

Sheet Number  $ext{LP-2}$ 



8.14.19 LA1600

3.4	NATIVE PLANT REQUIREMENT		REQUIRED	PROVIDED
	1. 60% OF REQUIRED TREES/F 20 TREES REQUIRED	PALMS MUST BE NATIVE SPECIES	I 2 NATIVE TREES	6 NATIVE PALMS \$ I 9 TREES
	2. 50% OF REQUIRED SHRUE 176 SHRUBS PROVIDED	S MUST BE NATIVE SPECIES  (VINES & GROUNDCOVER EXCLUDED)	88 NATIVE SHRUBS	I 02 NATIVE SHRUBS

3.5	USING PALMS TO FULFILL TREE REQUIREMENTS	REQUIRED	PROVIDED
	I. MAXIMUM OF 50% OF THE REQUIRED TREES MAY BE PALMS IO @ 3:I	30 MAX	6 PALMS

MITIGATION REQUIREMENTS	REQUIRED	PROVIDED
3 PALMS REMOVED IN TREE DISPOSITION PLAN	3 PALMS (1:1)	3 PALMS

#### PLANT SCHEDULE

ED 4 Eleacorpus desprene Japanese Blueserry 12' adn. 5td 8' clear, no volate Drought To Lin 4 Lagarstroemia Natches' Phile Grace Myrtile 12' can. 2' callstd. Full symmetrical hoods Drought To Common Name Size Common Name Native & Drought To Shall Parm 8' ct Straight Trunk Native & Drought To Shall Parm 8' ct Common Name Size Common Name Native & Drought To Shall Parm 8' ct Common Name Native & Drought To Native & Drought T								
ED 4 Elacocarpue disciplare  Lin 9 Lagerstroemia Nacinez**  White Crope Myritis 12 can, 2* cal sto.  Full symmetrical heade Drought To  Lin 9 Lagerstroemia Nacinez**  White Crope Myritis 12 can, 2* cal sto.  Full symmetrical heade Drought To  SP 6 Sobol polimetro  ACA 1**  ACA 1*	TREES	CODE	<u>aty</u>	BOTANICAL NAME	COMMON NAME	<u>SIZE</u>	<u>COMMENTS</u>	<u>NATIVE</u>
LN 8 Lagerstroemia Nosches* Mitte Crape Myrtie 12* och; 3* celletd. Full symmetrical needs Drought To  PALMS CODE GIY BOTANICA. NAME COMMON NAME SIZE COMMENTS NATIVE  SP 6 Saba pairetto Sacal Pain 9* ct Straight Trunk Native 8.72  SHRIBG CODE GIY. BOTANICA. NAME COMMON NAME SIZE COMMENTS NATIVE  ACA 17 Acalysta mikestera Real Coopenical* 24* x 24* Full, Bright Real Drought To  CAP2 4 Capparts cynophal ophora Jamaica Capen 4* ooh Full to base Native 8.72  VINES CODE GIY. BOTANICA. NAME COMMON NAME SIZE COMMENTS NATIVE  AT TJ 6 Troche isopermum jasminoides "Confederate" Cresping Fig 3 gal. 5 Rumans min Drought To  SHRIB AREAS CODE GIY BOTANICA. NAME COMMON NAME SIZE COMMENTS NATIVE  SHRIB AREAS CODE GIY BOTANICA. NAME COMMON NAME SIZE COMMENTS NATIVE  HAP 35 Hamelta patiens (Campacta) Dwarf Fire Bush 24* X 8* Staggered 50* oc Native 8.72  MIC 65 Muhlerbergio copillaris Fink Muhly 20* x 20*, full Staggered 24* oc Native 8.72  FOD 16 Padacarpus macrophyllus maki Maki Padacarpus 24* X 8* Staggered 24* oc Drought To  GROUND COVERS CODE GIY BOTANICA. NAME COMMON NAME SIZE COMMENTS Native 8.72  GROUND COVERS CODE GIY BOTANICA. NAME COMMON NAME SIZE COMMENTS Native 8.72  GROUND COVERS CODE GIY BOTANICA. NAME Green Scheff erra 20* x 20*, full Staggered 24* oc Drought To  GROUND COVERS CODE GIY BOTANICA. NAME COMMON NAME SIZE COMMENTS NATIVE  GROUND COVERS CODE GIY BOTANICA. NAME COMMON NAME SIZE COMMENTS NATIVE  GROUND COVERS CODE GIY BOTANICA. NAME COMMON NAME SIZE COMMENTS NATIVE  GROUND COVERS CODE GIY BOTANICA. NAME COMMON NAME SIZE COMMENTS NATIVE  GROUND COVERS CODE GIY BOTANICA. NAME COMMON NAME SIZE COMMENTANE SIZE COMMENTANE SIZE COMMENTS NATIVE  FIN BBS Fice microcarpa Green Island* Green Island Fice Bush Full 8 well branched Staggered 18* oc Drought To	<b>b</b> 2	ВА	6	Bulnesia arborea	Verawood	12' oah, min.	Full symmetrical canopy	Drought Tolerant
LN 9 Lagerethoem's Notchest White Crape Myrtle 12' och, 3' colletel. Full symmetrical needs Drought To SALMS GODE GTY BOTANICAL NAME GOMMON NAME SIZE GOMMON TITLE STRUCK NATIVE STRUCK SP 6 Sabal points to Sabal Polin 9' ct Straight Trunk Native size STRUBS GODE GTY BOTANICAL NAME GOMMON NAME SIZE GOMMON TITLE GOMMON		ED	4	Elaeocarpus decipiens	Japanese Blueberry	12' oah, Std	3' clear, no voids	Drought Tolerant
## SP 6 Sabal paintesto Sabal Palm 8 ct Straight Trunk Native 1 Depart of the Straight Trunk Native 1 Departs of the Straight Trunk Native 1 Departs of the Straight Trunk Native 1 Departs of the Straight Native 1 Departs of the St	7 3	LN	9	Lagerstroemia 'Natchez'	White Crape Myrtle	12' oah, 2" cal std.	Full symmetrical heads	Drought Tolerant
STREES CODE GTY BOTANICAL NAME COMMON NAME SIZE COMMENTS NATIVE  ACA IT Acalighta mikesiana Real Copperisoft 24" x 24" Full, Bright Real Drought To CAP2 4 Capper's cynophaliaphora Jamaica Caper 4" can Full to asse Notive 4" D VINES GODE GTY BOTANICAL NAME COMMON NAME SIZE COMMENTS NATIVE  FP 3 Ficus oumila Cresoning Fig 9 gal. 5 Rumers min Drought To Cresoning Fig 9 gal. 5 Rumers min Drought To CAPA STANDARD SIZE COMMENTS NATIVE  SHRUB AREAS CODE GTY BOTANICAL NAME COMMON NAME SIZE COMMENTS NATIVE  HAP 35 Hamelia accens Compactor Dwarf Fire Bush 24" X IB" Staggered 30" oc Notive 4 D Mark Fire Bush 24" X IB" Staggered 24" oc Notive 4 D Mark Fire Bush 20" x 20", full Staggered 24" oc Drought To SCH B4 Schefflera arboricala Green Schefflera 20" x 20", full Staggered 24" oc Drought To GROUND COVERS CODE GTY BOTANICAL NAME COMMON NAME SIZE CONTAINER NATIVE  FIM 383 Ficus microcorpa Green Island* Green Island Ficus 12" X IB" Staggered 18" oc Drought To GROUND COVERS CODE GTY BOTANICAL NAME COMMON NAME SIZE CONTAINER NATIVE  FIM 383 Ficus microcorpa Green Island* Green Island Ficus 12" X IB" Fill 4 well branched Staggered IB" oc Drought To Ground To Common NAME SIZE CONTAINER NATIVE	PALMS	CODE	<u>aty</u>	BOTANICAL NAME	COMMON NAME	<u>SIZE</u>	<u>COMMENTS</u>	<u>NATIVE</u>
ACA IT Acalypha wilkesiana Real Capperieaf 24' x 24' Full, Bright Real Drought To CAP2 4 Capparis synophallophara Jamaica Caper 4' och Full to base Native 4 D MINES COPE 2TY BOTANICAL NAME COMMON NAME SIZE COMMENTS NATIVE PP 3 Ficus pumilo Cresping Fig 3 gal. 5 Runners min Drought To Capparis Confederate' Confederate Jasmine 3 gal. 5 Runners min Drought To SHRUB AREAS CODE 2TY BOTANICAL NAME COMMON NAME SIZE COMMENTS NATIVE APPLIED AREAS CODE 2TY BOTANICAL NAME COMMON NAME SIZE COMMENTS NATIVE APPLIED AREAS CODE 2TY BOTANICAL NAME COMMON NAME SIZE COMMENTS NATIVE APPLIED AREAS CODE 2TY BOTANICAL NAME Pink Multip 20' x 20", full Staggered 30' oc Native 4 D MINES SIZE COMMENTS NATIVE APPLIED AREAS CODE 2TY BOTANICAL NAME PINK Multip 20' x 20", full Staggered 24" oc Native 4 D MINES SIZE CONTAINER NATIVE SCAND COVERS CODE 2TY BOTANICAL NAME COMMON NAME SIZE CONTAINER NATIVE STAGGERED 24" oc Drought To SEADLE COVERS CODE 2TY BOTANICAL NAME COMMON NAME SIZE CONTAINER NATIVE STAGGERED 30" oc Drought To SEADLE COVERS CODE 2TY BOTANICAL NAME COMMON NAME SIZE CONTAINER NATIVE STAGGERED 30" oc Drought To SEADLE COVERS CODE 2TY BOTANICAL NAME COMMON NAME SIZE CONTAINER NATIVE	*	SP	6	Sabal palmetto	Sabal Palm	8' ct	Straight Trunk	Native & Drought Tolerant
### CAP2 4 Capparis cynophallophora Jamaica Caper 4' och Full to base Notive 8 D  VINES CODE QTY BOTANICAL NAME COMMON NAME SIZE COMMENTS NATIVE  ###################################	SHRUBS	CODE	<u> QTY</u>	BOTANICAL NAME	COMMON NAME	<u>SIZE</u>	<u>COMMENTS</u>	NATIVE
VINES CODE GTY BOTANICAL NAME  FP 3 Flous pumila Creeping Fig 3 gal. 5 Runners min Drought To  A TJ 6 Trachelospermum jasminoides Confederate' Confederate Josmine 3 gal. 5 Runners min Drought To  SHRUB AREAS CODE GTY BOTANICAL NAME COMMON NAME SIZE COMMENTS NATIVE  HAP 35 Hamelia patens 'Compacta' Dwarf Fire Bush 24" X IB" Staggered 30" oc Notive 6 D  MUC 65 Muhlerbergia capillaris Fink Muhly 20" x 20", full Staggered 24" oc Notive 6 D  POD 16 Podocarpus macrophyllus maki Maki Fodocarpus 24" X IB" Staggered 24" oc Drought To  SCH 39 Schefflera arbonicola Green Schefflera 20" x 20", full Staggered 24" oc Drought To  GROUND COVERS CODE GTY BOTANICAL NAME COMMON NAME SIZE CONTAINER NATIVE  FIM 383 Ficus microcarpo Green Island' Green Island Ficus 12" X IB" Full & well branched Staggered 18" oc Drought To	•	ACA	17	Acalypha wilkesiana	Red Copperleaf	24" × 24"	Full, Bright Red	Drought Tolerant
FP 3 Ficus pumila Creeping Fig 3 gal. 5 Runners min Drought To  A TJ 6 Trachelospermum jaeminoides 'Confederate' Confederate Jasmine 3 gal. 5 Runners min Drought To  SHRUB AREAS CODE QTY BOTANICAL NAME COMMON NAME SIZE COMMENTS NATIVE  HAP 35 Hamelia patens 'Compacta' Dwarf Fire Bush 24" X IS" Staggered 30" oc Native 4 D  MUC 65 Muhlenbergia capilloris Pink Muhiy 20" x 20", full Staggered 24" oc Native 4 D  FOD 16 Fodocorpus macrophyllus maki Maki Podocarpus 24" X IS" Staggered 24" oc Drought To  SCH 39 Schefflera arboricola Green Schefflera 20" x 20", full Staggered 24" oc Drought To  SROUND COVERS CODE QTY BOTANICAL NAME COMMON NAME SIZE CONTAINER NATIVE  FIM 383 Ficus microcarpa 'Green Island' Green Island Ficus 12" X IS" Full 4 well branched Staggered 18" oc Drought To	MANAMANA + CC	CAP2	4	Capparis cynophallophora	Jamaica Caper	4' oah	Full to base	Native & Drought Tolerant
TJ 6 Trachelospermum Jasminoldes 'Confederate' Confederate Jasmine 3 gal. 5 Runners min Prought To 3HRUB AREAS CODE 9TY BOTANICAL NAME COMMON NAME SIZE COMMENTS NATIVE NATIVE 1	<u>VINES</u>	CODE	<u> QTY</u>	BOTANICAL NAME	COMMON NAME	<u>SIZE</u>	<u>COMMENTS</u>	<u>NATIVE</u>
SHRUB AREAS CODE QTY BOTANICAL NAME  COMMON NAME  SIZE  COMMENTS  NATIVE  Staggered 30" oc Native 4 D  Native 4 D  Native 4 D  ROD  ROD  ROD  ROD  ROD  ROD  ROD  R	$\triangle$	FP	3	Ficus pumila	Creeping Fig	3 gal.	5 Runners min	Drought Tolerant
HAP 35 Hamelia patens 'Compacta' Dwarf Fire Bush 24" X 18" Staggered 30" oc Native & D.  MUC 65 Muhlenbergia capillaris Pink Muhly 20" x 20", full Staggered 24" oc Native & D.  POD 16 Podocarpus macrophyllus maki Maki Podocarpus 24" X 18" Staggered 24" oc Drought To.  SCH 39 Schefflera arboricola Green Schefflera 20" x 20", full Staggered 24" oc Drought To.  GROUND COVERS CODE QTY BOTANICAL NAME COMMON NAME SIZE CONTAINER NATIVE  FIM 383 Ficus microcarpa 'Green Island' Green Island Ficus 12" X 18" Full & well branched Staggered 18" oc Drought To.	$\triangle$	LT	6	Trachelospermum jasminoides 'Confederate'	Confederate Jasmine	3 gal.	5 Runners min	Drought Tolerant
MUC 65 Muhlenbergia capillaris Pink Muhly 20" x 20", full Staggered 24" oc Native & D  POD 16 Podocarpus macrophyllus maki Maki Podocarpus 24" X 18" Staggered 24" oc Drought To  SCH 39 Schefflera arboricola Green Schefflera 20" x 20", full Staggered 24" oc Drought To  GROUND COVERS CODE QTY BOTANICAL NAME COMMON NAME SIZE CONTAINER NATIVE  FIM 383 Ficus microcarpa 'Green Island' Green Island Ficus 12" X 18" Full & well branched Staggered 18" oc Drought To	SHRUB AREAS	CODE	<u>aty</u>	BOTANICAL NAME	COMMON NAME	<u>SIZE</u>	<u>COMMENTS</u>	<u>NATIVE</u>
POD 16 Podocarpus macrophyllus maki Maki Podocarpus 24" X 18" Staggered 24" oc Drought To SCH 39 Schefflera arboricola Green Schefflera 20" x 20", full Staggered 24" oc Drought To GROUND COVERS CODE QTY BOTANICAL NAME COMMON NAME SIZE CONTAINER NATIVE FIM 383 Ficus microcarpa 'Green Island' Green Island Ficus 12" X 18" Full \$ well branched Staggered 18" oc Drought To		HAP	35	Hamelia patens 'Compacta'	Dwarf Fire Bush	24" × 18"	Staggered 30" oc	Native & Drought Tolerant
POD 16 Podocarpus macrophyllus maki Maki Podocarpus 24" X 18" Staggered 24" oc Drought To SCH 39 Schefflera arboricola Green Schefflera 20" x 20", full Staggered 24" oc Drought To GROUND COVERS CODE QTY BOTANICAL NAME COMMON NAME SIZE CONTAINER NATIVE FIM 383 Ficus microcarpa 'Green Island' Green Island Ficus 12" X 18" Full \$ well branched Staggered 18" oc Drought To		MUC	65	Muhlenbergia capillaris	Pink Muhly	20" × 20", full	Staggered 24" oc	Native ‡ Drought Tolerant
SCH 39 Schefflera arboricola Green Schefflera 20" x 20", full Staggered 24" oc Drought Tologogen Covers Code QTY BOTANICAL NAME COMMON NAME SIZE CONTAINER NATIVE  FIM 383 Ficus microcarpa 'Green Island' Green Island Ficus 12" X 18" Full \$ well branched Staggered 18" oc Drought Tologogen Common Name Stagger		POD	16	Podocarpus macrophyllus maki	Maki Podocarpus	24" × 18"	Staggered 24" oc	Drought Tolerant
FIM 383 Ficus microcarpa 'Green Island' Green Island Ficus 12" X 18" Full & well branched Staggered 18" oc Drought To		SCH	39	Schefflera arboricola	Green Schefflera	20" × 20", full	Staggered 24" oc	Drought Tolerant
	GROUND COVERS	CODE	<u>aty</u>	BOTANICAL NAME	COMMON NAME	<u>SIZE</u>	CONTAINER	<u>NATIVE</u>
SOD 1,772 sf Stenotaphrum secundatum St. Augustine Grass full sod		FIM	383	Ficus microcarpa 'Green Island'	Green Island Ficus	12" X 18" Full \$ well branched	Staggered 18" oc	Drought Tolerant
		SOD	1,772 sf	Stenotaphrum secundatum	St. Augustine Grass	full sod		

9-0524 - ALS FLORIST\CLIENT IN\AUG 14, 2019 DUMPSTER\ALS FLORIST SP.DWG 8/14/19 by JILL

1700 S.R. 7

Sheet Title ——
LANT LIST &


PLANT LIST
CODE DATA

Revision Dates

MARCH 2018

Sheet Number



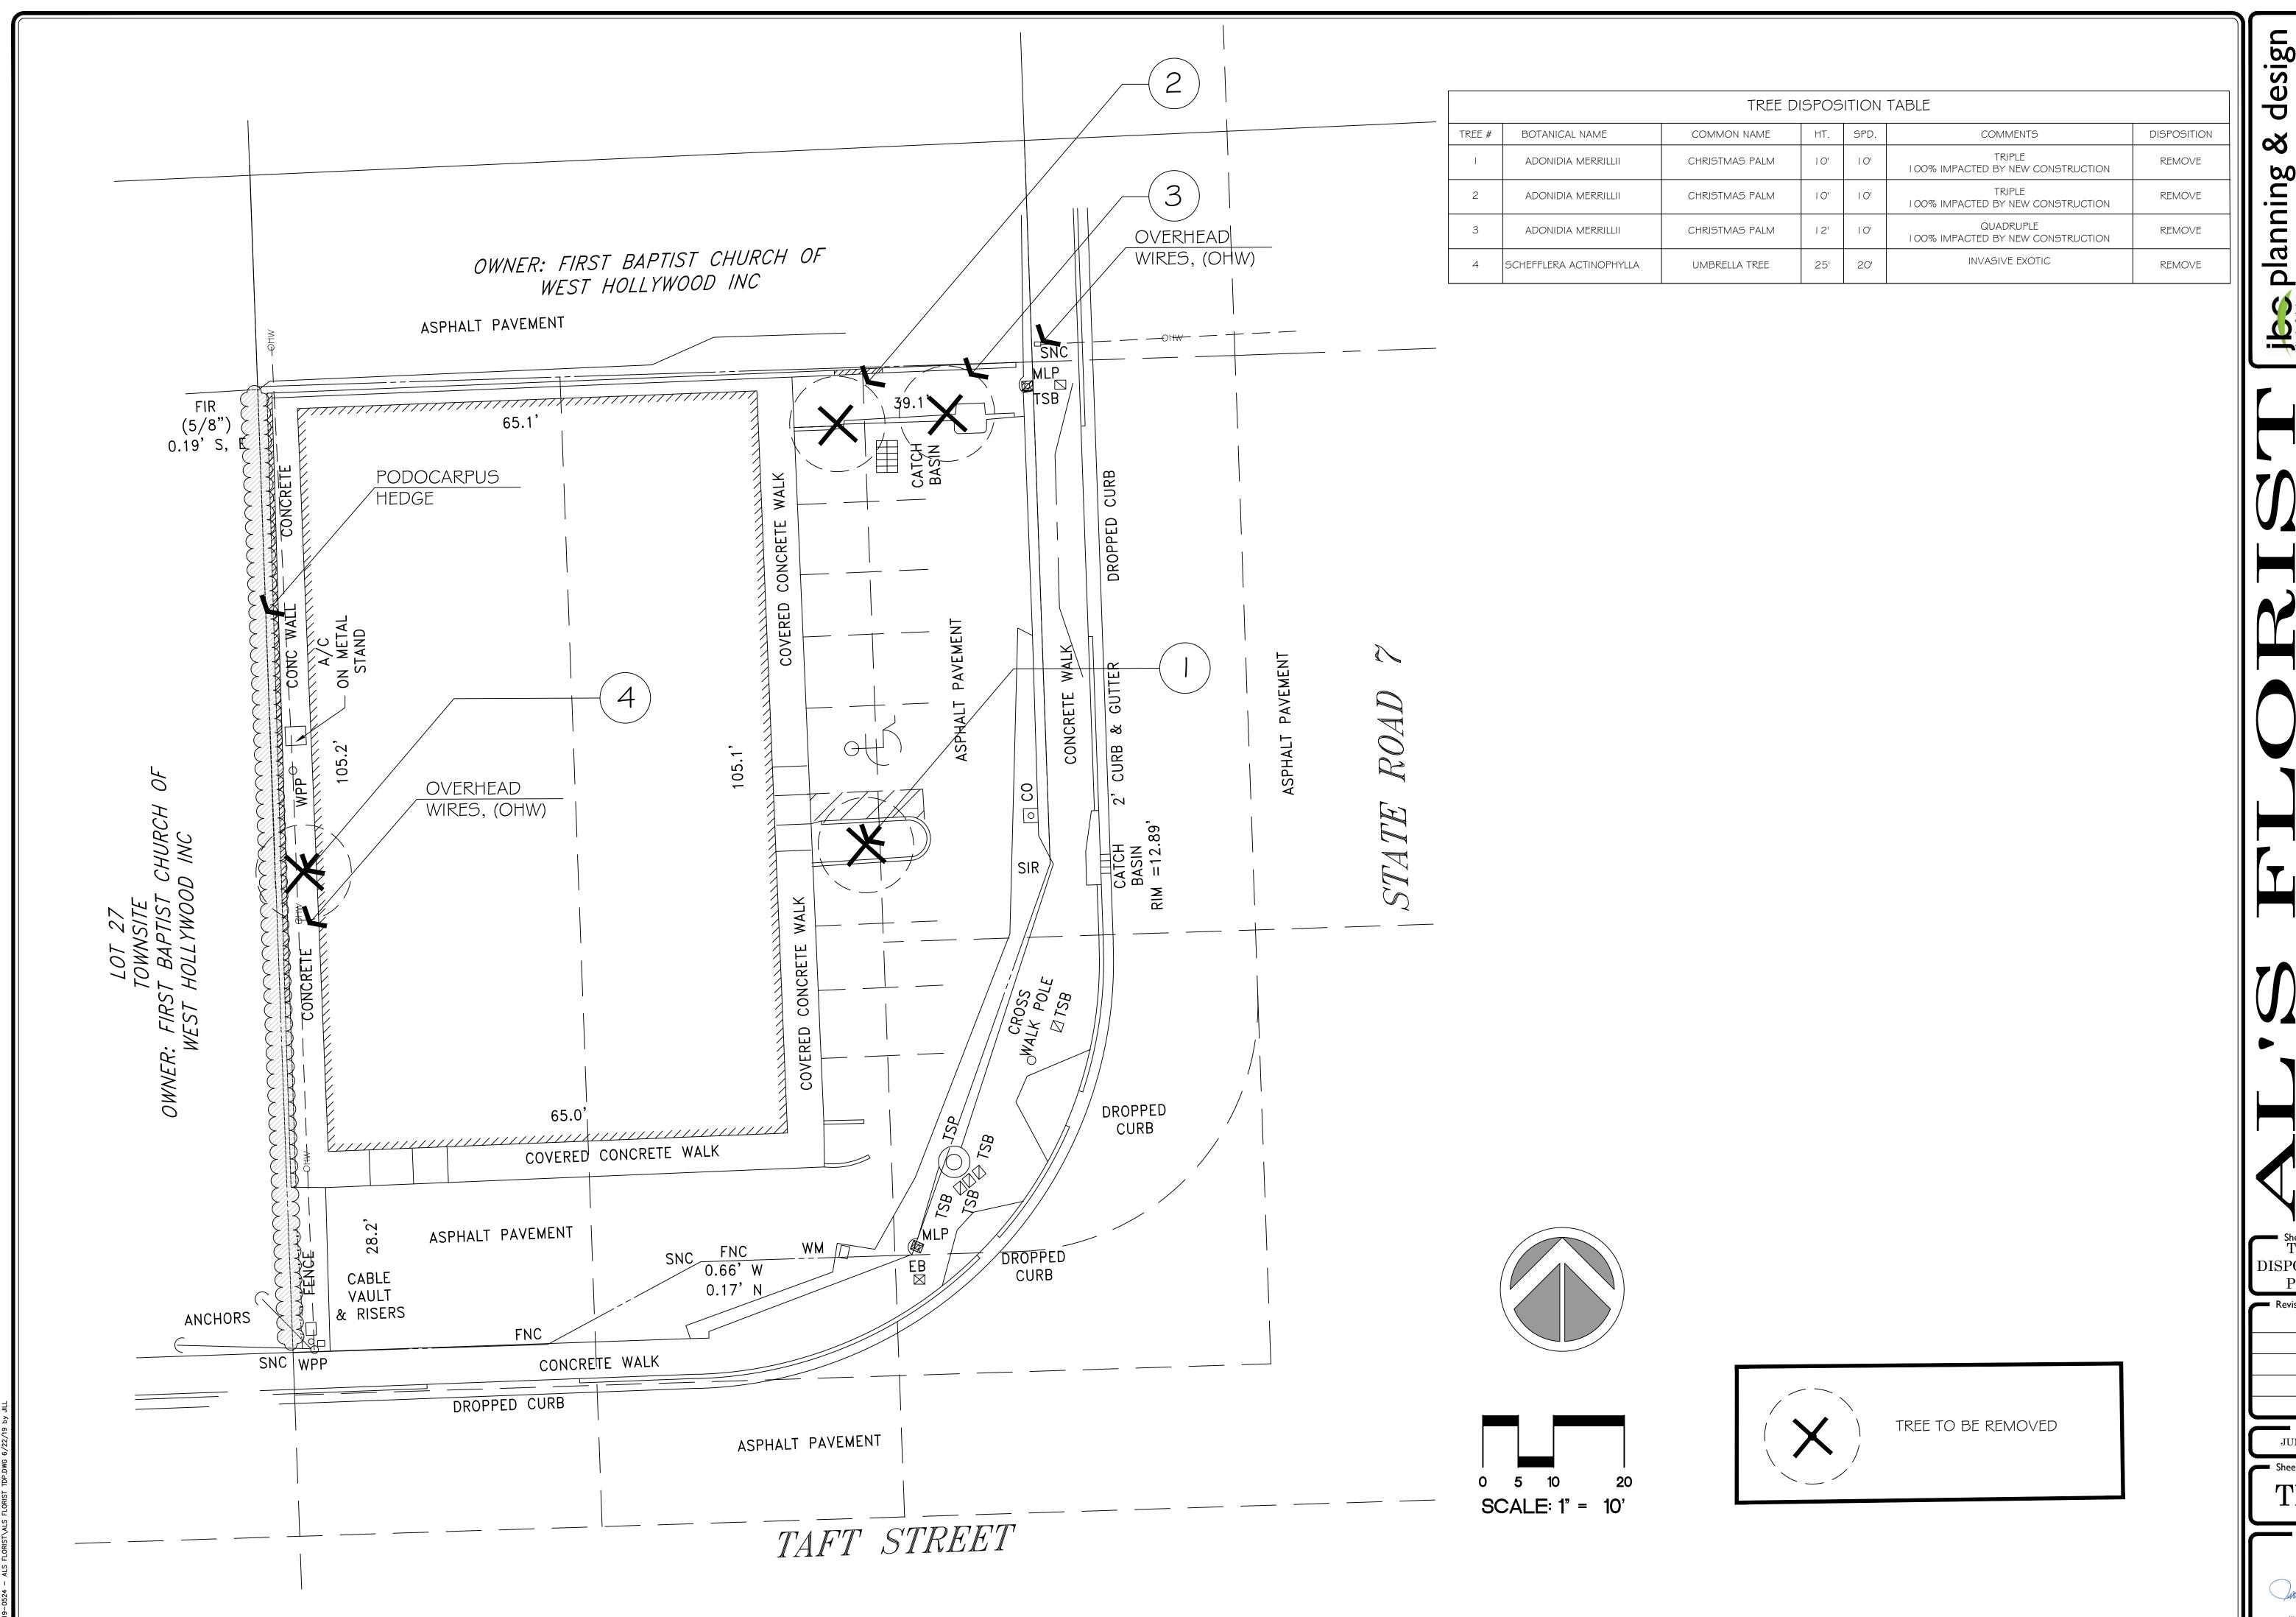


planning, landscape architecture & sustainable 1312 Majesty Terrace Weston, Florida 33327

Sheet Title TREE DISPOSITION PLAN
Revision Dates


Date
JUNE 2019


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JILL COHEN
6.24.19
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## **LOCATION MAP**

SCALE: NTS
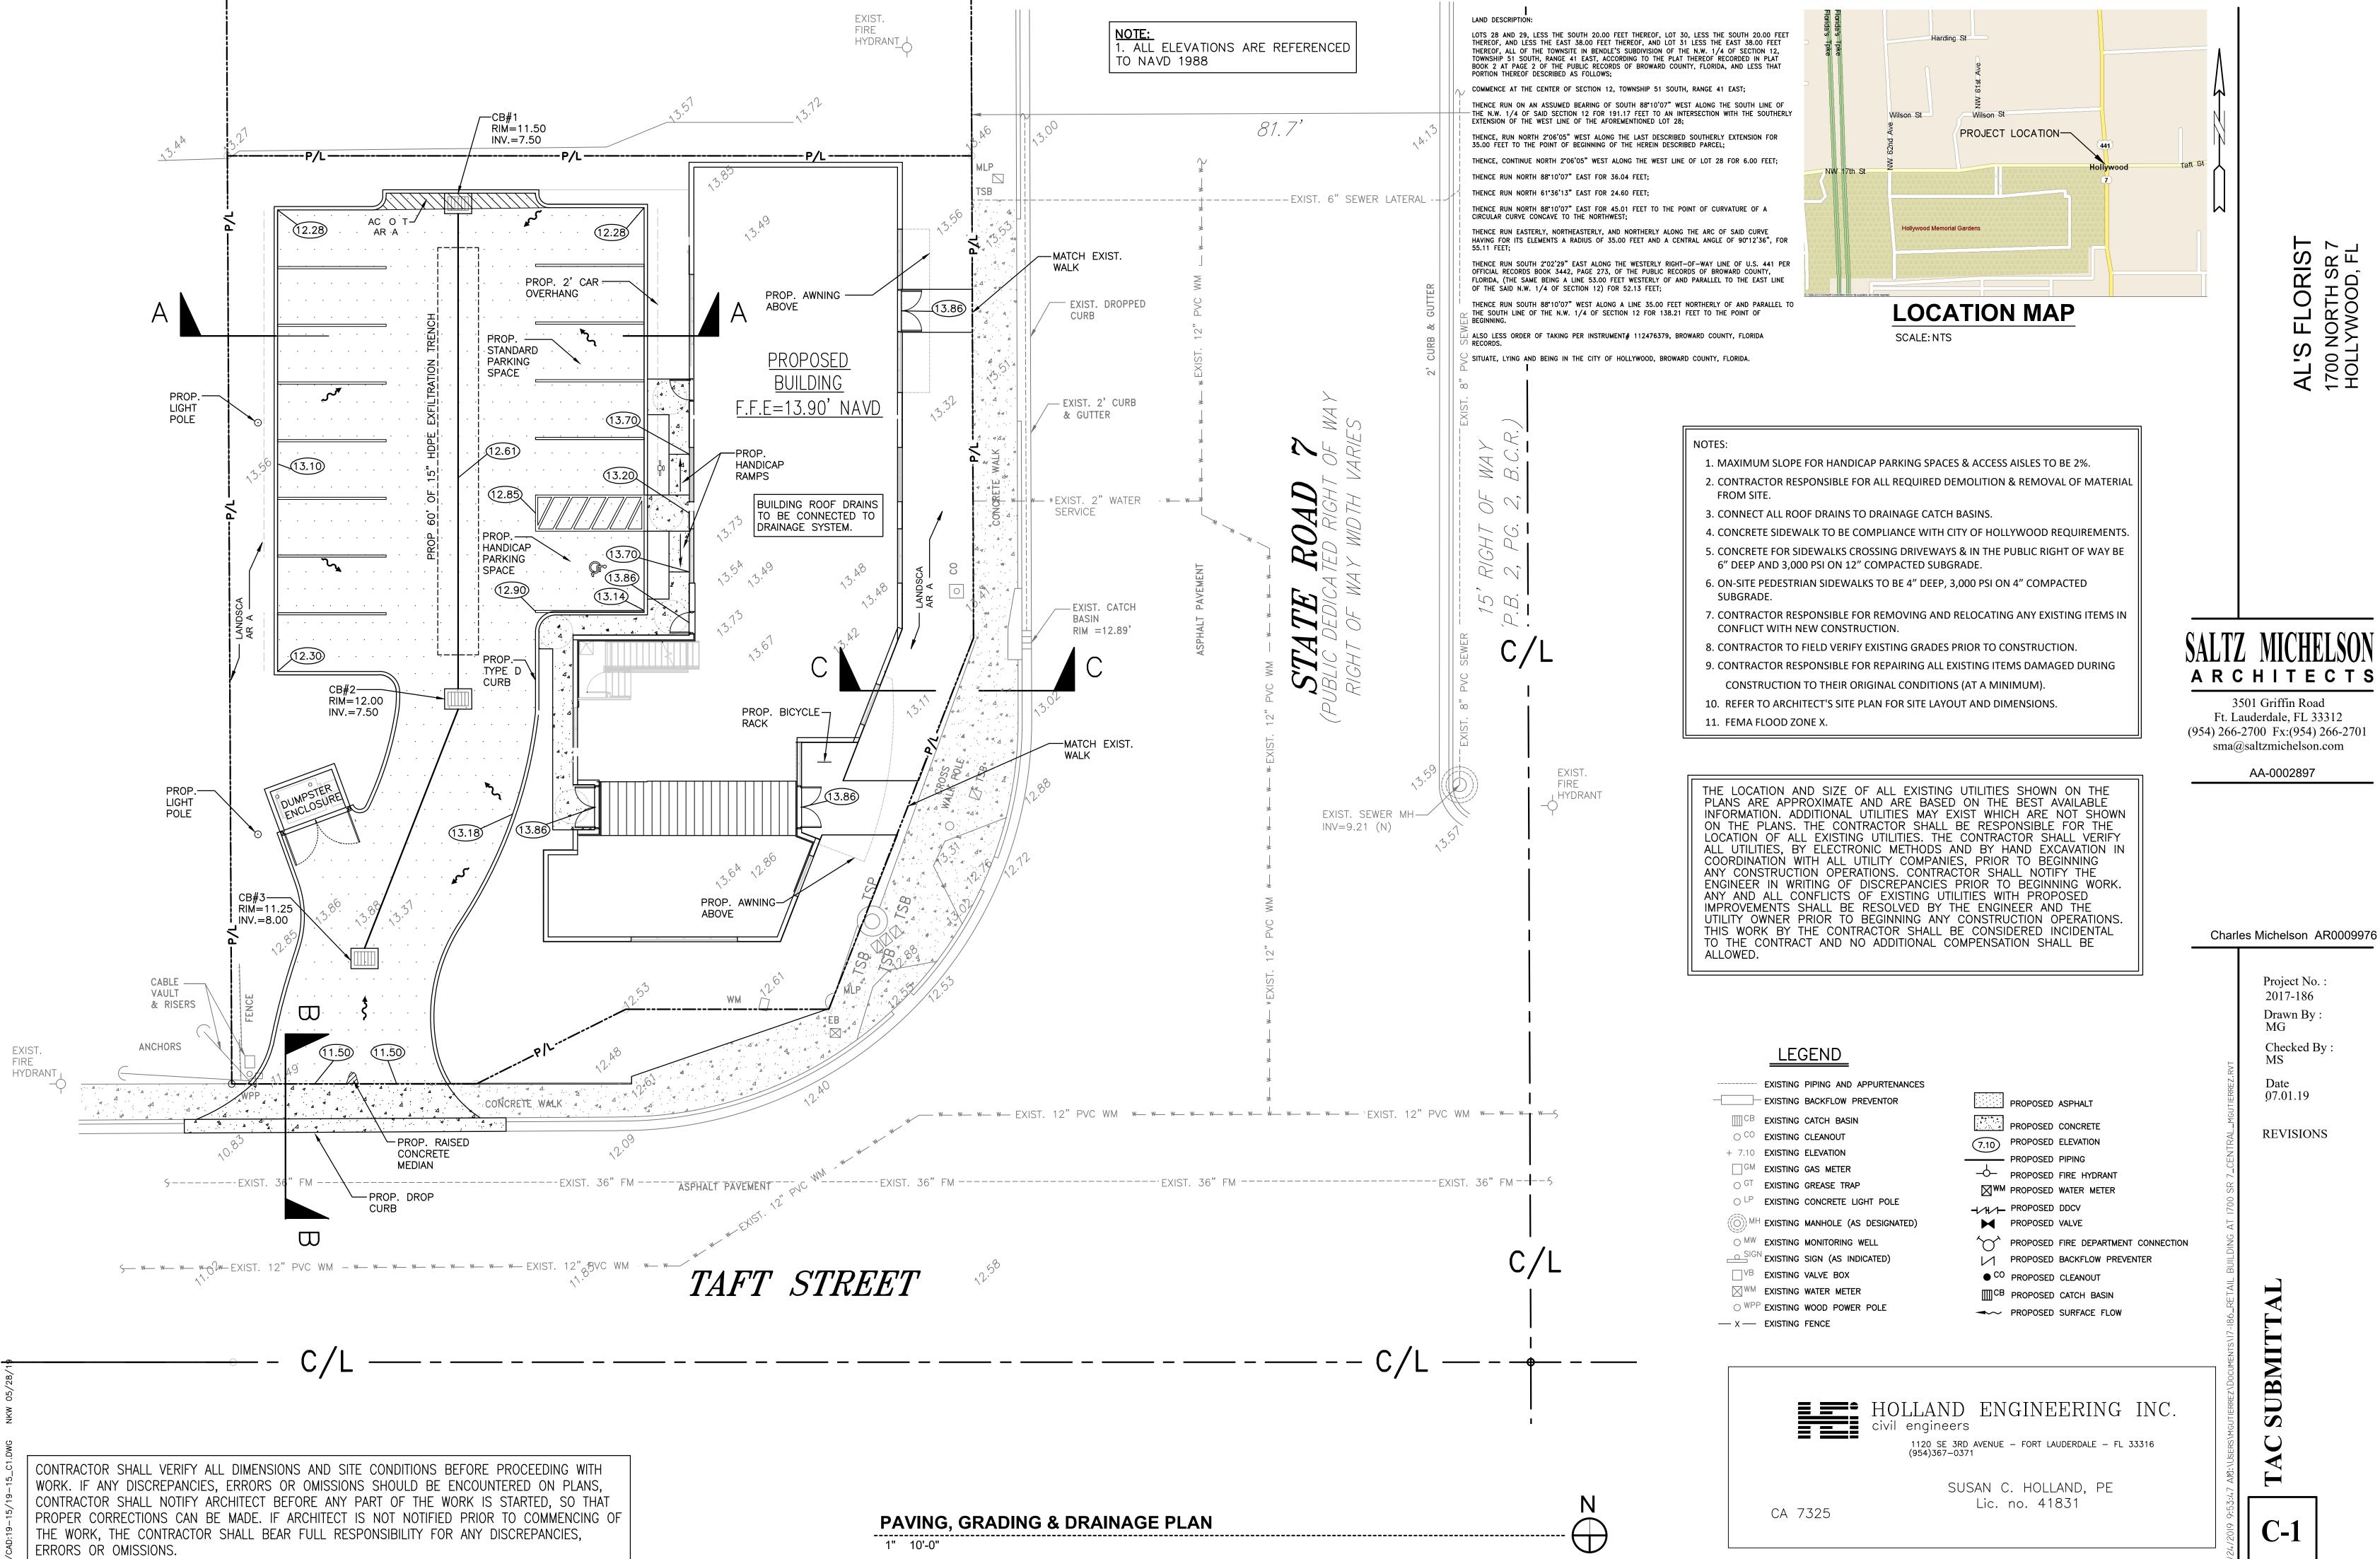
#### AND DESCRIPTION

LOTS 28 AND 29, LESS THE SOUTH 20.00 FEET THEREOF, LOT 30, LESS THE SOUTH 20.00 FEET THEREOF, AND LESS THE EAST 38.00 FEET THEREOF, AND LOT 31 LESS THE EAST 38.00 FEET THEREOF, ALL OF THE TOWNSITE IN BENDLE'S SUBDIVISION OF THE N.W. 1/4 OF SECTION 12, TOWNSHIP 51 SOUTH, RANGE 41 EAST, ACCORDING TO THE PLAT THEREOF RECORDED IN PLAT BOOK 2 AT PAGE 2 OF THE PUBLIC RECORDS OF BROWARD COUNTY, FLORIDA, AND LESS THAT PORTION THEREOF DESCRIBED AS FOLLOWS;

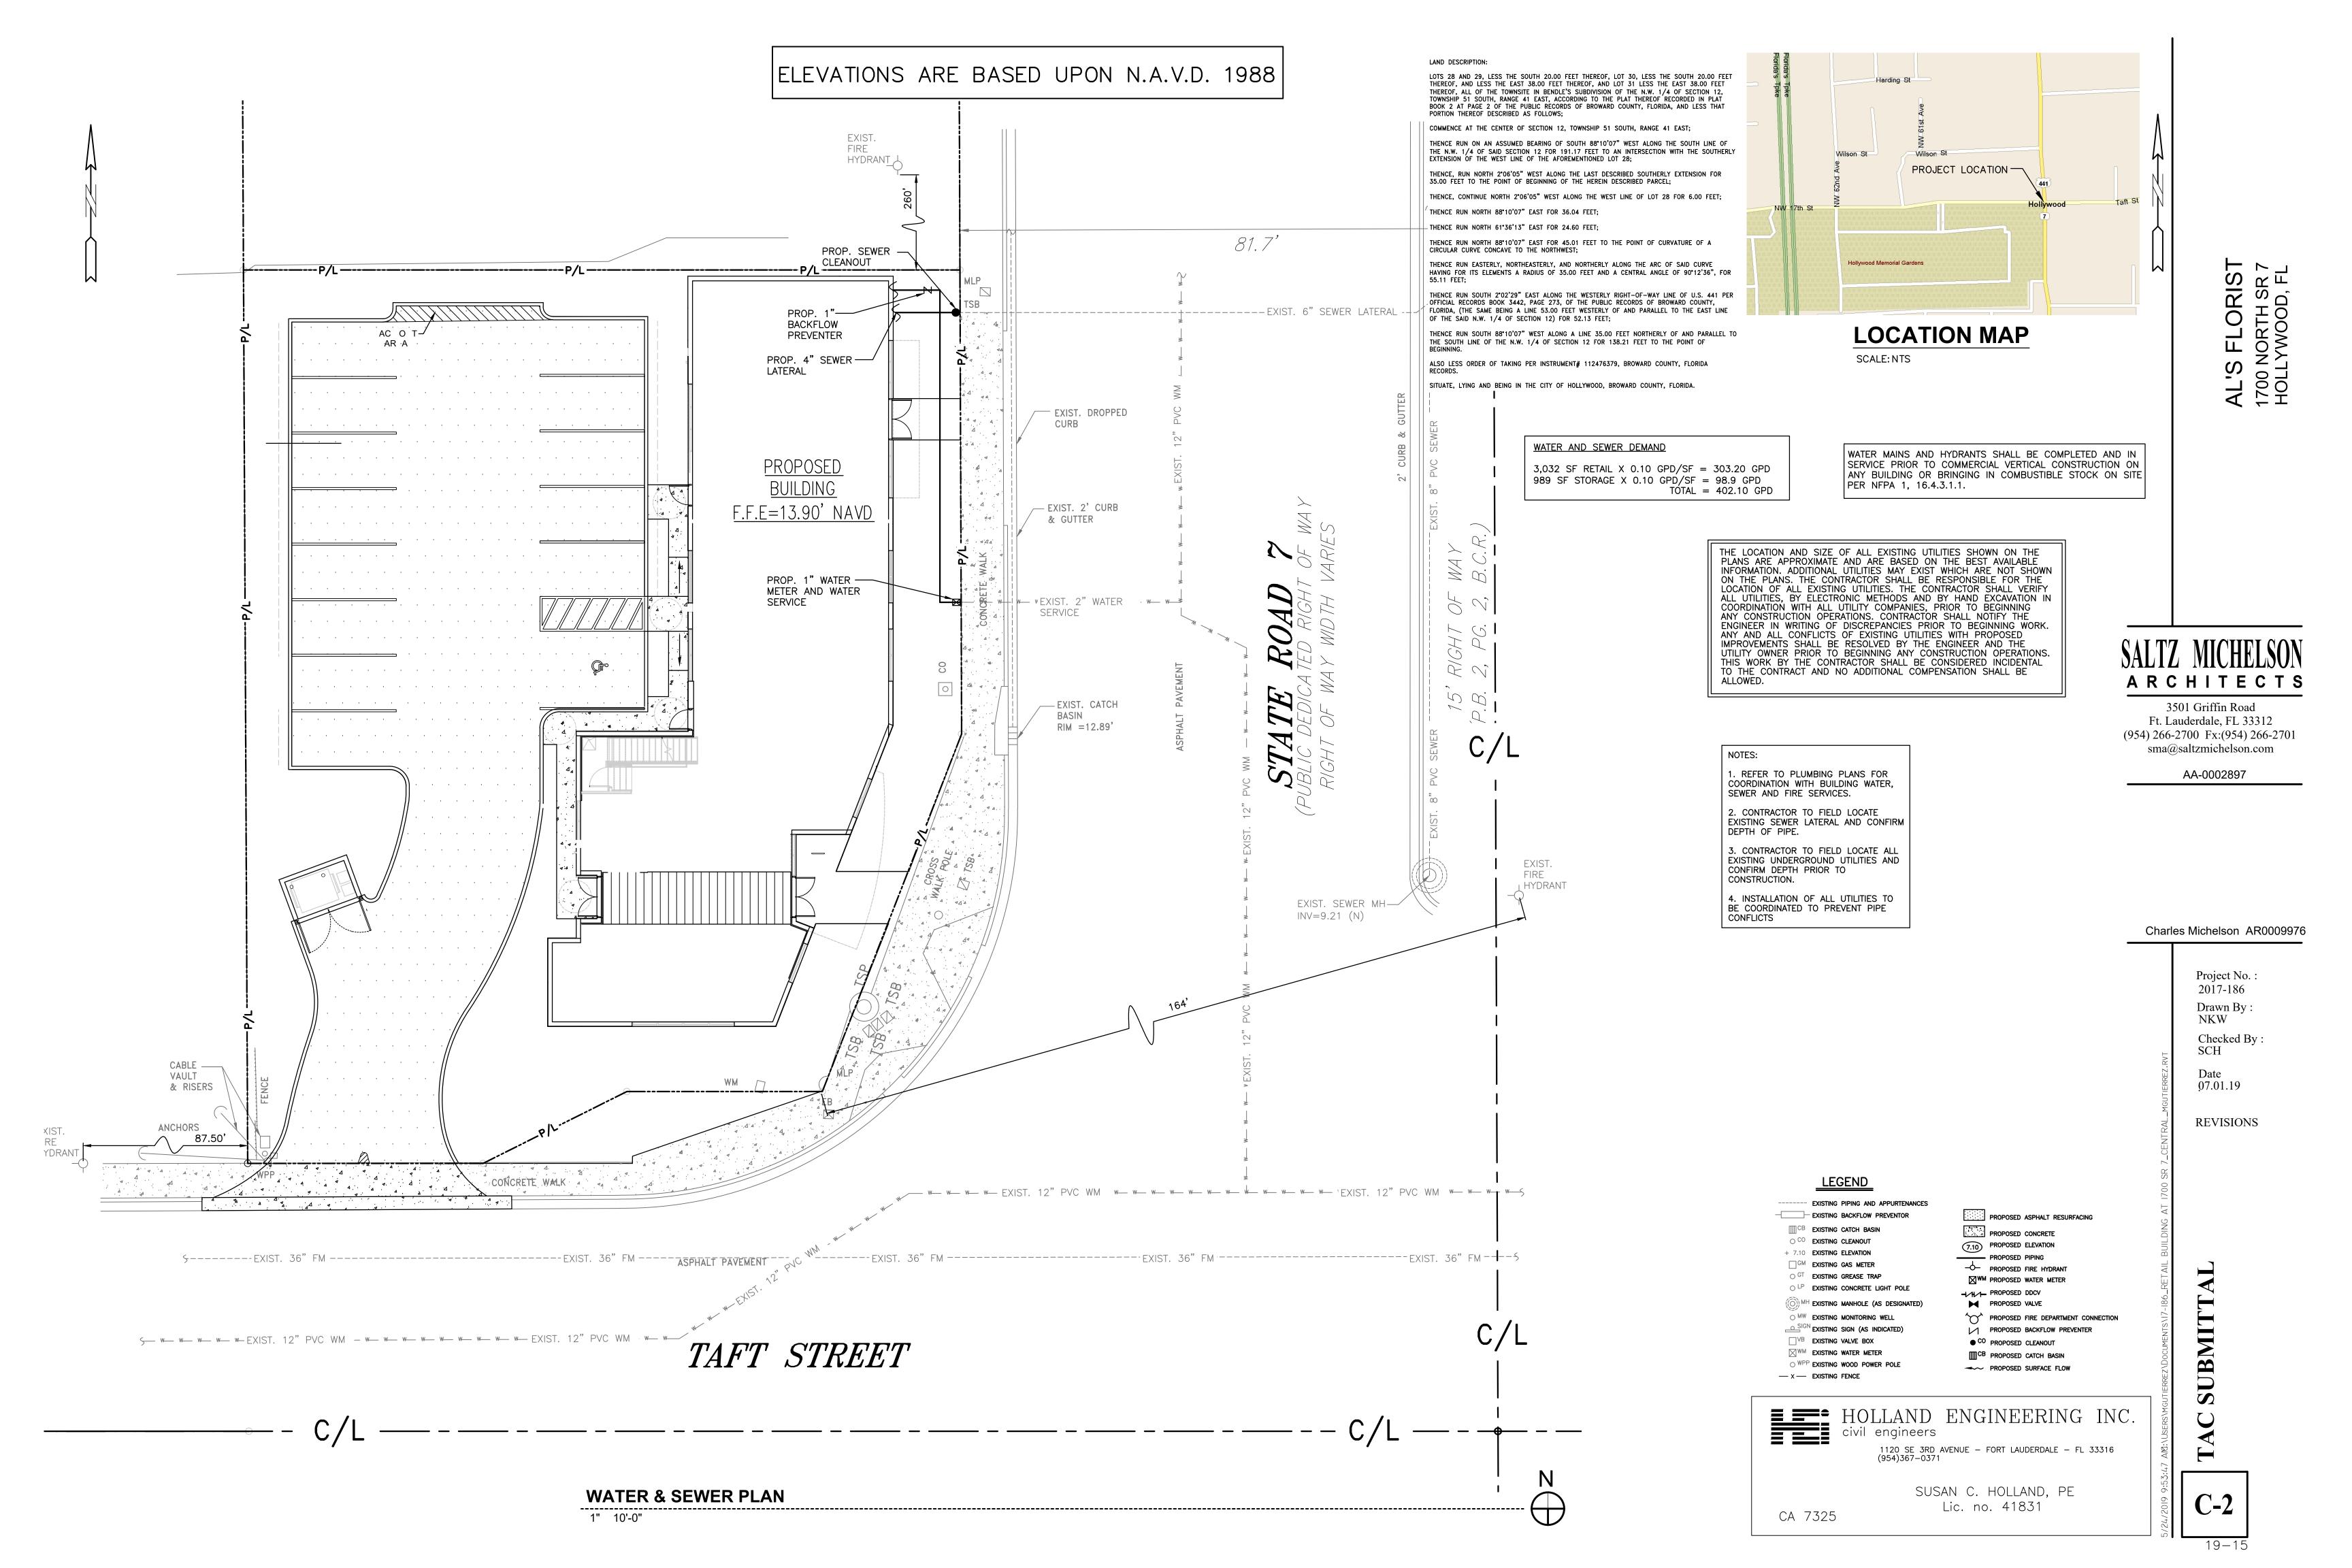COMMENCE AT THE CENTER OF SECTION 12, TOWNSHIP 51 SOUTH, RANGE 41 EAST;

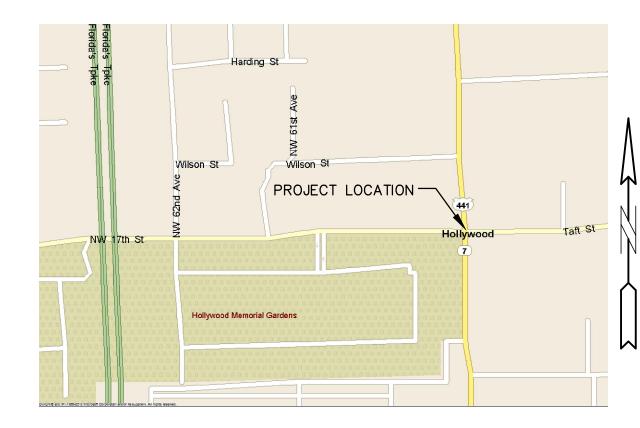THENCE RUN ON AN ASSUMED BEARING OF SOUTH 88\*10'07" WEST ALONG THE SOUTH LINE OF THE N.W. 1/4 OF SAID SECTION 12 FOR 191.17 FEET TO AN INTERSECTION WITH THE SOUTHERLY

THENCE, RUN NORTH 2\*06'05" WEST ALONG THE LAST DESCRIBED SOUTHERLY EXTENSION FOR 35.00 FEET TO THE POINT OF BEGINNING OF THE HEREIN DESCRIBED PARCEL;

THENCE, CONTINUE NORTH 2°06'05" WEST ALONG THE WEST LINE OF LOT 28 FOR 6.00 FEET;

THENCE RUN NORTH 88\*10'07" EAST FOR 36.04 FEET;
THENCE RUN NORTH 61\*36'13" EAST FOR 24.60 FEET;

EXTENSION OF THE WEST LINE OF THE AFOREMENTIONED LOT 28;

THENCE RUN NORTH 88°10'07" EAST FOR 45.01 FEET TO THE POINT OF CURVATURE OF A CIRCULAR CURVE CONCAVE TO THE NORTHWEST;

THENCE RUN EASTERLY, NORTHEASTERLY, AND NORTHERLY ALONG THE ARC OF SAID CURVE HAVING FOR ITS ELEMENTS A RADIUS OF 35.00 FEET AND A CENTRAL ANGLE OF 90°12'36", FOR 55.11 FEET;

THENCE RUN SOUTH 2°02'29" EAST ALONG THE WESTERLY RIGHT-OF-WAY LINE OF U.S. 441 PER OFFICIAL RECORDS BOOK 3442, PAGE 273, OF THE PUBLIC RECORDS OF BROWARD COUNTY, FLORIDA, (THE SAME BEING A LINE 53.00 FEET WESTERLY OF AND PARALLEL TO THE EAST LINE OF THE SAID N.W. 1/4 OF SECTION 12) FOR 52.13 FEET;

THENCE RUN SOUTH 88°10'07" WEST ALONG A LINE 35.00 FEET NORTHERLY OF AND PARALLEL TO

THE SOUTH LINE OF THE N.W. 1/4 OF SECTION 12 FOR 138.21 FEET TO THE POINT OF BEGINNING.

ALSO LESS ORDER OF TAKING PER INSTRUMENT# 112476379, BROWARD COUNTY, FLORIDA

SITUATE, LYING AND BEING IN THE CITY OF HOLLYWOOD, BROWARD COUNTY, FLORIDA.

AL'S FLORIST

# SALTZ MICHELSON ARCHITECTS

3501 Griffin Road Ft. Lauderdale, FL 33312 (954) 266-2700 Fx:(954) 266-2701 sma@saltzmichelson.com

AA-0002897

#### Charles Michelson AR0009976

Project No.: 2017-186

Drawn By:

Checked By SCH

07.01.19
REVISIONS

PROPOSED FIRE HYDRANT

WM PROPOSED WATER METER

PROPOSED CONCRETE

7.10 PROPOSED ELEVATION

PROPOSED PIPING

PROPOSED ASPHALT RESURFACING

PROPOSED DDCV
PROPOSED VALVE

PROPOSED FIRE DEPARTMENT CONNECTION
PROPOSED BACKFLOW PREVENTER

CO PROPOSED CLEANOUT

 CO PROPOSED CATCH BAS

PROPOSED CATCH BASIN

PROPOSED SURFACE FLOW



CA 7325

LEGEND

EXISTING BACKFLOW PREVENTOR

CB EXISTING CATCH BASIN

O CO EXISTING CLEANOUT

+ 7.10 **EXISTING ELEVATION** 

GM EXISTING GAS METER

○ GT EXISTING GREASE TRAP

O LP EXISTING CONCRETE LIGHT POLE

O MW EXISTING MONITORING WELL

SIGN EXISTING SIGN (AS INDICATED)

O WPP EXISTING WOOD POWER POLE

— X — EXISTING FENCE

MH EXISTING MANHOLE (AS DESIGNATED)

----- EXISTING PIPING AND APPURTENANCES

HOLLAND ENGINEERING INC.

1120 SE 3RD AVENUE – FORT LAUDERDALE – FL 33316 (954)367–0371


> SUSAN C. HOLLAND, PE Lic. no. 41831

1120 SE 3RD AVENUE - FORT LAU (954)367-0371

C-3

SUBMITT

40.45

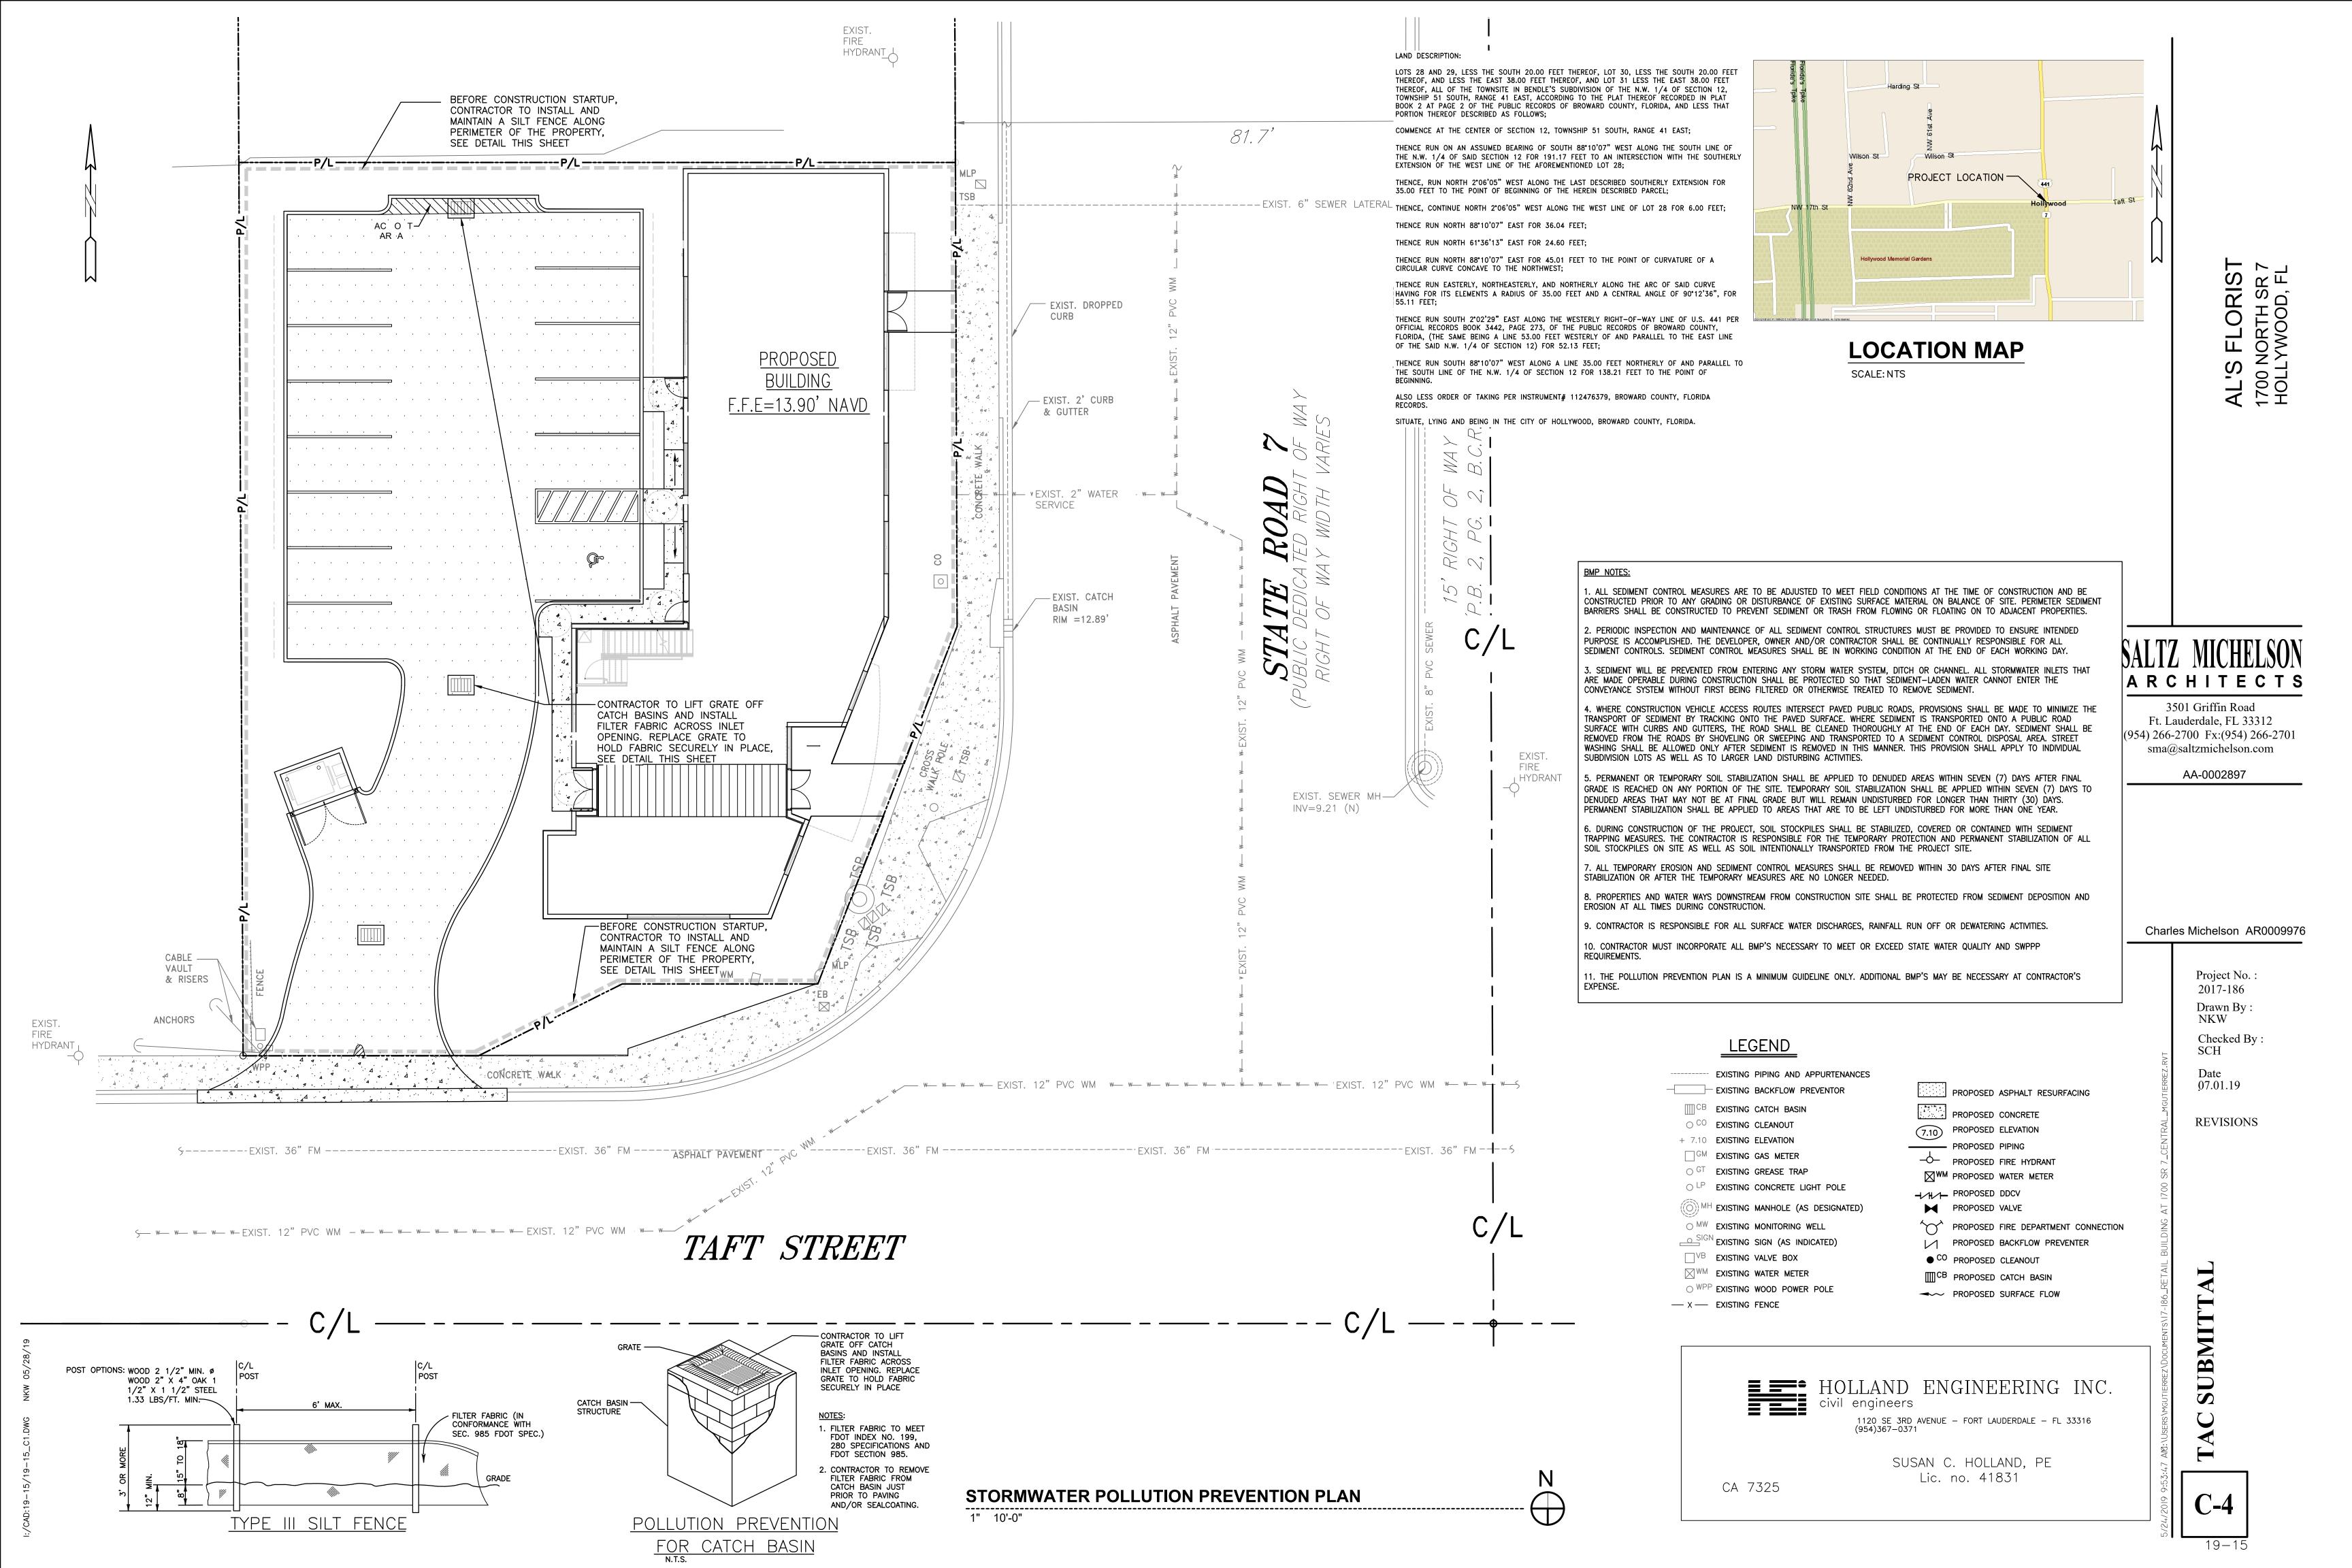

2. PRIOR TO CONSTRUCTION THE CONTRACTOR IS TO NOTIFY THE FOLLOWING COMPANIES & AGENCIES AND ANY OTHERS SERVING THE AREA:

FLORIDA POWER & LIGHT CO., CONSTRUCTION SOUTHERN BELL TELEPHONE & TEL. CO. CABLE CONSTRUCTION BUREAU LOCAL CITY / COUNTY ENGINEERING & UTILITY DEPARTMENTS FLORIDA DEPARTMENT OF TRANSPORTATION (FDOT), AS APPLICABLE UNDERGROUND UTILITIES NOIFICATION CENTER OF FLORIDA (S.U.N.S.H.I.N.E.)

#### PAVING, GRADING & DRAINAGE NOTES:

1. ALL UNSUITABLE MATERIALS, SUCH AS MUCK, HARDPAN, ORGANIC MATERIAL & OTHER DELETERIOUS MATERIAL AS CLASSIFIED BY AASHTO M-145, FOUND WITHIN THE ROAD & PARKING LOT AREAS SHALL BE REMOVED DOWN TO ROCK OR SUITABLE MATERIAL, & REPLACED W/ THE SPECIFIED FILL MATERIAL IN MAXIMUM 12" LIFTS COMPACTED TO NOT LESS THAN 100% MAXIMUM DRY DENSITY AT OPTIMUM MOISTURE IN ACCORDANCE W/ AASHTO T-99. THICKNESS OF LAYERS MAY BE INCREASED PROVIDED THE EQUIPMENT & METHODS USED ARE PROVEN BY FIELD DENSITY TESTING TO BE CAPABLE OF COMPACTING THICK LAYERS TO SPECIFIED DENSITIES.

2. ALL AREAS SHALL BE CLEARED & GRUBBED PRIOR TO CONSTRUCTION. THIS SHALL CONSIST OF THE COMPLETE REMOVAL & DISPOSAL OF ALL TREES, BRUSH, STUMPS, ROOTS, GRASS, WEEDS, RUBBISH & ALL OTHER OBSTRUCTION RESTING ON OR PROTRUDING THROUGH THE SURFACE OF THE EXIST. GROUND TO A DEPTH OF 12". ITEMS DESIGNATED TO REMAIN OR TO BE RELOCATED OR ADJUSTED SHALL BE SO

DESIGNATED ON THE DWGS. 3. FILL MATERIAL SHALL BE CLASSIFIED AS A-1, A-3 OR A-2.4 IN ACCORDANCE W/ AASHTO M-145 & SHALL BE FREE FROM VEGETATION & ORGANIC MATERIAL. NOT MORE THAN 12% BY WEIGHT OF FILL MATERIAL SHALL PASS THE NO. 200 SIEVE.

4. THE CONTRACTOR SHALL BE RESPONSIBLE FOR PROVIDING CERTIFIED MATERIAL TEST RESULTS TO THE ENGINEER OF RECORD PRIOR TO THE RELEASE OF FINAL CERTIFICATION BY THE ENG. TEST RESULTS MUST INCLUDE BUT MAY NOT BE LIMITED TO, DENSITIES FOR SUBGRADE & LIME ROCK, UTILITIES, EXCAVATION, ASPHALT GRADIATION REPORTS, CONC.

5. ALL INLETS & PIPE SHALL BE PROTECTED DURING CONSTRUCTION TO PREVENT SILTATION IN THE DRAINAGE SYSTEMS BY WAY OF TEMPORARY PLUGS & PLYWOOD OR PLASTIC COVERS OVER THE INLETS. THE ENTIRE DRAINAGE SYSTEM TO BE CLEAN OF DEBRIS PRIOR TO FINAL ACCEPTANCE.

6. WHERE NEW ASPHALT MEETS OR ABUTS EXIST. ASPHALT, THE EXIST. ASPHALT SHALL BE SAWCUT TO PROVIDE A STRAIGHT EVEN LINE. PRIOR TO REMOVING CURB OR GUTTER, THE ADJACENT ASPHALT SHALL ALSO BE SAWCUT TO PROVIDE A STRAIGHT EVEN LINE.

7. ALL PROPOSED GRADES (ELEVATIONS) REFER TO ASPHALT GRADES UNLESS INDICATED 8. SITE GRADING SHALL BE W/IN 0.1' OF THE REQUIRED ELEVATION & ALL AREAS SHALL BE GRADED TO DRAIN.

9. ALL SUBGRADE SHALL HAVE AN LBR OF 40 UNLESS OTHERWISE NOTED & SHALL BE COMPACTED TO 98% MAXIMUM DRY DENSITY PER AASHTO T-180. 10. ALL LIMEROCK SHALL BE COMPACTED TO 98% PER AASHTO T-180 & HAVE NOT LESS THAN

60% OF CARBONATES OF CALCIUM & MAGNESIUM UNLESS OTHERWISE DESIGNATED. ALL 11 CONCRETE & ASPHALT THICKNESS SHALL BE OF TYPE DESIGNATED ON DWGS. (SEE SECTIONS)

12. PLASTIC FILTER FABRIC SHALL BE MIRAFI, TYPAR OR EQUAL CONFORMING TO SECTION 985 OF THE FDOT STANDARD SPECIFICATIONS.

13. CONC. SIDEWALKS SHALL BE 4" THICK ON COMPACTED SUBGRADE, W/ 1/2" EXPANSION JOINTS PLACED AT A MAXIMUM OF 75'. CRACK CONTROL JOINTS SHALL BE 5' ON CENTER. THE BACK OF SIDEWALK ELEVATION SHALL EQUAL THE CROWN OF ROADWAY, UNLESS SPECIFIED OTHERWISE BY LOCAL CODES OR INDICATED ON DWGS. ALL CONC. SIDEWALKS THAT CROSS DRIVEWAYS SHALL BE 6" THICK.

14. PIPE SPECIFICATIONS: THE MATERIAL TYPE IS SHOWN ON THE DRAWINGS BY ONE OF THE FOLLOWING DESIGNATIONS -

RCP = REINFORCED CONC. PIPE, ASTM DESIGNATION C-76, TABLE III CMP = CORRUGATED METAL (ALUM.) PIPE, TM DESIGNATION M-196

CMP = (SMOOTH LINED) CORRUGATED METAL (ALUM.) PIPE, ASTM DESIGNATION M-196 SCP = SLOTTED CONC. PIPE, FDOT SECTIONS 941 & 942

PVC = POLYVINYLCHLORIDE PIPE PCMP = PERFORATED CMP, FDOT SECTION 945

DIP = DUCTILE IRON PIPE

#### PAVEMENT MARKING & SIGNING STANDARD NOTES

1. STOP SIGNS SHALL BE 30"x30" (R1-1), HIGH INTENSITY. 2. ALL SIGNS SHALL BE PLACED AT A HEIGHT NOT LESS THAN 5' & NOT GREATER THAN 7', THE HEIGHT IS MEASURED FROM THE BOTTOM OF THE SIGN TO THE EDGE OF NEAREST PAVEMENT. THE SIGN POST SHALL BE PLACED A MINIMUM OF 6' TO A MAXIMUM OF 12'

FROM THE ADJACENT PAVEMENT, & A MINIMUM OF 6' FROM THE CROSS TRAFFIC

PAVEMENT.

3. STOP BARS SHALL BE 24" WHITE. 4. ALL SITE PAVEMENT MARKINGS SHALL BE THERMOPLASTIC, EXCLUDING PARKING STALL STRIPING.

5. ALL PAVEMENT MARKINGS AND SIGNAGE IN THE ROAD RIGHT-OF-WAY SHALL BE THERMOPLASTIC & SHALL CONFORM TO MUTCD AND PBC TYPICAL T-P-06-001.


FILTER FABRIC TO BE SEALED AT-END OF EXFILTRATION TRENCH - NO SLOTS OR PERFORATION ELEVATIONS ARE REFERENCED TO NAVD 1988 ON THIS LENGTH OF PIPE FOR PERFORATED PIPE, JOINTS ARE TO BE BANDED, BUT NOT GASKETED FIN. GRADE FIN. GRADE-SEE PLAN | (11.50 MIN.) COMPACTED LIMEROCK BASE 24± - POLLUTION NON-WOVEN CONT. FILAMENT PERFORATED HDPE. POLYESTER FILTER PIPE INV. EL. 7.50 TRENCH BTM. 5.50 15" PERF. HDPE. STORM SEWER -\* POLLUTION BAFFLE - BALLAST ROCK SHALL BE 6" LOWER (3/4" or #57) - FDOT STD. NON-WOVEN IN ELEVATION THAN CONT. FILAMENT PIPE INVERT **≺**── 5.00'── POLYESTER FILTER EXFILTRATION TRENCH DETAIL N.T.S. WATER TABLE ELEV.=2.00' NAVD

R1-1 BROWARD CO. TRAFFIC ----ENGINEERING DEPT. STANDARD METAL SIGN POST (TYP.) -EDGE OF PAVEMENT FIN. GRADE CONC. FOOTING, TYP. 4"-ALL AROUND TYPICAL SIGN INSTALLATION

TYPE "D" CONC. CURB

TYPE "D" CONCRETE CURB DETAIL

ASPHALT PAVEMENT

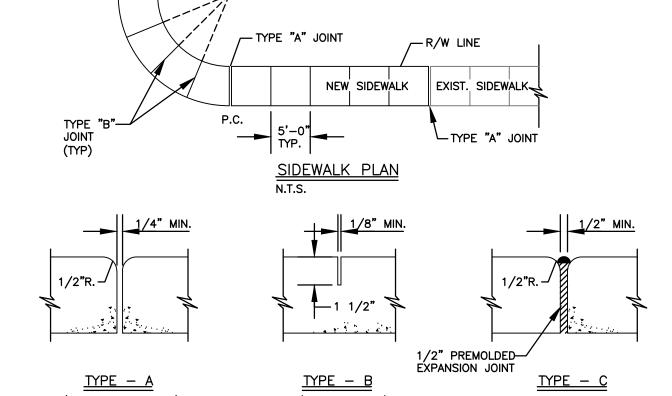



SURFACE WATER MANAGEMENT SYSTEM


NEEDED AND AT LEAST ONCE PER YEAR.


SHALL BE CLEANED/MAINTAINED AS

TYPE "A" JOINT

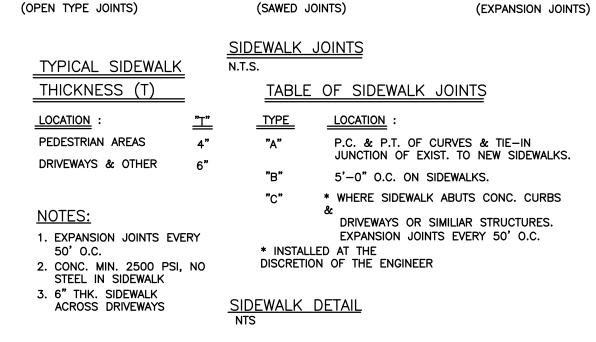

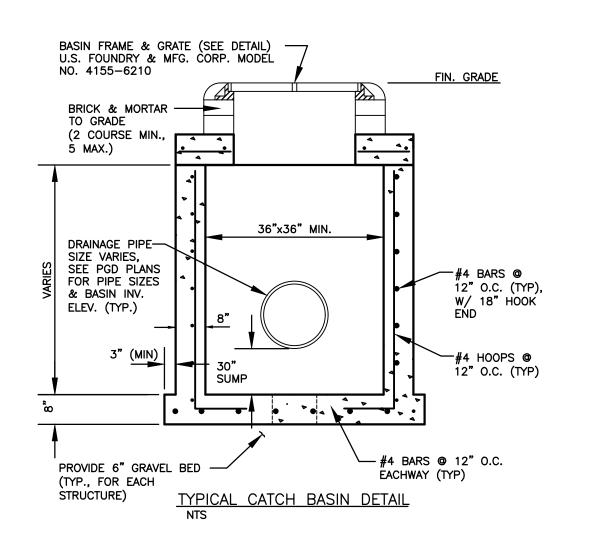

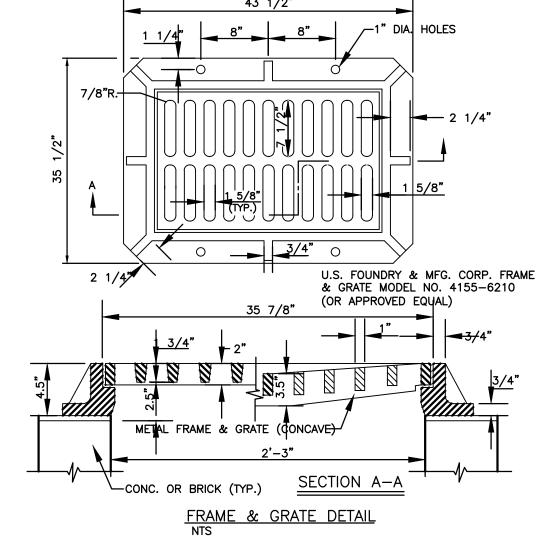

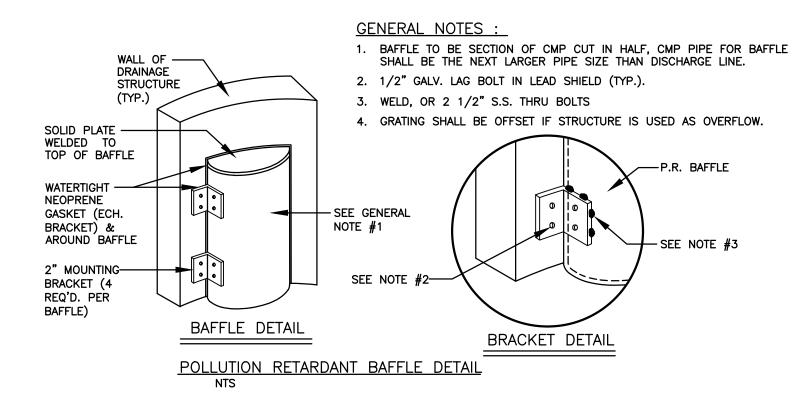


# SALTZ MICHELSON ARCHITECTS


AL'S FLORIST 1700 NORTH SR 7 HOLLYWOOD, FL

3501 Griffin Road Ft. Lauderdale, FL 33312 (954) 266-2700 Fx:(954) 266-2701 sma@saltzmichelson.com

AA-0002897

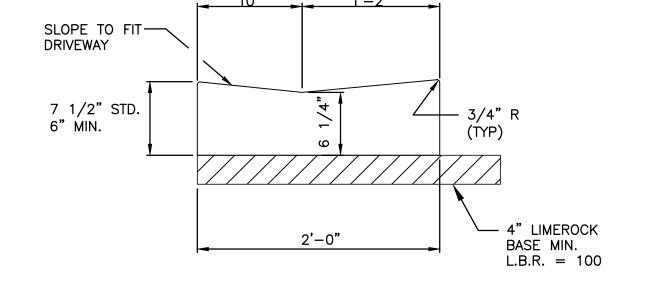

STANDARD DROP CURB

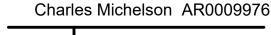


Project No. 2017-186 Drawn By NKW

Checked By

**REVISIONS** 

SCH

Date 07.01.19

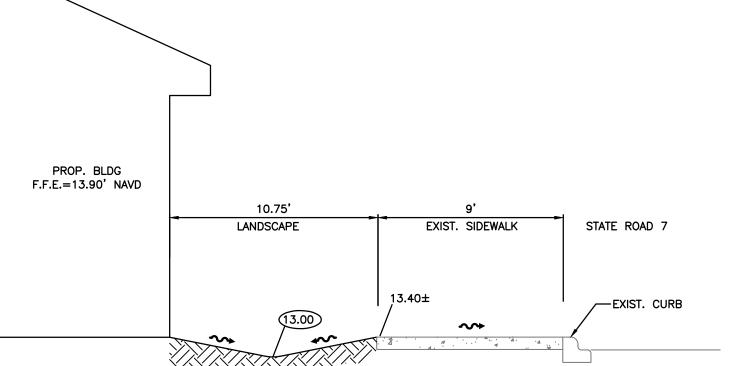






SUSAN C. HOLLAND, PE

Lic. no. 41831

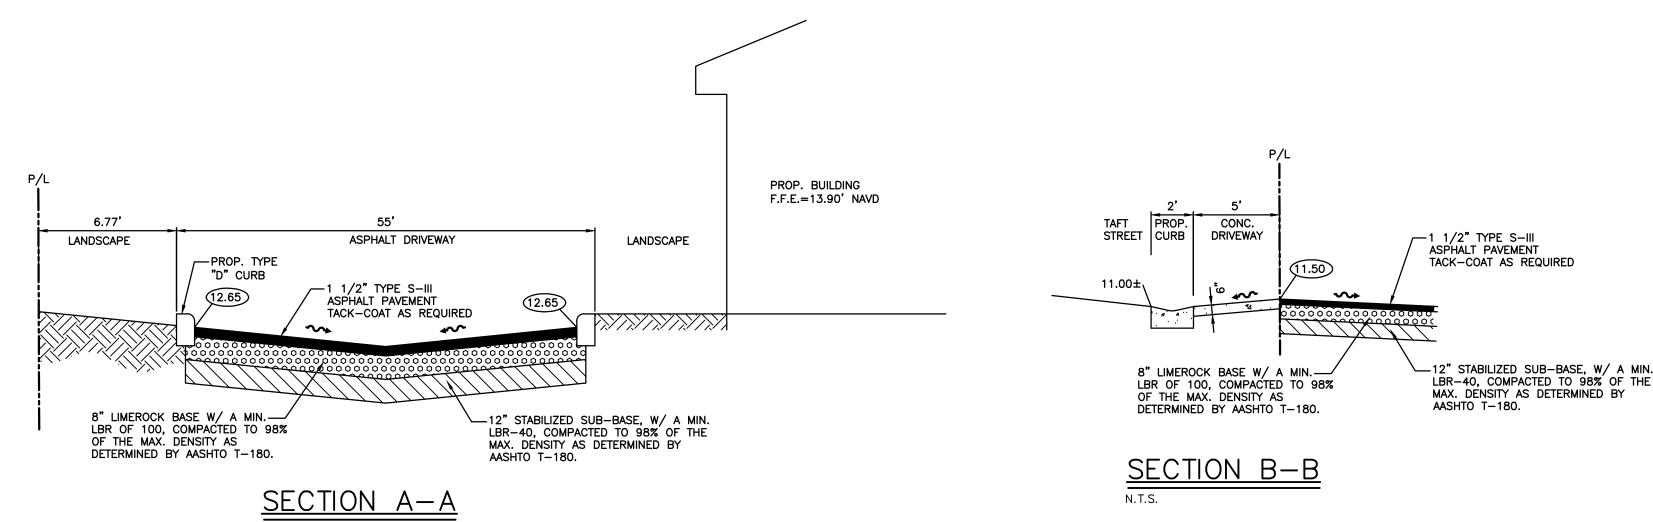

CA 7325

NTS

**CIVIL DETAILS & SECTION PLAN** 

SUBMITT

# ARCHITECTS

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AA-0002897

Project No.:

Charles Michelson AR0009976

2017-186 Drawn By NKW Checked By

SCH Date 07.01.19

**REVISIONS** 

SUBMITT





# HOLLAND ENGINEERING INC. 1120 SE 3RD AVENUE - FORT LAUDERDALE - FL 33316 SUSAN C. HOLLAND, PE Lic. no. 41831

**F**-----

994 DEPARTMENT OF PUBLIC UTILITIES STANDARD DETAIL REVISED: 11/06/2

DRAWING NO.

W-09

YPICAL 2-INCH HDPE WATER SERVICE FOR

SINGLE/DUAL 5/8" TO 1" METERS, AND ANY

SINGLE 1-1/2" TO 2" METERS



### **WATER SYSTEM NOTES:** NEW OR RELOCATED UNDERGROUND WATER MAINS INCLUDED IN THIS PROJECT THAT WILL CROSS ANY


NEW OR RELOCATED UNDERGROUND WATER MAINS INCLUDED IN THIS PROJECT THAT WILL CROSS ANY EXISTING OR PROPOSED PRESSURE-TYPE SANITARY SEWER, WASTEWATER OR STORM WATER FORCE MAIN, OR PIPELINE CONVEYING RECLAIMED WATER WILL BE LAID SO THE OUTSIDE OF THE WATER MAIN IS AT LEAST 12 INCHES ABOVE OR BELOW THE OTHER PIPELINE. [FAC 62-555.314(2); EXCEPTIONS ALLOWED


EXISTING OR PROPOSED GRAVITY OR VACUUM-TYPE SANITARY SEWER OR STORM SEWER WILL BE LAID SO


THE OUTSIDE OF THE WATER MAIN IS AT LEAST SIX INCHES ABOVE THE OTHER PIPELINE OR AT LEAST 12


INCHES BELOW THE OTHER PIPELINE.

- AT ALL UTILITY CROSSINGS DESCRIBED ABOVE, ONE FULL LENGTH OF WATER MAIN PIPE WILL BE CENTERED ABOVE OR BELOW THE OTHER PIPELINE SO THE WATER MAIN JOINTS WILL BE AS FAR AS POSSIBLE FROM THE OTHER PIPELINE. OR THE PIPES WILL BE ARRANGED SO THAT ALL WATER MAIN JOINTS ARE AT LEAST THREE FEET FROM ALL JOINTS IN VACUUM-TYPE SANITARY SEWERS, STORM SEWERS, STORM WATER FORCE MAINS, OR PIPELINES CONVEYING RECLAIMED WATER REGULATED UNDER PART III OF CHAPTER 62-610. F.A.C., AND AT LEAST SIX FEET FROM ALL JOINTS IN GRAVITY OR PRESSURE-TYPE SANITARY SEWERS. WASTEWATER FORCE MAINS, OR PIPELINES CONVEYING RECLAIMED WATER NOT REGULATED UNDER PART III OF CHAPTER 62-610, F.A.C. [FAC 62-555.314(2); EXCEPTIONS ALLOWED UNDER FAC 62-555.314(5)].
- NEW UNDERGROUND WATER MAINS INCLUDED IN THIS PROJECT TO BE DUCTILE IRON PIPE (D.I.P.) WHEN CROSSING BELOW SANITARY SEWER MAINS.
- POLYETHYLENE ENCASEMENT MATERIAL SHALL BE USED TO ENCASE ALL BURIED DUCTILE IRON PIPE, FITTINGS, VALVES, RODS, AND APPURTENANCES IN ACCORDANCE WITH AWWA C105, METHOD A. THE POLYETHYLENE TUBING SHALL BE CUT TWO FEET LONGER THAN THE PIPE SECTION AND SHALL OVERLAP THE ENDS OF THE PIPE BY ONE FOOT. THE POLYETHYLENE TUBING SHALL BE GATHERED AND LAPPED TO PROVIDE A SNUG FIT AND SHALL BE SECURED AT QUARTER POINTS WITH POLYETHYLENE TAPE. EACH END OF THE POLYETHYLENE TUBING SHALL BE SECURED WITH A WRAP OF POLYETHYLENE TAPE.
- THE POLYETHYLENE TUBING SHALL PREVENT CONTACT BETWEEN THE PIPE AND BEDDING MATERIAL, BUT IS NOT INTENDED TO BE A COMPLETELY AIRTIGHT AND WATERTIGHT ENCLOSURE. DAMAGED POLYETHYLENE TUBING SHALL BE REPAIRED IN A WORKMANLIKE MANNER USING POLYETHYLENE TAPE, OR THE DAMAGED SECTION SHALL BE REPLACED. POLY WRAP WILL NOT BE PAID FOR AS A SEPARATE BID ITEM. IT SHALL BE CONSIDERED TO BE A PART OF THE PRICE BID FOR WATER MAINS.
- FIRE HYDRANT BARRELS SHALL BE ENCASED IN POLY WRAP UP TO THE GROUND SURFACE AND THE WEEP HOLES SHALL NOT BE COVERED BY THE POLY WRAP.
- GATE VALVES FOR USE WITH PIPE LESS THAN THREE INCHES (3") IN DIAMETER SHALL BE RATED FOR TWO HUNDRED (200) PSI WORKING PRESSURE, NON-SHOCK, BLOCK PATTERN, SCREWED BONNET. NON-RISING STEM, BRASS BODY, AND SOLID WEDGE. THEY SHALL BE STANDARD THREADED FOR PVC PIPE AND HAVE A MALLEABLE IRON HANDWHEEL, GATE VALVES 3" THROUGH 16" IN DIAMETER SHALL BE RESILIENT SEAT AND BIDIRECTIONAL FLOW ONLY. VALVES FOR SPECIAL APPLICATIONS WILL REQUIRE CITY UTILITY APPROVAL.
- VALVE BOXES AND COVERS FOR ALL SIZE VALVES SHALL BE OF CAST IRON CONSTRUCTION AND ADJUSTABLE SCREW-ON TYPE. THE LID SHALL HAVE CAST IN THE METAL THE WORD "WATER" FOR THE WATER LINES. ALL VALVE BOXES SHALL BE SIX INCH (6") NOMINAL DIAMETER AND SHALL BE SUITABLE FOR DEPTHS OF THE PARTICULAR VALVE. THE STEM OF THE BURIED VALVE SHALL BE WITHIN TWENTY-FOUR INCHES (24") OF THE FINISHED GRADE UNLESS OTHERWISE APPROVED BY THE CITY.
- 10. ALL WATER MAIN INSTALLATIONS SHALL COMPLY WITH THE COLOR CODING REQUIREMENTS OF CHAPTER

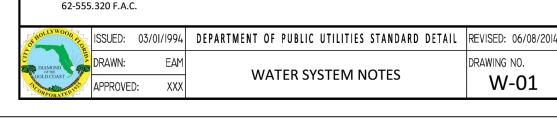

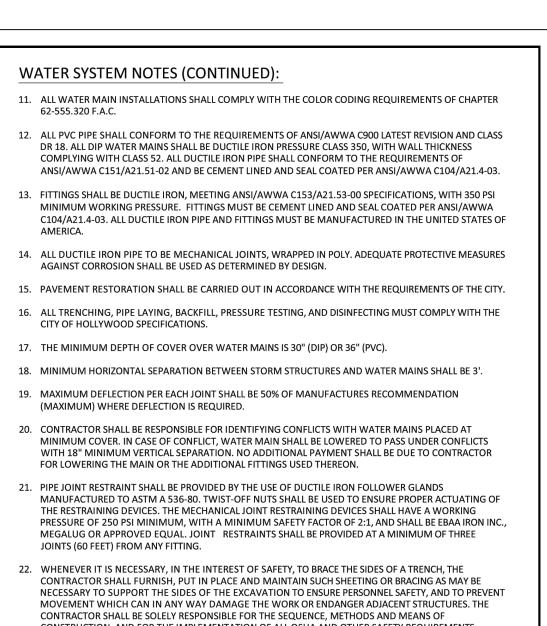

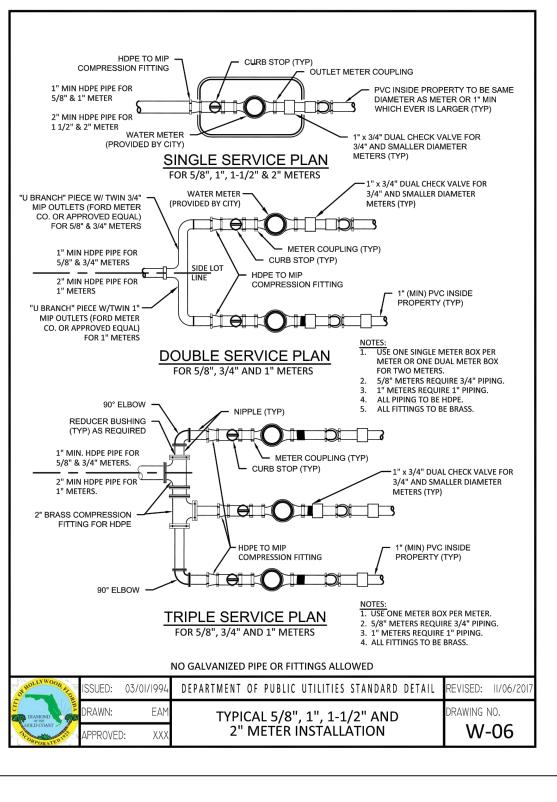

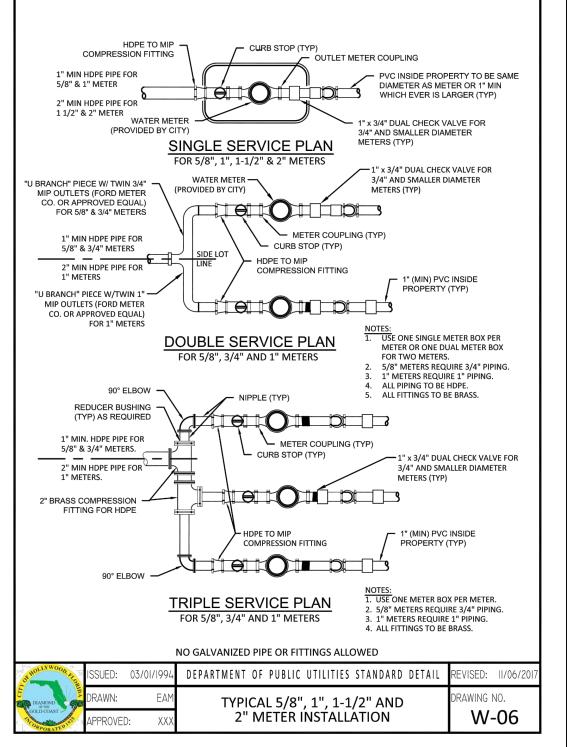

	_	FOR 5/8", 3/4" AND 1" METERS	2. 5/8" METERS REQUII 3. 1" METERS REQUIRE 4. ALL FITTINGS TO BE I	1" PIPING.	G.												
		NO GALVANIZED PIPE OR FITTINGS ALLO	WED														
): 03	/01/1994	DEPARTMENT OF PUBLIC UTILITIES S	STANDARD DETAIL	REVISED:	11/06/2017		OF HOLLY WOOD AND SERVICE SERV	ISSUED:	03/01/1994	DEPARTMENT	OF PUBLIC	UTILITIES S	TANDARD I	DETAIL	REVISED:	11/06/2017	
l:	EAM	1 1 1 1 1 1 1 1 1 1 1 1 1 1 1 1 1 1 1		DRAWING NO.				DIAMOND SOFTHE	DRAWN:	EAM	WATER I	METER S	ERVICE N	NOTES F	FOR	DRAWING N	
VED:	XXX			W-	06		GOLD COAST	APPROVEI	D: XXX	5/8	" THROU	GH 2" ME	TERS		W-	07	

**WATER METER SERVICE NOTES:** 

THE SAME AS THE METER DIAMETER.

HOLLYWOOD (NEW ACCOUNTS).

THE EXISTING BALL VALVE CURB STOP.

SIDEWALK, WHENEVER PRACTICAL.

SERVICE INSTALLATION.

6. APPROVED COPPER TUBING MAY BE USED AT THE CITY'S DISCRETION.

1. SUCCESSIVE TAPS INTO THE WATER MAIN SHALL BE SPACED NOT LESS THAN 18" ON CENTER.

MINIMUM SERVICE PIPE DIAMETER SHALL BE 1" FOR SINGLE OR DUAL ¾" OR SINGLE 1"

MINIMUM SERVICE PIPE DIAMETER SHALL BE 2" FOR SINGLE OR DUAL 1-1/2" OR SINGLE 2"

FOR METER DIAMETERS LARGER THAN 2", THE MINIMUM SERVICE PIPE DIAMETER SHALL BE

FOR NEW METER INSTALLATIONS, ALL SADDLES, VALVES, PIPING, FITTINGS, CURB STOPS, METER

VALVES, METER COUPLINGS, METER VAULTS AND COVERS SHALL BE FURNISHED AND INSTALLED

VALVES, METER COUPLINGS, METER VAULTS AND COVERS SHALL BE FURNISHED AND INSTALLED

a. CUT AND PLUG THE EXISTING SERVICE LINE AT THE MAIN AND AT THE METER, AND REMOVE

b. FURNISH AND INSTALL SERVICE SADDLE, CORPORATION STOP OR SERVICE VALVE AND VALVE

BY THE CONTRACTOR. THE WATER METERS WILL BE PROVIDED AND INSTALLED BY THE CITY OF

FOR METER RELOCATIONS, ALL SADDLES, VALVES, PIPING, FITTINGS, CURB STOPS, METER

9. FOR EXISTING METERS ABUTTING THE RIGHT-OF-WAY THAT ARE BEING DISCONNECTED FROM

BOX, PIPING AND FITTINGS UP TO AND INCLUDING THE BALL VALVE CURB STOP.

12. THE ELEVATION AT THE TOP OF THE METER BOX SHALL MATCH THE ELEVATION OF THE BACK OF

13. AS PART OF THE SERVICE INSTALLATION, THE CONTRACTOR SHALL RESTORE THE RIGHT-OF-WAY

AND RPMs, CONCRETE CURBS, SIDEWALKS, RAMPS (INCLUDING DETECTABLE WARNING

14. FOR UNPAVED AREAS, THE MINIMUM GROUND COVER ACCEPTED BY THE CITY IS SODDING.

TO MATCH EXISTING CONDITIONS, INCLUDING ROADWAY PAVEMENT, PAVEMENT MARKINGS


SURFACE), SODDING, AND ALL OTHER IMPROVEMENTS REMOVED OR DAMAGED DURING THE


EXISTING MAINS AND RECONNECTED TO NEW MAINS, THE CONTRACTOR SHALL:


BY THE CONTRACTOR. THE EXISTING WATER METER TO BE RELOCATED AND INSTALLED BY

2. P.E. TUBING SHALL BE IN ACCORDANCE WITH THE LATEST EDITION OF AWWA STANDARD C901,

"POLYETHYLENE (PE) PRESSURE PIPE AND TUBING, 1/2 IN. (13mm) THROUGH 3 IN. (76 mm), FOR

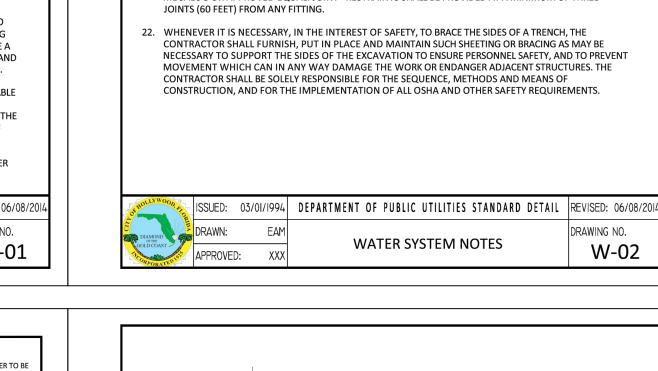

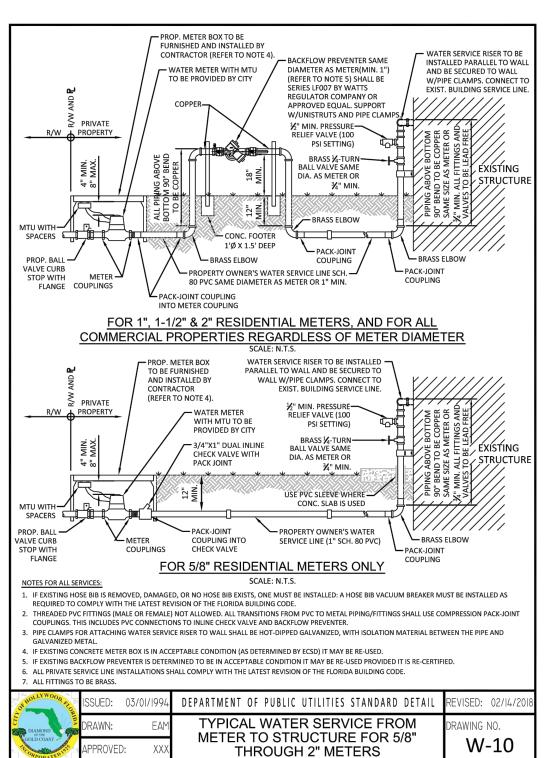


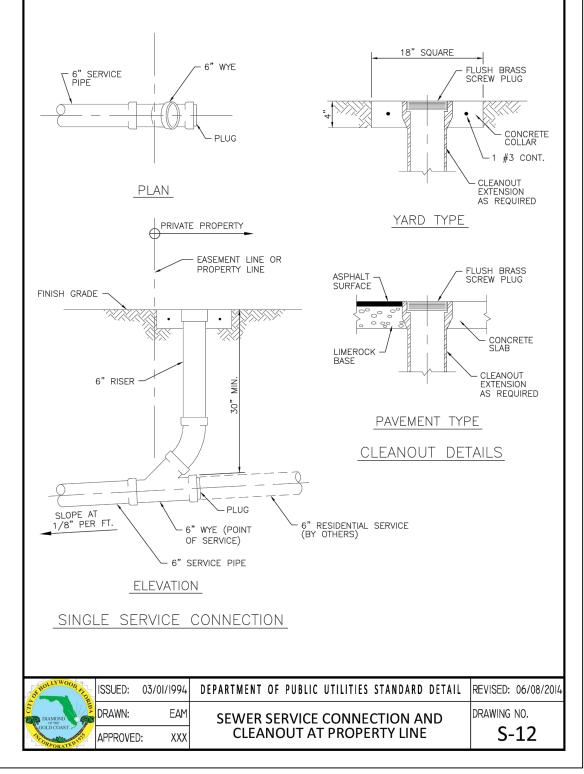

**UTILITY DETAILS** 

NTS

CA 7325

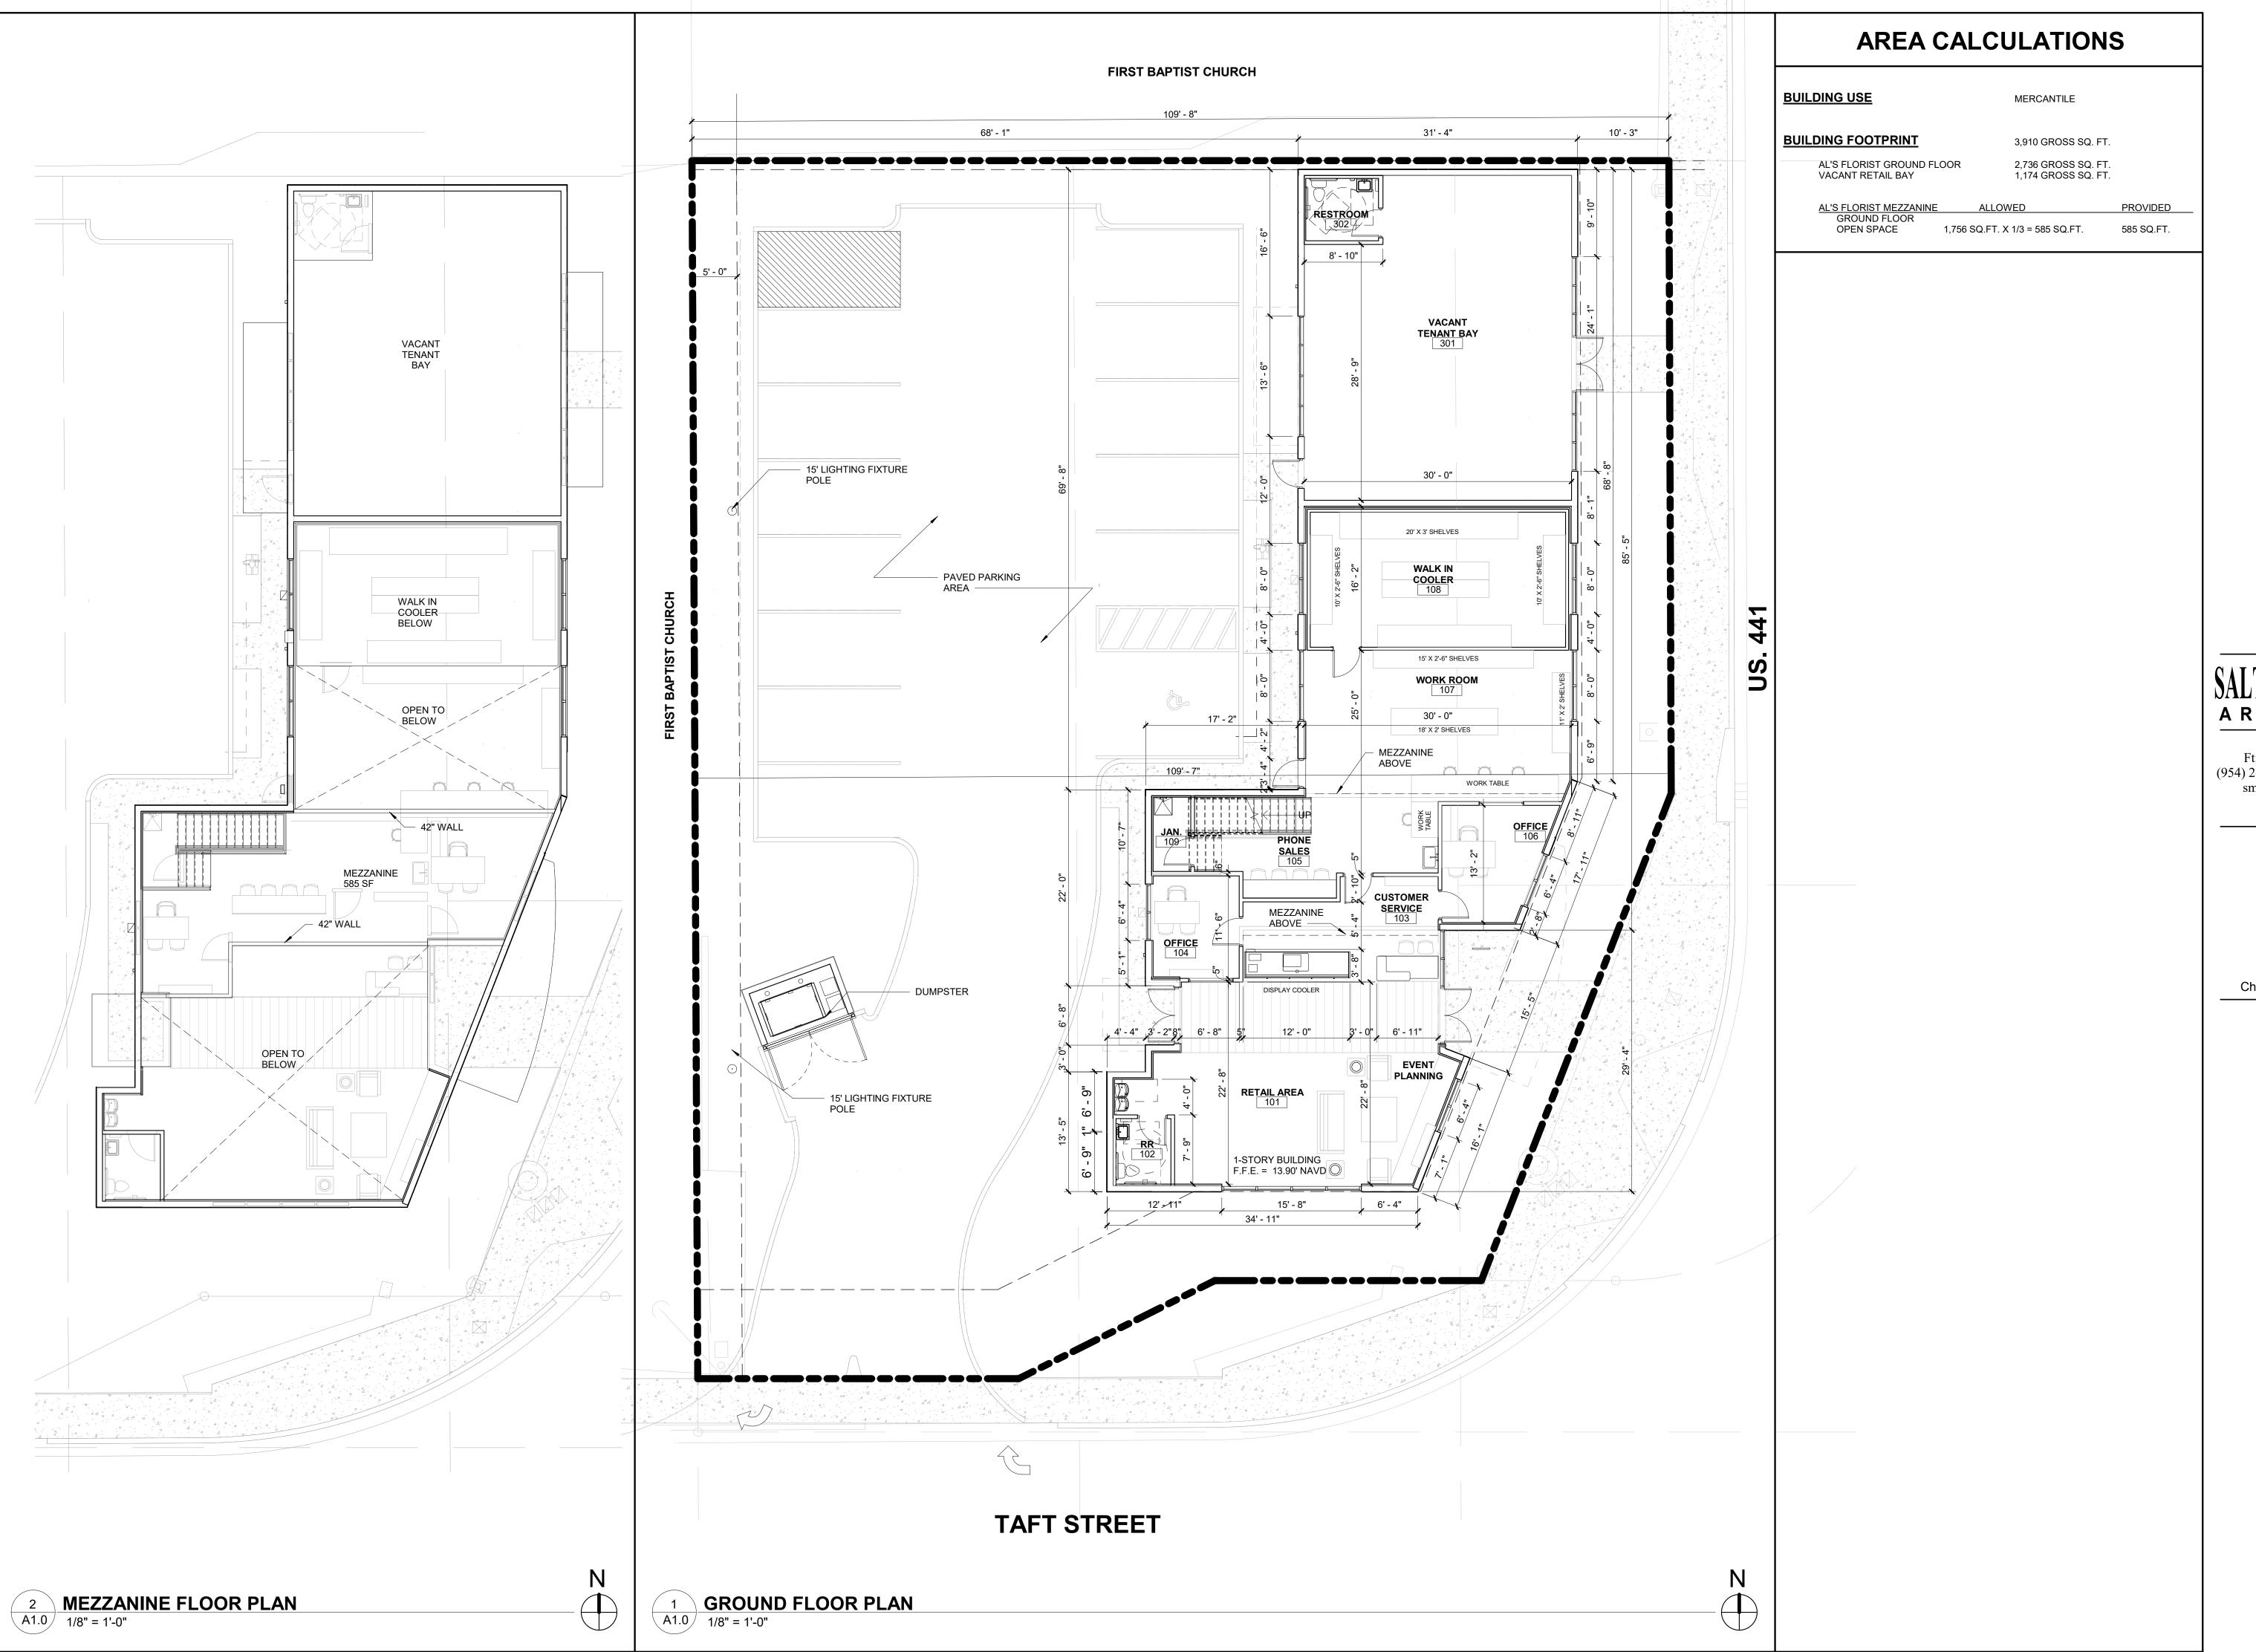

1700 NORTH SR 7 HOLLYWOOD, FL

# SALTZ MICHELSON ARCHITECTS

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AA-0002897

#### Charles Michelson AR0009976

Project No.: 2017-186 Drawn By : MG


Checked By:

Date 07.01.19

REVISIONS

**A1.0** 



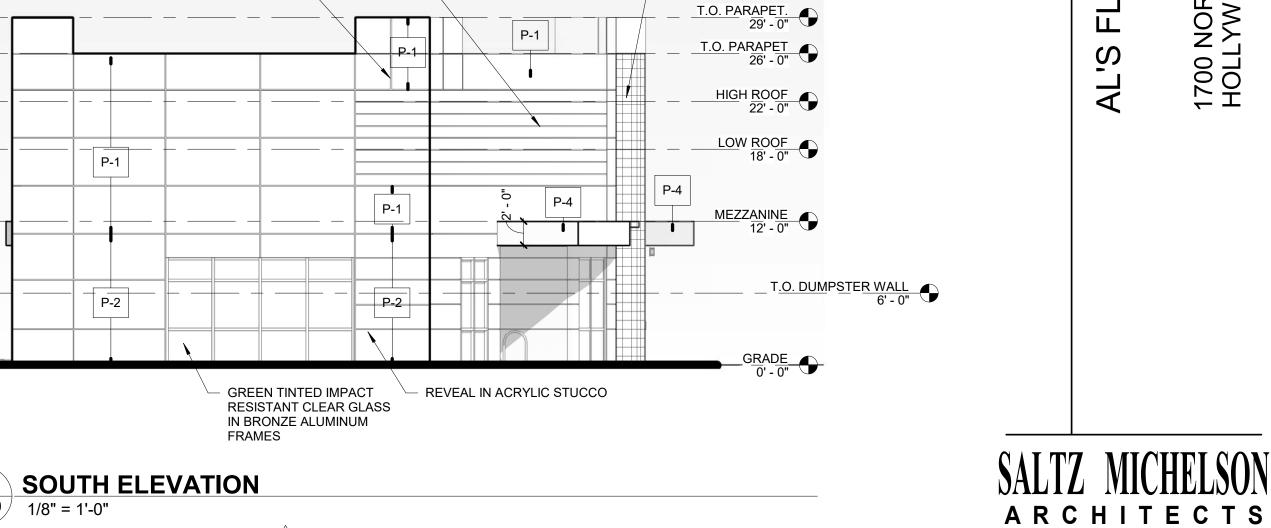

VINE ON STAINLESS

STEEL CABLE

LATTICE SYSTEM

**EAST ELEVATION** A3.0 1/8" = 1'-0"

DECORATIVE METAL PANELS IN STANDARD COLORS TO MATCH

P-1

P-1

BLDG. PAINTS -

SAFETY LIGHT, TYP

PRE ENGINEERED PRE FRABRICATED METAL AWNING —

GREEN TINTED IMPACT

RESISTANT CLEAR
GLASS IN BRONZE
ALUMINUM FRAME

VINE ON STAINLESS

STEEL CABLE

└─ REVEAL

LATTICE SYSTEM

REVEAL IN

ACRYLIC STUCCO

P-3

IMPACT RESISTANT SPANDREL GLASS IN

BRONZE FRAME ———

GREEN TINTED IMPACT

P-1

P-4

RESISTANT CLEAR

GLASS IN BRONZE

ALUMINUM FRAME

P-3

# A3.0 1/8" = 1'-0"

DECORATIVE METAL PANELS IN STANDARD

COLORS TO MATCH BLDG. PAINTS ———

REVEAL IN ACRYLIC STUCCO

# **COLOR LEGEND**

P-1 SW 6086 / 197-C2 SAND DUNE P-2 SW 6032 / 192-C5 DUTCH COCOA P-3 SW 6348 / 125-C5 REYNARD

P-4 SW 7041 / 249-C7 VAN DYKE BROWN

# **SPECIFIC NOTES**

The state of the s

1. ALL SIGNAGE SHALL BE IN COMPLIANCE WITH THE ZONING AND LAND DEVELOPMENT REGULATIONS.

2. ALL SIGNAGE WILL BE UNDER A SEPARATE PERMIT.

DECORATIVE METAL PANELS IN STANDARD COLORS TO MATCH BLDG. PAINTS REVEAL IN ACRYLIC STUCCO T.O. PARAPET. 29' - 0" T.O. PARAPET 26' - 0" HIGH ROOF 22' - 0" LOW ROOF 18' - 0" \_\_\_\_\_ P-1 P-4 P-4 P-1 MEZZANINE 12' - 0" P-3 P-2

**3 WEST ELEVATION** A3.0 1/8" = 1'-0"

**REVISIONS** 

T.O. DUMPSTER WALL 6' - 0"

Date

07.01.19

3501 Griffin Road Ft. Lauderdale, FL 33312

(954) 266-2700 Fx:(954) 266-2701 sma@saltzmichelson.com

AA-0002897

Charles Michelson AR0009976

Project No.:


2017-186

Drawn By : MG

Checked By:

**◯ 07.01.19 TAC COMMENTS 2** 08.15.19 TAC COMMENTS

**A3.0** 

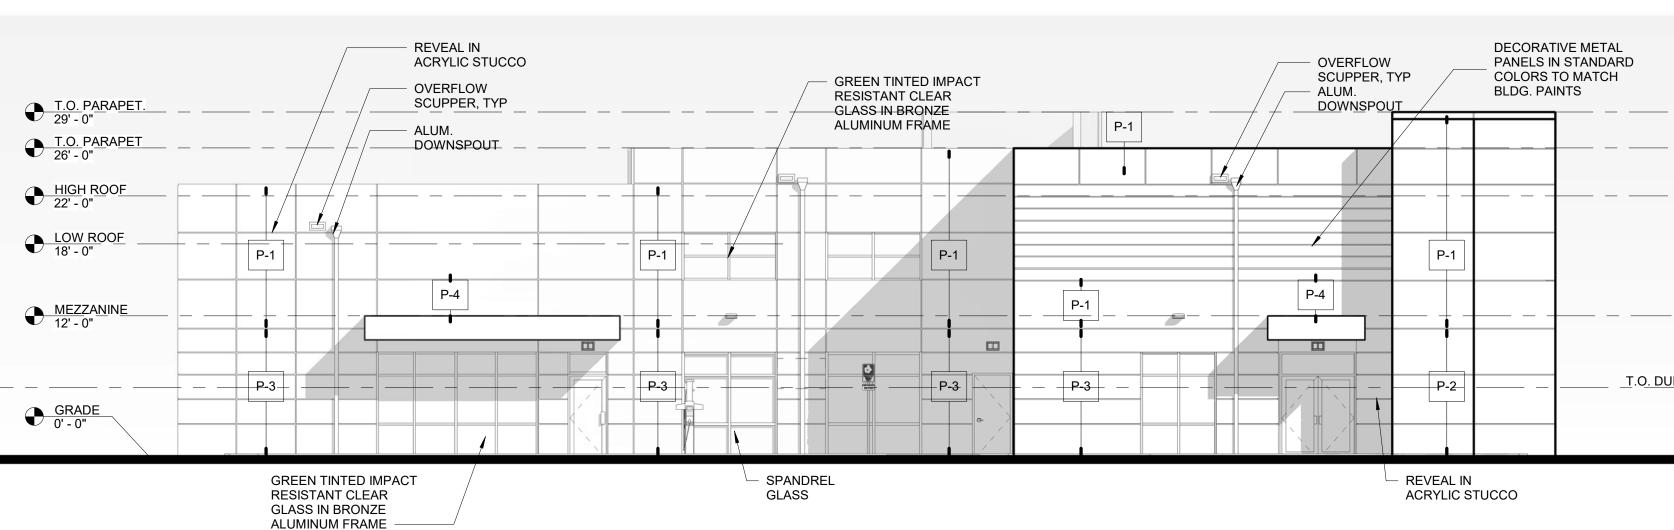

T.O. DUMPSTER WALL 6' - 0"

T.O. PARAPET. 29' - 0"

T.O. PARAPET 26' - 0"

HIGH ROOF 22' - 0"

LOW ROOF 18' - 0"

MEZZANINE 12' - 0"

T.O. DUMPSTER WALL 6' - 0"

P-1

P<del>-3</del>

GREEN TINTED IMPACT RESISTANT CLEAR GLASS IN

BRONZE ALUMINUM FRAME

4 NORTH ELEVATION A3.0 1/8" = 1'-0"

REVEAL IN ACRYLIC STUCCO

1 STREET PROFILE 441 1/16" = 1'-0"

# SALTZ MICHELSON ARCHITECTS

AL'S FLORIST

1700 NORTH SR 7 HOLLYWOOD, FL

3501 Griffin Road Ft. Lauderdale, FL 33312 (954) 266-2700 Fx:(954) 266-2701 sma@saltzmichelson.com

AA-0002897

### Charles Michelson AR0009976

Project No.: 2017-186

Drawn By: JC

Checked By:

Date 07.01.19

REVISIONS

1 07.01.19 TAC COMMENTS


Z 71 07.01.19 TAC COMMENTS


700 SR 7\_

NEW SHEET


NEW SHEET

A3.1

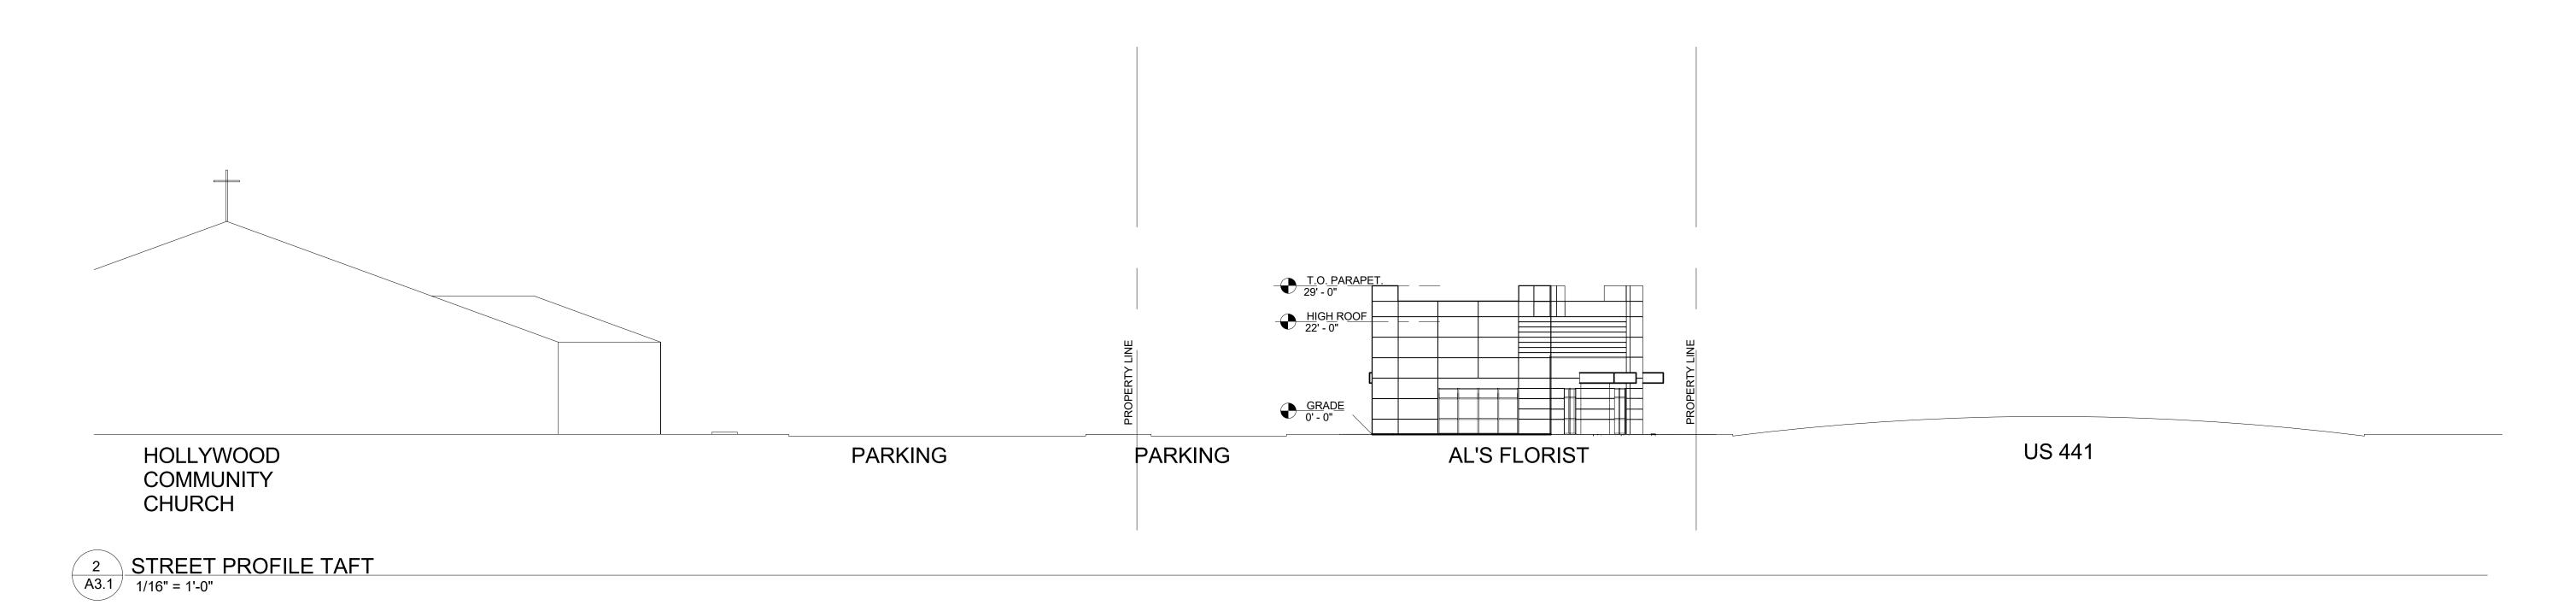

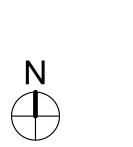

 $\circ$ 

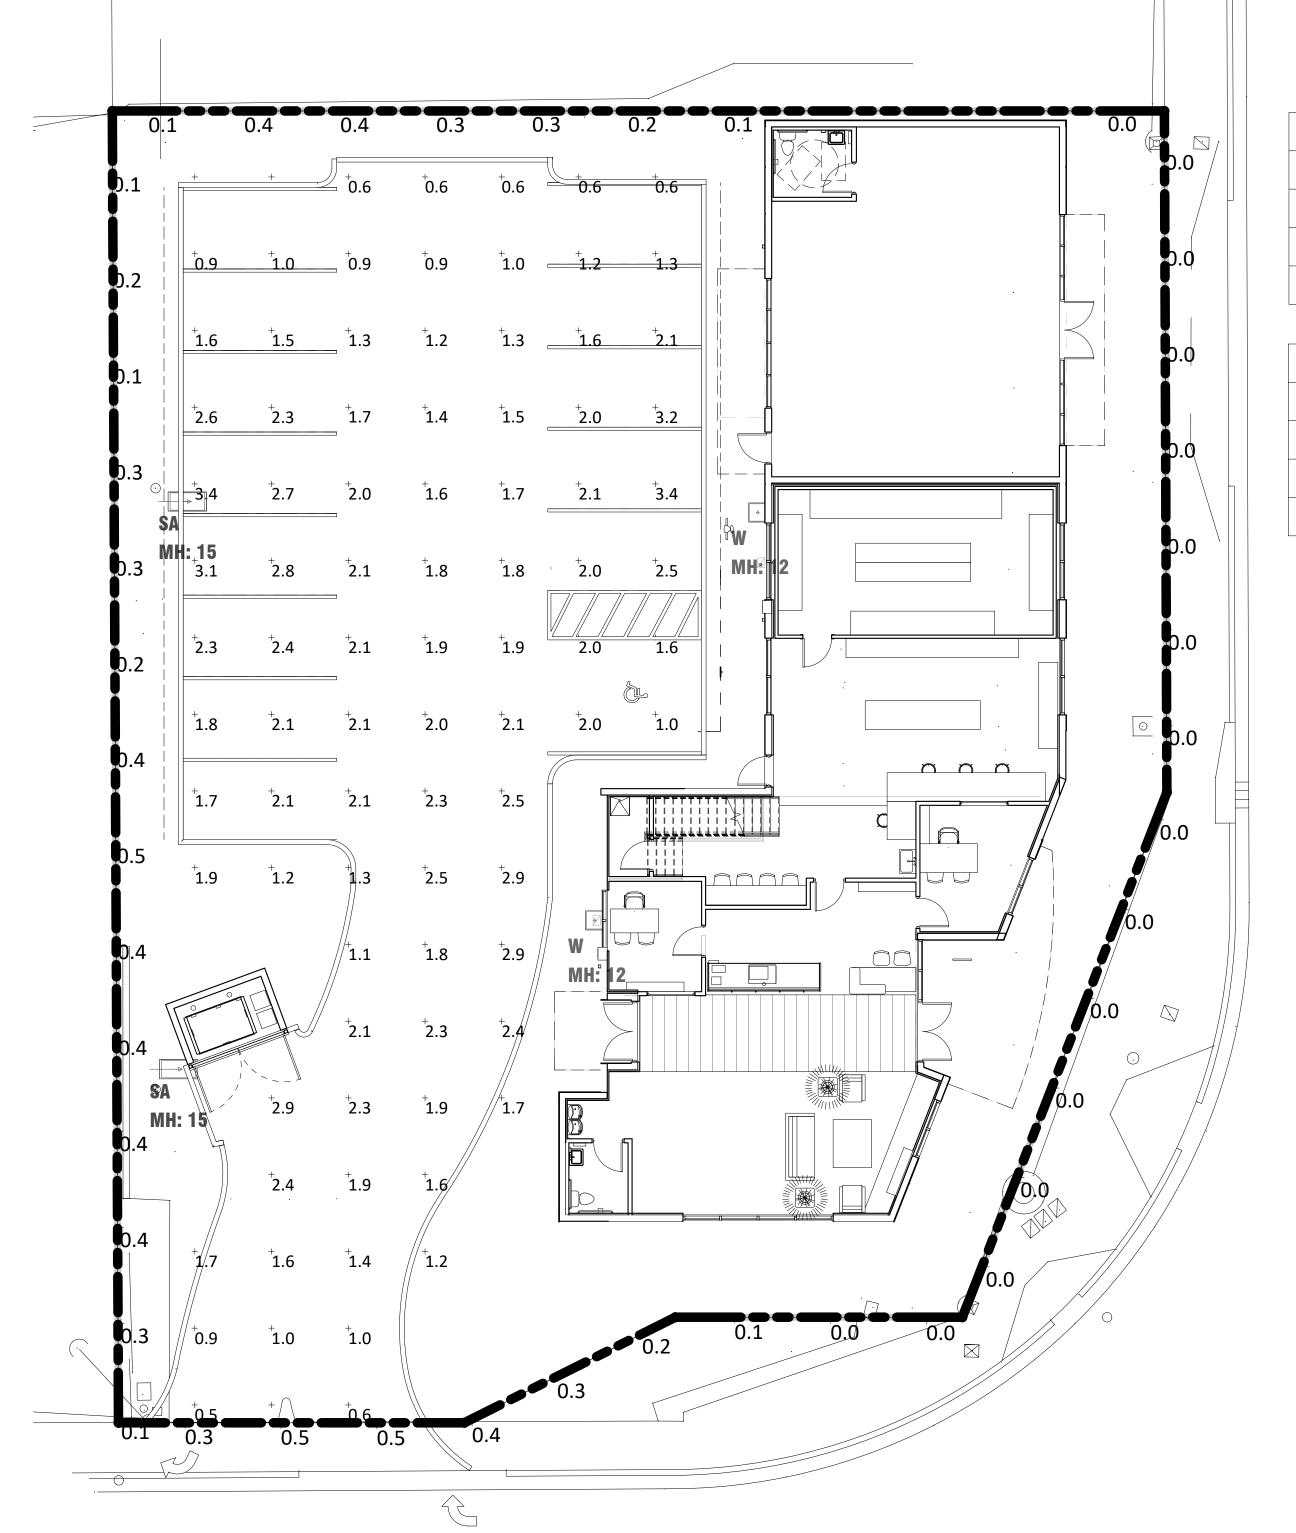

Calculation Summary								
Project: AL'S FLORIST SITE - JUNE 3, 2019								
Label	Avg	Max	Min	Avg/Min	Max/Min			
PROPERTY LINE SPILL	0.17	0.5	0.0	N.A.	N.A.			
SITE PARKING	1.74	3.4	0.5	3.48	6.80			

Luminaire Schedule									
Project: AL'S FLORIST SITE - JUNE 3, 2019									
Symbol	Qty	Label	Description	LLF	Lum. Watts	Total Watts			
-	2	SA	GARDCO ECF-S-32L-530-NW-G2-4-HIS POLE MOUNTED 15'	0.810	55.7	111.4			
$\boxed{ \Rightarrow  }$	2	w	GARDCO 121-16L-1000-NW-G3-4 WALL MOUNTED	0.810	55	110			

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AA-0002897

Charles Michelson AR0009976

Project No. : 2017-186

Drawn By: JC Checked By: CM

Date 07.01.19

REVISIONS

1 07.01.19 TAC COMMENTS 2 08.15.19 TAC COMMENTS

NEW SHEET

PH-1

2 **PHOTOMETRICS**1" = 10'-0"



#### SALTZ MICHELSON ARCHITECTS

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# AL'S FLORIST

SCALE: N.T.S.



Project No.: 2017-186 Drawn By: MG Checked By: CM Date: 08.16.19





# RENDERING HOLLYWOOD, FL **FLORIST** AL'S

A R C H I T E C T S

3501 Griffin Road
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(954) 266-2700 Fx: (954) 266-2701
sma@saltzmichelson.com

#### Charles Michelson AR0009976

Project No.: 2017-186

Drawn By:

VA Checked By:

CM Date: 8-16-19