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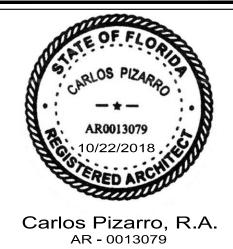
PROPOSED COLOR IMAGE



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Architecture • Planning • Interior Design

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AR - 0013079

Revisions:

10/02/2018 2 FINAL TAC REV.2

I DEVELOPERS LIMITED

I'S SHOPPING CENTER

Job Number: 15087.03

File Name:

Issued Date:

Drawn by: JC / LO


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SHEET NAME

COLOR IMAGES

SHEET NUMBER

A-17.0

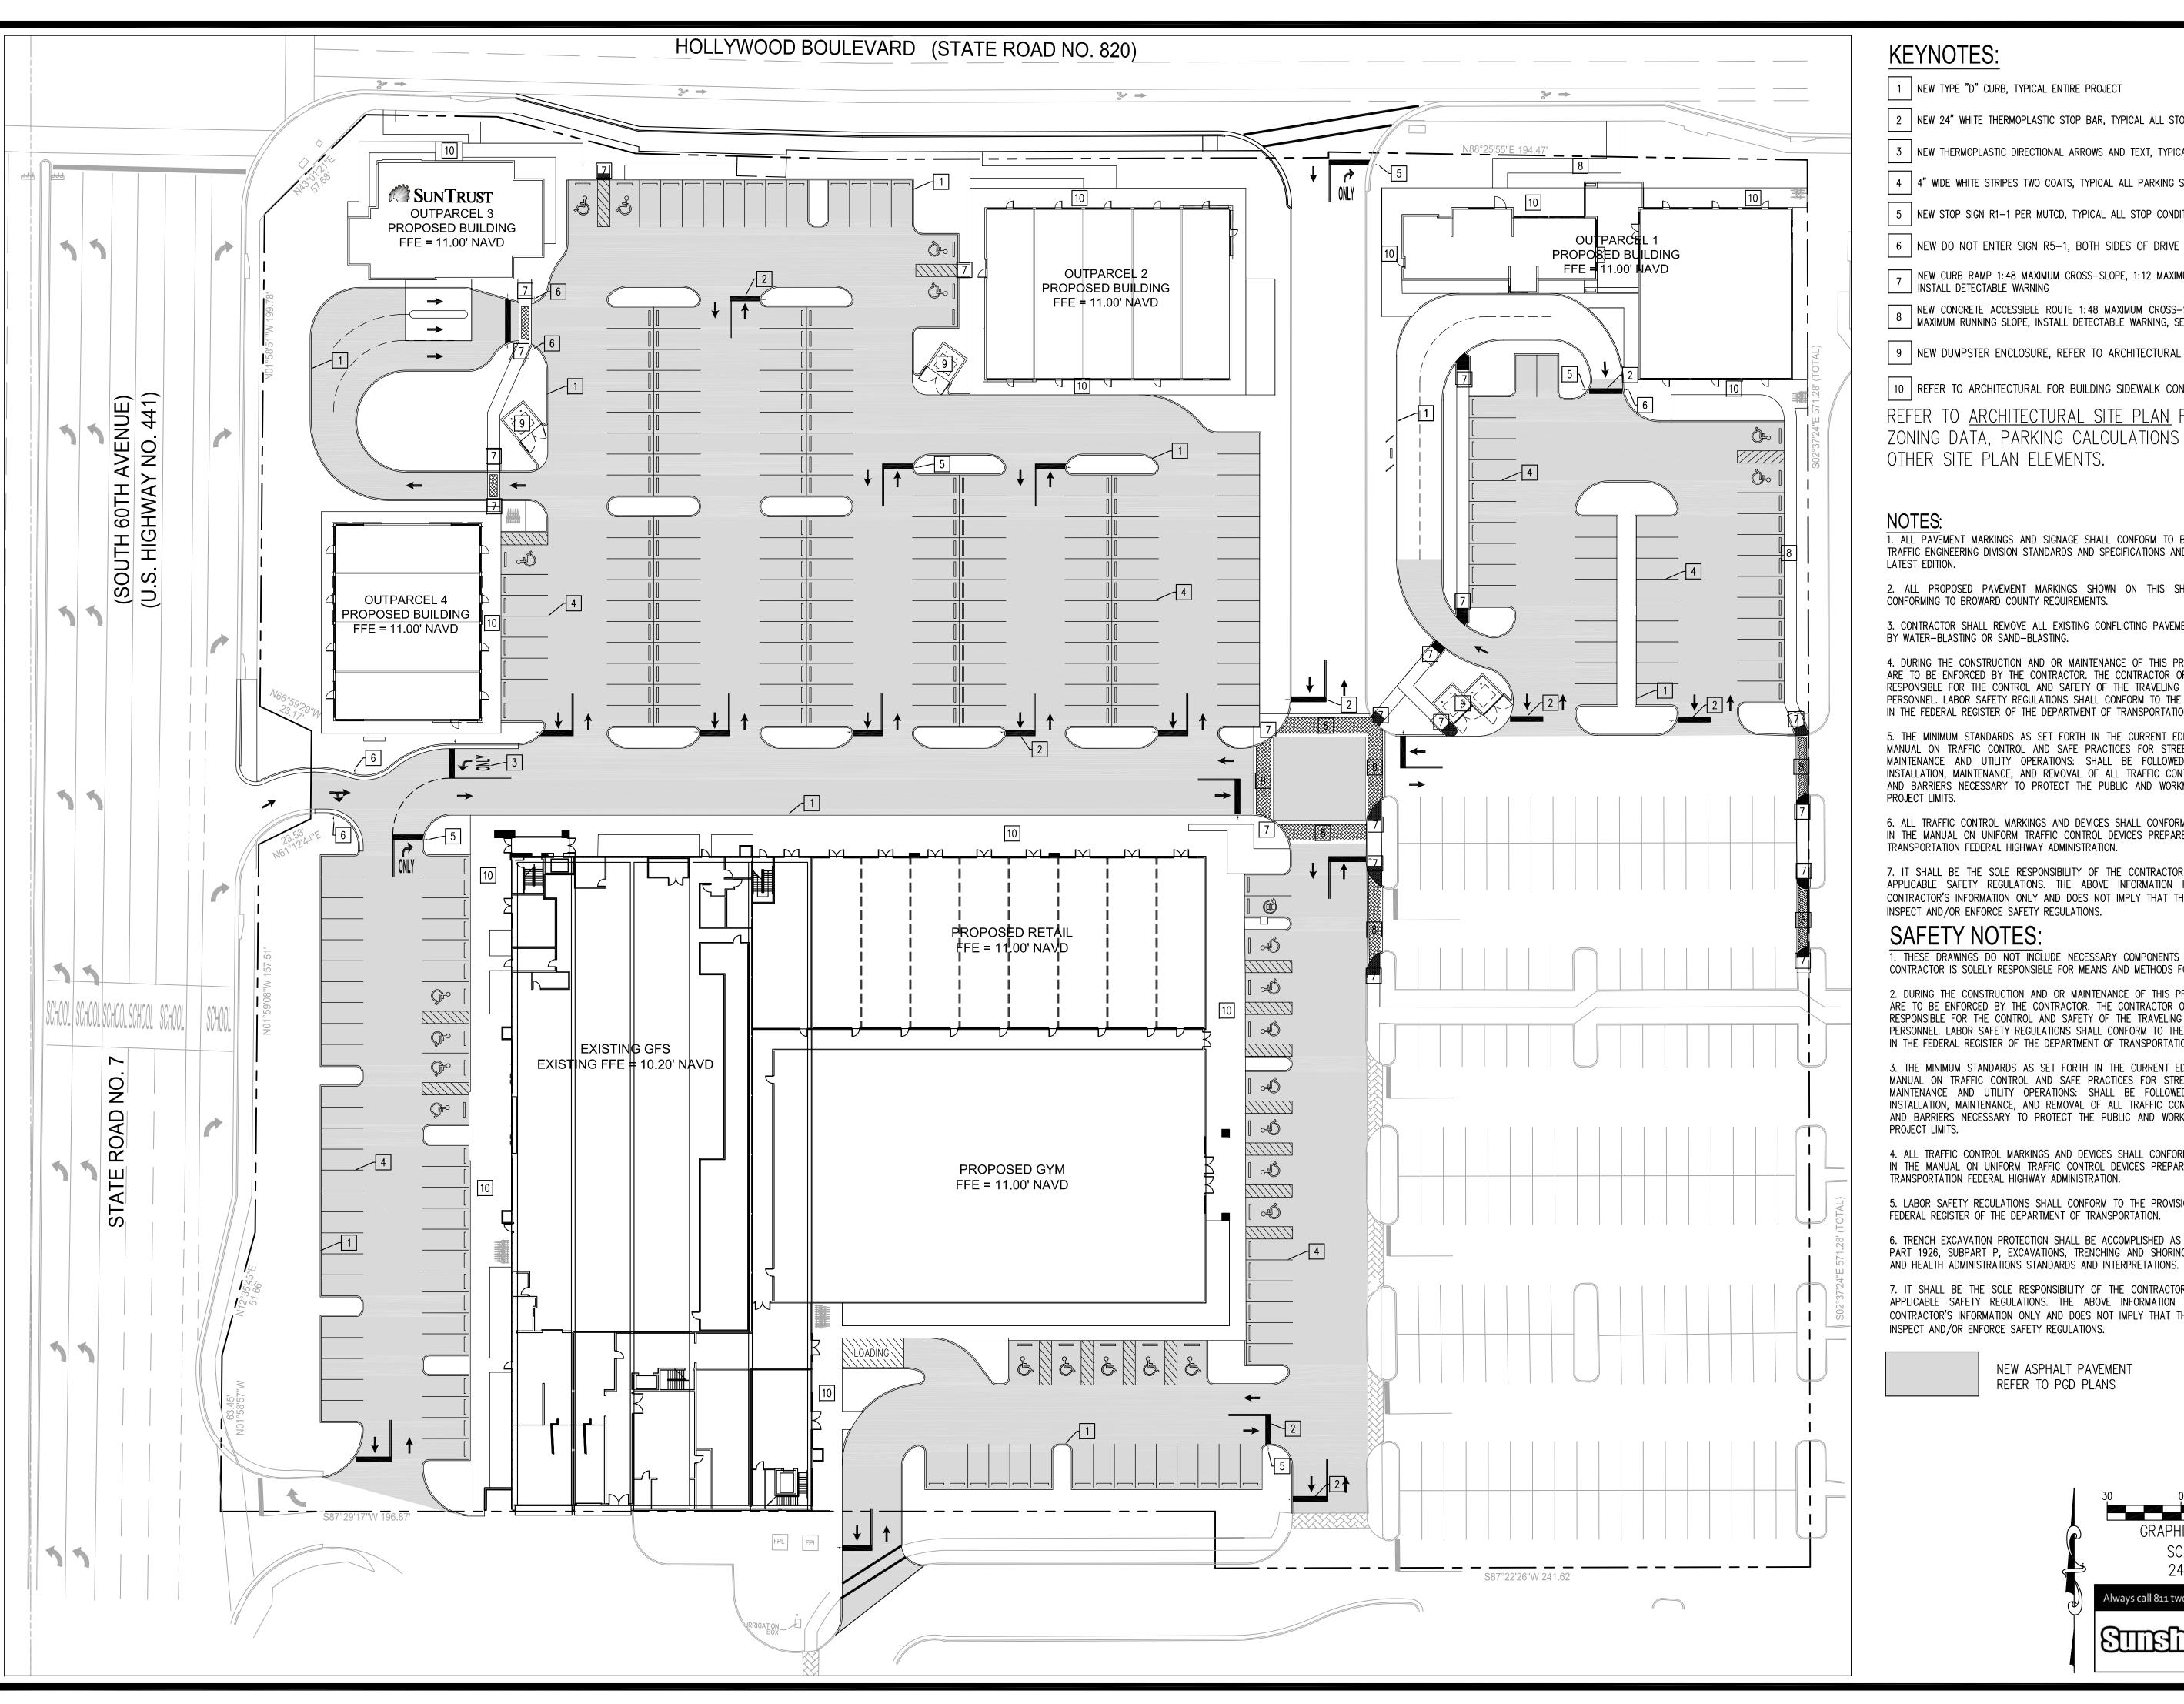

- 1 NEW TYPE "D" CURB, TYPICAL ENTIRE PROJECT
- 2 | NEW 24" WHITE THERMOPLASTIC STOP BAR, TYPICAL ALL STOP CONDITIONS
- 3 NEW THERMOPLASTIC DIRECTIONAL ARROWS AND TEXT, TYPICAL ALL STOP CONDITIONS
- 4 4" WIDE WHITE STRIPES TWO COATS, TYPICAL ALL PARKING SPACES
- 5 | NEW STOP SIGN R1-1 PER MUTCD, TYPICAL ALL STOP CONDITIONS
- 6 NEW DO NOT ENTER SIGN R5-1, BOTH SIDES OF DRIVE
- NEW CURB RAMP 1:48 MAXIMUM CROSS-SLOPE, 1:12 MAXIMUM RUNNING SLOPE, INSTALL DETECTABLE WARNING
- NEW CONCRETE ACCESSIBLE ROUTE 1:48 MAXIMUM CROSS—SLOPE, 1:20 (5.0%) MAXIMUM RUNNING SLOPE, INSTALL DETECTABLE WARNING, SEE DETAILS

- 10 REFER TO ARCHITECTURAL FOR BUILDING SIDEWALK CONSTRUCTION REFER TO <u>ARCHITECTURAL SITE PLAN</u> FOR ZONING DATA, PARKING CALCULATIONS AND OTHER SITE PLAN ELEMENTS.

1. ALL PAVEMENT MARKINGS AND SIGNAGE SHALL CONFORM TO BROWARD COUNTY PUBLIC WORKS, TRAFFIC ENGINEERING DIVISION STANDARDS AND SPECIFICATIONS AND SHALL CONFORM TO THE MUTCD

2. ALL PROPOSED PAVEMENT MARKINGS SHOWN ON THIS SHEET SHALL BE THERMOPLASTIC CONFORMING TO BROWARD COUNTY REQUIREMENTS.

3. CONTRACTOR SHALL REMOVE ALL EXISTING CONFLICTING PAVEMENT MARKINGS IN THE DRIVEWAYS BY WATER-BLASTING OR SAND-BLASTING.

4. DURING THE CONSTRUCTION AND OR MAINTENANCE OF THIS PROJECT, ALL SAFETY REGULATIONS ARE TO BE ENFORCED BY THE CONTRACTOR. THE CONTRACTOR OR HIS REPRESENTATIVE SHALL BE RESPONSIBLE FOR THE CONTROL AND SAFETY OF THE TRAVELING PUBLIC AND THE SAFETY OF HIS PERSONNEL. LABOR SAFETY REGULATIONS SHALL CONFORM TO THE PROVISIONS SET FORTH BY OSHA IN THE FEDERAL REGISTER OF THE DEPARTMENT OF TRANSPORTATION.

5. THE MINIMUM STANDARDS AS SET FORTH IN THE CURRENT EDITION OF THE STATE OF FLORIDA MANUAL ON TRAFFIC CONTROL AND SAFE PRACTICES FOR STREET AND HIGHWAY CONSTRUCTION, MAINTENANCE AND UTILITY OPERATIONS: SHALL BE FOLLOWED IN THE DESIGN APPLICATION, INSTALLATION, MAINTENANCE, AND REMOVAL OF ALL TRAFFIC CONTROL DEVICES, WARNING DEVICES, AND BARRIERS NECESSARY TO PROTECT THE PUBLIC AND WORKMEN FROM HAZARDS WITHIN THE

6. ALL TRAFFIC CONTROL MARKINGS AND DEVICES SHALL CONFORM TO THE PROVISIONS SET FORTH IN THE MANUAL ON UNIFORM TRAFFIC CONTROL DEVICES PREPARED BY THE U.S. DEPARTMENT OF TRANSPORTATION FEDERAL HIGHWAY ADMINISTRATION.

7. IT SHALL BE THE SOLE RESPONSIBILITY OF THE CONTRACTOR TO COMPLY AND ENFORCE ALL APPLICABLE SAFETY REGULATIONS. THE ABOVE INFORMATION HAS BEEN PROVIDED FOR THE CONTRACTOR'S INFORMATION ONLY AND DOES NOT IMPLY THAT THE OWNER OR THE ENGINEER WILL INSPECT AND/OR ENFORCE SAFETY REGULATIONS.

SAFETY NOTES:

. THESE DRAWINGS DO NOT INCLUDE NECESSARY COMPONENTS FOR CONSTRUCTION SAFETY. THE CONTRACTOR IS SOLELY RESPONSIBLE FOR MEANS AND METHODS FOR CONSTRUCTION SITE SAFETY.

2. DURING THE CONSTRUCTION AND OR MAINTENANCE OF THIS PROJECT, ALL SAFETY REGULATIONS ARE TO BE ENFORCED BY THE CONTRACTOR. THE CONTRACTOR OR HIS REPRESENTATIVE SHALL BE RESPONSIBLE FOR THE CONTROL AND SAFETY OF THE TRAVELING PUBLIC AND THE SAFETY OF HIS PERSONNEL. LABOR SAFETY REGULATIONS SHALL CONFORM TO THE PROVISIONS SET FORTH BY OSHA IN THE FEDERAL REGISTER OF THE DEPARTMENT OF TRANSPORTATION.

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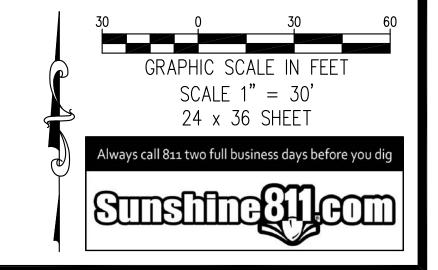
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5. LABOR SAFETY REGULATIONS SHALL CONFORM TO THE PROVISIONS SET FORTH BY OSHA IN THE FEDERAL REGISTER OF THE DEPARTMENT OF TRANSPORTATION.

6. TRENCH EXCAVATION PROTECTION SHALL BE ACCOMPLISHED AS REQUIRED BY THE PROVISIONS OF PART 1926, SUBPART P, EXCAVATIONS, TRENCHING AND SHORING OF THE OCCUPATIONAL SAFETY AND HEALTH ADMINISTRATIONS STANDARDS AND INTERPRETATIONS.

7. IT SHALL BE THE SOLE RESPONSIBILITY OF THE CONTRACTOR TO COMPLY AND ENFORCE ALL APPLICABLE SAFETY REGULATIONS. THE ABOVE INFORMATION HAS BEEN PROVIDED FOR THE CONTRACTOR'S INFORMATION ONLY AND DOES NOT IMPLY THAT THE OWNER OR THE ENGINEER WILL INSPECT AND/OR ENFORCE SAFETY REGULATIONS.

> NEW ASPHALT PAVEMENT REFER TO PGD PLANS



ENGINEERING

CIVIL ENGINEERING CONSULTANTS **CERTIFICATE OF AUTHORIZATION**

No. 29280

17110 SW 64TH COURT гнwest Ranches, Florida 3333

954.558.9628 GRACE Project No:

October 18, 2018

Revisions:

Plan Date:

Prepared For:

Chai Developers Limited Partnership 101 S. State Road 7, Suite # 205

Hollywood, Florida 33023

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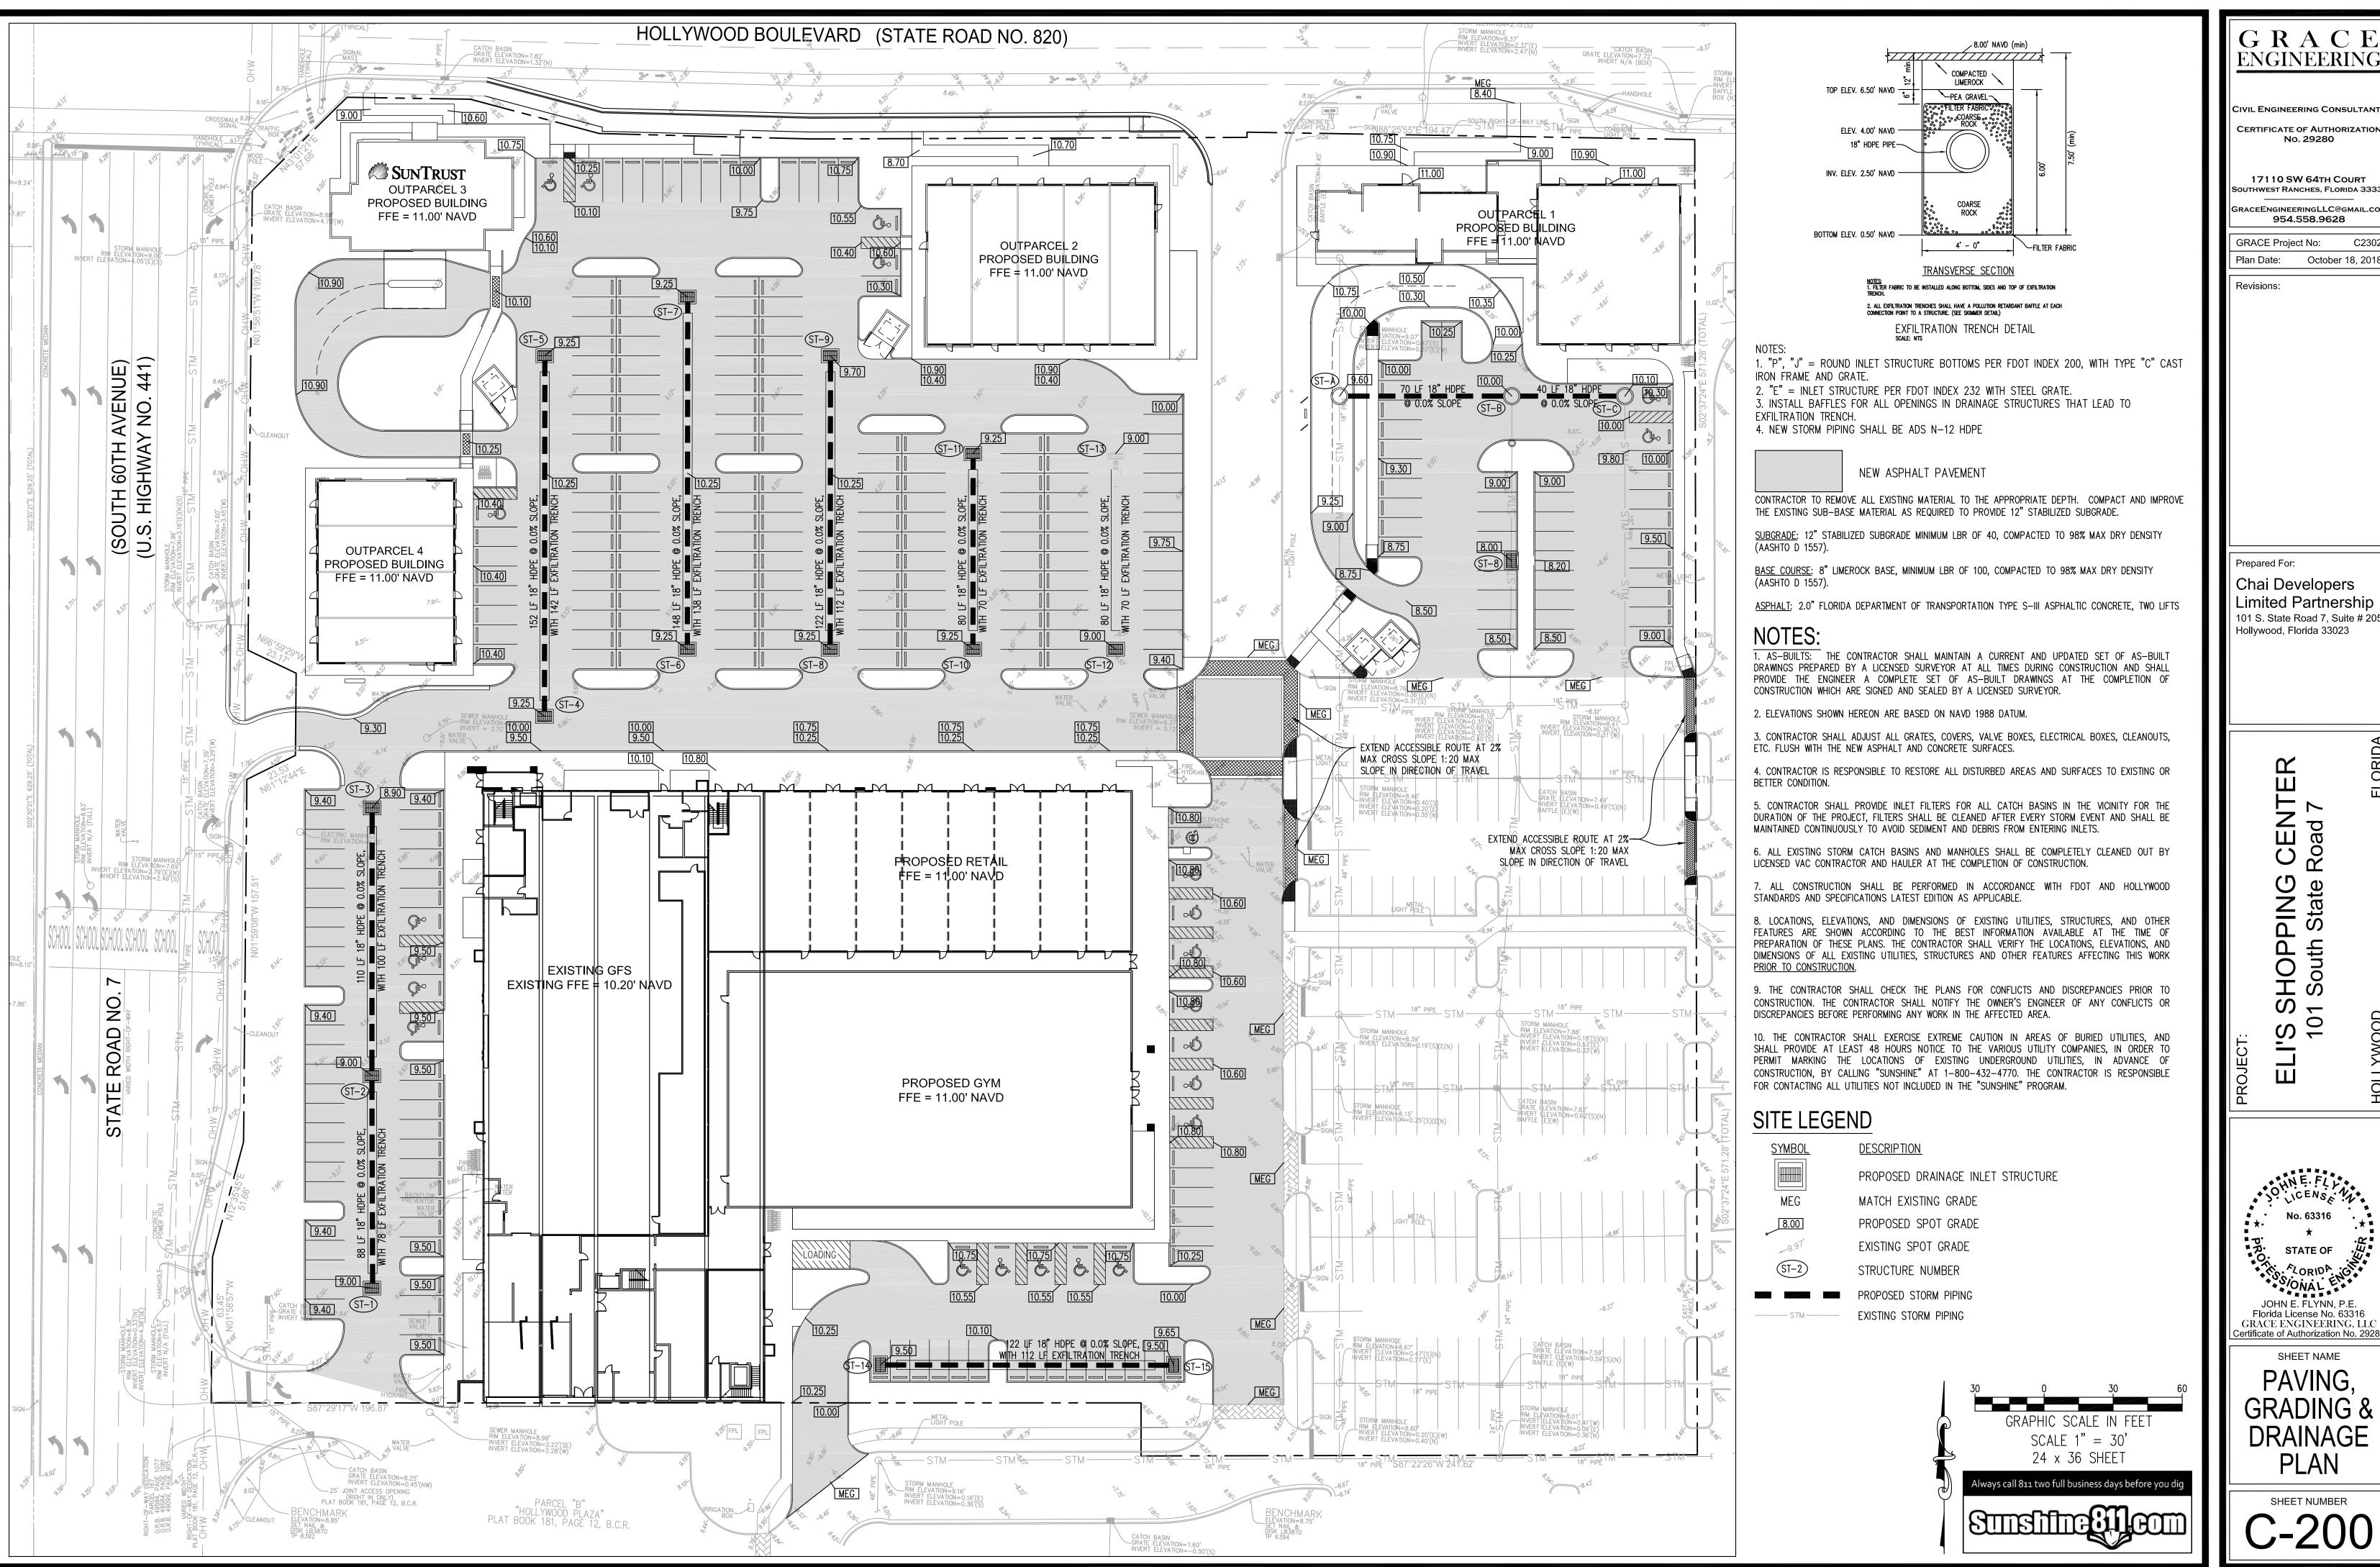
HNE FLY No. 63316 STATE OF ~ ORIDA JOHN E. FLYNN, P.E. Florida License No. 63316

Certificate of Authorization No. 2928 SHEET NAME

GRACE ENGINEERING, LLO

PAVEMEN1 MARKINGS & SIGNAGE

SHEET NUMBER



ENGINEERING

CIVIL ENGINEERING CONSULTANTS

CERTIFICATE OF AUTHORIZATION No. 29280

17110 SW 64TH COURT THWEST RANCHES, FLORIDA 3333 CEENGINEERINGLLC@GMAIL.CO 954.558.9628

GRACE Project No: October 18, 2018

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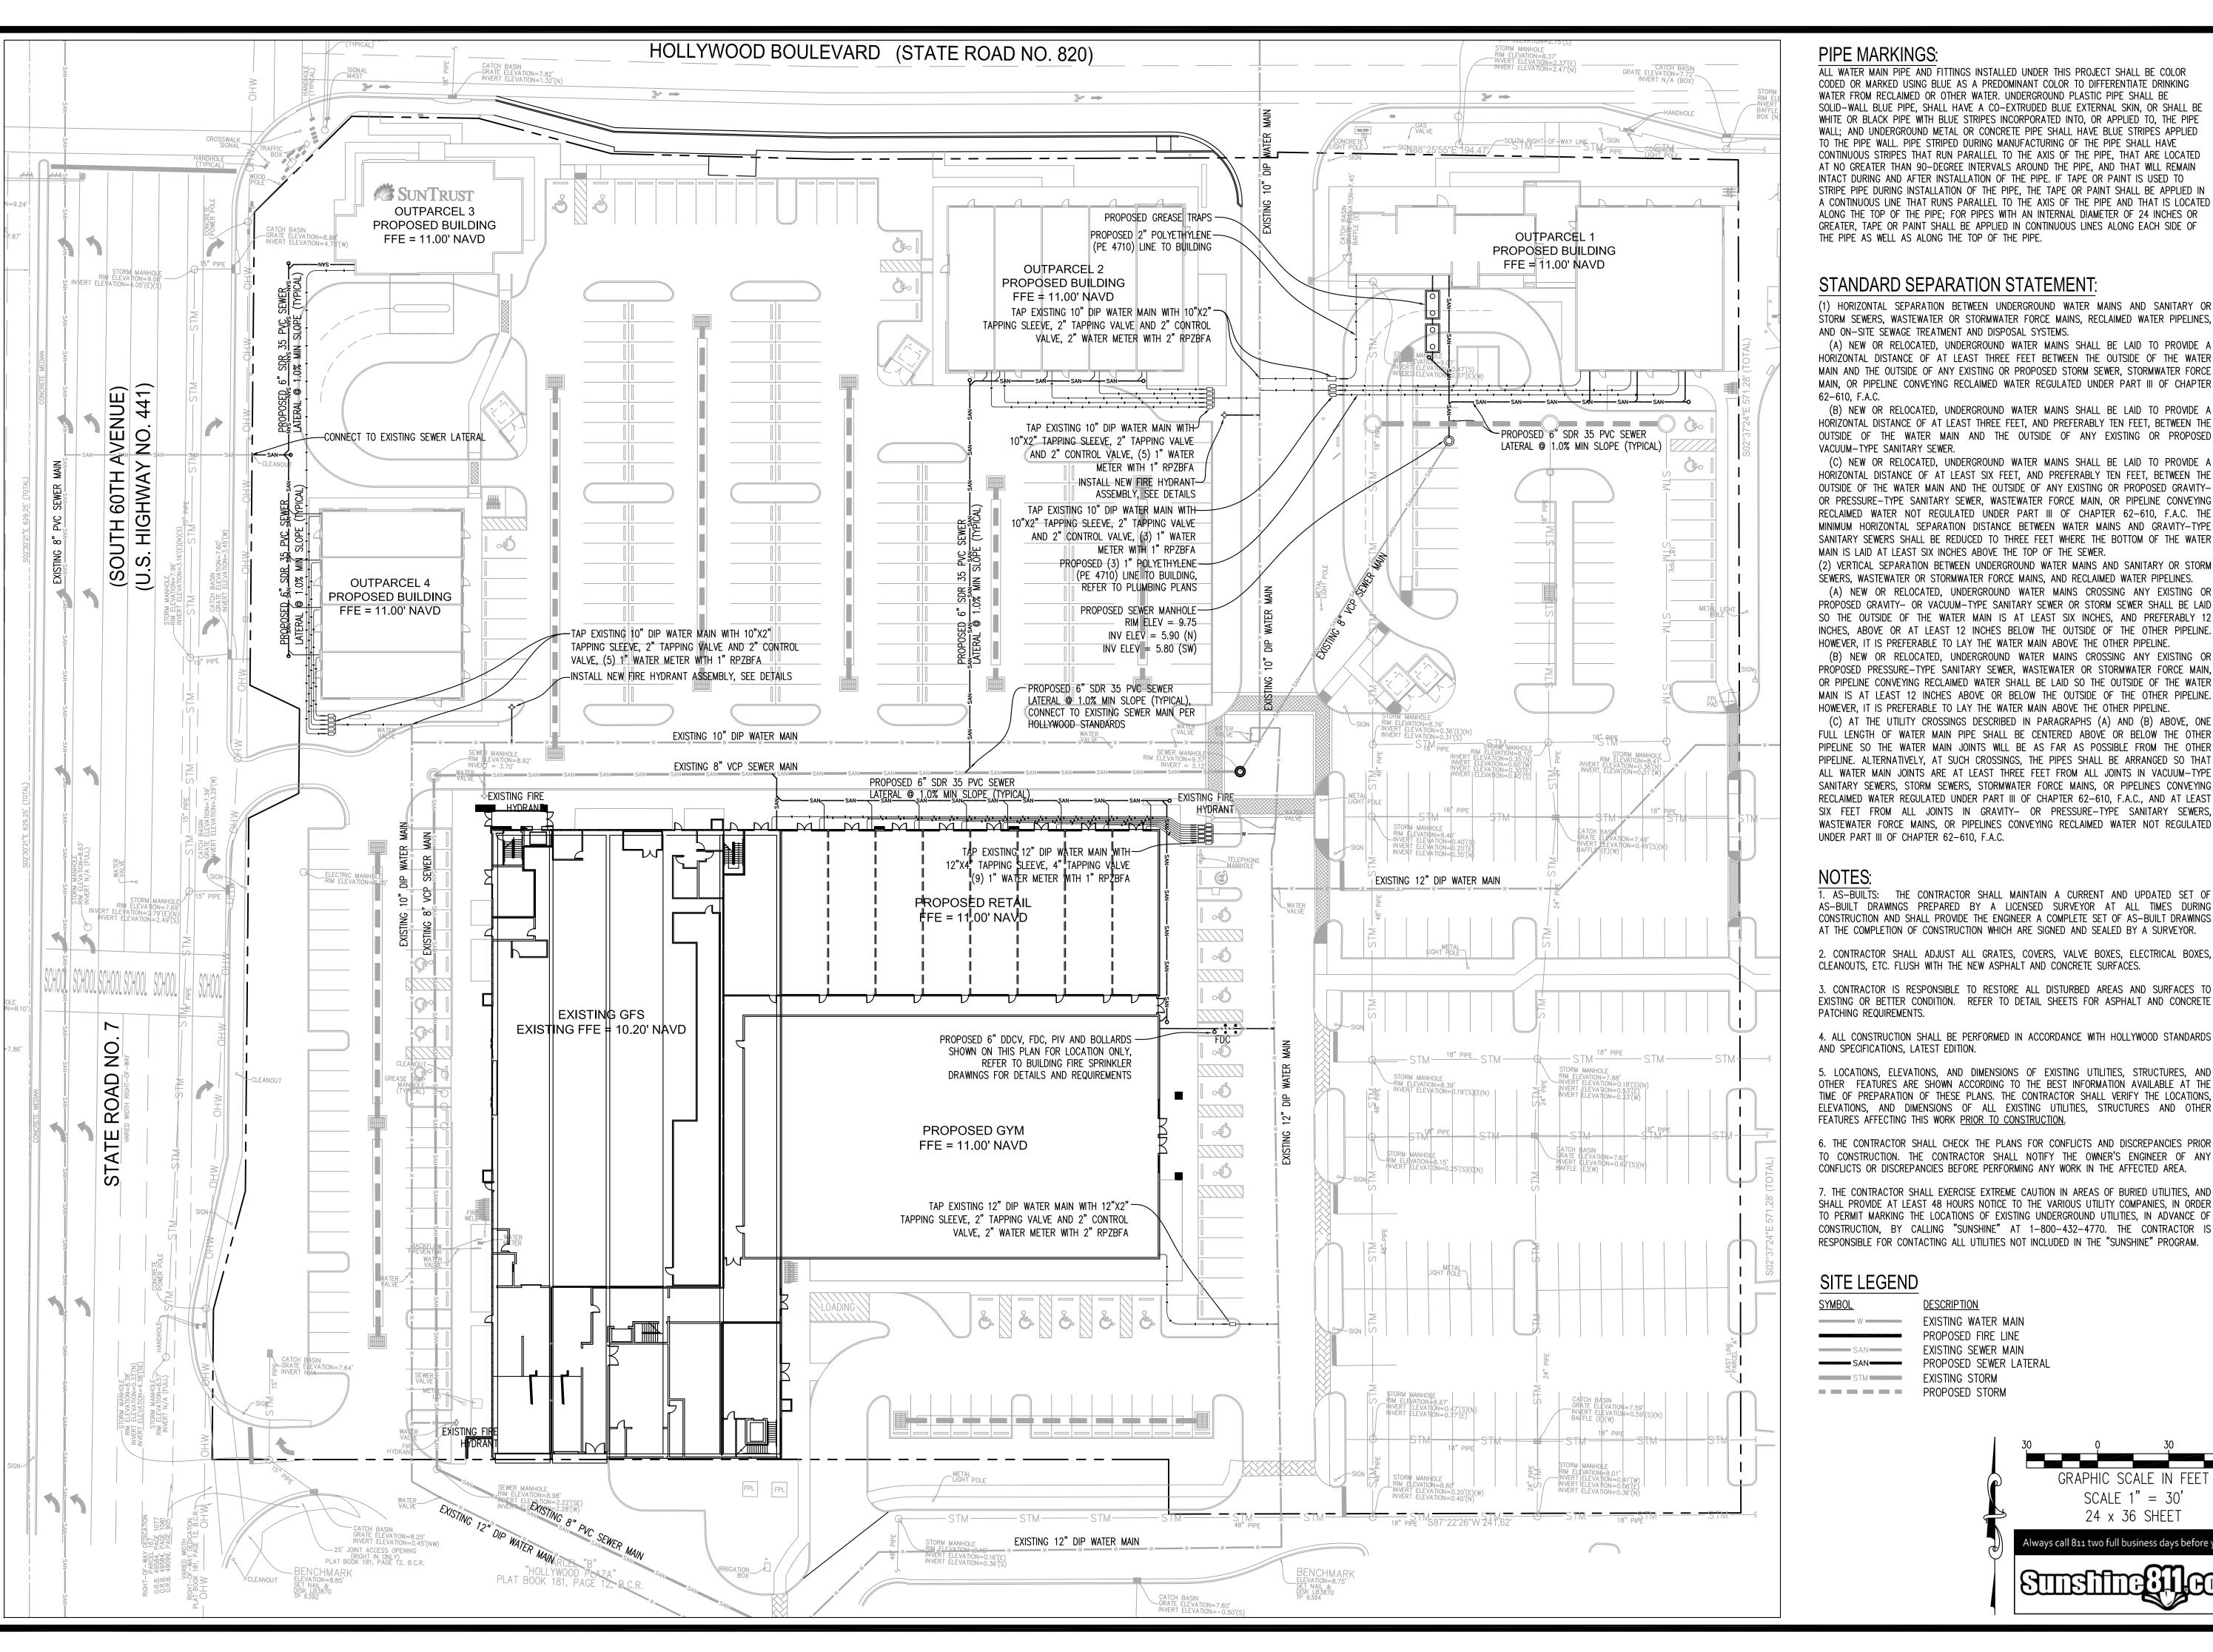
CENSE No. 63316 CORIDA.

GRACE ENGINEERING, LLC ertificate of Authorization No. 2928

JOHN E. FLYNN, P.E. Florida License No. 63316

SHEET NAME PAVING, DRAINAGE PLAN

SHEET NUMBER



PIPE MARKINGS:

ALL WATER MAIN PIPE AND FITTINGS INSTALLED UNDER THIS PROJECT SHALL BE COLOR CODED OR MARKED USING BLUE AS A PREDOMINANT COLOR TO DIFFERENTIATE DRINKING WATER FROM RECLAIMED OR OTHER WATER. UNDERGROUND PLASTIC PIPE SHALL BE SOLID-WALL BLUE PIPE, SHALL HAVE A CO-EXTRUDED BLUE EXTERNAL SKIN, OR SHALL BE WHITE OR BLACK PIPE WITH BLUE STRIPES INCORPORATED INTO, OR APPLIED TO, THE PIPE WALL; AND UNDERGROUND METAL OR CONCRETE PIPE SHALL HAVE BLUE STRIPES APPLIED TO THE PIPE WALL. PIPE STRIPED DURING MANUFACTURING OF THE PIPE SHALL HAVE CONTINUOUS STRIPES THAT RUN PARALLEL TO THE AXIS OF THE PIPE, THAT ARE LOCATED AT NO GREATER THAN 90-DEGREE INTERVALS AROUND THE PIPE, AND THAT WILL REMAIN INTACT DURING AND AFTER INSTALLATION OF THE PIPE. IF TAPE OR PAINT IS USED TO STRIPE PIPE DURING INSTALLATION OF THE PIPE. THE TAPE OR PAINT SHALL BE APPLIED IN A CONTINUOUS LINE THAT RUNS PARALLEL TO THE AXIS OF THE PIPE AND THAT IS LOCATED ALONG THE TOP OF THE PIPE; FOR PIPES WITH AN INTERNAL DIAMETER OF 24 INCHES OR GREATER, TAPE OR PAINT SHALL BE APPLIED IN CONTINUOUS LINES ALONG EACH SIDE OF THE PIPE AS WELL AS ALONG THE TOP OF THE PIPE.

STANDARD SEPARATION STATEMENT

(1) HORIZONTAL SEPARATION BETWEEN UNDERGROUND WATER MAINS AND SANITARY OR STORM SEWERS, WASTEWATER OR STORMWATER FORCE MAINS, RECLAIMED WATER PIPELINES, AND ON-SITE SEWAGE TREATMENT AND DISPOSAL SYSTEMS.

(A) NEW OR RELOCATED, UNDERGROUND WATER MAINS SHALL BE LAID TO PROVIDE A HORIZONTAL DISTANCE OF AT LEAST THREE FEET BETWEEN THE OUTSIDE OF THE WATER MAIN AND THE OUTSIDE OF ANY EXISTING OR PROPOSED STORM SEWER, STORMWATER FORCE MAIN. OR PIPELINE CONVEYING RECLAIMED WATER REGULATED UNDER PART III OF CHAPTER

(B) NEW OR RELOCATED, UNDERGROUND WATER MAINS SHALL BE LAID TO PROVIDE A HORIZONTAL DISTANCE OF AT LEAST THREE FEET, AND PREFERABLY TEN FEET, BETWEEN THE OUTSIDE OF THE WATER MAIN AND THE OUTSIDE OF ANY EXISTING OR PROPOSED VACUUM-TYPE SANITARY SEWER.

(C) NEW OR RELOCATED, UNDERGROUND WATER MAINS SHALL BE LAID TO PROVIDE A HORIZONTAL DISTANCE OF AT LEAST SIX FEET, AND PREFERABLY TEN FEET, BETWEEN THE OUTSIDE OF THE WATER MAIN AND THE OUTSIDE OF ANY EXISTING OR PROPOSED GRAVITY-OR PRESSURE-TYPE SANITARY SEWER, WASTEWATER FORCE MAIN, OR PIPELINE CONVEYING RECLAIMED WATER NOT REGULATED UNDER PART III OF CHAPTER 62-610, F.A.C. THE MINIMUM HORIZONTAL SEPARATION DISTANCE BETWEEN WATER MAINS AND GRAVITY-TYPE SANITARY SEWERS SHALL BE REDUCED TO THREE FEET WHERE THE BOTTOM OF THE WATER MAIN IS LAID AT LEAST SIX INCHES ABOVE THE TOP OF THE SEWER.

SEWERS, WASTEWATER OR STORMWATER FORCE MAINS, AND RECLAIMED WATER PIPELINES. (A) NEW OR RELOCATED, UNDERGROUND WATER MAINS CROSSING ANY EXISTING OR PROPOSED GRAVITY- OR VACUUM-TYPE SANITARY SEWER OR STORM SEWER SHALL BE LAID SO THE OUTSIDE OF THE WATER MAIN IS AT LEAST SIX INCHES, AND PREFERABLY 12 INCHES, ABOVE OR AT LEAST 12 INCHES BELOW THE OUTSIDE OF THE OTHER PIPELINE. HOWEVER, IT IS PREFERABLE TO LAY THE WATER MAIN ABOVE THE OTHER PIPELINE.

(B) NEW OR RELOCATED, UNDERGROUND WATER MAINS CROSSING ANY EXISTING OR PROPOSED PRESSURE-TYPE SANITARY SEWER, WASTEWATER OR STORMWATER FORCE MAIN, OR PIPELINE CONVEYING RECLAIMED WATER SHALL BE LAID SO THE OUTSIDE OF THE WATER MAIN IS AT LEAST 12 INCHES ABOVE OR BELOW THE OUTSIDE OF THE OTHER PIPELINE. HOWEVER, IT IS PREFERABLE TO LAY THE WATER MAIN ABOVE THE OTHER PIPELINE.

(C) AT THE UTILITY CROSSINGS DESCRIBED IN PARAGRAPHS (A) AND (B) ABOVE, ONE FULL LENGTH OF WATER MAIN PIPE SHALL BE CENTERED ABOVE OR BELOW THE OTHER PIPELINE SO THE WATER MAIN JOINTS WILL BE AS FAR AS POSSIBLE FROM THE OTHER PIPELINE. ALTERNATIVELY, AT SUCH CROSSINGS, THE PIPES SHALL BE ARRANGED SO THAT ALL WATER MAIN JOINTS ARE AT LEAST THREE FEET FROM ALL JOINTS IN VACUUM-TYPE SANITARY SEWERS, STORM SEWERS, STORMWATER FORCE MAINS, OR PIPELINES CONVEYING RECLAIMED WATER REGULATED UNDER PART III OF CHAPTER 62-610, F.A.C., AND AT LEAST SIX FEET FROM ALL JOINTS IN GRAVITY- OR PRESSURE-TYPE SANITARY SEWERS, WASTEWATER FORCE MAINS, OR PIPELINES CONVEYING RECLAIMED WATER NOT REGULATED UNDER PART III OF CHAPTER 62-610, F.A.C.

 AS-BUILTS: THE CONTRACTOR SHALL MAINTAIN A CURRENT AND UPDATED SET OF AS-BUILT DRAWINGS PREPARED BY A LICENSED SURVEYOR AT ALL TIMES DURING CONSTRUCTION AND SHALL PROVIDE THE ENGINEER A COMPLETE SET OF AS-BUILT DRAWINGS AT THE COMPLETION OF CONSTRUCTION WHICH ARE SIGNED AND SEALED BY A SURVEYOR.

2. CONTRACTOR SHALL ADJUST ALL GRATES, COVERS, VALVE BOXES, ELECTRICAL BOXES, CLEANOUTS, ETC. FLUSH WITH THE NEW ASPHALT AND CONCRETE SURFACES.

3. CONTRACTOR IS RESPONSIBLE TO RESTORE ALL DISTURBED AREAS AND SURFACES TO EXISTING OR BETTER CONDITION. REFER TO DETAIL SHEETS FOR ASPHALT AND CONCRETE PATCHING REQUIREMENTS.

4. ALL CONSTRUCTION SHALL BE PERFORMED IN ACCORDANCE WITH HOLLYWOOD STANDARDS AND SPECIFICATIONS, LATEST EDITION.


5. LOCATIONS, ELEVATIONS, AND DIMENSIONS OF EXISTING UTILITIES, STRUCTURES, AND OTHER FEATURES ARE SHOWN ACCORDING TO THE BEST INFORMATION AVAILABLE AT THE TIME OF PREPARATION OF THESE PLANS. THE CONTRACTOR SHALL VERIFY THE LOCATIONS, ELEVATIONS, AND DIMENSIONS OF ALL EXISTING UTILITIES, STRUCTURES AND OTHER FEATURES AFFECTING THIS WORK PRIOR TO CONSTRUCTION.

6. THE CONTRACTOR SHALL CHECK THE PLANS FOR CONFLICTS AND DISCREPANCIES PRIOR TO CONSTRUCTION. THE CONTRACTOR SHALL NOTIFY THE OWNER'S ENGINEER OF ANY CONFLICTS OR DISCREPANCIES BEFORE PERFORMING ANY WORK IN THE AFFECTED AREA.

7. THE CONTRACTOR SHALL EXERCISE EXTREME CAUTION IN AREAS OF BURIED UTILITIES, AND SHALL PROVIDE AT LEAST 48 HOURS NOTICE TO THE VARIOUS UTILITY COMPANIES, IN ORDER TO PERMIT MARKING THE LOCATIONS OF EXISTING UNDERGROUND UTILITIES, IN ADVANCE OF CONSTRUCTION, BY CALLING "SUNSHINE" AT 1-800-432-4770. THE CONTRACTOR IS RESPONSIBLE FOR CONTACTING ALL UTILITIES NOT INCLUDED IN THE "SUNSHINE" PROGRAM.

SITE LEGEND

<u>DESCRIPTION</u> EXISTING WATER MAIN PROPOSED FIRE LINE EXISTING SEWER MAIN PROPOSED SEWER LATERAL EXISTING STORM PROPOSED STORM

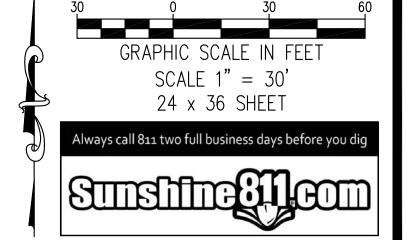

ENGINEERING

CIVIL ENGINEERING CONSULTANTS **CERTIFICATE OF AUTHORIZATION**

No. 29280

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CEENGINEERINGLLC@GMAIL.CO 954.558.9628 GRACE Project No:

Plan Date: October 18, 2018

Revisions:

Prepared For:

Chai Developers Limited Partnership

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Hollywood, Florida 33023

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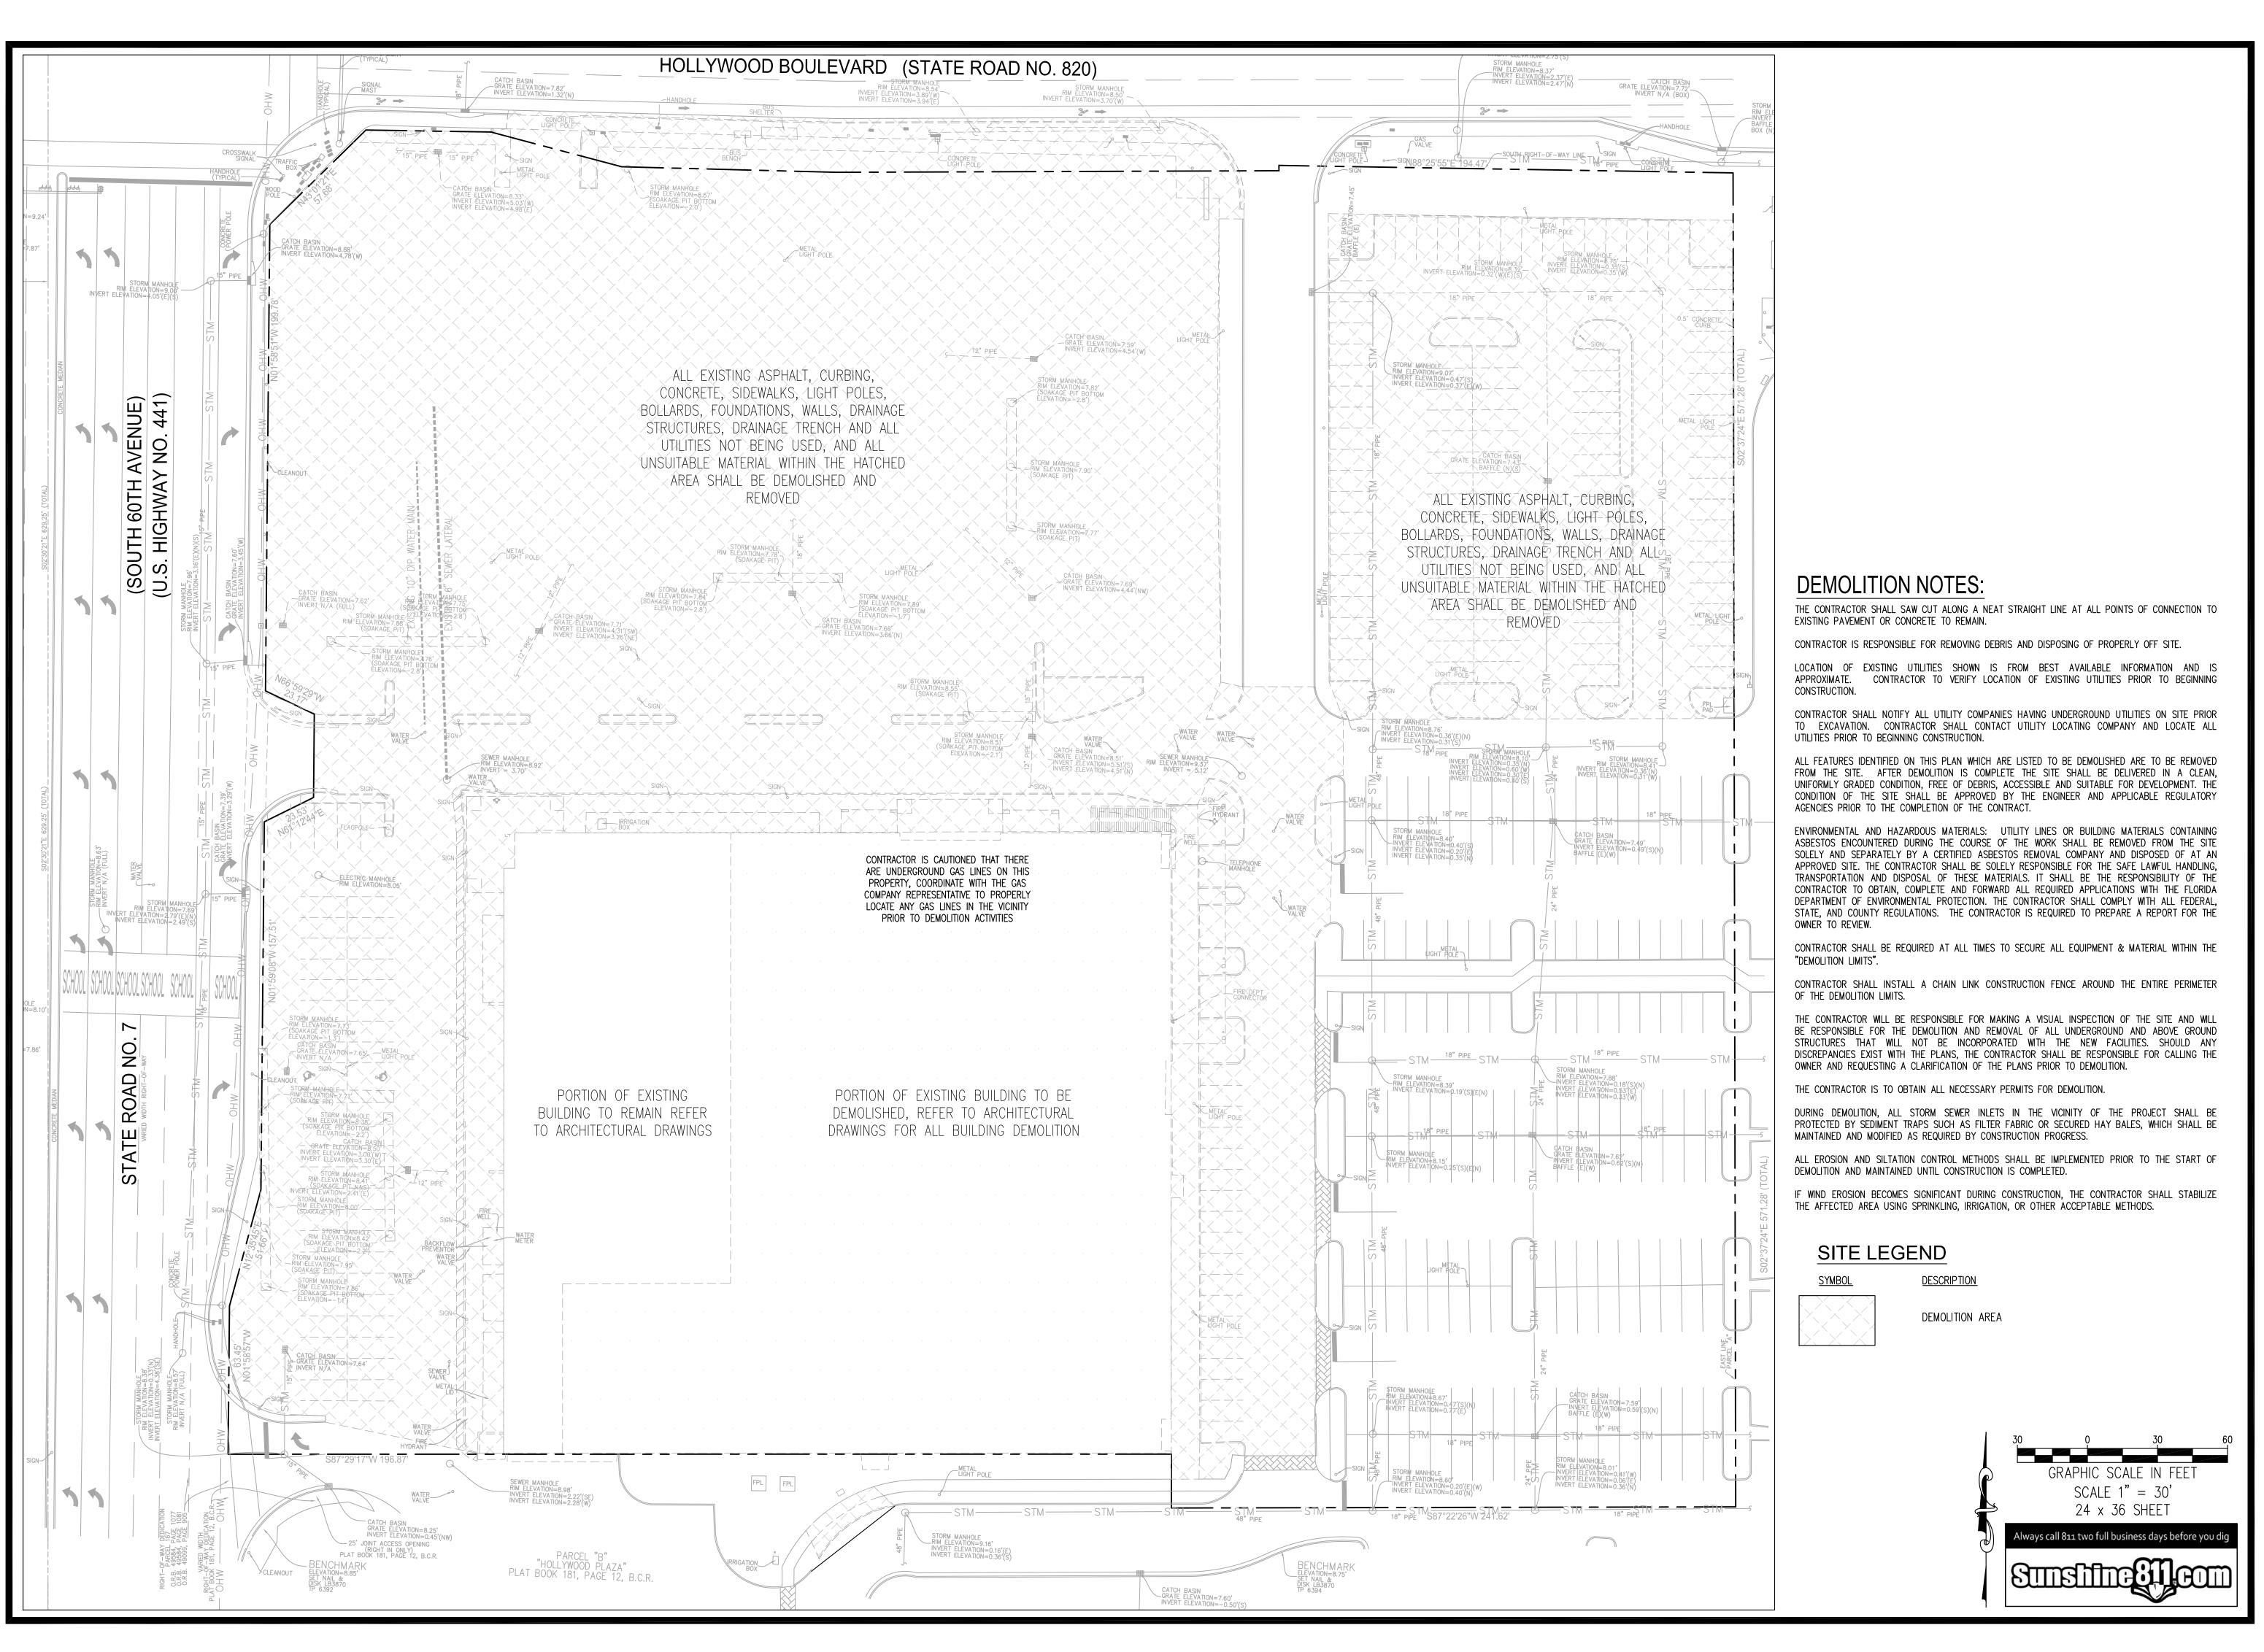
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CENSE No. 63316 STATE OF CORIDA. JOHN E. FLYNN, P.E. Florida License No. 63316 GRACE ENGINEERING, LLC

ertificate of Authorization No. 2928

WATER & PLAN

SHEET NUMBER



GRACE ENGINEERING

CIVIL ENGINEERING CONSULTANT

CERTIFICATE OF AUTHORIZATION No. 29280

17110 SW 64TH COURT
SOUTHWEST RANCHES, FLORIDA 3333

GRACEENGINEERINGLLC@GMAIL.CO

954.558.9628

GRACE Project No: C2302

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Revisions:

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Prepared For:

Chai Developers


Limited Partnership

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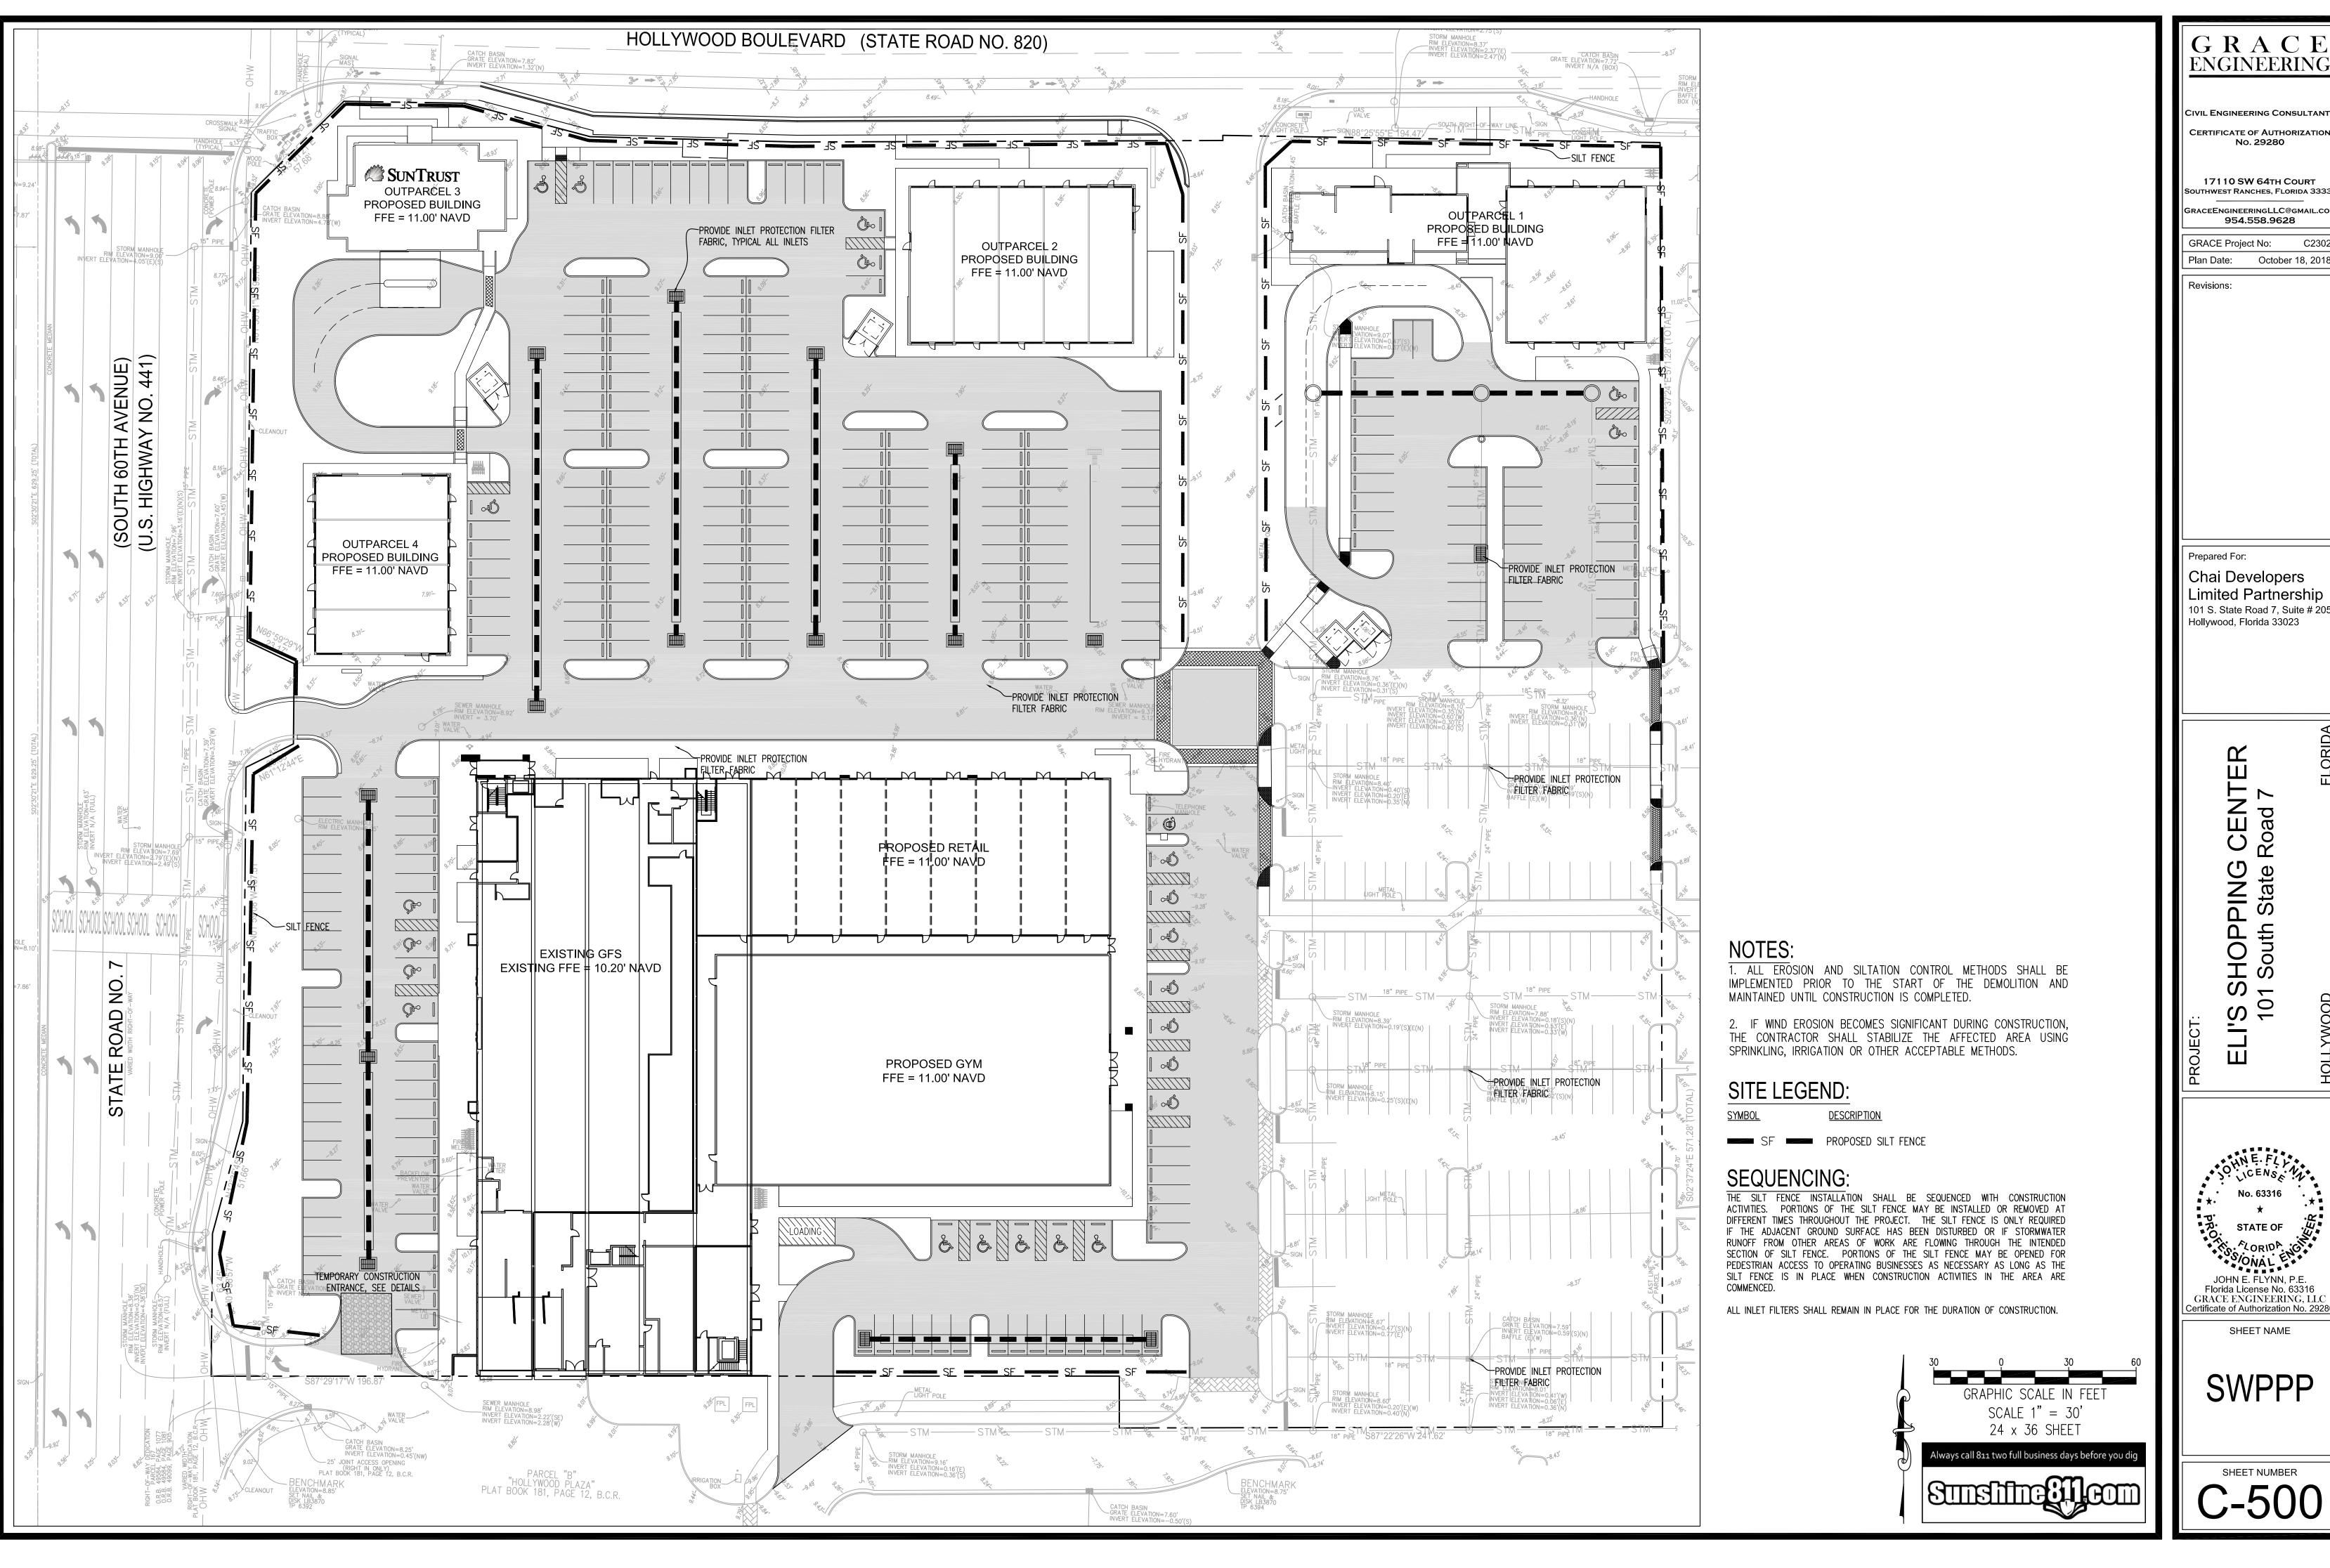


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CIVIL DEMOLITION PLAN


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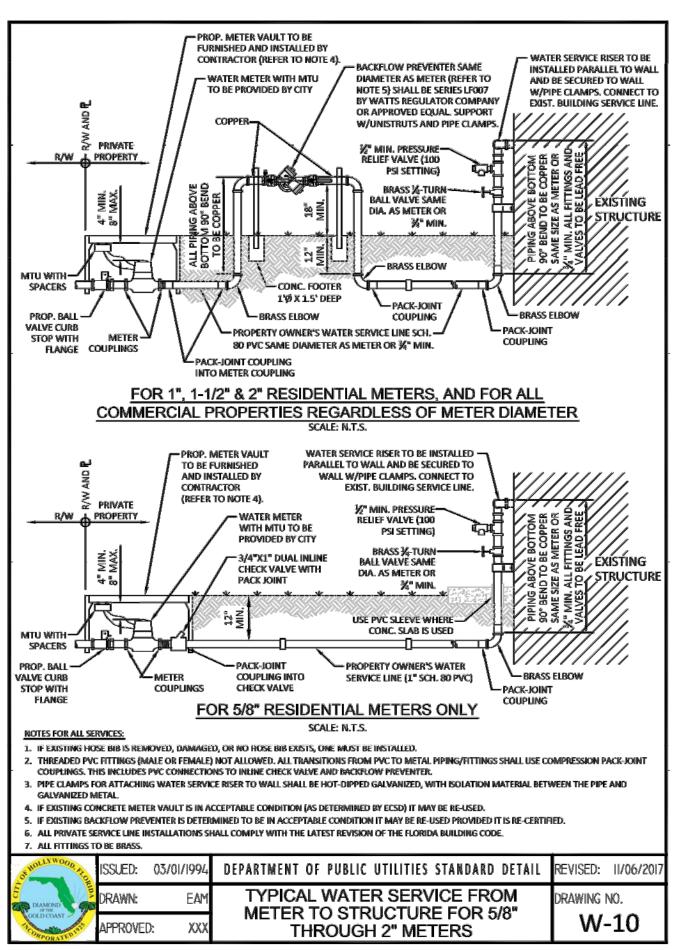
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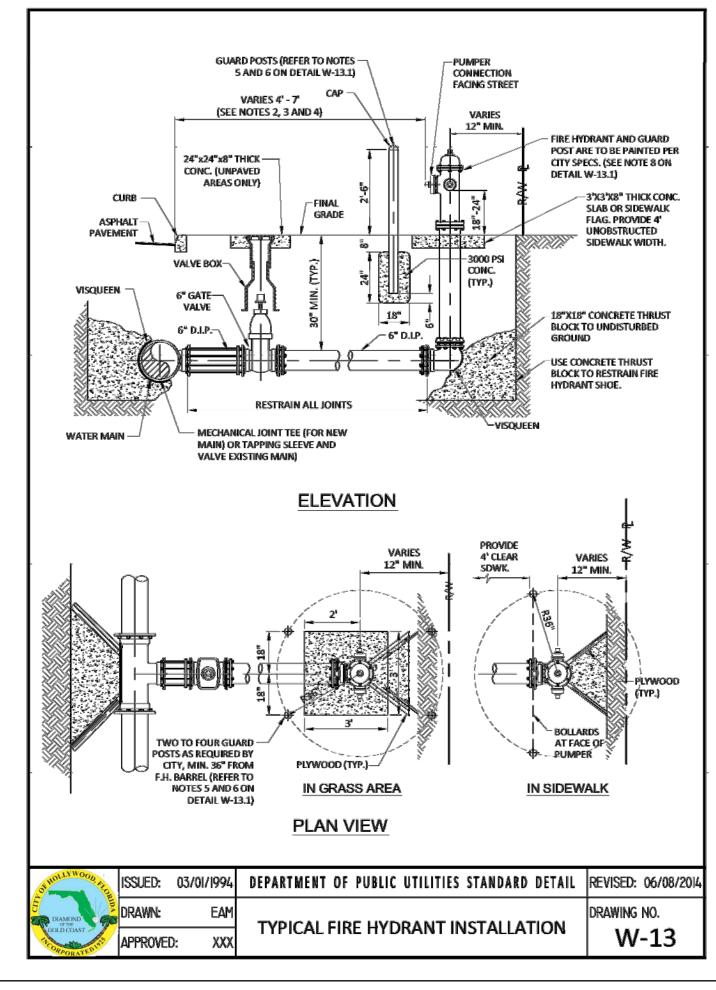



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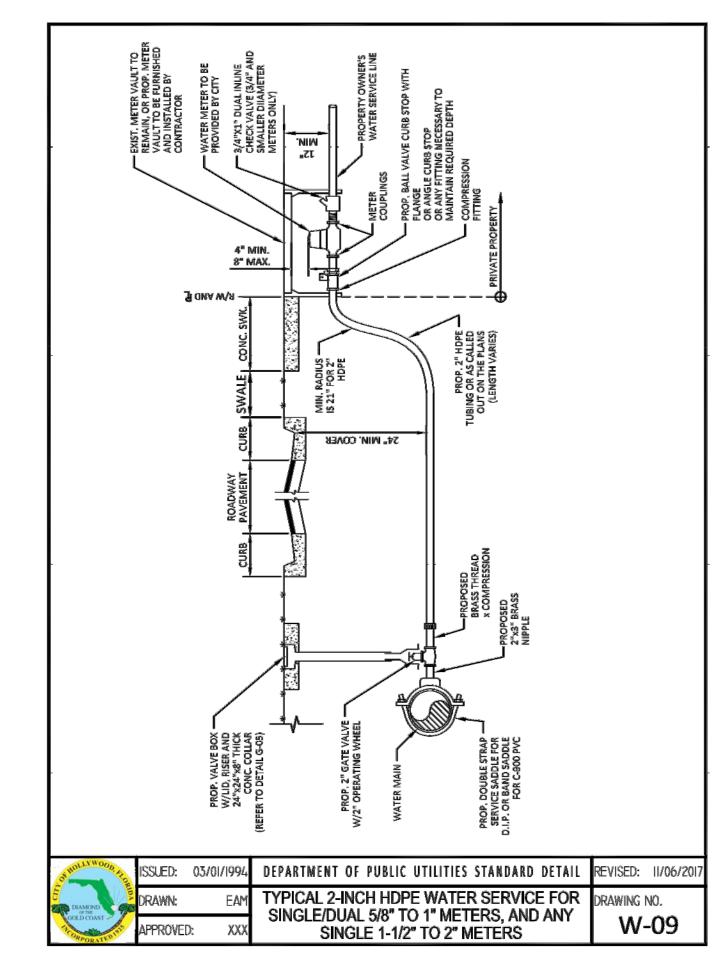
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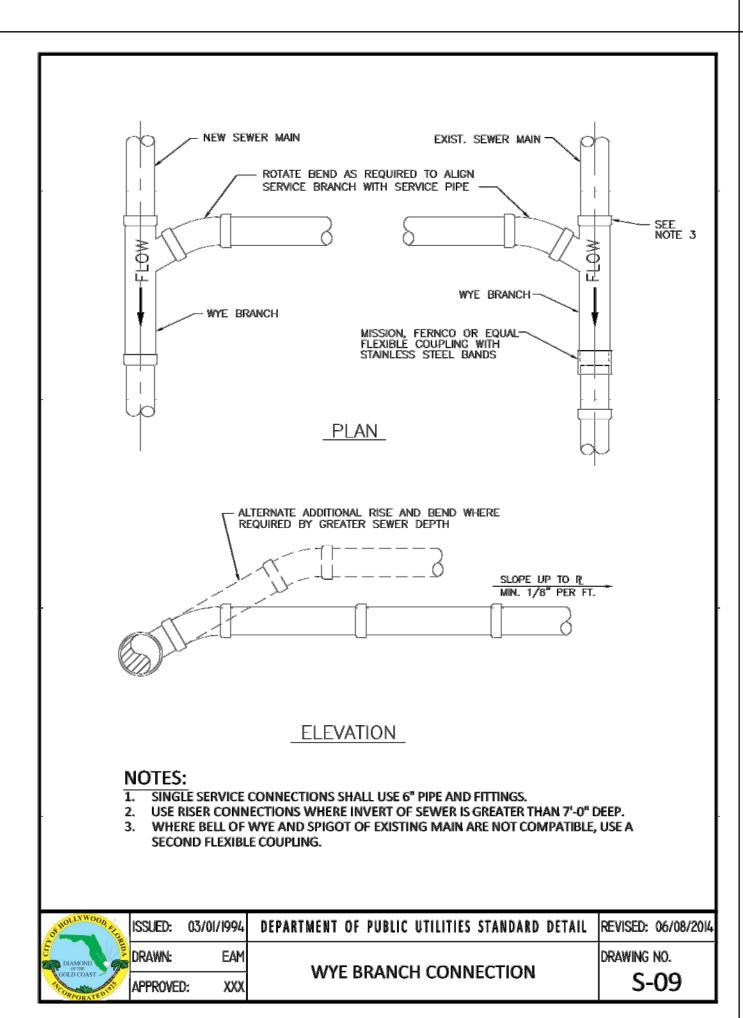


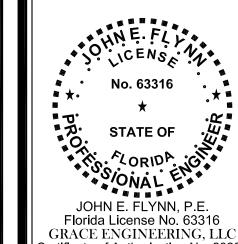







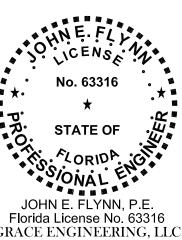

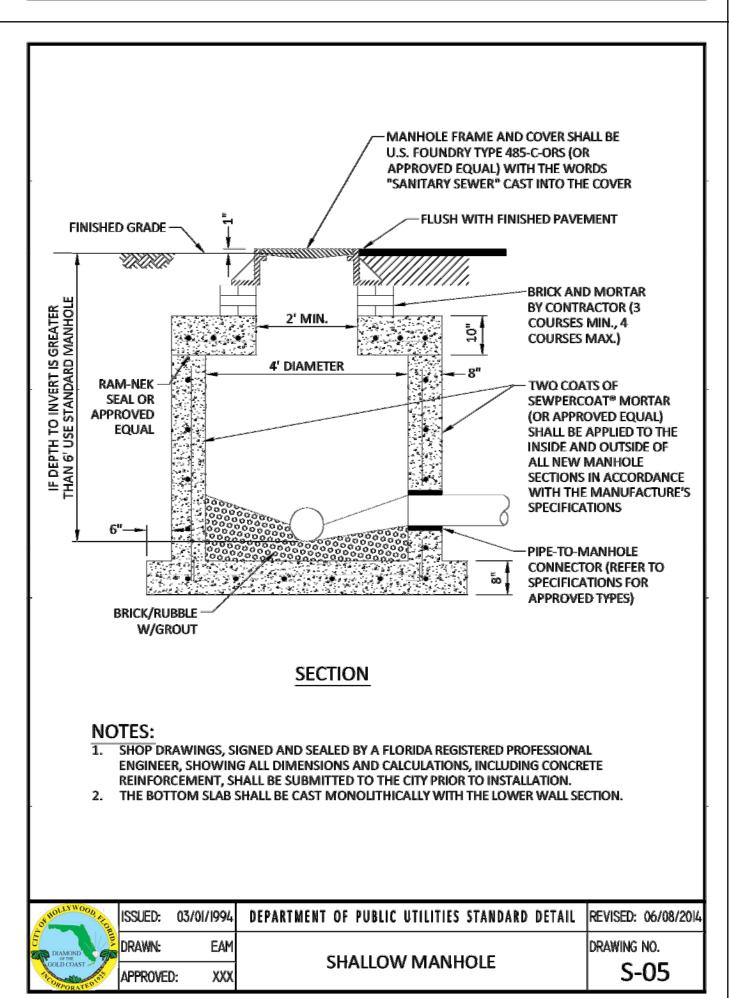

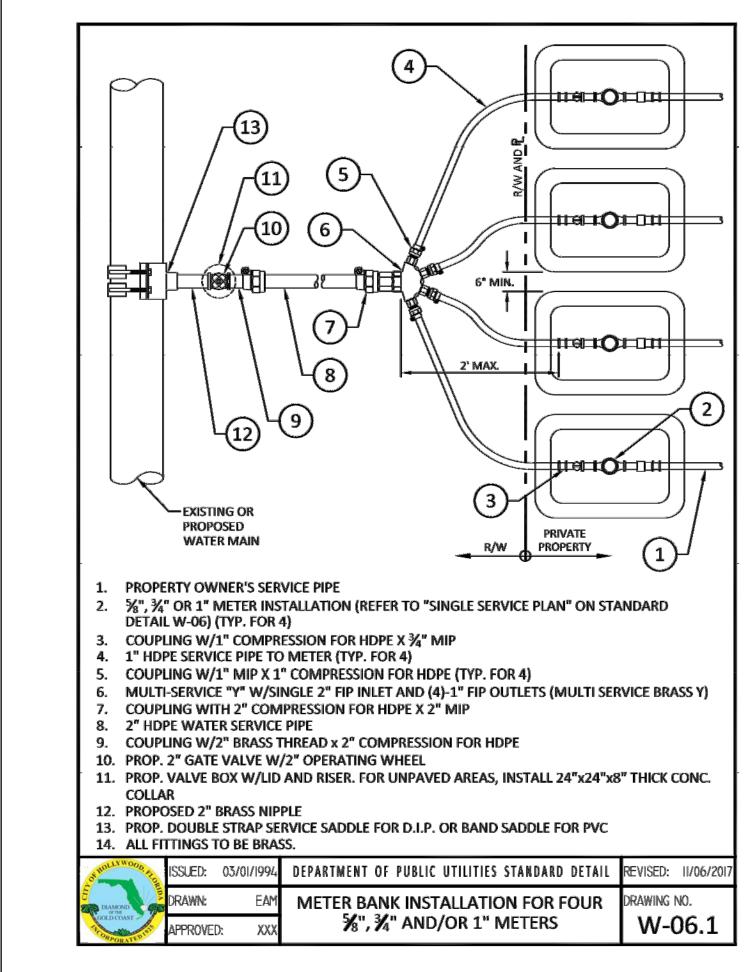

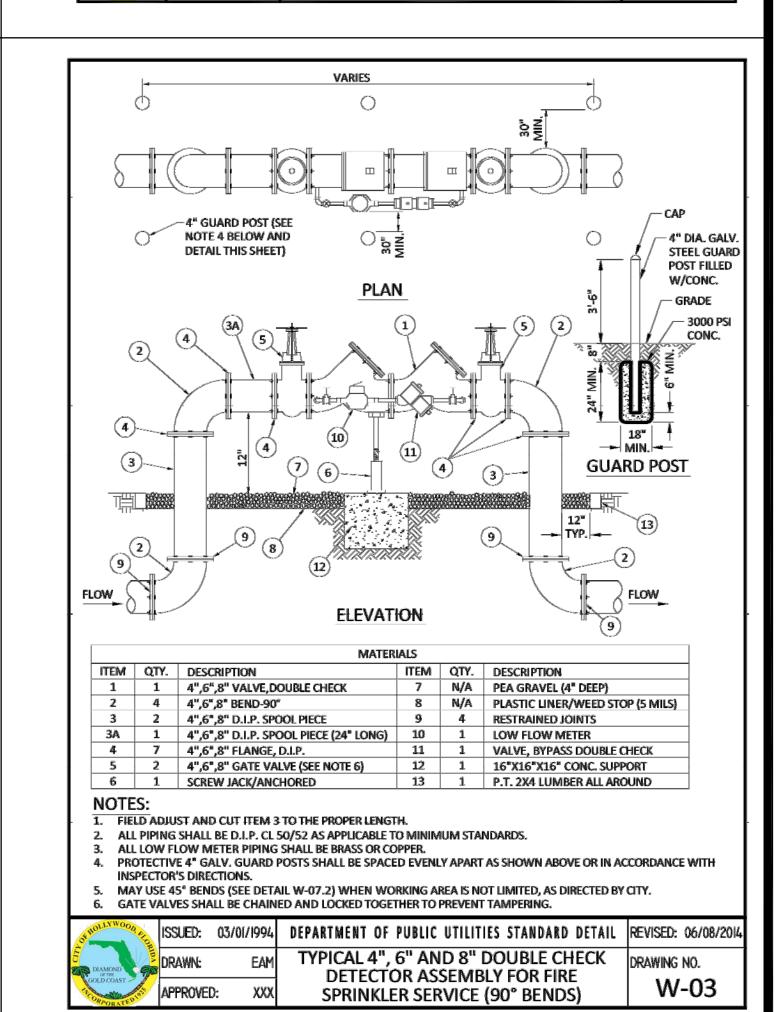



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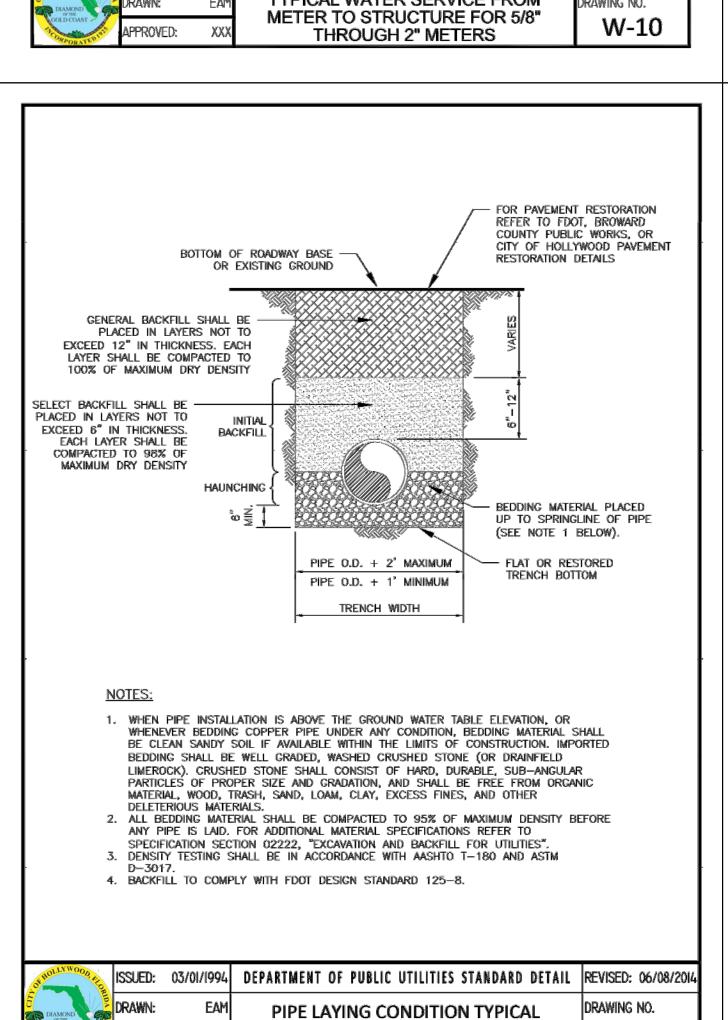
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STATE OF CORIDA JOHN E. FLYNN, P.E. Florida License No. 63316


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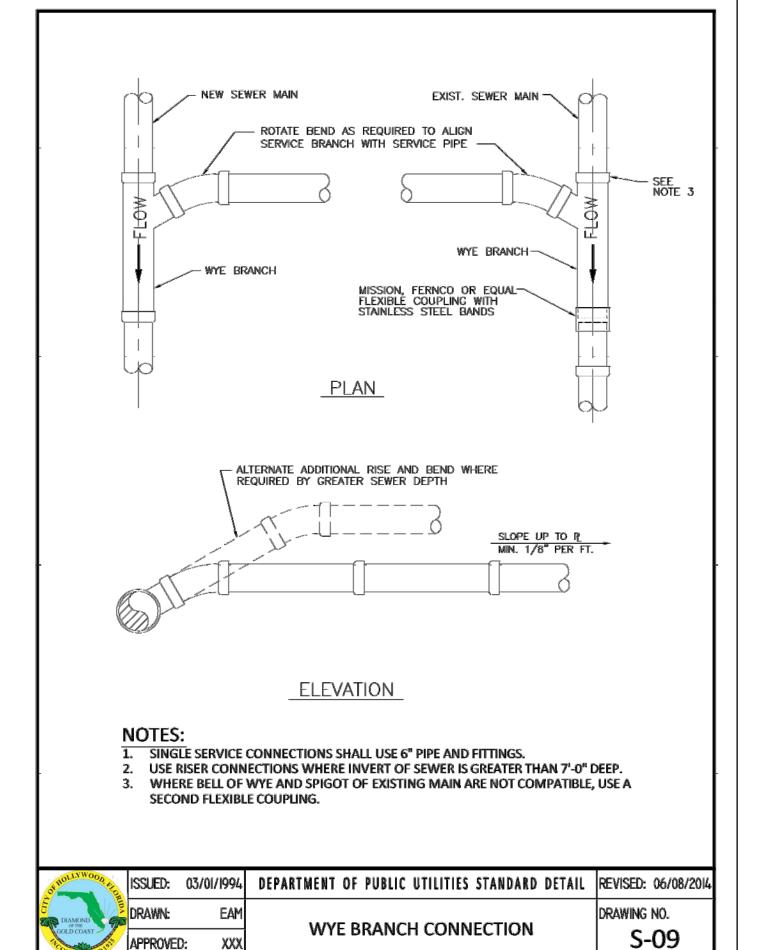
GRACE ENGINEERING, LLC


Certificate of Authorization No. 2928



SECTION (P.V.C.)



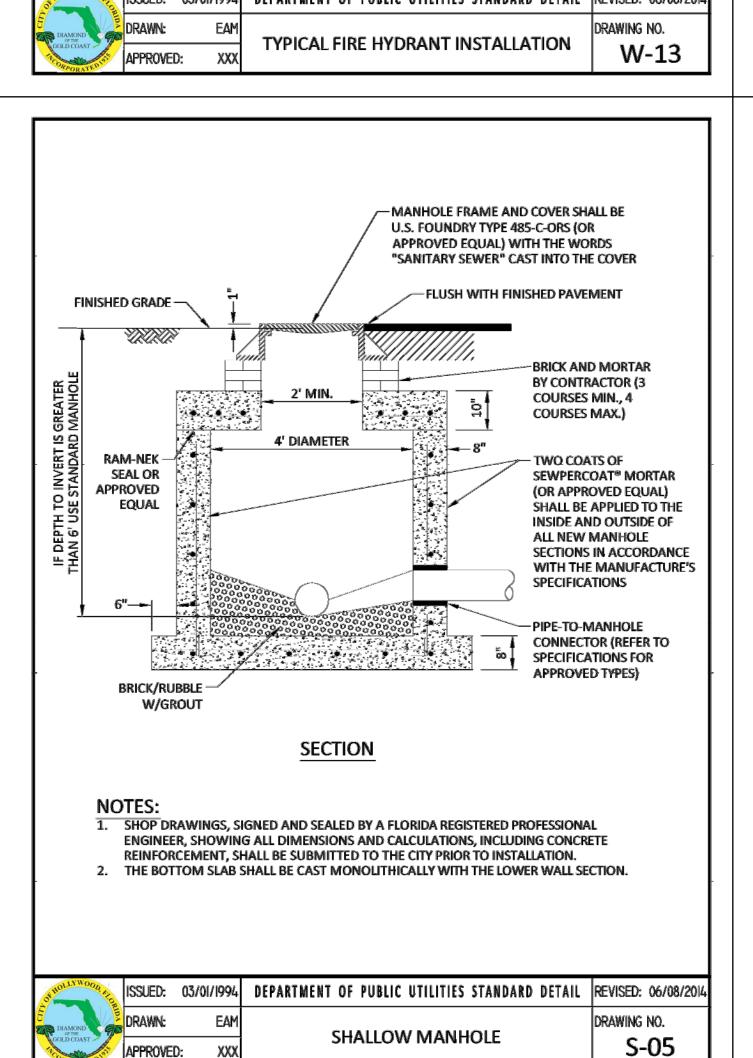

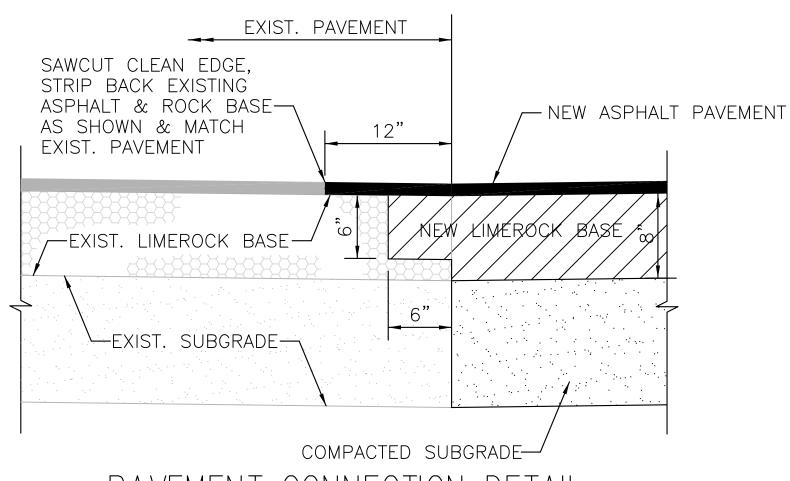



PAVEMENT CONNECTION DETAIL SCALE: NTS


SUBGRADE: 12" STABILIZED SUBGRADE MINIMUM LBR OF 40, COMPACTED TO 98% MAX DRY DENSITY (AASHTO D 1557).

BASE COURSE: 8" LIMEROCK BASE, MINIMUM LBR OF 100, COMPACTED TO 98% MAX DRY DENSITY (AASHTO D 1557).

ASPHALT: 2.0" FLORIDA DEPARTMENT OF TRANSPORTATION TYPE S-III ASPHALTIC CONCRETE, TWO LIFTS

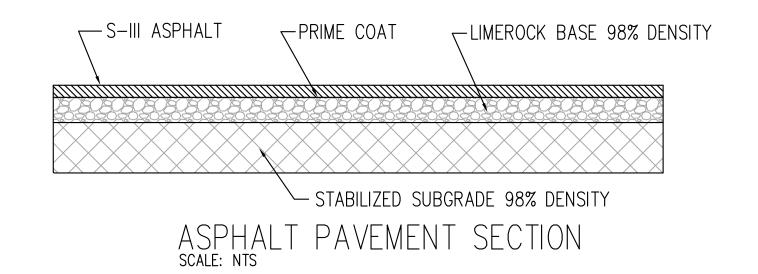

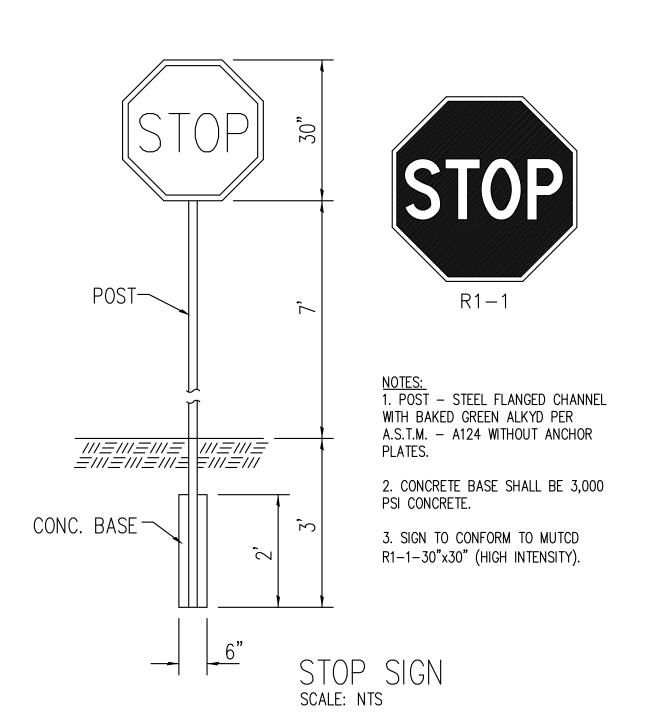

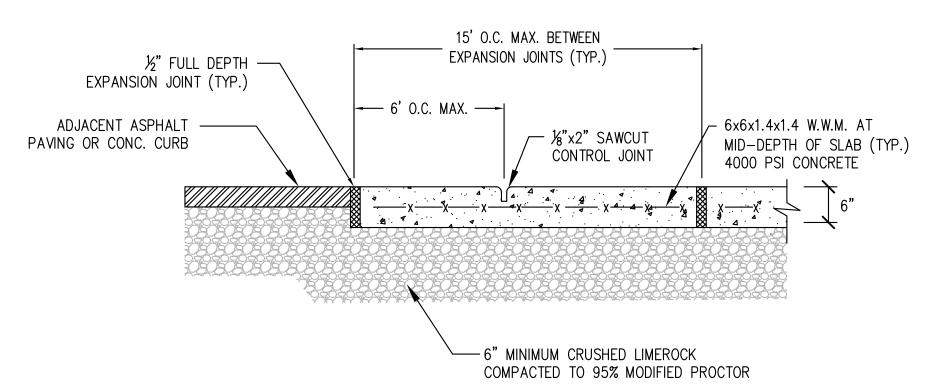



NOTES:

1. ½" BITUMINOUS EXPANSION JOINTS SHALL BE PLACED AT ALL CONCRETE EDGES AND AT 15' MAX INTERVALS.

2. 2" DEEP CONTROL JOINTS SHALL BE PLACED AT 6' MAX. INTERVALS.
 3. CRUSHED LIMEROCK BASE SHALL EXTEND A MINIMUM OF 6" BEYOND EDGE OF CONCRETE.

TYPICAL CONCRETE SLAB SECTION SCALE: NTS

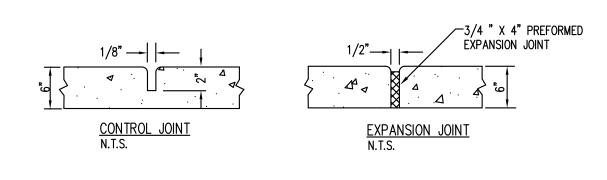

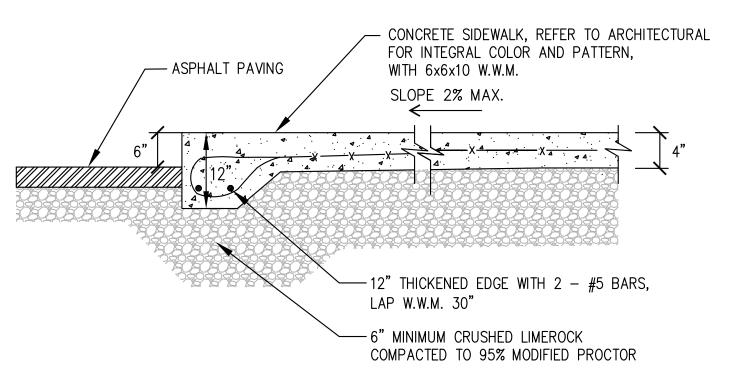

1. 3" BITUMINOUS EXPANSION JOINTS SHALL BE PLACED AT ALL CONCRETE EDGES AND AT 15' INTERVALS.
2. 2" DEEP CONTROL JOINTS SHALL BE PLACED AT 5' INTERVALS.

3. CRUSHED LIMEROCK BASE SHALL EXTEND A MINIMUM OF 6" BEYOND EDGE OF CONCRETE.

TYPICAL SIDEWALK

SCALE: NTS

6" WIDE 45° STRIPING AT 2'-0"

6" WIDE STRIPING

(2) COATS BLUE


6" WIDE STRIPING


HANDICAP LOGO

(2) COATS WHITE

O.C. (2) COATS WHITE

18' MIN.

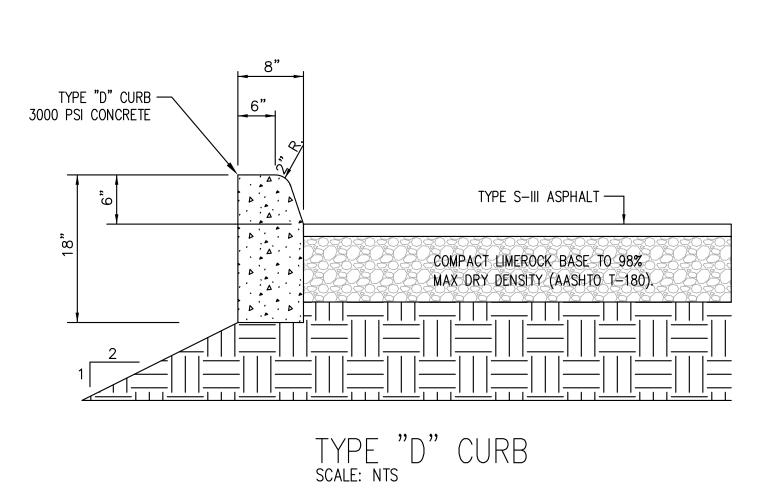

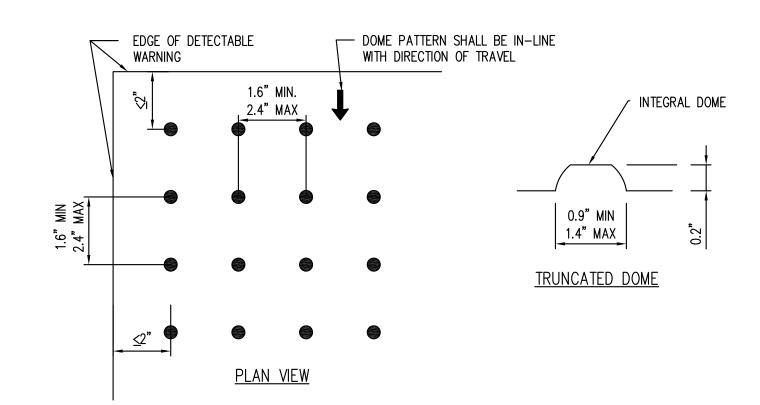



CFR TITLE 28 CHAPTER I PART 36 4.29.2: DETECTABLE WARNINGS ON WALKING SURFACES. DETECTABLE WARNINGS SHALL CONSIST OF RAISED TRUNCATED DOMES WITH A DIAMETER OF NOMINAL 0.9 IN (23 MM), A HEIGHT OF NOMINAL 0.2 IN (5 MM) AND A CENTER—TO—CENTER SPACING OF NOMINAL 2.35 IN (60 MM) AND SHALL CONTRAST VISUALLY WITH ADJOINING SURFACES, EITHER LIGHT—ON—DARK, OR DARK—ON—LIGHT. THE MATERIAL USED TO PROVIDE CONTRAST SHALL BE AN INTEGRAL PART OF THE WALKING SURFACE.

4.29.5 IF A WALK CROSSES OR ADJOINS A VEHICULAR WAY, THE BOUNDARY BETWEEN THE AREAS SHALL BE DEFINED BY A CONTINUOUS DETECTABLE WARNING WHICH IS 36 INCHES WIDE, COMPLYING WITH 4.29.2.

4.7.7 A CURB RAMP SHALL HAVE A DETECTABLE WARNING COMPLYING WITH 4.29.2. THE DETECTABLE WARNING SHALL EXTEND THE FULL WIDTH AND DEPTH OF THE CURB RAMP.

DETECTABLE WARNING SCALE: NTS

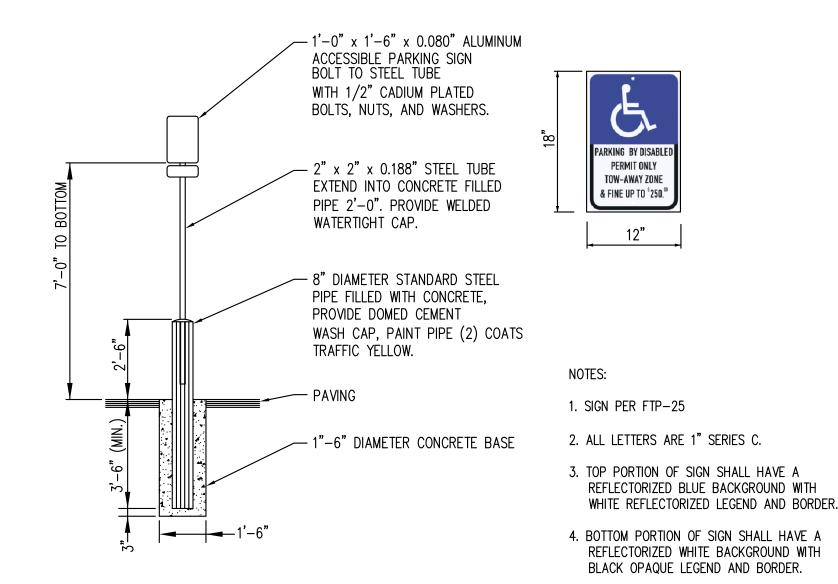

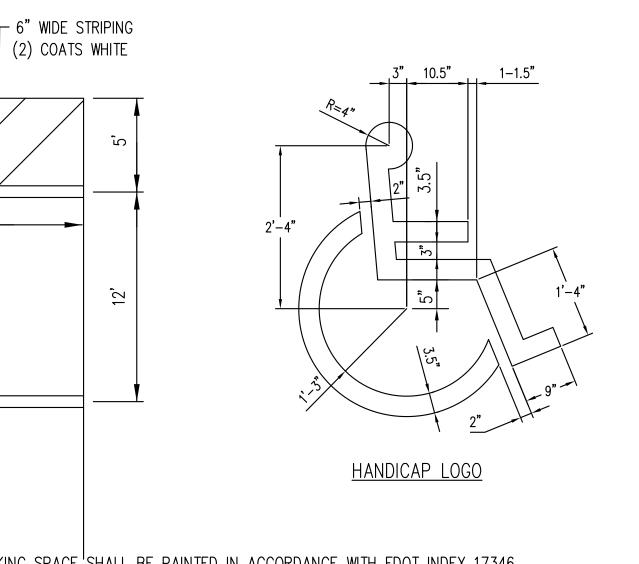

ACCESSIBLE PARKING SPACE SHALL BE PAINTED IN ACCORDANCE WITH FDOT INDEX 17346.

ACCESSIBLE PARKING SCALE: NTS

G R A C E ENGINEERING

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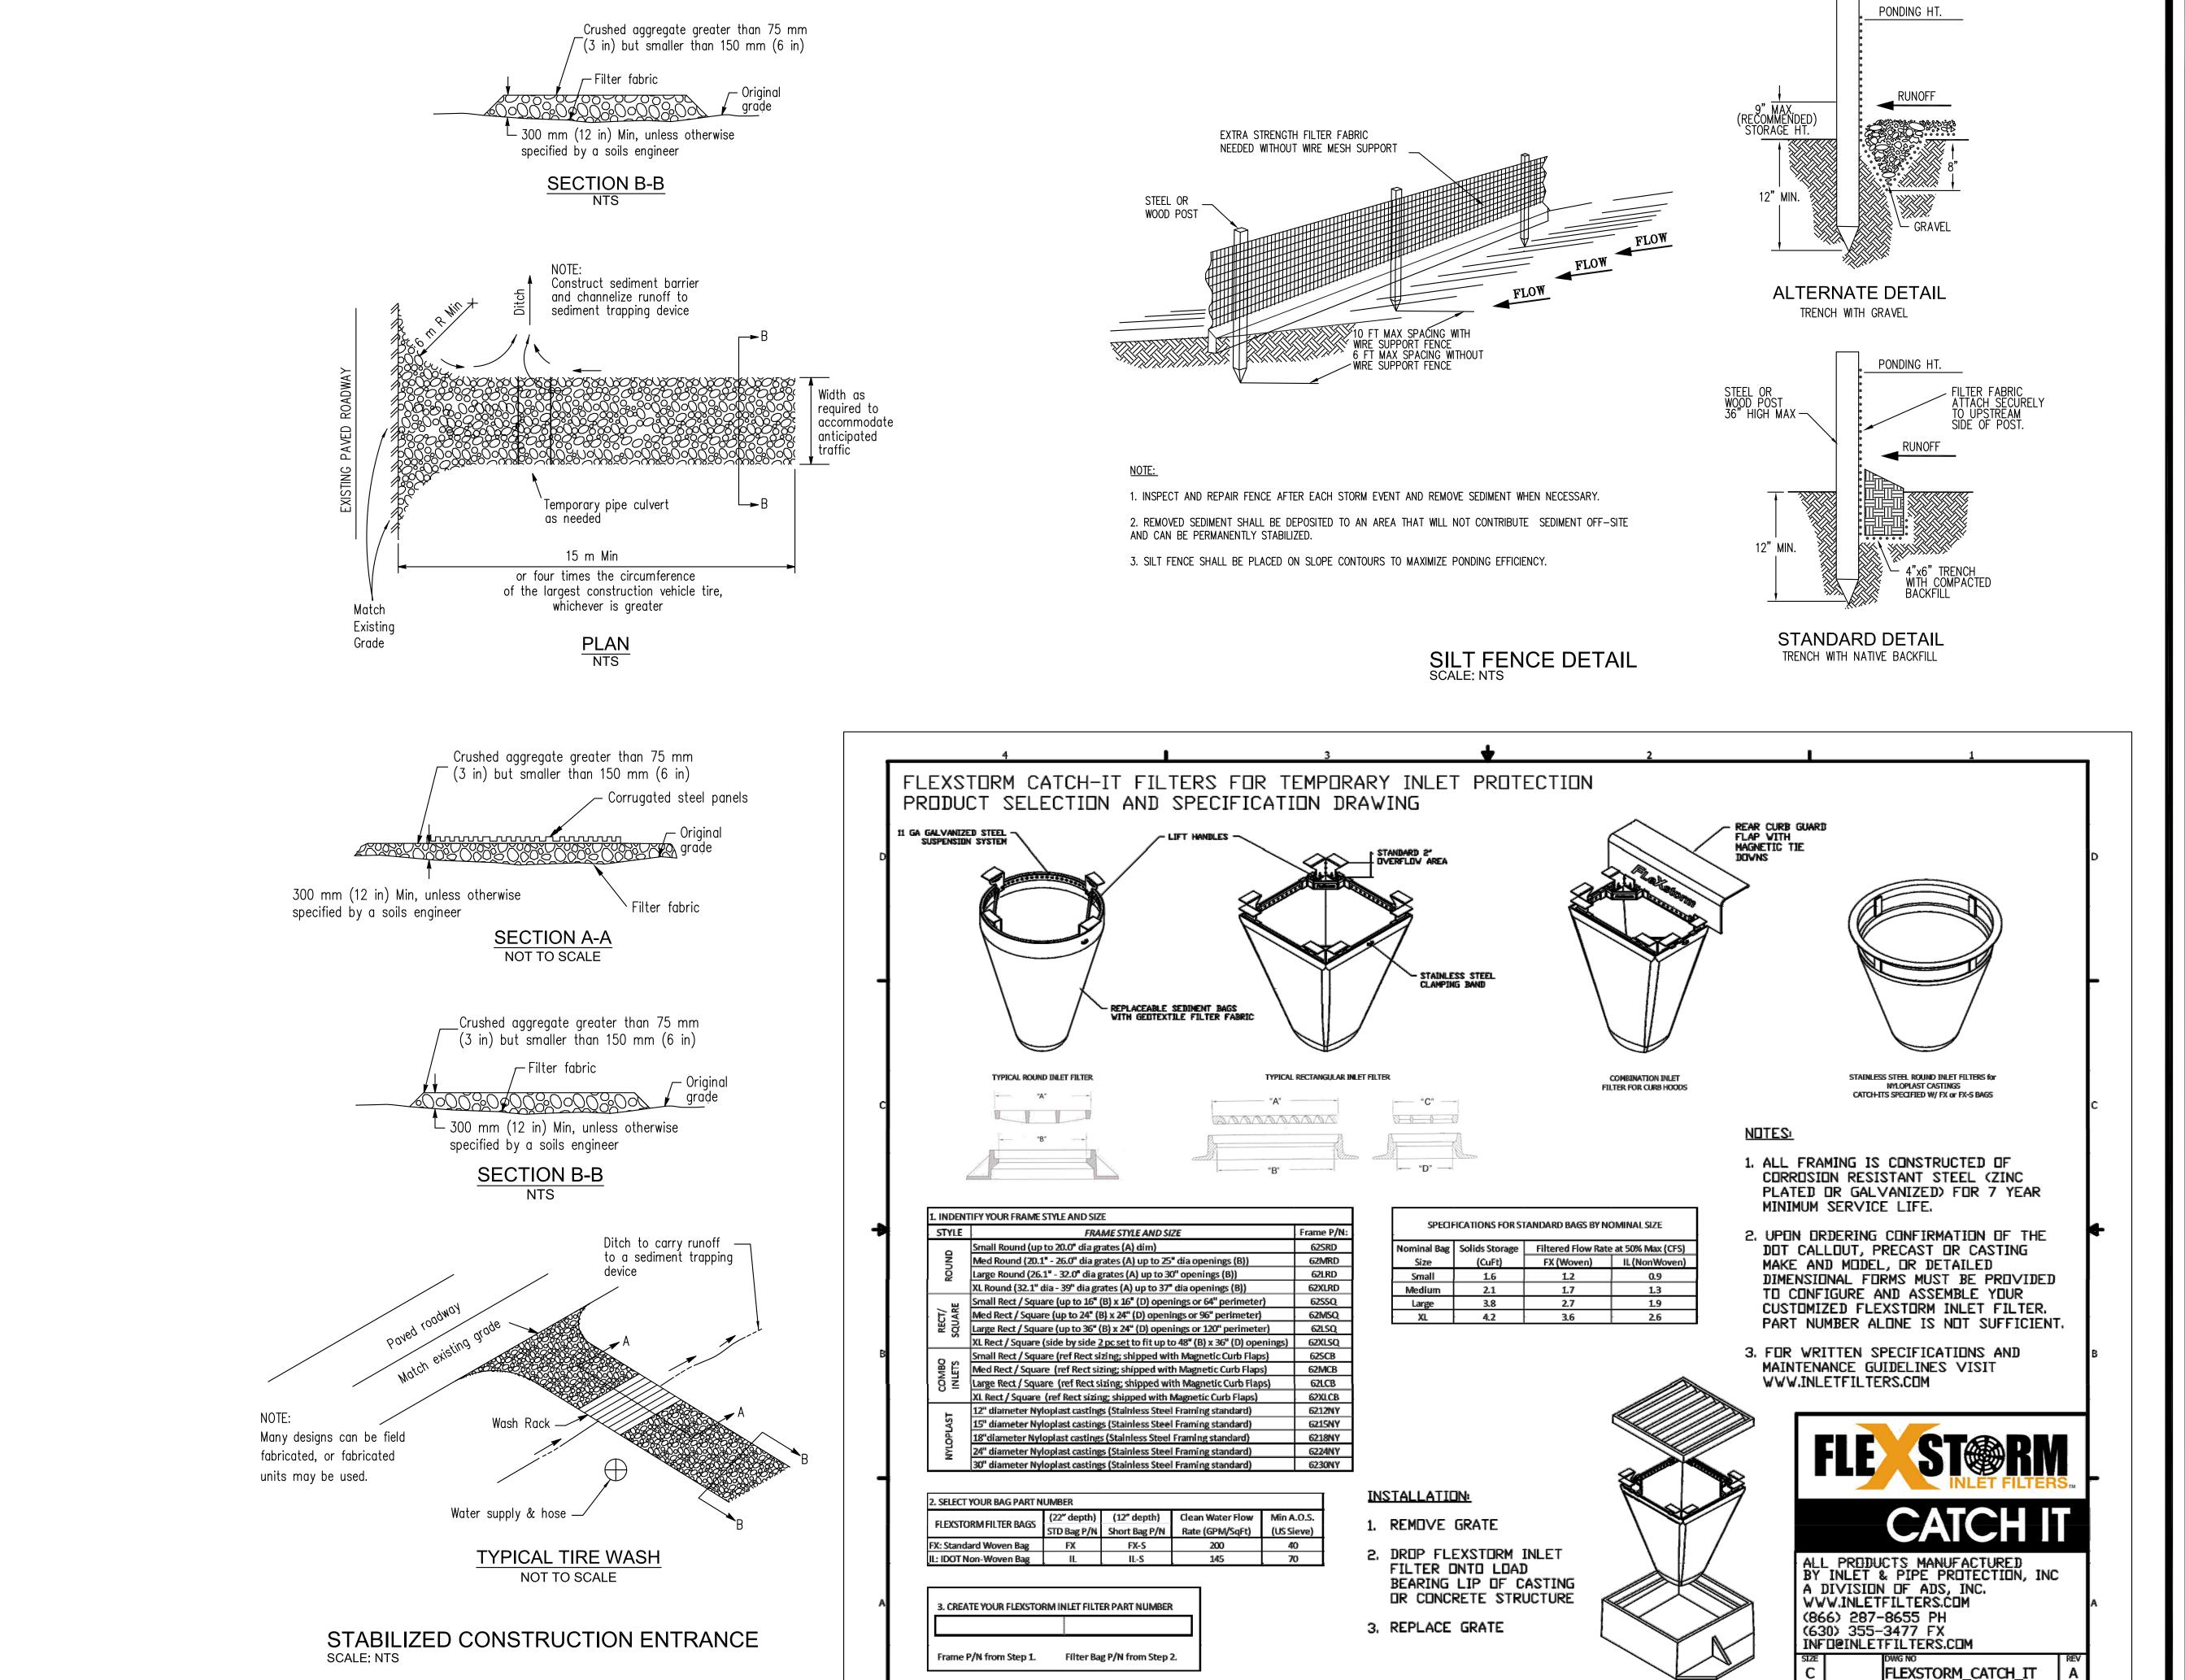
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GRACE ENGINEERING, LLC
Certificate of Authorization No. 2928

SHEET NAME

DETAILS

C-700



G R A C E ENGINEERING

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17110 SW 64TH COURT
SOUTHWEST RANCHES, FLORIDA 3333

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954.558.9628

GRACE Project No: C2302
Plan Date: October 18, 2018

Revisions:

Prepared For:

Chai Developers

Limited Partnership

101 S. State Road 7, Suite # 205

Hollywood, Florida 33023

CENTER Road 7

SHOPPING CE

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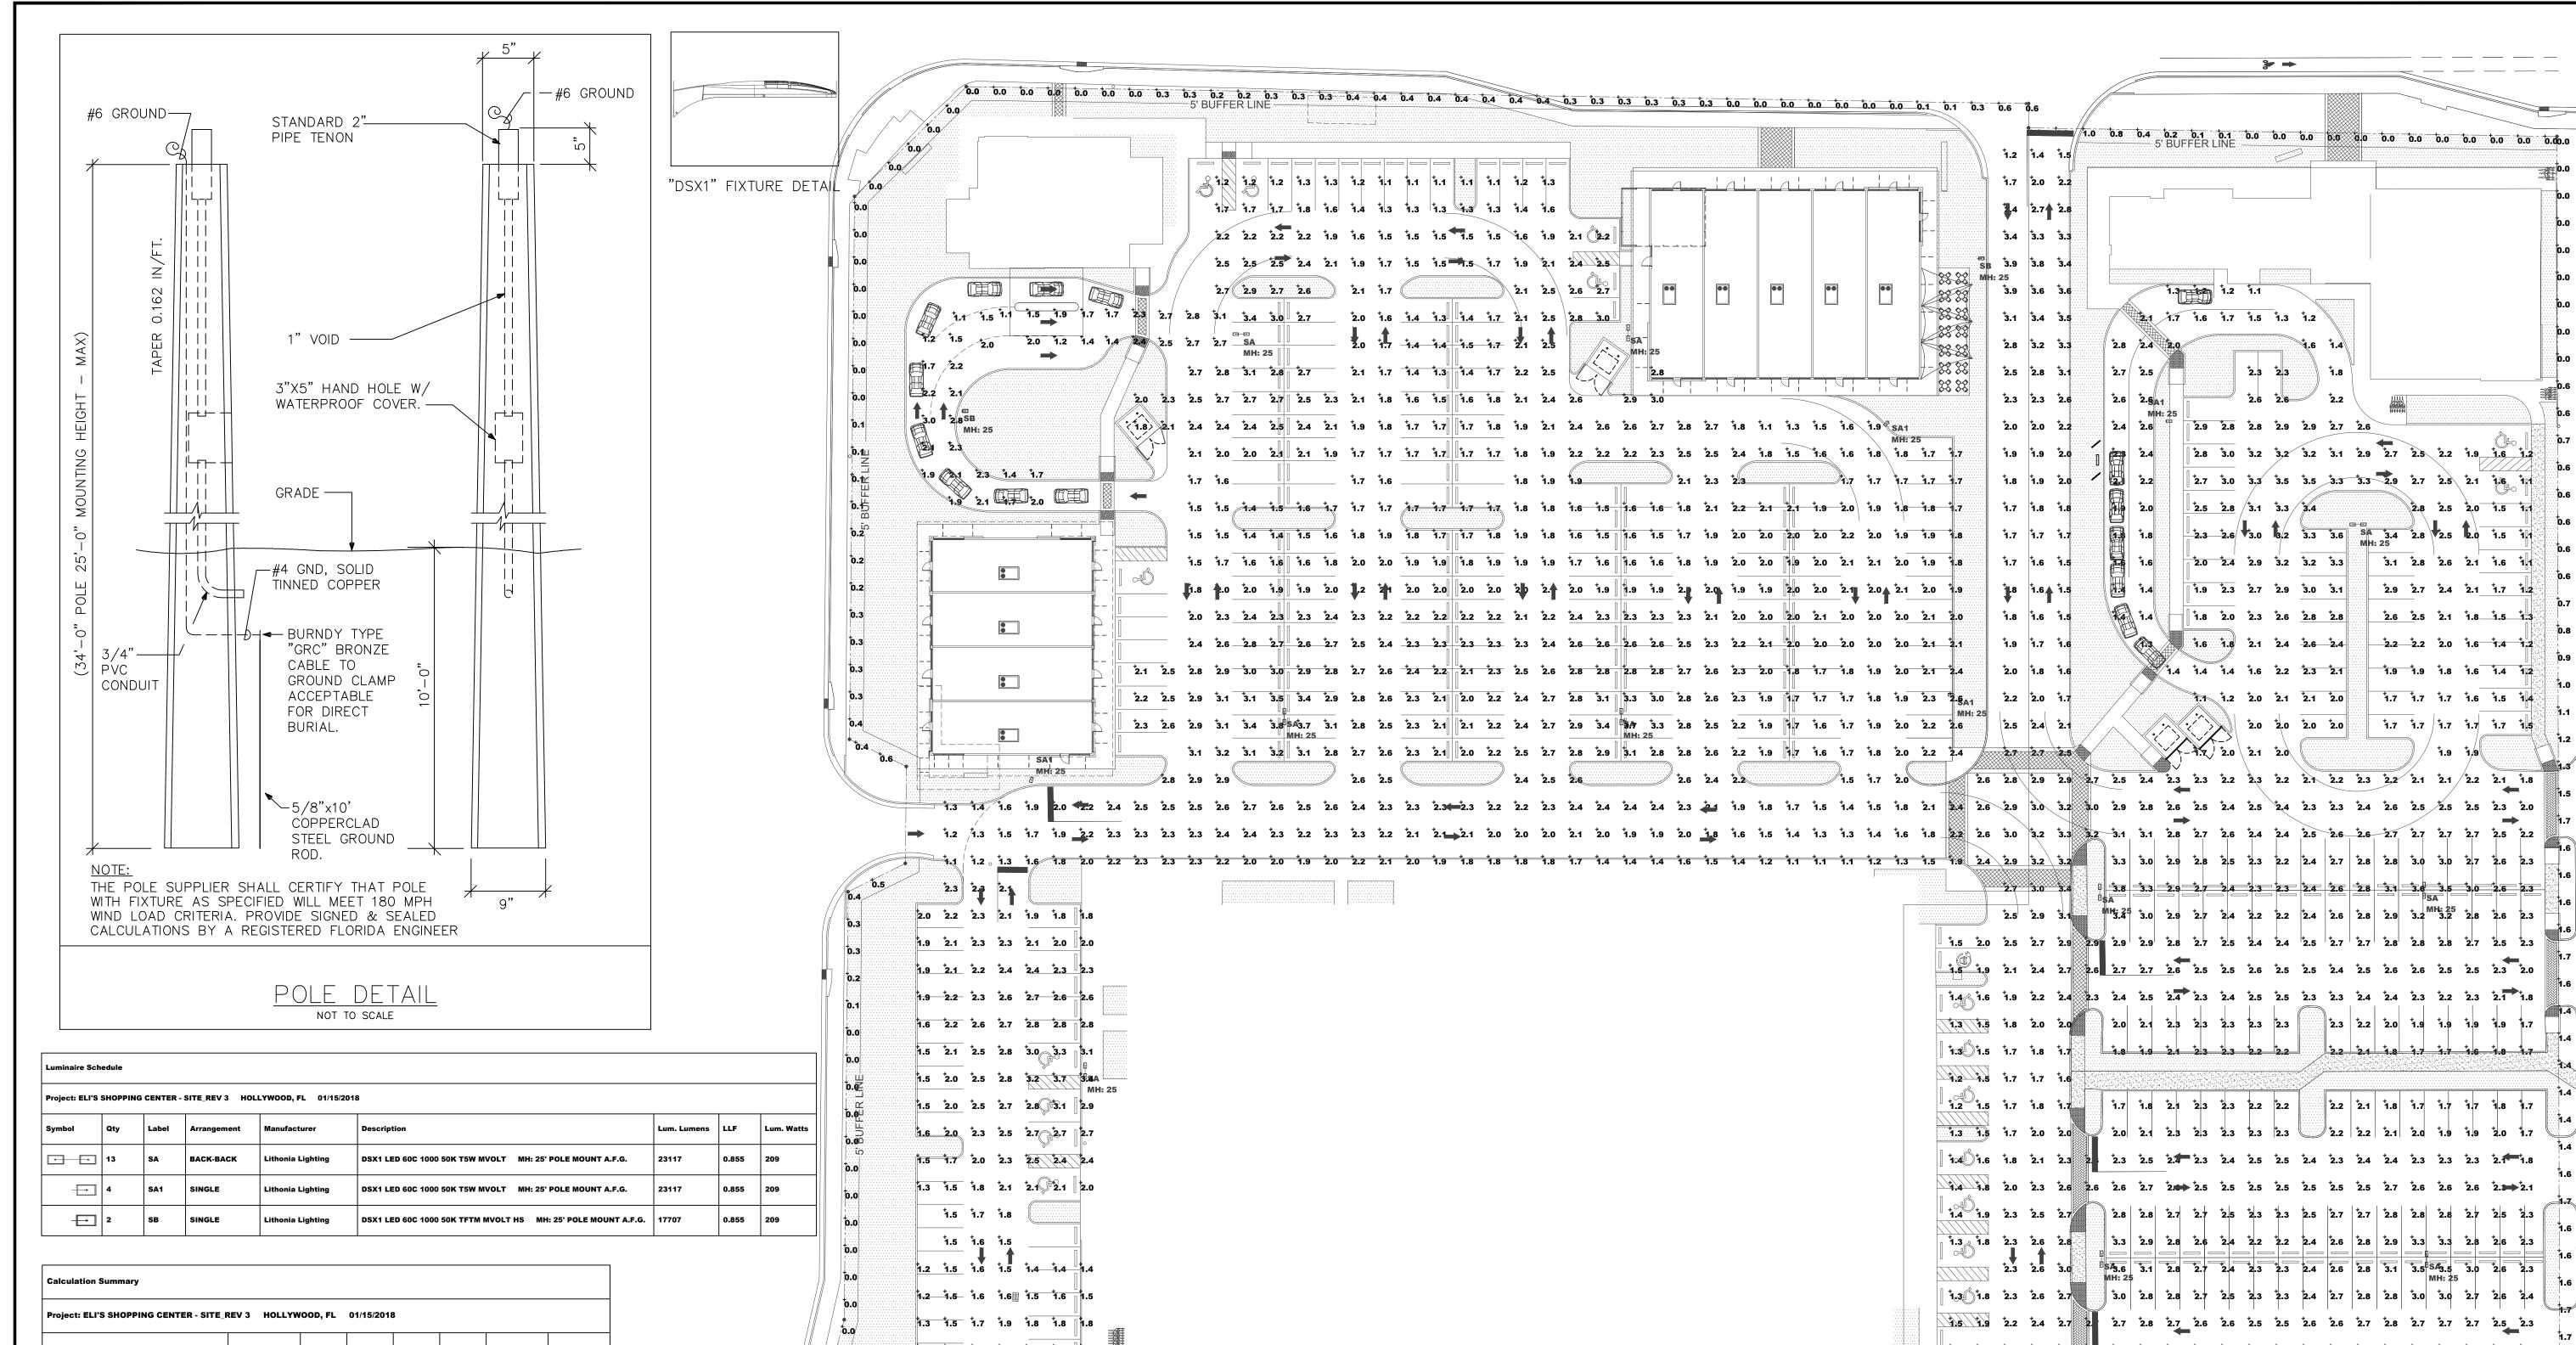
JOHN E. FLYNN, P.E.
Florida License No. 63316
GRACE ENGINEERING, LLC

Certificate of Authorization No. 2928
SHEET NAME

DETAILS

SHEET NUMBER

SHEET 1 OF 1



PROPERTY LINE EAST

PROPERTY LINE NORTH

ROPERTY LINE SOUTH

PROPERTY LINE WEST

1.2 1.5 1.7 1.8 1.7 1.8 2.1 2.3 2.3 2.2 2.2 2.2 2.1 1.8 1.7 1.7 1.7 1.8 1.7 1.3 1.5 1.7 2.0 2.0 2.0 2.1 2.3 2.3 2.3 2.3 2.3 2.2 2.2 2.2 2.1 2.0 1.9 1.9 2.0 1.7 1.4 1.6 1.8 2.1 2.3 2.5 2.4 2.3 2.5 2.4 2.3 2.5 2.4 2.3 2.4 2.3 2.4 2.3 2.3 2.3 2.3 2.4 2.8 1.4 1.8 2.0 2.3 2.6 2.6 2.7 2. 2. 2.5 2.5 2.5 2.5 2.5 2.5 2.5 2.7 2.6 2.6 2.6 2.3 2.1 3.3 2.9 2.8 2.6 2.4 2.2 2.2 2.4 2.6 2.8 2.9 3.3 3.3 2.8 2.6 2.3 \$\frac{1}{3}.6 \quad \frac{1}{3}.1 \quad \frac{1}{2}.8 \quad \frac{1}{2}.7 \quad \frac{1}{2}.4 \quad \frac{1}{2}.6 \quad \frac{1}{2}.8 \quad \frac{1}{3}.1 \quad \frac{1}{3}.5 \quad \quad \frac{1}{3}.5 \quad \frac{1}{3}.5 \quad \quad \frac{1}{3}.5 3.0 2.8 2.8 2.7 2.5 2.3 2.3 2.4 2.7 2.8 2.8 3.0 3.0 2.7 2.6 2.4 7.5 7.9 2.2 2.4 2.7 2.8 2.7 2.8 2.7 2.6 2.6 2.5 2.5 2.6 2.6 2.6 2.7 2.8 2.7 2.7 2.5 2.3 1.5 1.8 2.0 2.3 2.5 2.5 2.5 2.7 2.5 2.5 2.5 2.6 2.6 2.6 2.5 2.5 2.5 2.7 2.5 2.5 2.3 2.0 1.5 1.9 2.1 2.4 2.6 2.5 2.5 1.5 2.0 2.4 2.6 2.7 2.8 2.7 1.4 1.6 1.9 2.1 2.0 2.1 2.4 2.5 2.5 2.4 2.4 2.5 2.5 2.4 2.1 2.0 2.0 2.0 2.1 1.9 1.4 1.9 2.4 2.7 2.9 3.3 3.1 1.3 1.7 2.0 2.0 1.8 2.0 2.4 2.5 2.4 2.4 2.5 2.4 2.0 1.9 1.9 1.9 1.0 2.0 2.0 1.4 1.9 2.4 2.7 3.1 3.6 3.5A 1.1 1.4 1.6 1.8 2.1 2.3 2.3 2.3 2.5 2.4 2.3 2.4 2.5 2.5 2.4 2.3 1.4 1.7 1.9 2.0 1.9 2.0 2.1 2.4 2.5 2.5 2.4 2.4 2.5 2.5 2.4 2.1 2.0 1.9 1.9 2.0 1.9 1.4 2.0 2.4 2.7 1.5 1.9 2.2 2.4 2.6 2.6 2.6 2.6 1.4 1.6 1.9 2.2 2.4 2.3 2.3 1.2 1.2 2.3 2.6 3.0 2.8 3.6 3.1 2.8 2.7 2.4 2.3 2.3 2.4 2.6 1.9 2.3 2.6 2.7 2.9 2.8 2.7 2.5 2.3 2.3 2.5 2.7 2.8 2.8 2.9 2.9 2.9 2.7 2.6 2.3 1.1 1,4 1.6 1.9 1<u>.9 1.8 1</u>.8 1.1 1.4 1.5 1.4 2.6 2.9 1,34,45 3.0 2.8 2.6 2.4 2.2 2.2 2.4 2.6 2.8 3.0 3.4 MH3.25 2.9 2.6 2.3 2.3 2.5 2.7 2.8 2.7 2.6 2.4 2.2 2.2 2.4 2.6 2.7 2.7 2.8 2.8 2.7 2.5 2.3 1.8 **2.1** 2.3 2.6 2.5 2.6 2.6 2.5 2.4 2.4 2.4 2.4 2.4 2.4 2.5 2.6 2.6 2.6 2.6 2.3 2.1 0.8 1.1 1.4 1.7 2.0 2.3 2.4 2.3 2.4 2.3 2.2 2.3 2.3 2.3 2.2 2.3 2.4 2.5 2.3 2.4 2.3 2.0 1.7 1.5 BUCHANAN P.E CONSULTING INC. PHOTOMETRIC PLAN ENGINEERING 6191 W. ATLANTIC BLVD, SUITE# 2 MARGATE, FL 33063 CERTIFICATE OF AUTHORIZATION # 8842

F. 305-362-4420 dtiinfo@dtiarchitect.com www.dtiarchitect.com

Carlos Pizarro, R.A.

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2.0 2.0 2.0 2.0

2.2 2.2 2.0 1.6 1.4 1,2

1.7 1.7 1.7 1.6 1.5 14

1.7 1.7 1.7 1.7 1.7 1.5

Revisions: Date | Description

Job Number: 15087.02 File name:

Issued Date: 11/09/2016

Drawn by: J.C

Checked by: C.C / C.P SHEET NAME

SITE **PHOTOMETRIC**

PLAN

SHEET NUMBER

PH-1

DATE: ____

☐ RAJA BUCHANAN P.E # 48916 ☐ MAURICE LORD P.E # 72550