PLANNING DIVISION





File No. (internal use only):

2600 Hollywood Boulevard Room 315 Hollywood, FL 33022

GENERAL APPLICATION

	APPLICATION TYPE (CHECK ONE):
Highly your	Technical Advisory Committee
	☐ City Commission ☐ Planning and Development Board
* FLOHIDA	Date of Application: 4-30-20/8
Tel: (954) 921-3471	Location Address: 2324 Thonson Street.
Fax: (954) 921-3347	Lot(s): 13 Block(s): 12 Subdivision: Hollywood little Ranche
ling of the second seco	Zoning Classification: DH-2 Land Use Classification: MULTI FAMILY
This application must be completed in full and	Existing Property Use: S, F. Sq Ft/Number of Units: 1000 S.F. Sq Je
submitted with all documents	Is the request the result of a violation notice? () Yes (WNo If yes, attach a copy of violation. FAMIL
to be placed on a Board or Committee's agenda.	Has this property been presented to the City before? If yes, check al that apply and provide File Number(s) and Resolution(s):
Ti- and the state of the state of	☐ Economic Roundtable ☐ Technical Advisory Committee ☐ Historic Preservation Board
The applicant is responsible for obtaining the appropriate	☐ City Commission ☐ Planning and Development
checklist for each type of application.	Explanation of Request:
Applicant(a) a the light	+ A A A Stoost
Applicant(s) or their authorized legal agent must be	Number of units/rooms: 10NIT ONE BED. Sq Ft: 10 (7005) 1(600 Sq) 1(4005)
present at all Board or Committee meetings.	Value of Improvement: Section Estimated Date of Completion: 8-2019
Committee meetings.	Will Project be Phased? () Yes (V)No If Phased, Estimated Completion of Each Phase
At least one set of the	
submitted plans for each application must be signed	Name of Current Property Owner: 444 Construction Tre. (SACIH KADDAD)
and sealed (i.e. <u>Architect</u> or Engineer).	Address of Property Owner: 890 ALFONSO AVE CORAL GABLES, PL.
Engineer).	Telephone: 419509 1015 Fax: Email Address: HADDAD WHOMES CYAM
Documents and forms can be	Name of Consultant/Representative/Tenant (circle one): MIGUEL de Disan, 'Cert'.
accessed on the City's website	Address: 1657 Tyler Street Suit 107 Telephone: 9549263358
	Fax: 9549262021 Email Address: deducey work & act. Con.
	Date of Purchase: 8-31-2017 Is there an option to purchase the Property? Yes () No (4)
	If Yes, Attach Copy of the Contract.
	List Anyone Else Who Should Receive Notice of the Hearing:
Kan Ta	Address: Email Address:
	Littori / MOIOOO.

PLANNING DIVISION

File No. (Internal use only):

Second Hollywood Boulevard Room 315
Hollywood, FL 33022

CERTIFICATION OF COMPLIANCE WITH APPLICABLE REGULATIONS

The applicant/owner(s) signature certifies that he/she has been made aware of the criteria, regulations and guidelines applicable to the request. This information can be obtained in Room 315 of City Hall or on our website at www.hollywoodfl.org. The owner(s) further certifies that when required by applicable law, including but not limited to the City's Zoning and Land Development Regulations, they will post the site with a sign provided by the Office of Planning and Development Services. The owner(s) will photograph the sign the day of posting and submit photographs to the Office of Planning and Development Services as required by applicable law. Failure to post the sign will result in violation of State and Municipal Notification Requirements and Laws.

(I)(We) certify that (I) (we) understand and will comply with the provisions and regulations of the City's Zoning and Land Development Regulations, Design Guidelines, Design Guidelines for Historic Properties and City's Comprehensive Plan as they apply to this project. (I)(We) further certify that the above statements and drawings made on any paper or plans submitted herewith are true to the best of (my)(our) knowledge. (I)(We) understand that the application and attachments become part of the official public records of the City and are not returnable.

<i>A</i>	· • · · · · · · · · · · · · · · · · · ·
Signature of Current Owner:	Date: <u>4-30</u> -2018
PRINT NAME: SOUR MADDED	Date: 4-30-2012
Signature of Consultant/Representative:	Date: <u>Cf-30-</u> 2d8
PRINT NAME: Highel 3	
Signature of Tenant: N/A	Date:
PRINT NAME: N/A	Date:
Current Owner Power of Attorney	
l am the current owner of the described real property and that I am aware to my property, which is herebyto be my legal representative before the Committee) relative to all matters concerning this application.	e of the nature and effect the request for y made by me or I am hereby authorizing e(Board and/or
Sworn to and subscribed before me	
this day of	Signature of Current Owner
Notary Public	Print Name
State of Florida My Commission Evniras: (Check One) Bernandly known to war OD	
My Commission Expires:(Check One)Personally known to me; OR	Produced Identification

TA/NSPS URVI



N. 24th AVENUE

DESCRIPTION:

LOT 13, LESS THE SOUTH 60 FEET THEREOF, BLOCK 12, "AMENDED PLAT OF HOLLYWOOD LITTLE RANCHES", ACCORDING TO PLAT THEREOF, AS RECORDED IN PLAT BOOK 1, PAGE 26, OF THE PUBLIC RECORDS OF BROWARD COUNTY, FLORIDA.

SAID LAND SITUATED IN THE CITY OF HOLLYWOOD, BROWARD COUNTY, FLORIDA

SURVEYOR'S NOTES:

- 2.) HEREON.

 THE WORD "CERTIFY" AS USED HEREON IS AN OF PROFESSIONAL OPINION AND DOES NOT CON Y OR GUARANTEE,

 SPECIFICALLY STATED OR SHOWN HEREON. THIS
- S NOT PURPORT TO REFLECT OR REPRESENT THE ABSENCE OR STENCE OF ANY OF THE FOLLOWING, WHICH MAY BE APPLICABLE THE PRESENT OF INTENDED USES OF THE SUBJECT PROPERTY: EMENTS, BUILDING SETBACK LINES, RESTRICTIVE COVENANTS, DNING AND OTHER LAND USE REGULATIONS, THE LOCATION OF JBSURFACE IMPROVEMENTS, STRUCTURES OR UTILITIES, JBSURFACE WATER FLOW, BOTH ONTO OR FROM THE SITE, VINRONMENTALLY REGULATED OR SENSITIVE LANDS, ROADWAYS OR STREETS, PROPOSED USES, ETLANDS, ROADWAYS OR STREETS, PROPOSED USES,
- 6.) VERTIC OR RIGHT OF ACCESS.

 NO WETLAND MARKERS WERE OBSERVED BY THE UNDERSIGNED.

 NO FIELD DELINEATION OF WETLANDS BY A QUALIFIED SPECIALIST

 WAS REQUESTED BY THE UNDERSIGNED.

 ELEVATIONS SHOWN ARE REFERENCED TO NORTH AMERICAN

 CAL
- DATUM OF 1988.

 DATUM OF 1988.

 7.) BENCHMARK REFERENCE: CITY OF HOLLYWOOD INTERSECTION OF McKINLEY ST AND N 57 AV AND N 58 AV.

 3.) WITH REGARD TO TABLE A, ITEM 11 REFERENCED IN THE SURVEYOR'S CERTIFICATION:


 THIS SURVEY REFLECTS OBSERVED EVIDENCE OF UTILITIES.
 LACKING EXCAVATION, THE
 EXACT LOCATION OF UNDERGROUND FEATURES CANNOT BE ACCURATELY AND COMPLETELY DEPICTED.


SURVEY CERTIFICATION:

ŢO.

THIS IS TO CERTIFY THAT THIS MAP OR PLAT AND THE SURVEY ON WHICH IT IS BASED WERE MADE IN ACCORDANCE WITH THE 2016 MINIMUM STANDARD DETAIL REQUIREMENTS FOR ALTA / NSPS LAND TITLE SURVEYS, JOINTLY ESTABLISHED AND ADOPTED BY ALTA AND NSPS, AND INCLUDES ITEMS 1, 2, 3, 4, 8, 11(LIMITED), 13, 14, 16 AND 18 OF TABLE A THEREOF.

THE FIELD WORK WAS COMPLETED ON NOVEMBER 14, 2017

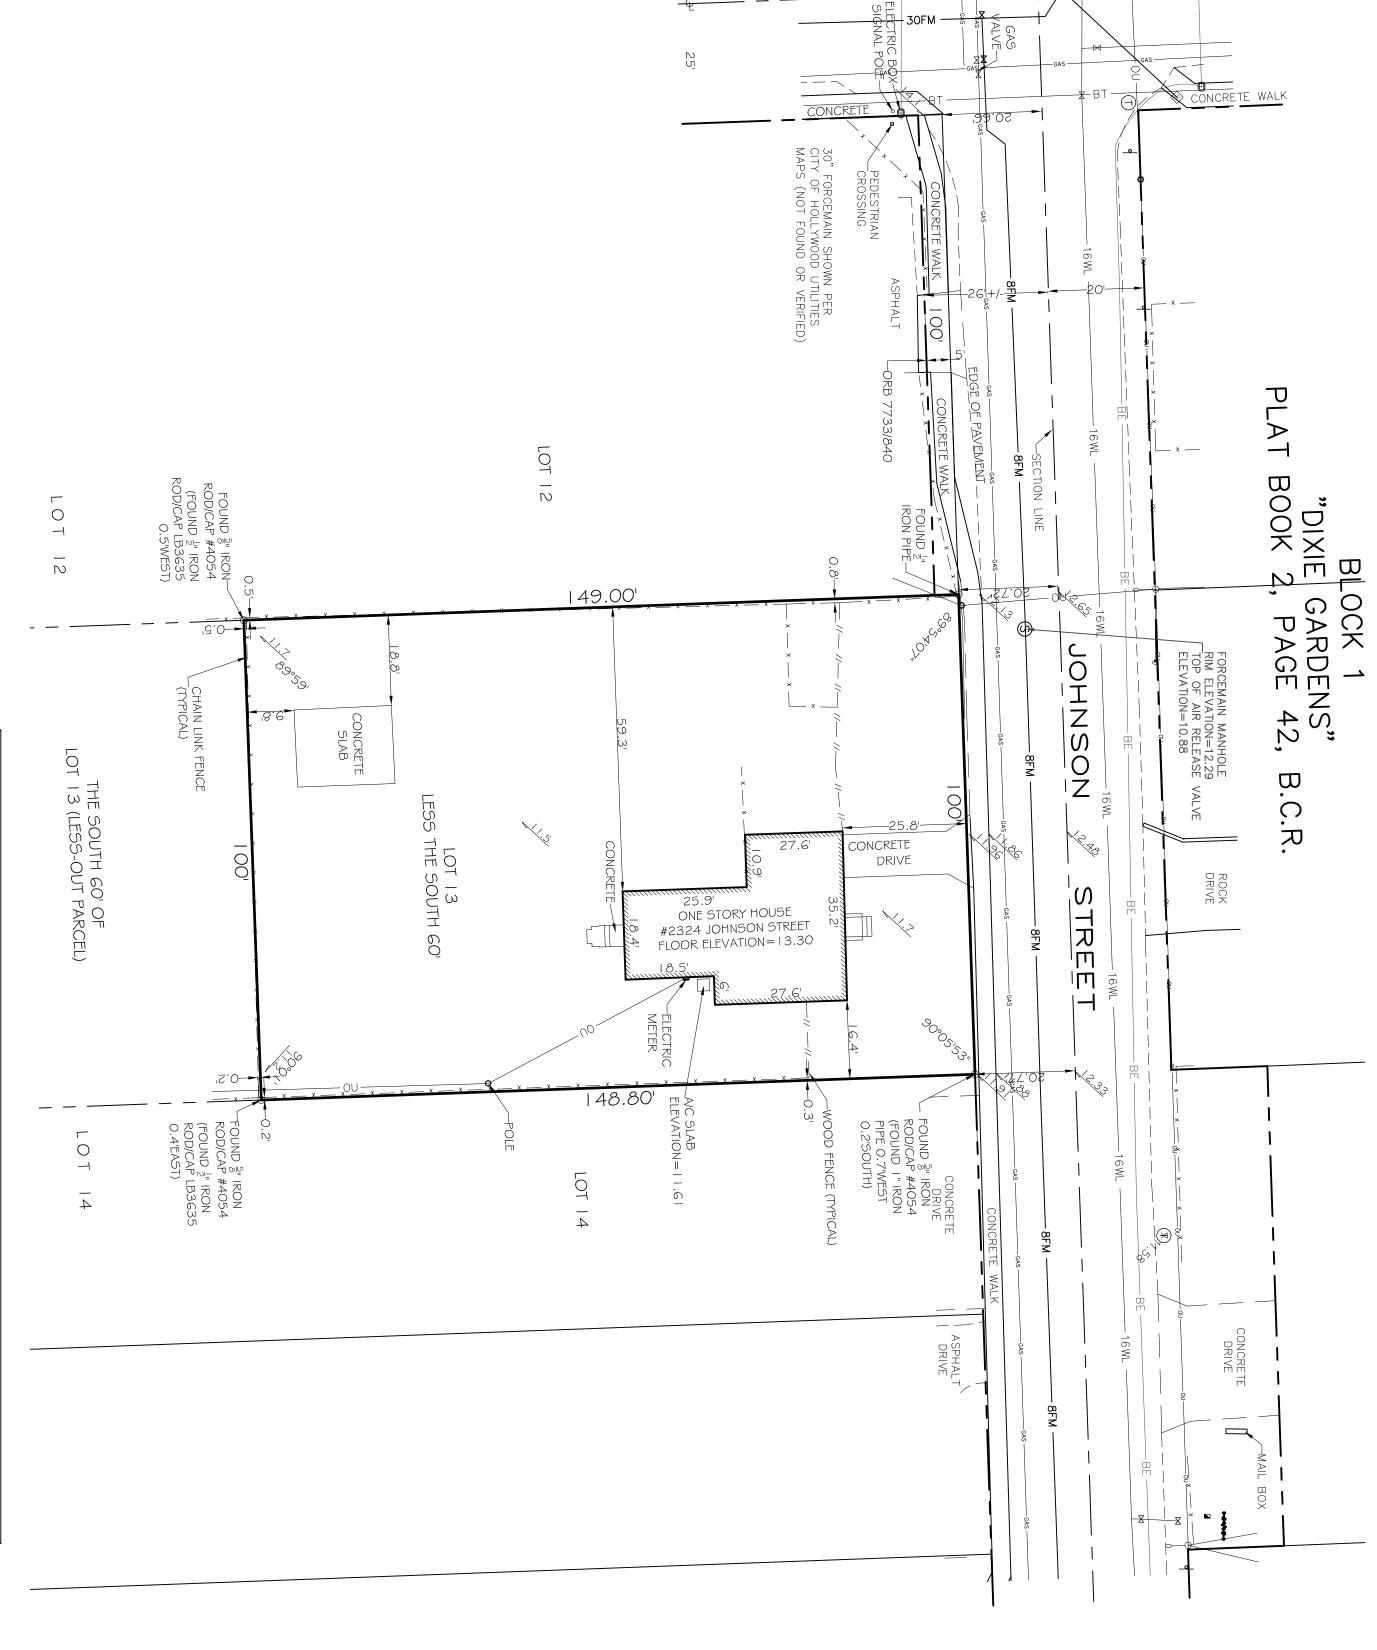

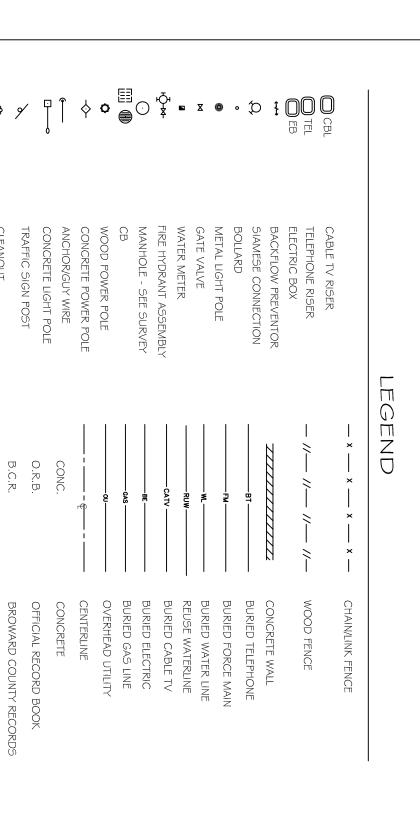


Ţ


(IN FEET) 1 INCH = 20 FEET	10	GRAPHIC SCALE
---------------------------------	----	---------------


NGS MC

	N CONSENT OF THE N/A	NO.		HALL NOT BE RELIED			_
	N/A N/A N/A	NO. SUFFIX ZONE		ロスクダムスク インクシー・・・・・・・・・・・・・・・・・・・・・・・・・・・・・・・・・・・・		CITY OF	V FLOOD IN
						CITY OF HOLLYWOOD	NSURANCI
	N/A	ELEV. FL	BASE L	レクスクス			RAIT MA
	N/A N/A N/A N/A	ELEV. FLR. ELEV GRD	FIRM BASE LOWEST AVG.			NO.	FEMA FLOOD INSURANCE RAIE MAP COMMUNITY
							REVISION
							DATE
	(0	ے					BY
NOT VALID WITHOUT TH	SCALE: 1"=20'	JOB #:8806					
NOT VALID WITHOUT THE SIGNATURE AND ORIGINAL	SHEET	DATE: 11-14-17				AL ANDLO	AI TA/NODO
VAL F	0	D		<u>'</u>	'		-

STEPHEN K. SEELEY, FOR THE FIRM PROFESSIONAL SURVEYOR & MAPPER FLORIDA REGISTRATION NO. 4574 GIBBS LAND SURVEYORS
2131 HOLLYWOOD BOULEVARD, SUITE 204
HOLLYWOOD, FL 33020 (954) 923-7666
LICENSED BUSINESS NO. 7018

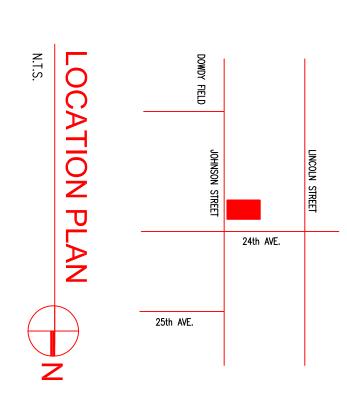

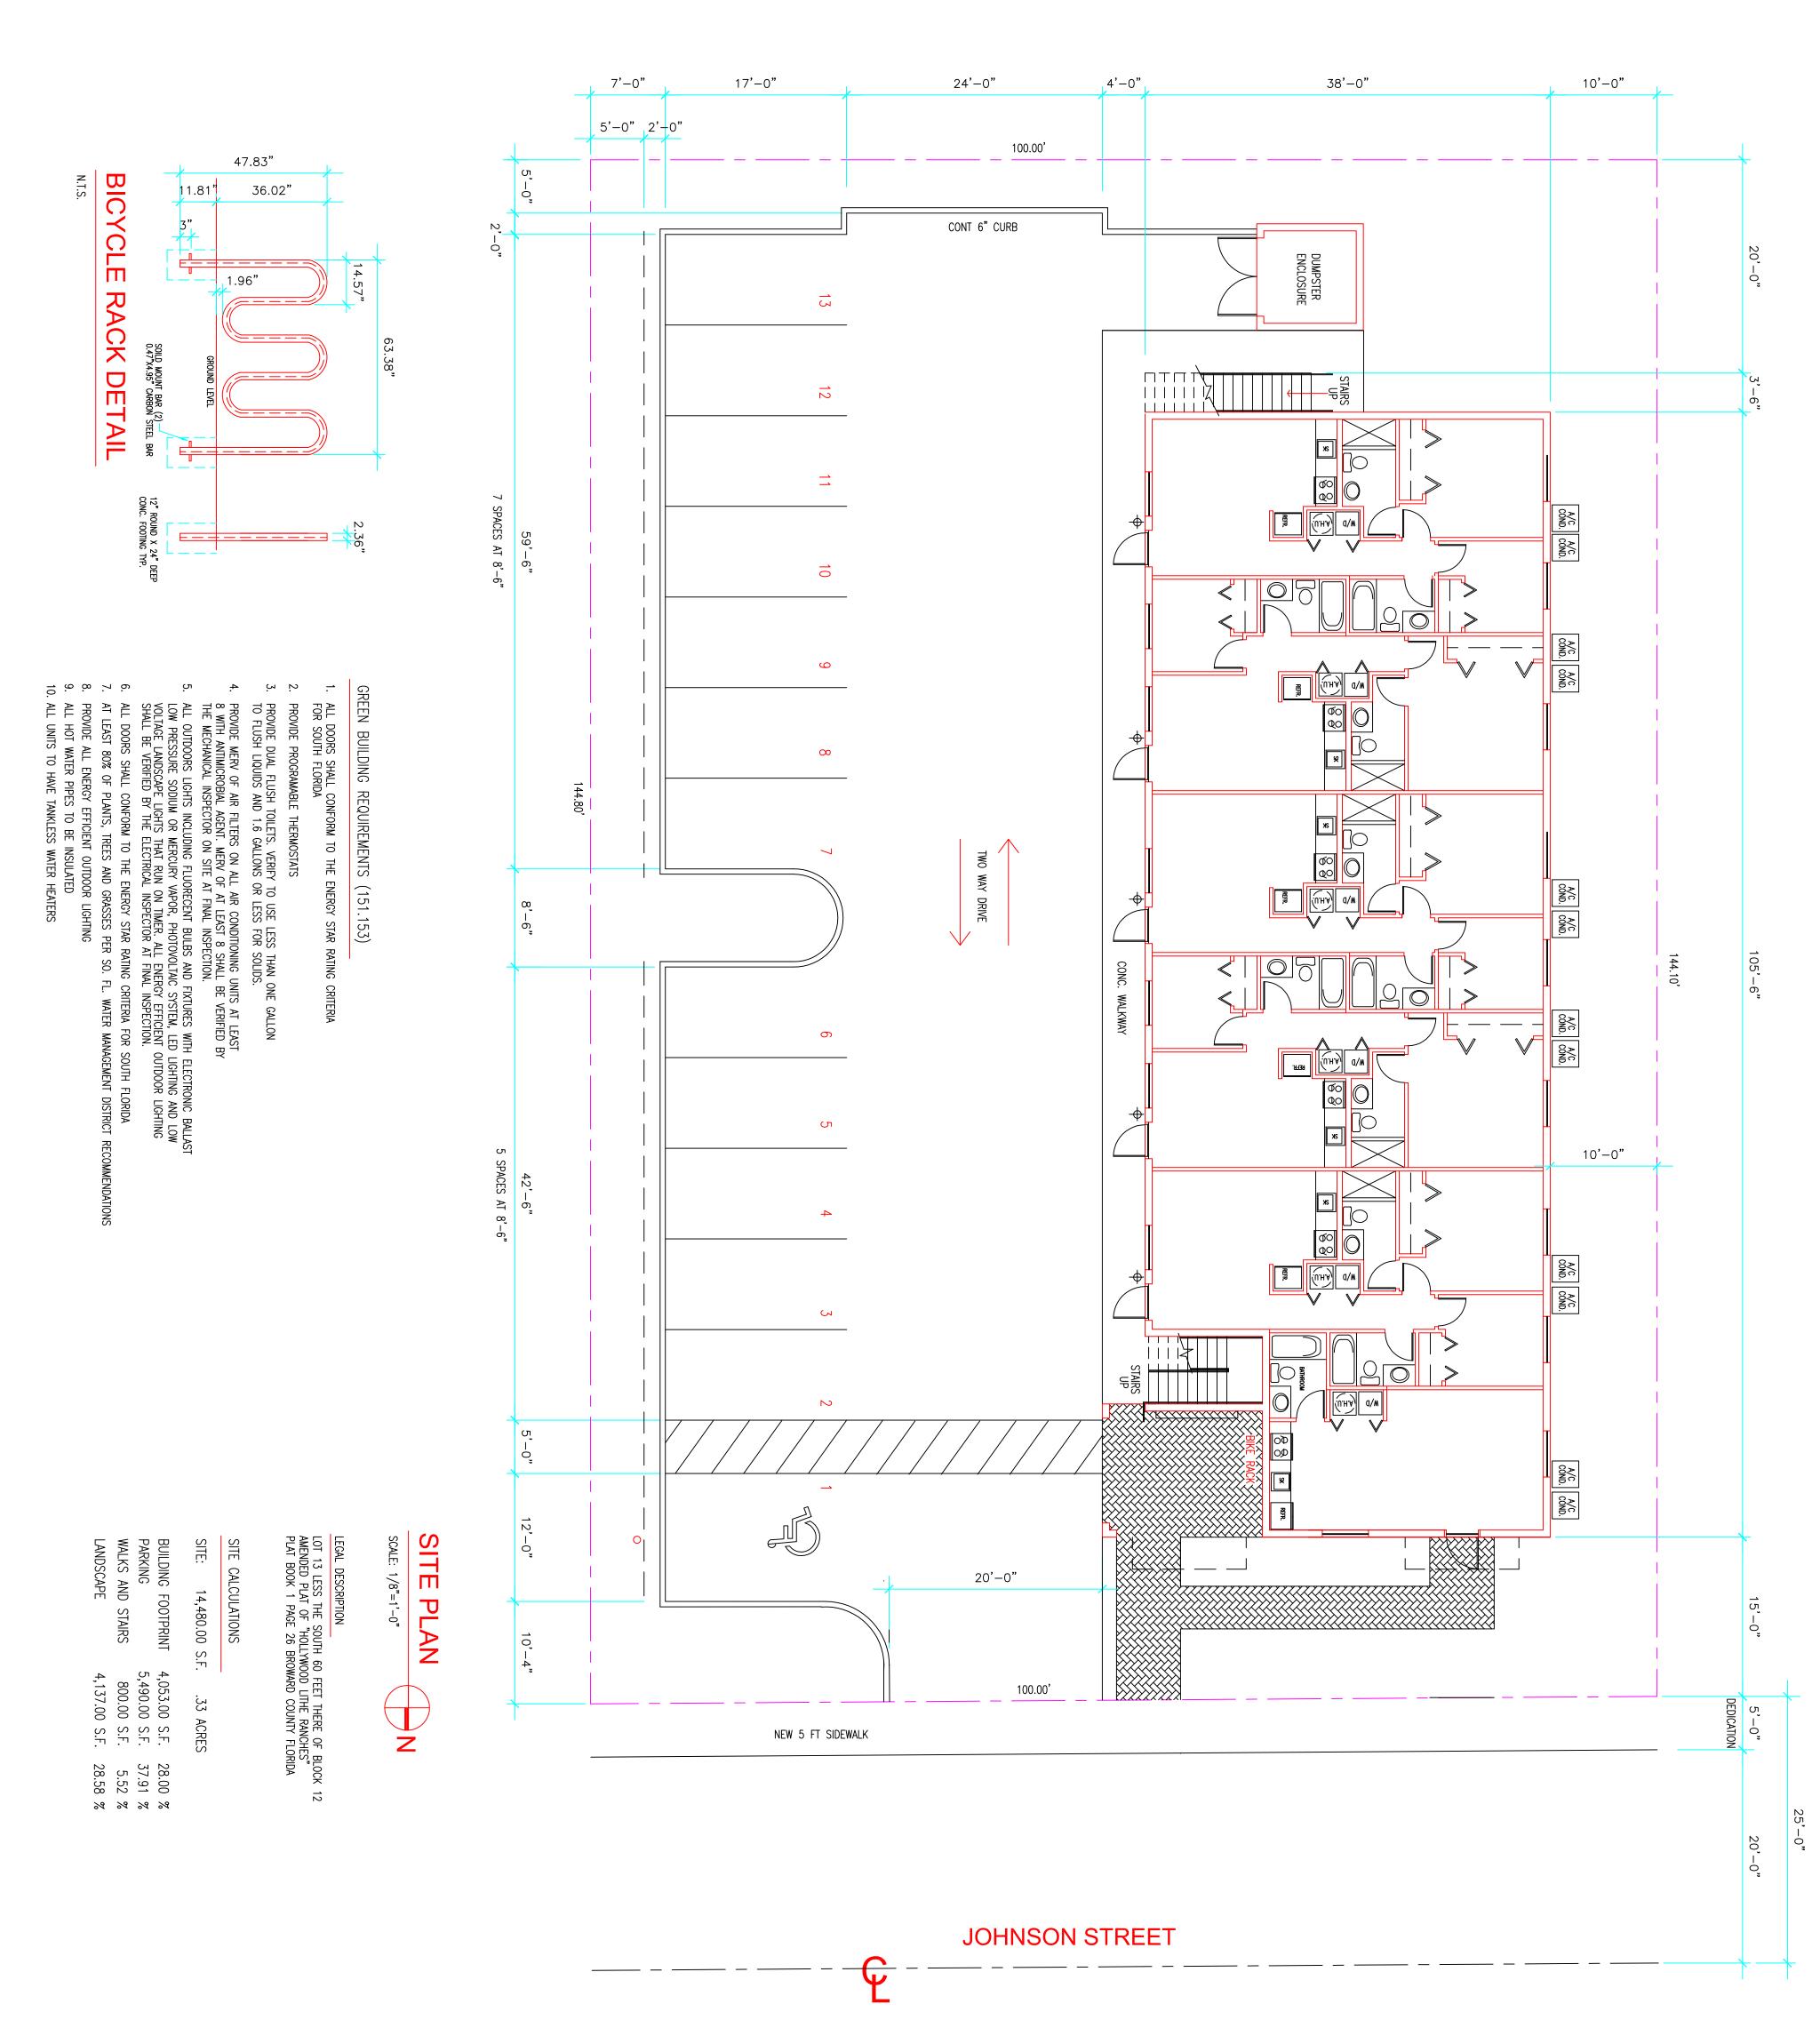


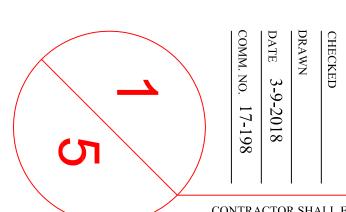



12 UNITS APARTMENTS
2324 JOHNSON STREET
HOLLYWOOD, FLORIDA

DATE REVISION ALL DESIGN, DRAWINGS, REPORTS, SPECIFICATIONS, COMPUTER FILES, FIELD	
DATA MOTEGAME AND AND OTHER DOCKNESSES	
DATA, NOTES AND ANY OTHER DOCUMENTS	;
PREPARED BY THE ARCHITECT AS	
INSTRUMENTS OF SERVICE SHALL REMAIN	
THE PROPERTY OF THE ARCHITECT AND IS	
NOT TO BE REPRODUCED, COPIED OR	
ALTERED IN WHOLE OR IN PART. IT IS ONLY	
TO BE USED FOR THE PROJECT AND SITE	
SPECIFICALLY IDENTIFIED HEREIN AND IS	
NOT TO BE USED ON ANY OTHER PROJECT.	
THE ARCHITECT SHALL RETAIN ALL COMMO	N
LAW COPYRIGHT AND OTHER RESERVED	
RIGHTS THERETO.	
WRITTEN DIMENSIONS SHALL HAVE	
PRECEDENCE OVER SCALE.	

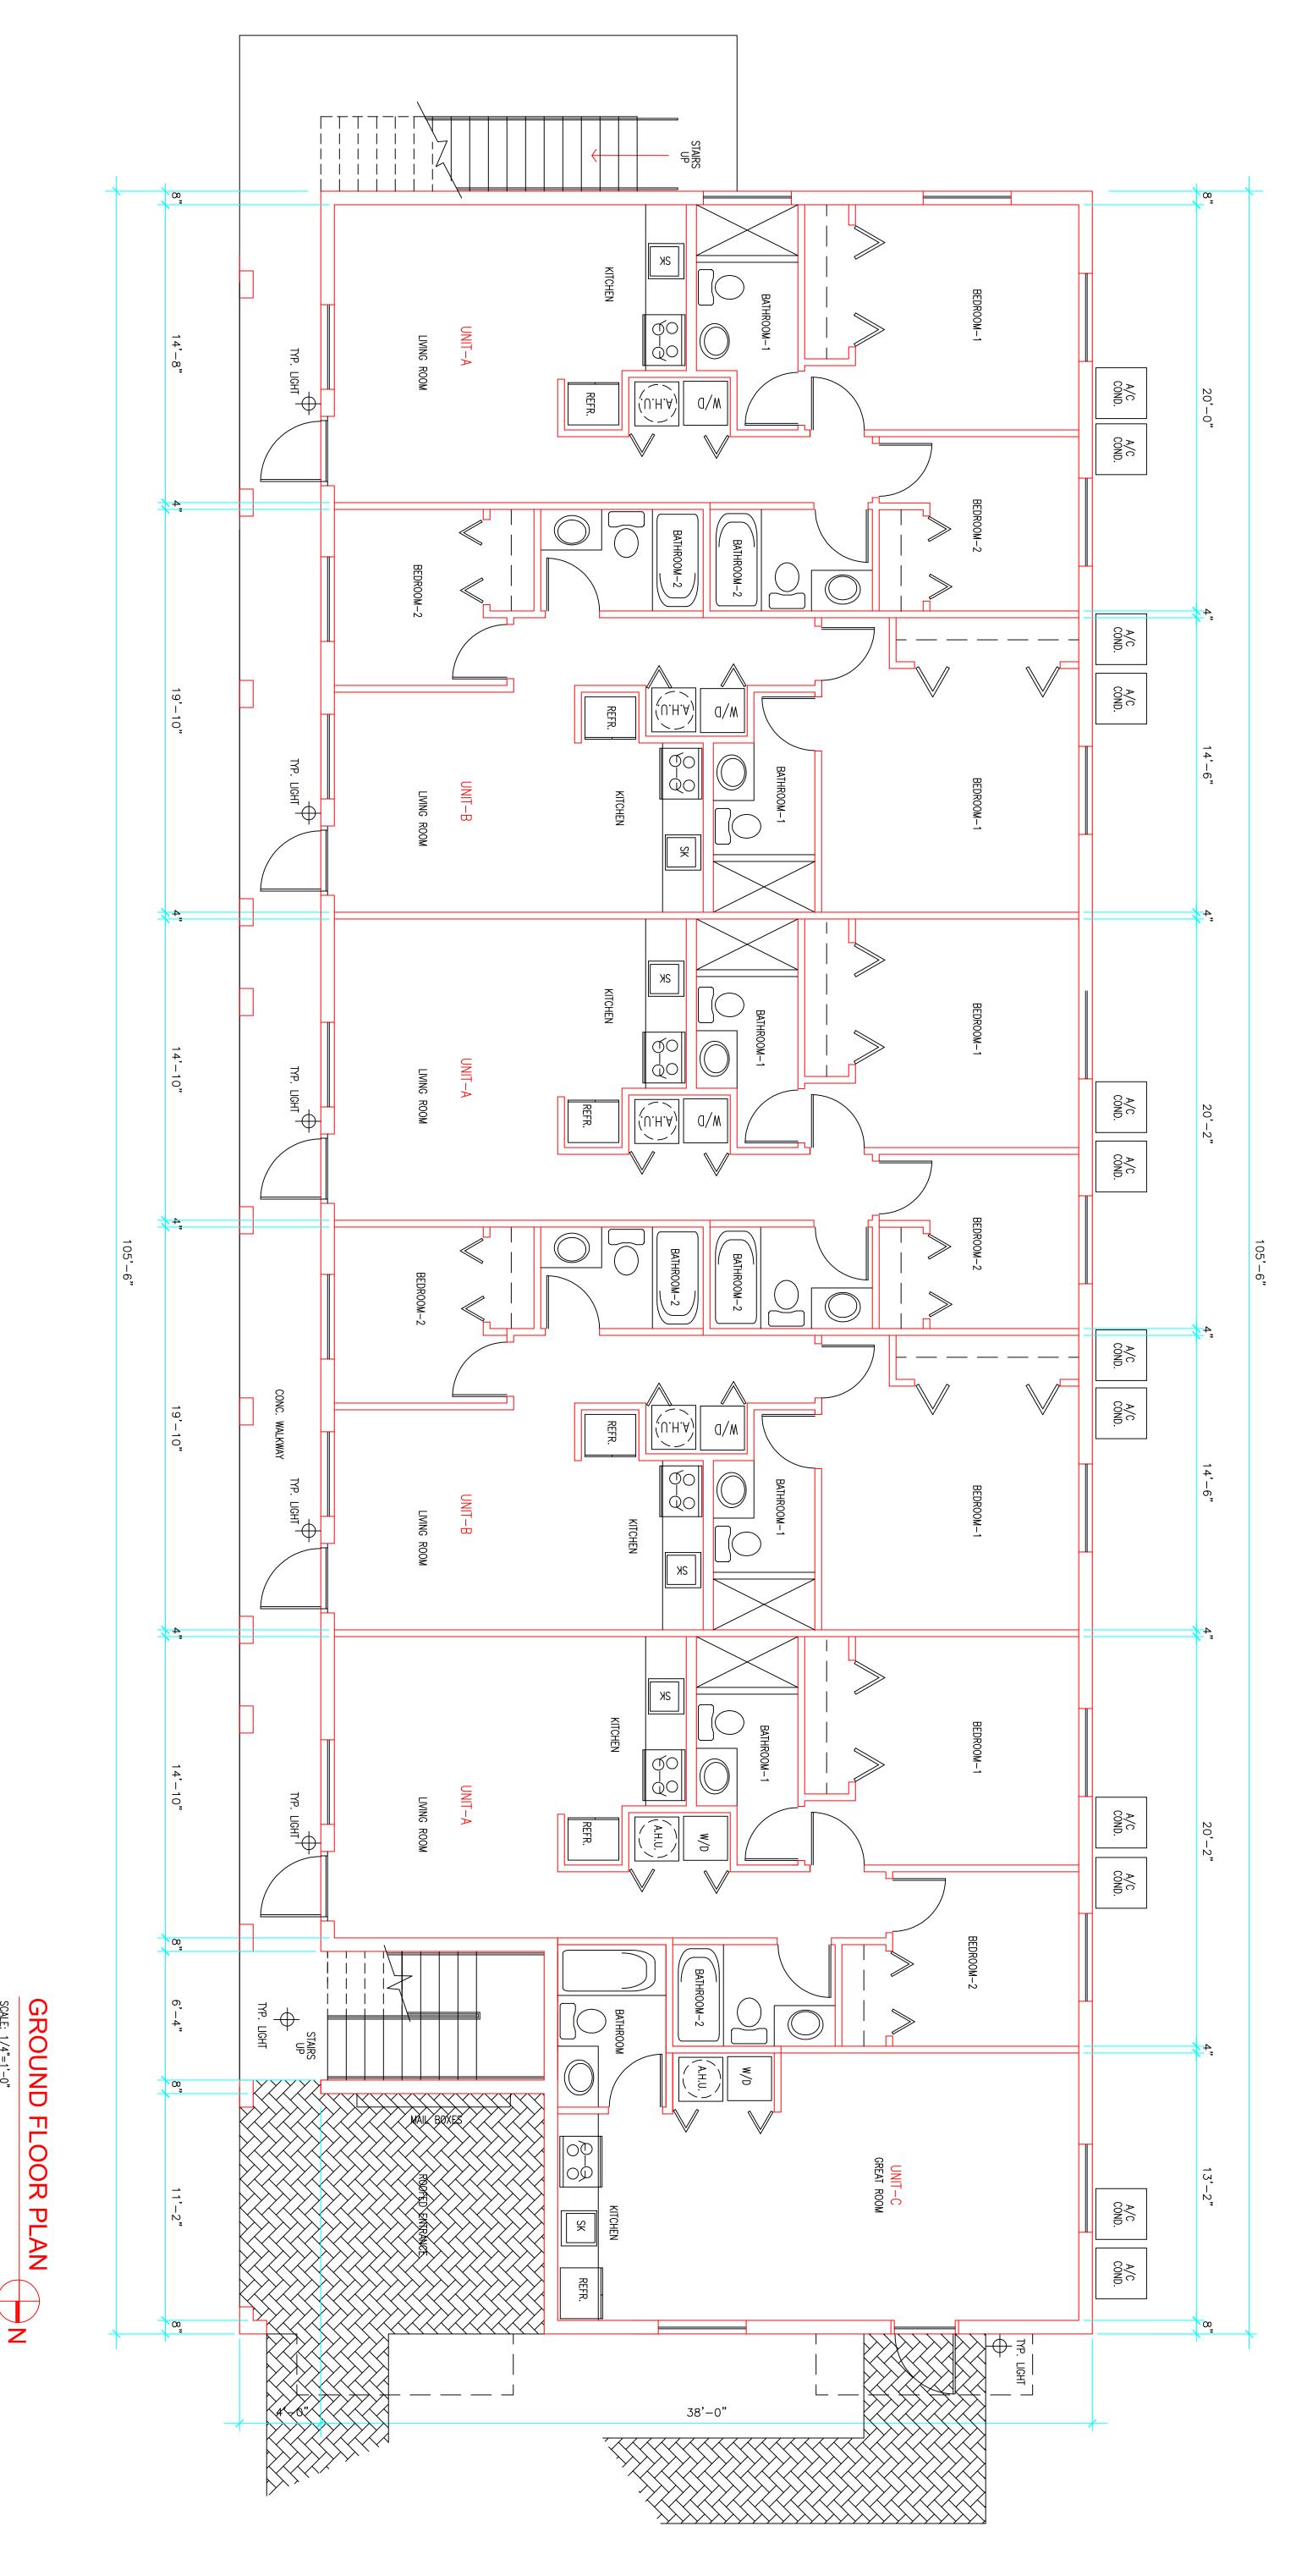

CHECKED

DRAWN

DATE 3-9-2018

COMM. NO. 17-198 5 CONTRACTOR SHALL FIELD VERIFY ALL DIMENSIONS, NOTES AND CONDITIONS PRIOR TO PROCEEDING WITH ANY WORK

Miguel de Diego
ARCHITECTP.A.
AA-26001641


700.00 SQ. FT. 680.00 SQ. FT. 400.00 SQ. FT.

1657 TYLER STREET SUITE 107 HOLLYWOOD, FLORIDA 33020 PH. (954) 926-3358 FAX (954) 926-2021

12 UNITS APARTMENTS 2324 JOHNSON STREET HOLLYWOOD, FLORIDA

NO.	DATE	REVISION

ALL DESIGN, DRAWINGS, REPORTS, SPECIFICATIONS, COMPUTER FILES, FIELD DATA, NOTES AND ANY OTHER DOCUMENTS PREPARED BY THE ARCHITECT AS INSTRUMENTS OF SERVICE SHALL REMAIN THE PROPERTY OF THE ARCHITECT AND IS
NOT TO BE REPRODUCED, COPIED OR
ALTERED IN WHOLE OR IN PART. IT IS ONLY
TO BE USED FOR THE PROJECT AND SITE
SPECIFICALLY IDENTIFIED HEREIN AND IS NOT TO BE USED ON ANY OTHER PROJECT. THE ARCHITECT SHALL RETAIN ALL COMMON LAW COPYRIGHT AND OTHER RESERVED RIGHTS THERETO.
WRITTEN DIMENSIONS SHALL HAVE
PRECEDENCE OVER SCALE.

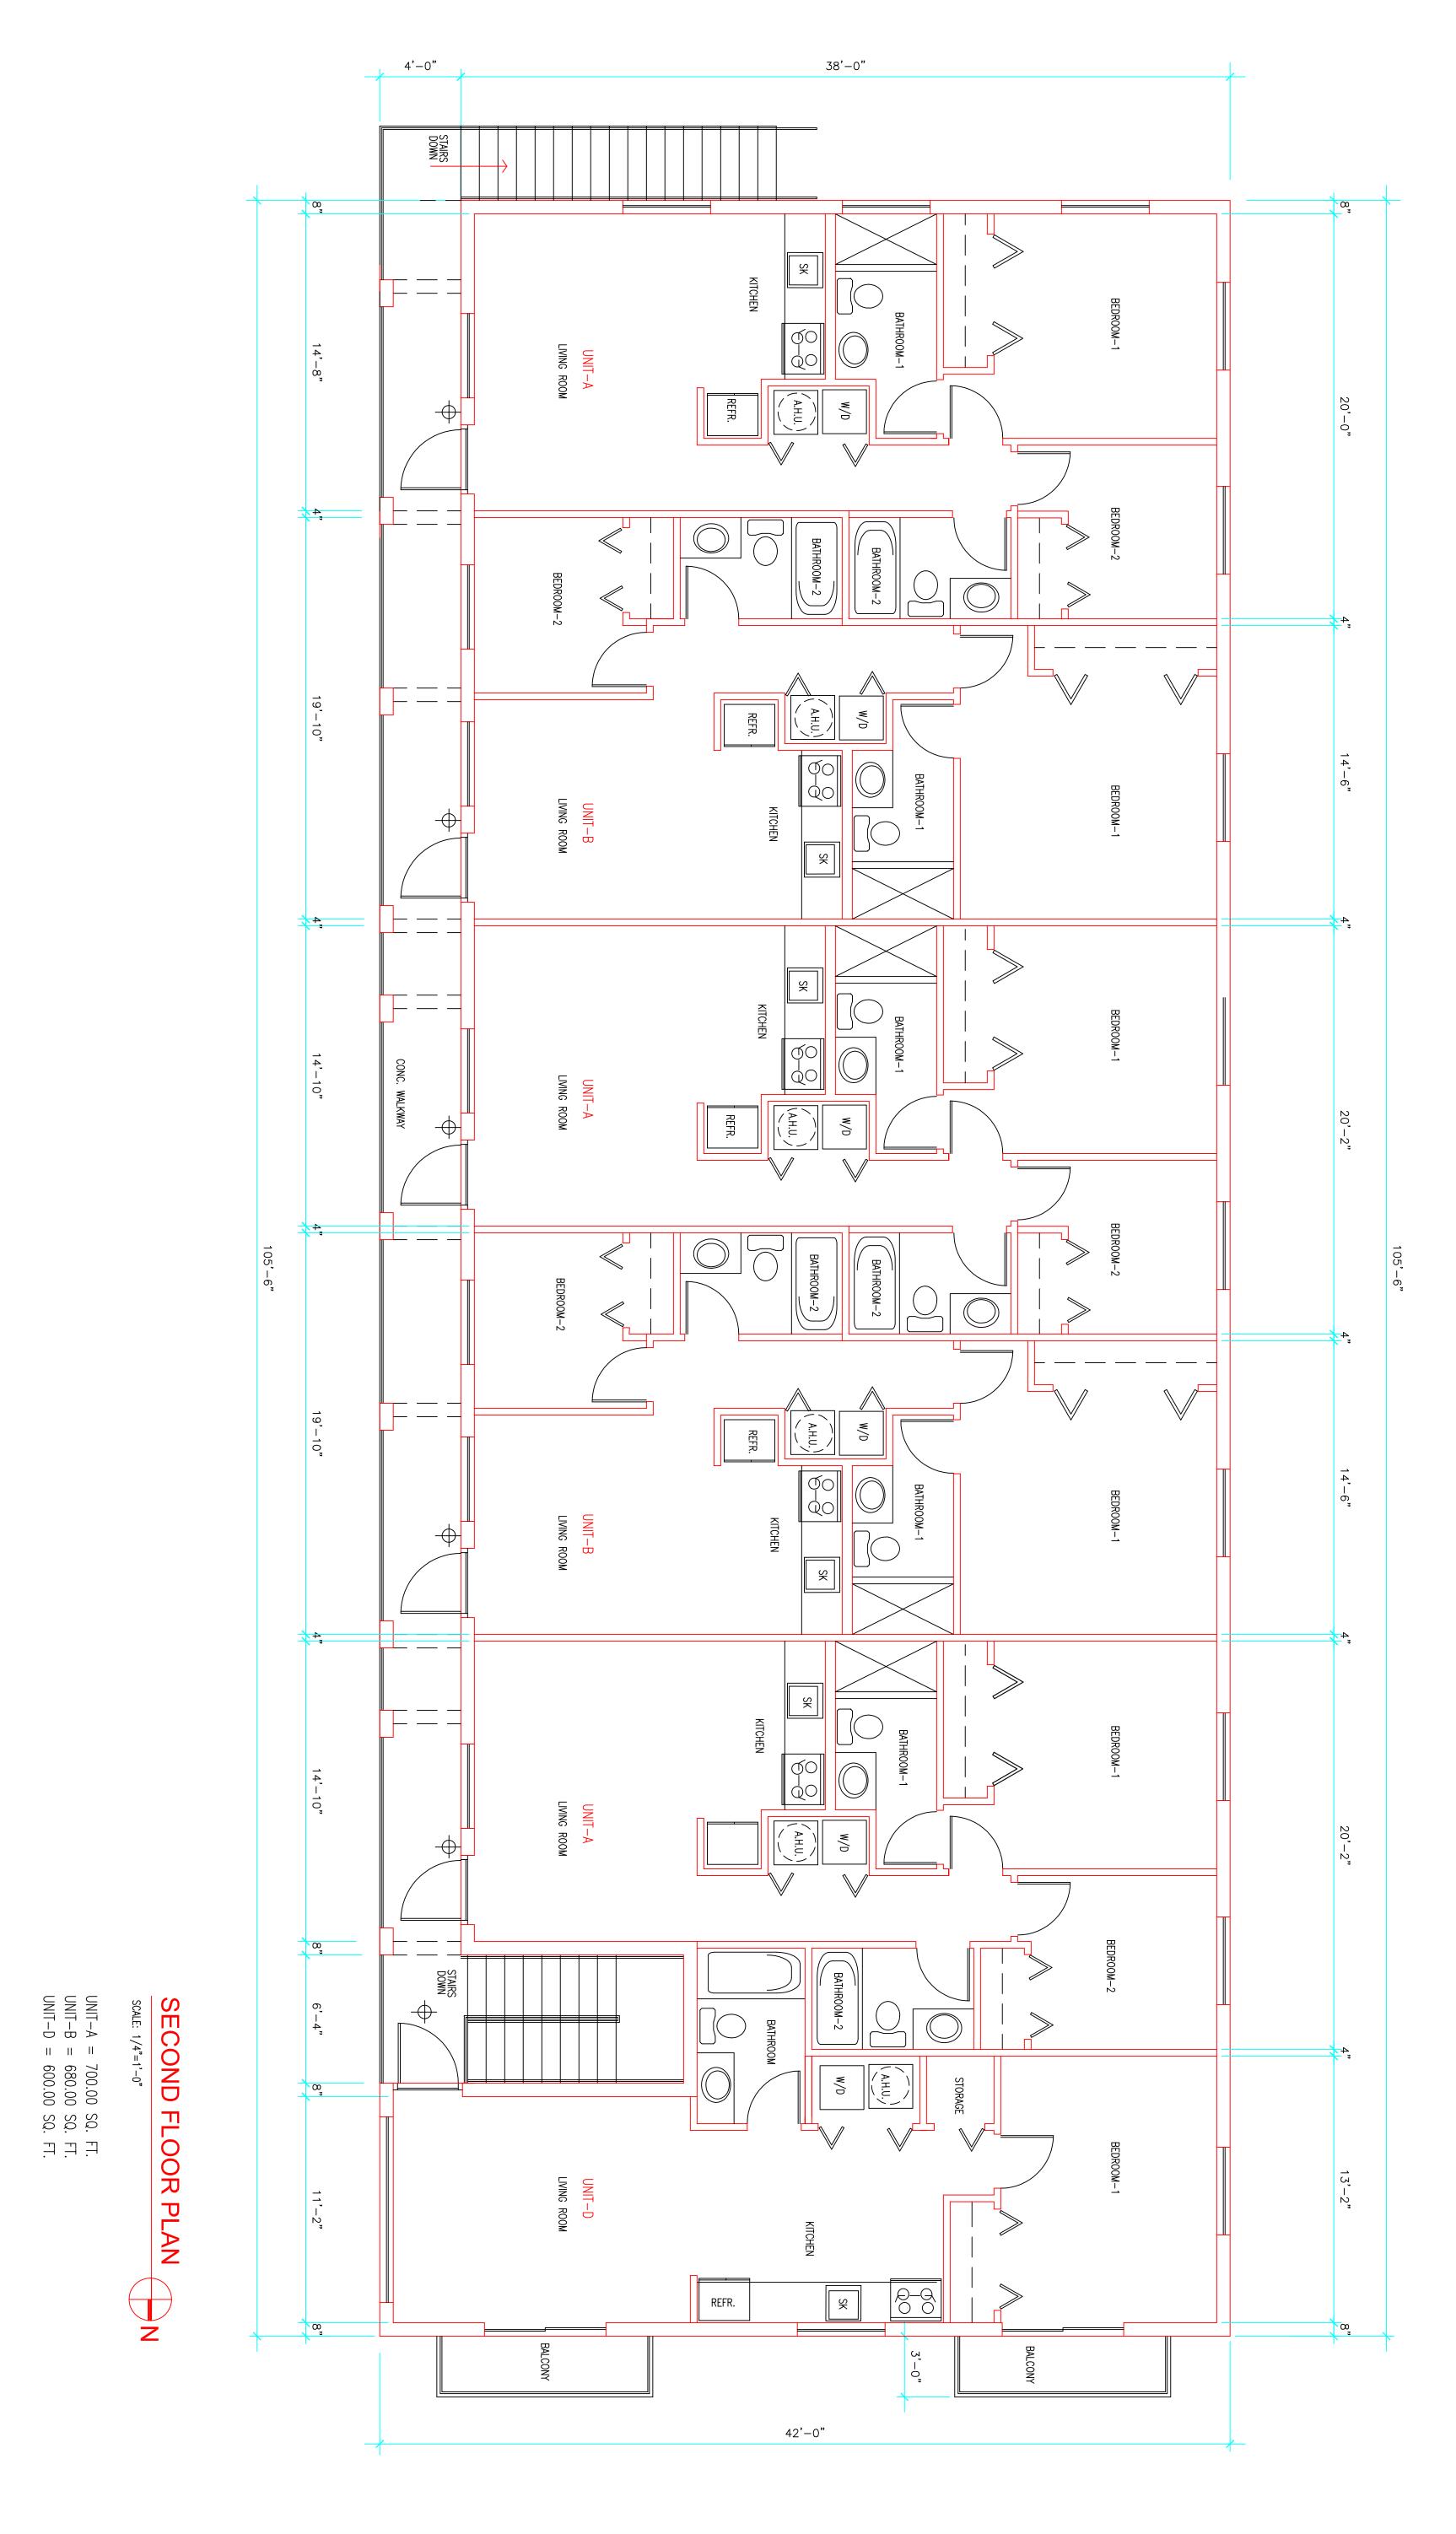




Miguel de Diego
ARCHITECTP.A.
AA-26001641 1657 TYLER STREET SUITE 107 HOLLYWOOD, FLORIDA 33020


PH. (954) 926-3358 FAX (954) 926-2021


12 UNITS APARTMENTS 2324 JOHNSON STREET HOLLYWOOD, FLORIDA


NO.	DATE	REVISION	A Si
			D Pi
			IN T
			N A
			T
			N T
			L

L DESIGN, DRAWINGS, REPORTS, ECIFICATIONS, COMPUTER FILES, FIELD TA, NOTES AND ANY OTHER DOCUMENTS ATA, NOTES AND ANY OTHER DOCUMENTS
REPARED BY THE ARCHITECT AS
INSTRUMENTS OF SERVICE SHALL REMAIN
HE PROPERTY OF THE ARCHITECT AND IS
OT TO BE REPRODUCED, COPIED OR
LTERED IN WHOLE OR IN PART. IT IS ONLY
O BE USED FOR THE PROJECT AND SITE
PECIFICALLY IDENTIFIED HEREIN AND IS
OUT TO BE USED ON ANY OTHER PROJECT OT TO BE USED ON ANY OTHER PROJECT.
HE ARCHITECT SHALL RETAIN ALL COMMON
AW COPYRIGHT AND OTHER RESERVED RIGHTS THERETO.
WRITTEN DIMENSIONS SHALL HAVE
PRECEDENCE OVER SCALE.

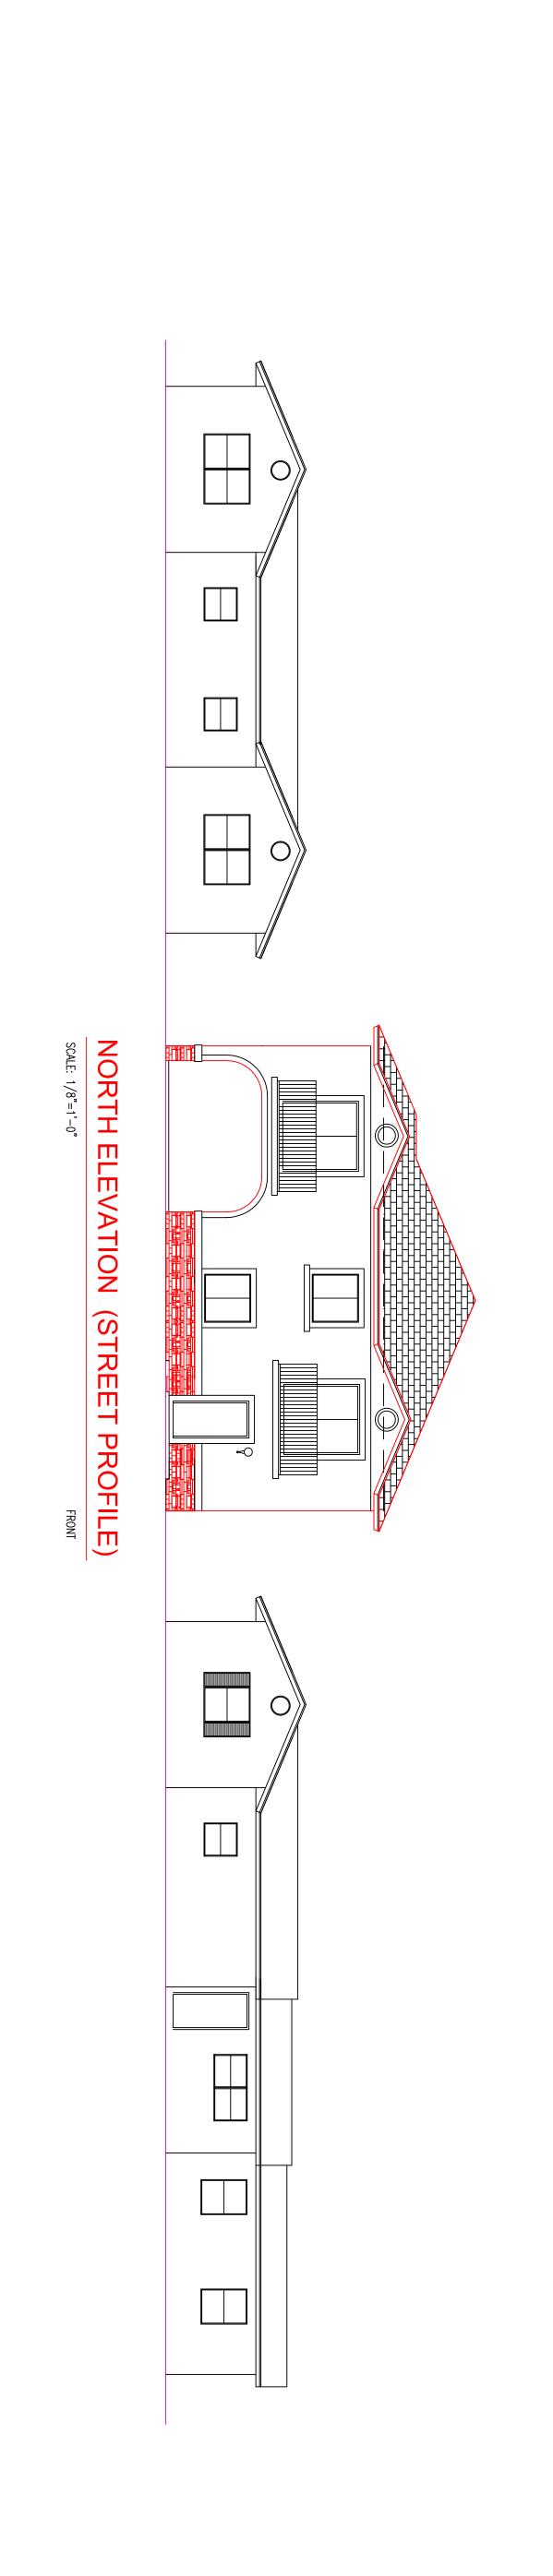

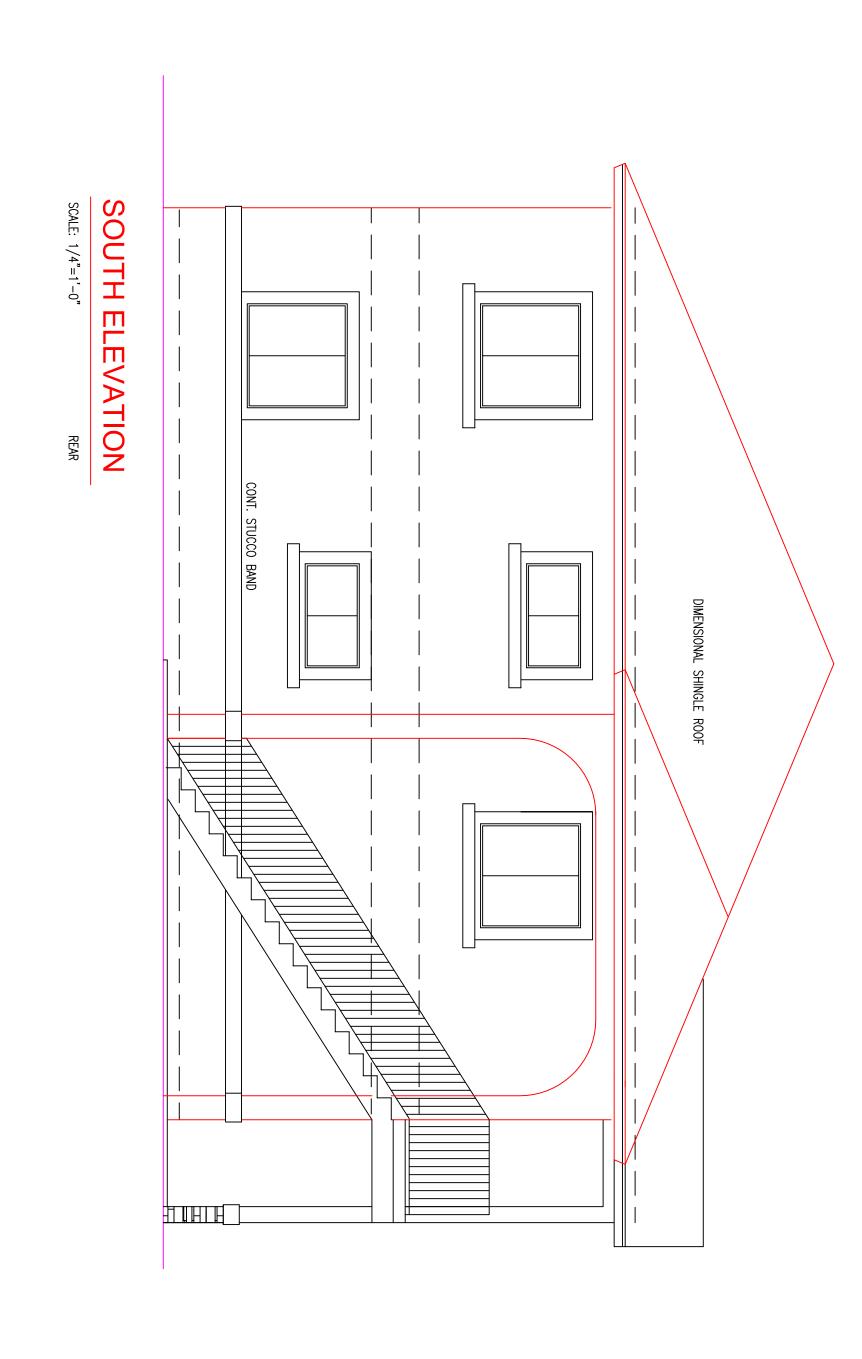

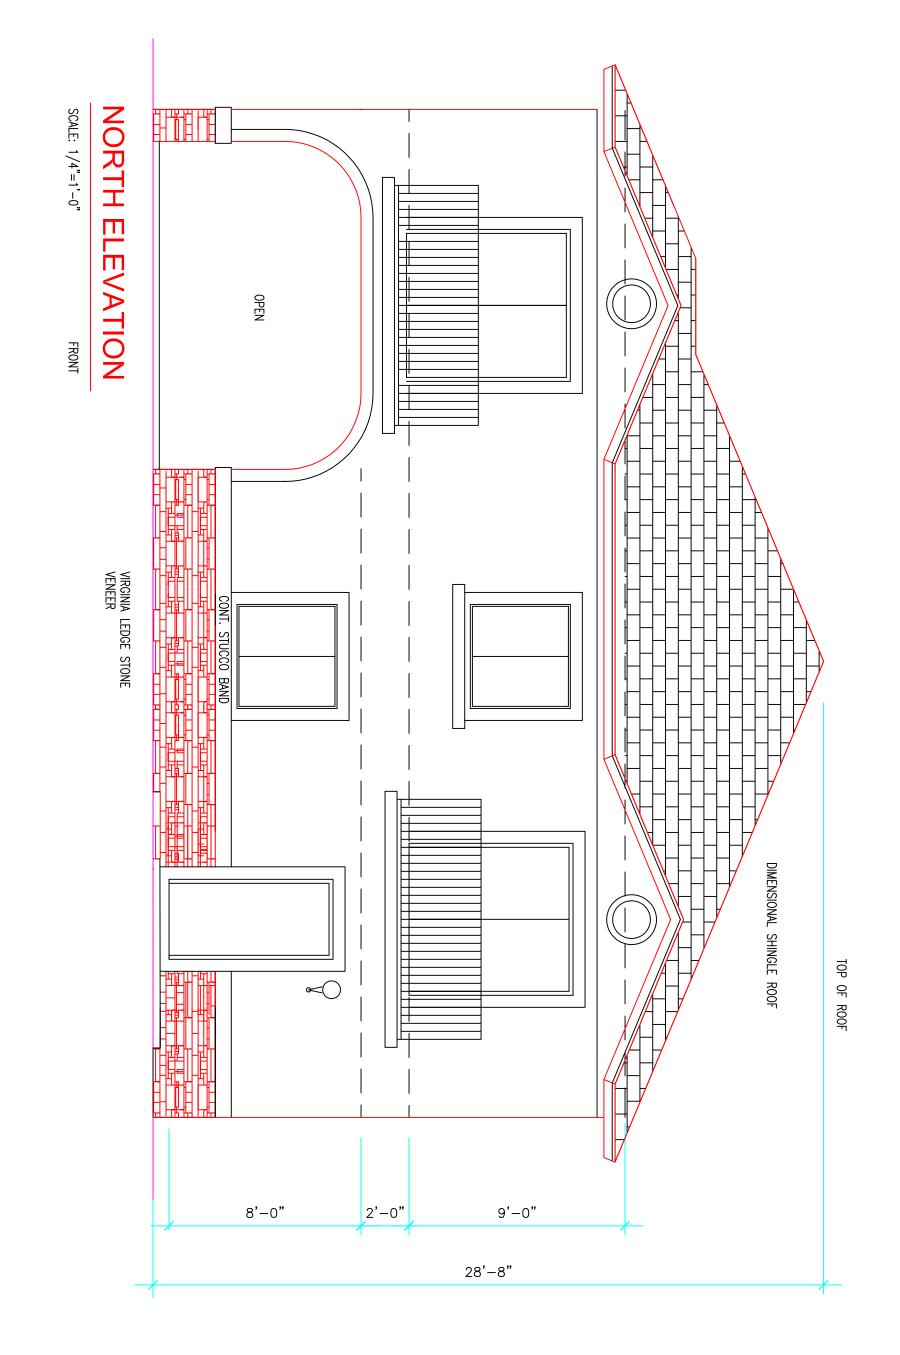

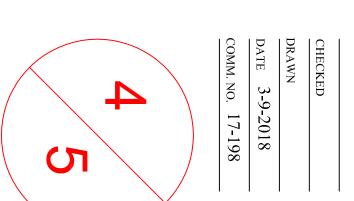



AA-26001641 1657 TYLER STREET SUITE 107 HOLLYWOOD, FLORIDA 33020 PH. (954) 926-3358 FAX (954) 926-2021


CONTRACTOR SHALL FIELD VERIFY ALL DIMENSIONS, NOTES AND CONDITIONS PRIOR TO PROCEEDING WITH ANY WORK

12 UNITS APARTMENTS
2324 JOHNSON STREET
HOLLYWOOD, FLORIDA

NO.	DATE	REVISION	

ALL DESIGN, DRAWINGS, REPORTS,
SPECIFICATIONS, COMPUTER FILES, FIELD
DATA, NOTES AND ANY OTHER DOCUMENTS
PREPARED BY THE ARCHITECT AS
INSTRUMENTS OF SERVICE SHALL REMAIN
THE PROPERTY OF THE ARCHITECT AND IS
NOT TO BE REPRODUCED, COPIED OR
ALTERED IN WHOLE OR IN PART. IT IS ONLY
TO BE USED FOR THE PROJECT AND SITE
SPECIFICALLY IDENTIFIED HEREIN AND IS
NOT TO BE USED ON ANY OTHER PROJECT.
THE ARCHITECT SHALL RETAIN ALL COMMON
LAW COPYRIGHT AND OTHER RESERVED
RIGHTS THERETO.
WRITTEN DIMENSIONS SHALL HAVE
PRECEDENCE OVER SCALE.



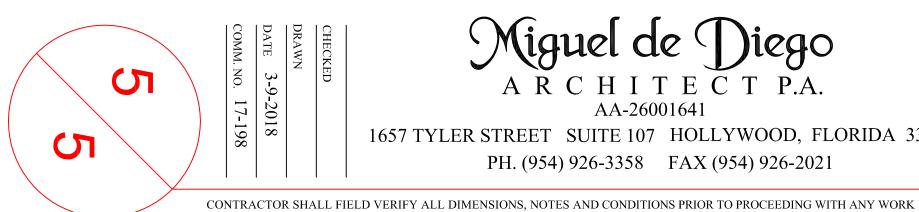

Miguel de Diego
ARCHITECTP.A.
AA-26001641

1657 TYLER STREET SUITE 107 HOLLYWOOD, FLORIDA 33020 PH. (954) 926-3358 FAX (954) 926-2021


12 UNITS APARTMENTS
2324 JOHNSON STREET
HOLLYWOOD, FLORIDA


NO.	DATE	REVISION	SP
			D/ PF
			IN TH
			NO AI
			TO
			SP NO TH
			LA
			RI

ALL DESIGN, DRAWINGS, REPORTS, SPECIFICATIONS, COMPUTER FILES, FIELD DATA, NOTES AND ANY OTHER DOCUMENTS DATA, NOTES AND ANY OTHER DOCUMENTS
PREPARED BY THE ARCHITECT AS
INSTRUMENTS OF SERVICE SHALL REMAIN
THE PROPERTY OF THE ARCHITECT AND IS
NOT TO BE REPRODUCED, COPIED OR
ALTERED IN WHOLE OR IN PART. IT IS ONLY
TO BE USED FOR THE PROJECT AND SITE
SPECIFICALLY IDENTIFIED HEREIN AND IS
NOT TO BE USED ON ANY OTHER PROJECT SPECIFICALLY IDENTIFIED HEREIN AND IS
NOT TO BE USED ON ANY OTHER PROJECT.
THE ARCHITECT SHALL RETAIN ALL COMMON
LAW COPYRIGHT AND OTHER RESERVED
RIGHTS THERETO.
WRITTEN DIMENSIONS SHALL HAVE
PRECEDENCE OVER SCALE.





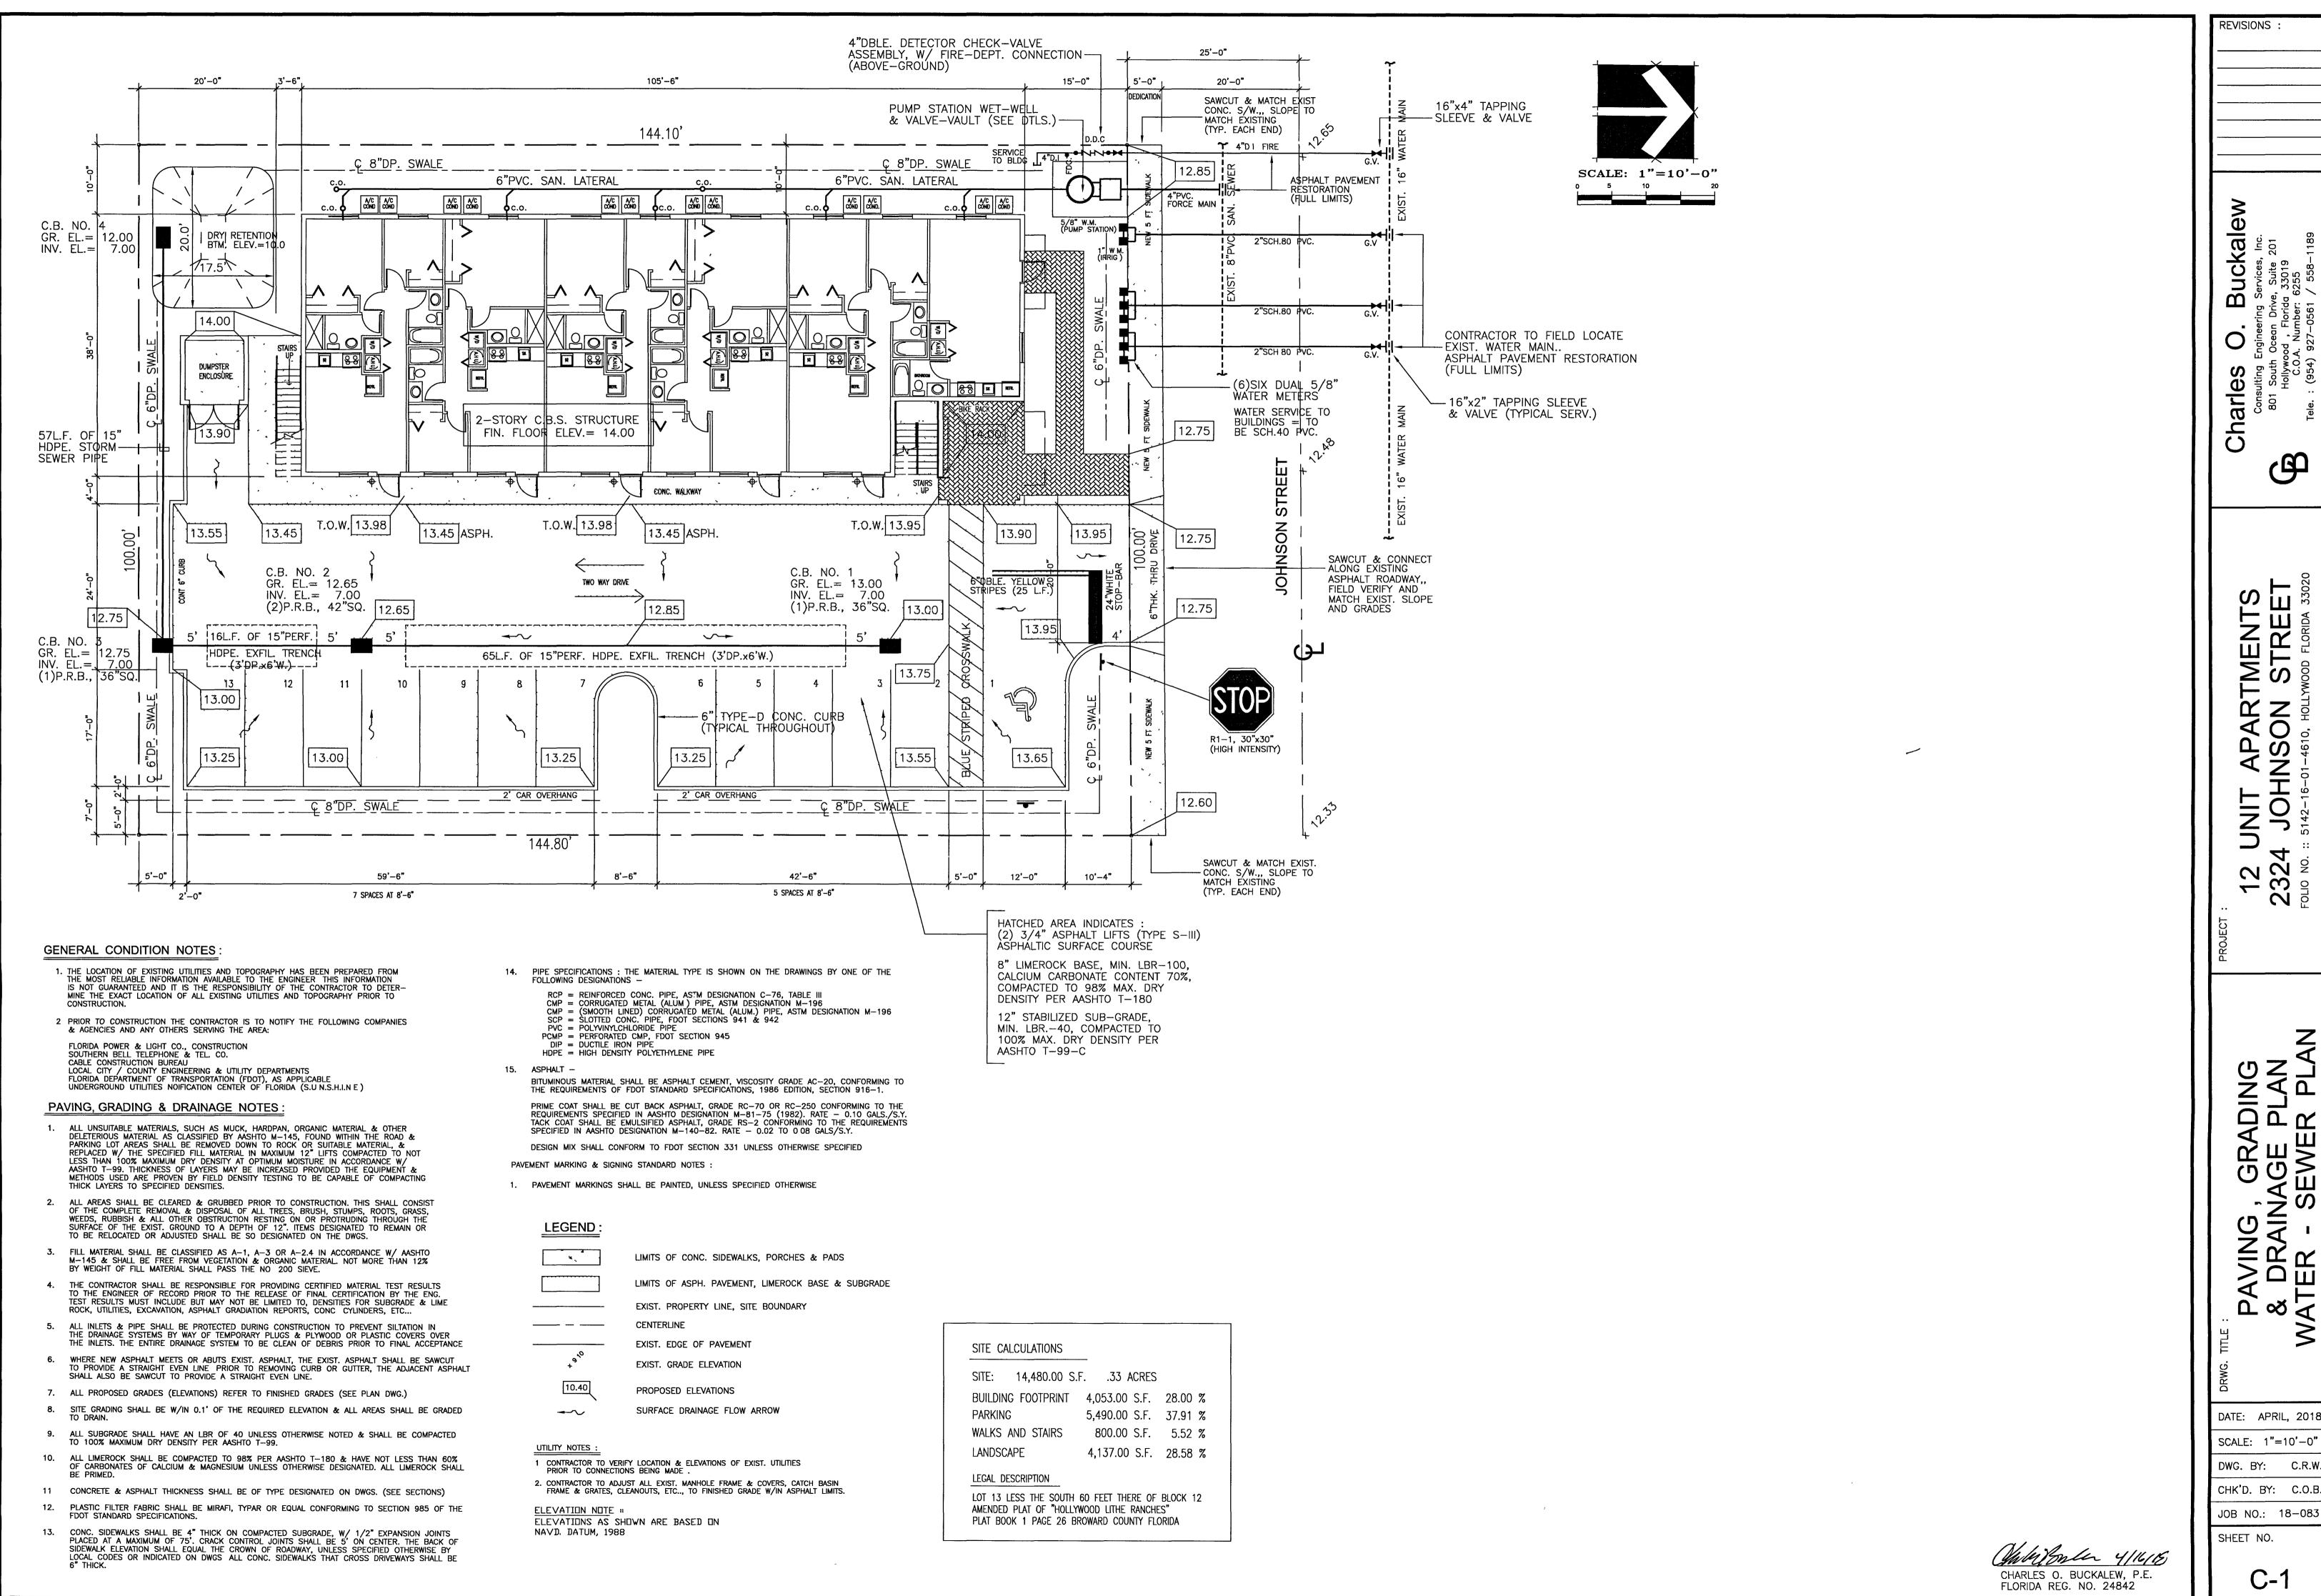

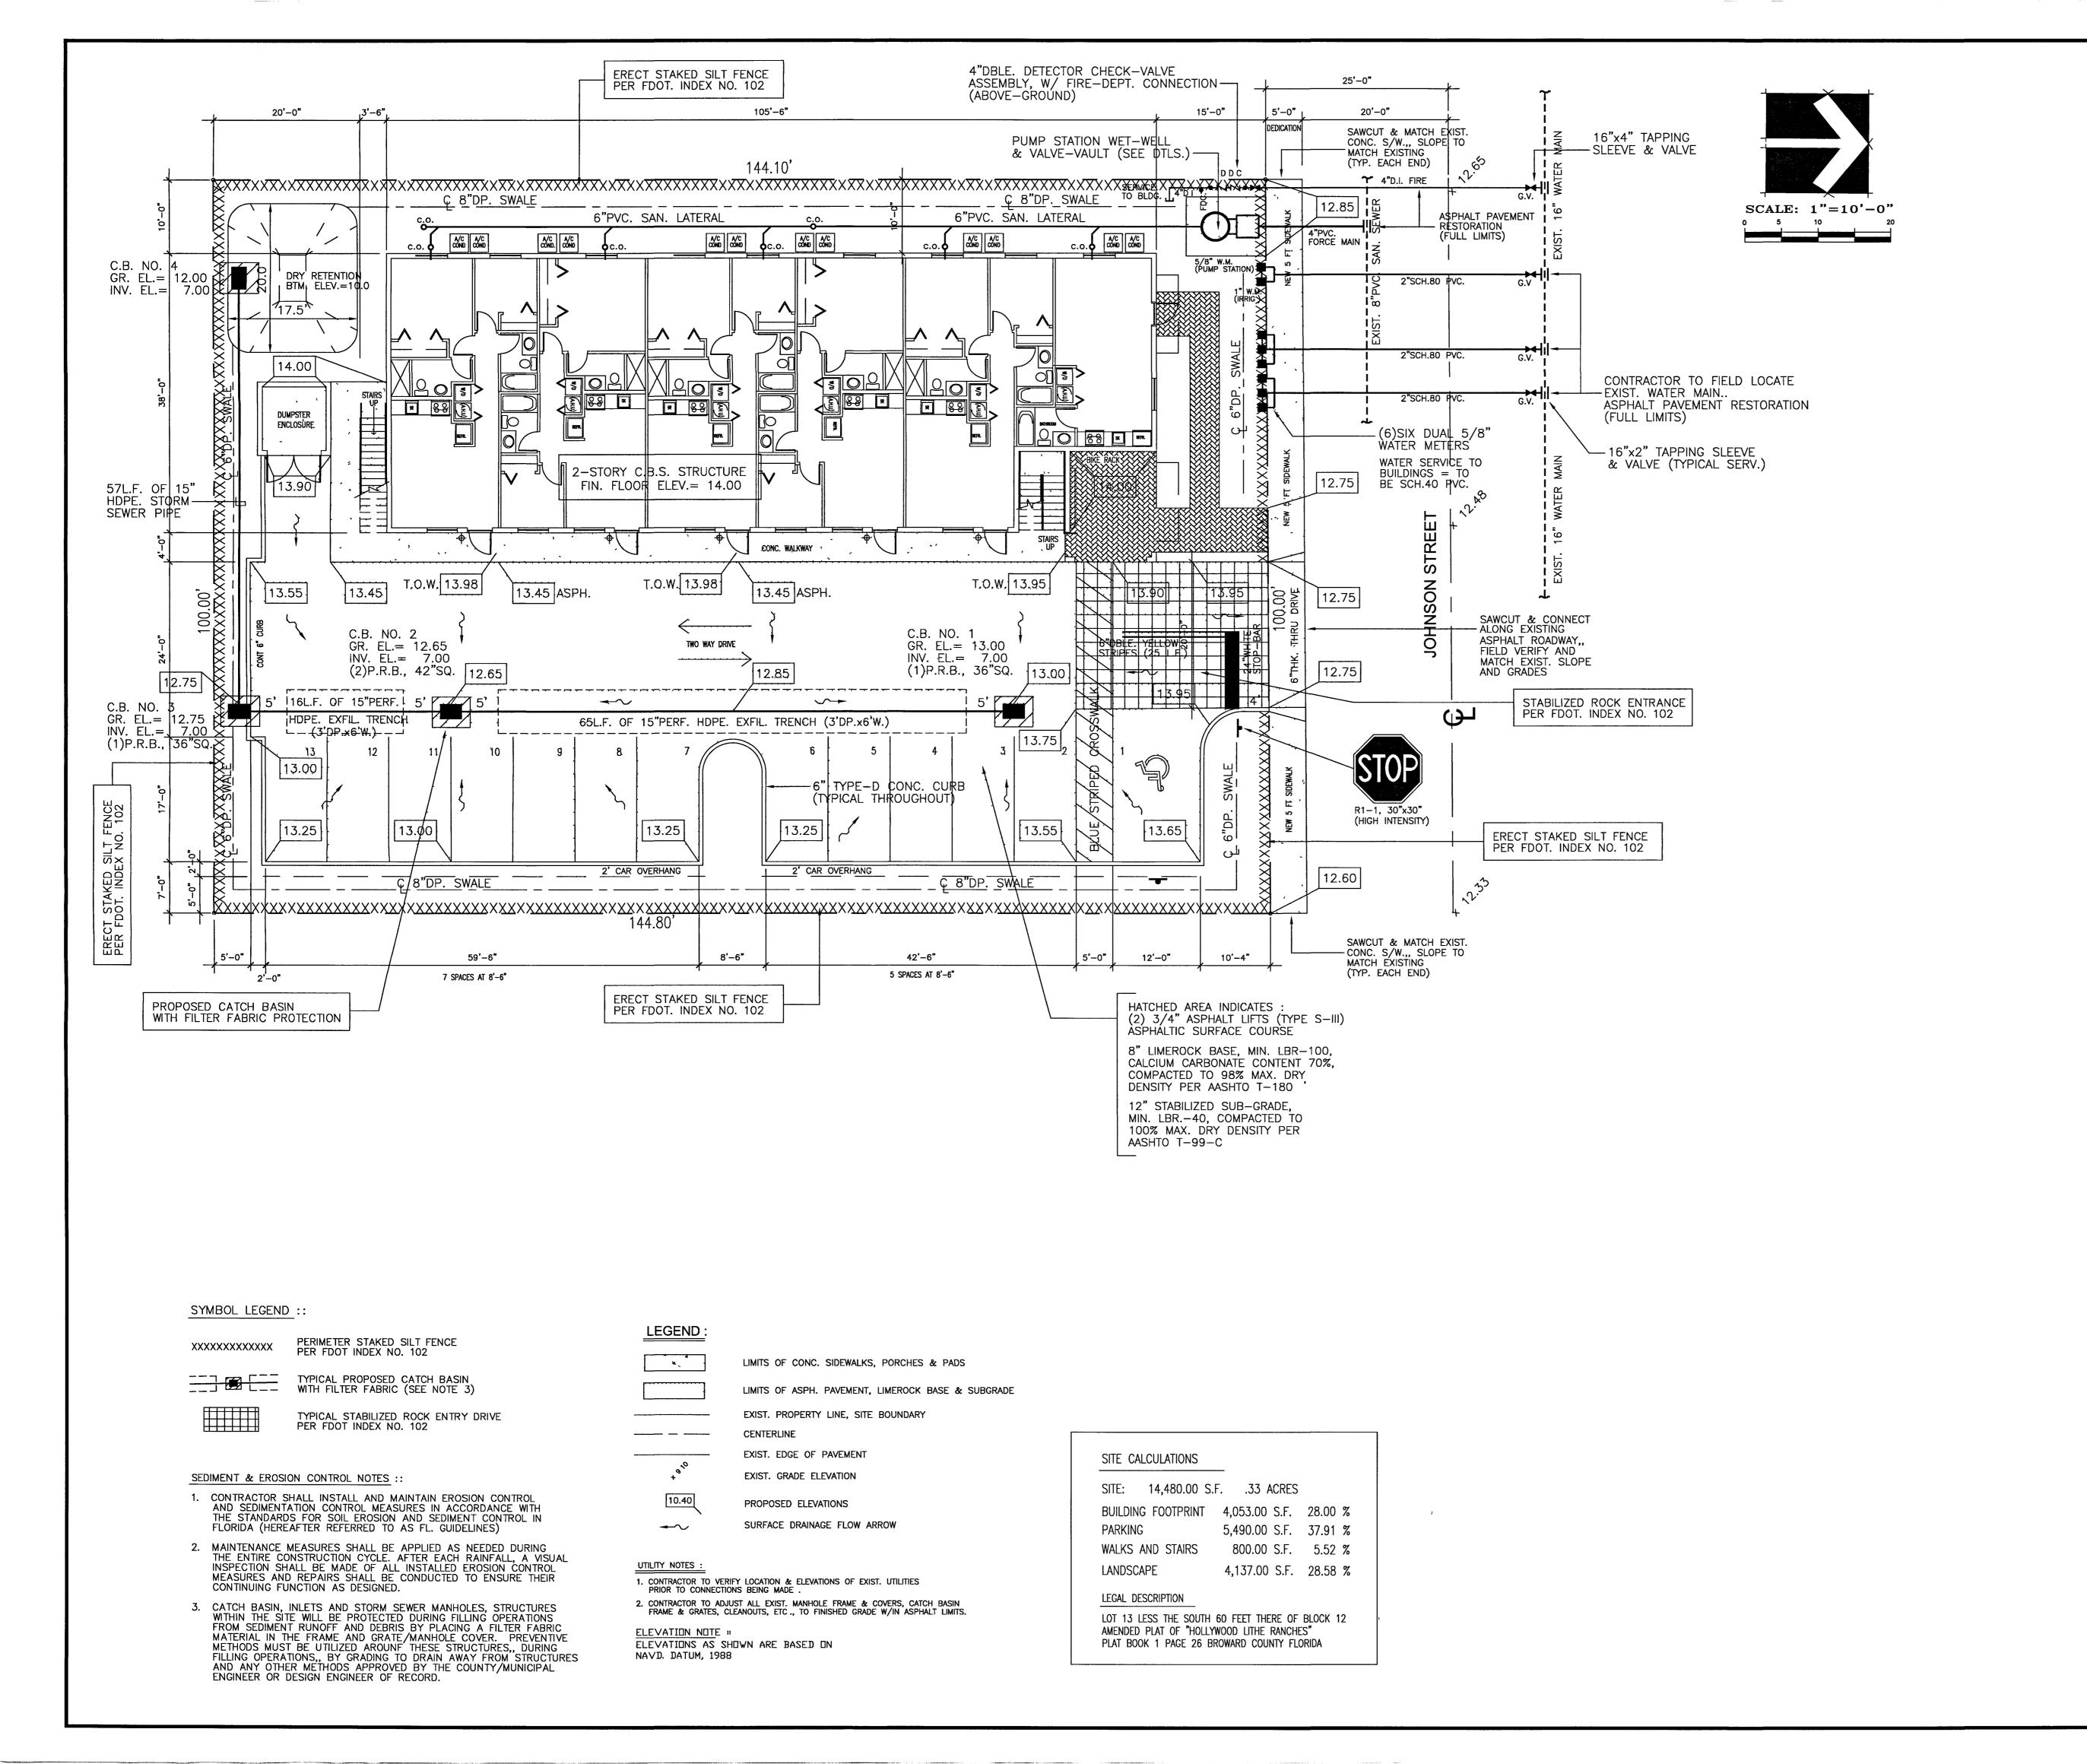

Charles O. Buckalew
Consulting Engineering Services, Inc.

2324 JOHNSON STREET
FOLIO NO. :: 5142-16-01-4610, HOLLYWOOD FLORIDA 33020
Tele. : (954) 927-0561 / 558-1189

REVISIONS:

EROSION CONTROL PLA

DATE: APRIL, 2018

SCALE: 1"=10'-0"


DWG. BY: C.R.W.

CHK'D. BY: C.O.B.
JOB NO.: 18-083

SHEET NO.

Chall Baker 4/16,18

CHARLES O. BUCKALEW, P.E. FLORIDA REG. NO. 24842

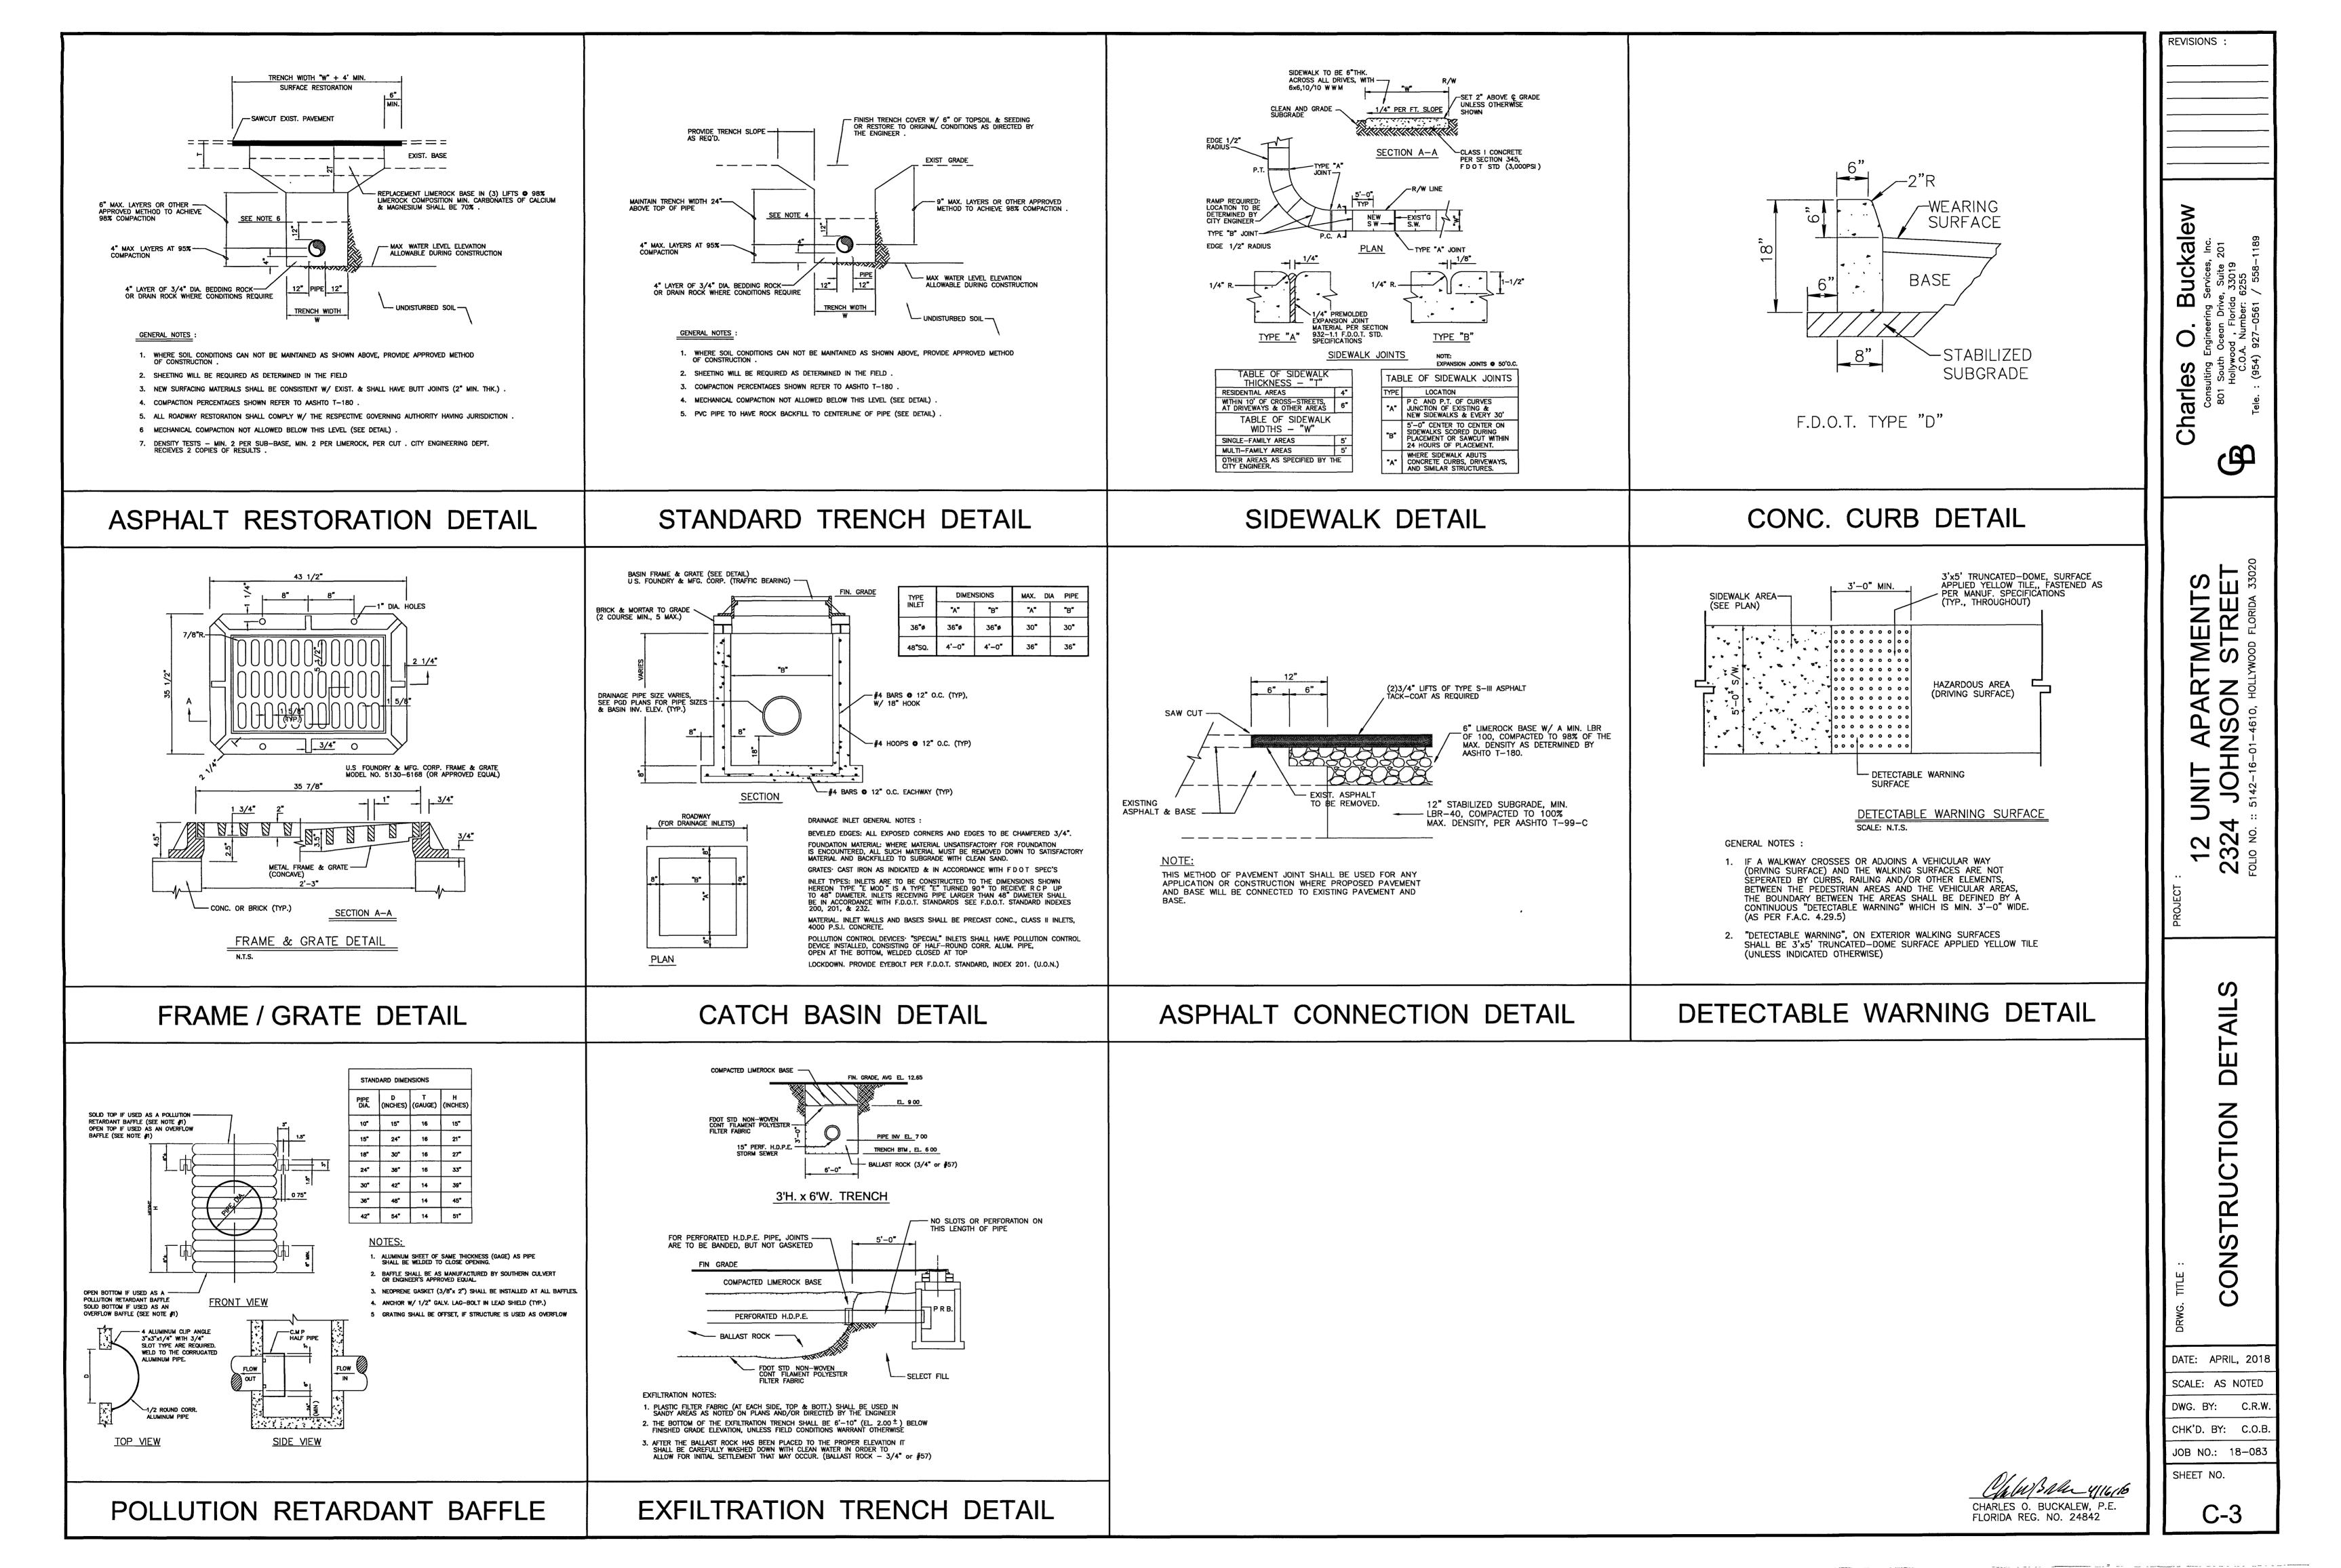

WATER NOTES:

- NEW OR RELOCATED UNDERGROUND WATER MAINS INCLUDED IN THIS PROJECT THAT WILL CROSS ANY EXISTING OR PROPOSED GRAVITY OR VACUUM-TYPE SANITARY SEWER OR STORM SEWER WILL BE LAID SO THE OUTSIDE OF THE WATER MAIN IS AT LEAST SIX INCHES ABOVE THE OTHER PIPELINE OR AT LEAST 12 INCHES BELOW THE OTHER PIPELINE
- NEW OR RELOCATED UNDERGROUND WATER MAINS INCLUDED IN THIS PROJECT THAT WILL CROSS ANY EXISTING OR PROPOSED PRESSURE-TYPE SANITARY SEWER, WASTEWATER OR STORM WATER FORCE MAIN, OR PIPELINE CONVEYING RECLAIMED WATER WILL BE LAID SO THE OUTSIDE OF THE WATER MAIN IS AT LEAST 12 INCHES ABOVE OR BELOW THE OTHER PIPELINE [FAC 62-555 314(2), EXCEPTIONS ALLOWED UNDER FAC 62-555 314(5)]
- AT ALL UTILITY CROSSINGS DESCRIBED ABOVE, ONE FULL LENGTH OF WATER MAIN PIPE WILL BE CENTERED ABOVE OR BELOW THE OTHER PIPELINE SO THE WATER MAIN JOINTS WILL BE AS FAR AS POSSIBLE FROM THE OTHER PIPELINE, OR THE PIPES WILL BE ARRANGED SO THAT ALL WATER MAIN JOINTS ARE AT LEAST THREE FEET FROM ALL JOINTS IN VACUUM-TYPE SANITARY SEWERS, STORM SEWERS, STORM WATER FORCE MAINS, OR PIPELINES CONVEYING RECLAIMED WATER REGULATED UNDER PART III OF CHAPTER 62-610, F.A.C., AND AT LEAST SIX FEET FROM ALL JOINTS IN GRAVITY OR PRESSURE-TYPE SANITARY SEWERS, WASTEWATER FORCE MAINS, OR PIPELINES CONVEYING RECLAIMED WATER NOT REGULATED UNDER PART III OF CHAPTER 62-610, F.A.C. [FAC 62-555 314(2), EXCEPTIONS ALLOWED UNDER FAC 62-555 314(5)]
- 4 NEW UNDERGROUND WATER MAINS INCLUDED IN THIS PROJECT TO BE DUCTILE IRON PIPE (D I.P) WHEN CROSSING BELOW SANITARY SEWER MAINS
- POLYETHYLENE ENCASEMENT MATERIAL SHALL BE USED TO ENCASE ALL BURIED DUCTILE IRON PIPE, FITTINGS, VALVES, RODS, AND APPURTENANCES IN ACCORDANCE WITH AWWA C105, METHOD A THE POLYETHYLENE TUBING SHALL BE CUT TWO FEET LONGER THAN THE PIPE SECTION AND SHALL OVERLAP THE ENDS OF THE PIPE BY ONE FOOT THE POLYETHYLENE TUBING SHALL BE GATHERED AND LAPPED TO PROVIDE A SNUG FIT AND SHALL BE SECURED AT QUARTER POINTS WITH POLYETHYLENE TAPE EACH END OF THE POLYETHYLENE TUBING SHALL BE SECURED WITH A WRAP OF POLYETHYLENE TAPE
- 6. THE POLYETHYLENE TUBING SHALL PREVENT CONTACT BETWEEN THE PIPE AND BEDDING MATERIAL, BUT IS NOT INTENDED TO BE A COMPLETELY AIRTIGHT AND WATERTIGHT ENCLOSURE DAMAGED POLYETHYLENE TUBING SHALL BE REPAIRED IN A WORKMANLIKE MANNER USING POLYETHYLENE TAPE, OR THE DAMAGED SECTION SHALL BE REPLACED POLY WRAP WILL NOT BE PAID FOR AS A SEPARATE BID ITEM IT SHALL BE CONSIDERED TO BE A PART OF THE PRICE BID FOR WATER MAINS.
- 7. FIRE HYDRANT BARRELS SHALL BE ENCASED IN POLY WRAP UP TO THE GROUND SURFACE AND THE WEEP HOLES SHALL NOT BE COVERED BY THE POLY WRAP
- GATE VALVES FOR USE WITH PIPE LESS THAN THREE INCHES (3") IN DIAMETER SHALL BE RATED FOR TWO HUNDRED (200) PSI WORKING PRESSURE, NON-SHOCK, BLOCK PATTERN, SCREWED BONNET, NON-RISING STEM, BRASS BODY, AND SOLID WEDGE THEY SHALL BE STANDARD THREADED FOR PVC PIPE AND HAVE A MALLEABLE IRON HANDWHEEL. GATE VALVES LESS THAN THREE INCHES (3") IN DIAMETER SHALL BE NIBCO-SCOTT T-113 LF WITH NO SUBSTITUTIONS ALLOWED LARGE GATE VALVES OVER 3" THRU 16" IN DIAMETER, MUST BE RESILIENT SEAT AND BIDIRECTIONAL FLOW ONLY MANUFACTURERS MUELLER, AMERICAN DARLING, AVK, OR CITY APPROVED EQUAL. VALVES FOR SPECIAL APPLICATION WILL REQUIRE CITY UTILITY APPROVAL.

TO HOSTINGOS TEST	ISSUED:	03/01/1994	DEPARTMENT OF PUBLIC UTILITIES STANDARD DETAIL	REVISED 06/08/2014
CAN CONT.	DRAWN	EAM	WATER SYSTEM NOTES	DRAWING NO
	APPROVE) XXX	WATER STSTEIN NOTES	W-01

WATER NOTES CONTINUED:

- 9 VALVE BOXES AND COVERS FOR ALL SIZE VALVES SHALL BE OF CAST IRON CONSTRUCTION AND ADJUSTABLE SCREW-ON TYPE THE LID SHALL HAVE CAST IN THE METAL THE WORD "WATER" FOR THE WATER LINES ALL VALVE BOXES SHALL BE SIX INCH (6") NOMINAL DIAMETER AND SHALL BE SUITABLE FOR DEPTHS OF THE PARTICULAR VALVE THE STEM OF THE BURIED VALVE SHALL BE WITHIN TWENTY-FOUR INCHES (24") OF THE FINISHED GRADE UNLESS OTHERWISE APPROVED BY THE CITY VALVE BOXES SHALL BE TYLER BRAND, NO SUBSTITUTES.
- 10 FIRE HYDRANTS PRESENTLY CITY OF HOLLYWOOD UTILITIES SPECIFICATIONS ALLOW ONLY MANUFACTURERS MUELLER MODEL SUPER CENTURION 200 5½" SIZE REFERENCE CATALOG NO A-423 AND AMERICAN DARLING MODEL B-84-B 5½" SIZE ANY DEVIATION FROM REQUIRED SPECIFICATIONS WILL REQUIRE CITY OF HOLLYWOOD UTILITIES APPROVAL.
- 11 ALL WATER MAIN INSTALLATIONS SHALL COMPLY WITH THE COLOR CODING REQUIREMENTS OF CHAPTER 62-555 320 F A C.
- 12 ALL PVC PIPE SHALL CONFORM TO THE REQUIREMENTS OF ANSI/AWWA C900 LATEST REVISION AND CLASS DR 18 ALL DIP WATER MAINS SHALL BE DUCTILE IRON PRESSURE CLASS 350, WITH WALL THICKNESS COMPLYING WITH CLASS 52 ALL DUCTILE IRON PIPE SHALL CONFORM TO THE REQUIREMENTS OF ANSI/AWWA C151/A21 51-02 AND BE CEMENT LINED AND SEAL COATED PER ANSI/AWWA C104/A21 4-03
- 13. FITTINGS SHALL BE DUCTILE IRON, MEETING ANSI/AWWA C153/A21 53-00 SPECIFICATIONS, WITH 350 PSI MINIMUM WORKING PRESSURE FITTINGS MUST BE CEMENT LINED AND SEAL COATED PER ANSI/AWWA C104/A21 4-03 ALL DUCTILE IRON PIPE AND FITTINGS MUST BE MANUFACTURED IN THE UNITED STATES OF AMERICA.
- 14 ALL DUCTILE IRON PIPE TO BE MECHANICAL JOINTS, WRAPPED IN POLY ADEQUATE PROTECTIVE MEASURES AGAINST CORROSION SHALL BE USED AS DETERMINED BY DESIGN
- 15 GATE VALVES 4" AND LARGER SHALL BE RESILIENT SEAT AND SHALL MEET ANSI/AWWA C-509-01 SPECIFICATIONS, LATEST REVISION. VALVES MUST BE MUELLER (O A.E.) VALVE BOXES SHALL BE TYLER UNION, CONTROL/GATE VALVES 3" AND SMALLER SHALL BE NIBCO T-133 LF NO SUBSTITUTIONS
- 16. PAVEMENT RESTORATION SHALL BE CARRIED OUT IN ACCORDANCE WITH THE REQUIREMENTS OF THE CITY
- 17 ALL TRENCHING, PIPE LAYING, BACKFILL, PRESSURE TESTING, AND DISINFECTING MUST COMPLY WITH THE CITY OF HOLLYWOOD SPECIFICATIONS
- 18 THE MINIMUM DEPTH OF COVER OVER WATER MAINS IS 30" (DIP) OR 36" (PVC)
- 19 MINIMUM CLEARANCE BETWEEN STORM STRUCTURES AND WATER MAINS SHALL BE 2', AND MAXIMUM DEFLECTION PER EACH JOINT SHALL BE 50% OF MANUFACTURES RECOMMENDATION (MAXIMUM) WHERE DEFLECTION IS REQUIRED
- 20 TAPPING SLEEVES SHALL BE MUELLER H-615 (O.A.E.) TAPPING VALVES 4" AND LARGER SHALL BE RESILIENT WEDGE TYPE MEETING ANSI/AWWA C509-01 ALL TAPPING VALVES SHALL HAVE A CAST-IN ALIGNMENT RING AND BE CAPABLE OF ACCEPTING A FULL-SIZE CUTTER
- 21 CONTRACTOR SHALL BE RESPONSIBLE FOR IDENTIFYING CONFLICTS WITH WATER MAINS PLACED AT MINIMUM COVER IN CASE OF CONFLICT, WATER MAIN SHALL BE LOWERED TO PASS UNDER CONFLICTS WITH 18" MINIMUM SEPARATION NO ADDITIONAL PAYMENT SHALL BE DUE TO CONTRACTOR FOR LOWERING THE MAIN OR THE ADDITIONAL FITTINGS USED THEREON

HOLEL HOOD TEN	ISSUED	03/01/1994	DEPARTMENT OF PUBLIC UTILITIES STANDARD DETAIL	REVISED 06/08/2014
THE COLET	DRAWN	EAM	MATER MOTEC	DRAWING NO
	APPROVE) XXX	WATER NOTES	W-01.1

WATER NOTES CONTINUED:

- PIPE JOINT RESTRAINT SHALL BE PROVIDED BY THE USE OF DUCTILE IRON FOLLOWER GLANDS
 MANUFACTURED TO ASTM A 536-80 TWIST-OFF NUTS SHALL BE USED TO ENSURE PROPER ACTUATING OF
 THE RESTRAINING DEVICES. THE MECHANICAL JOINT RESTRAINING DEVICES SHALL HAVE A WORKING
 PRESSURE OF 250 PSI MINIMUM, WITH A MINIMUM SAFETY FACTOR OF 2 1, AND SHALL BE EBAA IRON INC.,
 MEGALUG OR APPROVED EQUAL, JOINT RESTRAINTS SHALL BE PROVIDED AT A MINIMUM OF THREE
 JOINTS (60 FEET) FROM ANY FITTING
- 23. WHENEVER IT IS NECESSARY, IN THE INTEREST OF SAFETY, TO BRACE THE SIDES OF A TRENCH, THE CONTRACTOR SHALL FURNISH, PUT IN PLACE AND MAINTAIN SUCH SHEETING OR BRACING AS MAY BE NECESSARY TO SUPPORT THE SIDES OF THE EXCAVATION TO ENSURE PERSONNEL SAFETY, AND TO PREVENT MOVEMENT WHICH CAN IN ANY WAY DAMAGE THE WORK OR ENDANGER ADJACENT STRUCTURES THE CONTRACTOR SHALL BE SOLELY RESPONSIBLE FOR THE SEQUENCE, METHODS AND MEANS OF CONSTRUCTION, AND FOR THE IMPLEMENTATION OF ALL OSHA AND OTHER SAFETY REQUIREMENTS.


OF HOLLI HOOD TO	ISSUED.	03/01/1994	DEPARTMENT OF PUBLIC UTILITIES STANDARD DETAIL	REVISED 06/08/20	14
MAINNED TO THE COLUMN TO THE C	DRAWN	EAM	WATER NOTES	drawing no	7
	APPROVED	XXX	WATER NOTES	W-02	


WATER METER SERVICE NOTES:

BY THE CONTRACTOR

- 1 SUCCESSIVE TAPS INTO THE WATER MAIN SHALL BE SPACED NOT LESS THAN 18" ON CENTER
- P E TUBING SHALL BE IN ACCORDANCE WITH THE LATEST EDITION OF AWWA STANDARD C901, "POLYETHYLENE (PE) PRESSURE PIPE AND TUBING, 1/2 IN (13mm) THROUGH 3 IN. (76 mm), FOR WATER SERVICE"
- 3. SERVICE PIPE SHALL BE THE SAME SIZE AS THE WATER METER EXCEPT THAT NO SERVICE PIPE SHALL BE SMALLER THAN 1" DIAMETER.
- 4. SERVICE PIPE CROSSING UNDER THE ENTIRE WIDTH OF A ROADWAY PAVEMENT MUST BE 2"
 MINIMUM UNLESS OTHERWISE DIRECTED BY THE CITY
- THE 3" CASING UNDER THE ROAD IS TO BE USED ONLY WHEN THE WATER MAIN RUNS WITHIN THE SWALE ON THE OPPOSITE SIDE OF THE ROAD FROM THE METER SERVICE ALL CASING PIPE SHALL EXTEND A MINIMUM OF 2' BEYOND THE EDGE OF PAVED STREETS
- 6 APPROVED TYPE COPPER TUBING MAY BE USED AT THE CITY'S DISCRETION
- 7 FOR NEW METER INSTALLATIONS, ALL SADDLES, VALVES, PIPING, FITTINGS, CURB STOPS, METER VALVES, METER COUPLINGS, METER VAULTS AND COVERS SHALL BE FURNISHED AND INSTALLED BY THE CONTRACTOR
- 8 THE WATER METERS WILL BE PROVIDED BY THE CITY OF HOLLYWOOD AND INSTALLED BY THE CONTRACTOR
- 9 FOR METER RELOCATIONS, ALL SADDLES, VALVES, PIPING, FITTINGS, CURB STOPS, METER VALVES, METER COUPLINGS, METER VAULTS AND COVERS SHALL BE FURNISHED AND INSTALLED
- 10 THE EXISTING WATER METER TO BE RELOCATED AND INSTALLED BY CONTRACTOR
- FOR EXISTING METERS ABUTTING THE RIGHT-OF-WAY THAT ARE BEING DISCONNECTED FROM EXISTING MAINS AND RECONNECTED TO NEW MAINS, THE CONTRACTOR SHALL:
- a CUT AND PLUG THE EXISTING SERVICE LINE AT THE MAIN AND AT THE METER, AND REMOVE THE EXISTING BALL VALVE CURB STOP
- b Furnish and install service saddle, corporation stop or service valve and valve BOX, Piping and fittings up to and including the ball valve curb stop
- 12. THE ELEVATION AT THE TOP OF THE METER BOX SHALL MATCH THE ELEVATION OF THE BACK OF SIDEWALK.
- AS PART OF THE SERVICE INSTALLATION, THE CONTRACTOR SHALL RESTORE THE RIGHT-OF-WAY TO MATCH EXISTING CONDITIONS, INCLUDING ROADWAY PAVEMENT, PAVEMENT MARKINGS AND RPMs, CONCRETE CURBS, SIDEWALKS, RAMPS (INCLUDING DETECTABLE WARNING SURFACE), SODDING, AND ALL OTHER IMPROVEMENTS REMOVED OR DAMAGED DURING THE SERVICE INSTALLATION
- 14 FOR UNPAVED AREAS, THE MINIMUM GROUND COVER ACCEPTED BY THE CITY IS SODDING

GENOLLINGOO TO ISSUED.	03/01/1994	DEPARTMENT OF PUBLIC UTILITIES STANDARD DETAIL	REVISED 06/08/2014
DRAWN APPROVED	eam XXX	WATER METER SERVICE NOTES FOR 5/8" THROUGH 2" METERS	DRAWING NO W-O7

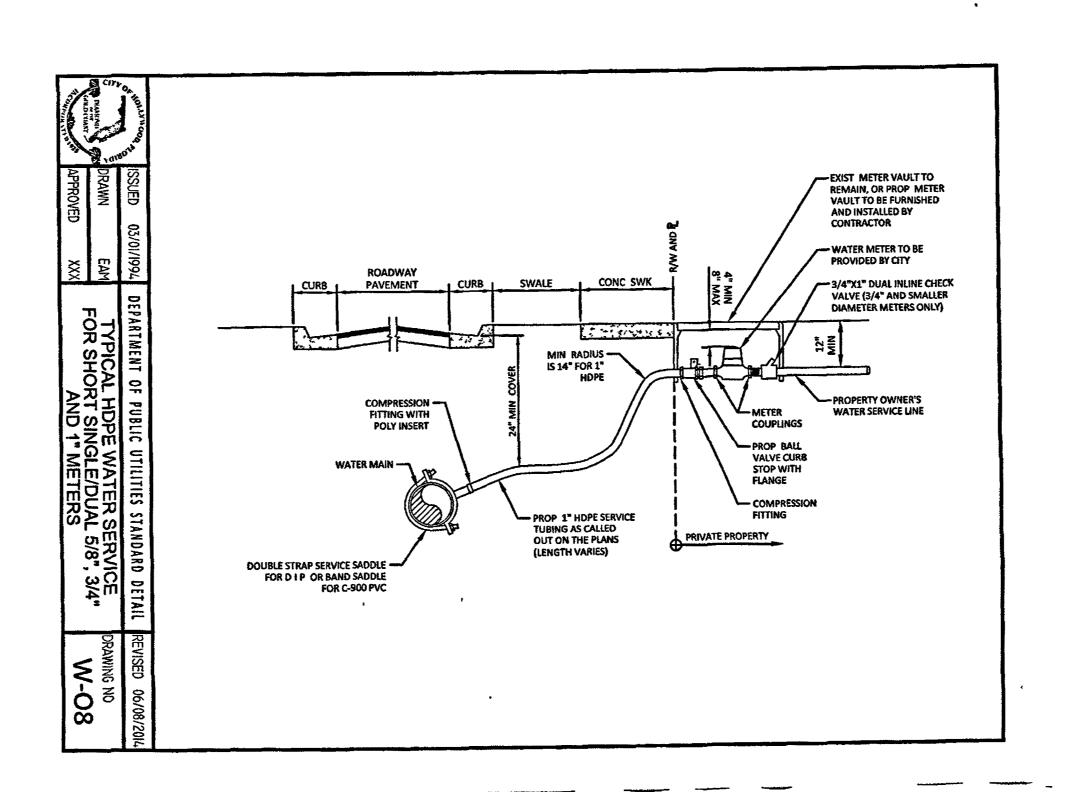

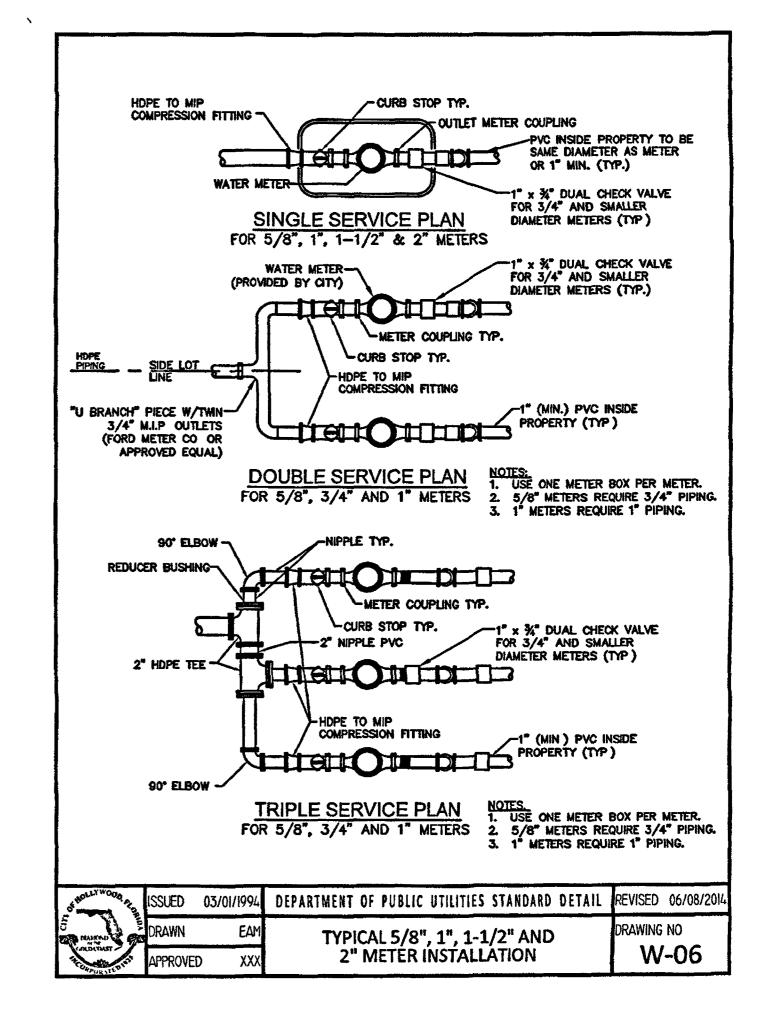

CHARLES O BUCKALEW, P.E FLORIDA REG NO. 24842 Duckalew
neering Services, Inc.
ean Drive, Suite 201
, Florida 33019
Number 6255
89 Fax · (954) 929-8988

REVISIONS .

Charles O. B. Consulting Engineering S. 801 South Ocean Drive, Hollywood, Florida C.O.A. Number 6 C.O.A. Numbe

சூ

UNIT APARTMENTS
1 JOHNSON STREET

SO


N E

ION DETAILS

CONSTRUCT

DATE: MARCH, 2016
SCALE. AS NOTED
DWG. BY: CRW.


JOB NO.: 16-232 SHEET NO.

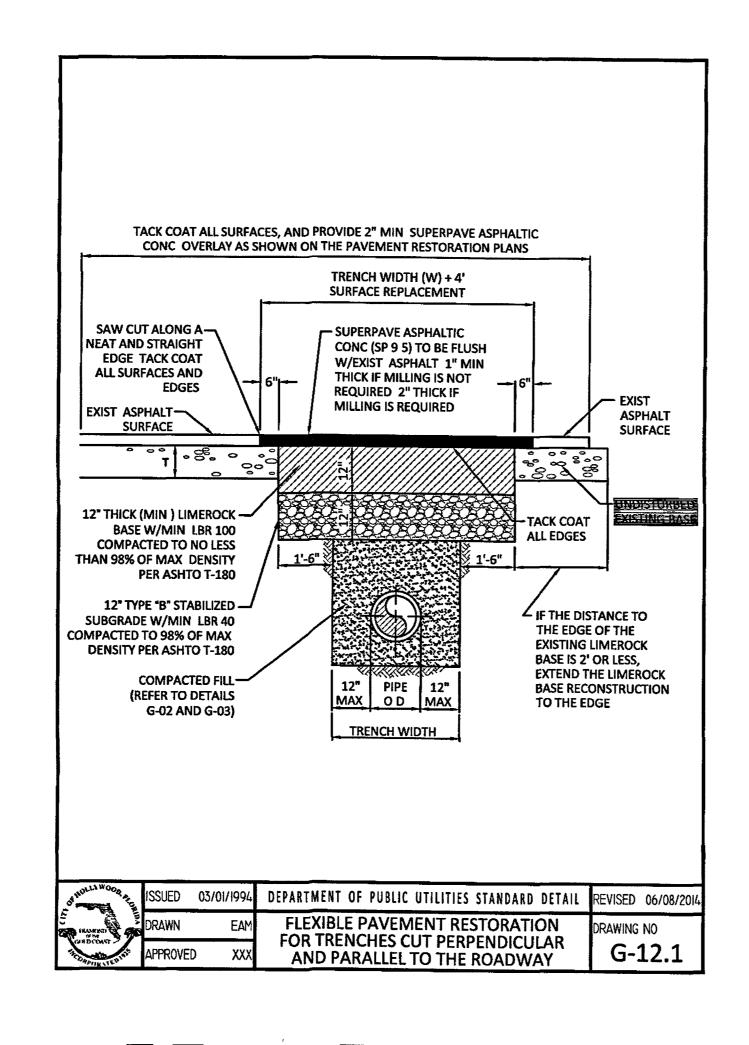




- THE ABOVE DETAILS APPLY ONLY TO ASPHALT PAVEMENT RESTORATION OVER UTILITY TRENCHES CUT WITHIN CITY OF HOLLYWOOD RIGHTS-OF-WAY FOR PAVEMENT RESTORATION WITHIN BROWARD COUNTY OR FDOT RIGHTS-OF-WAY REFER TO THE CORRESPONDING DETAILS FOR THOSE AGENCIES
- LIMEROCK BASE MATERIAL SHALL HAVE A MINIMUM L B R OF 100 AND A MINIMUM CARBONATE CONTENT OF 70% REPLACED BASE MATERIAL OVER TRENCH SHALL BE A MINIMUM OF 12" THICK"
- LIMEROCK BASE MATERIAL SHALL BE PLACED IN 6" MAXIMUM (LOOSE MEASUREMENT) THICKNESS LAYERS WITH EACH LAYER THOROUGHLY ROLLED OR TAMPED AND COMPACTED TO 98% OF MAXIMUM DENSITY, PER AASHTO T-180, PRIOR TO THE PLACEMENT OF THE SUCCEEDING LAYERS
- 4 STABILIZED SUBGRADE MATERIAL SHALL BE GRANULAR AND SHALL HAVE A MINIMUM L B R OF 40
- BACKFILL SHALL BE PLACED AND COMPACTED IN ACCORDANCE WITH THE PIPE LAYING CONDITION TYPICAL SECTIONS IN DETAILS G-02 AND G-03, AND THE SPECIFICATIONS, BUT TESTING WILL BEGIN 12" ABOVE THE INSTALLED FACILITY
- ALL EDGES AND JOINTS OF EXISTING ASPHALT PAVEMENT SHALL BE SAW CUT TO STRAIGHT LINES, PARALLEL TO OR PERPENDICULAR TO THE ROADWAY, PRIOR TO THE RESURFACING
- RESURFACING MATERIAL SHALL BE FDOT SUPERPAVE, AND SHALL BE APPLIED A MINIMUM OF TWO INCH IN THICKNESS
- 8 SURFACE TREATED PAVEMENT JOINTS SHALL BE LAPPED AND FEATHERED FOR A SMOOTH, FLUSH TRANSITION TO EXISTING PAVEMENT
- 9 IF THE TRENCH IS FILLED TEMPORARILY, IT SHALL BE COVERED WITH A 2" ASPHALTIC CONCRETE PATCH TO KEEP THE FILL MATERIAL FROM RAVELING UNTIL REPLACED WITH A PERMANENT PATCH
- 10 REFER TO SPECIFICATIONS FOR DETAILED PROCEDURES
- 11 WHERE THE UTILITY TRENCH CROSSES EXISTING ASPHALT DRIVEWAYS, THE LIMEROCK BASE THICKNESS MAY BE A MINIMUM OF 6 INCHES THICK REGARDLESS OF THE EXTENT OF IMPACT, THE ENTIRE DRIVEWAY SURFACE BETWEEN THE EDGE OF THE ROADWAY PAVEMENT AND PROPERTY LINE OR FRONT OF SIDEWALK SHALL BE OVERLAID USING 2-INCH THICK MINIMUM ASPHALTIC CONCRETE SURFACE COURSE WHERE INDICATED ON THE PLANS OR AS DIRECTED BY THE CITY/ENGINEER

OF HOLLYWOOD TES	ISSUED	03/01/1994	DEPARTMENT OF PUBLIC UTILITIES STANDARD DETAIL	REVISED 06/08/2014
CHANKAD CONTROL OF THE CONTROL OF TH	DRAWN	EAM	FLEXIBLE PAVEMENT RESTORATION	DRAWING NO
	APPROVED	XXX	NOTES	G-12

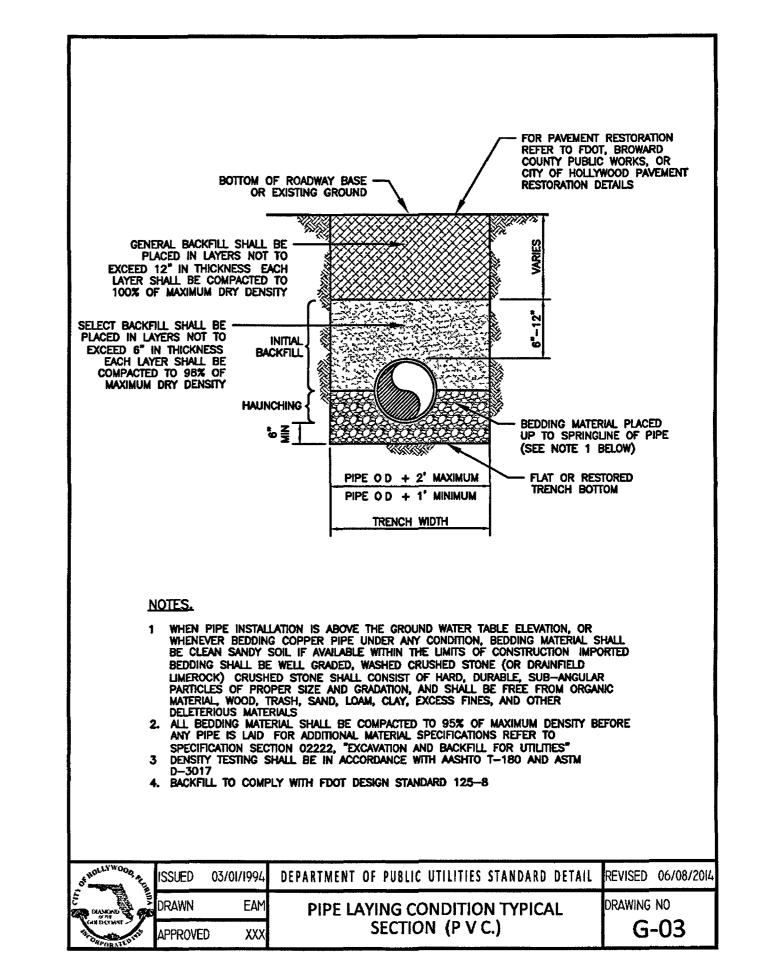

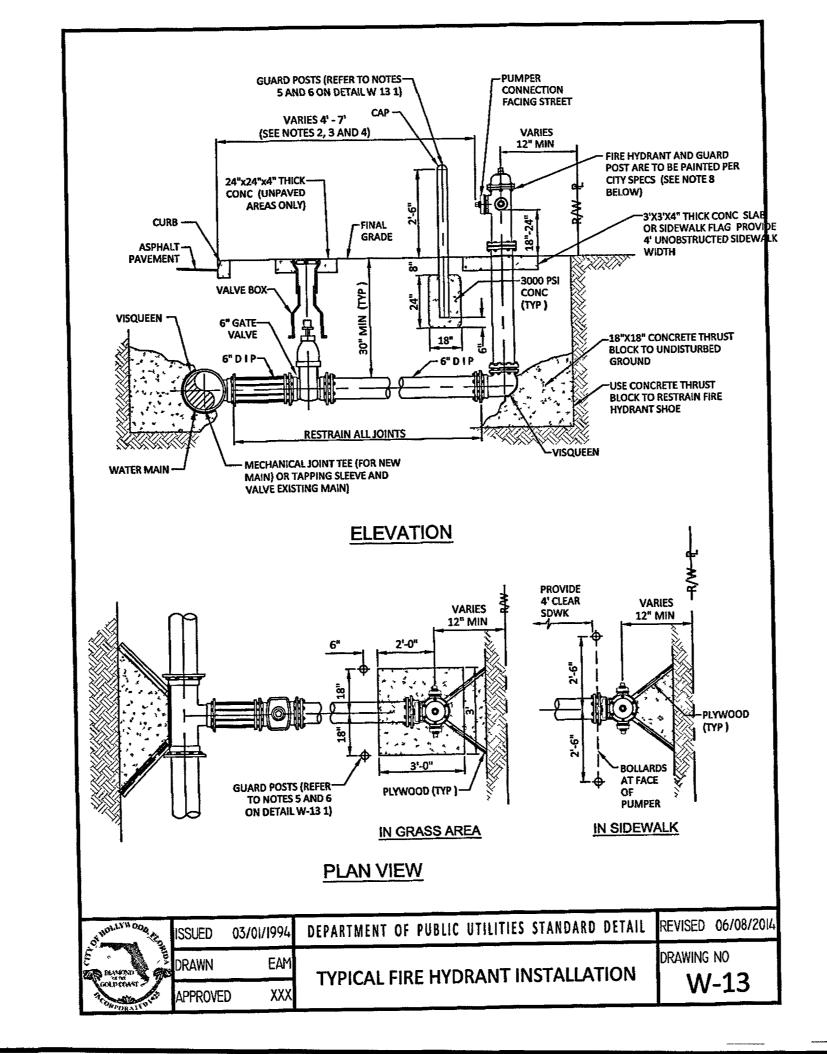

NOTES

- 1. IN ALL CASES, PROVIDE 4' UNOBSTRUCTED SIDEWALK CLEAR OF THE FIRE HYDRANT AND BOLLARDS.
- 2. FIRE HYDRANTS SHALL BE LOCATED BETWEEN 4' AND 7' FROM THE FACE OF CURB.
- 3. FIRE HYDRANTS SHALL NOT BE LOCATED WITHIN A RADIUS OR WITHIN FDOT CLEAR DRIVING ZONE.
- 4. WITHIN FDOT R/W, WHERE SPACE IS RESTRICTED THE FIRE HYDRANT MAY BE LOCATED 2' FROM THE FACE OF THE CURB AS LONG AS THERE IS A MINIMUM 4' UNOBSTRUCTED SIDEWALK BEHIND THE HYDRANT, AND THE HYDRANT BASE IS 4" OR LESS FROM GRADE IN ACCORDANCE WITH F.D.O.T. INDEX 700.
- 5. GUARD POSTS SHALL NOT BE ALLOWED WITHIN FDOT R/W.
- 6. OTHER THAN FDOT R/W, GUARD POSTS SHALL BE INSTALLED AS REQUIRED FOR SAFETY OR AS APPROVED BY THE DEPT. OF PUBLIC UTILITIES. IN SIDEWALK, LOCATE GUARD POSTS AT THE FACE OF THE PUMPER AND 2'-6' LEFT/RIGHT OF Q OF THE FIRE HYDRANT.EXTRA POSTS MAY BE REQUIRED IN INDUSTRIAL AND CONGESTED TRAFFIC AREAS. (4 POSTS MAX.)
- 7. FIRE HYDRANT CONCRETE SLAB AND CONCRETE GUARD POST FOOTINGS SHALL BE DIFFERENT POURS.
- 8. THE FIRE HYDRANT BONNET, OPERATING NUT, HOLD-DOWN NUT, PUMPER CAP AND HOSE CAPS SHALL BE PAINTED GREEN, AND THE HYDRANT UPPER BARREL SHALL BE PAINTED SILVER IN ACCORDANCE WITH CITY SPECIFICATIONS.

Of BOLLYHOOD	ISSUED	03/01/1994	DEPARTMENT OF PUBLIC UTILITIES STANDARD DETAIL	REVISED 06/08/2014
S orrigon	DRAWN	EAM	TYPICAL FIRE HYDRANT NOTES	DRAWING NO
A COMPORATE STATE	APPROVE	D XXX	TIPICAL FIRE TITONANT NOTES	W-13.1

CHARLES O BUCKALEW, PE FLORIDA REG NO 24842 Charles O. Buckaler

Consulting Engineering Services, Inc

Refer

Consulting Engineering Services, Inc

Routh Ocean Drive, Suite 201


Hollywood, Florida 33019


REVISIONS

12 UNIT APA 2324 JOHNSC FOLIO NO 5142-16-01-4610,

CONSTRUCTION DETAILS

DATE MARCH, 201
SCALE AS NOTED
DWG BY, CRW
CHK'D BY COB
JOB NO 17-043
SHEET NO

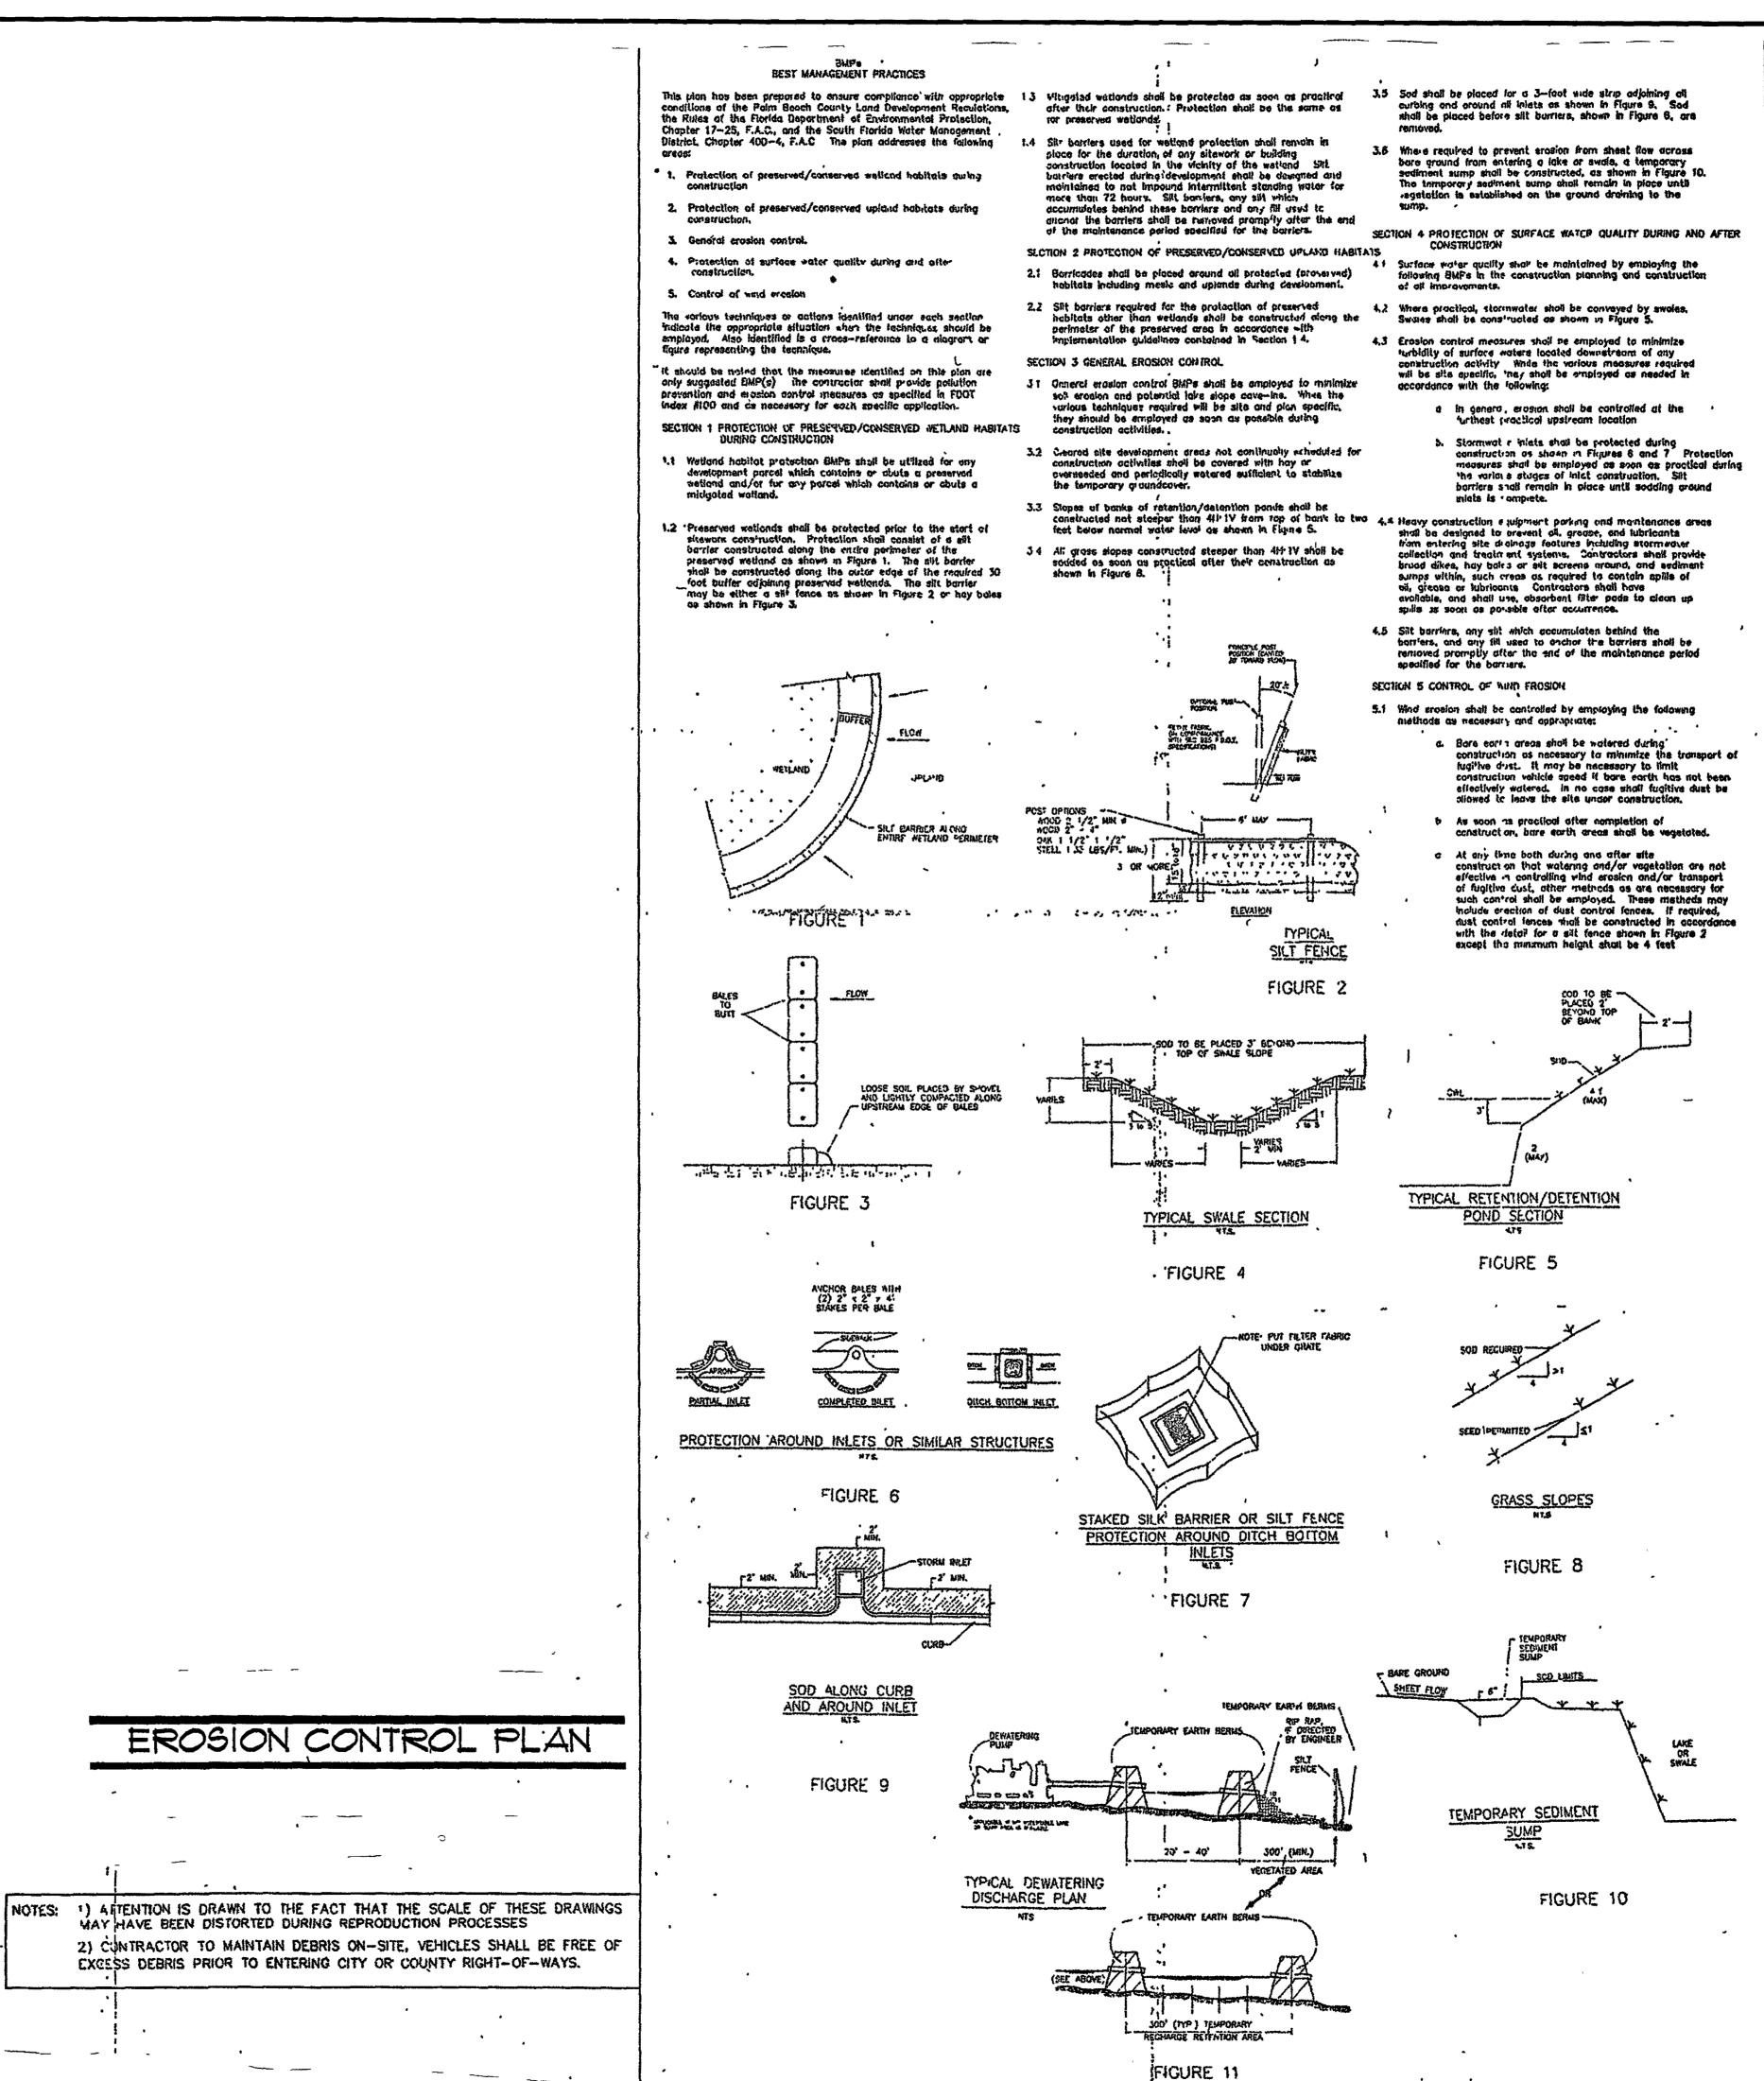

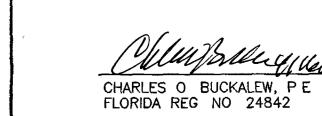

REVISIONS

Buckale


Represedute 201

Charles

S DETAIL HON ONSTRUC

DATE MARCH, 201 SCALE AS NOTED DWG BY CHK'D BY CO JOB NO 17-043

SHEET NO

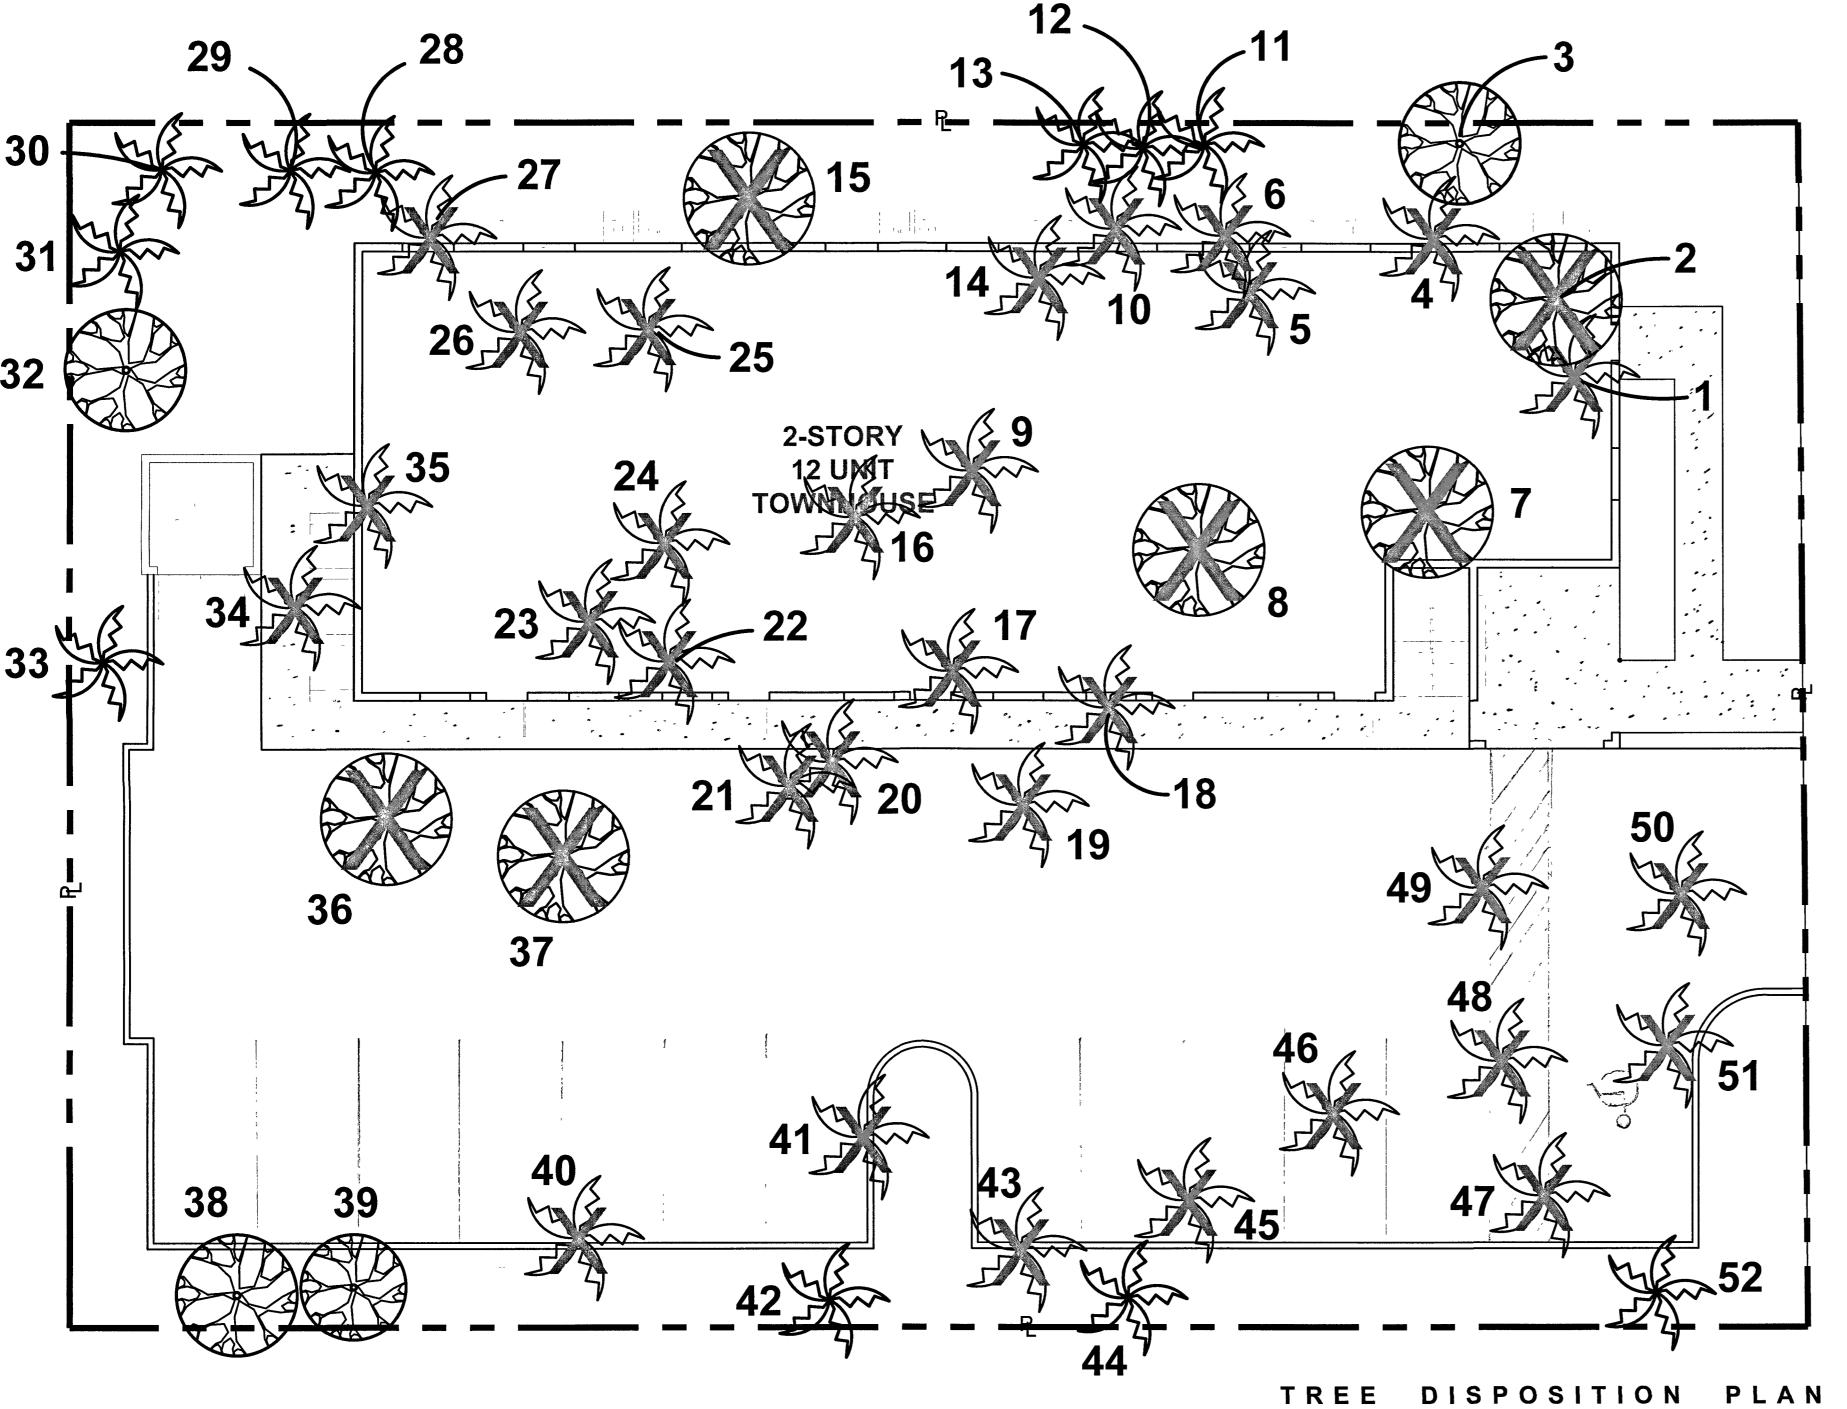



STREET

GENERAL DISPOSITION NOTES

- 1 CONTRACTOR TO VISIT SITE AND REVIEW PLANS PRIOR TO SUBMITTING A PROPOSAL TO OWNER CONTRACTOR SHALL VERIFY SITE AND TREE INFORMATION, AND BRING ANY DISCREPANCIES WITHIN THE PLANS TO THE ATTENTION OF THE LANDSCAPE ARCHITECT FOR CLARIFICATION PRIOR TO SUBMITTING A PROPOSAL
- 2 THESE PLANS WERE PREPARED BASED ON THE BEST INFORMATION AVAILABLE AT THE TIME OF DESIGN ALL FINAL PLANS SHALL BE COORDINATED WITH FINAL APPROVED SITE PLAN
- 3 CONTRACTOR TO VERIFY ALL UNDERGROUND UTILITIES BEFORE WORK COMMENCES AND SHALL PROTECT ALL UNDERGROUND/ABOVE GROUND UTILITIES AND EXISTING CONDITIONS-TO-REMAIN DURING CONSTRUCTION
- 4 THE TREE REMOVAL WORK HEREIN WILL REQUIRE MITIGATION IN ACCORDANCE WITH CITY OF HOLLYWOOD ARTICLE 9 TREE MITIGATION REQUIREMENTS
- 5 CONTRACTOR TO COMPLETELY REMOVE ALL PARTS OF TREES SPECIFIED FOR REMOVAL ON THE TREE DISPOSITION PLAN GRIND ALL TRUNKS/ROOT SYSTEMS OR TREES TO BE REMOVED A MINIMUM OF 18" DEPTH IN THEIR ENTIRETY AND FILL AND COMPACT WITH SUITABLE CLEAN SOIL TO FINAL GRADE
- 6 LANDSCAPE ARCHITECT RESERVES THE RIGHT TO MAKE CHANGES IN MATERIAL, QUANTITIES AND PROJECT SCOPE TO CONTRACTED WORK
- 7 IN THE EVENT OF DISPUTE, THE LANDSCAPE ARCHITECT'S INTERPRETATION SHALL BE FINAL
- 8 ALL WORK TO BE IN ACCORDANCE WITH ALL APPLICABLE REGULATIONS
- 9 CONTRACTOR TO LEAVE SITE COMPLETELY CLEAN, RESTORED, AND FREE OF DEBRIS CONTRACTOR TO REPAIR IN FULL ANY DAMAGE CAUSED BY WORK OR MOBILIZATION
- 10 FOR ALL TREES TO BE REMOVED, CONTRACTOR TO TAKE PROPER CARE IN REMOVAL TO NOT CAUSE DAMAGE TO EXISTING SITE FEATURES, CONDITIONS, INFRASTRUCTURE, OR THE GENERAL PUBLIC AND PASSERSBY COMPLETELY REMOVE TREES AND PROPERLY DISPOSE OF REMAINS OFF-SITE
- 11 NO TREES SHALL BE REMOVED OR RELOCATED UNTIL A CITY OF HOLLYWOOD TREE REMOVAL PERMIT IS ISSUED APPLICATIONS ARE AVAILABLE IN ROOM 308 OF CITY HALL OR VIA WEBSITE DOWNLOAD AT WWW HOLLYWOODFL ORG > DEPARTMENTS > ENGINEERING > ENGINEERING SERVICES
- 12 ALL TREES TO REMAIN SHALL BE PROTECTED IN PLACE BY A TREE PROTECTION BARRIER FENCE ERECTED TO THE EXTENTS OF THE CANOPY DRIPLINES SEE LANDSCAPE DETAILS SHEET FOR ADDITIONAL INFORMATION FAILURE TO MAINTAIN THE BARRIERS MAY RESULT IN DAMAGE TO TREES SPECIFIED TO REMAIN, ESPECIALLY ONES CLOSE TO ACTIVE CONSTRUCTION, WHICH MAY RESULT IN TREE MITIGATION COSTS, ADDITIONAL PERMITTING TIME AND COSTS, OR REJECTION OF TREES AT TIME OF FINAL INSPECTION TREE PROTECTION BARRIERS ARE TO REMAIN IN PLACE, TO THE EXTENTS OF THE TREE DRIPLINES, FOR THE ENTIRE DURATION OF CONSTRUCTION

TREE SYMBOL LEGEND



SCALE 1/8" = 1'-0"

- EXISTING PALM TO REMAIN
SEE TREE PROTECTION FENCING
DETAIL FOR FENCING TO BE ERECTED
AND MAINTAINED DURING ENTIRE
CONSTRUCTION PERIOD



- EXISTING PALM TO BE REMOVED
REMOVE ENTIRE ROOT SYSTEMS AND
FILL/LIGHTLY COMPACT/GRADE WITH
SUITABLE SOIL



- EXISTING TREE TO REMAIN
SEE TREE PROTECTION FENCING
DETAIL FOR FENCING TO BE ERECTED
AND MAINTAINED DURING ENTIRE
CONSTRUCTION PERIOD




- EXISTING TREE TO BE REMOVED
REMOVE ENTIRE ROOT SYSTEMS AND
FILL/LIGHTLY COMPACT/GRADE WITH
SUITABLE SOIL

TREE DISPOSITION TABLE

No.	LATIN NAME	COMMON NAME	DBH:	SIZE (HxW)	DISPOSITION
1	Thrinax radiata	Florida Thatch Palm	n/a	25' X 8'	REMOVE
2	Mangifera indica	Mango	8"	28' X 32'	REMOVE
3	Magnolia grandiflora	Southern Magnolia	8"	28' X 18'	REMAIN
4	Syagrus romanzoffiana	Queen Palm	n/a	30' X 18'	REMOVE
5	Sabal palmetto	Sabal Palm	n/a	28' X 16'	REMOVE
6	Carpentaria acuminata	Carpentaria Palm	n/a	28' X 8'	REMOVE
7	Persea americana	Avocado	5"	15' X 12'	REMOVE
8	Persea americana	Avocado	12"	30' X 32'	REMOVE
9	Veitchia montgomeryana	Montgomery Palm	n/a	24' X 12'	REMOVE
10	Veitchia montgomeryana	Montgomery Palm	n/a	28' X 12'	REMOVE
11	Carpentaria acuminata		n/a	20' X 8'	REMAIN
12	Carpentaria acuminata	Carpentaria Palm	n/a	20' X 8'	REMAIN
13	Carpentaria acuminata	•	n/a	20' X 8'	REMAIN
14	Veitchia merrillii	Christmas Palm	n/a	18' X 8'	REMOVE
15	Schinus terebinthifolia	Brazilian Pepper	18"	18' X 30'	REMOVE
16	Veitchia montgomeryana	Montgomery Palm	n/a	24' X 10'	REMOVE
17	Carpentaria acuminata		n/a	27' X 8'	REMOVE
18	Carpentaria acuminata	•	n/a	25' X 8'	REMOVE
19	·		n/a	23' X 8'	REMOVE
	Carpentaria acuminata			18' X 10'	REMOVE
20	Thrinax radiata	Florida Thatch Palm			
21	Carpentaria acuminata	•	n/a	30' X 8'	REMOVE
22	Veitchia montgomeryana	Montgomery Palm	n/a	28' X 12'	REMOVE
23	Sabal palmetto	Sabal Palm	n/a	28' X 10'	REMOVE
24	Areca catechu	Betel-nut Palm	n/a	14' X 10'	REMOVE
25	Carpentaria acuminata	Triple Carpentaria Palm	n/a	25' X 16'	REMOVE
26	Oncosperma horridum	Mountain Nibong Palm	n/a	25' X 10'	REMOVE
27	Carpentaria acuminata	·	n/a	25' X 8'	REMOVE
28	Carpentaria acuminata		n/a	25' X 8'	REMAIN
29	Carpentaria acuminata	Carpentaria Palm	n/a	30' X 8'	REMAIN
30	Carpentaria acuminata	Carpentaria Palm	n/a	20' X 8'	REMAIN
31	Syagrus romanzoffiana	Queen Palm	n/a	28' X 12'	REMAIN
32	Guaiacum officinale	Tree of Life	5"	18' X20'	REMAIN
33	Carpentaria acuminata	Triple Carpentaria Palm	n/a	28' X 14'	REMAIN
34	Carpentaria acuminata	Carpentaria Palm	n/a	25' X 8'	REMOVE
35	Trachycarpus fortuneii	Windmill Palm	n/a	23' X 12'	REMOVE
36	Ficus rubiginosa	Rusty Leaf Fig	9"	20' X 22'	REMOVE
37	Mangifera indica	Mango	10"	24' X 18'	REMOVE
38	Cananga odorata	Ylang Ylang	10"	27' X 20'	REMAIN
39	llex vomitoria	Yaupon Holly	6"	20' X 12'	REMAIN
40	Carpentaria acuminata	Carpentaria Palm	n/a	23' X 8'	REMOVE
41	Veitchia montgomeryana	Montgomery Palm	n/a	35' X 12'	REMOVE
42	Dypsis decaryi	Triangle Palm	n/a	35' X 18'	REMAIN
43	Veitchia montgomeryana	Montgomery Palm	n/a	32' X 12'	REMOVE
44	Cocos nucifera	Coconut Palm	n/a	35' X 18'	REMAIN
45	Veitchia montgomeryana	Montgomery Palm	n/a	32' X 12'	REMOVE
46	Carpentaria acuminata		n/a	25' X 16'	REMOVE
47	Wodyetia bifurcata	Foxtail Palm	n/a	20' X 14'	REMOVE
48	Carpentaria acuminata		n/a	25' X 14'	REMOVE
		•	-	16' X 8'	REMOVE
49	Carpentaria acuminata		n/a		
50	Dypsis decaryi	Triangle Palm	n/a	18' X 14'	REMOVE
51	Cocos n. 'Golden Malayan'	Golden Malayan Coco Palm		32' X 18'	REMOVE
52	Dictyosperma album	Hurricane Palm	n/a	10' X 8'	REMAIN
		Monocots) Removed		31	
	Total	Dicot DBH Removed		66"	
	Tota	l Mitigation Required		22 Trees @ Ht. & 31 Palr	

T T H 4-638-9825
No. REVISIONS DATE

GREEN EARTHLANDSCAPE ARCHITECTUR

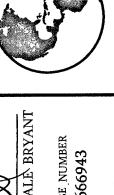

E WILLIAM DALE BRYANT
SHOWN

WDB

LA6666943

DATE
03-09-2018
V
SCALE AS SHOWN
DESIGNED BY WDB
DRAWN BY WDB

2 UNIT APARTMENT BUILDING 2324 JOHNSON STREET HOLLYWOOD, FL

TREE DISPOSITION PLAN

SHEET NUMBER

T.-100

7

SHEET NUMBER L-200

2-STORY **12 UNIT TOWNHOUSE** CONC. WALKWAY .

PLANT LIST & SPECIFICATIONS

				TREE AND PALMS		
5	SYMBOL	QUANTITY	LATIN NAME	COMMON NAME	SIZE	DESCRIPTION
-	ARD ESC	9	Ardısıa escallonıoıdes	MARLBERRY	2" DBH/12' HT	SINGLE LEADER TREE FORM, FULL RADIAL BRANCHING
В	BUL ARB	3	Bulnesia arborea	VERAWOOD	2" DBH/12' HT.	STRAIGHT TRUNK, FULL RADIAL BRANCHING
C	CAR ACU	19	Carpentaria acuminata	CARPENTARIA PALM	12'/16' CT HTS.	STRAIGHT EVEN, ALTERNATE CLEAR TRUNK HEIGHTS, FULL CROWNS
*N C	ON SER	8	Conocarpus erectus 'Sericeus'	SILVER BUTTONWOOD	12' HT	MULTI-LEADER, DENSE, FULL RADIAL BRANCHING
D	DEL REG	3	Delonix regia	ROYAL POINCIANA	3" DBH/14' HT	STRAIGHT TRUNK, FULL RADIAL BRANCHING
L	AG FAU	8	Lagerstroemia fauriei 'Muskogee'	MUSKOGEE CRAPE MYRTLE	2" DBH/12' HT	SINGLE LEADER TREE FORM, FULL RADIAL BRANCHING
*N N	/IYR FRA	8	Myrcianthes fragrans	SIMPSON'S STOPPER	12' HT	MULTI-LEADER, DENSE, FULL RADIAL BRANCHING
Р	PHO DAC	2	Phoenix dactylifera	SYLVESTER DATE PALM	12' C T	STRAIGHT EVEN TRUNKS WITH DIAMOND PATTERN FINISH, FULL CROW
*N S	SIM GLA	10	Sımaruba glauca	PARADISE TREE	2" DBH/12' HT	STRAIGHT TRUNK, FULL RADIAL BRANCHING
*N SYM	MBOL LEGEND	1	Magnolia grandiflora (existing)	EXISTING MAGNOLIA	8" dbh	PROTECT PER TREE PROTECTION BARRIER SHEET L-20
SYM	MBOL LEGEND	1	Cananga odorata (existing)	EXISTING YLANG-YLANG	10" dbh	PROTECT PER TREE PROTECTION BARRIER SHEET L-20
*N SYM	MBOL LEGEND	1	Guaiacum officinale (existing)	EXISTING TREE OF LIFE	5" dbh	PROTECT PER TREE PROTECTION BARRIER SHEET L-20
*N SYM	MBOL LEGEND	1	llex vomitoria (existing)	EXISTING YAUPON HOLLY	6" dbh	PROTECT PER TREE PROTECTION BARRIER SHEET L-20
SYM	MBOL LEGEND	11	Palm Species - Varies	SEE SHEET L-100 FOR SPECIES	VARIES	PROTECT PER TREE PROTECTION BARRIER SHEET L-20
				SHRUBS AND GROUNDO	OVER	
*N C	LU GUT	200	Clusia guttifera	LITTLELEAF CLUSIA	24" X 24"	FULL, SPACE 24" ON CENTER
F	IC GRN	152	Ficus microcarpa 'Green Island'	GREEN ISLAND FICUS	18" X 18"	FULL, SPACE 24" ON CENTER
IV	/IIC SCO	60	Microsorum scolopendria	WART FERN	15" X 15"	FULL, SPACE 24" ON CENTER
*N N	IUH CAP	18	Muhlenbergia capillaris	MUHLY GRASS	24" X 24"	FULL, SPACE 30" ON CENTER
Р	LU PUD	4	Plumeria pudica	BRIDAL BOUQUET	6' HT.	FULL, SPACE AS SHOWN ON PLAN @ 48" ON CENTER
*N R	RAP PUN	16	Rapanea punctata	MYRSINE	42" X 24"	FULL, SPACE 24" ON CENTER

LANDSCAPE PLANTING PLAN

SCALE 1/8" = 1'- 0"

TREE SYMBOL LEGEND



SEE TREE PROTECTION FENCING DETAIL FOR FENCING TO BE ERECTED AND MAINTAINED DURING ENTIRE CONSTRUCTION PERIOD



DURING ENTIRE CONSTRUCTION PERIOD

- EXISTING PALM TO REMAIN

EXISTING TREE TO REMAIN SEE TREE PROTECTION FENCING DETAIL FOR FENCING TO BE ERECTED AND MAINTAINED

*N - DENOTES FLORIDA NATIVE SPECIES

REQUIRED PROVIDED SECTION ARTICLE 9 LDR 2 TREES 2 TREES

60% NATIVE TREES/50% SHRUBS

STREET TREE REQUIREMENTS JOHNSON STREET - 100LF STREET FRONTAGE VEHICULAR USE AREAS 1,387 SF LANDSCAPED AREA 25% OF PARKING AREA TO BE LANDSCAPED - 5,490 SF 1,373 SF LANDSCAPED AREA 3 TERMINAL/PENINSULAR PARKING ISLANDS 3 TREES + LANDSCAPING 3TREES + LANDSCAPING OPEN SPACE TREE REQUIREMENTS 5 TREES 4,137 SF PERVIOUS OPEN SPACE 5 TREES AT-GRADE PARKING LOT 24" CONTINUOUS HEDGE 24" CONTINUOUS HEDGE TREE MITIGATION 31 PALMS REMOVED 31 PALMS OR 11 TREES 30 PALMS & 1 TREE 66" DBH BROADLEAF TREES 82" DBH BROADLEAF TREES 66" DBH DICOTS REMOVED

TABULAR DATA CODE CHART

REGULATING DOCUMENT. ARTICLE 9 LAND DEVELOPMENT & ZONING REGULATIONS

ZONING RM-12

NATIVE TREE AND SHRUB REQUIREMENT

LANDSCAPE NOTES & SPECIFICATIONS

- 1 CONTRACTOR TO VISIT SITE AND REVIEW PLANS PRIOR TO SUBMITTING A PROPOSAL TO OWNER CONTRACTOR SHALL VERIFY SITE AND TREE INFORMATION, AND BRING ANY AND ALL DISCREPANCIES, CONFLICTS, SHORTAGES, OR OTHER SCOPE/QUANTITY/ TIME RELATED ISSUES, INCOMPLETENESS OR CONSISTENCY WITHIN THE PLANS TO THE ATTENTION OF THE LANDSCAPE ARCHITECT IMMEDIATELY FOR CLARIFICATION PRIOR TO SUBMITTING A PROPOSAL OR BASING A PROPOSAL ON THE SCOPE OF WORK
- THESE PLANS WERE PREPARED BASED ON THE BEST INFORMATION AVAILABLE AT THE TIME OF DESIGN AND AS PROVIDED ALL FINAL PLANS SHALL BE COORDINATED WITH FINAL APPROVED SITE PLAN
- 3 CONTRACTOR TO VERIFY ALL UNDERGROUND UTILITIES BEFORE WORK COMMENCES AND SHALL PROTECT ALL UNDERGROUND/ABOVE GROUND UTILITIES AND EXISTING CONDITIONS-TO-REMAIN DURING CONSTRUCTION
- 4 SEE TREE PROTECTION DETAIL ON LANDSCAPE DETAILS SHEET FOR TREE PROTECTION TO BE ERECTED BEFORE ANY CONSTRUCTION ACTIVITIES BEGIN FOR TREES AND PALMS TO REMAIN, AND TO REMAIN INTACT AS ERECTED UNTIL FINAL COMPLETION OF PROJECT
- 5 IN THE EVENT OF DISPUTE, THE LANDSCAPE ARCHITECT'S INTERPRETATION SHALL BE FINAL
- 6 ALL WORK TO BE IN ACCORDANCE WITH ALL APPLICABLE REGULATIONS AND ADJUST IF NECESSARY TO AVOID
- 7 ALL WORK TO BE PERFORMED IN A PROFESSIONAL, WORKMANLIKE MANNER AND ONLY DURING THOSE TIMES PERMITTED BY THE CITY OF HOLLYWOOD PROTECT THE PUBLIC AND GENERAL PASSERSBY AT ALL TIMES AND PROTECT ALL TREES SPECIFIED TO REMAIN
- 8 ALL NEW PLANT MATERIAL SHALL BE FLORIDA NO 1 OR BETTER ACCORDING TO "GRADES AND STANDARDS FOR NURSERY PLANTS" PUBLICATION BY THE FLORIDA DEPT OF AGRICULTURE AND CONSUMER SERVICES ALL TREES OR PLANTS NOT MEETING THIS MINIMUM SPECIFICATION AS DEFINED IN THE PUBLICATION WILL BE
- 9 ALL TREES AND PALMS MUST BE PLANTED SO THE TOP OF THE ROOT BALL, ROOT FLARE, AND FIRST ORDER ROOTS ARE SLIGHTLY ABOVE THE FINAL GRADE (ADVENTITIOUS ROOTS ARE NOT CONSIDERED FIRST ORDER
- 10 ALL SYNTHETIC BURLAP, SYNTHETIC STRING, CORDS OR OTHER NON-BIODRADABLE MATERIALS SHALL BE COMPLETELY REMOVED IN THEIR ENTIRETY FROM THE ROOTBALLS BEFORE ANY TREES ARE PLANTED
- 11 FOR BIODEGRADABLE BURLAP ROOTBALL CONTAINMENT THE TOP PORTION OF BURLAP MUST BE REMOVED FROM THE TOP OF THE ROOTBALLS THE TOP 1/3RD OF WIRE BASKETS SHALL BE REMOVED, THE BOTTOM 2/3RDS SHALL BE CUT BEFORE THE TREES ARE INSTALLED
- 12 ALL SYNTHETIC TAPE (I.E., TAGGING TAPE, NURSERY TAPE) SHALL BE REMOVED FROM TRUNKS, BRANCHED, ETC BEFORE INSPECTION REMOVE ALL BAMBOO AND METAL STAKES FROM THE TREES
- 13 TREES SHALL HAVE A MULCH RING WITH A MINIMUM DIAMETER OF 4' MULCH WILL BE A GRADE B SHREDDED WOOD HARVESTED FROM EXISTING MELALEUCA OR EUCALYPTUS STANDS (STERILIZED TO DESTROY ANY SEEDS) OVER HEAVY WEED BARRIER FABRIC, SECURED IN PLACE USING METAL SOD STAPLES, AND APPROXIMATELY 3" DEPTH WHEN SETTLED $\,$ USE COMMERCIAL GRADE BLACK PLASTIC EDGING FOR SHAPE AND
- CONTAINMENT OF SHRUB & GROUNDCOVER LANDSCAPE PLANTING AREAS, STAKED IN PLACE 14 ALL TREES AND PALMS SHALL BE GUYED WITH PROPER HORTICULTURAL AND ARBORICULTURAL TECHNIQUES DO NOT USE WIRE, BLACK STRAPPING, OR OTHER SYNTHETIC MATERIAL FOR THE DIRECT STAKING OF TREES PLEASE USE BIODEGRADABLE MATERIAL FOR STAKING DIRECTLY AROUND TRUNKS SUCH AS SISAL TWINE NAILING INTO TREES AND PALMS FOR ANY REASON IS PROHIBITED ALL STAKING MATERIAL SHALL BE REMOVED ONCE TREES ARE ESTABLISHED
- 15 ALL PERVIOUS LANDSCAPED AREAS SHALL RECEIVE 100% IRRIGATION COVERAGE, AS DEFINED BY CITY OF HOLLYWOOD, SFWMD AND INDUSTRY STANDARDS (BEING 'HEAD-TO-HEAD' ARC THROW WITH 50% OVERLAP), BY MEANS OF AN AUTOMATIC, FULLY PROGRAMMABLE UNDERGROUND IRRIGATION SYSTEM UTILIZING PVC PIPE. RAINBIRD 1800 SERIES POP-UP SPRAY TYPE HEADS, REMOTE ELECTRONIC ZONE VALVES, A PROGRAMMABLE AUTOMATIC CONTROLLER WITH INTEGRATED RAIN SENSOR, BACKFLOW PREVENTION DEVICE, SCHEDULE 80 PVC SLEEVES FOR PIPING BENEATH PAVEMENT, ETC ADDITIONALLY, ALL NEWLY PLANTED TREES AND PALMS WILL RECEIVE A MINIMUM OF ONE (1) BUBBLER NOZZLE TO WATER THE ROOT SYSTEMS FOR ESTABLISHMENT ADJUST SET SCREW TO EMIT NO MORE THAN 25 GPM FLOW EACH THIS PLAN IS NOT COMPLETE WITHOUT IRRIGATION PLAN AND IRRIGATION DETAILS SHEETS L-300 AND L-301 IRRIGATION CONTRACTOR TO INSURE THAT FINAL SYSTEM AND ANY REQUIRED ADJUSTMENTS PROVIDE 100% COVERAGE AND ADDITIONAL ZONES OR HEADS MAY NEED TO BE ADDED TO ACHIEVE THIS ALL WORK SHALL COMPLY WITH MUNICIPAL AND COUNTY ORDINANCES, SFWMD REGULATIONS AND RESTRICTIONS AND THE STATE OF FLORIDA
- 16 FOLLOW APPROVED LANDSCAPE PLANS FOR SPECIES, SIZES, LOCATIONS, QUANTITIES, QUALITY, ETC. IF CONTRACTOR IS UNABLE TO LOCATE PLANT MATERIAL AT REQUIRED SPECIFICATIONS CONTACT THE LANDSCAPE ARCHITECT PRIOR TO ANY CHANGES OR SUBSTITUTIONS BEING ASSUMED, ORDERED, OR MADE
- 17 PLANT LIST IS PROVIDED FOR CONVENIENCE ONLY IF DISCREPANCIES EXIST BETWEEN PLANT TABLE AND PLAN, PLAN DRAWING AND ON-CENTER SPACING SHALL TAKE PRECEDENCE
- 18 ALL TREES ARE TO HAVE PROTECTIVE LAYER OF BURLAP OR SIMILAR HEAVY WOVEN PROTECTIVE FABRIC AROUND THE TRUNKS WHEN LOADING AND UNLOADING WITH MACHINE EQUIPMENT NO SCARRING OF TRUNKS WILL BE ACCEPTED AND MATERIALS THAT ARE SCARRED WILL BE REJECTED 19 ALL MATERIALS AND WORKMANSHIP WILL BE GUARANTEED FOR A PERIOD OF ONE YEAR AFTER FINAL


TO 90 DAYS AND BEGIN PHASE II WATER RESTRICTION SCHEDULE FOLLOWING THAT A SUMMARY IS

ON-SITE WORKERS OR PASSERSBY

ACCEPTANCE FROM FAILURE, DEATH, TERMINAL DECLINE, ETC THE WARRANTY PERIOD MAY BE EXTENDED BEYOND THAT TIMEFRAME IF, AT THE END OF ONE YEAR, ANY PLANTS ARE NOT IN A THRIVING STATE, INDICATIVE OF HEALTHY PLANTS OF EACH SPECIES 20 BEGIN WATERING ALL PLANT MATERIALS IMMEDIATELY AFTER INSTALLATION OR RELOCATION FOR RELOCATIONS SEE CARE AND WATERING SCHEDULE ABOVE FOR ALL NEW PLANTS, WATER ACCORDING TO SFWMD, BROWARD COUNTY AND CITY OF HOLLYWOOD REGULATIONS FOR NEW LANDSCAPE INSTALLATIONS UP

LANDSCAPING FROM 0-30 DAYS AFTER INSTALLATION WATERING CAN OCCUR ON ALL DAYS EXCEPT ON FRIDAYS FROM 30-90 DAYS, WATERING FOR NEW LANDSCAPING CAN OCCUR ON MONDAY, WEDNESDAY, THURSDAY, AND


- SATURDAY FOR BOTH ESTABLISHMENT WATERING PERIODS AND FINAL ESTABLISHED PERIOD, NO WATERING SHALL OCCUR BETWEEN 10 A M IN THE MORNING AND 4 P M IN THE AFTERNOON 21 ALL WORK WITHIN THESE PLANS TO BE DONE IN A SOUND, WORKMANLIKE MANNER, INDICATIVE OF THE PROFESSIONAL STANDARDS REGULATING EACH DISCIPLINE AND THE PERTINENT DIVISION OF THE CONSTRUCTION SPECIFICATIONS INSTITUTE, THE CITY OF HOLLYWOOD, AND ANY OTHER REGULATING OR GOVERNING AUTHORITY WORK WILL ONLY OCCUR WITHIN THE DAYS AND HOURS SPECIFIED WITHIN THE CODE OF ORDINANCES AND CONTRACTORS AND SUB-CONTRACTORS SHALL PERFORM WORK IN A SAFE, PROFESSIONAL MANNER WITHOUT UNNECESSARY DISTURBANCE TO THE SURROUNDING COMMUNITY, OTHER
- 22 ANY DAMAGE TO EXISTING CONDITIONS INCLUDING EXISTING LAWN AREA WILL BE RESTORED TO A CONDITION EQUAL TO OR EXCEEDING THE CONDITION AT TIME OF WORK COMMENCEMENT EXISTING LAWN REPAIR WILL BE DONE COMPLETE FOR ANY AND ALL DAMAGED AREAS AFFECTED BY WORK THIS INCLUDES MATCHING OF EXISTING GRASS SPECIES WITH WHOLE, CERTIFIED SOD LAID OVER 2" BLANKET OF HAND-RAKED, FINELY-GRADED TOPSOIL AFTER ANY NECESSARY EXCAVATION REQUIRED SO THAT NEW SOD MATCHES EXISTING OR PREVIOUS SOD IN APPEARANCE, ELEVATION, EXTENT, WITH CLEAN AND TIGHT JOINTS AND CUT IN PROPERLY SO THAT NEW AND EXISTING EDGES MEET SEAMLESSLY STAGGER JOINTS OF ALL NEW SOD SPECIES SHALL BE ST AUGUSTINE 'FLORATAM' VARIETY CERTIFIED TRUE TO NOMENCLATURE BY THE SUPPLIER ON RECEIPT IF EXISTING PLANTING BEDS ARE DAMAGED, RESTORE TO SAME CONDITION WITH SAME
- 23 ANY REFERENCE, MENTION OR INFERENCE OF 'PLANTING SOIL', 'AMENDED SOIL', 'SOIL MIX' OR THE LIKE SHALL MEAN A SPECIFIC SOIL MIX AS FOLLOWS 50-50 PERCENTAGE-BY-VOLUME RATIO, PRE-MIXED OFF SITE, AND COMPRISED OF 50% CLEAN, SCREENED SILICA SAND, AND 50% PULVERIZED FLORIDA MUCK, ALSO REFERRED TO AS TOPSOIL, FREE FROM ANY WEEDS, NEMATODES, SEEDS, AGGREGATE (OTHER THAN SPECIFIED SAND) OR OTHER DELETERIOUS MATERIALS AND PREPARED SPECIFICALLY FOR USE AS A SOIL AMENDMENT IN LANDSCAPING APPLICATIONS AN AMENDED ORGANIC OF COW MANURE OR ORGANIC PEAT IS ACCEPTABLE UP TO 10% OF THE TOTAL VOLUME OF THE MIX
- 24 CONTRACTOR SHALL SECURE ALL NECESSARY PERMITS PRIOR TO COMMENCING WORK BASED ON THESE
- 25 ALL BEDLINES FOR SHRUBS AND GROUNDCOVER TO HAVE FLOWING ARCS AS SHOWN CREATING AN ATTRACTIVE, ORGANIC AESTHETIC MULCHED BEDLINE EDGES WITH FLAT OR 'DEAD' AREAS THAT BREAK FROM THE CURVILINEAR NATURE WILL BE REJECTED

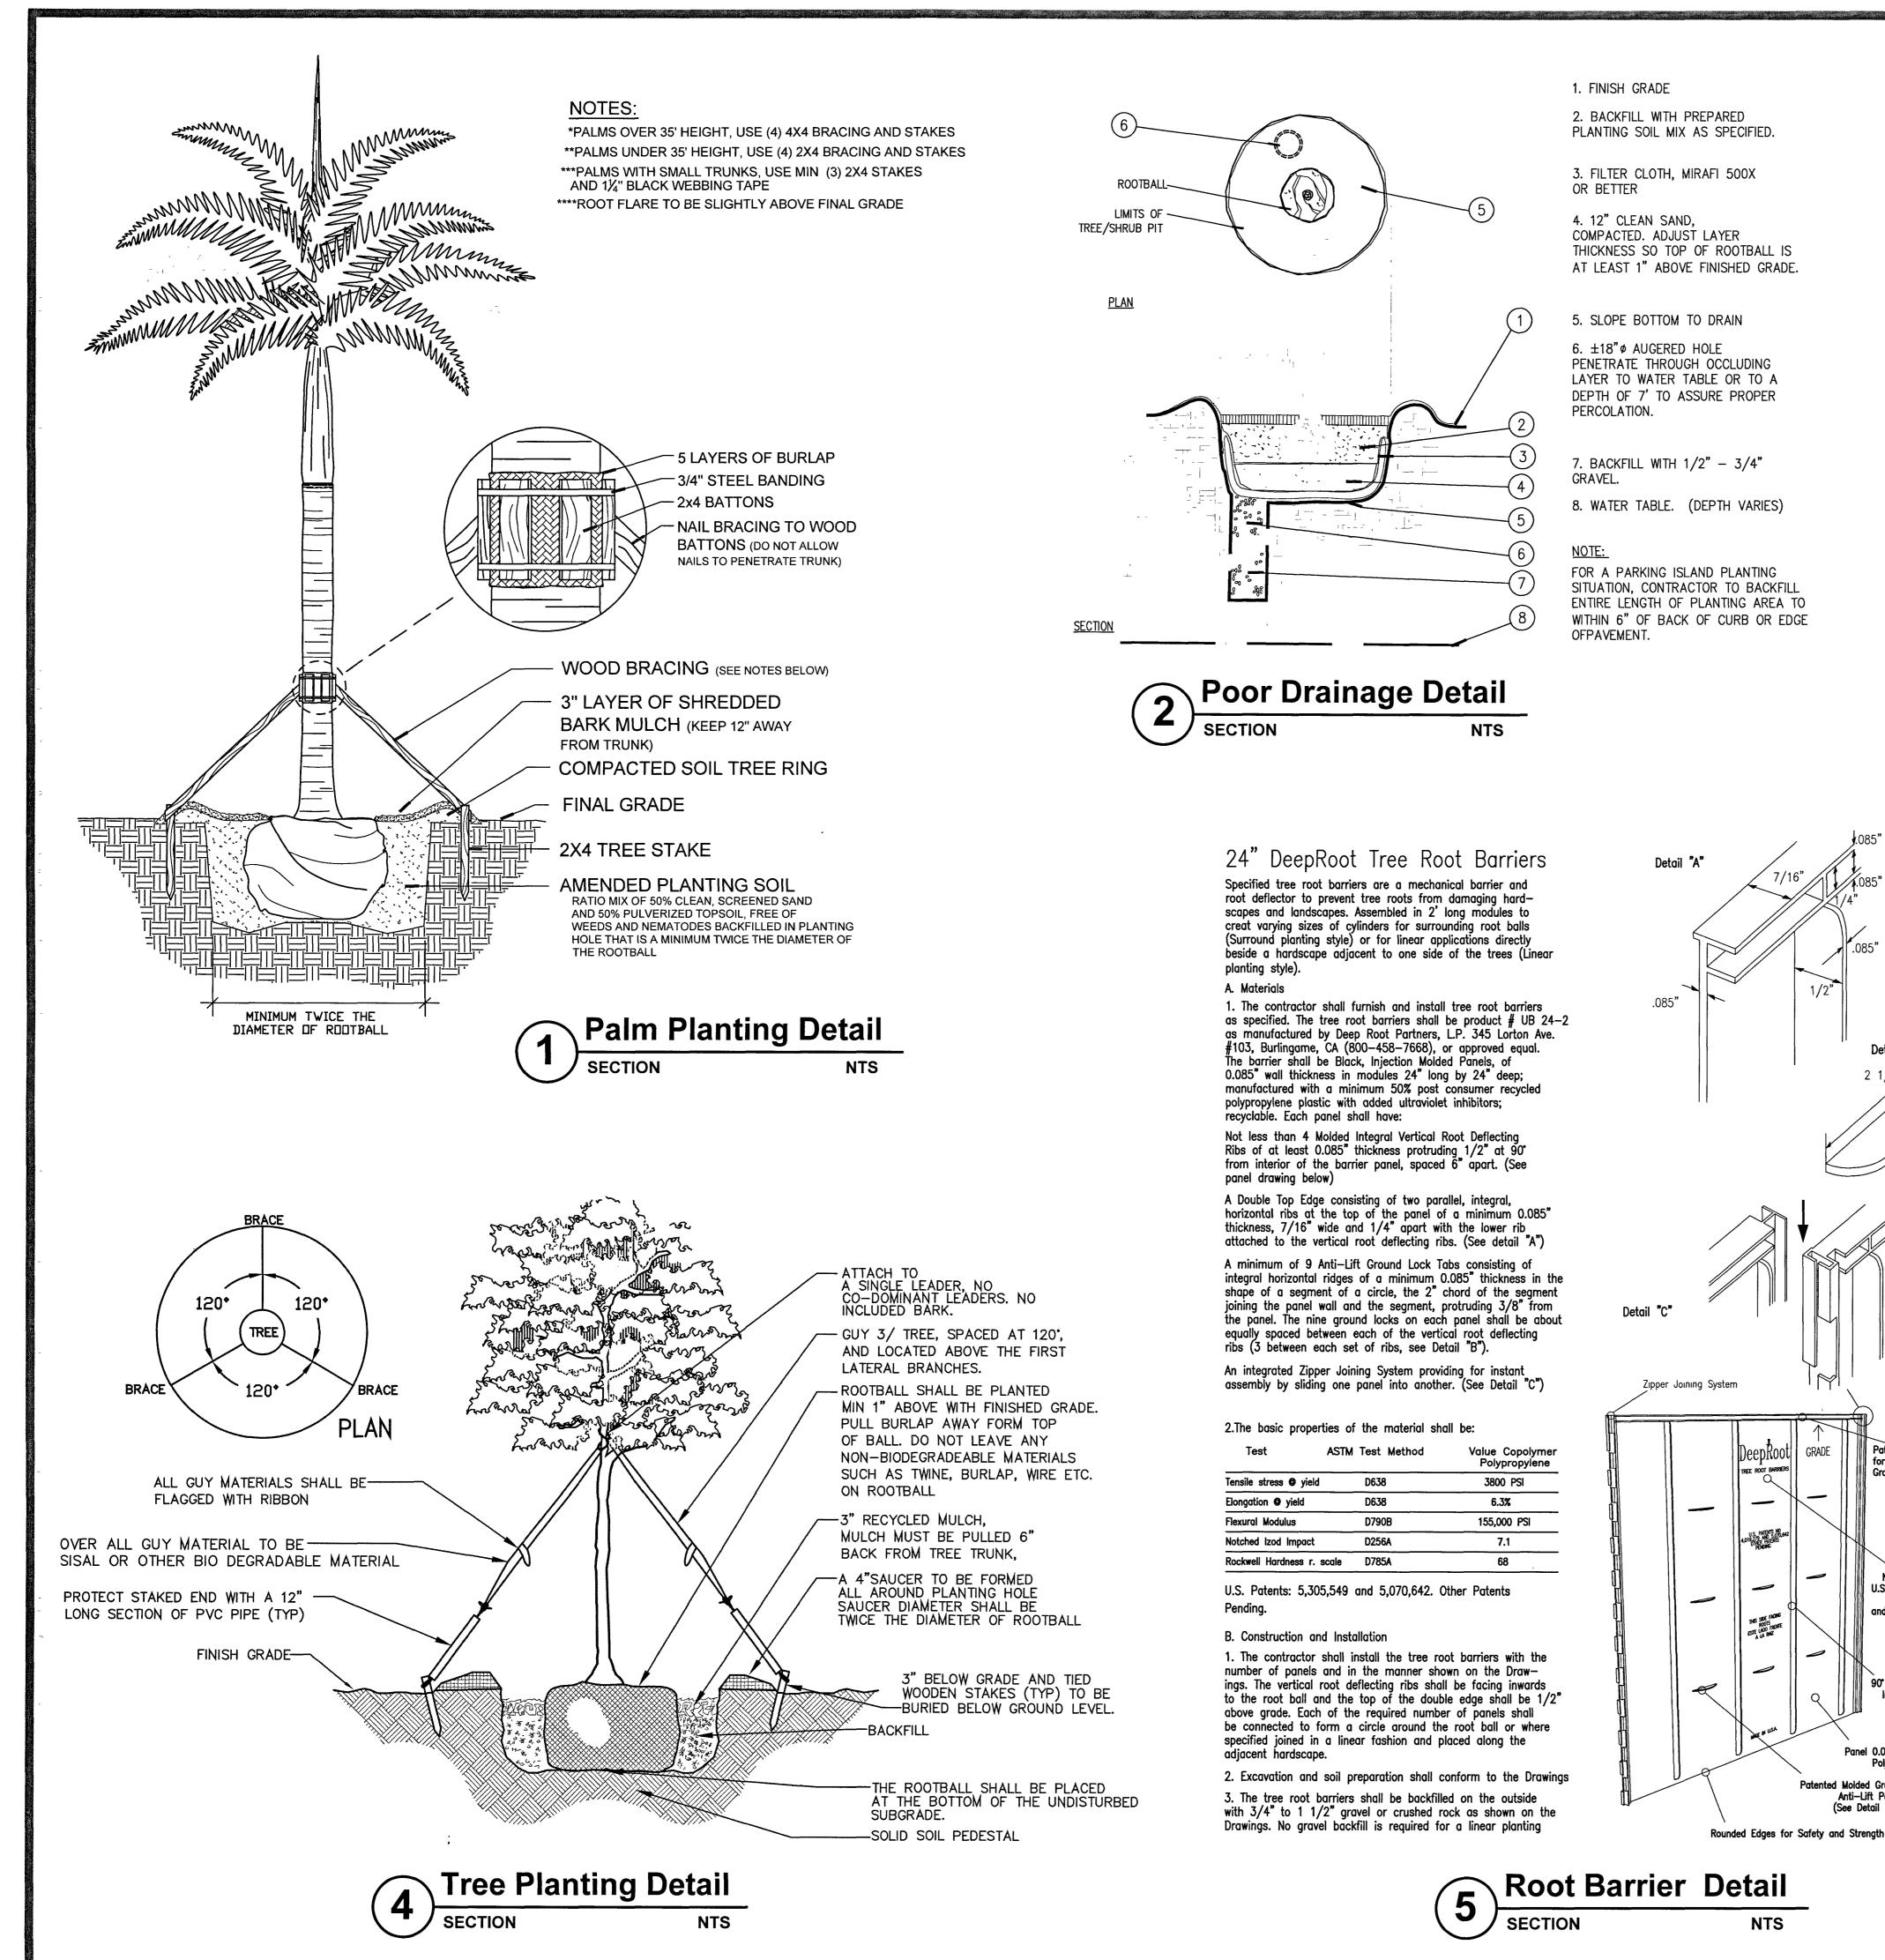


THICKNESS SO TOP OF ROOTBALL IS AT LEAST 1" ABOVE FINISHED GRADE.

SITUATION, CONTRACTOR TO BACKFILL ENTIRE LENGTH OF PLANTING AREA TO WITHIN 6" OF BACK OF CURB OR EDGE


SPACING BETWEEN ROWS TO BE AT A 60° ANGLE OF THE O.C. DISTANCE ALTERNATE SPACING OF PLANTS TO ASSURE PROPER COVERAGE OF GROUNDCOVER. 3" MINIMUM MULCH. SEE SPECIFICATIONS.

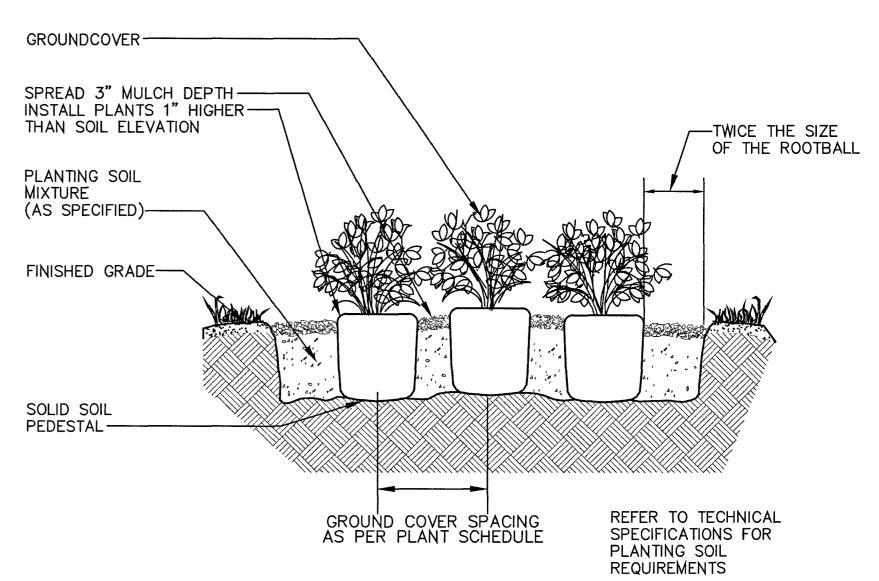

Shrub-Groundcover Planting Detail

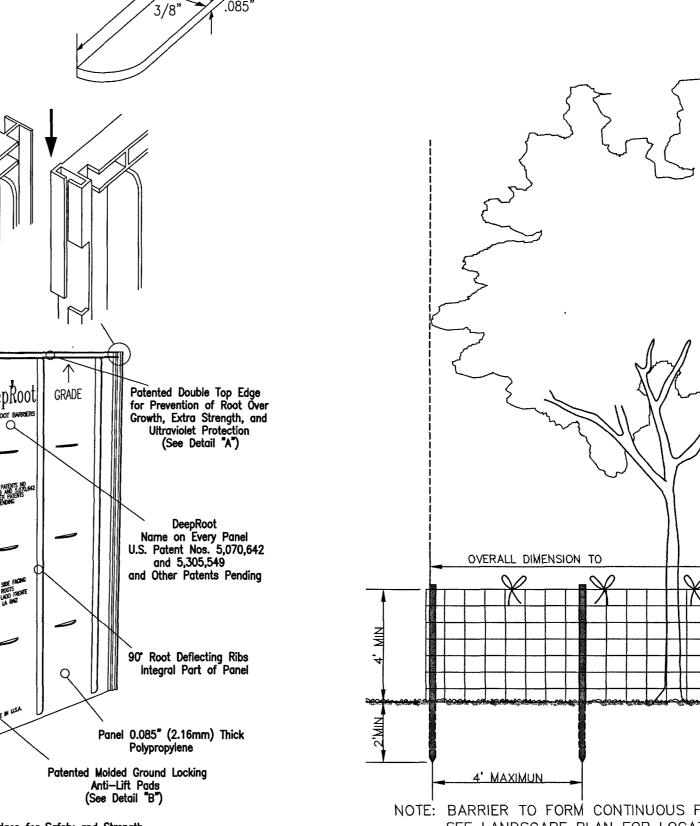

Detail "B"

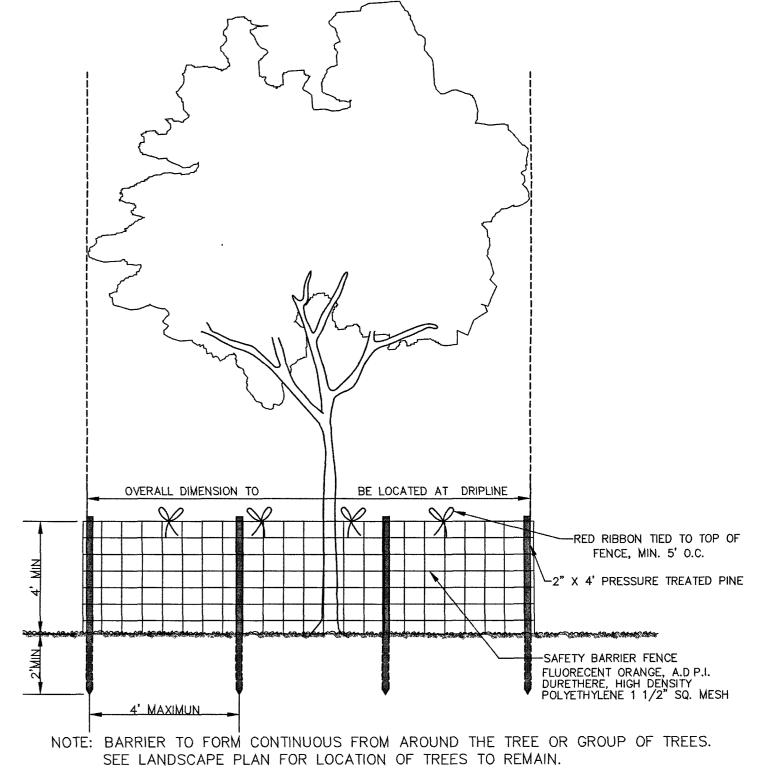




NDSC

2

BUILDING TREET

SHEET NUMBER L-201

NTS

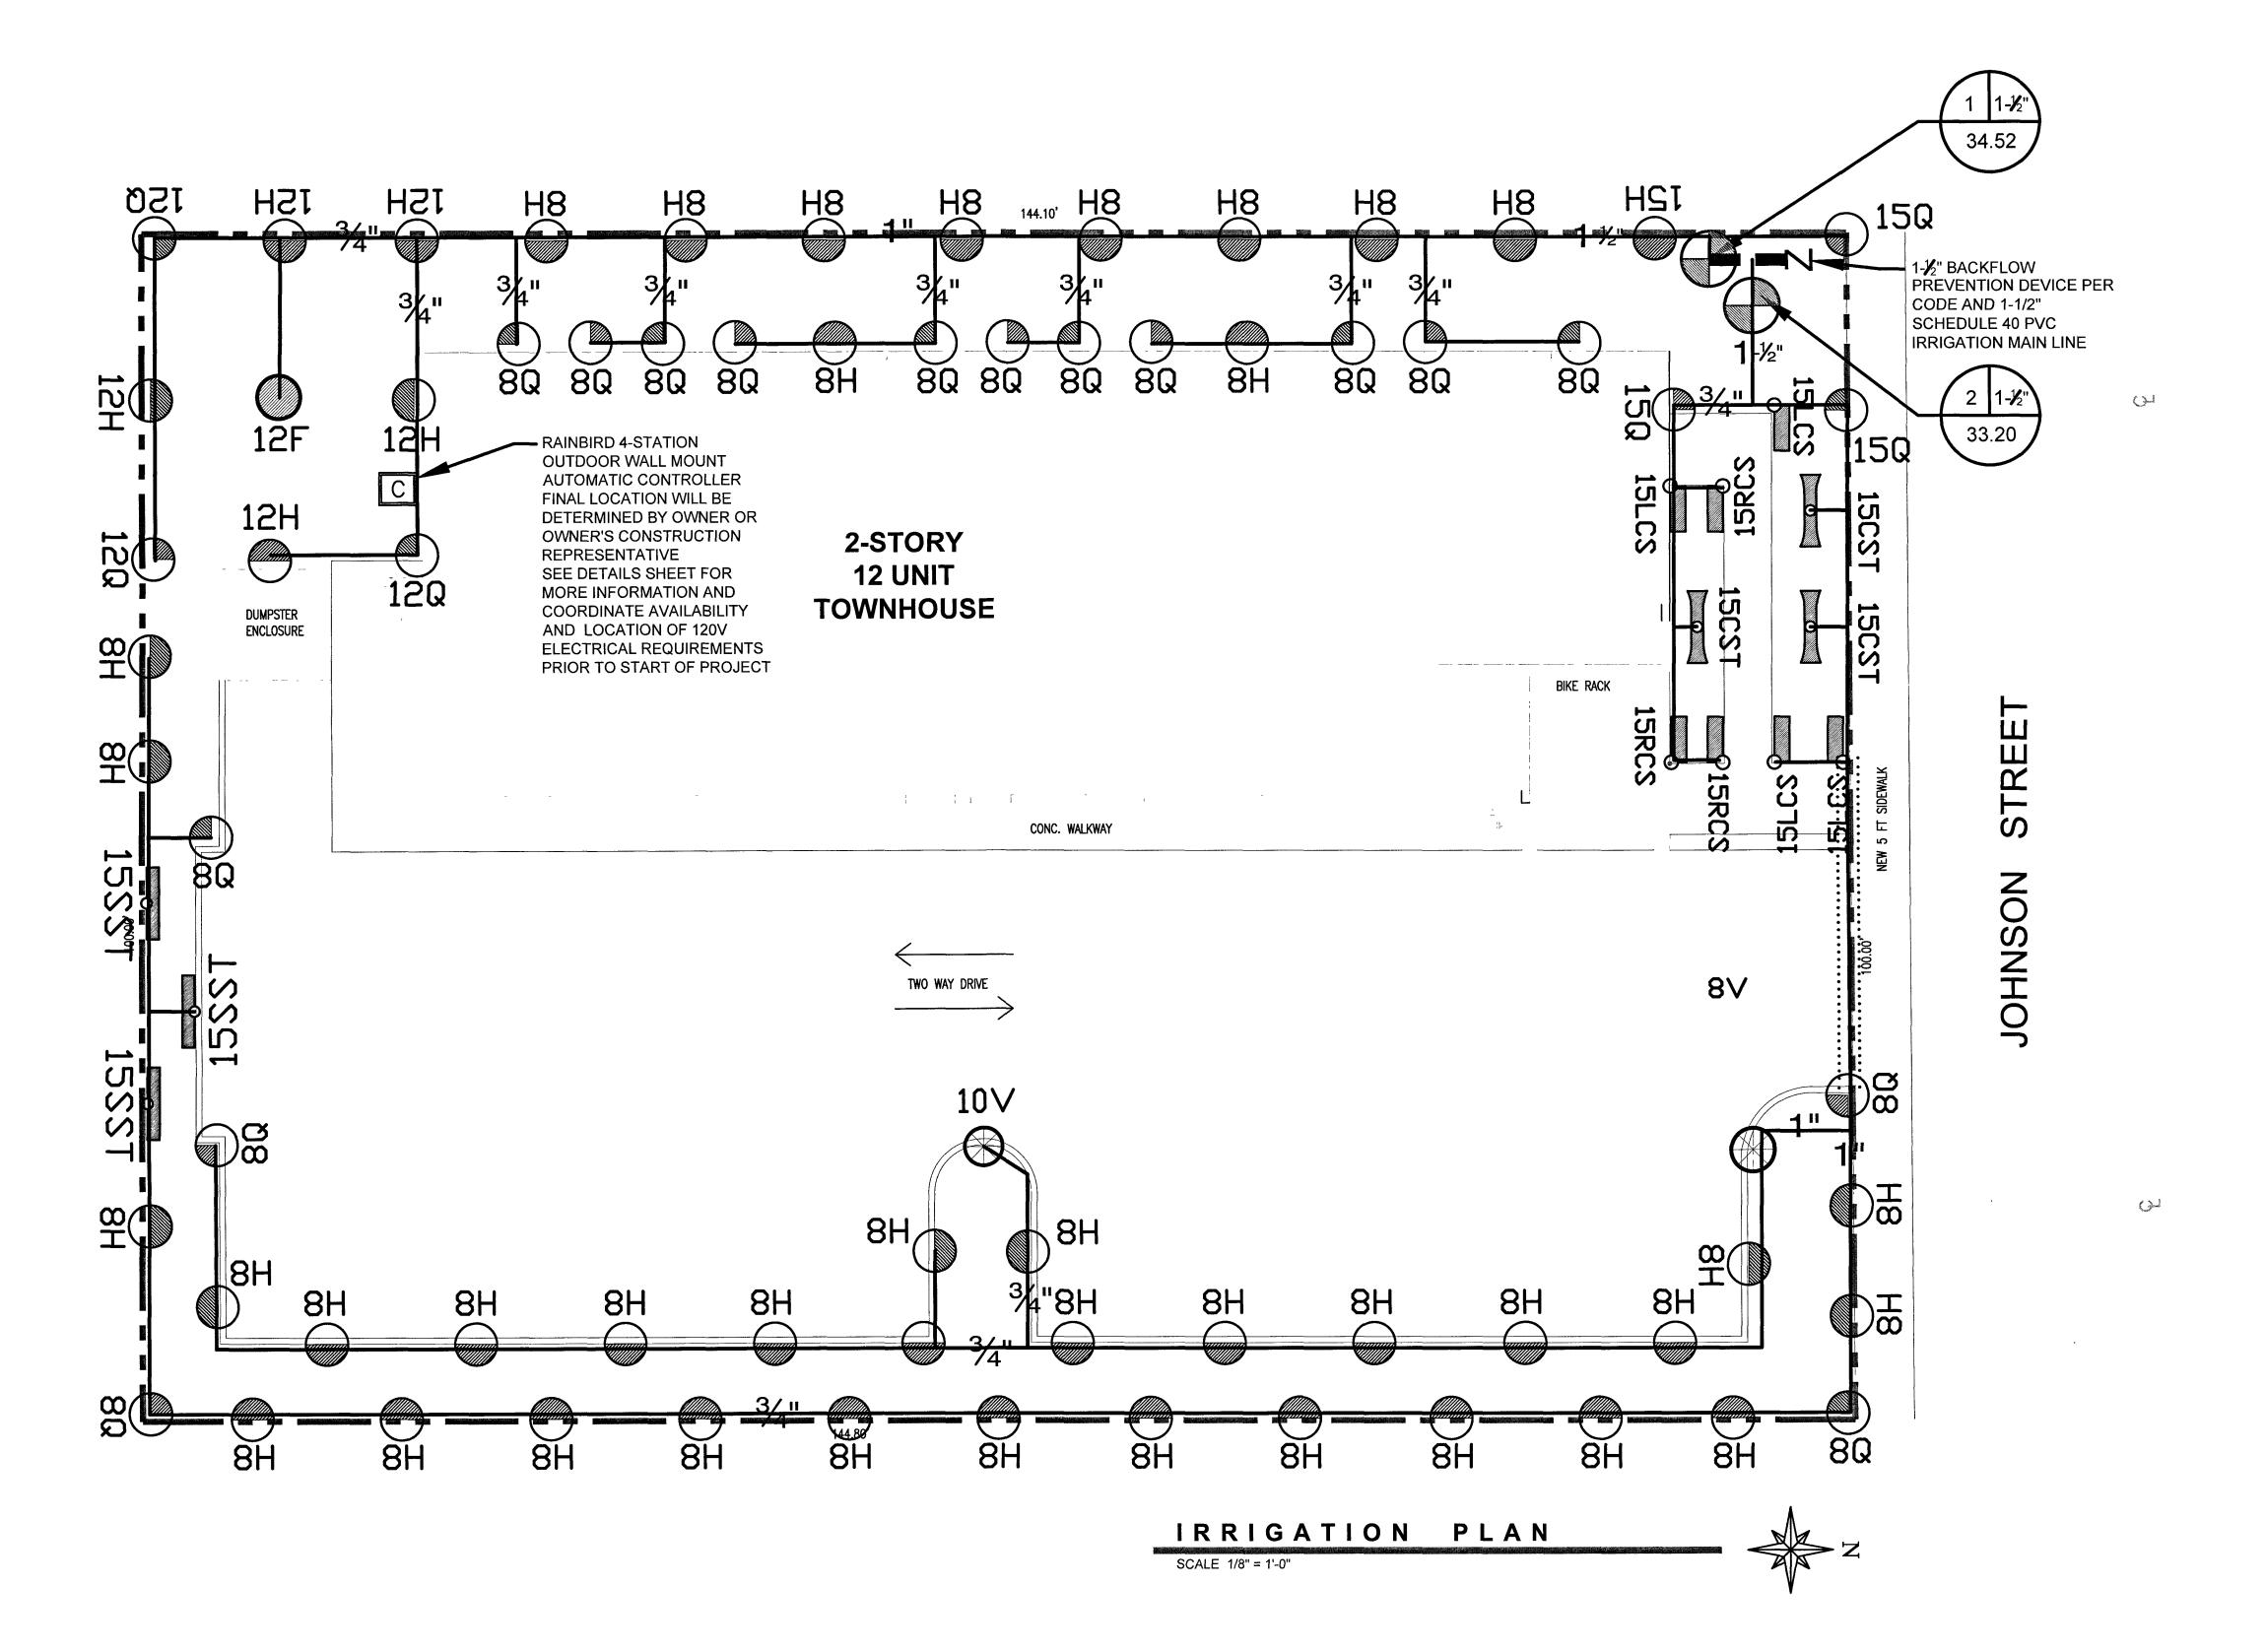


- 1 CONTRACTOR TO VISIT SITE AND REVIEW PLANS PRIOR TO SUBMITTING A PROPOSAL TO OWNER CONTRACTOR SHALL VERIFY SITE AND TREE INFORMATION, AND BRING ANY DISCREPANCIES WITHIN THE PLANS TO THE ATTENTION OF THE LANDSCAPE ARCHITECT FOR CLARIFICATION PRIOR TO SUBMITTING A PROPOSAL
- 2 THESE PLANS WERE PREPARED BASED ON THE BEST INFORMATION
- 3 CONTRACTOR TO VERIFY ALL UNDERGROUND UTILITIES BEFORE WORK COMMENCES AND SHALL PROTECT ALL UNDERGROUND/ABOVE GROUND
- 4 IRRIGATION SYSTEM WATER SOURCE WILL BE A NEW 1" IRRIGATION WATER METERED STATIC PRESSURE SOURCE SEE CIVIL DRAWINGS FOR TAP AND METER DETAILS
- 5 IRRIGATION CONTRACTOR TO COORDINATE WITH MEP ENGINEER AND GENERAL CONTRACTOR TO COORDINATE POWER NEEDS FOR AUTOMATIC CONTROLLER PRIOR TO PROJECT CONSTRUCTION ACTIVITIES THIS MUST BE DONE BEFORE PROJECT CONSTRUCTION BEGINS SO PROPER CALCULATIONS CAN BE DETERMINED AND PROPER INFRASTRUCTURE FOR IRRIGATION AND ELECTRICAL REQUIREMENTS ARE PROVIDED AS PART OF THE SCOPE OF THIS WORK, IRRIGATION CONTRACTOR SHALL PROVIDE SYSTEM COMPLETE AS SPECIFIED HEREIN, AND AS REQUIRED FOR PROPER PERFORMANCE TO PROVIDE 100% (HEAD-TO-HEAD) IRRIGATION COVERAGE OF ALL PERVIOUS PLANTED AREAS
- 6 THE SCOPE OF WORK INTENDED WHEN BIDDING ON THESE IRRIGATION PLANS IS TO PROVIDE A COMPLETE, COMPLIANT, SAFE, FULLY-OPERATIONAL, INSTALLED IRRIGATION SYSTEM ACCORDING TO THE DESIGNED IRRIGATION SYSTEM HEREIN THE IRRIGATION CONTRACTOR IS RESPONSIBLE FOR ALL COMPONENTS, APPROVALS, AND WORKMANSHIP TO MAKE THE SYSTEM FUNCTION PROPERLY AND IN ACCORDANCE WITH REGULATING CODES
- 7 CONTRACTOR WILL SECURE ALL NECESSARY PERMITS PRIOR TO SYSTEM INSTALLATION
- IF NOT INDICATED, A MIN OF 2 PIPE SIZES LARGER THAN THE SUPPLY LINE(S) CONTAINED ALL SLEEVES SHALL BE INSTALLED A MIN OF 18" BELOW FINISHED GRADE OF PAVEMENT OR AS REQUIRED BY SFWMD
- AND SHALL BE ARRANGED FOR EASY ADJUSTMENT AND ACCESS THE FLOW ADJUSTMENT FEATURE OF EACH VALVE SHALL BE UTILIZED TO BALANCE OPERATING PRESSURES THROUGHOUT THE SYSTEM VALVE BOXES SHALL BE INSTALLED FLUSH WITH GRADE AND SHALL INSURE PERCOLATION THROUGH THE BOX
- 10 WATERING TIME PER STATION WILL BE DETERMINED IN THE FIELD AND PER LOCAL REQUIREMENTS OR RESTRICTIONS REFER TO MANUFACTURER'S INSTRUCTIONS FOR PRECIPITATION RATES OF SPRINKLERS SPECIFIED AND SOUTH FLORIDA WATER MANAGEMENT DISTRICT REGULATIONS FOR WATERING, INCLUDING NEW LANDSCAPE INSTALLATIONS, INSTALLATIONS FROM 30-90 DAYS, AND REGULATIONS FOR ESTABLISHED LANDSCAPE
- 12. IRRIGATION PLAN IS SCHEMATIC AND MAY SHOW COMPONENTS SUCH AS VACUUM BREAKER, MAIN LINE, ZONE VALVES AND LATERAL LINES SLIGHTLY OFF FROM ACTUAL INTENDED LOCATIONS FOR GRAPHICAL CLARITY IRRIGATION CONTRACTOR TO ADJUST TO FIELD CONDITIONS AND INACCURACIES THAT ARE INHERENT WITH DRAWINGS AT 1 20 SCALE IRRIGATION CONTRACTOR TO CONTACT LANDSCAPE ARCHITECT FOR ANY SUBSTANTIAL CHANGES THAT WOULD NOT CONFORM TO THE INTENT OF THE IRRIGATION PLANS NO SUBSTITUTIONS IN MANUFACTURER MATERIALS WILL BE ACCEPTED UNLESS ACCEPTED IN WRITING BY THE LANDSCAPE ARCHITECT OF RECORD PRIOR TO ORDERING, PLANNING, OR INSTALLATION
- 14 USE RAINBIRD EXP-RZX BASIC SERIES 6-STATION OUTDOOR WALL MOUNT CONTROLLER OR APPROVED EQUAL IN A WALL MOUNTABLE STAINLESS STEEL SECURABLE ENCLOSURE ATTACH A HUNTER MINI-CLIK II RAIN
- 15 PLAN WAS DESIGNED BASED ON ASSUMPTION OF AT LEAST 40 PSI FROM NEW WATER METER
- 16 MAINLINE, LATERAL LINES, ZONE VALVES AND OTHER COMPONENTS ARE SHOWN SCHEMATICALLY TO MAINTAIN GRAPHICAL CLARITY ON THIS PLAN WHERE POSSIBLE KEEP MAIN LINE CLOSE TO WALL FOOTER, CURBS, AND EDGES OF PAVEMENT TO AVOID OBSTRUCTIONS OF FUTURE ROOT
- 17 NOT SHOWN GRAPHICALLY FOR CLARITY BUT INCLUDED IN ZONE CALCULATIONS, INCLUDE ONE BUBBLER NOZZLE FOR EACH NEW OR RELOCATED TREE ON SITE SET FLOW TO NO MORE THAN 25 GPM
- SEE SHEET L-301 FOR SPRINKLER SCHEDULE 19. RUN A MINIMUM OF TWO SPARE ZONE VALVE WIRES WITH MAIN LINE IN TWO DIFFERENT DIRECTIONS FROM CONTROLLER FOR FUTURE USE AS SPARE

IRRIGATION SYMBOL LEGEND



RAINBIRD PESB REMOTE ELECTRIC ZONE VALVE

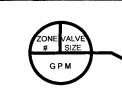

IRRIGATION ZONE CALLOUT

PIPE SIZE INDICATOR

1-1/2" SCHEDULE 40 PVC MAIN

SCHEDULE 200 LATERAL (CIRCUIT)

PIPE BEING SLEEVED)

PVC PIPE

• • • • SCHEDULE 80 PVC SLEEVE PIPE

• • • (MINIMUM TWICE THE SIZE OF



RAINBIRD ESP-RZX 4-ZONE PROGRAMMABLE CONTROLLER IN WALL MOUNT SECURABLE **ENCLOSURE WITH ATTACHED** RAIN SENSOR

NOTE INSTALL MANUAL BALL SHUTOFF VALVE DOWNSTREAM FROM POINT OF CONNECTION AND UPSTREAM FROM EACH ZONE VALVE BALL VALVES NOT SHOWN GRAPHICALLY FOR CLARITY

IRRIG

SHEET NUMBER

L-300

PI

BUILDING TREET), FL

IT APARTMENT BI 24 JOHNSON STR HOLLYWOOD, I

12

IRRIGATION NOTES AVAILABLE AT THE TIME OF DESIGN UTILITIES AND EXISTING CONDITIONS-TO-REMAIN DURING CONSTRUCTION 8 ALL SLEEVING SHALL BE SCHEDULE 80 PVC TO SIZE INDICATED ON PLAN, OR 9 ALL AUTOMATIC RAINBIRD VALVES SHALL BE INSTALLED IN A FIBERGLASS BOX

13 ALL MAIN AND LATERAL PIPING RUNS TO HAVE SOLVENT WELD JOINTS

SENSOR DEVICE PER MANUFACTURER'S INSTRUCTIONS

SYSTEMS

18 USE RAINBIRD 1800 SERIES SPRINKLER BODIES WITH NOZZLES AS SPECIFIED

WIRES


IRRIGATION SPRINKLER AND NOZZLE SCHEDULE


SYMBOL	DESCRIPTION	GPM	SYMBOL
5B <u>@</u>	RAINBIRD 5H STREAM BUBBLER NOZZLE ON FLEXIBLE PIPE	1.0	5'
€ \ 5Q	RAINBIRD 1806 OR 1812 PRS WITH 5Q MPR SPRAY NOZZLE	.10	5'
(4) 5H	RAINBIRD 1806 OR 1812 PRS WITH 5H MPR SPRAY NOZZLE	.20	5'
© 5F	RAINBIRD 1806 OR 1812 PRS WITH 5F MPR SPRAY NOZZLE	.41	5'
⊕ 6∨	RAINBIRD 1806 OR 1812 PRS WITH 6V VARIABLE ARC SPRAY NOZZLE	VARIES	6'
8 Q	RAINBIRD 1806 OR 1812 PRS WITH 8Q MPR SPRAY NOZZLE	.26	8'
8 H	RAINBIRD 1806 OR 1812 PRS WITH 8H MPR SPRAY NOZZLE	.52	8'
Ø 8F	RAINBIRD 1806 OR 1812 PRS WITH 8F MPR SPRAY NOZZLE	1.05	8'
₩ 8V	RAINBIRD 1806 OR 1812 PRS WITH 8V VARIABLE ARC SPRAY NOZZLE	VARIES	8'
10Q	RAINBIRD 1806 OR 1812 PRS WITH 10Q MPR SPRAY NOZZLE	.39	10'
10H	RAINBIRD 1806 OR 1812 PRS WITH 10H MPR SPRAY NOZZLE	.79	10'
10F	RAINBIRD 1806 OR 1812 PRS WITH 10F MPR SPRAY NOZZLE	1.58	10'
₩ 10∨	RAINBIRD 1806 OR 1812 PRS WITH 10V VARIABLE ARC SPRAY NOZZLE	VARIES	10'
120	RAINBIRD 1806 OR 1812 PRS WITH 12Q MPR SPRAY NOZZLE	.65	12'
© 12T	RAINBIRD 1806 OR 1812 PRS WITH 12T MPR SPRAY NOZZLE	.87	12'
12H	RAINBIRD 1806 OR 1812 PRS WITH 12H MPR SPRAY NOZZLE	1.30	12'
12TQ	RAINBIRD 1806 OR 1812 PRS WITH 12TQ MPR SPRAY NOZZLE	1.95	12'
	RAINBIRD 1806 OR 1812 PRS WITH 12F MPR SPRAY NOZZLE	2.60	12'
12F	RAINBIRD 1806 OR 1812 PRS WITH 12V VARIABLE ARC SPRAY NOZZLE	VARIES	12'
9 15Q	RAINBIRD 1806 OR 1812 PRS WITH 15Q MPR SPRAY NOZZLE	.92	15'
© 15T	RAINBIRD 1806 OR 1812 PRS WITH 15T MPR SPRAY NOZZLE	1.23	15'
2 15H	RAINBIRD 1806 OR 1812 PRS WITH 15H MPR SPRAY NOZZLE	1.85	15'
9 15TQ	RAINBIRD 1806 OR 1812 PRS WITH 15TQ MPR SPRAY NOZZLE	2.78	15'
0 15F	RAINBIRD 1806 OR 1812 PRS WITH 15F MPR SPRAY NOZZLE	3.70	15'
⊕ 15∨	RAINBIRD 1806 OR 1812 PRS WITH 15V VARIABLE ARC SPRAY NOZZLE	VARIES	15'
15EST	RAINBIRD 1806 OR 1812 PRS WITH 15EST MPR STRIP SPRAY NOZZLE	.61	4'X15
15CST	RAINBIRD 1806 OR 1812 PRS WITH 15CST MPR STRIP SPRAY NOZZLE	1.21	4'X30
15LCS	RAINBIRD 1806 OR 1812 PRS WITH 15LCS MPR STRIP SPRAY NOZZLE	.49	4'X15
15RCS	RAINBIRD 1806 OR 1812 PRS WITH 15RCS MPR STRIP SPRAY NOZZLE	.49	4'X15
15SST	RAINBIRD 1806 OR 1812 PRS WITH 15SST MPR STRIP SPRAY NOZZLE	1.21	4'X30
TZZ	RAINBIRD 1806 OR 1812 PRS WITH 9SST MPR STRIP SPRAY NOZZLE	1.21	9'X18
O PDP-ADJ	HUNTER PDP-ADJ ADJUSTABLE GEAR DRIVE POP-UP ROTOR HEAD	2.5	35'
O 6504	RAINBIRD 6504 GEAR DRIVE POP-UP ROTOR HEAD WITH STAINLESS STEEL SHAFT	5.5	45'

IRRIGATION DETAILS


NOTE. RAINBIRD 1806 SPRINKLERS TO BE INSTALLED FOR LOW GROUNDCOVER AREAS AND ALL TURF AREAS WHERE POP-UP SPRAY HEADS ARE SPECIFIED MPR NOZZLES (SIZE PER PLAN) FINISHED GRADE --- RAINBIRD 1806 SPRINKLER - BARBED MALE ELL - FLEX PIPE --- LATERAL PIPE __LATERAL TEE

RAINBIRD 1806 SPRINKLER

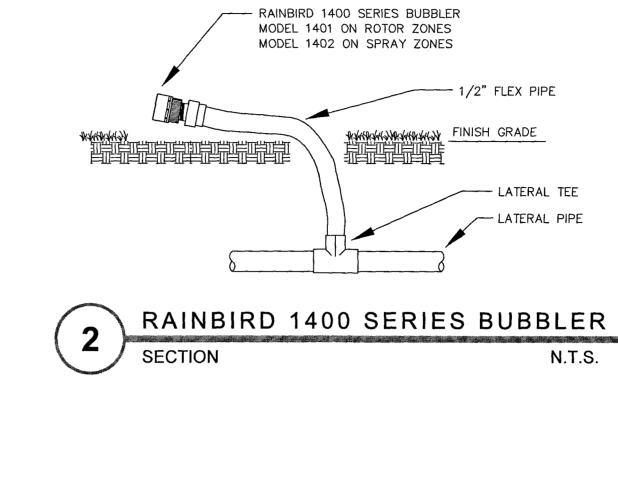

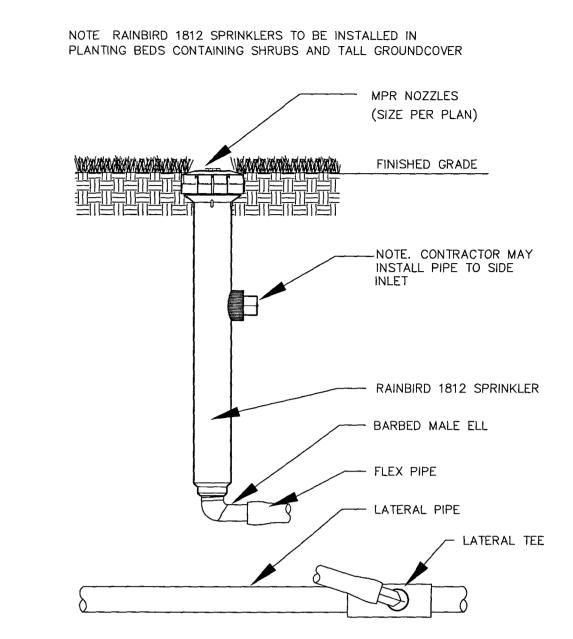



RAINBIRD 1812 SPRINKLER

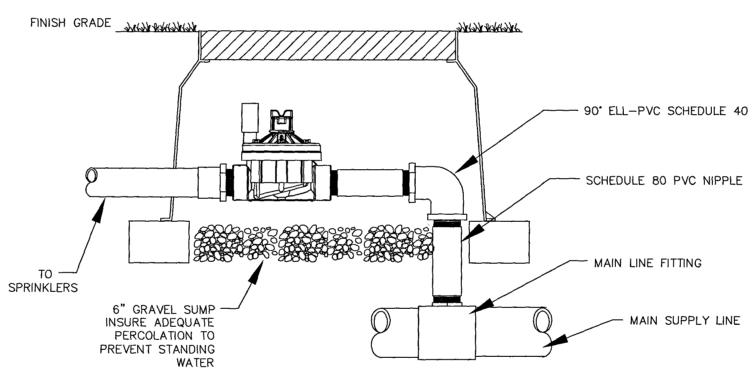


N.T.S.

NOTE FOR REUSE, GREY WATER, LAKE/CANAL, AND WELL-PUMP SOURCES USE PESB-R SERIES VALVES FOR NON-POTABLE SOURCES USE LOCKING PURPLE COVER, PURPLE PIPE AND PURPLE HEAD COVERS

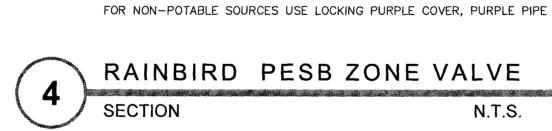


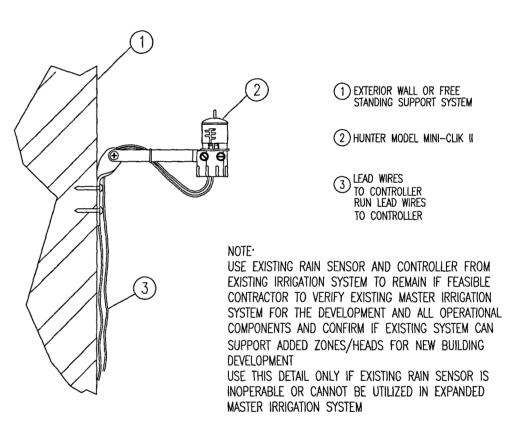



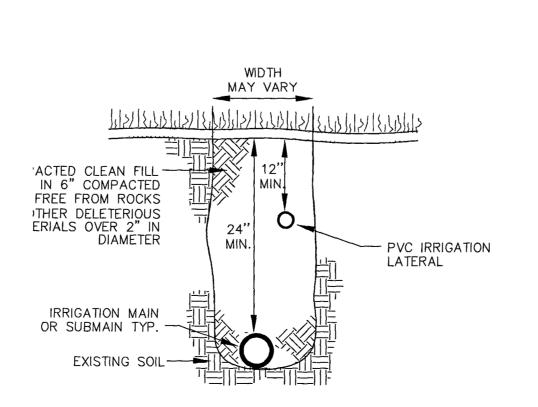

IRRIGATION TRENCHING DETAIL SECTION NT.S.

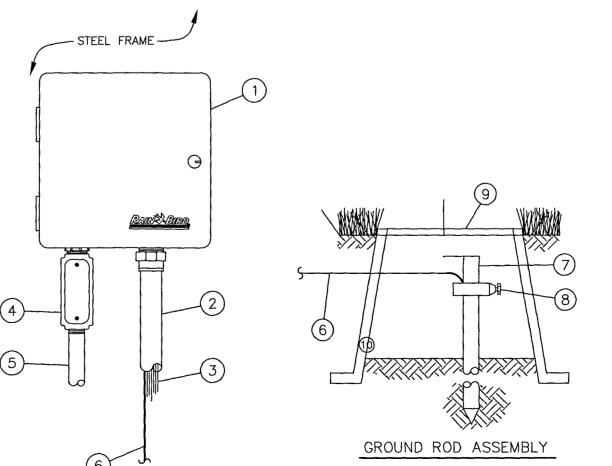

- CONTROLLER: RAIN BIRD ESP-RZX 4-STATION CONTROLLER OUTDOOR WALL MOUNT
- 2) 1.5-INCH PVC SCH 40 CONDUIT AND FITTINGS
- 3) WIRES TO REMOTE CONTROL VALVES
- 4 JUNCTION BOX
- 5) 1-INCH PVC SCH 40 CONDUIT AND FITTINGS TO POWER SUPPLY
- 6 BARE COPPER WIRE (#10 AWG MIN.): CONNECT TO GROUNDING BUSS IN CONTROLLER CABINET AND ROUTE TO GROUND ROD. PATH TO GROUND ROD SHOULD BE AS STRAIGHT AS POSSIBLE.
- 7) 5/8-INCH X 8 FT COPPER CLAD GROUNDING ROD OR GROUNDING PLATE.
- (8) GROUND ROD CLAMP OR WELDS
- COVER GROUNDING ROD WITH 10-INCH ROUND
 VALVE BOX AS SHOWN
- 10 FINISH GRADE



UNIT APARTMENT BUILDING 2324 JOHNSON STREET HOLLYWOOD, FL 12

H


L-301

SHEET NUMBER


IRRIGATION SPRINKLER AND NOZZLE SCHEDULE

SYMBOL	DESCRIPTION	G P.M.	SYMBO
5B <u>@</u>	RAINBIRD 5H STREAM BUBBLER NOZZLE ON FLEXIBLE PIPE	1.0	5'
5 Q	RAINBIRD 1806 OR 1812 PRS WITH 5Q MPR SPRAY NOZZLE	.10	5'
9 5H	RAINBIRD 1806 OR 1812 PRS WITH 5H MPR SPRAY NOZZLE	.20	5'
O 5F	RAINBIRD 1806 OR 1812 PRS WITH 5F MPR SPRAY NOZZLE	.41	5'
⊕ 6∨	RAINBIRD 1806 OR 1812 PRS WITH 6V VARIABLE ARC SPRAY NOZZLE	VARIES	6'
8 Q	RAINBIRD 1806 OR 1812 PRS WITH 8Q MPR SPRAY NOZZLE	.26	8'
8H	RAINBIRD 1806 OR 1812 PRS WITH 8H MPR SPRAY NOZZLE	.52	8'
Ø 8F ⊕	RAINBIRD 1806 OR 1812 PRS WITH 8F MPR SPRAY NOZZLE	1.05	8'
₩ 8∨	RAINBIRD 1806 OR 1812 PRS WITH 8V VARIABLE ARC SPRAY NOZZLE	VARIES	8'
10Q	RAINBIRD 1806 OR 1812 PRS WITH 10Q MPR SPRAY NOZZLE	.39	10'
10H	RAINBIRD 1806 OR 1812 PRS WITH 10H MPR SPRAY NOZZLE	.79	10'
2 00	RAINBIRD 1806 OR 1812 PRS WITH 10F MPR SPRAY NOZZLE	1.58	10'
₩ 10∨	RAINBIRD 1806 OR 1812 PRS WITH 10V VARIABLE ARC SPRAY NOZZLE	VARIES	10'
12Q	RAINBIRD 1806 OR 1812 PRS WITH 12Q MPR SPRAY NOZZLE	.65	12'
12T	RAINBIRD 1806 OR 1812 PRS WITH 12T MPR SPRAY NOZZLE	.87	12'
12H	RAINBIRD 1806 OR 1812 PRS WITH 12H MPR SPRAY NOZZLE	1.30	12'
12TQ	RAINBIRD 1806 OR 1812 PRS WITH 12TQ MPR SPRAY NOZZLE	1.95	12'
12F	RAINBIRD 1806 OR 1812 PRS WITH 12F MPR SPRAY NOZZLE	2.60	12'
12V	RAINBIRD 1806 OR 1812 PRS WITH 12V VARIABLE ARC SPRAY NOZZLE	VARIES	12'
15Q	RAINBIRD 1806 OR 1812 PRS WITH 15Q MPR SPRAY NOZZLE	.92	15'
15Q 15T	RAINBIRD 1806 OR 1812 PRS WITH 15T MPR SPRAY NOZZLE	1.23	15'
15H	RAINBIRD 1806 OR 1812 PRS WITH 15H MPR SPRAY NOZZLE	1.85	15'
1510 15TQ	RAINBIRD 1806 OR 1812 PRS WITH 15TQ MPR SPRAY NOZZLE	2.78	15'
15 F	RAINBIRD 1806 OR 1812 PRS WITH 15F MPR SPRAY NOZZLE	3.70	15'
∰ 15∨	RAINBIRD 1806 OR 1812 PRS WITH 15V VARIABLE ARC SPRAY NOZZLE	VARIES	15'
15EST	RAINBIRD 1806 OR 1812 PRS WITH 15EST MPR STRIP SPRAY NOZZLE	.61	4'X15
15CST	RAINBIRD 1806 OR 1812 PRS WITH 15CST MPR STRIP SPRAY NOZZLE	1.21	4'X30
15LCS	RAINBIRD 1806 OR 1812 PRS WITH 15LCS MPR STRIP SPRAY NOZZLE	.49	4'X15
15RCS	RAINBIRD 1806 OR 1812 PRS WITH 15RCS MPR STRIP SPRAY NOZZLE	.49	4'X15
15SST	RAINBIRD 1806 OR 1812 PRS WITH 15SST MPR STRIP SPRAY NOZZLE	1.21	4'X30
T228	RAINBIRD 1806 OR 1812 PRS WITH 9SST MPR STRIP SPRAY NOZZLE	1.21	9'X18
D PDP-ADJ	HUNTER PDP-ADJ ADJUSTABLE GEAR DRIVE POP-UP ROTOR HEAD	2.5	35'
6504	RAINBIRD 6504 GEAR DRIVE POP-UP ROTOR HEAD WITH STAINLESS STEEL SHAFT	5.5	45'

IRRIGATION DETAILS

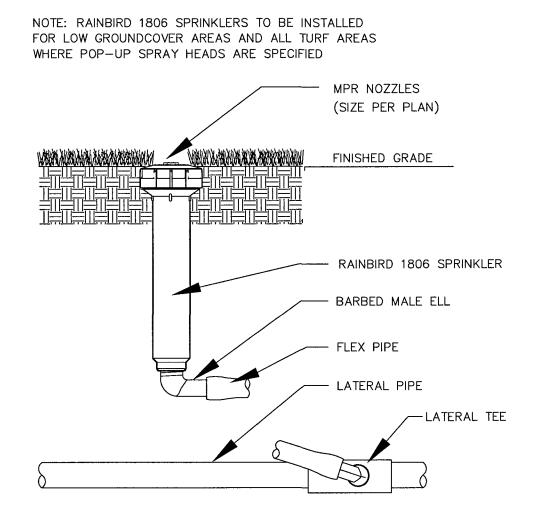

RAINBIRD 1806 SPRINKLER

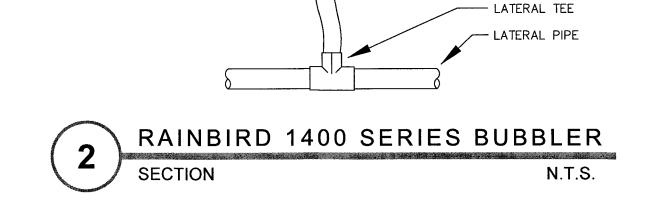


- RAINBIRD 1400 SERIES BUBBLER

MODEL 1401 ON ROTOR ZONES

MODEL 1402 ON SPRAY ZONES


- 1/2" FLEX PIPE

FINISH GRADE

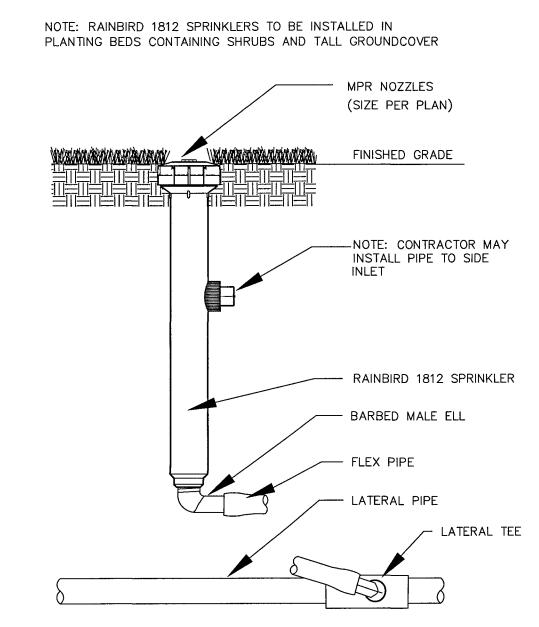


RAINBIRD 1812 SPRINKLER


SECTION

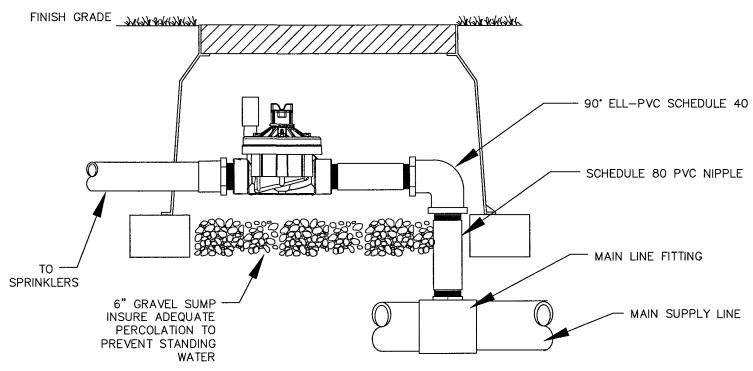


N.T.S.

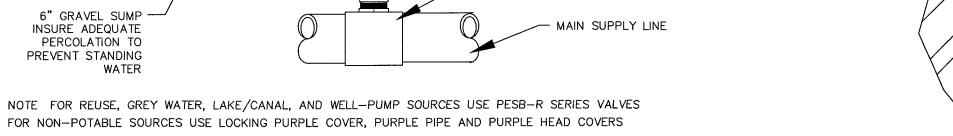

N.T S

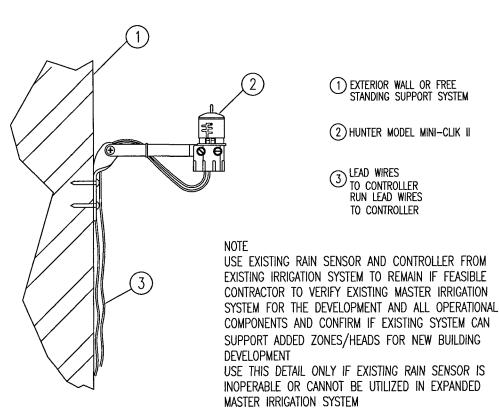




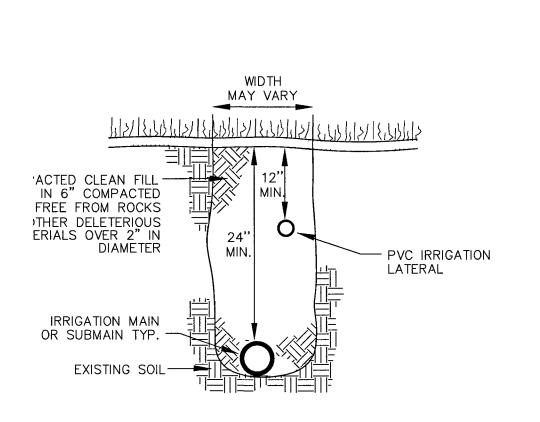

RAINBIRD PESB ZONE VALVE

SECTION



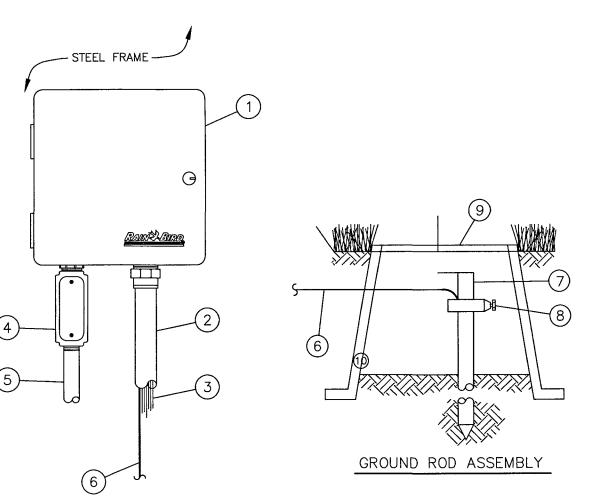

- CONTROLLER. RAIN BIRD ESP-RZX 4-STATION CONTROLLER OUTDOOR WALL MOUNT
- 2 1.5-INCH PVC SCH 40 CONDUIT AND FITTINGS

 3 WIRES TO REMOTE CONTROL VALVES
- 4 JUNCTION BOX
- 5 1-INCH PVC SCH 40 CONDUIT AND FITTINGS TO POWER SUPPLY
- BARE COPPER WIRE (#10 AWG MIN.): CONNECT TO GROUNDING BUSS IN CONTROLLER CABINET AND ROUTE TO GROUND ROD. PATH TO GROUND ROD SHOULD BE AS STRAIGHT AS POSSIBLE
- 7) 5/8-INCH X 8 FT COPPER CLAD GROUNDING ROD OR GROUNDING PLATE
- 8 GROUND ROD CLAMP OR WELDS
- 9 COVER GROUNDING ROD WITH 10-INCH ROUND VALVE BOX AS SHOWN
- 10 FINISH GRADE

7 RAINBIRD PROGRAMMABLE CONTROLLER
SECTION N.T.S


UNIT APARTMENT BUILDING 2324 JOHNSON STREET HOLLYWOOD, FL


12


H

SHEET NUMBER

L-301

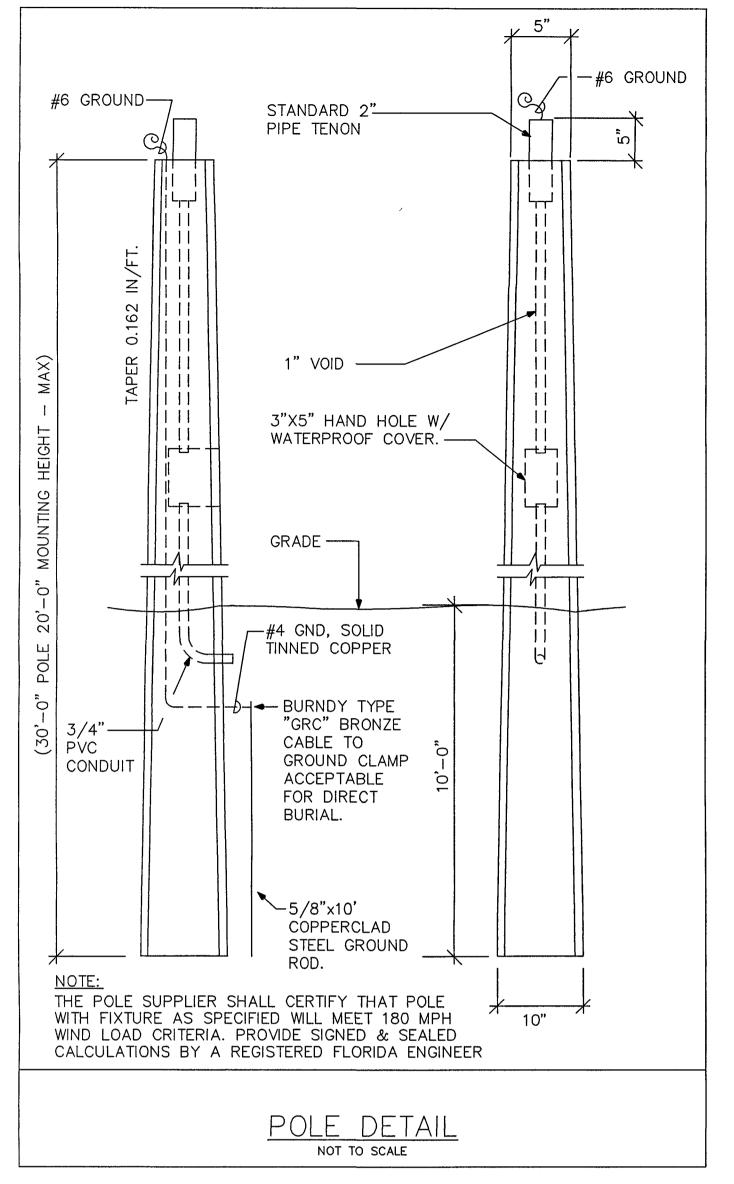

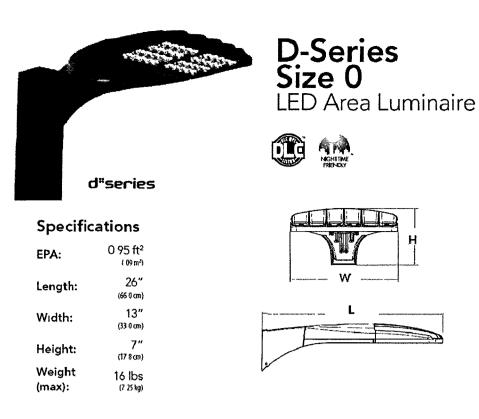


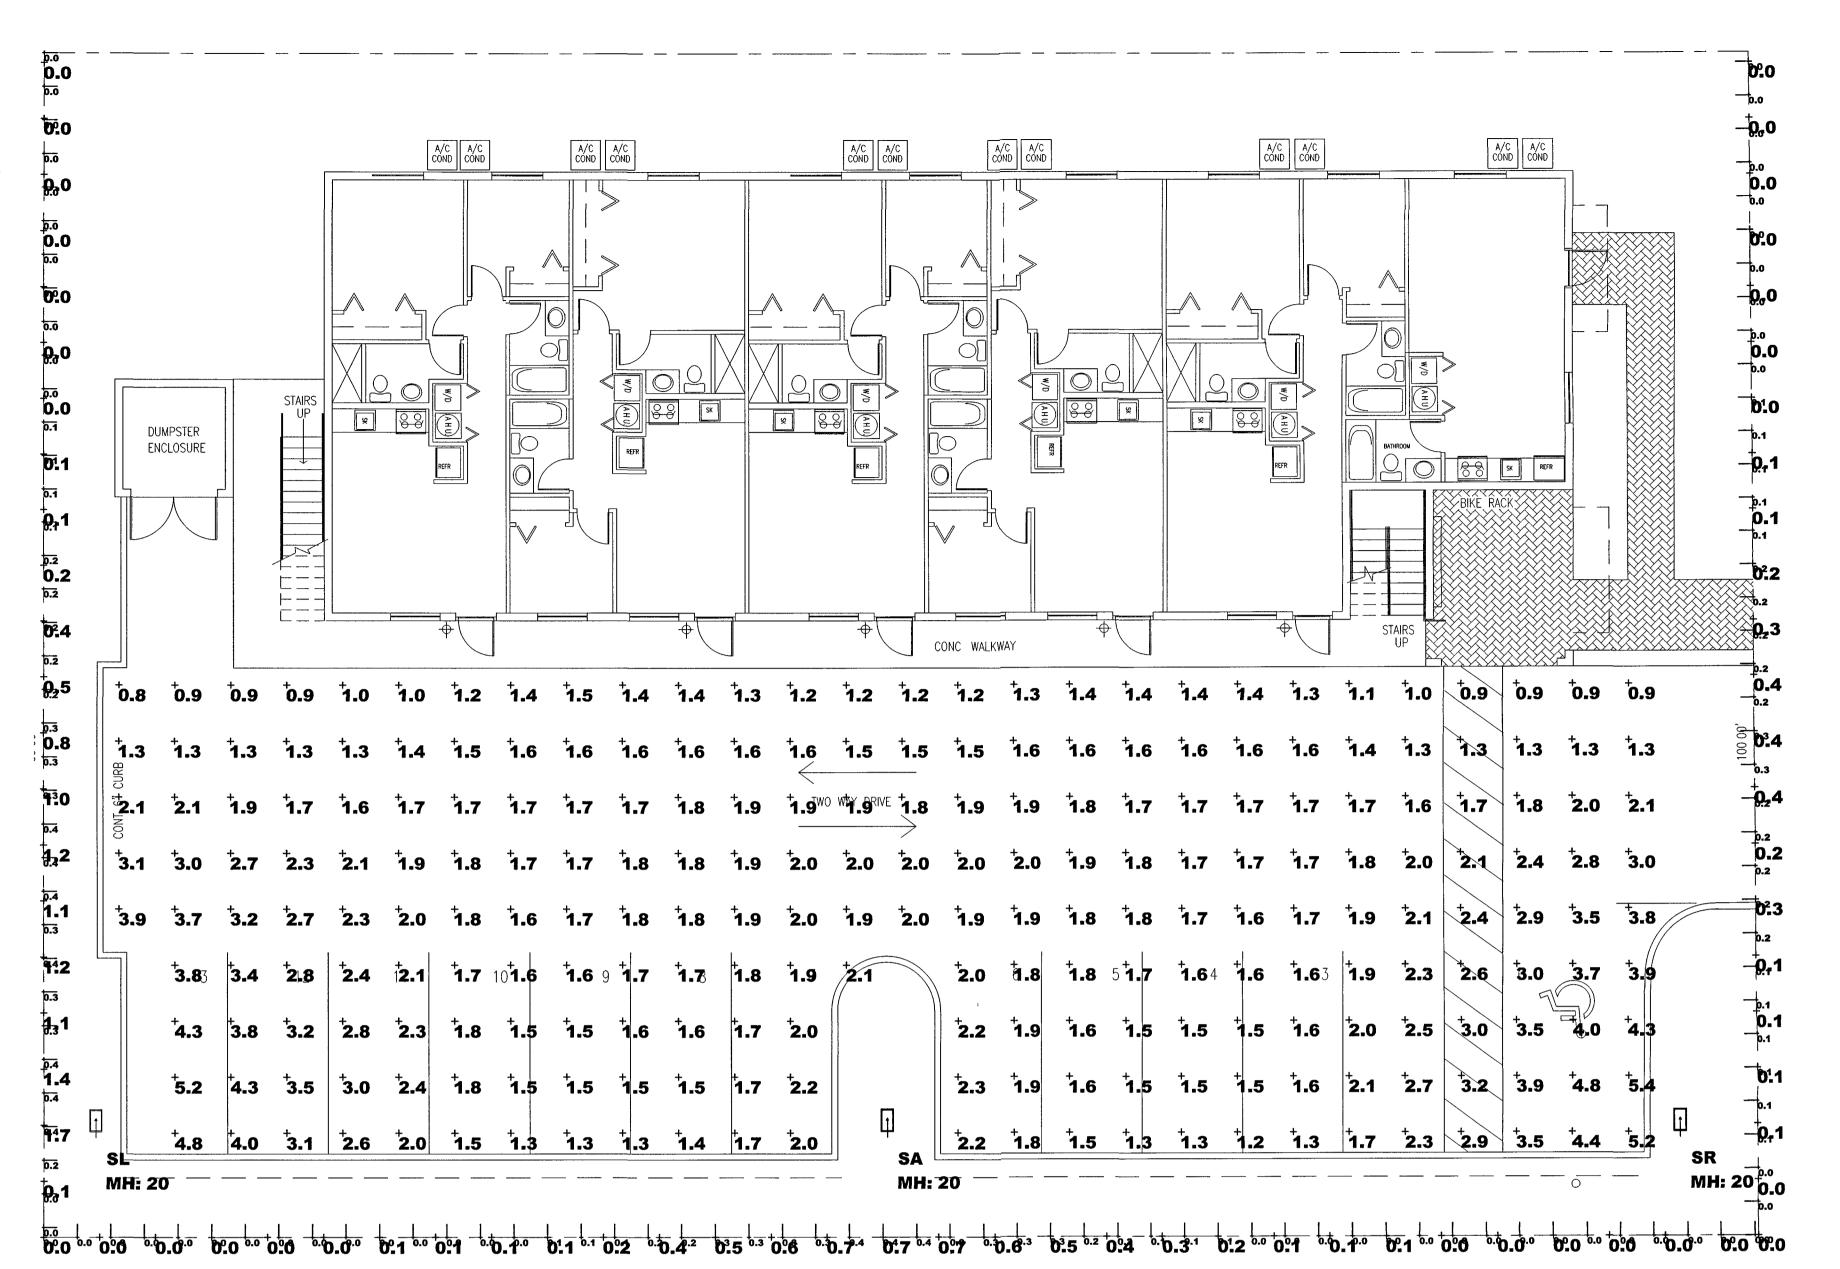


PHOTOMETRIC PLAN

SCALE: 1/8" = 1'-0"

Calculation Summary									
Project: 12 UNITS APARTMENTS - SITE HOLLYWOOD, FL 03/13/2018									
Label	CalcType	Units	Avg	Мах	Min	Avg/Min	Max/Min		
PARKING LOT	Illuminance	Fc	2.01	5.4	0.8	2.51	6.75		
PROPERTY LINE EAST (Horizontal)	Illuminance	Fc	0.21	0.7	0.0	N.A.	N.A.		
PROPERTY LINE EAST (Vertical)	Illuminance	Fc	0.10	0.4	0.0	N.A.	N.A.		
PROPERTY LINE NORTH (Horizontal)	Illuminance	Fc	0.13	0.4	0.0	N.A.	N.A.		
PROPERTY LINE NORTH (Vertical)	Illuminance	Fc	0.10	0.3	0.0	N.A.	N.A.		
PROPERTY LINE SOUTH (Horizontal)	Illuminance	Fc	0.50	1.7	0.0	N.A.	N.A.		
PROPERTY LINE SOUTH (Vertical)	Illuminance	Fc	0.17	0.4	0.0	N.A.	N.A.		

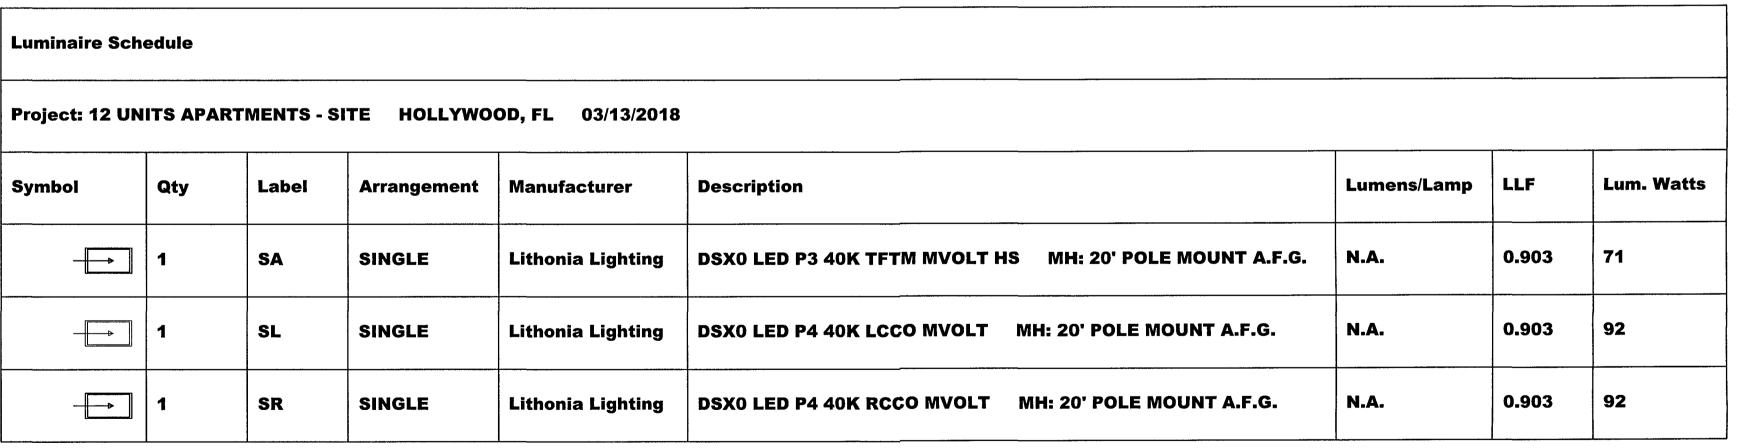

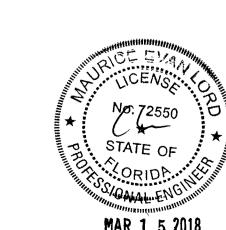

MAR 1 5 2018 BUCHANAN P.E. CONSULTING INC. ELECTRICAL * MECHANICAL * PLUMBING ENGINEERING 6191 W. ATLANTIC BLVD, SUITE# 2 MARGATE, FL 33063 Ph: 954-590-3300 Fax⁻ 954-590-2232 Email· BUCHANAN@MEPENGINEERS COM CERTIFICATE OF AUTHORIZATION # 8842

Diego ge Miguel
ARCH

CHECKED DRAWN DATE 3-9-2018

COMM. NO 17-198

☐ RAJA BUCHANAN PE # 48916 ☐ MAURICE LORD P.E # 72550