### **PLANNING DIVISION**



2600 Hollywood Boulevard Room 315 Hollywood, FL 33022 File No. (internal use only):

17-DP-58

# **GENERAL APPLICATION**



Tel: (954) 921-3471 Fax: (954) 921-3347

This application must be completed in full and submitted with all documents to be placed on a Board or Committee's agenda.

The applicant is responsible for obtaining the appropriate checklist for each type of application.

Applicant(s) or their authorized legal agent must be present at all Board or Committee meetings.

At least one set of the submitted plans for each application must be signed and sealed (i.e. Architect or Engineer).

Documents and forms can be accessed on the City's website at

http://www.hollywoodfl.org/DocumentCenter/Home/View/21



APPLICATION	I TYPE	(CHECK ONE):
-------------	--------	--------------

■ Technical Advisory Committee
☐ City Commission ☐ Planning and Development Board
Date of Application: 08/02/2017
Location Address: 1954 N. 30 <sup>th</sup> Rd, Hollywood, FL 33021 (Central Golf Section of Hollywood)
Lot(s): N/A Subdivision: N/A
Folio Number(s):5142 08 01 0041
Zoning Classification: <u>IM-1</u> Land Use Classification: <u>Low-Intensity Industrial &amp; Mfg Districts</u>
Existing Property Use: <u>Industrial Warehouse</u> Sq Ft/Number of Units: <u>35,429.05</u>
Is the request the result of a violation notice? ( ) Yes No If yes, attach a copy of violation.
Has this property been presented to the City before? If yes, check all that apply and provide File Number(s) and Resolution(s): PACO Meeting – July 10 <sup>th</sup> , 2017
☐ Economic Roundtable ☐ Technical Advisory Committee ☐ Historic Preservation Board
☐ City Commission ☐ Planning and Development
Explanation of Request: We are now presenting for the Preliminary Site Plan Review (TAC)
Number of units/rooms: Sq Ft: <u>269,260.48 sf</u>
Value of Improvement: \$11,616,290 Estimated Date of Completion: 08/01/2018
Will Project be Phased? ( ) Yes No If Phased, Estimated Completion of Each Phase:
Name of Current Property Owner: Eyal Lalo
Address of Property Owner: 3069 Taft Street, Hollywood, FL. 33021
Telephone: _954-921-2444 Fax: Email Address: elalo@invictawatch.com
Name of Consultant/Representative/Tenant (circle one): Brian Sosnow (Owner's Agent)
Address: 17435 NE 12th Ct., North Miami Beach, FL. 33162 Telephone: 305-770-1314
Fax: Email Address: <u>greenandgold@comcast.net</u>
Date of Purchase:Is there an option to purchase the Property? Yes ( ) No
If Yes, Attach Copy of the Contract.
List Anyone Else Who Should Receive Notice of the Hearing Gany Lalo glalo@invictawatch.com
Elmar Benavente (BE Design Associates, Inc.)  Address: 170 E. Boca Raton Rd. – Suite 1
Email Address: elmar@be-design.net Boca Raton FL. 33432

### PLANNING DIVISION



File No. (internal use only):

2600 Hollywood Boulevard Room 315 Hollywood, FL 33022

# **GENERAL APPLICATION**

### CERTIFICATION OF COMPLIANCE WITH APPLICABLE REGULATIONS

The applicant/owner(s) signature certifies that he/she has been made aware of the criteria, regulations and guidelines applicable to the request. This information can be obtained in Room 315 of City Hall or on our website at <a href="www.hollywoodfl.org">www.hollywoodfl.org</a>. The owner(s) further certifies that when required by applicable law, including but not limited to the City's Zoning and Land Development Regulations, they will post the site with a sign provided by the Office of Planning and Development Services. The owner(s) will photograph the sign the day of posting and submit photographs to the Office of Planning and Development Services as required by applicable law. Failure to post the sign will result in violation of State and Municipal Notification Requirements and Laws.

(I)(We) certify that (I) (we) understand and will comply with the provisions and regulations of the City's Zoning and Land Development Regulations, Design Guidelines, Design Guidelines for Historic Properties and City's Comprehensive Plan as they apply to this project. (I)(We) further certify that the above statements and drawings made on any paper or plans submitted herewith are true to the best of (my)(our) knowledge. (I)(We) understand that the application and attachments become part of the official public records of the City and are not returnable.

Signature of Current Owner:	Date: 8/25//2
PRINT NAME: Eyal Lalo	Date: 08/02/2017
Signature of Consultant/Representative:	Date: 8/75/17
PRINT NAME: Brian Sosnow (Owner's Agent)	Date: <u>08/02/2017</u>
Signature of Tenant:	Date:
PRINT NAME:	Date:
Current Owner Power of Attorney	*
I am the current owner of the described real property and that I am aware of the nature to my property, which is hereby made by me to be my legal representative before the Committee) relative to all matters concerning this application.	or I am hereby authorizing
MY COMMISSION #FF093581	of Current Owner
My Commission Expires: 2 18 18 (Check One) Personally known to me; OR Produced Idea	ntification

### LAND USE: COMMERCIAL CONSTRUCTION TYPE: I B (FBC 601, 602) BUILDING IS FIRE SPRINKLERED LEVEL OF ALTERATION: ALTERATION LEVEL 3 / NEW CONSTRUCTION

### **ABBREVIATIONS**


GLASS

RAD. RADIUS

AL. APPROX.	ALUMINUM APPROXIMATE	GYP. H.B.	GYPSUM HOSE BIB	REINF. REQ. RM.	REINFORCE REQUIRED ROOM
3D.	BOARD	H.C.	HOLLOW CORE	R.O.	ROUGH OPENING
BLDG.	BUILDING	HDWD.	HARDWOOD	RWD.	REDWOOD
BLK.	BLOCK	HDWE.	HARDWARE	R.W.L.	RAIN WATER LEA
BLKG.	BLOCKING	HGT.	HEIGHT	N.VV.L.	K/IIII W//IIK LL/
3M.	BEAM	H.M.	HOLLOW METAL	S.C.	SOLID CORE
30T.	BOTTOM	HORIZ.	HORIZONTAL	SCHED.	SCHEDULE
001.	DOTTOW	HUNIZ.	HORIZONTAL	SHT.	SHEET
CAB.	CABINET	I.D.	INSIDE DIAMETER	SIM.	SIMILAR
EM.	CEMENT	INCAND.	INCANDESCENT	SQ.	SQUARE
ER.	CERAMIC	INSUL.	INSULATION	55T.	STAINLESS STE
C.I.	CASTIRON	INT.	INTERIOR	STD.	STANDARD
CLR.	CLEAR	1111.	IVILION	STL.	STEEL
OL.	COLUMN	JAN.	JANITOR	STOR.	STORAGE
CONC.	CONCRETE	JT.	JOINT	STRUCT.	STRUCTURAL
CONN.	CONNECTION	01.	JOHVI	SUSP.	SUSPENDED
CONT.	CONTINUOUS	LAM.	LAMINATE	SYM.	SYMMETRICAL
TSK.	COUNTERSUNK	LAV.	LAVATORY		
DECOR	DECORATIVE	LOC.	LOCATION	T.	TREAD
ECOR.	DECORATIVE DETAIL	200.		T.C.	TOP OF CURB
DET. D.F.	DOUGLAS FIR	MAX.	MAXIMUM	TEL.	TELEPHONE
	DIAMETER	месн.	MECHANICAL	T&G	TONGUE AND G
DIA.	DIMENSION	MET.	METAL	THK.	THICK
DIM.	DOWN	MFR.	MANUFACTURER	T.O.B.	TOP OF BEAM
N.	DOWN SPOUT	MIN.	MINIMUM	T.O.FR.	TOP OF FRAMING
0.5.		MISC.	MISCELLANEOUS	T.O.L.	TOP OF LEDGER
WG.	DRAWING	M.O.	MASONRY OPENING	T.O.P.	TOP OF PLATE
- ^	FACIL	MTD.	MOUNTED	T.O.S.	TOP OF SLAB
A.	EACH ELEVATION	MUL.	MULLION	TYP.	TYPICAL
EL. ELEC.	ELECTRICAL	N.I.C.	NOT IN CONTRACT	' ' ' '	11110/12
ilet. Q.	EQUAL	N.F.P.A.	NATIONAL FIRE	U.O.N.	UNLESS OTHER
EXH.	EXHAUST	14.1 .1 ./ 1.	PROTECTION	0.0	NOTED
ΣΧΡ.	EXPANSION		ASSOCIATION		110122
XT.	EXTERIOR	N.T.S.	NOT TO SCALE	V.O.S.	VERIFY ON SITE
XIST.	EXISTING	111101	NOT TO COMEL	VERT.	VERTICAL
XIST. EV05.	EXISTING, VERIFY	0.A.	OVERALL	VEST.	VESTIBULE
., , , , , , , , , , , , , , , , , , ,	ON SITE	0.71. 0BS.	OBSCURE	V.G.D.F.	
ELEV.	ELEVATOR	0.C.	ON CENTER		
-LLY.	LLLYTTOR	0.D.	OUTSIDE DIAMETER	W/	WITH
A.U.	FORCE AIR UNIT	OFF.	OFFICE	W/O	WITHOUT
./\.u. :.F.	FINISH FLOOR	OPNG.	OPENING	W.C.	WATER CLOSET
 :.F.F.	FROM FINISH FLOOR	OPP.	OPPOSITE	WD.	WOOD
.г.т. :.Н.С.	FIRE HOSE CABINET	011.	OLLOGILE	WDW.	WINDOW
.11.0. IN.	FINISH	PL.	PLATE	W.H.	WATER HEATER
:L.	FLOOR	PLAS.	PLASTER	W.P.	WATER PROOF
L. LASH.	FLASHING	PLYWD.	PLYW00D	WSCT.	WAINSCOT
LUOR.	FLUORESCENT	PR.	PAIR	WT.	WEIGHT
.0.F.	FACE OF FINISH	PRCST.	PRECAST		
.o.n .	FACE OF MASONRY	P.T.D.F.	PRESSURE TREATED		
.0.S.	FACE OF STUD		DOUGLAS FIR		
		DTI	n i ntitioni	1	

# Y&G STATION PROJECT ARTISANAL MARKET & BOUTIQUE WAREHOUSE

1954 N 30th RD HOLLYWOOD FL. 33021

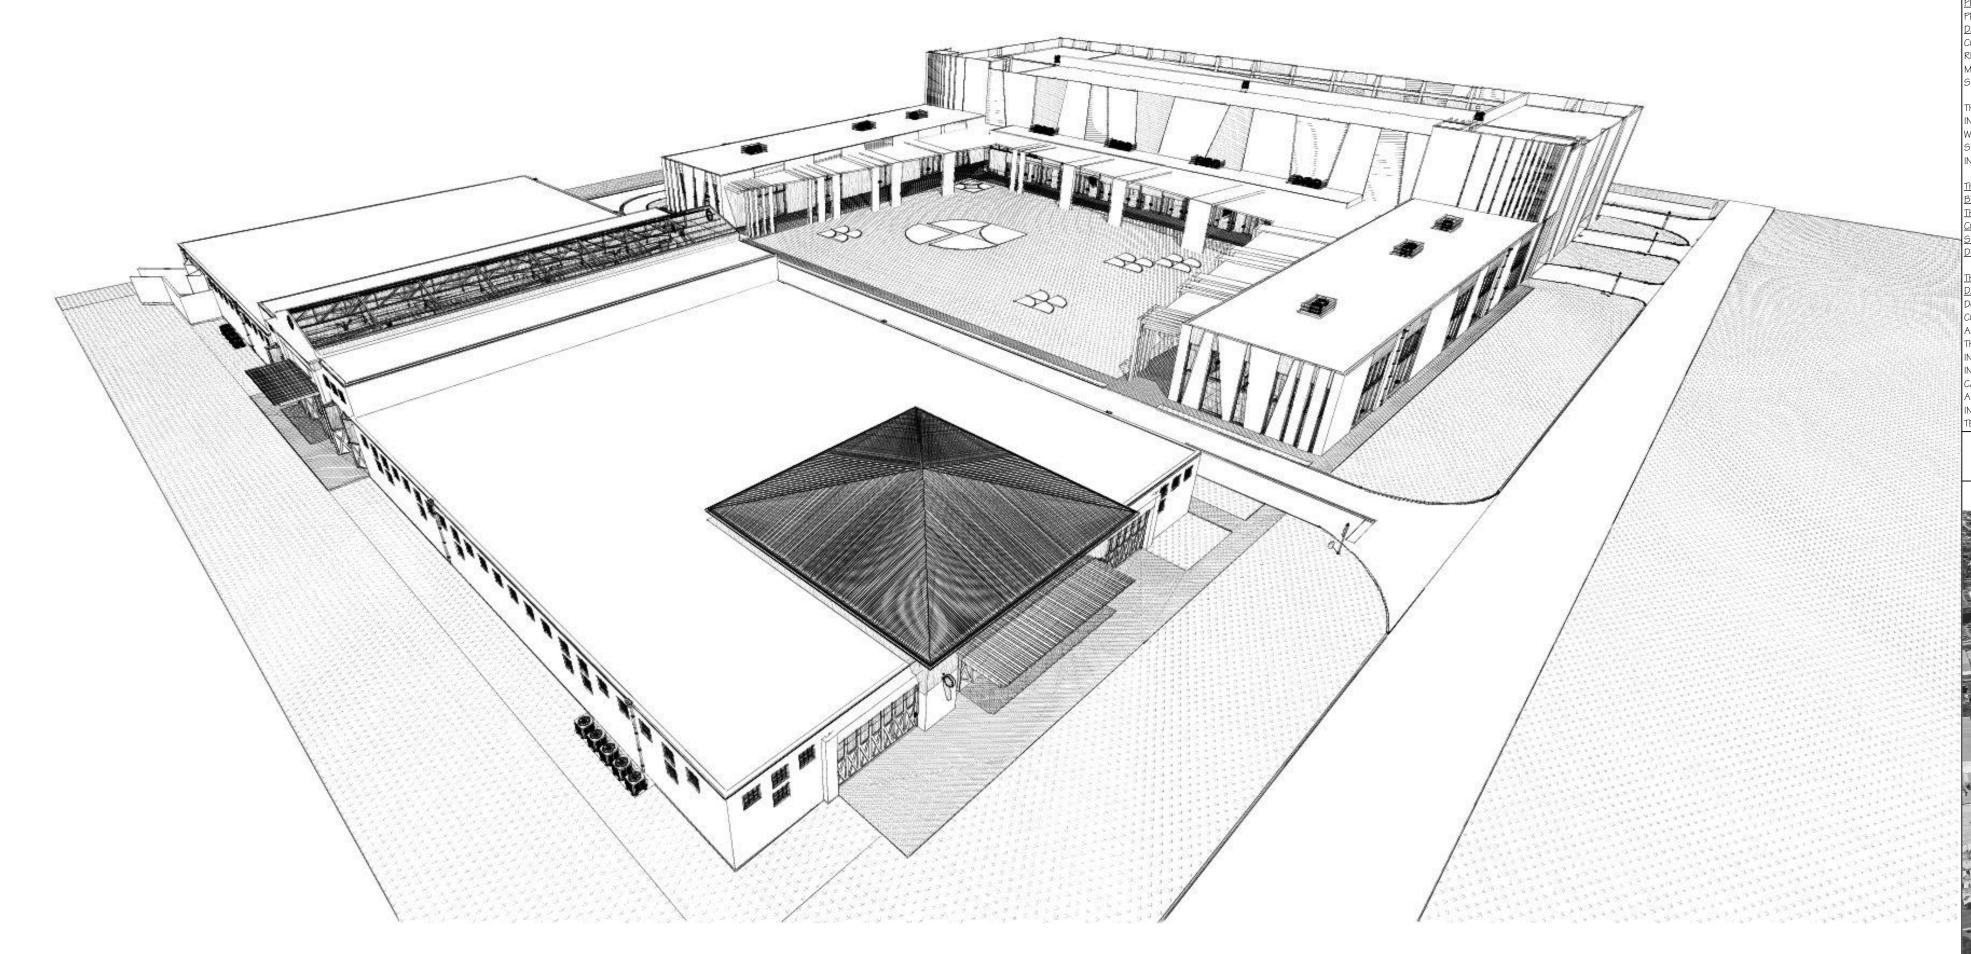

# INSURANCE PROVISION

### VICINITY MAP



DRAWING INDEX

GENERAL NOTES

- SEE INDIVIDUAL PLANS OF EACH DISCIPLINE FOR FURTHER NOTES AND BE DESIGN ASSOCIATES INC. IS THE DESIGNER OF THIS PROJECT AND WILL BE CALLED "THIS OFFICE". THIS SET OF DOCUMENTS (DRAWINGS, TEXTS. SPECIFICATIONS, ETC) IS PART OF THE CONTRACT DOCUMENTS FOR THIS PROJECT AND TO THE BEST OF OUR KNOWLEDGE, BELIEVE AND PROFESSIONAL JUDGMENT. THE ARCHITECTURAL DESIGN OF THIS BUILDING IS IN COMPLIANCE WITH THE LATEST BUILDING CODE APPLICABLE. WE RESERVE THE RIGHT TO ORDER MINOR CHANGES TO THE WORK NOT INVOLVING ADJUSTMENT OF THE CONTRACT SUM OR THE EXTENSION OF THE CONTRACT TIME, NOT INCONSISTENT WITH THE OWNER'S PROGRAM OR THE
- INTENT OF THE CONSTRUCTIONS DRAWINGS. THE CONSTRUCTION OF THIS PROJECT AND ALL WORK PERFORMED UNDER THIS CONTRACT, SHALL COMPLY WITH THE MOST RECENT EDITION OF THE BUILDING CODE, CITY LABOR LAWS, CITY ORDINANCES, CITY/COUNTY ZONING CODES, RULES AND REGULATIONS, AND ANY APPLICABLE CODES (WHICH MAY NOT BE SPECIFICALLY ADDRESSED ON THESE PLANS AND NOTES) AT THE TIME OF PERMIT SUBMISSION TO THE JURISDICTION OF WHICH IT IS BEING CONSTRUCTED IN. THE GENERAL CONTRACTOR (G.C.) SHALL BE
- RESPONSIBLE FOR OBTAINING ALL REQUIRED PERMITS TO CARRY OUT THE WORK DESCRIBED IN THE CONSTRUCTION DOCUMENTS. THE GENERAL CONTRACTOR AS MENTIONED HEREIN, DEFINED AS THE ENTITY TO WHICH HAS THE CONTRACTUAL AGREEMENT WITH THE OWNER FOR THE FULL CONSTRUCTION OF THE PROJECT AND WHICH INCLUDES ANY AND ALL OTHER PARTIES CONTRACTUALLY OBLIGATED TO THE GENERAL CONTRACTOR
- TO COMPLETE THIS PROJECT. • WHEN OWNER IS MENTIONED, SHALL BE HIM AND/OR HIS AGENT.

PTN. PARTITION

FOOT/FEET

FTG. FOOTING

BEFORE COMMENCEMENT OP ANY WORK IN THE SITE, THE GENERAL CONTRACTOR SHALL BE FAMILIAR WITH ALL THE CONDITIONS OF THIS PROJECT. THE CONTRACTOR SHALL CAREFULLY STUDY AND COMPARE THE VARIOUS DRAWINGS AND OTHER CONTRACT DOCUMENTS RELATIVE TO THE PORTION OF THE WORK, AS WELL AS ANY INFORMATION FURNISHED BY THE OWNER OR THIS OFFICE. THE GENERAL CONTRACTOR SHALL TAKE FIELD MEASUREMENTS OF ANY EXISTING CONDITIONS RELATED TO THAT PORTION OP THE WORK AND SHALL OBSERVE ANY CONDITION AT THE SITE AFFECTING IT. ALL THESE ACTS ARE FOR THE PURPOSE OF FACILITATING CONSTRUCTION BY THE CONTRACTOR AND ARE NOT FOR THE PURPOSE OF DISCOVERING ERRORS, OMISSIONS, AND / OR INCONSISTENCIES IN THE CONTRACT

DOCUMENTS: HOWEVER ANY ERRORS, OMISSIONS AND / OR INCONSISTENCIES FOUND BY THE GENERAL CONTRACTOR SHALL BE REPORTED PROMPTLY (PRIOR TO CONSTRUCTION) TO THIS OFFICE. STANDARDS CITED HERE. IN THE CODES SPECIFICATIONS AND OTHER STANDARDS NOTED AND CITED IN THESE DOCUMENTS AND PRODUCED BY THIS OFFICE, ARE HEREIN INCORPORATED AS IF FULLY SET FORTH IN DOCUMENT, THESE NOTES PROVIDE SUPPLEMENTAL INFORMATION NECESSARY FOR THE APPLICATION OF THESE CODES, SPECIFICATIONS AND

OTHER STANDARDS BY THE GENERAL CONTRACTOR AND EMPHASIZE CERTAIN REQUIREMENTS OF THESE CODES, SPECIFICATIONS AND STANDARDS, THESE NOTES SHALL NOT BE CONSTRUED BY ANYONE TO BE ALL-INCLUSIVE OF, OR TO REPLACE OR ALLEVIATE, IN WHOLE OR PART, ANY OF THE CODES, SPECIFICATIONS AND STANDARDS CITED HEREIN, THE GENERAL CONTRACTOR SHALL BE KNOWLEDGEABLE OF, AND SHALL AVAIL HIMSELF TO THESE CODES SPECIFICATIONS AND OTHER STANDARDS AND APPLY THEM TO THE WORK.

THE GENERAL CONTRACTOR SHALL COORDINATE WORK REQUIRED BY THESE DOCUMENTS WITH ALL TRADES INCLUDING AND NOT LIMITED TO STRUCTURAL MECHANICAL, PLUMBING, ELECTRICAL, CIVIL, LANDSCAPE AND OTHER DISCIPLINES.

. THE GENERAL CONTRACTOR SHALL CONSTRUCT AND BE RESPONSIBLE FOR THE BUILDING HEREIN. THE CONTRACT DOCUMENTS (DESIGNED BY THIS OFFICE) IN ACCORDANCE TO ALL GOVERNING CODES REGULATIONS, CITIES, MUNICIPALITIES AND BUILDING OFFICIALS HAVING JURISDICTION ON THIS SITE. THE CONTRACTOR SHALL COORDINATE WORK WITH EACH APPROPRIATE TRADE DISCIPLINE TO ASSURE NO CONFLICT OR DIVISION OF ANY REQUIRED OR SPECIFIED COMPONENT FOR A COMPLETE AND FUNCTIONAL PROJECT. THE G.C. IS RESPONSIBLE TO ASSURE THAT ALL MATERIALS SHALL BE NEW, OF QUALITY SPECIFIED, DELIVERY ON TIME AND AMPLE QUANTITY TO PREVENT DELAY OF WORK AND SHALL INSTALL ALL MATERIALS ACCORDING TO

MANUFACTURER'S RECOMMENDED SPECIFICATIONS

PROVIDE FIRE RESISTANT MATERIALS AND FIRE SEAL AS REQUIRED AT ALL OPENINGS, JOINTS, PENETRATIONS OR GAPS ON FIRE RATED ASSEMBLIES. DO NOT SCALE THE DRAWINGS TO OBTAIN DIMENSIONS. ANY DIMENSION NOT INDICATED ON DRAWINGS SHALL BE CONFIRMED WITH THIS OFFICE PRIOR TO COMMENCEMENT OF ANY WORK, THE GENERAL CONTRACTOR SHALL VERIFY ALL DIMENSIONS IN FIELD WITH SUB CONTRACTORS AND NOTIFY THIS OFFICE OF ANY DISCREPANCIES BETWEEN THE ACTUAL FIELD DIMENSIONS, SHOP DRAWINGS AND THESE DRAWINGS. WHERE THE CONTRACTOR ELECTS NOT TO VERIFY DIMENSIONS PRIOR TO COMMENCEMENT OF ANY WORK OR NOTIFY THE OWNER AND THIS OFFICE OF ANY DISCREPANCIES, THE GENERAL CONTRACTOR WILL ASSUME ANY AND ALL LIABILITIES FOR ANY AND ALL CORRECTIONS, REPLACEMENTS, TIME AND LABOR TO MAKE-WORK IN

ACCORDANCE TO CONTRACT DOCUMENTS. NO WORK SHALL BE PERFORMED OUTSIDE THE PROJECT LIMITS WITHOUT PRIOR WRITTEN APPROVAL FROM THE BUILDING DEPARTMENT, OWNER AND/OR THIS OFFICE WHERE APPLICABLE. THE GENERAL CONTRACTOR SHALL:

• PRIOR TO SUBMIT BID, FAMILIARIZE HIMSELF AND HIS SUB-CONTRACTORS WITH ALL EXISTING CONDITIONS AT THE SITE RELATIVE TO SCOPE OF WORK RELATING TO THIS PROJECT. MATERIALS HANDLING, STORAGE AND DELIVERY, WORKING SPACE AVAILABLE, SAFETY PRECAUTIONS REQUIRED, AND ALL OTHER CONDITIONS NECESSARY TO THE MAKING OF AN ACCURATE AND COMPLETE PROJECT BID. NO INCREASE IN PROJECT COST WILL BE ALLOWED FOR FAILURE TO KNOW EXISTING SITE

• IN FLORIDA CALL "SUNSHINE STATE ONE CALL" PRIOR TO DIG AT 811 OR (800) 432-4770 OR SUBMIT A REQUEST ONLINE AT WWW.CALLSUNSHINE.COM THEN WAIT FOR THE MARKS (2 BUSINESS DAYS) AND PROTECT THE MARKS DURING CONSTRUCTION.

 ACQUIRE ALL NECESSARY PRODUCT APPROVALS USED AND INSTALLED ON THIS PROJECT AS WELL AS ANY ADDITIONAL COUNTY AND LOCAL JURISDICTION REQUIRING ADDITIONAL DATA, CALCULATIONS SIGNED AND SEALED BY A STATE REGISTERED STRUCTURAL ENGINEER TO CERTIFY APPLICATION OF SAID PRODUCT IN ACCORDANCE TO THE CODE HAVING JURISDICTION.

 ASSEMBLE ALL REQUIRED GUARANTEES, WARRANTIES, AND MAINTENANCE CONTRACTS EXECUTED BY EACH OF THE RESPECTIVE MANUFACTURERS, SUPPLIERS AND SUB-CONTRACTORS, ALL THIS INFORMATION SHALL BE SUBMITTED TO THIS OFFICE. OWNER AND ALL PERTINENT PARTIES.

 PREPARE AND MAINTAIN THROUGHOUT THE LENGTH OF TIME IN CONSTRUCTION A FULL AND CURRENT SET OF ACCURATE "AS-BUILT" DRAWINGS, UPON COMPLETION OF THE PROJECT SUCH DRAWINGS WILL BE PRESENTED TO THE OWNER AND TO THIS OFFICE (2 SETS EACH) FOR PERMANENT RECORD AND INFORMATION.

CONTRACTOR SHALL NOTIFY OWNER 72 HOURS PRIOR TO THE COMPLETION OF INTERIOR FRAMING SO TO ALLOW FOR OWNER TO REVIEW FRAMING PRIOR TO THE START OF THE ELECTRICAL AND MECHANICAL CONTRACTOR SHALL HAVE ELECTRICAL AND MECHANICAL SUBCONTRACTORS TO INSTALL BOXES ONLY (NO WIRING OR DUCTS) FOR OWNER REVIEW. CONTRACTOR SHALL NOTIFY OWNER 24 HOURS IN ADVANCE.

CONTRACTOR SHALL CONFIRM SOIL BEARING CAPACITY PRIOR TO COMMENCING WORK AND SHALL SUBMIT REPORT TO OWNER AND THIS OFFICE. CONTRACTOR SHALL PROVIDE COMPACTION FOR WALKWAYS,

FLATWORK, DRIVEWAYS, ETC. AS REQUIRED. ALL "EXISTING" INFORMATION ON THE DRAWINGS HAS BEEN OBTAINED BY THIS OFFICE FROM THE OWNER, SUCH "EXISTING" INFORMATION SHALL BE CONSIDERED AS SHOWN SCHEMATICALLY ONLY, AND SHALL BE FIELD VERIFIED BY ALL CONTRACTORS TO SIZE, LOCATION, MATERIAL AND CURRENT ALL AREAS ADJACENT TO WORK, WHICH HAVE BEEN ALTERED AND/OR DAMAGED, SHALL BE REPAIRED TO MATCH EXISTING AND/OR FINISH OF NEW

ALL DEMOLITION AND REMOVAL OF EXISTING UTILITIES, STRUCTURES, PLANTING MATERIALS, ETC., SHALL BE DONE IN ACCORDANCE WITH ALL LOCAL, STATE AND NATIONAL GOVERNING AUTHORITIES.

G.C. IS RESPONSIBLE FOR ADEQUATE BRACINGS OF STRUCTURAL AND NON STRUCTURAL ELEMENTS DURING CONSTRUCTION, BUILDER SHALL PROVIDE A SAFE WORKING ENVIRONMENT AS WELL AS REQUIRED MEANS OF EGRESS FOR ALL PERSONNEL ON THE PROJECT SITE AS REQUIRED BY ALL

IF DISCREPANCY, STRUCTURAL ENGINEERING NOTES SUPERSEDE. SEE STRUCTURAL PLANS. CONCRETE FINISH SHALL BE LEVELED AND/OR PITCHED PROPERLY. FINISH O ALL EXTERIOR SURFACE CONCRETE SHALL BE BROOM FINISH. CONTRACTOR SHALL REVIEW IN COMPLETENESS ALL PRODUCT APPROVALS AND SHOP DRAWINGS OF ERRORS AND ADDRESS THEM, THEN SHALL

TO START OF CONSTRUCTION FOR THEIR REVIEW AND COORDINATION, IF SUCH SHOP DRAWINGS ARE NOT SUBMITTED AS MENTIONED, THE RESPONSIBILITY OF THE COORDINATION AND/OR ANY CORRECTIONS WHICH MAY OCCUR ARE THE RESPONSIBILITY OF THE CONTRACTOR. THIS OFFICE AND THE STRUCTURAL ENGINEER ACCEPT NO RESPONSIBILITY FOR STRUCTURAL BEAMS, COLUMNS AND FOOTINGS UNTIL REVIEW OF THE APPROVED DRAWINGS AND THE ENGINEERING SIGNED AND SEALED BY A STATE REGISTERED ENGINEER, HAS BEEN COMPLETED PRIOR TO THE START

SUBMIT TO THIS OFFICE AND STRUCTURAL ENGINEER (IF APPLICABLE) PRIOR

# OF CONSTRUCTION.

WITH CONCRETE SURFACES.

PROVIDE ACOUSTICAL CAULKING TOP, BOTTOM AND SIDES OF ALL INTERIOR STUD/GYPSUM BOARD WALLS PROVIDE 5/8" "TYPE X" DRYWALL AT ALL WALL AND CEILING ASSEMBLIES IF NO OTHER THICK IS SPECIFIED.

PROVIDE WATER RESISTANT GYPSUM BOARD ON ALL WET WALL PROVIDE ALL NECESSARY P.T. WOOD BLOCKING AT ALL REQUIRED LOCATIONS FOR ERECTION OF EQUIPMENT, SYSTEMS AND ACCESSORIES, IN CONTACT

VERIFY OPENINGS FOR PIPES AND DUCTS WITH ARCHITECTURAL, MEP AND STRUCTURAL PLANS. ALL HOLLOW METAL DOOR FRAMES ON BLOCK WALLS ARE TO BE GROUT

DIMENSIONS TO METAL STUD PARTITIONS ARE TO THE FINISHED SURFACE (NOMINAL) AND INTERIOR DIMENSIONS TO CONCRETE OR MASONRY WALLS, ARE TO FINISHED FURRING SURFACE (1 1/2" FROM ROUGH SURFACE), UNLESS

OTHERWISE NOTED. PROVIDE 1x2 P.T. FIRE STOP HORIZONTAL AT CEILINGS AND WALL INTERSECTIONS OR 8' O.C. VERTICAL MAX. AND ALL OTHER PER CODE

PROVIDE SCREENED VENTS AT FLOOR LEVEL IN GARAGE, 60" PER CAR MIN.

TRUSS MANUFACTURER SHALL SUBMIT SHOP DRAWINGS. WHICH SHALL

INCLUDE TRUSS PROFILES FRAMING PLAN AND CERTIFICATION BY A STATE REGISTERED ENGINEER TO THIS OFFICE AND OWNER. TRUSS MANUFACTURER SHALL NOT START FABRICATION UNTIL REVIEW OF SUCH SHOP DRAWINGS BY G.C., THIS OFFICE AND OWNER IS ISSUED, TRUSS MANUFACTURER IS RESPONSIBLE FOR SUPPLYING THE TRUSS ENGINEERING INDICATING GRAVITY LOADS AND UP-LIFT LOADS AND ENGINEERED TRUSS HARDWARE AND ANCHORAGE REQUIREMENTS FOR TRUSS TO TRUSS CONNECTIONS.

THE TRUSS LAYOUT SHOWN IS SCHEMATIC IN NATURE HOWEVER. THE SUPPORTING SUPERSTRUCTURE HAS BEEN DESIGNED UNDER THE ASSUMPTION THAT THE FRAMING SCHEME SHOWN WILL COMPLY WITH THE FINAL TRUSS DESIGNERS LAYOUT. THE FRAMING SCHEME (DIRECTION OF TRUSSES, MAJOR G.T. BEARING

POINTS, ETC) CAN BE MODIFIED ONLY AFTER OBTAINING PERMISSION FROM

THE ENGINEER OF RECORD WHO MUST REVIEW PROPOSED CHANGES AND

AUTHORIZE STRUCTURAL REVISIONS ACCORDINGLY. ALL WOOD IN CONTACT WITH MASONRY OR CONCRETE SHALL BE PRESSURE TREATED WITH A WOOD PRESERVATIVE TREATMENT NOT HAVING C.C.A. (CHROMATED COPPER ARSENATE), BUT AN ALTERNATE TREATMENT APPROVED BY THE EPA (ENVIRONMENTAL PROTECTION AGENCY) FOR THIS

ALL WOOD AND LUMBER SHALL BE FIRE RETARDANT TREATED AS PER REQUIREMENTS OF ALL APPLICABLE CODES.

AND NEED FOR REINSPECTION AND TREATMENT CONTRACT RENEWAL, SHALL BE PROVIDED. THE SIGN SHALL BE POSTED NEAR THE WATER HEATER OR ELECTRICAL PANEL

DOORS AND WINDOWS ALL EXTERIOR WINDOWS AND GLASS DOORS WILL HAVE AN APPROVED HURRICANE SHUTTER PROTECTION OR BE APPROVED HURRICANE WINDOWS EVERY BATHROOM DOOR LOCK SHALL BE IN COMPLIANCE WITH NFPA IOI-2I-

2.4.4, AND CLOSET DOOR LATCH PER NFPA 101-21-2.4.3. NO DOUBLE TWO SIDED LOCKS ON ENTRANCE DOORS WINDOW AND DOOR BUCKS ARE CONSIDERED AS FILLERS AND THE WINDOW AND/OR DOOR SHALL BE SECURED TO THE STRUCTURE THROUGH THE BUCKS IN ACCORDANCE WITH THE MANUFACTURERS PRODUCT APPROVAL AND

GLASS IN DOORS AND/OR ADJACENT TO DOORS SHALL WE TEMPERED CONTRACTOR SHALL PROVIDE FOR PERMIT ALL CODE REQUIRED PRODUCT APPROVALS FOR ALL EXTERIOR WINDOWS AND DOORS. FRONT DOOR AND GARAGE DOOR SHALL MEET WIND PRESSURES IMPACT TEST, WIND CYCLE TESTS, ETC. AS REQUIRED BY GOVERNING BUILDING CODE

ALL EXTERIOR DOORS A DOOR INTO GARAGE SHALL HAVE WEATHER

STRIPPING AND METAL THRESHOLD THE SECOND MEANS OF EGRESS SHALL COMPLY WITH NFPA 101-22-2.2.3 AND SHALL HAVE A CLEAR MINIMUM OPENING OF NOT LESS THAN 5.7 SQ.FT (MIN. 20" W / 24" H). THE BOTTOM OF THE WINDOW OPENING SHALL NOT BE MORE THAN 44" OFF THE FLOOR. IF WINDOW SILL AT UPPER FLOORS IS LESS THAN 36" ABOVE ADJACENT FLOOR, PROVIDE SAFE GUARD AT 42" ABOVE FLOOR AS SPECIFIED IN BUILDING CODE (IN FLORIDA) SECTION1617.4.1 . G.C. IS RESPONSIBLE FOR THE PROPER INSTALLATIONS AND WEATHER PROOFING. G.C. SHALL AVAIL HIMSELF OF THE INSTALLATION GUIDELINES,

FLOOR AND BASE IN BATHROOMS SHALL BE OF IMPERVIOUS MATERIALS. ALL STEEL COLUMNS, PLATES AND STEEL ANGLES SHALL BE FACTORY PRIMED OR GALVANIZED; ALL EXPOSED STEEL SHALL BE PAINTED OR GALVANIZED PRIOR TO COVERING UP.

MANUFACTURER SPECIFICATIONS AND ALL APPLICABLE CODES.

PROVIDE PAINT OF BEST QUALITY PROFESSIONAL LINE 3 - COAT SYSTEM (PRIMER AND 2 FINISH COATS) THROUGH OUT PROJECT, EXTERIOR WALL AND TRIM PROVIDE 7-YEAR PAINT MANUFACTURER SYSTEM FOR ALL EXTERIOR LOCATIONS, SUBMIT PROPOSED SYSTEM BY A PAINT APPLICATOR WITH PROVEN EXPERIENCE WITH SIMILAR TYPE PROJECTS. SYSTEM TO BE SUBMITTED TO THIS OFFICE FOR APPROVAL PRIOR TO BID.

AND SIDING) WITH APPROPRIATED PAINTABLE SILICONE SEALANT (DOW 756) BY DOW CORNING OR SIMILAR). PROVIDE MANUFACTURERS JOB SPECIFIC 20 YEAR WRITTEN WARRANTY, PREP AND PRIME ALL SURFACES AS RECOMMENDED BY SEALANT MANUFACTURER. REQUIRED GUARDS ON OPEN SIDES OF STAIRWAYS, RAISED FLOOR AREAS.

BALCONIES AND PORCHES. SHALL HAVE INTERMEDIATE RAILS OR

SEALANT SEAL ALL EXTERIOR JOINTS OF PROJECT (DOORS, WINDOWS, TRIM

ORNAMENTAL CLOSURES THAT DO NOT ALLOW PASSAGE OF A SPHERE 4" C MORE IN DIAMETER. DRYWALL TO BE MIN. LEVEL 4. G.C. SHALL GET WRITTEN PERMISSION BY OWNER IF LESS. ALL FINISHED HEIGHTS (TOP OF DOOR/WINDOWS, CEILINGS, ETC.) ARE IN REFERENCE TO THE FINISH FLOOR WHICH IS 1 1/2" (NOMINAL) ON TOP OF THE

SLAB OR CONCRETE FLOOR, WITHIN A/C ENCLOSURES, ALL CMU WALLS HAVE

SHALL BE SAFETY GLAZING THAT ARE LESS THAN 60" ABOVE THE FLOOR OF

CONTRACTOR SHALL PROVIDE SHOP DRAWINGS AND/OR SAMPLES FOR OWNERS REVIEW FOR ALL OR ANY CABINETRY, BUILT-INS, TRIM, DOORS, WINDOWS, MATERIALS, CUSTOM FEATURES, ETC. THAT ARE SHOWN ON DRAWINGS. ALL INTERIOR WINDOWS, DOORS AND OPENINGS SHALL BE CASED WITH WOOD TRIM. GLASS OR MIRRORS IMMEDIATELY SURROUNDING A BATH TUB OR SHOWER

AN INTERIOR FURRING 1 1/2" THICK (NOMINAL).

THE TUB OR SHOWER. CONTRACTOR SHALL COORDINATE ALL KITCHEN APPLIANCES, BATH FIXTURES, ACCESSORIES, ETC. WITH OWNER AND /OR THIS OFFICE. G.C. SHALL PROVIDE PROPER BACKING FOR WALL CABINETS

PLUMBING AND HVAC CONTRACTOR SHALL VERIFY ALL LOCATIONS / SIZES OF THEIR OUTLETS SUPPLIES AND CHASE AND SHALL BE RESPONSIBLE FOR HVAC CONTRACTOR SHALL PROVIDE ALL NECESSARY DOCUMENTATION AND

PRODUCT SPECIFICATIONS TO OBTAIN A BUILDING PERMIT AND COMPLETE

SUCH WORK AS REQUIRED BY MECHANICAL LATEST EDITION BUILDING CODE

AND THE SPECIFICATIONS. PLUMBING CONTRACTOR SHALL VERIFY CENTER LINE DIMENSIONS OF ALL FIXTURES THAT HAVE BEEN SPECIFIED BY OWNER OR THIS OFFICE, AND SHALL BE RESPONSIBLE FOR COORDINATION OF THE SAME, MAINTAIN MINIMUM PLUMBING BUILDING CODE CLEARANCES BETWEEN TOILET

FIXTURES AND ADJACENT WALL, CABINETRY AND/OR PLUMBING FIXTURE. PLUMBING CONTRACTOR SHALL COORDINATE ALL VERTICAL STACKS TO BE DIVERTED TO THE REAR OF ROOF RIDGE. SUCH VERTICAL STACKS SHALL BE

PAINTED TO MATCH ROOFING COLOR. PROVIDE SHUT-OFF VALVES AT ALL BATHROOMS AS REQUIRED BY LATEST BUILDING CODE APPROPRIATED SECTION. PROVIDE AIR CHAMBERS AT ALL FIXTURE BRANCHES. PROVIDE FIRE

DAMPERS AT SUPPLY AND RETURNS WHICH PASS THROUGH RATED ASSEMBLIES IF ANY. WATER CONSUMPTION IN PLUMBING FIXTURES SHALL COMPLY WITH TABLES GIVEN BY THE BUILDING CODE. ALL SHOWERS AND TUB/SHOWER COMBINATIONS SHALL BE PROTECTED WITH

ANTI-SCALD CONTROL VALVE. PROVIDE PROTECTION IN FRONT OF ALL EQUIPMENT (HVAC, WATER HEATER, WASHER, DRYER, ETC.) LOCATED IN GARAGE AT FLOOR LEVEL PER MECHANICAL CODE A/C UNITS MAY HAVE CONCRETE PADS OR OTHER APPROVED MATERIAL

EXTENDING ABOVE ADJOINING GRADE, OR SHALL BE SUSPENDED AT MIN. OF

6" ABOVE ADJOINING GRADE.

ELECTRICAL CONTRACTOR SHALL VERIFY ALL LOCATIONS/SIZES OF THEIR OUTLETS, SUPPLIES AND CHASE AND SHALL BE RESPONSIBLE FOR COORDINATION OF THE SAME. ALL WIRE SIZES BASED ON COPPER.

ALL BATHROOMS, GARAGE, UTILITY ROOM, KITCHEN COUNTER AND EXTERIOR W.P. RECEPTACLES SHALL HAVE G.F.I. CIRCUITS. ALL SERVICE WIRING SHALL BE COPPER. ALL FEEDER WRING SHALL BE COPPER.

PROVIDE W.P. DISCONNECT AT ALL A/C COMPRESSORS, SPRINKLER PUMPS. POOL PUMPS AND ALL EXTERIOR EQUIPMENT. WIRE AND BREAKER SIZING FOR ALL APPLIANCES AND EQUIPMENT SHALL BE AS MANUFACTURERS NAME PLATE REQUIREMENTS AND IS RESPONSIBILITY OF THE SUB-CONTRACTOR TO VERIFY SUCH INFORMATION PRIOR TO

INSTALLATION OF ELECTRICAL ROUGH. IF SUCH REQUIREMENTS DIFFER FROM THE PROPOSED ELECTRICAL SCHEDULE, THE CONTRACTOR SHALL NOTIFY THIS OFFICE AND/OR ENGINEER OF THE DISCREPANCY PRIOR TO ELECTRICAL ALL LIGHTING ABOVE TUB AND SHOWER SHALL BE WATERPROOF AND VAPOR

PROOF. PROVIDE G.F.I.C. IF WITH IN 6" RADIUS OF TOP OP TUB. . CLOSET LIGHTS SHALL COMPLY WITH N.E.C. ARTICLE 410-8.

### SITE PLAN GENERAL NOTES

THE ARCHITECTURAL SITE PLAN, IF PROVIDED IN THESE DOCUMENTS IS FOR GENERAL LOCATION OF THE BUILDING, POOL, DRIVEWAYS, SITE FEATURES, ETC. ONLY. THE G.C. SHALL BE RESPONSIBLE FOR VERIFYING BUILDING LOT FIT, LOT COVERAGE, EASEMENT LOCATIONS, SETBACKS AND SITE DIMENSIONS PRIOR TO PERMIT AND CONSTRUCTION. IF ANY CONFLICTS OCCUR THIS OFFICE SHALL BE NOTIFIED IN WRITING PRIOR TO PERMITTING AND


CONSTRUCTION. VERIFY CONNECTION/LOCATION OF UNDERGROUND TELEPHONE, ELECTRICAL, CABLE TV, ETC. SERVICE ENTRANCE WITH LOCAL AGENCY. THE LOCATION OF EXISTING UTILITIES AND STRUCTURES SHOWN ON THE CONSTRUCTION DOCUMENTS ARE APPROX. ONLY. THE G.C. IS RESPONSIBLE FOR VERIFYING

THE EXISTENCE AND ACTUAL LOCATION OF THEM. A/C AND OR POOL EQUIPMENT TO BE INSTALLED WITH MIN. CLEARANCE FROM EACH OTHER AND FROM BUILDING EDGE AS WELL AS MAINTAINING MIN. CLEARANCE FROM PROPERTY SET BACKS. ALL AS PRESCRIBED BY

UI	C5-U1	COVER SHEET
02	SP-01	SITE PLAN
03	A 1	CROUND FLOOR
04	A 1.1	CROUND FLOOR
05	A 1.2	GROUND FLOOR
-06	A 1.3	GROUND FLOOR
07	A 1.4	GROUND FLOOR
08	A 1.5	GROUND FLOOR
-00	A 2	2nd FLOOR MEZZANINE
10	A 2.1	2nd FLOOR MEZZANINE
11	A 2.2	2nd FLOOR MEZZANINE
12	A 2.3	2nd FLOOR MEZZANINE
13	A 3	OTAT LOOK
14	A 3.1	3:4FL00R
15	A 4	14th FLOOR PARKING GARAGE
16	A 4.1	4th FLOOR PARKING GARAGE
17	A 5.0	TERRAGE PARKING GARAGE
18	A 5.1	TERRACE PARKING GARAGE
10	A 6	ROOF PLAN
20	A-7	AREAS & USES
21	A-7.1	AREAS & USES
22	A-7.2	AREAS & USES
23	A-8	ELEVATIONS 01-02
24	A-8.1	ELEVATIONS 01-02
25	A-9	ELEVATIONS 03-04
26	A-9.1	ELEVATIONS 03-04
27	A-10	ELEVATIONS 05-06
28	A-10.1	ELEVATIONS 05-06
20	A 11	RENDERINGS & DETAILS
30	A 12	BUILDING SECTIONS 01
31		BUILDING SECTIONS 02
	A 13	

BID SETS OF CONSTRUCTION DOCS SHALL BE PROVIDED BY THE CONTRACTOR OR OWNER, NOT THIS OFFICE. THE CONTRACTOR IS RESPONSIBLE FOR OBTAINING AND DISTRIBUTING CURRENT DRAWINGS TO ALL SUBCONTRACTORS AND VENDORS.

16220.INV 161220.INV-15.plr 10/18/2017 PRINTING DATE

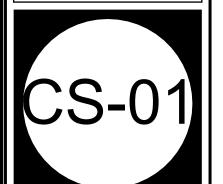

### "SUNSHINE STATE ONE CALL" PRIOR TO DIG AT 811 OR (800) 432-4770

FLOOD ZONE INFORMATION

0568

O.2 PCT

FLOOD INSURANCE RATE MAP (FIRM) INFO: NFIP COMMUNITY PANEL NUMBER: 125113 COUNTY NAME: HOLLYWOOD STATE: FL

PANEL No: SUFFIX: FLOOD ZONE: BASE FLOOD ELEVATION:

See Survey GROUND FLOOR ELEVATION: LOWEST ELEV. OF MAQ/EQUIP: See Survey LOWEST ADJACENT GRADE: See Survey

HIGHEST ADJACENT GRADE: See Survey SITE INFORMATION OBTAINED FROM SURVEY: RICHARD E. COUSINS 4188 STATE OF FLORIDA

SITE REGULATIONS

MAX. HEIGHT:	35'	45'-10"
MAX. NUMBER OF STORIES:		6
HORIZONTAL RESTRAINTS	REQUIRED	PROPOSAI
POOL:		
REAR SETBACK:	10'	10.12'
L & R (SIDE) SETBACK:	10'	10' & 34.07
FRONT SETBACK:	10'	50.18'
HORIZONTAL RESTRAINTS	REQUIRED	PROPOSAL

REFER TO LANDSCAPE AND CIVIL DRAWINGS FOR LANDSCAPE, GRADING, PAVING, DRAINAGE INFORMATION AND SEWER CONECTIONS. (IF APPLICABLE)

REQUEST FOR VARIANCE: SEE VR-01 ON SHEET SP-01

REFER TO STRUCTURAL DRAWINGS FOR COLUMN LOCATIONS AND DETAILS.

NEW WEAREHOSE ADDITION AND ARTISANAL MARKET & BOUTIQUE OFFICE/WEAREHOUSE & PARKING STRUCTURE

ADDRESS: 1954 N 30TH ROAD HOLLYWOOD, FLORIDA 33021

LEGAL DESCRIPTION: PORTION OF SEC. 8-51-42 & A PORTION OF TRACK "A". "CENTRAL GOLF SECTION OF HOLLYWOOD. (P.B. 9, PG. 44, B.C.R.) AREA = 216,300 SQ. FT. 4.9655 ACRES REFER TO SURVEY FOR ADDITIONAL INFORMATION.

ELEVATIONS LISTED HERE ARE FROM THE ARCHITECTURAL PROJECT

FOR THE EXTERIOR ELEVATIONS (DRAINAGE) FOLLOW THOSE FROM CIVIL ENGINEERS' PLANS AND /OR SURVEY. (IF APPLICABLE) 5.15 ✓


### SITE GRADING


GRADING SHALL BE ACCOMPLISHED IN ACCORDANCE WITH CHAPTER 33 OF THE FLORIDA BUILDING CODE. ALL EXCAVATED MATERIAL RESULTING FROM GRADING SHALL BE REMOVED FROM THE SITE BY THE CONTRACTOR EXCEPT SOIL TO BE STOCKPILED FOR REDISTRIBUTION ON SITE AS DIRECTED.

2. LIMIT SITE GRADING TO THE BUILDING PAD AND SURROUNDING BUILDING ENVELOPE. ALL AC PAVING AND CONCRETE SHALL SLOPE AWAY FROM THE BUILDING TO PROVIDE POSITIVE DRAINAGE AWAY FROM THE BUILDING AT A MIN. SLOPE OF 1/8" PER FOOT FOR CONCRETE AND AC AND 1/4" PER FOOT FOR NATURAL



A/C AREA CALCULATION

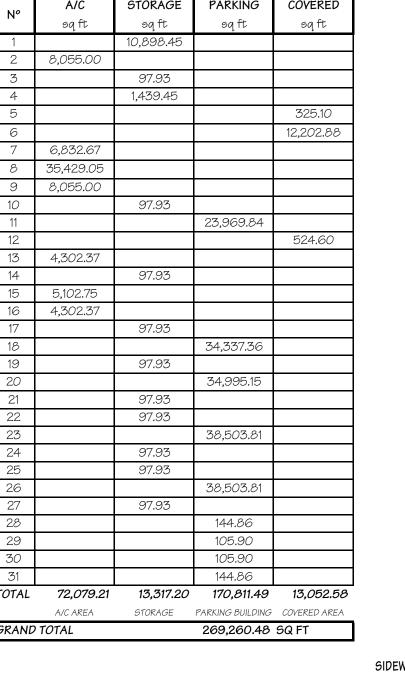

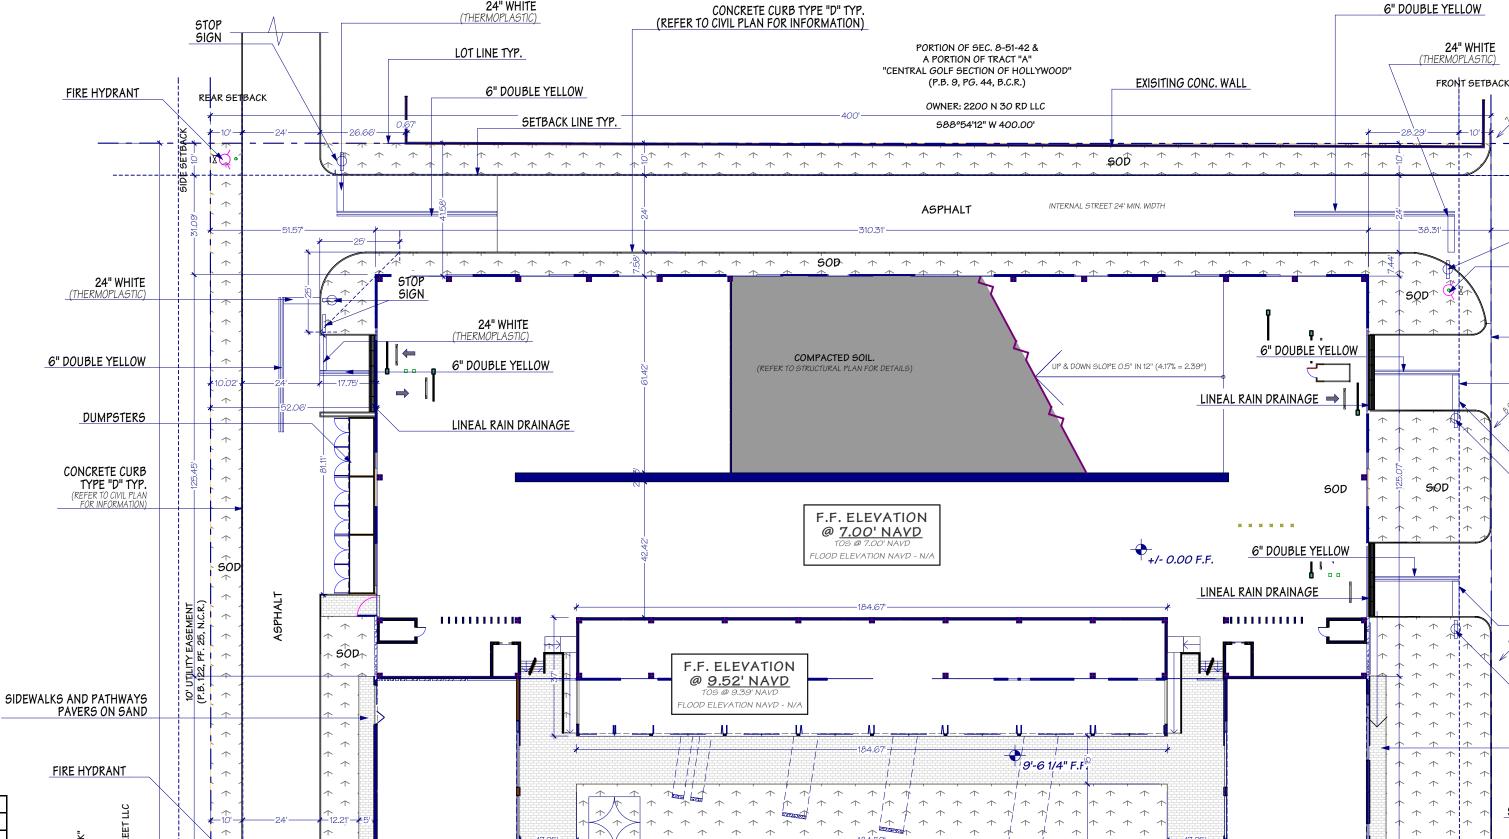

PORTION OF SEC. 8-51-42 & PORTION OF TRACT "A"

"CENTRAL GOLF SECTION OF

HOLLYWOOD" (P.B. 9, PG. 44, B.C.R.) AREA = 216,300 SQ. FT. 4,9655

ACRES


INTERNAL STREET 24' MIN. WIDTH

SIDEWALKS AND PATHWAYS

F.F. ELEVATION

@ <u>9.52' NAVD</u>

SCALE: 1'' = 30'

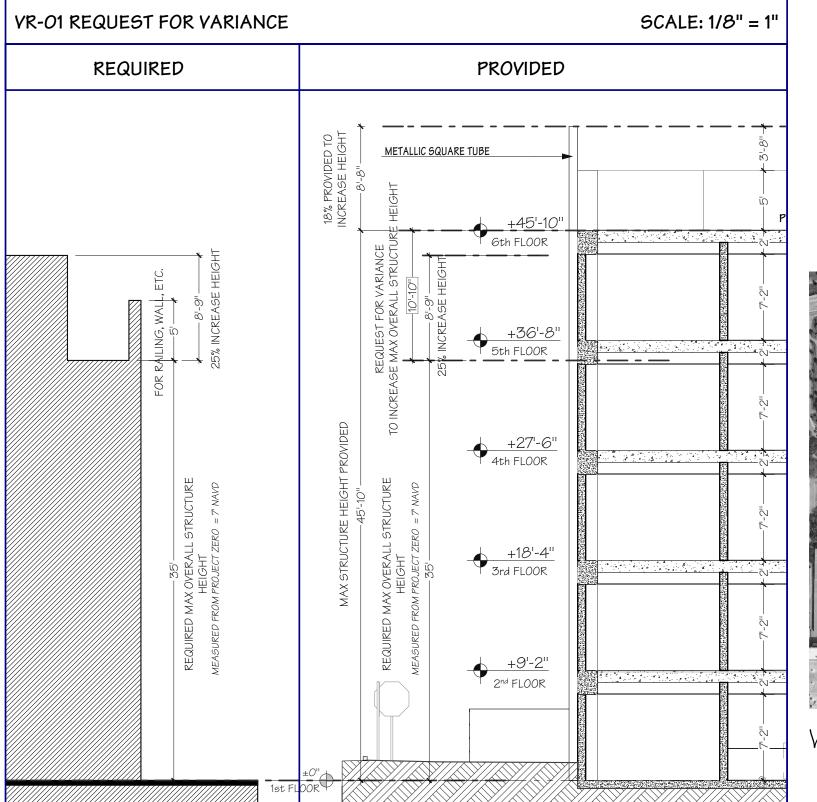

COVERED sq.ft sq.ft 10898.45 TORAGE 35.429.05 ITIQUE OFFICE/WAREHOUSE/SHOP/CAFÉ 36,650.16 12,202.88 ARKING STRUCTURE 173,230.24 256,207.90 13,052.58

**BUILDINGS/STRUCTURES AREAS** 

269,260.48



REFER TO SHEET # A-7, 7.1 & 7.2 AREAS AND USES FOR MORE INFORMATION

TAL PARKING SPACES REQUIRED A+B+C=

PARKING SPACES

REQUIRED

		PARKING SPACE PER CODE			
TYPE	AREAS	ARTISANAL MARKET	WAREHOUSE	BOUTIQUE OFF	
		1 X 250 sq ft	1 X 1,000 sq ft	1 X 400 sq ft	
REHOUSE (STORAGE)	13,317.20 sq ft		13.32		
TISANAL MARKET	35,429.05 sqft	141.72			
JTIQUE/SHOP/CAFÉ	24,720.97 sq ft	98.88			
JTIQUE OFFICE	11,935.42 sq ft			29.84	
		240.60	13.32	29.84	
				1	

01,710.00	

TOTAL

IMPERVIOUS	PERVIOUS
154,586.40	61,713.60
216,30	00.00

IMPERVIOUS AREA sq ft

ANDSCAPE MIN 25% REQUIRED =	54,075.00	25.00
ANDSCAPE PROVIDED =	61,713.60	28.53

RTISANAL MARKET

ARKING BUILDING

ABS FOR EQUIPMENT

ATHWAYS AND SIDEWALKS

UTIQUE OFFICE/SHOP CAFÉ


LANDSCAPE AREA CALCULATION


216,300.00

# PARKING SPACES

		INSIDE	
	HANDICAP	SPECIAL	REGULAR
1st FLOOR	6	1	85
2nd FLOOR	6		89
3rd FLOOR	6		93
4th FLOOR	6		114
5th FLOOR	6		114
6th FLOOR ROOF	2		72
TOTAL	32	1	567

TOTAL HANDICAP PARKING SAPACE PROVIDED	
TOTAL SPECIAL PARKING SPACE PROVIDED	
TOTAL REGULAR PARKING SAPACE PROVIDED	
GRAND TOTAL PARKING SPACE PROVIDED	

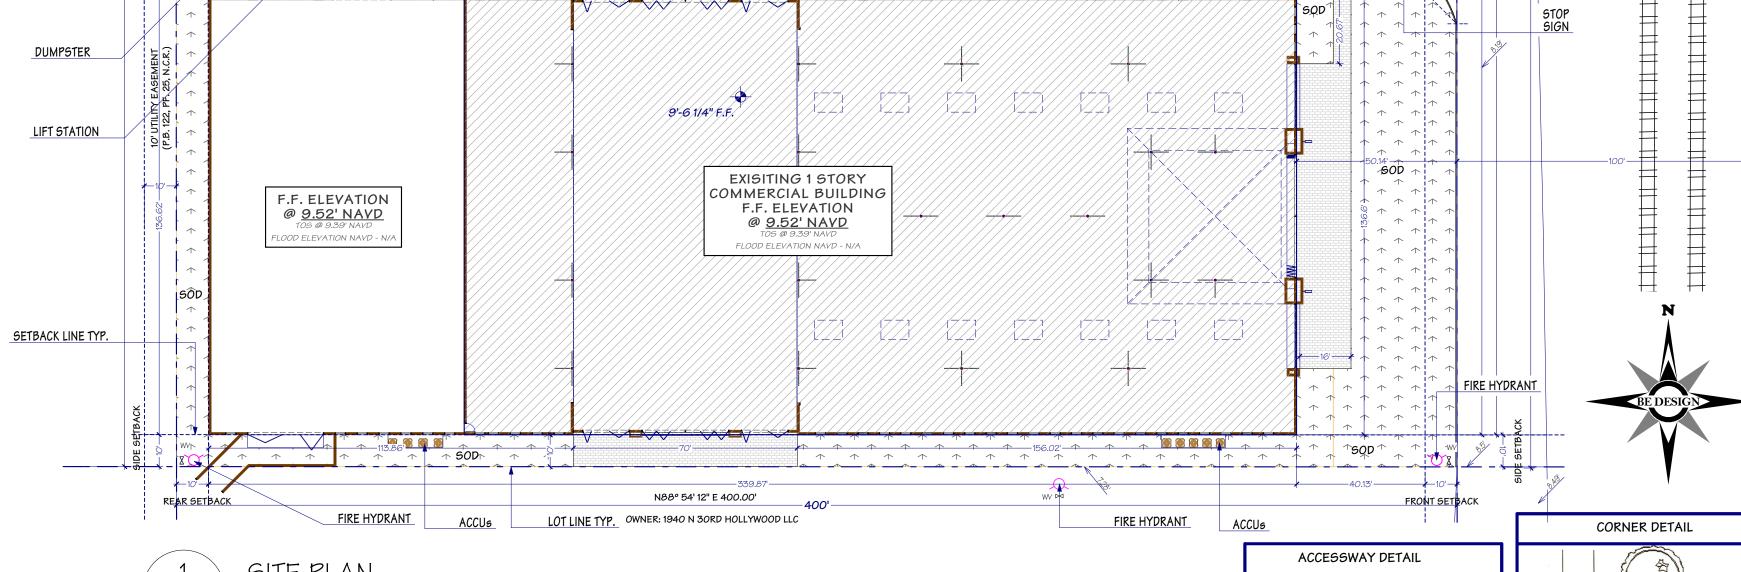

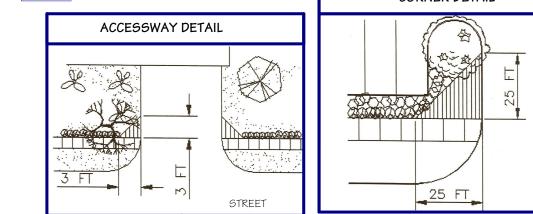

16220.INV 161220.INV-15.plr PRINTING DATE 10/18/2017 DRAWN BY E.B. - R.R

Paul H. Bach AR 0010442

copyright 2017

FIRE HYDRANT

LOT LINE TYP.

SETBACK LINE TYP.

24" WHITE

SIDEWALKS AND PATHWAYS

6" DOUBLE YELLOW

F.F. ELEVATION @ <u>9.52' NAVD</u>

9'-6 1/4" F.F.

PAVERS ON SAND


24" WHITE

SITE PLAN



\(\frac{1}{4}\) \(\frac{1}{4}\

29,265 sq ft

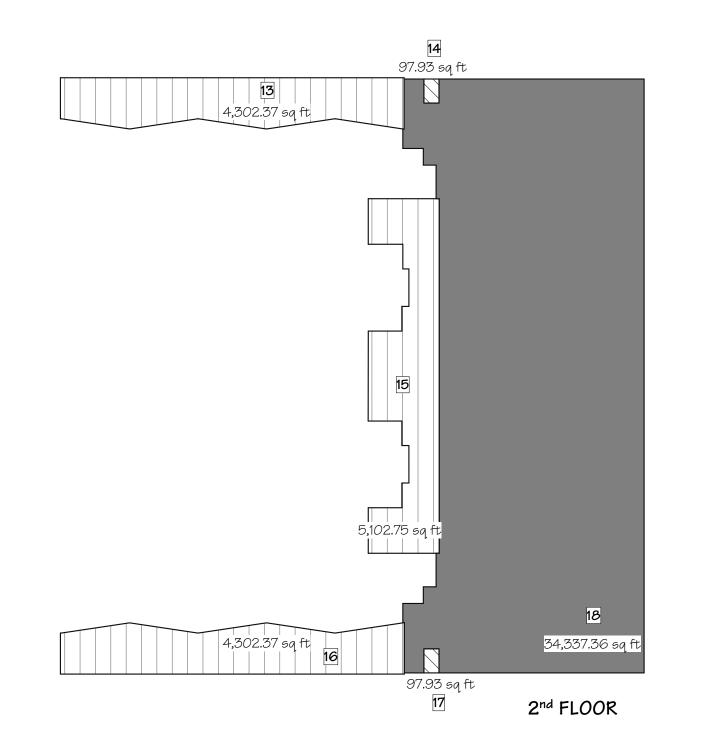

CALCULATION OF AREAS

IMPERVIOUS PERVIOUS 154,586.40 61,713.60 216,300.00


25.00%

28.53%


SCALE: 1" = 50'

54,075.00

61,713.60

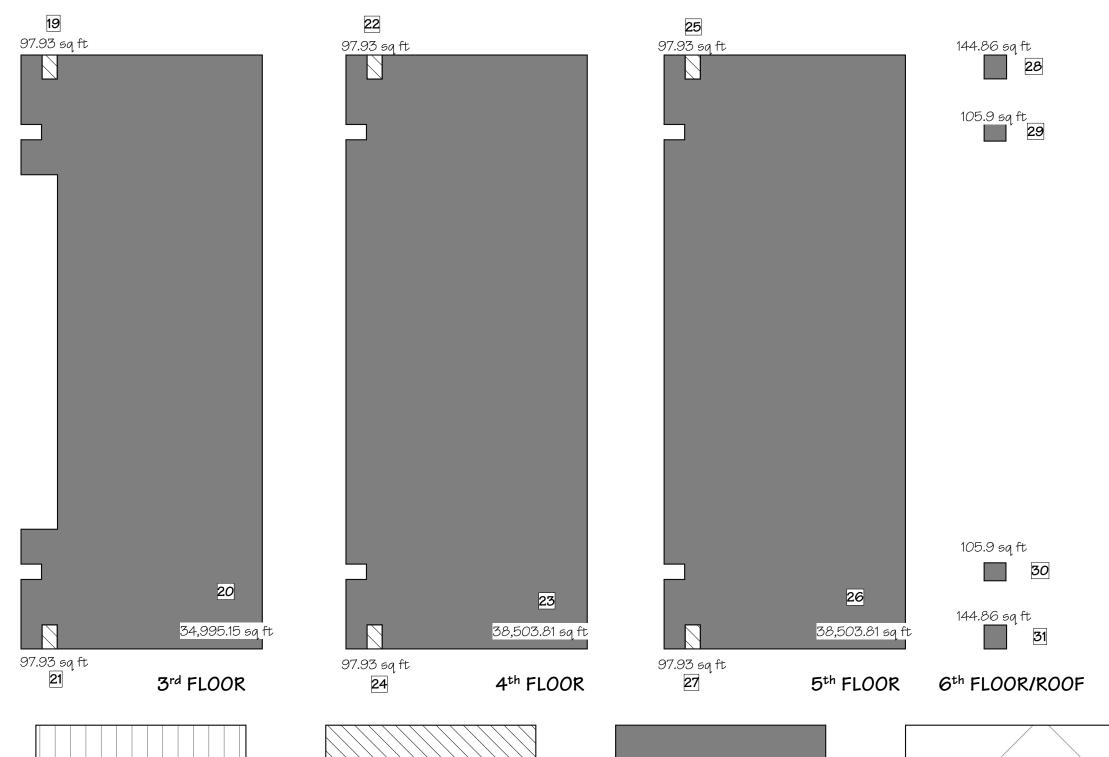

PARKING AREA

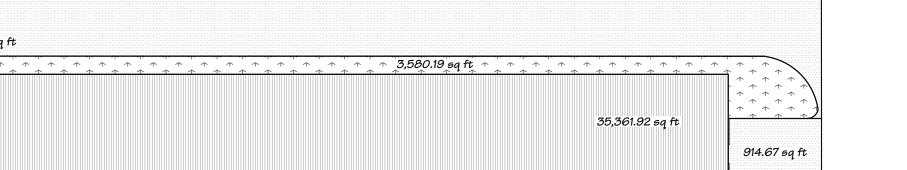

LANDSCAPE AREA CALCULATION

LOT AREA	216,300.00		
	•	IMPERVIOUS	PERVIOUS
		AREA	AREA
TYPE	sq ft	sq ft	sq ft
STORAGE	10,898.45	10,898.45	
ARTISANAL MARKET	35,429.03	35,429.03	
BOUTIQUE OFFICE/WAREHOUSE	6,831.87	6,831.87	
BOUTIQUE OFFICE/SHOP CAFÉ	16,050.00	16,050.00	
PARKING BUILDING	35,361.92	35,361.92	
SLABS FOR EQUIPMENT	148.51	148.51	
PATHWAYS AND SIDEWALKS	18,787.33	18,787.33	
ASPHALT	31,079.29	31,079.29	
SOD	61,713.60		61,713.60

LANDSCAPE MIN 25% REQUIRED =


ANDSCAPE PROVIDED =


	AREAS OF BUILDINGS/STRUCTI	URES		
				COVERED
TYPE	SHAPE Nº	sq ft	SHAPE Nº	sq ft
STORAGE	1	10898.45		
ARTISANAL MARKET	8	35,429.05	5 & 12	849.70
BOUTIQUE OFFICE/WAREHOUSE	7, 15	11,935.42		
BOUTIQUE/SHOP/CAFÉ	2, 9, 13 & 16	24,714.74	6.00	12,202.88
PARKING STRUCTURE	3, 4, 10, 11, 14, 17, 18 TO 31	173,230.24		
TOTAL		256,207.90		13,052.58
TOTAL			269,260.48	

STORAGE AREA

A/C AREA

7123.72 ∍q ft	6,831.87 sq ft	11,605.17 sq ft <sup>†</sup> 21,605.17 sq ft <sup>†</sup> 22,40,40,40,40,40,40,40,40,40,40,40,40,40,
2,717.68 sq ft	12,746.89 sq ft  12,746.89 sq ft  12,746.89 sq ft	8,025 sq ft  5,203.35 sq ft  7
3.42 sq ft + 10,898.45 sq ft	3,323.83 sq ft 789.5 sq ft 1 1 1 1 1 1 1 1 1 1 1 1 1 1 1 1 1 1	236.74 sq ft

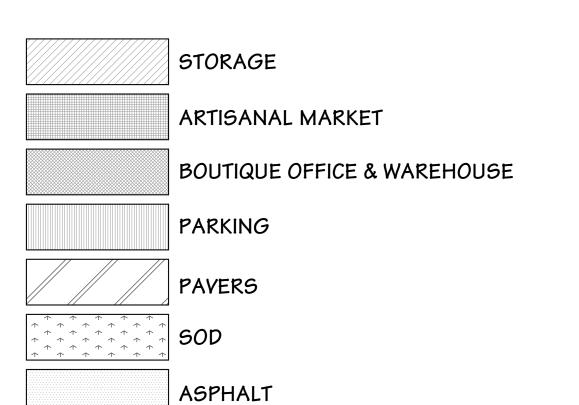

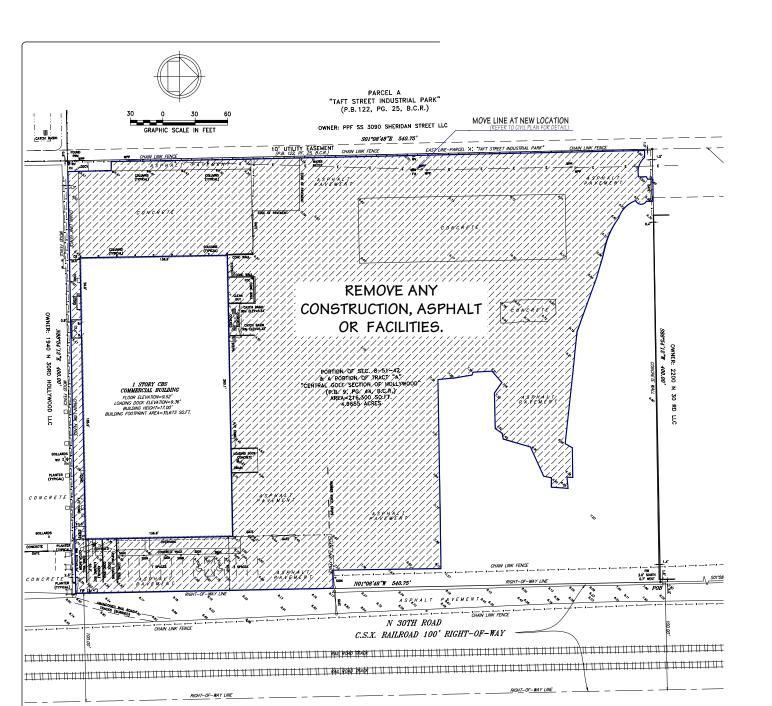

11 12		97.93		
			23,969.84	
172				524.60
13	4,302.37			
14		97.93		
15	5,102.75			
16	4,302.37			
17		97.93		
18			34,337.36	
19		97.93		
20			34,995.15	
21		97.93		
22		97.93		
23			38,503.81	
24		97.93		
25		97.93		
26			38,503.81	
27		97.93		
28			144.86	
29			105.90	
30			105.90	
31			144.86	
TOTAL	72,079.21	13,317.20	170,811.49	13,052.58
	A/C AREA	STORAGE	PARKING BUILDING	COVERED AREA
GRAND TO	OTAL		269,260.48	SQ FT

COVERED AREA

sq.ft

325.10 12,202.88

A/C AREA CALCULATION

1,439.45

7 6,832.67 8 35,429.05 9 8,055.00

GROUND FLOOR AREA SCALE: 1" = 40'

750.72 sq ft


+7,215.49 sq ft

AREAS TO REMOVE OR DEMILISH, ASPHALT, EXISTING EQUIPMENT OR BUILDINGS


Paul H. Bach AR 0010442 © copyright 2017

ARTISANAL MARKET & BOUTIQUE WAREHOUSE ATION PROJECT

16220.INV 161220.INV-15.pln PRINTING DATE 10/18/2017 DRAWN BY E.B. - R.R. AREAS & USES

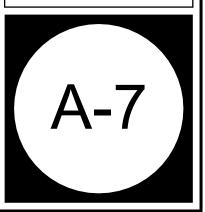

AREAS UNITS SCALE: 1" = 20'

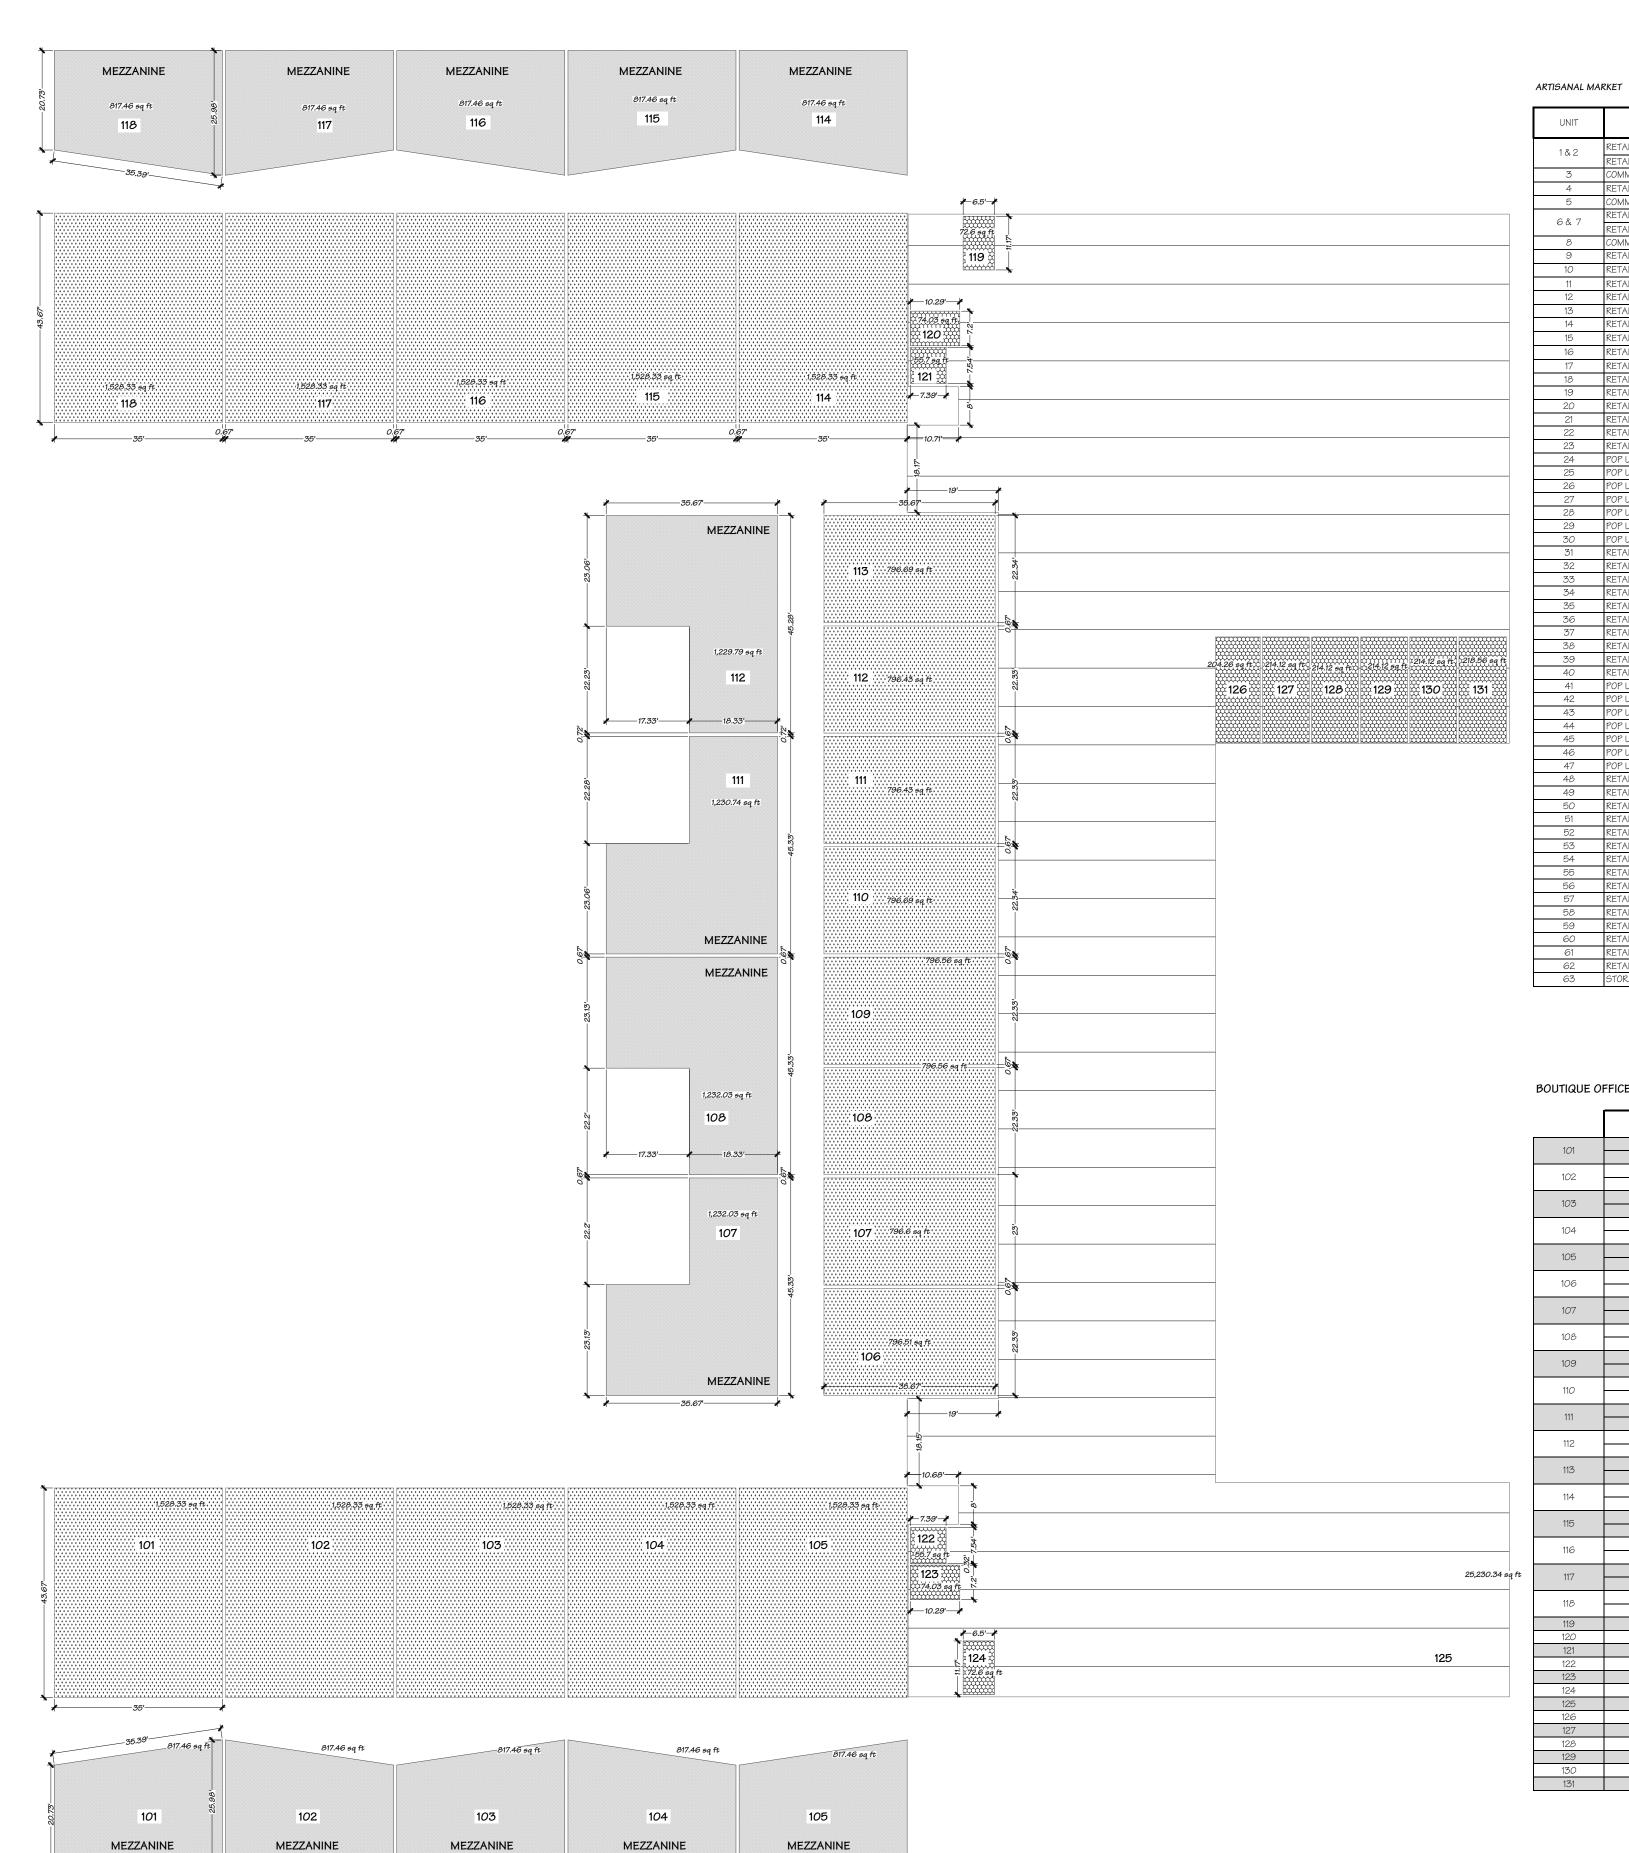

LIMIT	Here	/ IKE/10	COMMONATION	310K10L
UNIT	USES	SQ FT	SQ FT	SQ FT
	RETAIL SPACE	84.46		
1&2	RETAIL SPACE	506.84		
3	COMMON AREA	300.04	403.78	
4	RETAIL SPACE	1,865.39	-100.70	
5	COMMON AREA	1,000.00	395.00	
	RETAIL SPACE	133.00	333.00	
6 & 7	RETAIL SPACE	505.77		
8	COMMON AREA	303.77	21,195.15	
9	RETAIL SPACE	183.06	21,100.10	
10	RETAIL SPACE	190.00		
11	RETAIL SPACE	190.00		
12	RETAIL SPACE	190.00		
13	RETAIL SPACE	190.00		
14	RETAIL SPACE	190.00		
15	RETAIL SPACE	190.00		
16	RETAIL SPACE	190.00		
17	RETAIL SPACE	190.00		
18 19	RETAIL SPACE RETAIL SPACE	190.00 190.00		
20 21	RETAIL SPACE RETAIL SPACE	190.00 190.00		
22	RETAIL SPACE	190.00		
23	RETAIL SPACE	190.00		
24	POP UP SPACE	52.50		
25	POP UP SPACE	52.50		
26	POP UP SPACE	52.50		
27	POP UP SPACE	52.50		
28	POP UP SPACE	52.50		
29	POP UP SPACE	52.50		
30	POP UP SPACE	52.50		
31	RETAIL SPACE	422.50		
32	RETAIL SPACE	422.50		
33	RETAIL SPACE	651.63		
34	RETAIL SPACE	651.63		
35	RETAIL SPACE	651.63		
36	RETAIL SPACE	651.63		
37	RETAIL SPACE	651.63		
38	RETAIL SPACE	651.63		
39	RETAIL SPACE	525.63		
40	RETAIL SPACE	525.63		
41	POP UP SPACE	52.50		
42	POP UP SPACE	52.50		
43	POP UP SPACE	52.50		
44	POP UP SPACE	52.50		
45	POP UP SPACE	52.50		
46	POP UP SPACE	52.50		
47	POP UP SPACE	52.50		
48	RETAIL SPACE	183.06		
49	RETAIL SPACE	190.00		
50	RETAIL SPACE	190.00		
51	RETAIL SPACE	190.00		
52	RETAIL SPACE	190.00		
53	RETAIL SPACE	190.00		
54	RETAIL SPACE	190.00		
55	RETAIL SPACE	190.00		
56	RETAIL SPACE	190.00		
57	RETAIL SPACE	190.00		
58	RETAIL SPACE	190.00		
59	RETAIL SPACE	190.00		
60	RETAIL SPACE	190.00		
61	RETAIL SPACE	190.00		
62	RETAIL SPACE	190.00		
63	STORAGE			10,741.35
	1	1	i	
	TOTAL	AREA 15,322.62	21,993.93	10,741.35

\*NOTE: EACH AREA WAS CALCULATED WITHOUT WALLS

# BOUTIQUE OFFICE, OFFICE / WAREHOUSE, STRORAGE AND PARKING

	USES	AREA	
		SQ FT	
101	LEASE BOUTIQUE /SHOP CAFÉ	1528.33	1sT FLOOR
101		817.46	MEZZANINE
100	LEASE BOUTIQUE/SHOP/CAFÉ	1528.33	1sT FLOOR
102		817.46	MEZZANINE
107	LEASE BOUTIQUE /SHOP CAFÉ	1528.33	1sT FLOOR
103		817.46	MEZZANINE
404	LEASE BOUTIQUE/SHOP/CAFÉ	1528.33	1sT FLOOR
104		817.46	MEZZANINE
	LEASE BOUTIQUE /SHOP CAFÉ	1528.33	1sT FLOOR
105		817.46	MEZZANINE
	LEASE BOUTIQUE OFFICE, LOFT & WEREHOUSE	796.51	1sT FLOOR
106			
	LEASE BOUTIQUE OFFICE, LOFT & WEREHOUSE	796.6	1sT FLOOR
107		1232.03	MEZZANINE
	LEASE BOUTIQUE OFFICE, LOFT & WEREHOUSE	796.56	16T FLOOR
108	ELINE POUNCE OF FICE, EUT TO WEIGHTOUDE	1232.03	MEZZANINE
	LEASE BOUTIQUE OFFICE, LOFT & WEREHOUSE	796.56	16T FLOOR
109	ELIGE DOUTIQUE OFFICE, EUT A WEKEHOUDE	700.00	IST FEOOR
	LEASE BOUTIQUE OFFICE, LOFT & WEREHOUSE	796.69	1sT FLOOR
110	ELINE DOUNGE OF THE WENT HOUSE	, 50.00	1011 2001
	LEASE BOUTIQUE OFFICE, LOFT & WEREHOUSE	796.43	1sT FLOOR
111	EE/IGE DOUTIQUE OFFICE, EOFF & WEREHOUSE	1230.74	MEZZANINE
	LEASE BOUTIQUE OFFICE, LOFT & WEREHOUSE	796.43	1sT FLOOR
112	LEASE DOUTIQUE OFFICE, LOFT & WEREHOUSE	1229.79	MEZZANINE
	LEASE BOUTIQUE OFFICE. LOFT & WEREHOUSE	796.69	
113	LEASE DOUTIQUE OFFICE, LOFT & WENEHOUSE	790.09	1sT FLOOR
	LEASE BOUTIQUE/SHOP/CAFÉ	1528.33	1sT FLOOR
114	EE/IGE DOUTIQUE/GITOT/C/ITE	817.46	MEZZANINE
	LEASE BOUTIQUE /SHOP CAFÉ	1528.33	1sT FLOOR
115	LEASE DOUTIQUE /SHOT CAFE	817.46	
	LEACE BOUTIONE (CHORICAEÉ	1528.33	MEZZANINE
116	LEASE BOUTIQUE/SHOP/CAFÉ		1sT FLOOR
	LEACE POLITICIE (CLIOP CARÉ	817.46	MEZZANINE
117	LEASE BOUTIQUE /SHOP CAFÉ	1528.33	16T FLOOR
		817.46	MEZZANINE
118	LEASE BOUTIQUE/SHOP/CAFÉ	1528.33	15T FLOOR
***	04001.04	817.46	MEZZANINE
119	STORAGE	72.6	15T FLOOR
120	ELECTRICAL ROOM	74.03	1sT FLOOR
121	BATHROOM	55.7	1st FLOOR
122	BATHROOM	55.7	1st FLOOR
123	ELECTRICAL ROOM	74.03	1st FLOOR
124	STORAGE	72.6	1st FLOOR
125	PARKING AREA	25230.34	1st FLOOR
126	STORAGE	204.26	1st FLOOR
127	STORAGE	214.12	1st FLOOR
128	STORAGE	214.12	1st FLOOR
129	STORAGE	214.12	1st FLOOR
130	STORAGE	214.12	1st FLOOR
131	STORAGE	218.56	1st FLOOR

TOTAL AREA

\*NOTE: EACH AREA WAS CALCULATED WITHOUT WALLS

Paul H. Bach AR 0010442

© copyright 2017

R BOUTIQUE ARTISANAL MARKET & WAREHOUSI Y&G ST/



16220.INV RAWING EDITION 161220.INV-15.pln PRINTING DATE 10/18/2017

DRAWN BY E.B. - R.R. AREAS & USES

ELEVATOR

PARKING SPACES REQUIRED

PARKING SPACES PROVIDED

PARKING BUILDING AREA SQ FT 34118.57 72.6 72.6 USES 303 STORAGE
STORAGE
PARKING SPACE
STORAGE
STORAGE
PARKING SPACE
STORAGE 501 502 503 601 602 603 604 STORAGE STAIR ELEVATOR

		PARKING SPACE PER CODE				
TYPE	AREAS	ARTISANAL MARKET	WAREHOUSE	BOUTIQUE OFFICE		
	1 X 250 sq ft		1 X 1,000 sq ft	1 X 400 sq ft		
WAREHOUSE (STORAGE)	13,317.20 sqft		13.32			
ARTISANAL MARKET	35,429.05 sqft	141.72				
BOUTIQUE/SHOP/CAFÉ	24,720.97 sqft	98.88				
BOUTIQUE OFFICE	11,935.42 sq ft			29.84		
	·	240.60	13.32	29.84		
		Α	В	С		
		TOTAL PARKING SPACES F	REQUIRED A+B+C=	283.76		


		OUTSIDE			INSIDE		
	HANDICAP	SPECIAL	REGULAR	HANDICAP	SPECIAL	REGULAR	
1st FLOOR				6	1	85	
2nd FLOOR				6		89	
3rd FLOOR				6		93	
4th FLOOR				6		114	
5th FLOOR				6		114	
6th FLOOR ROOF				2		72	
				32	1	567	

Grand Total	600
total normal parking space	567
total special parking space	1
Total handicap parking space	32

\*NOTE: EACH AREA WAS CALCULATED WITHOUT WALLS

TOTAL AREA 146446.32

5<sup>th</sup> FLOOR

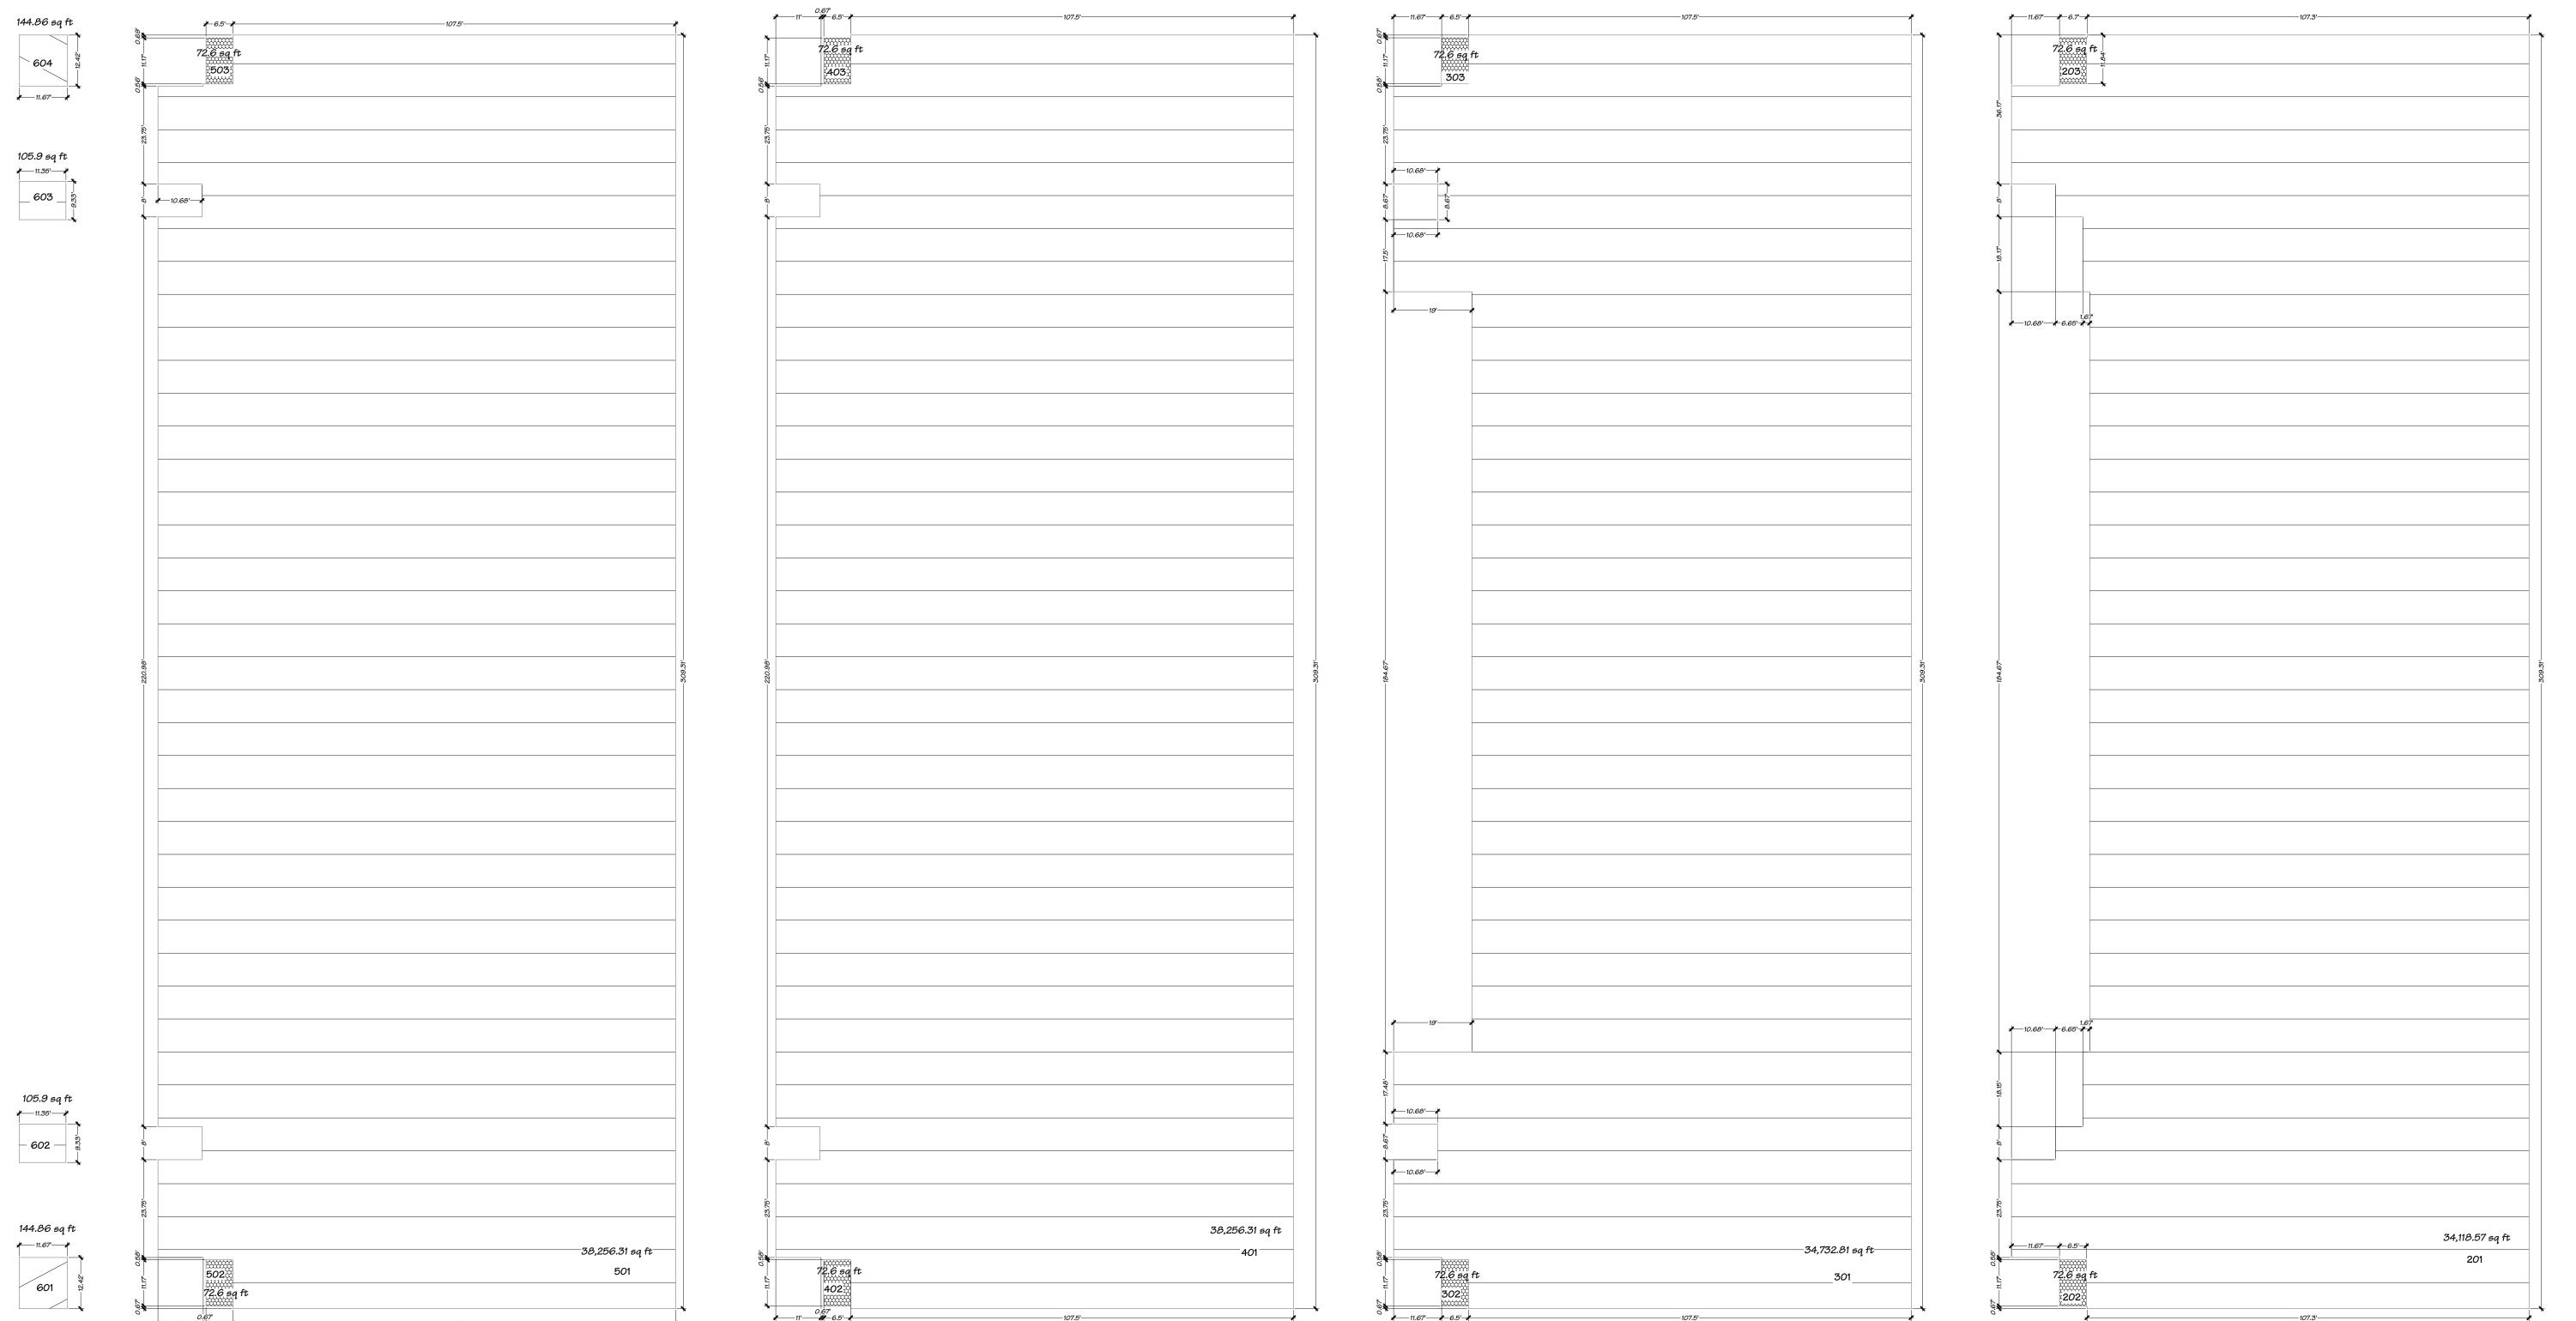

4<sup>th</sup> FLOOR





6<sup>th</sup> FLOOR



3<sup>rd</sup> FLOOR


© copyright 2017

Paul H. Bach AR *00*10442


<u>ARTISANAL MARKET & BOUTIQUE</u> <u>WAREHOUSE</u> ATION PROJECT Y&G ST/



161220.INV-15.pln PRINTING DATE 10/18/2017 DRAWN BY E.B. - R.R. AREAS & USES

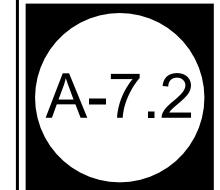


2<sup>nd</sup> FLOOR

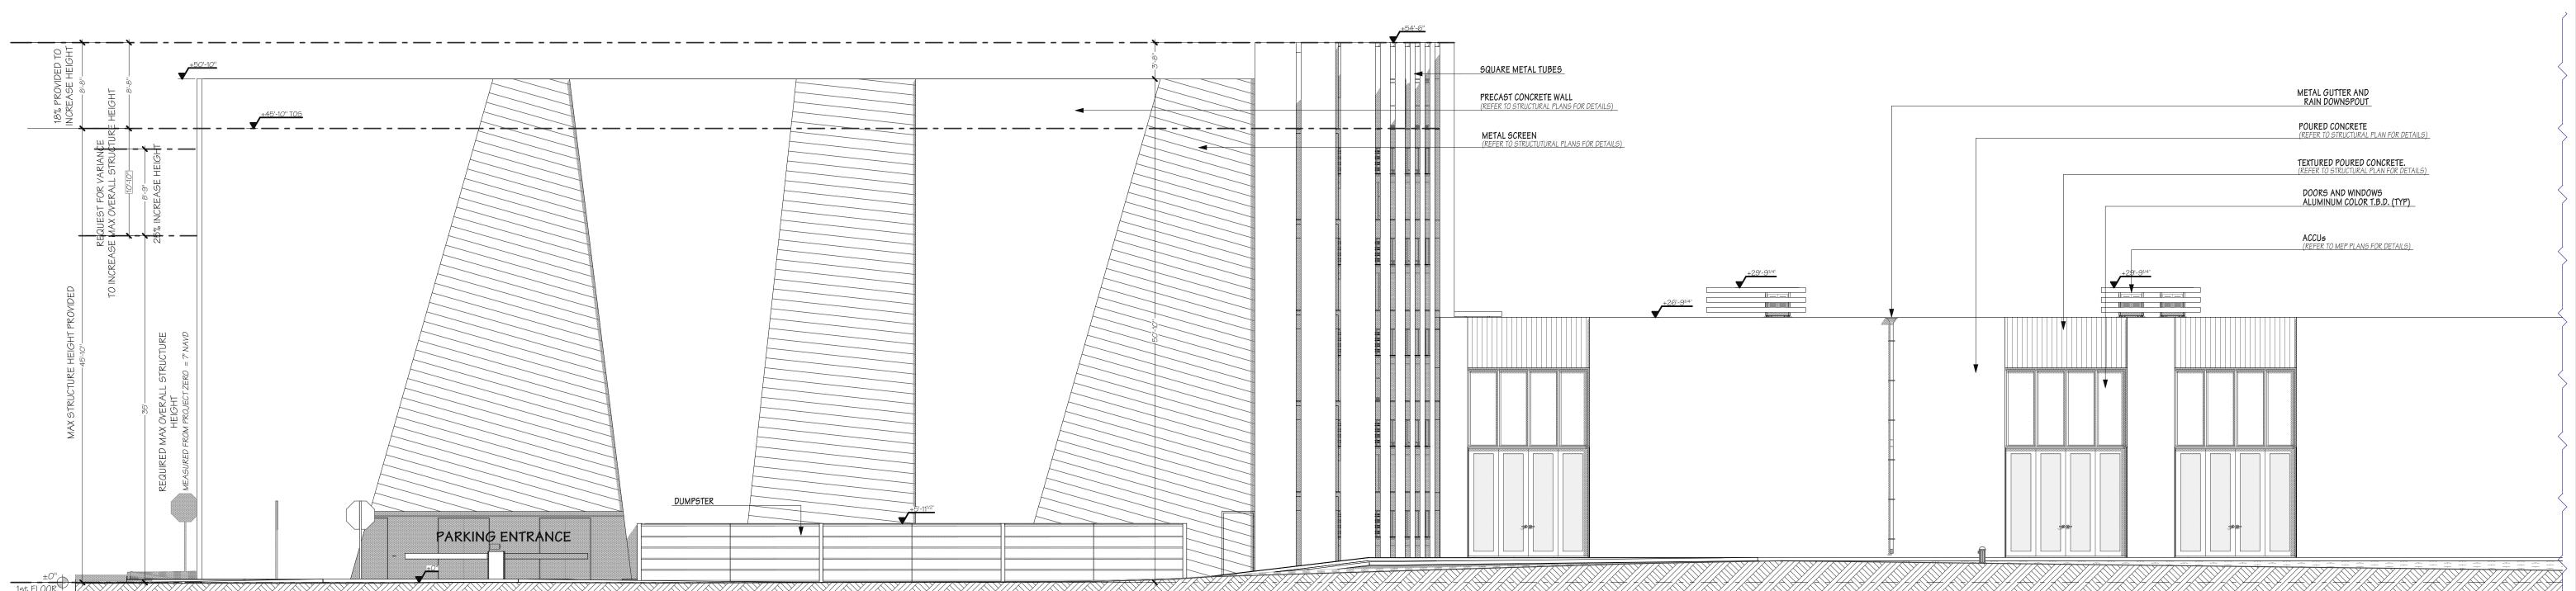

02 02 REAR VIEW ELEVATION

A-8 SCALE: 1/8" = 1'-0"

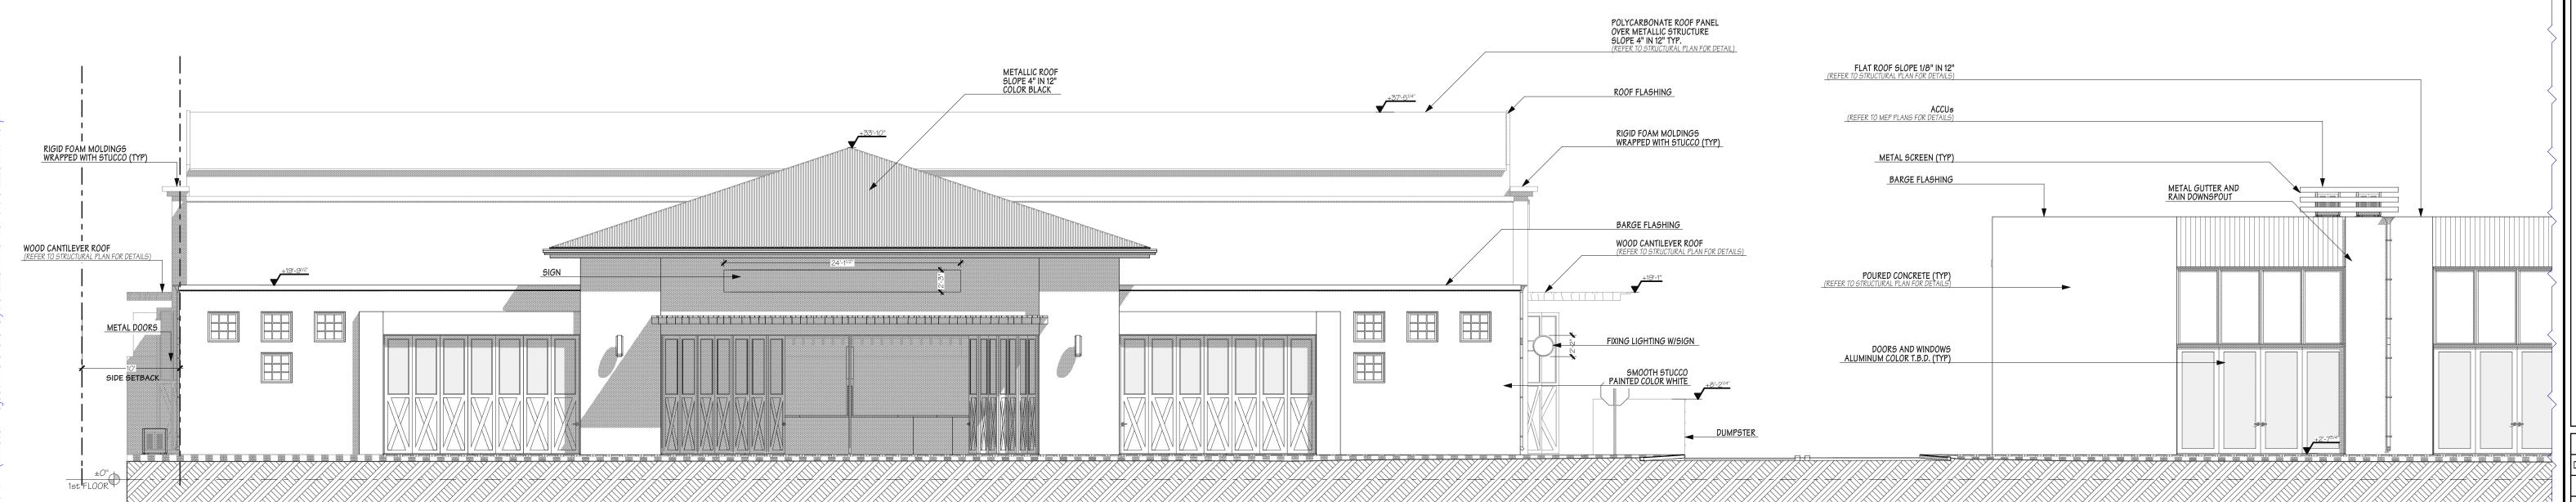

01 O1 FRONT VIEW ELEVATION

SCALE: 1/8" - 1'-0"

Paul H. Bach AR 0010442

CLIENT ISSUE / COMMENT BY DATE

PRELIMINAR T.A.C.

The Species project of the programmer of the present of the presence of the

Y&G STATION PROJECT
ARTISANAL MARKET & BOUTIQUE
WAREHOUSE

E Boca Raton Rd, Suite 1

Ta Raton, Florida 33432

The Solution So

MEDIATES, INC. A A

JOB ID 16220.INV


DRAWING EDITION 161220.INV-15.pln

PRINTING DATE 10/18/2017

DRAWN BY E.B. - R.R.


ELEVATIONS 01-02

A-8

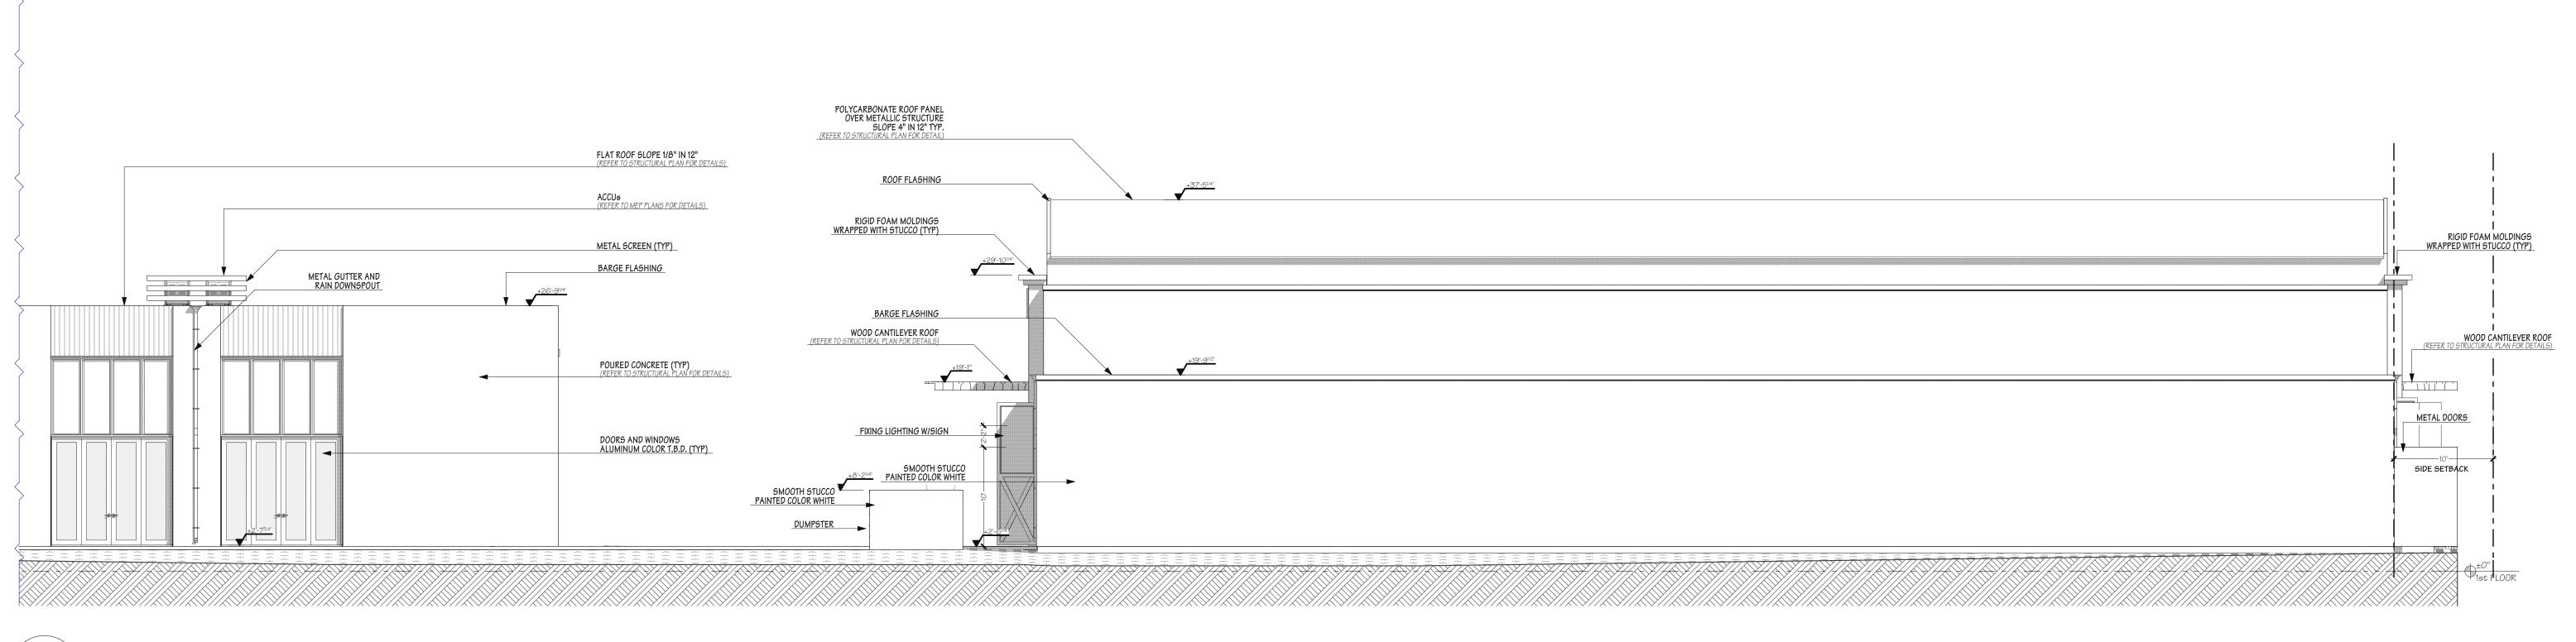

O2 REAR VIEW ELEVATION

A-8.1 SCALE: 1/8" = 1'-0"

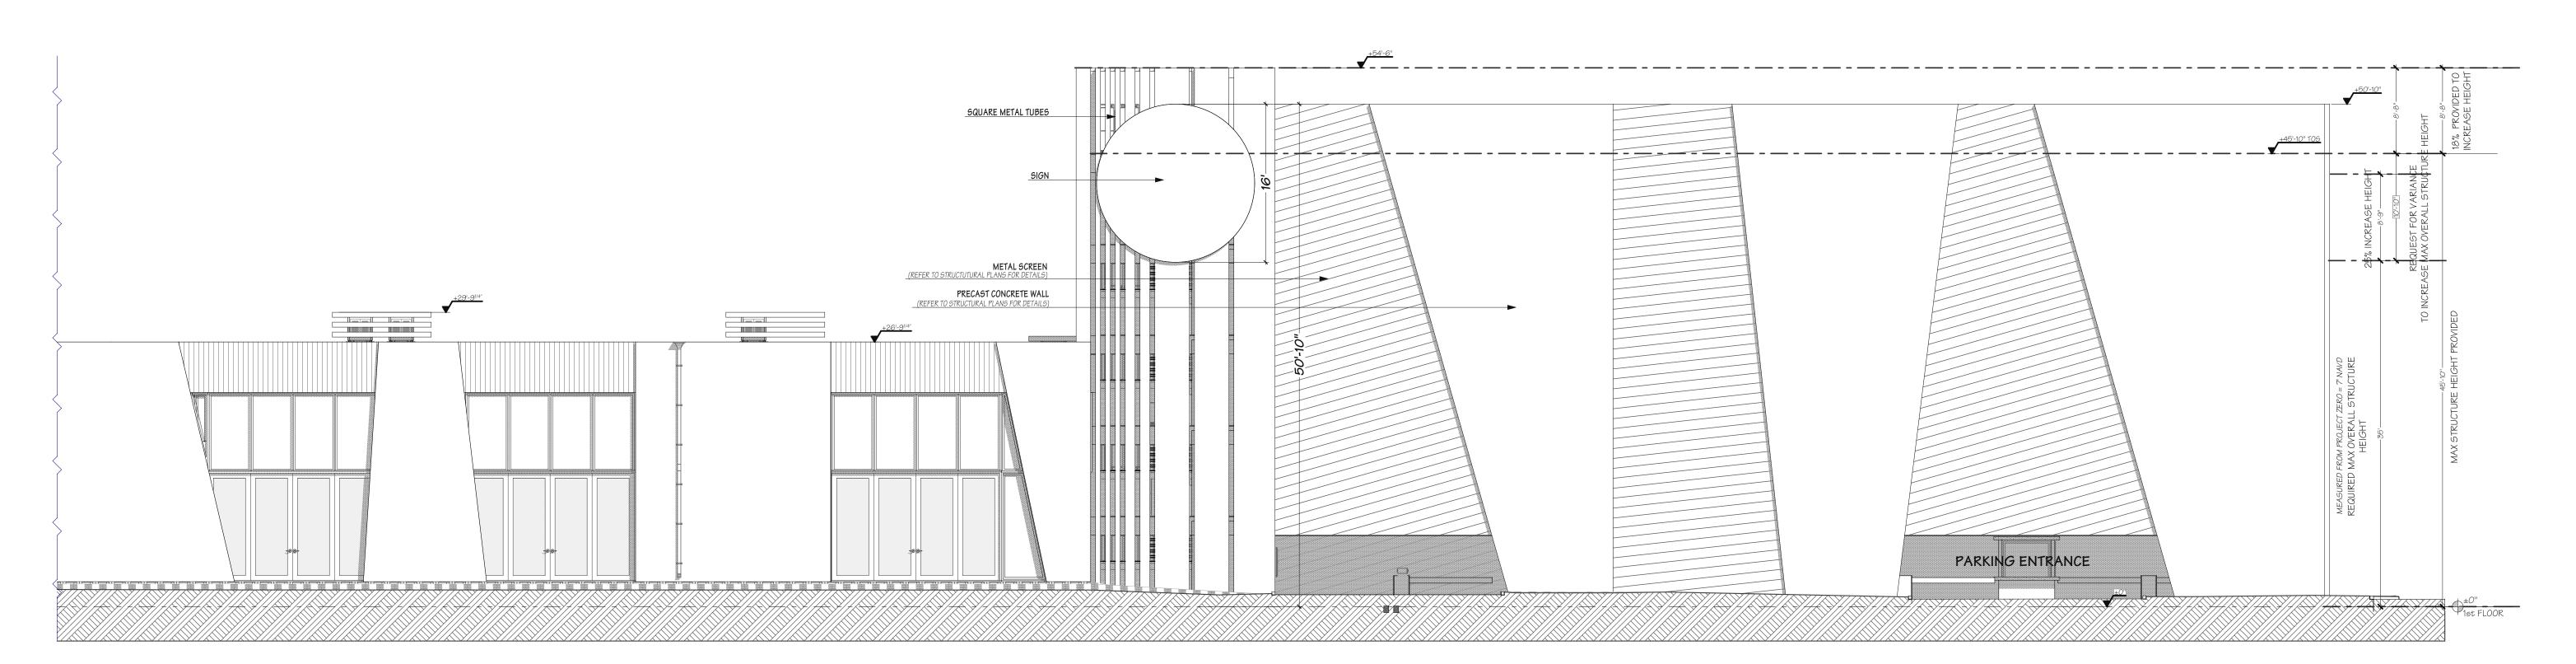

01 O1 FRONT VIEW ELEVATION

3.1 SCALE: 1/8" = 1'-0"

RG STATION PROJECT
FOR ELLISANAL MARKET & BOUTIQUE
FOR ELLISANAL MARKET WAREHOUSE

Paul H. Bach AR 0010442

© copyright 2017

| 70 E Boca Raton Rd, Suite | Boca Raton, Florida 334,32 | Phone: 56|362 6408 | Web: BE-DESIGN.NET | NC. A A Z 6 0 0 | Z Z 7

ZUSULIATES, INC.

JOB ID 16220.INV


DRAWING EDITION 161220.INV-15.pln


PRINTING DATE 10/18/2017

DRAWN BY E.B. - R.R.

**ELEVATIONS 01-02** 

A-8.1

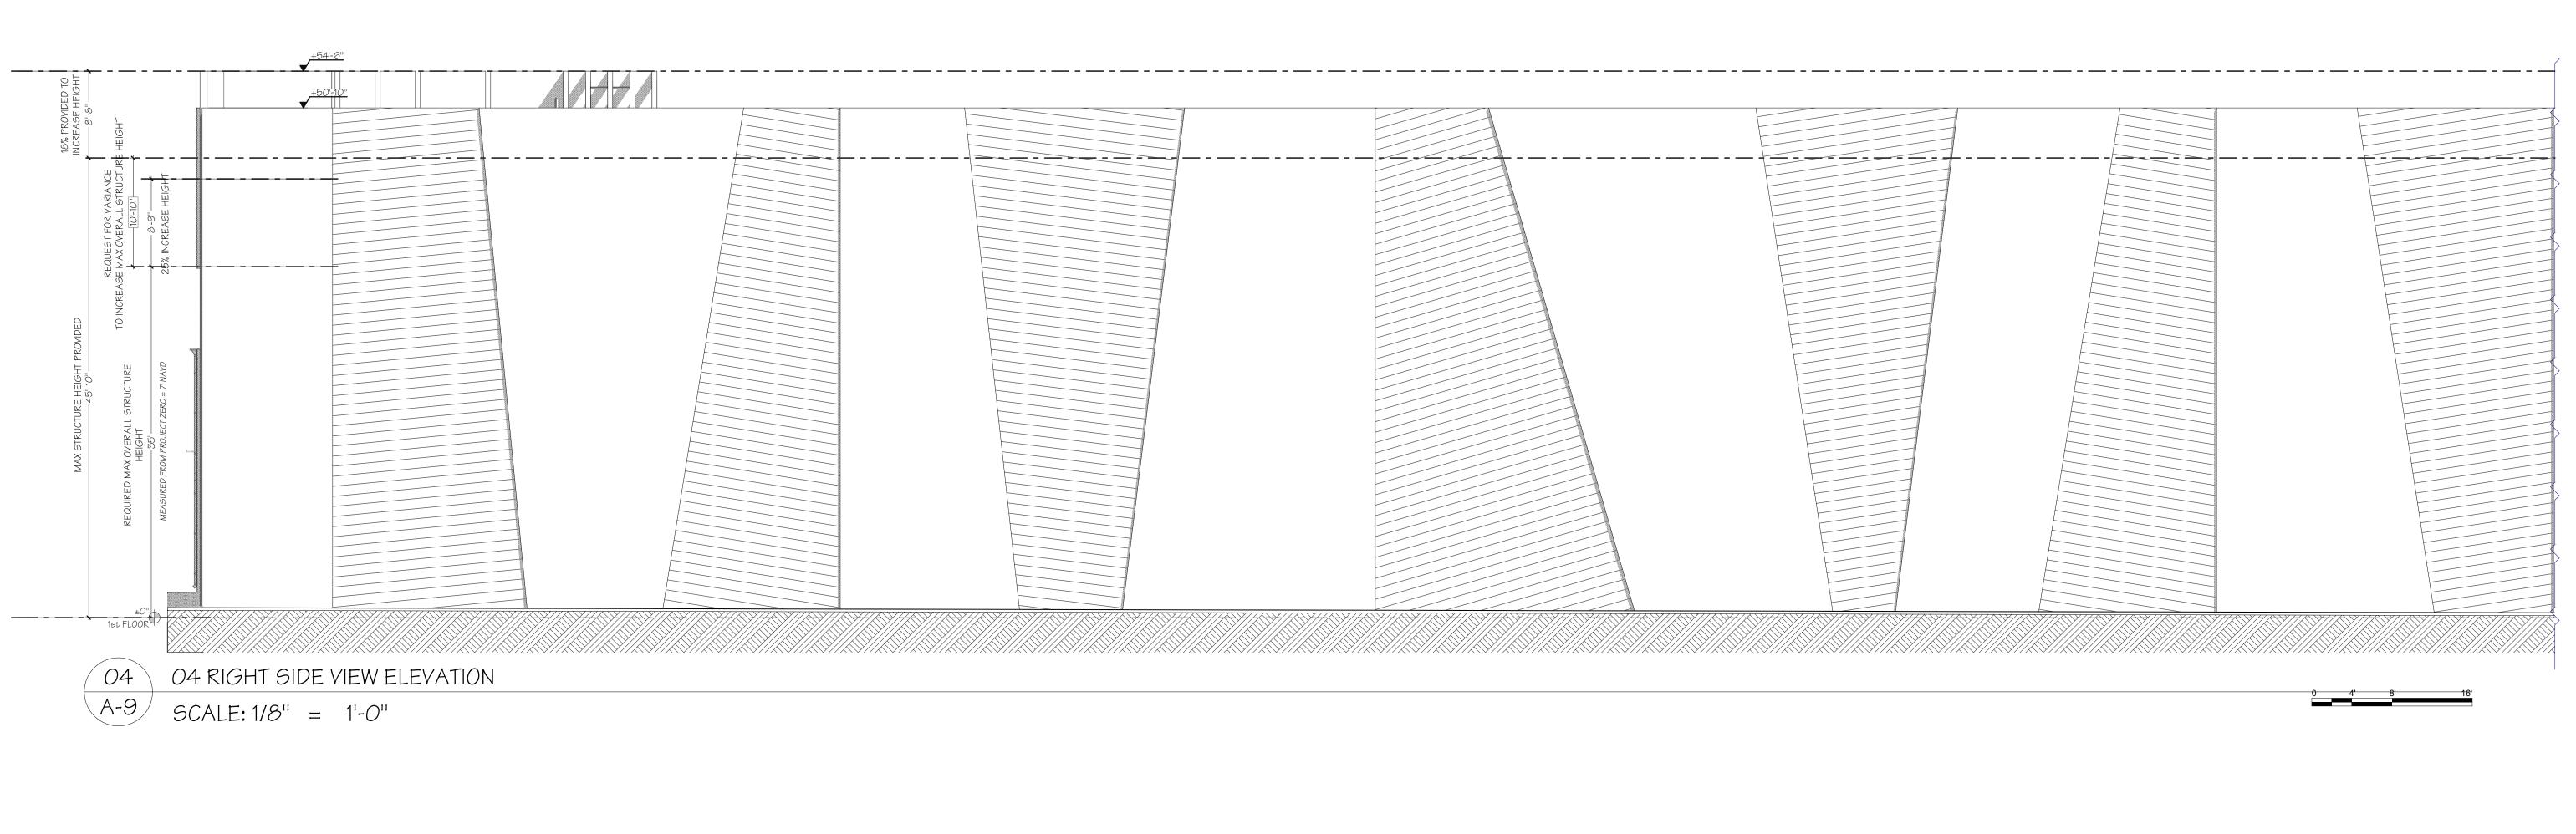

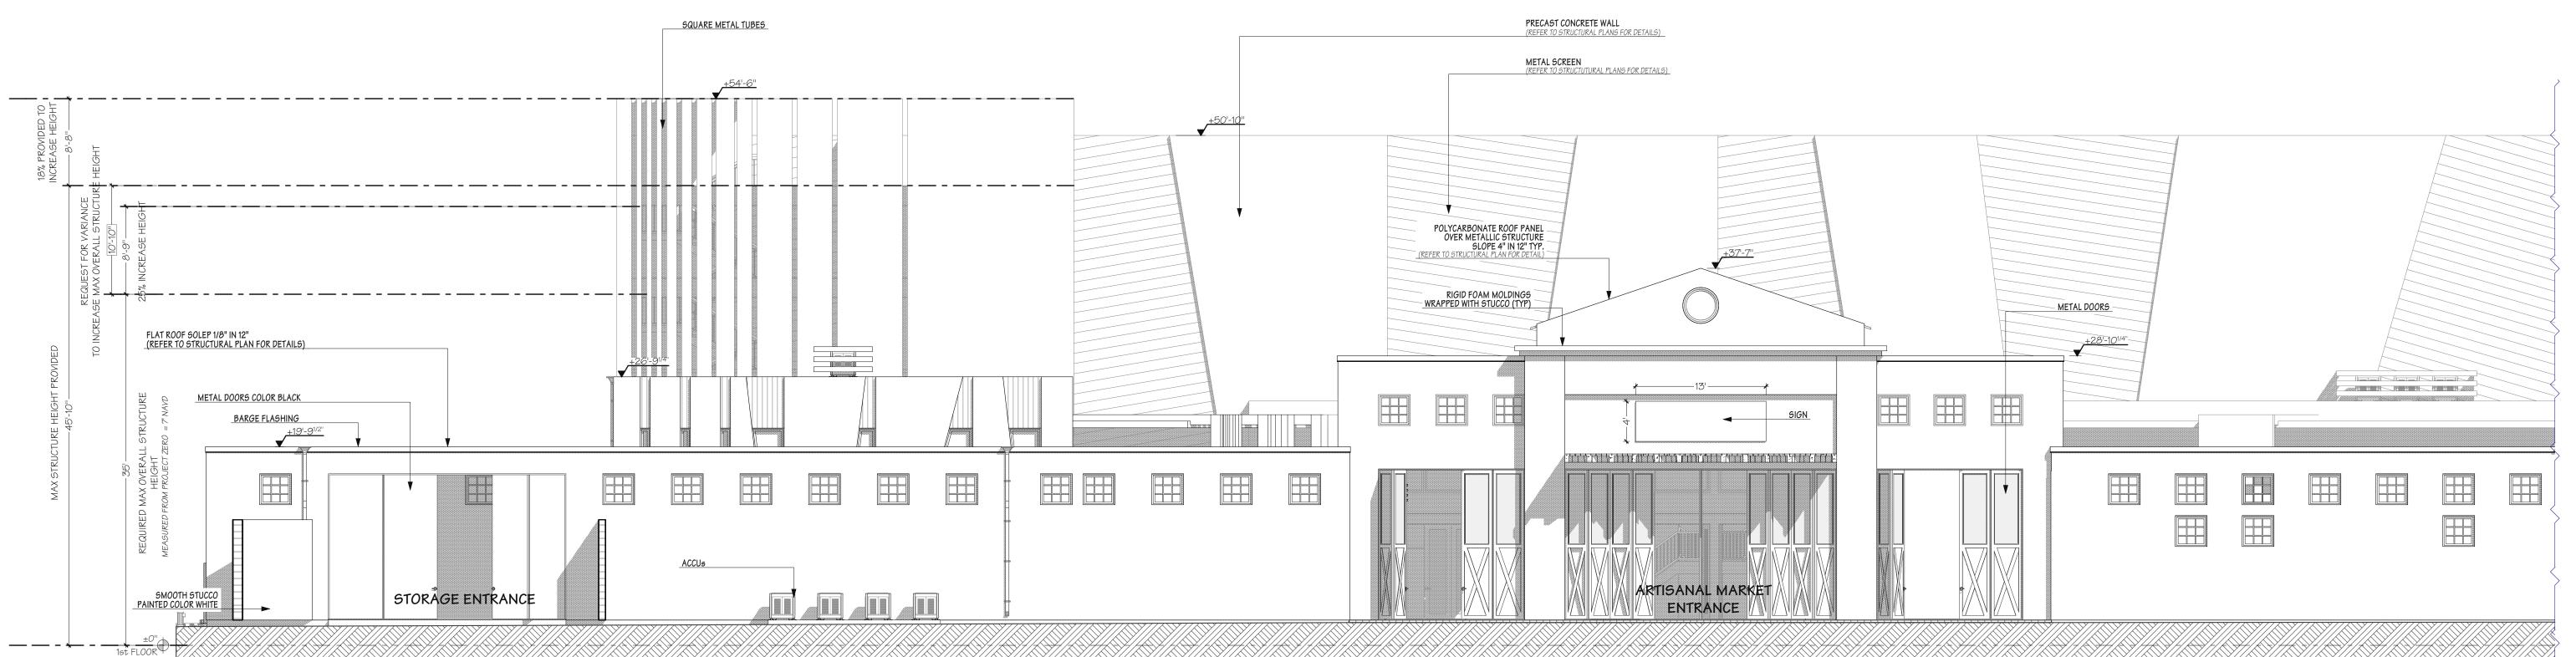


03 LEFT SIDE VIEW ELEVATION

SCALE: 1/8" = 1'-0"

<u>ARTISANAL</u> Y&G ST/

16220.INV RAWING EDITION 161220.INV-15.pln

PRINTING DATE 10/18/2017 DRAWN BY E.B. - R.R. **ELEVATIONS 03-04** 

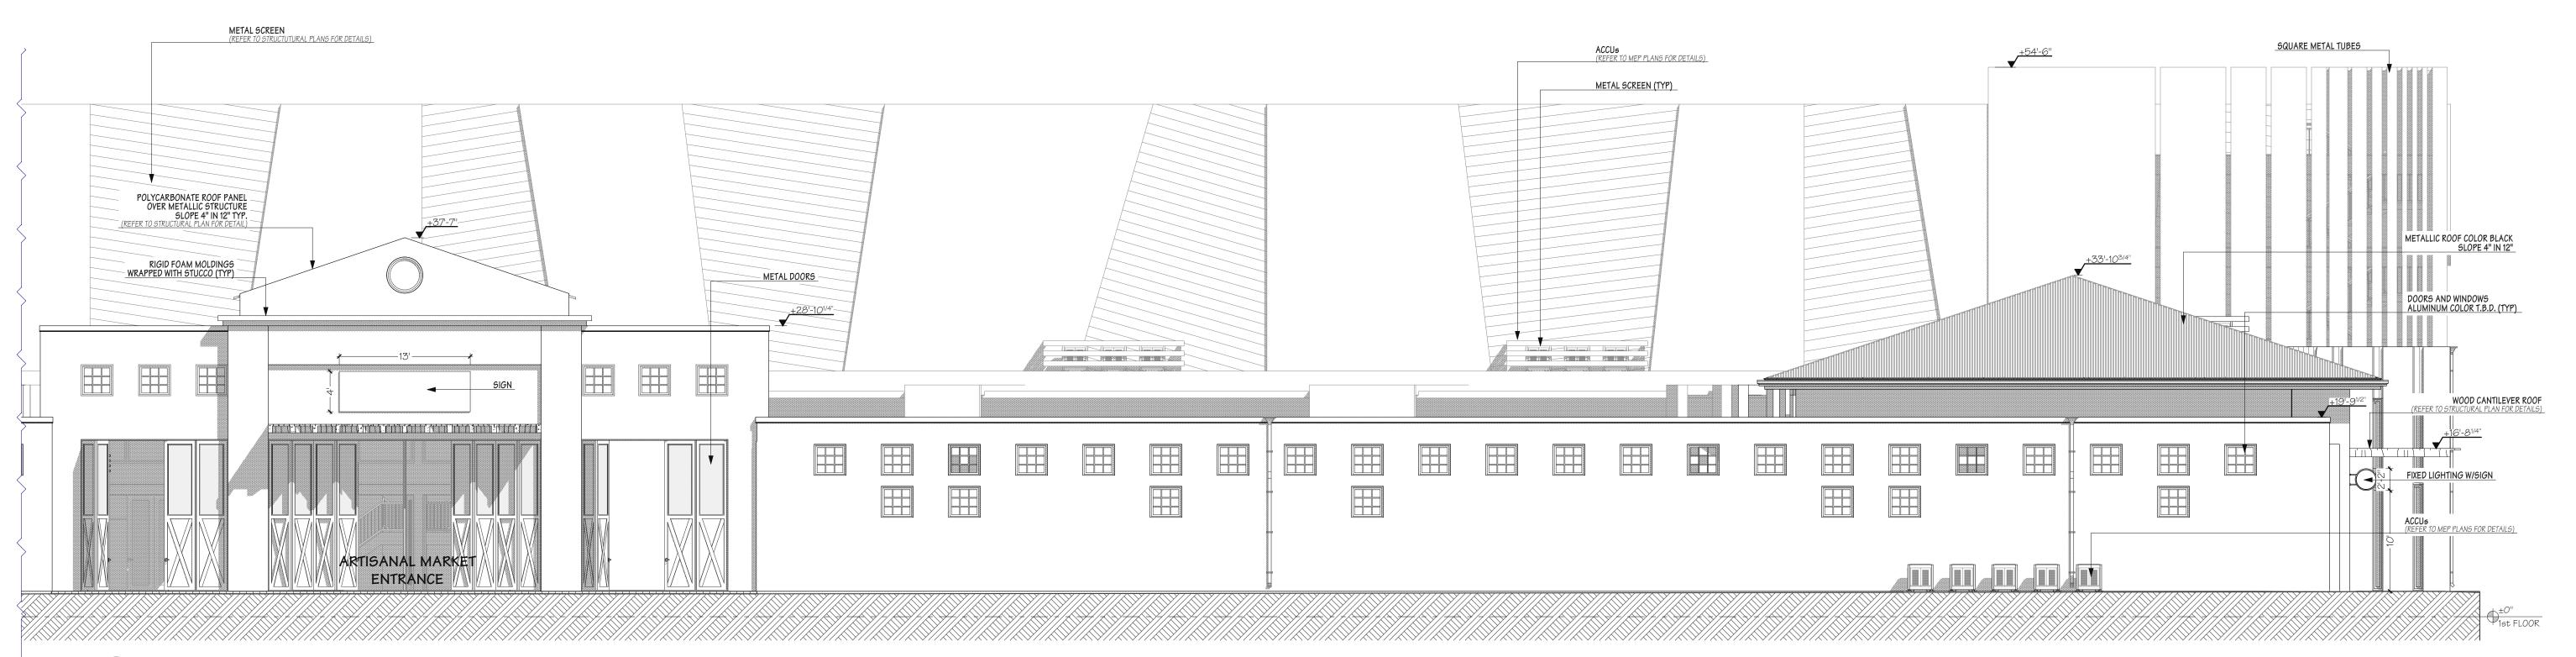

03 O3 LEFT SIDE VIEW ELEVATION

A-9.1 SCALE: 1/8" = 1'-0"

Paul H. Bach AR *00*10442

Y&G STATION PROJECT
ARTISANAL MARKET & BOUTIQUE
WAREHOUSE

70 E Boca Raton Rd, Suite |
Boca Raton, Florida 33432
Phone: 561362 6408
Web: BE-DESIGN.NET
A A Z 6 0 0 1 2 2 7

DESIGNES, INC.

JOB ID 16220.INV


ORAWING EDITION 161220.INV-15.pln


PRINTING DATE 10/18/2017

DRAWN BY E.B. - R.R.

**ELEVATIONS 03-04** 

A-9.1

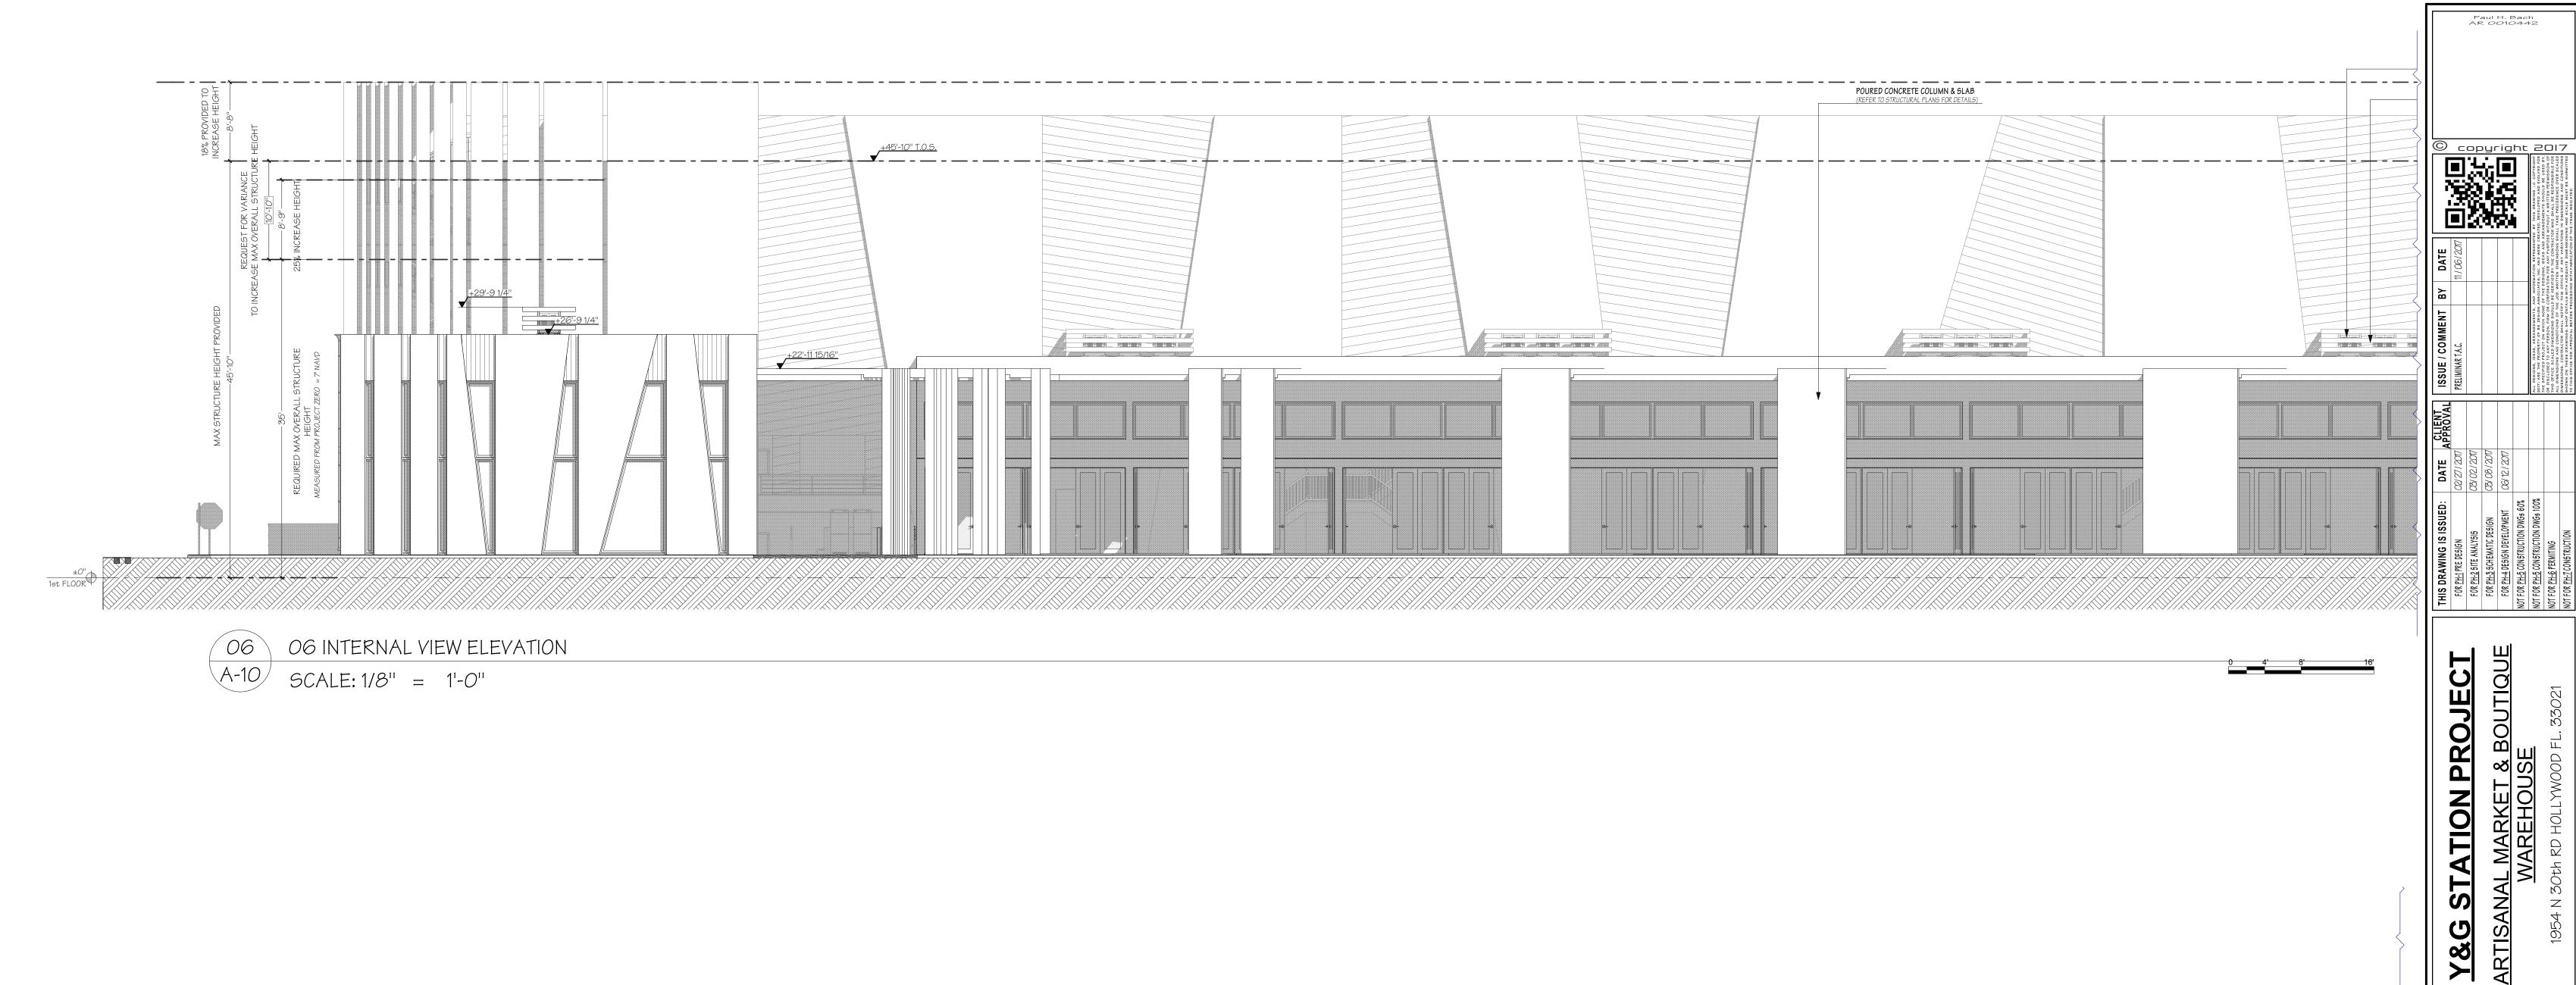

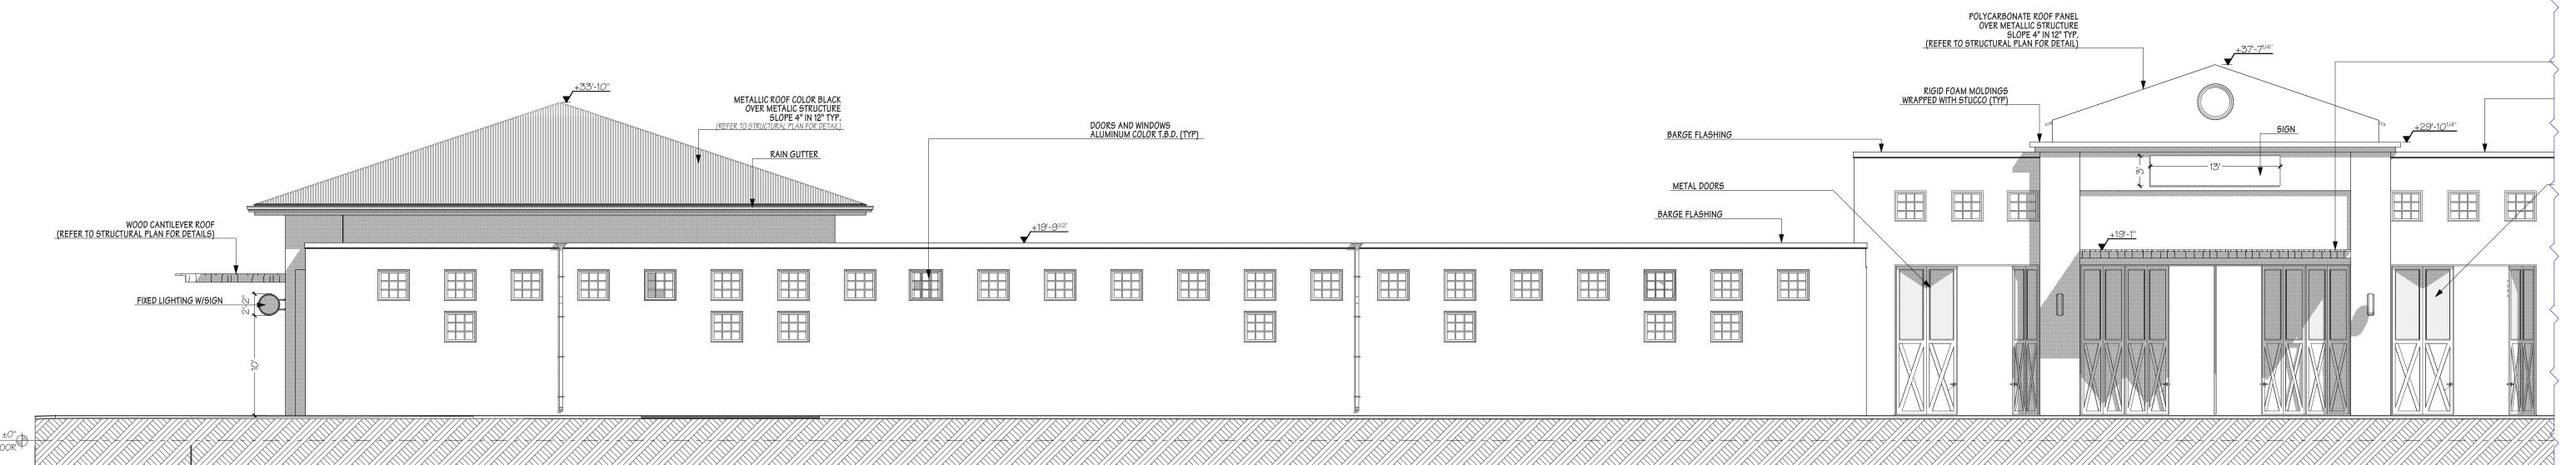



05 INTERNAL VIEW ELEVATION

SCALE: 1/8" = 1'-0"

16220.INV RAWING EDITION 161220.INV-15.pln PRINTING DATE 10/18/2017 DRAWN BY E.B. - R.R. **ELEVATIONS 05-06** 

Y&G ST/

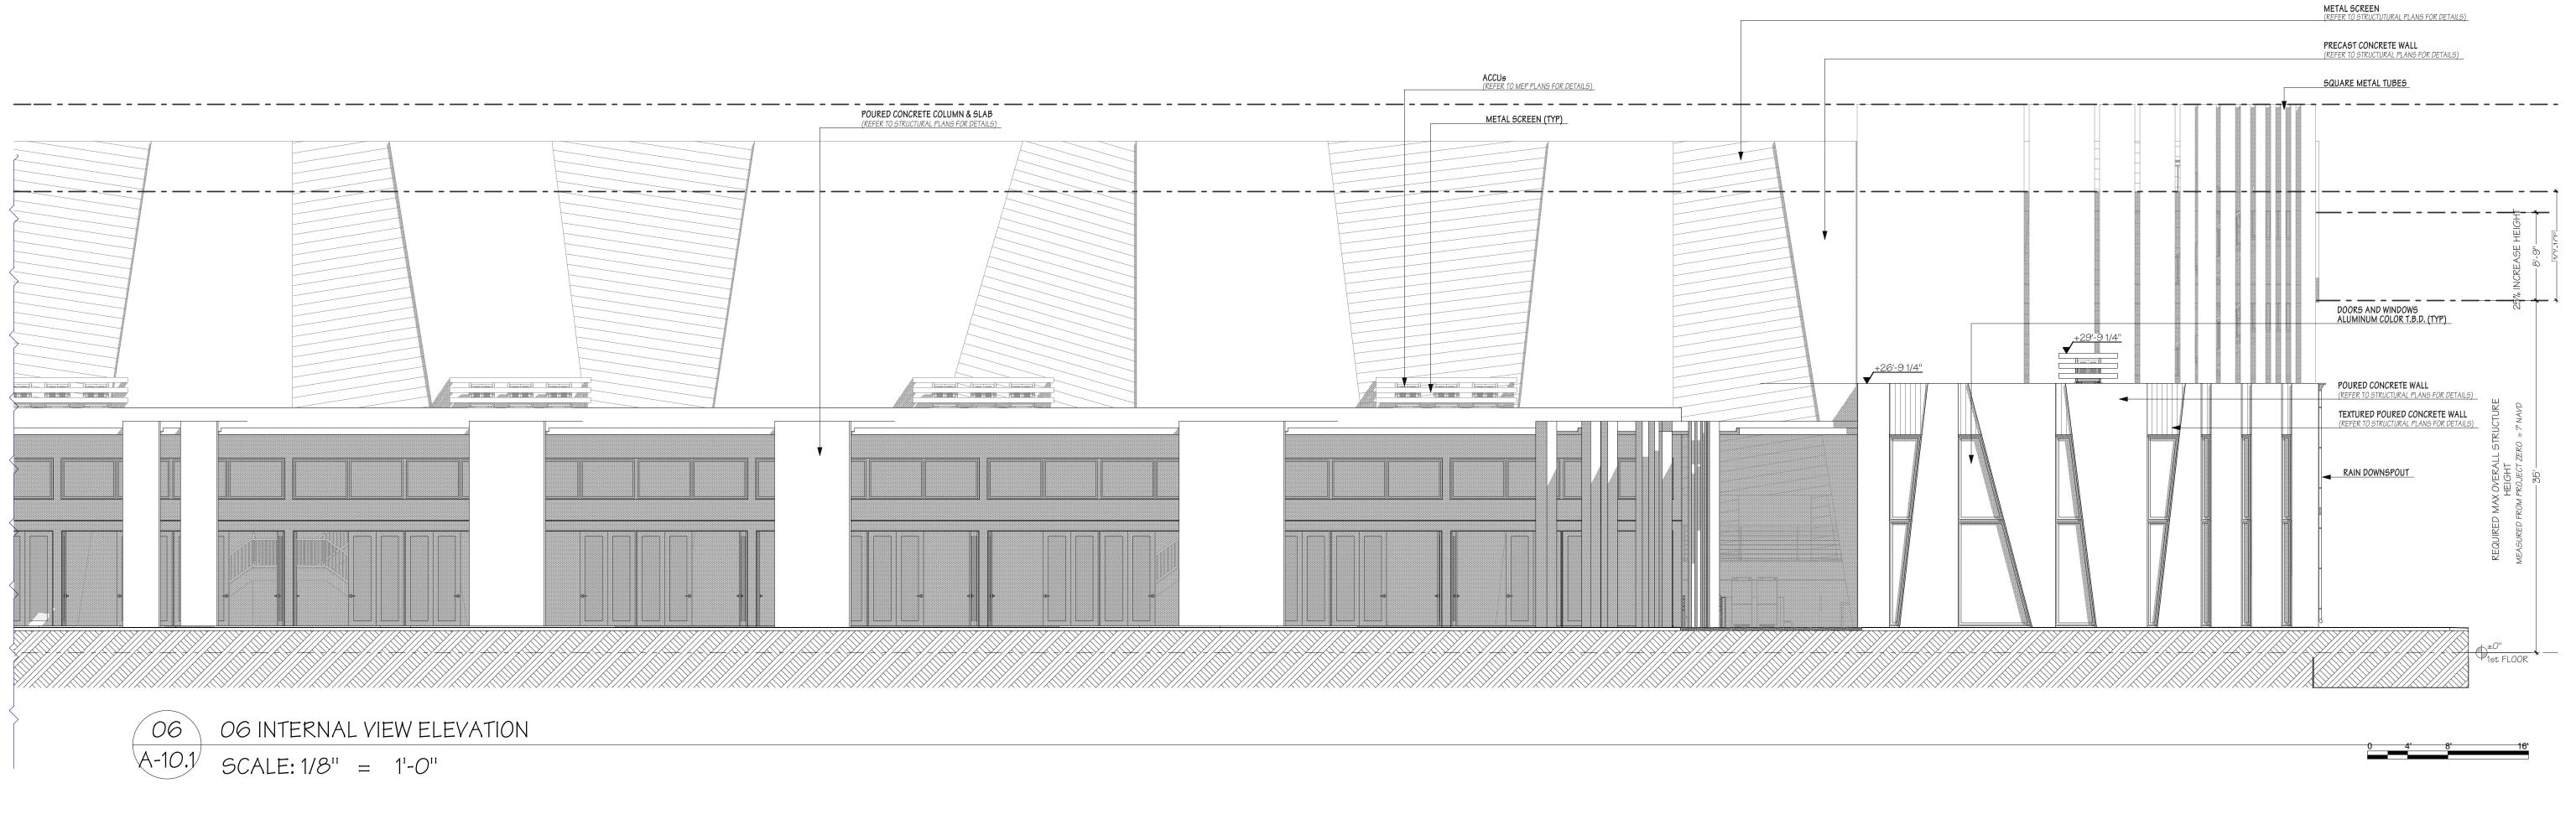

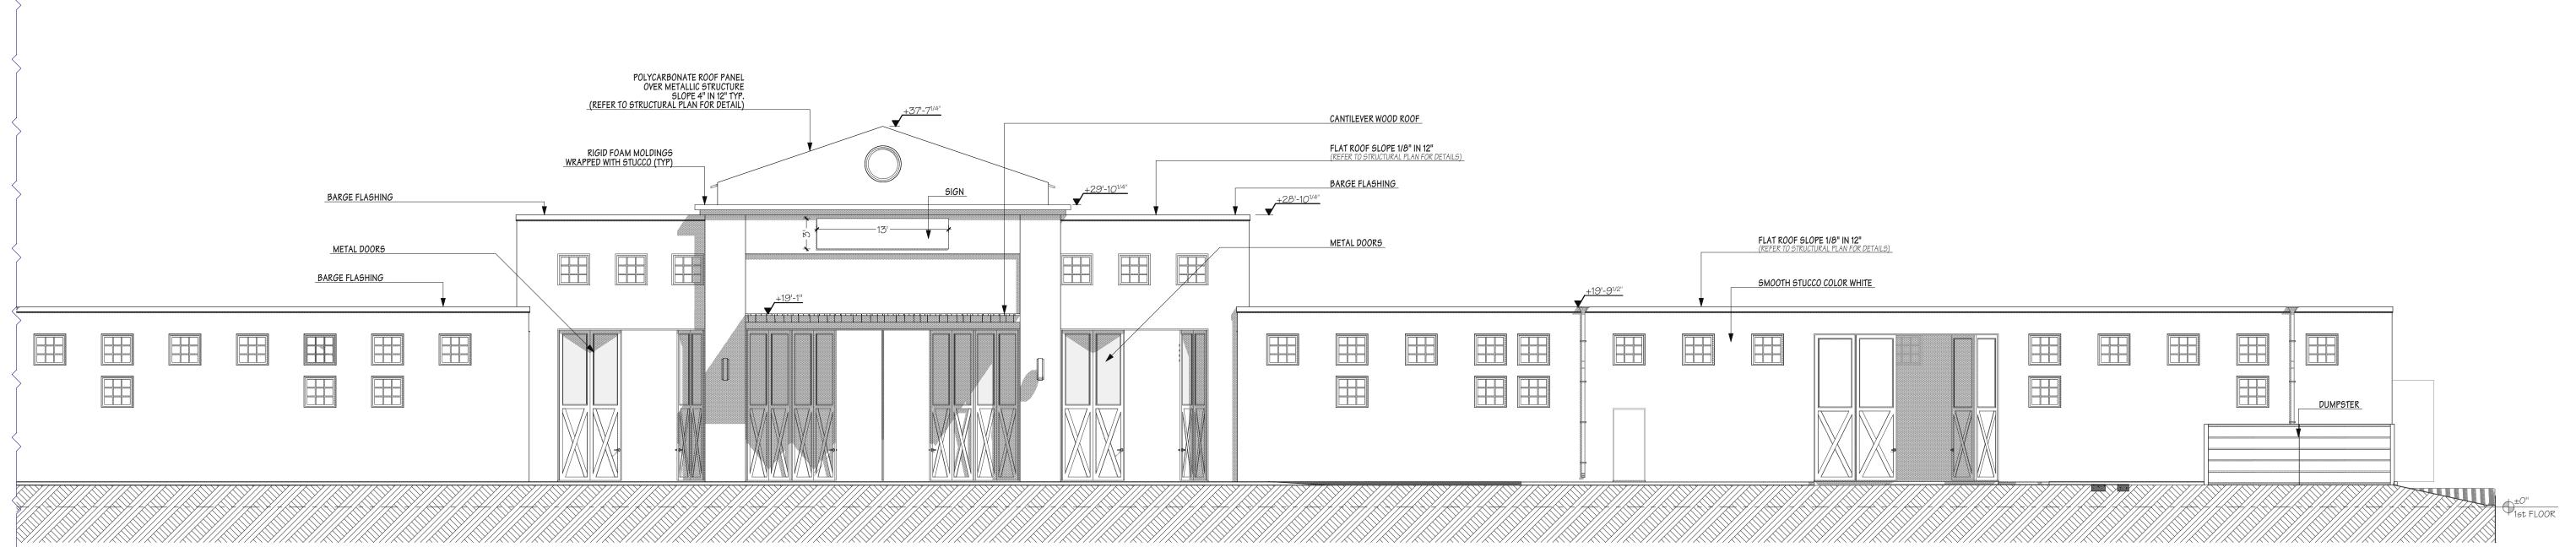

05 05 INTERNAL VIEW ELEVATION A-10.1 SCALE: 1/8" = 1'-0" THIS DRAWING IS ISSUED:

THIS DRAWING IS ISSUED:

FOR PH-1 PRE DESIGN

ON FOR PH-2 SITE ANALYSIS

FOR PH-2 SITE ANALYSIS

FOR PH-2 SITE ANALYSIS

ON FOR PH-

Paul H. Bach AR *001044*2

copyright 2017

TOE Boca Raton Rd, Suite 1
Boca Raton, Florida 334,32
Phone: 561 362 6408
Web: BE-DESIGN.NET

JOB ID 16220.INV

DRAWING EDITION 161220.INV-15.pln

PRINTING DATE 10/18/2017

DRAWN BY E.B. - R.R.

ELEVATIONS 05-06

A-10.1