#### **PLANNING DIVISION**



2600 Hollywood Boulevard Room 315 Hollywood, FL 33022 File No. (internal use only):

# **GENERAL APPLICATION**



Tel: (954) 921-3471 Fax: (954) 921-3347

This application must be completed in full and submitted with all documents to be placed on a Board or Committee's agenda.

The applicant is responsible for obtaining the appropriate checklist for each type of application.

Applicant(s) or their authorized legal agent must be present at all Board or Committee meetings.

At least one set of the submitted plans for each application must be signed and sealed (i.e. Architect or Engineer).

Documents and forms can be accessed on the City's website at

http://www.hollywoodfl.org/DocumentCenter/Home/View/21



_	
	APPLICATION TYPE (CHECK ONE):
	☐ Technical Advisory Committee ☐ Historic Preservation Board
	☐ City Commission ☐ Planning and Development Board
	Date of Application: 8 4 1 1 7
	Location Address: 1955 Tyler 5+ree+ 4 209 N . 20 th Avenue  Lot(s): 1 · 2 · 3 Block(s): 23 Subdivision: Hollywood  Folio Number(s): 514215014040 4 514215014041  Zoning Classification: ND - 3 Land Use Classification: PAC  Existing Property Use: Commercial Sq Ft/Number of Units: 15938  Is the request the result of a violation notice? ( ) Yes (√) No If yes, attach a copy of violation. Has this property been presented to the City before? If yes, check all that apply and provide File Number(s) and Resolution(s): P. A. C. O.  □ Economic Roundtable □ Technical Advisory Committee □ Historic Preservation Board
	☐ City Commission ☐ Planning and Development
	Explanation of Request: Technical Advisory Review of a three story office & retail Building
	Number of units/rooms: NIA Sq Ft: NIA
l	Value of Improvement: 2 million Estimated Date of Completion: July 2018
ľ	Will Project be Phased? ( ) Yes √No If Phased, Estimated Completion of Each Phase
ľ	
	Name of Current Property Owner: EZEVIEL DEUCLOPMENT, LLC
	Address of Property Owner: 1235 Seagol   Terrace Hollywood FI
١.	Telephone: 954 - 364 - 743 Fax: 954 - 456-658 Email Address: mezetic l C offi
ľ	Name of Consultant/Representative/Tenant (circle one): Toseph B. Valler
ľ	Address: 2417 HONYWOOD BIVO. HONYWOOTElephone: 954-920-574
, 1	Fax: 954-926-2841 Email Address: <u>Joseph @ valler architects.com</u> Date of Purchase: <u>T124113</u> Is there an option to purchase the Property? Yes ( ) No ( )
	f Yes, Attach Copy of the Contract.
	ist Anyone Else Who Should Receive Notice of the Hearing:
-	Address:
_	Address: Email Address:

## **PLANNING DIVISION**



2600 Hollywood Boulevard Room 315 Hollywood, FL 33022 File No. (internal use only):


## **GENERAL APPLICATION**

## **CERTIFICATION OF COMPLIANCE WITH APPLICABLE REGULATIONS**

The applicant/owner(s) signature certifies that he/she has been made aware of the criteria, regulations and guidelines applicable to the request. This information can be obtained in Room 315 of City Hall or on our website at <a href="www.hollywoodfl.org">www.hollywoodfl.org</a>. The owner(s) further certifies that when required by applicable law, including but not limited to the City's Zoning and Land Development Regulations, they will post the site with a sign provided by the Office of Planning and Development Services. The owner(s) will photograph the sign the day of posting and submit photographs to the Office of Planning and Development Services as required by applicable law. Failure to post the sign will result in violation of State and Municipal Notification Requirements and Laws.

(I)(We) certify that (I) (we) understand and will comply with the provisions and regulations of the City's Zoning and Land Development Regulations, Design Guidelines, Design Guidelines for Historic Properties and City's Comprehensive Plan as they apply to this project. (I)(We) further certify that the above statements and drawings made on any paper or plans submitted herewith are true to the best of (my)(our) knowledge. (I)(We) understand that the application and attachments become part of the official public records of the City and are not returnable.

Signature of Current Owner:	Date: 8 4 1 7
PRINT NAME: MICHAEL TZEKUL	Date: 8 4 17
Signature of Consultant/Representative:	Date: 8417
PRINT NAME: UBSUPH B. Kaller	Date: 8417
Signature of Tenant:	Date:
PRINT NAME:	Date:
Current Owner Power of Attorney	
am the current owner of the described real property and that I am aware of the nature to my property, which is hereby made by me committee) relative to all matters concerning this application.	and effect the request for or I am hereby authorizing Board and/or
Sworn to and subscribed before me  this day of way to Signature of C	Current Owner
Notary Public  State of Florida  State of Florida  Notary Public  State of Florida	elExekiel
My Commission Expires:(Check One)Personally known to me; OR Produced Identification	ification

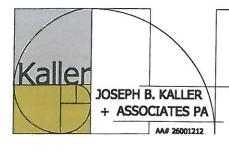

## architecture - interiors - planning

August 14, 2017

City of Hollywood 2600 Hollywood Boulevard Hollywood, Florida 33019

Reference:

1955 Tyler Street Mixed Use

Hollywood, Florida

Architect's Project #17093

TAC #17-DP-37

To Whom It May Concern:

The following are our responses to your Final Technical Advisory Comments for the above referenced Project.

### A. APPLICATION SUBMITTALS – Deandrea Moise

- 1. All items have been provided as listed in the O&E Report.
- 2. The last warranty Deed listed in the O&E Book 50052 Page 864 shows Ezekiel Development LLC. Sunbiz.org page enclosed shows Michael Ezekiel as manager of the development company.
- 3. Dates on title sheet have been corrected.
- 4. ALTA Survey:
  - a. A 24x36 copy of the survey has been included in the submittals.
  - b. Zoning information removed.
  - c. Lot size now defined as net lot.
  - d. Survey now based on O&E Report and it is noted in Note #2.
  - e. Survey now signed and sealed.
- 5. Site Plan:
  - a. Dimensions and other elements now do not overlap.
  - b. ND-3 now shown throughout the plan in the notes.
  - c. 19th Avenue now corrected to say 20th Avenue.
- 6. Noted.
- 7. Landscape plans now included in this submittal.
- 8. Plans fully dimensioned including parking area.
- 9. The President and Sergeant at Arms of the Civic Association met in our office to review the project as August is a recess month for the Civic Association. They are

in full support of the project and will write a letter saying such. The President and Sergeant at Arms are Ken Crawford and Christina Corbo respectively.

- 10. Noted.
- 11. Noted.

#### B. **ZONING - Deandrea Moise**

- 1. Wall mounted mail boxes will be provided in the entry lobby on the first floor.
- 2. Parking stalls are fully dimensioned on sheet SP-1.
- 3. The parking stalls are dimensioned showing 16' in length with a 2'-0" overhang to make it 18' in total length x 8'-6" in width.
- 4. Column to parking stall now 36" back from entry to stall.
- 5. The stall width has been increased to 9'-6" wide.
- 6. The alley is one way west bound. The garbage truck would enter the alley at 19<sup>th</sup> Avenue and travel west to the trash room at the corner of 20<sup>th</sup> and the alley. The garbage truck would pull out the containers in front of it and dispose of the garbage without blocking 20<sup>th</sup> Avenue.
- 7. Active liners illustrated and calculated on new sheet A-7.
- 8. The retail/restaurant/market type are 2591 sq. ft., less than the 10,000 sq. ft. required for a loading space. The office/institutional type uses one 10,030 sq. ft., less than the 20,000 sq. ft. required for a loading space.
- 9. Net lot area now matches the ALTA survey.
- 10. All encroachments are now dimensioned on the site and floor plans.
- 11. Noted. Data has been checked and corrected.
- 12. The garage is screened solid at eye level. Openings in screen in other places (high and low) are required for ventilation. See screen detail on sheet SP-3.
- 13. An electric charging station has been added to parking space #11.

## C. ARCHITECTURE & URBAN DESIGN - Deandrea Moise

- 1. Canopy has now been labeled concrete (15)
- 2. Decorative screen acts as a shading device for windows and will help with energy efficiency of AC units which is why it covers the glazing.
- 3. Materials have been provided in this submittal.

### -Terrence Cominsky

- 1. Mailboxes now shown in the main first floor lobby.
- 2. The canopy is concrete. This is now called out in the elevations.
- 3. Third floor shrubbery removed.
- 4. Noted.
- 5. Noted. This will be discussed with client at a later date.
- 6. The reception counter will have to be ADA. This will be noted and detailed in the construction documents.

#### D. LANDSCAPING - Dale Bryant

1. No comments.

#### E. SIGNAGE – Deandrea Moise

- 1. Letter heights now differentiated.
- 2. This separate sign permit is noted on the plans. Sheet SP-3.

#### F. <u>LIGHTING – Deandrea Moise</u>

1. Substantially Compliant.

#### G. GREEN BUILDING - Deandrea Moise

1. Substantially Compliant.

#### H. ENVIRONMENTAL SUSTAINABILITY - Lindsey Nieratka

1. Cool roof, highly reflective pavement, and the charging station have all been added to the site plan (SP-1) and the floor plan (A-1) sheets.

## I. <u>UTILITIES – James Rusnak/Wilford Zephyr</u>

1. Civil plans now submitted.

### J. BUILDING - Philip Sauer

1. Substantially Compliant

## K. ENGINEERING – Luis Lopez/Clarissa Ip

- 1. Street name revised.
- 2. Noted.
- 3. Columns are now 36" back from parking space entry.
- 4. Width of parking space adjacent to wall has been increased to 9.5 ft.
- 5. Minimum parking space length is 18' or 16' with 2' overhang as shown.
- 6. The parking detail on sheet SP-2 has been revised.
- 7. The text on sheet A-1 has been fixed.
- 8. Use for small retail space not yet known.
- 9. Pavement parking showing accessible route added.
- 10. Civil plans now included in submission.
- 11. Dropped curb indicated on plans.
- 12. Pavers are now only proposed within the boundaries of the site. Existing concrete sidewalk to remain until CRA proposed improvements finalized.

- 13. Existing light poles now on plans.
- 14. Existing on street parking plus the addition of one new space shown on site plan.
- 15. Mailbox bank shown in main entry lobby.
- 16. Noted.
- 17. Commercial space is 2591 sq. ft. Office space is 10,030 sq. ft. See new loading calculations.
- 18. Noted.
- 19. Noted.

#### L. FIRE - Janet Washburn

- 1. Fire flow testing has been scheduled and paid for. Calculations will be shown on civil drawings to meet 18.4.
- 2. Noted.
- 3. Fire department connection now shown on plans.
- 4. Note has been added to the civil plans.
- 5. Two way radio compliance noted on plans. Sheet SP-1.

#### M. <u>COMMUNITY DEVELOPMENT – Clay Milan</u>

- 1. Roof top canopy has now been described on elevation sheets.
- 2. The elevator does serve the third floor. It serves all floors.
- 3. Landscape plan and colored rendering now included in the submittal.

## N. ECONOMIC DEVELOPMENT - Brian Rademacher

- 1. Retail #1 use is yet to be determined.
- 2. Building will not be designed to support additional floors as it will not have the parking required to support the additional square footage.

## O. PARKS, RECREATION & CULTURAL ARTS - David Vasquez

1. No comments received.

# P. <u>POLICE DEPARTMENT – Christine Adamcik/Steven Bolger/Doreen Avitabile</u>

1. No Comments Received.

## Q. PUBLIC WORKS - Charles Lassiter/Karen Arndt

1. No comments received.

## R. DOWNTOWN AND BEACH CRA - Jorge Camejo/Susan Goldberg

1. Substantially compliant.

## S. PARKING - Harold King

1. Substantially Compliant.

## T. ADDITIONAL COMMENTS - Deandrea Moise

1. Noted.

If you should have any questions concerning these comments, please feel free to contact our office.

Sincerely, Joseph B. Kaller & Associates, P.A.

Michele Sherlock Senior Associate




#### PROJECT INFO:

3 STORY MIXED USE COMMERCIAL BUILDING

#### LEGAL DESCRIPTION

LOTS 1, 2 AND 3, ALL IN BLOCK 23, LESS THE NORTH 43 FEET OF LOTS 1. 2 AND 3, BLOCK 23 OF HOLLYWOOD, ACCORDING TO THE PLAT THEREOF. RECORDED IN PLAT BOOK 1, PAGE 21, OF THE PUBLIC RECORDS OF BROWARD COUNTY, FLORIDA. TOGETHER WITH THE NORTH 43 FEET OF LOTS 1, 2 AND 3, BLOCK 23 OF HOLLYWOOD, ACCORDING TO THE PLAT THEREOF, RECORDED IN PLAT BOOK 1. PAGE 21, OF THE PUBLIC RECORDS OF BROWARD COUNTY, FLORIDA; ALSO KNOW AS ALL OF LOTS 1, 2 AND 3, BLOCK 23 OF HOLLYWOOD, ACCORDING TO THE PLAT THEREOF, RECORDED IN PLAT BOOK 1, PAGE 21, OF THE PUBLIC RECORDS OF BROWARD COUNTY, FLORIDA.

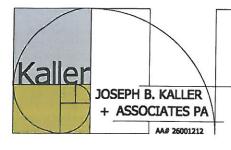

## architecture - interiors - planning

## GENERAL CRITERIA STATEMENT TYLER STREET MIXED USE 1955 TYLER STREET 17-DP-37 August 21, 2017

1. Architectural and Design Components. Architecture refers to the Architectural elements of exterior building surfaces. Architectural Details should be commensurate with the building mass. The use of traditional materials for new Architectural Details is recommended. Design of the Building(s) shall consider aesthetics and functionality, including the relationship of the pedestrian with the built environment.

Tyler Street Mixed Use is located at 1955 Tyler Street in the Downtown District of the City of Hollywood. It is sited on the northeast corner of Tyler Street and N. 20<sup>th</sup> Avenue.

The proposed Mixed Use Building is 3 stories in height with the Retail/Restaurant portion on the first floor and the Office portion on the two floors above. The Retail/Restaurant areas are accessed directly from the public right of way along Tyler Street and N. 20<sup>th</sup> Avenue, while the Offices are accessed through the Main Lobby on the first floor.

The first floor Retail/Restaurant bays have large storefronts that would attract both pedestrian and vehicular traffic to stop in. The Office floors are little more discreet with laser cut circular copper screening that acts as both a privacy barrier and a shading device. Occupants on the second floor are able to see out on to the street while outside cannot easily see inside. The third floor is set back allowing for outdoor areas where meetings, lunch, or other activities can take advantage of nice Florida days.

The style of architecture is Modern. These are clean lines, glass railings, large windows, concrete canopies, and laser cut metal panels that wrap the second floor. There is a play on volumes, with them placed at different elevations in order to evoke movement and interest. As the sun travels, so will interesting shadows dance across the façade.

The paint and awning colors are bold but also inviting. It beckons passersby's to come in and see what's happening here.

2. Compatibility. The relationship between existing Architectural styles and proposed construction, including how each building along the street relates to the whole and the pattern created with adjacent structures and the surrounding neighborhood. Buildings should contain architectural details that are characteristic of the surrounding neighborhood.

The surrounding structures range in size and scale from small to large. The architectural styles are from Mediterranean Revival to Modern. The common thread that binds all these sizes and styles are the presence of prominent storefronts that are on the first floor lining the street.

The storefront is the main characteristic of a downtown district. It tells the public that this is an area open and ready to invite people in. Awnings, canopies, and eyebrows shade these storefronts as well as the sidewalk all along the street.

3. Scale/Massing. Buildings shall be proportionate in scale, with a height which is consistent with the surrounding structures. Building mass shall reflect a simple composition of basic architectural details in relation to its length, width, height, lot coverage and setting of the structure in context with adjacent buildings. Architectural details included, but are not limited to, banding, molding and fenestration.

The scale of the proposed Mixed Use Building is low, and although wider than the building directly adjacent to it, it is broken up, pushed back and pulled forward, to give the appearance of being a series of smaller buildings together. The scale is extremely pedestrian friendly as there is a connection to the street at every level.

4. Landscaping. Landscaped area should contain a variety of native and other compatible plant types and forms, and be carefully integrated with existing buildings and paved areas. Existing mature trees and other significant plants on the site should be preserved.


In an urban setting, landscaping and the built environment are two separate parts of the choreography of a dance or composition of a song. The placement of trees is almost always in a rhythmical pattern, accentuating the entries to the buildings, shading outdoor seating on the sidewalks and framing specific architectural elements of a building. In the dance, planters along the base of buildings and flora entwined in trellises and overhangs softened the hard edges of walls, parapets, and balconies. These two elements are always in close proximity, relying on each other to create special and memorable spaces.

The Tyler Street Mixed Use project uses all of the elements described above to enhance the quality of the project.



main building color benjamin moore 0C-130 cloud white


accent color benjamin moore 1490 country life

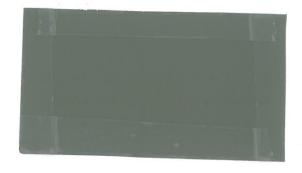

canvas awning sunbrella ginko



lazer cut screen powder coated copper

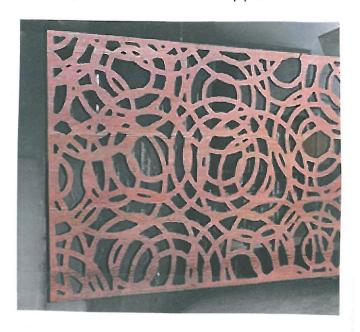





railing

white storefront framing






"bronze" horizontal metal tube screening



sconce

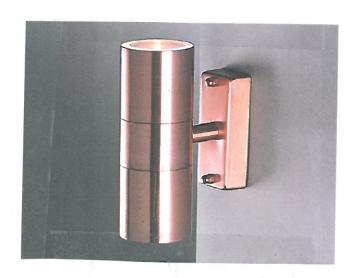

sconce





2001 TYLER ST. (WEST OF SITE)



950 POLK ST. (NORTH OF SITE)



(SOUTH OF SITE)



20TH & TYLER ST LOOKING SOUTH WEST



20TH & TYLER LOOKING BOOTH EAST



(EAST OF SITE)

1939 TYLER ST.



(EAST OF SITE)

# TYLER STREET MIXED USE

1955 TYLER STREET AND 209 N. 20TH AVE.

HOLLYWOOD

**FLORIDA** 



P.A.C.O. - JULY 10, 2017 PRELIMINARY T.A.C. MEETING - JULY 31, 2017 FINAL T.A.C. MEETING - SEPTEMBER 5, 2017 🛕

# PROJECT DATA

CODES:

FLORIDA BUILDING CODE, 5TH EDITION 2014 5TH EDITION FLORIDA FIRE PREVENTION CODE, 2016 BROWARD FIRE AMENDMENTS FLORIDA ADMINISTRATIVE CODE 69A-40

JURISDICTION: CITY OF HOLLYWOOD

BROWARD COUNTY STATE OF FLORIDA

## PROJECT TEAM

EZEKIEL DEVELOPMENT LLC

LANDSCAPE ARCHITECT

CONTACT: WAYNE TONNING

199 JEFFREY STREET

PHONE: (561) 414-8269

FAX: (561) 892-5977 EMAIL: tonningria@aol.com

BOCA RATON, FL 33487

TONNING AND ASSOCIATES INC.

CONTACT: MICHAEL EZEKIEL

ADDRESS: 1235 SEAGULL TERRACE

(954) 364-7437

EMAIL: mezekielabfiproductsinc.com

HOLLYWOOD, FL 33019

<u>ARCHITECT</u>

JOSEPH B. KALLER AND ASSOCIATES, P.A. CONTACT: MR. JOSEPH B. KALLER ADDRESS: 2417 HOLLYWOOD BLVD. HOLLYWOOD, FL 33020

(954) 920-5746 (954) 926-2841 joseph@kallerarchitects.com

<u>SURVEYOR</u>

COUSING SURVEYORS AND ASSOCIATES, INC. CONTACT: RICHARD COUSINS ADDRESS: 3921 SW 47TH AVENUE, SUITE 1011 **DAYIE, FL 33314** 

(954) 680-9885 RECsurveyr@aol.com

<u>CIVIL ENGINEER</u>

CHARLES O. BUCKALEW CONTACT: CHARLES O. BUCKALEW 801 SOUTH OCEAN DR. SUITE 201 HOLLYWOOD, FL 33019 PHONE: (954) 927-0561 CELL: (954) 558-1189

T-I COVER SHEET

C-3 CONSTRUCTION DETAILS

LP-2 LANDSCAPE PLAN - THIRD FLOOR (1)

A-5 BUILDING ELEVATIONS

A-6 BUILDING ELEVATIONS A-7 ACTIVE LINER DIAGRAMS

# DRAWING INDEX

SP-1 SITE PLAN AND SITE DATA

SP-2 SITE DETAILS SP-3 SIGN DETAILS AND CONTEXTUAL STREET ELEVATIONS

C-I PAYING & DRAINAGE AND WATER & SEWER PLANS

C-2 CONSTRUCTION DETAILS


EC-1 EROSION CONTROL PLAN

LP-I LANDSCAPE PLAN - FIRST FLOOR

A-I FIRST FLOOR PLAN

A-2 SECOND FLOOR PLAN A-3 THIRD FLOOR PLAN

A-4 ROOF PLAN

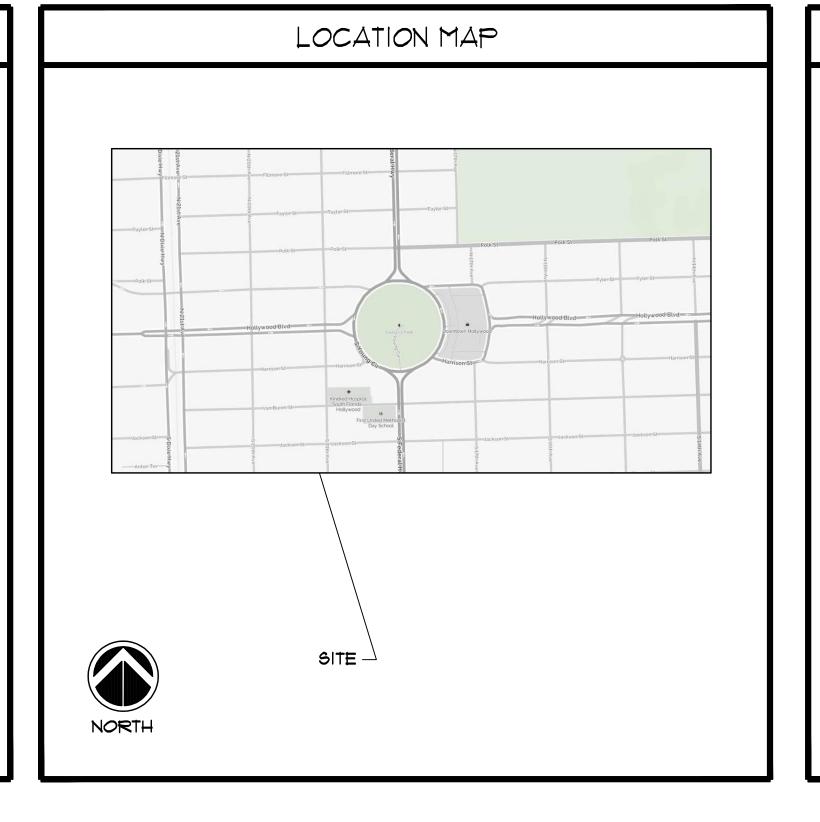

# AERIAL




SITE ---


JOSEPH B. KALLER FLORIDA R.A. # 0009239

No. DATE DESCRIPTION 8-10-17 PRELIM TAC

CHECKED BY: JBK

# ALTA/NSPS LAND TITLE SURVEY

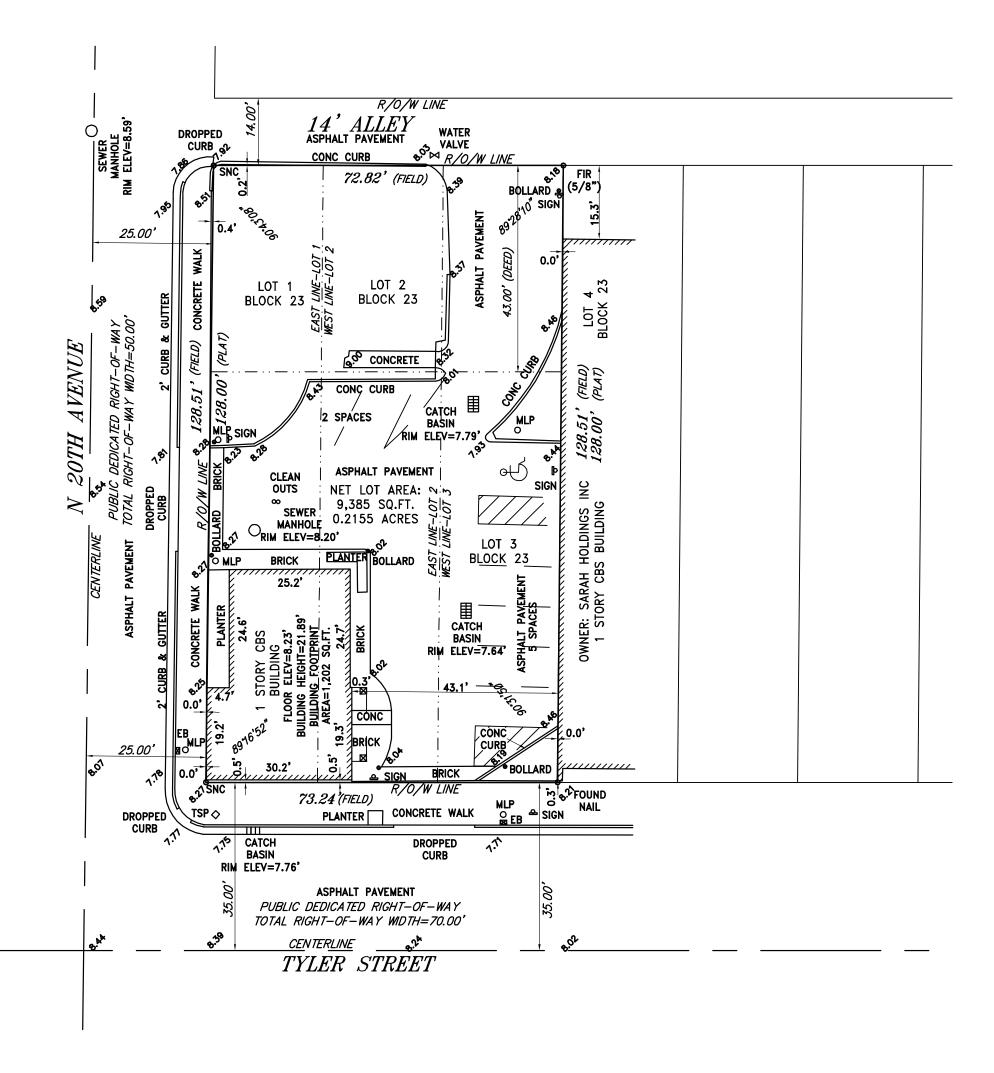


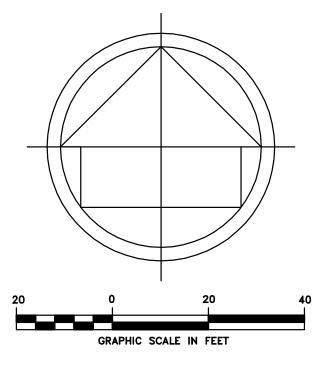

## LEGEND:

CHECKED BY CONCRETE DRAWN BY FIELD BOOK AND PAGE SET 5/8" IRON ROD & CAP #6448 SET NAIL AND CAP #6448 FOUND IRON ROD FOUND IRON PIPE FOUND NAIL AND CAP FOUND NAIL & DISC PLAT BOOK BROWARD COUNTY RECORDS CONCRETE BLOCK STRUCTURE CHAIN LINK/ WOOD FENCE OVERHEAD UTILITY LINE METAL LIGHT POLE WATER METER METAL LIGHT POLE ELECTRIC BOX TRAFFIC SIGNAL POLE TRAFFIC SIGNAL BOX WOOD POWER POLE FOUND DRILL HOLE AIR CONDITIONER FOUND DRILL HOLE RIGHT OF WAY TOP OF PIPE DEED BOOK L.W.D.D. LAKE WORTH DRAINAGE DISTRICT PERMANENT REFERENCE MONUMENT AMERICAN LAND TITLE ASSOCIATION NATIONAL SOCIATY OF PROFESSIONAL SURVEYORS

OFFICIAL RECORDS BOOK

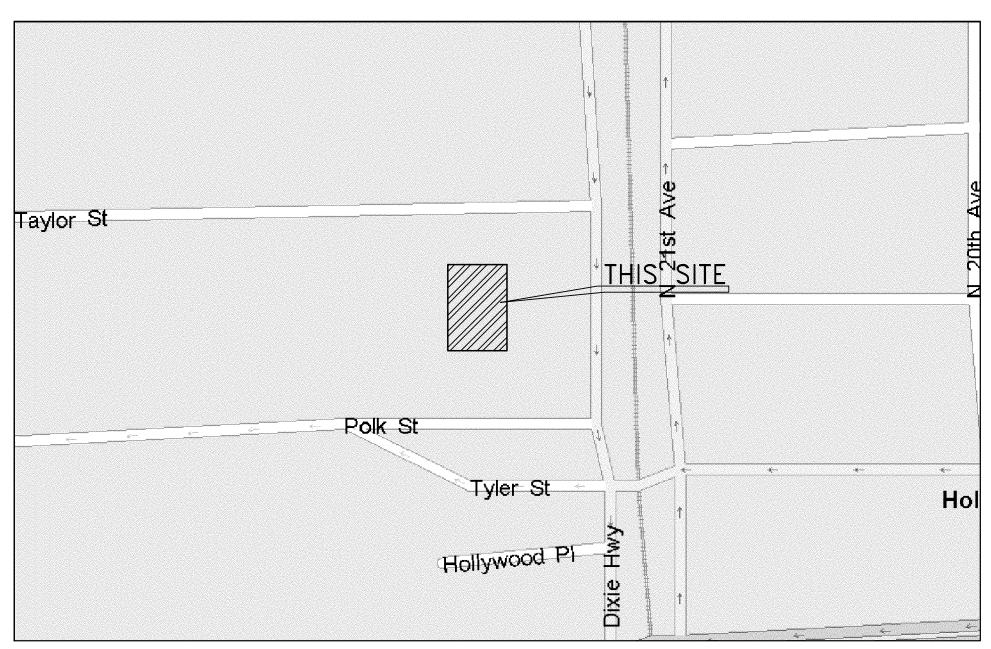

LOCATION MAP (NTS)



FLOOD ZONE INFOR	MATION
COMMUNITY NUMBER	125113
PANEL NUMBER	0569 H
ZONE	0.2PCT
BASE FLOOD ELEVATION	I N/A
EFFECTIVE DATE	08/18/14

## NOTES:

- 1. NOT VALID WITHOUT THE SIGNATURE AND THE ORIGINAL RAISED SEAL OF A FLORIDA LICENSED SURVEYOR AND MAPPER.
- 2. THE CERTIFICATION SHOWN HEREON TO THE EXTENT RELATING TO THE EXISTENCE OF EASEMENTS AND/OR RIGHTS-OF-WAY OF RECORD IS BASED UPON TITLE SEARCH REPORT ISSUED BY FIRST AMERICAN TITLE INSURANCE COMPANY. EFFECTIVE DATE: FROM SEPTEMBER 14, 1921 (PLAT RECORDING) THROUGH JULY 11, 2017 FATIC FILE #: 1062-3807982, CUSTOMER FILE #: EZEKIEL DEVELOPMENT LLC
- 3. THIS SURVEY WAS DONE SOLELY FOR BOUNDARY PURPOSES AND DOES NOT DEPICT THE JURISDICTION OF ANY MUNICIPAL, STATE, FEDERAL OR OTHER ENTITIES.
- 4. THE LAND DESCRIPTION SHOWN HEREON WAS PROVIDED BY THE CLIENT.

PHONE (954) 689-7766 FAX (954) 689-7799

- 5. UNDERGROUND IMPROVEMENTS NOT SHOWN.
- 6. ELEVATIONS SHOWN HEREON ARE BASED ON THE NORTH AMERICAN VERTICAL DATUM OF 1988 (NAVD88).
- 7. BENCHMARK REFERENCE: CITY OF HOLLYWOOD BENCHMARK AT JEFFERSON STREET & 16TH AVENUE, ELEVATION=4.19' (NAVD88)

## **EXCEPTIONS:**

ALL MATTERS PER PLAT BOOK 1, PAGE 21, B.C.R.

## LAND DESCRIPTION:

ALL OF LOTS 1, 2 AND 3, ALL IN BLOCK 23, LESS THE NORTH 43 FEET OF LOTS 1, 2 AND 3, BLOCK 23 OF "HOLLYWOOD", ACCORDING TO THE PLAT THEREOF, RECORDED IN PLAT BOOK 1, PAGE 21 OF THE PUBLIC RECORDS OF BROWARD COUNTY, FLORIDA;

TOGETHER WITH THE NORTH 43 FEET OF LOTS 1, 2 AND 3, BLOCK 23 OF "HOLLYWOOD", ACCORDING TO THE PLAT THEREOF, RECORDED IN PLAT BOOK 1, PAGE 21 OF THE PUBLIC RECORDS OF BROWARD COUNTY, FLORIDA;

ALSO KNOWN AS ALL OF LOTS 1, 2, AND 3, BLOCK 23 OF "HOLLYWOOD", ACCORDING TO THE PLAT THEREOF, RECORDED IN PLAT BOOK 1, PAGE 21 OF THE PUBLIC RECORDS OF BROWARD COUNTY, FLORIDA CERTIFIED TO:

EZEKIEL DEVELOPMENT, LLC, A FLORIDA LIMITED LIABILITY COMPANY FIRST AMERICAN TITLE INSURANCE COMPANY

## SURVEYOR'S CERTIFICATION

THIS IS TO CERTIFY THAT THIS MAP OR PLAT AND THE SURVEY ON WHICH IT IS BASED WERE MADE IN ACCORDANCE WITH THE "2016 MINIMUM STANDARD DETAIL REQUIREMENTS FOR ALTA/NSPS LAND TITLE SURVEYS," JOINTLY ESTABLISHED AND ADOPTED BY ALTA AND NSPS, AND INCLUDES ITEMS 1, 2, 3, 4, 6(A), 6(B) (NONE SUPPLIED), 7(A), 7(B), 7(C), 8, 9, 11, 13, 14, 16, 17, 18, 19 (NONE DISCLOSED) AND 20 OF TABLE A THEREOF. PURSUANT TO THE ACCURACY STANDARDS AS ADOPTED BY ALTA AND NSPS AND IN EFFECT ON THE DATE OF THIS CERTIFICATION, UNDERSIGNED FURTHER CERTIFIES THAT IN MY PROFESSIONAL OPINION, AS A LAND SURVEYOR REGISTERED IN THE STATE OF FLORIDA, THE RELATIVE POSITIONAL ACCURACY OF THIS SURVEY DOES NOT EXCEED THAT WHICH IS SPECIFIED THEREIN. THE FIELD WORK WAS COMPLETED ON JULY 13, 2017.

RICHARD E. COUSINS PROFESSIONAL SURVEYOR AND MAPPER FLORIDA REGISTRATION No. 4188.

COUSINS SURVEYORS & ASSOCIATES, INC. 3921 SW 47TH AVENUE, SUITE 1011 DAVIE, FLORIDA 33314 CERTIFICATE OF AUTHORIZATION: LB # 6448

EZEKIEL DEVELOPMENT LLC

CLIENT:

209 N 20TH AVENUE, 1955 TYLER STREET

REVISIONS DATE FB/PG DWN CKD 07/13/17 SKETCH AM REC ALTA/NSPS LAND TITLE SURVEY 07/17/17 ---- JD REC REVISED TO REFLECT TITLE SEARCH REPORT


REVISIONS DATE FB/PG DWN CKD

PROJECT NUMBER: 8420-17

SCALE : 1" = 20'

SHEET

HOLLYWOOD, FLORIDA

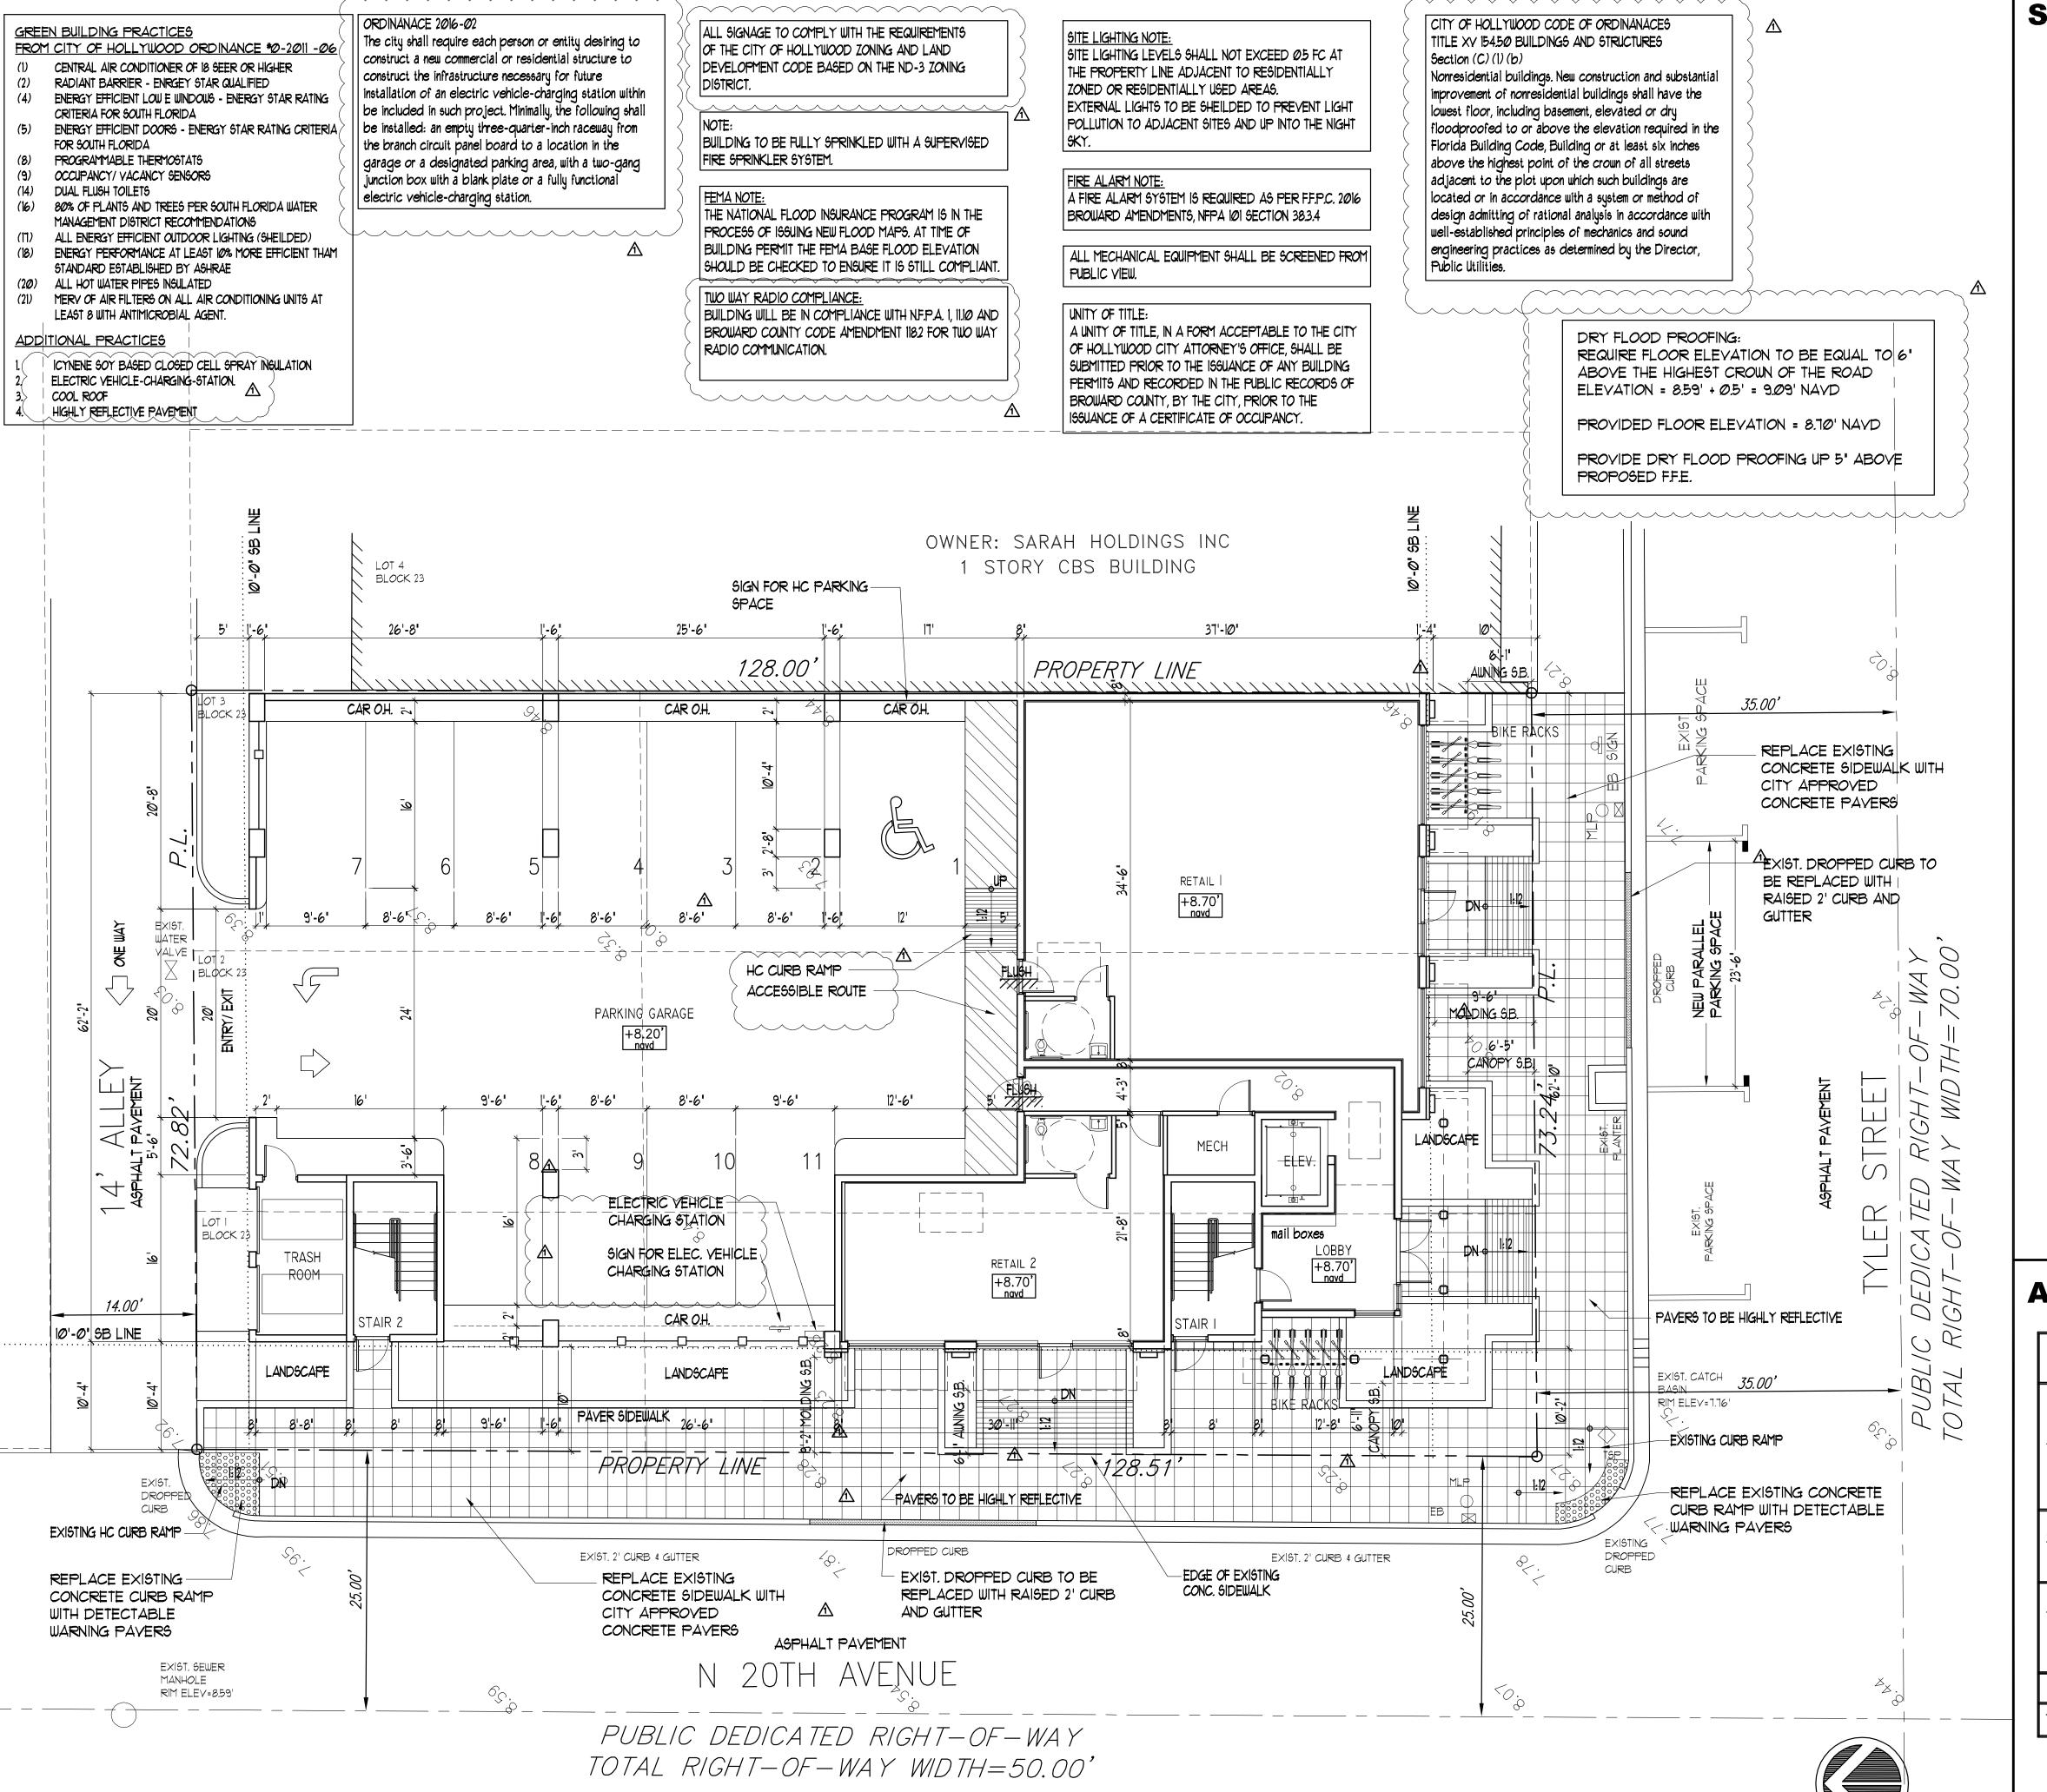

SITE DATA

LEGAL DESCRIPTION

LOTS 1, 2 AND 3, ALL IN BLOCK 23, LESS THE NORTH 43 FEET OF LOTS 1, 2 AND 3, BLOCK 23 OF HOLLYWOOD,
ACCORDING TO THE PLAT THEREOF, RECORDED IN PLAT BOOK
1, PAGE 21, OF THE PUBLIC RECORDS OF BROWARD COUNTY, TOGETHER WITH THE NORTH 43 FEET OF LOTS 1, 2 AND 3, BLOCK 23 OF HOLLYWOOD, ACCORDING TO THE PLAT THEREOF, RECORDED IN PLAT BOOK 1, PAGE 21, OF THE PUBLIC RECORDS OF BROWARD COUNTY, FLORIDA; ALSO KNOW AS ALL OF LOTS 1, 2 AND 3, BLOCK 23 OF HOLLYWOOD, ACCORDING TO THE PLAT THEREOF, RECORDED IN PLAT BOOK 1, PAGE 21, OF THE PUBLIC RECORDS OF BROWARD COUNTY, FLORIDA

PROPERTY ADDRESSES

1955 TYLER STREET AND 209 N 20TH AVE HOLLYWOOD, FL 33020

SITE INFORMATION

**EXISTING ZONING:** NORTH DOWNTOWN HIGH INTENSITY MIXED USE DISTRICT (ND-3) LAND USE DESIGNATION: REGIONAL ACTIVITY CENTER

NET LOT AREA:

9,385.0 SQUARE FEET

3.00 <u>ALLOWED</u> **PROVIDED** 14,378.0 SF **BUILDABLE AREA:** 28,155.0 SF COMMERCIAL USE: RETAIL 2591 SF OFFICES 10,030 SF

**REQUIRED** <u>PROVIDED</u> PARKING: 1ST AND 2ND FLOORS O SPACES 0 SPACES ND-3 DISTRICT 11 SPACES 11 SPACES 3RD FLOOR TOTAL = 11 SPACES 11 SPACES

<u>REQUIRED</u> <u>PROVIDED</u> RETAIL/ MARKET (2591 SF) NOT REQ. LESS THAN 10,000 SF 0 SPACE OFFICES (10,030 SF) NOT REQ. LESS THAN 20,000 SF

SETBACKS:

02757101101	<u>REQUIRED</u>	PROVIDED
	BASE (<55')	BASE (<55')
(a) FRONTAGE (TYLER ST)	10'-0" C	10'-0" C
(b) FRONTAGE (20TH AVE)	10'-0" C	10'-0" C
(c) SIDE INTERIOR (EAST)	0'-0"	0'-0"
(d) ALLEY	5'-0"	5'-0"

**BUILDING SUMMARY** 

**BUILDING HEIGHT:** 

<u>PROVIDED</u> <u>ALLOWED</u> 3 STORIES / 39'-0"

GROSS BUILDING AREA:

TERRACES TOTAL FIRST FLOOR SECOND FLOOR 6726 THIRD FLOOR 4207

# **AREAS**

	SPACE	AR	EA	GROS	S AREA	AREA	
		AC	NON AC	AC	NON AC	NOT INCL.	
	COMMERCIAL -RETAIL	2049					
	RESIDENTIAL LOBBY	288			1		
	TRASH ROOM	149		2521	382	3576	
1ST FL	MECH ROOM	35					
	STAIRWELLS		308				
	ELEVATOR		74				
	GARAGE		3576				
2ND FL	COMMERCIAL -OFFICE	6344					
	STAIRWELLS		308				
	ELEVATOR		74	6344	6344 525		
	TERRACE		143	1			
	OFFICE SUITES	3686					
3RD FL	STAIRWELLS		308	3825	2341		
	ELEVATOR		74				
	RESTROOMS	139					
	TERRACES		1959				
				12690	3248		
TOTAL GRO	150						

JOSEPH B. KALLER

ASSOCIATES PA AA# 26001212

2417 Hollywood Blvd. Hollywood, Florida 33020 (954) 920 5746 phone - (954) 926 2841 fax kaller@bellsouth.net

SEAL

JOSEPH B. KALLER

FLORIDA R.A. # 0009239

REET MIXED USE

**REVISIONS** No. DATE DESCRIPTION


This drawing, as an instrument of service, is and shall remain the


used in any way without the permission of the Architect.

PROJECT No.: DATE: DRAWN BY: CHECKED BY:


SHEET

SITE PLAN SCALE: 1/8"= 1'-0"

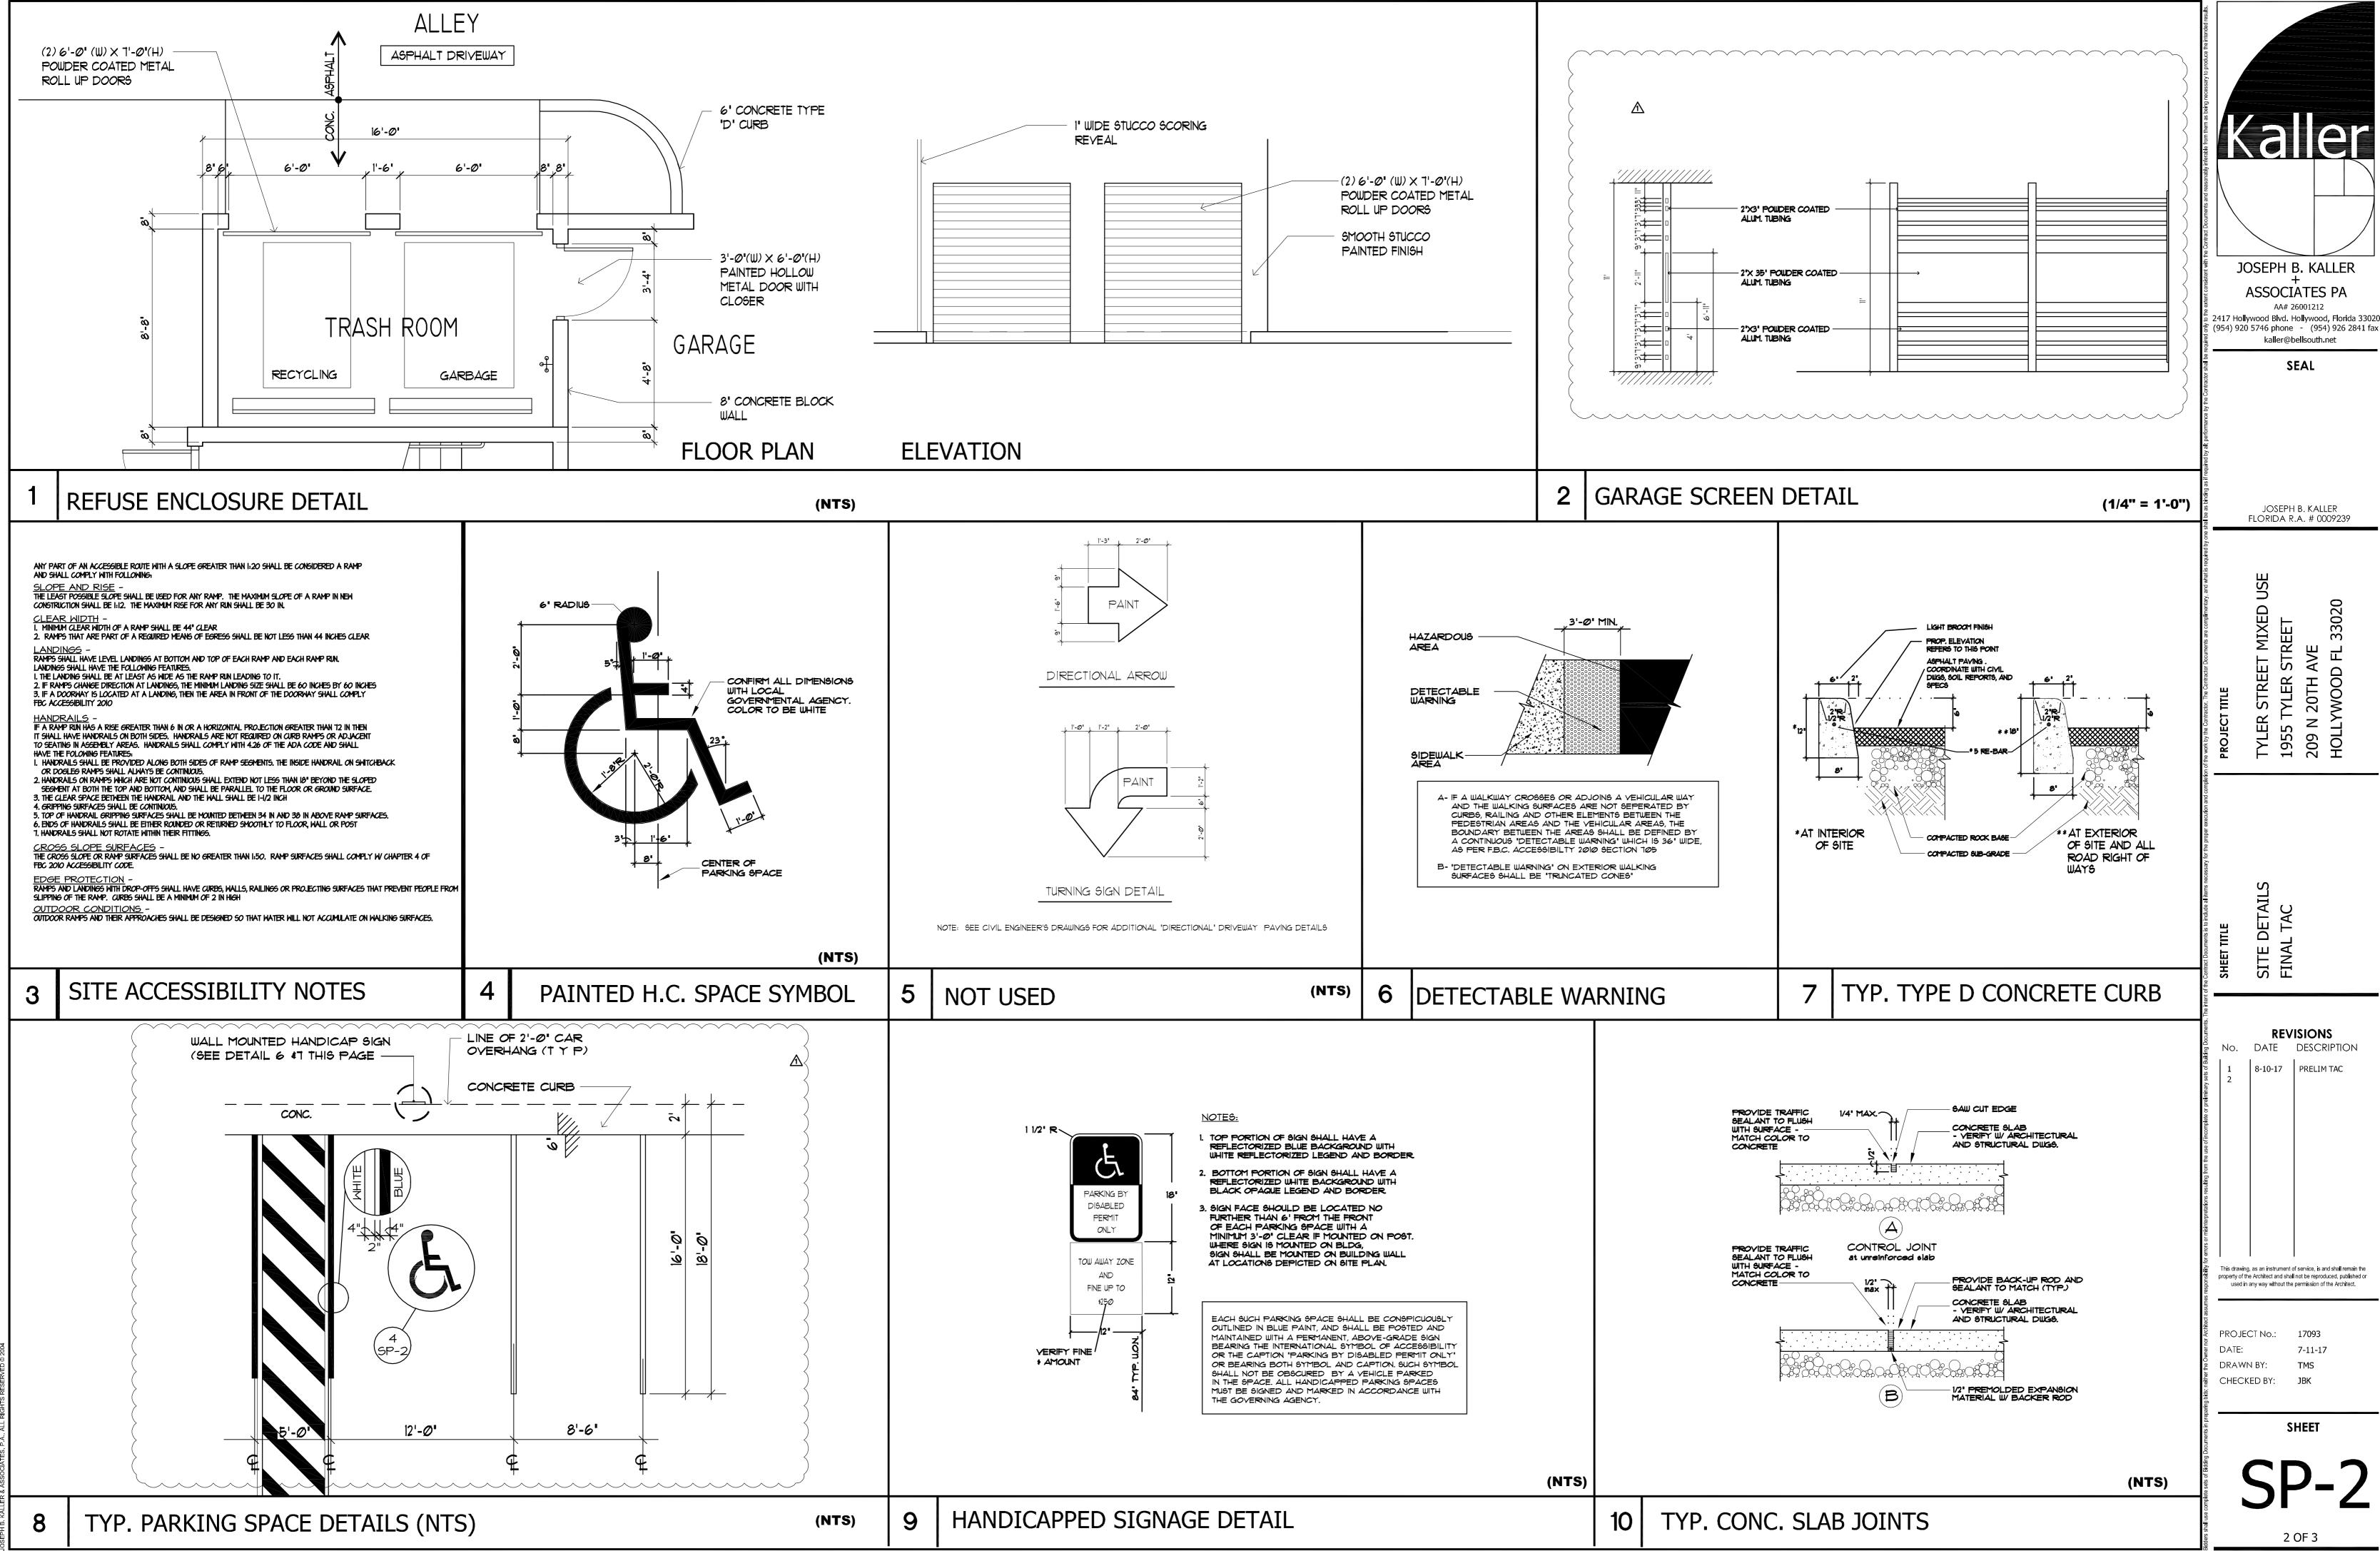


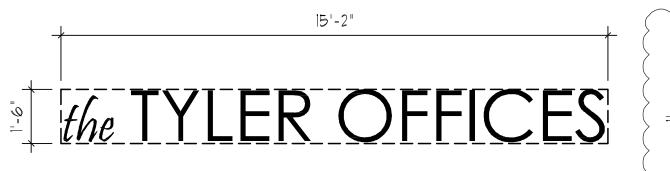

NAME SIZE = 55 S.F. FONT STYLE - PRISTINA FONT STYLE - CENTURY GOTHIC

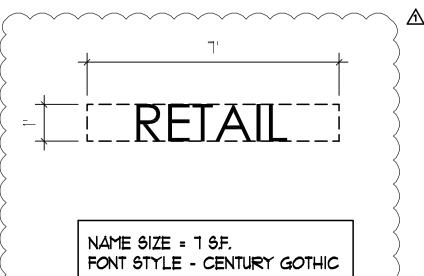


ALLEY

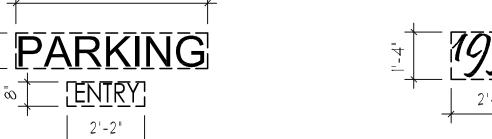


NAME SIZE = 5.5 S.F. FONT STYLE - CENTURY GOTHIC

NAME SIZE = 1.5 S.F. FONT STYLE - CENTURY GOTHIC

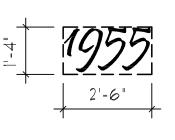

NUMBER SIZE =3.2 S.F. FONT STYLE - PRISTINA



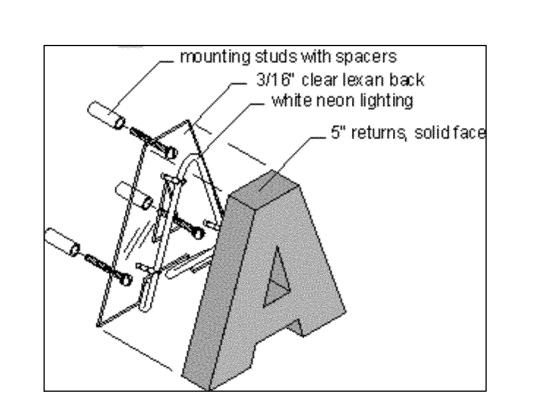

2 SIGN DETAILS
SCALE: 3/8"= 1'-0"

ALL SIGNAGE TO COMPLY WITH THE REQUIREMENTS OF THE CITY OF HOLLYWOOD ZONING AND LAND DEVELOPMENT CODE BASED ON THE ND-2 ZONING DISTRICT.

ALL SIGNAGE TO BE NEON BACK LIT PIN MOUNTED

CHANNEL LETTERS

1950

NOTE:

A SEPARATE SIGN PERMIT IS REQUIRED FOR EACH


A SEPARATE ELECTRICAL PERMIT IS REQUIRED FOR SIGNS REQUIRING ILLUMINATION.

VIEW EAST FROM NORTH 20TH AVE.

1955

N. 20TH AVE.

POLK STREET

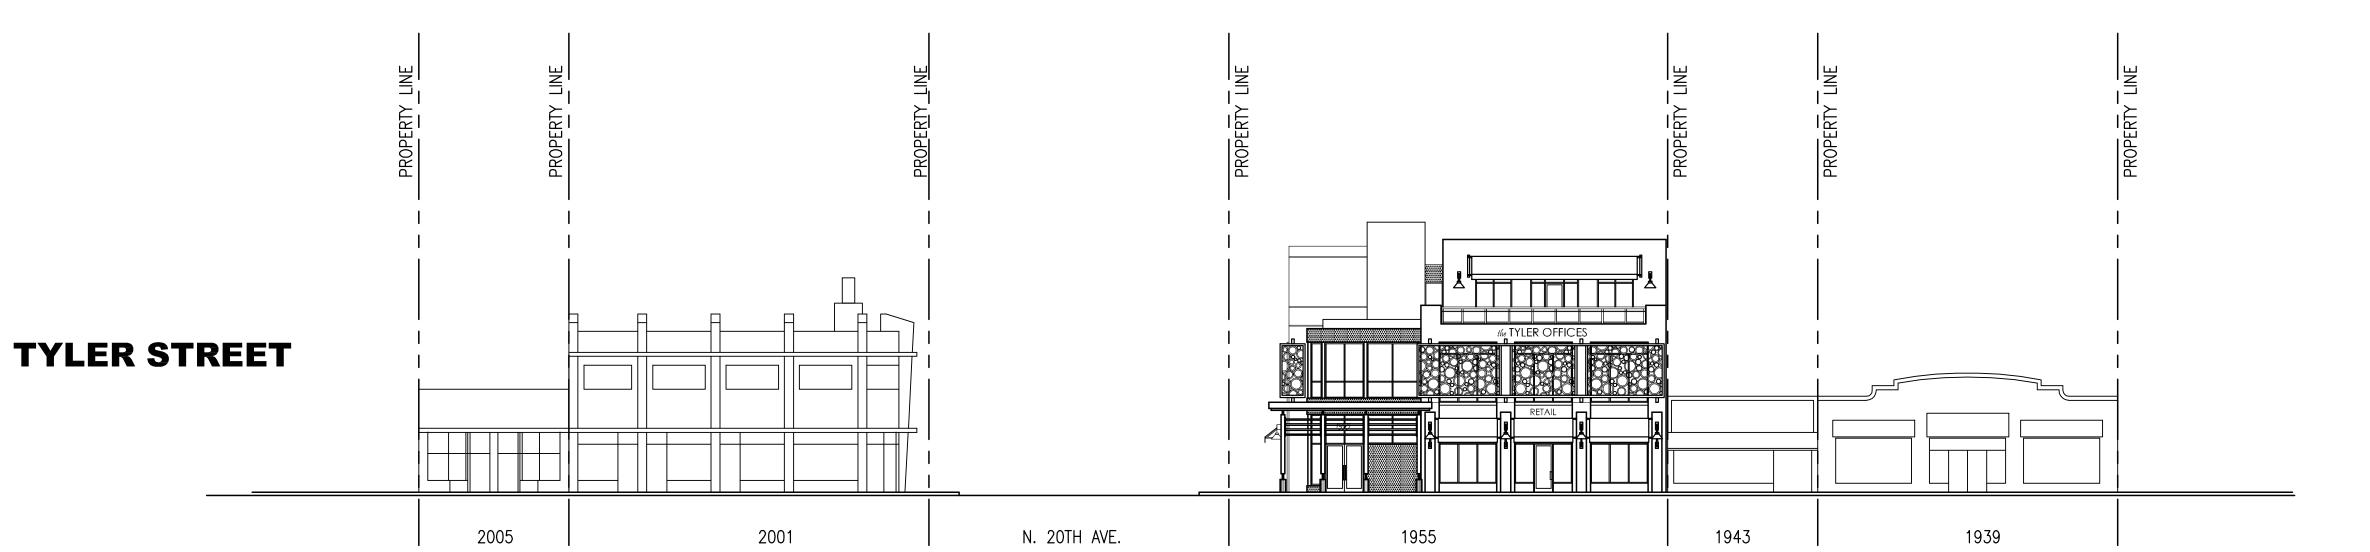

TYLER STREET

VIEW NORTH FROM TYLER STREET

123

SHEET

**REVISIONS** No. DATE DESCRIPTION

This drawing, as an instrument of service, is and shall remain the property of the Architect and shall not be reproduced, published or used in any way without the permission of the Architect.

DRAWN BY: CHECKED BY:

Kaller

JOSEPH B. KALLER

ASSOCIATES PA

2417 Hollywood Blvd. Hollywood, Florida 33020 (954) 920 5746 phone - (954) 926 2841 fax kaller@bellsouth.net

SEAL

JOSEPH B. KALLER FLORIDA R.A. # 0009239

ALLEY

2 CONTEXTUAL STREET ELEVATIONS
SCALE: 1/16"= 1'-0"

CONFLICTS
Wherever it is not possible to maintain the minimum standards in 1) and 2), then

all piping material shall be ductile iron pipe (DIP). All DIP shall be class 50 or higher. Adequate protective measures against corrosion shall be used as

determined by the design and site conditions. Additionally, the potable water

main shall a full joint centered on the conflict and mechanically restrained. An absolute minimum vertical separation distance of 6 inches shall be provided

between the invert of the upper pipe and the crown of the lower pipe.

improvement of nonresidential buildings shall have the

Florida Building Code, Building or at least six inches

above the highest point of the crown of all streets

adjacent to the plot upon which such buildings are

well-established principles of mechanics and sound

Public Utilities.

engineering practices as determined by the Director,

located or in accordance with a system or method of design admitting of rational analysis in accordance with

floodproofed to or above the elevation required in the

lowest floor, including basement, elevated or dry

# SITE DATA

LEGEND ٠. ٠. ٠.

LIMITS OF CONC. SIDEWALKS, PORCHES & PADS

LIMITS OF ASPH. PAVEMENT, LIMEROCK BASE & SUBGRADE EXIST. PROPERTY LINE, SITE BOUNDARY

EXIST. EDGE OF PAVEMENT EXIST. GRADE ELEVATION 8.50

PROPOSED ELEVATIONS

SURFACE DRAINAGE FLOW ARROW TYPE "D" CONC. CURB (AS APPLICABLE)

CATCH BASIN W/ EXFILTRATION TRENCH **—** 

## GENERAL NOTES

- 1. ELEVATIONS SHOWN HEREON REFER TO NORTH AMERICAN VERTICAL DATUM (1988) AND ARE INDICATED AS SHOWN
- 2. CONTRACTOR TO VERIFY LOCATION & ELEVATIONS OF EXIST. UTILITIES PRIOR TO CONNECTIONS BEING MADE .
- 3. IN AREAS WHERE ASPHALT PAVEMENT ABUTS EXIST. ASPHALT, CONTRACTOR TO SAWCUT EXIST. PAVEMENT & SLOPE PAVEMENT TO MATCH EXIST. ELEVATIONS
- 4. CONTRACTOR TO ADJUST ALL EXIST. MANHOLE FRAME & COVERS, CATCH BASIN FRAME & GRATES, CLEANOUTS, ETC.., TO FINISHED GRADE W/IN ASPHALT LIMITS.

## GENERAL CONDITION NOTES -

- 1. THE LOCATION OF EXISTING UTILITIES AND TOPOGRAPHY HAS BEEN PREPARED FROM THE MOST RELIABLE INFORMATION AVAILABLE TO THE ENGINEER. THIS INFORMATION IS NOT GUARANTEED AND IT IS THE RESPONSIBILITY OF THE CONTRACTOR TO DETER-MINE THE EXACT LOCATION OF ALL EXISTING UTILITIES AND TOPOGRAPHY PRIOR TO
- 2. PRIOR TO CONSTRUCTION THE CONTRACTOR IS TO NOTIFY THE FOLLOWING COMPANIES & AGENCIES AND ANY OTHERS SERVING THE AREA:

FLORIDA POWER & LIGHT CO., CONSTRUCTION SOUTHERN BELL TELEPHONE & TEL. CO. CABLE CONSTRUCTION BUREAU LOCAL CITY / COUNTY ENGINEERING & UTILITY DEPARTMENTS FLORIDA DEPARTMENT OF TRANSPORTATION (FDOT), AS APPLICABLE UNDERGROUND UTILITIES NOIFICATION CENTER OF FLORIDA (S.U.N.S.H.I.N.E.)

## PAVING. GRADING & DRAINAGE NOTES -

- ALL UNSUITABLE MATERIALS, SUCH AS MUCK, HARDPAN, ORGANIC MATERIAL & OTHER DELETERIOUS MATERIAL AS CLASSIFIED BY AASHTO M-145, FOUND WITHIN THE ROAD & PARKING LOT AREAS SHALL BE REMOVED DOWN TO ROCK OR SUITABLE MATERIAL, & REPLACED W/ THE SPECIFIED FILL MATERIAL IN MAXIMUM 12" LIFTS COMPACTED TO NOT LESS THAN 100% MAXIMUM DRY DENSITY AT OPTIMUM MOISTURE IN ACCORDANCE W/ AASHTO T-99. THICKNESS OF LAYERS MAY BE INCREASED PROVIDED THE EQUIPMENT & METHODS USED ARE PROVEN BY FIELD DENSITY TESTING TO BE CAPABLE OF COMPACTING
- 2. ALL AREAS SHALL BE CLEARED & GRUBBED PRIOR TO CONSTRUCTION. THIS SHALL CONSIST OF THE COMPLETE REMOVAL & DISPOSAL OF ALL TREES, BRUSH, STUMPS, ROOTS, GRASS, WEEDS, RUBBISH & ALL OTHER OBSTRUCTION RESTING ON OR PROTRUDING THROUGH THE SURFACE OF THE EXIST. GROUND TO A DEPTH OF 12". ITEMS DESIGNATED TO REMAIN OR TO BE RELOCATED OR ADJUSTED SHALL BE SO DESIGNATED ON THE DWGS
- 3. FILL MATERIAL SHALL BE CLASSIFIED AS A-1, A-3 OR A-2.4 IN ACCORDANCE W/ AASHTO M-145 & SHALL BE FREE FROM VEGETATION & ORGANIC MATERIAL. NOT MORE THAN 12% BY WEIGHT OF FILL MATERIAL SHALL PASS THE NO. 200 SIEVE.
- THE CONTRACTOR SHALL BE RESPONSIBLE FOR PROVIDING CERTIFIED MATERIAL TEST RESULTS TO THE ENGINEER OF RECORD PRIOR TO THE RELEASE OF FINAL CERTIFICATION BY THE ENG. TEST RESULTS MUST INCLUDE BUT MAY NOT BE LIMITED TO, DENSITIES FOR SUBGRADE & LIME ROCK, UTILITIES, EXCAVATION, ASPHALT GRADIATION REPORTS, CONC. CYLINDERS, ETC..
- ALL INLETS & PIPE SHALL BE PROTECTED DURING CONSTRUCTION TO PREVENT SILTATION IN THE DRAINAGE SYSTEMS BY WAY OF TEMPORARY PLUGS & PLYWOOD OR PLASTIC COVERS OVER THE INLETS. THE ENTIRE DRAINAGE SYSTEM TO BE CLEAN OF DEBRIS PRIOR TO FINAL ACCEPTANCE.
- WHERE NEW ASPHALT MEETS OR ABUTS EXIST. ASPHALT, THE EXIST. ASPHALT SHALL BE SAWCUT TO PROVIDE A STRAIGHT EVEN LINE. PRIOR TO REMOVING CURB OR GUTTER, THE ADJACENT ASPHALT SHALL ALSO BE SAWCUT TO PROVIDE A STRAIGHT EVEN LINE.
- 7. ALL PROPOSED GRADES (ELEVATIONS) REFER TO FINISHED GRADES (SEE PLAN DWG.)
- 8. SITE GRADING SHALL BE W/IN 0.1' OF THE REQUIRED ELEVATION & ALL AREAS SHALL BE GRADED
- 9. ALL SUBGRADE SHALL HAVE AN LBR OF 40 UNLESS OTHERWISE NOTED & SHALL BE COMPACTED TO 100% MAXIMUM DRY DENSITY PER AASHTO T-99.
- ALL LIMEROCK SHALL BE COMPACTED TO 98% PER AASHTO T-180 & HAVE NOT LESS THAN 60% OF CARBONATES OF CALCIUM & MAGNESIUM UNLESS OTHERWISE DESIGNATED. ALL LIMEROCK SHALL
- CONCRETE & ASPHALT THICKNESS SHALL BE OF TYPE DESIGNATED ON DWGS. (SEE SECTIONS)
  - PLASTIC FILTER FABRIC SHALL BE MIRAFI, TYPAR OR EQUAL CONFORMING TO SECTION 985 OF THE FDOT STANDARD SPECIFICATIONS.
- CONC. SIDEWALKS SHALL BE 4" THICK ON COMPACTED SUBGRADE, W/ 1/2" EXPANSION JOINTS PLACED AT A MAXIMUM OF 75'. CRACK CONTROL JOINTS SHALL BE 5' ON CENTER. THE BACK OF SIDEWALK ELEVATION SHALL EQUAL THE CROWN OF ROADWAY, UNLESS SPECIFIED OTHERWISE BY LOCAL CODES OR INDICATED ON DWGS. ALL CONC. SIDEWALKS THAT CROSS DRIVEWAYS SHALL BE
- PIPE SPECIFICATIONS: THE MATERIAL TYPE IS SHOWN ON THE DRAWINGS BY ONE OF THE FOLLOWING DESIGNATIONS -
  - RCP = REINFORCED CONC. PIPE, ASTM DESIGNATION C-76, TABLE III
  - CMP = CORRUGATED METAL (ALUM.) PIPE, ASTM DESIGNATION M-196CMP = (SMOOTH LINED) CORRUGATED METAL (ALUM.) PIPE, ASTM DESIGNATION M-196
  - SCP = SLOTTED CONC. PIPE, FDOT SECTIONS 941 & 942 PVC = POLYVINYLCHLORIDE PIPE
- PCMP = PERFORATED CMP, FDOT SECTION 945
- DIP = DUCTILE IRON PIPE HDPE = HIGH DENSITY POLYETHYLENE PIPE

FIRE HYDRANT LOCATIONS

BITUMINOUS MATERIAL SHALL BE ASPHALT CEMENT, VISCOSITY GRADE AC-20, CONFORMING TO THE REQUIREMENTS OF FDOT STANDARD SPECIFICATIONS, 1986 EDITION, SECTION 916-1.

PRIME COAT SHALL BE CUT BACK ASPHALT, GRADE RC-70 OR RC-250 CONFORMING TO THE REQUIREMENTS SPECIFIED IN AASHTO DESIGNATION M-81-75 (1982). RATE - 0.10 GALS./S.Y. TACK COAT SHALL BE EMULSIFIED ASPHALT, GRADE RS-2 CONFORMING TO THE REQUIREMENTS SPECIFIED IN AASHTO DESIGNATION M-140-82. RATE - 0.02 TO 0.08 GALS/S.Y.

DESIGN MIX SHALL CONFORM TO FDOT SECTION 331 UNLESS OTHERWISE SPECIFIED.

## PAVEMENT MARKING & SIGNING STANDARD NOTES :

PAVEMENT MARKINGS SHALL BE THERMOPLASTIC, UNLESS SPECIFIED OTHERWISE.

CHARLES O. BUCKALEW, P.E. FLORIDA REG. NO. 24842

PLA RA AVING, DRAIN

CHK'D. BY: C.O.B.

SHEET NO.

TRENCH DRAIN DETAIL

TYLER STREET IN PROJECT AREA


REVISIONS

4/27/17

DATE: AUG, 2016 SCALE: 1"=10'-0"

DWG. BY: C.R.W.

JOB NO.: 16-287

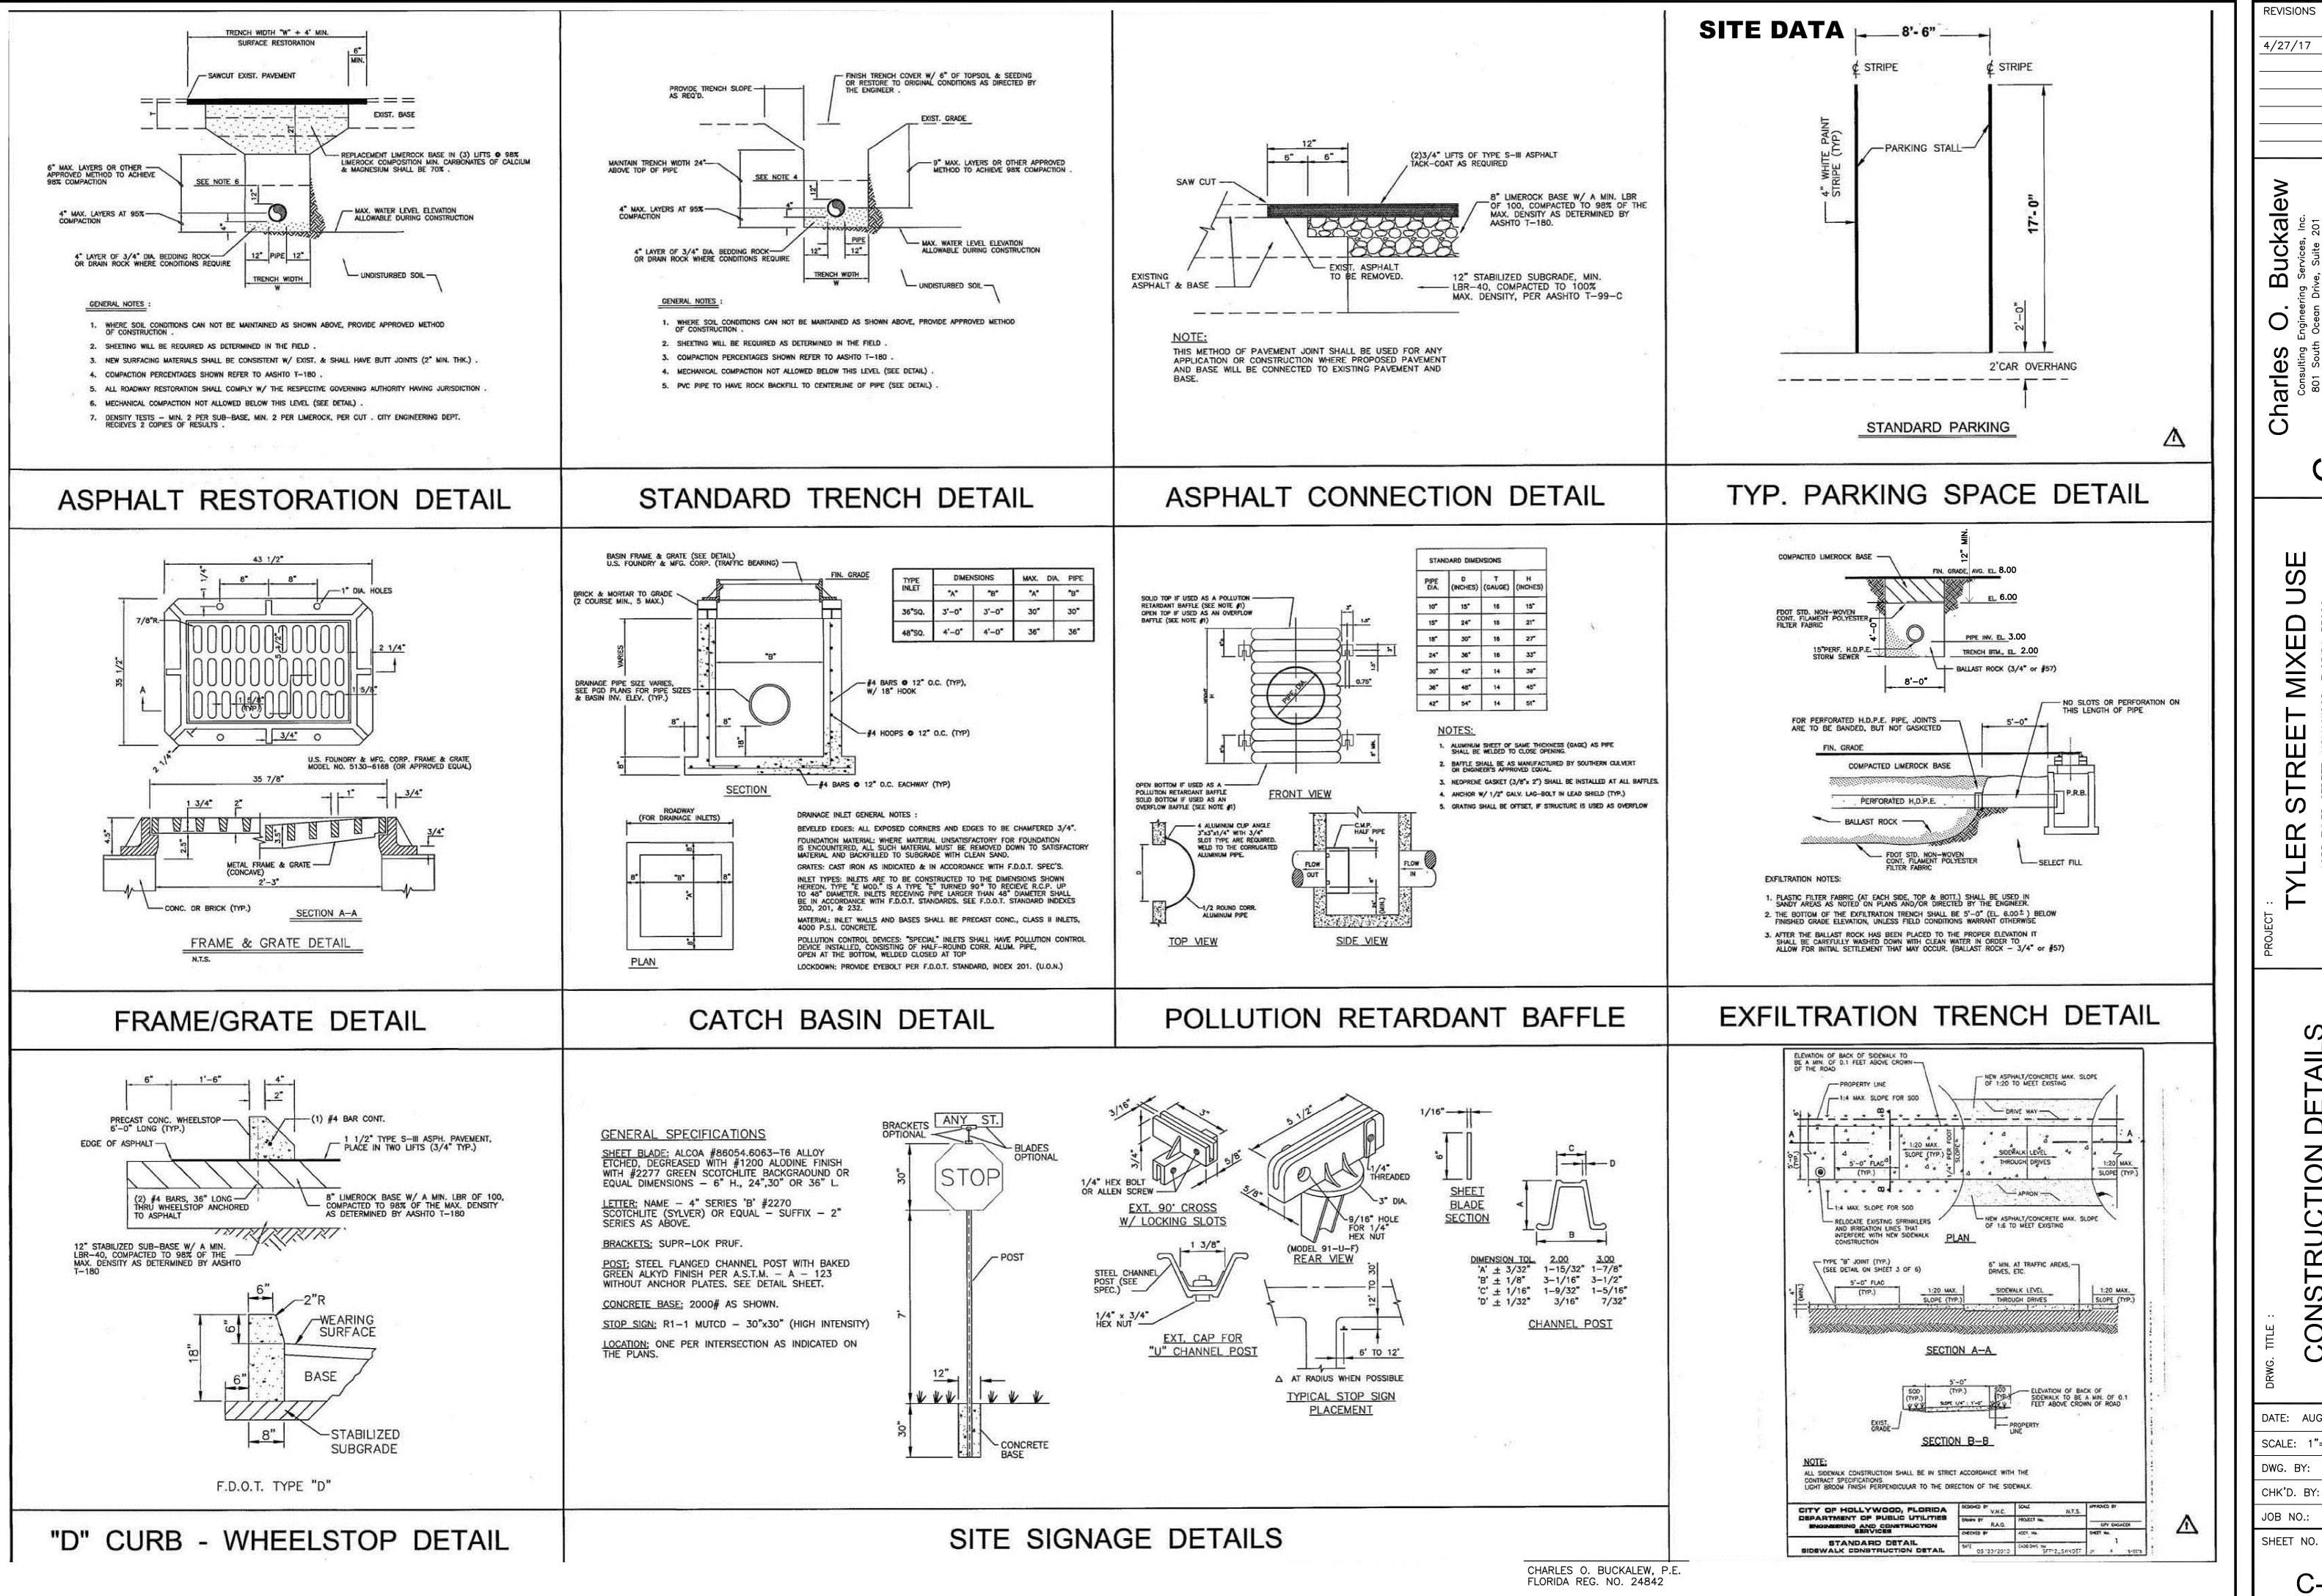

DATE: AUG, 2016 SCALE: 1"=10'-0"

DWG. BY: C.R.W. CHK'D. BY: C.O.B. JOB NO.: 16-287

C-2

- 1. NEW OR RELOCATED UNDERGROUND WATER MAINS INCLUDED IN THIS PROJECT THAT WILL CROSS ANY EXISTING OR PROPOSED GRAVITY OR VACUUM-TYPE SANITARY SEWER OR STORM SEWER WILL BE LAID SO THE OUTSIDE OF THE WATER MAIN IS AT LEAST SIX INCHES ABOVE THE OTHER PIPELINE OR AT LEAST 12 INCHES BELOW THE OTHER PIPELINE.
- 2. NEW OR RELOCATED UNDERGROUND WATER MAINS INCLUDED IN THIS PROJECT THAT WILL CROSS ANY EXISTING OR PROPOSED PRESSURE-TYPE SANITARY SEWER, WASTEWATER OR STORM WATER FORCE MAIN, OR PIPELINE CONVEYING RECLAIMED WATER WILL BE LAID SO THE OUTSIDE OF THE WATER MAIN IS AT LEAST 12 INCHES ABOVE OR BELOW THE OTHER PIPELINE. [FAC 62-555.314(2); EXCEPTIONS ALLOWED UNDER FAC 62-555,314(5)].
- 3. AT ALL UTILITY CROSSINGS DESCRIBED ABOVE, ONE FULL LENGTH OF WATER MAIN PIPE WILL BE CENTERED ABOVE OR BELOW THE OTHER PIPELINE SO THE WATER MAIN JOINTS WILL BE AS FAR AS POSSIBLE FROM THE OTHER PIPELINE, OR THE PIPES WILL BE ARRANGED SO THAT ALL WATER MAIN JOINTS ARE AT LEAST THREE FEET FROM ALL JOINTS IN VACUUM-TYPE SANITARY SEWERS, STORM SEWERS, STORM WATER FORCE MAINS, OR PIPELINES CONVEYING RECLAIMED WATER REGULATED UNDER PART III OF CHAPTER 62-610, F.A.C., AND AT LEAST SIX FEET FROM ALL JOINTS IN GRAVITY OR PRESSURE-TYPE SANITARY SEWERS, WASTEWATER FORCE MAINS, OR PIPELINES CONVEYING RECLAIMED WATER NOT REGULATED UNDER PART III OF CHAPTER 62-610, F.A.C. [FAC 62-555.314(2); EXCEPTIONS ALLOWED UNDER FAC 62-555.314(5)].
- 4. NEW UNDERGROUND WATER MAINS INCLUDED IN THIS PROJECT TO BE DUCTILE IRON PIPE (D.I.P.) WHEN CROSSING BELOW SANITARY SEWER MAINS.
- 5. POLYETHYLENE ENCASEMENT MATERIAL SHALL BE USED TO ENCASE ALL BURIED DUCTILE IRON PIPE, FITTINGS, VALVES, RODS, AND APPURTENANCES IN ACCORDANCE WITH AWWA C105, METHOD A. THE POLYETHYLENE TUBING SHALL BE CUT TWO FEET LONGER THAN THE PIPE SECTION AND SHALL OVERLAP THE ENDS OF THE PIPE BY ONE FOOT. THE POLYETHYLENE TUBING SHALL BE GATHERED AND LAPPED TO PROVIDE A SNUG FIT AND SHALL BE SECURED AT QUARTER POINTS WITH POLYETHYLENE TAPE. EACH END OF THE POLYETHYLENE TUBING SHALL BE SECURED WITH A WRAP OF POLYETHYLENE TAPE.
- 6. THE POLYETHYLENE TUBING SHALL PREVENT CONTACT BETWEEN THE PIPE AND BEDDING MATERIAL, BUT IS NOT INTENDED TO BE A COMPLETELY AIRTIGHT AND WATERTIGHT ENCLOSURE. DAMAGED POLYETHYLENE TUBING SHALL BE REPAIRED IN A WORKMANLIKE MANNER USING POLYETHYLENE TAPE, OR THE DAMAGED SECTION SHALL BE REPLACED. POLY WRAP WILL NOT BE PAID FOR AS A SEPARATE BID ITEM. IT SHALL BE CONSIDERED TO BE A PART OF THE PRICE BID FOR WATER MAINS.
- FIRE HYDRANT BARRELS SHALL BE ENCASED IN POLY WRAP UP TO THE GROUND SURFACE AND THE WEEP HOLES SHALL NOT BE COVERED BY THE POLY WRAP.
- GATE VALVES FOR USE WITH PIPE LESS THAN THREE INCHES (3") IN DIAMETER SHALL BE RATED FOR TWO HUNDRED (200) PSI WORKING PRESSURE, NON-SHOCK, BLOCK PATTERN, SCREWED BONNET, NON-RISING STEM, BRASS BODY, AND SOLID WEDGE. THEY SHALL BE STANDARD THREADED FOR PVC PIPE AND HAVE A MALLEABLE IRON HANDWHEEL. GATE VALVES LESS THAN THREE INCHES (3") IN DIAMETER SHALL BE NIBCO-SCOTT T-113 LF WITH NO SUBSTITUTIONS ALLOWED. LARGE GATE VALVES OVER 3" THRU 16" IN DIAMETER, MUST BE RESILIENT SEAT AND BIDIRECTIONAL FLOW ONLY. MANUFACTURERS: MUELLER, AMERICAN DARLING, AVK, OR CITY APPROVED EQUAL. VALVES FOR SPECIAL APPLICATION WILL REQUIRE CITY UTILITY APPROVAL

OF HOLITHOOP ALL	ISSUED:	03/01/1994	DEPARTMENT OF PUBLIC UTILITIES STANDARD DETAIL	REVISED: 06/08/2014
CONDCOAST	DRAWN:	EAM	WATER SYSTEM NOTES	DRAWING NO.
ACOMPORNOS IN	APPROVED	: XXX		W-01

## WATER NOTES CONTINUED:

- 9. VALVE BOXES AND COVERS FOR ALL SIZE VALVES SHALL BE OF CAST IRON CONSTRUCTION AND ADJUSTABLE SCREW-ON TYPE. THE LID SHALL HAVE CAST IN THE METAL THE WORD "WATER" FOR THE WATER LINES. ALL VALVE BOXES SHALL BE SIX INCH (6") NOMINAL DIAMETER AND SHALL BE SUITABLE FOR DEPTHS OF THE PARTICULAR VALVE. THE STEM OF THE BURIED VALVE SHALL BE WITHIN TWENTY-FOUR INCHES (24") OF THE FINISHED GRADE UNLESS OTHERWISE APPROVED BY THE CITY. VALVE BOXES SHALL BE TYLER BRAND, NO SUBSTITUTES.
- 10. FIRE HYDRANTS: PRESENTLY CITY OF HOLLYWOOD UTILITIES SPECIFICATIONS ALLOW ONLY MANUFACTURERS: MUELLER MODEL SUPER CENTURION 200 51/4" SIZE REFERENCE CATALOG NO. A-423 AND AMERICAN DARLING MODEL B-84-B 5½" SIZE. ANY DEVIATION FROM REQUIRED SPECIFICATIONS WILL REQUIRE CITY OF HOLLYWOOD UTILITIES APPROVAL.
- 11. ALL WATER MAIN INSTALLATIONS SHALL COMPLY WITH THE COLOR CODING REQUIREMENTS OF CHAPTER 62-555.320 F.A.C.
- 12. ALL PVC PIPE SHALL CONFORM TO THE REQUIREMENTS OF ANSI/AWWA C900 LATEST REVISION AND CLASS DR 18. ALL DIP WATER MAINS SHALL BE DUCTILE IRON PRESSURE CLASS 350, WITH WALL THICKNESS COMPLYING WITH CLASS 52. ALL DUCTILE IRON PIPE SHALL CONFORM TO THE REQUIREMENTS OF ANSI/AWWA C151/A21.51-02 AND BE CEMENT LINED AND SEAL COATED PER ANSI/AWWA C104/A21.4-03.
- 13. FITTINGS SHALL BE DUCTILE IRON, MEETING ANSI/AWWA C153/A21.53-00 SPECIFICATIONS, WITH 350 PSI MINIMUM WORKING PRESSURE. FITTINGS MUST BE CEMENT LINED AND SEAL COATED PER ANSI/AWWA C104/A21.4-03. ALL DUCTILE IRON PIPE AND FITTINGS MUST BE MANUFACTURED IN THE UNITED STATES OF
- 14. ALL DUCTILE IRON PIPE TO BE MECHANICAL JOINTS, WRAPPED IN POLY. ADEQUATE PROTECTIVE MEASURES AGAINST CORROSION SHALL BE USED AS DETERMINED BY DESIGN.
- 15. GATE VALVES 4" AND LARGER SHALL BE RESILIENT SEAT AND SHALL MEET ANSI/AWWA C-509-01 SPECIFICATIONS, LATEST REVISION. VALVES MUST BE MUELLER (O.A.E.). VALVE BOXES SHALL BE TYLER UNION, CONTROL/GATE VALVES 3" AND SMALLER SHALL BE NIBCO T-133 LF. NO SUBSTITUTIONS.
- 16. PAVEMENT RESTORATION SHALL BE CARRIED OUT IN ACCORDANCE WITH THE REQUIREMENTS OF THE CITY.
- 17. ALL TRENCHING, PIPE LAYING, BACKFILL, PRESSURE TESTING, AND DISINFECTING MUST COMPLY WITH THE CITY OF HOLLYWOOD SPECIFICATIONS.
- 18. THE MINIMUM DEPTH OF COVER OVER WATER MAINS IS 30" (DIP) OR 36" (PVC).
- 19. MINIMUM CLEARANCE BETWEEN STORM STRUCTURES AND WATER MAINS SHALL BE 2', AND MAXIMUM DEFLECTION PER EACH JOINT SHALL BE 50% OF MANUFACTURES RECOMMENDATION (MAXIMUM) WHERE DEFLECTION IS REQUIRED.
- 20. TAPPING SLEEVES SHALL BE MUELLER H-615 (O.A.E.). TAPPING VALVES 4" AND LARGER SHALL BE RESILIENT WEDGE TYPE MEETING ANSI/AWWA C509-01. ALL TAPPING VALVES SHALL HAVE A CAST-IN ALIGNMENT RING AND BE CAPABLE OF ACCEPTING A FULL-SIZE CUTTER.
- 21. CONTRACTOR SHALL BE RESPONSIBLE FOR IDENTIFYING CONFLICTS WITH WATER MAINS PLACED AT MINIMUM COVER. IN CASE OF CONFLICT, WATER MAIN SHALL BE LOWERED TO PASS UNDER CONFLICTS WITH 18" MINIMUM SEPARATION. NO ADDITIONAL PAYMENT SHALL BE DUE TO CONTRACTOR FOR LOWERING THE MAIN OR THE ADDITIONAL FITTINGS USED THEREON.

0	ISSUED:	03/01/1994	DEPARTMENT OF PUBLIC UTILITIES STANDARD DETAIL	REVISED: 06/08/2014
MAURAU SELECTIANT	DRAWN:	EAM		DRAWING NO.
	APPROVED	: XXX	WATER NOTES	W-01.1

## WATER NOTES CONTINUED:

- 22. PIPE JOINT RESTRAINT SHALL BE PROVIDED BY THE USE OF DUCTILE IRON FOLLOWER GLANDS MANUFACTURED TO ASTM A 536-80. TWIST-OFF NUTS SHALL BE USED TO ENSURE PROPER ACTUATING OF THE RESTRAINING DEVICES. THE MECHANICAL JOINT RESTRAINING DEVICES SHALL HAVE A WORKING PRESSURE OF 250 PSI MINIMUM, WITH A MINIMUM SAFETY FACTOR OF 2:1, AND SHALL BE EBAA IRON INC., MEGALUG OR APPROVED EQUAL JOINT RESTRAINTS SHALL BE PROVIDED AT A MINIMUM OF THREE JOINTS (60 FEET) FROM ANY FITTING.
- 23. WHENEVER IT IS NECESSARY, IN THE INTEREST OF SAFETY, TO BRACE THE SIDES OF A TRENCH, THE CONTRACTOR SHALL FURNISH. PUT IN PLACE AND MAINTAIN SUCH SHEETING OR BRACING AS MAY BE NECESSARY TO SUPPORT THE SIDES OF THE EXCAVATION TO ENSURE PERSONNEL SAFETY, AND TO PREVENT MOVEMENT WHICH CAN IN ANY WAY DAMAGE THE WORK OR ENDANGER ADJACENT STRUCTURES. THE CONTRACTOR SHALL BE SOLELY RESPONSIBLE FOR THE SEQUENCE, METHODS AND MEANS OF CONSTRUCTION, AND FOR THE IMPLEMENTATION OF ALL OSHA AND OTHER SAFETY REQUIREMENTS.


;	Or HUILLINGO OF THE	ISSUED:	03/01/1994	DEPARTMENT OF PUBLIC UTILITIES STANDARD DETAIL	REVISED: 06/08/2014
	Marketon & Co.	DRAWN:	EAM		DRAWING NO.
	OKPORATION TO	approved	D: XXX	WATER NOTES	W-02
,					


## SITE DATA


## WATER METER SERVICE NOTES:

- SUCCESSIVE TAPS INTO THE WATER MAIN SHALL BE SPACED NOT LESS THAN 18" ON CENTER.
- 2. P.E. TUBING SHALL BE IN ACCORDANCE WITH THE LATEST EDITION OF AWWA STANDARD C901 "POLYETHYLENE (PE) PRESSURE PIPE AND TUBING, 1/2 IN. (13mm) THROUGH 3 IN. (76 mm), FOR
- 3. SERVICE PIPE SHALL BE THE SAME SIZE AS THE WATER METER EXCEPT THAT NO SERVICE PIPE SHALL BE SMALLER THAN 1" DIAMETER.
- 4. SERVICE PIPE CROSSING UNDER THE ENTIRE WIDTH OF A ROADWAY PAVEMENT MUST BE 2" MINIMUM UNLESS OTHERWISE DIRECTED BY THE CITY.
- 5. THE 3" CASING UNDER THE ROAD IS TO BE USED ONLY WHEN THE WATER MAIN RUNS WITHIN THE SWALE ON THE OPPOSITE SIDE OF THE ROAD FROM THE METER SERVICE. ALL CASING PIPE SHALL EXTEND A MINIMUM OF 2' BEYOND THE EDGE OF PAVED STREETS.
- APPROVED TYPE COPPER TUBING MAY BE USED AT THE CITY'S DISCRETION.
- 7. FOR NEW METER INSTALLATIONS, ALL SADDLES, VALVES, PIPING, FITTINGS, CURB STOPS, METER VALVES, METER COUPLINGS, METER VAULTS AND COVERS SHALL BE FURNISHED AND INSTALLED BY THE CONTRACTOR.
- 8. THE WATER METERS WILL BE PROVIDED BY THE CITY OF HOLLYWOOD AND INSTALLED BY THE CONTRACTOR.
- 9. FOR METER RELOCATIONS, ALL SADDLES, VALVES, PIPING, FITTINGS, CURB STOPS, METER VALVES, METER COUPLINGS, METER VAULTS AND COVERS SHALL BE FURNISHED AND INSTALLED BY THE CONTRACTOR.
- 10. THE EXISTING WATER METER TO BE RELOCATED AND INSTALLED BY CONTRACTOR.
- 11. FOR EXISTING METERS ABUTTING THE RIGHT-OF-WAY THAT ARE BEING DISCONNECTED FROM **EXISTING MAINS AND RECONNECTED TO NEW MAINS, THE CONTRACTOR SHALL:**
- a. CUT AND PLUG THE EXISTING SERVICE LINE AT THE MAIN AND AT THE METER, AND REMOVE THE EXISTING BALL VALVE CURB STOP.
- b. FURNISH AND INSTALL SERVICE SADDLE, CORPORATION STOP OR SERVICE VALVE AND VALVE BOX, PIPING AND FITTINGS UP TO AND INCLUDING THE BALL VALVE CURB STOP.
- 12. THE ELEVATION AT THE TOP OF THE METER BOX SHALL MATCH THE ELEVATION OF THE BACK OF SIDEWALK.
- 13. AS PART OF THE SERVICE INSTALLATION, THE CONTRACTOR SHALL RESTORE THE RIGHT-OF-WAY TO MATCH EXISTING CONDITIONS, INCLUDING ROADWAY PAVEMENT, PAVEMENT MARKINGS AND RPMs, CONCRETE CURBS, SIDEWALKS, RAMPS (INCLUDING DETECTABLE WARNING SURFACE), SODDING, AND ALL OTHER IMPROVEMENTS REMOVED OR DAMAGED DURING THE SERVICE INSTALLATION.
- 14. FOR UNPAVED AREAS, THE MINIMUM GROUND COVER ACCEPTED BY THE CITY IS SODDING.

of HOLLI "OOR ALL	ISSUED:	03/01/1994	DEPARTMENT OF PUBLIC UTILITIES STANDARD DETAIL	REVISED: 06/08/2014
M unitary	DRAWN:	EAM	WATER METER SERVICE NOTES FOR	DRAWING NO.
ROLL ROCKATED	APPROVED	): <b>X</b> XX	5/8" THROUGH 2" METERS	W-07
		(Title: TO)	of the state of th	4.5

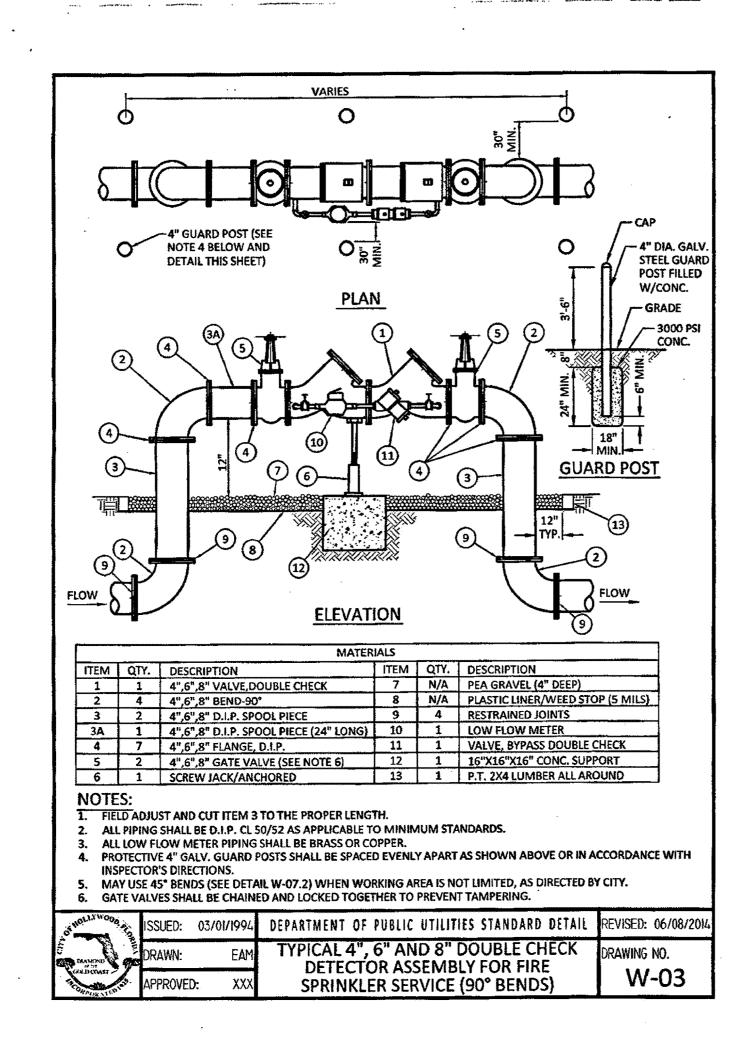

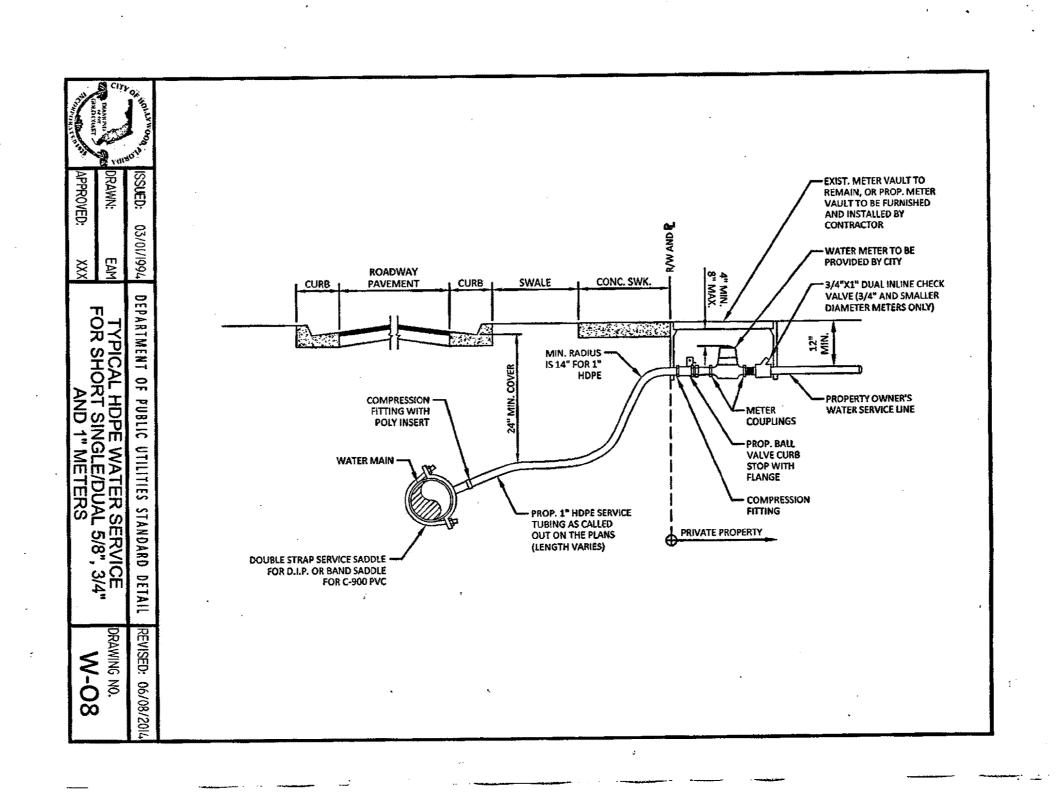

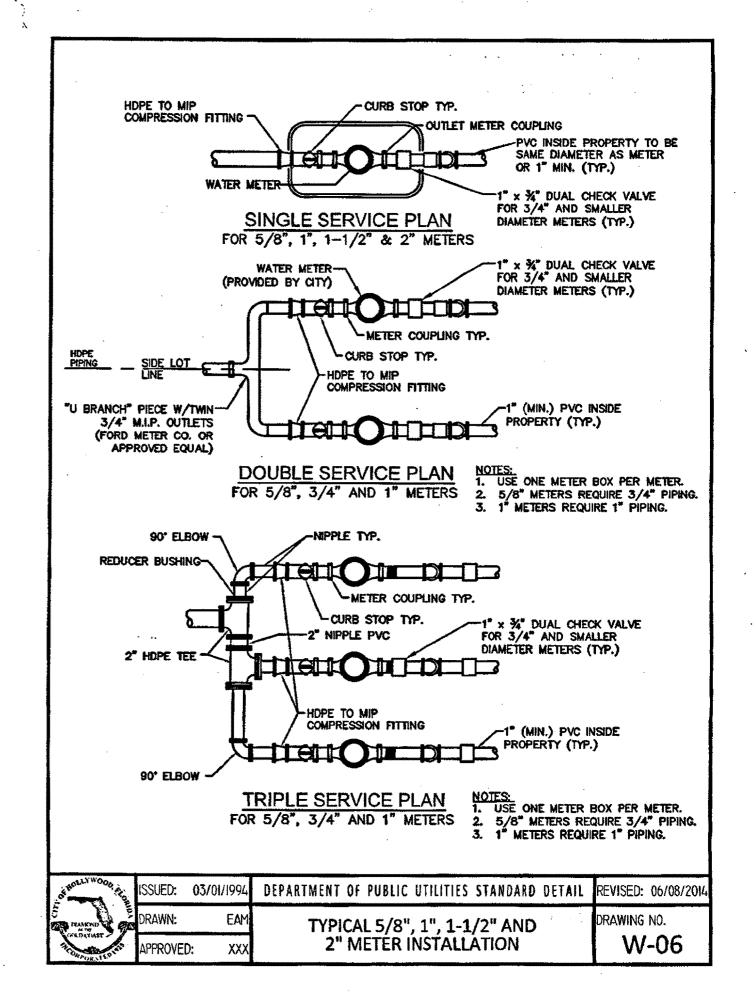

CHARLES O. BUCKALEW, P.E. FLORIDA REG. NO. 24842

REVISIONS 4/27/17

a

CHK'D. BY: C.O.B. JOB NO.: 16-287

SHEET NO.

C-3

FIGURE 11

CHARLES O. BUCKALEW, P.E. FLORIDA REG. NO. 24842

EC-3

JOB NO.: 16-287 SHEET NO.

DATE: AUG, 2016

SCALE: 1"=10'-0"

REVISIONS

4/27/17

Buckale


0

arle

MIXE

Ш

Ш

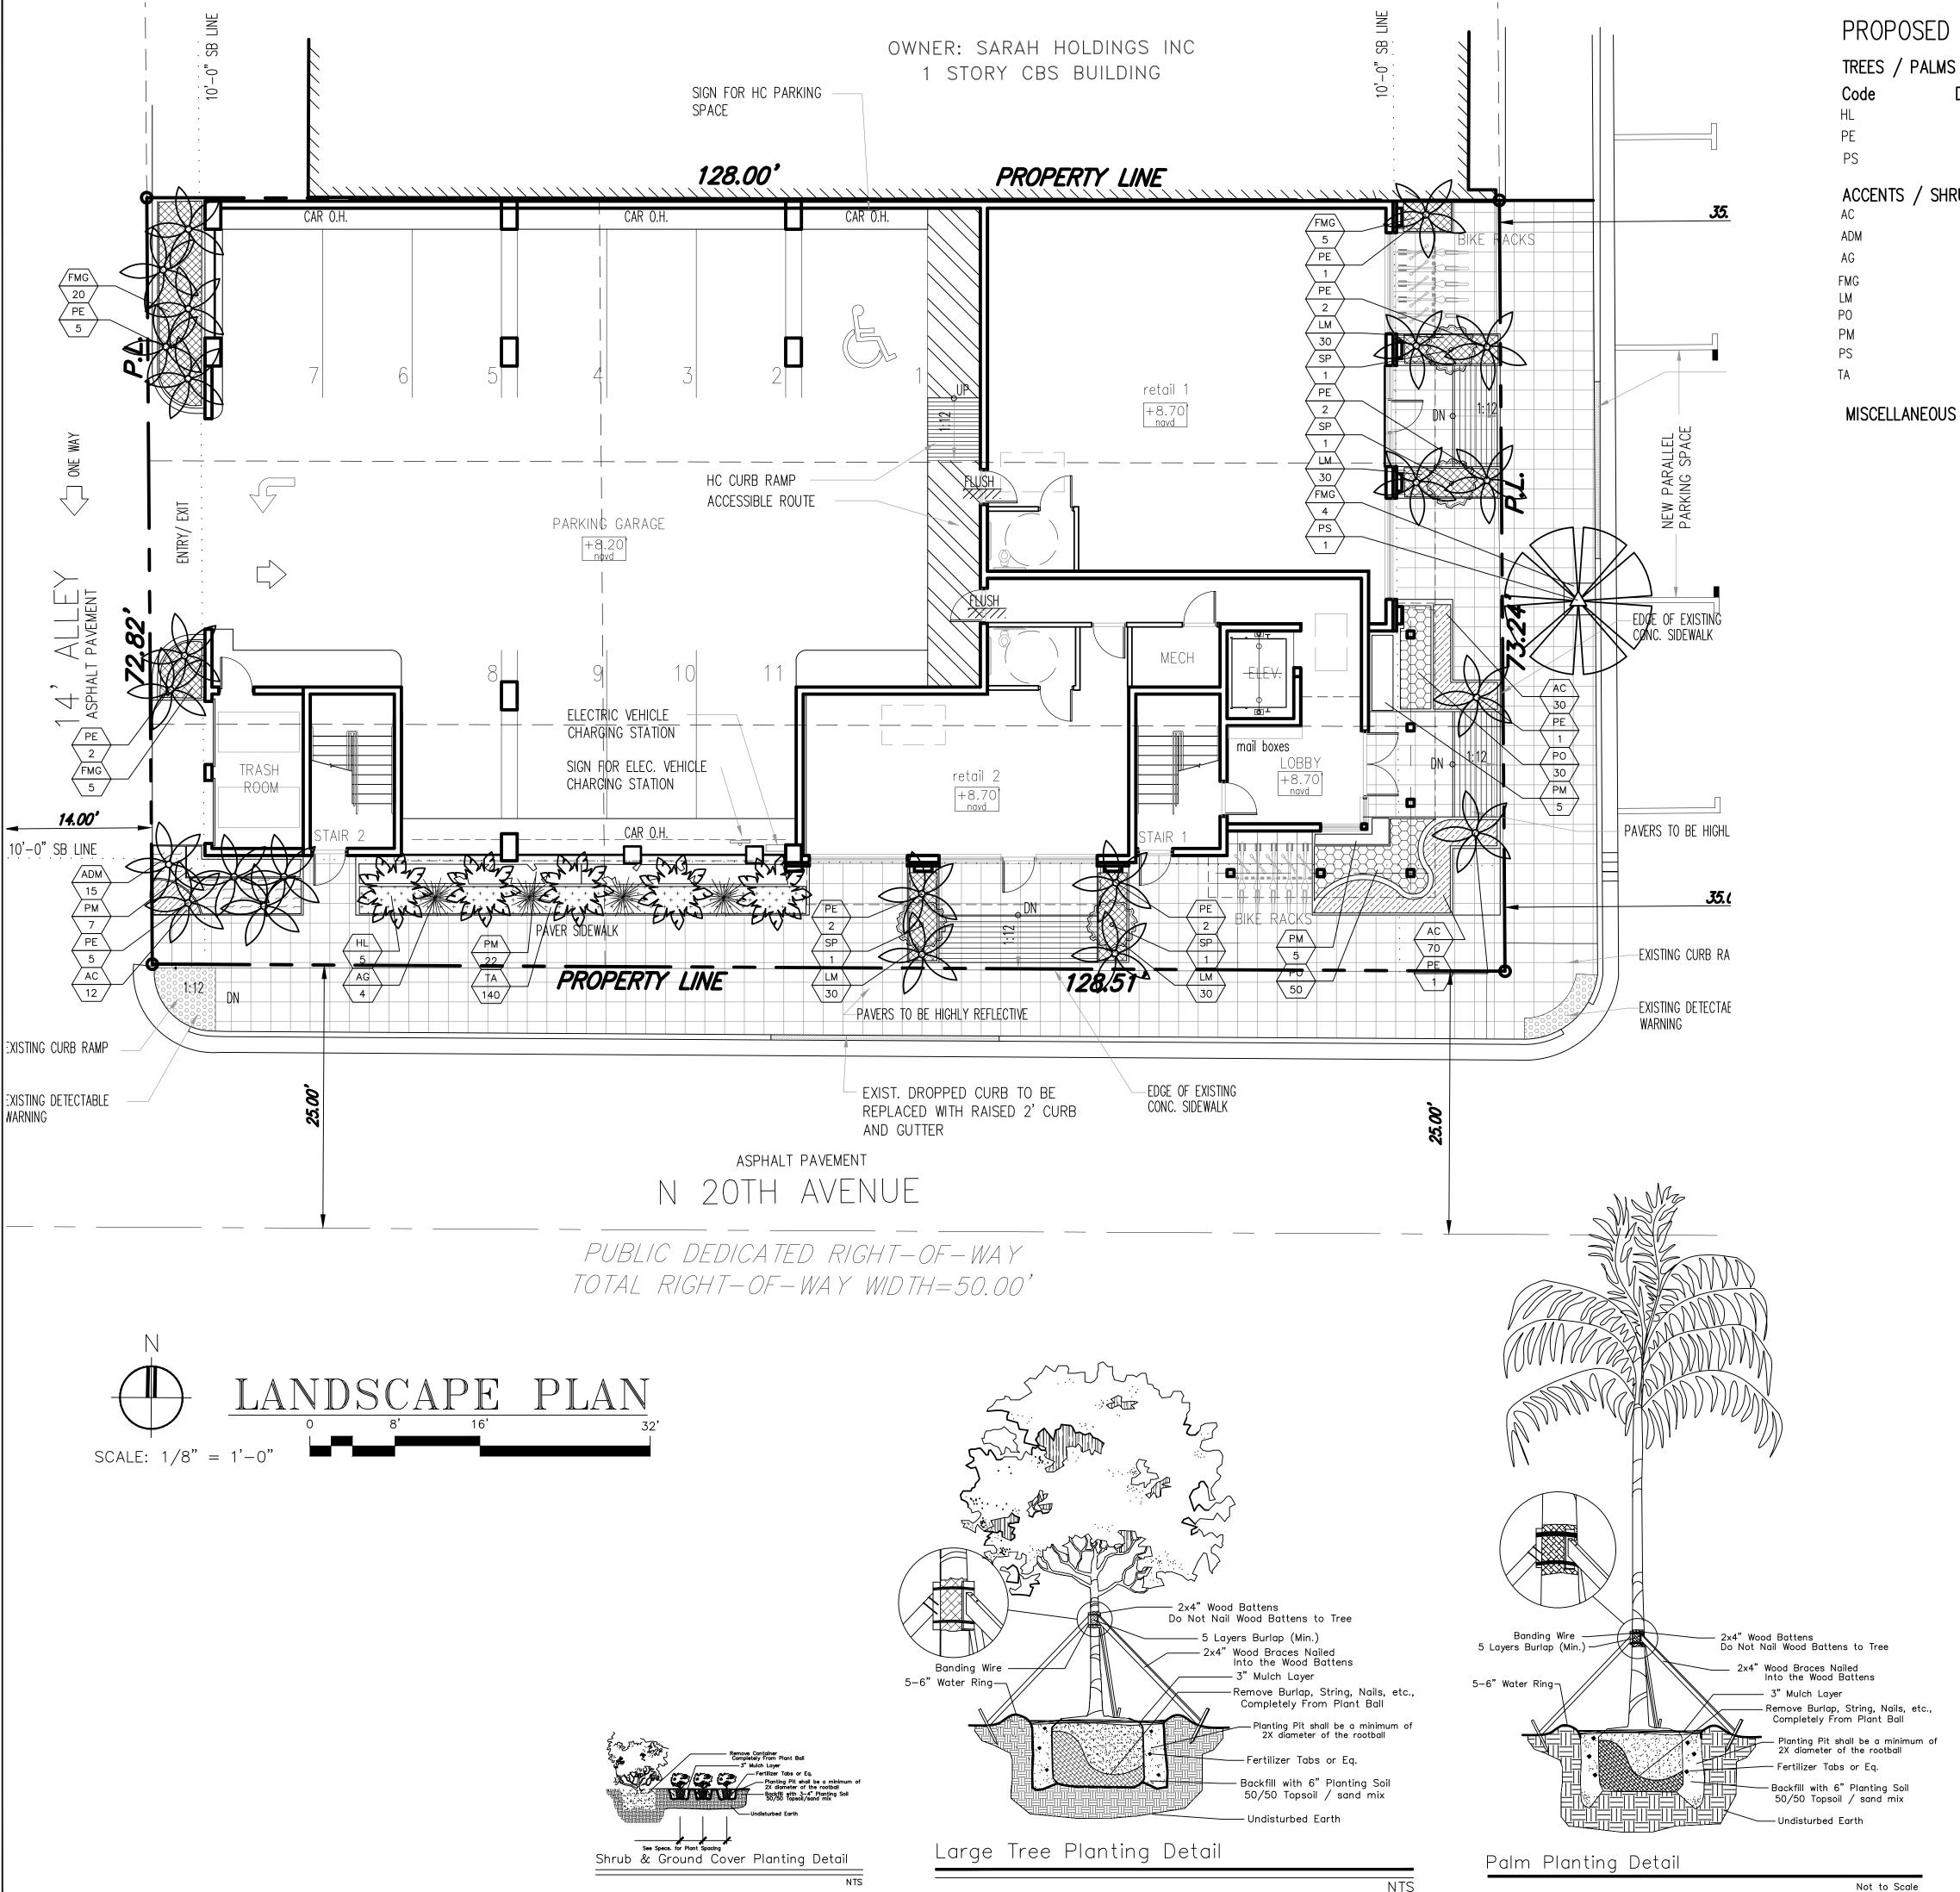

# PROPOSED PLANT LIST

de	Drought	QTY.	Botanical Name / Common Name
	V	5	Hyophorbe lagenicaulis / Bottle Palm
	V	23	Ptychosperma elegens / Solitaire Palms
	V	1	Phoenix sylvestris / Sylvester Palm
CENTS	/ SHRUBS / GF		
	V	112	Aptenia cordifolia / Baby Sunrose

MODELLIO /		CITOCITE	OUTLINO
AC .	٧	112	Aptenia cordifolia / Baby Sunrose
ADM	٧	15	Asparagus densiflorus 'Myers' / Foxtail Ferr
4G	V	4	Agave sp / Blue Giant Agave
MG	٧	34	Ficus macrocarpa / Green Island Ficus
.M	V	120	Liriope muscari / Liriope
0	V	80	Peperomia obtusifolia / Peperomia
PM	V	39	Podocarpus macrophyllus / Podocarpus
PS	V	4	Senna polyphylla / Desert Cassia
A	٧	140	Trachelspermum asiaticum / Asiatic Jasmin

## **MISCELLANEOUS**

Florida Native Plant Species Low Drought Tolerance
Moderate Drought Tolerance
Very Drought Tolerant

# NOTES:

## GENERAL PLANTING REQUIREMENTS

All sizes shown for plant material on the plans are to be considered Minimum. All plant material must meet or exceed these minimum requirements for both height and spread. Any other requirements for specific shape or effect as noted on the plan(s) will also be required for final acceptance.

Specifications

1 gal., 12" OA, 12" OC

7 gal., 36" OA, 36"' OC

3 gal., 18" OA, 24" OC 1 Gal., 12" OA, 12" OC

3 Gal., 24" OA, 2' OC

3 Gal., 24" OA, 2' OC

3 Gal., 24" OC

1 Gal., 12" OC

10 Gal., 48" OA

B&B Field Grown, 6-8' OA B&B Field Grown, 12-14' OA B&B Field Grown, 12-14' OA

All plant material furnished by the landscape contractor shall be Florida #1 or better as established by "Grades and Standards for Florida Nursery Plants" and "Grades and Standards for Florida Nursery Trees". All material shall be installed as per CSI specifications.

All plant material as included herein shall be warrantied by the landscape contractor for a minimum period as follows: All trees and palms for 12 months, all shrubs, vines, groundcovers and miscellaneous planting materials for 90 days, and all lawn areas for 60 days after final acceptance by the owner or owner's representative.

All plant material shall be planted in planting soil that is delivered to the site in a clean loose and friable condition. All soil shall have a well drained characteristic. Soil must be free of all rocks, sticks, and objectionable material including weeds and weed seeds as per CSI specifications.

Twelve inches (12") of planting soil 50/50 sand/topsoil mix is required around and beneath the root ball of all trees and palms, and 1 cubic yard per 50 bedding or groundcover plants.

All landscape areas shall be covered with Eucalyptus or sterilized seed free Melaleuca mulch to a minimum depth of three inches (3") of cover when settled. Cypress bark mulch shall not be used.

All plant material shall be thoroughly watered in at the time of planting; no dry planting permitted. All plant materials shall be planted such that the top of the plant ball is flush with the surrounding grade.

All landscape and lawn areas shall be irrigated by a fully automatic sprinkler system adjusted to provide 100% coverage of all landscape areas. All heads shall be adjusted to 50% overlap as per manufacturers specifications and performance standards utilizing a rust free water source. Each system shall be installed with a rain sensor.

Each lot shall supply, install, and maintain an individual irrigation system for that individual lot.

It is the sole responsibility of the landscape contractor to insure that all new plantings receive adequate water during the installation and during all plant warranty periods. Deep watering of all new trees and palms and any supplemental watering that may be required to augment natural rainfall and site irrigation is mandatory to insure proper plant development and shall be provided as a part of this contract.

All plant material shall be installed with fertilizer, which shall be State approved as a complete fertilizer containing the required minimum of trace elements in addition to N-P-K, of which 50% of the nitrogen shall be derived from an organic source as per CSI specifications.

Contractors are responsible for coordinating with the owners and appropriate public agencies to assist in locating and verifying all underground utilities prior to excavation.

All ideas, designs and plans indicated or represented by this drawing are owned by and are the exclusive property of Wayne K. Tonning,RLA.

The plan takes precedence over the plant list.

# SPECIAL INSTRUCTIONS

General site and berm grading to  $\pm/-1$  inch (1") shall be provided by the general contractor. All finished site grading and final decorative berm shaping shall be provided by the landscape contractor.

All sod areas as indicated on the planting plan shall receive Stenotaphrum secundatum, St. Augustine 'Floratam' solid sod. It shall be the responsibility of the landscape contractor to include in the bid, the repair of any sod which may be damaged from the landscape installation operations.

9

 $\triangleleft$ 

 $\bigcirc$ 


 $\mathbb{Z}$ 


PROJECT NO. <u>17-127</u> DESIGNED BY \_ CHECKED BY

08-17-17 DATE P-1

SHT. NO. **REVISIONS:** 

Shrub & Ground Cover Planting Detail

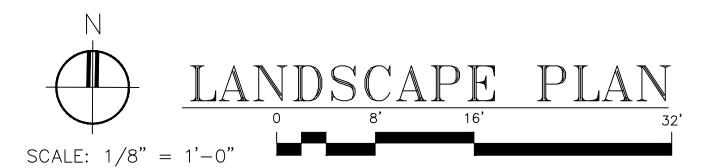

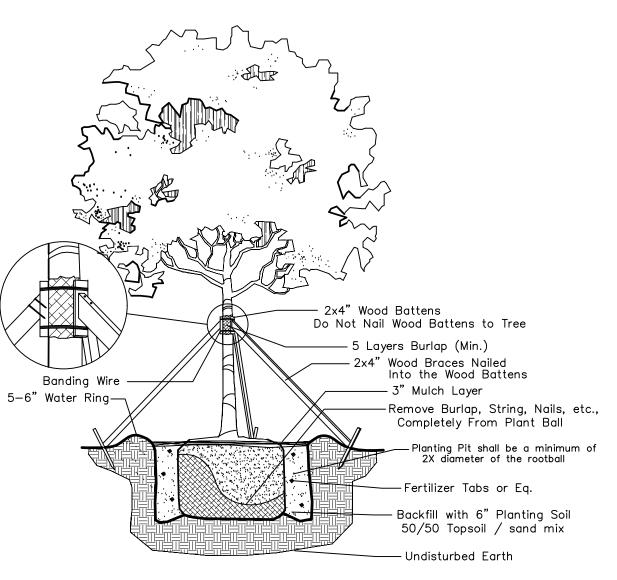

Large Tree Planting Detail



PROPOSED PLANT LIST

TREES / PALMS

QTY. Botanical Name / Common Name

Specifications

6 Coccothrinax Miraguama / Miraguama Palm

B&B Field Grown, 6-8' OA

ACCENTS / SHRUBS / GROUND COVERS

30 Ficus macrocarpa / Green Island Ficus

3 gal., 18" OA, 24"' OC

**MISCELLANEOUS** 

Florida Native Plant Species Low Drought Tolerance Moderate Drought Tolerance Very Drought Tolerant

# NOTES:

# GENERAL PLANTING REQUIREMENTS

All sizes shown for plant material on the plans are to be considered Minimum. All plant material must meet or exceed these minimum requirements for both height and spread. Any other requirements for specific shape or effect as noted on the plan(s) will also be required for final acceptance.

All plant material furnished by the landscape contractor shall be Florida #1 or better as established by "Grades and Standards for Florida Nursery Plants" and "Grades and Standards for Florida Nursery Trees". All material shall be installed as per CSI specifications.

All plant material as included herein shall be warrantied by the landscape contractor for a minimum period as follows: All trees and palms for 12 months, all shrubs, vines, groundcovers and miscellaneous planting materials for 90 days, and all lawn areas for 60 days after final acceptance by the owner or owner's representative.

All plant material shall be planted in planting soil that is delivered to the site in a clean loose and friable condition. All soil shall have a well drained characteristic. Soil must be free of all rocks, sticks, and objectionable material including weeds and weed seeds as per CSI specifications.

Twelve inches (12") of planting soil 50/50 sand/topsoil mix is required around and beneath the root ball of all trees and palms, and 1 cubic yard per 50 bedding or groundcover plants.

All landscape areas shall be covered with Eucalyptus or sterilized seed free Melaleuca mulch to a minimum depth of three inches (3") of cover when settled. Cypress bark mulch shall not be used.

All plant material shall be thoroughly watered in at the time of planting; no dry planting permitted. All plant materials shall be planted such that the top of the plant ball is flush with the surrounding grade.

All landscape and lawn areas shall be irrigated by a fully automatic sprinkler system adjusted to provide 100% coverage of all landscape areas. All heads shall be adjusted to 50% overlap as per manufacturers specifications and performance standards utilizing a rust free water source. Each system shall be installed with a rain sensor.

Each lot shall supply, install, and maintain an individual irrigation system for that individual lot.

It is the sole responsibility of the landscape contractor to insure that all new plantings receive adequate water during the installation and during all plant warranty periods. Deep watering of all new trees and palms and any supplemental watering that may be required to augment natural rainfall and site irrigation is mandatory to insure proper plant development and shall be provided as a part of this contract.

All plant material shall be installed with fertilizer, which shall be State approved as a complete fertilizer containing the required minimum of trace elements in addition to N-P-K, of which 50% of the nitrogen shall be derived from an organic source as per CSI specifications.

Contractors are responsible for coordinating with the owners and appropriate public agencies to assist in locating and verifying all underground utilities prior to excavation.

All ideas, designs and plans indicated or represented by this drawing are owned by and are the exclusive property of Wayne K. Tonning,RLA.

The plan takes precedence over the plant list.

## SPECIAL INSTRUCTIONS

General site and berm grading to  $\pm/-1$  inch (1") shall be provided by the general contractor. All finished site grading and final decorative berm shaping shall be provided by the landscape contractor.

All sod areas as indicated on the planting plan shall receive Stenotaphrum secundatum, St. Augustine 'Floratam' solid sod. It shall be the responsibility of the landscape contractor to include in the bid, the repair of any sod which may be damaged from the landscape installation operations.

 $\triangleleft$  $\bigcirc$  $\angle$ 

 $\geq$ 

PROJECT NO. <u>17-127</u> WKT

DESIGNED BY \_ CHECKED BY 08-17-17 DATE

P-2SHT. NO. **REVISIONS:** 

Banding Wire — - 2x4" Wood Battens Do Not Nail Wood Battens to Tree 5 Layers Burlap (Min.) — 2x4" Wood Braces Nailed Into the Wood Battens 5−6" Water Ring¬ — Remove Burlap, String, Nails, etc., Completely From Plant Ball

Not to Scale


— Planting Pit shall be a minimum of 2X diameter of the rootball

— Fertilizer Tabs or Eq.

-Undisturbed Earth

-Backfill with 6" Planting Soil

50/50 Topsoil / sand mix

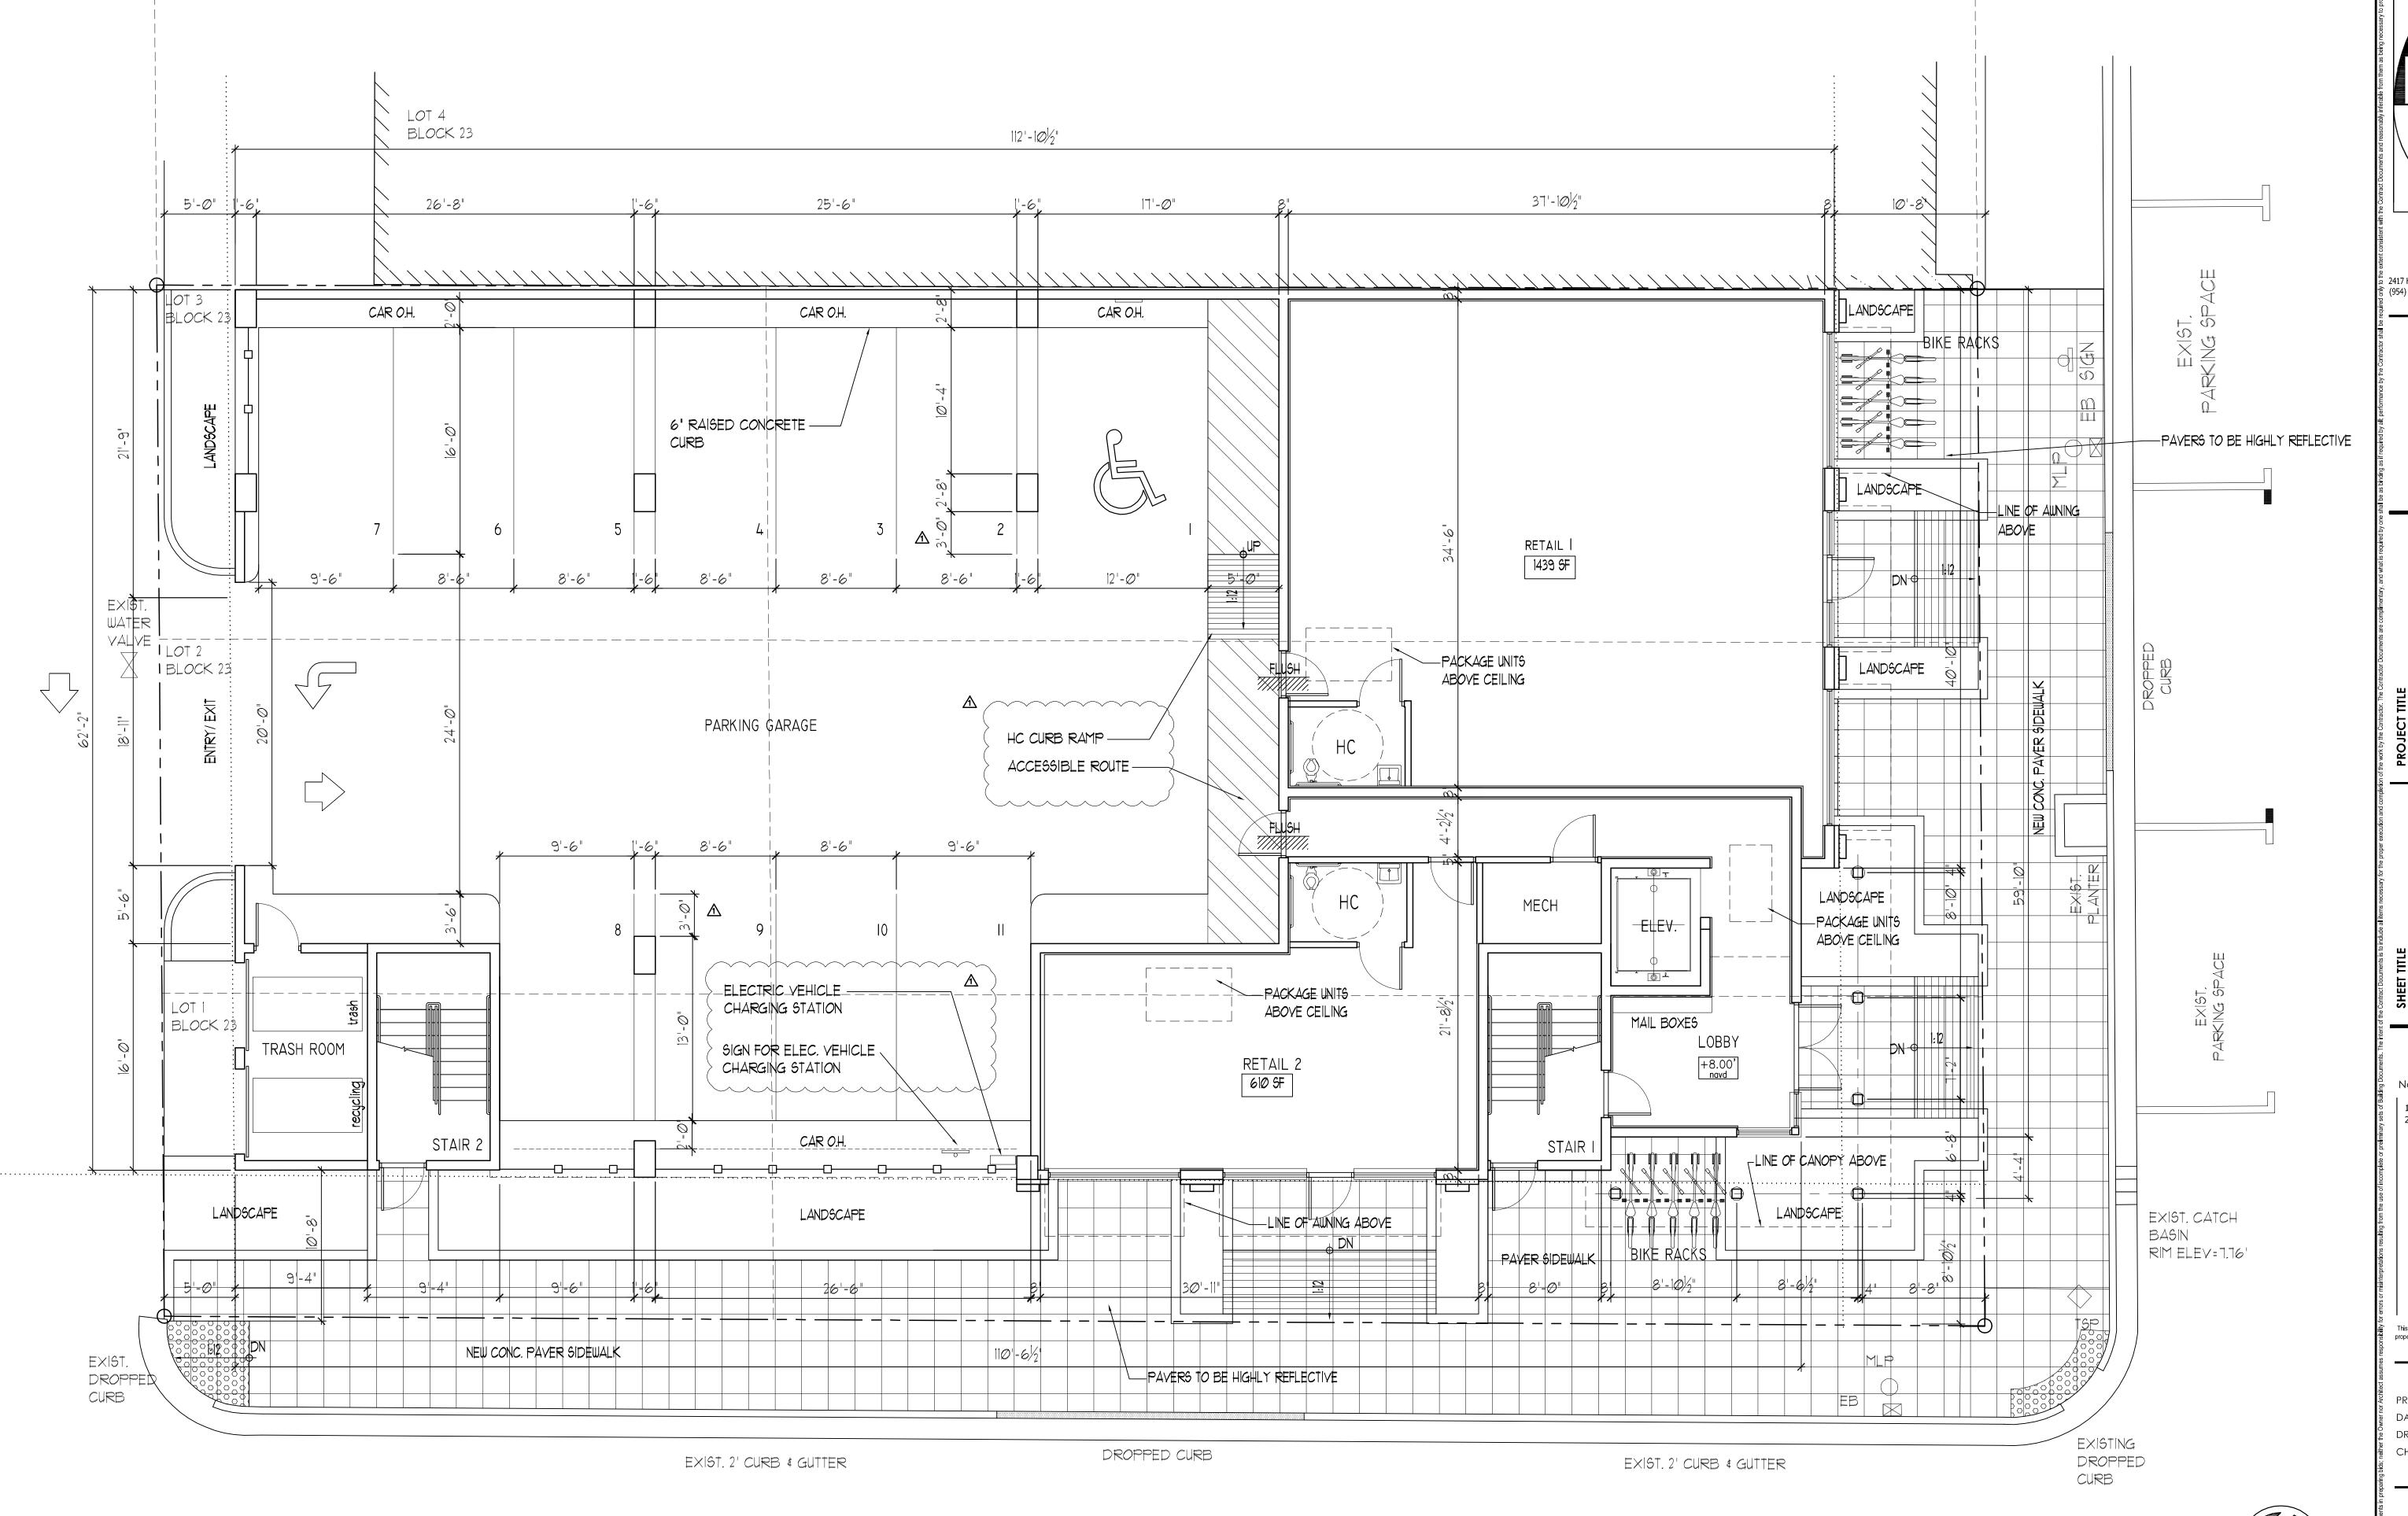



Kaler JOSEPH B. KALLER

ASSOCIATES PA 2417 Hollywood Blvd. Hollywood, Florida 33020 (954) 920 5746 phone - (954) 926 2841 fax kaller@bellsouth.net

SEAL

JOSEPH B. KALLER FLORIDA R.A. # 0009239

TYLER STREET MIXED USE 1955 TYLER STREET AND 209 N. 20TH AVE. HOLLYWOOD FL 33020

**REVISIONS** No. DATE DESCRIPTION

8-10-17 FINAL TAC

This drawing, as an instrument of service, is and shall remain the property of the Architect and shall not be reproduced, published or used in any way without the permission of the Architect.


PROJECT No.: 17093 DATE: 7-11-17 DRAWN BY:


CHECKED BY:

SHEET

1 OF 6


MANHOLE

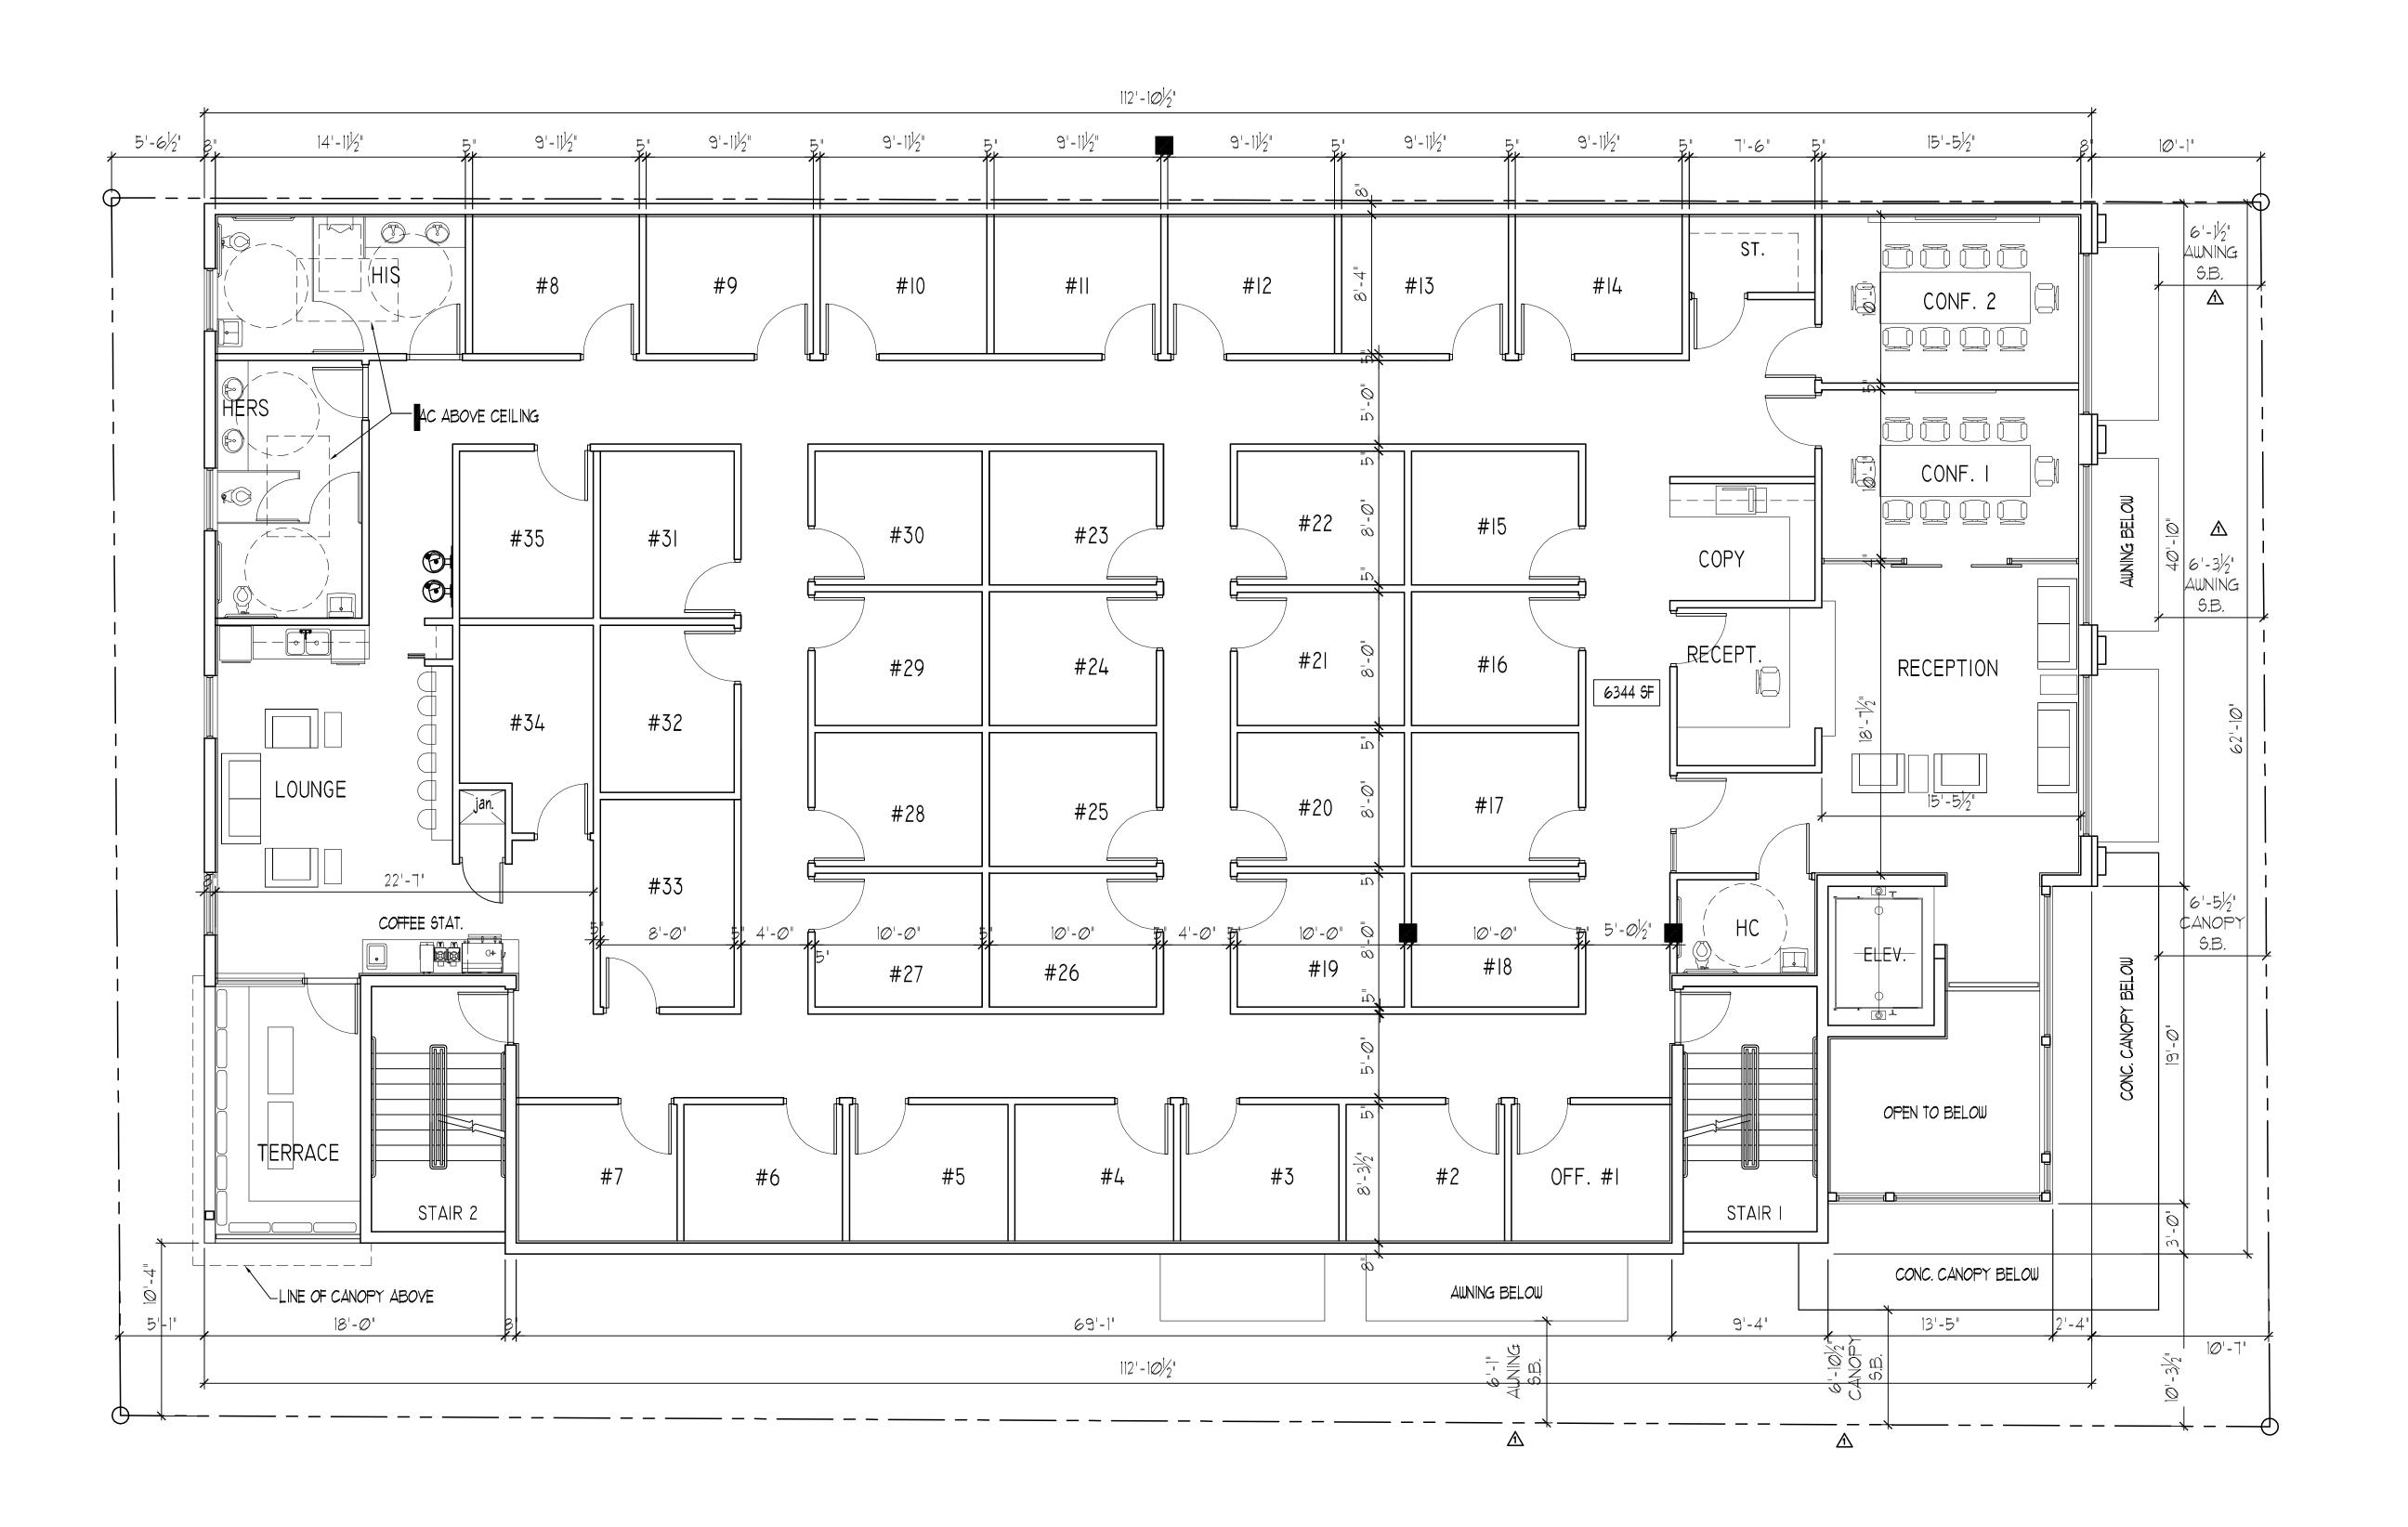

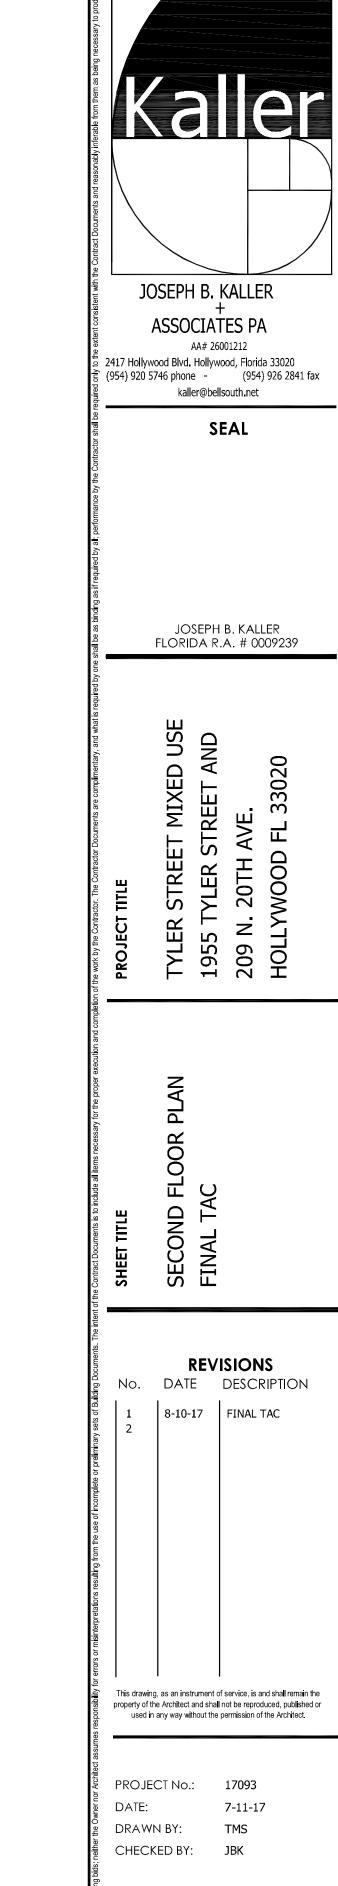


NORTH

SHEET

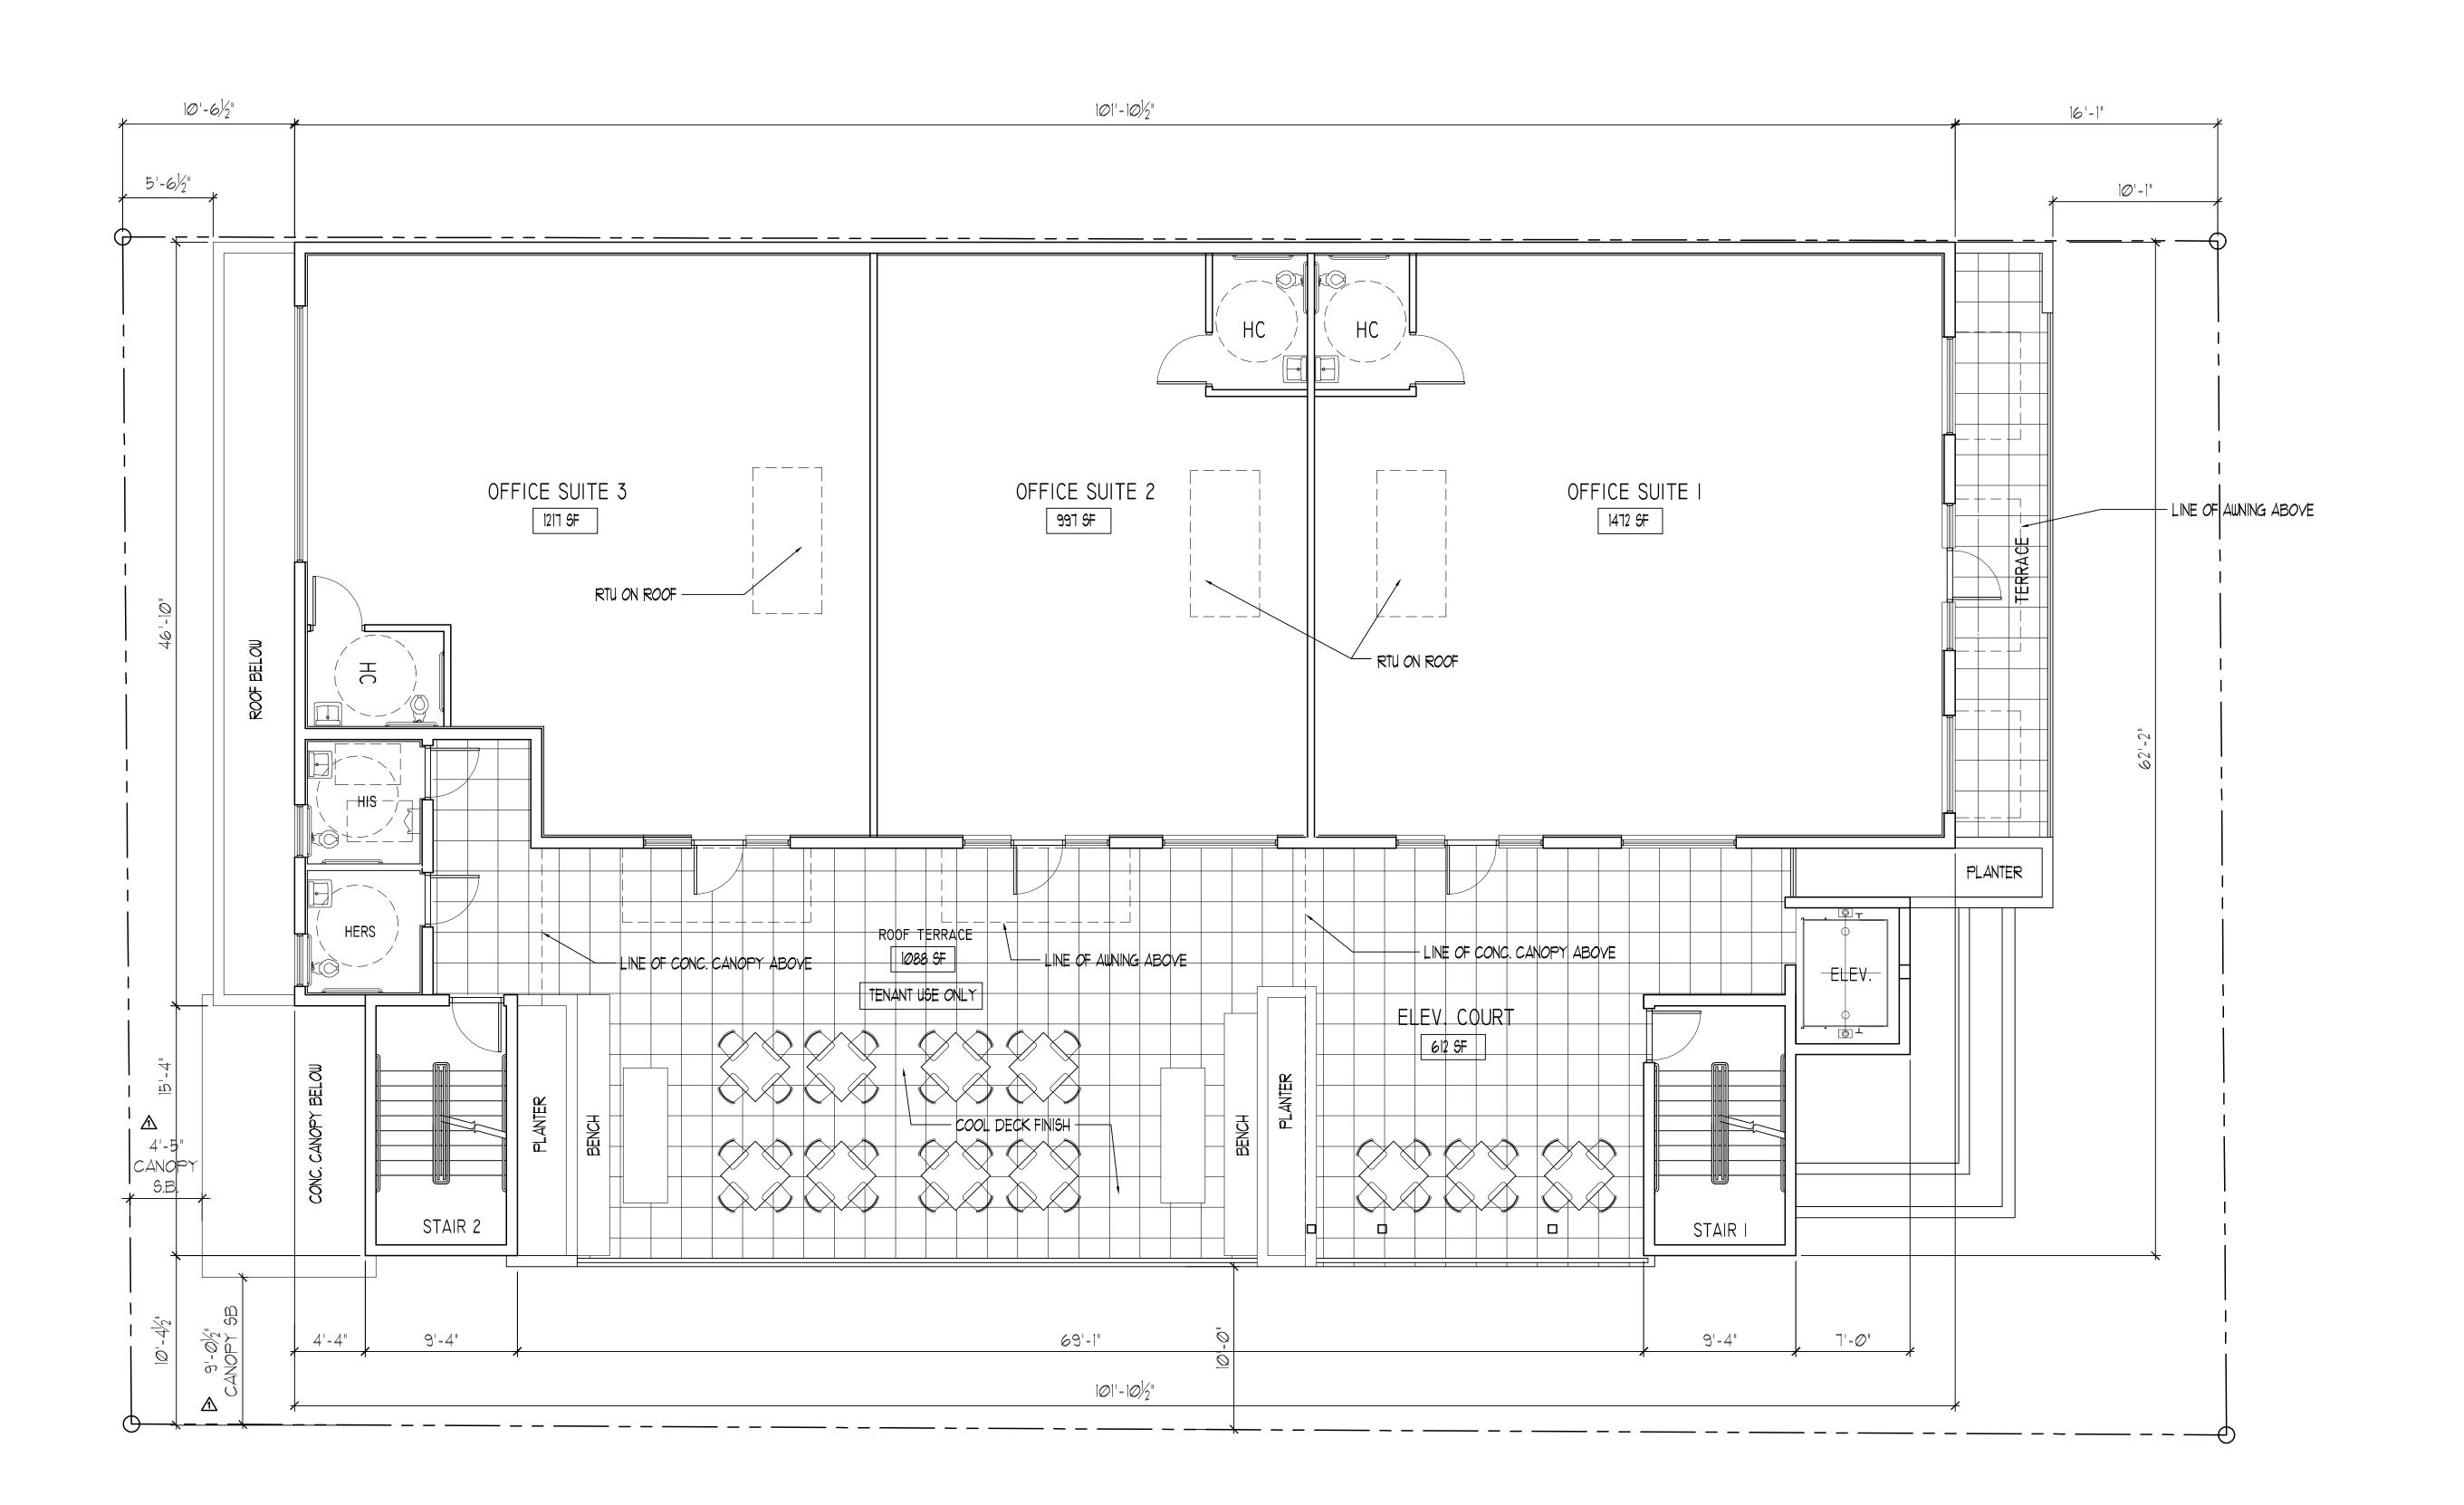



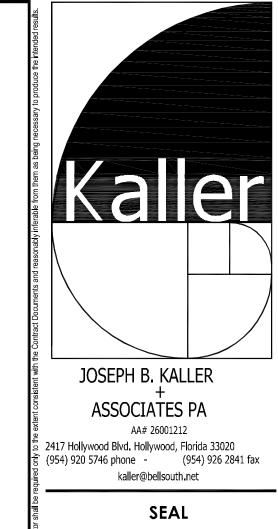

JOSEPH B. KALLER FLORIDA R.A. # 0009239

LER STREET MIXED USE 55 TYLER STREET AND 9 N. 20TH AVE.

THIRD FLOOR PLAN FINAL TAC

REVISIONS
No. DATE DESCRIPTION

1 8-10-17 PRELIM TAC

1 8-10-17 PRELIM TAC

This drawing, as an instrument of service, is and shall remain the property of the Architect and shall not be reproduced, published or used in any way without the permission of the Architect.

PROJECT No.: 17093


DATE: 7-11-17

DRAWN BY: TMS

CHECKED BY: JBK

SHEET

**A-3** 

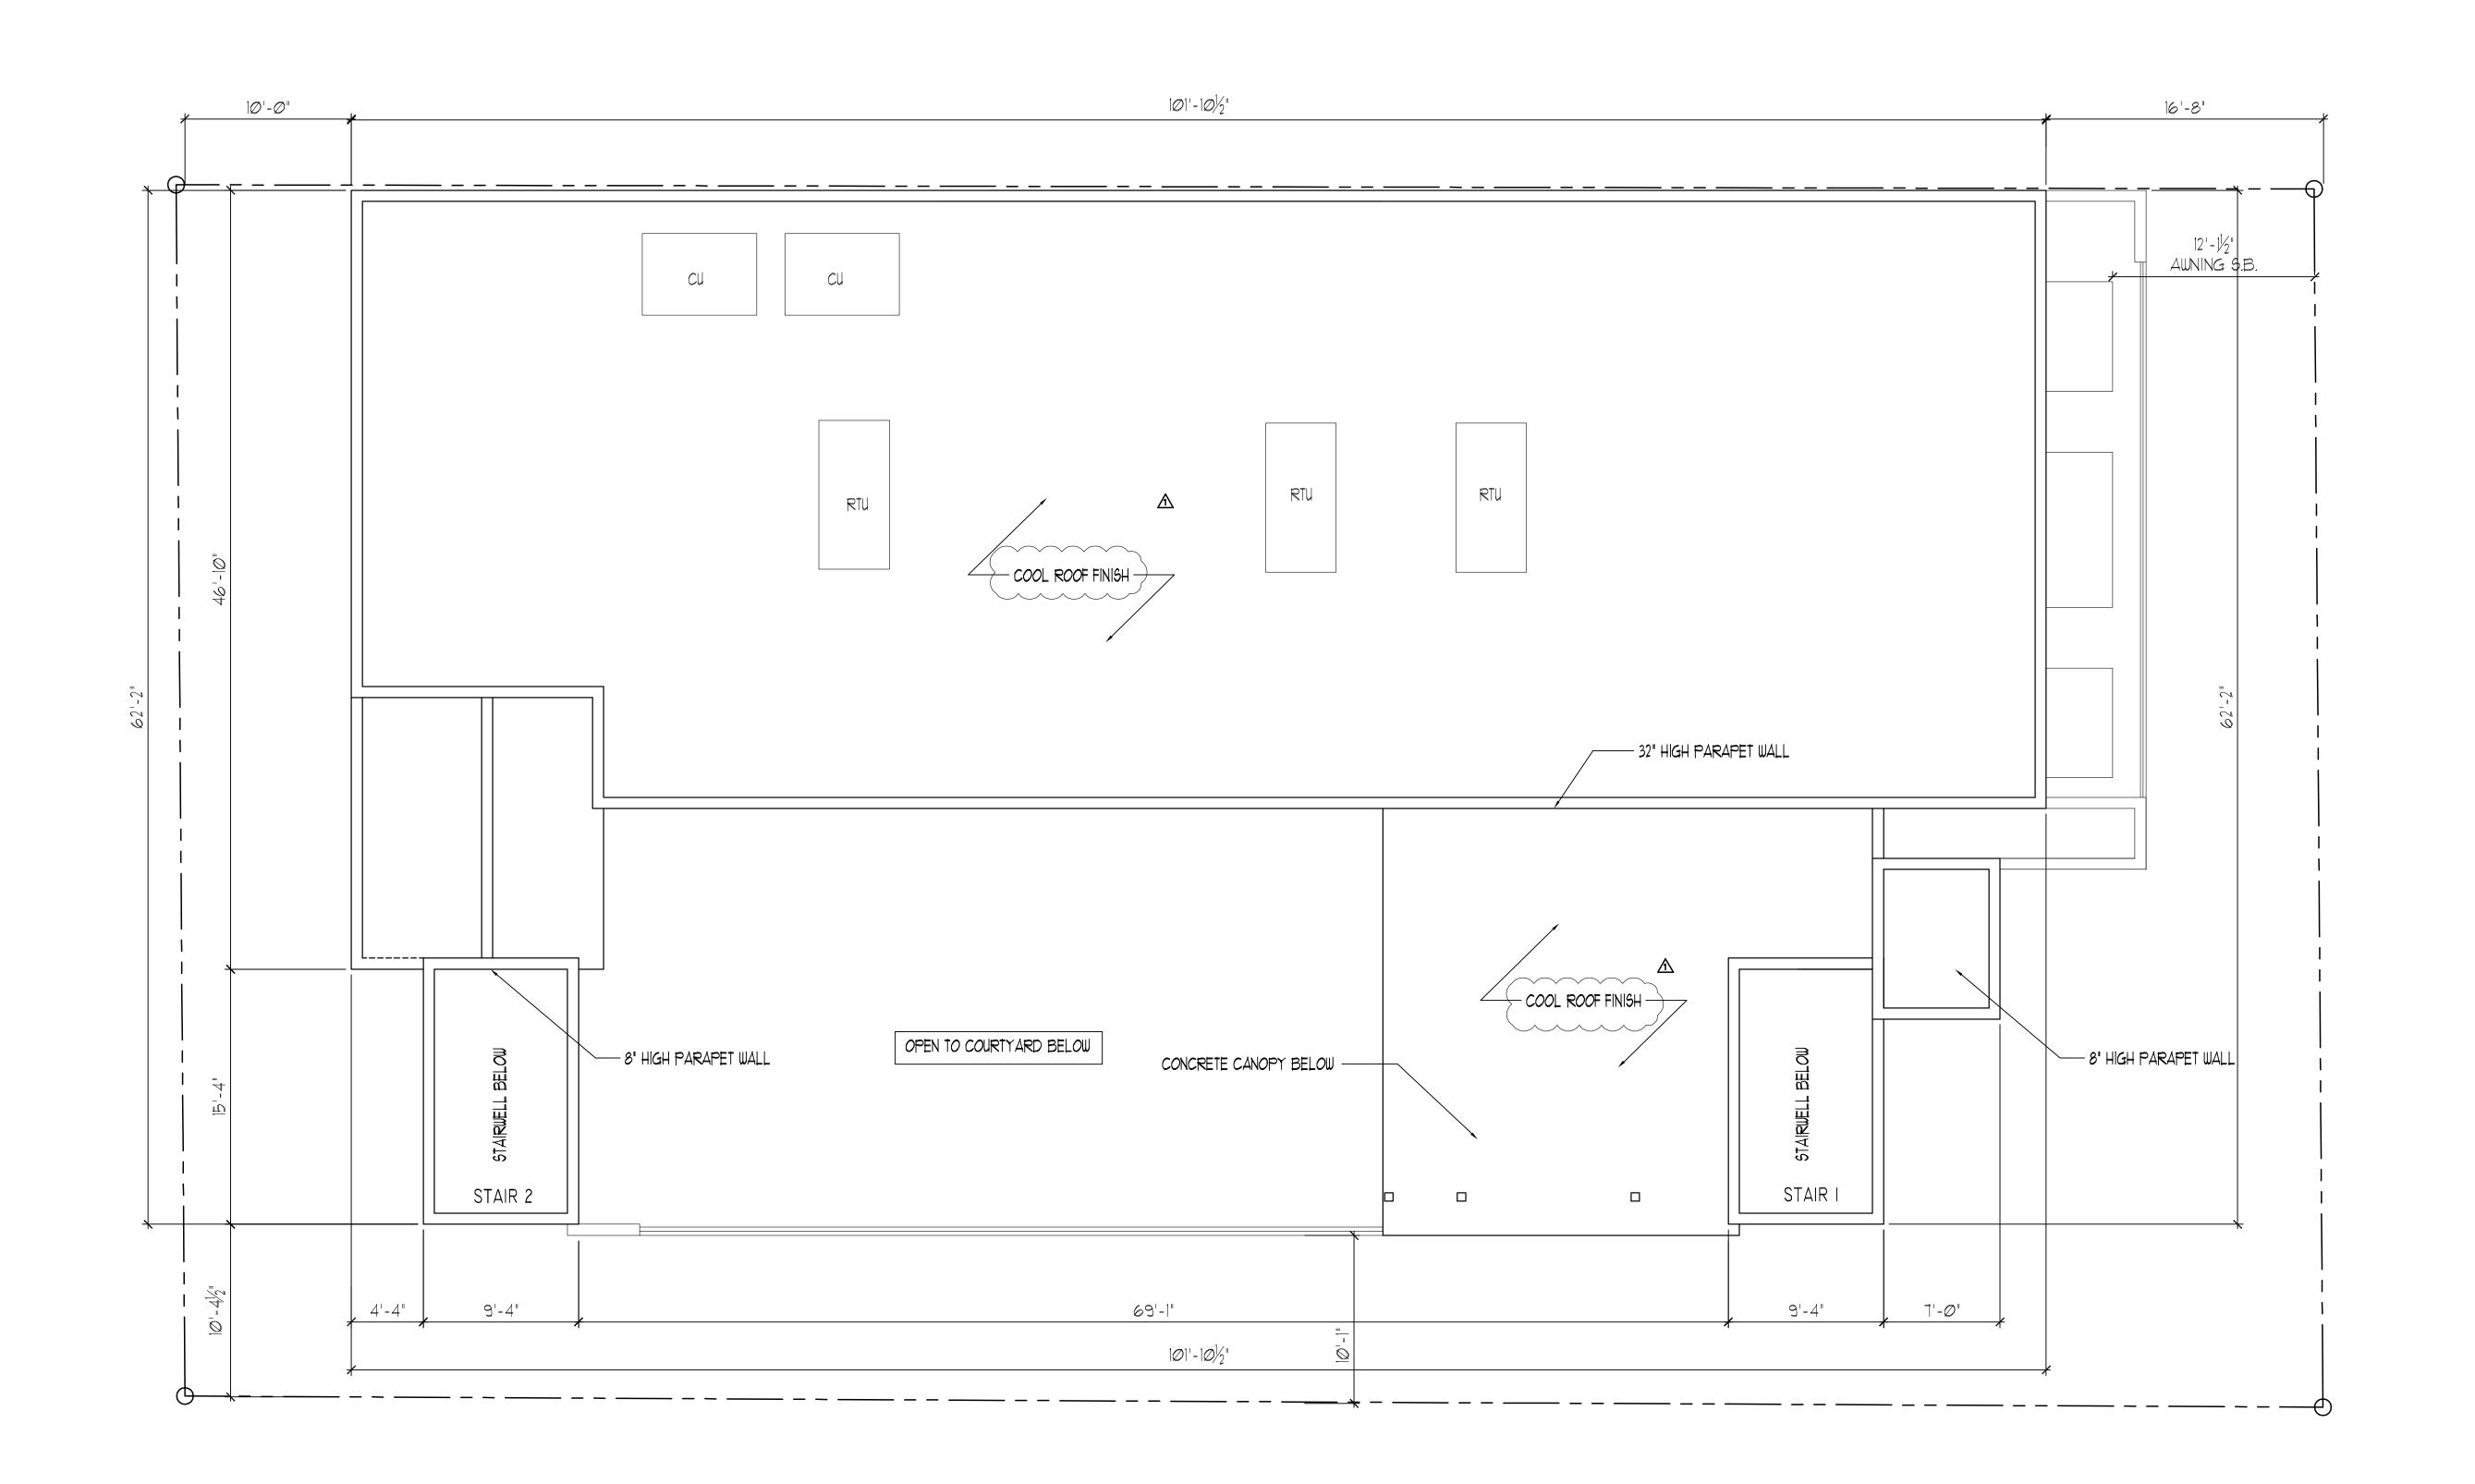



JOSEPH B. KALLER + ASSOCIATES PA AA# 26001212


2417 Hollywood Blvd. Hollywood, Florida 33020
(954) 920 5746 phone - (954) 926 2841 fax kaller@bellsouth.net SEAL JOSEPH B. KALLER FLORIDA R.A. # 0009239 TYLER STREET MIXED USE 1955 TYLER STREET AND 209 N. 20TH AVE. HOLLYWOOD FL 33020

**REVISIONS** No. DATE DESCRIPTION


This drawing, as an instrument of service, is and shall remain the property of the Architect and shall not be reproduced, published or used in any way without the permission of the Architect.

PROJECT No.: 17093 DATE: DRAWN BY: CHECKED BY: JBK

SHEET

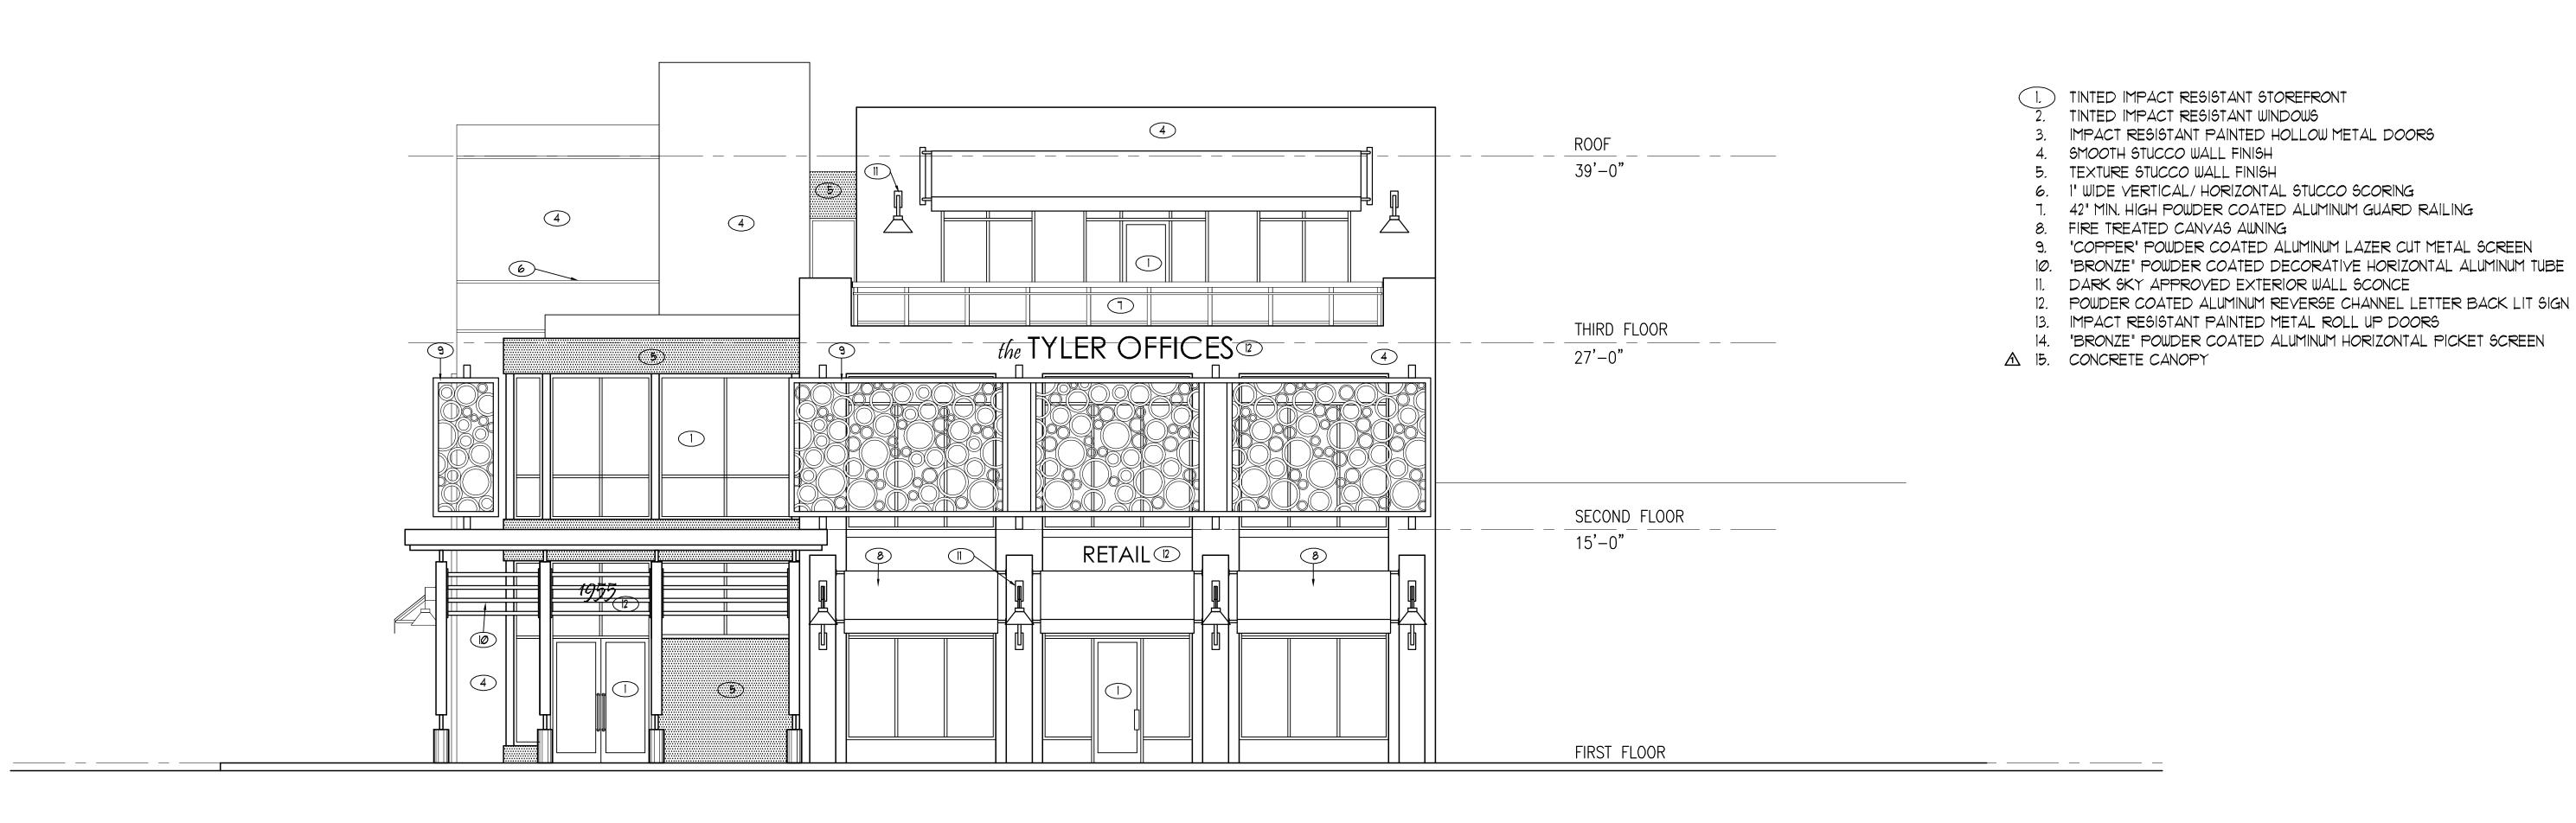


# **SOUTH ELEVATION**

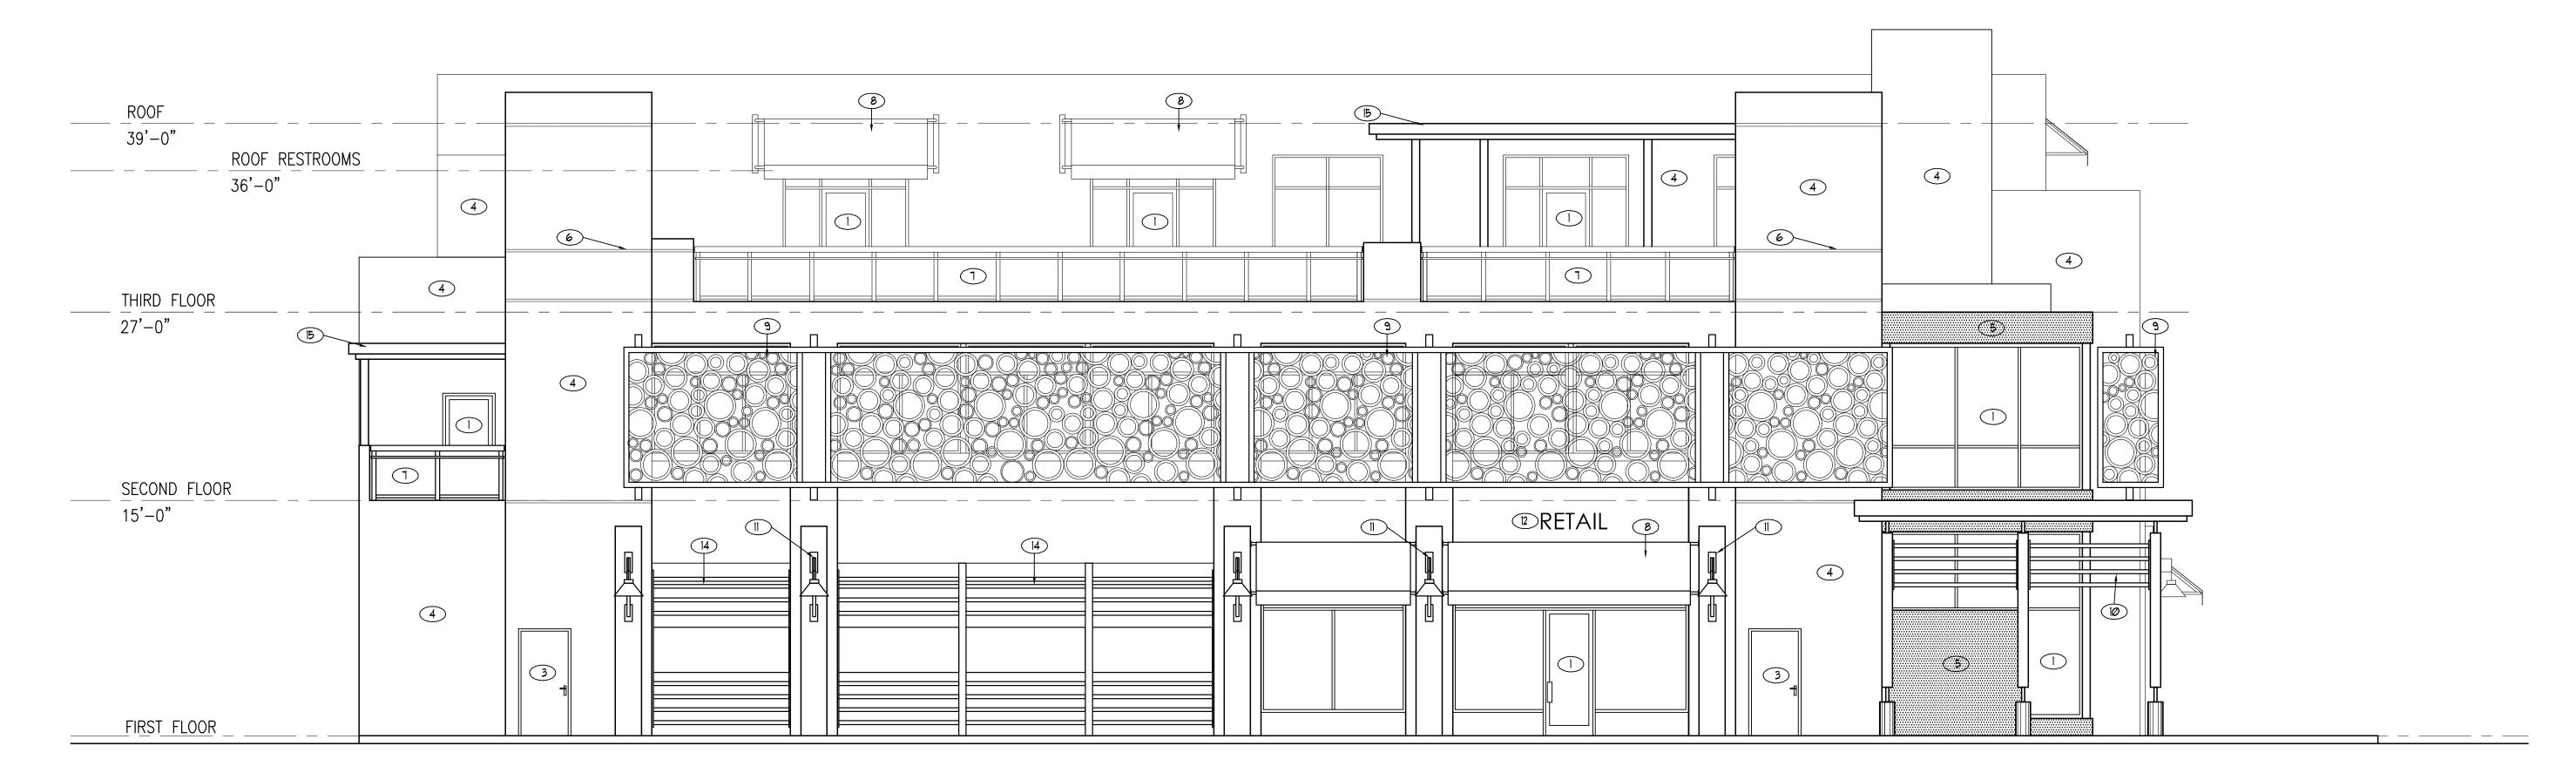

**WEST ELEVATION** 

ELEVATIONS
SCALE: 3/16"= 1'-0"

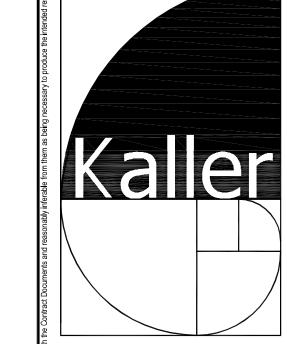

JOSEPH B. KALLER + ASSOCIATES PA AA# 26001212

2417 Hollywood Blvd. Hollywood, Florida 33020 (954) 920 5746 phone - (954) 926 2841 fax kaller@bellsouth.net

SEAL

JOSEPH B. KALLER FLORIDA R.A. # 0009239

TYLER STREET MIXED USE 1955 TYLER STREET HOLLYWOOD FL 33020

ELEVATIONS FINAL TAC

REVISIONS

No. DATE DESCRIPTION

1 2

This drawing, as an instrument of service, is and shall remain the property of the Architect and shall not be reproduced, published or used in any way without the permission of the Architect.

PROJECT No.: 17093


DATE: 7-11-17

DRAWN BY: TMS


CHECKED BY: JBK

SHEET

**A-5** 

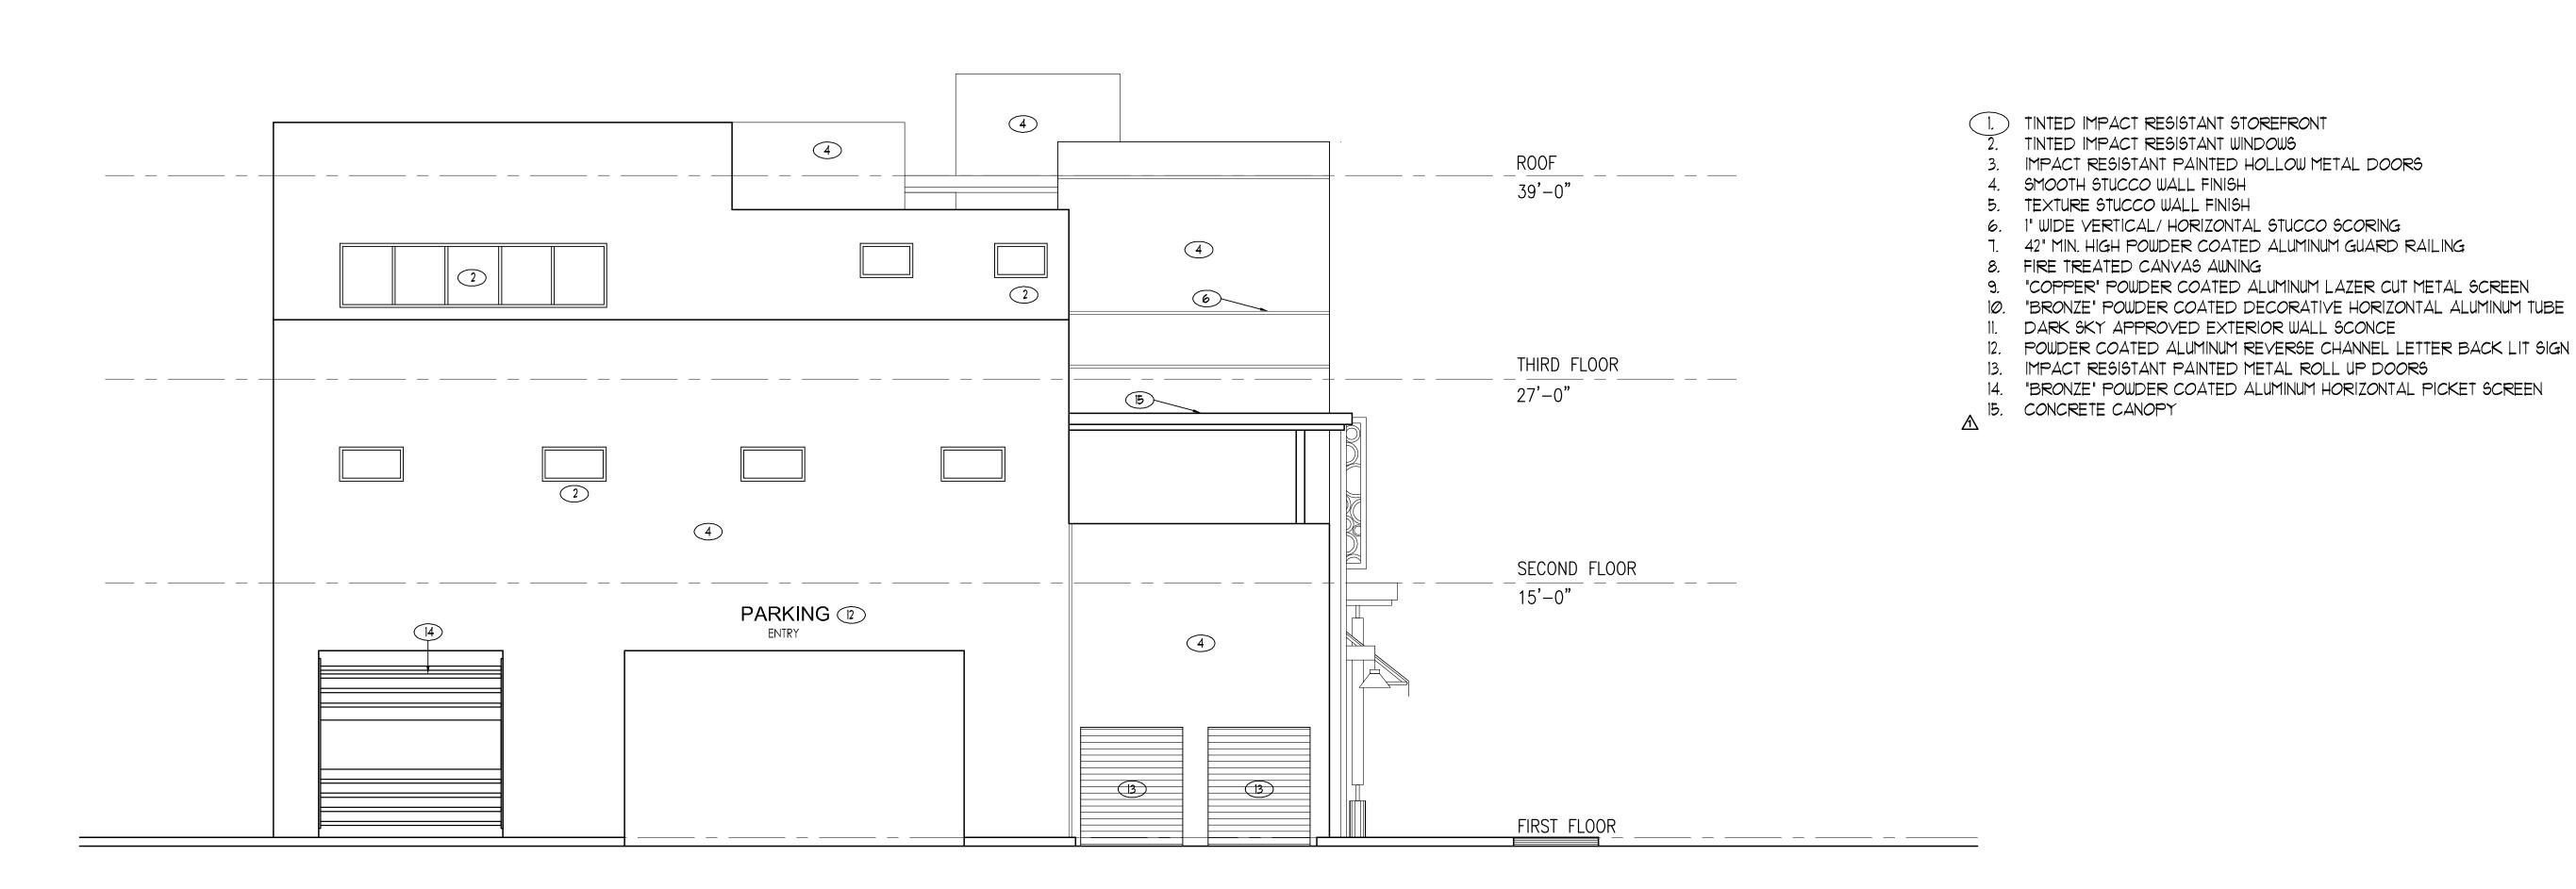

# **NORTH ELEVATION**

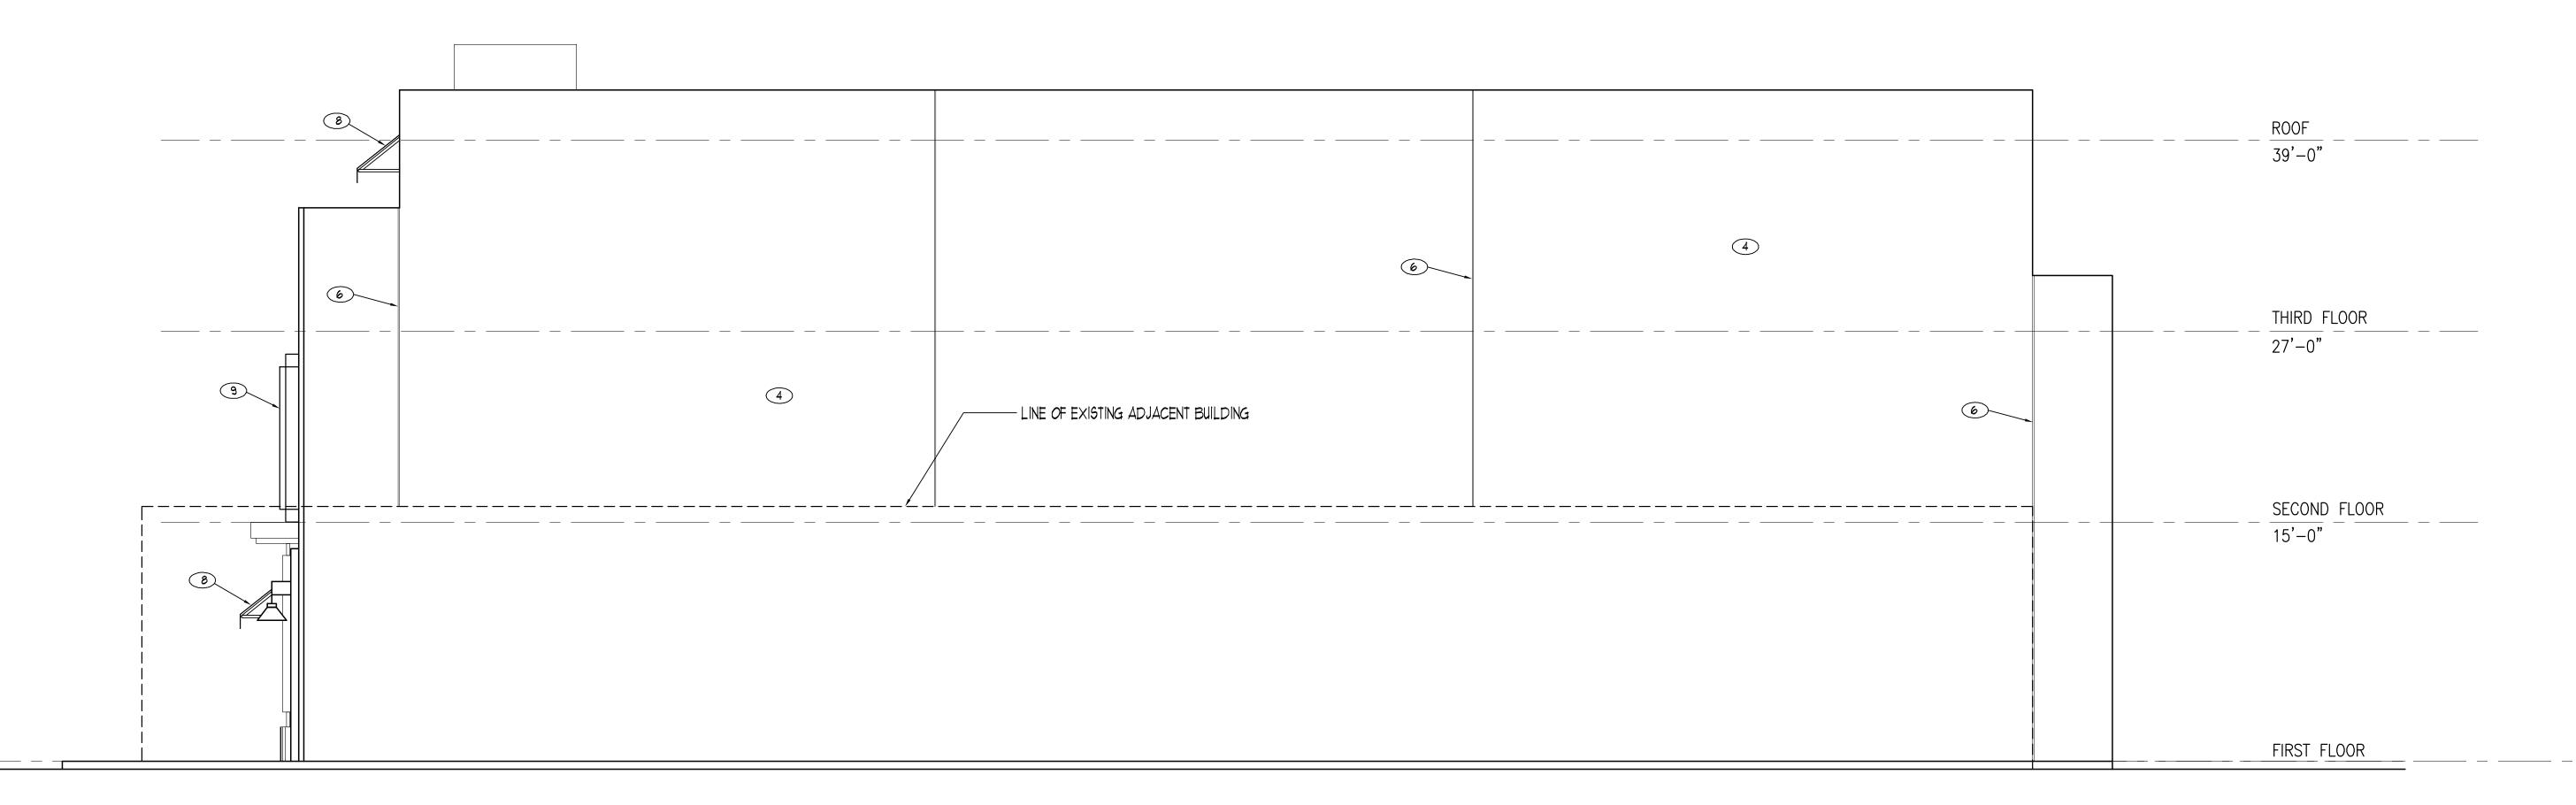

# **EAST ELEVATION**

ELEVATIONS
SCALE: 3/16"= 1'-0"

JOSEPH B. KALLER

ASSOCIATES PA

AA# 26001212 2417 Hollywood Blvd. Hollywood, Florida 33020 (954) 920 5746 phone - (954) 926 2841 fax kaller@bellsouth.net

SEAL

JOSEPH B. KALLER FLORIDA R.A. # 0009239


TYLER STREET MIXED USE 1955 TYLER STREET AND HOLLYWOOD FL 33020 209 N. 20TH AVE.

No. DATE DESCRIPTION This drawing, as an instrument of service, is and shall remain the


**REVISIONS** 

property of the Architect and shall not be reproduced, published or used in any way without the permission of the Architect.

PROJECT No.: 17093 DRAWN BY: CHECKED BY:

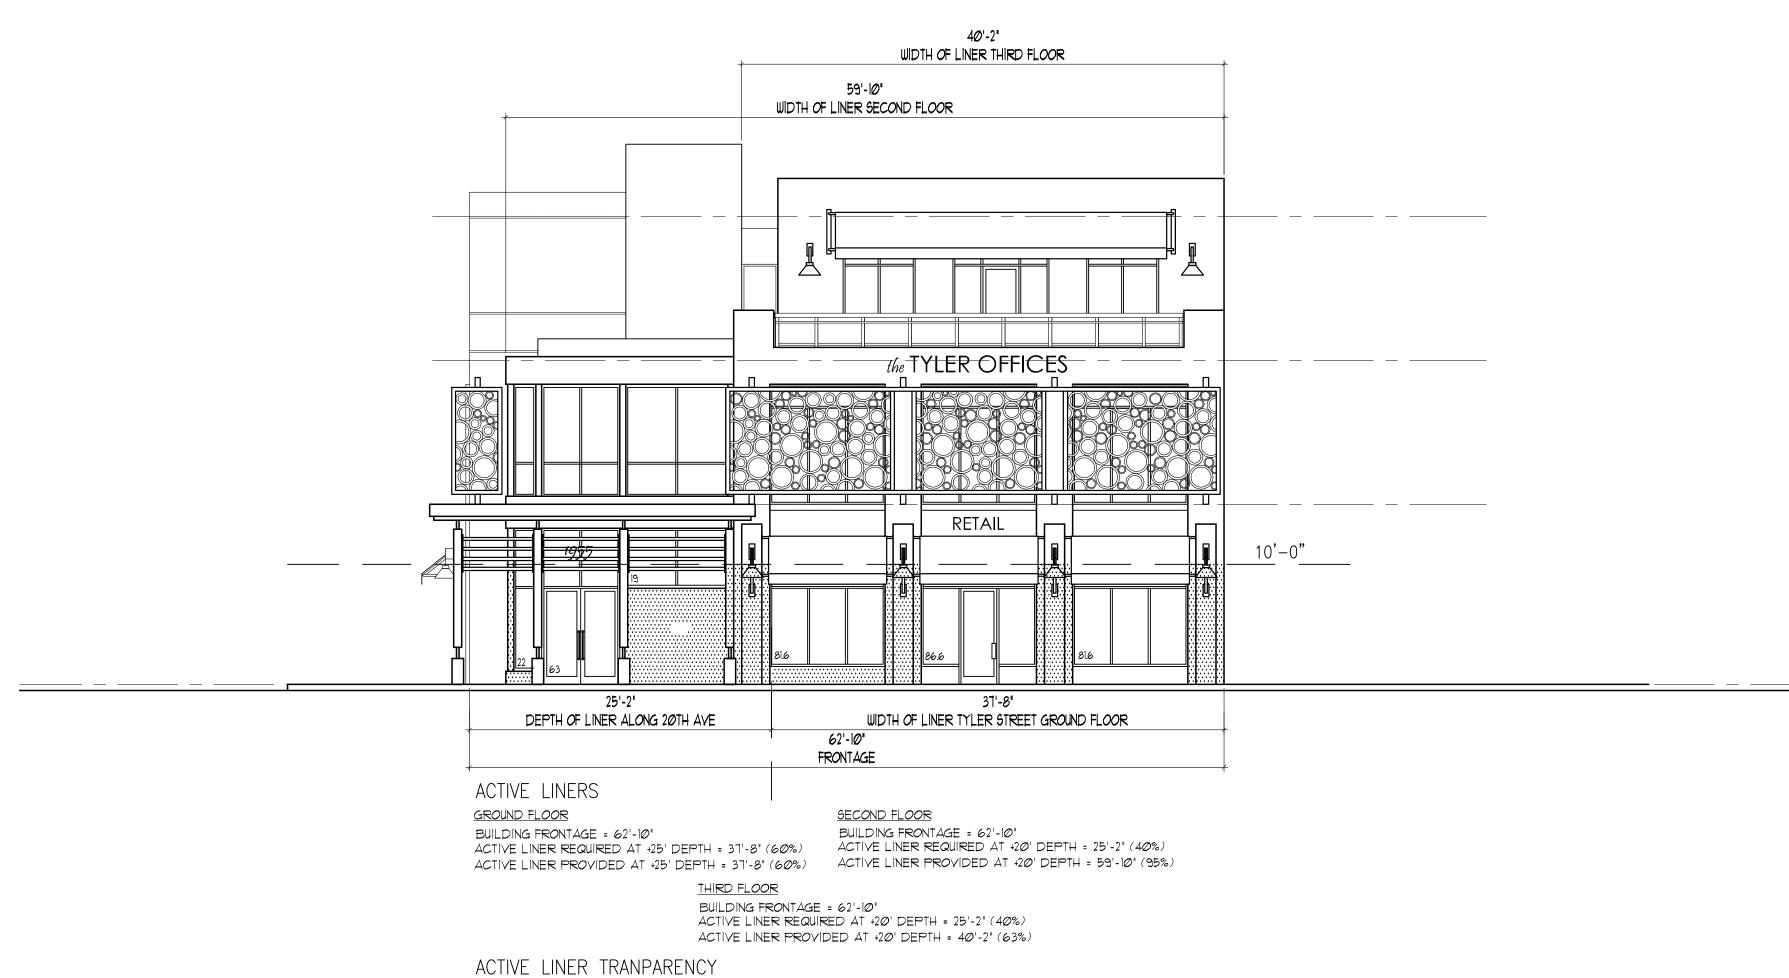

# **SOUTH ELEVATION**

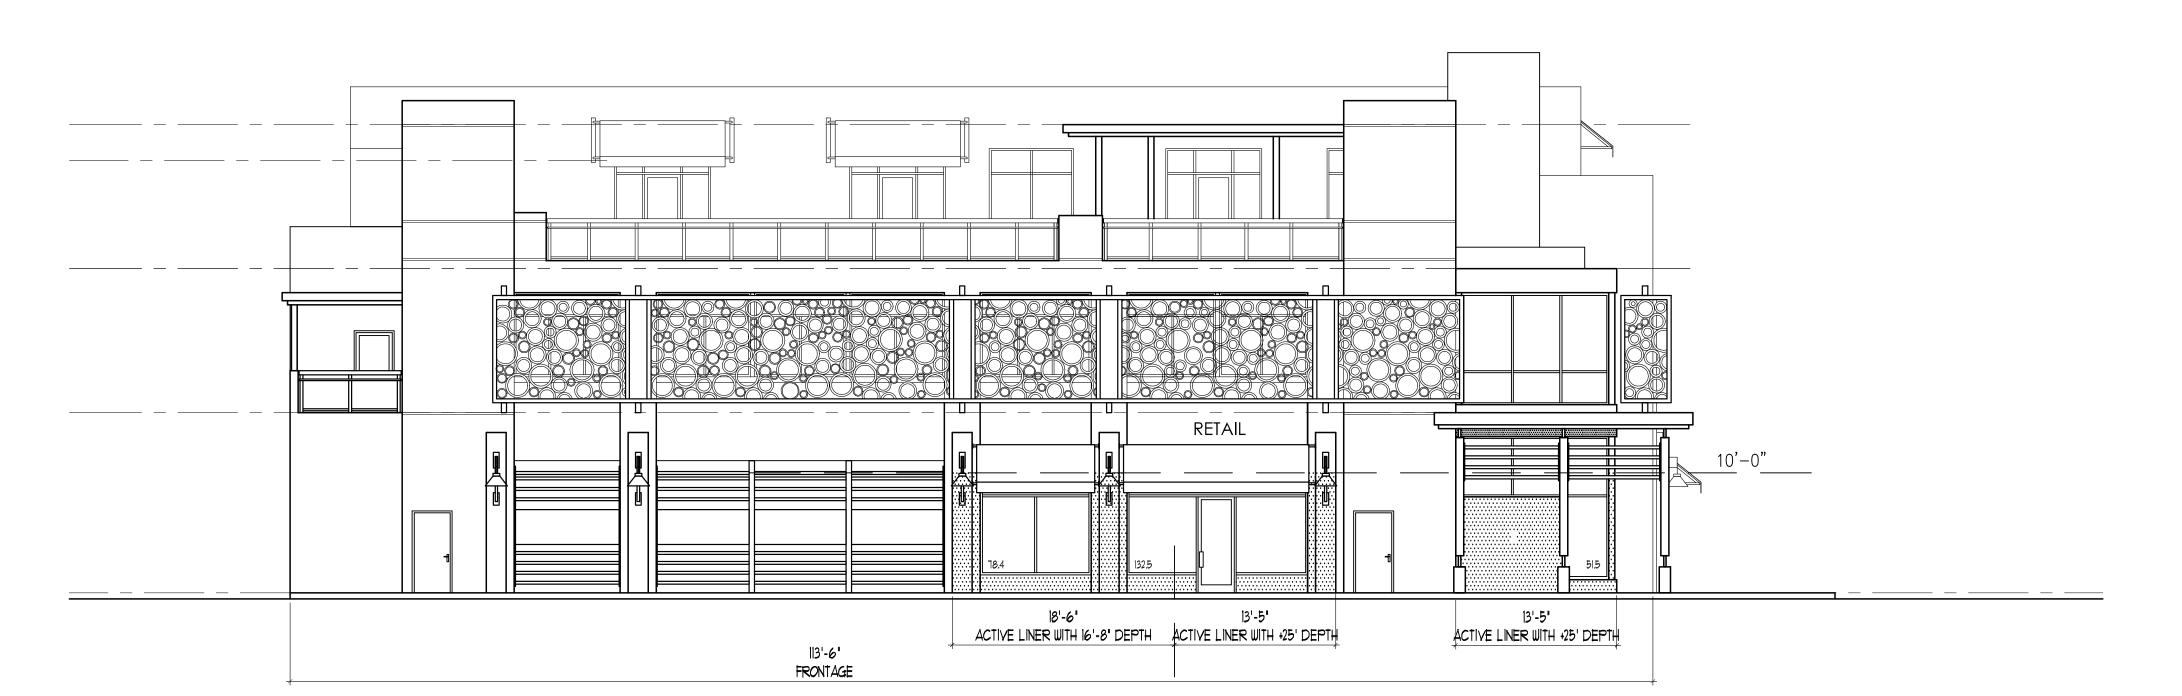

ACTIVE LINERS

COMMERCIAL ACTIVE LINER AREA = 650.5 S.F. TRANSPARENCY REQUIRED = 325.25 S.F. (50%) TRANSPARENCY PROVIDED = 353.8 S.F. (54.4%)

BUILDING FRONTAGE = 113'-6"

ACTIVE LINER REQUIRED = 45'-4" (40%)

ACTIVE LINER PROVIDED AT +25' DEPTH = 26'-10" (23.7%)

ACTIVE LINER PROVIDED AT +15' DEPTH = 18'-6" (16.3%)

45'-4" (40.0%)

WEST ELEVATION

ACTIVE LINER TRANPARENCY

COMMERCIAL ACTIVE LINER AREA = 483 S.F.

TRANSPARENCY REQUIRED = 241.5 S.F. (50%)

TRANSPARENCY PROVIDED = 262.4 S.F. (54.3%)

ELEVATIONS
SCALE: 1/8"= 1'-0"

JOSEPH B. KALLER

ASSOCIATES PA

AA# 26001212

2417 Hollywood Blvd. Hollywood, Florida 33020
(954) 920 5746 phone - (954) 926 2841 fax kaller@bellsouth.net

SEAL

JOSEPH B. KALLER FLORIDA R.A. # 0009239

TYLER STREET MIXED USE 1955 TYLER STREET HOLLYWOOD FL 33020

ACTIVE LINERS FINAL TAC

REVISIONS
No. DATE DESCRIPTION

1
2

This drawing, as an instrument of service, is and shall remain the property of the Architect and shall not be reproduced, published or used in any way without the permission of the Architect.

PROJECT No.: 17093

DATE: 7-11-17

DRAWN BY: TMS

CHECKED BY: JBK

SHEET

**A-7** 



