#### CITY OF HOLLYWOOD, FLORIDA INTER-OFFICE MEMORANDUM DEPARTMENT OF DEVELOPMENT SERVICES PLANNING DIVISION

DATE:

April 13, 2017

FILE NO.: P-17-09

TO:

Planning and Development Board

VIA:

Leslie A. Del Monte, Planning Manager

FROM:

Jean-Paul W. Perez, Planning Administrator \rangle

SUBJECT:

Continued item from the February 9, 2017, meeting (16-DPV-49)

#### **EXPLANATION:**

Due to the Board's concern with particular design decisions of the proposed of the mixed-use building located in the Commercial Beach Resort District (BRT-25-C), on February 8, 2017, the Applicant requested the item be continued which was granted by the Planning and Development Board ("Board") unanimously; and, to be heard at the April 13, 2017 Board meeting. Attached you will find the revised submittal package which includes amended drawings, a narrative, and the original packets.

Staff finds the proposed design to be incompatible with the characteristic of the neighborhood. Additionally, the proposed design is not cohesive, and does not establish a relationship between the functionality and aesthetics of the structure. As such, *Staff recommends continuance*.

#### **RECOMMENDATION:**

Variances 1-3:

Continuance.

Design:

Continuance.

Site Plan:

Continuance.


#### **ATTACHMENTS:**

Attachment I:

Revised Submittal Package

Attachment II:

Planning and Development Board Package

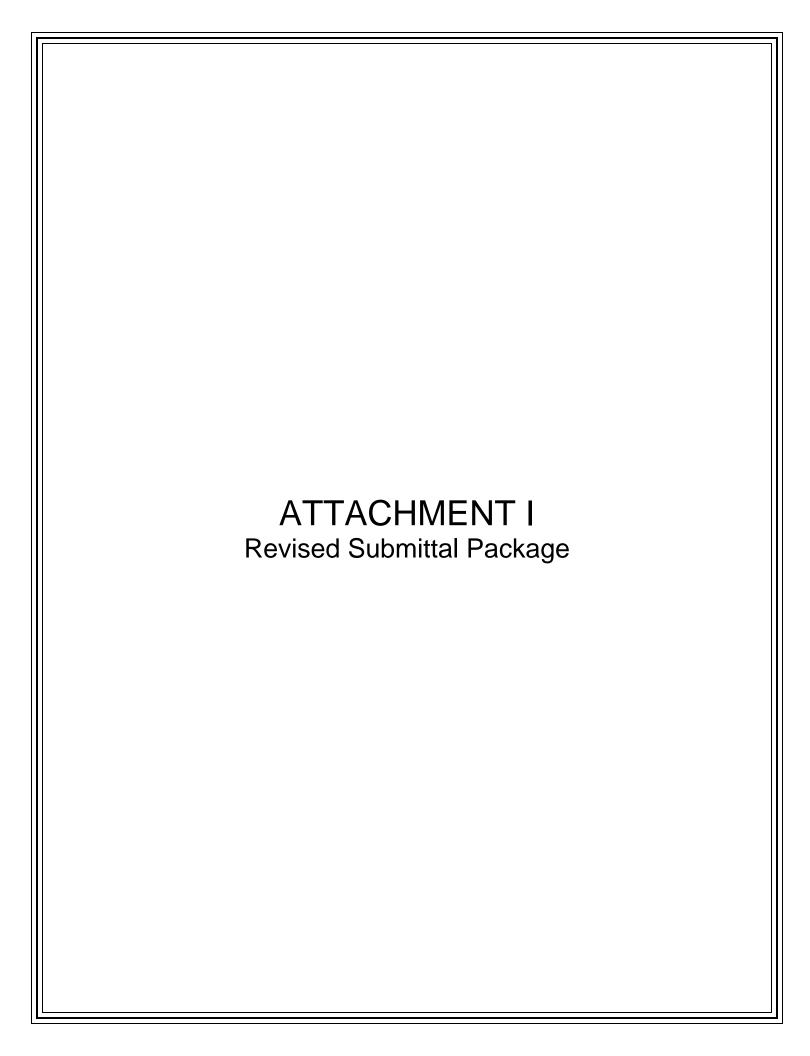

THE BLUE BUILDING
Project Revision Narrative
3-01st. 2017
Page 1 of 2

## **VEE**architecture corp.

#### VICTOR ELIAS EISENSTEIN, AIA, RA, USGBC ARCHITECT

Project management, Planning, Quality Control, Residential, Commercial, Hotel, Bar, Restaurant, Retail, Healthcare www.veearch.com

State of Florida business license AA26001709 State of Florida registered Architect AR92121

1111 Park Centre Blvd. suite 105-B, Miami Gardens, Fla. 33169 ph:305-625-0007 cell:786-229-1318 victor@veearch.com

Professional registrations

The council of Engineers and Architects of the State of Israel.- #41149
The National Board of Architects of the Republic of Colombia.- #1258
The DBPR State of Florida, Board of Architecture.- #AR92121
State of Florida Business License #AA26001709
Miami-Dade County Small Business Development #12911
Miami-Dade County Public Schools #6518331
Miami-Dade County Community Business Enterprise
CBE cat. 14 Architecture
CBE cat. 18 Architectural construction management



March 1st, 2017

To:

City of Hollywood Planning & Development Board

2600 Hollywood Boulevard, Room 419

Hollywood, Fla. 33022

CBE cat. 4(4-02) Aviation systems

#### REF: DEVELOPMENT BOARD REVISION NARRATIVE

The Blue Building 320-324 Minnesota Street, Hollywood, Fla. 33019

#### **BOARD MEMBERS OVERALL COMMENTS**

Pertinent to the February 9th. 2017 Board Submittal meeting, The Development Board found The Blue Building to be too square in nature with a conflictive Architectural design lacking facades with shadows, eye-lids, balconies and/or other distinctive elements from all 4 angles of the building. Also, a second concern was the minimal use of building materials, textures and finishes with an over all excessive implementation of the color Blue.

#### THE REVISED BUILDING APPEARENCE

In order to accomplish a uniformed project and comply with the Board comments, the following revisions were made to the exterior facades of the building:

#### To address the square/box appearance of the building:

Incorporated design lines with a more "modernistic" intent featuring an attractive center
piece that is spherical in shape that protrudes from the middle of the front facade which
is impressive, has volumetric elements, shadows and constructed from added balconies
protruding from the glass facade of the building facing Minnesota Street. This feature not

THE BLUE BUILDING
Project Revision Narrative
3-01st. 2017
Page 2 of 2

only gives the building shadows, depth and volume movement but has also given us the ability to eliminate a previous requested variance.

- The compliance with the required 10'-0" front yard with no building extensions overhanging over the front-yard and except, for balconies that are allowed 25% = 2'-6" overhang therefore, eliminating the previous Variance requested
- The incorporation of distinctive modeled elements within the side and rear facades of the building, creating visual attention of artistic interest including a moon shaped cut out on the west side facade with uneven elevations to give volumetric movement and optical illusion of height changes on the west side of the building.
- Pop out windows from the hotel and office floors to give depth and shadows on the East side façade.
- Increased use of glass on the building to give a more modern feel on the front elevation, east side elevation and rear elevation of the building with an attractive view of the automated parking system at work. This element provides an added depth to the building due to its openness to the inside elements.

#### To address the Color concerns of the project:

- Coordinated the use of different materials based on the previously approved color palette, featuring a range of tone colors from intensive Blue grading down to White, dark grey and Black on all 4 sides of the Building including but not limited to:
  - i. exposed smooth concrete;
  - ii. different color glass windows;
  - iii. aluminum reflective panels;
  - iv. stainless steel bands;
  - v. smooth and textured stucco finish,
  - vi. LEED accent illumination features.

#### **END OF PROJECT DESCIPTION**

With great respect to the members of the Development Review Board (DRB) and the criteria used for the requested approval and based on my responsive support description of all pertinent issues to this project, I remain confident to receive your fair and balanced decision that will allow the continuation with the development of this project.

Thank you for your attention, Sincerely.

VEEarchitecture corp

VICTOR ELIAS EISENSTEIN, AIA / RA / USGBC

A R C H I T E C


1111 Park Centre Blvd, suite 105-B

Miami Gardens, Fla. 33169

ph: 305-625-0007 cell: 786-229-1318

ph: 305-625-0007 cell: 786-229-1318 victor@veearch.com www.veearch.com

# The Blue Building Executive Hotel Suite and Office

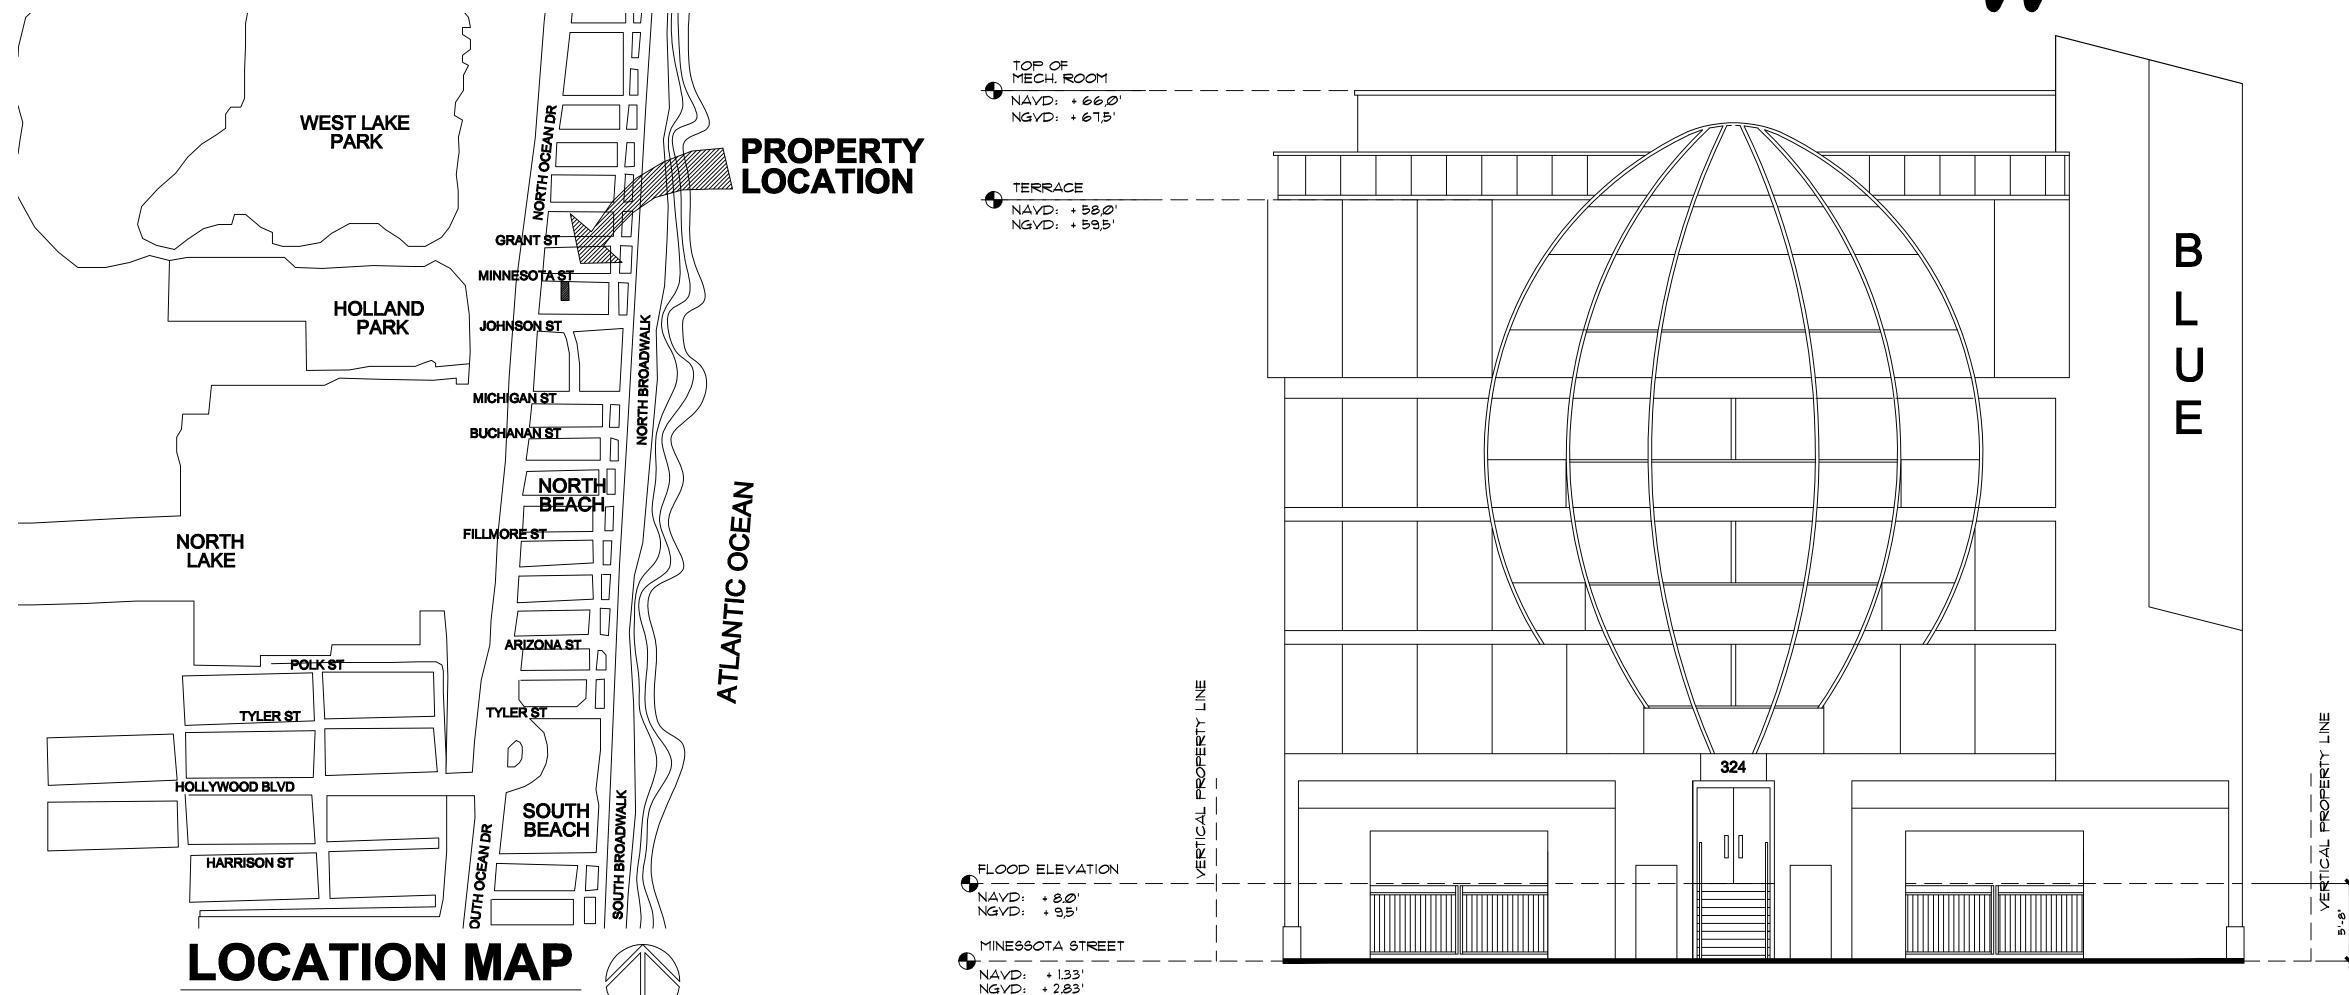

#### **INDEX OF DRAWINGS**

#### ARCHITECTURE

A-CP INDEX OF DRAWINGS
COVER PAGE AND CONTACT LIST
LOCATION MAP

ALTA SURVEY
LEGAL DESCRIPTION

111 SCHEDULE OF AREAS

SITE PLAN

A-02 PROJECT CODE COMPLIANCE

GREEN BUILDING PRACTICES FIRE HYDRANTS LOCATION

A-1 PROJECT GENERAL DESCRIPTION BASE FLOOD ELEVATION

GROUND FLOOR MAIN ACCESS
MAIN ENTRANCE ADA ACCESSIBLE PATH
ADA VERTICAL LIFT DETAIL

A-3 STREET FEATURES VISUAL TRIANGLE

4-4 SECOND FLOOR PLAN
HANDICAPPED HOTEL ROOM DISTRIBUTION
SKY-TOWER PARKING

A-4-1

ADA COMPLIANT HOTEL ROOM TYPE 'B'
WALL REINFORCEMENT AND HEIGHT INSTALL.

THIRD AND FOURTH FLOORS PLAN
HOTEL ROOM DISTRIBUTION

SKY-TOWER PARKING

FIFTH FLOOR PLAN
OFFICE PLAN LAYOUT DISTRIBUTION

SKY-TOWER PARKING

A-7

TERRACE FLOOR PLAN

SKY-PARKING MECHANICAL EQUIPMENT ROOM

A-8 BUILDING ROOF PLAN

4-9 BUILDING ELEVATIONS SIGNAGE DESIGN CRITERIA

A-10 BUILDING ELEVATIONS

STREET PROFILE

A\_11 BUILDING SECTIONS A-A AND B-B

SKY-PARKING SECURITY NOTES PARKING PODIUM VEHICULE COUNT

A-12 SITE GRADING PLAN
PERIMETER FENCE ELEVATION AND DETAILS
ACTIVE USE FRONT ELEVATION

A-13 GROUND FLOOR PERVIOUS AREAS TERRACE FLOOR PERVIOUS AREAS

**A-14** GROUND FLOOR PERVIOUS AREAS TERRACE FLOOR PERVIOUS AREAS PERVIOUS AREAS CALCULATIONS

A-15 COLOR PHOTOGRAPS OF EXISTING PROPERTY AND ADJACENT STRUCTURE

#### **CIVIL ENGINEERING**

CS-1 COVER PAGE

E-1 CONCEPTUAL ENGINEERING PLAN

CD-1 CONCEPTUAL ENGINEERING DETAILS

CD-2 CONCEPTUAL ENGINEERING DETAILS

CD-3 CONCEPTUAL ENGINEERING DETAILS

CD-4 CONCEPTUAL ENGINEERING DETAILS

HYDRANT FLOW TEST

#### **LANDSCAPE**

TERRACE FLOOR PLAN GROUND FLOOR PLAN

#### VARIANCES

1.- WEST SIDE ACCESS TO BUILDING FROM THE 5'-0" WIDE SIDE-YARD FEATURING A PAYED SERVICE PASSAGE

2.- STREET CURB-CUT EXCEEDS 30% OF LOT FRONTAGE

### LIST OF CONTACTS

**NOT TO SCALE** 

#### ARCHITECT OF RECORD

VEE ARCHITECTURE CORP VICTOR ELIAS EISENSTEIN, AIA, RA, USGBC

1111 PARK CENTRE BLVD.
SUITE 105-B
MIAMI GARDENS, FLA. 33169
OFFICE: 305-625-0007
CELL: 786-229-1318
VICTOR@VEEARCH.COM

#### **OWNER**

DR. AYLEE HALLAK

101 NE 162 STREET

NORTH MIAMI BEACH, FLA. 33162

AYLEEHALLAK@HOTMAIL.COM

#### MECHANICAL ENGINEER

CT. ENGINEERING INC CARLOS TILLAN, P.E.

11214 SW. 156 PLACE MIAMI, FLA. 33196 305-527-9041 TILLAN31@YAHOO.COM

#### STRUCTURAL ENGINEER

ASD CONSULTANT ENGINEERING FERNANDO AZCUE, PE

7320 SW 142 PLACE MIAMI, FLA. 33177 786-351-3663 FAZCUE@ASDCONSENG.COM

#### LANDSCAPE ARCHITECT

BOTANICAL VISIONS INC. WILLIAM REEVE

4651 NORTH DIXIE HIGHWAY BOCA RATON, FLA. 33431 561-361-6677 954-253-8704 CELL WREEVE@BOTANICALVISIONS.COM

#### **CIVIL ENGINEER**

HSQ GROUP INC.
NOUR SHEHADEH, PE
JAY HUEBNER, PE

1489 W. PALMETTO PARK ROAD SUITE 340 BOCA RATON, FLA. 33486 561-392-0221 NOUR@HSQGROUP.NET JAY@HSQGROUP.NET

#### CITY OF HOLLYWOOD, FLA

CITY HALL
2600 HOLLYWOOD BLVD.
SUITE 320
HOLLYWOOD, FLA. 33486
BLDGINFO@HOLLYWOODFL.ORG

911

WATER SERVICE 954-921-3241
REQUEST INSPECTION 954-921-3335
PUBLIC WORKS 954-967-4526
FIRE RESCUE 954-967-4248
POLICE 954-967-4357

**EMERGENCY** 

VICTOR ELIAS EISENSTEIN, ALA
ARCHITECTURE
PROJECT MANAGEMENT, PLANNING, GUALITY CONTROL
VICTOR@VEEARCH.COM

1111 PARK CENTRE BLVD #105-B MIAMI GARDENS, FLA. 33169

fice: 305-625-0007 cell: 786-229-1318

ILDING AND OFFICE

**BU** SUITE

THE BL EXECUTIVE H

TAC & PDB

DEVELOPMENT BOARD

**SUBMITTAL** 

2-27-2017

PROJECT No:

NATALIE F

PAGE No:

AS INDICATED

CHECKED BY:

OTA FLA

OF FLA 33139

Office: 305-625-0007 cell: 786-229-1

OF FLA 35139

OF FLA

SEAL: VICTOR ELIAS EISENSTEIN

IE BLUE BUILDING
CUTIVE HOTEL SUITE AND OFFICE
320-324 MINNESOTA STREET
HOLLYWOOD, FLA. 33019

REVISIONS:

TAC & PDB

JBMITTAL:

DEVELOPMENT
BOARD
SUBMITTAL

CALE:

AS INDICATED

2-27-2017
PROJECT No:

DRAWN BY: CHECKED BY:
NATALIE P. VEE

PAGE No:

A-CP1








**REAR AND WEST SIDE ELEVATION** 



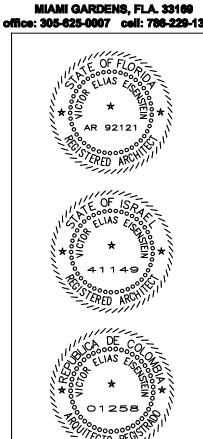


320-324 MINNESOTA HOLLYWOOD, FLA.

TAC & PDB

DEVELOPMENT BOARD SUBMITTAL

AS INDICATED

PROJECT No:

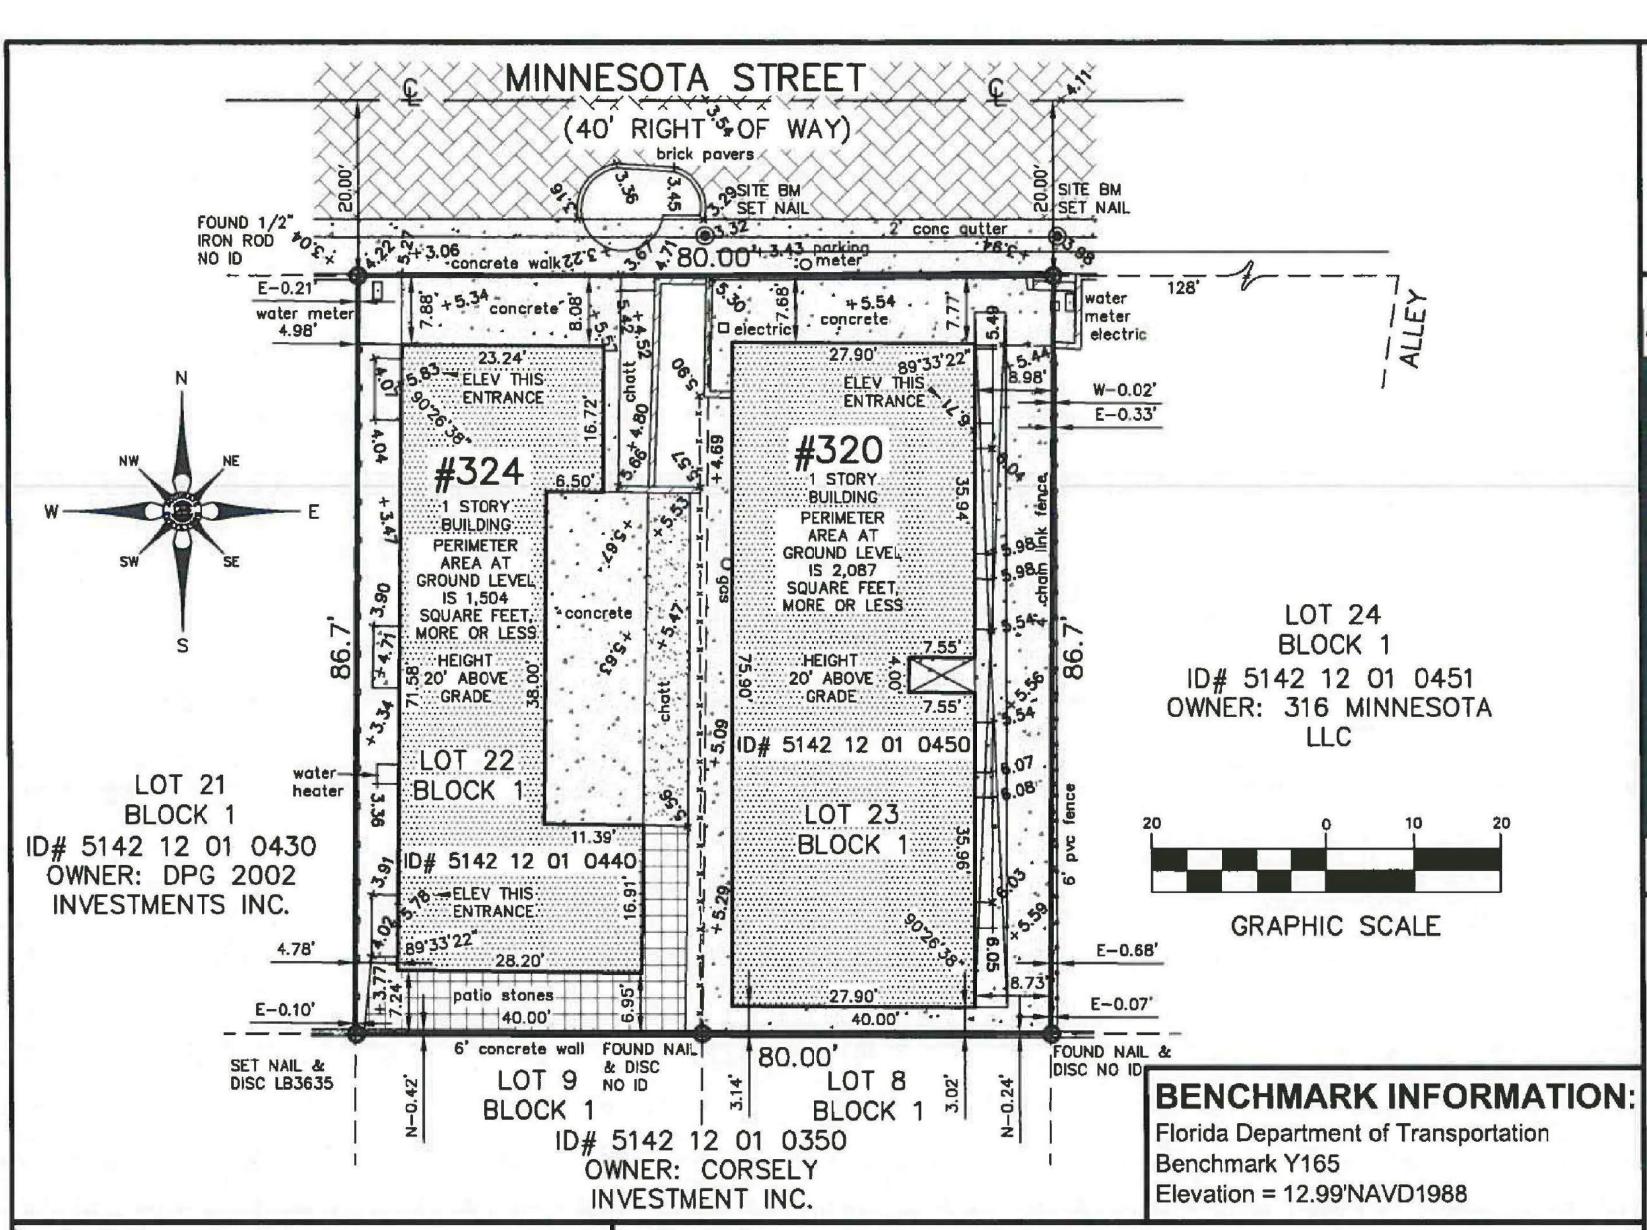

#### STREET ADDRESS:

320 & 324 Minnesota Street, Hollywood, Florida 33019

#### **LEGAL DESCRIPTION:**

Lots 22 and 23, Block 1, HOLLYWOOD BEACH FIRST ADDITION, according to the Plat thereof, as recorded in Plat Book 1, Page 31, of the Public Records of Broward County, Florida.

#### **FLOOD INFORMATION:**


Community name and number: Hollywood 125113 Map and panel number: 12011C0588H

Panel date: 08-18-14 Index date: 08-18-14 Flood zone: "AE"

Base flood elevation: 7'NAVD1988

#### NOTES:

- 1. Unless otherwise noted field measurements are in agreement with record measurements.
- 2. Bearings shown hereon are based on a bearing of N/A.
- 3. The lands shown hereon were not abstracted for ownership, rights of way, easements, or other matters of records by Accurate Land Surveyors, Inc.
- 4. Ownership of fences and walls if any are not determined.
- 5. This survey is the property of Accurate Land Surveyors, Inc. and shall not be used or reproduced in whole or in part without written authorization.
- 6. This survey is made for the exclusive use of the certified hereon, to be valid one year from the date of survey as shown hereon.
- 7. This survey was made for mortgage and title purposes only and is not valid for design or construction purposes.
- 8. This survey reflects all obtainable, legible, plottable, recorded matters of survey per Town and Country Title Guaranty of Hollywood, Ownership and Encumbrance Reports File No. 320 MINNESOTA STREET, effective August 4, 2016 at 5:18 pm., and File No. 324 MINNESOTA, effective August 28, 2014.
- 9. Perimeter area of the subject property is 6,935 square feet, more or less.

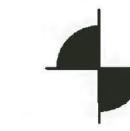

ACCURATE LAND SURVEYORS, INC. L.B. #3635

1150 E. ATLANTIC BLVD. POMPANO BEACH, FLORIDA 33060

TEL. (954) 782-1441 FAX. (954) 782-1442

## TA/NSPS LAND TITLE & TOPOGRAPHIC SURVEY



LOCATION SKETCH NOT TO SCALE

#### **KNOWN EASEMENTS:**

None.

#### **OBSERVED ENCROACHMENTS:**

Concrete in road right of way along the North boundary.

#### **CERTIFY TO:**

Marilyn Gallego Aylee Hallak

#### **CERTIFICATION:**

CENTERLINE This is to certify that this map or plat and the survey on which it is based were made in accordance with the "Minimum Standard Detail Requirements for ALTA/NSPS Land Title Surveys," jointly established and adopted by ALTA and NSPS in 2016, and includes Items 1, 2, 3, 4, 7a, 7b1, 8, 9, 11, 13, 14 and 16 of Table A thereof. Pursuant to the Accuracy Standards as adopted by ALTA and NSPS and in effect on the date of this certification, undersigned further certifies that in my professional opinion, as a land surveyor registered in the State of Florida, the Relative Positional Accuracy of this survey does not exceed that which is specified therein.

CHATT.

B.C.R.

O.R.B.

ROBERT L. THOMPSON (PRESIDENT)

PROFESSIONAL SURVEYOR AND MAPPER No.3869 - STATE OF FLORIDA

CHECKED BY FIELD BOOK ALS-SU-16-2746

**GRAPHIC SCALE** 

LEGEND OF ABBREVIATIONS:

**ELEVATION** 

NORTH AMERICAN

**VERTICAL DATUM** 

AIR CONDITIONER

CHATTAHOOCHEE

PLAT BOOK

FLORIDA POWER & LIGHT

OFFICIAL RECORDS BOOK

ELEVATIONS BASED ON N.A.V.D.

**BROWARD COUNTY RECORDS** 

NORTH

SKETCH SU-16-2746

Not valid without

the signature and the

original roised seal of

a Florida Licensed

Surveyor and Mapper.

#### PROPERTY LEGAL DESCRIPTION

DRAWN BY

MLW

LOT 23, BLOCK 1, HOLLYWOOD BEACH FIRST ADDITION, ACCORDING TO THE PLAT THERE AS RECORDED IN PLAT BOOK 1, PAGE 31, OF THE PUBLIC RECORDS OF BROWARD COUNTY, FLORIDA.-

PROPERTY ADDRESS: 320 MINNESOTA STREET, HOLLYWOOD, FLA. 33019

PROPERTY OWNER: MARILYN GALLEGO

DATE OF SURVEY

08-22-16

#### PROPERTY LEGAL DESCRIPTION

LOT 22, BLOCK 1, HOLLYWOOD BEACH FIRST ADDITION, ACCORDING TO THE PLAT THERE AS RECORDED IN PLAT BOOK 1, PAGE 31, OF THE PUBLIC RECORDS OF BROWARD COUNTY, FLORIDA .-

PROPERTY ADDRESS: 324 MINNESOTA STREET, HOLLYWOOD, FLA. 33019

PROPERTY OWNER: DR. AYLEE HALLAK 101 NE. 162 STREET, MIAMI, FLA. 33162







**BU** SUITE OTA FLA. 


TAC & PDB


DEVELOPMENT BOARD

SUBMITTAL AS INDICATED

2-27-2017 PROJECT No:

CHECKED BY NATALIE P.

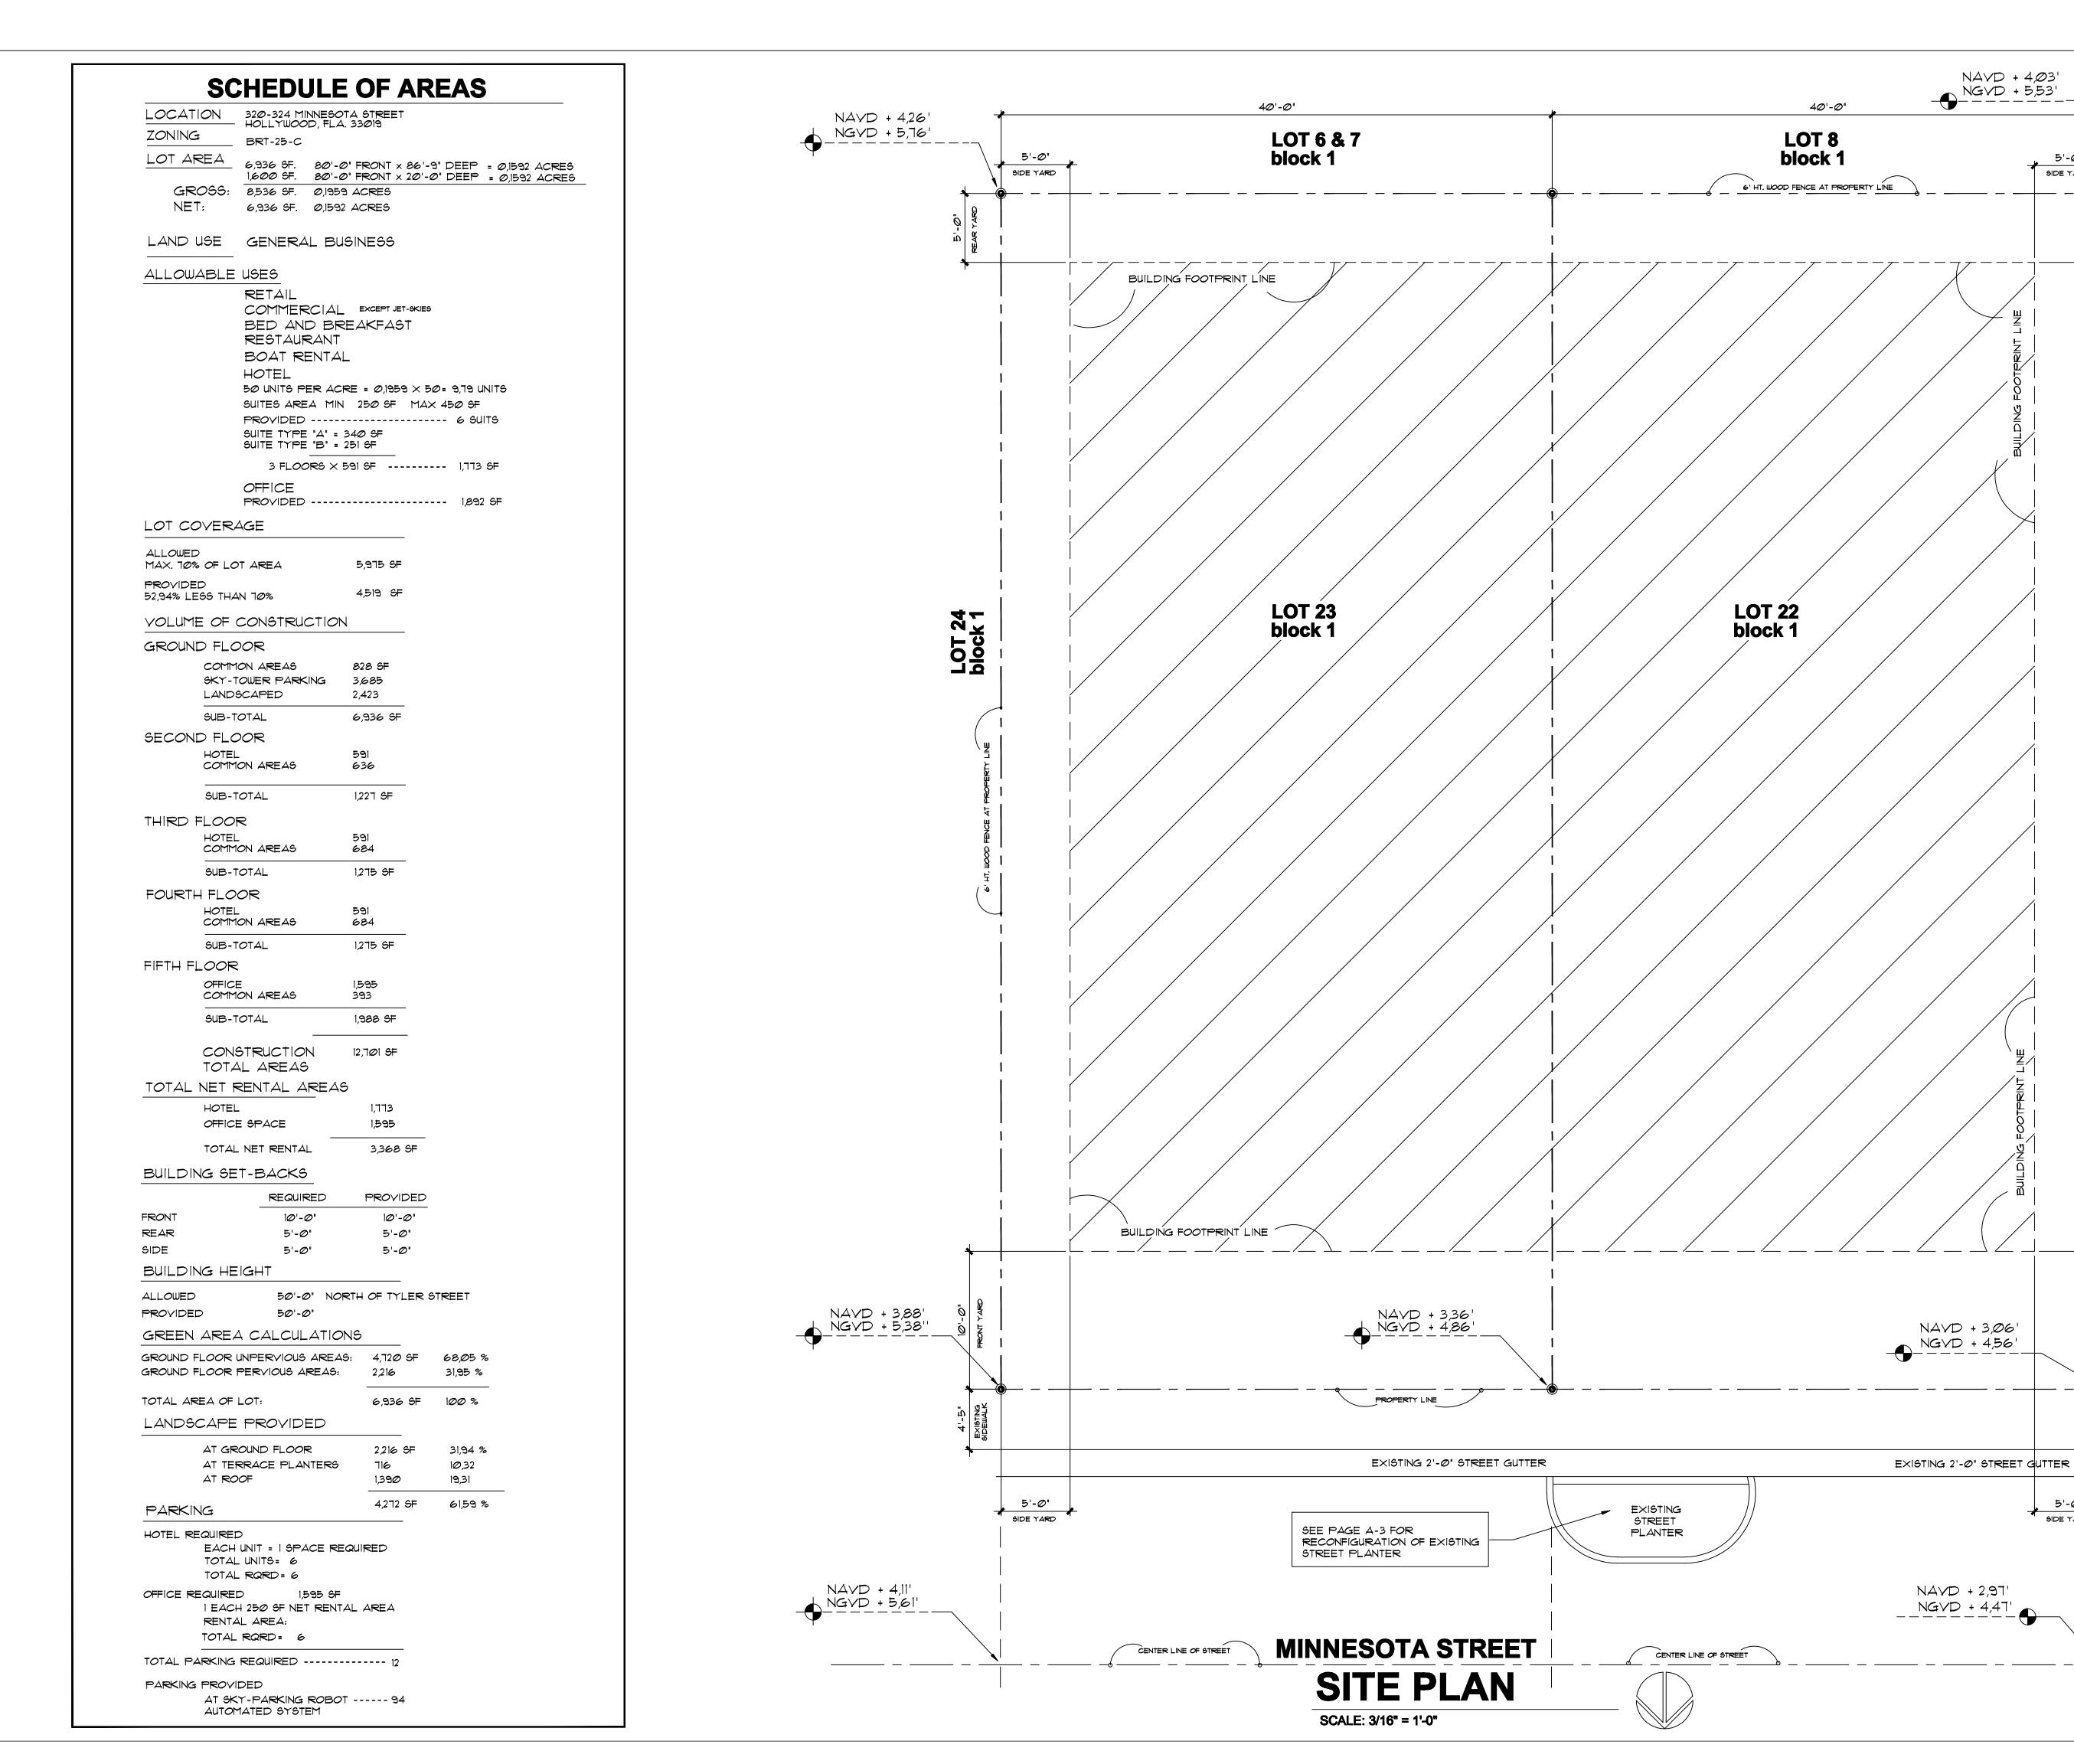

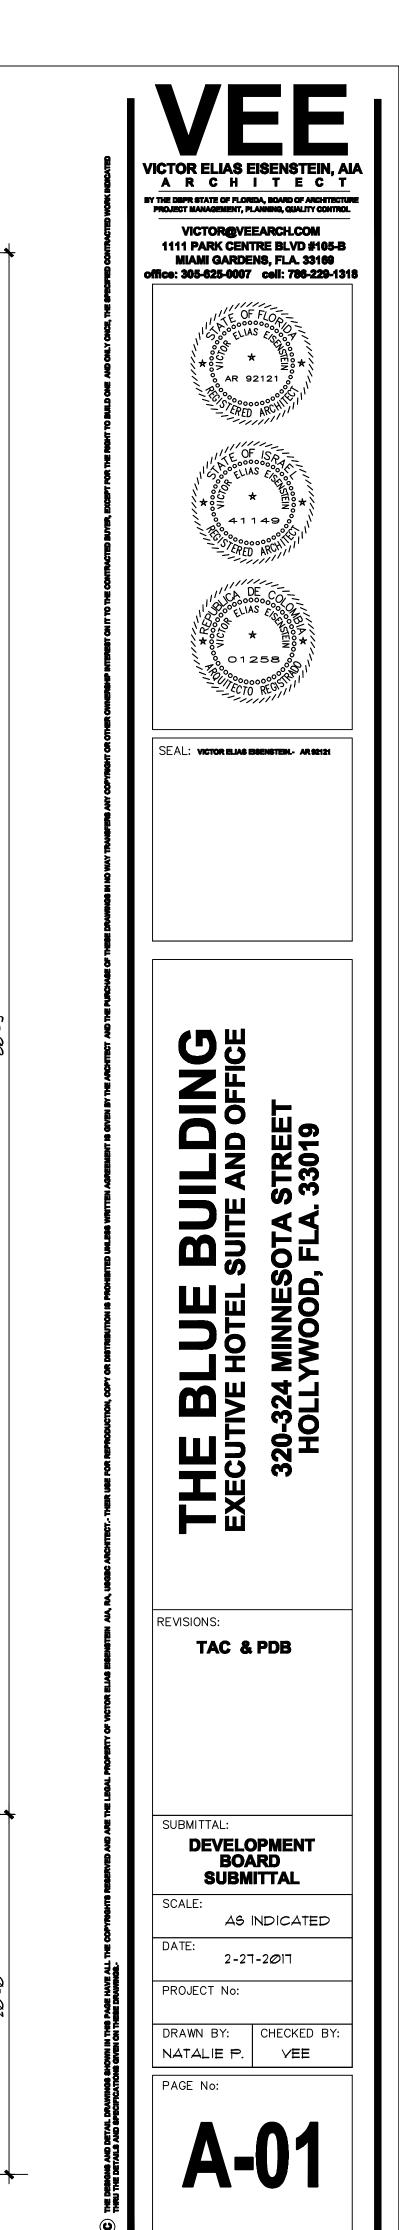

NAVD + 4,03'

5'-Ø"

SIDE YARD

LOT 21 block 1

5'-**0"** 

SIDE YARD

#### THE PROJECT DESCRIPTION

TO DEMOLISH THE EXISTING ONE FLOOR HOME-RESIDENCE LOCATED AT 324 AND 320 MINNESOTA STREET IN HOLLYWOOD, FLA. AND THE ERECTION OF A NEW 5 FLOORS HEIGHT BUILDING FEATURING 3 FLOORS OF MOTEL SPACE AND ONE TOP FLOOR DEDICATED TO OFFICE

THE PROPOSED SUBMITTAL OF DRAWINGS FEATURES A MIX-USE OF A TOTAL OF SIX MOTEL SUITES DISTRIBUTED 2 PER FLOOR ON 3 FLOORS AND ONE LEVEL OF OFFICE USE THE GROUND FLOOR IS DEDICATED TO PEDESTRIAN ACCESS AND AUTOMOBILE PARKING AT THE AUTOMATED SKY-TOWER

THE MOTEL SUITES ARE LOCATED ON THE 2ND-3RD AND 4TH FLOOR AND THE OFFICE RENTAL SPACE IS FEATURED IN THE 5TH FLOOR

THE ROOF-TERRACE OF THE BUILDING IS DEDICATED TO DECORATIVE GARDENING BUILT-UP IN THE BEST EFFORT TO REDUCE THE HEAT-ISLAND EFFECT AS WELL AS A THE COMFORT OF OPEN SPACE FOR THE TENANTS ENTERTAINMENT USE

THE TOTAL PARKING CAPACITY OF 94 VEHICLES IS INTENDED TO BE RENTED IN A MONTHLY BASIS TO BUSINESS EMPLOYEES AND ADJACENT MOTELS THEREFORE, THE 2 ACCESS TO PARKING WILL OPERATE SIMULTANEOUSLY IN THE SAME DIRECTION AT MORNING AND OPPOSITE DIRECTION AT END OF THE DAY, ALLOWING FOR FAST MOVEMENT OF VEHICLES FROM THE STREET

#### SUSTAINABLE CONSTRUCTION

THIS PROJECT REPRESENTS THE BEST VOLUNTARY EFFORT OF THE OWNER TO COMPLY WITH GREEN-BUILDING SUSTANABLE PRACTICES AND ORDINANACES BY YHE CITY OF HOLLYWOOD WITHIN THE GUIDE-LINES FOR SUSTAINABLE CONSTRUCTION IN COMPLIANCE WITH THE USGBC AND

THIS PROJECT WILL BE REGISTERED FOR LEED CERTIFICATION AS PER THE CITY OF HOLLYWOOD GREEN BUILDING ORDINANCE

#### THE PARKING SYSTEM

INNOVATIVE AUTOMATED HANDICAPPED COMPLIANT SELF-PARKING SYSTEM ON AN INDEPENDENT TOWER WITH CAPACITY OF 94 AUTOMOBILES SPACES THAT ARE MOVED VERTICALLY AND HORIZONTALLY TO ITS STALL-STORE DESTINATION BY A ROBOTIC ELEVATOR MECHANISM

UPON ACCESING THE PROPERTY, THE DRIVER EXITS THE VEHICULE AND PROCEED TO ENTER HIS-HER UNIQUE PARKING IDENTIFYING CODE INTO A WALL-MOUNTED COMPUTER CONTROLED KEY BOARD THAT WILL VERIFY THE VEHICULE CONDITION AND THE AVAILABLE OPEN SPACE DESIGNATED TO STORE THE VEHICULE

ONCE THE PERSONAL CODE IS ENTERED INTO THE COMPUTERIZED SYSTEM THEN, THE DRIVER PROCEEDS TO EXIT THE ACCESS-PARKING PLATFORM. ONLY AFTER THIS ACTION TAKES EFFECT AND AFTER THE COMPUTER DETECTION SYSTEM VERIFY THAT NO PERSON IS OCCUPAYING THE PLATFORM THEN, THE ACCESS SLIDING-DOOR WILL BE AUTOMATICALLY CLOSED AND AN ALARM DISTINCTIVE SOUND AND STROBO-LIGHT IS EMMITED TO ALERT THE INITIATION OF A MECHANICAL MOVEMENT.-

THE AUTOMATIC ROBOT-SYSTEM WILL ELEVATE VERTICALLY AND MOVE HORIZONTALLY THE VEHICULE TO ITS DESIGNATED FINAL STALL POSITION .-UPON COMPLETION OF THIS OPERATION THE VEHICULE ELEVATOR WILL RETURN TO ITS ORIGINAL POSITION AT THE GROUND LEVEL .-

THE ROBOTIC PARKING SYSTEM WILL NOT OPERATE IF HUMAN SIGNATURE ARE FOUND BY INFRARED DETECTION INSIDE THE VEHICULE AS WELL AS IN THE ACCESS PLATFORM AT THE GROUND LEVEL

UPON REQUESTING TO RETRIVE THE VEHICULE BY ENTERING THE UNIQUE IDENTIFYING CODE AT THE WALL MOUNTED KEY-BOARD, THE COMPUTER CONTROLLED SYSTEM WILL REPEAT THE ELECTRONIC SECURITY PROCESS VERIFYING THAT NO PERSON IS INSIDE THE ACCESS PARKING PLATFORM AND CLOSING THE ACCESS GATE TO PEDESTRIANS .-

THE AUTOMOBILE WILL BE RETRIVED AND POSITIONED AT THE GROUND FLOOR IN TOP OF THE GIRATORY ROUND TABLE .-THIS MECHANISM WILL ROTATE AND POSITION THE VEHICULE INTO A FORWARD POSITION TOWARDS THE STREET FOR EXIT DRIVING .-

THE ROBOTIC PARKING SYSTEM INCLUDES A SIGNALIZATION OF RED AND GREEN LIGHTS AT EACH ACCESS PREVENTING DRIVERS OF CONFLICTS OF USE WITH INCOMING OR OUTGOING AUTOMOBILES

THE MANUFACTURER ESTIMATED TOTAL TIME ELAPSED FOR THE AUTOMOBILE PARKING OR RETRIVED IS 90 SECONDS

SEE ATTACHED TRAFFIC STUDY FOR TOTAL CAPACITY PARKING OF 94 AUTOMOBILES AND

OFF-STREET STACKING USING BOTH ENTRANCES OR EXITS AT THE SAME TIME

SEE ALSO ATTCHED PARKING OPERATIONAL SUMMARY FOR DETAILED SEQUENCE OF INBOUND OR OUTBOUND OF VEHICLES FROM THE BUILDING

#### PARKING EFFICIENCY

TOTAL CAPACITY OF 94 AUTOMOBILES X 30 SECONDS PER CAR = 47 MINUTES 41 MINUTES / 2 ENTRANCES = 23 MINUTES ALL ARRIVING AT THE SAME TIME REASONABLE TIME FRAME OF ARRIVAL FOR PARKING OF ALL EMPLOYEES = 60 MINUTES 94 AUTOMOBILES / 60 MINUTES = 90 SECONDS PER AUTOMOBILE CONSIDERING 30 SECONDS PARKING TIME PER AUTOMOBILE, RESULTING IN NO WAITING OR STACKING IN THE STREET .- SEE ATTACHED TRAFFIC REPORT

#### PARKING STACKING

IF NECESSARY DUE TO UNFORESEEN CIRCUNSTANCES, STACKING PARKING IS PROVIDED

2 OFF STREET AT ACCESS DRIVEWAY

#### **ELECTRIC VEHICULE CHARGING STATION**

151-154 IN COMPLIANCE WITH CITY ORDINANCES, ELECTRIC VEHICULE CHARGING STATION INFRASTUCTURE IS PROVIDED AT THE GROUND LEVEL OF THE BUILDING

MINIMALLY THE FOLLOWING SHALL BE INSTALLED: EMPTY 3/4" RACEWAY FROM THE BRANCH CIRCUIT PANEL BOARD TO A LOCATION IN THE GARAGE OR PARKING AREA, WITH A TWO GANG JUNCTION BOX WITH A BLANK PLATE OR A FULLY FUNCTIONAL ELECTRIC VEHICLE CHARGING STATION MAY BE INSTALLED

FIBER-CEMENT SIDING PANELS "HARDIPLANK"

26300 LA ALAMEDA, SUITE 250.- MISSION VIEJO, CA. 92691

METRO-DADE COUNTY FLA. PROD.ACCEPTANCE No. 94-1234-04 NON-COMBUSTIBLE WHEN TESTED IN ACCORDANCE WITH ASTM TEST METHOD E-136.-

SURFACE BURNING CAPABILITIES WHEN TESTED IN ACCORDANCE TO ASTM METHOD E-84: FLAME SPREAD: FUEL CONTRIBUTED

SMOKE DEVELOPED

#### **PASSENGER ELEVATOR**

MACHINE ROOM-LESS GEN-2 GERALESS GENERATION BY OTIS WITH SPEED OF 200 FEET PER MINUTE AND 12 PERSONS CAPACITY .-ENVIRONMENTALLY FRIENDLY USES 15% LESS ENERGY THAN TRADITIONALLY GEARED SYSTEMS .-EACH ELEVATOR LANDING FEATURES A SMOKE-PROOF ELEVATOR LOBBY IN COMPLIANCE WITH LIFE SAFETY NFPA-101 AND THE 2014 FLORIDA BUILDING CODE

#### **EXIT STAIRS**

DESIGNED SEPARATED FROM THE BUILDING BY A 2 HOURS FIRE RESISTANT BARRIER AND 1-1/2 FIRE METAL DOORS - EACH FLOOR CONFIGURATION FEATURES 2 REMOTE ACCESS TO THE EMERGENCY EXIT STAIRS ELIMINATING THE DEAD-END CONDITION AND IN COMPLIANCE WITH THE FLORIDA BUILDING CODE .-

THE STAIRS ARE TO BE BUILT WITH REINFORCED EXPOSED CONCRETE AND METAL HAND-RAILS AT EACH SEGMENT

#### **ROOF RAIN-WATER COLLECTION**

COLLECTED AT THE DRAIN-WELL AT THE GROUND LEVEL THAT IS TO BE RE-USED FOR IRRIGATION SAFE BUILDING OF PLANTS AND GRASS WITHIN THE BUILDING SITE .-

#### **INSTA-HOT WATERS**

ELECTRIC TANKLESS WATER HEATERS REF: EEMAZ SP-3512 COMPLY WITH 0,5 GPM HANDWASHING OUTLET TEMP AT 90 DEGREES TO BE USED AT ALL SHOWERS AND HAND-SINKS .- NO LIME, CALCIFICATION OR SEDIMENTATION AND NO-STANBY HEAT LOSS

#### **AC EQUIPMENT ROOF LOCATION**

LOCATED BEHIND VARIABLE HIGH SOLID 42" HT. PARAPETS TO AVOID VISUAL DISTURBANCE AT THE HIGHEST PART OF THE ROOF AND ACCESSIBLE TO MAINTENANCE PERSONNEL ONLY

#### TRASH TEMPORARY STATION

APPROX 93 SF LOCATED AT THE GROUND FLOOR AND TOWARDS THE SOUTH END OF THE BUILDING FEATURES VOLUNTARY RECYCLE BINS SEPARATING ORGANICS FROM PAPER AND GLASS ITEMS.- MAINTENACE PERSONNEL WILL CART-OUT THE BINS TO THE CURB-SIDE ON THE SCHEDULED DAYS FOR PICKUP BY THE WASTE MANAGER CONTRACTOR SERVICING THE AREA.-

DUMPSTER DIMENSIONS: 2'-0" WIDE  $\times$  3'-0" HT.  $\times$  6'-0" LONG = 1 CUBIC YARD = 202 GLS REMOVAL SERVICE WILL BE PROVIDED NOT LESS THAN ONE TIME PER WEEK

TRASH ROOM CAPACITY: 2 CUBIC YARDS = 404 GLS SEE PAGE A-ØI FOR TRASH CALCULATIONS

#### LAUNDRY ROOM

LOCATED AT THE GROUND FLOOR FEATURES HEAVY-LOAD CAPACITY ONE WASHER AND ONE DRYER, MOP SINK AND UTILITY COUNTER AND SHELVING ABOVE AND FOR THE USE OF THE MOTEL CUSTOMERS .-

THERAPIST OFFICE FEATURES ALSO A LAUNDRY ROOM FOR RE-TRAINING IN THE USE OF THE MACHINES

#### **ACCESS LOBBY**

PEDESTRIAN ACCESS CONTROLED BY A CONCIERGE DESK FOR SECURITY AND SERVICE TO THE HOTEL CUSTOMERS AND OFFICE TENANTS

#### **ADA VERTICAL LIFT**

ACCESSIBLE USE FROM THE GROUND FLOOR LEVEL TO THE ACCESS LOBBY AND VICE VERSA.SEE PAGE A-2 DETAIL A-A AS WELL AS THE ACCESSIBLE PATH CONNECTING THE

VERTICAL LIFT SHAFTWAY MODEL STRAIGHT TROUGH APPLICATION ADA COMPLIANT, KEYED OPERATION WITH BATTERY POWER EMERGENCY MANUFACTURED BY GARAVENTA WWW.GARAVENTA.CA 1-800-663-6556

HIDRAULIC OPERATION

NO KEY REQUIRED FOR CALL STATIONS AND PLATFORM CONTROLS 750 LBS WITH SAFETY FACTOR OF 5

SPEED IT FT PER MINUTE AT FULL LOAD 3 HP MOTOR, 120 V, 15 AMPS CIRCUIT

#### **OFFICE SPACE**

LOCATED AT THE 5TH FLOOR TO BE USED FOR DR. HALLACK TERAPHY PRACTICE AND SERVICED BY PASSENGER ELEVATOR AND FEATURING BALCONIES AND

#### BASE FLOOD ELEVATION

CITY OF HOLLYWOOD BENCHMARK AT FIRE HIDRANT FLANGE AT GEORGIAN AND N. OCEAN NGVD 4,41'

AT CROWN OF MINNESOTA STREET NGVD + 2.83'MAP PANEL NO 12011 C 0317 SUFFIX G

FLOOD ZONE BASE FLOOD ELE + 80' NAVD DATE OF CERTIFICATE 6-30-2010 FLA. BUILDING AND LAND SURVEYING

1660-0008 EXPIRES 3-31-12 OMB No

NGVD + 9,5' PROVIDED AT FIRST FLOOR NAVD + 8,0'

#### **GREEN BUILT-UP ROOF**

THE CREATION OF A GREEN ROOF BUILT-UP TO REDUCE THE HEAT ISLAND EFFECT REFLECTING THE SUN CAUSING THE BUILDING SURFACE TEMPERATURE TO DECREASE AND CONTRIBUTING TO LEED CREDITS UNDER THE CATEGORIES OF:

STORM WATER MANAGEMENT LANDSCAPE AND EXTERIOR DESIGN REDUCTION OF HEAT ISLAND EFFECT RECYCLED CONTENT OF MATERIALS WATER EFFICIENT LANDSCAPING LOCAL AND REGIONAL MATERIALS OPTIMIZED ENERGY PERFORMANCE

#### **HOTEL SUITE**

SIX HOTEL SUITES LOCATED 2 PER FLOOR AT 2ND + 3RD AND 4TH FLOORS, - THE MOTEL SUITE FEATURES COMMON USE AREAS AS A LAUNDRY ROOM AND TRASH CHUTE, ENTRANCE RECEPTION AREA, AND BALCONIES: KITCHENETTE AND EATING TABLE

EXECUTIVE SUITE UNITS FEATURES ONE HANDICAPPED COMPLIANT RESTROOMS AND CLOSETS: LARGE WINDOW PICTURE TYPE SLIDING-DOORS WITH METAL GUARD-RAIL PROTECTION AT OPEN POSITION THEREFORE CREATING THE EFFECT OF A BALCONY

FULLY FIRE PROTECTED BY AN AUTOMATED FIRE-SPRINKLER SYSTEM WITH TWO SEPARATED EMERGENCY MEANS OF EGRESS, MANUAL FIRE-EXTINGUISHERS AT EACH FLOOR, LIFE-SAFETY EXIT SIGNS, SMOKE DETECTORS, HORN-STROBO LIGHTS LINKED TO A CENTRAL EMERGENCY ALARM IN COMPLIANCE WITH THE NATIONAL FIRE PROTECTION ASSOC NFPA-101.- SMOKE CONTROL AND FIREFIGHTERS ACCESS .- THE BUILDING CONSTRUCTION IS SPECIFIED WITH UNCOMBUSTIBLE MATERIALS

THE DESIGN OF THE FIRE SPRINKLER SYSTEM SHALL BE EH-II

#### **BICYCLE RACKS**

ARE PROVIDED AT THE REAR OF THE BUILDING AND TO PROMOTE THE LESS USE OF AUTOMOBILES TO COMMUTE FOR OFFICE WORK

#### **AC REFRIGERANTS**

ZERO USE OF CFC BASED REFRIGERATINTS ON THE HVAC SYSTEM IS MANDATORY .-CHLOROFLUORCARBONS CFC'S ARE HYDROCARBONS RESPONSIBLE FOR THE ATMOSPHERE OZONE LAYER DUCT-LESS AC SYSTEM, REFRIGERANT TO USE R410A ZERO OZONE DEPLETION

MECHANICAL ENGINEER IS DIRECTED TO SPECIFY EQUIPMENT THAT USE HYDROCHLOROFLUORCARBONS HCF'S THAT CAUSE SIGNIFICANT LESS DEPLETION OF THE OZONE LAYER AND IN COMPARISSON TO THE CFS'S

#### **MAIL DELIVERY METHOD**

CENTRAL WALL MOUNTED CONSOLE SERVICED FROM ITS FRONT, IS CONVINIENTLY LOCATED AT THE BUILDING MAIN ENTRANCE ROOM AND IN PROXIMITY TO THE ELEVATOR LOBBY

FIVE EXISTING FIRE-HYDRANTS LOCATIONS ARE WITHIN 250 FEET RADIUS DISTANCE FROM THE PROPERTY. - SEE FIRE-HYDRANTS LOCATION MAP AT THIS PAGE

#### **CONSTRUCTION MATERIALS**

THE FOLLOWING LIST OF INTENDED MATERIALS TO BE USED IS THE OWNER VOLUNTARY EFFORT TO COMPLY WITH THE PRACTICE AND GUIDELINES FOR SUSTAINABLE CONSTRUCTION IN COMPLIANCE WITH THE USGBC AND LEED .-

- ØI STEEL REINFORCED CONCRETE ON COLUMNS AND FLOOR CONCRETE SLABS
- PVC WATERPROOF FLAT ROOF MEMBRANE AT WALKABLE ROOF-DECK FINISHED WITH HEAVY DUTY THERMOPLASTIC MEMBRANE
- WATERPROOF EXPOSED CONCRETE AT FLAT ROOF, STAIRS, WC'S PRODUCT BY XYPEX CRISTALINE MIXED DIRECTLY WITH CONCRETE
- GREEN CONCRETE AS A RESULT OF ADDED FLY-ASH TO CONCRETE.- THIS IS THE MICROSCOPIC RESIDUAL OF BURNING COAL AT ELECTRIC PLANTS MAKES CONCRETE MALLEABLE AND EASIER TO WORK, STRONGER AND
- 05 EXTERIOR BUILDING ENVELOPE WALL PARTITIONS IN CONCRETE BLOCK TO RESIST LARGE MISSILE IMPACT AND HIGH HURRICANE WINDS
- 06 FLOOR TILE CONCRETE MORTARS WIXED WITH FLY-ASH FOR BETTER PERFORMANCE
- LARGE MISSILE IMPACT RESISTANT LAMINATED GLASS AT WINDOWS AND GLASS
- 08 ALL EXTERIOR BUILDING ENVELOPE TO BE WATERPROOF WITH XYPEX COMPOUND
- ALL EXTERIOR DOORS AND WINDOW FRAMES IN ULTREX FIBERGLASS BY MARVIN STONG THAN STEEL, 34% LOWER HEATING COST, 38% LOWER COOLING COST, HEAT RESISTANT, NON-CORROSIVE, 8X LESS EXPANSION, 8X STRONGER THAN VINYL
- 10 ALL EXTERIOR PAYED AREAS AT THE GROUND FLOOR AND THE TERRACE TO BE PRODUCED WITH PERMEABLE PAVERS

#### INTERIOR

- Ø1 3-5/8 METAL STUDS, 20 GA EA. 18' OC AND GYPSUM BOARD EA. FLOOR TO CEILING AND FIBER SOUND BLANKET BETWEEN STUDS
- SOUND INSULATION 3" FIBERGLASS BLANKET BETWEEN PARTITION STUDS FROM FLOOR TO CEILING
- 03 EXTERIOR WALL CLOSED CELL SPRAYED FIBER R-6 THERMAL INSULATION BETWEEN FURRINGS AND COVERED WITH 5/8 NO-PAPER GYPSUM BOARD
- KITCHENETTE AND WC CABINETS MADE IN SKY-BLEND BOARD AGRIFIBER
- PRODUCTS WITH NO UREA FORMALDEHYDES RESINS ALL APPLIANCES SPECIFIED AS UL AND ENERGY STAR LABELED
- WOOD FLOORS MADE FROM RAPIDLY RENEWABLE FIBERS AND CERTIFIED 06
- ALL ACCESS DOORS AND DOOR FRAMES TO MOTEL SUITES AND OFFICE TO BE
- GALVANIZED STEEL SKIN METAL DOORS, 20 MINUTES FIRE RESISTIVE ALL DOOR HARDWARE TO COMPLY WITH ADA AND NFPA GUIDELINES
- ALL WC'S TO BE ADA COMPLIANT
- INTERIOR PAINT BY SHERWIN-WILLIAMS AND OF LOW YOC POLUTANTS
- AS PER THE ENERGY POLICY ACT (EPA) APRIL 2010 HIGH EFFICIENCY ENERGY AND WATER SAVING EQUIPMENT STANDARDS AND NSF

SHOWERS 1,7 GLS / MINUTE TOILETS HET 1,28 GP / FLUSH FAUCETS 1,7 GLS / MINUTE

ACCOUSTICAL FLOORING UNDERLAYMENT "ECO SILENCER" MADE FROM POST-CONSUMER RECYCLED GRANULATED RUBBER TIRES WWW. FOAMPRODUCTS.COM 1-800-526-3626

#### **EXTERIOR ILLUMINATION**

EXTERIOR AMBER LIGHTING IS NOT TO EXCEED 0,5 FOOT-CANDELS AT ALL PROPERTY LINES EXTERIOR ILLUMINATION TO COMPLY WITH CITY OF HOLLYWOOD TURTLE ORDINANCE Ø-2011-ØT AND SECTION 6-22-D-6-5

#### **IRRIGATION NOTES**

AS PER THE CITY OF HOLLYWOOD LANDSCAPE MANUAL PROVIDE 100% IRRIGATION COVERAGE BY MEANS OF AN AUTOMATC SPRINKLER SYSTEM DISIGNED AND CONSTRUCTED IN ACCORDANCE WITH THE CITY OF HOLLYWOOD CODE OF ORDINANCES AND THE REGULATIONS OF THE SOUTH FLORIDA WATER MANAGEMENT DISTRICT

ARCHITECT By the DBPR State of Florida, Board of Architecto PROJECT MANAGEMENT, PLANSING, QUALITY CONTRO

VICTOR@VEEARCH.COM 1111 PARK CENTRE BLVD #105-B MIAMI GARDENS, FLA. 33169 fice: 305-625-0007 cell: 786-229-1318





SEAL: VICTOR ELIAS EISENSTEIN.- AR8212

TREE 33019

REVISIONS:

TAC & PDB

DEVELOPMENT BOARD

SUBMITTAL

AS INDICATED 2-27-2017

CHECKED BY: DRAWN BY: NATALIE F YEE

PROJECT No:

#### PROJECT CODE COMPLIANCE

OCCUPANCY CLASSIFICATION HOTEL GROUP R-1 OFFICE GROUP B

BUILDING

CONSTRUCTION TYPE: 2014 FBC TABLE 601

TYPE I NON-COMBUSTIBLE CONCRETE SUPPORT STRUCTURE AND CONCRETE ROOF, FIRE PROTECTED, FULLY SPRINKLERED WITH FIRE ALARM AND SMOKE DETECTORS

AREA SEPARATION

BETWEEN MOTEL AND OFFICE USE FIRE-RATE SEPARATION REQUIRED: I HOUR PROVIDED 2 HOURS

PARKING STRUCTURE CONSTRUCTION TYPE

> TYPE I NON-COMBUSTIBLE METAL AND CONCRETE STRUCTURE, FIRE PROTECTED, FULLY SPRINKLERED WITH FIRE ALARM, SMOKE DETECTORS AND SMOKE EVACUATION SYSTEM

AREA SEPARATION

BETWEEN PARKING STRUCTURE AND BUILDING FIRE-RATE SEPARATION REQUIRED: 2 HOURS PROVIDED 2 HOURS

FIRE SEPARATION BETWEEN BUILDINGS

MAX AREA OF EXTERIOR WALL OPENINGS FIRE SEPARATION DISTANCE BETWEEN BUILDINGS

2014 FBC. CHAPTER 1 TABLE 105-8

AREA OF LARGEST EXTERIOR WALL: ----- 4,298 SF 10 TO LESS OF 15 FEET UNPROTECTED-SPRINKLERED ----- 45% ALLOWED OPEN AREA ON EXTERIOR WALL: 4,298 SF X 45% = 1,934 SF PROVIDED OPEN AREA ON EXTERIOR WALL: ------ 691 SF

GOVERNING CODES

DISTANCE BETWEEN BLDGS

2014 FLORIDA BUILDING CODE WITH SUPPLEMENTS 2014 FLORIDA BUILDING CODE CHAPTER 11 ADA

2010 NEC NATIONAL ELECTRIC CODE

2012 FFPC FLORIDA FIRE PREVENTION CODE 101, 5TH EDITION 2014 NFPA-101 LIFE SAFETY CODE

CITY OF HOLLYWOOD, FLA. BUILDING CODE ORDINANCES

BLDG OCCUPANT LOAD

1,773 SF HOTEL 200 SF PER OCCUPANT = 9 OFFICE 1,595 SF 100 SF PER OCCUPANT = 16

> TOTAL 25 OCCUPANTS

MIN NUMBER OF EXITS RORD OCCUPANT LOAD 1 TO 500=

OCCUPANT LOAD 501 TO 1000= OCCUPANT LOAD ABOVE 1000=

MEANS OF EGRESS

EXITS REQUIRED EXITS PROVIDED

INTERIOR FINISHES 2014 FBC 803-1-1

CLASS FLAME SPREAD INDEX Ø - 25 26 - 75

MAX FLAME SPREAD MATERIAL CLASS FOR GROUP OCCUPANCY R-1 AND B FOR A BLDG FIRE PROTECTED WITH AUTOMATIC SPRINKLERS AS FOLLOWS: 2014 FBC TABLE 803-9

76 - 200

CLASS EXIT ENCLOSURES AND PASSAGEWAYS CORRIDORS ROOMS AND

FLOORS

ENCLOSED SPACES

CRITICAL RADIANT FLUX

EXIT CORRIDORS AND EXITS NOT LESS THAN 0,45 W/CM2 ASSEMBLY: I-1 / I-2 / I-3

EXIT CORRIDORS AND EXITS NOT LESS THAN 0,22 W/CM2 BUT NO MORE THAN 0,45 W/CM2 ASSEMBLY: A / B / E / H / M / R-1 / R-2 / I-4 / S EXTERIOR ILLUMINATION

EXTERIOR AMBER LIGHTING IS NOT TO EXCEED 05 FOOT-CANDELS IF ADJACENT TO RESIDENTIAL EXTERIOR ILLUMINATION TO COMPLY WITH CITY OF HOLLYWOOD TURTLE ORDINANCE Ø-2011-ØT AND SEC. 6-22-D-4-b-5

SIGNAGE

SIGNAGE IS TO BE SUBMITTED UNDER A SEPARATE PERMIT BY THE SIGNAGE CONTRACTOR SEE SIGNAGE CRITERIA AT PAGE A-9

CLOSED GARAGE

FBC 2014 SEC. 406-6

MECHANICAL VENTILATION SHALL BE PROVIDED ENTIRE GARAGE SPACE IS AIR CONDITIONED PROVIDING DRY AIR ENCLOSED GARAGE SHALL BE EQUIPED WITH AN AUTOMATIC FIRE SPRINKLER SYSTEM

GARBAGE HOLDING STATION DIMENSIONS:

17'-8" LONG × 4'-8" WIDE = 82,3 SF

DUMPSTER SIZE 2'-0" WIDE × 3'-0" HT. × 6'-0" LONG = ONE CUBIC YARD = 202 GLS

DUMPSTER ROOM CAPACITY 3 CUBIC YARDS = 606 GLS

DUMPSTER ROOM IS AIR CONDITIONED AS PER CITY CODE AND ORDINANCES

YOLUME OF TRASH CALCULATION

OFFICE I Cu. YD EACH 10,000 SF PER DAY

0,16 Cu.YD 0,80 Cu. YD PER WEEK 0,16 × 5 DAYS =

HOTEL Ø,16 Cu. YD EACH ROOM PER WEEK 0.16 × 6 ROOMS =

0,96 Cu. YD PER WEEK

1,76 Cu. YD PER WEEK

DUMPSTER CAPACITY

2 Cu. YD SERVICED ONE TIME PER WEEK = 2 Cu.YD

#### PROJECT CODE COMPLIANCE NPDES APPLICABLE TO PROPERTIES OVER ONE ACRE

THE CONSTRUCTION ACTIVITY ON THIS SITE IS REGULATED BY CITY CODE CHAPTER 54.- FAILURE TO MAINTAIN JOB-SITE EROSION AND SEDIMENTATION CONTROL IN ACCORDANCE WITH PERMIT CONDITIONS AND APPLICABLE REGULATIONS, MAY REULT IN FINES UP TO 500 PER DAY.-

PRIOR TO ISSUANCE OF BUILDING PERMIT, A STORM WATER POLLUTION PREVENTION PLAN -SWPPP- SHALL BE REQUIRED .- THE SWPPP MUST BE MAINTENED AT THE JOB SITE AT ALL TIMES .- THE SWPPP SHALL CONTAIN DETAILED DESCRIPTIONS OF STRUCTURE, PROCEEDURES, CONTACT NAMES AND OR CONTROL MEASURES DESIGNED TO REDUCE SEDIMENT AND STORM

CONSTRUCTION SITES AND OPERATIONS SHALL BE REQUIRED TO MAINTAIN DURING AND AFTER ALL DEMOLITION, CONSTRUCTION, DEVELOPMENT, EXCAVATION, DEWATERING AND OR ALTERATION OPERATIONS, STRUCTURAL AND NON-STRUCTURAL, BEST MANAGEMENT PRACTICES - BMP - WITH THE INTENT TO REDUCE POLLUTANTS AND SEDIMENT IN STORMWATER RUNOFF

FOR ADDITIONAL INFORMATION REGARDING NPDES REGULATIONS PLEASE

FLORIDA DEPARTMENT OF ENVIRONMENTAL PROTECTION 2600 BLAI ROAD, MS 2500 TALLAHASSEE, FLA. 32399-2400

850-245-7522 WWW.DEP.STATE.FL.US/WATER

WINDOW AND DOOR ROUGH CLEAR OPENINGS

PASSAGE DOORWAYS SHALL HAVE A MIN. OF 32 INCHES WITH THE DOOR OPEN 90 DEGREES, MEASURED BETWEEN THE FACE OF THE DOOR AND THE OPPOSITE STOP .-2014 FBC 11-4-13-5

DOOR CLEARENCE WIDTH NFPA-101 SEC. 7-2-1-2-2 FIG. 7-2-1-2-3A

A STANDARD 34 INCHES DOOR PROVIDES AN ACCEPTABLE 32 INCHES CLEAR OPENING

DOORS MIN. WIDTH SHALL NOT APPLY TO DOOR OPENINGS THAT ARE NOT PART OF THE REQUIRED MEANS OF EGRESS IN GROUPS R-2 AND R-3 OCCUPANCIES 2014 FBC 1008-1-1 EXCEPTION (1)

ARCHITECTURAL DRAWINGS ARE INDICATING REQUIRED CLEAR WIDTH OPENING DIMENSIONS AT DOORS AND THE GENERAL CONTRACTOR IS RESPONSIBLE TO PROVIDE DOOR ROUGH OPENINGS TO COMPLY WITH DORWAY CLEAR PASSAGE AS PER 2014 FBC. REQUIREMENTS .-

FLOOR PLANS DIMENSIONS DO NOT INCLUDE ANY REQUIRED ADDITIONAL ROUGH OPENINGS AT E.A. SIDE FOR DOOR OR WINDOW FRAMING.

CONTRACTOR SHALL VERIFY DISCREPANCIES WITH THE ARCHITECT.

LANDSCAPE AREAS

FOR LANDSCAPE PERVIOUS AREAS CALCULATION SEE PAGE A-14

#### ACCESSIBILITY NOTES

2014 FLORIDA BUILDING CODE CHAPTER 11 ESTABLISHES STANDARDS FOR ACCESSIBILITY TO PLACES OF PUBLIC ACOMMODATION AND COMMERCIAL FACILITIES BY INDIVIDUALS WITH DISABILITIES .-

BUILDING ENTRANCE STAIRS IS ON THE ACCESSIBLE ROUTE WITH NO CHANGE IN LEVEL OF MORE THAN 1/2" ALONG ROUTE AND MAX LEVEL CHANGE OF 3/4" AT ENTRY DOORS AND THRESHOLDS IN COMPLIANCE WITH CODE AS PER THE USE OF AN ADA APPROVED CHAIR-LIFT MECHANICAL SYSTEM

ALL DOORS SHALL PROVIDE A CLEAR OPENING OF 32" WHEN DOOR IS OPEN 90 DEGREES. A STANDARD 34 INCHES DOOR PROVIDES AND ACCEPTABLE NOMINAL 32 INCHES OPENING.

LIGHT SWITCHES AND ELECTRICAL OUTLETS INSIDE THE REST-ROOMS ARE TO BE LOCATED NO HIGHER THAN 48" AND NO LOWER THAN 15" AFF.-

RESTROOMS SHALL BE PROVIDED WITH FIRE-RATED WOOD OR METAL REINFORCEMENTS INSIDE THE PARTITION WALLS TO ALLOW FOR THE INSTALLATION OF GRAB-BARS AROUND THE TOILET COMODE .- SUCH REINFORCEMENTS SHALL BE IN ACCORDANCE WITH THE DIRECTIVES GIVEN ON THE ILLUSTRATIONS AND IN COMPLIANCE WITH THE 2014 FLORIDA BUILDING CODE FOR MIN. STRUCTURAL RESISTANCE OF 250 LBS APPLIED ON ANY DIRECTION .-

GROUND FLOOR ACCESSIBLE PATH

SEE PAGE A-2 FOR DETAILED ACCESSIBLE PATH AT GROUND FLOOR

THRESHOLD INSPECTOR

THIS IS A THRESHOLD BUILDING AND SHALL COMPLY WITH SEC. 110-3-7 OF THE 2014 FBC.-THIS SECTION INCLUDES THE SUBMITTAL AND REVIEW OF A STRUCTURAL INSPECTION PLAN PRIOR TO BUILDING PERMIT ISSUANCE AND THE EMPLOYMENT OF A SPECIAL THRESHOLD INSPECTOR DURING CONSTRUCTION

#### ALL WOOD COMPONENTS OF THIS PROJECT SHALL BE FIRE RETARDANT COATED

GENERAL CONTRACTOR TO PROVIDE SUBMITTAL TO THE ARCHITECT ON ALL DOCUMENTATION FOR THE FIRE RATED PLYWOOD AND OR ANY WOOD COMPONENTS TO BE USED ON THIS PROJECT AND STATING COMPLIANCE WITH THE TESTING REQUIREMENTS FOR ASTM-E-136 AS NOTED IN THE DEFINITION FOR NON-COMBUSTIBLE MATERIAL,-

WOOD FIRE RETARDING OR EQUIVALENT PRODUCT RECOMMENDED TO BE USED BY THE CONTRACTOR:

UNIVERSAL FIRE SHIELD CHEMICALS .-

400 AVENUE R, SW. WINTER HEAVEN, FLA. - 33880 1-800-608-5699 WWW.FIRECHEMICALS.COM

PRODUCT REF: W-1000 WOOD SHIELD CLASS "A" EXTERIOR AND INTERIOR USE FLAME SPREAD: 25 SMOKE: 90

FLASH POINT Ø .- NON TOXIC, NO PETROLEUM .-NO PBDE OR ASBESTOS. ENVIRONMENTALLY SAFE.-

MEETS OR EXCEEDS:

UL723.- ASTM E-84.- NFPA 703.- NFPA 255.- ASTM E-108.-

#### **GREEN BUILDING PRACTICES**

- 151-153 THE FOLLOWING RESIDENTIAL AND COMMERCIAL GREEN BUILDING PRACTICES FOR EITHER CATEGORY ARE APPROVED
  - CENTRAL AIR CONDITIONER OF 18 SEER OR HIGHER
- ENERGY EFFICIENCY LOW & WINDOWS, ALL WINDOWS SHALL CONFROM TO THE ENERGY STAR RATING CRITERIA FOR SOUTH FLORIDA AS APPROVED BY THE NFRC -NATIONAL FENESTRATION RATING COUNCIL-
- ENERGY STAR APPROVED ROOFING MATERIALS
- PROGRAMABLE THERMOSTATS
- PERVIOUS PAVEMENT

FINAL INSPECTION

- REUSE FOR IRRIGATION .- WHERE WASTEWATER REUSE IS AVAILABLE, WASTEWATER REUSE SHALL BE USED.- WHERE WASTEWATER REUSE IS NOT AVAILABLE, RAINWATER RESUSE SHALL BE USED.- PLANS SHALL INDICATE SYSTEM TO BE USED AND IF RAINWATER REUSE IS TO BE USED, SYSTEM SHALL SUBSTANTIALLY COMPLY WITH RAINWATER HARVESTING GUIDELINES ADOPTED BY THE BROWARD COUNTY BOARD RULES AND APPEALS .- SYSTEM MUST BE VERIFIED BY PLUMBING INSPECTIOR AT FINAL INSPECTION.
- 7.- AT LEAST 80% OF PLANTS, TREETS AND GRASSES PER SOUTH FLORIDA WATER MANAGEMENT DISTRICT RECOMMENDATIONS -LATEST EDITION - LANDSCAPE PLAN REVIEWED AND APPROVED BY A LANDCSAPE ARCHITECT SHALL BE SUBMITTED WITH PERMIT APPLICATION .-LANDSCAPING SHALL BE VERIFIED BY INSPECTION PRIOR FINAL CERTIFICATE OF OCCUPANCY
- ALL ENERGY-EFFICIENT OUTDOOR LIGHTING .- SUGGESTED LIGHTS FOR OUTDOOR SPACES INCLUDE FLUORSCENT BULBS AND FIXTURES WITH ELECTRONIC BALLASTS -MORE EFFICIENT THAN MAGNETIC TYPES- LOW PRESSURE SODIUM OR MERCUTY VAPOR, PHOTOVALTIC SYSTEMS, LED LIGHTING AND LOW VOLTAGE LANDCSAPE LIGHTS THAT RUN ON A TIMER - ALL ENERGY EFFICIENT OUTDOOR LIGHTING SHALL BE VERIFIED BY ELECTRICAL INSPECTOR AT FINAL INSPECTION
- 9.- ENERGY PERFORMANCE AT LEAST 10% MORE EFFICIENT THAN STANDARD ESTABLIESHE BY ASHRAE -LATEST EDITION- CALCULATIONS SHALL BE SUBMITTED WITH PERMIT APPLICATION
- 10.- ALL HOT WATER PIPES INSULATED.- ALL HOT WATER PIPES SHALL HAVE A MINIMUM OF 1/2" INSULATION INCLUDING BURIED PIPES -CPVC IS NOT A SUITABLE REPLACEMENT FOR INSULATION- ALL HOT WATER PIEPS INSULATED SHALL BE SHOWN ON PLANS AND VERIFIED BY LUMBING INSPECTIOR ON SITE AT FINAL INSPECTION

MERY OF AIR FILTERS ON ALL AIR CONDITIONING UNITS, AT LEAST 8 WITH ANTI-MICROBIAL

AGENT .- MERY OF AT LEAST 8 SHALL BE VERIFIED BY MECHANICAL INSPECTOR ON SITE AT

BICYCLE RACKS IMAGE AND SPECS



WALL MOUNTED BIKE RACK IS DEVELOPED WITH A SIMPLE STRUCTURAL DESIGN TO PROVIDE EFFICIENT STORAGE FOR BICYCLES IN AREAS WITH SPACE CONSTRAINTS.

CONSTRUCTED WITH 1"O.D. 11-GAUGE STEEL TUBING, THE WALL MOUNTED RACK IS FINISHED IN A DURABLE BLACK PVC DIP TO PROTECT BIKES FROM SCRATCHES OR SCUFFING. THE WALL RACK PROVIDES OFF THE GROUND STORAGE FOR 1 TO 2 BIKES THAT IS U-LOCK COMPATIBLE. THE WALL RACK IS GREAT FOR RESIDENTIAL OR COMMERCIAL USE.

BICYCLE RACKS

WITHIN THE OWNER'S VOLUNTARY EFFORT TO COMPLY WITH LEED GUIDELINES BISCILE RACKS ARE PROVIED FOR NOT LESS THAN 5% OF THE BUILDING OCCUPANT LOAD

OCCUPANT LOAD: 25

5% OF OCCUPANCY = 2 BISCICLE RACKS PROVIDED



### SITE LOCATION

NOT TO SCALE

FIRE HIDRANTS PROXIMITY LOCATION



ARCHITECT BY THE DBPR STATE OF FLORIDA, BOARD OF ARCHITECTO PROJECT MANAGEMENT, PLANNING, QUALITY CONTRO

VICTOR@VEEARCH.COM 1111 PARK CENTRE BLVD #105-B MIAMI GARDENS, FLA. 33169 ffice: 305-625-0007 cell: 786-229-1318 AR 92121

41149 01258

SEAL: VICTOR ELIAS EISENSTEIN.- AR 9212

り
思 STREE 33019


TAC & PDB


DEVELOPMENT


BOARD SUBMITTAL AS INDICATED


2-27-2017 PROJECT No:


CHECKED BY: DRAWN BY: YEE NATALIE F

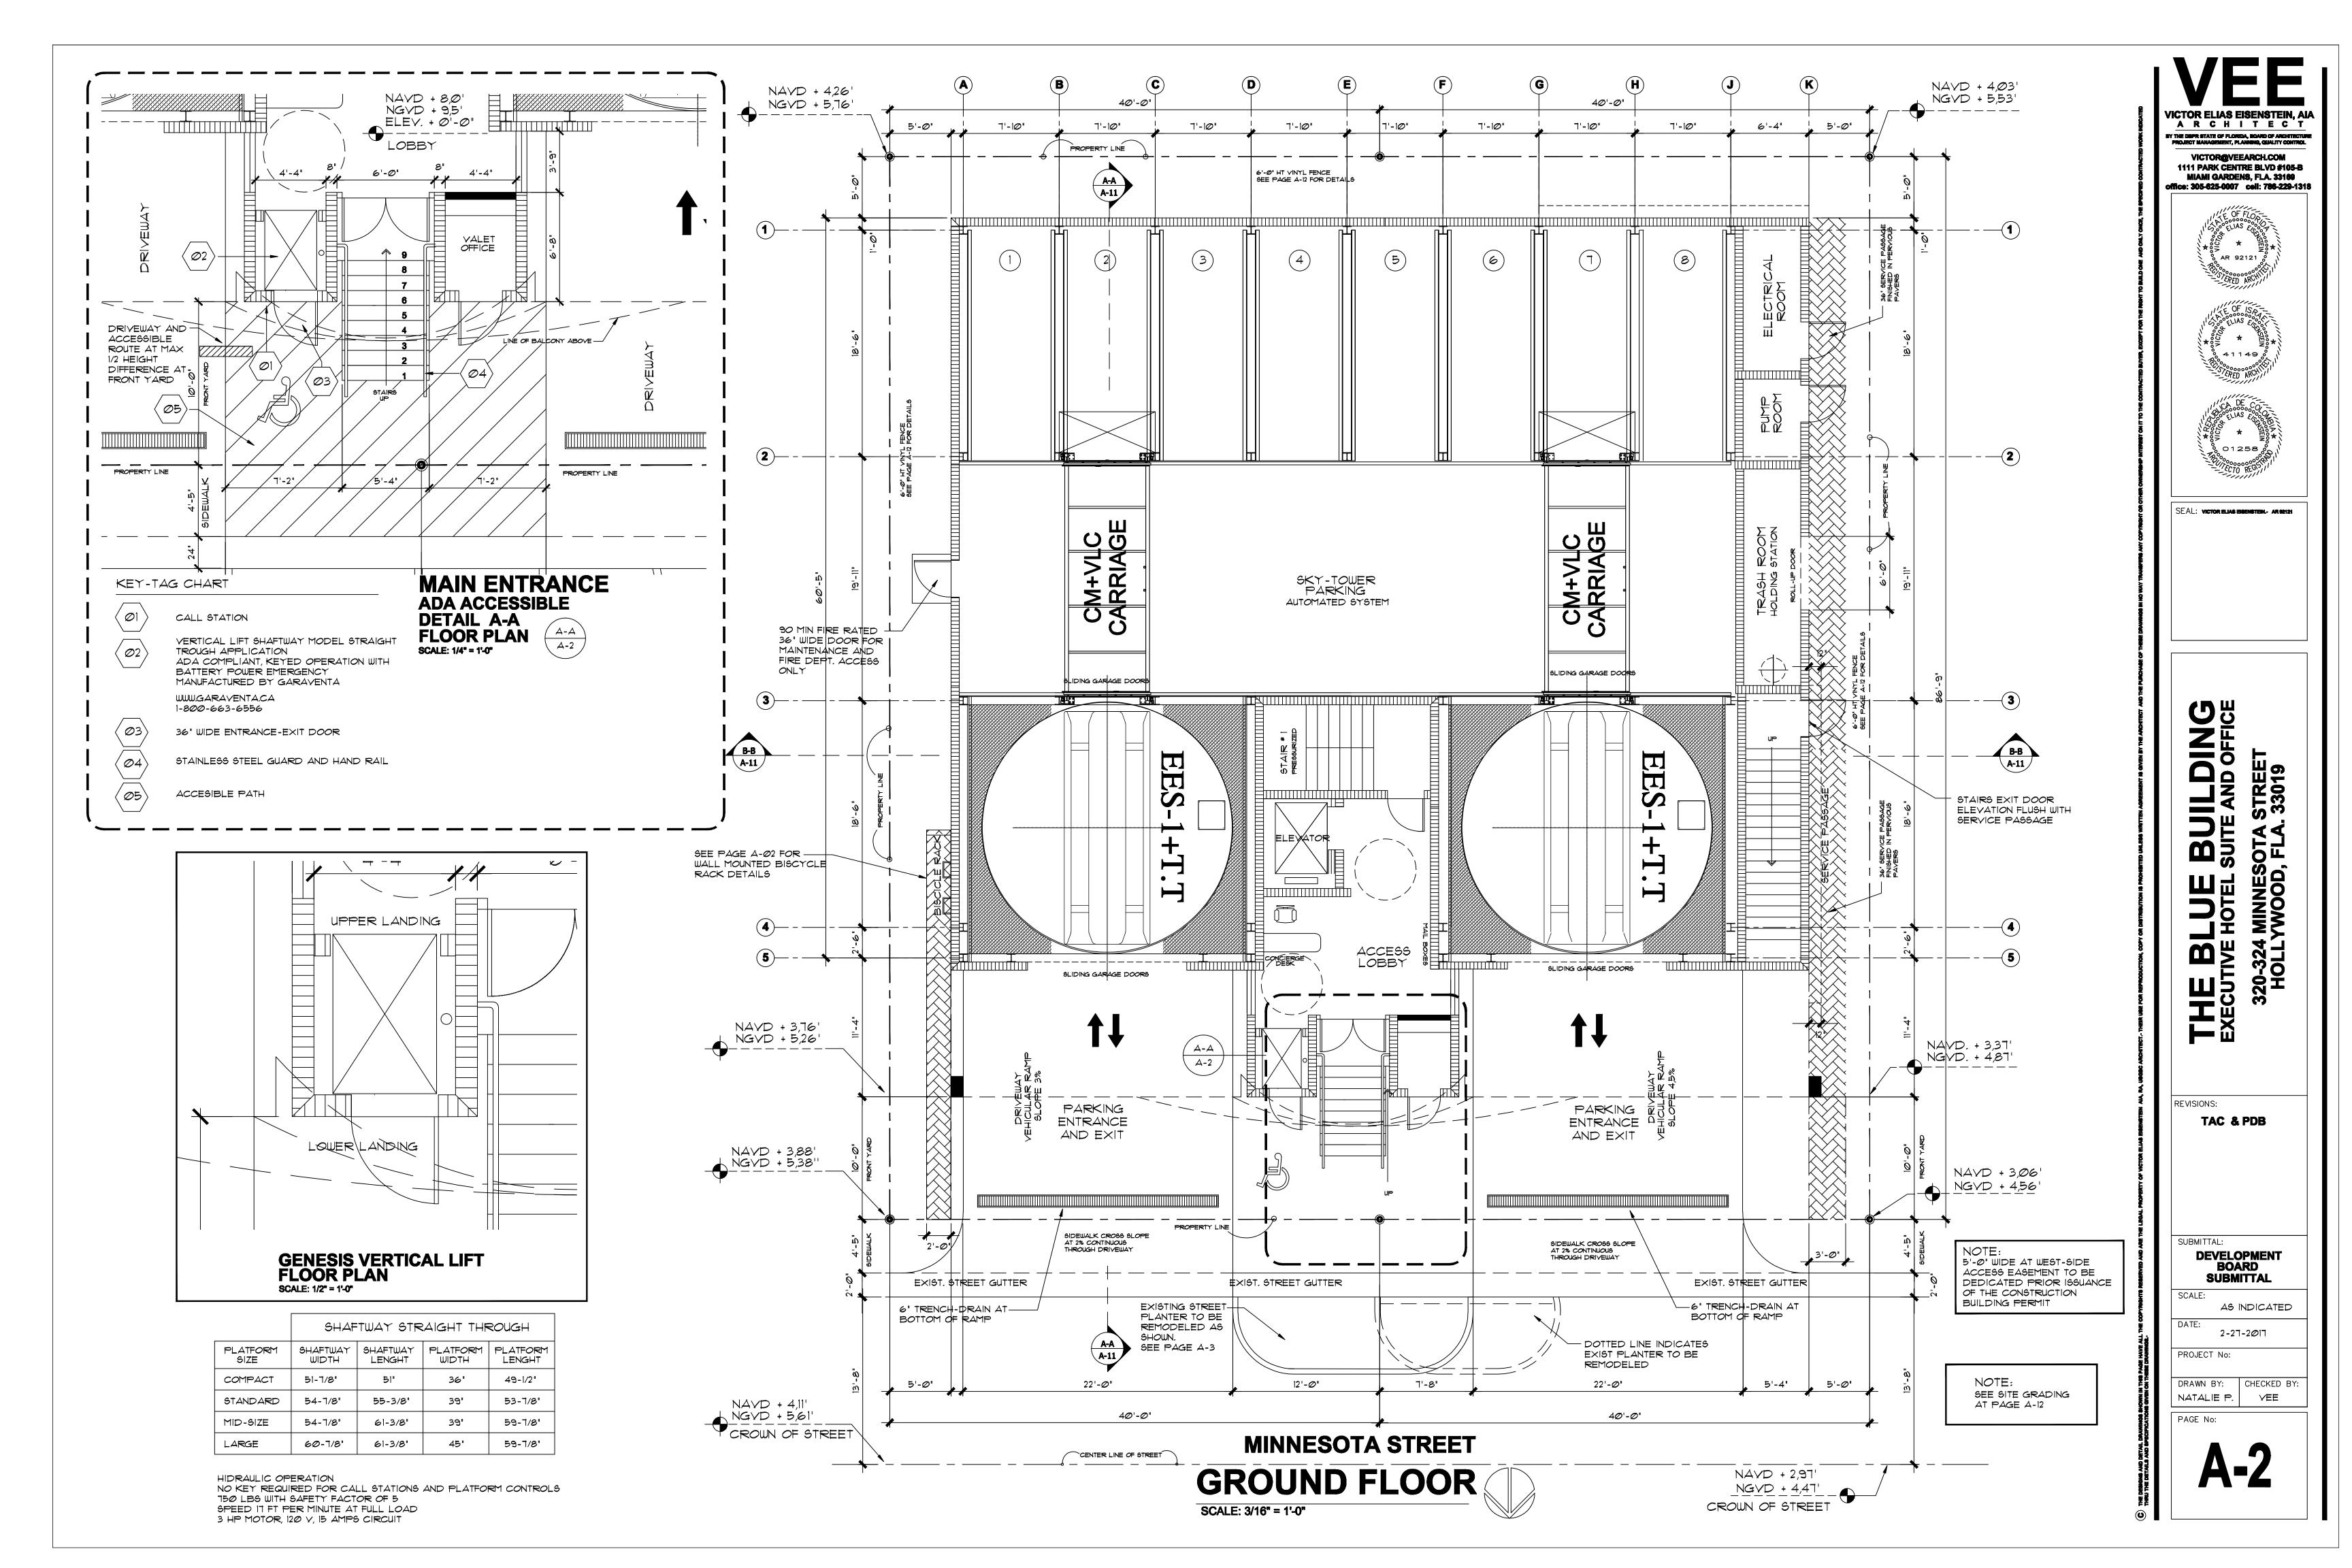


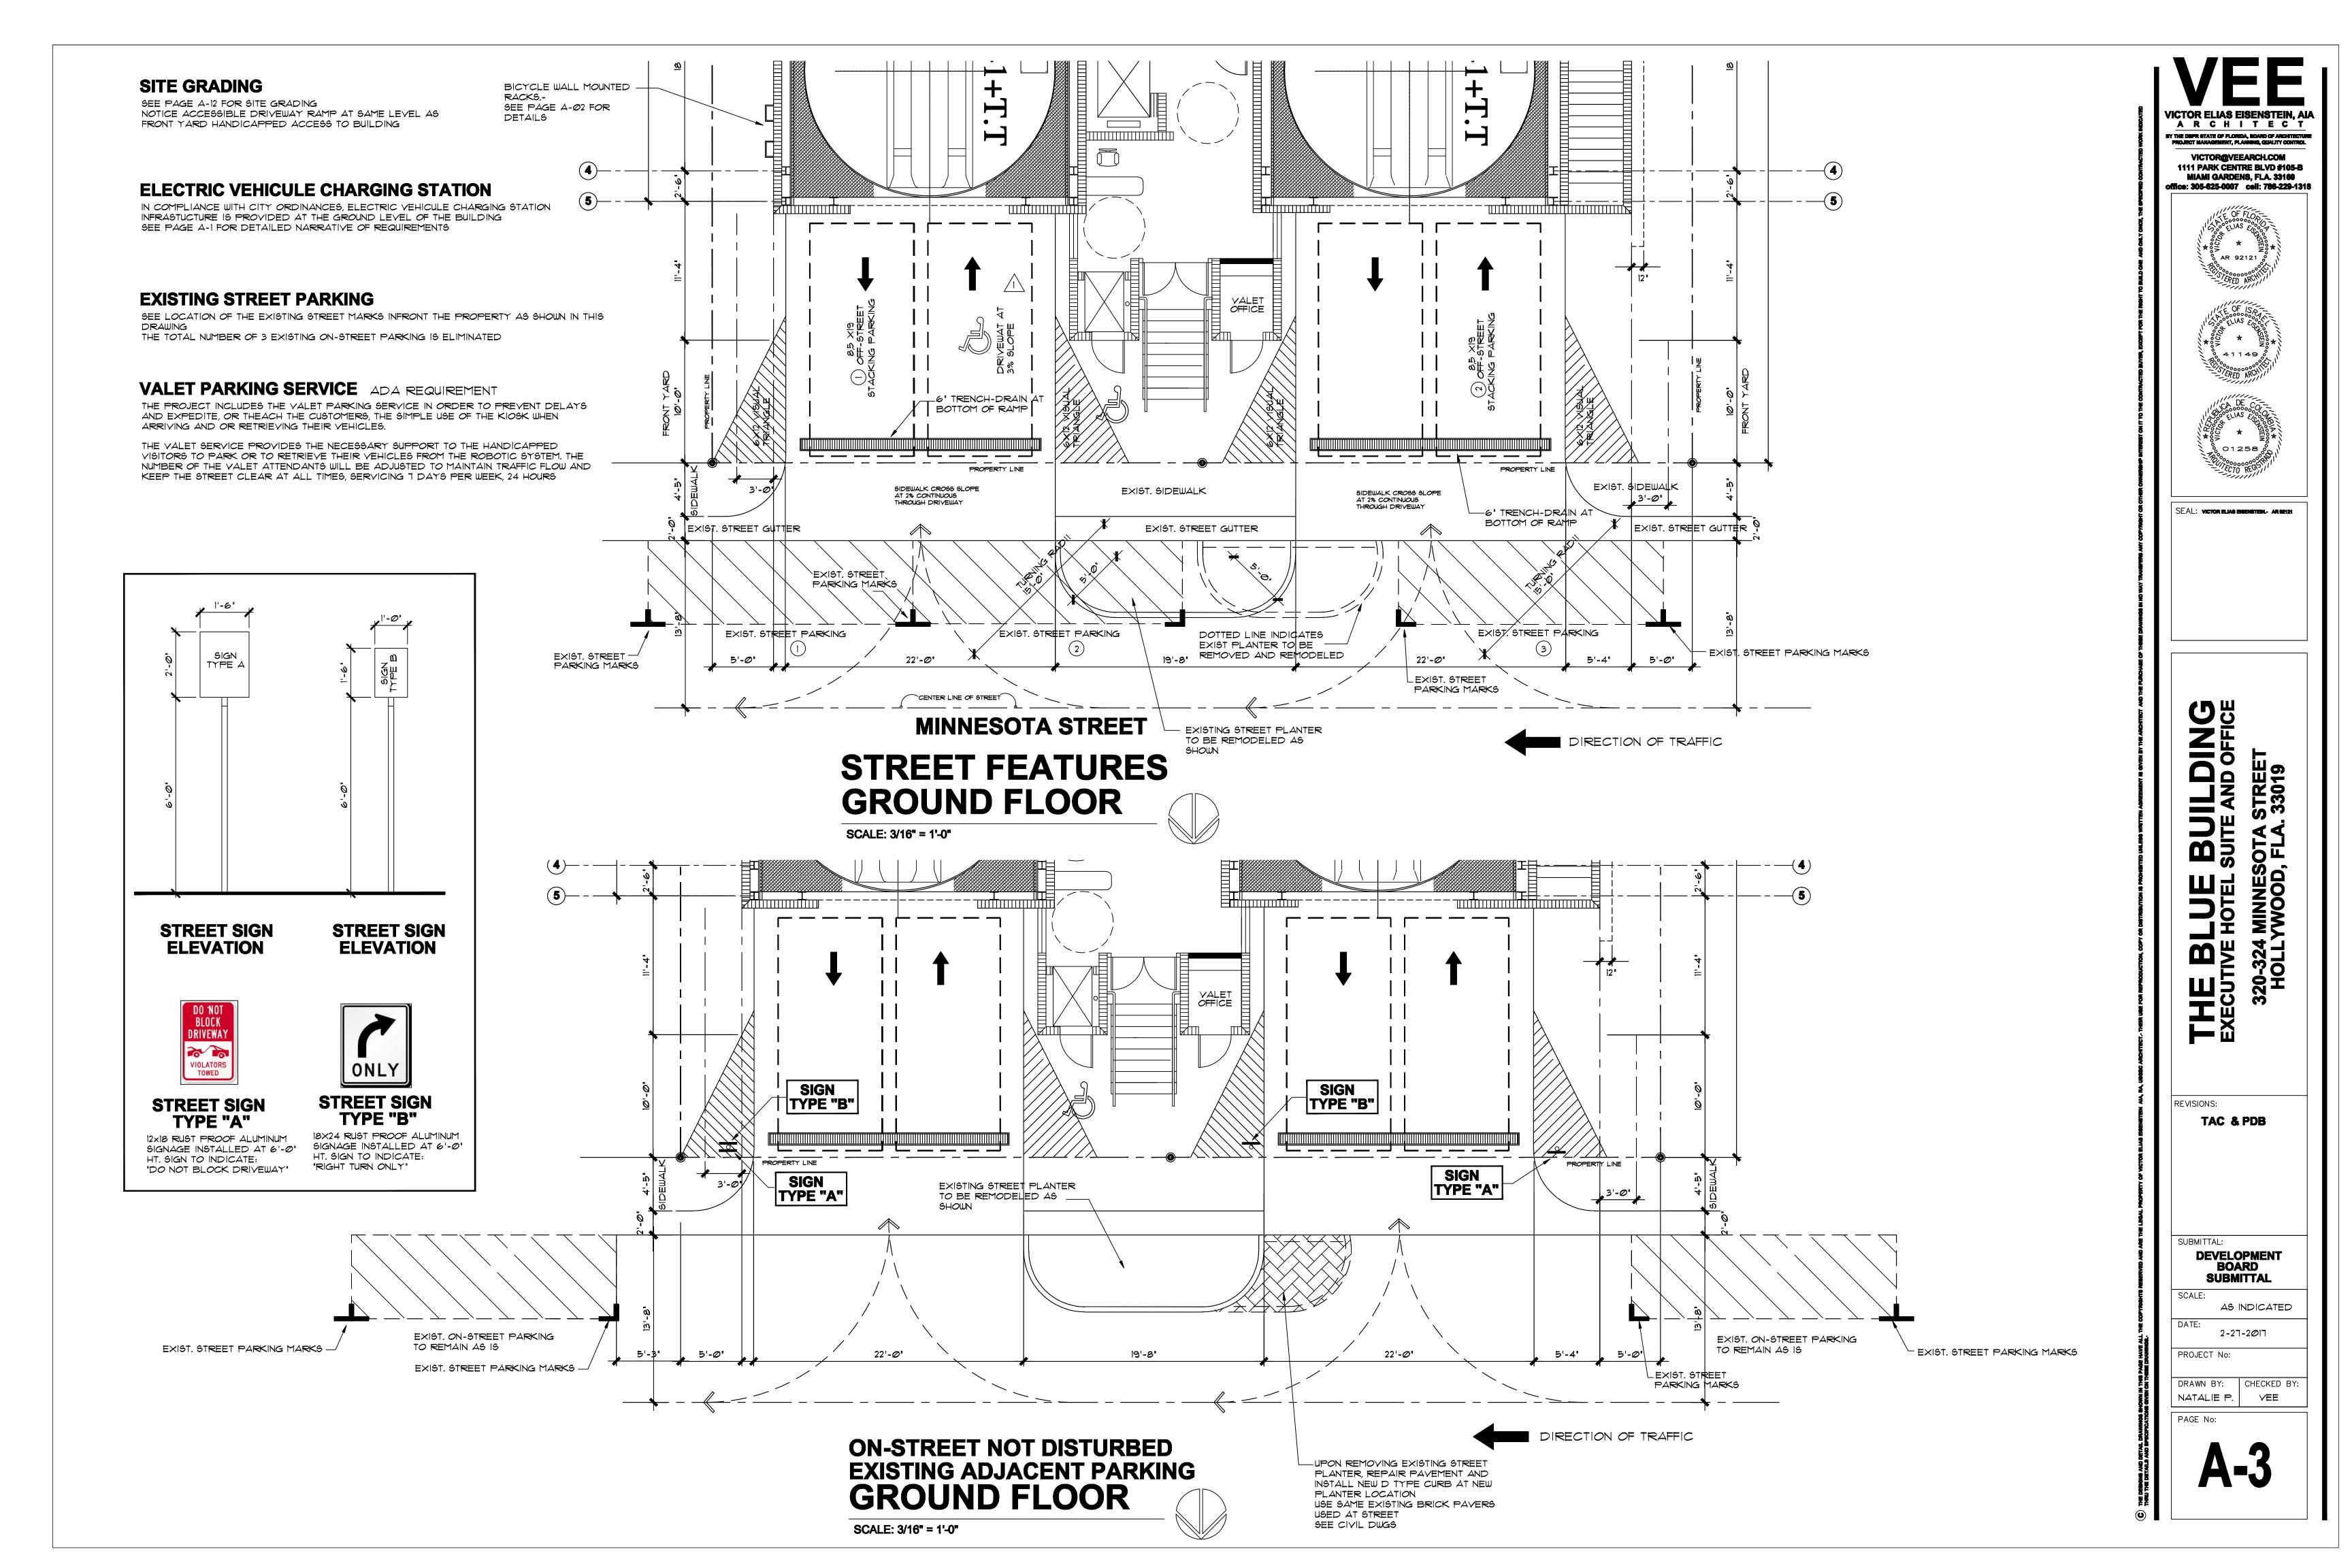

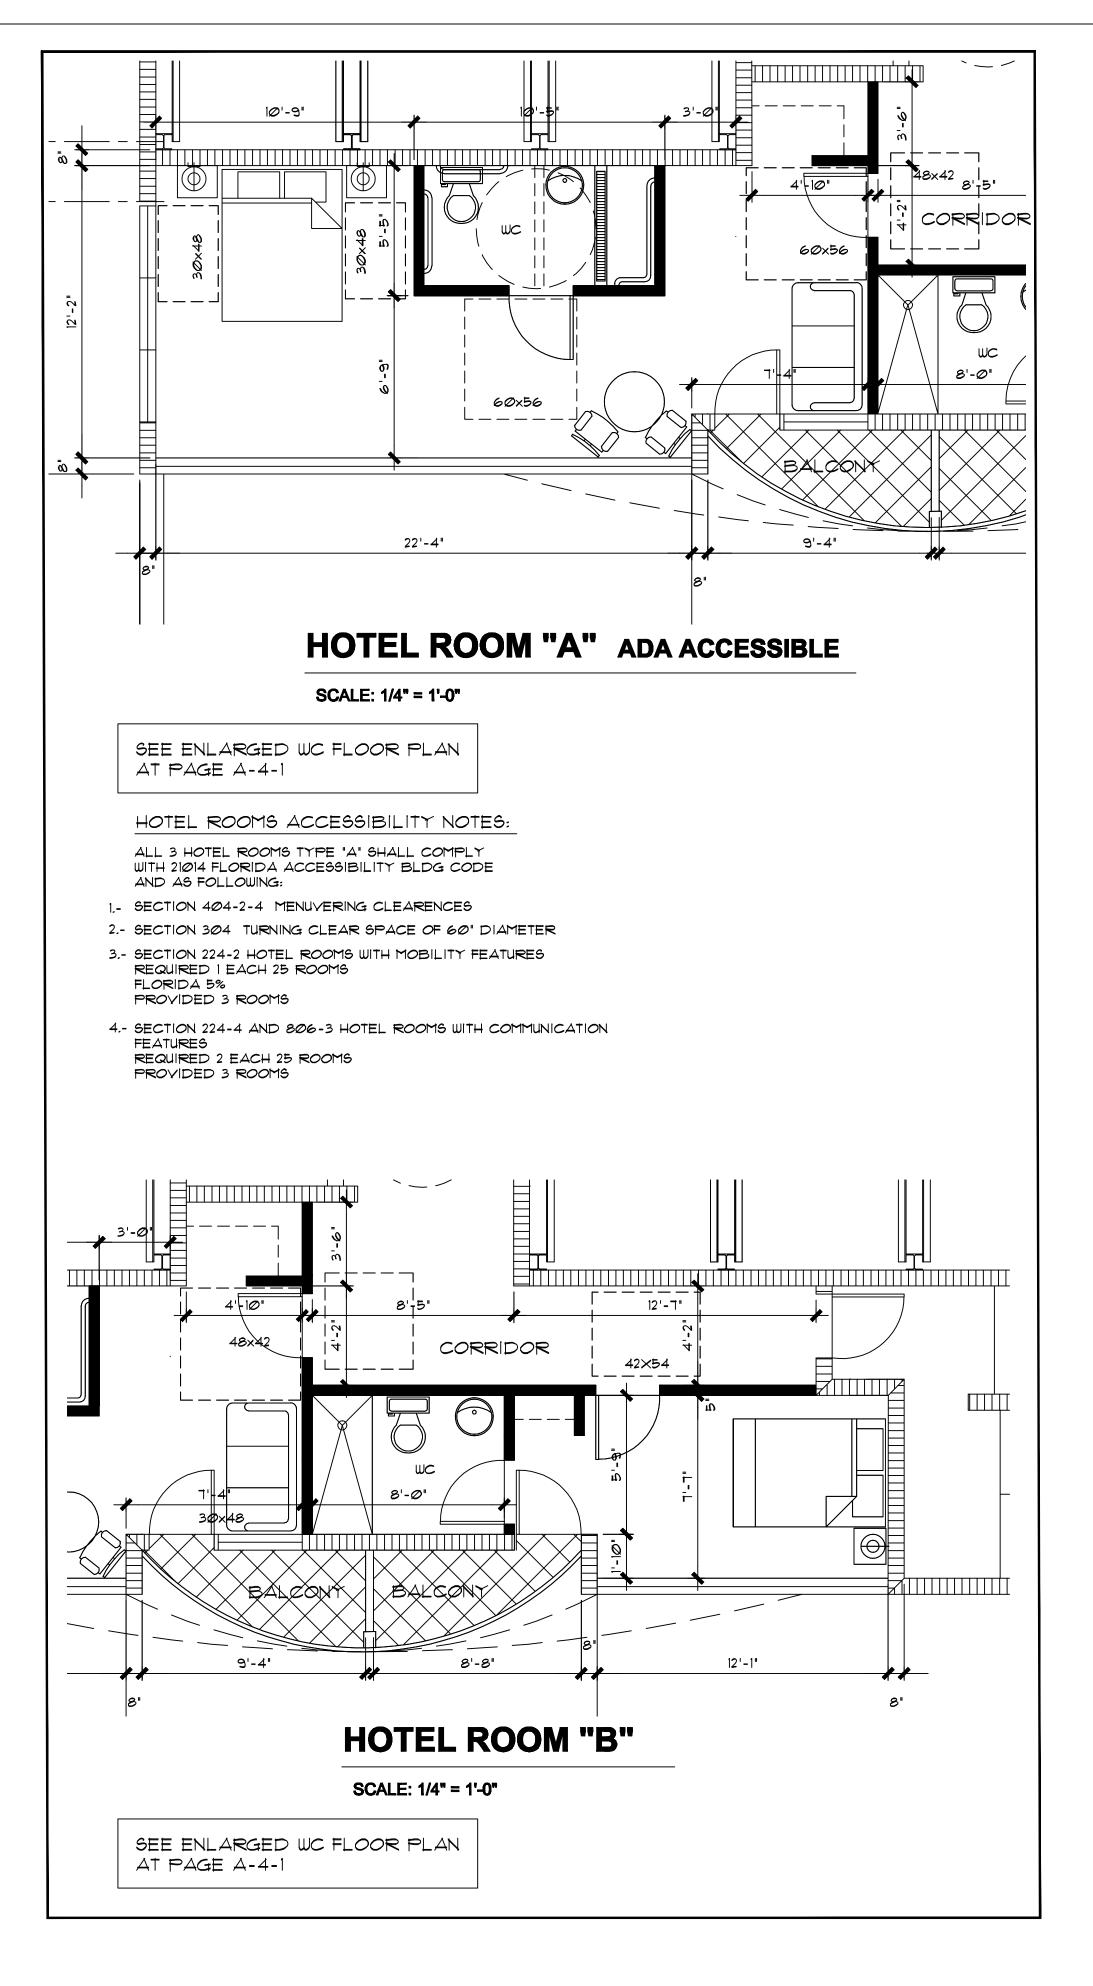

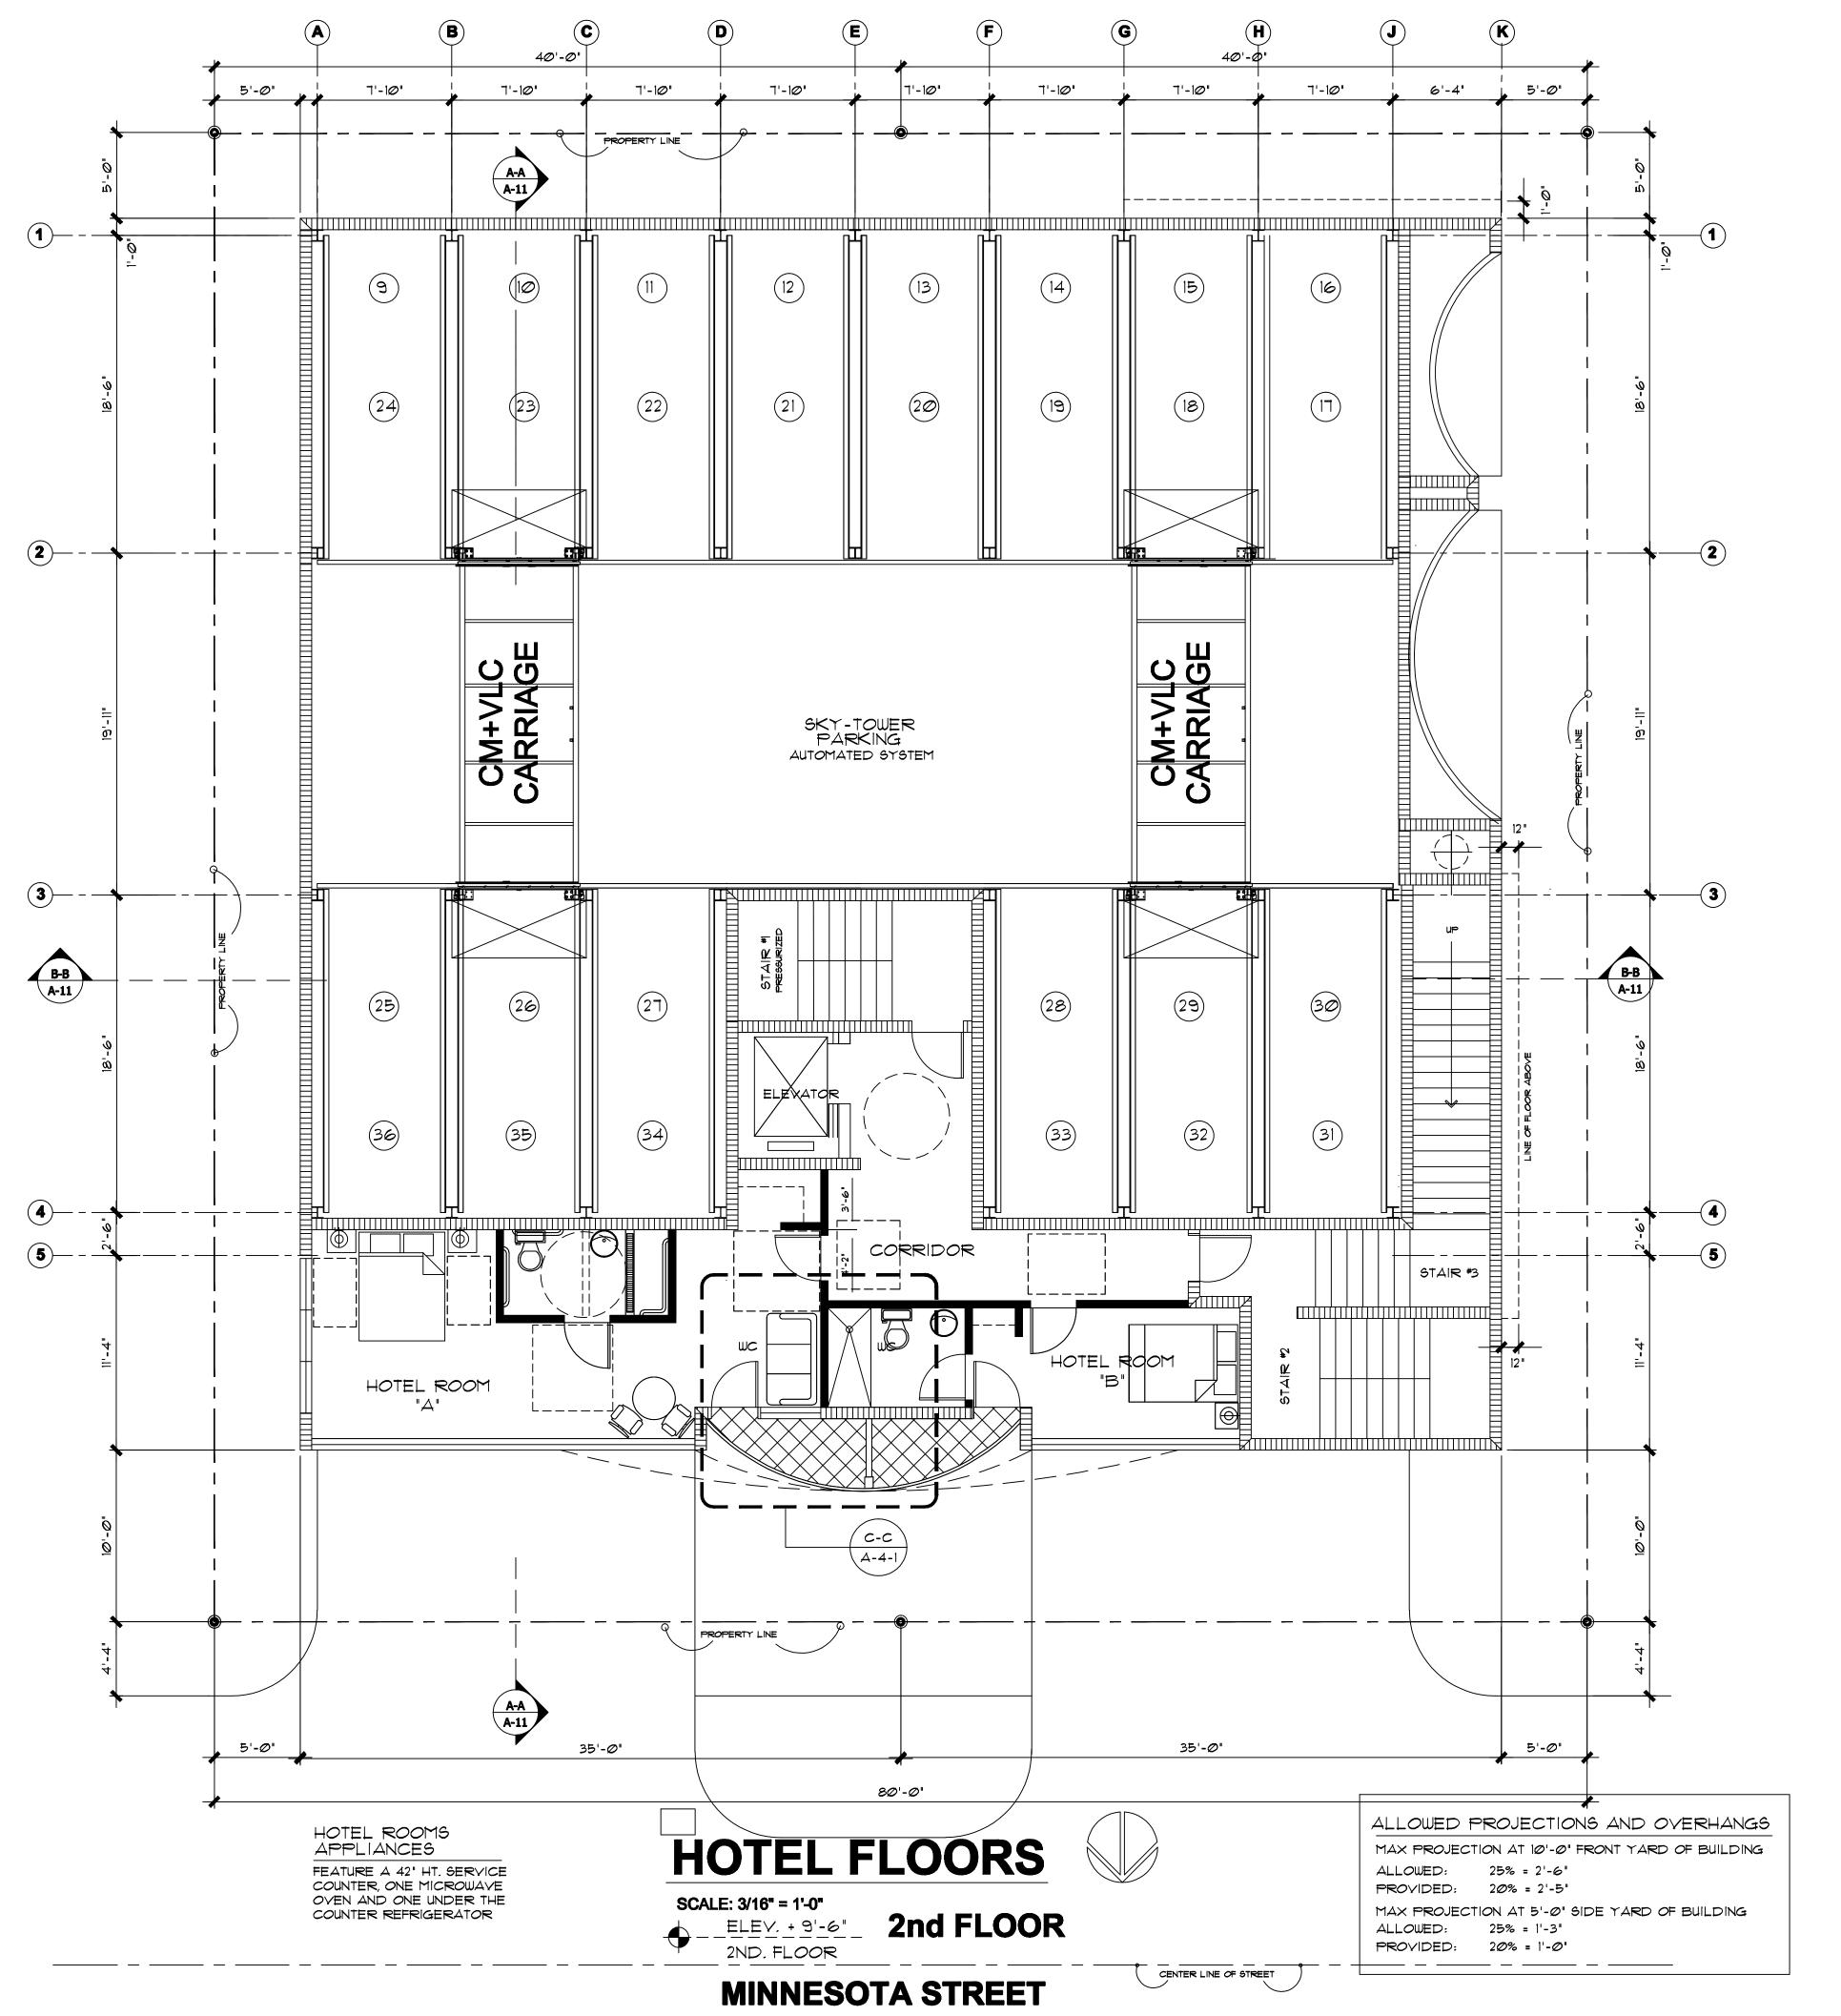

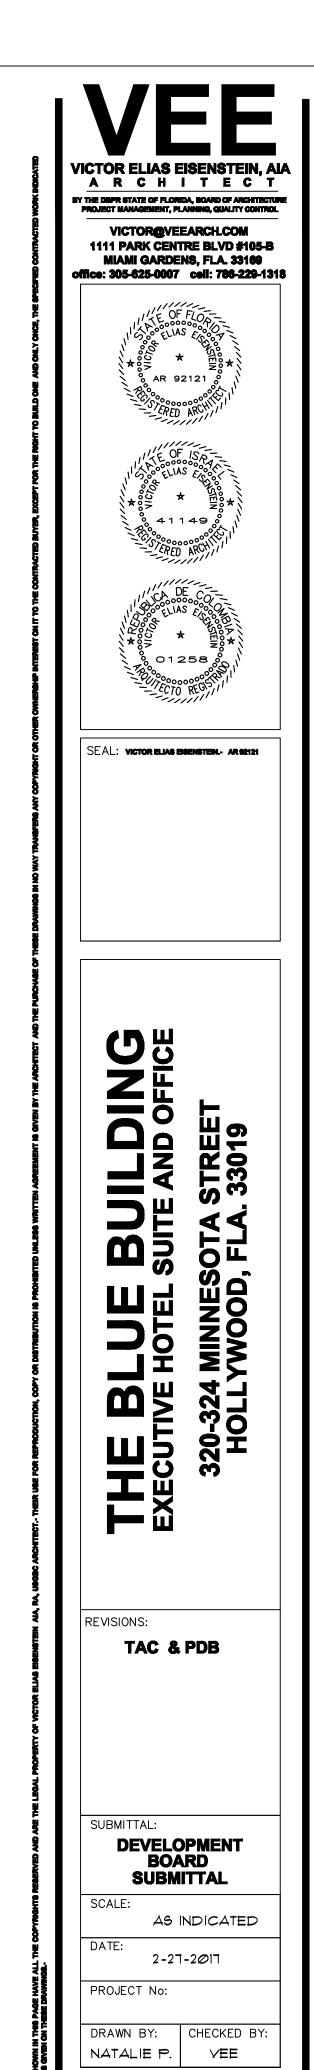

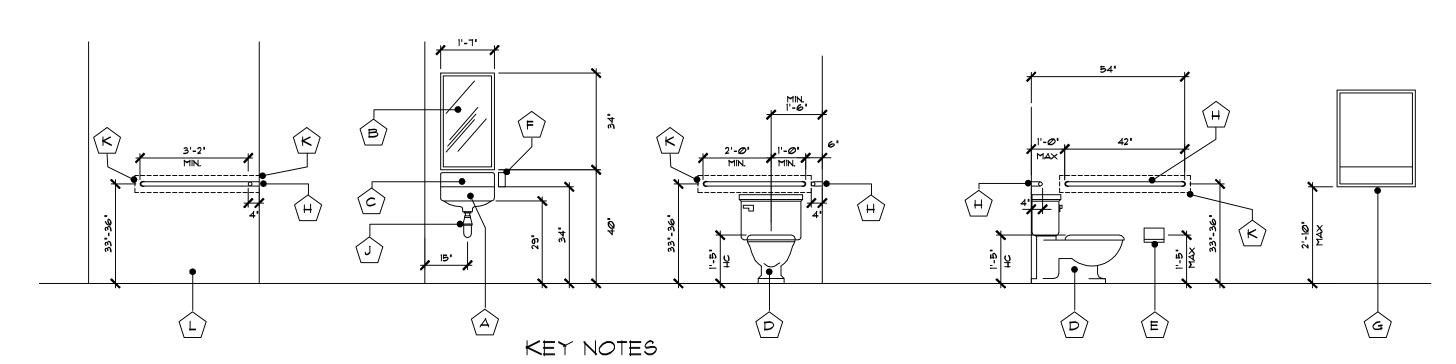


- WALL MOUNTED LAVATORY RIM OR COUNTER NO HIGHER THAN 34" ABOVE THE FINISH FLOOR.- 2014 FBC. 606-3
- MIRROR SHALL BE MOUNTED SLANTED OVER THE LAVATORY AND THE BOTTOM EDGE OF THE REFLECTING SURFACE NO HIGHER THAN 40" ABOVE THE FINISH FLOOR.-2014 FBC. 603-3
- FAUCET CONTROL VALVES SHALL BE OPERABLE WITH ONE HAND AND SHALL NOT REQUIRE TIGHT GRASPING, PINCHING OR TWISTING THE WRIST.-FORCE REQUIRED TO ACTIVATE CONTROLS SHALL BE NO GREATER THAN 5 LBS.-2014 FBC SEC. 309-4
- HANDICAP TOILET WITH TOP OF THE SEAT BETWEEN 17" AND 19" AFF 2014 FBC. SEC. 604-4
- SURFACE MOUNTED TOILET TISSUE DISPENSER

F LIQUID SOAP DISPENSER

609-6

- SEAT COVER DISPENSER
- STAINLESS STEEL GRAB BAR DIAM. 1-1/4 TO 1-1/2.THE CLEAR SPACE BETWEEN THE WALL AND THE
  GRAB BAR SHALL BE 1-1/2
  2010 FBC 609
  GRAB BARS SHALL NOT ROTATE WITHIN THEIR
  FITTINGS.-
- HOT WATER AND DRAIN PIPES UNDER THE LAYATORIES SHALL BE INSULATED OR OTHERWISE CONFIGURED TO PROTECT AGAINST CONTACT.THERE SHALL BE NO SHARP OR ABRASIVE SURFACES UNDER LAYATORIES.2014 FBC 606-5
- REINFORCED AREAS INSIDE PARTITION WALLS FOR INSTALLATION OF GRAB BARS.2014 FBC 609-8
- (L) CONTINUOUS DRAIN BARRIER FREE SHOWER

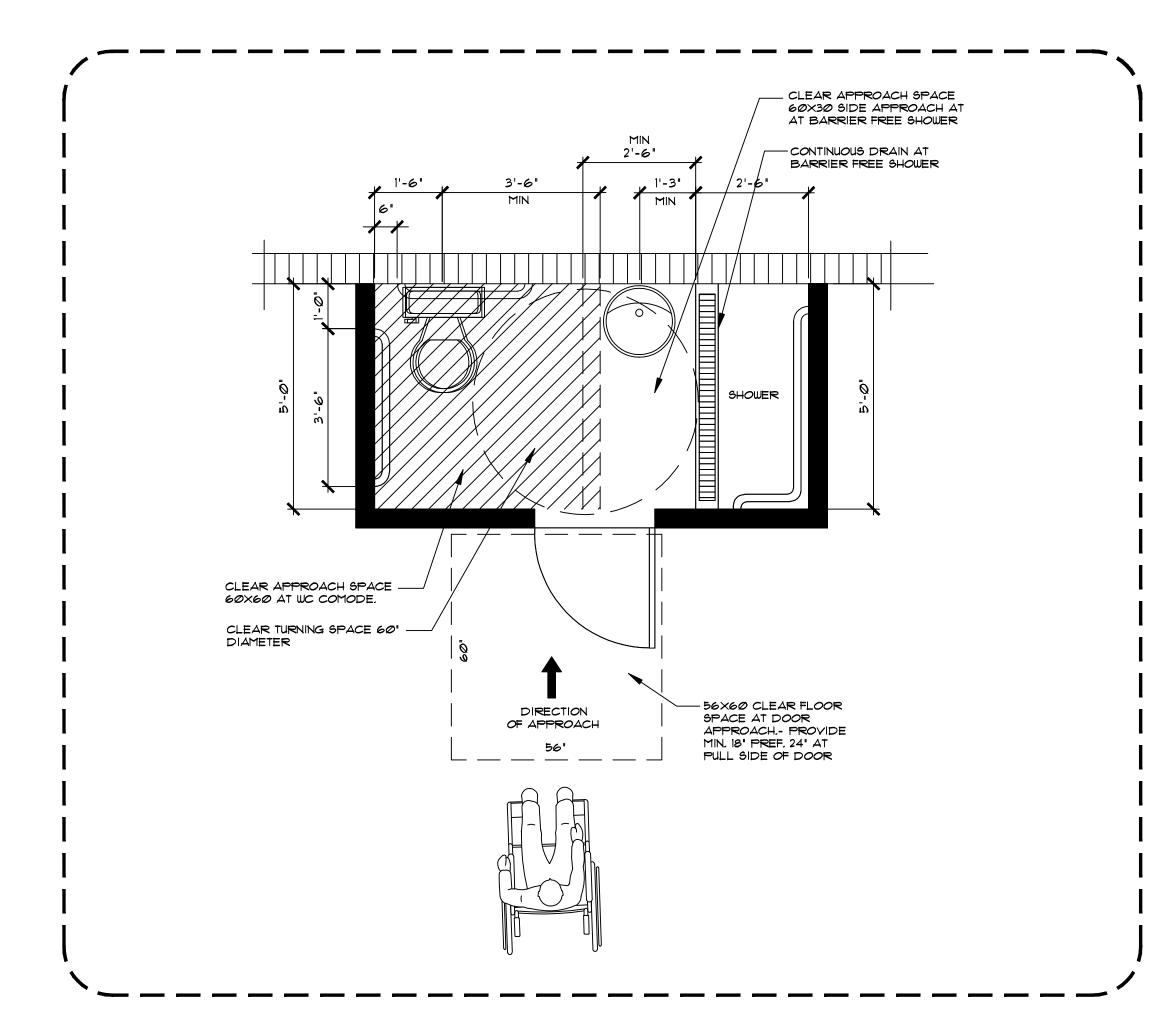


## REQUIRED MIN. FREE FLOOR SPACE HOTEL ROOMS TYPE "A" ADA ACCESSIBLE

#### **TYPICAL WC. DETAIL**

NOT TO SCALE



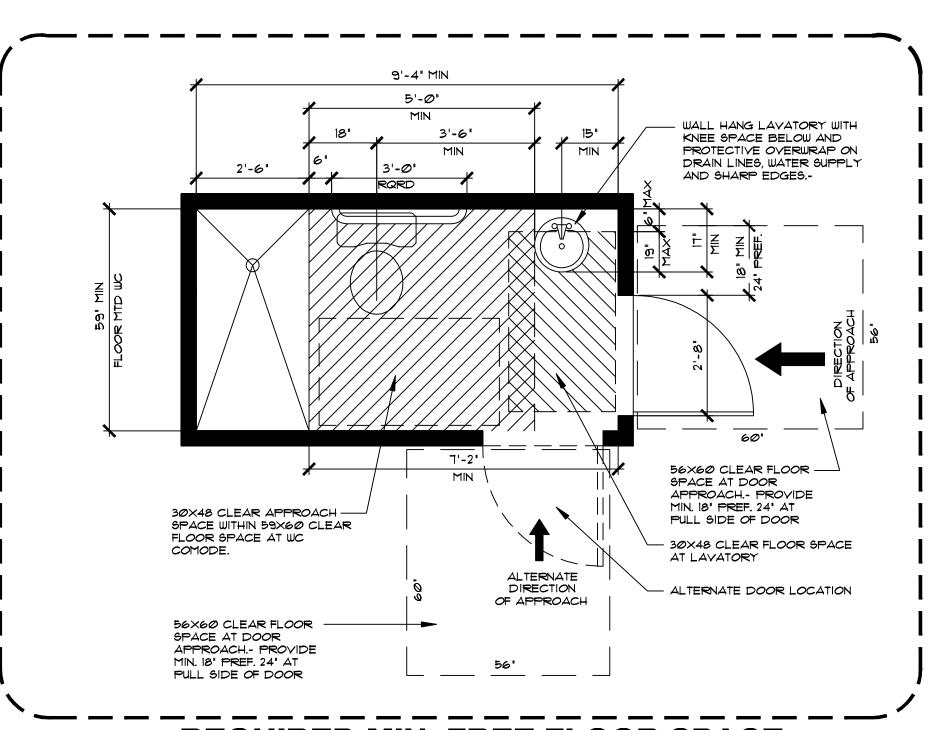

REQUIRED MIN. FREE FLOOR SPACE HOTEL ROOMS TYPE "B"

**TYPICAL WC. DETAIL** 

NOT TO SCALE



VICTOR ELIAS EISENSTEIN, AIA
ARCHITECTURE
PROJECT MANAGEMENT, PLANNING, QUALITY CONTROL

VICTOR@VEEARCH.COM
1111 PARK CENTRE BLVD #105-B
MIAMI GARDENS, FLA. 33169
office: 305-625-0007 ceil: 788-229-1318



SEAL: VICTOR ELIAS EISENSTEIN.- A

LDING IND OFFICE

THE BLUE BUILDIN

EXECUTIVE HOTEL SUITE AND OFF

320-324 MINNESOTA STREET

REVISIONS:

TAC & PDB

JBMITTAL:

DEVELOPMENT
BOARD
SUBMITTAL

SCALE:

AS INDICATED

DATE:


2-27-2017

PROJECT No:

DRAWN BY: CHECKED BY:
NATALIE P. VEE

PAGE No:

A-4-1

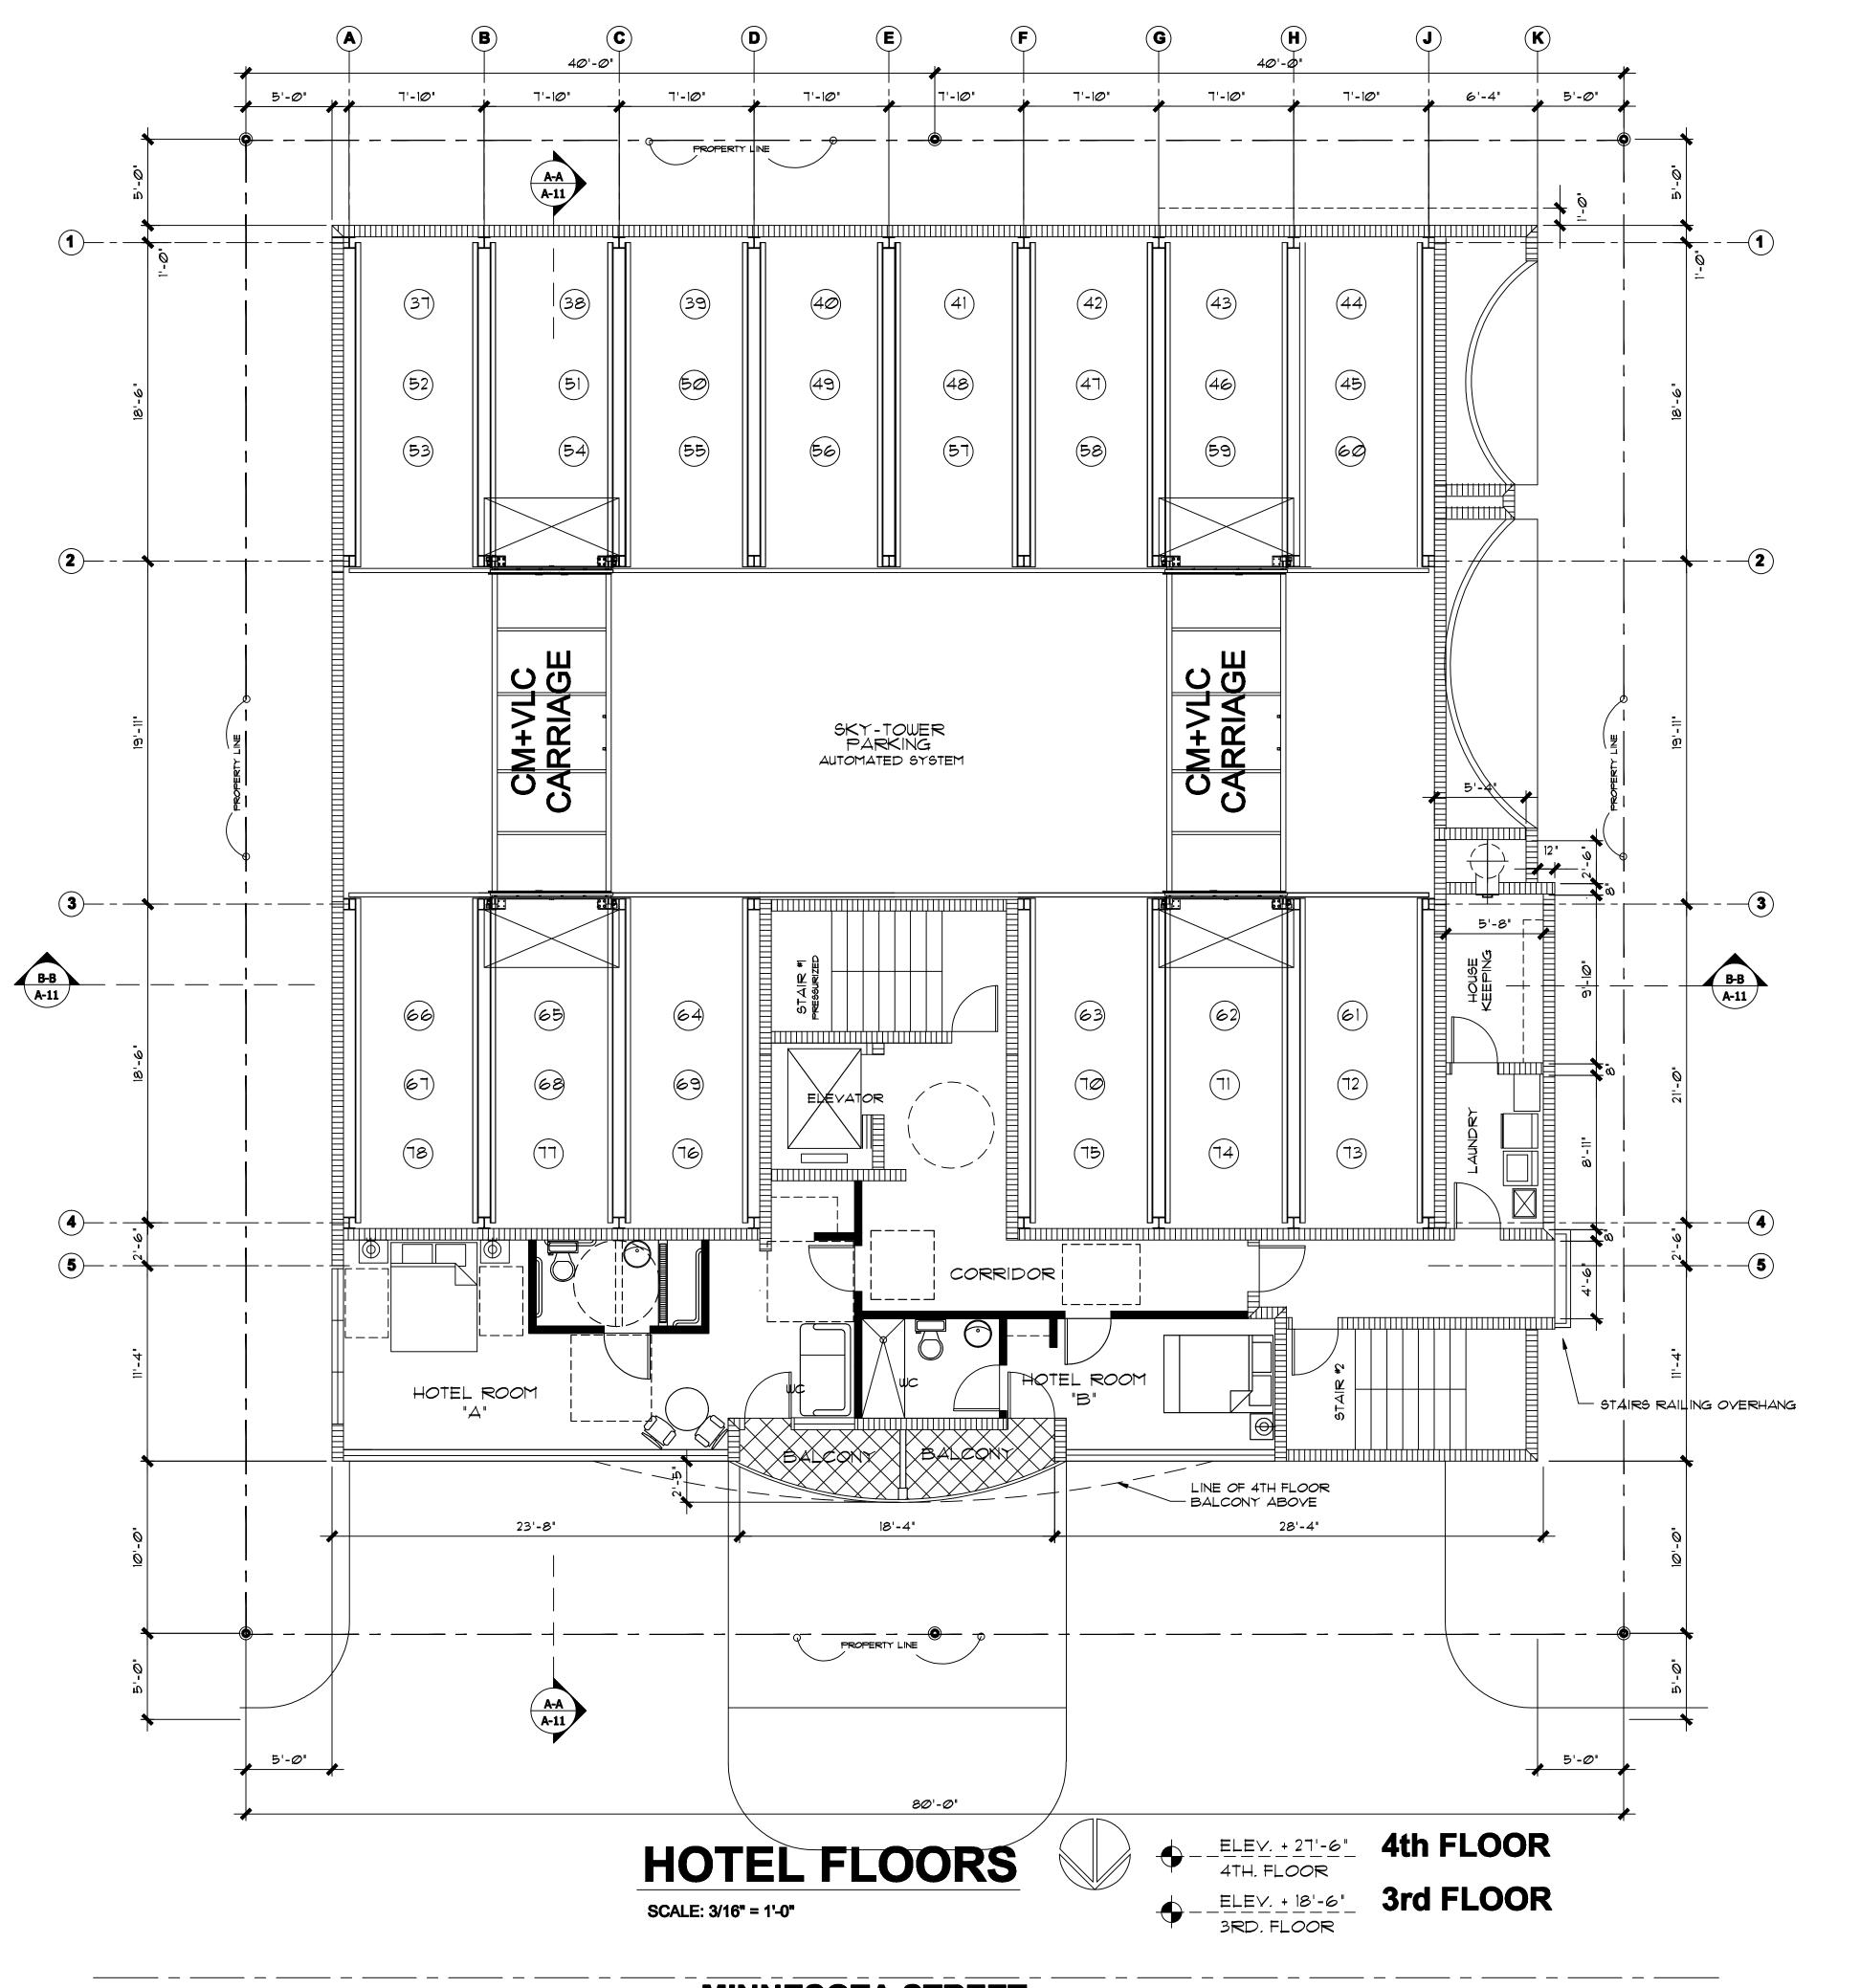

ADA GENERAL NOTE

ALL HOTEL ROOMS "TYPE A" SHALL
COMPLY WITH 21014 FLORIDA
ACCESSIBILITY BLDG CODE
SECTION 304 AND 404-2 AS WELL
AS SECTION 224-2 AND 224-4

HOTEL ROOMS
APPLIANCES
FEATURE A 42" HT. SERVICE
COUNTER, ONE MICROWAVE
OVEN AND ONE UNDER THE
COUNTER REFRIGERATOR

ALLOWED PROJECTIONS AND OVERHANGS

MAX PROJECTION AT 10'-0" FRONT YARD OF BUILDING

ALLOWED: 25% = 2'-6"

PROVIDED: 20% = 2'-5"

MAX PROJECTION AT 5'-0" SIDE YARD OF BUILDING

ALLOWED: 25% = 1'-3"

PROVIDED: 20% = 1'-0"

SUBMITTAL:

DEVELOPMENT
BOARD
SUBMITTAL

TAC & PDB

THE BLUE EXECUTIVE HOTEL \$

VICTOR ELIAS EISENSTEIN, AIA ARCHITECT

BY THE DBPR STATE OF FLORIDA, BOARD OF ARCHITECTUR PROJECT MANAGEMENT, PLANNING, QUALITY CONTROL

VICTOR@VEEARCH.COM 1111 PARK CENTRE BLVD #105-B MIAMI GARDENS, FLA. 33169 office: 305-625-0007 cell: 786-229-1318

SEAL: VICTOR ELIAS EISENSTEIN.- AR 92121

STREET . 33019

320-324 MINNESOTA HOLLYWOOD, FLA.

SCALE:

AS INDICATED

DATE: 2-27-2017

PROJECT No:


DRAWN BY: CHECKED BY:

NATALIE P. VEE

**A-5** 

MINNESOTA STREET

CENTER LINE OF STREET

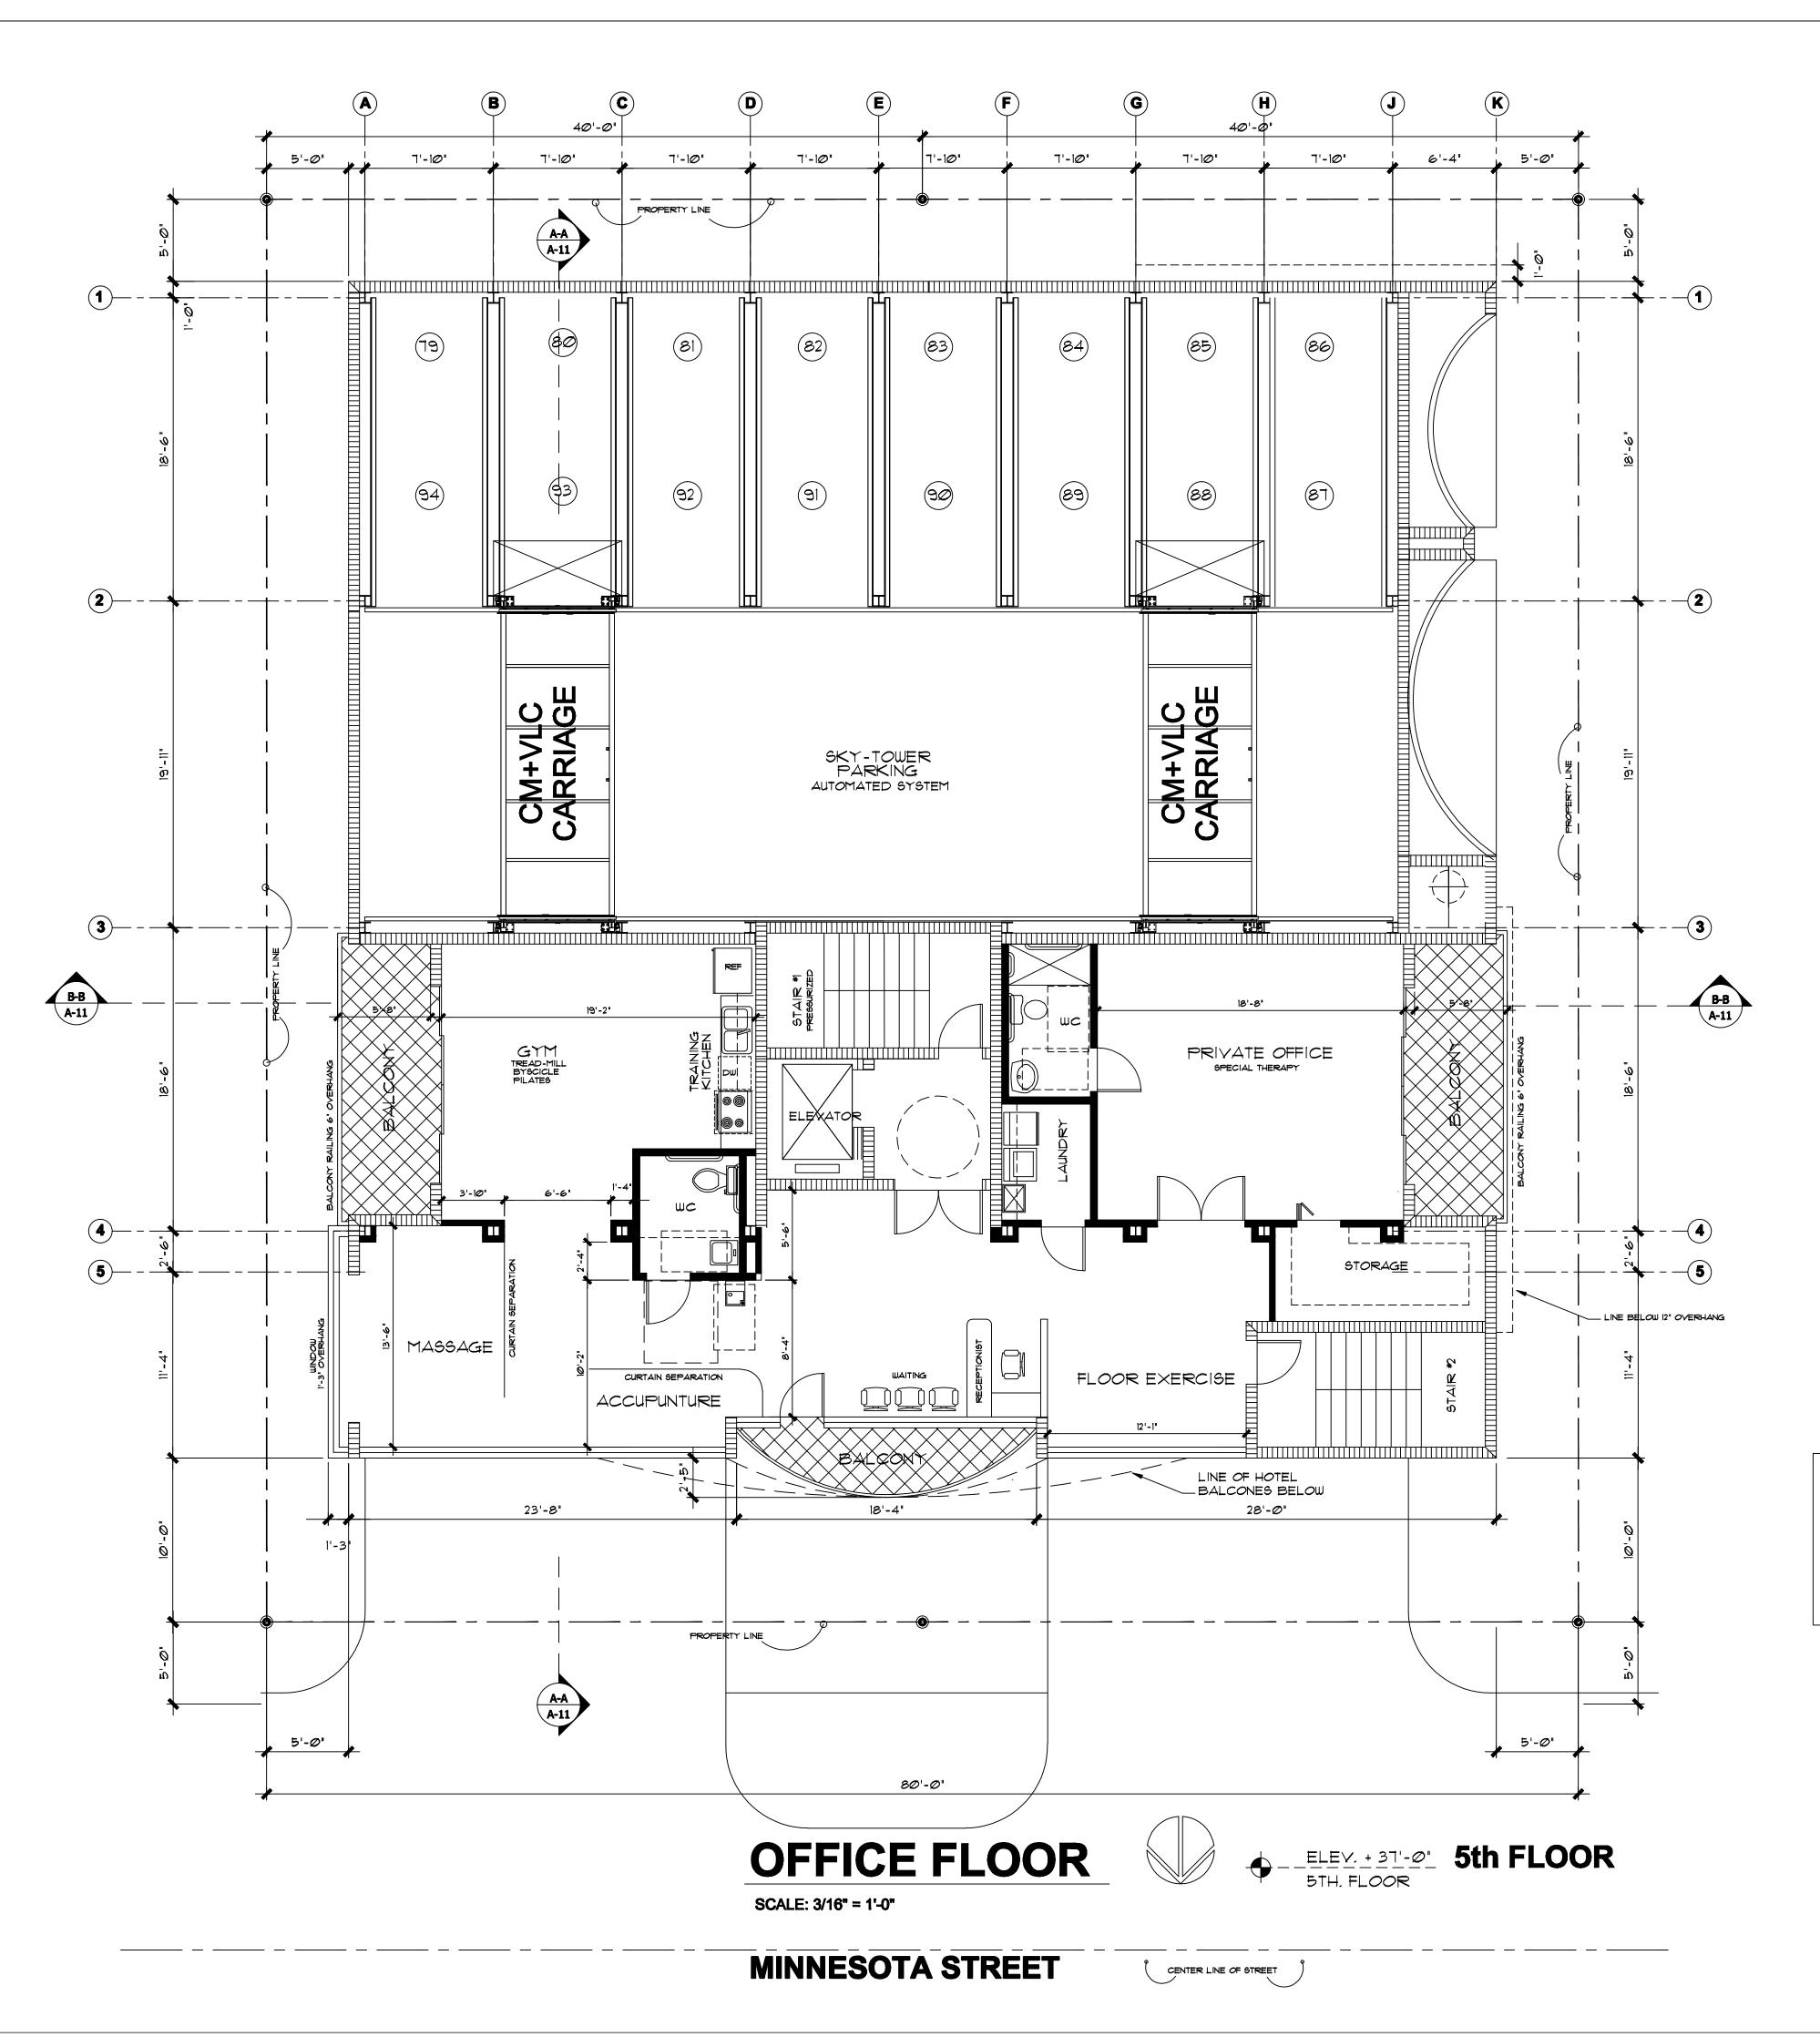

NOTICE:

THE DEPICTED KITCHEN AND ALL OF ITS APPLIANCES
AT THE OFFICE OF THE 5TH FLOOR IS INTENDED FOR
TRAINING PURPOSES ALTHOUGH, EQUIPMENT IS
FUNCTIONAL BUT NO COOKING IS PART OF THE THERAPY
PROVIDED

ALLOWED PROJECTIONS AND OVERHANGS

MAX PROJECTION AT 10'-0" FRONT YARD OF BUILDING

ALLOWED: 25% = 2'-6"
PROVIDED: 20% = 2'-5"

MAX PROJECTION AT 5'-0" SIDE YARD OF BUILDING

ALLOWED: 25% = 1'-3"
PROVIDED: 20% = 1'-0"

VICTOR ELIAS EISENSTEIN, AIA
ARCHITE CT
BY THE DEPR STATE OF FLORIDA, BOARD OF ARCHITECTURE
PROJECT MANAGEMENT, PLANNING, QUALITY CONTROL

VICTOR@VEEARCH.COM
1111 PARK CENTRE BLVD #105-B
MIAMI GARDENS, FLA. 33169
office: 305-625-0007 cell: 786-229-1318







SFAI: VICTOR ELIAS EIGENSTEIN. AF



THE BLUE BUILDII
EXECUTIVE HOTEL SUITE AND OF
320-324 MINNESOTA STREET
HOLLYWOOD, FLA. 33019

REVISIONS:

TAC & PDB

SUBMITTAL:

DEVELOPMENT
BOARD


BOARD SUBMITTAL SCALE: AS INDICATED

DATE: 2-27-2017

PROJECT No:

DRAWN BY: CHECKED BY:

NATALIE P. VEE
PAGE No:

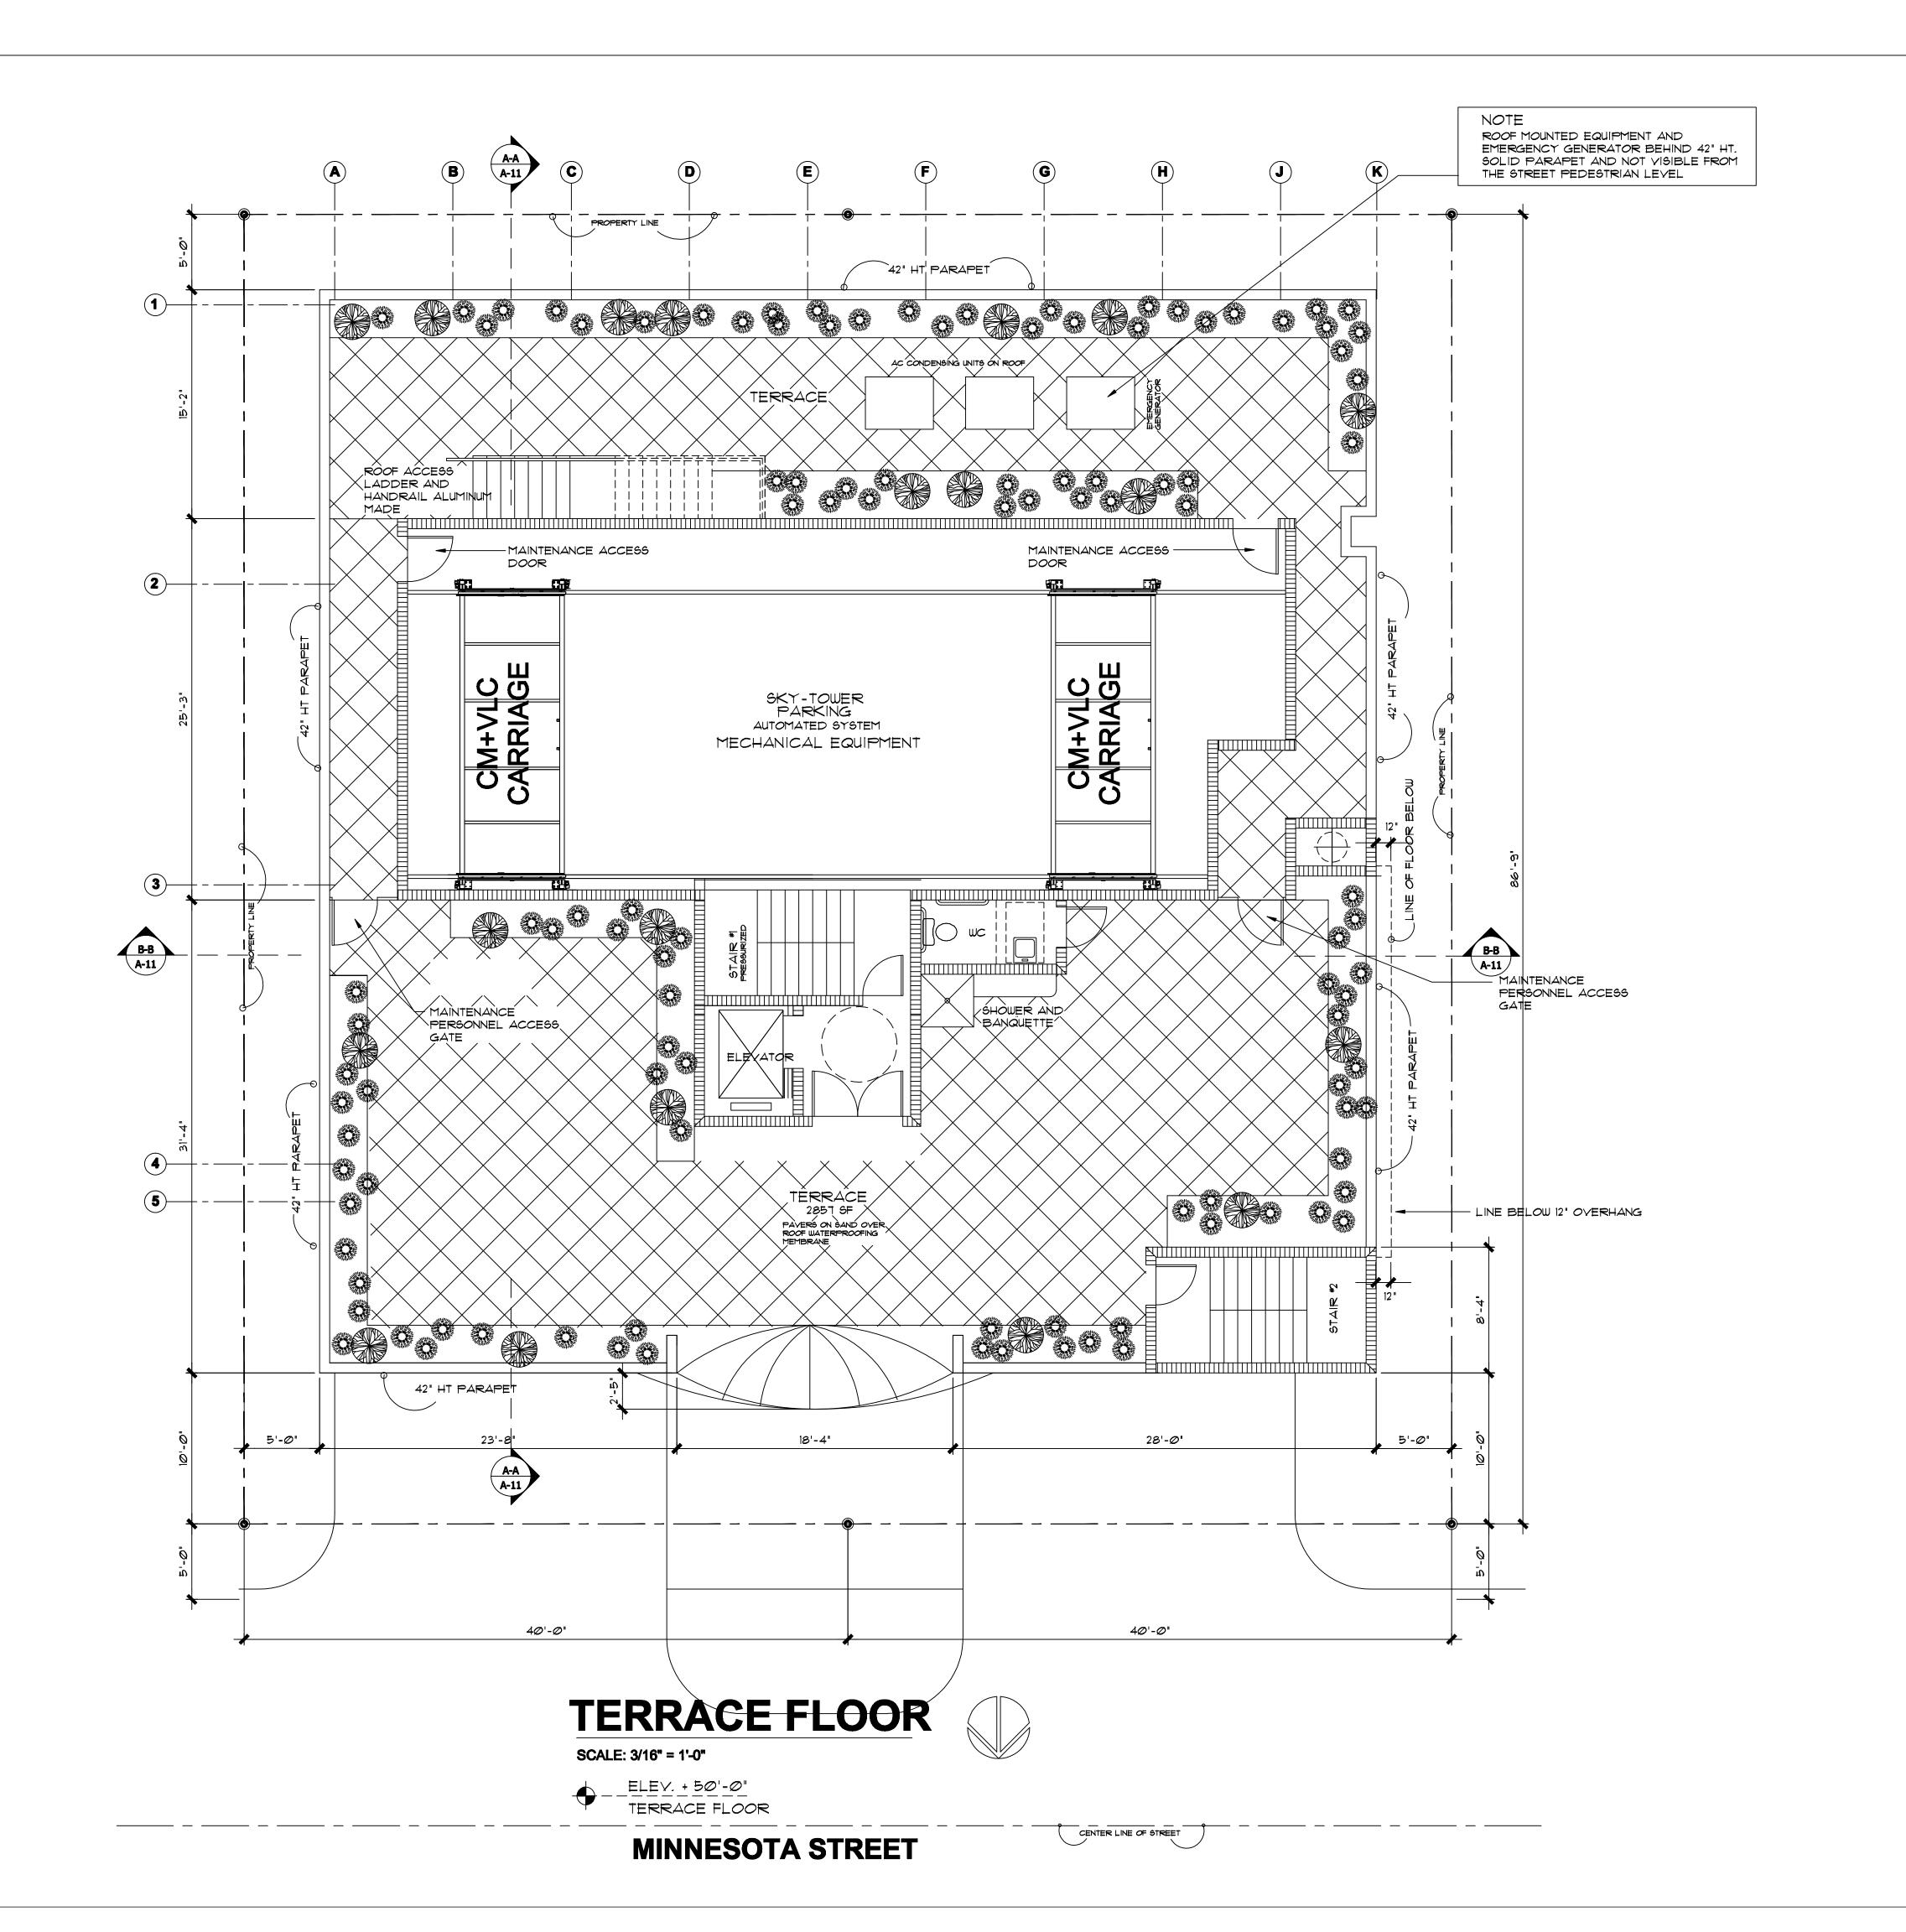

VICTOR ELIAS EISENSTEIN, AIA ARCHITECT BY THE DBPR STATE OF FLORIDA, BOARD OF ARCHITECTUR PROJECT MANAGEMENT, PLANNING, QUALITY CONTROL VICTOR@VEEARCH.COM 1111 PARK CENTRE BLVD #105-B MIAMI GARDENS, FLA. 33169 office: 305-625-0007 cell: 786-229-1318







ILDING AND OFFICE STREET 33019 320-324 MINNESOTA HOLLYWOOD, FLA. THE BLUE EXECUTIVE HOTEL &

TAC & PDB


DEVELOPMENT BOARD SUBMITTAL

AS INDICATED

2-27-2017 PROJECT No:

CHECKED BY: DRAWN BY:

VEE NATALIE P

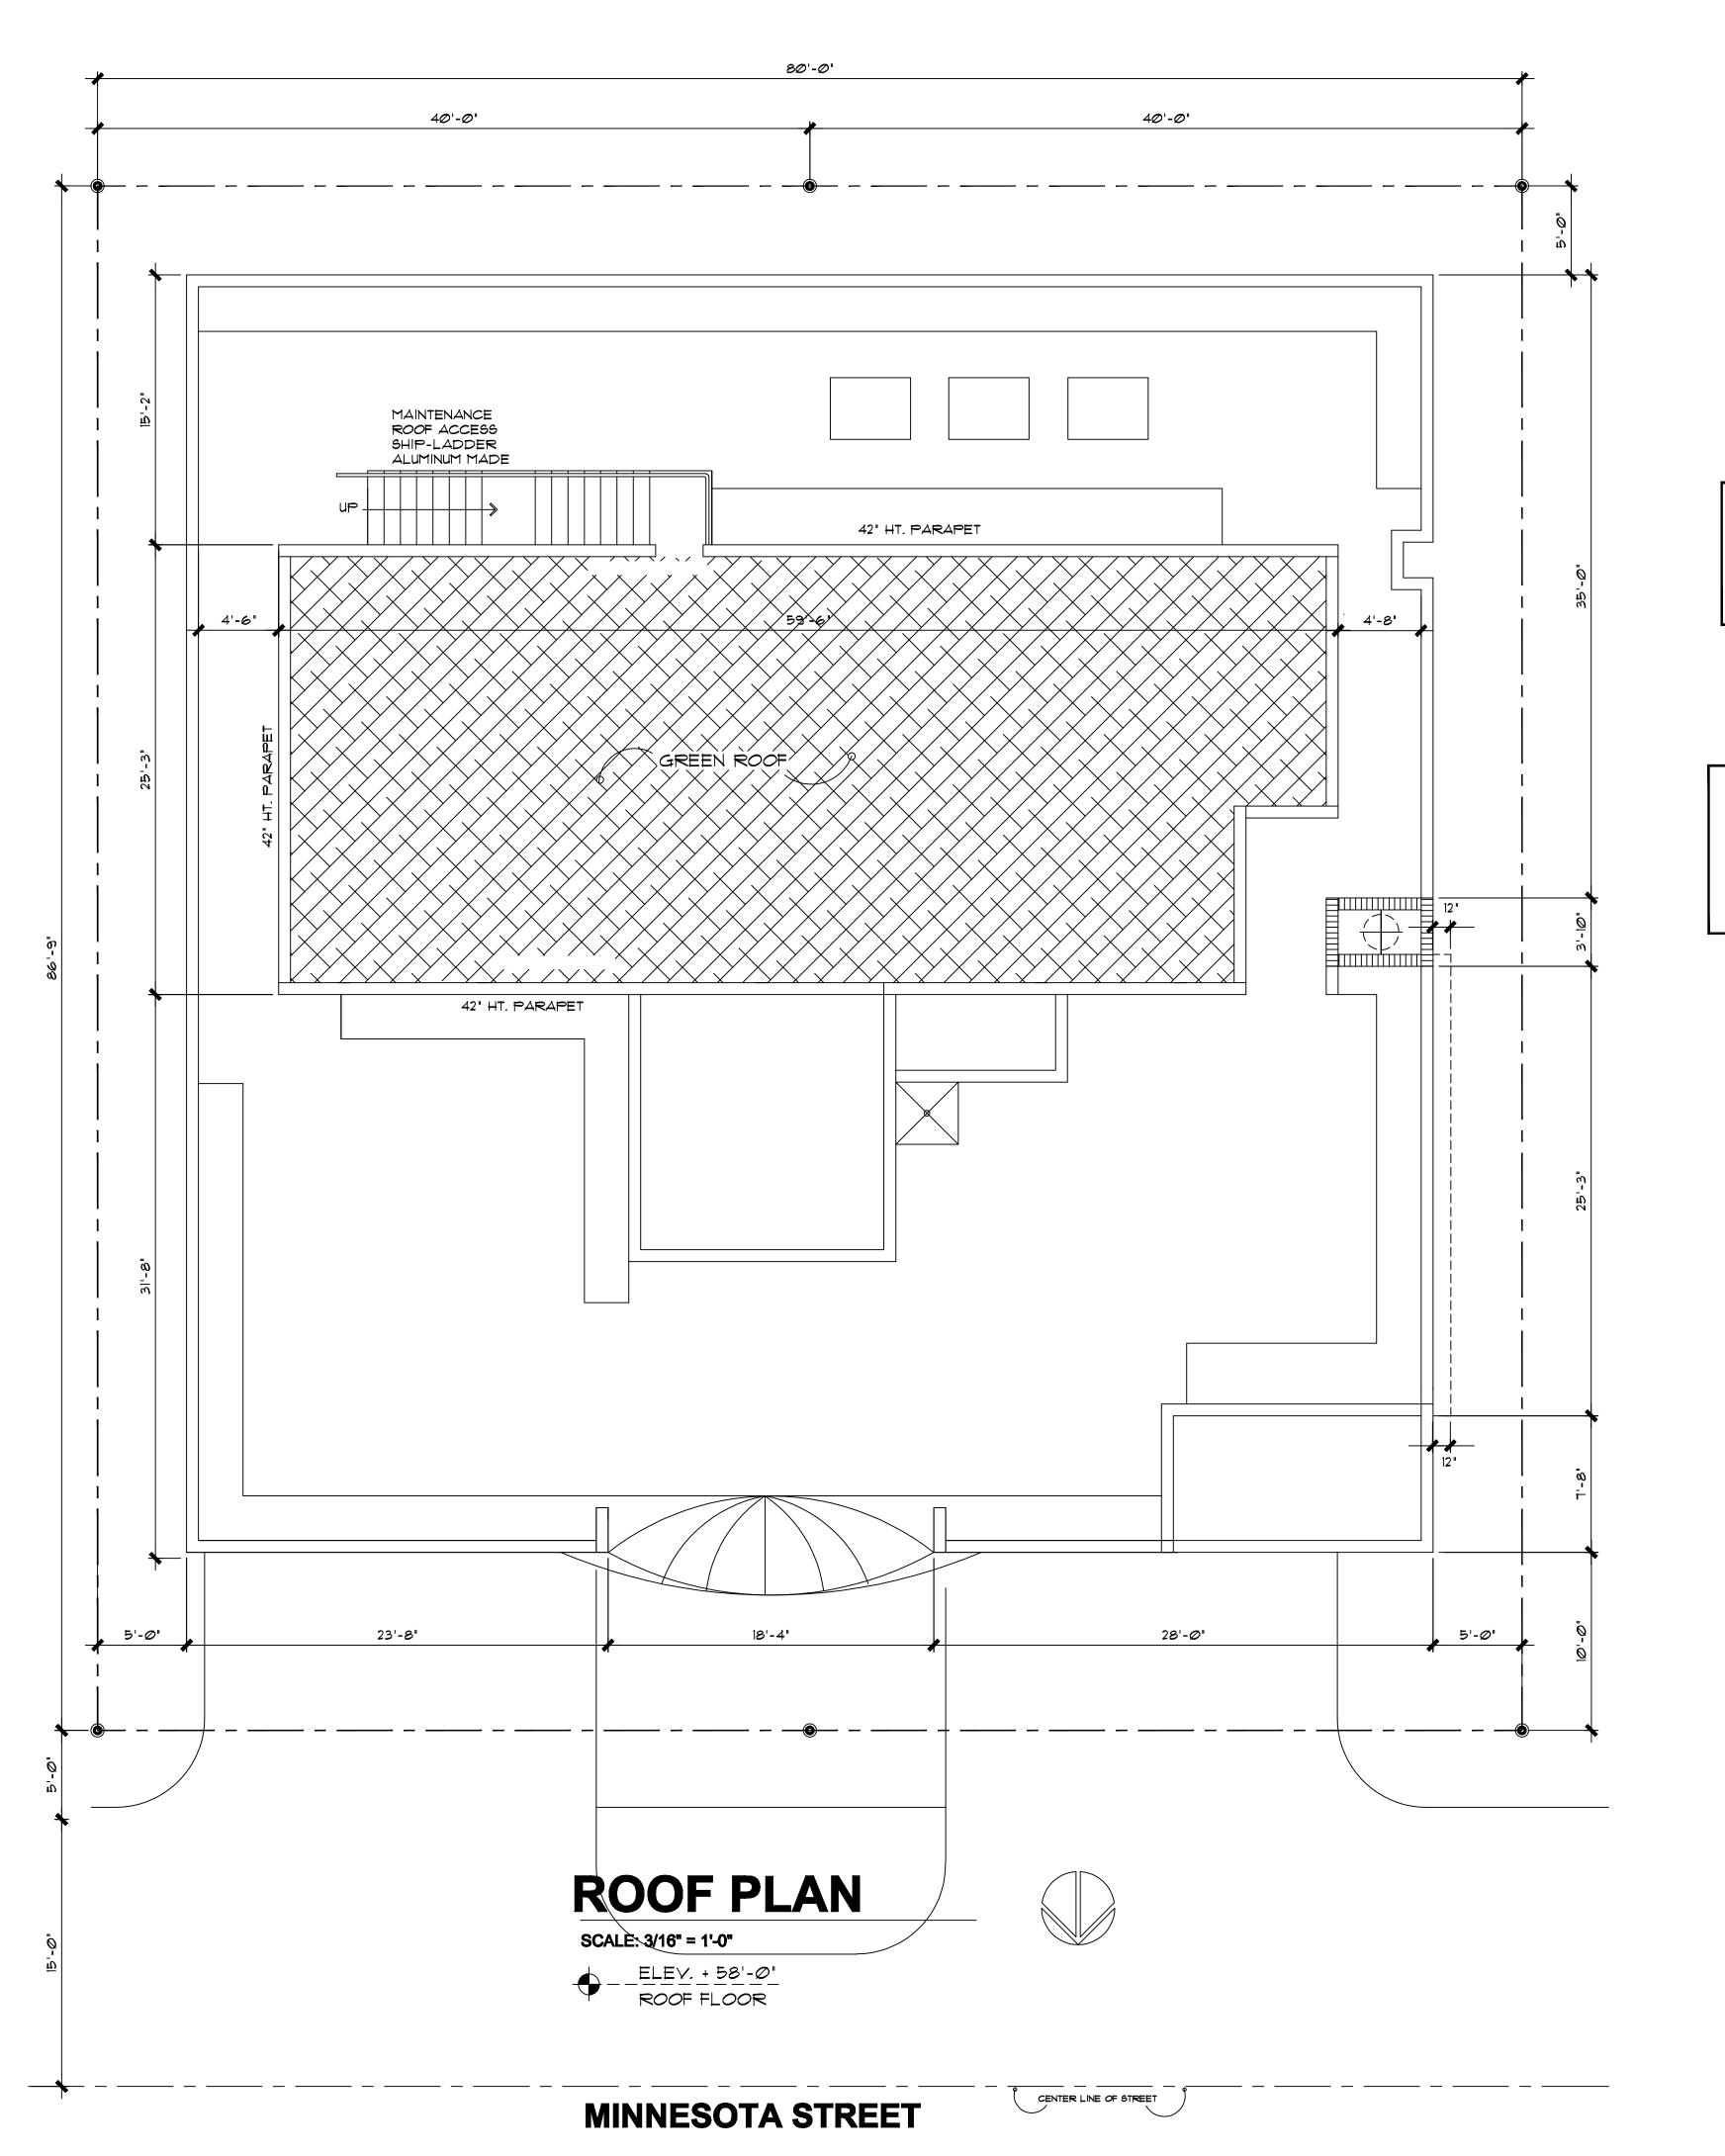

ROOF PLANTING

SOD LAWN IS ONLY PROVIDED ON THE ROOF AREA AND TO BE IRRIGATED BY AUTOMATED SYSTEM IRRIGATION AND PLANTING DETAILS WILL BE PROVIDED IN THE LANDSCAPED DRAWINGS

#### **IRRIGATION NOTES**

AS PER THE CITY OF HOLLYWOOD LANDSCAPE MANUAL, PROVIDE 100% IRRIGATION COVERAGE BY MEANS OF AN AUTOMATC SPRINKLER SYSTEM DISIGNED AND CONSTRUCTED IN ACCORDANCE WITH THE CITY OF HOLLYWOOD CODE OF ORDINANCES AND THE REGULATIONS OF THE SOUTH FLORIDA WATER MANAGEMENT DISTRICT

VICTOR ELIAS EISENSTEIN, AIA
ARCHITECTURE
PROJECT MANAGEMENT, PLANNING, QUALITY CONTROL

VICTOR ON VEE A DICH COM

VICTOR@VEEARCH.COM


1111 PARK CENTRE BLVD #105-B

MIAMI GARDENS, FLA. 33169

office: 305-625-0007 cell: 786-229-1318



SEAL: VICTOR ELIAS EISENSTEIN.- AR92121

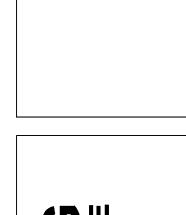

BLUE BUILDIN VE HOTEL SUITE AND OFF 24 MINNESOTA STREET

VISIONS:

SUBMITTAL:

DEVELOPMENT
BOARD
SUBMITTAL


SCALE:
AS INDICATED


DATE: 2-27-2*©*17

PROJECT No:

DRAWN BY: CHEC

PAGE No:

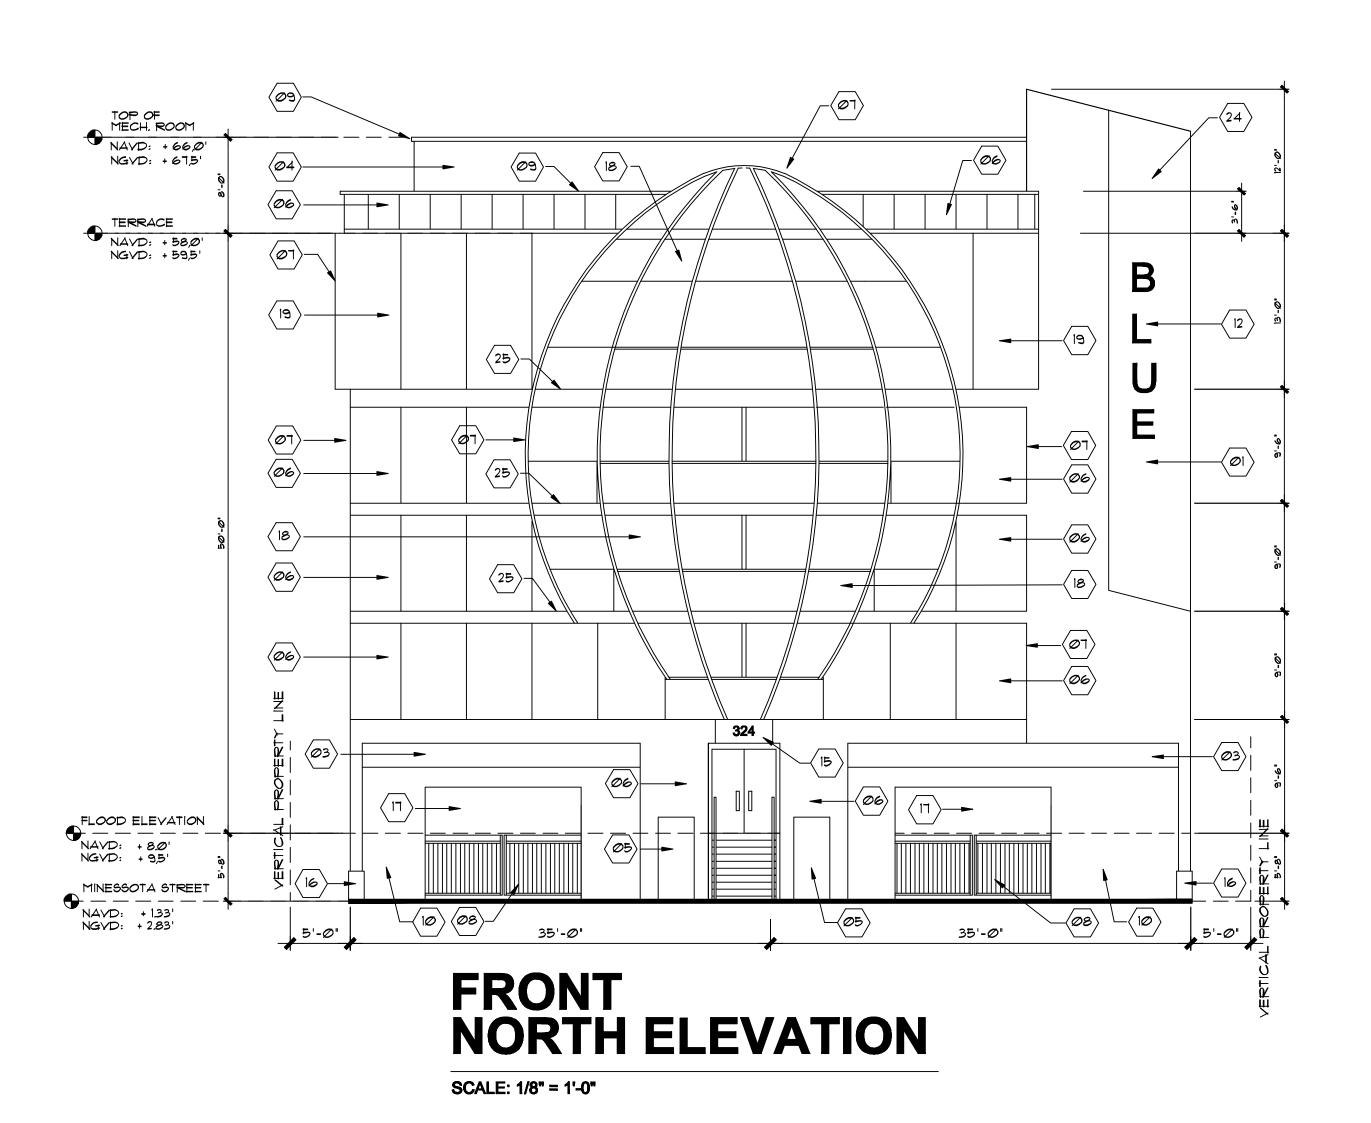

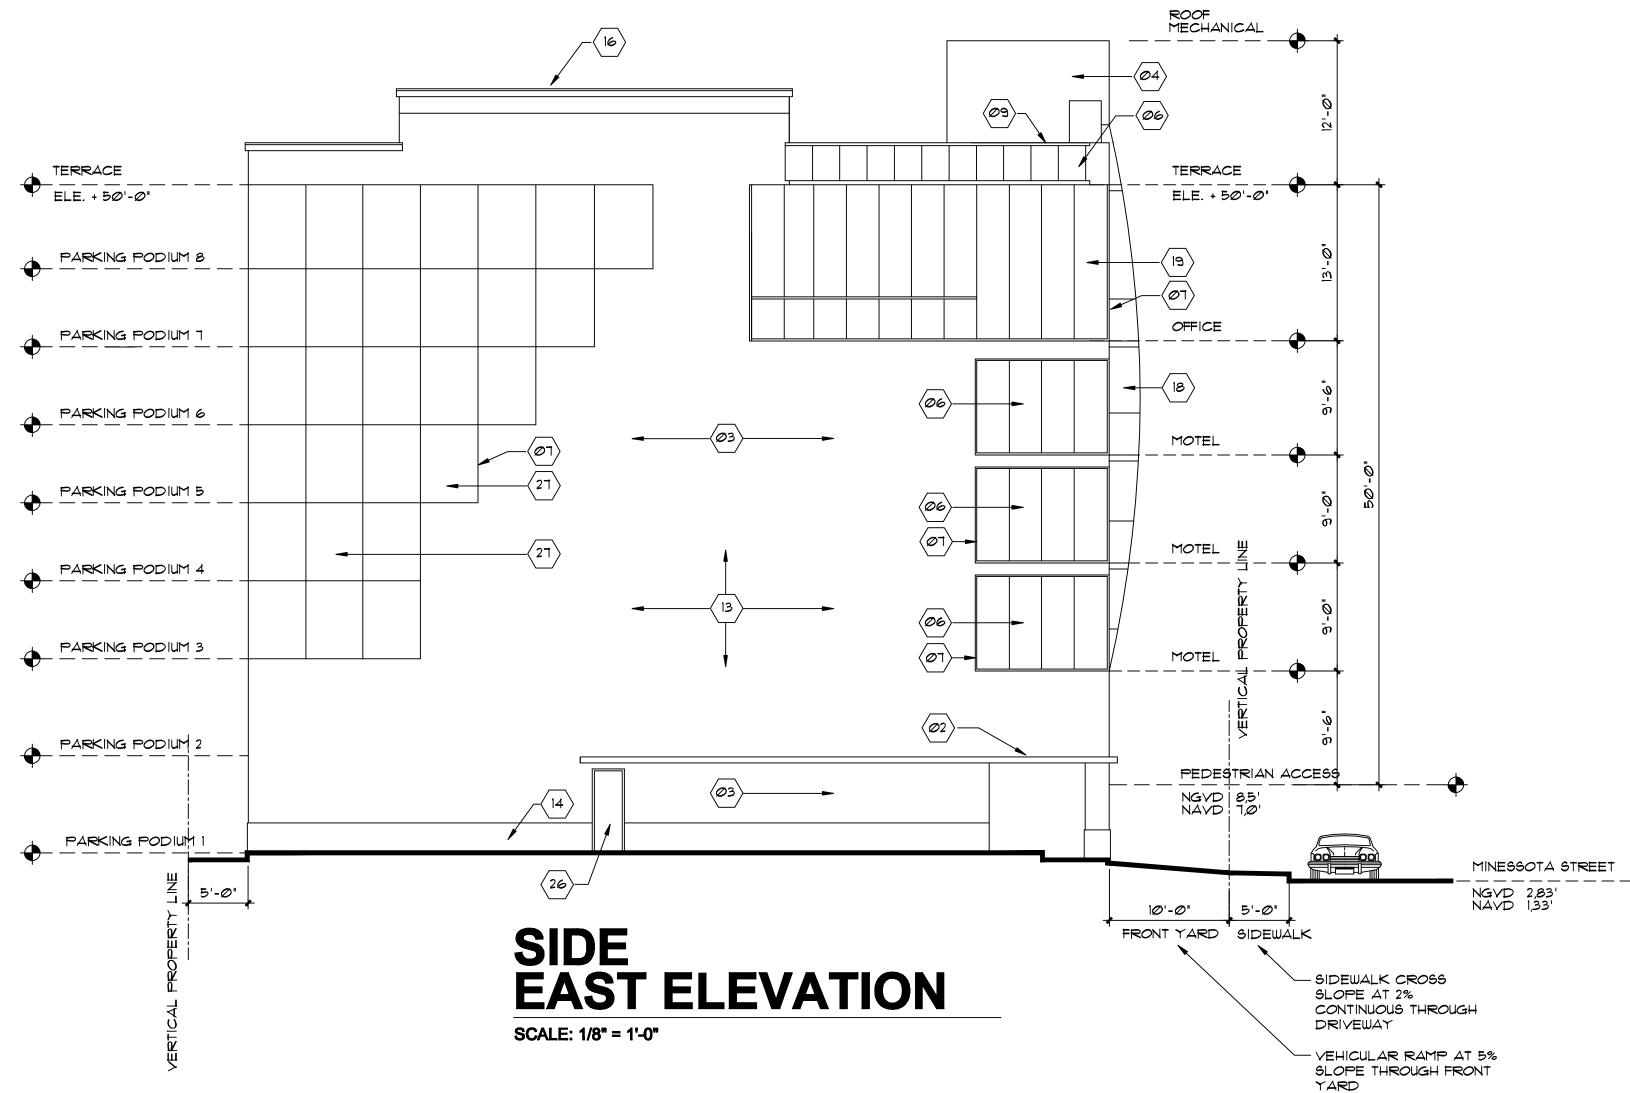

#### SIGNAGE DESIGN CRITERIA

ALL SIGNAGE SHALL BE IN COMPLIANCE WITH LAND DEVELOPMENT REGULATIONS ALL SIGNS ELECTRICALLY ILLUMINATED SHALL REQUIRE A SEPARATE ELECTRIC PERMIT

ARTICLE 8-4

REVERSE CHANNELED LETTERS WITH WHITE TRANSLUCENT FACE

ARTICLE 8-5-3A

MINIMUM 7'-5" ABOVE THE SIDEWALK

ARTICLE 8-5-B-2 AT BRT-25 DISTRICTS

ALLOWED MAX AREA = 30 SF

SECONDARY SIGN ADDRESS NUMBER

ALLOWED 6" AT GROUND FLOOR OR 24" MAX ON PARAPET AT 3 STORY BLGS OR HEIGHER


#### SIGNAGE PROPOSED

INDIRECT ILLUMINATED

AREA 28,30 SF ALLOWED = 30 SF
HEIGHT 38'-6" ABOVE SIDEWALK
TYPE INDIVIDUAL CARVED LETTERS
MATERIALS CONCRETE

SIGNAGE IS SUBJECT TO A SEPARATE PERMIT BY THE SIGNAGE CONTRACTOR

LETTERS

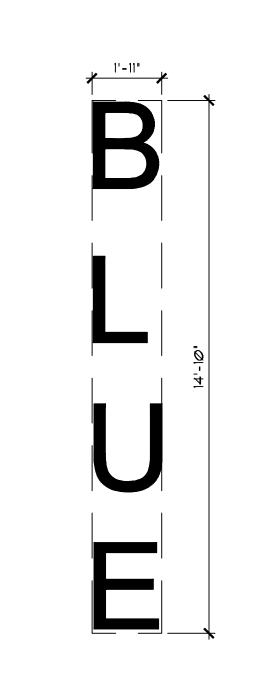

COLOR COORDINATION CHART, MATERIALS AND FINISH TEXTURES

ALL COLORS BY SHERWIN WILLIAMS EXTERIOR USE PAINTS OR SIMILAR

- CONCRETE STRUCTURE CLADDED WITH
  REFLECTIVE ALUMINUM PANELS COLOR
  SW-6958 DYNAMIC BLUE .- PANTONE PMS 293
- TEXTURED STUCCO SURFACE FINISH.- SW-6793
  BLUE BELL.- PANTONE PMS 292
- SMOOTH STUCCO SURFACE FINISH.- SW-6791 LAUREN'S SURPRISE.- PANTONE PMS 290
- SMOOTH STUCCO SURFACE FINISH.- SW-7006
  EXTRA WHITE
- EXTERIOR USE ALUMINUM GLASS DOOR AND FRAME

- MOTEL WINDOW GLASS DARK-GRAY TINTED
  WINDOWS LARGE MISSILE IMPACT RESISTANT
- WINDOW ULTREX FIBERGLASS FRAMES SW-7075 WEB GRAY PANTONE PMS 431
- ULTREX FIBERGLASS SLIDING GATE SW-7075
  WEB GRAY
  PANTONE PMS 431
- ULTREX FIBERGLASS RAILING SW-7075 WEB GRAY PANTONE PMS 431
- TEXTURED STUCCO FINISH SW-6794 FLYWAY PANTONE PMS 285
- SMOOTH CONCRETE FINISH NATURAL COLOR GREY
- 28,30 SF SIGNAGE 2'-6" X 1'-10" INDIVIDUAL
  CARVED LETTERS INDIRECT ILLUMINATED
  SIGNAGE AT 38'-6" HT ABOVE SIDEWALK

- (13) 1/2" SCORE LINES ON STUCCO AS NEEDED
- 36" HT. APRON 1" STUCCO REVEAL SW-6794
  FLYWAY.- PANTONE PMS 285
- MAIN ENTRANCE STAINLESS STEEL PLAQUE AND ADDRESS NUMBER
- KEYSTONE MOLDING SMOOTH FINISH

  HEMPTY SPACE
- SPHERICAL ALUMINUM AND LIGHT BLUE-TINTED GLASS WIND RESISTANT STOREFRONT 2'-5"
  OVERHANG
- OFFICE WINDOW GLASS SMOKED BLACK TINTED WINDOWS LARGE MISSILE IMPACT RESISTANT
- RECESSED SPHERICAL SHAPE PAINTED CONCRETE NATURAL COLOR

- RECESSED SEPARACTION SPACE BETWEEN SPHERES FINISH IN TEXTURED STUCCO PAINTED
- COLOR SW-7075 WEB GRAY PANTONE PMS 431

  HALF-MOON PERIMETER LED LIGHT
  LINE-FIXTURE SW-6920 CENTER STAGE.-
- PANTONE PMS 375

  HALF-MOON PERIMETER LED LIGHT LINE-FIXTURE SW-6907 FORSYTHIA
- PANTONE PMS 109

  30 DEGREES BEVELED SURFACE FOR CARVED LETTERS OF SINGAGE
- CONCRETE SLAB ALLOWED OVERHANG MAX
- EXTERIOR METAL DOOR
  FRAME AND DOOR PAINT COLOR WHITE
- PARKING CLEAR GLASS WINDOWS LARGE MISSILE IMPACT RESISTANT

HIGH-WIND RESISTANT GLASS

ALL GLASS DOORS, WINDOWS AND FRAMES OF THIS PROJECT TO BE HURRICANE HIGH WINDS AND LARGE MISSILE IMPACT RESISTANT AS PER STATE OF FLORIDA PODUCT APPROVAL VICTOR ELIAS EISENSTEIN, AIA
ARCHITE DEPRISATE OF FLORIDA, BOAND OF ARCHITECTURE
PROJECT MANAGEMENT, PLANDING, QUALITY CONTROL

VICTOR@VEEARCH.COM

1111 PARK CENTRE BLVD #105-B
MIAMI GARDENS, FLA. 33169

office: 305-625-0007 ceil: 786-229-1318





AL: VICTOR ELIAS EISENSTEIN.- AR



CUTIVE HOTEL SUITE AND OI HOLLYWOOD, FLA. 33019

REVISIONS:

TAC & PDB

UBMITTAL:

DEVELOPMENT
BOARD

SUBMITTAL

SCALE:

AS INDICATED


DATE:

2-27-2017

PROJECT No:

DRAWN BY: CHECKED BY:
NATALIE P. VEE

PAGE No:

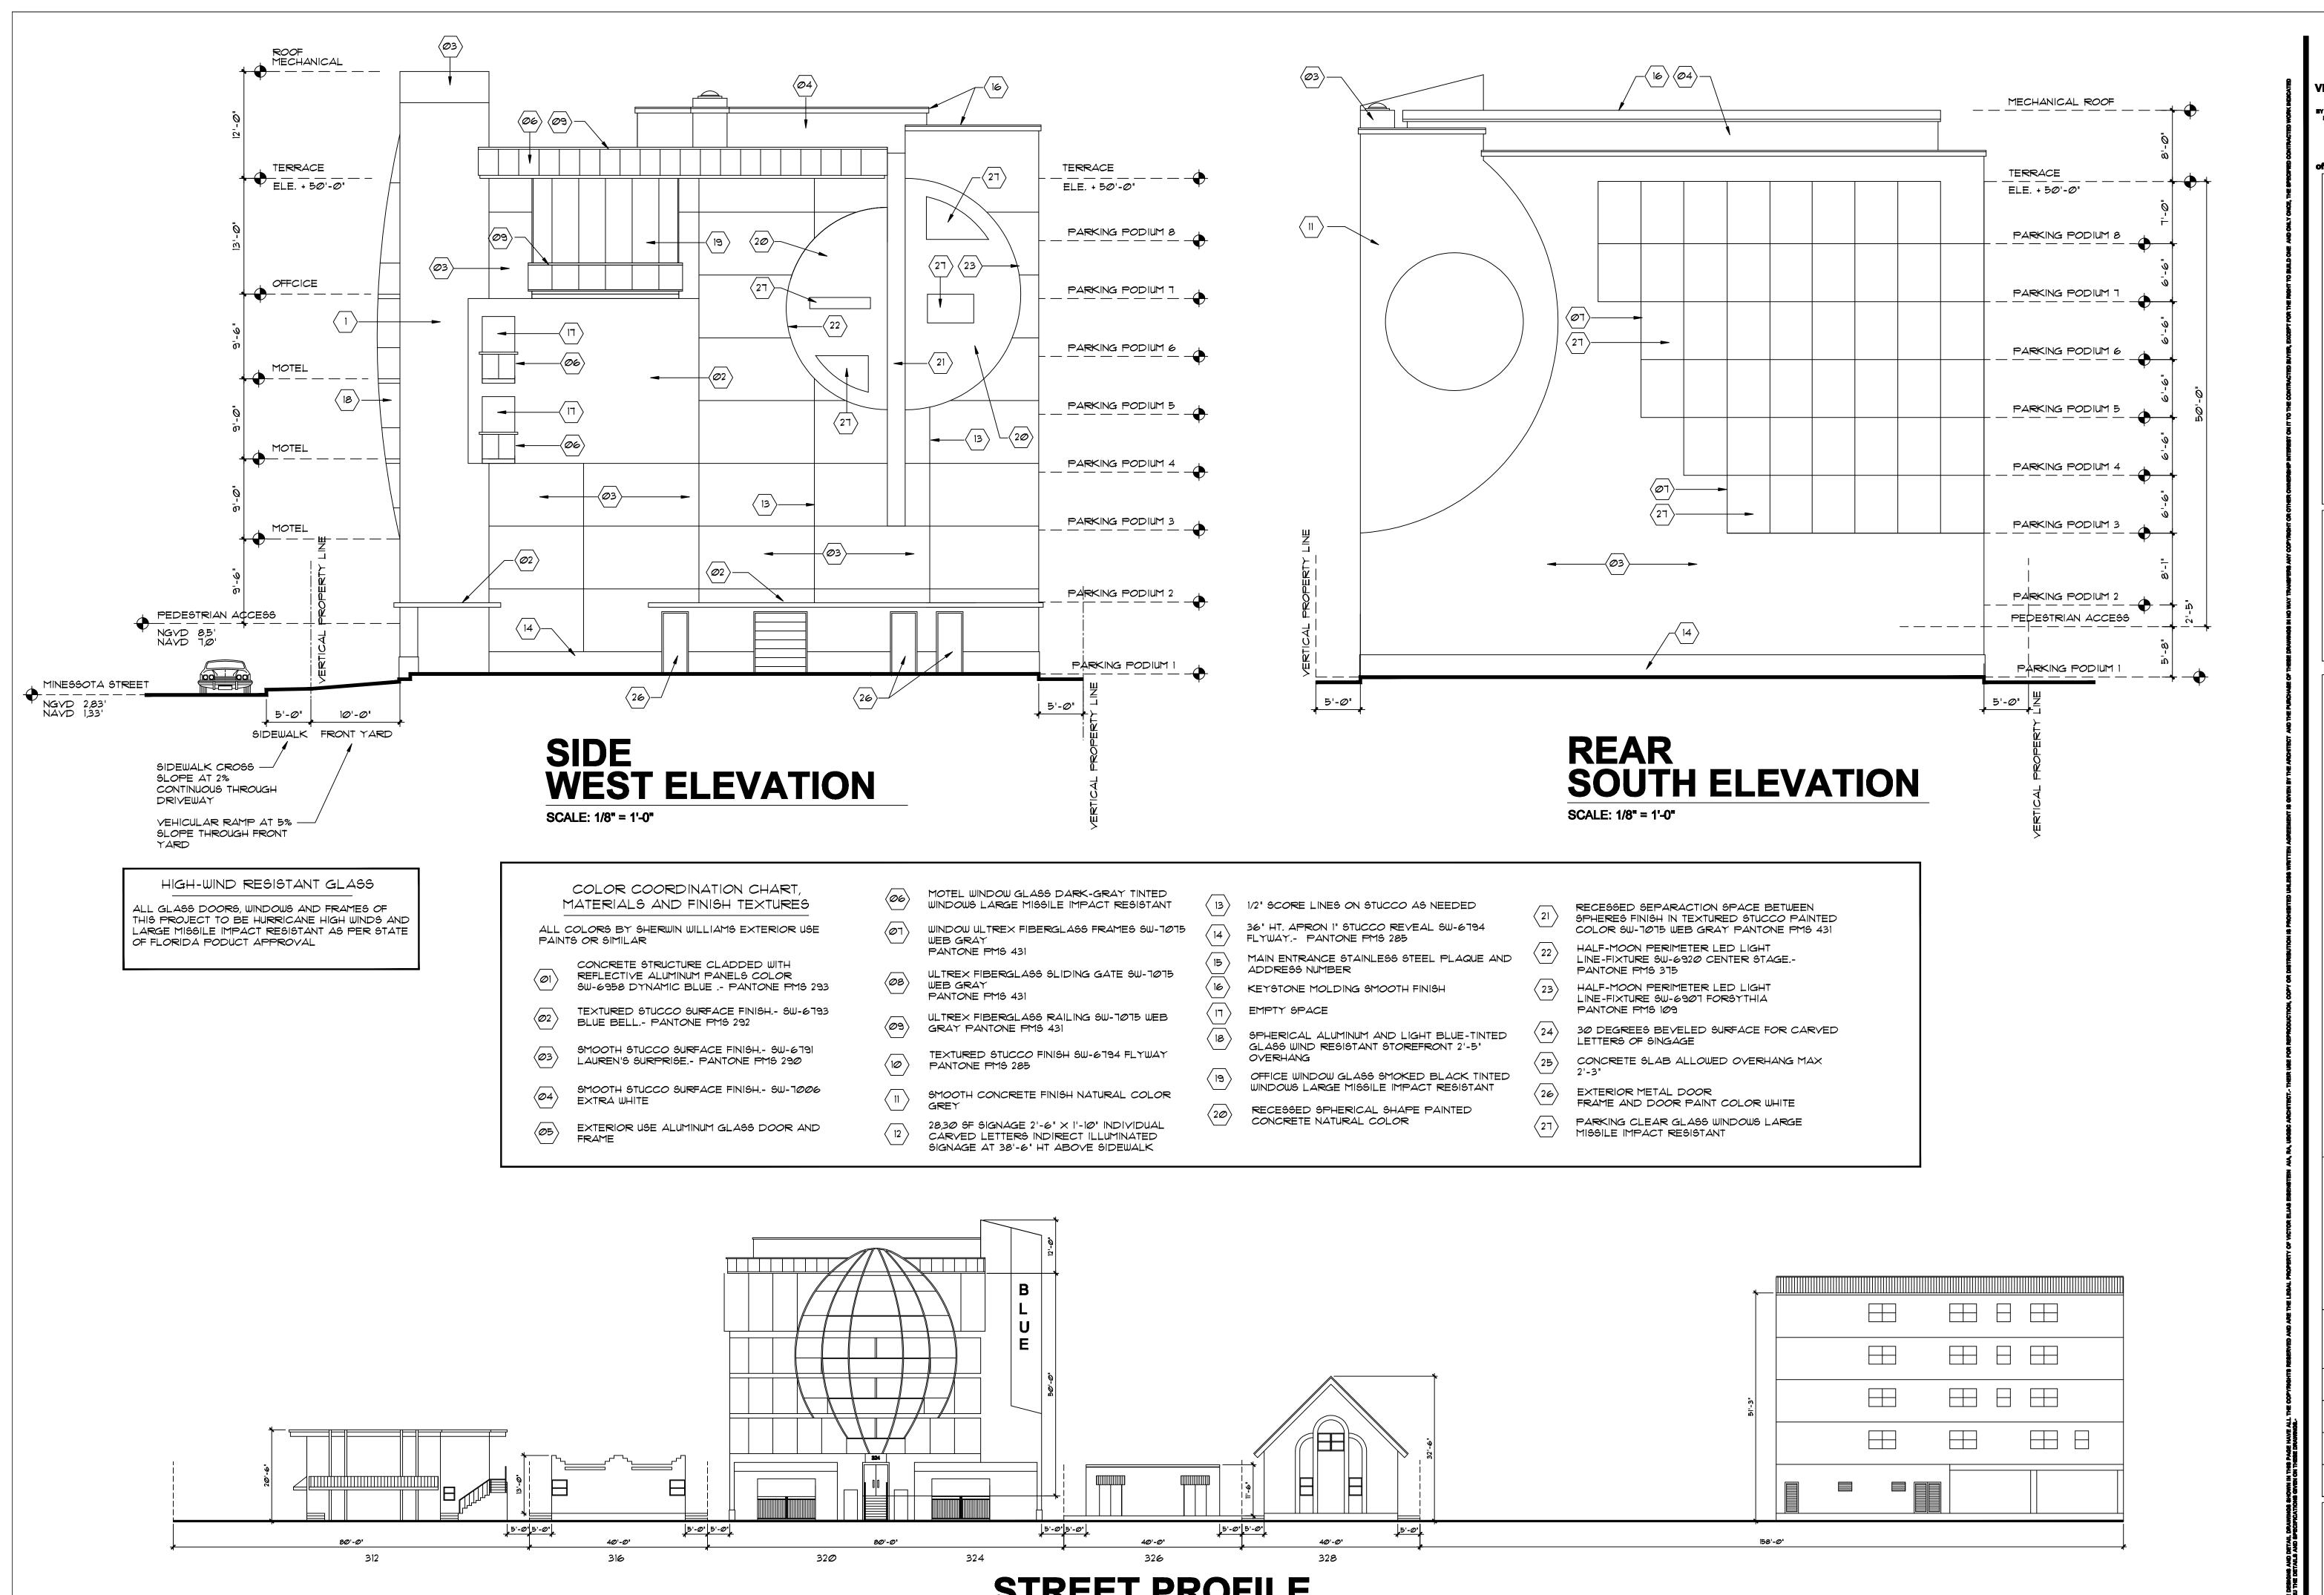

1111 PARK CENTRE BLVD #105-B MIAMI GARDENS, FLA. 33169 Mice: 305-625-0007 cell: 788-229-1318



ILDING AND OFFICE STREET 33019 HE BL

REVISIONS:

TAC & PDB

DEVELOPMENT BOARD

SUBMITTAL AS INDICATED

DATE: 2-27-2017

NATALIE P.


PAGE No:

PROJECT No: CHECKED BY: DRAWN BY:

VEE

STREET PROFILE

SCALE: 1/16" = 1'-0"

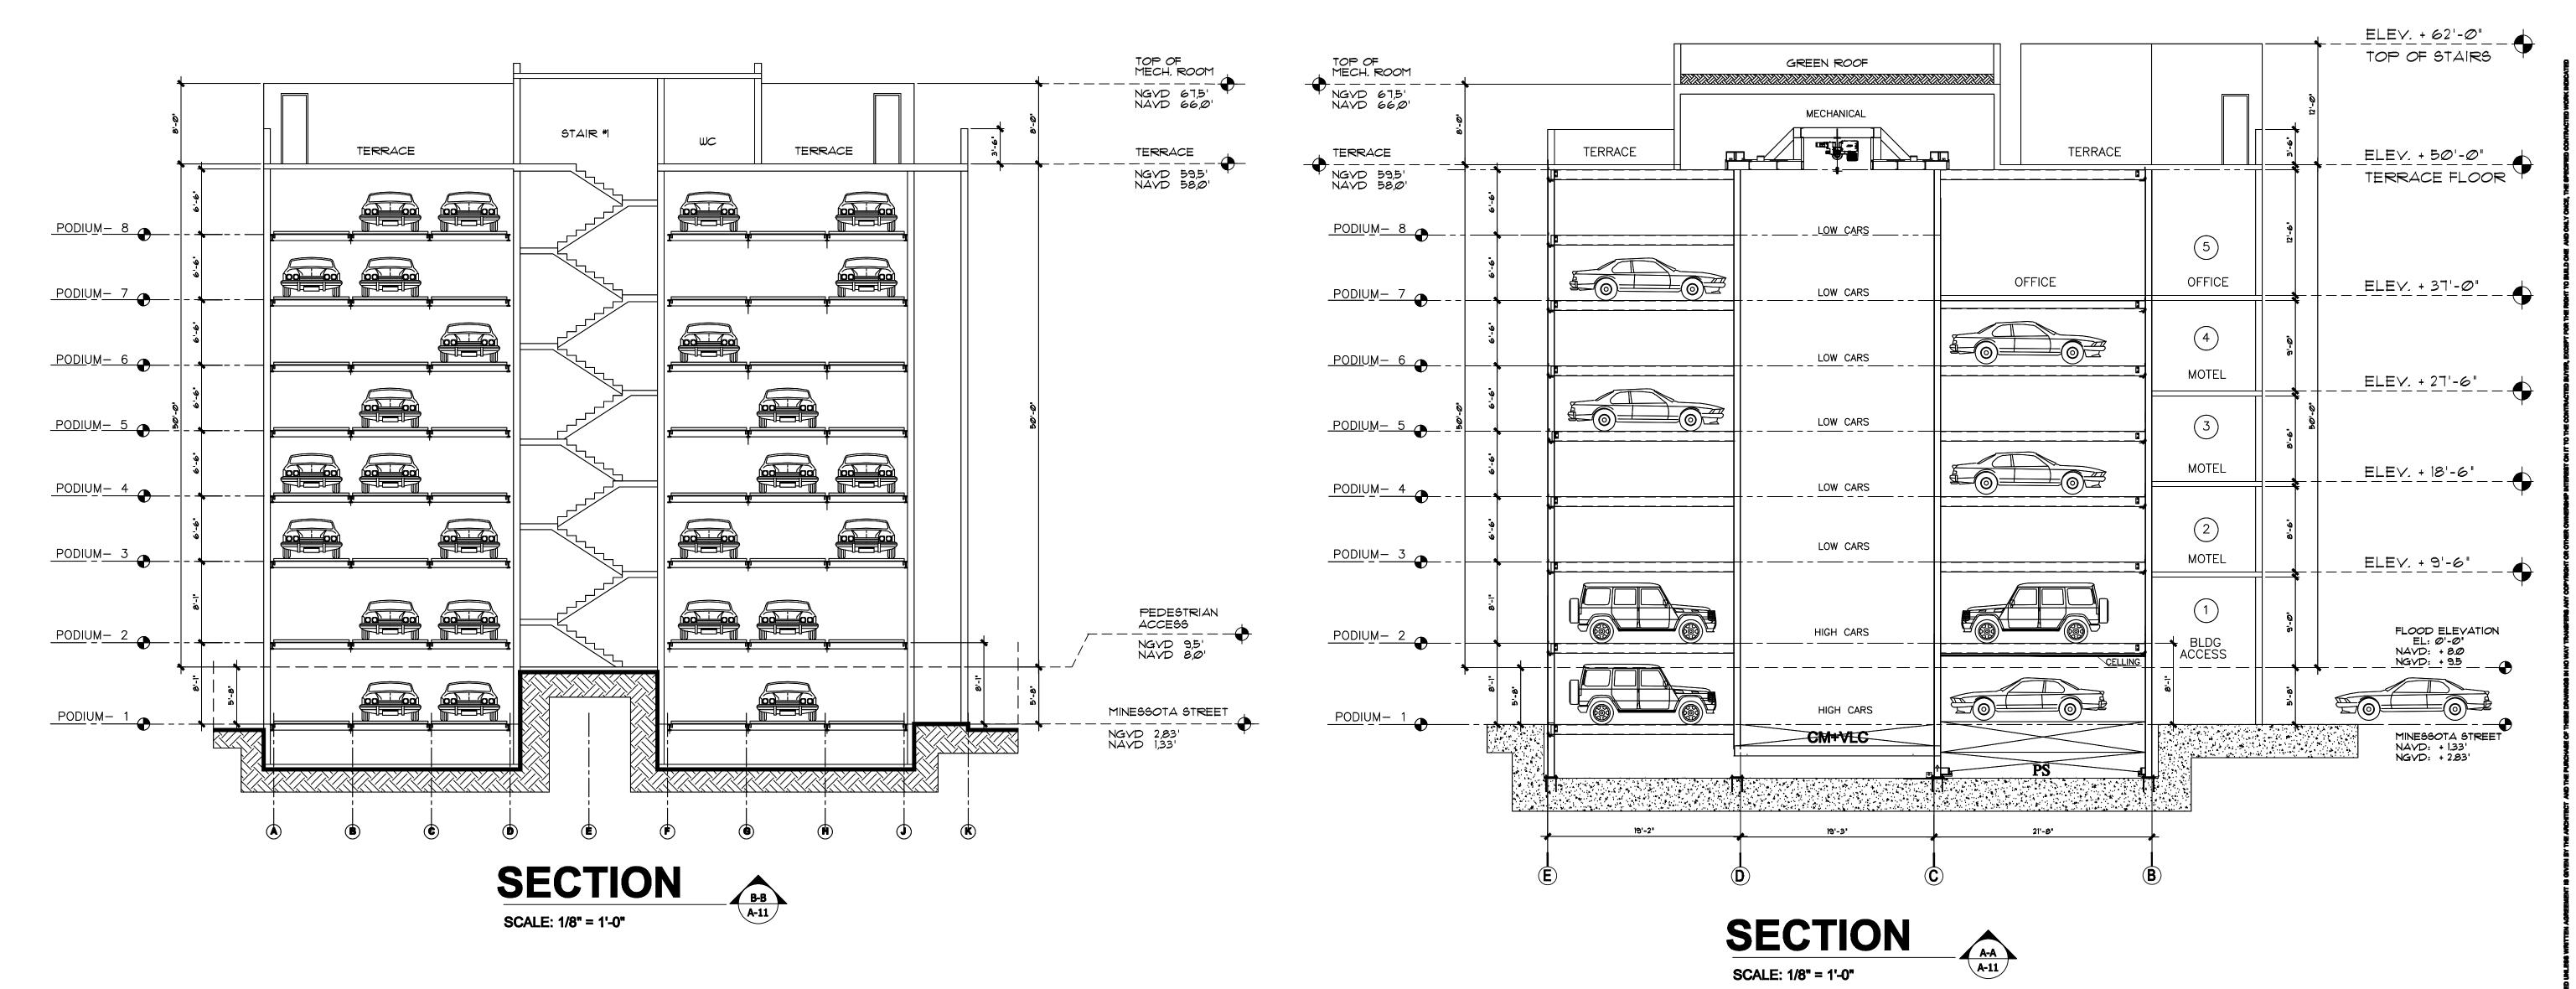

PARKING GARAGE NOTES

PARKING GARAGE TOWER IS FIRE PROTECTED WITH FIRE-SPRINKLERS COYERING EACH VEHICLE STALL

METAL STRUCTURAL COMPONENTS ARE SPRAYED WITH I HOUR FIRE RETARDAND INHIBITORS "INTERGARD 251" EPOXY ZINC PHOSPHATE PRIMER.

HOT-DIP GALVANIZE OF ALL STRUCTURAL COMPONENTS THAT DO NOT REQUIRE PAINTING

STAINLESS-STEEL MOVABLE COMPONENTS

ZINC-PLATED FINISH FOR ALL STEEL COMPONENTS THAT ARE NOT PAINTED OR NOT STAINLESS STEEL OR NOT GALVANIZED

#### CLOSED GARAGE

INTENTIONALLY THE PARKING TOWERS IS CONSIDERED UNDER THE CATEGORY OF A CLOSED GARAGE AND MECHANICAL EXHAUST VENTILATION IS PROVIDED

CONSIDERING THE PROXIMITY TO THE OCEAN AND HUMIDITY IN THE AIR, THEN AC DRY AIR IS PROVIDED TO THE ENTIRE PARKING GARAGE PREVENTING CORROSION TO METAL COMPONENTS

ELECTRIC VEHICULE CHARGING STATION

IN COMPLIANCE WITH CITY ORDINANCES, ELECTRIC VEHICULE CHARGING STATION INFRASTUCTURE IS PROVIDED AT THE GROUND LEVEL OF THE BUILDING

SEE PAGE A-1 FOR DETAILED NARRATIVE

PARKING STRUCTURE
LIFE SAFETY DEVISES

AUTOMATIC FIRE SUPRESSION SPRINKLERS COVERING EACH AUTOMOBILE

SMOKE DETECTORS
FIRE ALARM

STROBE LIGHT HORN COMBINATION

SMOKE EVACUATION MECHANICAL SYSTEM

EMERGENCY BATTERY BACK-UP LIGHTING

AUTOMATIC SHUT-OFF OPERATION BY INFRARED DETECTION OF MOVEMENT INSIDE AUTOMOBILES

PARKING GARAGE TOWER HAVE A 2 HRS FIRE SEPARATION BARRIER FROM THE REST OF THE BUILDING ROBOTIC PARKING SYSTEM FEATURES
ACCESS-EGRESS TURN TABLE AT GROUND LEVEL
TO ALLOW AUTOMOBILES TO EGRESS FACING THE
STREET.TOTAL ON-SITE PARKING CAPACITY = 94 SPACES

TOTAL ON-SITE PARKING CAPACITY: 94 SPACES
ALL 94 SPACES MEET THE ADA HANDICAPPED
PARKING WITH MIN CLEAR DIMENSIONS AS
REQUIRED BY CODE

PARKING COUNT:		
PODIUM 1 PODIUM 2 PODIUM 3 PODIUM 4 PODIUM 5 PODIUM 6 PODIUM 8	8 14 14 14 14 8 8	
TOTAL	94	

VICTOR ELIAS EISENSTEIN, AIA
ARCHITECTURE
BY THE DEPRISTATE OF FLORIDA, BOARD OF ARCHITECTURE
PROJECT MANAGEMENT, PLANNING, GUALITY CONTROL
VICTOR®VEEARCH.COM

VICTOR@VEEARCH.COM

1111 PARK CENTRE BLVD #105-B

MIAMI GARDENS, FLA. 33169

office: 305-625-0007 coll: 786-229-1318

OF FLOODS & SENSON AR 92121

AR 92121

OF SARAN AR 92121

AR 92121

DE COLIAS ESTABLES AR 92121

SEAL: VICTOR BLIAS EIGENSTEIN.- AR 32121

01258

BLUE BUILDING
TIVE HOTEL SUITE AND OFFICE
-324 MINNESOTA STREET
OLLYWOOD, FLA. 33019

REVISIONS:

TAC & PDB

UBMITTAL:

DEVELOPMENT
BOARD
SUBMITTAL

SCALE:

AS INDICATED


DATE:


2-27-2017


PROJECT No:

DRAWN BY: CHECKED BY:
NATALIE P. YEE

PAGE No:

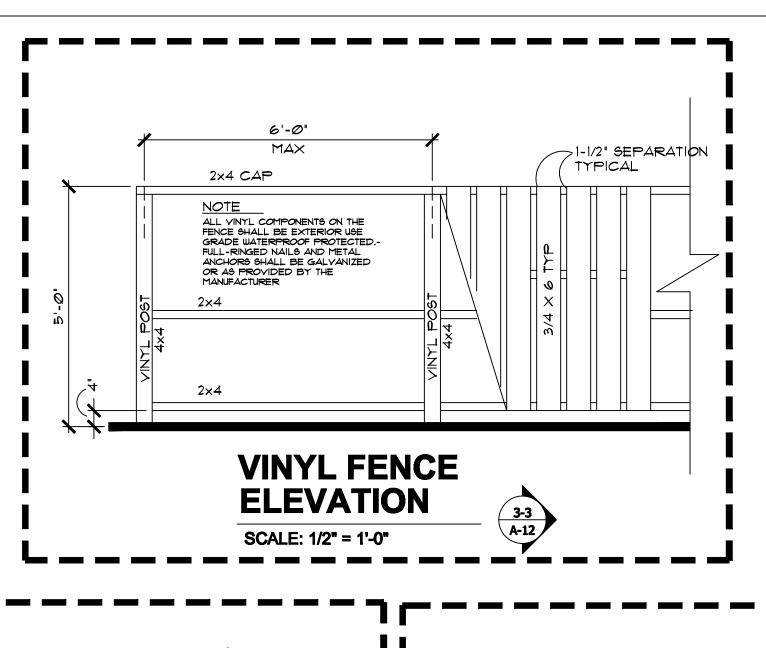

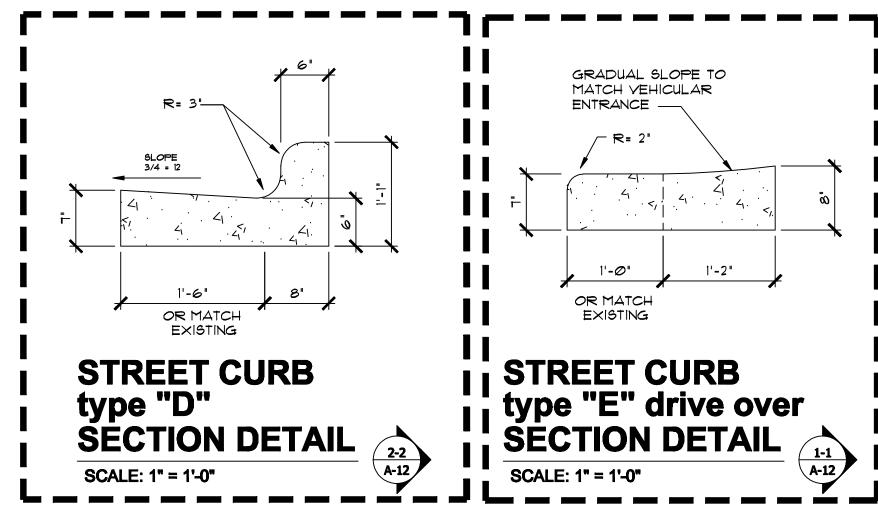

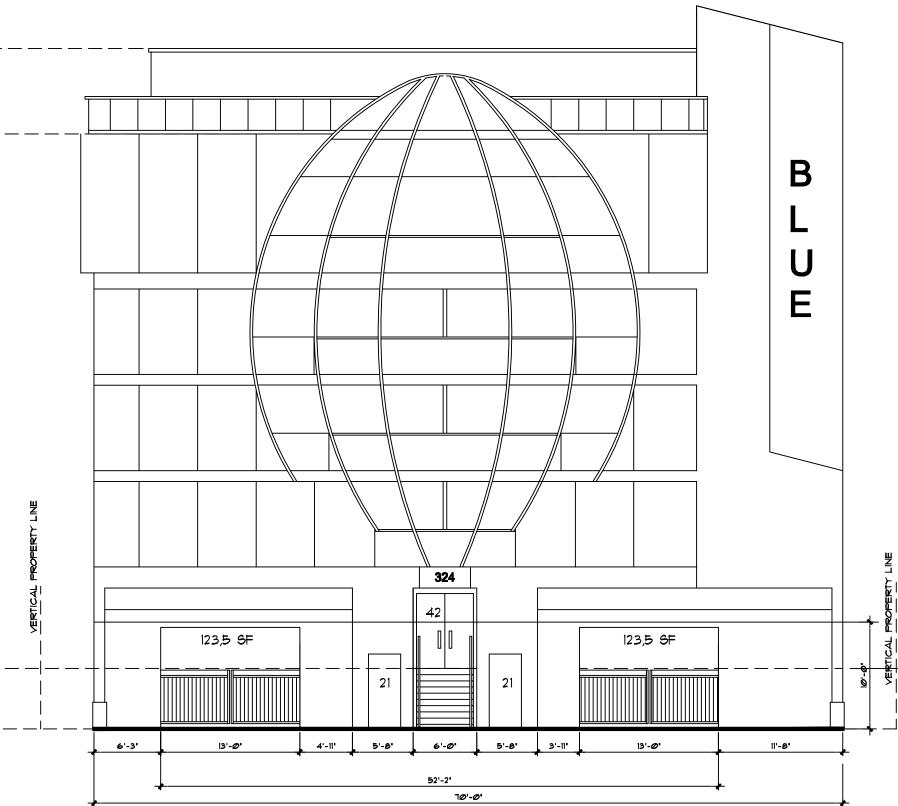


#### **ACTIVE LINERS**

70'-0" BUILDING FRONTAGE 42'-Ø" 60% REQUIRED 58'-4" PROVIDED

#### **ACTIVE LINERS TRANSPARENCY**


BUILDING FRONTAGE 260,8 SF 50% REQUIRED = PROVIDED =

 $52'-2" \times 10'-0"$  HT. = 521 SF. 331 SF

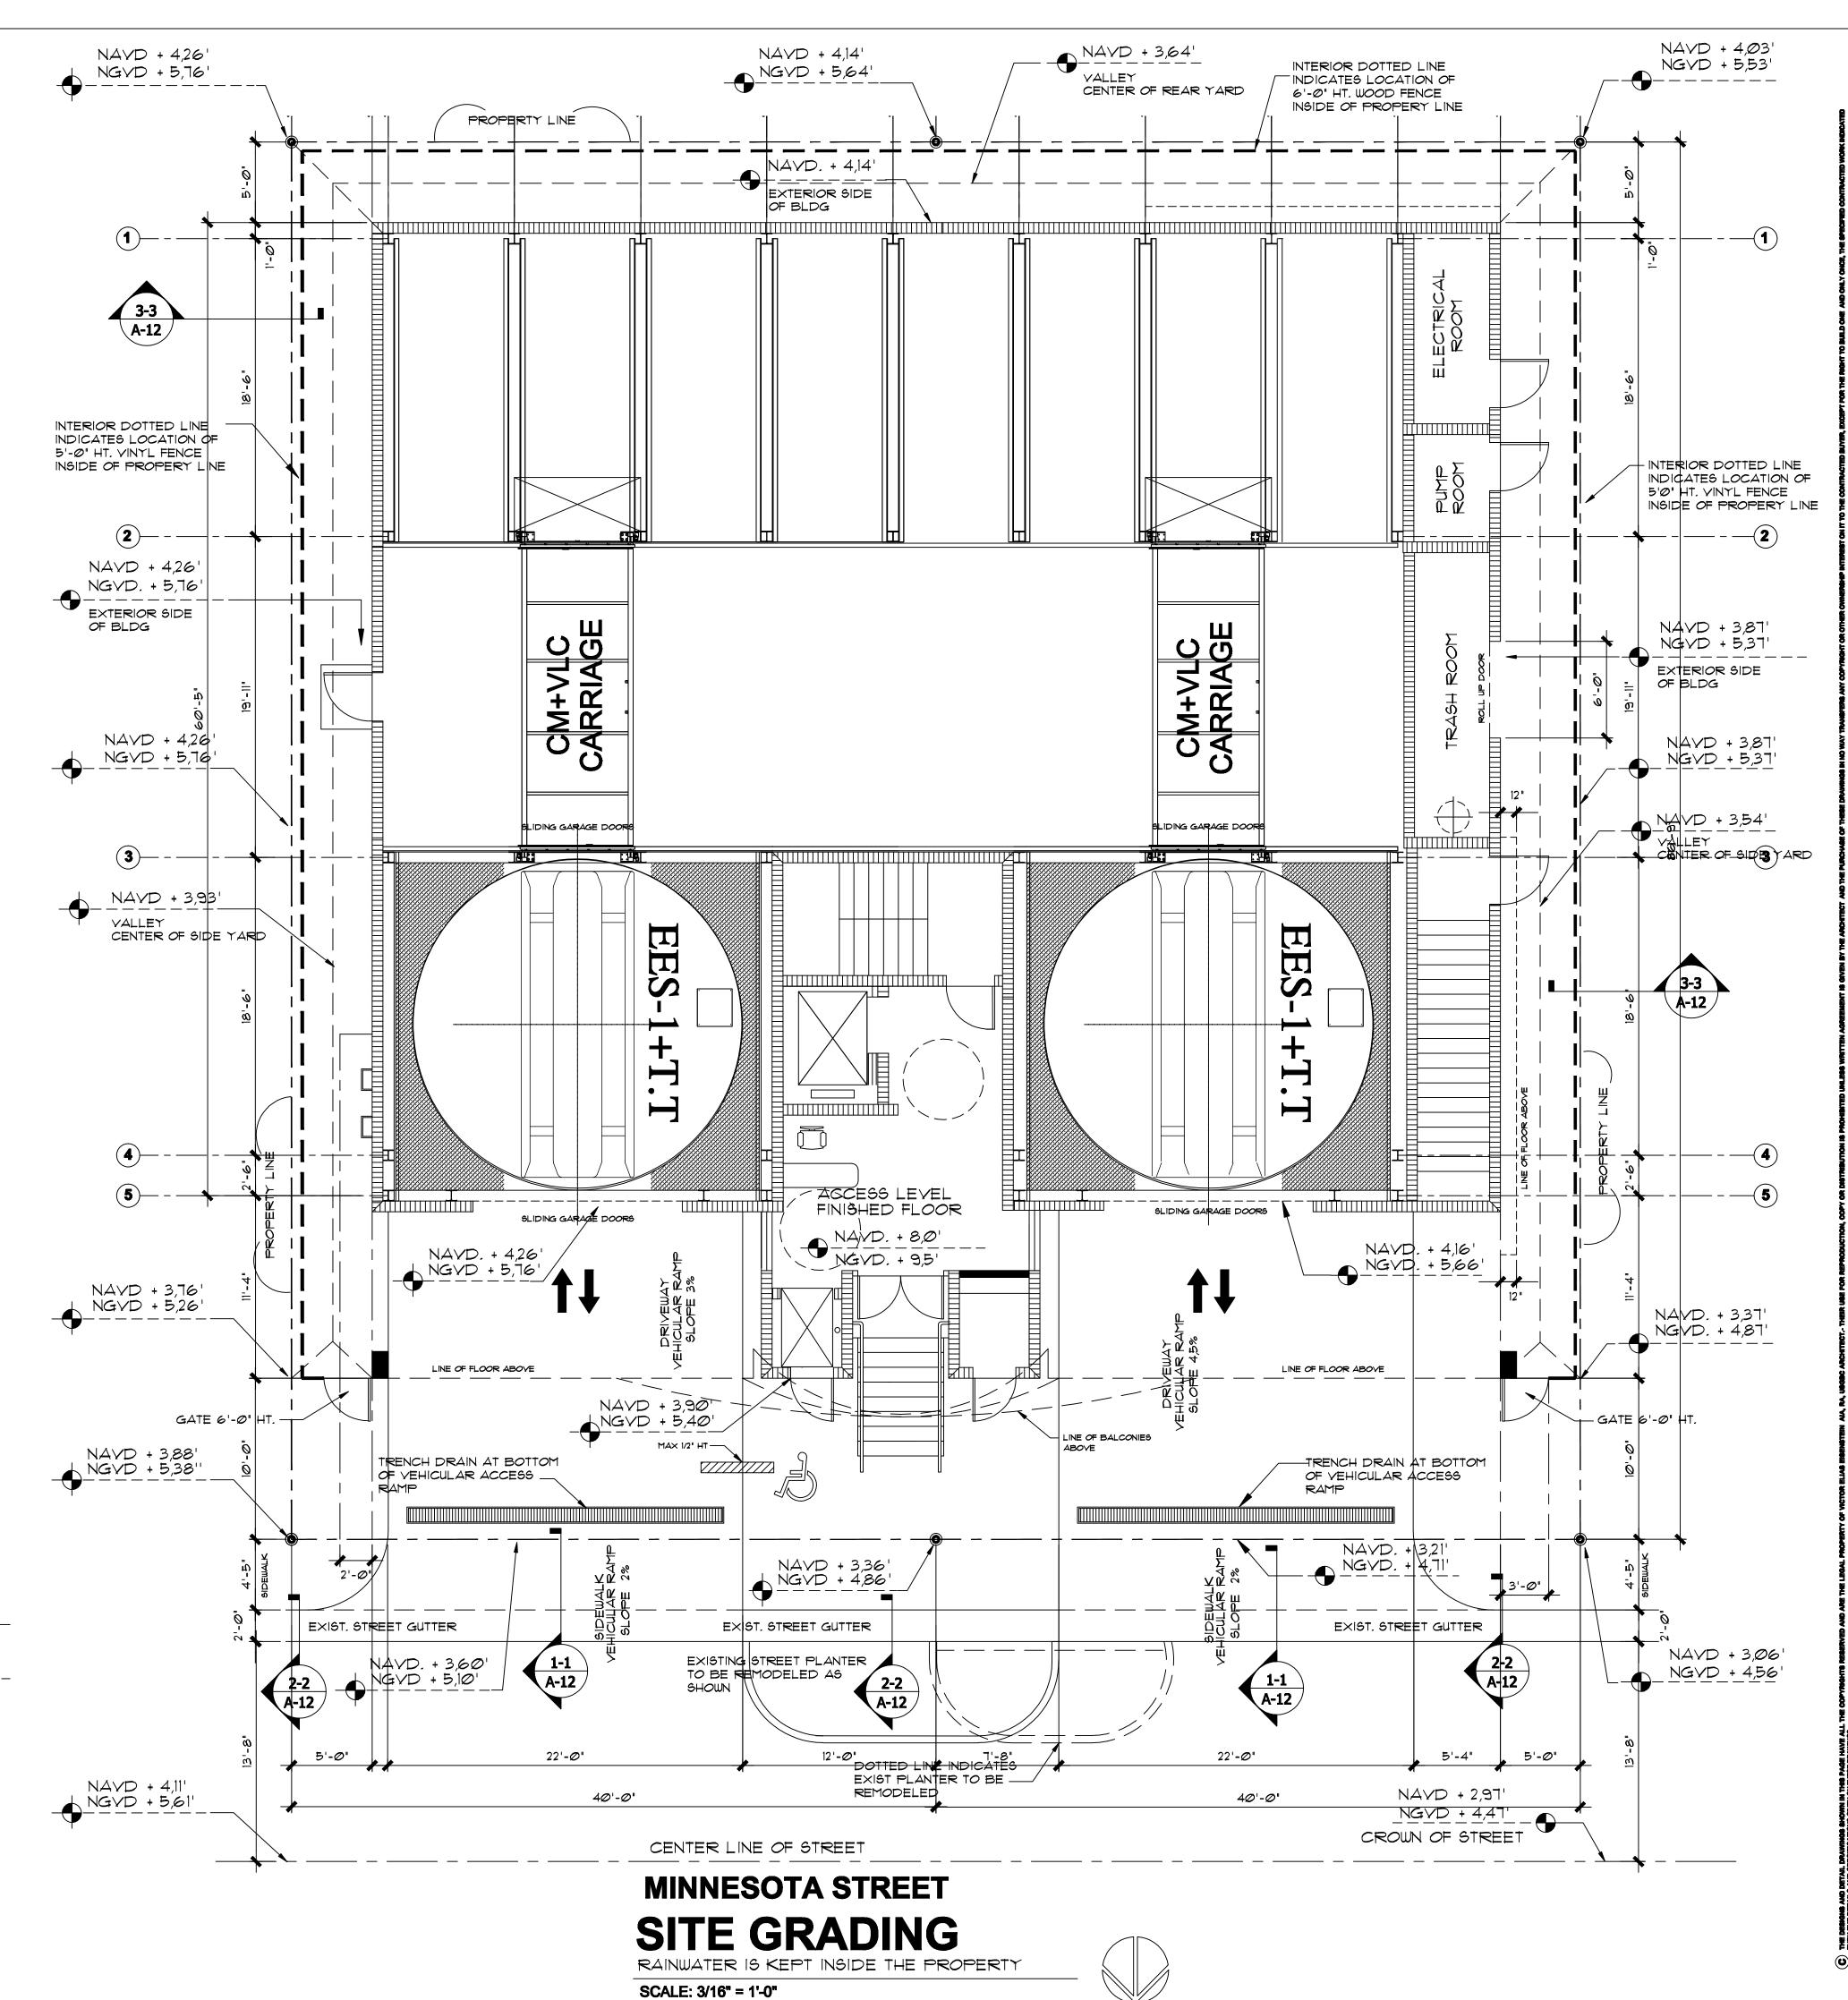

VICTOR ELIAS EISENSTEIN, AIA A R C H I T E C T BY THE DRPR STATE OF FLORIDA, BOARD OF ARCHITECTU PROJECT MANAGEMENT, PLANNING, QUALITY CONTROL

VICTOR@VEEARCH.COM 1111 PARK CENTRE BLVD #105-B MIAMI GARDENS, FLA. 33169 office: 305-625-0007 cell: 786-229-1318

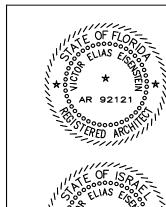



ILDING AND OFFICE

STREET 33019 **BU** SUITE 320-324 MINNESOTA HOLLYWOOD, FLA THE BLUE EXECUTIVE HOTEL


REVISIONS: TAC & PDB

> DEVELOPMENT BOARD SUBMITTAL

AS INDICATED 2-27-2017


PROJECT No: DRAWN BY: CHECKED BY: VEE


NATALIE F PAGE No:

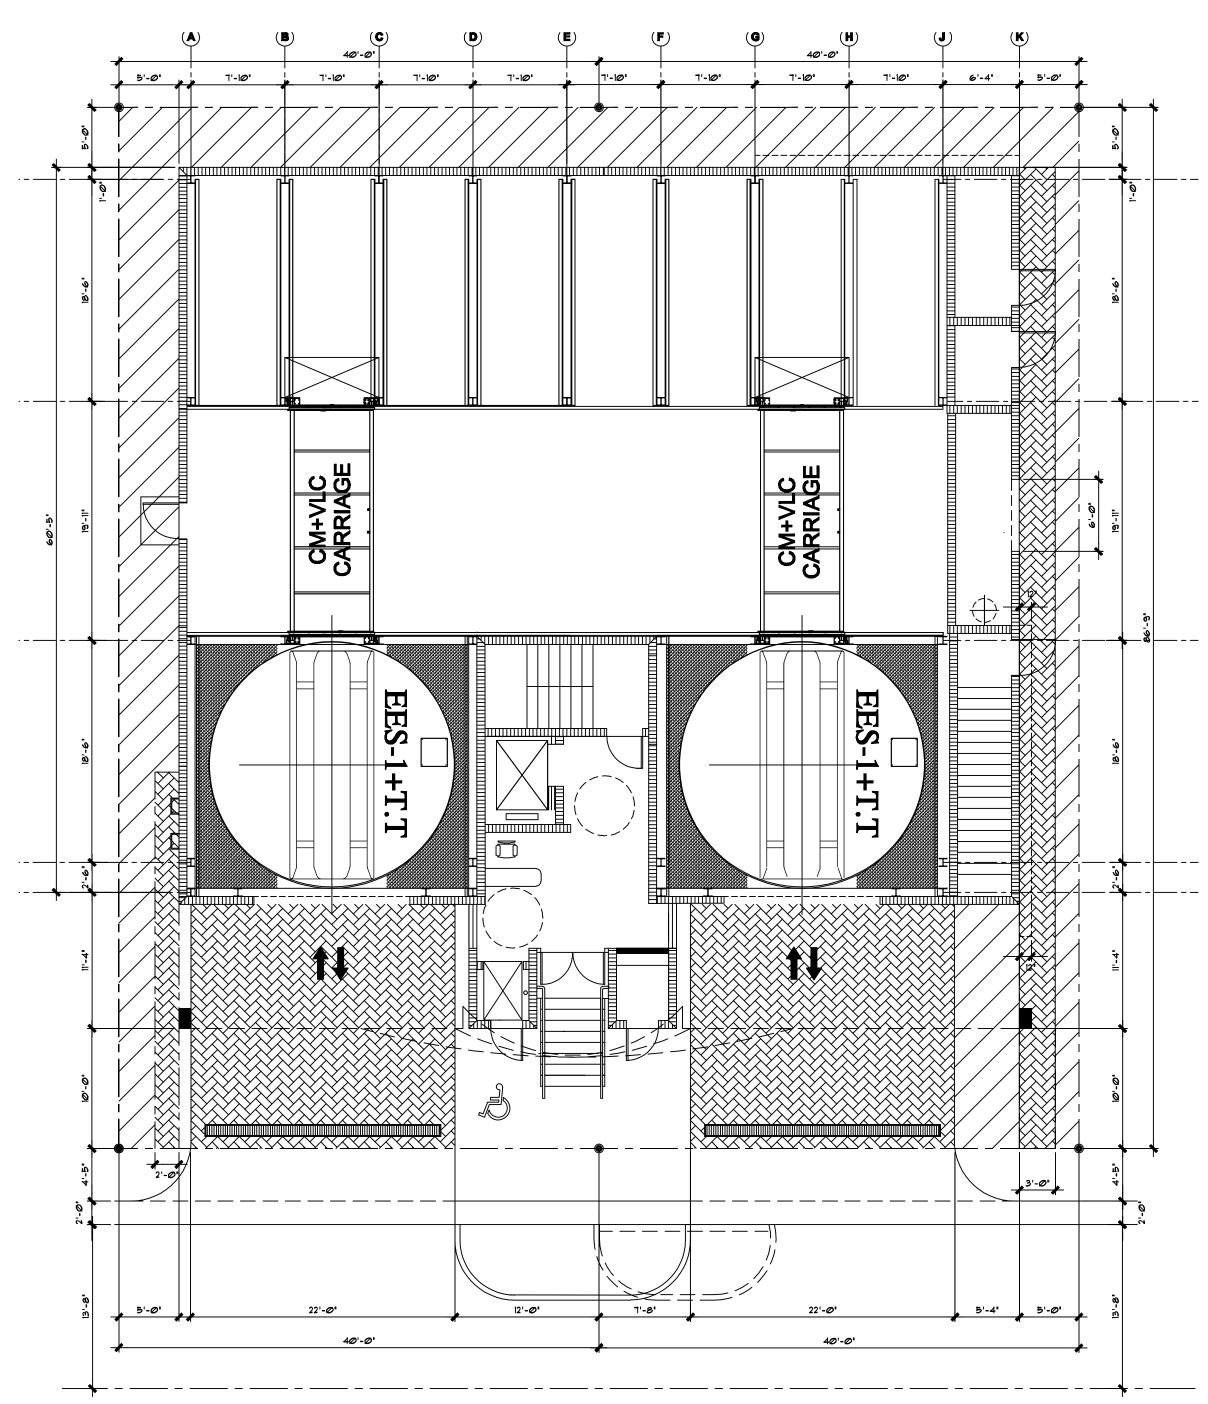

# GROUND FLOOR PERVIOUS AREAS

SCALE: 1/8" = 1'-0"

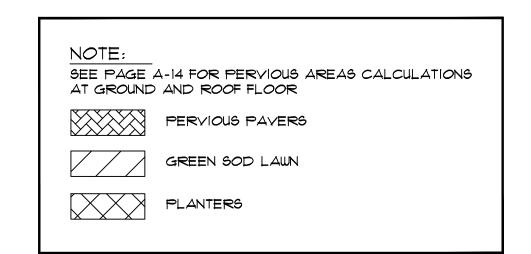


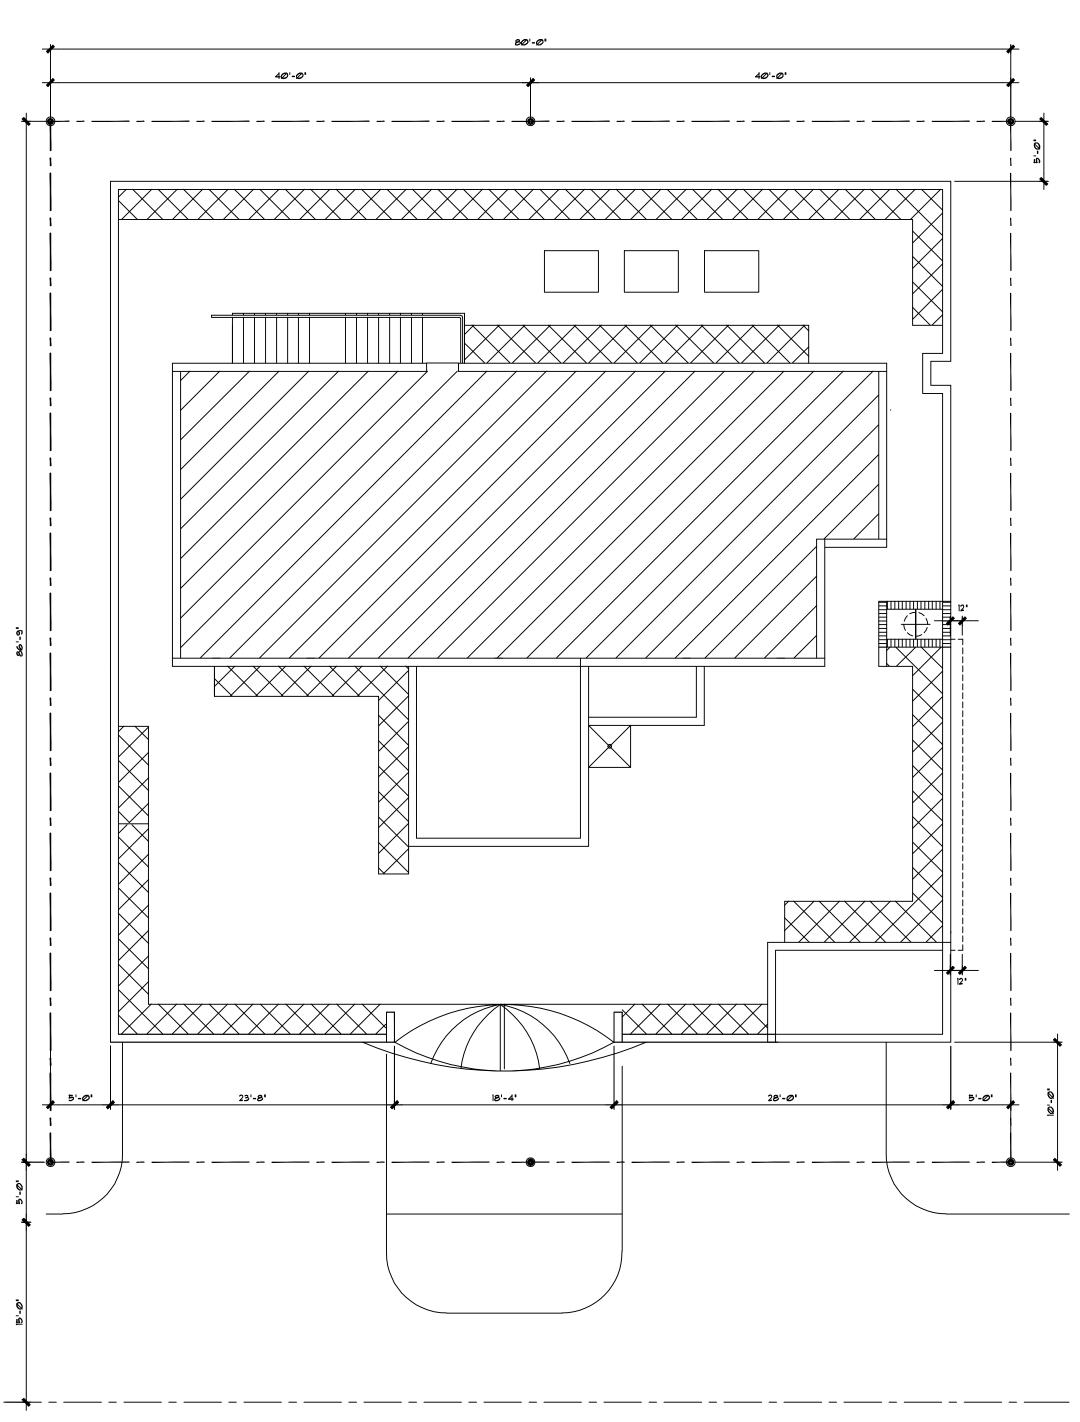

# TERRACE AND ROOF PERVIOUS AREAS

SCALE: 1/8" = 1'-0"

- ELEY. + 50'-0" TERRACE FLOOR

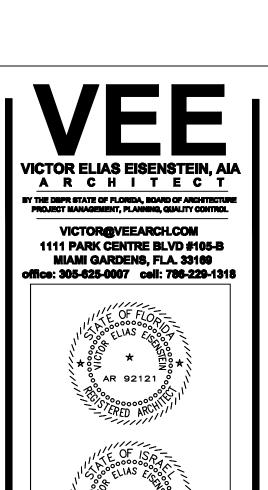

SEAL: VICTOR BLAS ESCHISTEN. ARSEIN

320-324 MINNESOTA STREE HOLLYWOOD, FLA. 33019

/ISIONS:

TAC & PDB

SUBMITTAL:

DEVELOPMENT
BOARD
SUBMITTAL

SCALE:

AS INDICATED


DATE:


2-27-2017

DATE: 2-27-201 PROJECT No:

DRAWN BY: CHECKED BY

GE No:

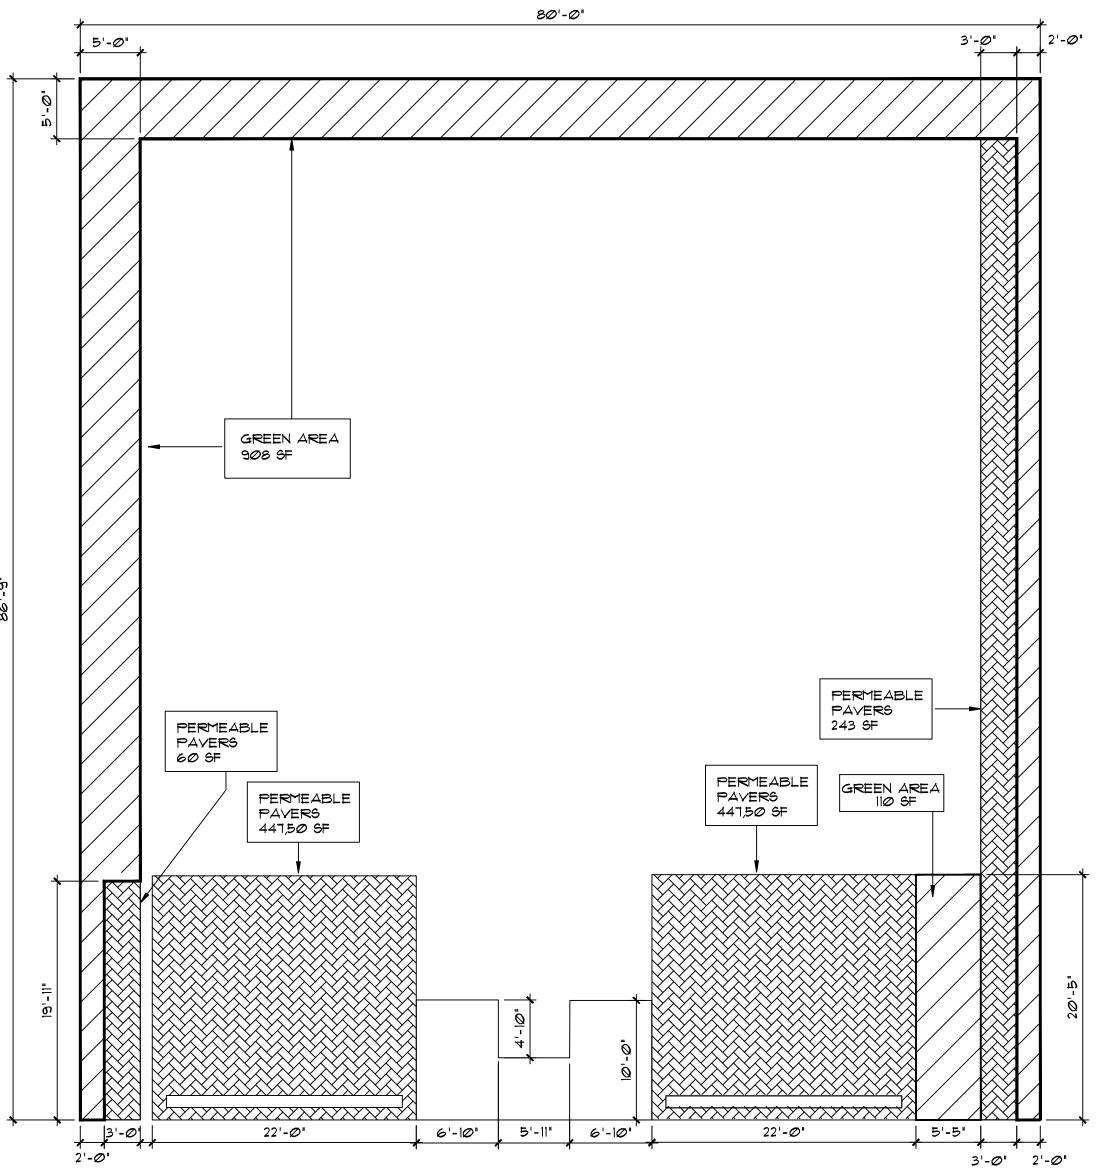

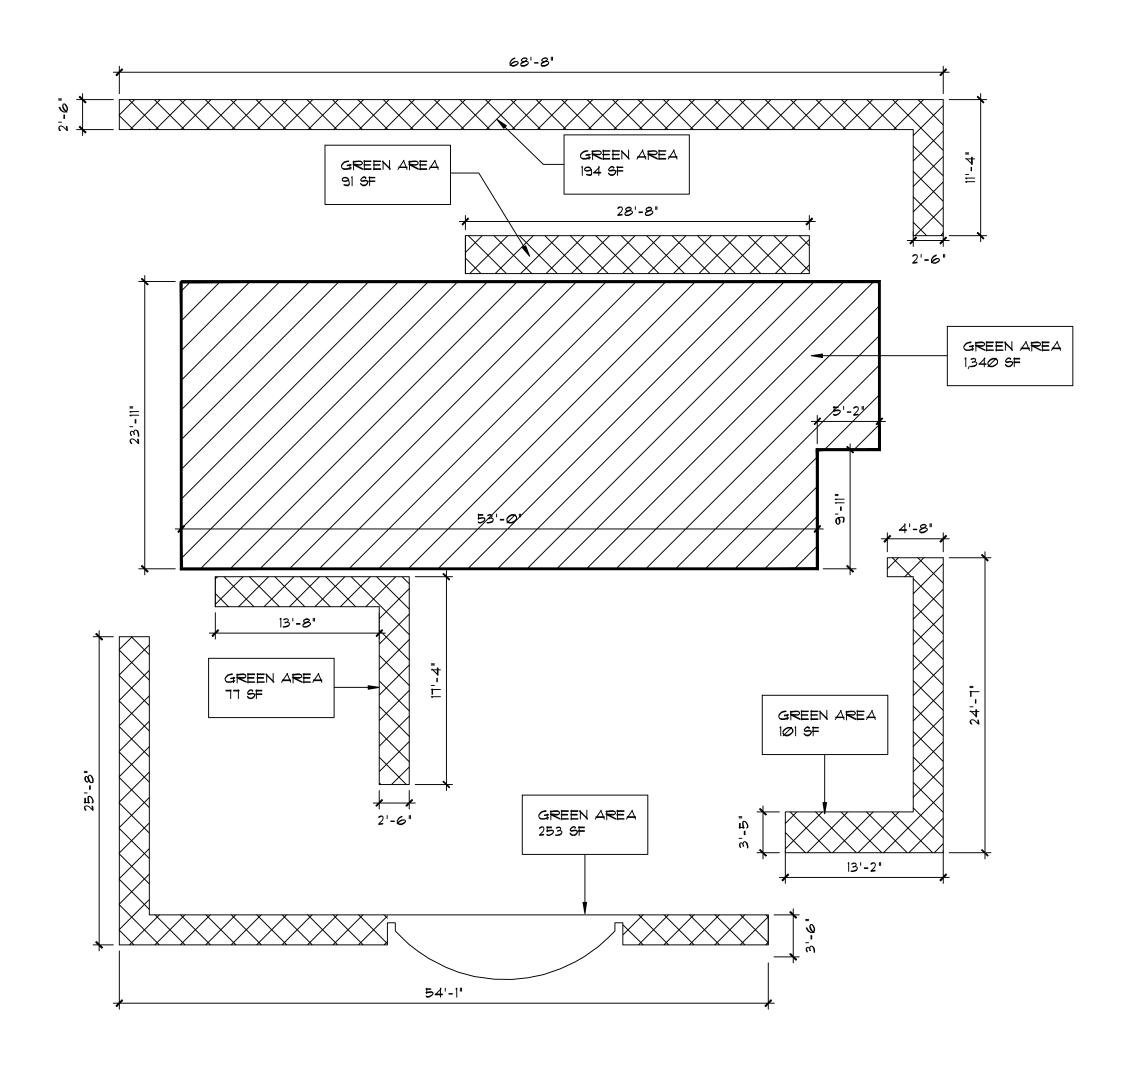

# GROUND FLOOR PERVIOUS AREAS



SCALE: 1/8" = 1'-0"

# KEY NOTES: PERVIOUS PAVERS GREEN SOD LAWN PLANTERS


# GROUND FLOOR PERVIOUS AREA CALCULATION

LOT AREA		6,936 SF
GREEN AREA PERMEABLE PAVERS	1,018 SF 1,198 SF	14,67 % 17,27 %
GROUND FLOOR TOTAL	2,216 SF	31,94 %

## TERRACE AND ROOF PERVIOUS AREA CALCULATION

LOT AREA	(	6,936 SF	
PLANTERS Roof Green Area	716 SF 1,340 SF	10,32 % 19,31 %	
TERRACE	2,056 SF	29,631 %	_
GRAN TOTAL PERVIOUS AREAS	4,272 SF	61,59 %	_

# TERRACE AND ROOF PERVIOUS AREAS

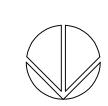

SCALE: 1/8" = 1'-0"


TERRACE FLOOR

#### **IRRIGATION NOTES**

AS PER THE CITY OF HOLLYWOOD LANDSCAPE MANUAL, PROVIDE 100% IRRIGATION COVERAGE BY MEANS OF AN AUTOMATC SPRINKLER SYSTEM DISIGNED AND CONSTRUCTED IN ACCORDANCE WITH THE CITY OF HOLLYWOOD CODE OF ORDINANCES AND THE REGULATIONS OF THE SOUTH FLORIDA WATER MANAGEMENT DISTRICT

VICTOR ELIAS EISENSTEIN, AIA
ARCHITECTURE
PROJECT MANAGEMENT, PLANISMO, GUALITY CONTROL

VICTOR@VEEARCH.COM

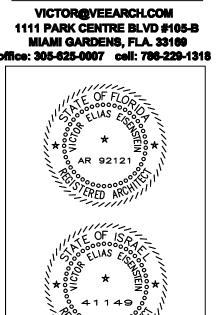



SEAL: VICTOR ELIAS EISENSTEIN.- AF

UILDING
TE AND OFFICE
A STREET

THE BLUE BUIL

EXECUTIVE HOTEL SUITE AN

320-324 MINNESOTA STR
HOLLYWOOD, FLA. 330

REVISIONS:

TAC & PDB

SUBMITTAL:

DEVELOPMENT
BOARD
SUBMITTAL

SCALE:

AS INDICATED


DATE:


2-27-2017

PROJECT No:

DRAWN BY: CHECKED BY
NATALIE P. VEE

PAGE No:

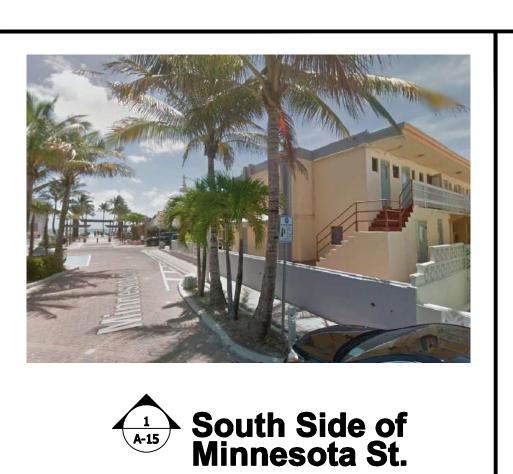

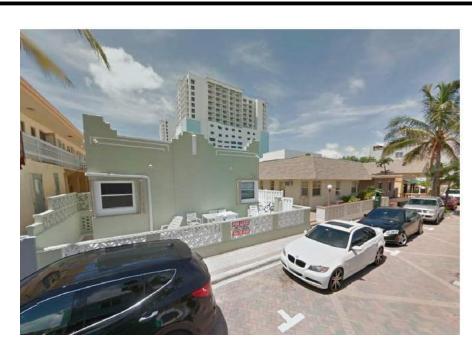

South Side of Minnesota St.










**LOT 22** South Side of Minnesota St.

South Side of Minnesota St.

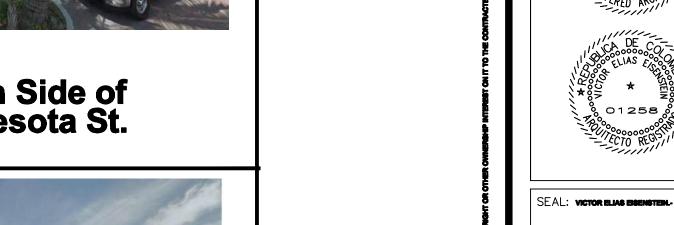











North Side of Minnesota St.

North Side of Minnesota St.





























3 A-15





7 A-15

PICTURE KEY PLAN NOT TO SCALE



NORTH OCEAN DRIVE A1A

DEVELOPMENT BOARD SUBMITTAL AS INDICATED PROJECT No:

TAC & PDB

ILDING AND OFFICE

VICTOR@VEEARCH.COM 1111 PARK CENTRE BLVD #105-B MIAMI GARDENS, FLA. 33169 Mice: 305-625-0007 cell: 786-229-1318


#### **Hydrant Flow Test Procedure**

#### Procedure For One & Two Flow Hydrant Test:

- Establish hydrants closest to location and associated water main(s).
- Static/Residual hydrant (P) should be located close to location (preferably off same main as to provide future water source).
- Flow hydrant(s) (F) should be located off same main up and down stream from mid-point test (static/residual) hydrant.
- Note static system pressure off P hydrant before opening any other (note any unusual or remarkable anomalies such as high demand sources, construction, etc.)
- Flow F1 hydrant and record GPM and residual off P hydrant. Flow F2 hydrant and record GPM and residual off P hydrant.
- Flow F1 & F2 simultaneously and record GPM separately from F1 and F2 and record P hydrant residual.


F1 & F2 Designation shall represent first and second flowed hydrants respectively Designation shall represent test hydrant for static and residual distribution system pressures.

HQS GROUP, INC.	CORNE	R OF MINNESOT	A ST. & SUR	F RD.	
Date: 10/3/16	Time:	8:15 A.M.	Static Press	ure	> 6;
Residual/Static Hydrant		Address/Locat	ion	Residual	Pressures
P - Hydrant				F-1 Only	F-2 Only
FH003442		312 Minnesota	St.	62	62
				F-1& F-2 ┗ "	> 59
Flow Hydrants		Address/Locat	ion	Flov	w Rate
<b>F-1 Hydrant</b> (Individual)					PM
FH003444		1200 N Surf R	d.	<b>1</b> 2 2 2 2 2 2 2 2 2 2 2 2 2 2 2 2 2 2 2	190
F-2 Hydrant				G	PM
(Individual) <b>FH003443</b>		339 Minnesota	St.	1	130
F-1 Hydrant				G	PM
(Both Flowing)				1	190
F-2 Hydrant				G	PM
(Both Flowing)				1	130

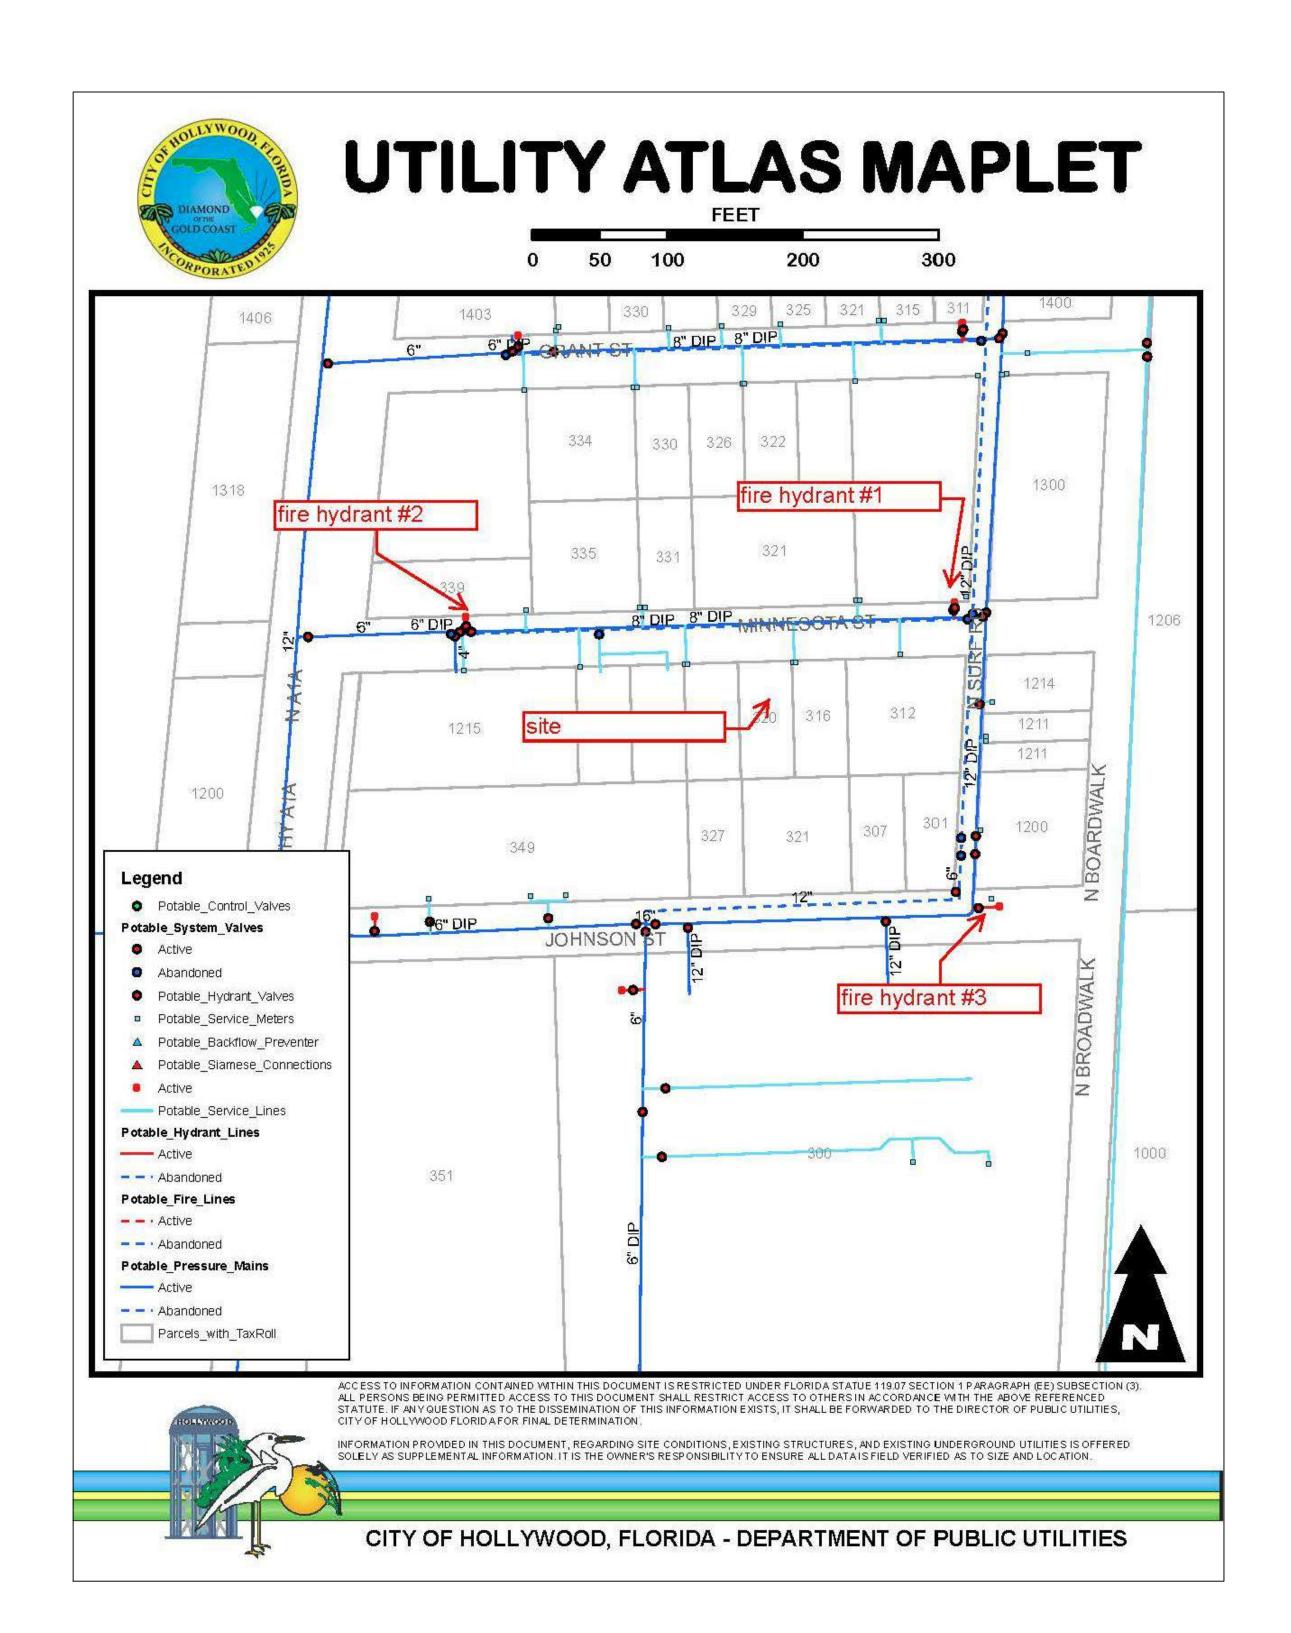





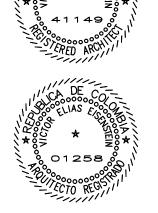


TAC & PDB

DEVELOPMENT BOARD SUBMITTAL

AS INDICATED

12-27-2016 PROJECT No:

DRAWN BY: CHECKED BY: NATALIE P.

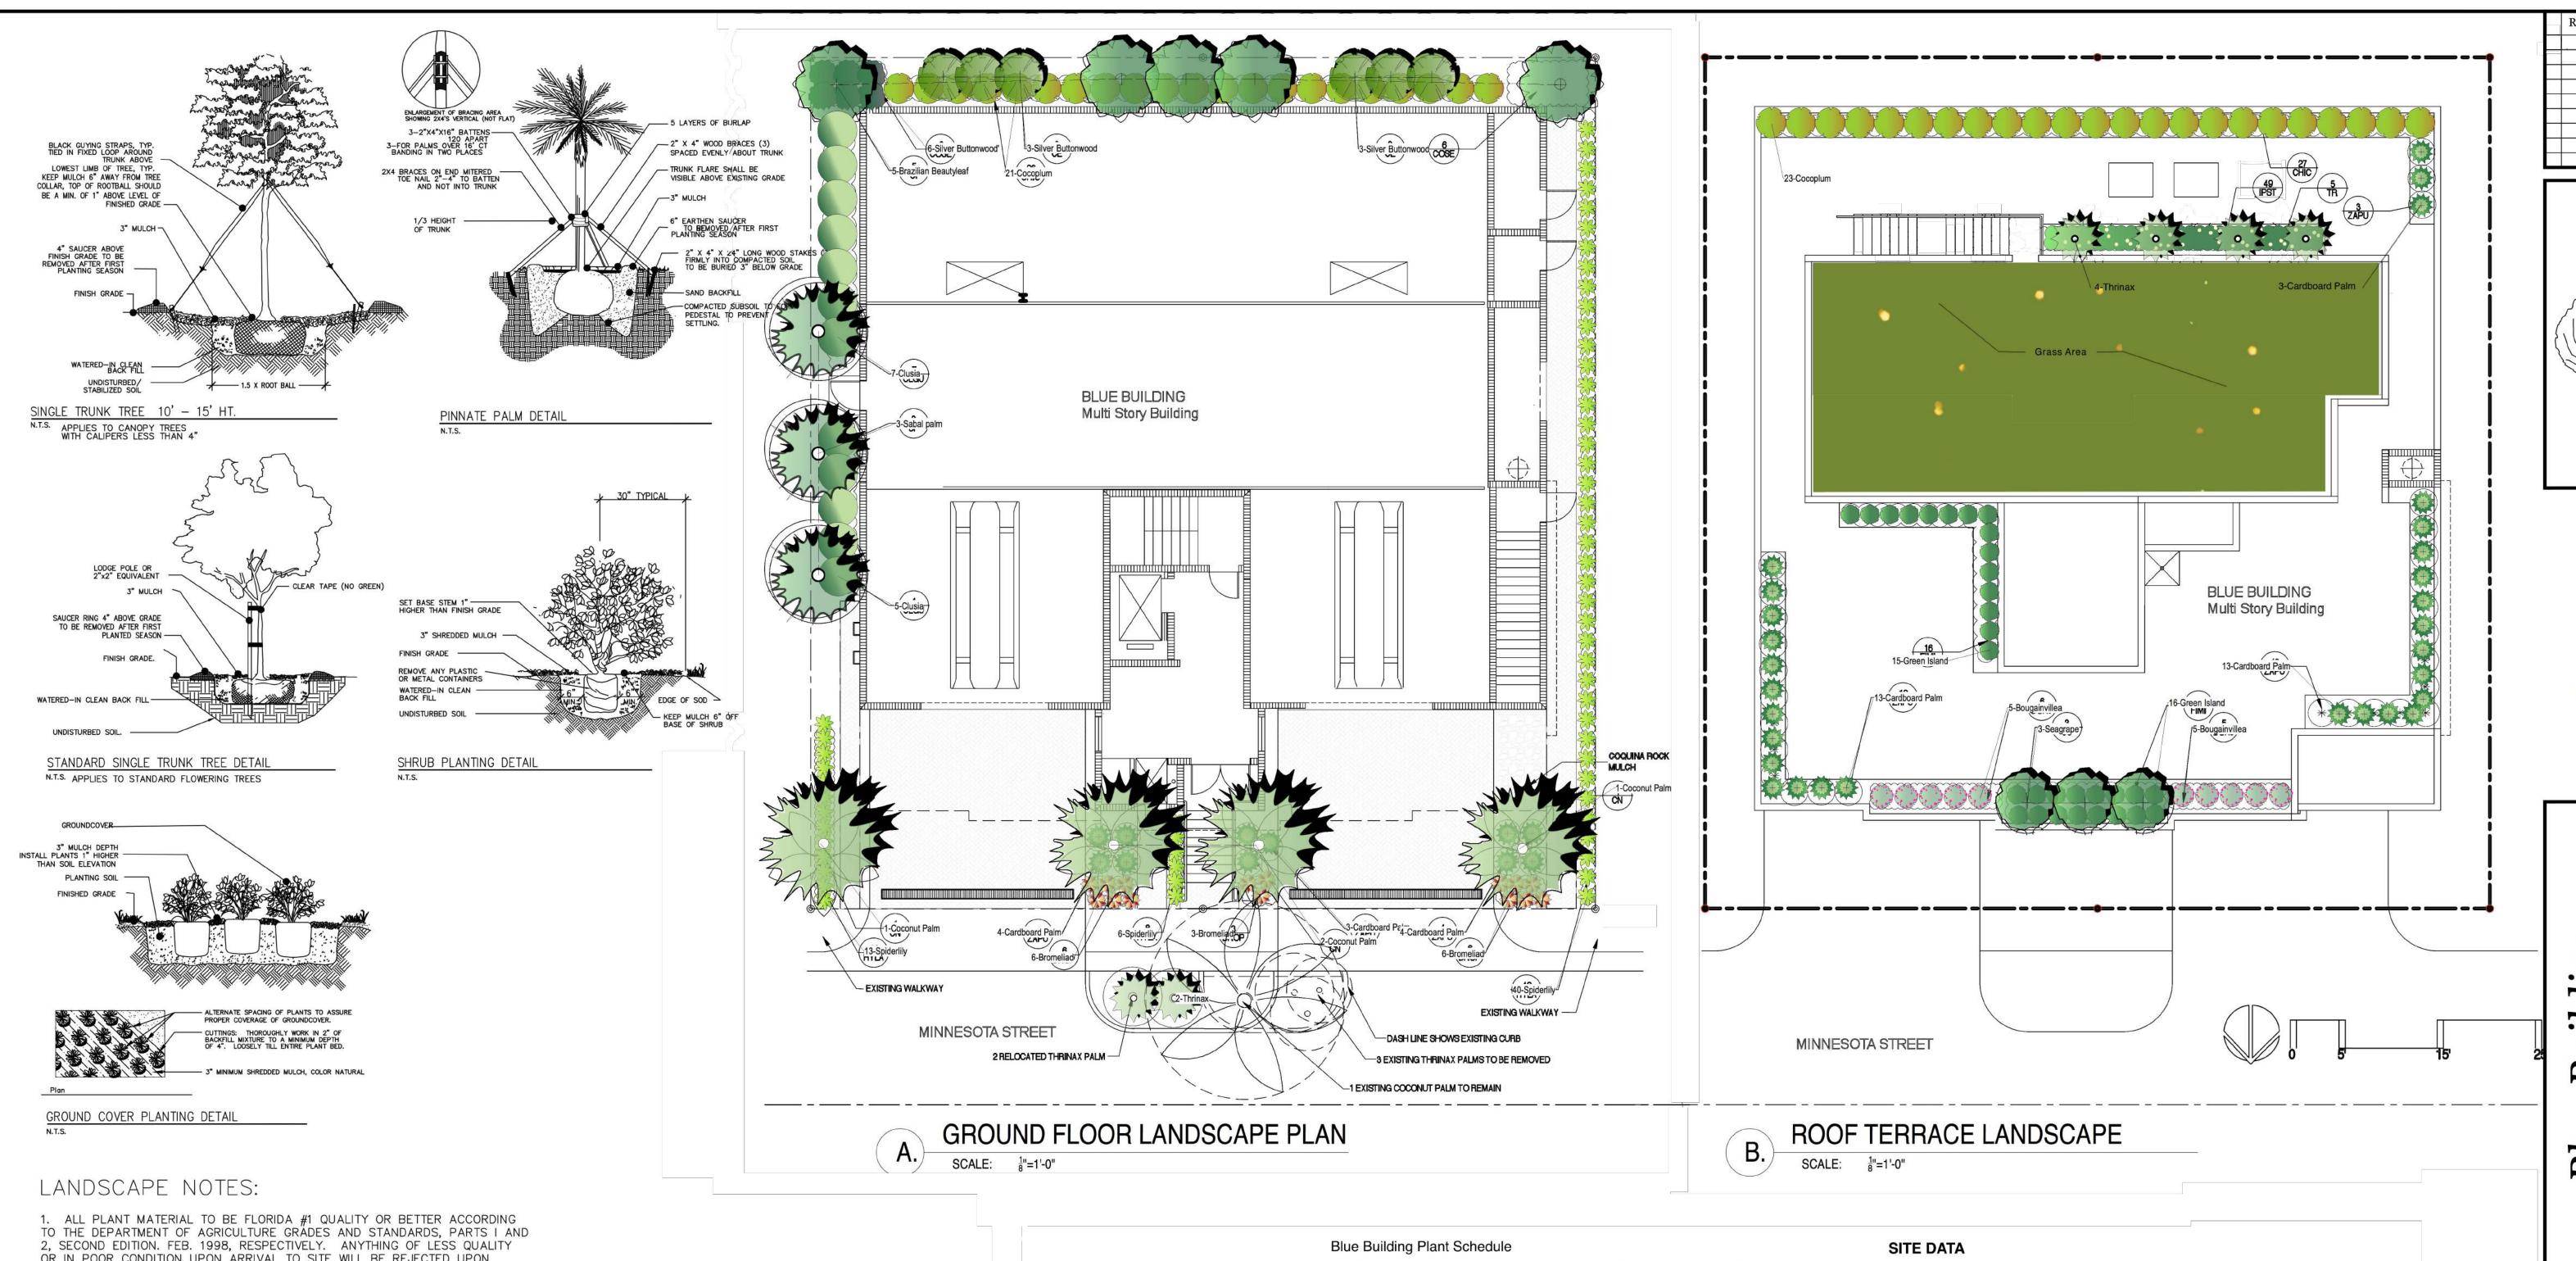

OR IN POOR CONDITION UPON ARRIVAL TO SITE WILL BE REJECTED UPON INSPECTION.

2. ALL MULCH MATERIAL WILL BE TOP GRADE, STERILIZED, FREE OF SEEDS, PESTS, AND MOLD.

3. PLANT BEDS SHALL BE TOPPED WITH A MINIMUM OF 3" OF SHREDDED MULCH (PREFERABLY PINE BARK) NON-COLOR OR 'NATURAL' UNLESS OTHERWISE DIRECTED BY OWNER OR L.A.

4. ALL GUYING AND BRACING OF TREES TO USE 2X2X36" STAKES WITH BLACK NYLON GUYING STRAPS SECURED WITH MIN. 8" LOOP, TO TREE TRUNK ABOVE FIRST BRANCH, UNLESS OTHERWISE DIRECTED BY OWNER OR L.A. 5. ALL GUYING AND BRACING OF PALMS TO BE INSTALLED ACCORDING TO GUIDELINES SHOWN, NO NAILS ARE TO BE DRIVEN INTO THE TRUNK OF THE PALM TREES.

6. PLANT BEDS SHALL BE FREE OF WEEDS AND VOLUNTEER GROWTH UPON COMPLETION OF LANDSCAPE INSTALLATION.

7. LANDSCAPE CONTRACTOR SHALL REVIEW ALL DRAWINGS AND PREPARE OWN QUANTITY COUNTS PRIOR TO BID. IN THE EVENT OF DISCREPENCY THE PLAN SHALL TAKE PRECEDENCE OVER THE PLANT LIST.

8. LANDSCAPE CONTRACTOR SHALL BE RESPONSIBLE FOR LOCATING ALL UNDERGROUND UTILITIES PRIOR TO DIGGING ACCORDING TO FLORIDA LAW, AND SHALL CONTACT SUNSHINE STATE ONE CALL AT 1-800-432-4770, A MINIMUM OF TEN BUSINESS DAYS BEFORE DIGGING.

9. LANDSCAPE PLAN IS A GRAPHIC DEPICTION OF INTENT AND MAY BE ALTERED BASED ON PLANT AVAILABILITY AND FIELD CONDITIONS UPON

APPROVAL OF LANDSCAPE ARCHITECT. 10. OWNER SHALL PROVIDE IRRIGATION SYSTEM THAT PROVIDES FOR 100% COVERAGE AND 100% OVERLAP FOR LANDSCAPE AREA UPON COMPLETION OF LANDSCAPE INSTALLATION, IRRIGATION SYSTEM SHALL INCLUDE A RAIN SENSOR AND A RUST PROHIBITOR DEVICE (IF NECESSARY). ALL PVC RISERS SHALL HAVE A FLAT BLACK FINISH.

Qty	Key	Botanical Name	Size	Spacing	Description	Native
5	TR	Thrinax radiata	25 Gallon, 5-6' OA Ht.	As Shown on Plan	Healthy Trunk & Full Frond Head	Y
20	FIMI	Ficus microcarpa 'Green Island'	3 Gallon, 12" Ht.	24" o.c.	Healthy Full, Gloss Leaf	N
53	CHIC	Chrysobalanus icaco 'Red Tip'	3 Gallon, 15" Ht.	30" o.c.	Healthy, Full, Glossy Leaf	Y
11	CLGU	Clusia guttifera	3 Gallon, 18" Ht.	48" o.c.	Healthy, Full Leaf	Υ
12	COSE	Conocarpus erectus 'Sericeus'	3 Gallon., 18" Ht.	30" o.c.	Healthy, Full Leaf	Υ
39	ZAPU	Zamia pumila	3 Gallon, 18" Ht.	30" o.c.	Healthy Full, Free of Pests	Y
49	IPST	Ipomoea stolonifera	1 Gallon, 6" Ht.	18" o.c.	Healthy vine, Blooming	Y
64	HYLA	Hymenocallis latifolia	3 Gallon, 18" Ht.	24" o.c.	Healthy, Full Leaf	Υ
4	CN	Cocos nucifera 'Maypan'	8' C.T. B&B	As Shown on Plan	Single Trunk	N
15	BROP	Bromeliad 'Orange Parfait'	1 Gallon, 6" Ht.	24" o.c.	Full Head, Healthy Colorful Leaf	N
6	CE	Conocarpus erectus 'Sericeus'	30 Gallon, 12' Ht.	As Shown on Plan	Standard Trunk, Specimen	Y
3	CU	Coccoloba uvifera	25 Gallon, 5-6' OA Ht.	As Shown on Plan	Shrub Form, Multi Trunk	Y
5	CI	Calophyllum inophyllum	45 Gallon, 12' OA Ht.	As Shown on Plan		Υ
11	вонј	Bougainvillea 'Helen Johnson'	3 Gallon, 30" O.C.	30" o.c.	Full, Healthy	N

Colorful

IMPER						
	ERVIOUS AREA					
	BUILDING FOOT PRINT	5082	SF			
	DRIVEWAY AND WALKWAY	1247	SF			
	TOTAL IMPERVIOUS	6329	SF	0.15	Ac.	91%
PERVI	VIOUS AREA					
	LANDSCAPE	625	SF	0.01	Ac.	9%
NATIV	IVE RATIO					
	QTY OF NATIVE PLANTS	250		83%		
	QTY OF NON NATIVE PLANTS	50		17%		
	TOTAL PLANTS	300				
	QTY OF NON NATIVE PLANTS	50				

#### Existing Trees & Palms

Species Name	Common Name	Estimated Height	Canopy Spread	Overall Condition	Proposed Action
Thrinax radiata	Thrinax Palm	12' OA	6'	Good	Relocate
Thrinax radiata	Thrinax Palm	10' OA	5'	Fair	Relocate
Thrinax radiata	Thrinax Palm	8' OA	4'	Poor	Remove
Cocos nucifera	Coconut Palm	22' OA	18'	Good	Remain



**5**,00 uildi

Landscape Planting Plan

SCALE 1/8"=1'-0 CHECKED BY: AR DRAWN BY: CG DATE: 12/10/16 FILE: BLUEBUILDING-LA1 SHEET

OF - SHEETS

