CITY OF HOLLYWOOD, FLORIDA DEPARTMENT OF DEVELOPMENT SERVICES PLANNING DIVISION

DATE:

March 09, 2017

FILE: 16-DPS-78

TO:

Planning and Development Board

VIA:

Leslie Del Monte, Planning Manager V

FROM:

Alexandra Carcamo, Principal Planner

SUBJECT:

Special Exception, Design, and Site Plan for an approximate 5,000 sq. ft. place of

worship located at 2726 Van Buren Street (Downtown Hollywood Synagogue).

APPLICANT'S REQUEST

Special Exception, Design and Site Plan for an approximate 5,000 sq.ft. place of worship (Downtown Hollywood Synagogue).

STAFF'S RECOMMENDATION

Special Exception: Approval.

Design:

Approval, if Special Exception is granted.

Site Plan:

Approval, if the Special Exception and Design are granted.

REQUEST

The subject property, located at 2726 Van Buren Street, is within the Multi-family Residential Core District. The current request is for a Special Exception, Design, and Site Plan for an approximate 5.000 sq. ft. place of worship.

Pursuant to the Zoning and Land Development Regulations, places of worship located in the Multi-family Residential Core Districts require a Special Exception. A Special Exception is defined as a use that is not generally appropriate in a district, but would be appropriate if it is consistent with the review criteria. The Multi-family Residential Core Purpose states, to provide adequate and compatible transitions in scale, character, and uses to adjacent residential neighborhoods.

The site is currently vacant. A one story building at 16 feet in height is proposed. The design consists of simple lines throughout the building with various openings. An accentuated main entrance is emphasized with decorative stone cladding. A neutral paint palette and varying materials, such as smooth stucco, and decorative screening materials are also used. The landscape plan incorporates an array of native trees, palms, and shrubs while improving the streetscape along Van Buren Street.

SITE INFORMATION

Owner/Applicant: Address/Location:

28 Avenue Facility, LLC 2726 Van Buren Street

Net Area of Property:

24,190 sq. ft. (0.56 acres) Regional Activity Center

Land Use:

Zoning: Multi-Family Residential Core (MC-1)

Existing Use of Land: Vacant

ADJACENT LAND USE

North: Regional Activity Center

South: Low Residential

East: Regional Activity Center **West:** Regional Activity Center

ADJACENT ZONING

North: Transitional Core (TC-1)
South: Single Family (RS-6)

East: Multi-Family Residential Core (MC-1) **West:** Multi-Family Residential Core (MC-1)

CONSISTENCY WITH THE COMPREHENSIVE PLAN

Located within the Regional Activity Center (RAC), the subject site is surrounded by commercial; multifamily and single family residential; and other institutional uses. The goal of the Land Use Element is to promote a distribution of land uses that will enhance and improve the residential, business, resort, and natural communities while allowing landowners to maximize the use of their property. The request will enhance the existing conditions of the site while providing a service to the area and region.

The proposed request is consistent with Comprehensive Plan based upon the following:

Goal: Promote a distribution of land uses that will enhance and improve the residential, business, resort, and natural communities while allowing land owners to maximize the use of their property.

Policy 4.9: Place a priority on protecting, preserving and enhancing residential neighborhoods while incorporating the unique characteristics of redevelopment areas.

CONSISTENCY WITH THE CITY-WIDE MASTER PLAN

The site is located in Sub-Area 3, East Central Hollywood, defined by Dixie Highway to the east, Stirling Road to the north, Pembroke Road to the south and I-95 to the west. This area includes the residential neighborhoods of Liberia/Oakwood Hills, North Central and South Central. The proposed request is consistent with the City-Wide Master Plan, based upon the following Guiding Principles and Policies.

Guiding Principles and Policies:

- Promote the highest and best use of land in each sector of the City without compromising the goals of the surrounding community.
- Increase participation and promote the expansion of cultural and educational programs.
- Attract and retain businesses that will increase economic opportunities for the City while enhancing the quality of life for residents.

APPLICABLE CRITERIA

Analysis of Criteria and Findings for Special Exception as stated in the City of Hollywood's Zoning and Land Development Regulations, Article 5.

CRITERIA 1: The proposed use must be consistent with the principles of the City's Comprehensive

Plan.

ANALYSIS:

The intent of the Land Use Element is to lay out the physical plan for future redevelopment while promoting the highest and best use for each property. The project is located within the Regional Activity Center Land Use. The major purpose of this Land Use Category is to facilitate multi-use and mixed-use development, encourage mass transit, reduce the need for automobile travel, provide incentives for quality development, and give definition to urban form. The proposed place of worship is consistent with the Comprehensive Plan as the goal of the Land Use Element is to promote a distribution of land uses that will enhance and improve the residential, business, resort, and natural communities while allowing landowners to maximize the use of their property. The request will enhance the existing conditions of the site while providing a service to the area and region as a place of worship serves as an anchor for the community.

The Applicant states, "The proposed use is compatible with the existing land use pattern and other real properties in the vicinity. Specifically, as the Property is 82 ft. from an existing church as well as a variety of community uses (i.e. schools, day care facility, doctor's office)."

FINDING: Consistent.

CRITERIA 2: The proposed use must be compatible with the existing land use pattern and

designated future uses and with the existing natural environment and other real

properties within the vicinity.

ANALYSIS: The existing land use for this property is Regional Activity Center (RAC). The RAC

was significantly expanded in 2005, which incorporated (this property) the area between Downtown and Interstate-95, among other areas. Prior to this, the land use was Medium Intensity Residential 11-16 units per acre, the area to the north was Office (now RAC) and the area to the south has continued to be Low Residential. Overtime, as intended with the RAC expansion, this portion of Van Buren Street has transitioned from being mostly residential uses to community facilities uses, such as schools, day cares, and places of worship; these uses provide a transition to surrounding residential neighborhoods. As such, the request for a place of worship is

compatible with the surrounding uses.

FINDING: Consistent.

CRITERIA 3: That there will be provisions for safe traffic movement, both vehicular and pedestrian,

both internal to the use and in the area which will serve the use.

ANALYSIS: The Applicant has worked with Staff to provide both vehicular and pedestrian access.

The proposed development will enhance the street scape to a corridor that serves as

a buffer to neighboring residential areas.

As stated by the Transportation Engineer hired by the Applicant "...traffic generated by the proposed synagogue use will be minimal and will not have any measurable impact on the surrounding roadway network, particularly during the weekday peak hours when the surrounding roadway network experiences its peak volumes.

Therefore, this project will not generate any adverse traffic impacts and is a complementary use from a traffic generation perspective because its peak activity period occurs on weekend, outside of the peak traffic weekday volume periods on the surrounding roadways."

FINDING: Consistent.

CRITERIA 4: That there are setbacks, buffering, and general amenities in order to control any

adverse effects of noise, light, dust and other potential nuisances.

ANALYSIS: The proposed setbacks exceed the requirement for the district. Moreover, the

Applicant is proposing to significantly increase the quality and quantity of landscaping on the site; attention to the south boundaries are given, specifically to those adjacent to residential areas. As part of the improvements, additional buffering materials which include a 6 foot solid wall bordering the property line along the east, west, and south.

The place of worship will be gated for additional security.

The Applicant states, "As proposed the Synagogue will more than adequately address all potential nuisances. In fact, all of the proposed setback, lighting, and landscaping requirements are met or exceed what is required by the City's Code."

FINDING: Consistent.

CRITERIA 5: The proposed use, singularly or in combination with other Special Exceptions, must

not be detrimental to the health, safety, or appearance of the neighborhood or other adjacent uses by reason of any one or more of the following: the number, area, location, height, orientation, intensity or relation to the neighborhood or other

adjacent uses.

ANALYSIS: Other Special Exception uses, such as schools, places of worship and daycares do

coexist in this area, in addition to offices. Some additional uses within the vicinity include City Hall, Public Library, restaurants and retail. As such, this street provides transitional uses between the more intense uses along Hollywood Boulevard and single family neighborhood to the south. The proposed place of worship is not

detrimental to the health, safety, or appearance of the neighborhood.

FINDING: Consistent.

CRITERIA 6: The subject parcel must be adequate in shape and size to accommodate the

proposed use.

ANALYSIS: The subject parcel is adequate in shape and size to accommodate the proposed use

and meets the requirements by code. Parking is provided on site and direct pedestrian access off of Van Buren Street leads to the main entrance of the

Synagogue.

The Applicant states, "The subject parcel is adequate in shape and size to accommodate the proposed use. In fact, because of the size of the parcel, the developer was able to orient the building in a way that reduced the impact to Van

Buren Street."

FINDING: Consistent.

CRITERIA 7: The proposed use will be consistent with the definition of a Special Exception and will

meet the standards and criteria of the zoning classification in which such use is

proposed to be located, and all other requirements for such particular use set forth elsewhere in the zoning code, or otherwise adopted by the City Commission.

ANALYSIS:

A Special Exception is defined as a use that is not generally appropriate in a district, but would be appropriate if it is consistent with the review criteria. The Multi-family Residential Core Purpose states, to provide adequate and compatible transitions in scale, character, and uses to adjacent residential neighborhoods. The majority of zoning districts allow certain Special Exception uses; in multi-family districts a place of worship falls in that category.

FINDING:

Consistent.

Analysis of Criteria and Findings for Design as stated in the City of Hollywood Zoning and Land Development Regulations, Article 5.

CRITERIA 1:

Architectural and Design components. Architecture refers to the architectural elements of exterior building surfaces. Architectural details should be commensurate with the building mass. The use of traditional materials for new architectural details is recommended. Design of the building(s) shall consider aesthetics and functionality, including the relationship of the pedestrian with the built environment.

ANALYSIS:

The design consists of simple lines throughout the building with various openings. An accented main entrance is emphasized with decorative stone cladding. A neutral paint palette and varying materials, such as smooth stucco, and decorative screening materials are also used.

FINDING:

Consistent.

CRITERIA 2:

Compatibility. The relationship between existing architectural styles and proposed construction, including how each building along the street relates to the whole and the pattern created with adjacent structures and the surrounding neighborhood. Buildings should contain architectural details that are characteristic of the surrounding neighborhood.

ANALYSIS:

The Design Guidelines state new construction should differentiate itself from neighboring buildings in terms of architectural style while the scale, rhythm, height and setbacks as well as the location of windows, doors and balconies bear some relationship to neighboring buildings and maintain some resemblance of compatibility. The proposed development is compatible with the surrounding neighborhoods, specifically the adjacent uses along Van Buren Street.

FINDING:

Consistent.

CRITERIA 3:

Scale/Massing. Buildings shall be proportionate in scale, with a height which is consistent with the surrounding structures. Building mass shall reflect a simple composition of basic architectural details in relation to its length, width, height, lot coverage, and setting of the structure in context with adjacent buildings. Architectural details include, but are not limited to, banding, molding, and fenestration.

ANALYSIS:

The development consists of a one story building with a maximum height of 16 feet. Enhancement of the street scape to a corridor that serves as a buffer to neighboring residential areas is proposed adding landscape buffers and direct pedestrian access. As stated by the Applicant, "the spatial arrangement for this facility places its architectural scale emphasis on the main entrance and the main worshiping space. This larger "mass" or "volume" of the building is placed towards the pedestrian and is

celebrated with the articulation of precious and organic Jerusalem stone cladding sections."

FINDING: Consistent.

CRITERIA 4: Landscaping. Landscaped areas should contain a variety of native and other compatible

plant types and forms, and be carefully integrated with existing buildings and paved areas. Existing mature trees and other significant plants on the site should be preserved.

ANALYSIS: The landscape plan incorporates an array of native trees, palms, and shrubs while

improving the streetscape along Van Buren Street. The Applicant has worked with the City in selecting appropriate landscaping material which meets the City of

Hollywood's landscaping requirements.


FINDING: Consistent.

SITE PLAN

The Technical Advisory Committee (TAC) found the proposed Site Plan compliant with all regulations as set forth in Article 6 of the Zoning and Land Development Regulations on January 19, 2017. Therefore Staff recommends approval, if the Special Exception and Design are granted.

ATTACHMENTS

Attachment A: Application Package
Attachment B: Land Use and Zoning Map

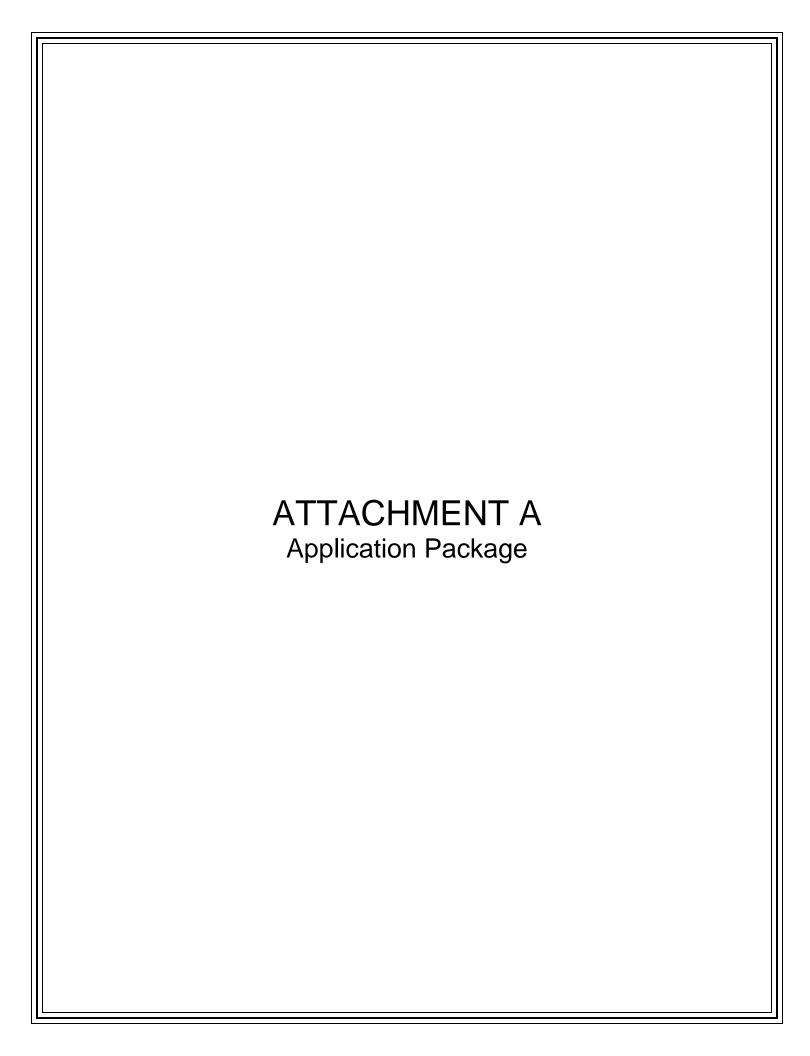

DEPARTMENT OF PLANNING



2600 Hollywood Boulevard Room 315 Hollywood, FL 33022

File No	(internal use	only).			
FILE INO.	(internal use	Offly).		1	

GENERAL APPLICATION



Tel: (954) 921-3471 Fax: (954) 921-3347

This application must be completed in full and submitted with all documents to be placed on a Board or Committee's agenda.

The applicant is responsible for obtaining the appropriate checklist for each type of application.

Applicant(s) or their authorized legal agent must be present at all Board or Committee meetings.

At least one set of the submitted plans for each application must be signed and sealed (i.e. Architect or Engineer).

Documents and forms can be accessed on the City's website at

http://www.hollywoodfl.org/ DocumentCenter/Home/ View/21



(tel: 305-593-9959)

(fax: 305-593-9855)

APPLICATION TWO WAS ASSESSED TO SELECT THE SECOND S
APPLICATION TYPE (CHECK ONE):
☐ Technical Advisory Committee ☐ Historic Preservation Board
☐ City Commission
Date of Application: 01.23.2017
Location Address: <u>2726 Van Buren Street, Hollywood, FL 33020</u> Lot(s): Lot 17, & Part of Lot 16 Block(s): <u>29</u> Subdivision: <u>Hollywd Little Ranc</u>
Folio Number(s):5142-16-02-2860
Zoning Classification: MC-1 Land Use Classification: Regional Activity Cen Existing Property Use: Vacant Property Sq Ft/Number of Units: N/A
Is the request the result of a violation notice? () Yes (No If yes, attach a copy of violation
Has this property been presented to the City before? If yes, check al that apply and provide File
Number(s) and Resolution(s):
☐ Economic Roundtable ☐ Technical Advisory Committee ☐ Historic Preservation Board
☐ City Commission
Explanation of Request: REQUESTING APPROVAL FOR PROPOSED 5,026 SQ.FT. ONE-STO RELIGIOUS FACILITY
RELIGIOUS FACILITY
Number of units/rooms: N/A Sq Ft:5,026 SQ.FT.
Value of Improvement: \$1.5 MILLION Estimated Date of Completion:JULY 2017
Will Project be Phased? () Yes (No If Phased, Estimated Completion of Each Phase
A CONTRACT OF THE TOTAL CONTRACT OF THE TOTA
Name of Current Property Owner: 28 Avenue Facility, LLC
Address of Property Owner:6340 SUNSET DRIVE, MIAMI. FL 33143
Telephone:786-412-8741 Fax: Email Address: ROSANNE47@AOL.COM
Name of Consultan(Representative/) enant (circle one): Rabbi C. Albert (Hlwd. Downtown Syna
Address: 3728 N.E. 209th Terrace, Aventura, FL. 33180 Telephone: 786-234-0627,
Fax: <u>n/a</u> Email Address: <u>rcalbert18@gmail.com</u>
Date of Purchase: N/A Is there an option to purchase the Property? Yes()No(
If Yes, Attach Copy of the Contract.
List Anyone Else Who Should Receive Notice of the Hearing:IVAN FAJARDO (CIVICA, LLC)
Address:

DEPARTMENT OF PLANNING



2600 Hollywood Boulevard Room 315 Hollywood, FL 33022

GENERAL APPLICATION

Personally known to me; OR ___

CERTIFICATION OF COMPLIANCE WITH APPLICABLE REGULATIONS

The applicant/owner(s) signature certifies that he/she has been made aware of the criteria, regulations and guidelines applicable to the request. This information can be obtained in Room 315 of City Hall or on our website at www.hollywoodfl.org. The owner(s) further certifies that when required by applicable law, including but not limited to the City's Zoning and Land Development Regulations, they will post the site with a sign provided by the Office of Planning and Development Services. The owner(s) will photograph the sign the day of posting and submit photographs to the Office of Planning and Development Services as required by applicable law. Failure to post the sign will result in violation of State and Municipal Notification Requirements and Laws.

(I)(We) certify that (I) (we) understand and will comply with the provisions and regulations of the City's Zoning and Land Development

Regulations, Design Guidelines, Design Guidelines for Historic Properties and City's Comprehensive Plan as they apply to this project. (I)(We) further certify that the above statements and drawings made on any paper or plans submitted herewith are true to the best of (my)(our) knowledge. (I)(We) understand that the application and attachments become part of the official public records of the City and are not returnable. Signature of Current Owner: **PRINT NAME**: ROSANNE WRIGHT Date: _____ Signature of Consultart/Representative: PRINT NAME: Rabbi Chaim Albert Date: Date: Signature of Tenant: Date:___ PRINT NAME: **CURRENT OWNER POWER OF ATTORNEY** I am the current owner of the described real property and that I am aware of the nature and effect the request for (project description) DOWNTOWN HOLLYWOOD SYNAGOGUE to my property, which is hereby made by me or I am hereby authorizing (name of the representative) Rabbi Chaim Albert to be my legal representative before the TAC and ALL other City (Board and/or Committee) relative to all matters concerning of Hollywood Applications this application. Sworn to and subscribed before me this 23 hd day of _ SIGNATURE OF CURRENT OWNER Notary Public State of Florida PRINT NAME State of Monda My Commission FF 148101 Expires 08/27/2018

(Check One)

My Commission Expires:



HOLLYWOOD DOWNOWN SYNAGOGUE

Final Planning & Development Board Application

PROJECT LEGAL DESCRIPTION:

The East 18 feet of Lot 16 and all of Lot 17, Block 29, HOLLY LITTLE RANCHES, according to the Plat thereof as filed in Plat Book 1, page 26, of the Public Records of Broward County, Florida.

PROJECT INFORMATION:

The Proposed Hollywood Downtown Synagogue shall be a religious use facility located under property address of 2726 Van Buren Street, Hollywood, FL. 33020.

The site has on orthogonal / regular geometry with a total area of 0.55 acres and a street frontage of 118' feet. The proposed building structure shall be a one-story, 5,000 sq.ft. facility with religious worshiping hall and classroom areas.

The building construction and its component shall comply with the requirements of the Florida Building Code, and the Florida Fire Prevention Code. The building shall be protected by a full-time automated fire-suppression sprinkler system, and a fill-time monitored fire alarm system.

The facility's main entrance shall front Van Buren Street, and shall be articulated with decorative accent stone, the secondary facades shall have a smooth painted finish. The proposed landscaping shall include native spices consistent with xeriscape practices, and shall form thick buffers of continuous organic material. The exterior areas shall have lighting consistent with the City of Hollywood's zoning ordinances and shall be arranged so as to minimize the light-spill beyond the property lines.

Respectfully Submitted

IVAN A. FAJARDO Senior Project Manager

CIVICA, LLC Architecture + Urban Design

Exhibit "1"

<u>The Hollywood Downtown Synagogue, Corp. Justification for Special Exception</u> to Operate a Synagogue at 2726 Van Buren Street

Hollywood Downtown Synagogue, Corp. ("Developer") intends to operate the Hollywood Downtown Synagogue ("Synagogue") at 2726 Van Buren St. ("Property") in the City of Hollywood (City). The Synagogue will provide people in the neighboring Community an opportunity to be part of a new, invocative, caring and welcoming Jewish Synagogue. Rabbi Chaim Albert, the President of the Hollywood Downtown Synagogue, Corp., will lead the new Synagogue in an under-served area. Rabbi Albert has been the congregational leader of Young Israel of Aventura and has a track record of outstanding leadership and vision for this new and growing Jewish Synagogue. The Property is proposed for construction on land that is zoned MC-1. In order to operate a Synagogue on the Property, a Special Exception must be granted. As outlined below, the granting of this Special Exception request will adhere to the review criteria set forth in Section 5.3.G.2 of the City's Land Development Code ("Code")¹:

a. The proposed use must be consistent with the principles of the City's Comprehensive Plan.

The proposed use is consistent with the principles of the City's Comprehensive Plan in that the construction of the Synagogue will allow the use of a vacant property that has no landscaping and temporary fencing (the vacant lot was created by the demolition of an existing eyesore), provide a significant religious opportunity for the residents in the City, promote beautification of the area and increase the City's tax base. The Comprehensive plan calls for improvements to the City in many different ways. If approved as proposed the Synagogue will revitalize the area and encourage redevelopment through the provision of an upscale use and an investment in the City's urban core as encouraged by the Neighborhood Master Plan, and in accordance with the City's comprehensive Plan. Additionally, Policy CW.44 of the City's City-Wide Master Plan provides as follows: "Foster economic development through creative land use, zoning and development regulations, City service sand City policies." Clearly, the addition of the Synagogue to the neighborhood will compliment the existing Church and Schools on the Van Buren Street between 26th and 28th Avenues. In addition the City has long followed the policy to approve Places of Worship to attract and retain families to the City and has consistently approved Places of Worship to implement those goals.

¹ The Developer reasonably believes that the Special Exception criteria are facially unconstitutional, and unconstitutional as-applied to this Project since the City advised of its final decision to apply the Code to this Project. Because the criteria contain ill-defined, un-defined, or vague terms for which the City cannot provide an objective definition, the Developer is attempting in good faith to comply, while reserving all of its rights to challenge the Code, its criteria and the City's application thereof to this Project.

b. The proposed use must be compatible with the existing land use pattern and designated future uses and with the existing natural environment and other real properties within the vicinity.

The proposed use is compatible with the existing land use pattern and other real properties in the vicinity. Specifically, as the Property is 82 ft. from an existing Church as well as a variety of community uses (i.e. Schools, day care facility, doctor's office). The Property is also adjacent to a residential neighborhood. The Synagogue is a perfect addition to the area. The proposed use will improve the tax base of the area, and encourage redevelopment to an urban infill area. The City's Comprehensive Plan provides that one Land Use Element Goal is to "Promote a distribution of land uses that will enhance and improve the residential, business, resort and natural communities while allowing land owners to maximize the use of their property." The Synagogue is consistent with this goal because it is compatible with the existing church and schools nearby and the nursery school in the immediate area. The compliment of Religious Facilities and schools (nursery, middle or high) will continue to attract and keep families in the area, which in turn will continue to increase property values in the neighborhood. The Synagogue will market to young families, especially those in Hollywood who want to be part of a new, invocative, caring and welcoming Jewish Community.

c. That there will be provisions for safe traffic movement, both vehicular and pedestrian, both internal to the use and in the area which will serve the use.

As evidenced by the traffic study prepared by Kimley Horn in connection with the site plan for The Hollywood Downtown Synagogue (see Attachment "A"), the Developer would provide a safe and efficient traffic pattern for the Synagogue. Specifically the report states, "... traffic generated by the proposed synagogue use will be minimal and will not have any measurable impact on the surrounding roadway network, particularly during the weekday peak hours when the surrounding roadway network experiences its peak volumes. Therefore, this project will not generate any adverse traffic impacts and is a complementary use from a traffic generation perspective because its peak activity period occurs on weekends, outside of the peak traffic weekday volume periods on the surrounding roadways."

d. That there are setbacks, buffering, and general amenities in order to control any adverse effects of noise, light, dust and other potential nuisances.

As proposed the Synagogue will more than adequately address all potential nuisances. In fact, all of the proposed setback, lighting and landscaping requirements are met or exceed what is required by the City's Code. Further, the building's main entrance will be far from the rear of the building, so Van Buren Street will not be negatively impacted. Any potential nuisances will also be mitigated through the provision of a 6 ft. solid concrete block wall around South, East and West boundaries of the site in addition to lush landscaping along the site perimeter. NO variances are being requested or required on the proposed Property.

e. The proposed use, singularly or in combination with other Special Exceptions, must not be detrimental to the health, safety, or appearance of the neighborhood or other adjacent uses by reason of any 1 or more of the following: the number, area, location, orientation, intensity or relation to the neighborhood or other adjacent uses.

The proposed use will not be detrimental to the neighborhood. The scale of the Synagogue is in keeping with the surrounding neighborhood. The orientation of the building North/South is a benefit because there is less of an impact on Van Buren St. Further, as previously stated, the construction of the Synagogue will cause a vacant lot with a temporary fence to make way for the construction of a new facility, which will enhance the neighborhood.

f. The subject parcel must be adequate in shape and size to accommodate the proposed use.

The subject parcel is adequate in shape and size to accommodate the proposed use. In fact, because of the size of the parcel, the Developer was able to orient the building in a way that reduced the impact to Van Buren Street. Further, given the buffering at the rear of the Property, and the amount of open space that separates the parking area from the neighbors to the south, the site is perfect for the proposed use. As proposed, the Synagogue will benefit the neighborhood through a design plan that is aesthetically pleasing, efficient, landscaped, buffered and safe.

g. The proposed use will be consistent with the definition of a Special Exception and will meet the standards and criteria of the zoning classification in which such use is proposed to be located, and all other requirements for such particular use set forth elsewhere in the zoning code, or otherwise adopted by the City Commission.

According to the Code, Places of Worship are allowed and have consistently been approved in zoning categories like MC-1 by a Special Exception. It is a use that is appropriate if it is consistent with the review criteria set forth herein. Considering the Synagogue's proximity to residential development, and the proximity to an existing Church, this location appears to be appropriate for the proposed use. If approved, residents of the City and future residents of the City who want a new, invocative, caring and welcoming Jewish Community will benefit from the placement of the Synagogue on the Property.

Attachment "A"



December 14, 2016

Rabbi Chaim Albert c/o Downtown Hollywood Synagogue Corp. 3728 NE 209th Terrace Aventura, FL 33180

RE: Hollywood Downtown Synagogue – Traffic Statement

Hollywood, Florida

Dear Rabbi Albert:

As requested, Kimley-Horn and Associates, Inc. has prepared a traffic impact statement for the proposed synagogue facility to be located at 2726 Van Buren Street in Hollywood, Florida. The development program includes a one-story synagogue facility with a total building area of 4,527 square feet. Figure 1 illustrates the site location. As shown in the attached site plan, vehicular access will be provided via one full-access driveway on Van Buren Street.

Trip Generation Determination

A trip generation determination was prepared to determine the volume of trips generated by the proposed synagogue. To perform this calculation, rates and equations published by the Institute of Transportation Engineers (ITE) in the *Trip Generation Manual*, 9th Edition were used to determine the trip generation potential of the proposed synagogue. Rates and equations for Synagogue (ITE Land Use 561) were used for the trip generation calculations. To provide a conservative analysis, the "peak hour of generator" rates were used instead of "peak hour of adjacent street traffic". During the weekday PM peak hour, the peak hour of adjacent street traffic coincides with the peak hour of generator. *Table 1* summarizes the trip generation calculation for this project for weekday conditions and *Table 2* summarizes the trip generation calculation for weekend conditions.



TABLE 1 WEEKDAY PEAK HOUR TRIP GENERATION HOLLYWOOD DOWNTOWN SYNAGOGUE								
Land Use	Land Use Intensity AM Peak Hour PM Peak Hour					ur		
Land Use	Intensity		Total	ln	Out	Total	ln	Out
Synagogue	4,527	sq. ft.	2	1	1	8	4	4
Net New External Trips			2	1	1	8	4	4

Trip generation was calculated using the following data:

AM Peak Hour Trip Generation

Synagogue | ITE [561] = T = 0.42 trips per 1,000 SF (56% in / 44% out) *

PM Peak Hour Trip Generation

Synagogue ITE [561] = T = 1.69 trips per 1,000 SF (47% in / 53% out) **

Notes:

- * Used AM peak hour of generator to provide conservative analysis
- ** PM peak hour of generator is same as PM peak hour of adjacent street traffic

TABLE 2 WEEKEND PEAK HOUR TRIP GENERATION HOLLYWOOD DOWNTOWN SYNAGOGUE						
Land Use	Intensity		Weekend Peak Hour			
Edita 630			Total	ln	Out	
Synagogue	4,527	sq. ft.	34	17	17	
Net New External Trips			34	17	17	

Trip generation was calculated using the following data:

Weekend Peak Hour Trip Generation

Synagogue ITE [561] = T = 7.58 trips per 1,000 SF (49% in / 51% out) *

Notes:

* Based on Sunday peak hour of generator

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As shown in *Table 1*, the proposed synagogue has the potential to generate 2 AM peak hour trips and 8 PM peak hour trips on a typical weekday peak hour basis. This impact is considered to be *de minimis* and would not have any measurable impact on level of service on the surrounding roadway network. As shown in Table 2, during the peak the weekend hour, the site has the potential to generate a total of 34 peak hour trips. This volume is also a low impact and is substantially lower than the traffic generated by the nearby schools on Van Buren Street during the weekday peak hours. Because school is not in session on weekends and therefore background volumes on Van Buren Street are significantly lower than they are prior to school arrival and dismissal, the synagogue's traffic prior to and after services will be accommodated without adverse impacts on the surrounding transportation network.



As shown, traffic generated by the proposed synagogue use will be minimal and will not have any measurable impact on the surrounding roadway network, particularly during the weekday peak hours when the surrounding roadway network experiences its peak volumes. Therefore, this project will not generate any adverse traffic impacts and is a complementary use from a traffic generation perspective because its peak activity period occurs on weekends, outside of the peak traffic weekday volume periods on the surrounding roadways.

Please contact me via telephone at (561) 840-0248 or via e-mail at chris.heggen@kimley-horn.com should you have any questions regarding this evaluation.

Sincerely,

KIMLEY-HORN AND ASSOCIATES, INC.

No. 58636

Tanspartation Engine

Number 58636

Certificate of Authorization Number CA00000696


Attachment

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Project Site






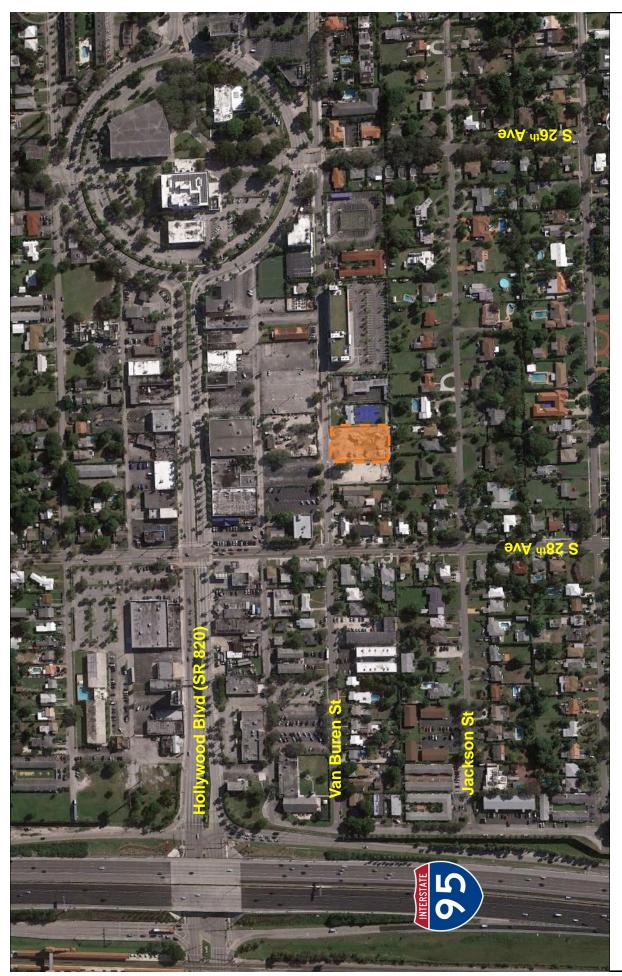

PROJECT:

ALL REQUIRED COUNTY AND STATE RELATED PERMITTS SHALL BE OBTAINED PRIOR TO CITY OF HOLLYWOOD BDLG DEPT PERMIT ISSUANCE

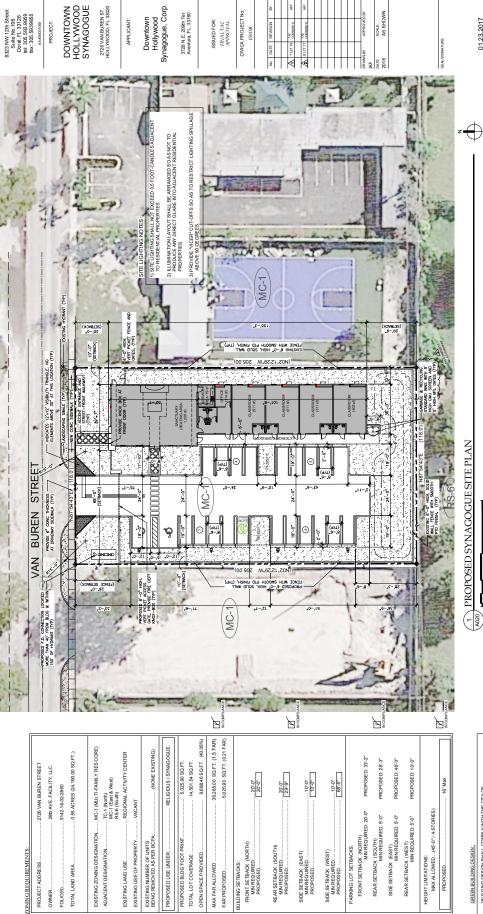

3728 N.E. 209th Ter Aventura, FL. 33180

FINAL TAC APPRO VAL

ISSUED FOR:

APPLICANT:

AND PROPOSED SYNAGOGUE SITE PLAN

*BUILDING DESIGN SHALL COMPLY WITH THE CITY OF HOLLYWOOD GREEN BUILDING ORDINANCE AS APPLICABLE

GREEN BUILDING DESIGN

PARKING DATA ANALYSIS PARKING REQUIEMENTS BASED ON THE ZONING AND LAND DEVELOPMENT CODE OF ORDINANCES.

Parking Require

7	INCOMPLIANCE
22 Spaces	
	┰

/ 250 sq.ft. 1,259 sq.ft. / 60 sq.ft.

114 sq.ft.

IN COMPUANCE

I Pkg per e.a. 60 sq.ft. of seating area pkg per e.a. 250 sq.ft. of office space

CLASSIFICATION & CONSTRUCTION TYPE DATA - FBC-2014 EDITION & FFPC-NFPA 101	(A) (VSSEWBLY)	PLACES OF RELIGIOUS WORSHIP	TYPE-VB	BUILDING PROTECTED BY AUTOMATED WATER BASED FIRE SUPPRESSION SPRINGLER SYSTEM AND FULL-TIME MONITORED FIRE ALARM	CLASSIFICATION AREA COMPLIANCE 6,000 SQ.FT. LIMT FOR USE A:3 5,025,00 SQ.FT. PROPOSED	RATING REQUIRED AND PROVIDED FOR TYPE-VB CONSTRUSTION AS PER FBC TABLE 601	NACT O HES	ONS O HRS		& JOSTS) 0 HRS
CLASSIFICATION & CONSTRUC	OCCUPANCY GROUP:		CONSTRUCTION TYPE: AS PER FBC 2014 (TABLE-801) (602.5) AS PER FPPC 2014 (SEC - 8.2.1.2)	FRE SUPPRESSION SYSTEM:	BUILDING DESCRIPTIONS FOR TYPE-VB CLASSIFICATION AREA COMPLIANCE (PREFABRICATED MODILAR BUILDING)	RATING REQUIRED AND PROVIDED FO	- PRIMARY STRUCTURAL FRAME RATING - BEARING EXTERIOR AND INTERIOR WALLS	- NON-BEARING WALLS AND PARTITIONS.	- FLOOR CONSTRUCTION (INCL BEAM & JOISTS)	- ROOF CONSTRUCTION (NCL BEAM & JOISTS)
4	awo:	NI C								

ATION & CONSTRUCT	ATION & CONSTRUCTION TYPE DATA - FBC-2014 EDITION & FFPC-NFPA 101
GROUP:	A.3 (ASSEMBLY)
2014 (SEC-6.1.3)	PLACES OF RELIGIOUS WORSHIP
ION TYPE: 2014 (TABLE-601) (602.5) 3:2014 (SEC - 8.2.1.2)	TYPE.VB
SSION SYSTEM:	BUILDING PROTECTED BY AUTOMATED WATER BASED FIRE SUPPRESSION SPRINGLER SYSTEM AND FULL-TIME MONIT CRED FIRE ALARM
SCRPTIONS FOR TYPE-VB (ATED MODULAR BUILDING)	SCR PTIONS FOR TYPE VIG CLASSIFICATION AREA COMPLIANCE 6,000 SQ.F.T. LIMIT FOR USE A.3 MEDIAAR BUILDING) 5,025,00 SQ.F.T. IPROPOSED
QUIRED AND PROVIDED FOR	QUIRED AND PROVIDED FOR TYPE-VB CONSTRUSTION AS PER FBC TABLE 601
Y STRUCTURAL FRAME RATING	SAH O SAH
3 EXTERIOR AND INTERIOR WALLS	WALLS OHRS
ARING WALLS AND PARTITIONS.	SNC O HRS
CONSTRUCTION (INCL. BEAM & JOISTS).	
ONSTRUCTION (NCLBEAM & JOISTS)	& JOISTS) 0 HRS

COMPANY WAY	SHEET TITLE	PROPOSED	SITE PLAN	ONA	SITE DATA

01.23.2017

AND	SITE DATA	T NUMBER	000
		SHEET	

Downtown Hollywood Synagogue

PROJECT ADDRESS:

2726 VAN BUREN ST. HOLLYWOOD, FL 33020

APPLICANT:

DOWNTOWN HOLLYWOOD SYNAGOGUE, CORP

3728 N.E. 209th Terrace Aventura, FL. 33180

SUBMITTAL:

PLANNING AND ZONING DEPT..... TAC Responses (REV-2) Jan-2017

A R C H I T E C T

C T T C A

tel: 305.593.9959 8323 NW 12th St. Suite No.106. Doral, Fl. 33126 fax: 305.593.9855

19 20 CITY HALL 30 VAN BUREN STREET 14 15 16 17 18 19 20 21 22 23 24 25 26 ONO 29 20 13 12 11 10 9 8 7 6 5 4 3 2 1

PROJECT LEGAL DESCRIPTION:

The East 18 feet of Lot 16 and all of Lot 17, Block 29, HOLLY LITTLE RANCHES, according to the Plat thereof as filed in Plat Book 1, page 26, of the Public Records of Broward County, Florida.

BASED ON O&E BY Fidelity National Title Insurance Company: Order No. 6014112

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ALTA SURVEY	
A-010	AERIAL AND CONTEXT PLAN
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A-031	ROOF PLAN & FIRE-FLOW TEST
A-040	MISCELLANEOUS SITE DETAILS
A-050	SITE PHOTOGRAPHS & STREET PROFILE
3 A-060	SITE LIGHTING PLAN & PHOTOMETRIC STUDIES
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A-080	PROJECT RENDITION
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CIVIL-6	ON-SITE PAVING & DRAINAGE DETAILS
CIVIL-7	ON-SITE PERVIOUS AND IMPERVIOUS BREAKOUT
CIVIL-8	PAVEMENT MARKINGS & SIGNAGE
CIVIL-9	MARKINGS & SIGNAGE - STANDARD DETAILS
CIVIL-10	WATER & SEWER CIVIL UTILITIES PLAN LAYOUT
CIVIL-11	WATER & SEWER STANDARD DETAILS
LP-1	LANDSCAPE PLANTING PLAN
LP-2	LANDSCAPE NOTES & DETAILS

16-DPS-78

FOR CITY OF HOLLYWOOD STAFF:

MEETING DATE: 01/23/2017

BOARD / COMMITTEE: (P & D)

ALUA ACSM LAND UTUE SURVEY

3 TCI, Inc.

PROFESSIONAL LAND SURVEYORS AND MAPPERS MIAMI, FLORIDA

LEGEND:

SCALE: 1"=20'

CO CLEANOUT CATCH BASIN CPP CONCRETE POWER POLE GPo GUARD POLE © GREASE TRAP

© GAS VALVE - HANDICAP SIGN LIGHT POLE LBO LIGHT BOLLARD

EB. ELECTRIC BOX

© ELECTRIC MANHOLE FIRE HYDRANT ICVo IRRIGATION CONTROL VALVE (M) MONITORING WELL

MB, MAIL BOX - SIGN (S) SANITARY SEWER MANHOLE (D) STORM SEWER MANHOLE (T) TELEPHONE MANHOLE O UNKNOWN MANHOLE PM_D PARKING METER

≪ SPOT LIGHT √5,6

SPOT ELEVATION S SEWER VALVE ub<mark>d</mark> utility box WATER VALVE M WATER METER

WPPO WOOD POLE WITH TRANSFORMER

WP WOOD POLE

ABBREVIATIONS:

A/C AIR CONDITIONING PAD BLDG. BUILDING (B.O.B.) BASIS OF BEARING C.L.F. CHAIN LINK FENCE CBS CONCRETE BLOCK STRUCTURE (C) CALCULATED CB CATCH BASIN CH. CHORD DISTANCE © CENTER LINE

CONC. CONCRETE ∆ delta E EAST ENC. ENCROACHMENT F.I.P. FOUND IRON PIPE F.F.E. FINISH FLOOR ELEVATION F.N. FOUND NAIL

L LENGTH N NORTH N.G.V.D. NATIONAL GEODETIC VERTICAL DATUM O.E. OVERHEAD ELECTRIC LINE O/L ON LINE

GV GAS VALVE

(MEAS.) MEASURED

S SOUTH


W WEST

P.R.M. POINT REFERENCE MONUMENT (REC.) RECORD R RADIUS R/W RIGHT-OF-WAY

SEC. SECTION T TANGENT U.E. UTILITY EASEMENT

LOT 8 BLOCK 30 "LITTLE RANCHES" PLAT BOOK 1, PAGE 26 (RECORDS OF BROWARD COUNTY, FLORIDA) UNDER CONSTRUCTION N87°54'43"E (B.O.B.) 75.00' F.I.P.1/2" 6' TEMPORARY CONSTRUCTION CHAIN LINK FENCE -6' TEMPORARY CONSTRUCTION CHAIN LINK FENCE DEVELOPED LAND F.I.P.1/2"_ LOT 10 BLOCK 29 "LITTLE RANCHES" PLAT BOOK 1, PAGE 26

(RECORDS OF BROWARD COUNTY, FLORIDA)

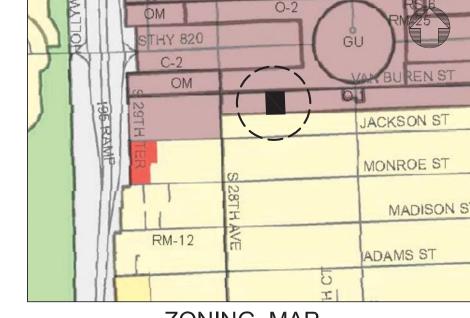

ZONING MAP NOT TO SCALE

DATE OF COMPLETION:

LEGAL DESCRIPTION:

THIS LEGAL DESCRIPTION IS PER TITLE COMMITMENT ORDER NO. TITLE INSURANCE COMPANY AND IS AS FOLLOWS: The East 18 feet of Lot 16 and all of Lot 17, Block 29, HOLLY LITTLE RANCHES, according to the Plat thereof as filed in

Plat Book 1, page 26, of the Public Records of Broward County, Florida.

Ownership & Encumbrance Report No. 6014112 by Fidelity National Insurance Company: Dated 09-26-2016

THE UNDERSIGNED, BEING A REGISTERED LAND SURVEYOR OF THE STATE OF FLORIDA CERTIFIES TO:

28th AVE. FACILITY, LLC, a Florida Limited Liability Company

ADOPTED BY AMERICAN LAND TITLE ASSOCIATION, NATIONAL SOCIETY OF PROFESSIONAL SURVEYORS AND AMERICAN CONGRESS OF SURVEYING

SURVEYS MEASREMENTS WHICH CONTROL LAND BOUNDARIES FOR ALTA/ACSM LAND TITLE SURVEYS;" OR

2. THE SURVEY WAS MADE ON THE GROUND ON APRIL 23rd 2015 RV ME OR UNDER MY SUPERVISION AND CORRECTLY SHOWS THE LEGAL DESCRIPTION AND THE LAND AREA OF THE SUBJECT PROPERTY, THE LOCATION AND TYPE OF ALL BUILDING, STRUCTURES AND OTHER

3. THERE ARE NO PARTY WALLS AND NO OBSERVABLE, ABOVE-GROUND ENCROACHMENTS (A) BY THE IMPROVEMENTS ON THE SUBJECT PROPERTY UPON ADJOINING PROPERTIES. STREETS, ALLEYS, EASEMENTS OR RIGHT-OF-WAY OR (B) BY THE IMPROVEMENTS ON ANY ADJOINING PROPERTIES.

AND LISTED IN THE TITLE INSURANCE COMMITMENT ORDER NO. 5155759. DATED FEBRUARY 19, 2015, AT 05:00 PM, ISSUED BY FIDELITY NATIONAL RECORDING REFERENCE, TO THE EXTENT THAT SUCH MATTERS CAN BE LOCATED HAS BEEN PLOTTED ON THE SURVEY. IF THE EASEMENT HAS NOT BEEN PLOTTED, THERE IS A STATEMENT AS TO WHY NOT. THE PROPERTY SHOWN ON THE SURVEY IS THE PROPERTY DESCRIBED IN THE TITLE

5. THE LOCATION OF THE SUBJECT PROPERTY IS IN ZONE RM-18, MEDIUM HIGH DENSITY MULTIPLE FAMILY. SETBACKS ARE AS PER CITY OF HOLLYWOOD LAND DEVELOPMENT REGULATIONS:

FRONT = 20 FEET

SIDE = 20% OF LOT WIDTH TOTAL. 7.5 MINIMUM FEET

6. THE PROPERTY HAS DIRECT ACCESS TO AND FROM PUBLICLY USED AND MAINTAINED STREET KNOWN AS VAN BUREN STREET

7. MUNICIPAL WATER, MUNICIPAL STORM SEWER AND MUNICIPAL SANITARY FACILITIES, TELEPHONE, AND ELECTRIC SERVICES OF PUBLIC UTILITIES ARE AVAILABLE AT THE BOUNDARY OF THE PROPERTY IN THE LOCATIONS AS SHOWN ON THE SURVEY

8. THE SUBJECT PROPERTY DOES NOT SERVE ADJOINING PROPERTY FOR VISIBLE SUBSURFACE DRAINAGE STRUCTURES, VISIBLE WATER COURSES, UTILITIES, STRUCTURAL SUPPORT OR INGRESS & EGRESS

9. THIS PROPERTY APPEARS TO BE LOCATED IN FLOOD ZONE X, AS PER FEDERAL EMERGENCY MANAGEMENT AGENCY (FEMA) COMMUNITY-PANEL

10. THE LAND AREA OF THE SUBJECT PROPERTY IS IN TOTAL $\pm 24,190$ SQUARE FEET OR ± 0.56 ACRES AS DESCRIBED IN THE LEGAL DESCRIPTION.

11. THE LAND IS VACANT AND DOES NOT HAVE ANY STRUCTURE ERECTED INSIDE OF IT 12. THERE ARE 0 REGULAR PARKING SPACES AND 0 MARKED HANDICAPPED PARKING SPACES ON THE SUBJECT PROPERTY

13. ELEVATIONS ARE BASED UPON THE NORTH AMERICAN VERTICAL DATUM 1988 AS PER N.G.S. (NATIONAL GEODETIC SURVEY) VERTICAL CONTROL POINT M-312 (PID AD2500), WITH ELEVATION 13.44 FEET.

14. THE PARTIES LISTED ABOVE AND THEIR SUCCESSORS AND ASSIGNS ARE ENTITLED TO RELY ON THE SURVEY AND THIS CERTIFICATE AS BEING

15. THERE IS NO EVIDENCE OF THE PROPERTY BEING USED AS A WASTE DUMP.

16. THERE IS NO EVIDENCE OF WETLANDS ON THE PROPERTY. NO MAPS WERE PROVIDED.

THAT I HAVE REVIEWED THE COMMITMENT AND ALL ITEMS ARE SHOWN ON THE SURVEY THE ITEMS SHOWN HERE FORTH ARE PER SCHEDULE B-II OF TITLE COMMITMENT ORDER NO. 5155759 DATED FEBRUARY 19, 2015; AT 5:00 P.M.

ITEMS NO. 6 ORDINANCE #76 CHANGING THE NAME OF STREETS IN HOLLYWOOD, AFFECTS THE SUBJECT PROPERTY, AS RECORDED IN O.R.B. 8136 PAGE 244. NOTHING TO SHOW ON SURVEY.

ITEMS NO. 7 ORDINANCE 2002-61, DOES NOT AFFECT THE SUBJECT PROPERTY, REGARDING THE BROWARD COUNTY WETLANDS MAP, AS RECORDED

ITEMS NO. 9 ORDINANCE 2005-19, AFFECTS THE SUBJECT PROPERTY, REGARDING THE REGIONAL ACTIVITY CENTER, AS RECORDED IN O.R.B. 40082

ITEMS NO. 8 ORDINANCE 2005-18, AFFECTS THE SUBJECT PROPERTY, REGARDING THE REGIONAL ACTIVITY CENTER, AS RECORDED IN O.R.B. 40082 PAGE 1783, NOTHING TO SHOW ON SURVEY

CITY HALL LOCATION

LOCATION MAP SCALE: 1"=300' SECTION 16, TOWNSHIP 53 S., RANGE 41 E.

FLOOD INSURANCE RATE MAP DATA (FIRM):

Flood Zone "X", as per Federal Emergency Management Agency (FEMA) Community-Panel Number: 12011C / City of Hollywood 125113 Map No. 0568 Suffix H,

Effective Date: August 18, 2014

THIS PROPERTY APPEARS TO BE LOCATED IN FLOOD ZONE "X", AS PER FEDERAL EMERGENCY MANAGEMENT AGENCY (FEMA) COMMUNITY-PANEL NUMBER 12011C, MAP NO. 0568, SUFFIX H, EFFECTIVE DATE: 08-18-2014

LOT SQUARE FOOTAGE

24,190 sq.ft. 0.56 acres

NOTE:

BEARINGS AS SHOWN HEREON ARE BASED UPON THE CENTER LINE OF VAN BUREN STREET, WITH AN ASSUMED BEARING OF N87'54'43"E, SAID LINE TO BE CONSIDERED A WELL MONUMENTED LINE.

SURVEYOR'S CERTIFICATE:

I hereby certify: That this "ALTA/Boundary and Topographic Survey" and the Survey Map resulting therefrom was performed under my direction and is true and correct to the best of my knowledge and belief and further, that said "ALTA/Boundary and Topographic Survey" meets the intent of the applicable provisions of the "Minimum Technical Standards for Land Surveying in the State of Florida", pursuant to Rule 5J-17 of the Florida Administrative Code and its implementing law, Chapter 472.027 of the Florida Statutes.

3TCI, Inc., a Florida Corporation Florida Certificate of Authorization Number LB7799

Rolando Ortiz

Registered Surveyor and Mapper LS4312 State of Florida


NOTICE: Not valid without the signature and original raised seal of a Florida Licensed Surveyor and Mapper. Additions or deletions to Survey Maps by other than the signing party are prohibited without the written consent of the signing party.

REVISIONS

ALTA / ACSM SURVEY 28th AVE. FACILITY, LLC 2726 VAN BUREN ST, HOLLYWOOD FL 33020

3TCI, Inc. LB7799 PROFESSIONAL LAND SURVEYORS AND MAPPERS 12211 SW 129th CT. MIAMI FL 33186 tel: 305.316.8474 fax: 305.378.1662 www.3tci.com



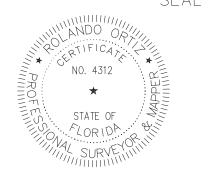

ommunity panel numbe 125113

CITY OF HOLLYWOOD

12011C0568

08/18/2014

BENCH MARK:

M-312

13.44

HOLLYWOOD CITY HALL

/DWG INFO:

15-827

1"=20'

SHEET: 1 OF 1



8323 NW 12th Street Suite No.106 Doral, FL 33126 tel: 305.593.9959 fax: 305.5939855

AA #26001093

PROJECT:

DOWNTOWN HOLLYWOOD SYNAGOGUE

2726 VAN BUREN ST. HOLLYWOOD, FL 33020

APPLICANT:

Downtown Hollywood Synagogue, Corp.

3728 N.E. 209th Ter Aventura, FL. 33180

ISSUED FOR: FINAL TAC APPROVAL

CIVICA PROJECT No:

10	No.	DATE	REVISION	BY
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AS SHOWN

SEAL/SIGNATURE

01.23.2017


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SHEET TITLE


PROPOSED AERIAL CONTEXT

SHEET NUMBER

A-010

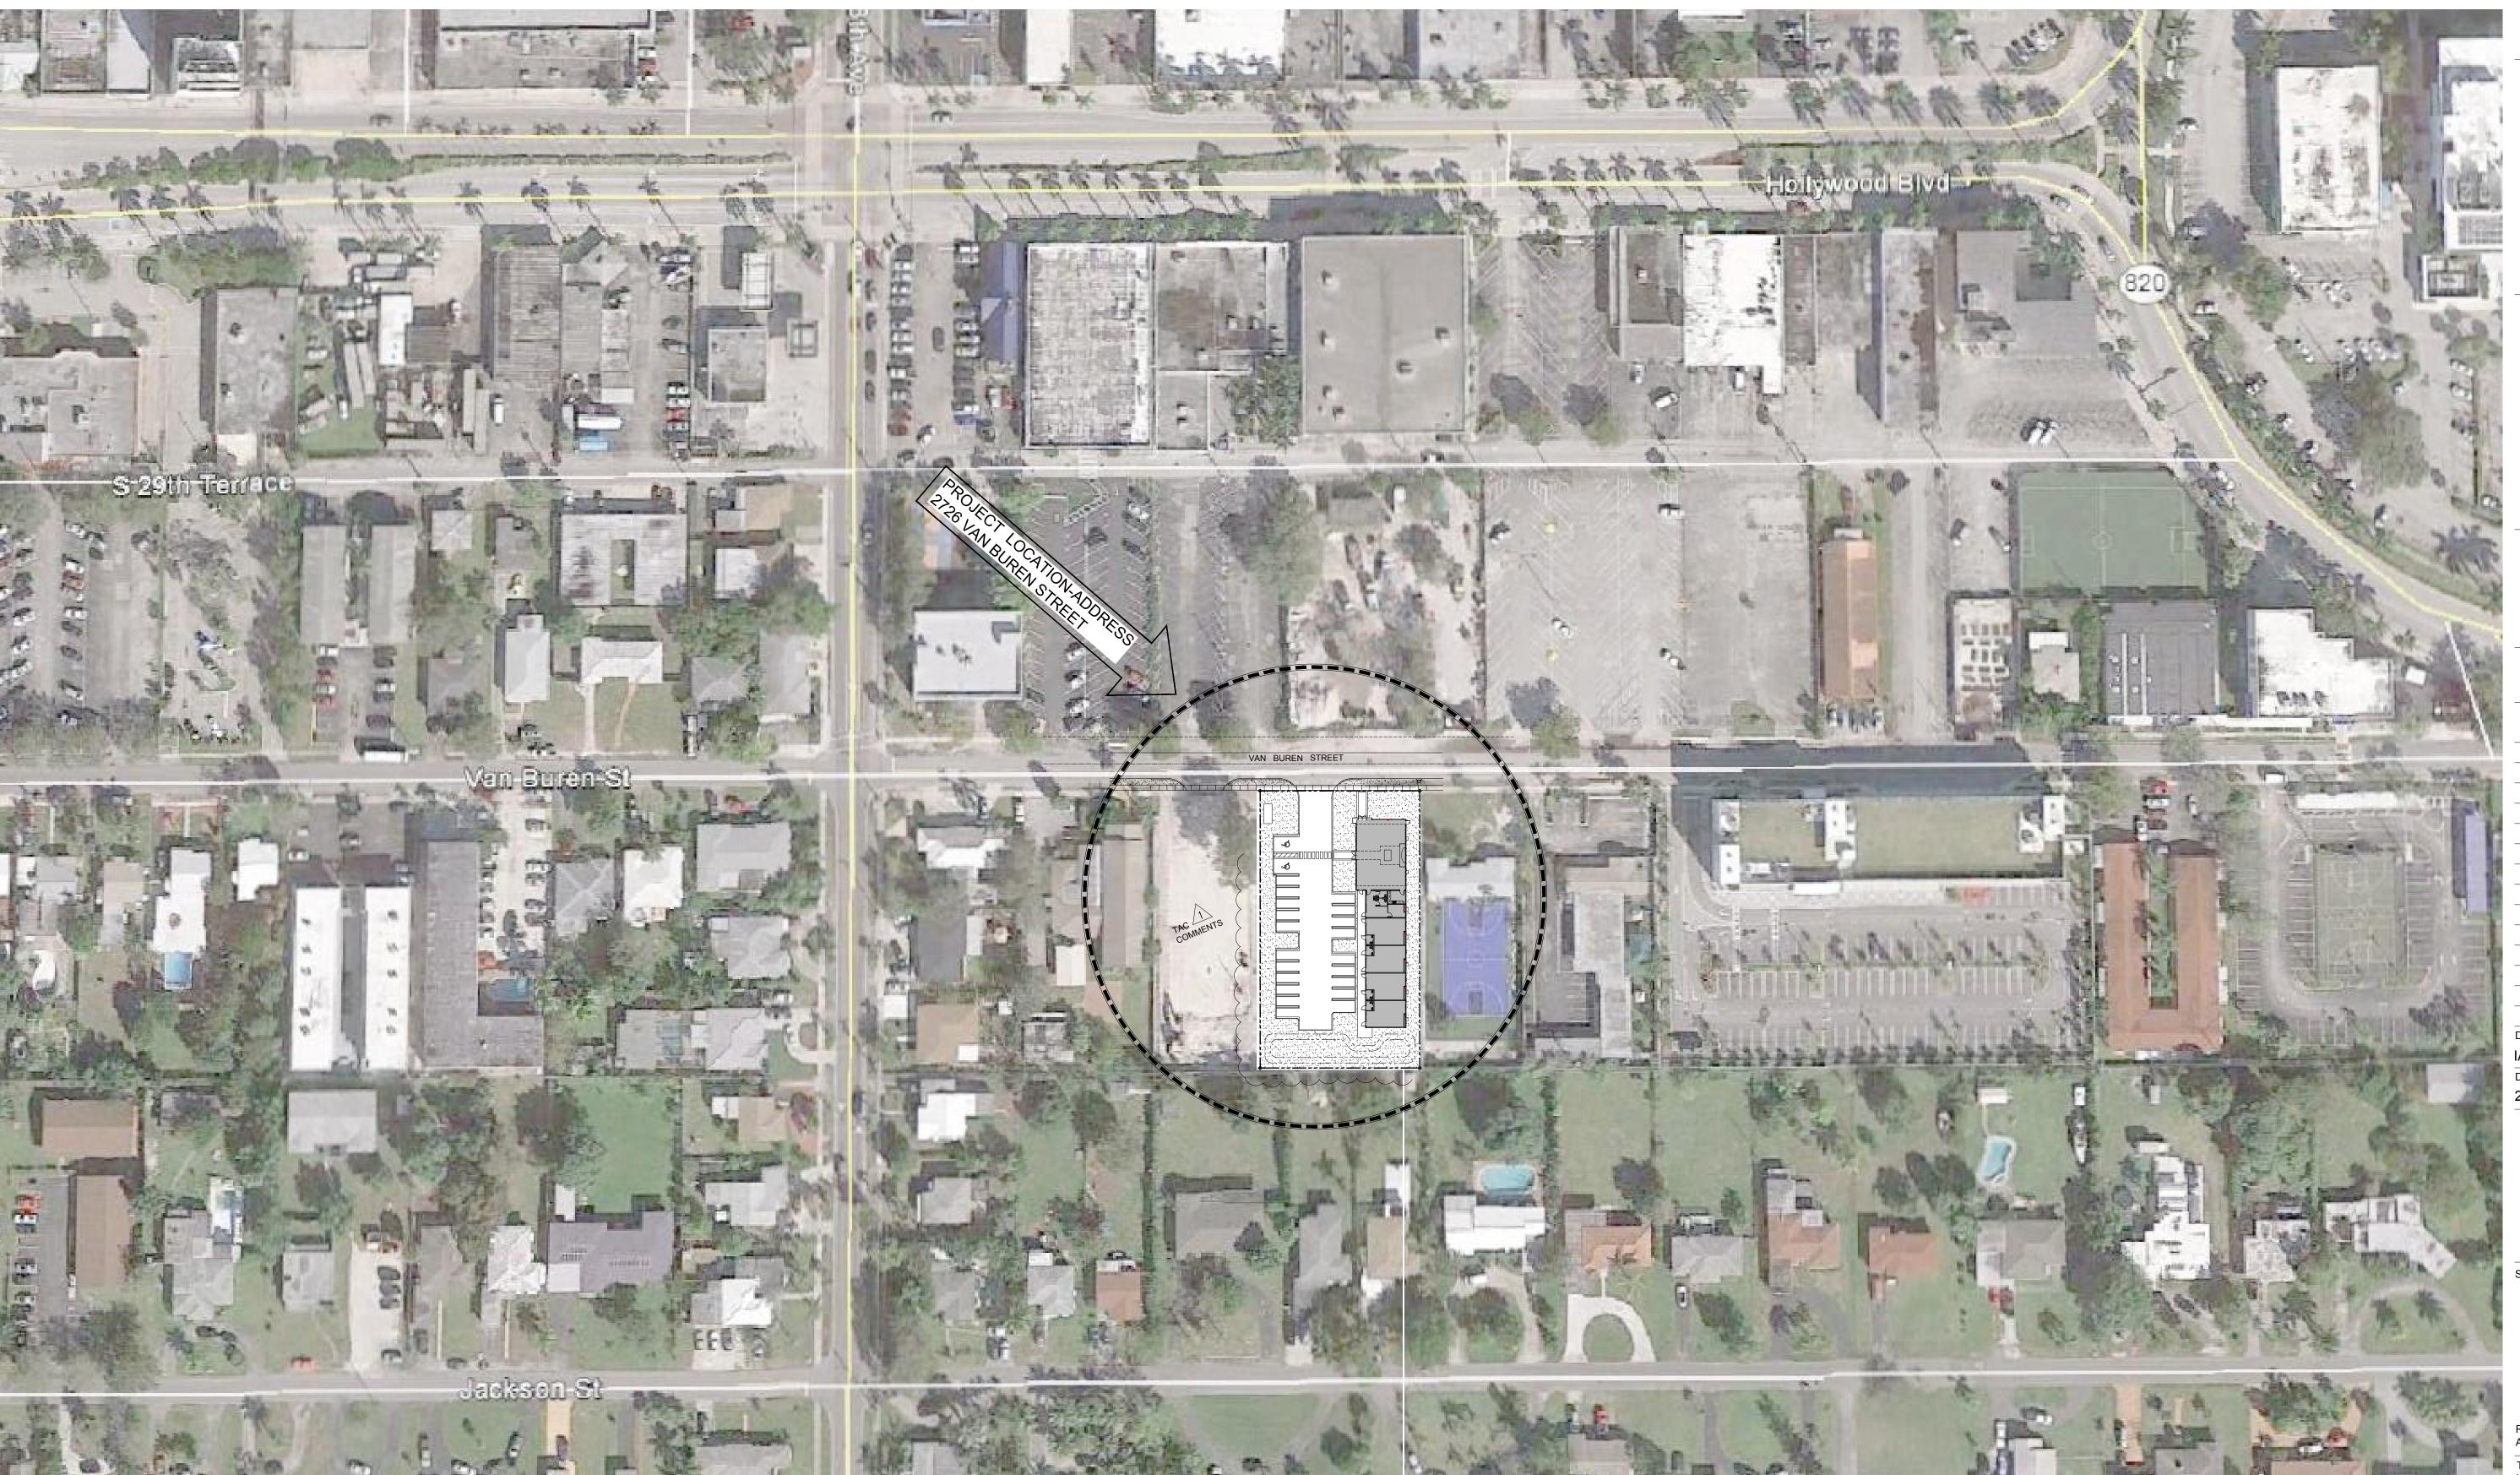

ALL REQUIRED COUNTY AND STATE RELATED PERMITTS SHALL BE OBTAINED PRIOR TO CITY OF HOLLYWOOD BDLG DEPT PERMIT ISSUANCE

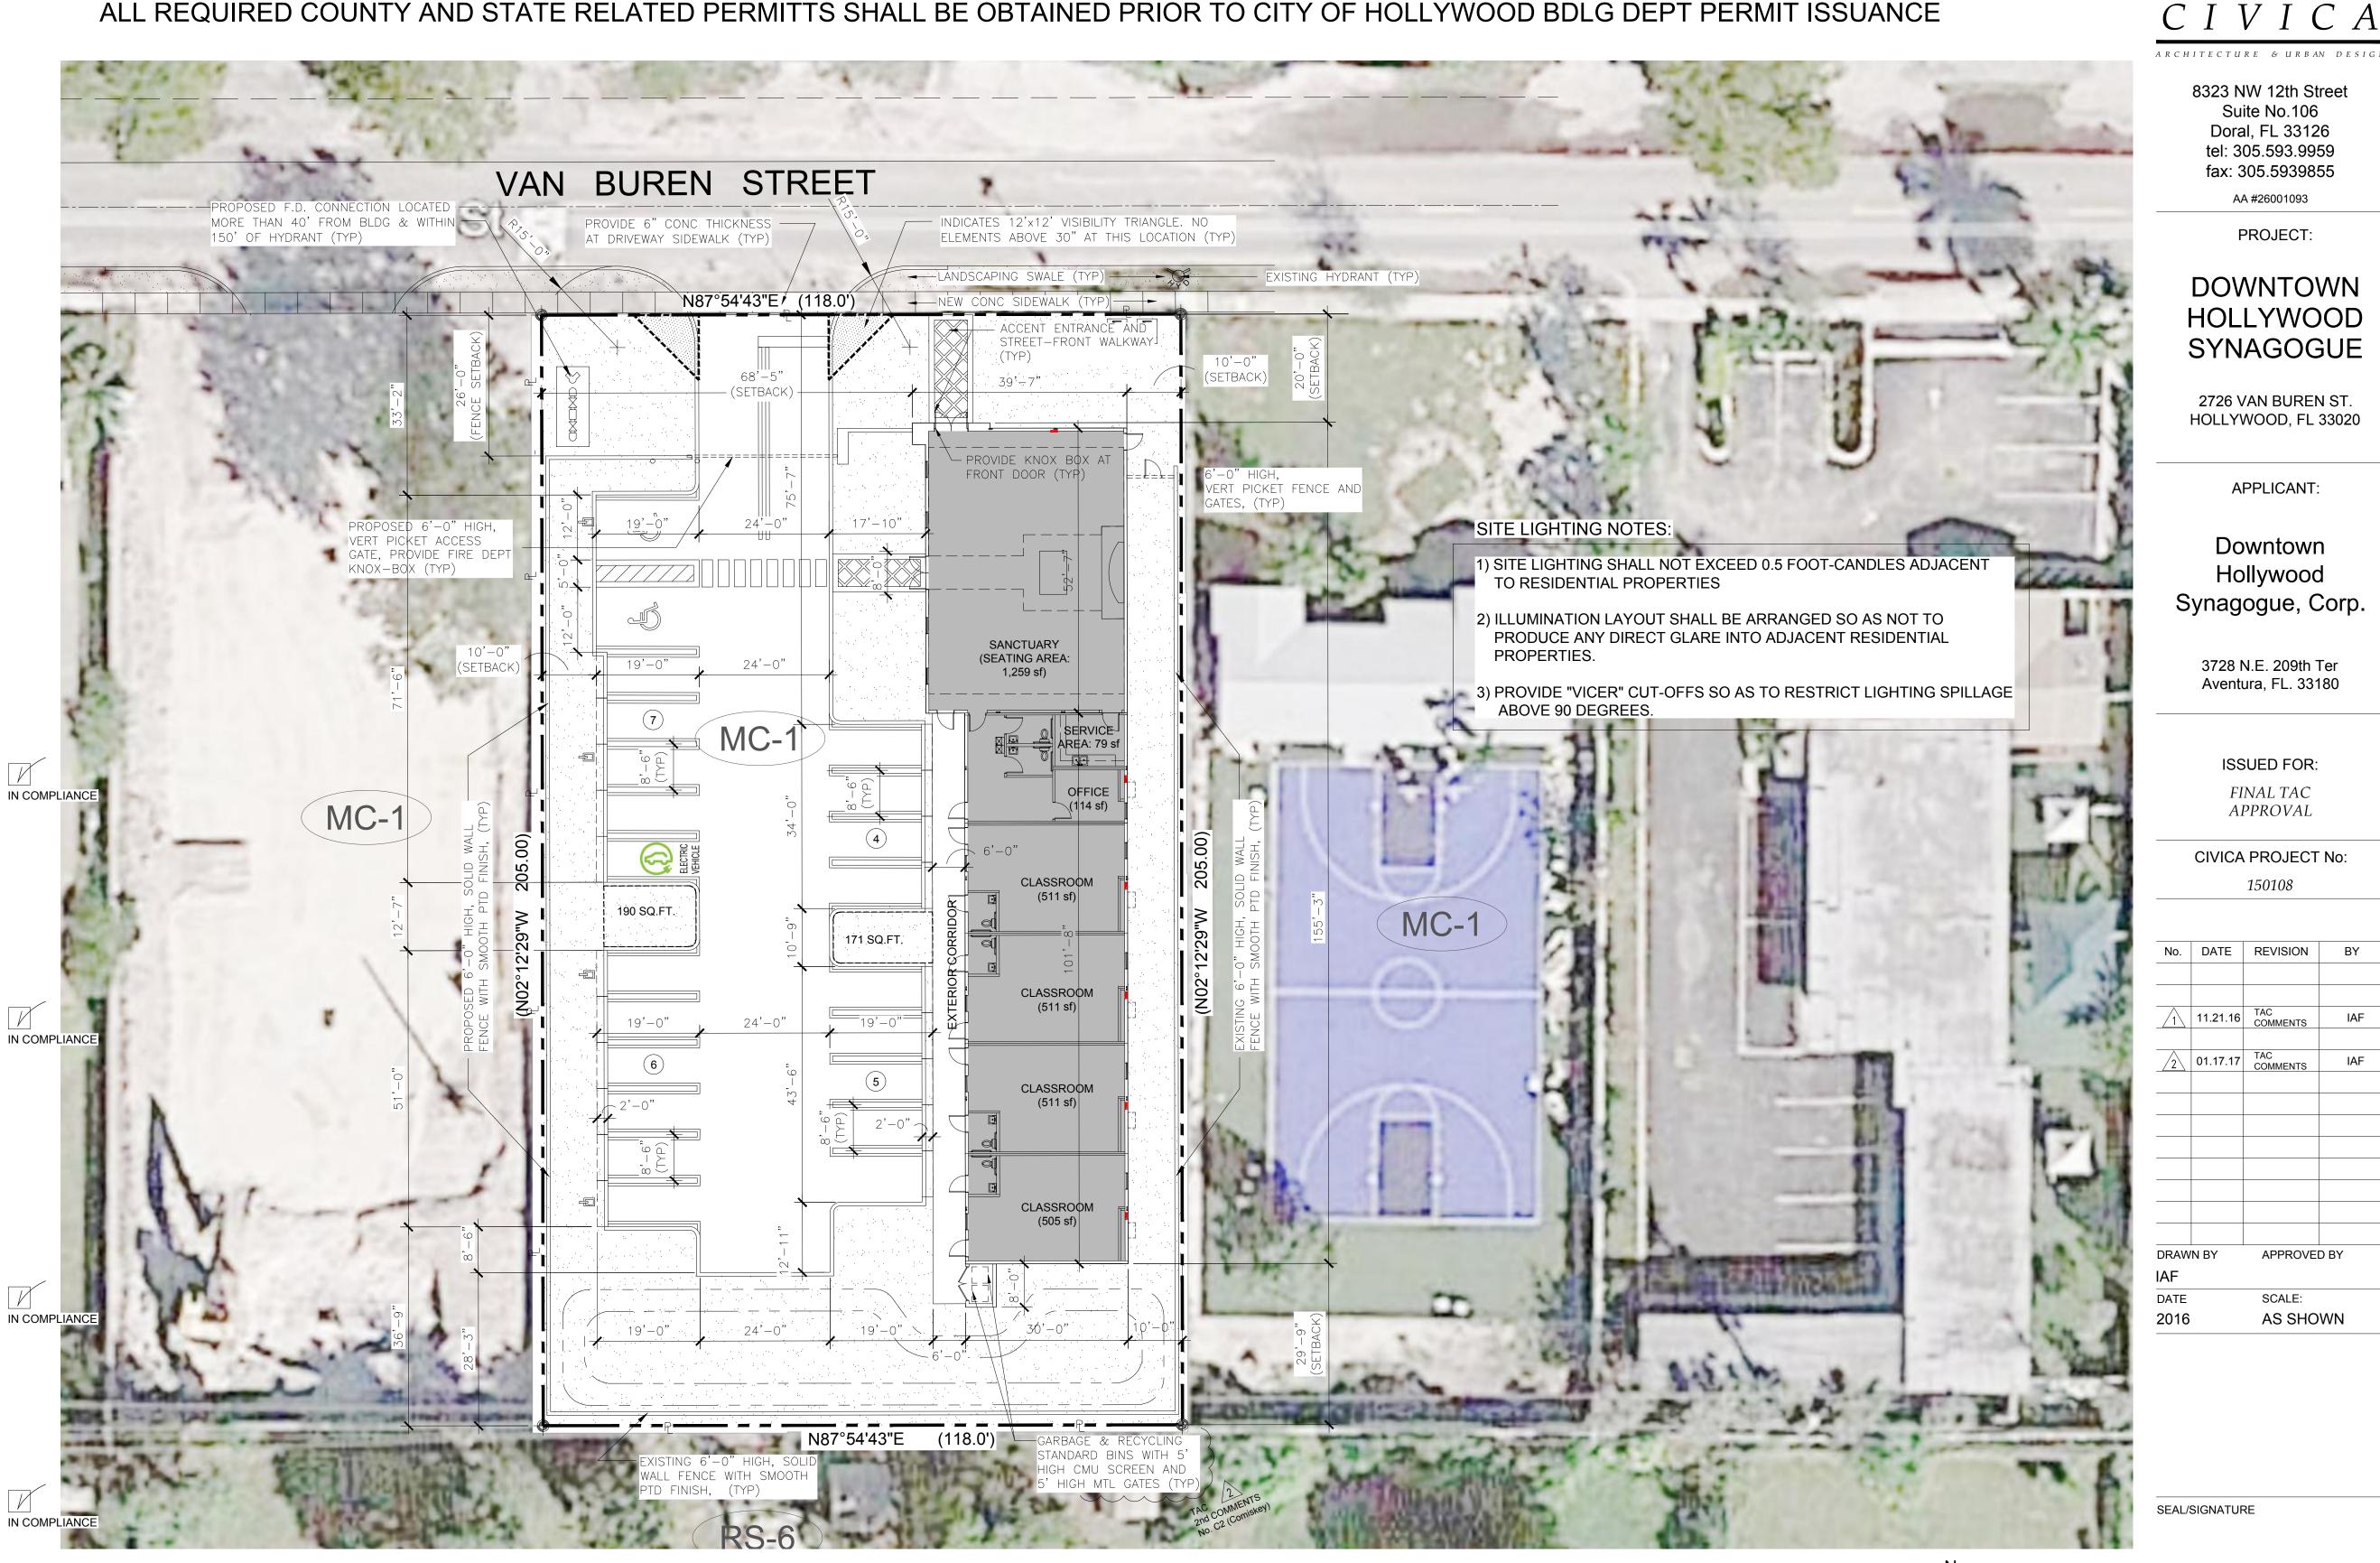

GREEN BUILDING DESIGN

ZONING REQUIREMENTS:

. 2726 VAN BUREN STREET

28th AVE. FACILITY, LLC.

. 0.55 ACRES (24,190.00 SQ.FT.)

. MC-1 (MULTI-FAMILY RES CORE)

REGIONAL ACTIVITY CENTER

(NONE EXISTING)

9,688.46 SQ.FT. (40.05%)

36,285.00 SQ.FT. (1.5 FAR)

5,025.90 SQ.FT. (0.21 FAR)

RELIGIOUS / SYNAGOGUE

5,025.90 SQ.FT.

14,501.54 SQ.FT.

. 20'-0"

20'-0"

. 20'-0"

29'-9"

. 10'-0" 10'-0"

. 10'-0" 68'-5"

PROPOSED: 33'-2"

PROPOSED: 28'-3"

PROPOSED: 48'-0"

PROPOSED: 10'-0"

16' Max

. 5142-16-02-2860

TC-1 (North)

RS-6 (South)

. VACANT

MC-1 (East & West)

PROJECT ADDRESS.

TOTAL LAND AREA.

EXISTING ZONING DESIGNATION.

ADJACENT DESIGNATION

EXISTING USE OF PROPERTY.

EXISTING NUMBER OF UNITS

PROPOSED USE UNDER..

TOTAL LOT COVERAGE

OPEN SPACE PROVIDED.

MAX FAR ALLOWED

FAR PROPOSED.

BUILDING SETBACKS:

BEING REMOVED AS PER BCPA:

PROPOSED BLDG FOOT PRINT.

FRONT SETBACK (NORTH)

REAR SETBACK (SOUTH)

MIN REQUIRED

MIN REQUIRED

SIDE SETBACK (EAST)

SIDE SETBACK (WEST) MIN REQUIRED.

PARKING LOT SETBACKS:

FRONT SETBACK (NORTH)

REAR SETBACK (SOUTH)

SIDE SETBACK (EAST)

REAR SETBACK (WEST)

HEIGHT LIMITATIONS:

PROPOSED..

MIN REQUIRED

PROPOSED..

PROPOSED..

PROPOSED..

PROPOSED..

EXISTING LAND USE.

OWNER.

FOLIO(S)..

*BUILDING DESIGN SHALL COMPLY WITH THE CITY OF HOLLYWOOD GREEN BUILDING ORDINANCE AS APPLICABLE.

MIN REQUIRED: 20'-0"

MIN REQUIRED: 5'-0"

MIN REQUIRED: 5'-0"

MIN REQUIRED: 5'-0"

SAMPLE OF PROPOSED GREEN PRACTICES:

MAX ALLOWED....(45'-0" / 4-STORIES)

- 1) Central air conditioner of 18 SEER or higher.
- 2) Radiant barrier Energy Star qualified applied to attic or crawlspace.
- 3) Energy efficient (Low e) windows. All windows shall conform to the Energy Star rating criteria for South Florida as approved by the NFRC (National Fenestration Rating Council).
- 4) Energy efficient doors. All doors shall conform to the Energy Star rating criteria for South Florida.
- 5) Energy Star approved roofing materials. White Cool-Roof TOP system by GAF.
- 6) Programmable thermostats. 7) Occupancy/vacancy sensors.
- 8) Dual flush toilets.
- 9) All energyefficient outdoor lighting.
- 10) All hot water pipes insulated. 11) Electric vehicle charging station infrastructure.

IN COMPLIANCE

PROPOSED SYNAGOGUE SITE PLAN

PARKING DATA ANALYSIS

SCALE: 1/16" = 1'-0"

PARKING REQUIREMENTS BASED ON THE ZONING AND LAND DEVELOPMENT CODE OF ORDINANCES.

Code Requirement	Parking Required			Parking Provided
1 Pkg per e.a. 60 sq.ft. of seating area	1,259 sq.ft. / 60 sq.ft.	=	21 Spaces	
1 pkg per e.a. 250 sq.ft. of office space	114 sq.ft. / 250 sq.ft.	=	1 Spaces	22 Spaces
TOTAL PARKING	(21 Sanctuary) + (1 Office)	=	22 Spaces	

* 2 ACCECCIDI E DADVING CDAC	LEC DDOMIDED	IN COMPLIANCE W	/ EDC Chapar 11 (ADA)
* 2 ACCESSIBLE PARKING SPAC	LES LICOVIDED	IN COMPLIANCE W	rbc-Chaper-11 (ADA)
			• '

ر اکار	CLASSIFICATION & CONSTRUCT	TION TYPE DATA - FBC-2014 EDITION & FFPC-NFPA 101
COMPI	OCCUPANCY GROUP: AS PER FBC 2014 (SEC-303.4)	A-3 (ASSEMBLY)
Z	AS PER FFPC 2014 (SEC-6.1.3)	PLACES OF RELIGIOUS WORSHIP
	CONSTRUCTION TYPE:	

AS PER FBC 2014 (TABLE-601) (602.5) AS PER FFPC 2014 (SEC - 8.2.1.2) BUILDING PROTECTED BY AUTOMATED WATER BASED FIRE SUPPRESSION FIRE SUPPRESSION SYSTEM: SPRINKLER SYSTEM AND FULL-TIME MONITORED FIRE ALARM BUILDING DESCRIPTIONS FOR TYPE-VB CLASSIFICATION AREA COMPLIANCE. . 6,000 SQ.FT. LIMIT FOR USE A-3

(PREFABRICATED MODULAR BUILDING) 5,025.90 SQ.FT. PROPOSED RATING REQUIRED AND PROVIDED FOR TYPE-VB CONSTRUSTION AS PER FBC TABLE 601

- PRIMARY STRUCTURAL FRAME RATING... - BEARING EXTERIOR AND INTERIOR WALLS...... 0 HRS - NON-BEARING WALLS AND PARTITIONS.... - FLOOR CONSTRUCTION (INCL BEAM & JOISTS)......0 HRS - ROOF CONSTRUCTION (INCL BEAM & JOISTS)......0 HRS

IN COMPLIANCE

01.23.2017

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8323 NW 12th Street Suite No.106 Doral, FL 33126 tel: 305.593.9959

fax: 305.5939855

AA #26001093

PROJECT:

DOWNTOWN

HOLLYWOOD

SYNAGOGUE

2726 VAN BUREN ST.

HOLLYWOOD, FL 33020

APPLICANT:

Downtown

Hollywood

Synagogue, Corp.

3728 N.E. 209th Ter

Aventura, FL. 33180

ISSUED FOR

FINAL TAC

APPROVAL

CIVICA PROJECT No:

150108

11.21.16

01.17.17 TAC COMMENTS

APPROVED BY


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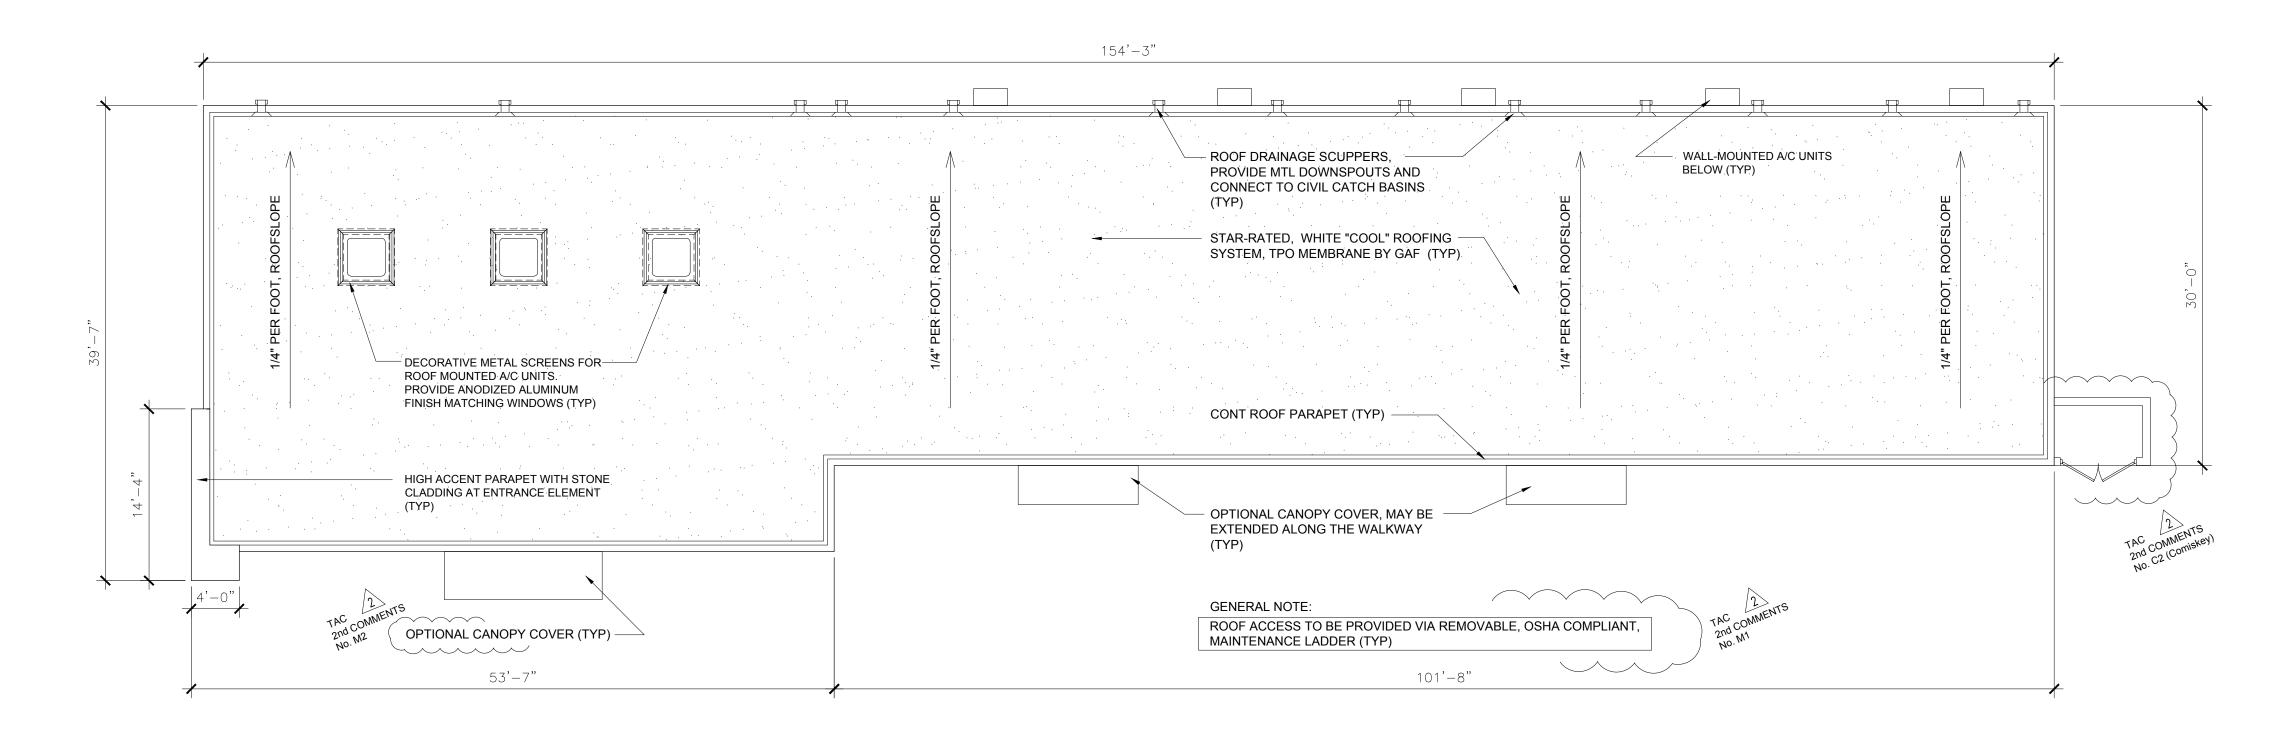
SHEET TITLE

PROPOSED SITE PLAN AND SITE DATA


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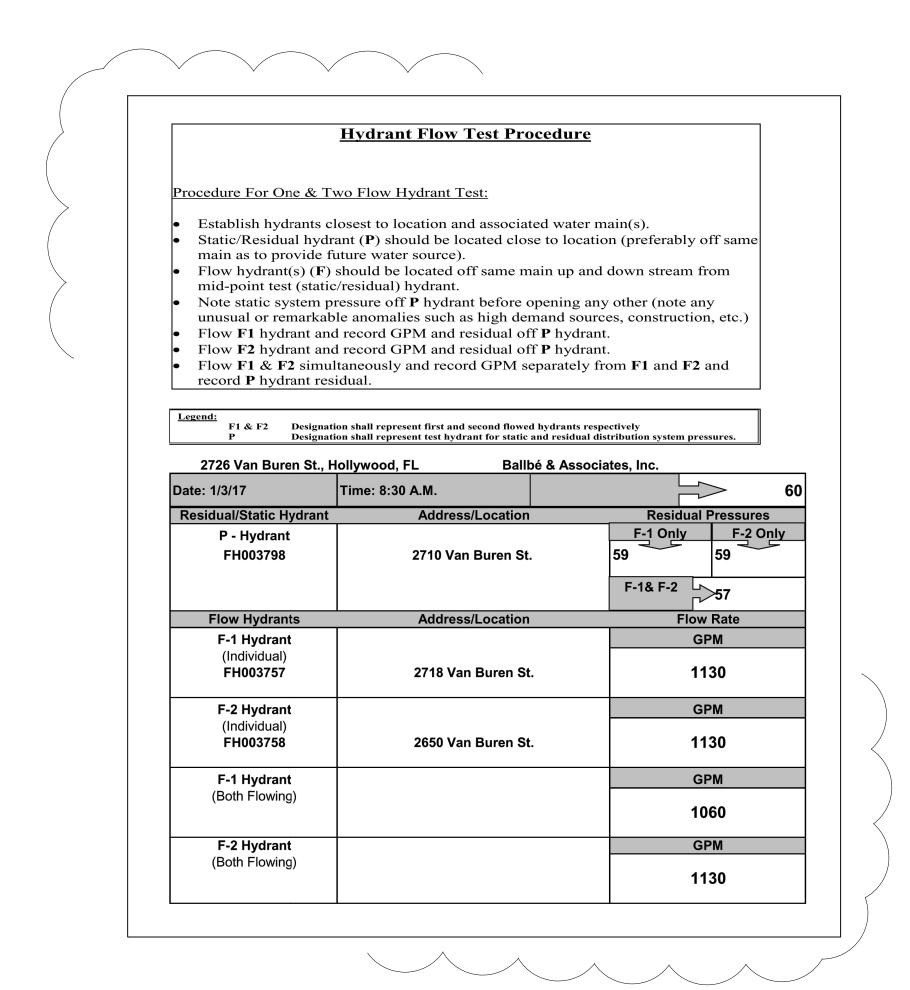
A-020





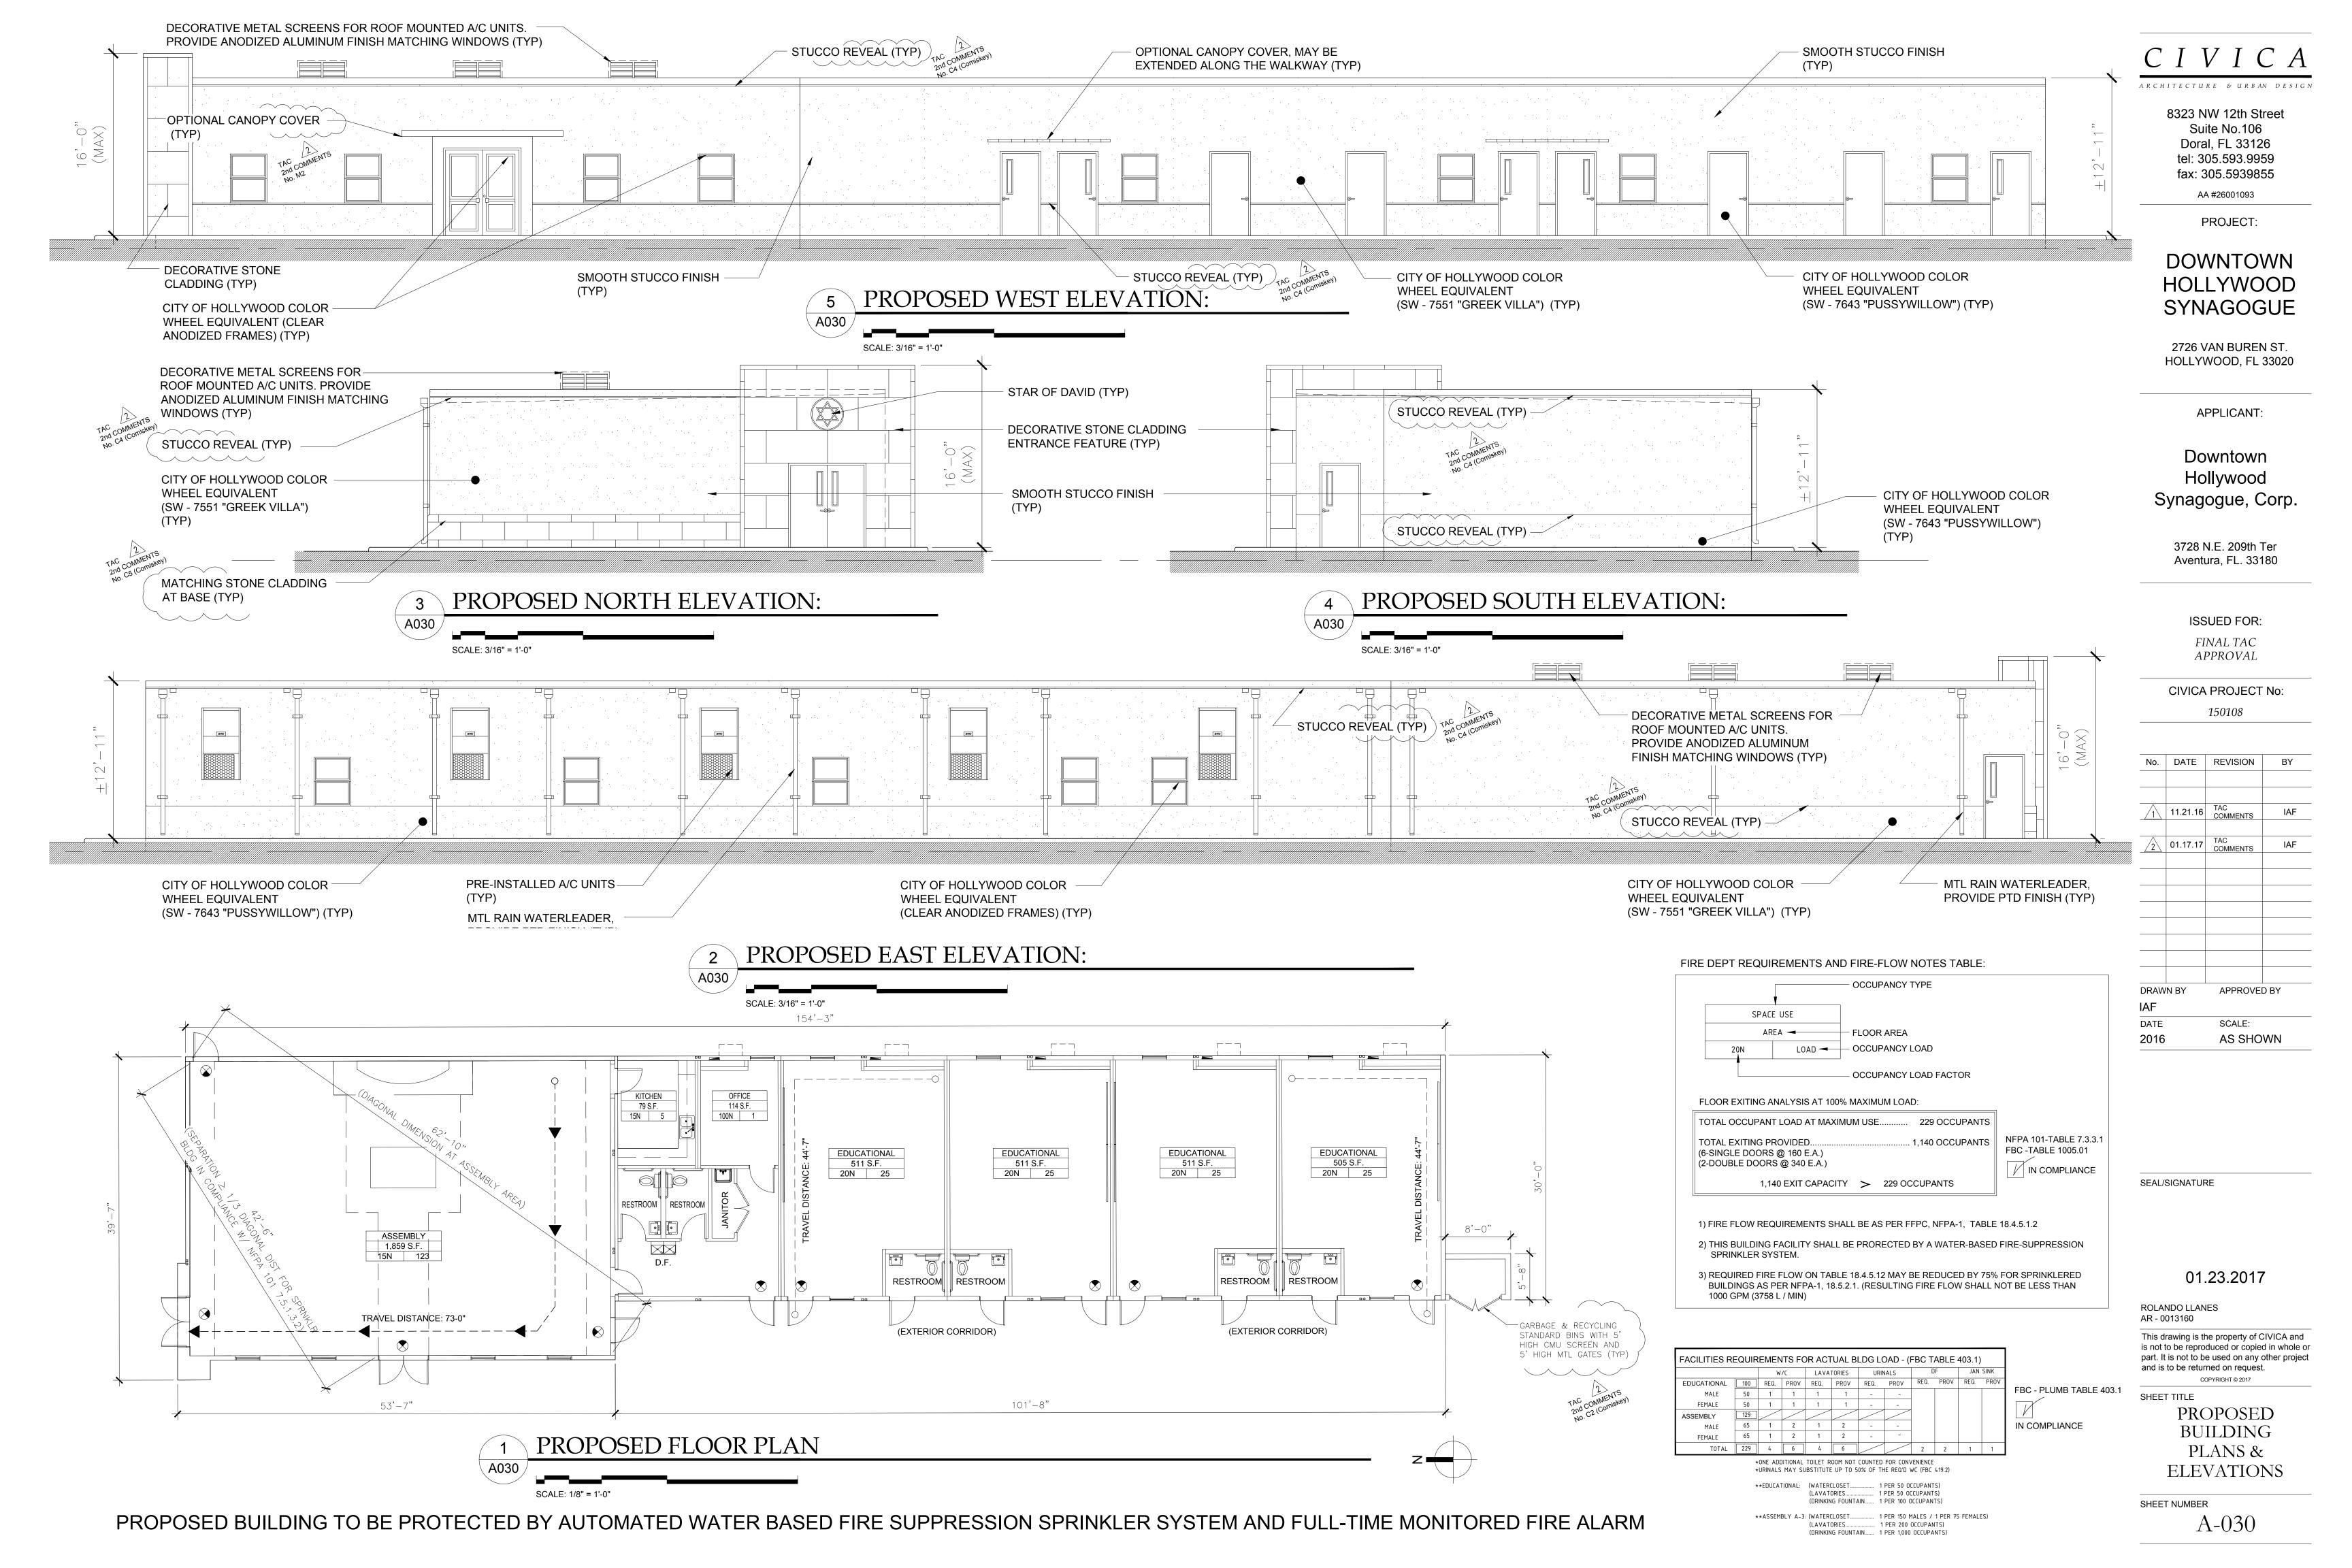



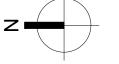



ARCHITECTURE & URBAN DESIGN

8323 NW 12th Street Suite No.106 Doral, FL 33126 tel: 305.593.9959 fax: 305.5939855

AA #26001093

PROJECT:

DOWNTOWN HOLLYWOOD SYNAGOGUE

2726 VAN BUREN ST. HOLLYWOOD, FL 33020

APPLICANT:

Downtown Hollywood Synagogue, Corp.

> 3728 N.E. 209th Ter Aventura, FL. 33180

> > ISSUED FOR: FINAL TAC

CIVICA PROJECT No:

150108

APPROVAL

No.	DATE	REVISION	BY
2	01.17.17	TAC COMMENTS	IAF
DRAW	'N BY	APPROVE	D BY
IAF			
DATE		SCALE:	

AS SHOWN

SEAL/SIGNATURE

2016

01.23.2017

ROLANDO LLANES AR - 0013160

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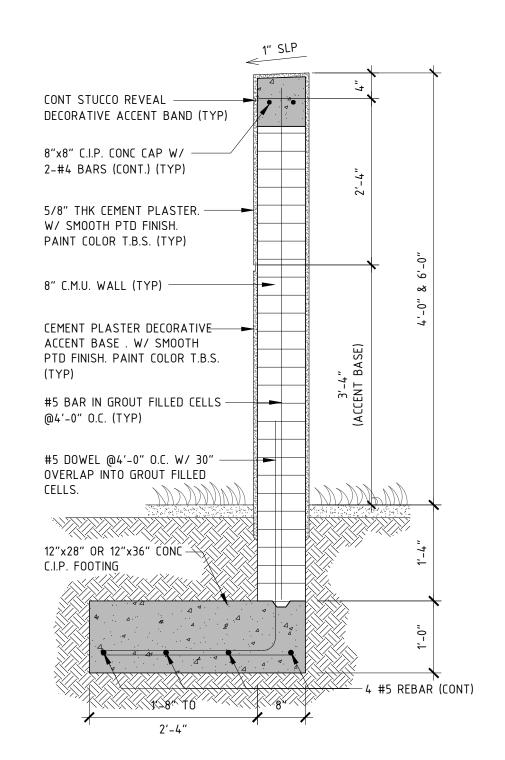
SHEET TITLE

PROPOSED ROOF PLAN



.....

SHEET NUMBER
A-031



CONCRETE FENCE: SECTION DETAIL


SCALE: 3/16" = 1'-0"

\ A040

8'-6" 5'-0" 12'-0" WHITE PAINT 5'-0" SQ. INTERNATIONAL SYMB OF ACCESSIBILITY (TYP) (FDOT 6'-6" 4" BLUE PAINT STRIPES @ 45°, SPACED AT 12" O.C. (TYP) THERMOPLASTIC TRAFFIC PAINT STRIPPING (WHITE) (TYP) — 24" VEHICLE OVERHANG ALLOWED OVER GREEN AREAS (TYP) ACCESSIBILITY SIGN ON POST OR-SECURED TO WALL @ 7'-0" HIGH.

3 PARKING STALL DETAILS

SCALE: 1/4" = 1'-0"

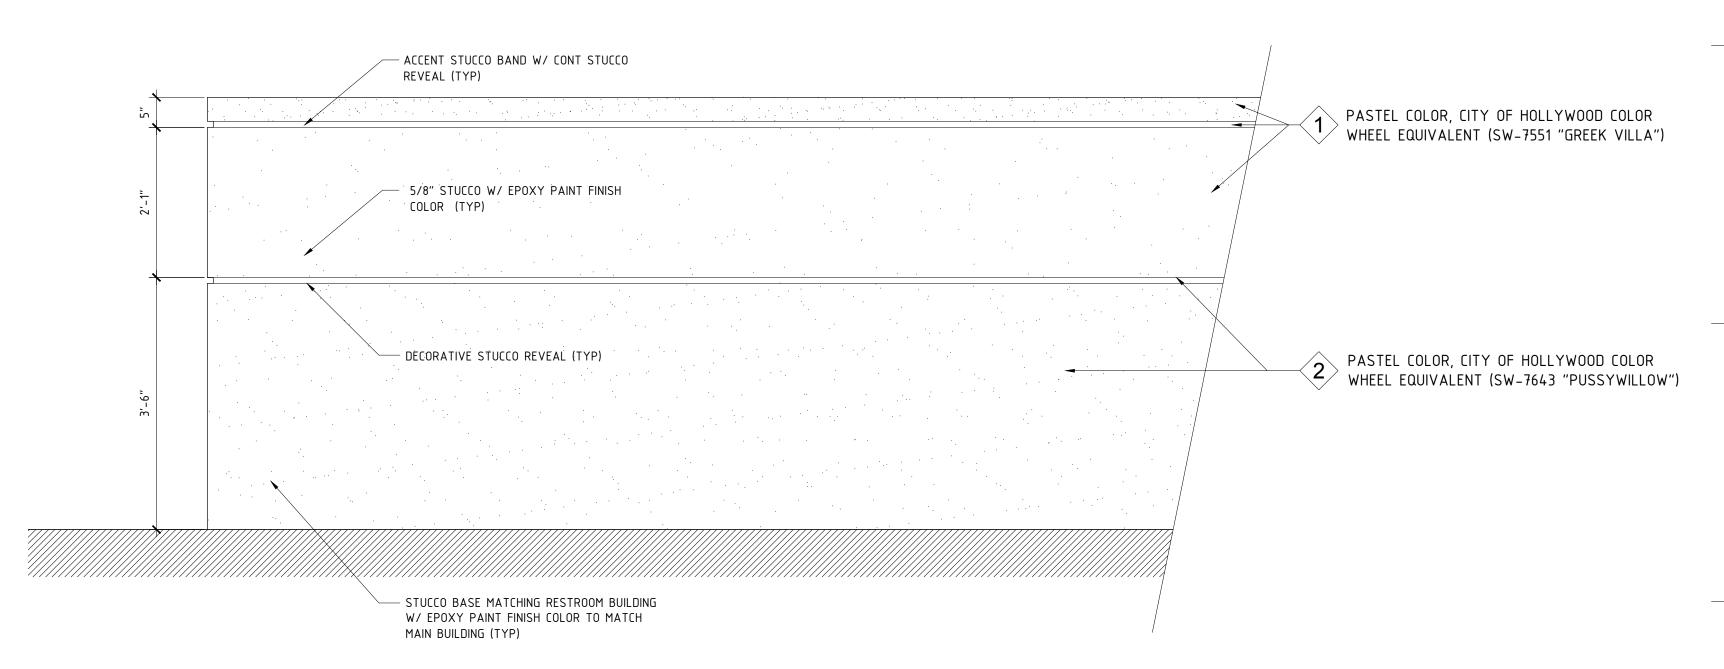


CONCRETE FENCE: TYPICAL ELEVATION DETAIL

CONCRETE WALL FINISH COLORS SHALL BE CONSISTENT W/ BATHROOM BUILDING FINISHED

SCALE: 3/16" = 1'-0"

A040

FINISH NOTE:

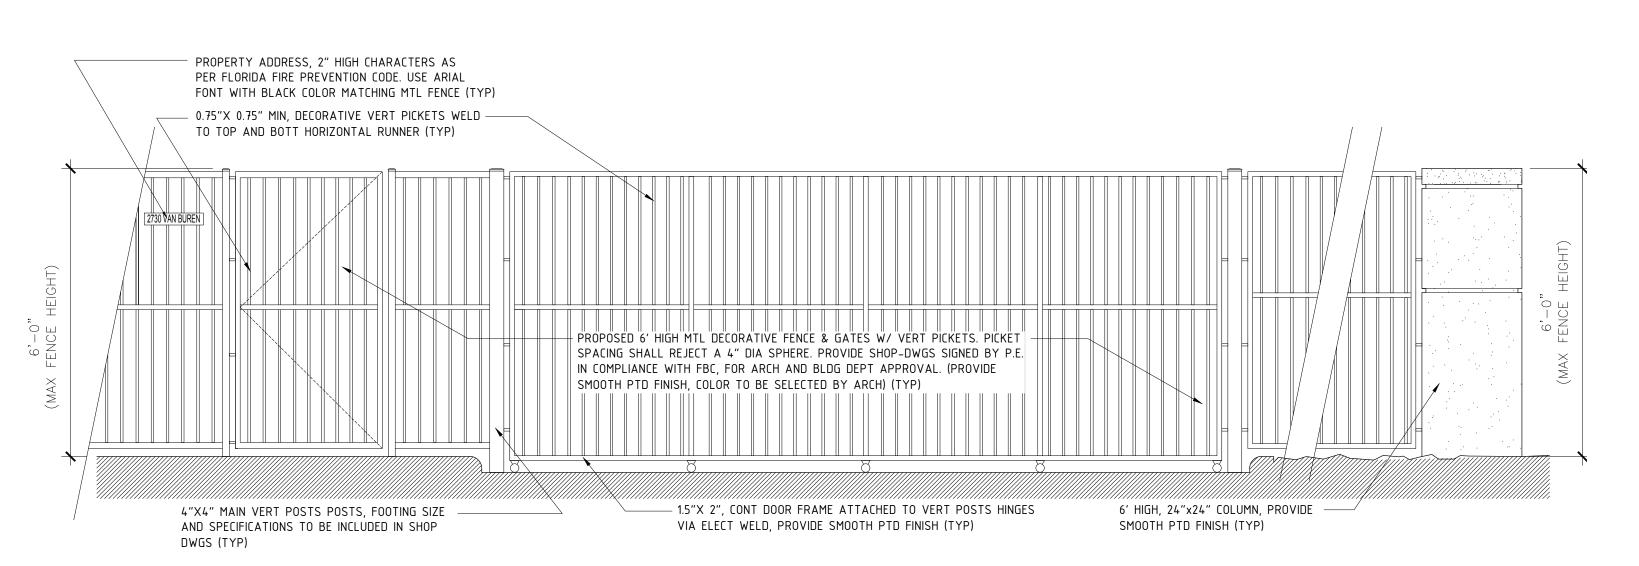

FINISH NOTE:

PROVIDE FENCING ASSEMBLY "BLACK" FINISH MATCHING 13-DPVS-47 APPROVAL OR CITY OF HOLLYWOOD COLOR WHEEL EQUIVALENT (TYP)

4 TYPICAL CHAINLINK FENCE DETAIL

SCALE: 1/4" = 1'-0"

C I V I C A

ARCHITECTURE & URBAN DESIGN

8323 NW 12th Street Suite No.106 Doral, FL 33126 tel: 305.593.9959 fax: 305.5939855

AA #26001093

PROJECT:

DOWNTOWN HOLLYWOOD SYNAGOGUE

2726 VAN BUREN ST. HOLLYWOOD, FL 33020

APPLICANT:


Downtown Hollywood Synagogue, Corp.

> 3728 N.E. 209th Ter Aventura, FL. 33180

> > ISSUED FOR: FINAL TAC APPROVAL

CIVICA PROJECT No:

150108

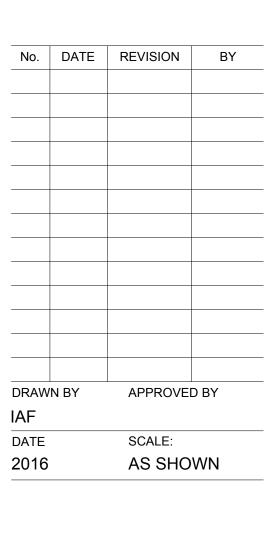

SEAL/SIGNATURE

01.23.2017

ROLANDO LLANES AR - 0013160

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SHEET TITLE

MISC SITE DETAILS

SHEET NUMBER

A-040



2726 VAN BUREN (EXISTING CONDITION - VACANT LAND)




VAN BUREN STREET - EXISTING PROFILE

(EXISTING CONDITION - CITY OF HOLLYWOOD CONSTRUCTION STAGING AREA)



2717 VAN BUREN

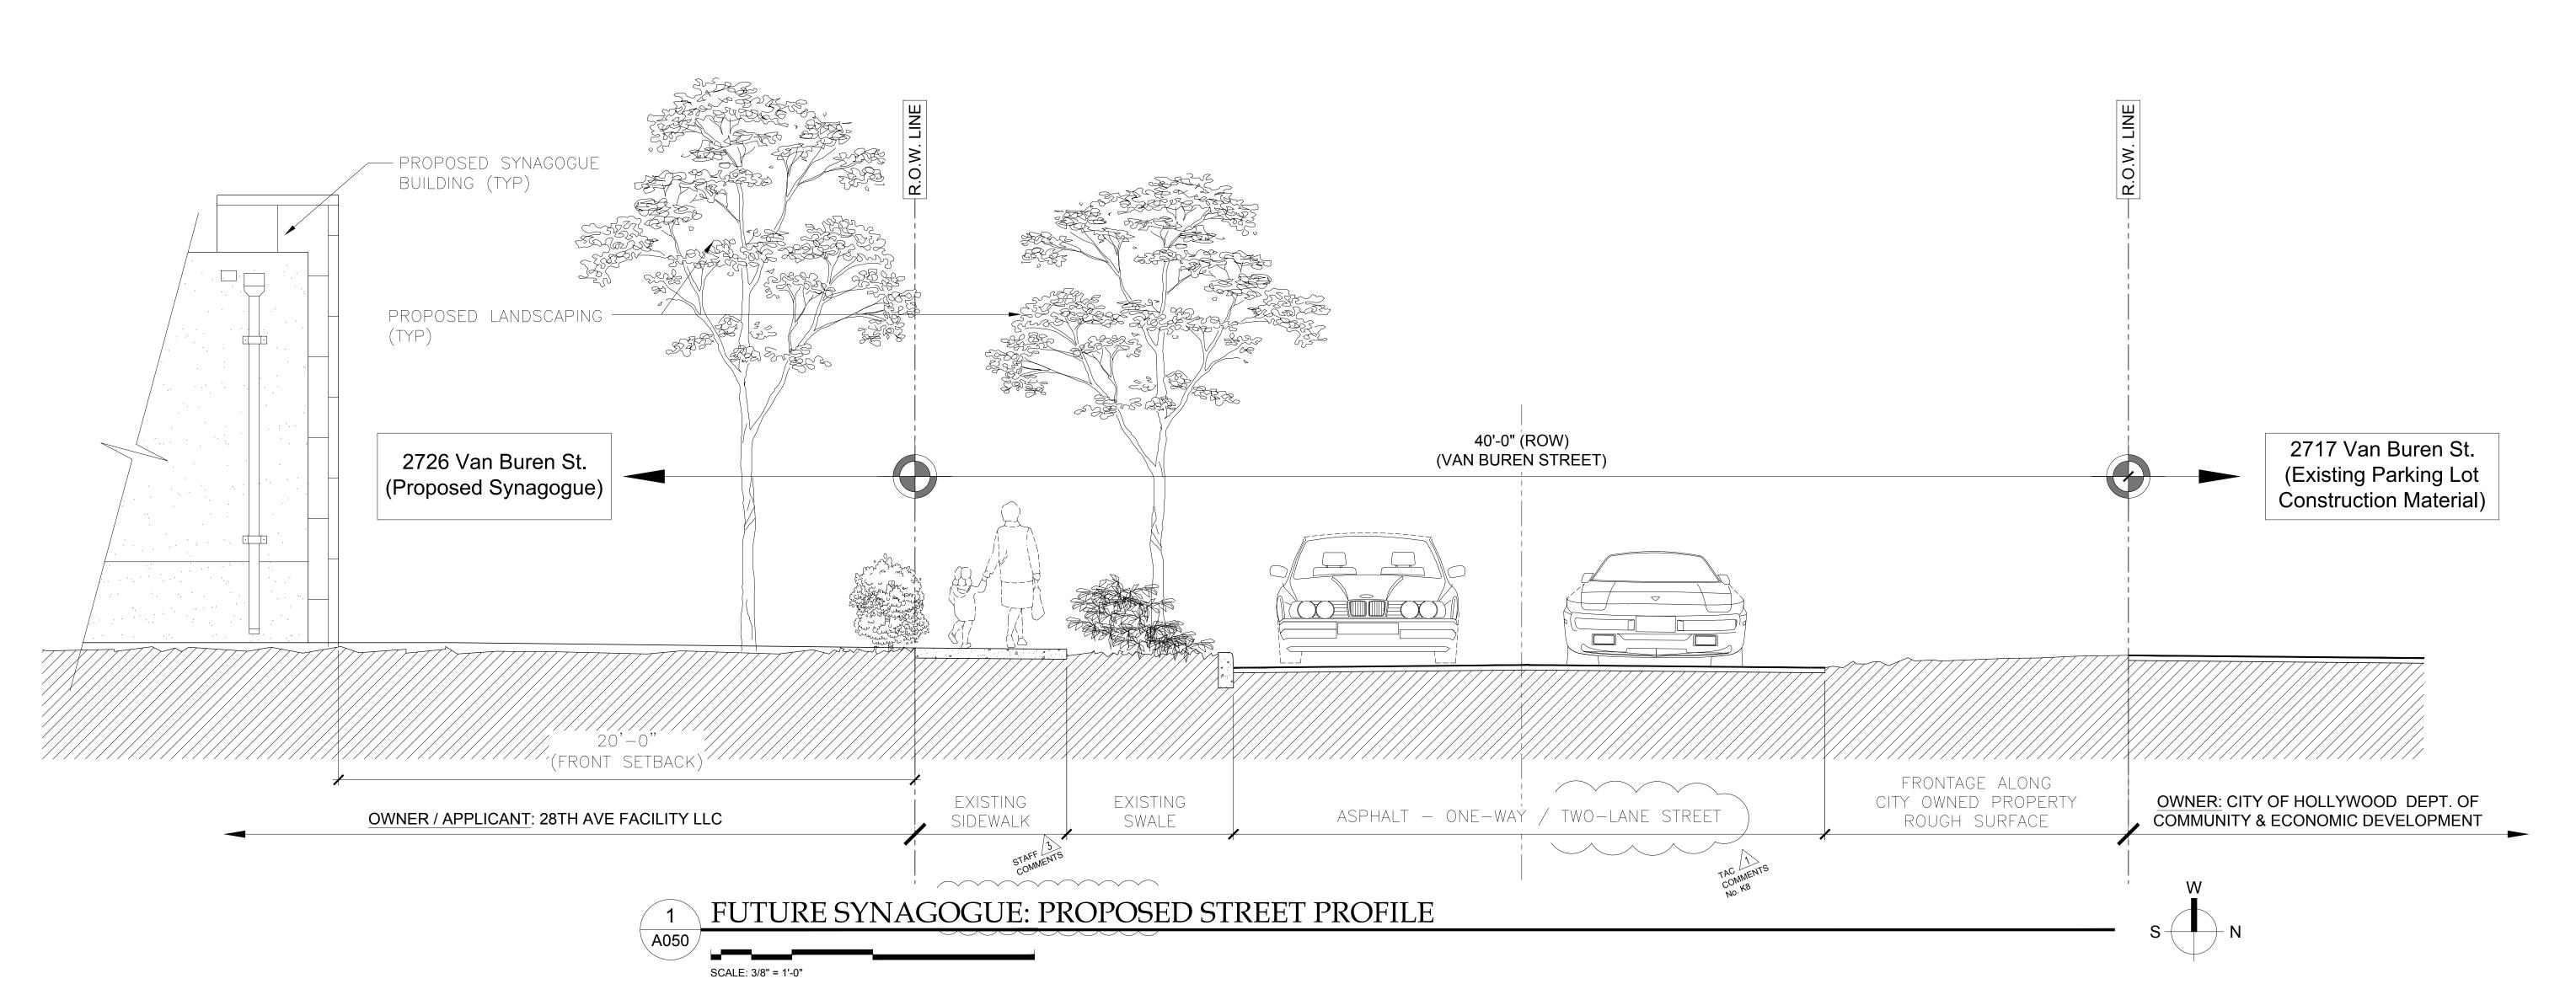

C I V I C A

8323 NW 12th Street Suite No.106 Doral, FL 33126 tel: 305.593.9959 fax: 305.5939855

ARCHITECTURE & URBAN DESIGN

AA #26001093

PROJECT:

DOWNTOWN HOLLYWOOD SYNAGOGUE

2726 VAN BUREN ST. HOLLYWOOD, FL 33020

APPLICANT:

Downtown Hollywood Synagogue, Corp.

> 3728 N.E. 209th Ter Aventura, FL. 33180

> > ISSUED FOR:

FINAL TAC APPROVAL

CIVICA PROJECT No:

150108

No.	DATE	REVISION	BY
1	11.21.16	TAC	IAF
		COMMENTS	
DRAW	N BY	APPROVE	D BY
IAF			
DATE		SCALE:	

AS SHOWN

SEAL/SIGNATURE

01.23.2017

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SHEET TITLE

SITE PHOTOGRAPHS AND PROPOSED STREET PROFILE

SHEET NUMBER

A-050





SITE PLAN NOTES:

1) SITE LIGHTING SHALL NOT EXCEED 0.5 FOOT-CANDLES ADJACENT TO RESIDENTIAL PROPERTIES

2) ILLUMINATION LAYOUT SHALL BE ARRANGED SO AS NOT TO PRODUCE ANY DIRECT GLARE INTO ADJACENT RESIDENTIAL PROPERTIES.

3) PROVIDE "VICER" CUT-OFF SO AS TO RESTRICT LIGHTING SPILLAGE ABOVE 90 DEGREES.

C I V I C A

ARCHITECTURE & URBAN DESIGN

8323 NW 12th Street Suite No.106 Doral, FL 33126 tel: 305.593.9959 fax: 305.5939855

AA #26001093

PROJECT:

DOWNTOWN HOLLYWOOD SYNAGOGUE

2726 VAN BUREN ST. HOLLYWOOD, FL 33020

APPLICANT:

Downtown Hollywood Synagogue, Corp.

> 3728 N.E. 209th Ter Aventura, FL. 33180

> > ISSUED FOR:
> >
> > FINAL TAC
> >
> > APPROVAL

CIVICA PROJECT No:

150108

No.	DATE	REVISION	BY
1	11.21.16	TAC COMMENTS	IAF
DRAW	N BY	APPROVE	D BY
IAF			
DATE		SCALE:	

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SEAL/SIGNATURE

01.23.2017

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SHEET TITLE

LIGHTING


SITE PLAN

& PHOTOMETRICS

SHEET NUMBER

A-060

PROPOSED SITE LIGHTING & PHOTOMETRUIC STUDY

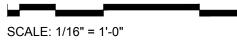

Luminaire Schedule									
Symbol Qty Label Arrangement		[MANUFAC]	Total Lamp Lumens	Lum. Watts					
	4	S4HS	SINGLE	Lithonia Lighting	KSF2 250M R4SC	19000	0.720	288	

Calculation Summary							
Label	СаІсТуре	Units	Avg	Max	Min	Avg/Min	Max/Min
Site	Illuminance	Fc	1.71	2.9	0.5	3.42	5.80
Spill	Illuminance	Fc	0.14	0.4	0.0	N.A.	N.A.

SCALE: 3/32" = 1'-0"



ARCHITECTURE & URBAN DESIGN

8323 NW 12th Street Suite No.106 Doral, FL 33126 tel: 305.593.9959 fax: 305.5939855

AA #26001093

PROJECT:

DOWNTOWN HOLLYWOOD SYNAGOGUE

2726 VAN BUREN ST. HOLLYWOOD, FL 33020

APPLICANT:

Downtown Hollywood Synagogue, Corp.

> 3728 N.E. 209th Ter Aventura, FL. 33180

> > ISSUED FOR:

FINAL TAC APPROVAL

CIVICA PROJECT No:

150108

No.	DATE	REVISION	BY
1	11.21.16	TAC COMMENTS	IAF
2	01.17.17	TAC COMMENTS	IAF
3	01.20.17	P&D CHECKLIS	T IAF
DRAW	'N BY	APPROVE	D BY
IAF			
DATE		SCALE:	

AS SHOWN

SEAL/SIGNATURE

2016

01.23.2017

ROLANDO LLANES AR - 0013160

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SHEET TITLE

SITE PLAN RENDITION

SHEET NUMBER

A-070







11.21.16 TAC COMMENTS IAF






HOLLYWOOD DOWNTOWN SYNAGOGUE

CIVICA, LLC BROWARD COUNTY, FLORIDA

<u>LEGEND</u>

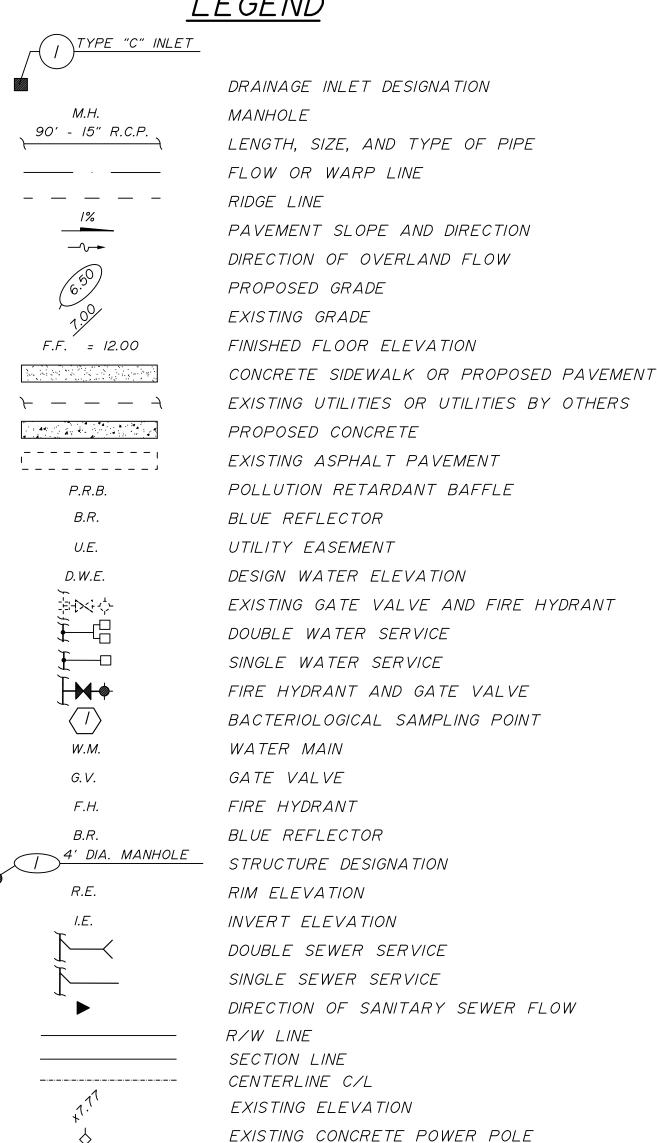

EXISTING WOOD POLE



LOCATION MAP SCALE: 1"=100'

PROJECT LOCATION



2737 Northeast 30th Place Fort Lauderdale, Florida 33306 Phone: (954) 491-7811 **Authorization No. EB-26343**

INDEX OF SHEETS:

INDEX OF SHEETS.	
DESCRIPTION:	SHEET NO.:
COVER SHEET	CI
GENERAL NOTES AND SPECIFICATIONS	C2
DEMOLITION - PLAN	C3
PAVING AND DRAINAGE SYSTEM - PLAN	C4
PAVING AND DRAINAGE SYSTEM - SECTIONS	C5
PAVING AND DRAINAGE SYSTEM - DETAILS	<i>C6</i>
PERVIOUS IMPERVIOUS BREAK OUT - PLAN	<i>C7</i>
PAVEMENT MARKINGS AND SIGNAGE - PLAN	C8
PAVEMENT MARKINGS AND SIGNAGE - DETAILS	<i>C</i> 9
WATER AND SEWER - PLAN	CIO
WATER AND SEWER SYSTEM - DETAILS	CII

LEGAL DESCRIPTION:

LOTS 16 AND 17, BLOCK 29 OF HOLLYWOOD LITTLE RANCHES, ACOORDING TO PLAT THEREOF AS RECORDED IN PLAT BOOK I, PAGE 26, PUBLIC RECORDS OF BROWARD COUNTY, FLORIDA.



SITE IMPROVEMENTS

Engineer of Record:	CARLOS J. BALLBE'	Project Number:
	Date: <u>///3/20/7</u>	201620
Registered Engineer Nur State of Florida		Sheet Number:

- **GENERAL NOTES:**
- I. ALL MATERIALS AND CONSTRUCTION WITHIN THE LIMITS OF THE SUBJECT PROPERTY SHALL CONFORM TO THE STANDARDS AND SPECIFICATION OF THE CITY OF HOLLYWOOD AND BROWARD COUNTY, FLORIDA.
- 2. IT SHALL BE THE DUTY OF THE CONTRACTOR, UPON EXECUTION OF THE CONTRACT, TO INFORM ALL PUBLIC SERVICES COMPANIES, INDIVIDUALS, AND ANY OTHERS OWNING OR CONTROLLING AND FACILITIES OR STRUCTURES WITHIN THE LIMITS OF THE PROJECT WHICH MAY CONFLICT WITH CONSTRUCTION OF THIS PROJECT, INCLUDING U.N.C.L.E. AT (800) 432-4770. CONTRACTOR SHALL PROTECT ALL EXISTING UTILITIES, STRUCTURES, SURVEY MARKERS AND OTHER FACILITIES. ALSO, CONTRACTOR SHALL INSPECT SITE AND VERIFY IF OTHER UTILITIES/STRUCTURES ARE PRESENT ON THE SITE OTHER THAN THOSE SHOWN ON THE PLANS.
- 3. THE CONTRACTOR IS REQUIRED TO FULLY INFORM HIMSELF CONCERNING THE LOCATIONS OF PUBLIC AND PRIVATE FACILITIES AND STRUCTURES ON, UNDER. OR OVER THE PROJECT WHICH MAY OR MAY NOT REQUIRE RELOCATION. ADJUSTMENT, AND/OR RECONSTRUCTION, AND WHICH MAY INTERFERE WITH HIS OPERATIONS. ALSO, CONTRACTOR SHALL PREPARED HIS BID AND ENTERED INTO THE CONTRACT IN FULL UNDERSTANDING OF THE CONDITIONS TO BE ENCOUNTERED AND HIS RESPONSIBILITY THEREWITH. ENGINEER HAS SHOWN ON THE DRAWINGS SUCH FACILITIES AND STRUCTURE THAT ARE OBVIOUS FROM A VISIT TO THE SITE, THE LOCATIONS OF WHICH HAVE BEEN OBTAINED FROM EXISTING MAPS AND RECORDS AND ARE, THEREFOR, SHOWN IN APPROXIMATE LOCATIONS. SUCH INDICATIONS ON THE DRAWINGS SHALL NOT RELIEVE THE CONTRACTOR OF ANY RESPONSIBILITY IN THIS RESPECT. OWNER AND ENGINEER SHALL NOT BE HELD RESPONSIBLE FOR ANY OMISSION OR FAILURE TO GIVE NOTICE TO THE CONTRACTOR OF ANY FACILITY OR STRUCTURE ON, UNDER, OR OVER THE PROJECT.
- 4. CONTRACTOR SHALL PROTECT BENCHMARKS, UTILITIES, EXISTING TREES, SHRUBS AND OTHER LANDSCAPE FEATURES DESIGNATED FOR PRESERVATION WITH TEMPORARY FENCING OR BARRICADE SATISFACTORY TO THE ENGINEER. NO MATERIAL SHALL BE STORED OR CONSTRUCTION OPERATION CARRIED ON WITHIN 4 FEET OF ANY TREE TO BE SAVED OR WITHIN THE TREE PROTECTION FENCE.
- 5. THE CONTRACTOR SHALL SAVE HARMLESS THE OWNER FROM ANY EXPENSES INCURRED IN THE RELOCATION, PRESERVATION, OR RECONSTRUCTION OF AND SHALL BE RESPONSIBLE FOR TAKING SUCH MEASURES AS NECESSARY TO PROTECT THE HEALTH, SAFETY AND WELFARE OF THOSE PERSONS HAVING ACCESS TO THE WORK SITE.
- 6. THE LOCATION OF THE EXISTING UTILITIES AS SHOWN ON THE PLANS WERE OBTAINED FROM AVAILABLE RECORDS AND ARE APPROXIMATE. CONTRACTOR SHALL FIELD VERIFY ALL LOCATIONS, SIZE, MATERIAL AND ELEVATION OF THE EXISTING FACILITIES PRIOR TO CONSTRUCTION AND SHALL CONTACT THE ENGINEER-OF-RECORD SHOULD THERE BE ANY DISCREPANCIES WITH THE APPROVED CONSTRUCTION DRAWINGS.
- 7. PRIOR TO CONSTRUCTION, A PRE-CONSTRUCTION MEETING SHALL BE SCHEDULED WITH THE CITY, COUNTY, OWNER, CONTRACTOR, DRAINAGE DISTRICT, ENGINEER AND ALL INTERESTED PARTIES INVOLVED WITH THE CONSTRUCTION OF THE IMPROVEMENTS. CONTRACTOR SHALL MAINTAIN A CURRENT APPROVED SET OF CONSTRUCTION PLANS ON-SITE. THE PLANS ARE TO BE MADE AVAILABLE TO THE CITY ENGINEER OR HIS DESIGNEE UPON REQUEST.
- 8. THE CONTRACTOR SHALL SAFEGUARD ALL EXISTING LANDSCAPING WHEN POSSIBLE. SOD RESTORATION IS NOT PART OF THIS CONTRACT, HOWEVER THE CONTRACTOR SHALL RESTORE THE CONSTRUCTION AREA SO THAT IT CAN BE SODDED WITHOUT ADDITIONAL WORK BEING REQUIRED. SOD AND LANDSCAPING WORK SHALL BE COORDINATED BY THE LANDSCAPE ARCHITECT.
- 9. CONTRACTOR SHALL INFORM ALL COMPANIES, INDIVIDUALS AND OTHER OWNING OR CONTROLLING FACILITIES OR STRUCTURES WITHIN THE LIMITS OF THE WORK WHICH HAVE TO BE RELOCATED, ADJUSTED OR RECONSTRUCTED IN SUFFICIENT TIME FOR THE UTILITY OR ORGANIZATION TO PERFORM SUCH WORK IN CONJUNCTION WITH OR IN ADVANCE OF THE CONTRACTOR'S OPERATION.
- IO. CONTRACTOR SHALL PROVIDE TO OWNER AND ENGINEER WITH AS-BUILT INFORMATION PERTAINING TO THE LOCATION AND ELEVATION OF PROPOSED IMPROVEMENTS BY A FLORIDA REGISTERED SURVEYOR & MAPPER. AS-BUILT INFORMATION SHALL INCLUDE ALL STRUCTURES, PIPE, FITTINGS, SUBGRADE, BASE AND PAVEMENT. COMPACTION TESTING SHALL BE PERFORMED BY A FLORIDA STATE CERTIFIED SOILS TESTING LABORATORY.
- II. ALL DEVIATIONS FROM THE PLANS MUST BE APPROVED BY THE OWNER, ENGINEER-OF-RECORD AND PERMITTING AGENCIES WITH JURISDICTION ON THE WORK PRIOR TO THE WORK BEING PERFORMED.
- 12. CONTRACTOR MUST NOTIFY OWNER, ENGINEER, AND CITY AT LEAST 48 HOURS PRIOR TO START OF CONSTRUCTION AND ANY REQUIRED INSPECTIONS AND
- 13. ALL UNDERGROUND IMPROVEMENTS MUST BE INSPECTED BY THE ENGINEER AND PERMITTING AGENCIES PRIOR TO BACKFILLING.
- 14. A COPY OF THE FOLLOWING PUBLICATIONS MUST BE AVAILABLE AT THE SITE DURING CONSTRUCTION:
- a. FLORIDA DEPARTMENT OF TRANSPORTATION STANDARD SPECIFICATION FOR ROAD AND BRIDGE CONSTRUCTION, LATEST REVISION.
- b. FLORIDA DEPARTMENT OF TRANSPORTATION ROADWAY AND TRAFFIC DESIGN STANDARDS, LATEST REVISION.
- c. UNITED STATES DEPARTMENT OF TRANSPORTATION FEDERAL HIGHWAY ADMINISTRATION MANUAL OF UNIFORM TRAFFIC CONTROL DEVICES, LATEST REVISION.

- PAVING AND DRAINAGE SYSTEM NOTES:
- I. ALL CONSTRUCTION SHALL CONFORM TO THE STANDARDS AND SPECIFICATIONS OF THE CITY OF HOLLYWOOD ENGINEERING DEPARTMENT, THE BROWARD COUNTY ENVIRONMENTAL PROTECTION AND GROWTH MANAGEMENT, AND THE FLORIDA DEPARTMENT OF TRANSPORTATION ROADWAY AND TRAFFIC DESIGN STANDARDS, LATEST EDITION.
- 2. ALL DRAINAGE PIPES SHALL BE REINFORCED CONCRETE PIPE (R.C.P) MEETING THE REQUIREMENTS OF ASTM SPECIFICATION C76-85a, UNLESS OTHERWISE NOTED ALL DRAINAGE PIPE SHALL CONFORM TO F.D.O.T. INDEX NO. 205.
- 3. THE DRAINAGE SYSTEM HAS BEEN DESIGNED FOR THE USE OF R.C.P. PIPE DIAMETERS AND INVERT ELEVATIONS SHOWN ON THE PLANS ARE FOR R.C.P.
- 4. MINIMUM COVER FOR ALL PIPE CULVERTS SHALL MEET THE REQUIREMENTS OF THE FLORIDA DEPARTMENT OF TRANSPORTATION ROADWAY AND TRAFFIC DESIGN STANDARDS (INDEX NO. 205).
- 5. ALL UNDERGROUND FACILITIES SHALL BE INSTALLED PRIOR TO PLACING THE LIMEROCK BASE MATERIAL.
- 6. THE FOLLOWING INSPECTIONS ARE REQUIRED:
- CLEARING AND DEMUCKING FILLING STORM DRAINS/UTILITIES - LAMPING
- SUBGRADE ROCK BASE
- PRIME COAT
- *ASPHALT*
- FINAL PAVEMENT MARKINGS
- HORIZONTAL CONTROL POINTS AND PAVEMENT REFERENCE MONUMENTS.
- 7. DENSITY TESTS FOR SUBGRADE MUST BE SUBMITTED TO AND APPROVED BY THE CITY. DENSITY TESTS AND AS-BUILTS FOR LIMEROCK BASE MUST BE SUBMITTED AND APPROVED BY THE CITY PRIOR TO THE PLACEMENT OF ANY ASPHALT.
- 8. PRECAST CONCRETE MANHOLES AND CATCH BASINS SHALL CONFORM TO THE REQUIREMENTS OF ASTM C-478 AND 64T FOR CONCRETE STRENGTH, STEEL REINFORCEMENT, AREA, PLACEMENT AND APPEARANCE WHEN MANUFACTURED ENGINEERING TESTING LABORATORY, SIGNED AND DATED, CERTIFYING THAT THEY MEET THE REQUIREMENTS OF ASTM C-478 FOR CONCRETE STRENGTH. STEEL REINFORCEMENT AREA AND PLACEMENT, AND APPEARANCE MANHOLES MUST BE INSPECTED BY THE ENGINEER BEFORE UNLOADING.
- 9. MINIMUM WALL AND BASE THICKNESS FOR PRECAST MANHOLES AND CATCH BASINS SHALL BE 8 INCHES. REINFORCING STEEL FOR MANHOLES AND CATCH BASINS SHALL CONFORM TO THE REQUIREMENTS OF ASTM A-615, A-305, A-185 AND A-497 LATEST REVISION. SPLICES SHALL HAVE A MINIMUM LAP OF 24 BAR DIAMETERS. MINIMUM COVER OVER REINFORCING STEEL SHALL BE 3 INCHES. ALL DRAINAGE STRUCTURES SHALL MEET FDOT SPECIFICATION.
- IO. ALL OPENINGS IN PRECAST MANHOLES AND CATCH BASINS SHALL BE CAST AT THE TIME OF MANUFACTURE.
- II. PRECAST MANHOLE AND CATCH BASIN SHOP DRAWINGS SHALL BE SUBMITTED TO THE CITY AND ENGINEER FOR APPROVAL PRIOR TO FABRICATION.
- 12. ALL MANHOLES AND CATCH BASINS SHALL BE SET PLUMB TO LINE AND GRADE, AND SHALL REST ON A FIRM, CAREFULLY GRADED SUBGRADE, WHICH SHALL PROVIDE UNIFORM BEARING UNDER BASE.
- 13. MANHOLE AND CATCH BASIN SECTIONS SHALL BE JOINTED WITH A MASTIC COMPOUND PRODUCING A WATER TIGHT BOND (RAM-NEK FLEXIBLE GASKETS BY K.T. SNYDER CO., INC. AND PRIMED WITH RAM-NEK PRIMER OR APPROVED EQUAL). THE REMAINING SPACE SHALL BE FILLED WITH CEMENT MORTAR AND FINISHED SO AS TO PRODUCE A SMOOTH CONTINUOUS SURFACE INSIDE AND OUTSIDE THE WALLS SECTIONS.
- 14. CONCRETE FOR PRECAST MANHOLES SHALL ATTAIN A MINIMUM COMPRESSIVE STRENGTH OF 4,000 PSI AT 28 DAYS. ALL CONCRETE AND MORTAR USED IN MANHOLE CONSTRUCTION SHALL HAVE TYPE II CEMENT.
- 15. ALL SPACES AROUND PIPES ENTERING OR LEAVING MANHOLES SHALL BE COMPLETELY FILLED WITH EMBECO MORTAR (NON-METALLIC), NON-SHRINKING OR APPROVED EQUAL.
- 16. SHOP DRAWINGS OF ALL MATERIALS BEING USED SHALL BE SUBMITTED TO THE ENGINEER AND THE CITY OF TAMARAC FOR APPROVAL PRIOR TO ORDERING MATERIALS. CONTRACTOR SHALL BE RESPONSIBLE FOR ANY REVISED OR UNACCEPTABLE MATERIALS INSTALLED OR ORDERED WITHOUT AN APPROVED SHOP DRAWING. THE FOLLOWING SHOP DRAWINGS SHALL BE SUBMITTED:
- A. MANHOLES / CATCH BASINS
- C. FRAME & GRATES (COVERS) D. HEADWALLS
- 17. ALL P.C.P. OR R.P.M. SHOWN ON THE PLAT SHALL BE RAISED TO FINAL GRADE IF THEY ARE LOCATED IN PAVEMENT OR CONCRETE DRAINAGE STRUCTURES TO BE CLEANED PRIOR TO CITY ACCEPTANCE, IF LOCATED WITHIN PUBLIC RIGHT-OF-WAY.
- 18. PROCTORS SHALL BE PERFORMED ON ALL MATERIAL, SUBGRADE AND BASE AND ANY SUBSEQUENT CHANGES IN MATERIALS. LIMEROCK BEARING RATIOS, SIEVE ANALYSIS AND DENSITIES REQUIRED BY THE CONTRACT DOCUMENTS SHALL BE SUBMITTED TO THE CITY.
- 19. CONCRETE SIDEWALKS SHALL BE FOUR (4) INCHES THICK, EXCEPT AT DRIVEWAYS WHERE THEY SHALL BE SIX (6) INCHES THICK. SIDEWALK SUBGRADE SHALL BE GRUBBED, COMPLETELY DEMUCKED AND COMPACTED TO 98% OF MAXIMUM DRY DENSITY AS DETERMINED BY AASHTO T-180. OPEN TYPE EXPANSION JOINTS SHALL BE USED. SIDEWALK MUST BE SEPARATE FROM THE TRAVEL WAY AND CONSTRUCTED IN ACCORDANCE WITH THE F.D.O.T. ROADWAY AND TRAFFIC.
- 20. REAR YARD DRAIN PIPE MATERIALS SHALL BE SMOOTH LINED HIGH DENSITY POLYETHYLENE AASHTO M294, TYPES S, N-I2 PROFILE ULTRA OR APPROVED EQUAL.
- 21. REAR YARD DRAINS SHALL HAVE A CONCRETE COLLAR 18"X18"X6" MINIMUM.

SPECIFICATIONS FOR PVC SURFACE DRAINAGE PRODUCTS

PVC SURFACE DRAINAGE INLETS SHALL INCLUDE THE INLINE DRAINS, DRAIN BASINS, AND CATCH BASINS AS INDICATED ON THE CONTRACT DRAWINGS AND REFERENCED WITHIN THE CONTRACT SPECIFICATIONS. THE CAST IRON GRATES FOR EACH OF THESE FITTINGS IS TO BE CONSIDERED AND INTEGRAL PART OF THE SURFACE DRAINAGE INLET AND SHALL BE FURNISHED BY THE SAME MANUFACTURER. THE SURFACE DRAINAGE INLETS SHALL BE AS MANUFACTURED BY NYLOPLAST, USA, INC. OR PRIOR APPROVED EQUAL.

2. <u>MATERIALS:</u>
THE INLINE DRAINS, DRAIN BASINS, AND CATCH BASINS REQUIRED FOR THIS CONTRACT
TO THE TOTAL PROPERTY OF THE PROP SHALL BE MANUFACTURED FROM PVC PIPE STOCK, UTILIZING A THERMO-MOLDING PROCESS TO REFORM THE PIPE STOCK TO THE FURNISHED CONFIGURATION, THE DRAINAGE PIPE CONNECTION STUBS SHALL BE MANUFACTURED FROM PVC PIPE STOCK AND FORMED TO PROVIDE A WATERTIGHT CONNECTION WITH THE PIPING SYSTEM SPECIFIED. THIS JOINT TIGHTNESS SHALL CONFORM TO ASTM D3212. THE PIPE CONNECTION STUBS SHALL BE JOINED TO THE MAIN BODY OF THE DRAIN BASIN OR CATCH BASIN UTILIZING A WATERTIGHT, GASKETED, SWEDGED - TYPE CONNECTION.

- 3. THE PIPE STOCK USED TO MANUFACTURE THE MAIN BODY AND PIPE STUBS OF THE SURFACE DRAINAGE INLETS SHALL MEET EITHER ASTM D3034 OR ASTM D679. THE SWEDGE GASKET MATERIAL AND THE GASKETS USED TO FORM THE CONNECTING JOINT WITH THE PIPE STUB SHALL MEET THE REQUIREMENTS OF ASTM F477. SURFACE DRAINAGE PRODUCTS SHALL MEET THE MECHANICAL PROPERTY REQUIREMENTS FOR FABRICATED FITTINGS AS DESCRIBED IN ASTM F794, F979, AND F1336.
- 4. THE GRATES FURNISHED FOR ALL SURFACE DRAINAGE INLETS SHALL BE CAST IRON AND SHALL BE MADE SPECIFICALLY FOR EACH FITTING. GRATES FOR 12" AND LARGER CATCH BASINS AND INLINE DRAINS SHALL BE CAPABLE OF SUPPORTING H-20 WHEEL LOADING. GRATES FOR CATCH BASINS AND INLINE DRAINS INLETS SMALLER THAN 12" SHALL BE CAPABLE OF SUPPORTING LIGHT WHEEL LOAD TRAFFIC. METAL USED IN THE MANUFACTURE OF THE CASTING SHALL CONFORM TO ASTM A-48-83 CLASS 30B FOR GRAY IRON. THE CASTING SHALL BE FURNISHED WITH A BLACK PAINT.

5. <u>INSTALLATION</u>

THE SPECIFIED PVC SURFACE DRAINAGE INLETS SHALL BE INSTALLED USING CONVENTIONAL FLEXIBLE PIPE BACKFILL MATERIALS AND PROCEDURES. THE BACKFILL MATERIAL SHALL BE CRUSHED STONE OR OTHER GRANULAR MATERIAL MEETING THE REQUIREMENTS OF CLASS I OR 2 MATERIAL AS DEFINED IN ASTM D2321. THE SURFACE DRAINAGE INLETS SHALL BE BEDDED AND BACKFILLED UNIFORMLY IN ACCORDANCE WITH ASTM D2321.

BROWARD COUNTY D.P.E.P. NOTES ON WATER — SEWER SEPARATION

1. <u>VERTICAL CROSSINGS:</u>

SANITARY SEWER SYSTEMS AND/OR RECLAIMED WATER MAINS SHALL CROSS UNDER POTABLE WATER MAINS WHENEVER PHYSICALLY POSSIBLE. SANITARY SEWER SYSTEMS AND/OR RECLAIMED WATER MAINS CROSSING BELOW POTABLE WATER MAINS SHALL BE LAID TO PROVIDE A PREFERRED VERTICAL SEPARATION DISTANCE OF 12 INCHES (MINIMUM 6" FOR GRAVITY/RECLAIMED MAIN) BETWEEN THE NVERT OF THE POTABLE WATER MAIN AND THE CROWN OF THE LOWER PIPE.

2. HORIZONTAL SEPERATIONS:

WHERE IT IS PHYSICALLY POSSIBLE:

SANITARY SEWER SYSTEMS REQUIRE A PREFERRED 10-FOOT HORIZONTAL SEPARATION DISTANCE (MINIMUM 6-FOOT) OUTSIDE TO OUTSIDE OF PIPE BETWEEN ANY POTABLE WATER MAIN PARALLEL INSTALLATIONS.

WHERE EVER EITHER ARE NOT PHYSICALLY POSSIBLE, THEN THE POTABLE WATER MAIN SHALL BE LAID AT THE MAXIMUM PHYSICAL HORIZONTAL SEPERATION DISTANCE POSSIBLE AND EITHER LAID:

A. IN A SEPERATE TRENCH.;

B. ON AN UNDISTURBED EARTH SHELF;

2. <u>CONFLICTS:</u>


WHEREVER IT IS NOT POSSIBLE TO MAINTAIN THE MINIMUM STANDARDS IN 1) AND 2), THEN ALL PIPING MATERIAL SHALL BE DUCTILE IRON PIPE (DIP). ALL DIP SHALL BE CLASS 50 OR HIGHER. ADEQUATE PROTECTIVE MEASURES AGAINST CORROSION SHALL BE USED AS DETERMINED BY TH DESIGN AND SITE CONDITIONS. ADDITIONALLY, THE POTABLE WATER MAIN SHALL HAVE A FULL JOINT CENTERED ON THE CONFLICT AND MECHANICALLY RESTRAINED. AN ABSOLUTE MINIMUM VERTICAL SEPARATION DISTANCE OF 6 INCHES SHALL BE PROVIDED BETWEEN THE INVERT OF THE THE UPPER PIPE AND THE CROWN OF THE LOWER PIPE.


Designed by: CJB Date: 5/20/6 Date: 5/2016 ADMDrawn by: Checked by: ____CJB ___ Date: 5/2016 NO. DATE BY REVISION NO. DATE BY REVISION

& ASSOCIATES Civil Engineering • Planning • Surveyin

2737 Northeast 30th Place Fort Lauderdale, Florida 33306 Phone: (954) 491-7811 **Authorization No. EB-26343**

Engineer of Record: CARLOS J. BALLBE GENERAL NOTES AND SPECIFICATIONS Project Number 201620 Date: 1/13/2017 HOLLYWOOD DOWNTOWN SYNAGOGUE Sheet Number: Registered Engineer Number: 41811 State of Florida C2 CIVICA, LLC

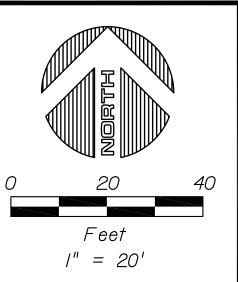

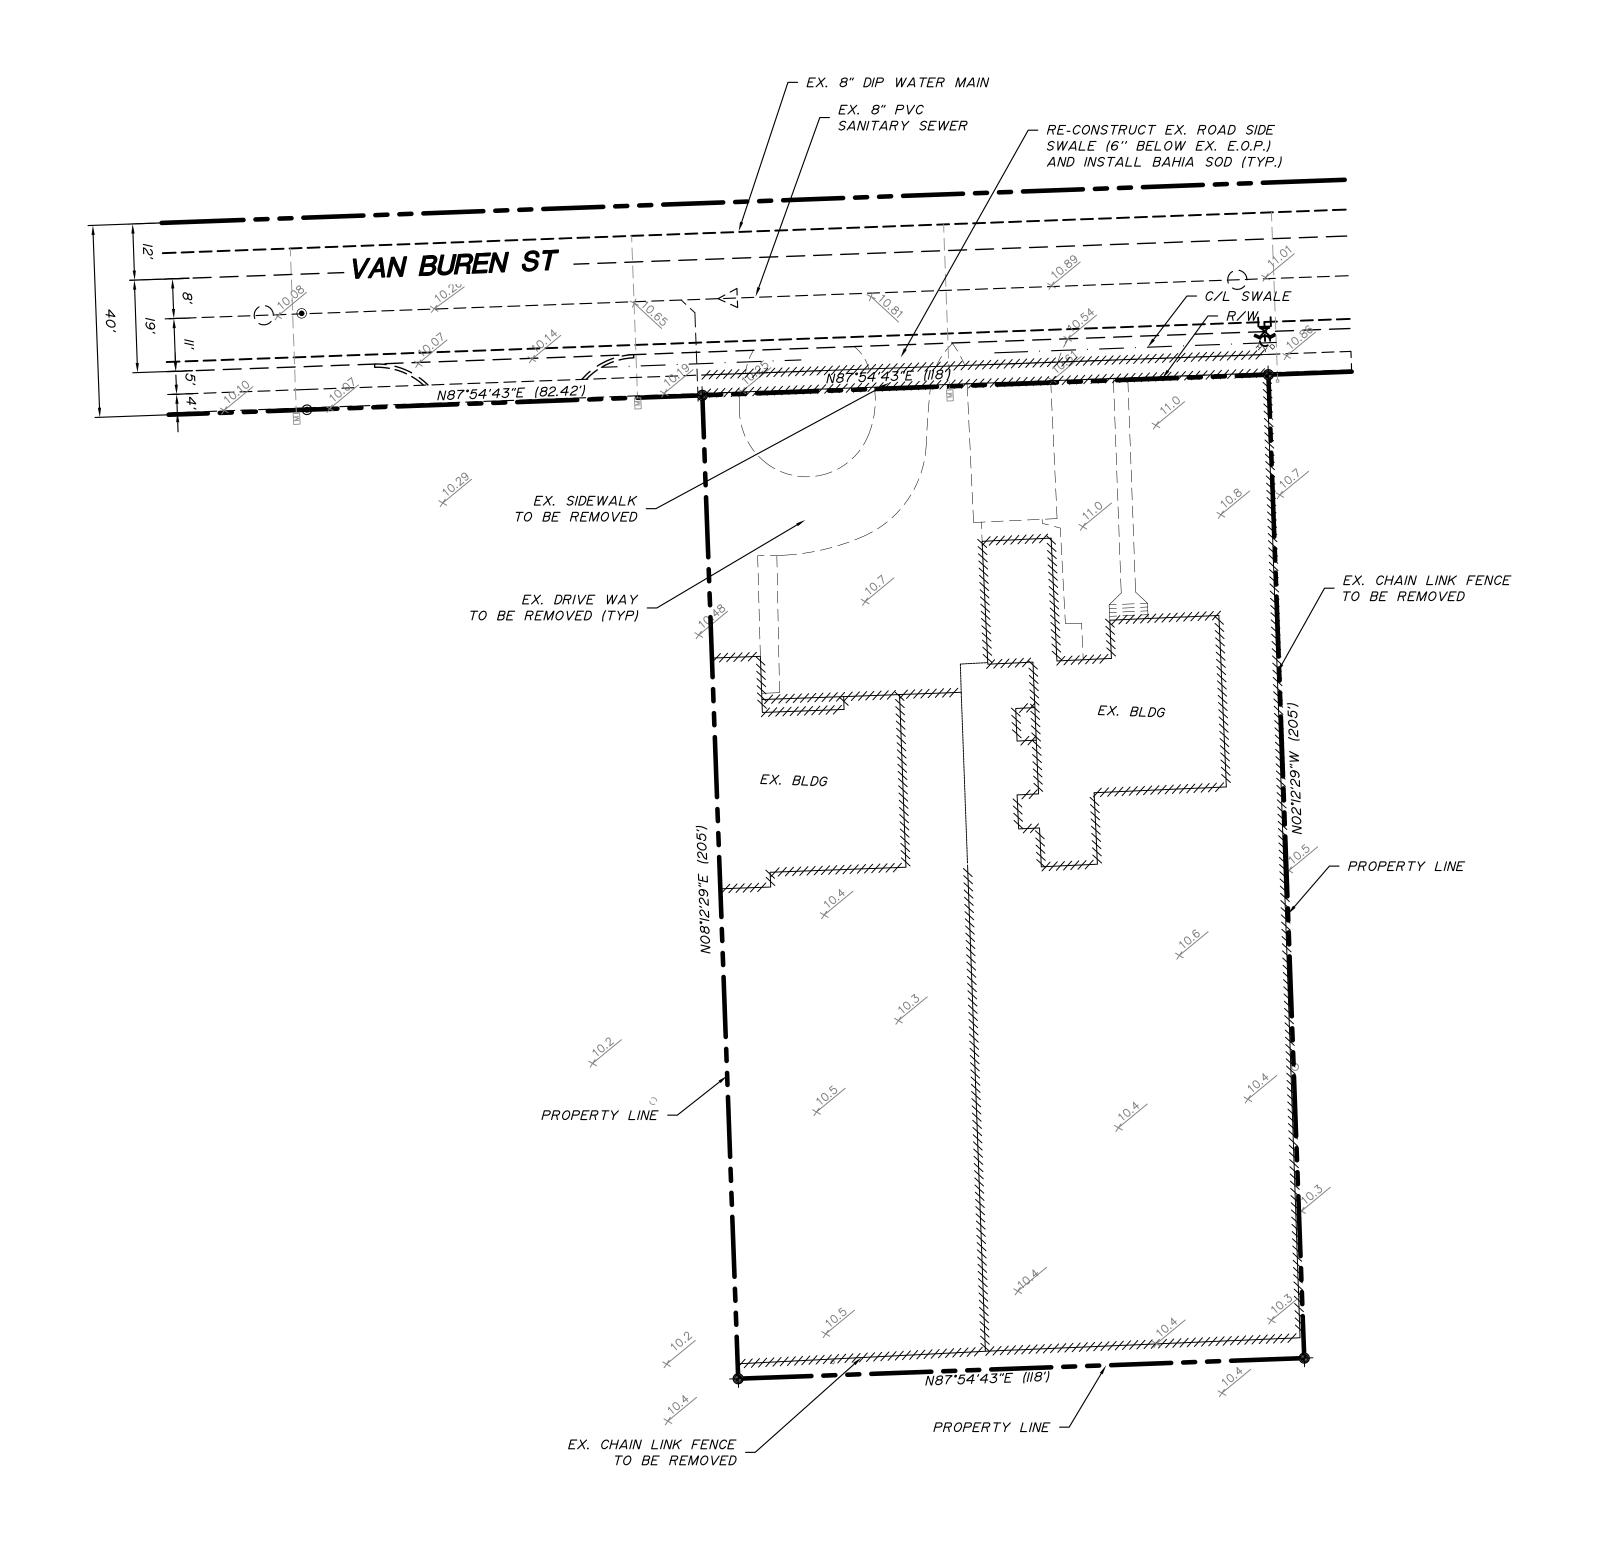



<u>NOTES:</u> 1. ELEVATIONS ARE BASED ON THE NORTH AMERICAN VERTICAL DATUM OF 1988 UNLESS OTHERWISE SHOWN

								Designed by:	CJB	Date:	5/2016
								Drawn by:	ADM	_ Date:	5/2016
								Checked by: _	CJB	_ Date:	5/2016
NO.	DATE	BY	REVISION	NO.	DATE	BY	REVISION				



Engineer of Record: CARLOS J. BALLBE Date: 1/13/2017 Registered Engineer Number: 41811 State of Florida	DEMOLITION PLAN	Project Number:
	HOLLYWOOD DOWNTOWN SYNAGOGUE CIVICA, LLC	Sheet Number:

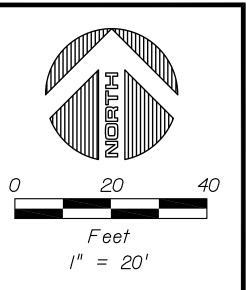

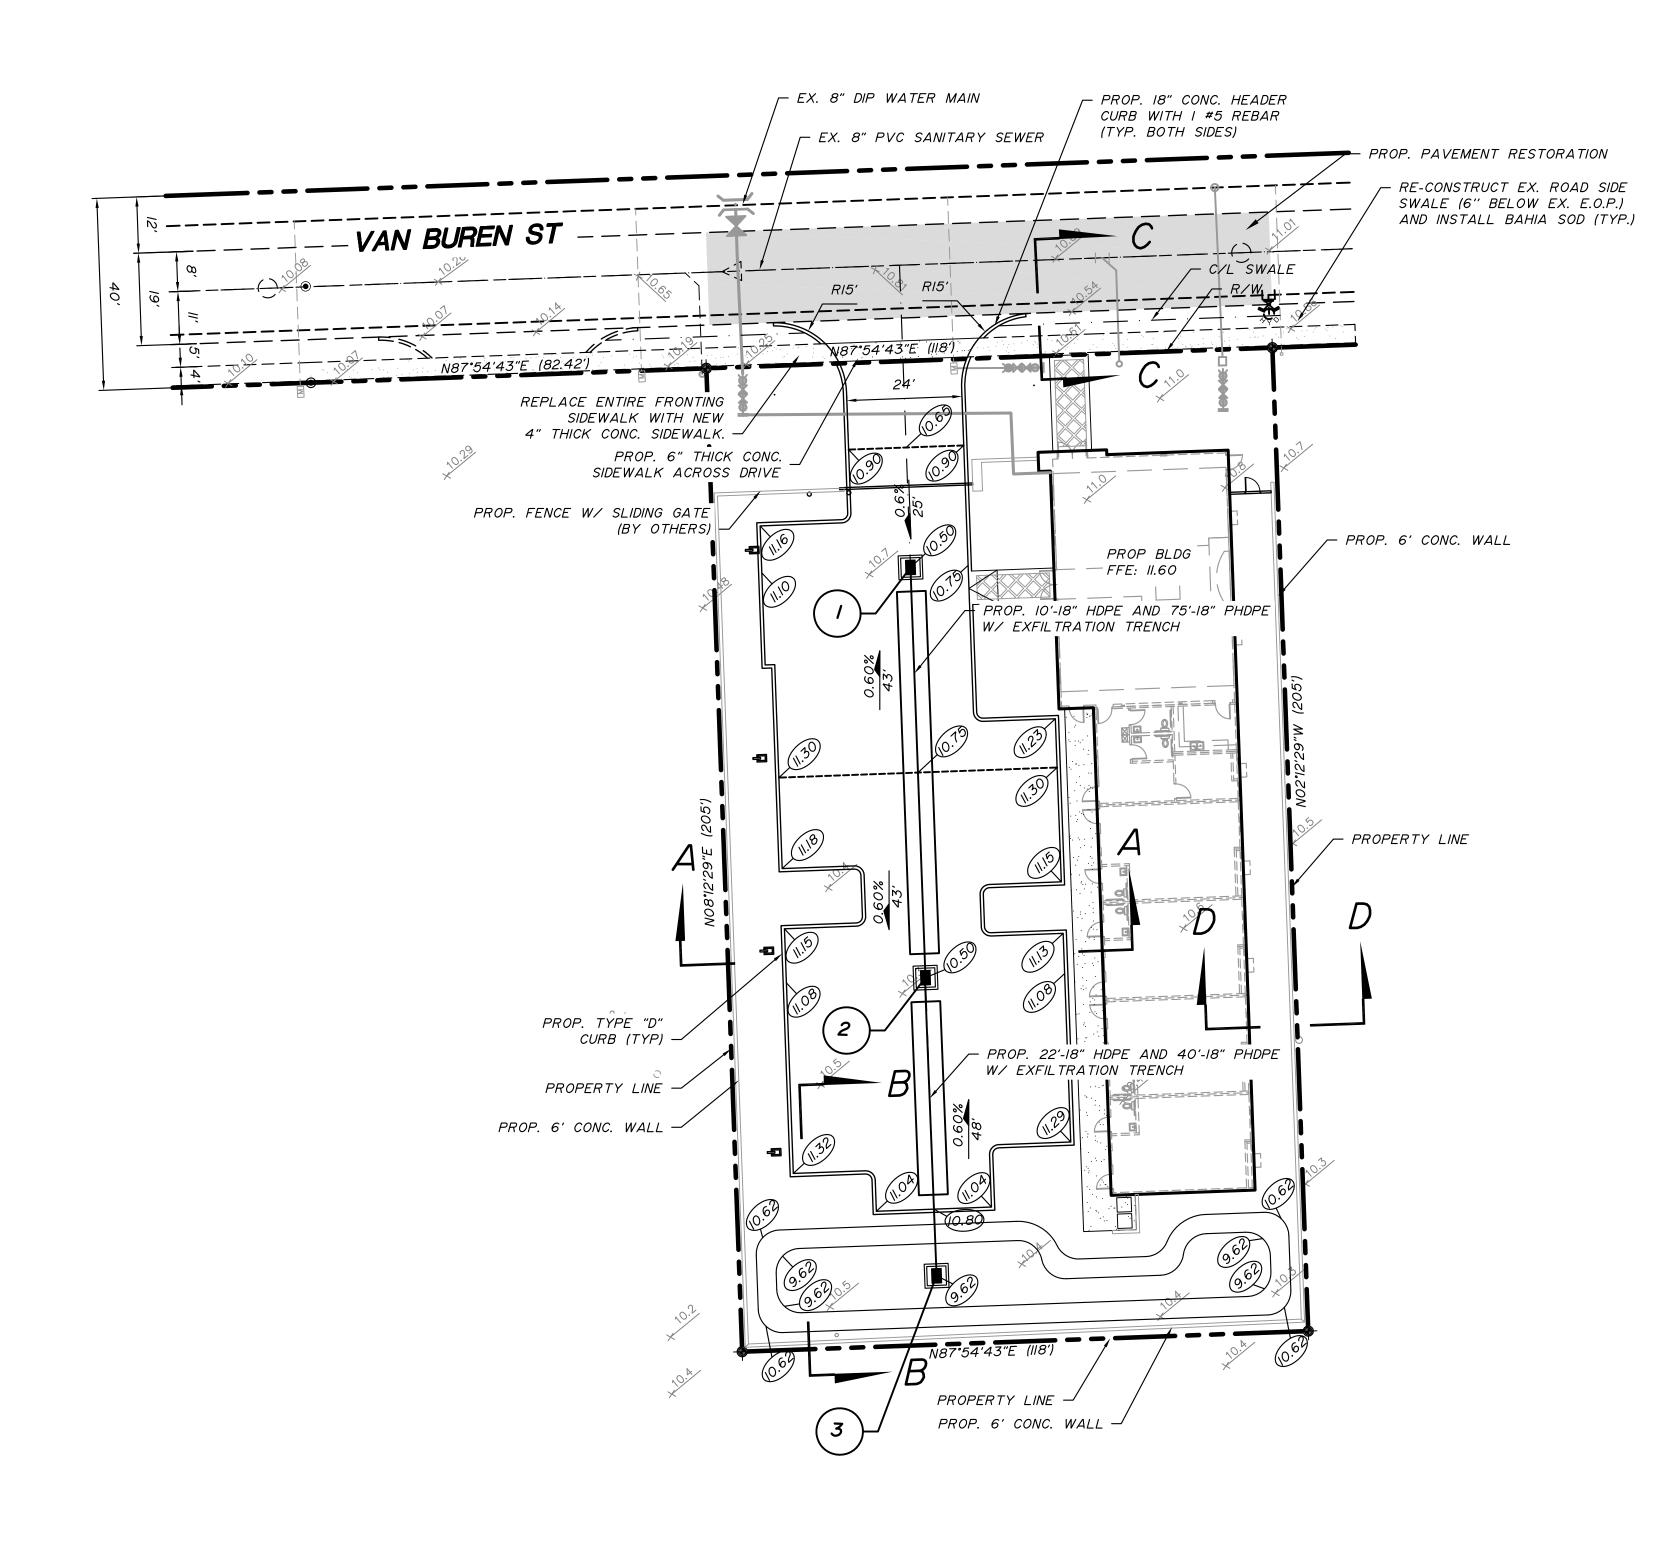

TYPE "C" INLET

W/ USF 4155-6210

R.E. 10.50

I.E. 4.85 S (PRB).

TYPE "C" INLET

W/ USF 4155-6210

R.E. 10.50


I.E. 4.85 N (PRB), S (PRB).

TYPE "C" DITCH BOTTOM INLET W/ USF 620 GRATE


R.E. 9.62
I.E. 4.85 N (PRB).

<u>NOTES:</u> 1. ELEVATIONS ARE BASED ON THE NORTH AMERICAN VERTICAL DATUM OF 1988 UNLESS OTHERWISE SHOWN


				Designed by: CJB Date: 5/2016 Drawn by: ADM Date: 5/2016	2737 Northeast 30th Place Fort Lauderdale, Florida 33306	Engineer of Record: CARLOS J. BALLBE	PAVING AND DRAINAGE SYSTEM PLAN	Project Number: 201620
NO. DATE	BY REVISION	NO. DATE BY	REVISION	Checked by: CJB Date: 5/2016 Checked by: CJB Date: 5/2016 Civil Engineering • Planning • Surveying	Phone: (954) 491-7811 Authorization No. EB-26343	Registered Engineer Number: State of Florida Date: 1/13/2017 4/8//	HOLLYWOOD DOWNTOWN SYNAGOGUE CIVICA, LLC	Sheet Number:

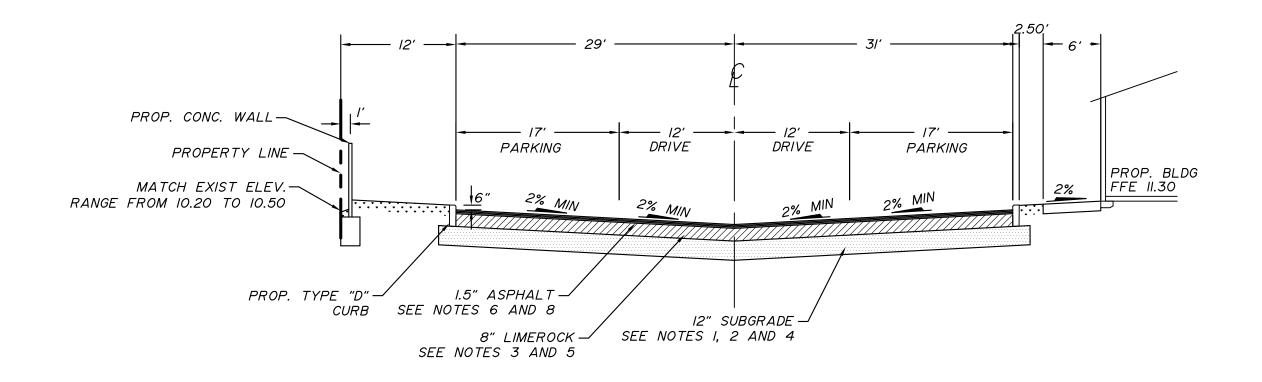


SECTION A-A

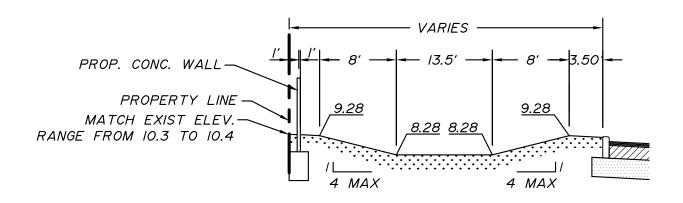

SECTION B-B

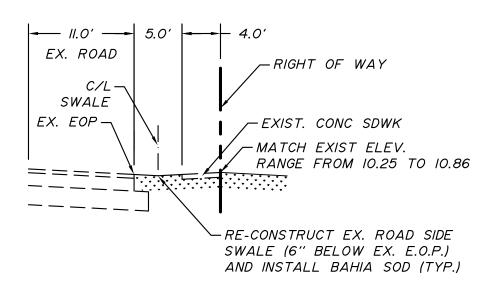

SECTION C-C

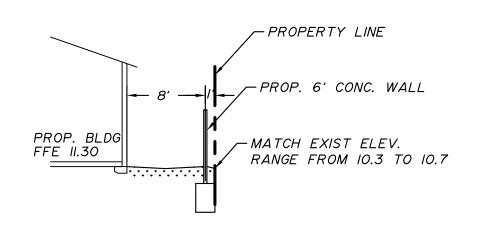

SECTION D-D

PAVEMENT NOTES:


- I. THE FULL DEPTH OF ALL EXISTING ORGANIC AND DELETERIOUS MATERIAL WITHIN THE ROADWAYS, RIGHT-OF-WAYS AND UTILITY/DRAINAGE EASEMENTS SHALL BE REMOVED. NO MATERIAL OF FDOT CLASS A-5, A-7 OR A-8 SHALL BE ALLOWED.
- 2. ALL MATERIAL SUPPORTING THE ROADWAY AND SHOULDERS SHALL HAVE A MINIMUM LIMEROCK BEARING RATIO (L.B.R.) OF 40. THE SUBGRADE SHALL BE 12" COMPACTED TO 98% OF MAXIMUM DRY DENSITY AS PER AASHTO T-180. THE ENGINEER AND COUNTY INSPECTOR WILL DETERMINE THE LOCATION AND NUMBER OF DENSITY TESTING, WHICH SHALL BE APPROXIMATELY ONE DENSITY FOR EVERY 7000 SQUARE FEET OF ROAD.
- 3. LIMEROCK BASE SHALL BE 8" PRIMED AND SHALL HAVE A MINIMUM LIMEROCK BEARING RATE (LBR) OF 100, SHALL BE OF THE MIAMI FORMATION, HAVING A MINIMUM PERCENTAGE OF CARBONATES OF CALCIUM AND MAGNESIUM OF 60, UNLESS OTHERWISE APPROVED. BASE MATERIAL SHALL BE COMPACTED TO A DENSITY OF NOT LESS THAN 98% OF MAXIMUM DRY DENSITY AS DETERMINED BY AASHTO T-180 UNDER ALL PAVED AREAS.
- 4. BASE COURSE CONSTRUCTION SHALL NOT BE STARTED UNTIL ALL UNDERGROUND CONSTRUCTION IN THE VICINITY HAS BEEN INSTALLED, TESTED AND ACCEPTED.
- 5. PRIME AND TACK COAT FOR BASE SHALL CONFORM TO THE REQUIREMENTS
 AND SPECIFICATIONS OF SECTIONS 300-I THROUGH 300-7 OF F.D.O.T. STANDARDS
 SPECIFICATIONS. PRIME COAT SHALL BE APPLIED AT A RATE OF 0.25 GALLONS
 PER SQUARE YARD.
- 6. THE WEARING SURFACE SHALL BE 1.5 APPLIED IN TWO 3/4 INCH LIFTS AND SHALL BE ASPHALT CONCRETE TYPE S-3 WITH TACK COAT USED BETWEEN PAVING COURSES AS PER F.D.O.T. MINIMUM STANDARDS.
- 7. THE FIRST LIFT OF ASPHALT SHALL BE INSTALLED ½ INCH BELOW THE LIP OF CURB. THE SECOND LIFT OF ASPHALT TO BE ¼ INCH ABOVE THE LIP OF CURB. THE SECOND LIFT SHALL NOT BE APPLIED UNTIL A MINIMUM OF 80% OF THE HOUSES HAVE BEEN CONSTRUCTED OR AS DIRECTED BY THE OWNER.
- 8. ALL GRADES SHOWN ARE FINISH ASPHALT PAVEMENT GRADES (2ND LIFT)
 UNLESS OTHERWISE NOTED.
- 9. ALL REPAIRS TO EXISTING PAVEMENT SHALL RECEIVE SAW-CUT EDGES PRIOR TO RELAYING ASPHALT. UTILITY PIPING OR WIRING LESS THAN FOUR (4) INCHES IN DIAMETER REQUIRES A SCHEDULE 40 PVC CASING PIPE WITH SAND BACKFILLS UNDER PAVED AREAS ONLY.
- IO. ALL EXISTING CONTROL POINTS AND/OR REFERENCE MARKERS SHALL BE RAISED TO FINAL GRADE. THESE POINTS AND REFERENCE MARKERS SHALL BE LOCATED AND NOTED ON THE PLAN.
- II. LABORATORY PROCTOR COMPACTION TEST (T-180) SHALL BE PERFORMED ON ALL MATERIAL, SUBGRADE AND BASE AND ANY SUBSEQUENT CHANGES IN MATERIALS. LIMEROCK BEARING RATIOS, SIEVE ANALYSIS AND DENSITIES REQUIRED BY THE CONTRACT DOCUMENTS SHALL BE SUBMITTED TO THE ENGINEER-OF-RECORD.

								Designed by:	CJB	Date:	5/2016
								_		•	
								Drawn by: _	ADM	Date:	5/2016
								Checked by: _	CJB	Date:	5/2016
NO.	DATE	BY	REVISION	NO.	DATE	BY	REVISION				




2737 Northeast 30th Place
Fort Lauderdale, Florida 33306
Phone: (954) 491-7811
Authorization No. EB-26343

Engineer of Record: CAR	LOS J. BALLBE	PAVING AND DRAINAGE SYSTEM SECTIONS	Project Number: 201620
Registered Engineer Number:	Date: 1/13/2017	HOLLYWOOD DOWNTOWN SYNAGOGUE CIVICA, LLC	Sheet Number:
State of Florida	41811		<i>C5</i>

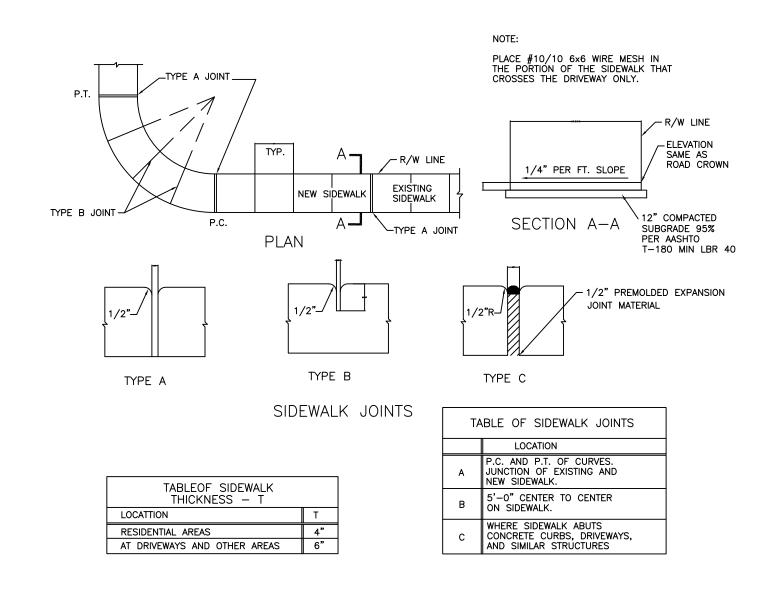

SIDEWALK CONSTRUCTION DETAIL

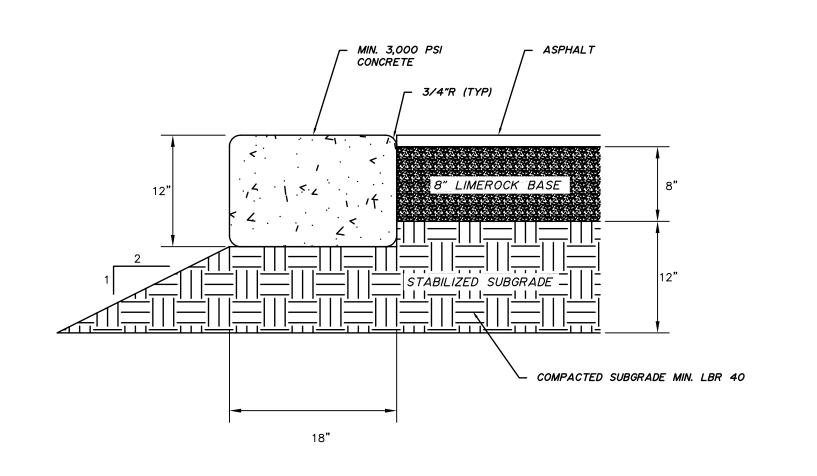


GENERAL NOTES:


- I. LIMEROCK BASE SHALL BE COMPACTED TO NOT LESS THAN 98% OF MAXIMUM DENSITY AS DETERMINED BY AASHTO T-180 WITH MINIMUM LBR 100 AND MAXIMUM 6" LIFTS
- 2. SUBGRADE SHALL BE COMPACTED TO NOT LESS THAN 98% OF MAXIMUM DENSITY AS DETERMINED BY AASHTO T-180 WITH MINIMUM LBR 40 AND A MAXIMUM OF 6" LIFTS.


ADDITIONAL CURBING NOTES:


- I. DENSITY TEST SHALL BE REQUIRED ATA A MINIMUM OF ONE PPER 200 LINEAR FEET, AND PERFORMED BY AN APPROVED INDEPENDENT LABORATORY AT THE CONTRACTOR'S EXPENSE.
- 2. EXTRUDED CURB SHALL BR POURED MONOLITHICALLY ALL CURBS SHALL BE CONSTRUCTED IN ACCORDANCE WITH THIS DETAIL
- 3. CONTROL JOINTS SHALL BE TOOLED OR CUT
- EVERY TEN (IO) FEET. 4. ALL AREAS BEHIND CURBS SHALL BE BACKFILLED WITHIN 72 HOURS OF PLACEMENT.


CONC. HEADER CURB DETAIL

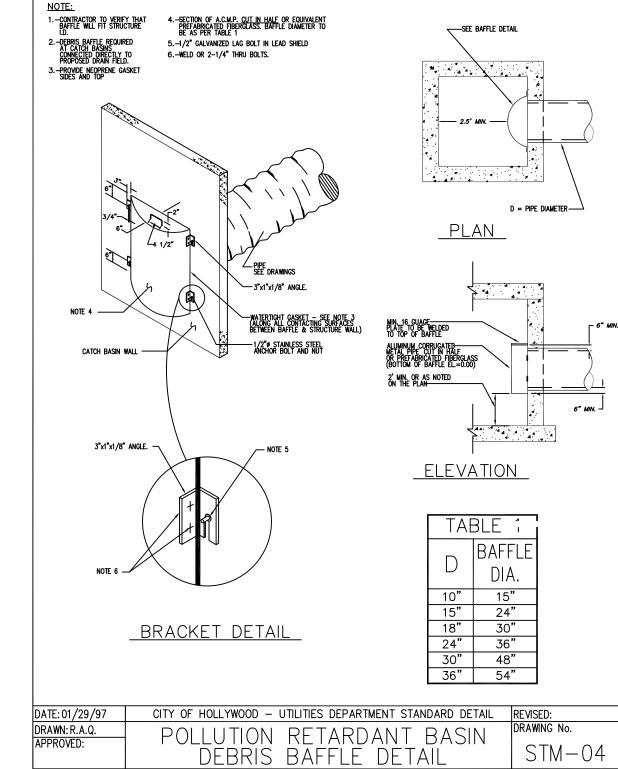

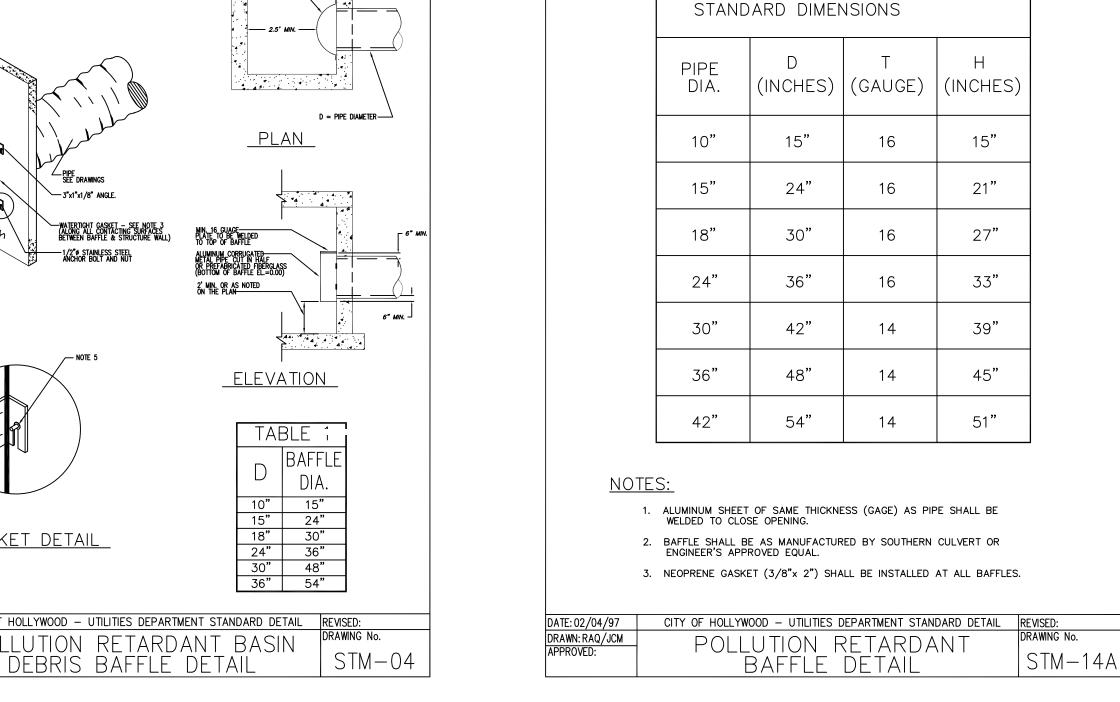

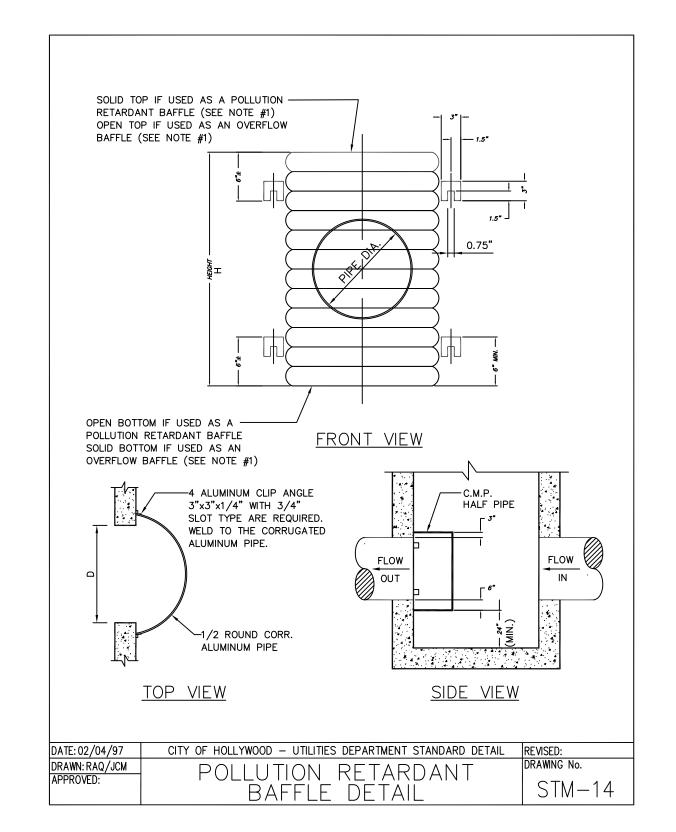


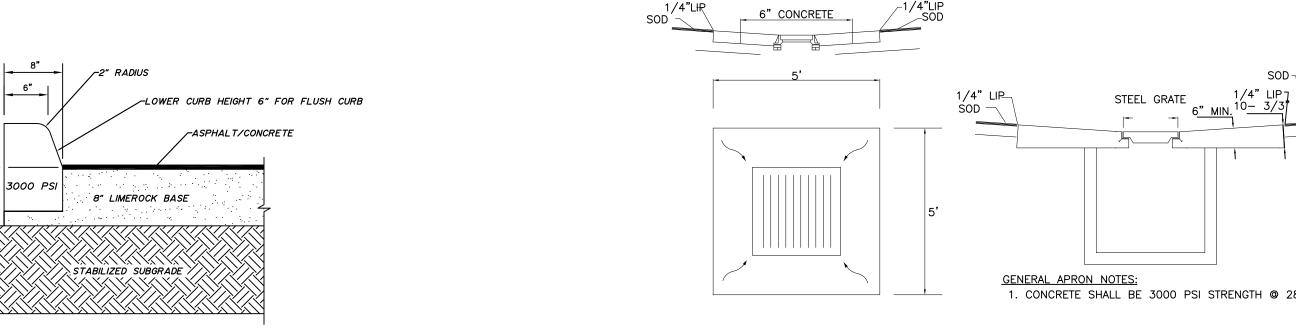


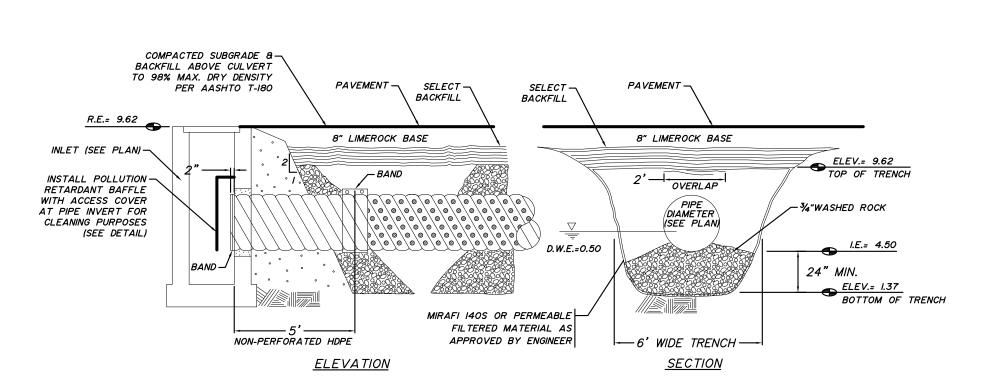

TYPE "D" MOD CURB DETAIL

EXFILTRATION TRENCH DETAIL

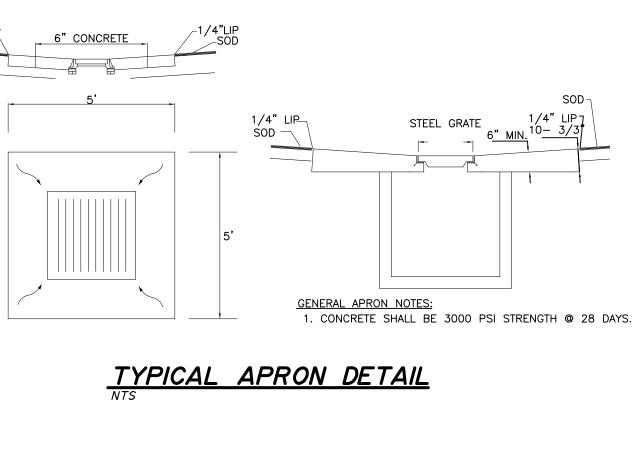

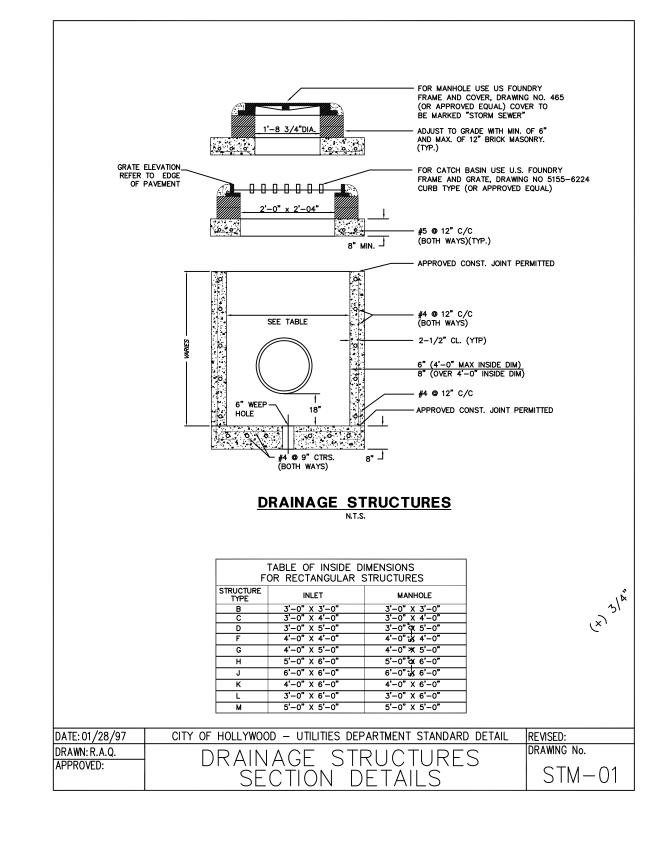


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								Checked by: _	CJB	Date:	2/2015
NO.	DATE	BY	REVISION	NO.	DATE	BY	REVISION	1			




2737 Northeast 30th Place Fort Lauderdale, Florida 33306 Phone: (954) 491-7811 **Authorization No. EB-26343**

Engineer of Record: CARLOS J. BALLBE Date: 1/13/2017 Registered Engineer Number: 41811 State of Florida

PAVING AND DRAINAGE SYSTEM Project Number: 201620 DETAILS HOLLYWOOD DOWNTOWN SYNAGOGUE Sheet Number: C6 CIVICA, LLC

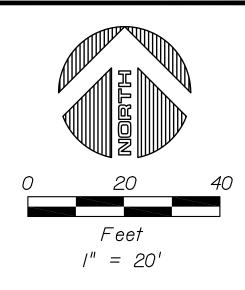

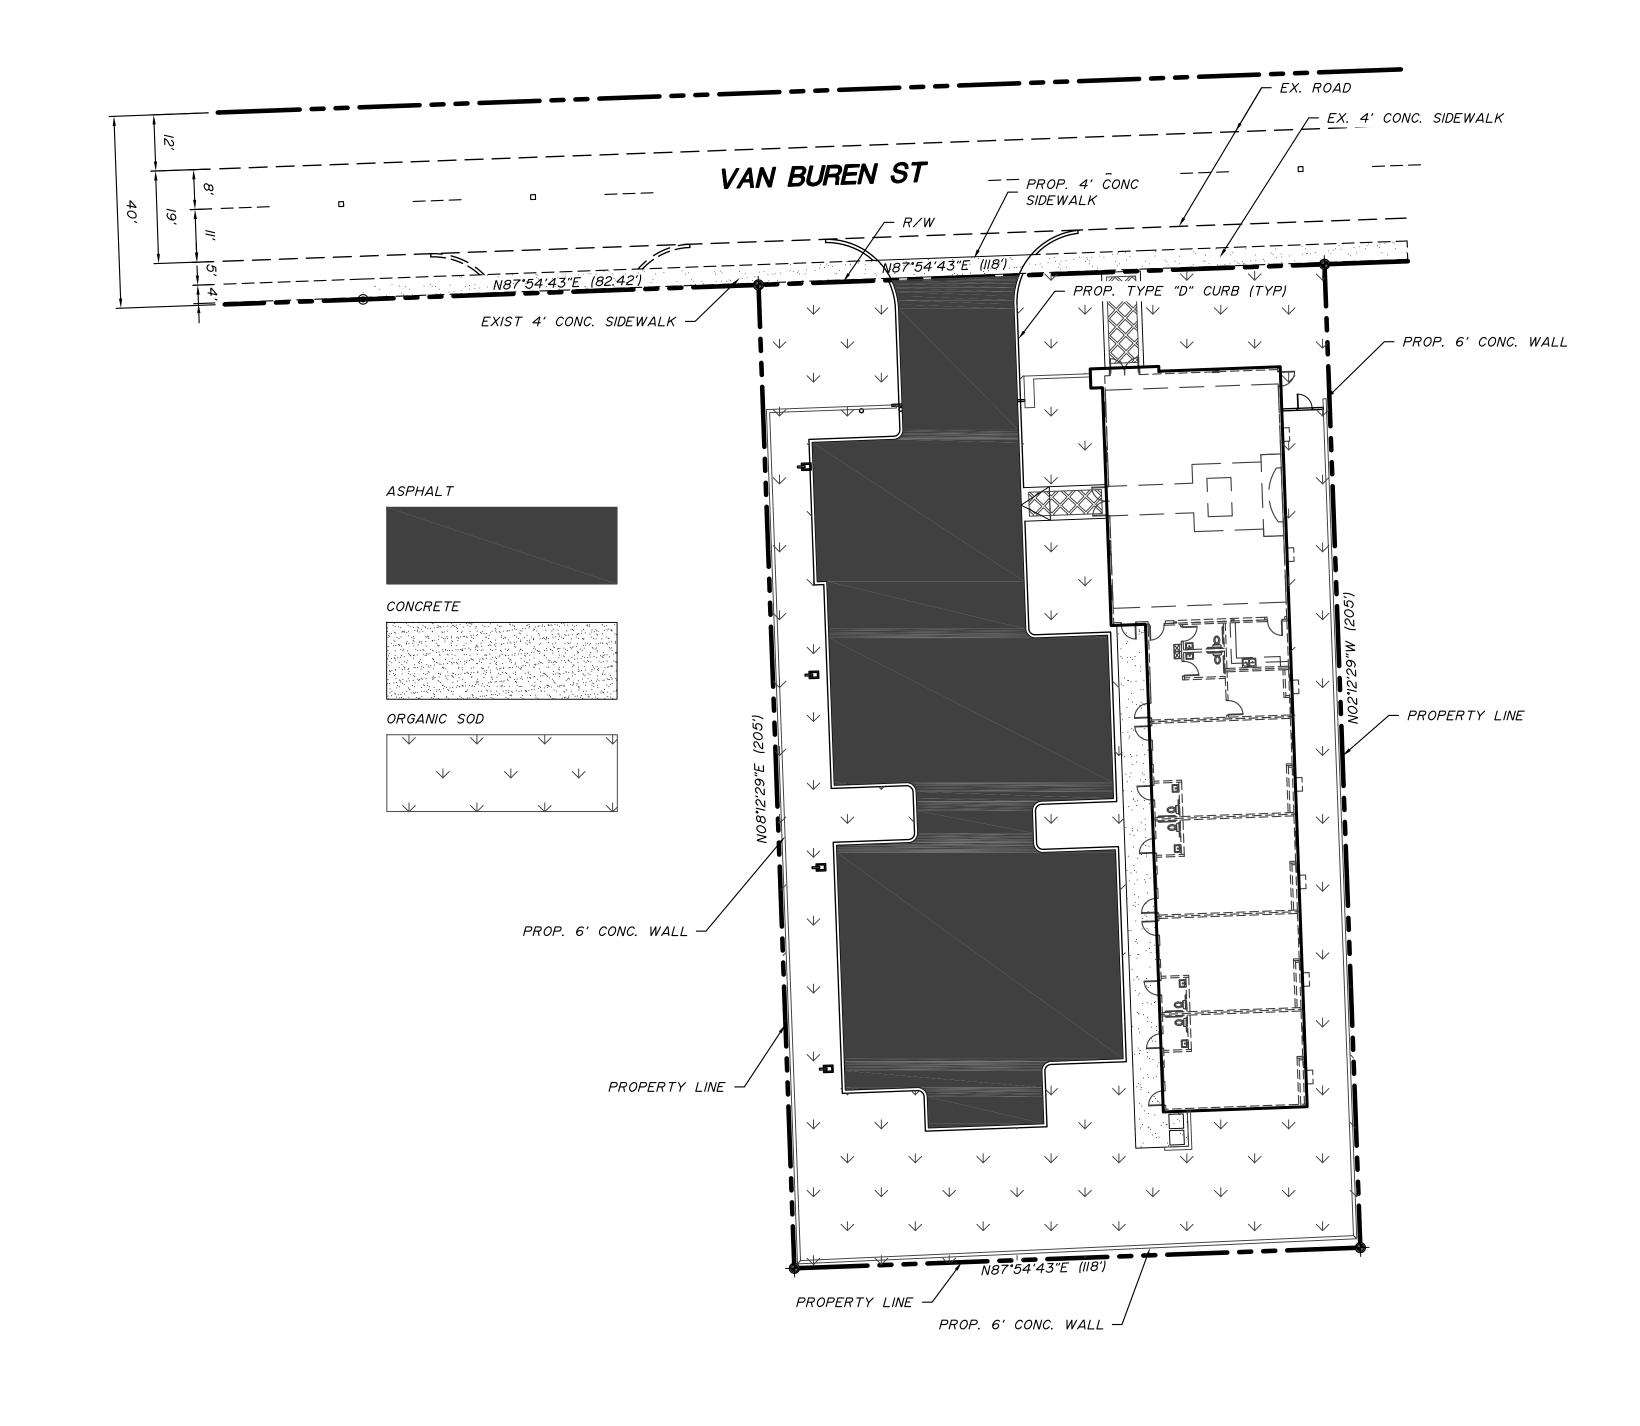



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								Drawn by: _	ADM	Date:	2/2015
<u>/i.</u>	5/27/2015	A.M.	REVISED PER CITY OF HOLLYWOOD COMMENTS					Checked by: _	CJB	Date	2/2015
NO.	DATE	BY	REVISION	NO.	DATE	BY	REVISION				




2737 Northeast 30th Place
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Authorization No. EB-26343
Authorization No. EB-26343


Engineer of Record: CARLOS J. BALLBE	PERVIOUS AND IMPERVIOUS BREAKOUT	Project Number: 201620
Registered Engineer Number: Date: 1/13/2017 State of Florida Date: 1/13/2017 41811	HOLLYWOOD DOWNTOWN SYNAGOGUE CIVICA, LLC	Sheet Number:

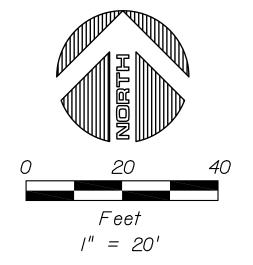

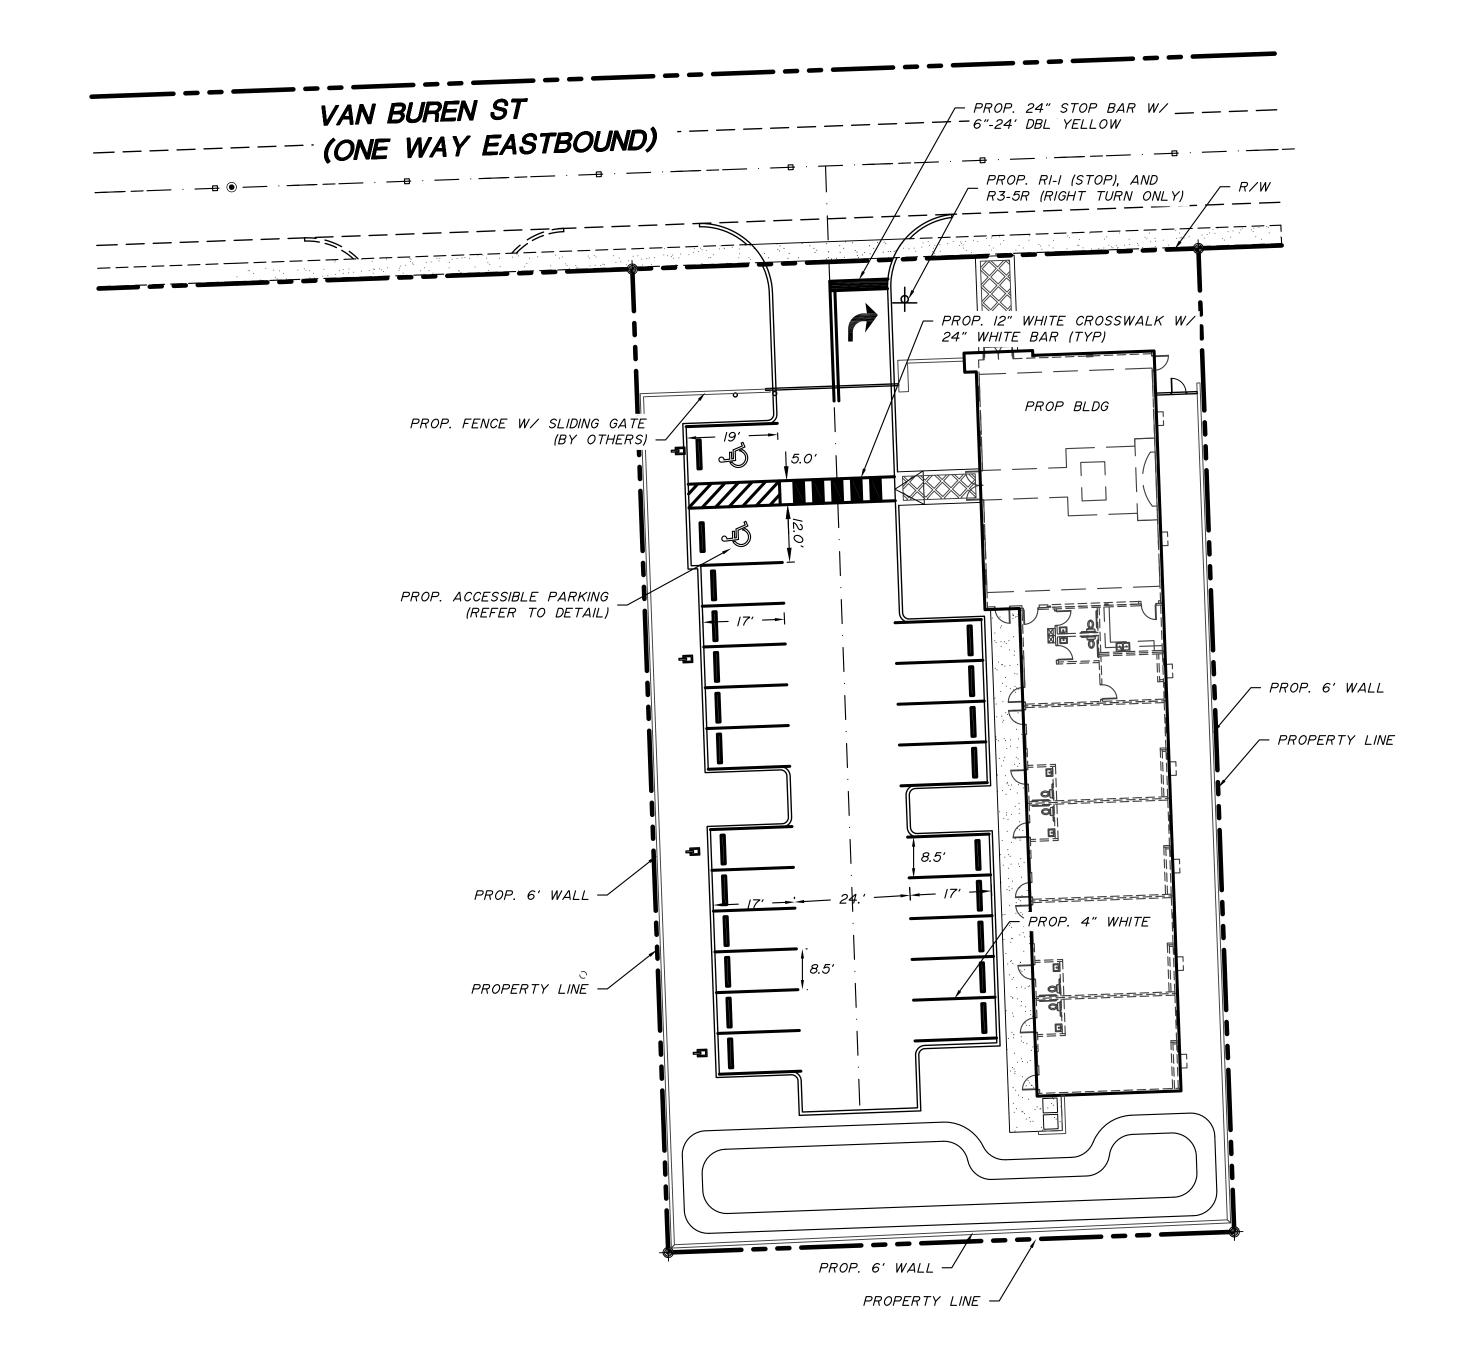

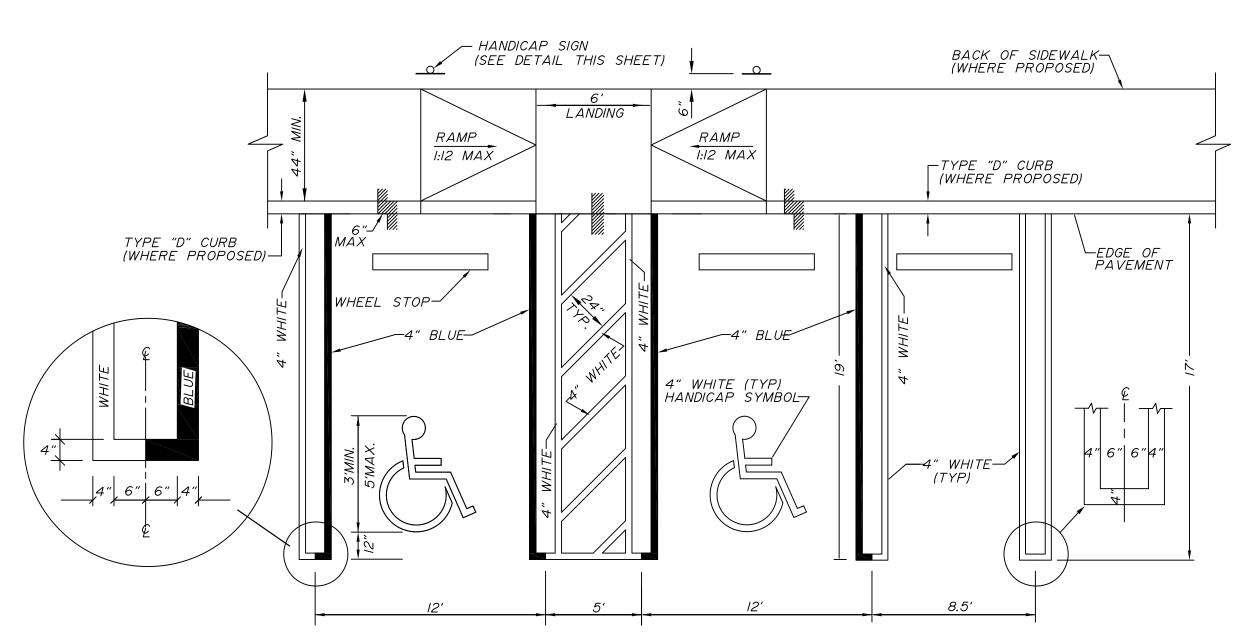

PARKING STALL - ACCESSIBLE & STANDARD

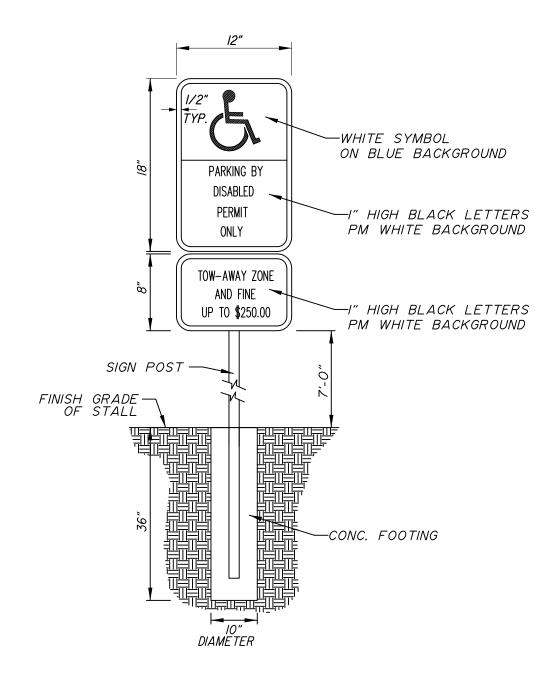

ACCESSIBLE PARKING SIGN


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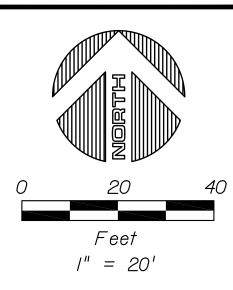
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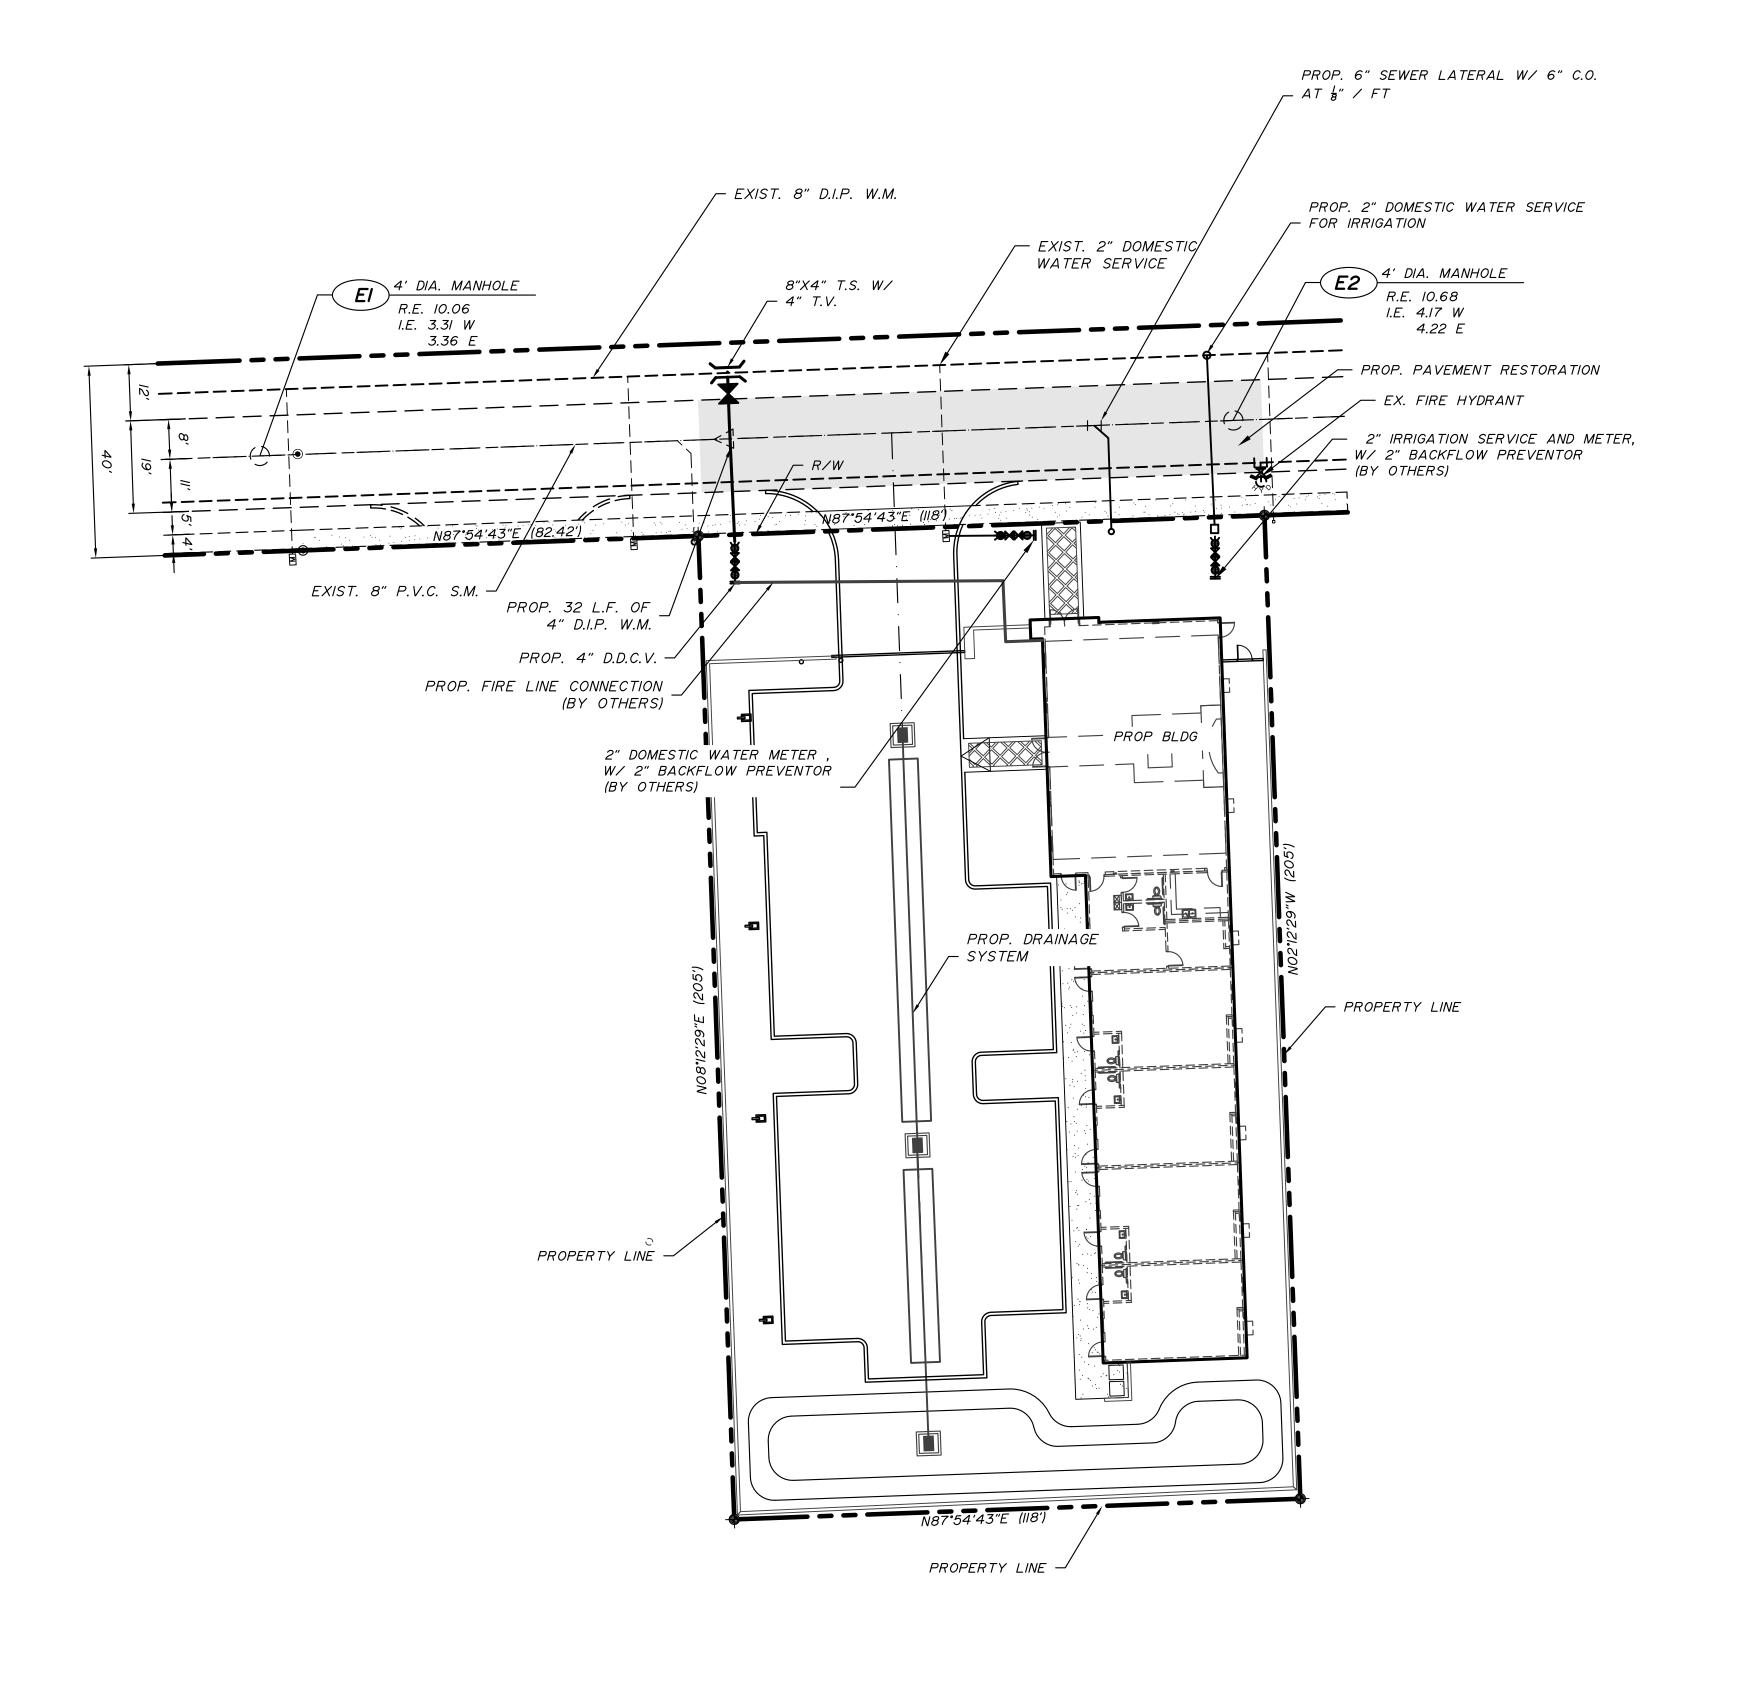


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2737 Northeast 30th Place
Fort Lauderdale, Florida 33306
Phone: (954) 491-7811
Authorization No. EB-26343

Engineer of Record: CARLOS J. BALLBE	PAVEMENT MARKINGS AND SIGNAGE PLAN	Project Number: 201620
Registered Engineer Number: State of Florida Date: 1/13/2017 4/8//	HOLLYWOOD DOWNTOWN SYNAGOGUE CIVICA, LLC	Sheet Number:





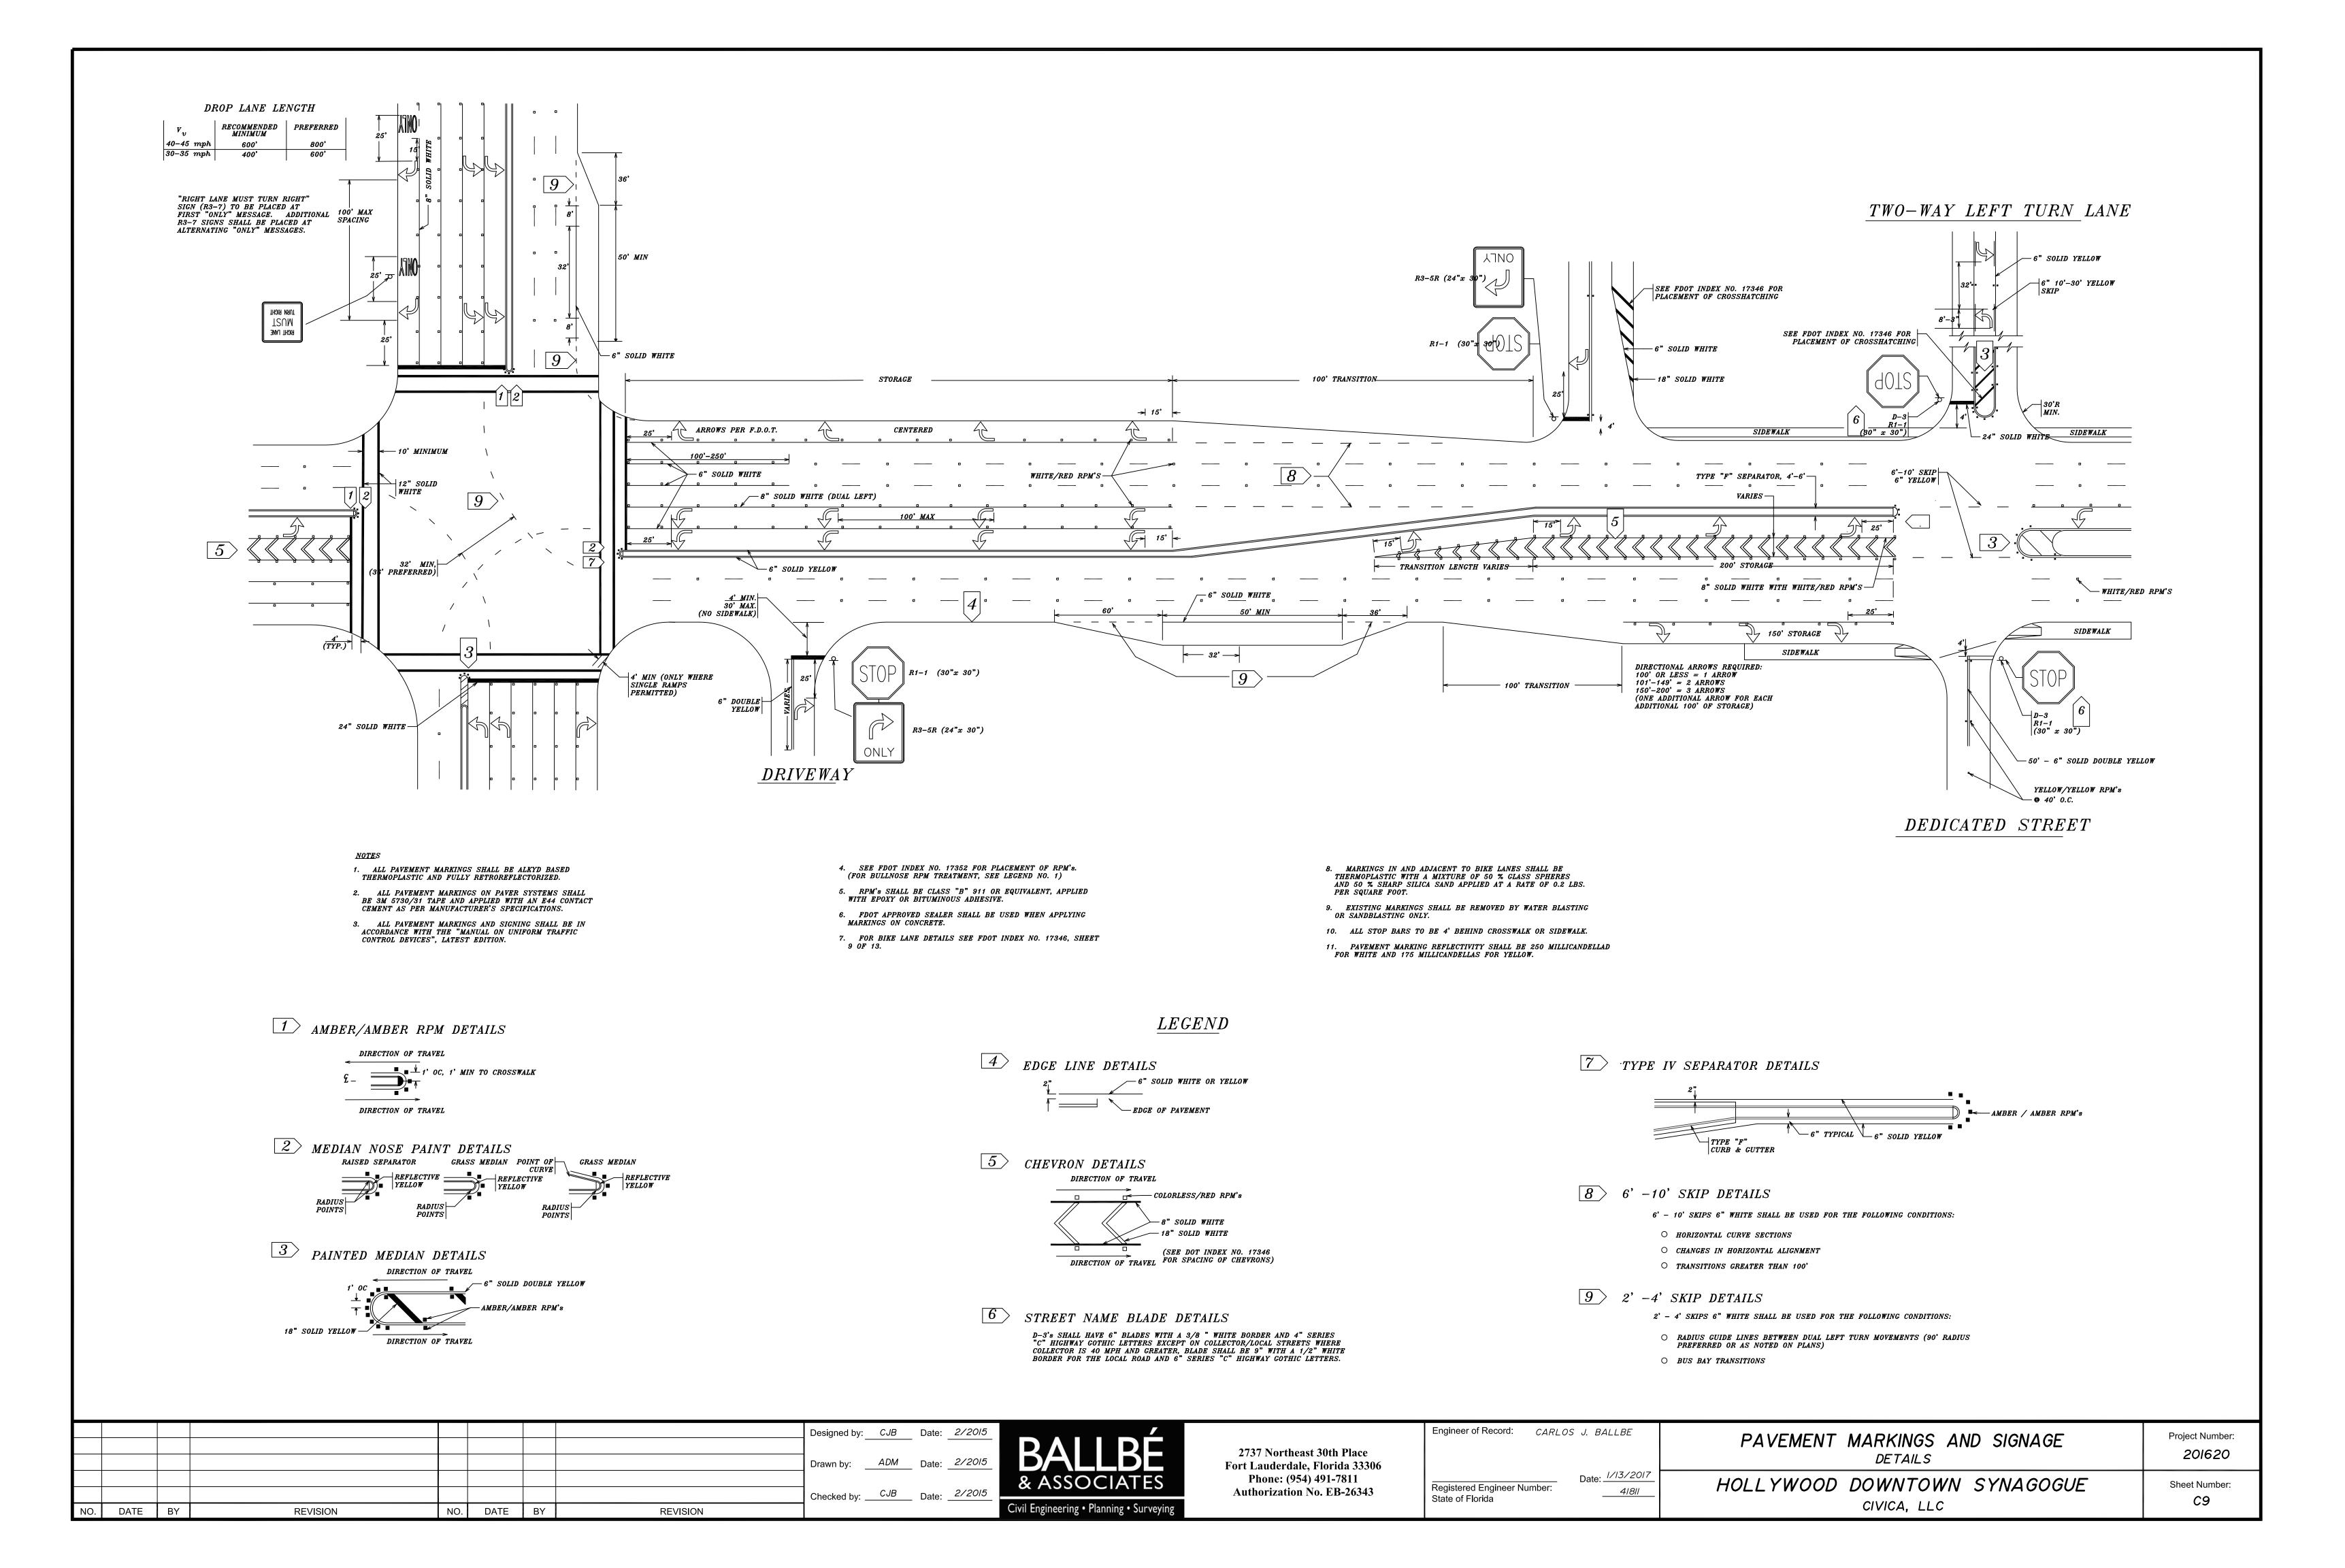


<u>NOTES:</u> 1. ELEVATIONS ARE BASED ON THE NORTH AMERICAN VERTICAL DATUM OF 1988 UNLESS OTHERWISE SHOWN


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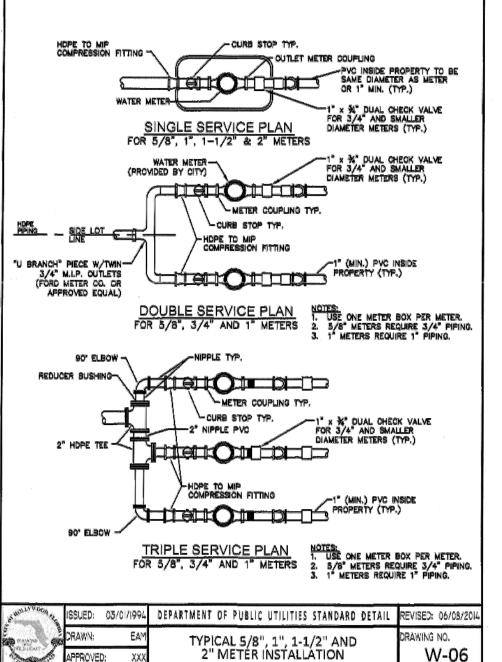



2737 Northeast 30th Place
Fort Lauderdale, Florida 33306
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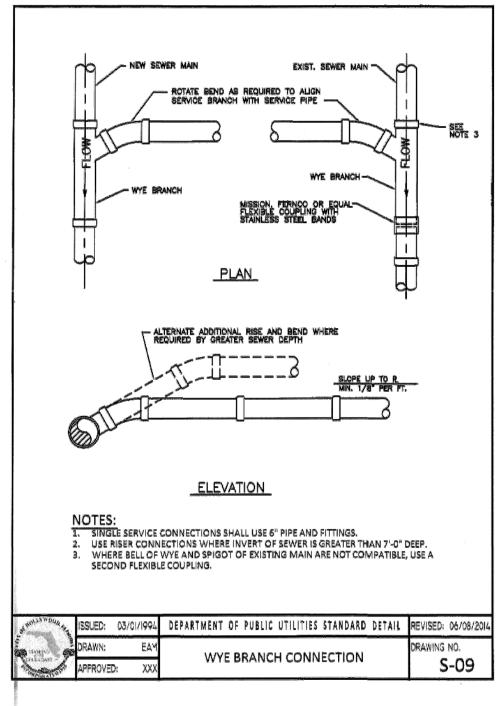
Engineer of Record: CARLOS J. BALLBE	WATER AND SEWER PLAN	Project Number: 201620
Registered Engineer Number: State of Florida Date: 1/13/2017 4/8//	HOLLYWOOD DOWNTOWN SYNAGOGUE CIVICA, LLC	Sheet Number:







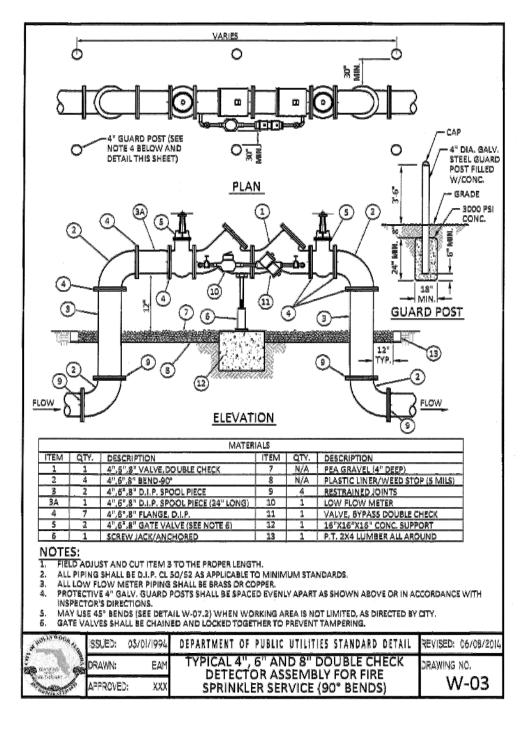


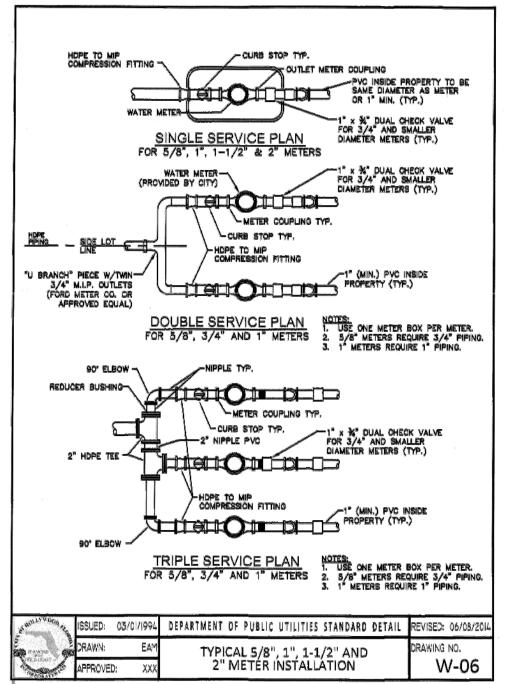


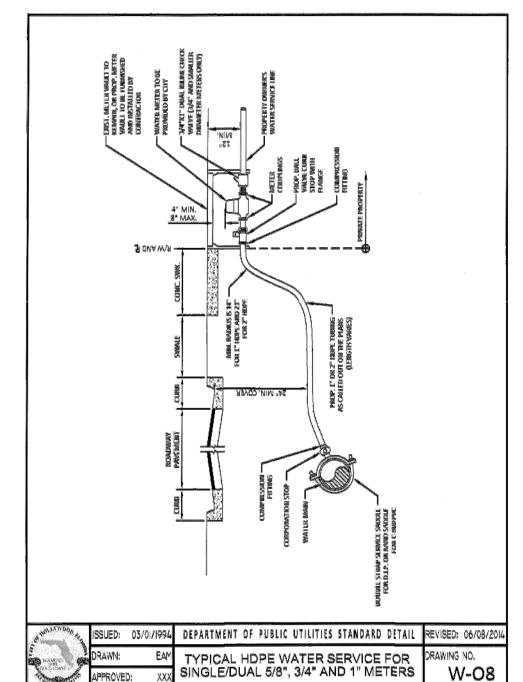

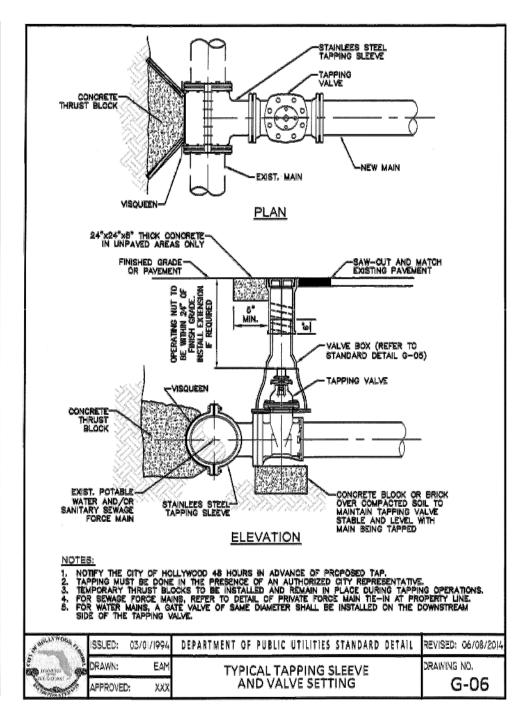

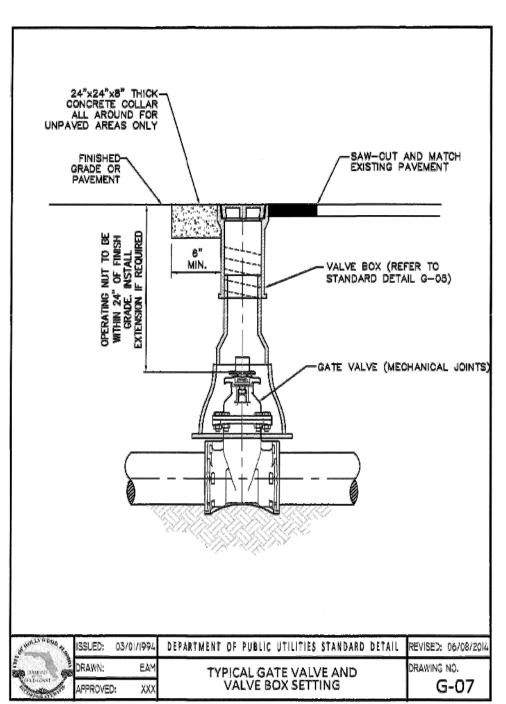

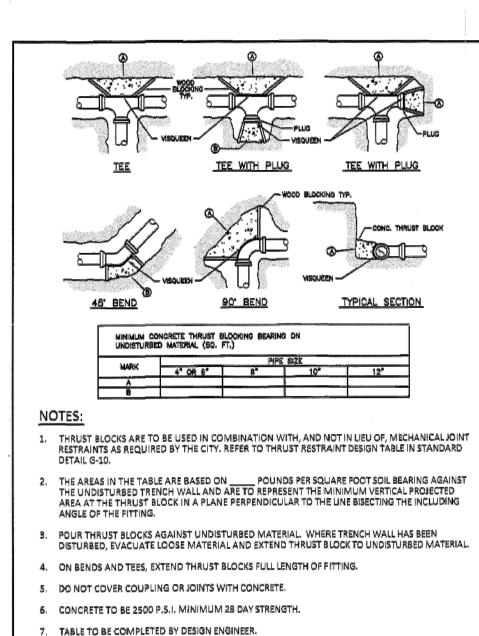

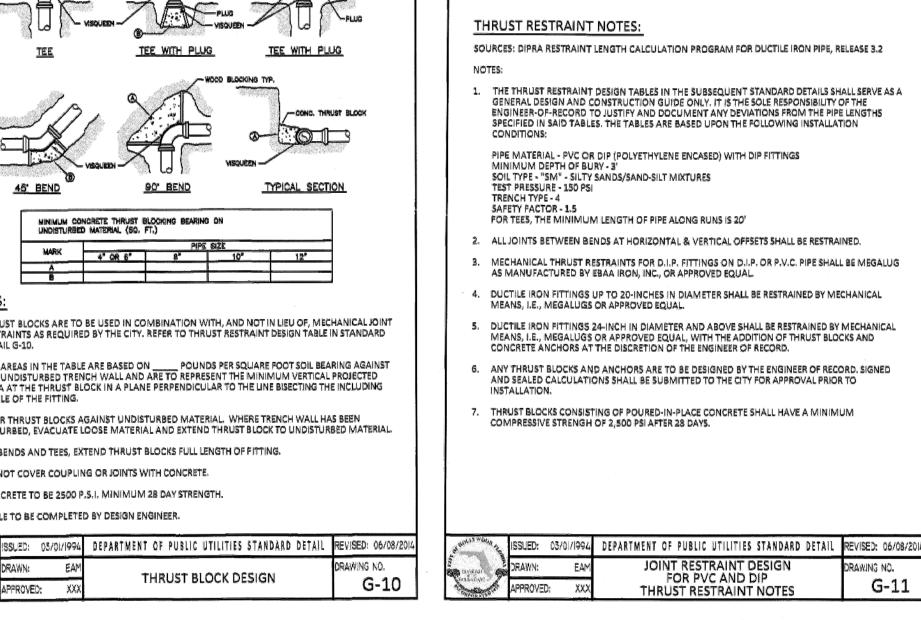

WATER METER SERVICE NOTES:

SHALL BE SMALLER THAN 1" DIAMETER.

THE EXISTING BALL VALVE CURB STOP.

ISSUED: 03/01/1994

MINIMUM UNLESS OTHERWISE DIRECTED BY THE CITY.

12. APPROVED TYPE COPPER TUBING MAY BE USED AT THE CITY'S DISCRETION.

SUCCESSIVE TAPS INTO THE WATER MAIN SHALL BE SPACED NOT LESS THAN 18" ON CENTER. P.E. TUBING SHALL BE IN ACCORDANCE WITH AWWA STANDARD C901, "POLYETHYLENE (PE)

PRESSURE PIPE AND TUBING, 1/2 IN. (13mm) THROUGH 3 IN. (76 mm), FOR WATER SERVICE".

SERVICE PIPE SHALL BE THE SAME SIZE AS THE WATER METER EXCEPT THAT NO SERVICE PIPE

SERVICE PIPE CROSSING UNDER THE ENTIRE WIDTH OF A ROADWAY PAVEMENT MUST BE 2"

11. THE 3" CASING UNDER THE ROAD IS TO BE USED ONLY WHEN THE WATER MAIN RUNS WITHIN THE SWALE ON THE OPPOSITE SIDE OF THE ROAD FROM THE METER SERVICE. ALL CASING PIPE SHALL EXTEND A MINIMUM OF 2' BEYOND THE EDGE OF PAVED STREETS.

13. FOR NEW METER INSTALLATIONS, ALL SADDLES, VALVES, PIPING, FITTINGS, CURB STOPS, METER

14. THE WATER METERS WILL BE PROVIDED BY THE CITY OF HOLLYWOOD AND INSTALLED BY THE

15. FOR EXISTING METERS ABUTTING THE RIGHT-OF-WAY THAT ARE BEING DISCONNECTED FROM EXISTING MAINS AND RECONNECTED TO NEW MAINS, THE CONTRACTOR SHALL:

a. CUT AND PLUG THE EXISTING SERVICE LINE AT THE MAIN AND AT THE METER, AND REMOVE

b. FURNISH AND INSTALL SERVICE SADDLE, CORPORATION STOP OR SERVICE VALVE AND VALVE BOX, PIPING AND FITTINGS UP TO AND INCLUDING THE BALL VALVE CURB STOP. THE ELEVATION AT THE TOP OF THE METER BOX SHALL MATCH THE ELEVATION OF THE BACK OF

AS PART OF THE SERVICE INSTALLATION, THE CONTRACTOR SHALL RESTORE THE RIGHT-OF-WAY

TO MATCH EXISTING CONDITIONS, INCLUDING ROADWAY PAVEMENT, PAVEMENT MARKINGS AND RPMs, CONCRETE CURBS, SIDEWALKS, RAMPS (INCLUDING DETECTABLE WARNING

SURFACE), SODDING, AND ALL OTHER IMPROVEMENTS REMOVED OR DAMAGED DURING THE


DEPARTMENT OF PUBLIC UTILITIES STANDARD DETAIL REVISED: 06/08/20


WATER METER SERVICE NOTES FOR


5/8" THROUGH 2" METERS

10. FOR UNPAYED AREAS, THE MINIMUM GROUND COVER ACCEPTED BY THE CITY IS SODDING.

VALVES, METER COUPLINGS, METER VAULTS AND COVERS SHALL BE FURNISHED AND INSTALLED

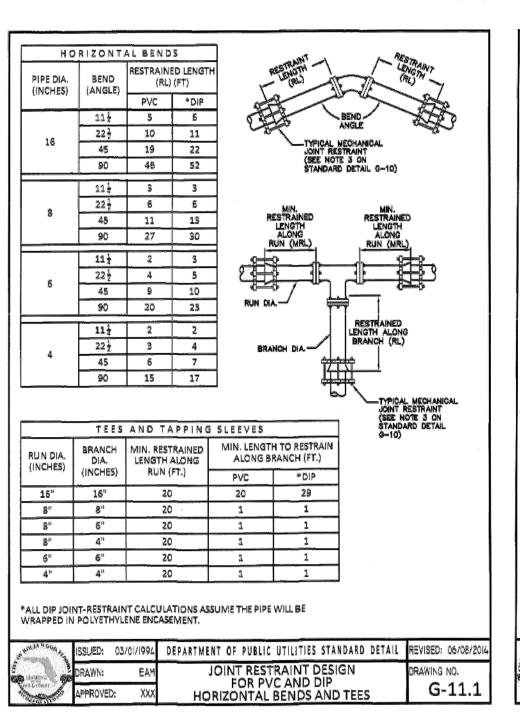

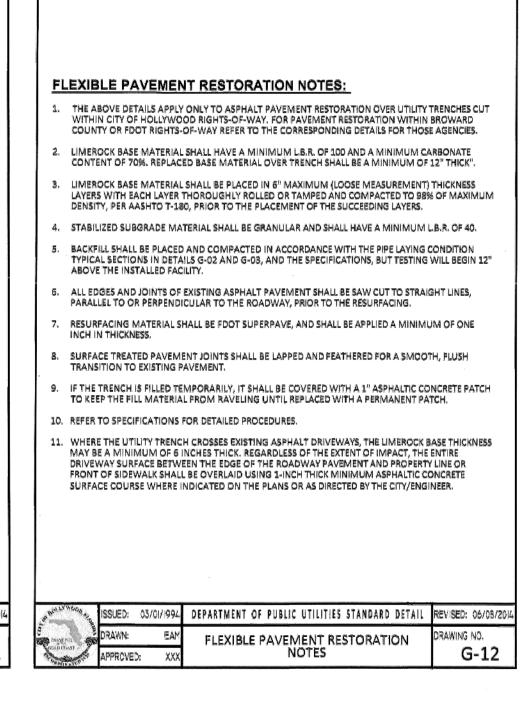

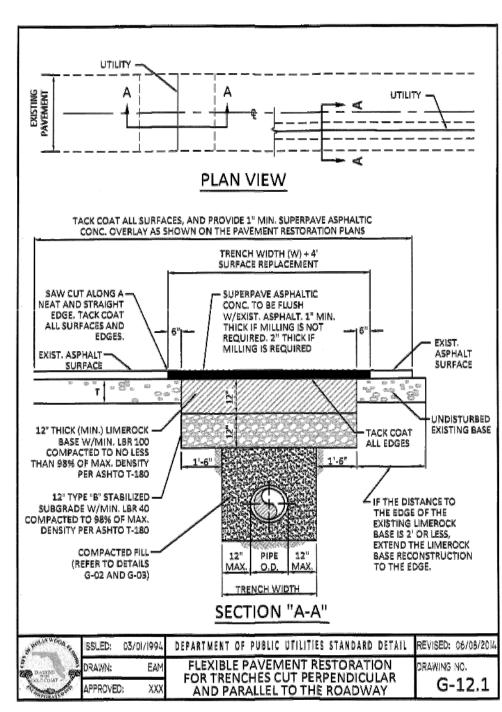


Project Number:

Sheet Number:

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201620



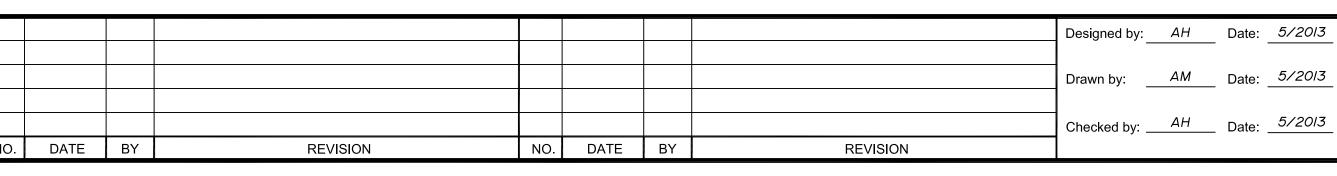

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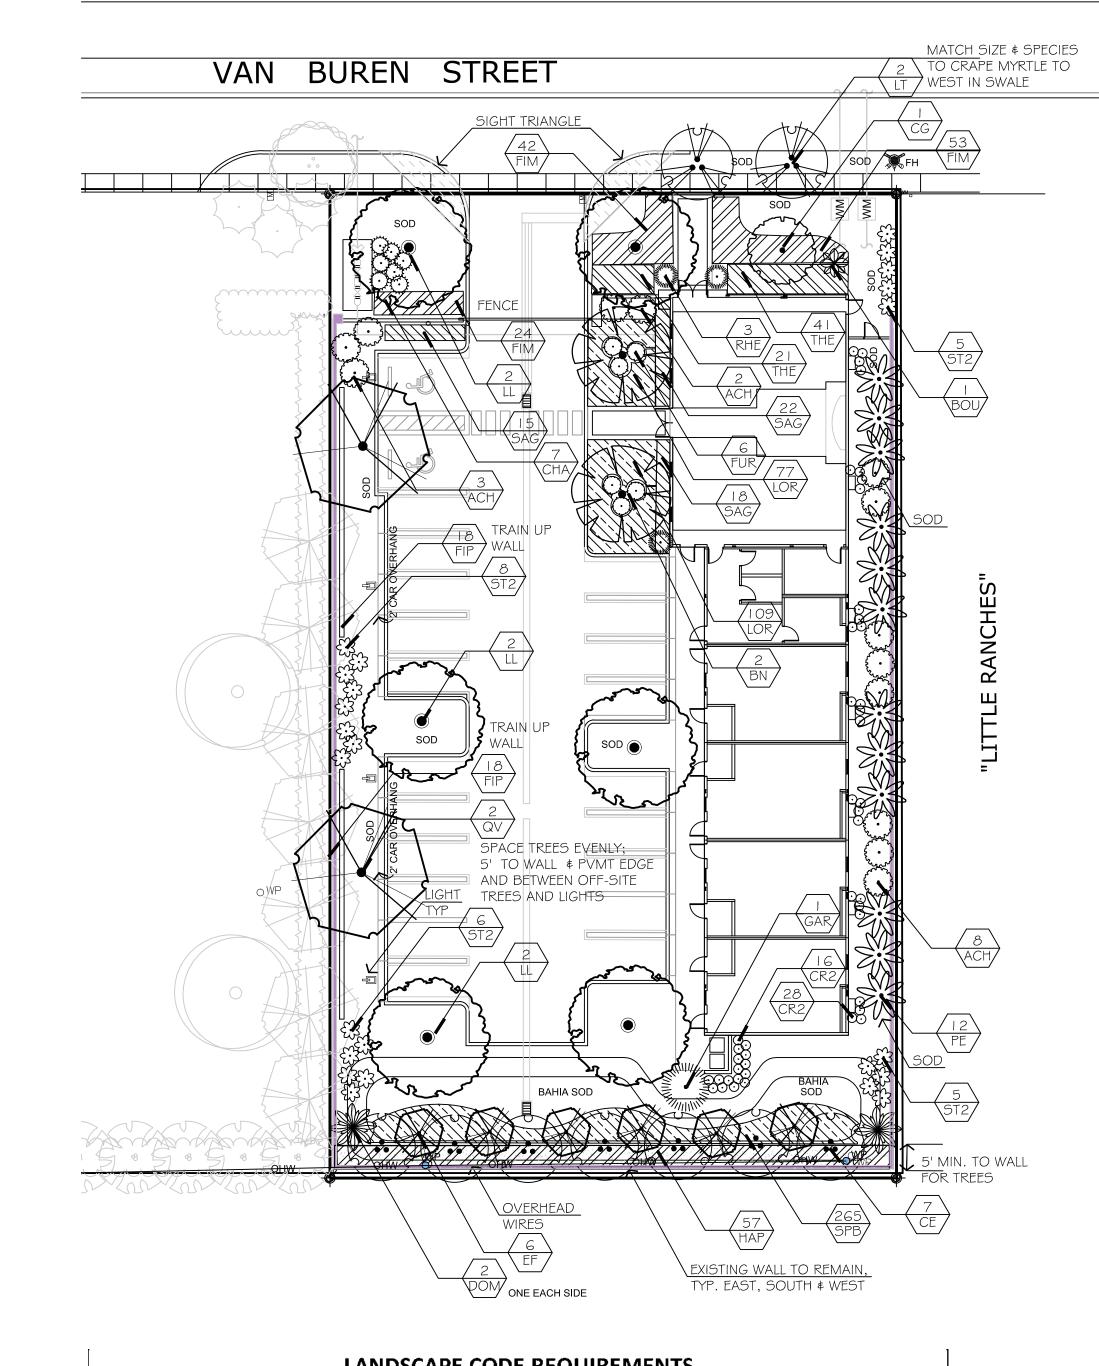
2737 Northeast 30th Place Fort Lauderdale, Florida 33306 Phone: (954) 491-7811 **Authorization No. EB-26343**

Engineer of Record: CARLOS J. BAL	LBÉ	WATER AND SEWER SYSTEM DETAILS
Registered Engineer Number: State of Florida Date: 1/2	41811	HOLLYWOOD DOWNTOWN SYNAGOGUE


PLANT SCHEDULE

	ILANI JOH		_					
	TREES	CODE	<u>aty</u>	BOTANICAL NAME	COMMON NAME	<u>SIZE</u>	<u>COMMENTS</u>	<u>NATIVE</u>
_	{· }	CG	I	Caesalpinia granadillo	Bridal Veil Tree	12' min., 2" cal,	Full symmetrical heads	Moderate Water Needs
?		CE	7	Conocarpus erectus Sericeus	Silver Buttonwood	12' oah, min.	Multi-trunk	Native \$ Drought Tolerant
		EF	6	Eugenia foetida	Spanish Stopper	12' oah	2" standard	Native \$ Drought Tolerant
7		LT	2	Lagerstroemia x 'Tuscarora'	Crape Myrtle Coral Pink	12' oah, min.	Multi-trunk, full	Drought Tolerant
	(·)	LL	6	Lysiloma latisiliqua	Wild Tamarind	12' high, 5' spr	3" caliper	Native \$ Drought Tolerant
		QV	2	Quercus virginiana	Live Oak	2.5" cal., 5' spr. min.	14' - 16' oah	Native & Drought Tolerant
	PALM TREES	CODE	QTY	BOTANICAL NAME	COMMON NAME	SIZE	<u>COMMENTS</u>	<u>NATIVE</u>
		BN	2	Bismarckia nobilis 'Silver'	Silver Bismarck Palm	12' <i>oa</i> h	Straight trunk, intact branches	Drought Tolerant
Si	B	PE	12	Ptychosperma elegans	Alexander Palm	16' \$ 18' oah	Place on angle away from bldg	Drought Tolerant
Ü	SHRUBS	CODE	<u>aty</u>	BOTANICAL NAME	COMMON NAME	<u>SPACING</u>	<u>COMMENTS</u>	<u>NATI√E</u>
	Every Services	ACH	13	Acalypha hispida	Chenille Plant	As Shown	7 gal, 36" full	Drought Tolerant
		B <i>0</i> U	I	Bougainvillea hybrid	Purple Bougainvillea	4' oah, staked	w/trellis, train up wall/fence	Drought Tolerant
		CHA	7	Chamaedorea cataractarum	Cat Palm	7 gal	4' × 4' Full	Drought Tolerant
	\odot	CR2	44	Chrysobalanus icaco 'Redtip'	Red Tip Cocoplum	3 gal	24" ht.x 20" spr.,2' oc.	
		DOM	2	Dombeya × seminole	Pink Dombeya	15 gal	4' × 4' Full	Moderate Water neds
	\odot	FUR	6	Furcraea foetida	Giant False Agave	7 gal	As shown	Drought Tolerant
		GAR	I	Gardenia jasminoides 'Miami Supreme'	Gardenia	15 gal	Grafted, Full	Moderate Water Needs
	ANNUM STATE OF THE	RHE	3	Rhapis excelsa	Lady Palm	As Shown	4' oah	Drought Tolerant
		ST2	24	Strelitzia reginae	Orange Bird of Paradise	7 gal, 3' - 4' oah	6 stem minimum	Native & Drought Tolerant
	SHRUB AREAS	CODE	<u>aty</u>	BOTANICAL NAME	COMMON NAME	<u>SPACING</u>	<u>COMMENTS</u>	FIELD3
		FIM	119	Ficus microcarpa 'Green Island'	Green Island Ficus	3 gal	10" × 10" staggered 24" oc	Drought Tolerant
		HAP	57	Hamelia patens 'Compacta'	Dwarf Fire Bush	7 gal	42" X 30", 3' oc staggered	Native & Depression Areas
		LOR	186	Loropetalum chinese rubrum Razzleberri	Razzleberri	3 gal	10" X 10" Stag. 20" oc	Drought Tolerant
		SAG	52	Schefflera arboricola	Dwarf Green Arboricola	3 gal	20" × 20" staggered 2' oc	Drought Tolerant
		SPB	265	Spartina bakeri	Sand Cord Grass	l gal	9" X 9" stag 18" oc	Native & Depression Areas
		THE	62	Thunbergia erecta	King's Mantle	3 gal	20" × 20" staggered 2' oc	Moderate Water Needs

SOD TO BE ST. AUGUSTINE 'FLORTAM' UNLESS NOTED OTHERWISE



Requirement	L.F or Number	-	Quan. Prov'd	Req'd	Prov'd	Comments
WOOD SYNAGOGUE- RM18 ZO	ONE					
OPEN SPACE						
Pervious Area						
1 Tree/1,000 Square Feet	9,676	10	10			Includes all pervious area within property.
		10	10			Subtotal Trees
PERIMETER BUFFER						
Perimeter Landscape (East)	205					Active Court
1 Tree @ 1/50 L.F.		4	3			Limited Area; see Note #1 below
1 shrub or vine /10 L.F with wall		21	17			Existing 6' high wall on site
Perimeter Landscape (South)	118					Residential Use
1 Tree @ 1/20 L.F.		6	13			Overhead Wires; see Note #2 & #3 below
1 shrub or vine /10 L.F with wall		12	58			Existing 6' high wall on site
Perimeter Landscape (West)	205					Parking Lot - similar use
1 Tree @ 1/50 L.F.		4	4			Limited Area; see Note #2 below
1 shrub or vine /10 L.F with wall		21	43			Existing 6' high wall on site
Perimeter Landscape (North)	118					Residential Use
1 Tree @ 1/50 L.F.		3	3			Van Buren Street
Shrubs @ 1/2 L.F.		59	60			
		17	23			Subtotal Trees
		113	178			Subtotal Shrubs or Vines
TOTAL TREES		27	33			Includes 20 trees & 12 Palms @ 3:1
TOTAL SHRUBS		113	261			
Native Requirement						
Trees @ 60%	27	16	21			Native Trees
Shrubs @ 50%	113	57	101			Native Shrubs
1. Palms provided at 3:1 for limited pla	anting are:	a.				
			es, some	tree heis	ghts have	been reduced to meet the requirements of
the 'Right Tree in the Right Place'.	= 0 (())	aa iii k	20) 301110		5. 165 TIQ VC	. waster surveyer to imperious requirements of

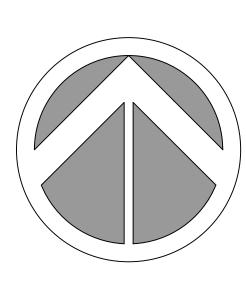

SCALE: 1" = 20'



ARCHITECTURE & URBAN DESIGN

8323 NW 12th Street Suite No.106 Doral, FL 33126 tel: 305.593.9959 fax: 305.5939855

AA #26001093

PROJECT:

HOLLYWOOD DOWNTOWN SYNAGOGUE

2726 VAN BUREN ST. HOLLYWOOD, FL 33020

> APPLICANT: Hollywood Downtown Synagogue

1041 N.E. 176th Terrace North Miami Beach, FL 33162

ISSUED FOR:

CITY of HOLLYWOOD ZONING DEPT

CIVICA PROJECT No:

150108

No.	DATE	REVISION	BY	
1	12.14.16	PER CITY	JBC	

DRAWN BY APPROVED BY

DATE SCALE: AS SHOWN



planning & design planning, landscape architecture & sustainable design

SEAL/SIGNATURE



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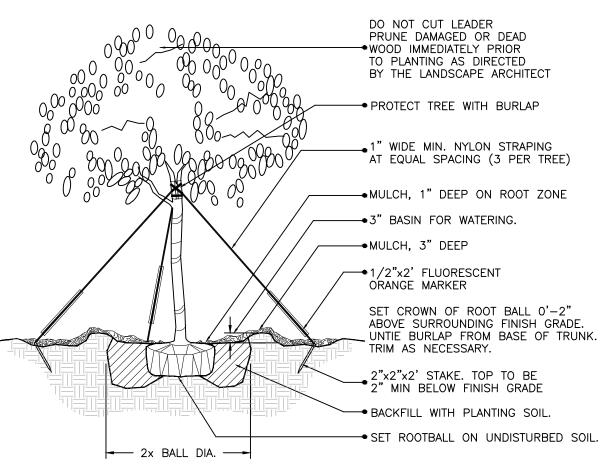
SHEET TITLE

LANDSCAPE PLAN


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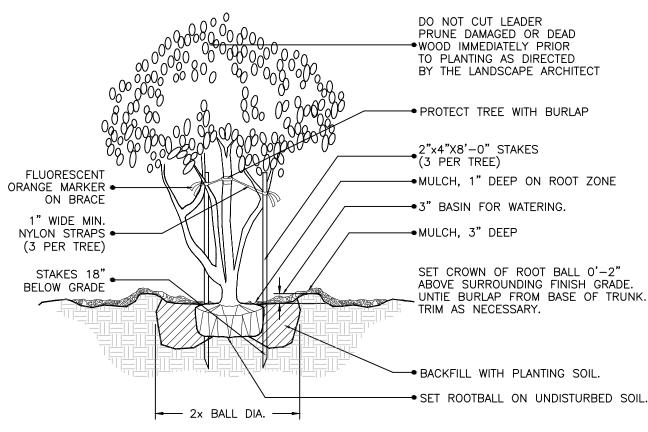
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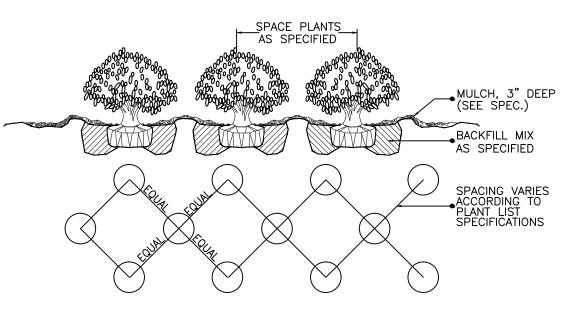
(2" cal. and over) LARGE TREE PLANTING DETAIL




(2" cal. and under) SMALL TREE PLANTING DETAIL




MULTI- TRUNK AND SMALL TREE (2" cal. and under) PLANTING DETAIL

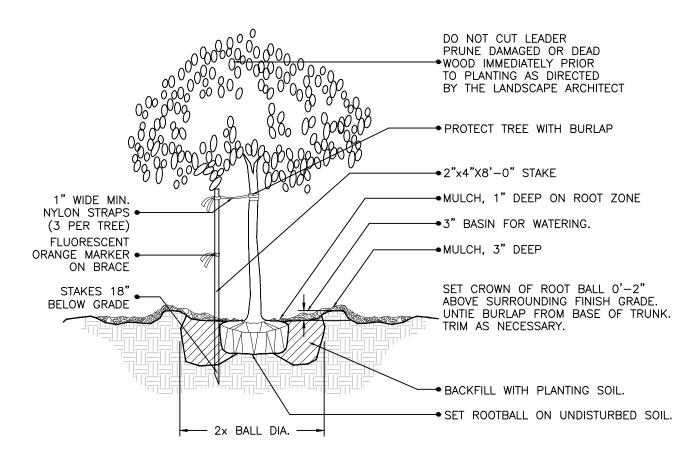


SHRUB / GROUNDCOVER SPACING / PLANTING DETAIL

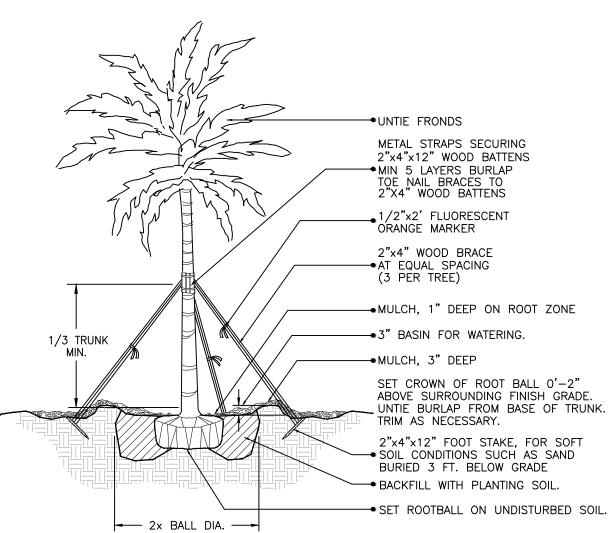


LARGE PALM PLANTING DETAIL

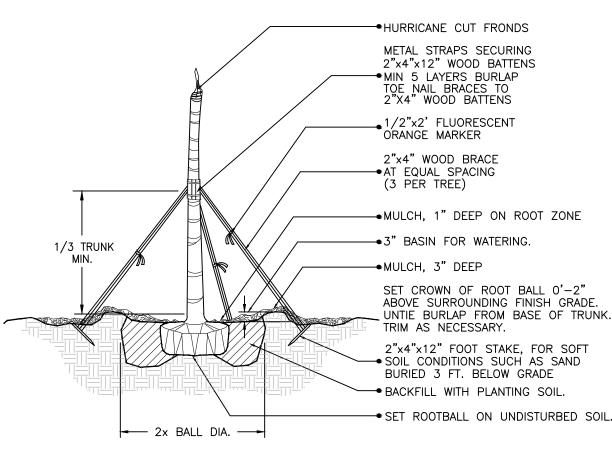

CIGARED SABAL PALM PLANTING DETAIL

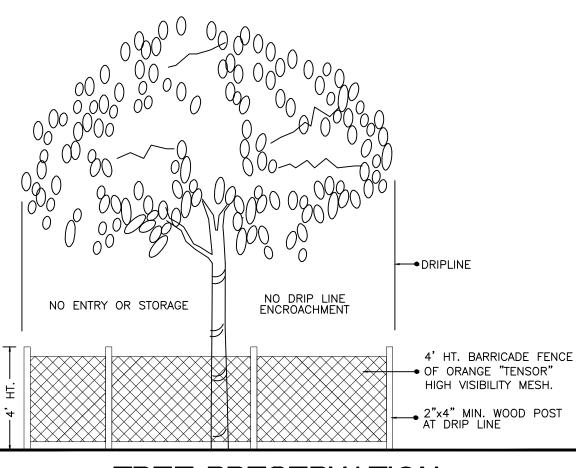

TREE PRESERVATION
BARRICADE FENCING DETAIL

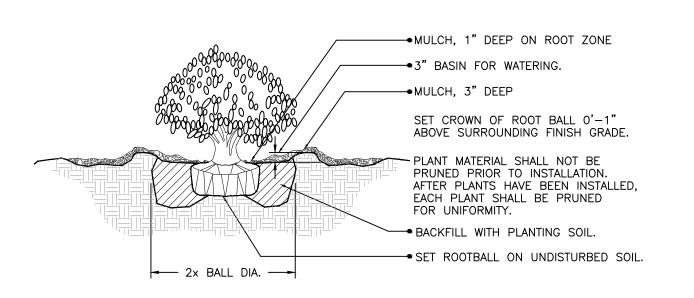

SHRUB PLANTING DETAIL

GENERAL NOTES:

to receive planting soil as per details.

1. PLANT MATERIAL: All plant material shall be Florida #1 or better as established by "Grades and Standards for Nursery Plants" of the state of Florida, Department of Agriculture.

2. All trees, shrubs and groundcovers shall be of the sizes as specified in the Plant List.

3. Quantities listed on the the Plant List are for estimating purposes. Contractor shall verify all quantities. Mulch, topsoil, fertilizer, etc. shall be included in the unit cost of the plants.

4. Where there is a discrepancy either in quantities, plant names, sizes or specifications between the plan or plant list, the plan takes precedence.

5. All planting beds and water basins for trees shall be covered with a 3" minimum depth of shredded eucalyptus or florimulch grade 'B' or better.

6. The Planting Plan shall be installed in compliance with all existing codes and applicable deed restrictions.

7. SOD: All areas not used for buildings, vehicular use areas, walks or planting beds shall be grassed. Grassing shall extend to any abutting street pavement edge and to the mean waterline of any abutting canal, lake or waterway.

8. PLANTING SOIL: All trees and shrubs shall be planted with a minimum of 12" topsoil around and beneath the rootball. Minimum topsoil shall be 6" for groundcover areas and 2" for sodded grass areas.

9. Planting soil to be a weed-free mixture of 50% sand, 40% muck, and 10% Canadian peat. All plant material

10. Contractor is responsible for determining all utility locations and installing facilities so as to not conflict. All damage to existing utilities or improvements caused by Contractor shall be repaired at no additional cost to the Owner.

11. Contractor to notify "Sunshine State One Call of Florida, Inc." at 1-800-432-4770 Two Full Business Days prior to digging for underground utility locations.

12. Contractor shall be responsible for providing final grading of all associated planting areas.

13. After final grade, area to be raked to 6" depth and all rock and foreign inorganic materials removed and

aisposed of properly off-site.

14. All planting holes to be hand dug except where machine dug holes will not adversely affect or damage

utilities or improvements (see note 8).

15. No plunging of any tree or palm will be accepted. All plants to be planted at the nursery grade or slightly higher.

16. Contractor shall stake \$ guy all trees and palms at time of planting as per the appropriate detail.

Contractor is responsible for the maintenance and/or repair of all staking and guying during warranty period and removal \$ disposal of staking after establishment period.

17. Fertilizer for grass areas shall be NPK 16-4-8 @ 12.5 lbs/1000 s.f. or 545 lbs/acre. Nitrogen 50% slow release form & fertilizer to include secondary micronutrients.

18. SUBSTITUTIONS AND CHANGES: All substitutions and changes shall be approved in writing prior to installation. Any discrepancies between plans, site and specifications shall be brought to the immediate attention of the Landscape Architect, the owner and governing municipality.

19. WATERING: All plant material shall be watered in at time of planting in accordance with standard nursery practices. In addition, Contractor will continue watering of plant material until substantial completion and as

needed thereafter for a period of 2 months.

20. All new plant material shall be guaranteed for I year from time of final acceptance of project. Any plant material not in a healthy growing condition will be replaced by the Contractor at no additional cost to the Owner within 10 days of notification. For all replacement plant material, the warranty period shall be extended

winds less than 75 mph, will be re-set and braced by the Contractor at no additional cost to the Owner.

21. The successful bidder shall furnish to the Owner a unit price breakdown for all materials. The Owner may, at its discretion, add or delete from the materials utilizing the unit price breakdown submitted.

an additional 45 days beyond the original warranty period. All trees that lean or are blown over, caused by

22. No plant material will be accepted showing evidence of cable, chain marks, equipment scars, or otherwise

23. Plant material will not be accepted when the ball of earth surrounding its roots has been cracked, broken

or otherwise damaged.

24. Root-prune all trees a minimum of (8) weeks prior to planting.

25. All landscaped areas will be irrigated by an underground, automatic, rust-free irrigation system providing 100% coverage and 100% spray overlap. The system shall be maintained in good working order and designed to minimize water on impervious services and not overspray walkways. A rain sensor device shall be installed to override the irrigation cycle of the system when adequate rainfall has occurred.

26. All plant material planted within the sight distance triangle areas (see plan) shall provide unobstructed cross-visibility at a horizontal level between 30 inches and 8 feet above adjacent street grade.

27. No canopy trees shall be planted within 12 feet of a light pole. No palm species shall be planted within 6 feet of a light pole.

28. Ground cover plantings shall provide not less than 50 percent coverage immediately upon planting and 100 percent coverage within 6 months after planting.

29. Tree protection barricades shall be provided by Landscape Contractor around existing trees that may be impacted by the proposed construction. Prior to any construction a tree protection barricade inspection shall be conducted by the landscape architect, owner or governing municipality. Refer to landscape detail for tree preservation barricade fencing.

30. In all pedestrian areas, all trees and palms shall be maintained to allow for clear passage at an 8 foot clear trunk

31. All landscape material shall be setback a minimum of 10' from any Fire Hydrant.

32. Sod to be installed in solid pieces, laid on min. 2" finely graded amended soil mix with staggered tight?

· 10"105.

C I V I C A

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APPLICANT:
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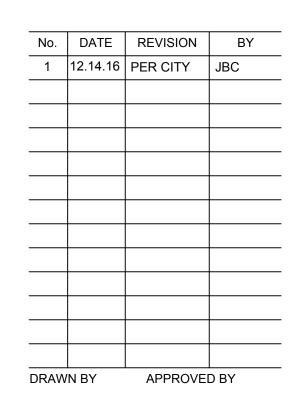
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DATE 2016


AS SHOWN

SCALE:

planning & design planning & design

planning, landscape architecture & sustainable design

Delle

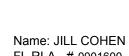

SEAL/SIGNATURE

Name: JILL COHEN
FL RLA - # 0001600

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SHEET TITLE

LANDSCAPE NOTES AND DETAILS

SHEET NUMBER
LP-2

