CITY OF HOLLYWOOD, FLORIDA DEPARTMENT OF DEVELOPMENT SERVICES PLANNING DIVISION

DATE: December 8, 2016

FILE: 16-DPV-56

TO:

Planning and Development Board

FROM:

Alexandra Carcamo, Principal Planner

SUBJECT:

Variances, Design, and Site Plan for an approximate 4,500 square foot retail space (The

Place at Hollywood - Phase V).

REQUEST:

Approval of Variances, Design, and Site Plan for an approximate 4,500 square foot retail space (The Place at Hollywood – Phase V).

Variance 1:

To increase the number of permitted monument signs from four to five.

RECOMMENDATION:

Variances:

Approval.

Design:

Approval, if Variances are granted.

Site Plan:

Approval, if Variances and Design are granted.

BACKGROUND

The subject site is currently vacant, generally located on the southeast corner of Hollywood Boulevard and State Road 7, the main commercial node of the State Road 7 Corridor. The current request contains sub-parcels which are part of a phased development totaling approximately 40 acres called the Place at Hollywood, which contains a Wal-Mart store, several retail uses, restaurants, and personal service facilities. The overall project which identified these sub-parcels for future development was approved by the Board on November 14, 2013. Phase II of this development was approved on July 9, 2015 which consisted of a Special Exception allowing a Service Station including a convenience store (RaceTrac). On December 10, 2015, Phase III was approved consisting of retail space serving as Junior Anchors to the overall development and on January 14, 2016, Phase IV was approved allowing additional retail and restaurant space.

REQUEST

At approximately 40 acres, the project is comprised of three parcels and proposes a phased development. Today, Palm Beach 2000, Inc. and Vestmaz, Inc. (the Applicant) requests Variances, Design, and Site Plan for an approximate 4,500 square foot retail space (The Place at Hollywood - Phase V) which will complete the Phased development as it is the only vacant parcel left for the overall site.

As proposed, the building design maintains overall cohesion with the plaza using similar architectural elements, treatments, and materials. Materials include glass, stucco, various stone veneers and architectural screens and louvers. Accentuated volumes and other architectural features highlight building

entrances, which are proposed to face the public right-of-way. The Applicant worked with Staff to ensure adequate vehicular and pedestrian circulation is provided. Safe pedestrian access is provided from the public sidewalk to building entrances and throughout the site.

The landscaping was designed with both beautification and function in mind and all landscape requirements have been met. The proposed landscape helps articulate the property and enhance the design of the building. A variety of native plants and trees are proposed to work in concert with the preserved on-site trees. Ample buffers are provided where required with a considerable amount of native trees, shrubs, and ground cover.

Due to the size, configuration, dual-frontage condition, and tenant mix of the proposed project, signage in excess of what is permitted by-right is necessary. Therefore, the Applicant is requesting a variance to increase the number of permitted monument signs from four to five in order to unify the existing sign plan and design which is proportionately appropriate and compatible with the design of the overall project. As this is a phased development, four signs were previously approved in Phase I, which allowed each retail/restaurant space to have a dedicated monument sign fronting each building in addition to the larger sign for the overall plaza. The current request is for the fifth monument sign which will serve to identify the proposed retail shop building fronting State Road 7; should each of these buildings be located on individual parcels, this variance would not be necessary. As such, Staff recommends approval.

SITE INFORMATION

Owner/Applicant: Palm Beach 2000, Inc. and Vestmaz, Inc.

Address/Location: 101 S. State Road 7

Net Area of Property: Overall 1,747,214 Sq. Ft. (Phase V - 28,120 Sq. Ft)

Land Use:Transit Oriented CorridorZoning:SR7 CCD-CC, C-2, C-3

Existing Use of Land: Vacant

ADJACENT LAND USE

North: Transit Oriented Corridor
South: Transit Oriented Corridor
Low Residential, Office
West: Transit Oriented Corridor

ADJACENT ZONING

North: Commercial Corridor District - Commercial Core Sub-Area, Medium Intensity Commercial

District, Medium/High Intensity Commercial District, (SR7 CCD-CC, C-3, C-4)

South: Single Family District, Commercial Corridor District - Commercial Core Sub-Area, Medium

Intensity Commercial District, Medium/High Intensity Commercial District, (RS-6, SR7 CCD-

CC, C-3, C-4)

East: Single Family District, Mixed Use Office District (RS-5, RS-6, OM)

West: Commercial Corridor District - Commercial Core Sub-Area, Medium Intensity Commercial

District, Medium/High Intensity Commercial District, (SR7 CCD-CC, C-3, C-4)

CONSISTENCY WITH THE COMPREHENSIVE PLAN

Located within the Transit Oriented Corridor, the project is surrounded by commercial, single family, and multi-family residential uses. The goal of the Land Use Element is to promote a distribution of land uses that will enhance and improve the residential, business, resort, and natural communities while allowing land owners to maximize the use of their property. Development of this site will increase the availability of commercial uses and expand the mixture of uses in the area; serving the adjacent community as well as the region.

Policy 2.2.11: Promote the development of US 441/SR 7 as a major transit corridor.

Policy 3.1.1: Continue to prioritize US 441/SR 7 Corridor for redevelopment opportunities and work with the Florida Department of Transportation and other applicable agencies on design of the highway, and create innovative zoning to implement future plans.

Policy 3.1.4: Promote land assembly along the US 441/SR 7 Corridor to create larger development parcels for economic sustainability to offset the physical and economic loss from Florida Department of Transportation right-of-way acquisition.

Policy 3.1.5: Provide increased buffering between businesses along the US 441/SR 7 Corridor and adjacent residential areas.

CONSISTENCY WITH THE CITY-WIDE MASTER PLAN

The City-Wide Master Plan is a compilation of policy priorities and recommendations designed to improve the appearance, appeal, and economic tax base of the City. It establishes a format for future direction and vision for the City.

The City-Wide Master Plan recognizes the need for a mix of uses along the corridors and identifies the US 441/SR 7 Corridor as a Special Emphasis Area of high importance for the development of the City and its improved image. The proposed project is consistent with the City-Wide Master Plan based upon the following:

Guiding Principles and Policies:

- Promote the highest and best use of land in each sector of the City without compromising the goals of the surrounding community.
- Attract and retain businesses that will increase economic opportunities for the City while enhancing the quality of life for residents.

Policy CW.21: Create and expand where appropriate commercial and industrial zones to increase tax dollars.

Policy CW.44: Foster economic development through creative land use, zoning and development regulations, City services and City policies.

Policy CW.46: Place emphasis on redevelopment along the major highway corridors; SR 7, US 1, Dixie Highway, Hollywood Boulevard and A-1-A by limiting expansion of residential areas, and deepening industrial and commercial zones to increase tax revenues.

APPLICABLE CRITERIA

Analysis of Criteria and Findings for Sign Variances as stated in the City of Hollywood's Zoning and Land Development Regulations Article 5.

Variance 1: To increase the number of permitted monument signs from four to five.

CRITERIA 1: The variance is not contrary to the public interest.

ANALYSIS: The Variance request is to increase the number of permitted monument signs

from four to five. Four signs were previously approved in Phase I of the phased development. The current request is for the fifth monument sign which will serve to identify the proposed retail shops fronting State Road 7. Should each of these buildings be located on individual parcels, this variance would not be necessary.

Therefore, granting the Variance request should not affect the public interest in any way.

FINDING: Consistent.

CRITERIA 2: The variance is required due to special conditions.

ANALYSIS: Due to the size, configuration, dual-frontage condition, and tenant mix of the

proposed project, signage in excess of what is permitted by-right is necessary. The Applicant worked with Staff to minimize the amount and magnitude of Variances necessary by reducing the number and size of signs; and creating a uniform sign plan and design which is proportionally appropriate and compatible

with the design of the overall project.

FINDING: Consistent.

CRITERIA 3: A literal enforcement of the provisions of Article 8 may result in unnecessary

hardship.

ANALYSIS: The Zoning and Land Development Regulations limits the number of monument

signs to one frontage. However, given the extensive length of the frontage and the amount of buildings adjacent to it, additional signage is necessary. Should each of these buildings be located on smaller individual parcels, this variance

would not be necessary.

FINDING: Consistent.

Analysis of Criteria and Findings for Design as stated in the City of Hollywood's Zoning and Land Development Regulations, Article 5.

CRITERIA 1: Architectural and Design components. Architecture refers to the architectural

elements of exterior building surfaces. Architectural details should be commensurate with the building mass. The use of traditional materials for new architectural details is recommended. Design of the building(s) shall consider aesthetics and functionality, including the relationship of the pedestrian with the

built environment.

ANALYSIS: The architectural details for the proposed buildings fit harmoniously with the

building's mass. As proposed, the building design maintains overall cohesion with the plaza using similar architectural elements, treatments, and materials. Materials include glass, stucco, various stone veneers and architectural screens and louvers. Accentuated volumes and other architectural features highlight building entrances, which are proposed to face the public right-of-way, as recommended by the Design Guidelines. The Applicant worked with Staff to ensure adequate vehicular and pedestrian circulation is provided. Safe pedestrian access is provided from the public sidewalk to building entrances and

throughout the site.

FINDING: Consistent.

CRITERIA 2: Compatibility. The relationship between existing architectural styles and

proposed construction, including how each building along the street relates to the whole and the pattern created with adjacent structures and the surrounding neighborhood. Buildings should contain architectural details that are

characteristic of the surrounding neighborhood.

ANALYSIS:

Since Hollywood Boulevard and State Road 7 are commercial corridors, the proposed development is consistent with the surrounding buildings in scale, massing, and placement. Therefore, it maintains a uniform alignment with the existing street profile; as well as with other buildings proposed in the shopping center. Architectural detailing is provided in harmony with the surrounding built environment using an array of materials to provide an identity for the buildings while creating a cohesive fabric.

FINDING:

Consistent.

CRITERIA 3:

Scale/Massing. Buildings shall be proportionate in scale, with a height which is consistent with the surrounding structures. Building mass shall reflect a simple composition of basic architectural details in relation to its length, width, height, lot coverage, and setting of the structure in context with adjacent buildings. Architectural details include, but are not limited to, banding molding, and fenestration.

ANALYSIS:

The proposed project was designed contextually and it's massing, scale, rhythm, and architectural elements, are compatible with the adjacent commercial corridors. The proposed one-story building is approximately 24 feet in height. Meeting all setback requirements, the building placement also creates a consistent pattern.

As recommended by the City Design Guidelines, while the proposed building distinguishes itself from neighboring buildings in terms of architectural elements, the scale, rhythm, height, and setbacks bear some relationship to neighboring buildings and maintain some resemblance of compatibility. Materials include glass, stucco, various stone veneers and architectural screens and louvers. Accentuated volumes and other architectural features highlight building entrances, which are proposed to face the public right-of-way, as recommended by the Design Guidelines.

FINDING:

Consistent.

CRITERIA 4:

Landscaping. Landscaped areas should contain a variety of native and other compatible plant types and forms, and be carefully integrated with existing buildings and paved areas. Existing mature trees and other significant plants on the site should be preserved.

ANALYSIS:

The landscaping was designed with both beautification and function in mind and all landscape requirements have been met. The proposed landscape helps articulate the property and enhance the design of the buildings. A variety of native plants and trees are proposed to work in concert with the preserved onsite trees. Ample buffers are provided where required with a considerable amount of native trees, shrubs, and ground cover. Vehicular use areas are landscaped along the perimeter and with internal islands, improving the image of the site.

FINDING:

Consistent.


SITE PLAN

The Technical Advisory Committee (TAC) found the proposed Site Plan compliant with all regulations as set forth in Article 6 of Zoning and Land Development Regulations on October 20, 2016. Therefore, Staff recommends approval, if the Variances and Design are granted.

ATTACHMENTS

Attachment A:

Application Package Land Use and Zoning Maps Attachment B:

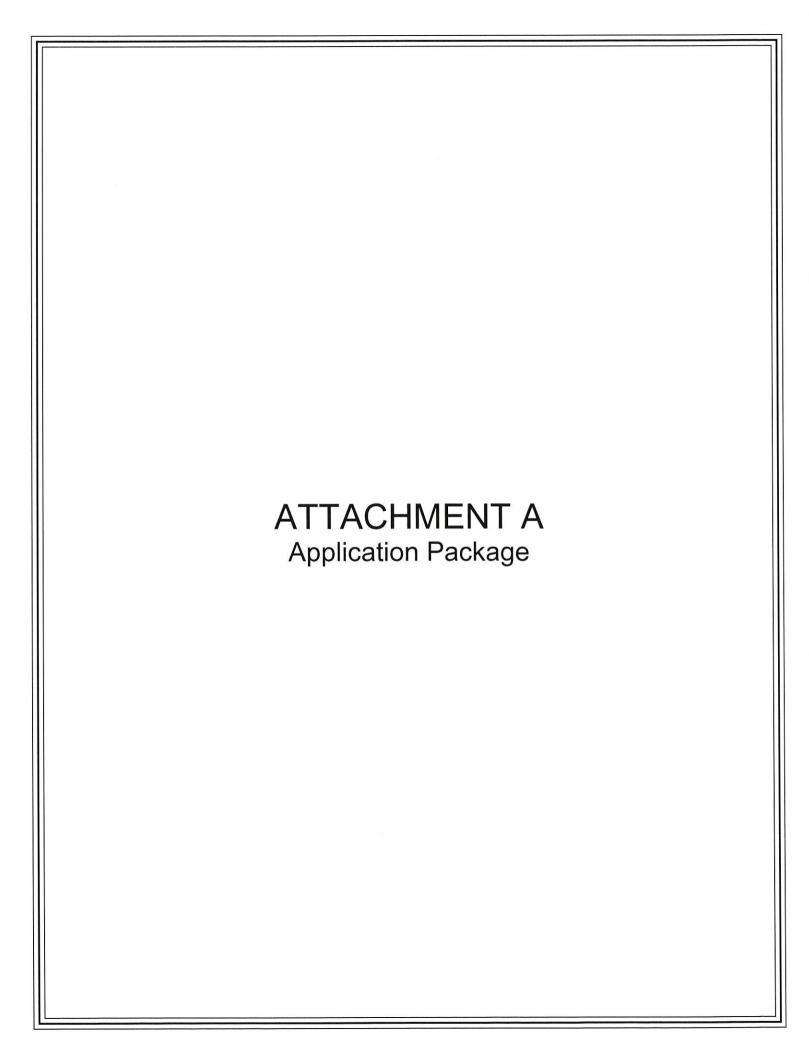

DEPARTMENT OF PLANNING



2600 Hollywood Boulevard Room 315 Hollywood, FL 33022 File No. (internal use only):

GENERAL APPLICATION



Tel: (954) 921-3471 Fax: (954) 921-3347

This application must be completed <u>in full</u> and submitted with all documents to be placed on a Board or Committee's agenda.

The applicant is responsible for obtaining the appropriate checklist for each type of application.

Applicant(s) or their authorized legal agent must be present at all Board or Committee meetings.

At least one set of the submitted plans for each application must be signed and sealed (i.e. Architect or Engineer).

Documents and forms can be accessed on the City's website at http://www.hollywoodfl.org/DocumentCenter/Home/View/21



APPLICATION TYPE (CHECK ONE)	:
☐ Technical Advisory Committee	☐ Historic Preservation Board
☐ City Commission	☑ Planning and Development Board
Date of Application:	
Location Address: <u>333 State Road 7, Holl</u>	ywood Florida
Lot(s):Parcel B, Plat Book 181, Page 12Block(s):	Subdivision: *SEE ATTACHED SURVE
Folio Number(s): _514113370021	
	_ Land Use Classification: 71: Transit Oriented Corridor
Existing Property Use: Commercial	
	P() Yes (X) No If yes, attach a copy of violation.
Has this property been presented to the City Number(s) and Resolution(s):	before? If yes, check al that apply and provide File
☐ Economic Roundtable ☐ Technical Ad	visory Committee
☐ City Commission	Development
Explanation of Request: 4,500 sf retail add	ition to out parcel development
Number of units/rooms: N/A	Sq Ft:4,500 S.F.
Value of Improvement: \$450,000 (est)	Estimated Date of Completion: 8/1/2017
Will Project be Phased? () Yes (X)No	If Phased, Estimated Completion of Each Phase
Name of Current Property Owner: Palm Be	each 2000, Inc. and Vestmaz, Inc.
Address of Property Owner: 336 E. Dania B	Beach Boulevard
	Email Address:amicha@dacarmanagement.n
Name of Consultant/Representative/Tenant	(circle one): Kimley-Horn and Associates, Inc.
Address: 445 24th Street, Suite, 200 Vero Beach, F	FL 32960 Telephone: 772.794.4100
Fax: Email Address: _	Greg.Wilfong@Kimley-Horn.com
Date of Purchase: Is there	an option to purchase the Property? Yes () No (X)
If Yes, Attach Copy of the Contract.	
List Anyone Else Who Should Receive Notic	e of the Hearing:
A	ddress: Email Address:

DEPARTMENT OF PLANNING



2600 Hollywood Boulevard Room 315 Hollywood, FL 33022

GENERAL APPLICATION

CERTIFICATION OF COMPLIANCE WITH APPLICABLE REGULATIONS

The applicant/owner(s) signature certifies that he/she has been made aware of the criteria, regulations and guidelines applicable to the request. This information can be obtained in Room 315 of City Hall or on our website at www.hollywoodfl.org. The owner(s) further certifies that when required by applicable law, including but not limited to the City's Zoning and Land Development Regulations, they will post the site with a sign provided by the Office of Planning and Development Services. The owner(s) will photograph the sign the day of posting and submit photographs to the Office of Planning and Development Services as required by applicable law. Failure to post the sign will result in violation of State and Municipal Notification Requirements and Laws.

(I)(We) certify that (I) (we) understand and will comply with the provisions and regulations of the City's Zoning and Land Development Regulations, Design Guidelines, Design Guidelines for Historic Properties and City's Comprehensive Plan as they apply to this project. (I)(We) further certify that the above statements and drawings made on any paper or plans submitted herewith are true to the best of (my)(our) knowledge. (I)(We) understand that the application and attachments become part of the official public records of the City and are not returnable. Signature of Current Owner: Date: 10-12-16 PRINT NAME: Alberto Micha Buzali Date: _____ Vice President of Palm Beach 2000, Inc / Vice President of Vestmaz, Inc. Signature of Consultant/Representative:_____ Date: PRINT NAME: Greg Wilfong Date: Signature of Tenant: Date: PRINT NAME: Date: **CURRENT OWNER POWER OF ATTORNEY** I am the current owner of the described real property and that I am aware of the nature and effect the request for to my property, which is hereby made by me or I (project description) am hereby authorizing (name of the representative) to be my legal representative before the _____(Board and/or Committee) relative to all matters concerning this application. Sworn to and subscribed before me this 12 day of UHODET SIGNATURE OF CURRENT OWNER Alberto Micha Buzali, Vice President Palm Beach 2000, Inc Vice President of Vestmaz, Inc. Notary Public State of Florida My Commission Expires: 5 28 19 (Check One) Personally known to me; OR _____



The Place at Hollywood Phase VI

Legal Description

A portion of parcel "B" of "Hollywood Plaza" according to the plat thereof as recorded in plat book 181, page 12, of the public records of Broward County, Florida, being more particularly described as follows:

commence at the most southerly southwest corner of said parcel "B"; thence on the westerly boundary of said parcel "B", also being the east right-of-way line of State Road no. 7 (U.S. highway no. 441) the following 4 courses and distances: 1) north 01°47'16" west 48.66 feet to the point of beginning; 2) continue north 01°47'16" west 9.34 feet; 3) north 45°59'46" west 35.35 feet; 4) north 00°59'46" west 84.82 feet; thence north 87°22'36" east 238.28 feet; thence south 02°37'24" east 100.49 feet to a point of curvature of a circular curve, concave northwesterly; thence southwesterly on the arc of said curve, with a radius of 19.33 feet, a central angle of 90°00'00", for an arc distance of 30.36 feet to a point of tangency; thence south 87°22'36" west 197.22 to the point of beginning,

Project Information

Project Description

The proposed Place at Hollywood Phase VI is a 0.65 acre outparcel development consisting of one retail buildings totaling 4,500 square feet, located within The Place at Hollywood development. Improvements include parking lots, landscaping, stormwater system and utilities.

Location

Section 13, Township 51 S, Range 41 E

Address

333 S. State Road 7, Hollywood, FL 33023

Zonina

- SR7 CCD-CC: Commercial Corridor District- Commercial Core Sub-area
- C-2: Low/Medium Intensity Commercial District

Land Use

71: Transit Oriented Corridor



The Place at Hollywood Phase V South Retail

Existing Conditions Photo #1 (Looking North)




PROJECT LOCATION



The Place at Hollywood Phase V South Retail

Existing Conditions Photo #2 (Looking Southeast)



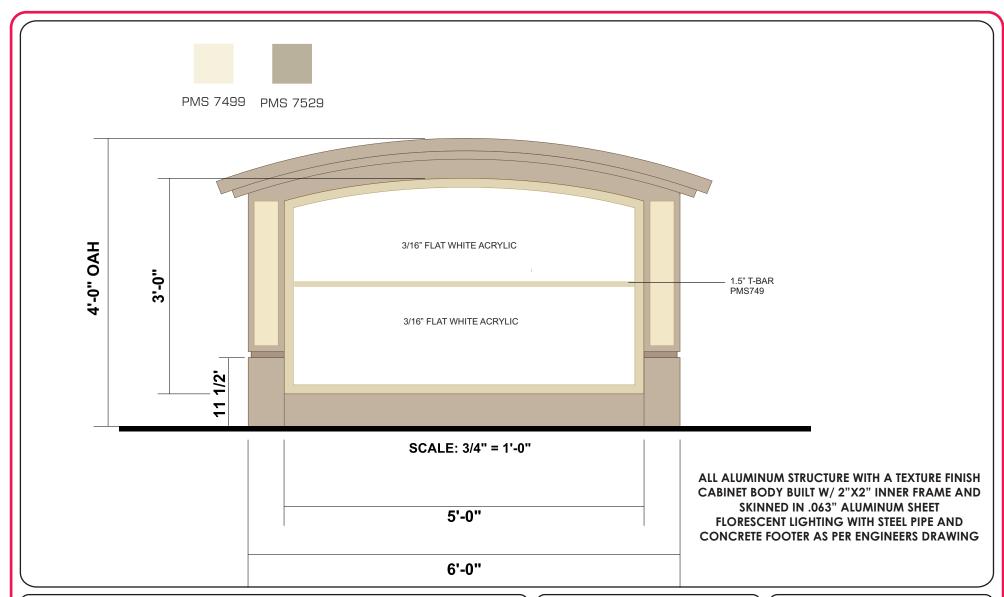

PROJECT NAME: THE PLACE AT HOLLYWOOD46 DATE: 9/9/16

DESCRIPTION:

FABRICATE AND INSTALL ONE DOUBLE FACED ILLUMINATED MONUMENT SIGN AS PER DRAWING.

I have carefully reviewed and hereby accept the drawing(s) as shown. All additional changes must be in writing and approved by both parties.

signature

date

This drawing is for illustration purposes only. Colors and scaling in drawing may vary.




1101 29th Avenue West Bradenton, FL 34205

Phone: 941.747.1000 Fax: 941-746.5689

SITE CONSTRUCTION PLANS THE PLACE AT HOLLYWOOD PHASE V **SOUTH RETAIL** 333 SOUTH STATE ROAD 7

HOLLYWOOD, BROWARD COUNTY, FL

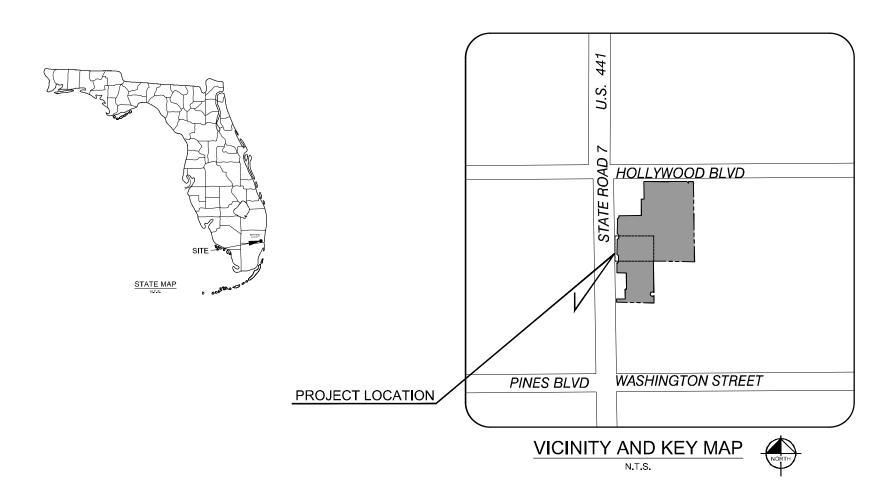

Sheet List Table

SHEET TITLE

C-000	COVER SHEET
1 OF 1	BOUNDARY AND TOPOGRAPHIC SURVEY
C-001	GENERAL NOTES
C-100	EROSION AND SEDIMENT CONTROL PLAN
C-101	SWPPP DETAILS
C-200	DEMOLITION PLAN
C-300	OVERALL SITE PLAN
C-301	OVERALL PARKING PLAN
C-302	SITE PLAN
C-303	SITE PLAN DETAILS
C-400	PAVING, GRADING AND DRAINAGE PLAN
C-401	PAVING, GRADING AND DRAINAGE DETAILS
C-500	UTILITY PLAN
C-501	CITY OF HOLLYWOOD STANDARD POTABLE WATER DETAILS
C-502	CITY OF HOLLYWOOD STANDARD POTBALE WATER DETAILS
C-503	CITY OF HOLLYWOOD STANDARD POTBALE WATER DETAILS
C-504	CITY OF HOLLYWOOD STANDARD WASTEWATER DETAILS
C-505	CITY OF HOLLYWOOD STANDARD WASTEWATER DETAILS
L-100	LANDSCAPE PLAN
L-200	LANDSCAPE DETAILS

(PREPARED BY GUTIERREZ & LOZANO ARCHITECTS) ARCHITECT

LANDSCAPE SPECIFICATIONS

SHEET NUMBER FLOOR PLAN A-1 0 **ROOF PLAN ELEVATIONS** A-2.0 COLOR ELEVATIONS

SHEET NUMBER

L-300

PROJECT DESIGN TEAM

KIMLEY-HORN AND ASSOCIATES, INC. GREG WILFONG, P.E. 445 24TH STREET, SUITE 200

OWNER:

DACAR MANAGEMENT, LLC 336 E. DANIA BEACH BLVD. DANIA, FL 33004 PHONE: (954) 927-4885

SURVEY
PULICE LAND SÜRVEYORS, INC.
JOHN PULICE
5381 NOB HILL ROAD
SUNRISE, FL 33351

ARCHITECT

CARLOS LOAZANO GUTIERREZ AND LOZANO ARCHITECTS, P.A. 2830 WEST STATE ROAD 84, SUITE 117

LANDSCAPE ARCHITECT

KIMLEY-HORN AND ASSOCIATES, INC. MATTHEW FRANKO 3660 MAGUIRE BOULEVARD, SUITE 200

ENVIRONMENTAL

LIST OF CONTACTS

TELEPHONE

FIRE CHIEF

ATET
BILL SERPE
8601 W. SUNRISE BLVD. ROOM 2106
PLANTATION, FL 33322
PHONE: (954) 476-6125

CITY PLANNING/ZONING

CITY ENGINEERING

STORMWATER

BUILDING OFFICIAL

CABLE

ELECTRIC
FLORIDA POWER & LIGHT
JAMES TALLEY
4000 DAVIE ROAD EXTENSION

<u>WATER</u>

CITY OF HOLLYWOOD JAMES RUSNAK 2600 HOLLYWOOD BLV HOLLYWOOD, FL 33022 PHONE: (954) 921–3302

SANITARY SEWER

NATURAL GAS

MEETINGS PRELIMINARY TAC 09/06/16 FINAL TAC PLANNING DEV. BOARD CITY COMMISSION

ALERT TO CONTRACTOR:


YWOOD PHASE OUTH RETAIL THE PLACE AT HOLL) V S(

Kimley » Horn

C-000

SHEET

COVER

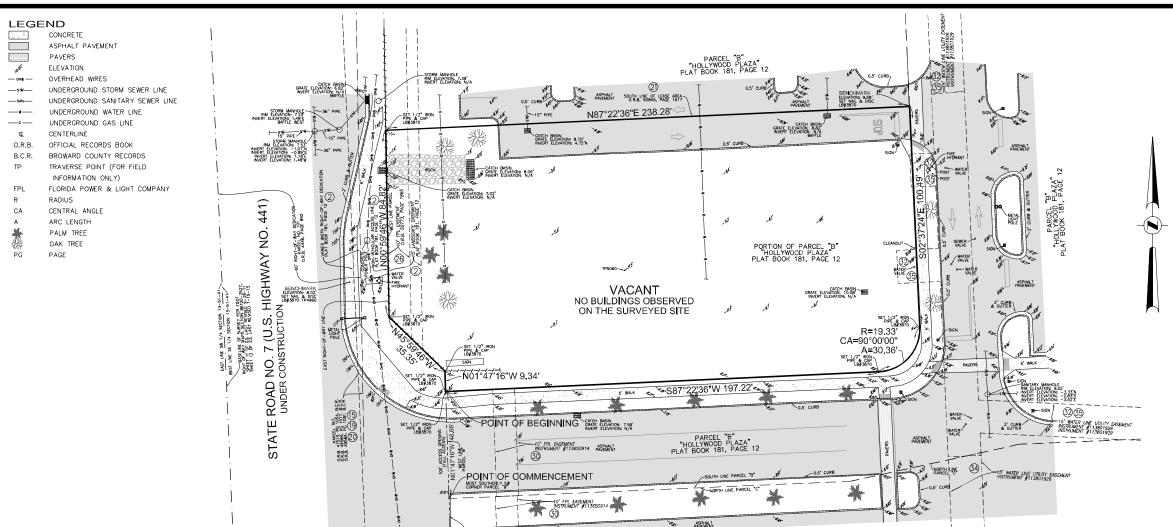

LEGAL DESCRIPTION:

A PORTION OF PARCEL "B" OF "HOLLYWOOD PLAZA" ACCORDING TO THE PLAT THEREOF AS RECORDED IN PLAT BOOK 181, PAGE 12, OF THE PUBLIC RECORDS OF BROWARD COUNTY, FLORIDA, BEING MORE PARTICULARLY DESCRIBED AS FOLLOWS:

COMMENCE AT THE MOST SOUTHERLY SOUTHWEST CORNER OF SAID PARCEL "B": THENCE ON THE WESTERLY BOUNDARY OF SAID PARCEL "B", ALSO BEING THE EAST RIGHT-OF-WAY LINE OF STATE ROAD NO. 7 (U.S. HIGHWAY NO. 441) THE FOLLOWING 4 COURSES AND DISTANCES: 1) NORTH 0147/16" WEST 48.66 FEET TO THE POINT OF BEGINNING; 2) CONTINUE NORTH 0147/16" WEST 9.34 FEET; 3) NORTH 45'59'46" WEST 35.35 FEET; 4) NORTH 075'39'46" WEST 84.82 FEET; THENCE NORTH 87'22'36" EAST 100.49 FEET TO A POINT OF CURVATURE OF A CIRCULAR CURVE, CONCAVE NORTHWESTERLY; THENCE SOUTHWESTERLY ON THE ARC OF SAID CURVE, WITH A RADIUS OF 19.33 FEET, A CENTRAL ANGLE OF 90'00". FOR AN ARC DISTANCE OF 30.36 FEET TO A POINT OF TANGENCY; THENCE SOUTH 87'22'36" WEST 197.22 TO THE POINT OF PEGINNING.

SAID LANDS SITUATE, LYING AND BEING IN THE CITY OF HOLLYWOOD, BROWARD COUNTY, FLORIDA, AND CONTAINING 28,120 SQUARE FEET, 0.6456 ACRES.



COPYRIGHT 2016 BY PULICE LAND SURVEYORS, INC. ALL RIGHTS RESERVED. NO PART OF THIS SURVEY MAY BE REPRODUCED, IN ANY FORM OR BY ANY MEANS, WITHOUT PERMISSION IN WRITING FROM AN OFFICER OF PULICE LAND SURVEYORS, INC.

NOTES:

17) NORTH LINE OF LEASE AREA OR, PAGE 1349 CENTERLINE OF ANCHOR EASEMENT O.R.B. 952, PAGE 32

NOTES:
1) IEDVINIONS ARE BASED ON NORTH AMERICAN MERICAL DATUM OF 1988, BROWARD COUNTY BENCHMARK #\$2062; ELEVATION: 8.50 FEET.
2) FLOOD ZONE: AH: BASE FLOOD ELEVATION: 10 FEET; PANEL #\$2015 0064H.

MAP DATE: \$71.874.
3) HIS STELL SET IN SECON 11, TOMINGIP SI SOUTH, PANEL #\$1.51, BROWARD COUNTY, FLORIDA.
3) HIS STELL SET IN SECON 11, TOMINGIP SI SOUTH, PANEL #\$1.51, BROWARD COUNTY, FLORIDA.
4) PRESCONABLE EFFORTS WERE MADE RECARDING THE EXISTREE AND THE LOCATION OF UNDERGROUND UTILITIES. THIS FIRM, HOWEVER, DOES NOT ACCEPT RESPONSIBILITY FOR THIS INFORMATION. BEFORE EXCAVATION OF CONSTRUCTION CONTACT THE APPROPRISED CHILD COUNTAGE.
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PARCEL "C" "HOLLYWOOD PLAZA" PLAT BOOK 181, PAGE 12

POSTERIOR DE SE ACRESOS "HDLLYWOOD PLAZA" PLAT BOOK 181, PAGE 12, B.C.R. SURVEY SITE 7 8 9 10 11 12 15 BLOCK 6 "HILLSDE PARK" PLAT BOOK 3B, PAGE 20 PRODE AT 1875 POLY PLAT PLAT 8000 TOS PAGE 40 TRADISON UNPLATTED ACREAGE PORTION OF SE 1/4 SECTION 13-51-41 VICINITY MAP NOT TO SCALE

THOLLYWOOD BEACH

AND SARDENS BLOCK 46

AND PAGE 15

HOLLYWOOD BEACH CARDENS P.B. 10, PAGE 15


- NO COSINER SE 1/4

CERTIFICATION:

TO DACAR MANAGEMENT, LLC, A FLORIDA LIMITED LIABILITY COMPANY; PALM BEACH 2000, INC., A FLORIDA CORPORATION; VESTMAZ, INC., A FLORIDA CORPORATION; COMMONWEALTH LAND TITLE INSURANCE COMPANY; DUNAY MISKEL AND BACKMAN, LLP:

THIS IS TO CERTIFY THAT THIS MAP OR PLAT AND THE SURVEY ON WHICH IT IS BASED WERE MADE IN ACCORDANCE WITH THE 2016 MINIMUM STANDARD DETAIL REQUIREMENTS FOR ALTA/NSPS LAND TILE SURVEYS, JOINTLY ESTABLISHED AND ADOPTED BY ALTA AND NSPS, AND INCLUDES ITEMS 1, 3, 4, 8, & 11 OF TABLE A THEREOF.

JOHN F. PULICE, PROFESSIONAL SURVEYOR AND MAPPER LS2691 BETH BURNS, PROFESSIONAL SURVEYOR AND MAPPER LS6136
UNCTOR R. GLBERT, PROFESSIONAL SURVEYOR AND MAPPER LS6274
STATE OF FLORIDA

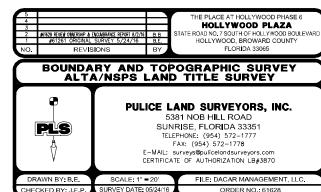

- 1. THE CONTRACTOR AND SUBCONTRACTORS SHALL OBTAIN A COPY OF THE FLORIDA DEPARTMENT OF TRANSPORTATION "STANDARD SPECIFICATIONS FOR ROAD AND BRIDGE CONSTRUCTION" (LATEST EDITION) AND BECOME FAMILIAR WITH THE CONTENTS PRIOR TO COMMENCING WORK, AND, UNLESS OTHERWISE NOTED, A WORK SHALL CONFORM AS APPLICABLE TO THESE STANDARDS AND SPECIFICATIONS.
- 2. THE CONTRACTOR SHALL BE RESPONSIBLE FOR FURNISHING ALL MATERIAL AND LABOR TO CONSTRUCT THE FACILITY AS SHOWN AND DESCRIBED IN THE CONSTRUCTION DOCUMENTS IN ACCORDANCE WITH THE APPROPRIATE APPROYING AUTHORITIES, SPECIFICATIONS AND REQUIREMENTS. CONTRACTOR SHALL CLEAR AND GRUB ALL AREAS UNLESS OTHERWISE INDICATED, REMOVING TREES, STUMPS, ROOTS, MUCK, EXISTING PAVEMENT AND ALL OTHER DELETERIOUS MATERIAL.
- EXISTING PAVEMENT AND ALL OTHER DELETERIOUS MATERIAL.

 3. EXISTING UTILITIES SHOWN ARE LOCATED ACCORDING TO THE INFORMATION AVAILABLE TO THE ENGINEER AT THE TIME OF THE OPOGRAPHIC SURVEY AND HAVE NOT BEEN INDEPENDENTLY VERIFIED BY THE OWNER OR THE ENGINEER, GUARANTEE IS NOT MADE THAT ALL EXISTING UNDERGROUND UTILITIES ARE SHOWN OR THAT THE LOCATION OF HOSE SHOWN ARE ENTIRELY ACCURATE. FINDING THE ACTUAL LOCATION OF ANY EXISTING UTILITIES IS THE CONTRACTOR'S RESPONSIBILITY AND SHALL BE DONE BEFORE COMMENCING ANY WORK IN THE VICINITY. FURTHERMORE, THE CONTRACTOR'S FAILLE FULLY RESPONSIBLE FOR ANY AND ALL DAMAGES DUE TO THE CONTRACTOR'S FAILLE TO EXACTLY LOCATE AND PRESERVE ANY AND ALL UNDERGROUND UTILITIES. THE OWNER OF ENGINEER WILL ASSUME NO LIABILITY FOR ANY DAMAGES SUSTAINED OR COST INCURRED BECAUSE OF THE OPERATIONS IN THE VICINITY OF EXISTING UTILITIES OR STRUCTURES, NOR FOR TEMPORARY BRACING AND SHORING OF SAME. IF IT IS NECESSARY TO SHORE, SKANG, SWING OR RELOCATE A UTILITY. THE UTILITY COMPANY OR DEPARTMENT A FRECTED SHALL BE CONTACTED AND THEIR PERMISSION OBTAINED REPARTISING THE METHOD TO USE FOR SUCH WORK.
- 4. IT IS THE CONTRACTOR'S RESPONSIBILITY TO CONTACT THE VARIOUS UTILITY IT IS THE CONTRACTOR'S RESPONSIBILITY TO CONTACT THE VARIOUS UTILITY COMPANIES WHICH MAY HAVE BURIED OR AREAL UTILITIES WITHIN OR NEAR THE CONSTRUCTION AREA BEFORE COMMENCING WORK. THE CONTRACTOR SHALL PROVIDE 48 HOURS MINIMUM NOTICE TO ALL UTILITY COMPANIES PRIOR TO BEGINNING CONSTRUCTION. AN APPROXIMATE LIST OF THE UTILITY COMPANIES WHICH THE CONTRACTOR MUST CALL BEFORE COMMENCING WORK IS PROVIDED ON THE COVER SHEET OF THESE CONSTRUCTION PLANS. THIS LIST SERVES AS A GUIDE ONLY AND IS NOT INTENDED TO LIMIT THE UTILITY COMPANIES WHICH THE CONTRACTOR MAY WISH TO NOTIFICE.
- THE CONTRACTOR SHALL BE RESPONSIBLE FOR OBTAINING ALL REQUIRED CONSTRUCTION PERMITS AND BONDS IF REQUIRED PRIOR TO CONSTRUCTION.
- 6. THE CONTRACTOR SHALL HAVE AVAILABLE AT THE JOB SITE AT ALL. TIMES ONE COPY OF THE CONSTRUCTION DOCUMENTS INCLUDING PLANS. SPECIFICATIONS GEOTECHNICAL REPORT AND SPECIAL CONDITIONS AND COPIES OF ANY REQUIRED. CONSTRUCTION PERMITS.
- 7. ANY DISCREPANCIES ON THE DRAWINGS SHALL BE IMMEDIATELY BROUGHT TO THE ATTENTION OF THE OWNER AND ENGINEER BEFORE COMMENCING WORK, NO FIELD CHANGES OR DEVIATIONS FROM DESIGN ARE TO BE MADE WITHOUT PRIOR APPROVAL OF THE OWNER AND NOTIFICATION TO THE ENGINEER.
- 8. ALL COPIES OF COMPACTION, CONCRETE AND OTHER REQUIRED TEST. RESULTS ARE TO BE SENT TO THE OWNER AND DESIGN ENGINEER OF RECORD DIRECTLY FROM THE TESTING AGENCY.
- 9. THE CONTRACTOR SHALL BE RESPONSIBLE FOR SUBMITTING TO THE ENGINEER A CERTIFIED RECORD SURVEY SIGNED AND SEALED BY A PROFESSIONAL LAND SURVEYOR REGISTERED IN THE STATE OF FLORIDA DEPICTING THE ACTUAL FIELD LOCATION OF ALL CONSTRUCTED IMPROVEMENTS THAT ARE REQUIRED BY THE JURISDICTIONAL AGENCIES FOR THE CERTIFICATION PROCESS, ALL SURVEY COSTS WILL BE THE CONTRACTORS RESPONSIBILITY.
- 10. THE CONTRACTOR SHALL BE RESPONSIBLE FOR DOCUMENTING AND MAINTAINING AS-BUILT INFORMATION WHICH SHALL BE RECORDED AS CONSTRUCTION PROGRESSES OR AT THE COMPLETION OF APPROPRIATE CONSTRUCTION INTERVALS AND SHALL BE RESPONSIBLE FOR PROVIDING AS-BUILT DRAWINGS TO THE OWNER FOR THE PURPOSE OF CERTIFICATION TO JURISDICTIONAL AGENCIES AS REQUIRED. ALL AS-BUILT DATA SHALL BE COLLECTED BY A STATE OF FLORIDA PROFESSIONAL LAND SURVEYOR WHOSE SERVICES ARE ENGAGED BY THE CONTRACTOR.
- 11. ANY WELLS DISCOVERED ON SITE THAT WILL HAVE NO USE MUST BE PLUGGED BY A LICENSED WELL DRILLING CONTRACTOR IN A MANNER APPROVED BY ALL JURISUITIONAL AGENCIES. CONTRACTOR SHALL BE RESPONSIBLE FOR DITAINING
- 12. ANY WELL DISCOVERED DURING EARTH MOVING OR EXCAVATION SHALL BE REPORTED TO THE APPROPRIATE JURISDICTIONAL AGENCIES WITHIN 24 HOURS AFTER DISCOVER
- 13. THE CONTRACTOR SHALL BE RESPONSIBLE FOR VERIFYING THAT THE PROPOSED IMPROVEMENTS SHOWN ON THE PLANS DO NOT CONFLICT WITH ANY KNOWN EXISTING OR OTHER PROPOSED IMPROVEMENTS, IF ANY CONFLICTS ARE DISCOVERED, THE CONTRACTOR SHALL NOTIFY THE OWNER PRIOR TO INSTALLATION OF ANY PORTION OF THE SITE WORK THAT WOULD BE AFFECTED. FAILURE TO NOTIFY OWNER OF AN IDENTIFIABLE CONFLICT PRIOR TO PROCEEDING WITH INSTALLATION RELIEVES OWNER OF ANY OBLIGATION TO PAY FOR A RELATED CHANGE ORDER.

DEMOLITION NOTES

- ALL MATERIAL REMOVED FROM THIS SITE BY THE CONTRACTOR SHALL BE DISPOSED OF BY THE CONTRACTOR IN A LEGAL MANNER.
- REFER TO THE TOPOGRAPHIC SURVEY FOR ADDITIONAL DETAILS OF EXISTING STRUCTURES, ETC., LOCATED WITHIN THE PROJECT SITE. UNLESS OTHERWISE NOTED, ALL EMSTING BUILDINGS, STRUCTURES, SLASS, CONCRETE. ASPHALT, DEBRIS PILES, SIGNS, AND ALL APPURTENANCES ARE TO BE REMOVED FROM THE SITE BY THE CONTRACTOR AND PROPERLY DISPOSED OF IN A LEGAL MANNER AS PART OF THIS CONTRACT. SOME ITEMS TO BE REMOVED MAY NOT BE DEPICTED ON THE TOPOGRAPHIC SURVEY. IT IS THE CONTRACTOR'S RESPONSIBILITY TO VISIT THE SITE AND DETERMINE THE FOLL EXTENT OF ITEMS TO BE REMOVED. IF ANY TEMS ARE IN QUESTION, THE CONTRACTOR SHALL CONTACT THE OWNER PRIOR TO REMOVAL OF SAID ITEMS.
- 3. THE CONTRACTOR SHALL REFER TO THE DEMOLITION PLAN AND LANDSCAPE PLAN FOR DEMOLITION/PRESERVATION OF EXISTING TREES. ALL TREES NOT SPECIFICALLY SHOWN TO BE PRESERVED OR RELOCATED SHALL BE REMOVED AS A PART OF THIS CONTRACT, TREE PROTECTION FENCING SHALL BE INSTALLED PRIOR TO ANY DEMOLITION.
- 4. CONTRACTOR SHALL ADJUST GRADE OF ANY EXISTING UTILITIES TO REMAIN.

PAVING, GRADING AND DRAINAGE NOTES

- 1. ALL PAVING, CONSTRUCTION, MATERIALS, AND WORKMANSHIP WITHIN JURISDICTION'S RIGHT-OF-WAY SHALL BE IN ACCORDANCE WITH LOCAL OR COUNTY SPECIFICATIONS AND STANDARDS (LATEST EDITION) OR FDOT SPECIFICATIONS AND STANDARDS (LATEST EDITION) IF NOT COVERED BY LOCAL OR COUNTY REGULATIONS
- 2. ALL UNPAVED AREAS IN EXISTING RIGHTS-OF-WAY DISTURBED BY CONSTRUCTION
- TRAFFIC CONTROL ON ALL FDOT, LOCAL AND COUNTY RIGHTS-OF-WAY SHALL MEET THE REQUIREMENTS OF THE MANUAL OF UNFORMTRAFFIC CONTROL DEVICES (U.S. DOT/FHA) AND THE REQUIREMENTS OF THE STATE AND ANY LOCAL. AGENCY HAVING JURISDICTION, IN THE EVENT THAT THE CONTRACT DOCUMENTS AND THE JURISDICTIONAL AGENCY REQUIREMENTS ARE NOT IN AGREEMENT, THE MOST
- 4. THE CONTRACTOR SHALL GRADE THE SITE TO THE ELEVATIONS INDICATED AND SHALL REGRADE WASHOUTS WHERE THEY OCCUR AFTER EVERY RAINFALL UNITL A GRASS STAND IS WELL ESTABLISHED OR ADEQUATE STABLIZATION OCCURS.
- ALL OPEN AREAS WITHIN THE PROJECT SITE SHALL BE SODDED UNLESS INDICATED OTHERWISE ON THE LANDSCAPE PLAN.
- L AREAS INDICATED AS PAVEMENT SHALL BE CONSTRUCTED IN ACCORDANCE WITH E TYPICAL PAVEMENT SECTIONS AS INDICATED ON THE DRAWINGS.
- 7. WHERE EXISTING PAVEMENT IS INDICATED TO BE REMOVED AND REPLACED, THE CONTRACTOR SHALL SAW CUT A MINIMUM 2" DEEP FOR A SMOOTH AND STRAIGHT JOINT AND REPLACE THE PAVEMENT WITH THE SAME TYPE AND DEPTH OF MATERIAL AS
- 8. WHERE NEW PAVEMENT MEETS THE EXISTING PAVEMENT, THE CONTRACTOR SHALL SAW CUIT THE EXISTING PAVEMENT A MINIMUM 2" DEEP FOR A SMOOTH AND STRAIGHT JOINT AND MATCH THE EXISTING PAVEMENT ELEVATION WITH THE PROPOSED. PAVEMENT UNLESS OTHERWISE INDICATED.
- 9. THE CONTRACTOR SHALL INSTALL FILTER FABRIC OVER ALL DRAINAGE STRUCTURES FOR THE DURATION OF CONSTRUCTION AND UNTIL. ACCEPTANCE OF THE PROJECT BY THE OWNER. ALL DRAINAGE STRUCTURES SHALL BE CLEANED OF DEBRIS AS REQUIRED. DURING AND AT THE END OF CONSTRUCTION TO PROVIDE POSITIVE DRAINAGE FLOWS.
- 10. IF DEWATERING IS REQUIRED, THE CONTRACTOR SHALL OBTAIN ANY APPLICABLE REQUIRED PERMITS. THE CONTRACTOR IS TO COORDINATE WITH THE OWNER AND THE DESIGN ENGINEER PRIOR TO ANY EXCAVATION.
- 11. STRIP TOPSOIL AND ORGANIC MATTER FROM ALL AREAS OF THE SITE AS REQUIRED. IN SOME CASES TOPSOIL MAY BE STOCKPILED ON SITE FOR PLACEMENT WITHIN LANDSCAPED AREAS BUT ONLY AS DIRECTED BY THE OWNER.
- 12. FIELD DENSITY TESTS SHALL BE TAKEN AT INTERVALS IN ACCORDANCE WITH THE LOCAL JURISDICTIONAL AGENCY OR TO FDOT STANDARDS. IN THE EVENT THAT THE CONTRACT DOCUMENTS AND THE JURISDICTIONAL AGENCY REQUIREMENTS ARE NOT IN AGREEMENT, THE MOST STRINGENT SHALL GOVERN.
- 13. ALL SLOPES AND AREAS DISTURBED BY CONSTRUCTION SHALL BE GRADED AS PER PLANS. THE AREAS SHALL THEN BE SODDED OR SEEDED AS SPECIFIED IN THE PLANS, FERTILIZED, MULCHED, WATERED AND MAINTAINED UNTIL HARDY GRASS GROWTH IS ESTABLISHED IN ALL AREAS. ANY AREAS DISTURBED FOR ANY REASON PRIOR TO FINAL ACCEPTANCE OF THE JOB SHALL BE CORRECTED BY THE CONTRACTOR AT NO ADDITIONAL COST TO THE OWNER. ALL EARTHEN AREAS WILL BE SODDED OR SEEDED AND MULCHED AS SHOWN ON THE LANDSCAPING PLAN.
- 14. ALL CUT OR FILL SLOPES SHALL BE 4 (HORIZONTAL):1 (VERTICAL) OR FLATTER UNLESS
- 15. THE CONTRACTOR SHALL BE RESPONSIBLE FOR THE CONTROL OF DUST AND DIRT RISING AND SCATTERING IN THE AIR DURING CONSTRUCTION AND SHALL PROVIDE WATER SPRINKLING OR OTHER SUITABLE METHODS OF CONTROL. THE CONTRACTOR SHALL COMPLY WITH ALL GOVERNING REGULATIONS PERTAINING TO ENVIRONMENTAL
- 16. THE CONTRACTOR SHALL TAKE ALL REQUIRED MEASURES TO CONTROL TURBIDITY, INCLUDING BUT NOT LIMITED TO THE INSTALLATION OF TURBIDITY BARRIERS AT ALL LOCATIONS WHERE THE POSSIBILITY OF TRANSFERRING SUSPENDED SOLIDS INTO THE RECEIVING WATER BODY EXISTS DUE TO THE PROPOSED WORK, TURBIDITY BARRIERS MUST BE MAINTAINED IN EFFECTIVE CONDITION AT ALL LOCATIONS UNTIL CONSTRUCTION IS COMPLETED AND DISTURBED SOIL AREAS ARE STABILIZED, THEREAFTER, THE CONTRACTOR MUST REMOVE THE BARRIERS, AT NO TIME SHALL THESE OF ANY CREATER DISCHARGE WHICH WICH ATES THE MICHES OF USING THE THERE BE ANY OFF-SITE DISCHARGE WHICH VIOLATES THE WATER QUALITY STANDARDS IN CHAPTER 17-302, FLORIDA ADMINISTRATIVE CODE.
- 17. SOD, WHERE CALLED FOR MUST BE INSTALLED AND MAINTAINED ON EXPOSED SLOPES WITHIN 48 HOURS OF COMPLETING FINAL GRADING, AND AT ANY OTHER TIME AS NECESSARY, TO PREVENT EROSION, SEDIMENTATION OR TURBID DISCHARGES.
- 18. THE CONTRACTOR MUST REVIEW AND MAINTAIN A COPY OF THE ENVIRONMENTA THE SOURCE PERMIT COMPLETE WITH ALL CONDITIONS, ATTACHMENTS, EXHIBITS, AND PERMIT MODIFICATIONS IN GOOD CONDITION AT THE CONSTRUCTION SITE. THE COMPLETE PERMIT MUST BE AVAILABLE FOR REVIEW UPON REQUEST BY WATER MANAGEMENT DISTRICT REPRESENTATIVES.
- 19. THE CONTRACTOR SHALL ENSURE THAT ISLAND PLANTING AREAS AND OTHER PLANTING AREAS ARE NOT COMPACTED AND DO NOT CONTAIN ROAD BASE MATERIALS. THE CONTRACTOR SHALL ALSO EXCAVATE AND REMOVE ALL UNDESIRABLE MATERIAL FROM ALL AREAS ON THE SITE TO BE PLANTED AND PROPERLY DISPOSED OF IN A LEGAL
- THE CONTRACTOR SHALL INSTALL ALL UNDERGROUND STORM WATER PIPING PER MANUFACTURER'S RECOMMENDATIONS.

RECORD DRAWINGS

1. CONTRACTOR SHALL PROVIDE TO THE ENGINEER AND OWNER A MINIMUM OF 10 HARD COPIES OF A PAVING, GRADING AND DRAINAGE RECORD DRAWING AND A SEPARATE UTILITY RECORD DRAWING, AS WELL AS BOTH IN AUTOCAD 2012 OR LATER, BOTH PREPARED BY A FLORIDA REGISTERED SURVEYOR, THE RECORD DRAWINGS SHALL VERIFY ALL DESIGN INFORMATION INCLUDED ON THE DESIGN PLANS OF THE SAME

WATER AND SEWER UTILITY NOTES

- 1. THE CONTRACTOR SHALL CONSTRUCT GRAVITY SEWER LATERALS, MANHOLES GRAVITY SEWER LINES AND DOMESTIC WATER AND FIRE PROTECTION SYSTEM AS SHOWN ON THESE PLANS. THE CONTRACTOR SHALL FURNISH ALL NECESSARY MATERIALS, EQUIPMENT, MACHINERY, TOOLS, MEANS OF TRANSPORTATION AND LABOR NECESSARY TO COMPLETE THE WORK IN FULL AND COMPLETE ACCORDANCE WITH THE SHOWN. DESCRIBED AND REASONABLY INTENDED REQUIREMENTS OF THE CONTRACT DOCUMENTS AND JURISDICTIONAL AGENCY REQUIREMENTS. IN THE EVENT THAT THE CONTRACT DOCUMENTS AND THE JURISDICTIONAL AGENCY REQUIREMENTS ARE NOT IN AGREEMENT, THE MOST STRINGENT SHALL GOVERN.
- ALL EXISTING UNDERGROUND UTILITY LOCATIONS SHOWN ARE APPROXIMATE THE CONTRACTOR SHALL COMPLY WITH ALL REQUIREMENTS FOR UTILITY LOCATION AND COORDINATION IN ACCORDANCE WITH THE NOTES CONTAINED IN THE GENERAL CONSTRUCTION SECTION OF THIS SHEET.
- 3. THE CONTRACTOR SHALL RESTORE ALL DISTURBED VEGETATION IN KIND, UNLESS SHOWN OTHERWISE.
- DEFLECTION OF PIPE JOINTS AND CURVATURE OF PIPE SHALL NOT EXCEED THE MANUFACTURER'S SPECIFICATIONS, SECURELY CLOSE ALL OPEN ENDS OF PIPE AND FITTINGS WITH A WATERTIGHT PLUG WHEN WORK IS NOT IN PROGRESS. THE INTERIO OF ALL PIPES SHALL BE CLEAN AND JOINT SURFACES WIPED CLEAN AND DRY AFTER THE PIPE HAS SEEN LOWERED INTO THE TRENCH, VALVES SHALL BE PLUMB AND LOCATED ACCORDING TO THE PLANS.
- ALL PHASES OF INSTALLATION, INCLUDING UNLOADING, TRENCHING, LAYING AND BACK FILLING, SHALL BE DONE IN A FIRST CLASS WORKMANLIKE MANNER. ALL PIPE AND FITTINGS SHALL BE CAREFULLY STORED FOLLOWING MANUFACTURERS RECOMMENDATIONS. CARE SHALL BE TAKEN TO AVOID DAMAGE TO THE COATING OR LINING IN ANY D.I. PIPE FITTINGS. ANY PIPE OR FITTING WHICH IS DAMAGED OR WHICH HAS FLAWS OR IMPERFECTIONS WHICH, IN THE OPINION OF THE ENGINEER OR OWNER, RENDERS IT UNFIT FOR USE, SHALL NOT BE USED. ANY PIPE NOT SATISFACTORY FOR USE SHALL BE CLEARLY MARKED AND IMMEDIATELY REMOVED FROM THE JOB SITE, AND SHALL BE REPLACED AT THE CONTRACTORS SYEENSE. SHALL BE REPLACED AT THE CONTRACTOR'S EXPENSE.
- 6. WATER FOR FIRE FIGHTING SHALL BE AVAILABLE FOR USE PRIOR TO COMBUSTIBLES 7. ALL UTILITY AND STORM DRAIN TRENCHES LOCATED UNDER AREAS TO RECEIVE PAVING
- SHALL BE COMPLETELY BACK FILLED IN ACCORDANCE WITH THE GOVERNING JURISDICTIONAL AGENCY'S SPECIFICATIONS. IN THE EVENT THAT THE CONTRACT DOCUMENTS AND THE JURISDICTIONAL AGENCY REQUIREMENTS ARE NOT IN AGREEMENT, THE MOST STRINGENT SHALL GOVERN
- 8. UNDERGROUND LINES SHALL BE SURVEYED BY A STATE OF FLORIDA PROFESSIONAL LAND SURVEYOR PRIOR TO BACK FILLING.
- 9. CONTRACTOR SHALL PERFORM, AT HIS OWN EXPENSE, ANY AND ALL TESTS REQUIRED BY THE SPECIFICATIONS AND/OR ANY AGENCY HAVING JURISDICTION. THESE TESTS MAY INCLUDE, BUT MAY NOT BE LIMITED TO, INFLITRATION AND EXFLITRATION, TELEVISION INSPECTION AND A MANDREL TEST ON CRAVITY SEWER. A COPY OF THE TEST RESULTS SHALL BE PROVIDED TO THE UTILITY PROVIDER, OWNER AND JURISDICTIONAL AGENCY AS REQUIRED.

EROSION CONTROL NOTES

- THE STORM WATER POLLUTION PREVENTION PLAN ("SWPPP") IS COMPRISED OF THIS EROSION CONTROL PLAN, THE STANDARD DETAILS, THE PLAN NARRATIVE, ATTACHMENTS INCLUDED IN SPECIFICATIONS OF THE SWPPP, PLUS THE PERMIT AND ALL SUBSEQUENT REPORTS AND RELATED DOCUMENTS.
- ALL CONTRACTORS AND SUBCONTRACTORS INVOLVED WITH STORM WATER POLLUTION PREVENTION SHALL OBTAIN A COPY OF THE STORM WATER POLLUTION PREVENTION PLAN AND THE STATE OF FLORIDA NATIONAL POLLUTIANT DISCHARGE ELIMINATION SYSTEM GENERAL PERMIT (NPDES PERMIT) AND BECOME FAMILIAR WITH THEIR CONTENTS.
- THE CONTRACTOR SHALL IMPLEMENT BEST MANAGEMENT PRACTICES AS REQUIRED BY THE SWPPP, ADDITIONAL BEST MANAGEMENT PRACTICES SHALL BE IMPLEMENTED AS DICTATED BY CONDITIONS AT NO ADDITIONAL COST TO THE OWNER THROUGHOUT ALL PHASES OF CONSTRUCTION.
- BEST MANAGEMENT PRACTICES (BMP'S) AND CONTROLS SHALL CONFORM TO FEDERAL, STATE, OR LOCAL REQUIREMENTS OR MANUAL OF PRACTICE, AS APPLICABLE, THE CONTRACTOR SHALL IMPLEMENT ADDITIONAL CONTROLS AS DIRECTED BY THE PERMITTING AGENCY OR OWNER.
- 5. EROSION CONTROL PLAN MUST CLEARLY DELINEATE ALL STATE WATERS, PERMITS FOR ANY CONSTRUCTION ACTIMITY IMPACTING STATE WATERS OR REGULATED WETLANDS MUST BE MAINTAINED ON SITE AT ALL TIMES.
- 6. THE CONTRACTOR SHALL MINIMIZE CLEARING TO THE MAXIMUM EXTENT PRACTICAL OR AS REQUIRED BY THE GENERAL PERMIT.
- 7. CONTRACTOR SHALL DENOTE ON PLAN THE TEMPORARY PARKING AND STORAGE AREA WHICH SHALL ALSO BE USED AS THE EQUIPMENT MAINTENANCE AND CLEANING AREA, EMPLOYEE PARKING AREA, AND AREA FOR LOCATING PORTABLE FACILITIES, OFFICE TRAILERS, AND TOILET FACILITIES.
- 8. ALL WASH WATER (CONCRETE TRUCKS, VEHICLE CLEANING, EQUIPMENT CLEANING. ETC.) SHALL BE DETAINED AND PROPERLY TREATED OR DISPOSED.
- 9. SUFFICIENT OIL AND GREASE ABSORBING MATERIALS AND FLOTATION BOOMS SHALL BE MAINTAINED ON SITE OR READILY AVAILABLE TO CONTAIN AND CLEAN-UP FUEL O CHEMICAL SPILLS AND LEAKS.
- 10. THE CONTRACTOR SHALL BE RESPONSIBLE FOR DUST CONTROL ON SITE. THE USE OF MOTOR OILS AND OTHER PETROLEUM BASED OR TOXIC LIQUIDS FOR DUST SUPPRESSION OPERATIONS IS PROVISITED.
- 11. RUBBISH, TRASH, GARBAGE, LITTER, OR OTHER SUCH MATERIALS SHALL BE DEPOSITED INTO SEALED CONTAINERS. MATERIALS SHALL BE PREVENTED FROM LEAVING THE PREMISES THROUGH THE ACTION OF WIND OR STORM WATER DISCHARGE INTO DRAINAGE DITCHES OR WATERS OF THE STATE.
- 12. ALL STORM WATER POLLUTION PREVENTION MEASURES PRESENTED ON THE PLAN SHALL BE INITIATED AS SOON AS PRACTICABLE.

EROSION CONTROL NOTES (CONT.)

- 13. STABILIZATION PRACTICES SHOULD BE INITIATED AS SOON AS PRACTICAL, BUT IN NO CASE MORE THAN 7 DAYS WHERE CONSTRUCTION HAS TEMPORARILY CEASED
- 14. DISTURBED PORTIONS OF THE SITE WHERE CONSTRUCTION ACTIVITY HAS PERMANENTLY STOPPED SHALL BE PERMANENTLY SEEDED. THESE AREAS SHALL BE SEEDED NO LATER THAN 7 DAYS AFTER THE LAST CONSTRUCTION ACTIVITY OCCURRED IN THESE AREAS, REFER TO SECTION 991 OF THE FOOT STANDARD SPECIFICATIONS FOR SEEDING AND MAINTENANCE REQUIREMENTS.
- 15. IF THE ACTION OF VEHICLES TRAVELING OVER THE GRAVEL CONSTRUCTION ENTRANCES IS NOT SUFFICIENT TO REMOVE THE MAJORITY OF DIRT OR MUD. THEN THE TIRES MUST BE WASHED BEFORE THE VEHICLES ENTER A PUBLIC ROAD, IF WASHING IS USED, PROVISIONS MUST BE MADE TO INTERCEPT THE WASH WATER AND TRAP THE
- 16. ALL MATERIALS SPILLED, DROPPED, WASHED, OR TRACKED FROM VEHICLES ONTO ROADWAYS OR INTO STORM DRAINS MUST BE REMOVED AS SOON AS POSSIBLE.
- THE CONTRACTOR SHALL BE RESPONSIBLE FOR REMOVING SEDIMENT IN THE DETENTION POND AND ANY SEDIMENT THAT MAY HAVE COLLECTED IN THE STORM SEWER DRAIMAGE SYSTEMS IN CONJUNCTION WITH THE STABILIZATION OF THE SITE.
- 18. ON-SITE & OFF SITE SOIL STOCKPILE AND BORROW AREAS SHALL BE PROTECTED FROM EROSION AND SEDIMENTATION THROUGH IMPLEMENTATION OF BEST MANAGEMENT PRACTICES. STOCKPILE AND BORROW AREA LOCATIONS SHALL BE NOTED ON THE EROSION CONTROL PLAN AND PERMITTED IN ACCORDANCE WITH GENERAL PERMIT
- SLOPES SHALL BE LEFT IN A ROUGHENED CONDITION DURING THE GRADING PHASE TO REDUCE RUNOFF VELOCITIES AND EROSION.
- 20. DUE TO GRADE CHANGES DURING THE DEVELOPMENT OF THE PROJECT, THE CONTRACTOR SHALL BE RESPONSIBLE FOR ADJUSTING THE EROSION CONTROL MEASURES (SILT FENCES, ETC.) TO PREVENT EROSION.
- 21. ALL CONSTRUCTION SHALL BE STABILIZED AT THE END OF EACH WORKING DAY, THIS NOLUDES BACK FILLING OF TRENCHES FOR UTILITY CONSTRUCTION AND PLACEMENT OF GRAVEL OR BITUMNOUS PAVING FOR ROAD CONSTRUCTION.

MAINTENANCE

ALL MEASURES STATED ON THE EROSION AND SEDIMENT CONTROL PLAN, AND IN THE ALL MEASURES STATED ON THE EROSION AND SEDIMENT CONTROL PLAN, AND IN THE STORM MATER POLLUTION PREVENTION PLAN, SHALL BE MAINTAINED IN FULLY FUNCTIONAL CONDITION UNTIL NO LONGER REQUIRED FOR A COMPLETED PHASE OF WORK OR FINAL STABILIZATION OF THE STEET, ALL EROSION AND SEDIMENTATION CONTROL MEASURES SHALL BE CHECKED BY A QUALIFIED PERSON AT LEAST ONCE EVERY SEVEN CALLENDAR DAYS AND WITHIN 24 HOURS OF THE END OF A 0.5" RAINFALL EVENT, AND CLEANED AND REPAIRED IN ACCORDANCE WITH THE

- 1. INLET PROTECTION DEVICES AND BARRIERS SHALL BE REPAIRED OR REPLACED IF THEY SHOW SIGNS OF UNDERMINING, OR DETERIORATION.
- 2. ALL SEEDED AREAS SHALL BE CHECKED REGULARLY TO SEE THAT A GOOD STAND IS MAINTAINED. AREAS SHOULD BE FERTILIZED, WATERED AND RESEEDED AS NEEDED. FOR MAINTENANCE REQUIREMENTS REFER TO SECTION 981 OF THE STANDARD SPECIFICATIONS.
- SILT FENCES SHALL BE REPAIRED TO THEIR ORIGINAL CONDITIONS IF DAMAGED.
 SEDIMENT SHALL BE REMOVED FROM THE SILT FENCES WHEN IT REACHES
 ONE-HALF THE HEIGHT OF THE SILT FENCE.
- THE CONSTRUCTION ENTRANCES SHALL BE MAINTAINED IN A CONDITION WHICH
 WILL PREVENT TRACKING OR FLOW OF MUD ONTO PUBLIC RIGHTS-OF-WAY. THIS
 MAY REQUIRE PERIODIC TOP DRESSING OF THE CONSTRUCTION ENTRANCES AS
 CONSTRUCTION FOR THE MODEL

 OF THE CONSTRUCTION ENTRANCES.
- 5. THE TEMPORARY PARKING AND STORAGE AREA SHALL BE KEPT IN GOOD CONDITION (SUITABLE FOR PARKING AND STORAGE). THIS MAY RECUIRE PERIODIC TOP DRESSING OF THE TEMPORARY PARKING AS CONDITIONS DEMAND.
- OUTLET STRUCTURES IN THE SEDIMENTATION BASINS SHALL BE MAINTAINED IN OPERATIONAL CONDITIONS AT ALL TIMES, SEDIMENT SHALL BE REMOVED FROM SEDIMENT BASINS OR TRAPS WHEN THE DESIGN CAPACITY HAS BEEN REDUCED.
- 7 ALL MAINTENANCE OPERATIONS SHALL BE DONE IN A TIMELY MANNER BUT IN NO

TYPICAL ENGINEER OBSERVATIONS

CONTRACTOR SHALL NOTIFY ENGINEER 48 HOURS IN ADVANCE OF THE FOLLOWING

- PRE-CONSTRUCTION MEETING
- SUBGRADE PREPARATION
- BASE INSTALLATION - ASPHALT INSTALLATION
- UNDERGROUND PIPING AND UTILTIES INSTALLATION
 INSTALLATION OF STRUCTURES, DDCV, HYDRANTS, METERS, ETC.
- SIDEWALK INSTALLATION
- CONNECTIONS TO WATER AND SEWER MAINS TESTS OF UTILITIES

3RD PARTY TEST REPORTS REQ'D

TEST REPORTS REQUIRED FOR CLOSE OUT INCLUDE, BUT ARE NOT LIMITED TO:

- DENSITY TEST REPORTS
- BACTERIOLOGICAL TESTS OF WATER SYSTEM
 PRESSURE TEST OF WATER/SEWER
 LEAK TESTS ON SEWER SYSTEM AND GREASE TRAPS
- ANY OTHER TESTING REQUIRED BY THE AGENCY

THE PRESENCE OF ROCK SHOULD BE ANTICIPATED

THIS PROJECT. CONTRACTOR'S BID SHALL

VICLUDE CONSIDERATION FOR ADDRESSING THIS

BOLLE

ALERT TO CONTRACTOR:

THE PRESENCE OF GROUNDWATER SHOULD BE ANTICIPATED ON THIS PROJECT, CONTRACTOR'S I SHALL INCLUDE CONSIDERATION FOR THIS ESUEL WHEN PERFORMING GRADING OPERATIONS UNITED PERFORMENT OF WET WEATHER, PROVIDE ACQUAITE DEWATERING, DRAINAGE AND GROUND VATER MANAGEMENT TO CONTROL MOISTURE OF SOILS. REFER TO MASTER SITE SPECIFICATION

ALL WIM GENERAL CONTRACTOR WORK TO BE COMPLETED (EARTHWORK, FINAL UTILITIES, AND FI GRADING) BY THE MILESTONE DATE IN PROJECT DOZUMENTS, OUTLOT AREA TO BE KEPT FREE OF JOB TRAILERS AND STORAGE AFTER THE CONTRACT MILESTONE DATE FOR THE OUTLOT. WI

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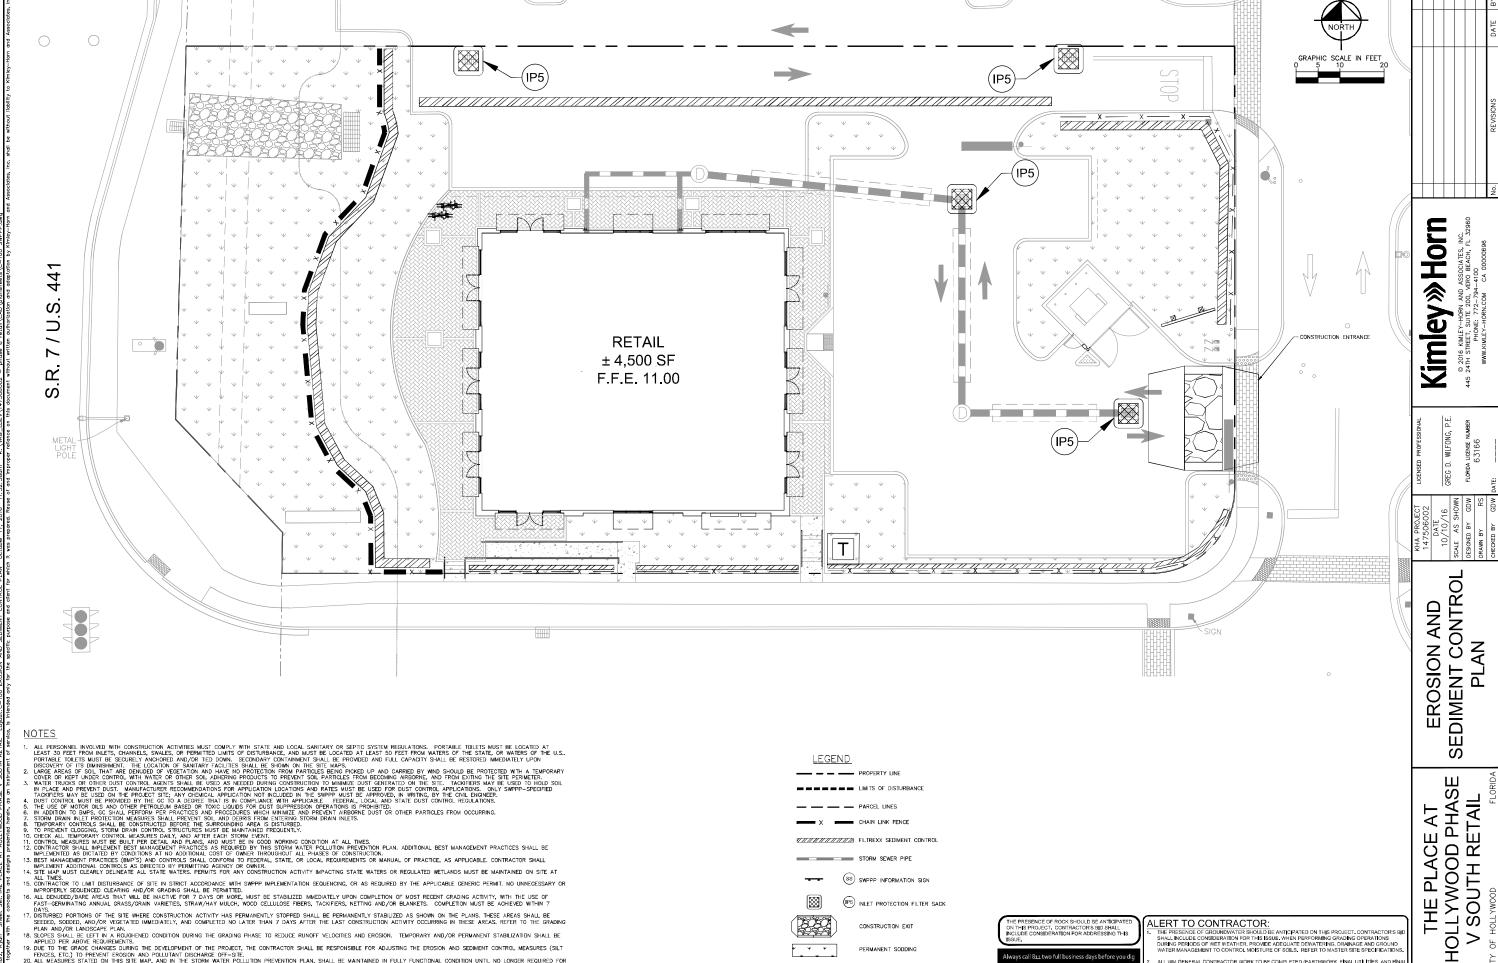
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SHEET NUMBER C-001

GENERAL CONTRACTOR TO PROVIDE CLEAR ACCESS FOR OUTLOT CONTRACTOR TO THE SPEC PARCEL AT ALL TIMES AFTER MILESTONE DATE, PURCHASER OF OUTLOT TO PROVIDE PERMIT DOCUMENTS AND SWPPP REQUIRED BY STATELOCAL REQUIREMENTS FOR SPECIFIC OUTLOT.



- FAST-GERMINATING ANNUAL GRASS/GRAIN VARIETIES, STRAW/HAY MULCH, WOOD CELLULOSE FIBERS, TACKFIERS, NETTING AND/OR BLANKETS. COMPLETION MUST BE ACHEVED WITHIN 7
 DAYS.

 7. DISTURBED PORTIONS OF THE SITE WHERE CONSTRUCTION ACTIVITY HAS PERMANENTLY STOPPED SHEEP, SCIDED, AND/OR VEGETATED IMMEDIATELY, AND COMPLETED NO LATER THAN 7 DAYS AFTER THE LAST CONSTRUCTION ACTIVITY OCCURRING IN THESE AREAS. REFER TO THE GRADING PLAN AND/OR LANDSCAPE PLAN.

 8. SLOPES SHALL BE LETE IN A ROUGHNED CONDITION DURING THE GRADING PHASE TO REDUCE RUNOFF VELOCITIES AND EROSION. TEMPORARY AND/OR PERMANENT STABILIZATION SHALL BE APPLIED FOR ABOVE REQUIREMENTS.

 9. DUE TO THE GRADE CHANGES DURING THE DEVELOPMENT OF THE PROJECT, THE CONTRACTOR SHALL BE RESPONSIBLE FOR ADJUSTING THE EROSION AND SEDIMENT CONTROL MEASURES (SILT FENCES, ETC.) TO PREVENT EROSION AND POLLUTANT DISCHARGE OFF-SITE.

 9. ALL MEASURES STATED ON THIS SITE MAP, AND IN THE STORM WATER POLLUTION PREVENTION PLAN, SHALL BE MAINTAINED IN FULLY FUNCTIONAL CONDITION UNTIL NO LONGER REQUIRED FOR A COMPLETED PHASE OF WORK OR FINAL STRABILIZATION OF THE SITE. ALL EROSION AND SEDIMENTATION CONTROL MEASURES SHALL BE CHECKED BY A QUALIFIED PERSON IN ACCORDANCE WITH THE CONTRACT DOCUMENTS OR THE APPLICABLE PERMIT, WHICHEVER IS MORE STRINGENT, AND REPARRED IN ACCORDANCE WITH THE STOPPLICATE PERMIT, HIS EXPLICABLE PERMIT, WHICHEVER IS MORE STRINGENT, AND REPARRED IN ACCORDANCE WITH THE STOPPLICABLE PERMIT, WHICHEVER IS MORE STRINGENT, AND REPARRED IN ACCORDANCE WITH THE STOPPLICABLE PERMIT, WHICHEVER IS MORE STRINGENT, AND REPARRED IN ACCORDANCE WITH THE STEP PLANT. THE STOPPLICABLE PERMIT HIS STEP LAND.

 21. STORM WATER POLLUTANT CONTROL MEASURES INSTALLED DURING CONSTRUCTION, THAT WILL ALSO PROVIDE STORM WATER MANGEMENT BEHEFITS AFTER CONSTRUCTION, ARE INCLUDED IN THE CONTRACT DOCUMENTS. THE STEP-SPECIFIC POST CONSTRUCTION STORM WATER POLLUTANT ENDITION FINAL PROJECT INSPECTION AND APPROVAL.


 22. ALL CONTROLS AND SYSTEMS MUST BE INSTALLED AND FUNCTIONING AS DESIGNED AND FREE OF ACCUM

SS SWPPP INFORMATION SIGN IP5 INLET PROTECTION FILTER SACK CONSTRUCTION EXIT PERMANENT SODDING

ALERT TO CONTRACTOR:

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IODS OF WET WEATHER, PROVIDE ADEQUATE DEWATERING, DRAINING OFERATIONS AGEMENT TO CONTROL MOISTURE OF SOILS. REFER TO MASTER SITE SPECIFICATION

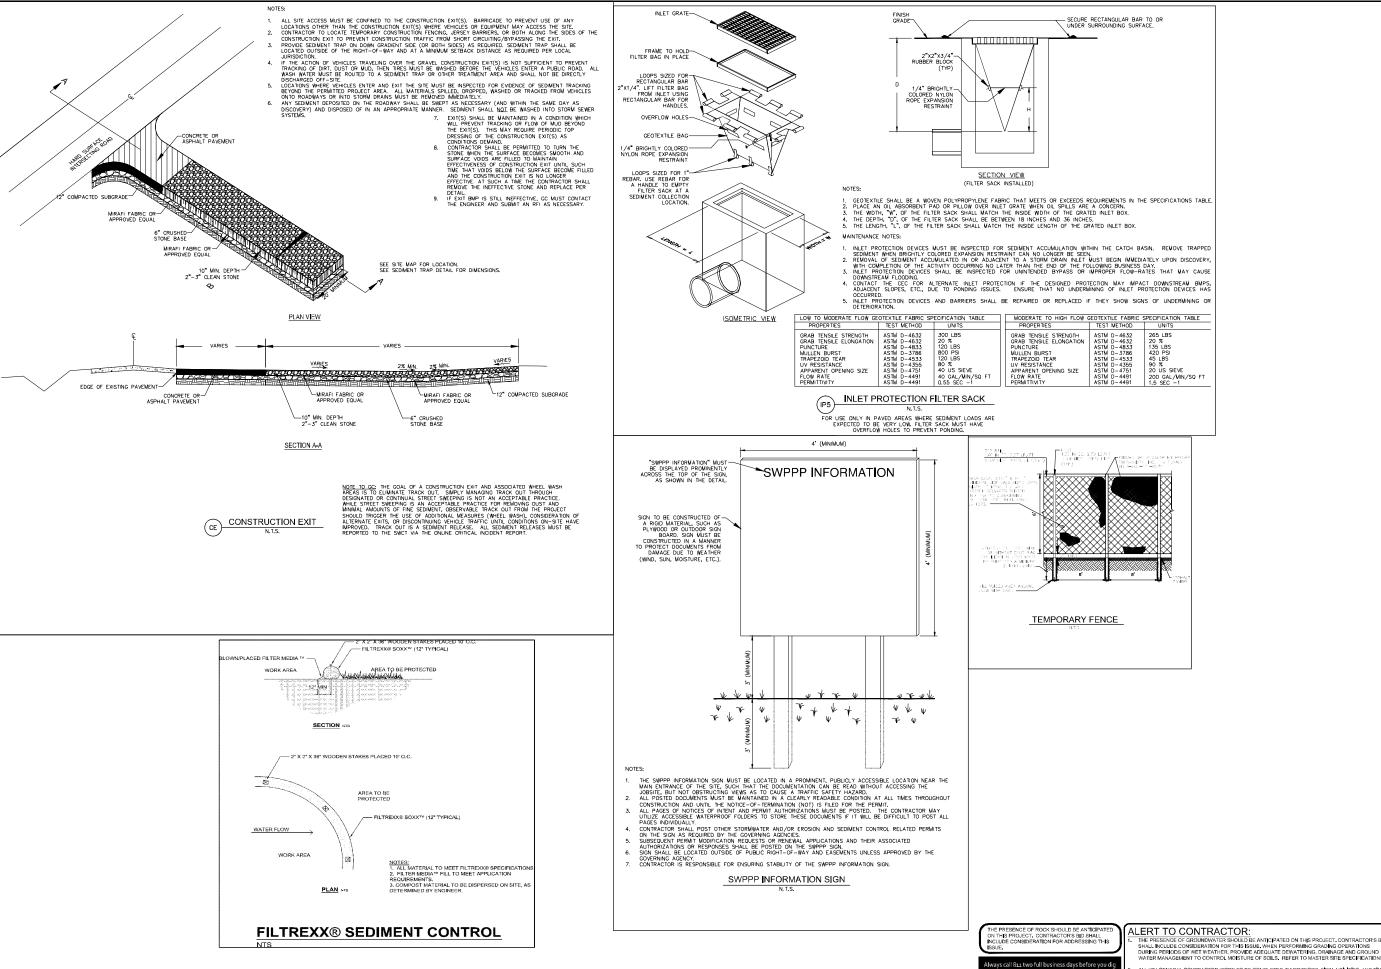

ETAIL $\overline{\Box}$ **SWPPP PHASE** HOLLYWOOD PHA V SOUTH RETAII Υ PLACE

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Kimley » Horn


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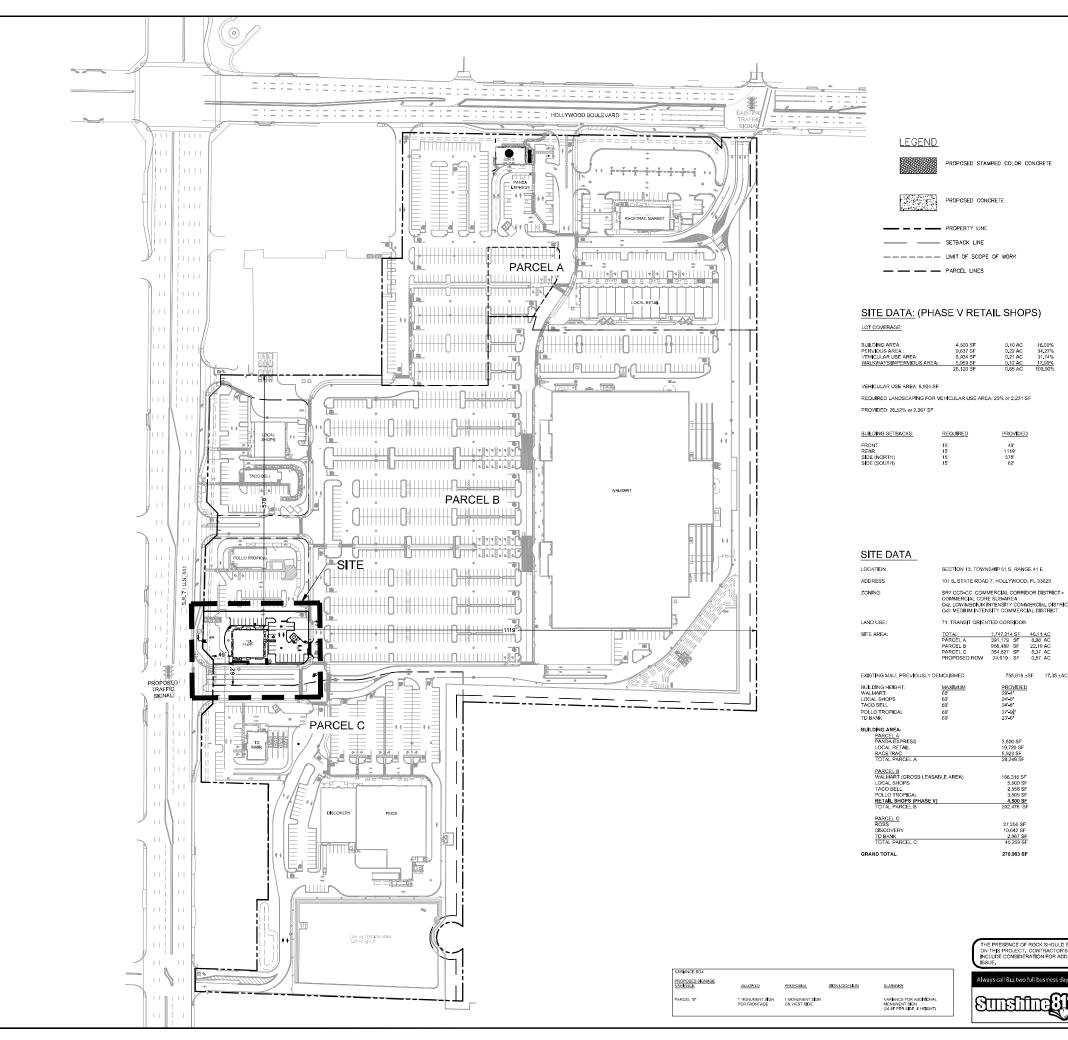
WILFONG, P.E.

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Sunslifine [1] com





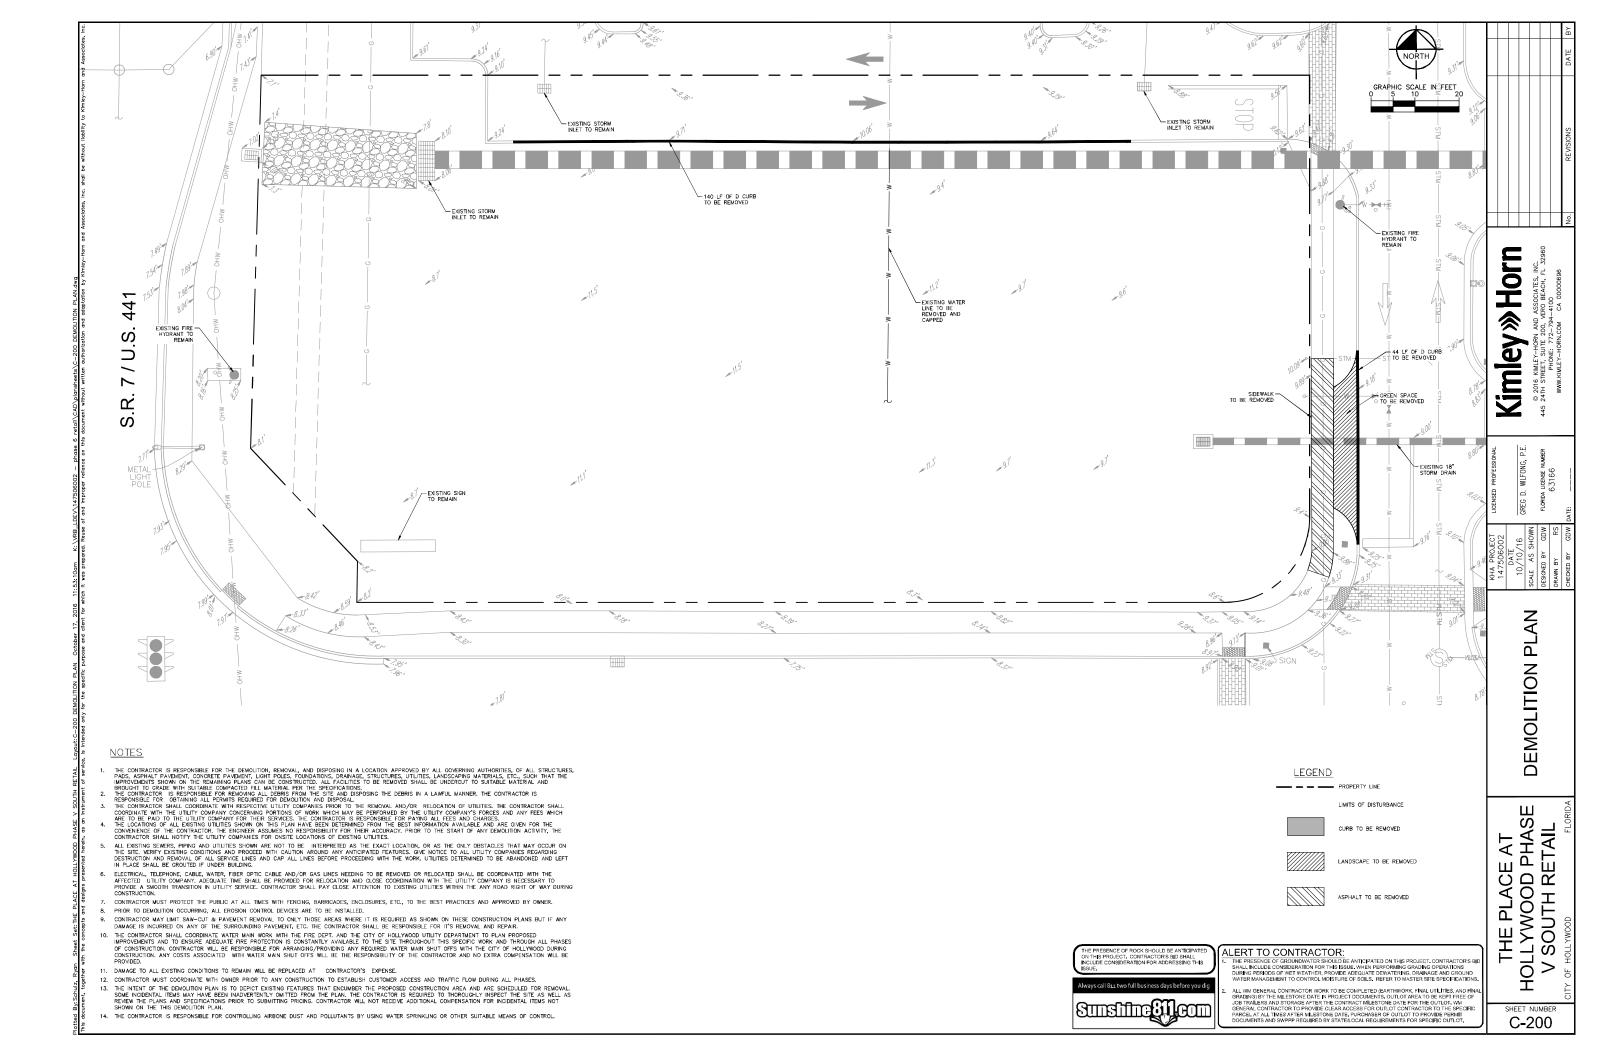

PARCELS 'A', 'B' AND 'C', 'HOLLYWOOD PLAZA' ACCORDING TO THE PLATTHEREFORE, AS RECORDED IN PLAT BOOK 181, PAGE 12, OF THE PUBLIC RECORDS OF BROWARD COUNTY, FLORIDA.

SECTION 13, TOWNSHIP 51 S, RANGE 41 E ADDRESS: 333 S, STATE ROAD 7, HOLLYWOOD, FL 33023 ZONING: SR7 CCD-CC: COMMERCIAL CORRIDOR DISTRICT -COMMERCIAL CORE SUB-AREA
C-2: LOW/MEDIUM INTENSITY COMMERCIAL DISTRICT
C-3: MEDIUM INTENSITY COMMERCIAL DISTRICT

NET AREA: 1,747,214 SF OR 40,11 AC

NOTES:
-THE MAXIMUM FOOT-CANDLE LEVEL AT PROPERTY LINES (MAXIMUM 0.5 ADJACENT TO RESIDENTIAL.
-ALL MECHANICAL EQUIPMENT SHALL BE PROPERLY SCREENED FROM PUBLIC VIEW,
-ALL SIGNAGE WILL BE COMPLIANT WITH ZONING AND LAND DEVELOPMENT REGULATIONS.

BUILDING AREA: PERVIOUS AREA:	4,500 SF 9,637 SF	0.10 AC 0.22 AC	16.00% 34.27%
VEHICULAR USE AREA:	8,924 SF	0.21 AC	31.74%
WALKWAYS/MPERVIOUS AREA:	5,059 SF	D,12 AC	17,99%
	28,120 SF	0.65 AC	100.00%

PARCEL A (391,179 SF)

CURRENTLY PROPOSED N/A N/A N/A N/A APPROVED 5,928 SF/ 0.14 AC 73,314 SF/ 1.68 AC

PARCEL B (966,489 SF)

PREVIOUSLY <u>APPROVED</u> 197,976 SF/ 4.46 AC 24,327 SF/ 0.56 AC 571,799 SF/ 13.21 AC 172,387 SF/ 3.96 AC CURRENTLY PROPOSED 202,476 SF/ 4.65 AC 0 SF/ 0.00 AC 581,989 SF/ 13.36 AC 182,024 SF/ 4.18 AC BUILDING AREA: FUTURE DEVELOPMENT AREA: IMPERVIOUS AREA: PERVIOUS AREA: PARCEL C (364,627 SF) PREVIOUSLY CURRENTLY PROPOSED N/A N/A N/A N/A APPROVED 40.259 SF/0.92 AC BUILDING AREA: FUTURE DEVELOPMENT AREA: IMPERVIOUS AREA: PERVIOUS AREA:

0 SF/ 0.00AC 217,592 SF/5,00AC 106,776 SF/2.45AC

BUILDING SETBACKS: PHASE II PROVIDED REQUIRED PARCEL A FRONT PARCEL B FRONT REAR SIDE (SOUTH) SIDE (NORTH) PARCEL C FRONT REAR SIDE (SOUTH) SIDE (NORTH)

THE PRESENCE OF GROUNDWATER SHOULD BE ANTICIPATED ON THIS PROJECT, CONTRACTOR'S B SHALL INCLUDE CONSIDERATION FOR THIS ISSUE, WHEN PERFORMING GRADING OPERATIONS DURING PERIODS OF WET WEATHER, PROVIDE ADQUATE DEWARTENIS, DRAINAGE AND GROUND WATER MANAGEMENT TO CONTROL MOISTURE OF SOILS, REFER TO MASTER SITE SPECIFICATION:

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ALERT TO CONTRACTOR:

SHEET NUMBER C-300

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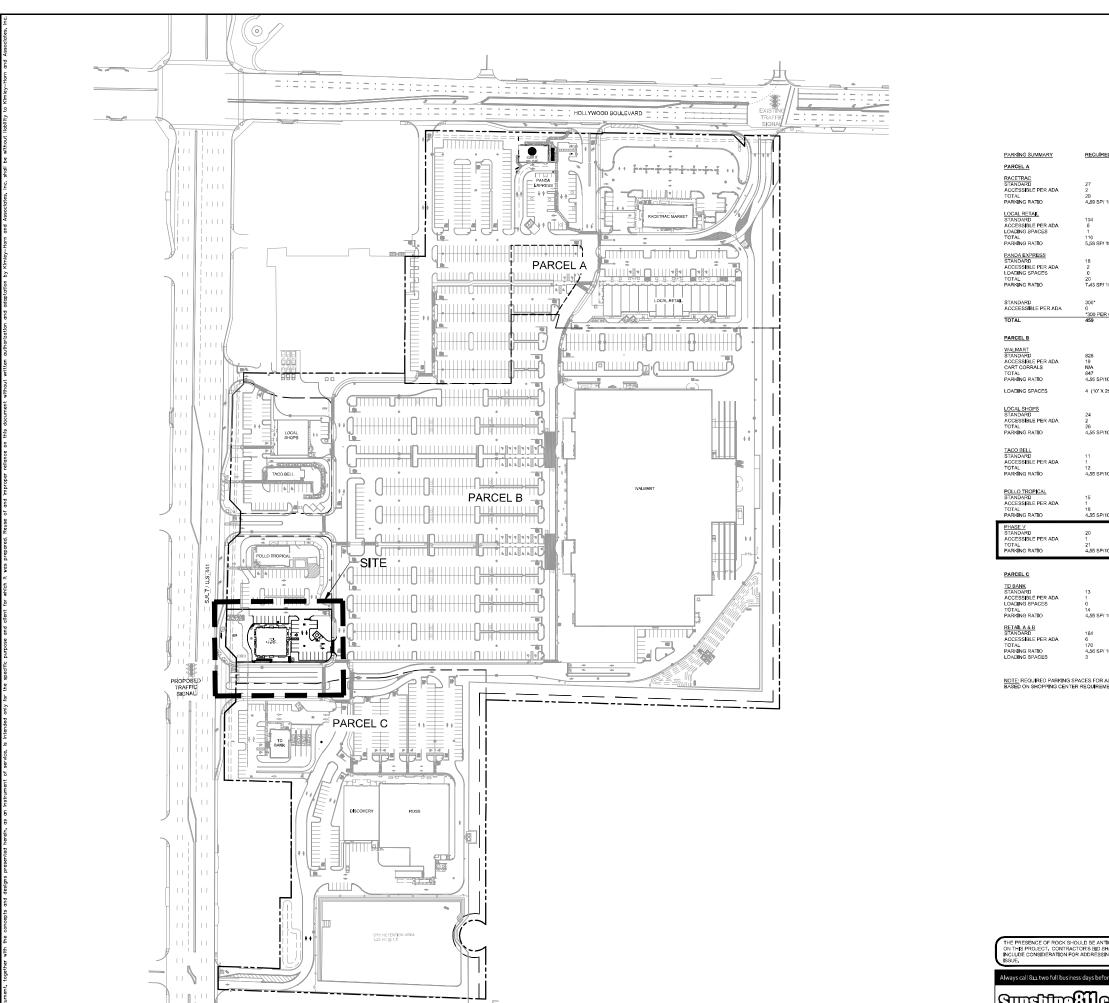
WLFONG, P.E.

PLAN SITE OVERALL

HOLLYWOOD PHASE V SOUTH RETAIL

ΑT

THE PLACE





PROVIDED 300 PER CROSS PARKING AGREEMENT

29 (NOT INCLUDED IN TOTAL) 4 (10' X 25') 6 (10' X 130')

37 10.56 SP/1000 SF 4.55 SP/1000 SF

PHASE V		
STANDARD	20	24
ACCESSIBLE PER ADA	1	1
TOTAL	21	25
PARKING RATIO	4.55 SP/1000 SF	5.55 SP/1000 SF

TD BANK		
STANDARD	13	28
ACCESSIBLE PER ADA	1	2
LOADING SPACES	0	0
TOTAL	14	30
PARKING RATIO	4.55 SP/ 1000 SF	10.11 SP/ 1000 SF
RETAIL A & B		
STANDARD	164	164
ACCESSIBLE PER ADA	6	6
TOTAL	170	170
PARKING RATIO	4.56 SP/ 1000 SF	4.56 SP/ 1000 SF

OVERALL PARKING PLAN

Kimley » Horn


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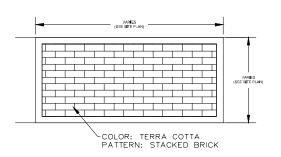
GREG D. WLFONG, P.E.

THE PLACE AT HOLLYWOOD PHASE V SOUTH RETAIL


ALERT TO CONTRACTOR:

1. THE PRESENCE OF GROUNDWATER SHOULD BE A SHALL INCLUDE CONSIDERATION FOR THIS ISSUE




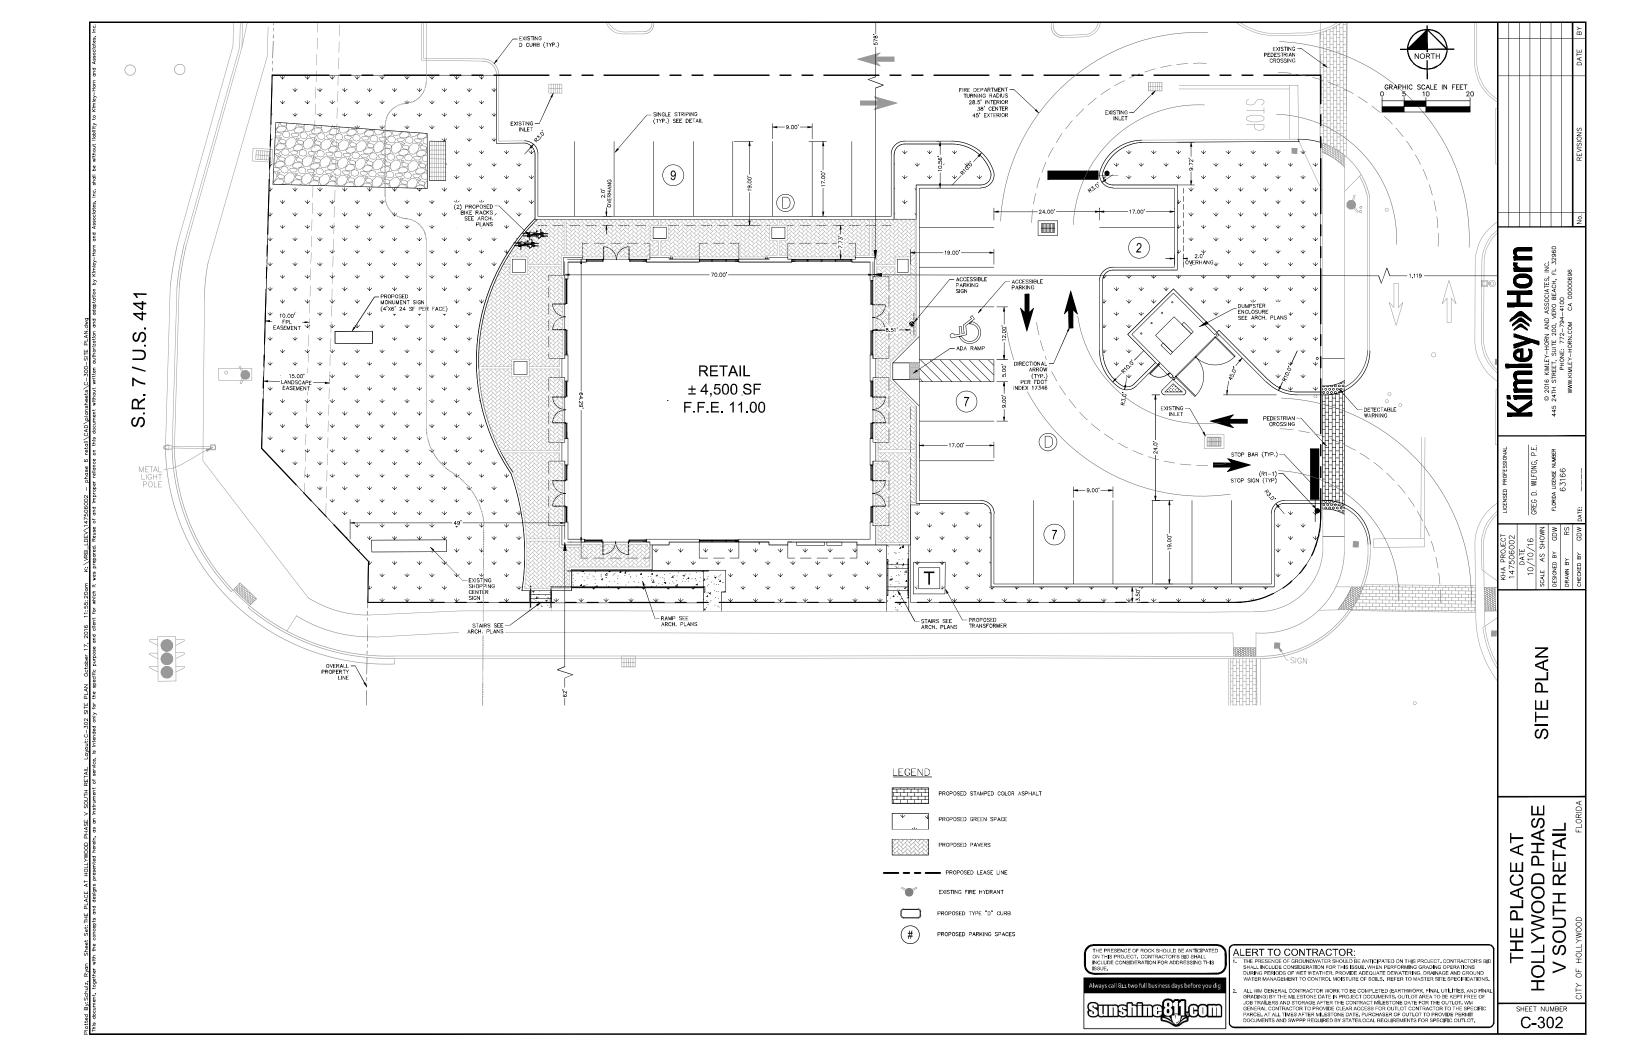


STAMPED COLORED ASPHALT DETAIL PROVIDED BY KIMLEY-HORN AND ASSOC.

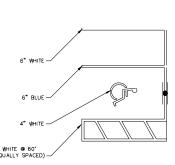



ADA PARKING STALL STRIPING

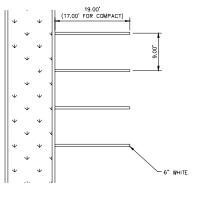


PARKING STALL STRIPING

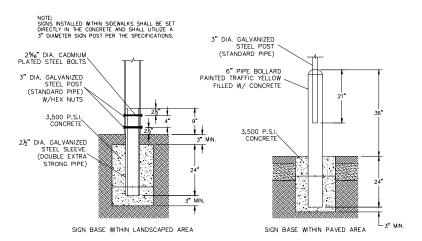


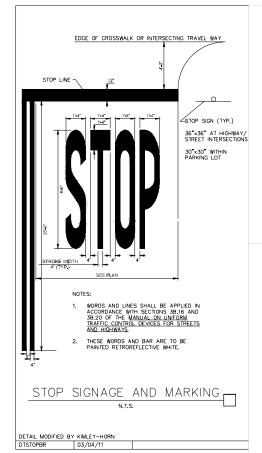

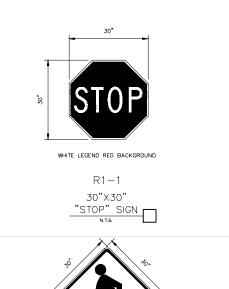


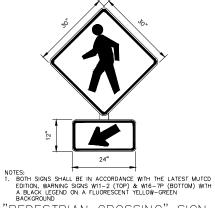




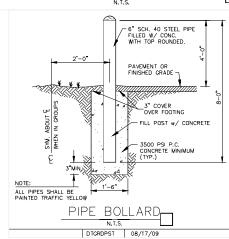


SIGN BASE

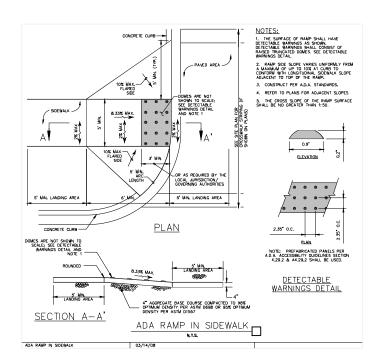

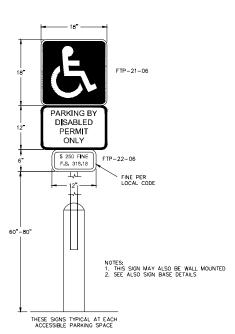



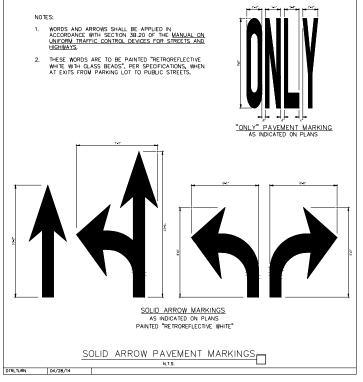



ALERT TO CONTRACTOR:

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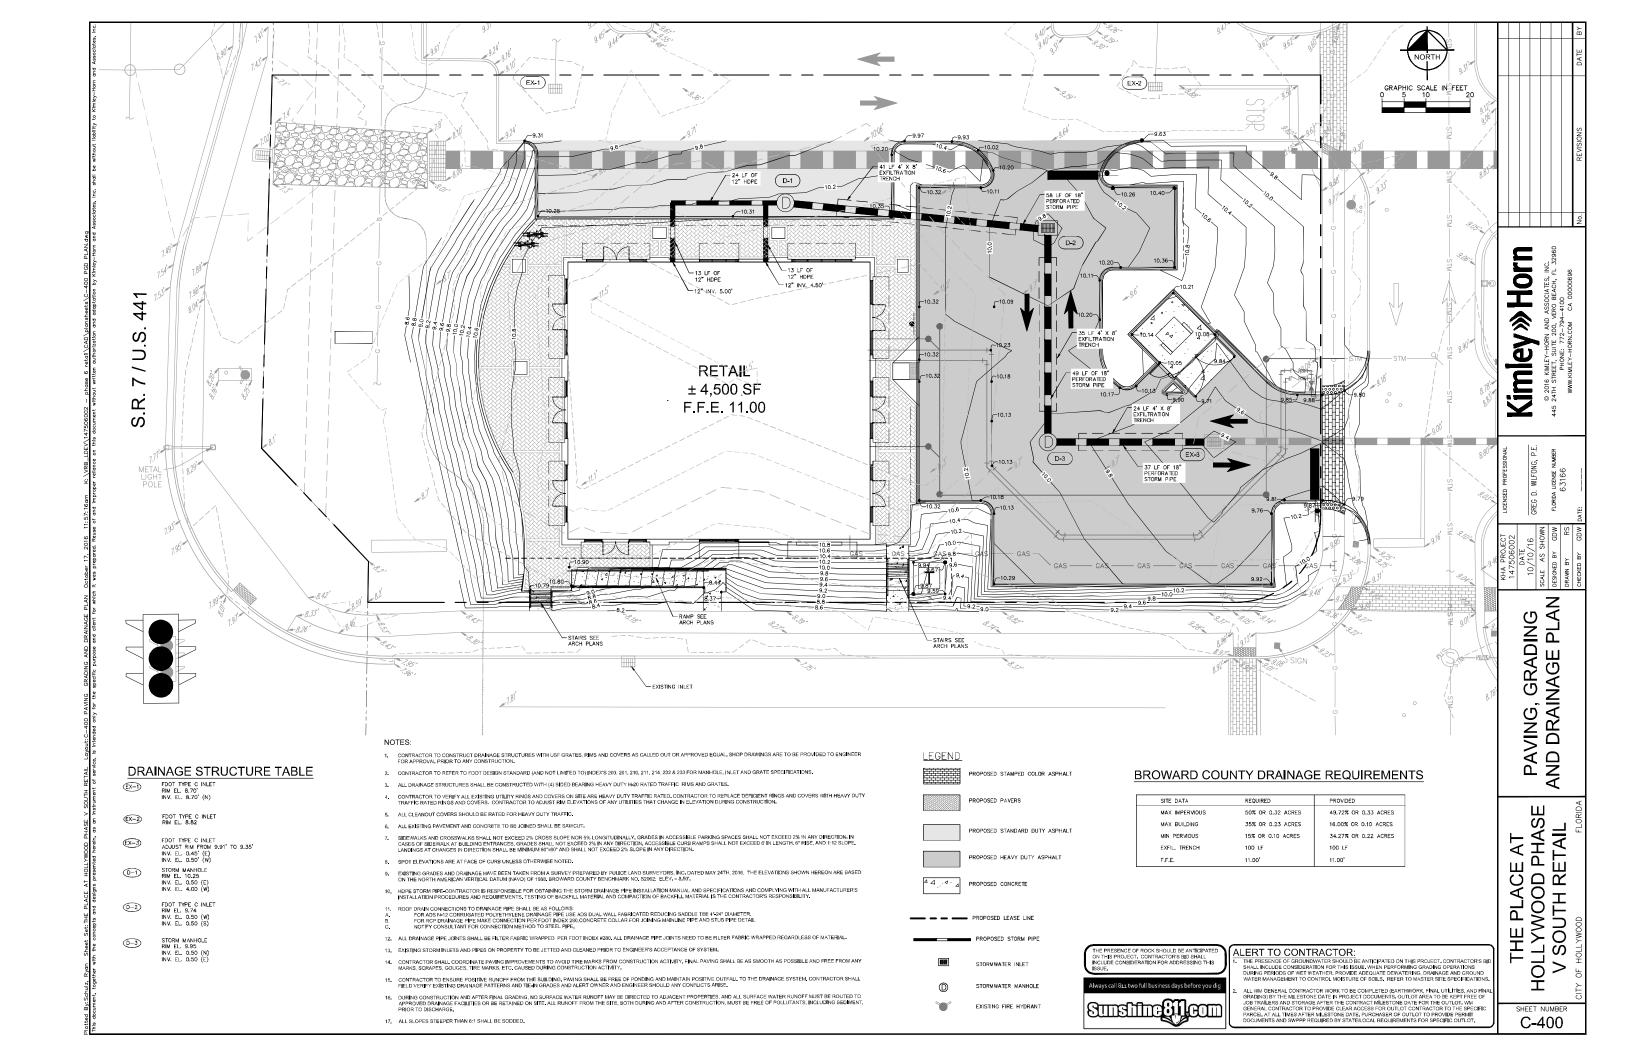
THE PLACE AT HOLLYWOOD PHASE V SOUTH RETAIL

SHEET NUMBER C-303


Kimley » Horn © 2016 KIMLEY 445 24TH STREET, ' PHON WWW.KIMLEY-GREG D. WILFONG, P.E.

> **DETAILS** PLAN

SITE



STANDARD ASPHALT PAVING

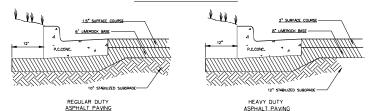


PC CONCRETE 7" PCC SURFACE COURSE

4" (FREE DRAINING)" BASE COURSE (MIN LBR 100) -4" (FREE DRAINING)* STABILIZED SUBGRADE (MIN LBR 40)

CONCRETE PAYING


- (*) BASE AND STABULZED SUBGRADE COURSES BENEATH CONCRETE PAVEMENT SHALL HAVE A MINIMUM PERMEABILITY (K) GREATER THAN OR EQUAL TO GLODY-Job. BASE AND SUBGRADE MATERIALS SHOULD BE COMPACTED TO AT LEAST 88% OF THE MATERIALS MODIFIED PROCICIOR (MASHIDI **) 1807 / ASTIMUM DESTY DENSIVAD
- FOR LIMEROCK, COQUINA, BANKRUN SHELL OR CRUSHED CONCRETE, MIN. LBR=100. FOR SOIL CEMENT BASE, MIN. (7) DAY COMPRESSIVE STRENGTH=300 PSI.

CONTROL JOINTS FOR CRACK CONTROL SHOULD BE CLOSELY SPACED, BETWEEN 8 TO 12 FEET APART. CONTROL JOINTS SHOULD BE PROVIDED IN A UNFORM SQUARE OR RECEIVANCIAN PATTERN. THE JOINTS SHOULD BE SUBIRITIED FOR REVIEW AND APPROVED PROF. AND APPROVED P

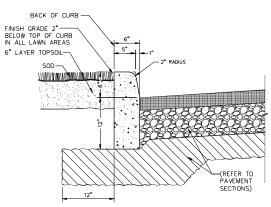

MODIFIED TYPE "D" CURB DETAIL

DETAIL PROVIDED BY KIMLEY-HORN AND ASSOCIATES, INC.

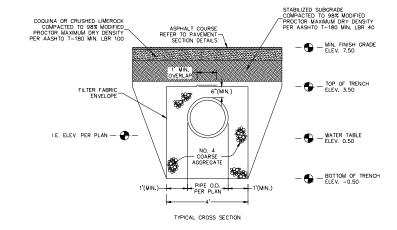

2

LONGITUDINAL SECTION

-NO. 4 COARSE AGGREGATE

FILTER FABRIC ENVELOPE

COUPLING BAND

PERFORATED PIPE-

NOTES:

1. PIPE INVERT SHOULD BE AT OR ABOVE THE WATER TABLE WHENEVER POSSIBLE.

2. THE CONTRACTOR SHALL TAKE THE NECESSARY PRECAUTIONS TO PREVENT CONTAMINATION OF THE TRENCH WITH SAND, SLIT AND FOREIGN MATERIALS.

3. THE 12" DIAMETER WERP HOLE SHALL BE ELIMINATED, WHEN THE BOTTOM OF THE INLET IS BELOW THE NORMAL WATER TABLE, UNLESS OTHERWISE SHOWN IN THE PLANS.


-8' NONPERFORATED PIPE

NO. 4 COARSE AGGREGATE

FILTER FABRIC ENVELOPE

-INLET OR MANHOLE (SEE PLAN)

EXFILTRATION TRENCH

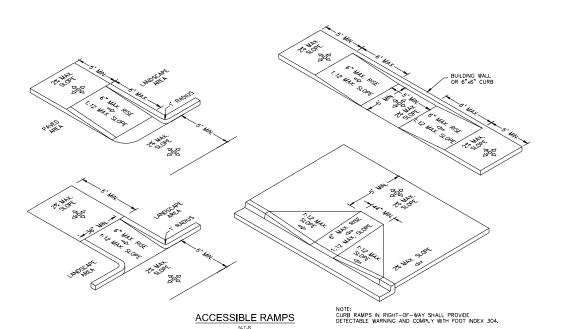

ALERT TO CONTRACTOR:

LENT I O CONTRACTOR.

THE PRESENCE OF GROUNDWATER SHOULD BE ANTICIPATED ON THIS PROJECT. CONTRACTOR'S BY SHALL INCLUDE CONSIDERATION FOR THIS ISSUE, WHEN PERFORMING GRADING OPERATIONS DURING PERFOCS OF WET WEATHER, PROVIDE ADQUATE DEWATERION, DRAINAGE AND GROUND WATER MANAGEMENT TO CONTROL MOISTURE OF SOLS. REFER TO MASTER SITE SPECIFICATIONS

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HOLLYWOOD PHASE V SOUTH RETAIL


THE PLACE AT


PERFORATED PIPE


Kimley » Horn © 2016 KIMLEY 445 24TH STREET, ' PHON WWW.KIMLEY-


GREG D. WILFONG, P.E.


PAVING, GRADING AND DRAINAGE DETAILS

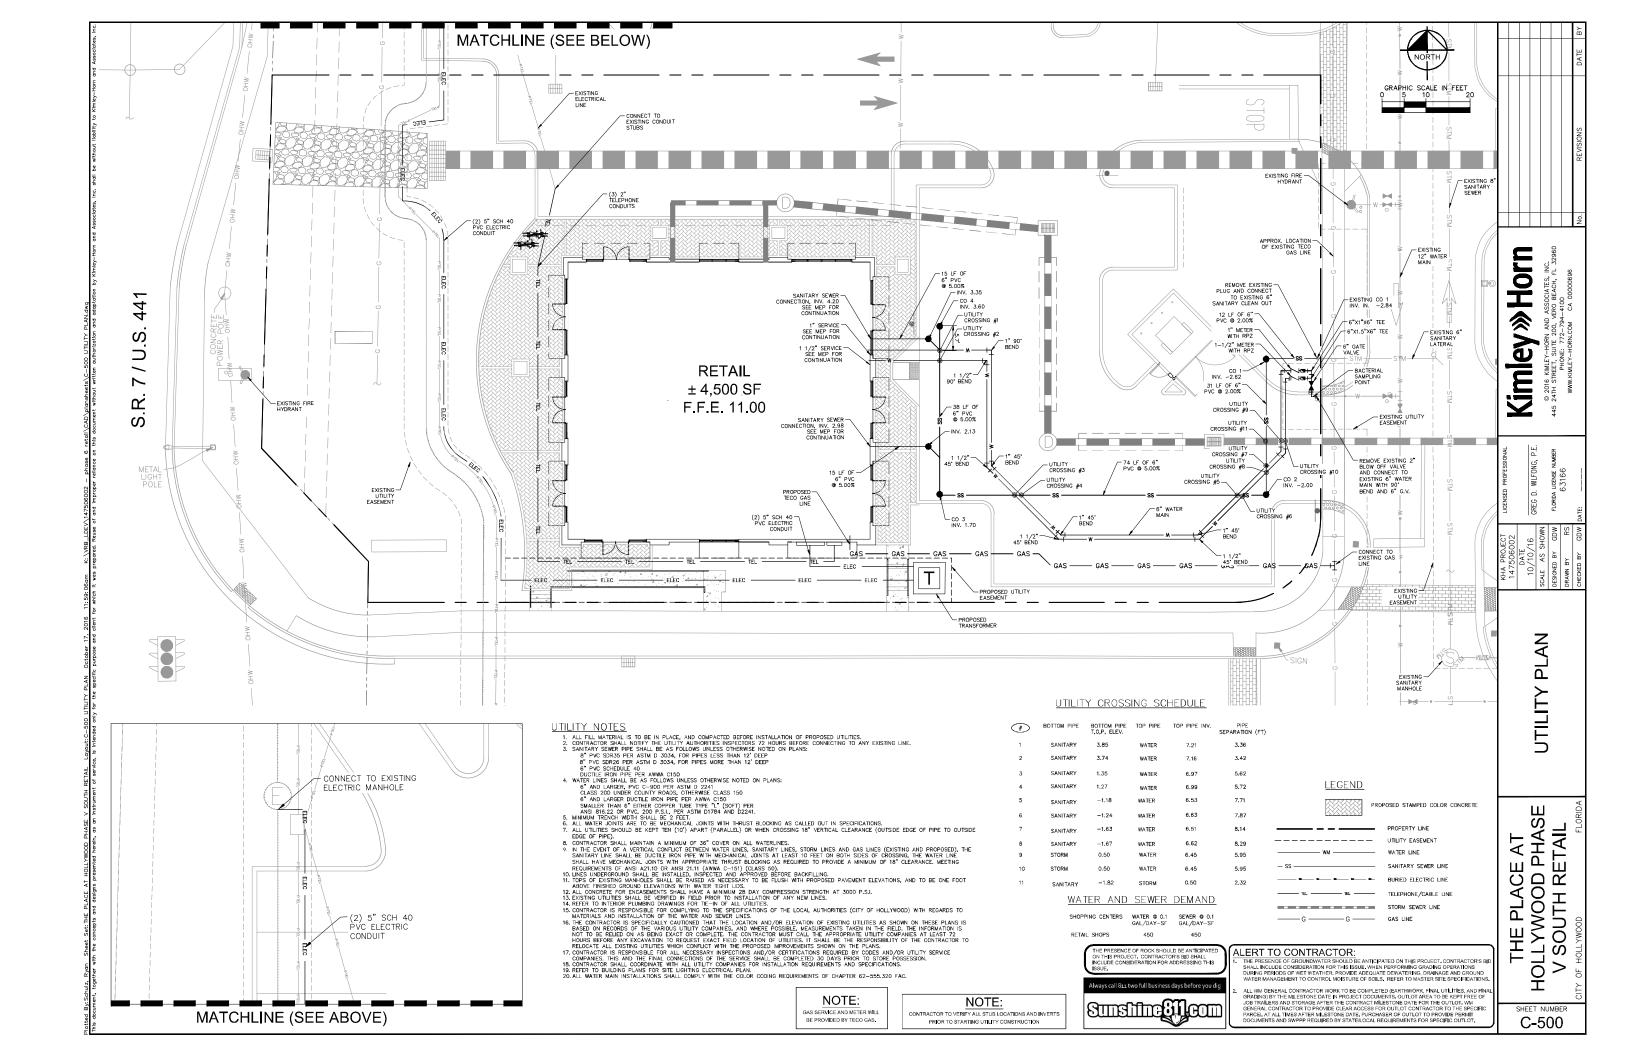


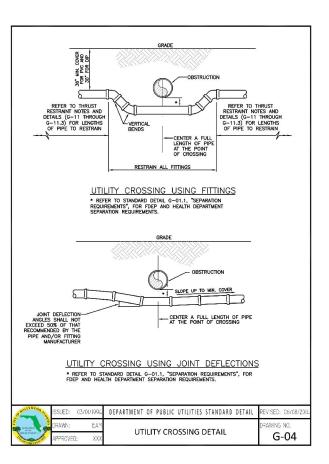


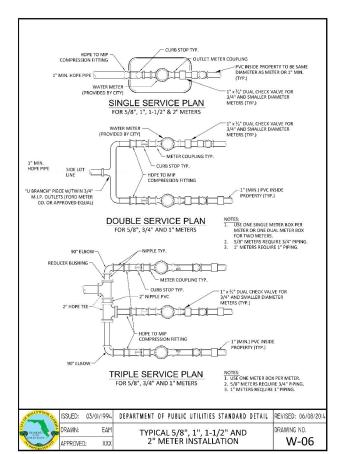


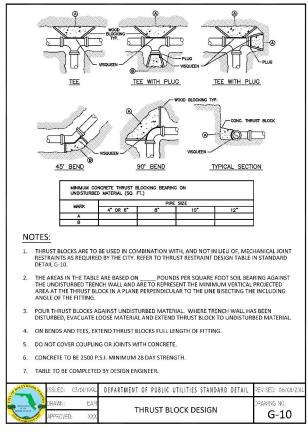

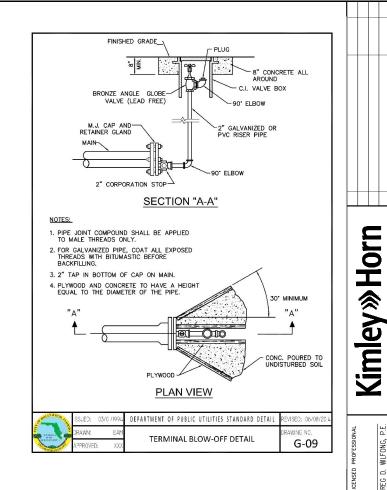

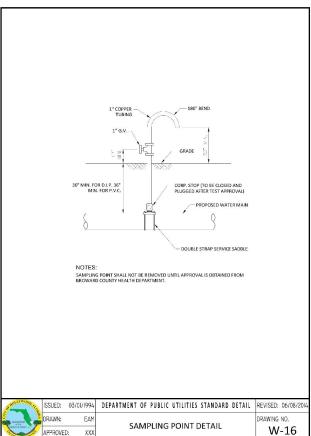

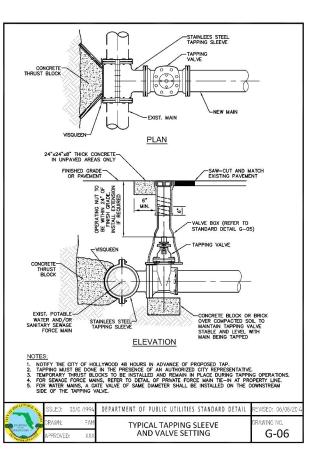

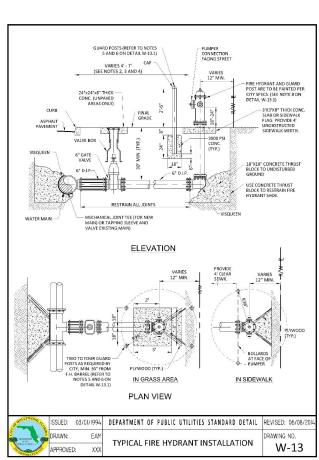



ALERT TO CONTRACTOR:

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HOLLYWOOD PHASE V SOUTH RETAIL THE PLACE AT

CITY OF HOLLYWOOD STANDARD POTABLE WATER DETAILS

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WILFONG, P.E.

WATER MAIN TESTING AND DISINFECTION NOTES:


- NO CONNECTIONS TO THE EXISTING LINES SHALL BE MADE UNTIL THE PRESSURE AND BACTERIOLOGICAL TESTS HAVE BEEN PERFORMED ON THE PROPOSED WATER MAINS AND THE SYSTEM HAS BEEN APPROVED BY THE CITY OF HOLLYWOOD AND THE BROWARD COUNTY HEALTH DEPARTMENT.
- THE PRESSURE TEST SHALL BE PERFORMED FOR 2 HOURS AT A CONSTANT PRESSURE OF 150 PSI AND IN ACCORDANCE WITH RULE 62-555.330 (FAC) C600 AWWA LATEST REVISION, EXCEPT AS OTHERWISS SPECIFIED HERRIN AND IN SPECIFICATION SECTION 15995, "PIPEUNE TESTING AND DISINFECTION", PRESSURE TEST SHALL BE WITHESSED BY THE CITY OF HOLLYWOOD. THE ALLOWABLE LEAKAGE SHALL BE LESS THAN THE NUMBER OF GALLONS PER HOUR AS DETERMINED BY THE FORMULA:


- L = THE ALLOWABLE LEAKAGE IN GALLONS PER HOUR
- D = THE ADMINAL DIAMETER OF THE PIPE BEING TESTED.

 D = THE NOMINAL DIAMETER OF THE PIPE BEING TESTED.

 P = THE AVERAGE TEST PRESSURE IN POUNDS PER SQUARE INCH.
- 3. THE COMPLETE LENGTH OF THE PROPOSED WATER MAIN SHALL BE TESTED, IN LENGTHS NOT TO EXCEED 2,000 FEET PER TEST.
- 4. PROPOSED WATER MAINS SHALL BE DISINFECTED IN ACCORDANCE WITH THE LATEST EDITION OF ANSI/AWWA STANDARD C651 AND BACTERIOLOGICAL TESTED FOR TWO CONSECUTIVE DAYS IN ACCORDANCE WITH SPECIFICATION SECTION 15995, "PIPELINE TESTING AND DISINFECTION".
- 5. BACTERIOLOGICAL TESTS SHALL BE REQUESTED AND PAID FOR BY THE CONTRACTOR.
- 6. THE CONTRACTOR SHALL DIRECTLY HIRE A TESTING LABORATORY CERTIFIED BY THE FLORIDA DEPARTMENT OF HEALTH IN ORDER TO COLLECT AND TEST WATER SAMPLES FROM THE WATER DISTRIBUTION SYSTEM TO BE PLACED INTO SERVICE SAMPLE COLLECTION AND BACTERIOLOGICAL ANALYSES SHALL BE PERFORMED IN ACCORDANCE WITH RULES 62-555. 3166, 62-555. 340 AND 62-555. 330 (FAC), AS WELLAS ALL REQUIREMENTS OF THE BROWARD COUNTY HEALTH DEPARTMENT PERMIT.
- 7. THE WATER DISTRIBUTION SYSTEM SHALL NOT BE CONSIDERED COMPLETE AND READY FOR FINAL INSPECTION UNTIL SUCCESSFUL TEST RESULTS ARE OBTAINED FOR ALL TESTS DESCRIBED ABOVE.

	OF HOLLY WOOM ATE	ISSUED:	03/01/1994	DEPARTMENT OF PUBLIC UTILITIES STANDARD DETAIL	REVISED: 06/08/2014
ELAMAN D	DRAWN:	EAM	WATER MAIN TESTING AND	DRAWING NO.	
	GOLD CHAST	APPROVE): XXX	DISINFECTION NOTES	W-14

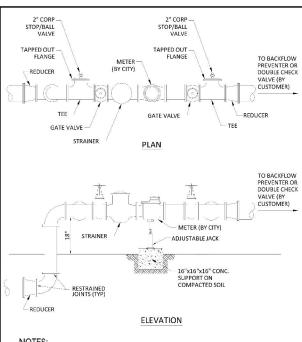


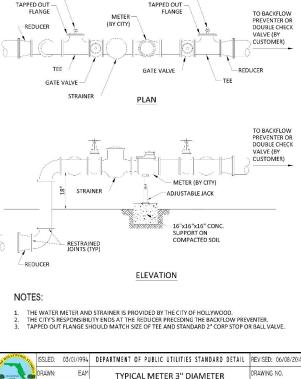

AND LARGER

APPROVED: XXX

W-11

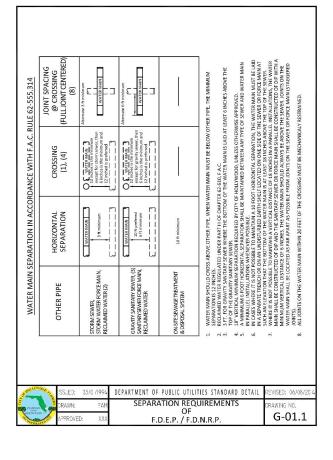

FLEXIBLE PAVEMENT RESTORATION NOTES:

10. REFER TO SPECIFICATIONS FOR DETAILED PROCEDURES.

CONTENT OF 70%. REPLACED BASE MATERIAL OVER TRENCH SHALL BE A MINIMUM OF 12" THICK"

LIMEROCK BASE MATERIAL SHALL BE PLACED IN 6" MAXIMUM (LOOSE MEASUREMENT) THICKNESS LAYERS WITH EACH LAYER THOROUGHLY ROLLED OR TAMPED AND COMPACTED TO 98% OF MAXIMUM DENSITY, PER AASHTO T-180, PRIOR TO THE PLACEMENT OF THE SUCCEEDING LAYERS.

STABILIZED SUBGRADE MATERIAL SHALL BE GRANULAR AND SHALL HAVE A MINIMUM L.B.R. OF 40.

6. ALL EDGES AND JOINTS OF EXISTING ASPHALT PAVEMENT SHALL BE SAW CUT TO STRAIGHT LINES, PARALLEL TO OR PERPENDICULAR TO THE ROADWAY, PRIOR TO THE RESURFACING. RESURFACING MATERIAL SHALL BE FDOT SUPERPAVE, AND SHALL BE APPLIED A MINIMUM OF TWO INCH IN THICKNESS.

SURFACE TREATED PAVEMENT JOINTS SHALL BE LAPPED AND FEATHERED FOR A SMOOTH, FLUSH TRANSITION TO EXISTING PAVEMENT.

IF THE TRENCH IS FILLED TEMPORARILY, IT SHALL BE COVERED WITH A 2" ASPHALTIC CONCRETE PATCH TO KEEP THE FILL MATERIAL FROM RAVELING UNTIL REPLACED WITH A PERMANENT PATCH.

. WHERE THE UTILITY TRENCH CROSSES EXISTING ASPHALT DRIVEWAYS, THE LIMEROCK BASE THICKNESS MAY BE A MINIMUM OF 6 INCHES THICK. REGARDLESS OF THE EXTENT OF IMPACT, THE ENTIRE DRIVEWAY SURFACE BETWEEN THE EDGE OF THE ROOMWAY PAVEMENT AND PROPERTY LINE OR FRONT OF SIDEWALK SHALL BE OVERLAID USING 2-INCH THICK MINIMUM ASPHALTIC CONCRETE


DEPARTMENT OF PUBLIC UTILITIES STANDARD DETAIL


FLEXIBLE PAVEMENT RESTORATION


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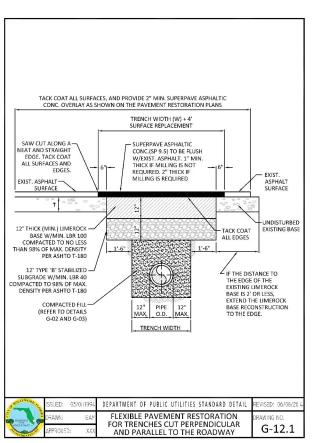
G-12


SURFACE COURSE WHERE INDICATED ON THE PLANS OR AS DIRECTED BY THE CITY/ENGINEER



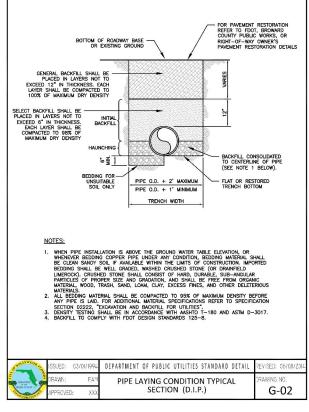

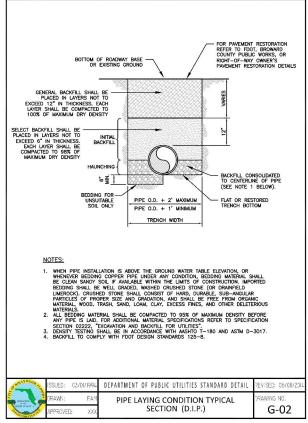

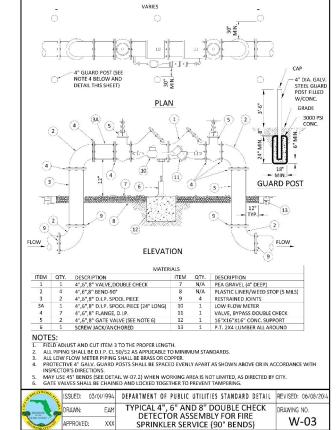

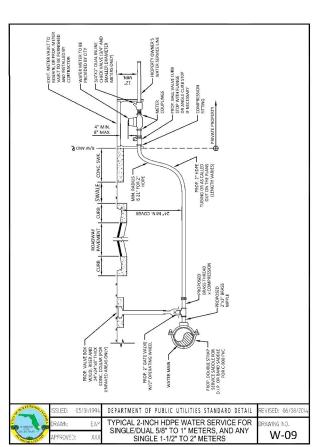




ALERT TO CONTRACTOR: THE PRESENCE OF GROUNDWATER SHOULD BE ANTICIPATED ON THIS PROJECT, CONTRACTOR'S B SHALL INCLUDE CONSIDERATION FOR THIS ISSUE, WHEN PERFORMING GRADING OPERATIONS DURING PERIODS OF WET WEATHER, PROVIDE ADQUARTE DEWARTENIS, DRAINAGE AND GROUND WATER MANAGEMENT TO CONTROL MOISTURE OF SOILS, REFER TO MASTER SITE SPECIFICATION. ALL WIM GENERAL CONTRACTOR WORK TO BE COMPLETED (EARTHWORK, FINAL UTILITIES, AND FINA GRADING) BY THE MILESTONE DATE IN PROJECT DOCUMENTS, OUTLOT AREA TO BE KEPT FREE OF JOB TRALERS AND STORAGE AFTER THE CONTRACT MILESTONE DATE FOR THE OUTLOT. WIM GENERAL CONTRACTOR TO PROVIDE CLEAR ACCESS FOR OUTLOT CONTRACTOR TO THE SPECIFIC PARCEL AT ALL TIMES AFTER MILESTONE DATE, PURCHASER OF OUTLOT TO PROVIDE PERMIT DOCUMENTS AND SWPPP REQUIRED BY STATELOCAL REQUIREMENTS FOR SPECIFIC OUTLOT.


Kimley » Horn © 2016 KIMLEY 445 24TH STREET, PHON WWW.KIMLEY-WLFONG, P.E.


HOLLYWOOD POTBALI ETAILS STANDARD I $\overline{\Box}$ OF CITY


> Ш S YWOOD PHAS A PLACE Ш N SC


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G-12

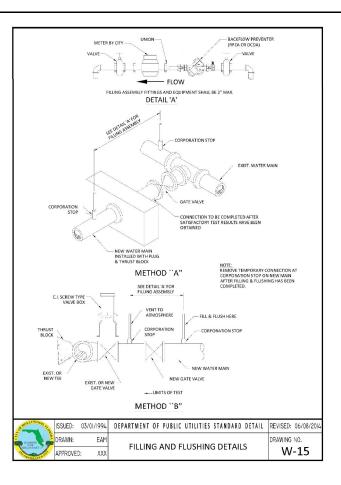

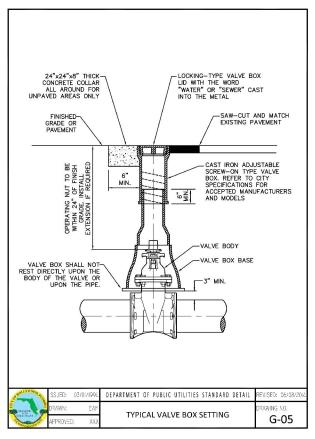ALERT TO CONTRACTOR:

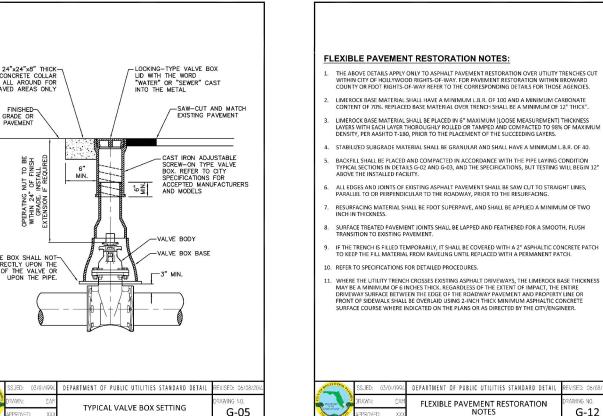LENT I O CONTRACTOR.

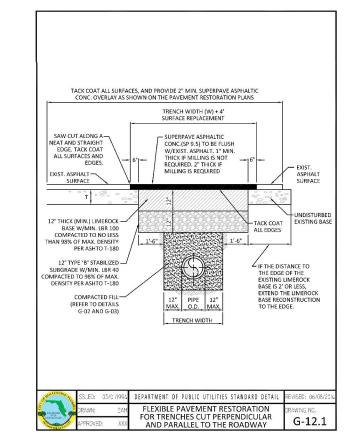THE PRESENCE OF GROUNDWATER SHOULD BE ANTICIPATED ON THIS PROJECT. CONTRACTOR'S BY SHALL INCLUDE CONSIDERATION FOR THIS ISSUE, WHEN PERFORMING GRADING OPERATIONS DURING PERFOCS OF WET WEATHER, PROVIDE ADCOLUTE DEWATERION, DRAINAGE AND GROUND WATER MANAGEMENT TO CONTROL MOISTURE OF SOLS. REFER TO MASTER SITE SPECIFICATIONS

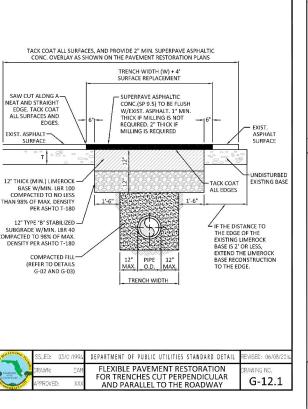ALL WIM GENERAL CONTRACTOR WORK TO BE COMPLETED (EARTHWORK, FINAL UTILITIES, AND FINA GRADING) BY THE MILESTONE DATE IN PROJECT DOCUMENTS, OUTLOT AREA TO BE KEPT FREE OF JOB TRALERS AND STORAGE AFTER THE CONTRACT MILESTONE DATE FOR THE OUTLOT. WIM GENERAL CONTRACTOR TO PROVIDE CLEAR ACCESS FOR OUTLOT CONTRACTOR TO THE SPECIFIC PARCEL AT ALL TIMES AFTER MILESTONE DATE, PURCHASER OF OUTLOT TO PROVIDE PERMIT DOCUMENTS AND SWPPP REQUIRED BY STATELOCAL REQUIREMENTS FOR SPECIFIC OUTLOT.

PHASE HOLLYWOOD PHAS V SOUTH RETAIL A PLACE 뽀

) ASSOCIATES, INC. VERO BEACH, FL 32960 4-4100 CA 00000696


© 2016 KIMLEY-445 24TH STREET, S PHON WWW.KIMLEY-


Kimley » Horn


GREG D. WILFONG, P.E.


HOLLYWOOD D POTBALE DETAILS

CITY OF HOL STANDARD F WATER DE

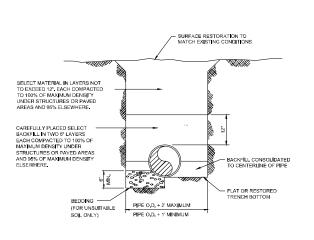

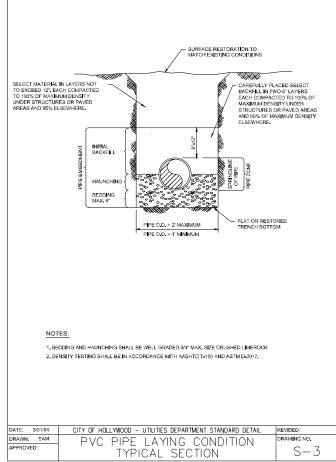

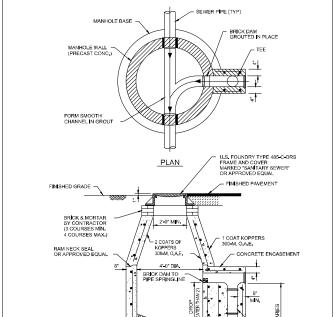

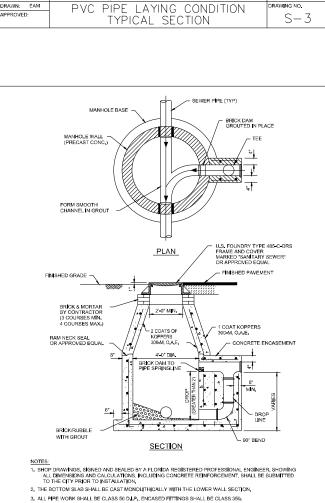

DATE: 3/01/94 CITY OF HOLLYWOOD - UTILITIES DEPARTMENT STANDARD DETAIL


DROP


MANHOLE


RAWING NO.

S-7

DRAWN: EAM

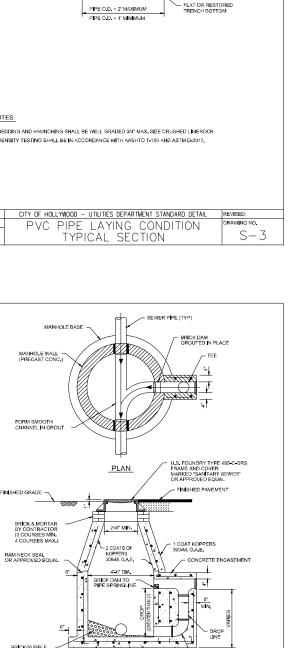

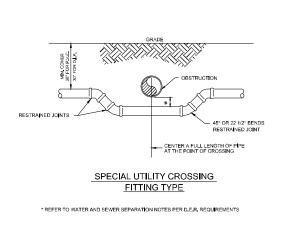


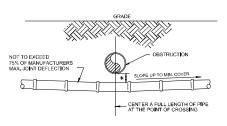



STANDARD UTILITY CROSSING DEFLECTION TYPE

* REFER TO WATER AND SEWER SEPARATION NOTES PER D.E.R. REQUIREMENTS

DATE: 3/01/94	CITY OF HOLLYWOOD - UTILITIES DEPARTMENT STANDARD DETAIL	REVISED:
DRAWN: EAM		DRAWING NO.
APPROVED:	UTILITY CROSSING DETAIL	S-4

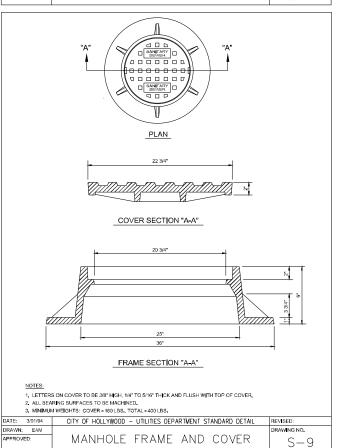

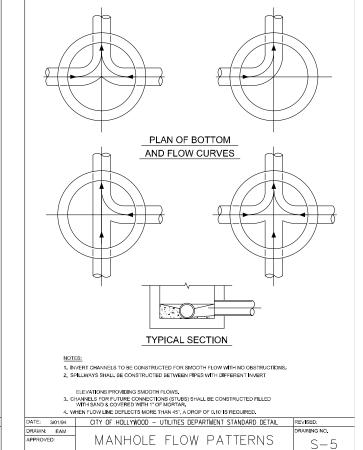

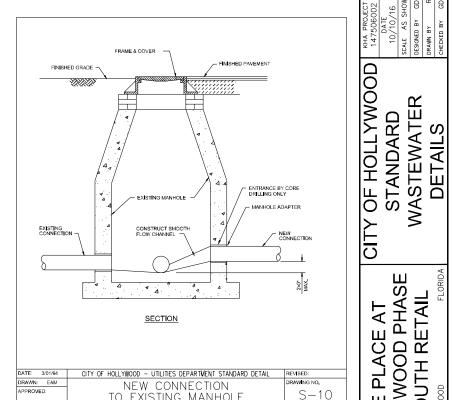



DURING PERIODS OF WET WEATHER, PROVIDE ADEQUATE DEWATERING, DRAINAGE AND GROUND WATER MANAGEMENT TO CONTROL MOISTURE OF SOILS, REFER TO MASTER SITE SPECIFICATION

ALL WINGENERAL CONTRACTOR WORK TO BE COMPLETED (EARTHWORK, FINAL UTILITIES, AND FINA GRADNIG BY THE MILESTONE DATE IN PROJECT DOCUMENTS, OUTLOT AREA TO BE KEPT FREE OF JOB TRALLERS AND STORAGE AFTER THE CONTRACT MILESTONE DATE FOR THE OUTLOT. WINGENERAL CONTRACTOR TO PROVIDE CLEAR ACCESS FOR OUTLOT CONTRACTOR TO THE SPECIFIC PARCEL AT ALL THISS AFTER MILESTONE DATE, TWICKHASER OF OUTLOT TO PROVIDE PERMIT DOCUMENTS AND SWIPPP REQUIRED BY STATE/LOCAL REQUIREMENTS FOR SPECIFIC OUTLOT.

THE PLACE AT HOLLYWOOD PHASE V SOUTH RETAIL

Kimley » Horn


WILFONG, P.E.

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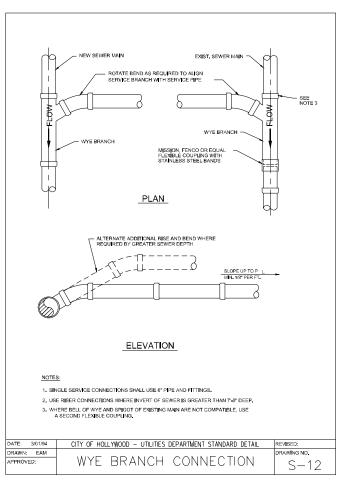
SHEET NUMBER C-504


NEW CONNECTION TO EXISTING MANHOLE THE PRESENCE OF ROCK SHOULD BE ANTICIPATED ON THIS PROJECT. CONTRACTOR'S BID SHALL INCLUDE CONSIDERATION FOR ADDRESSING THIS ALERT TO CONTRACTOR:


W=TRENCH WIDTH D=DIAMETER I, BEDDING MATERIAL WHEN NECESSARY, SHALL BE CLEAN SANDY SOIL WHENEVER AVALABLE WITHIN THE LIMITS OF CONSTRUCTION. IMPORTED BEDDING SHALL BE WELL GRANDE 34" MAX, SEZE ORUSHED LIMBEOCK. ALL BEDDING MATERIAL SHALL BE COMPACTED TO 95% OF MAXIMUM DENSITY BEFORE ANY PIPE IS LAID. 2. DENSITY TESTING SHALL BE IN ACCORDANCE WITH AASHTO T-180 AND ASTM D-3017. CITY OF HOLLYWOOD - UTILITIES DEPARTMENT STANDARD DETAIL REVISED: DATE: 3/01/94 PIPE LAYING CONDITION TYPICAL SECTION (D.I.P.) S-2

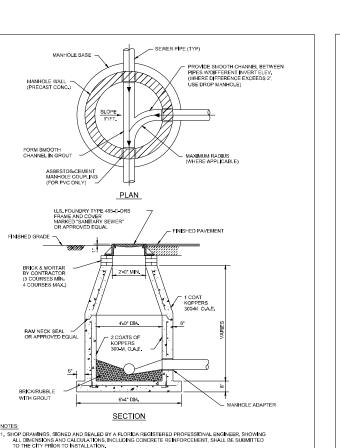


2. THE BOTTOM SLAB SHALL BE CAST MONOLITHICALLY WITH THE LOWER WALL SECTION. CITY OF HOLLYWOOD - UTILITIES DEPARTMENT STANDARD DETAIL STANDARD PRECAST MANHOLE S - 6



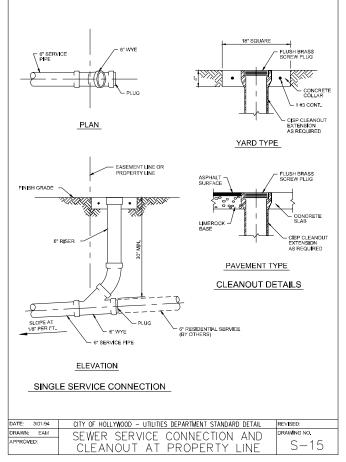

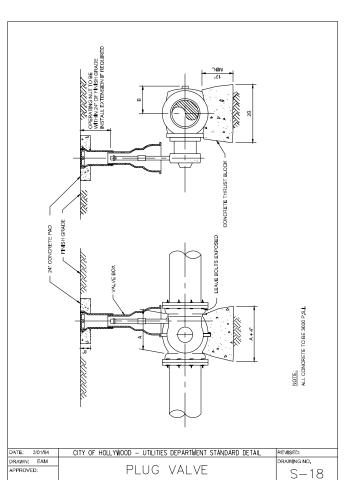

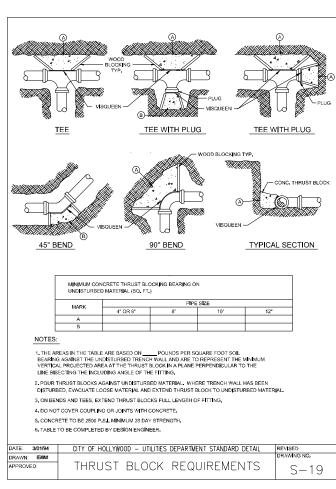




ALERT TO CONTRACTOR:

ALL WM GENERAL CONTRACTOR WORK TO BE COMPLETED (EARTHWORK, FINAL UTILITIES, AND FINAL GRADING BY THE MLESTONE DATE IN PROJECT DOCUMENTS, OUTLOT AREA TO BE KEPT FREE OF JOB TRALERS AND STORAGE AFTER THE CONTRACT MLESTONE DATE FOR THE OUTLOT. WM GENERAL CONTRACTOR TO PROVIDE GLEAR ACCESS FOR OUTLOT CONTRACTOR TO THE SPECIFIC PARCEL AT ALL THESE AFTER MLESTONE DATE, PURCHASER OF OUTLOT TO PROVIDE PERMIT DOCUMENTS AND SWPPP REQUIRED BY STATELOCAL REQUIREMENTS FOR SPECIFIC OUTLOT.

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TY OF HOLLYWOOD
STANDARD
WASTEWATER
DETAILS CITY

> HOLLYWOOD PHASE V SOUTH RETAIL THE PLACE AT



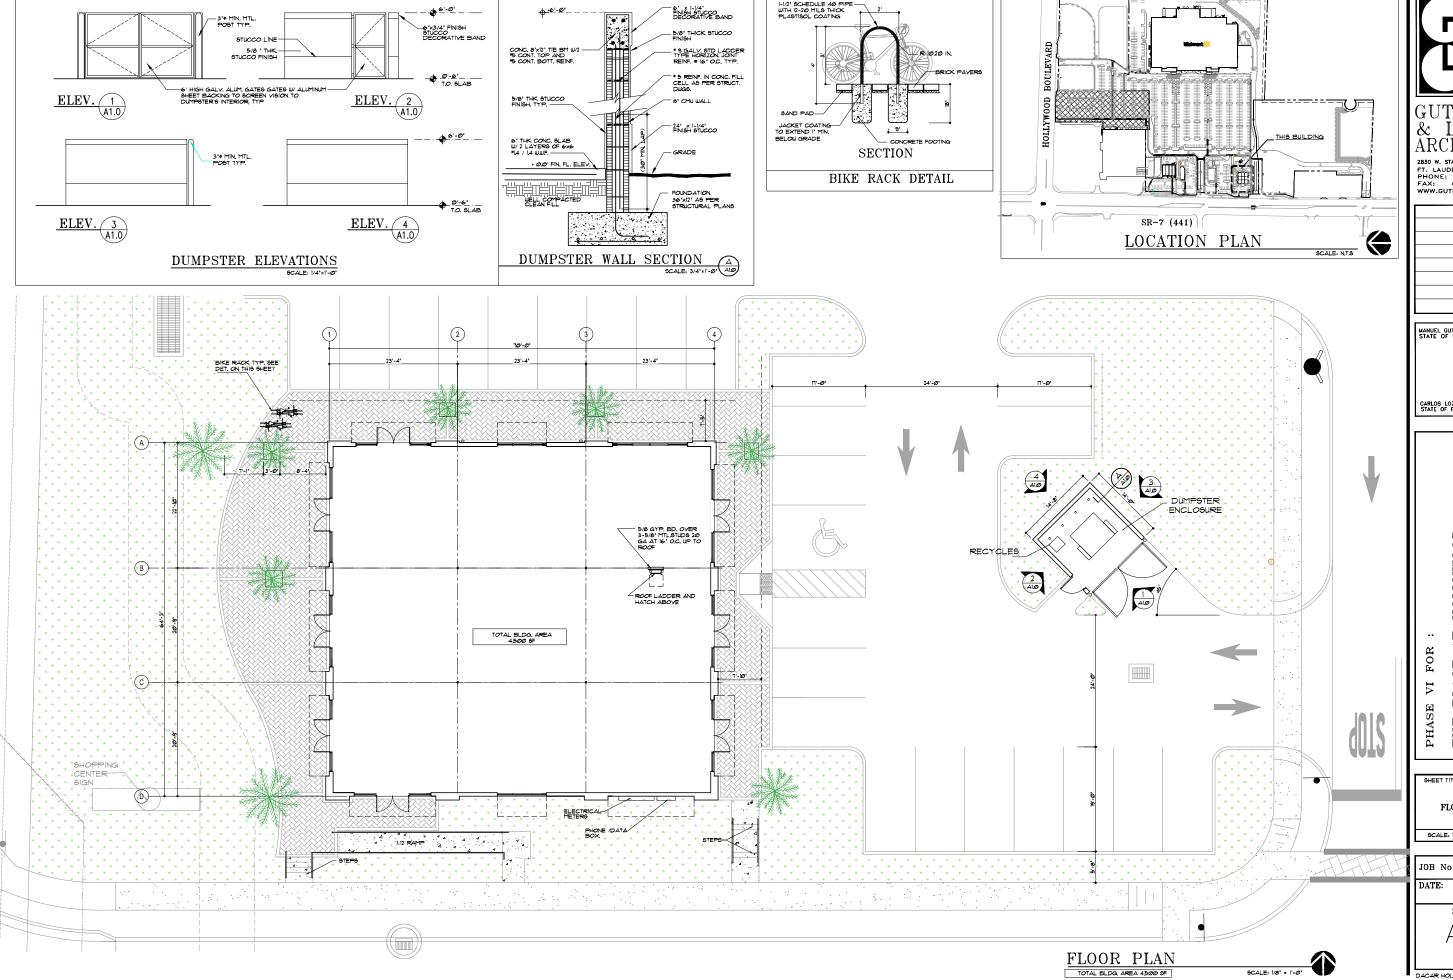

& LOZANO ARCHITECTS

2830 W. STATE ROAD 84, SUITE 117 FT. LAUDERDALE, FL. 33312 PHONE: (954) 321—3442 FAX: (954) 321—3844 WWW.GUTIERREZLOZANO.COM

REVISIONS

MANUEL GUTIERREZ STATE OF FLA. REG. No. 8253

SEAL

CARLOS LOZANO
STATE OF FLA. REG. No. 0014722

THE PLACE AT HOLLYWOOD
AT:
333 S. SR-7
HOLLYWOOD, FLORID

SHEET TITLE :

FLOOR PLAN

SCALE: 1'*1/8'


JOB No.:

DATE: 08/04/16

SHEET

A 1. 0

DACAR HOLLYWOOD/ LocalShops

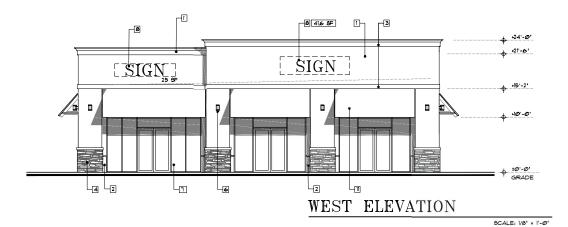

LEGEND

STUCCO FINISH WALL
DECORATOR'S WHITE PM-3 BENJAMIN MOORE

4 STONE VENEER: LEDGESTONE 'PRO-LEDGE 'BLACK FOREST' BY CORONADO STONE PRODUCTS.

EXTERIOR FIXTURE LIGHTS
GARDCO LIGHTING, MODEL: CYLINDERS 301 LINE UP/DN
CODE: 301-E-W-L-50MH-120-NP (NATURAL ALUMINUM COLOR)

LOCATION FOR SKINAGE BY TENANTS, ALL SKINAGE
SHALL COMPLY WITH CITY CODES AND ORDINANCES
AND SHALL BE SUBMITTED TO LANDLORD FOR
APPROVAL.
SKINAGE WILL BE REVISED AND APPROVED BY THE
CITY UNDER SEPARATE PERMIT.

MTL. DOWNSPOUT, PAINT TO MATCH ADJACENT WALL

CANVAS AUNING:
COLOR: BLUE SELECTED BY ARCHITECT

12 R.T.J. BY TENANT.

3 TUBULAR FIXED LADDER WITH CAGE PROVIDE SHOP DUGS.

NOTE:


NOTALL COLOR PAINT SAMPLES IN AN AREA OF 100 SF, APPROX,
AND CALL ARCHITECT/ OWNER FOR SITE APPROVAL BEFORE
PROCEEDING WITH PAINT JOB.

2 STUCCO FINISH WALL DELRAY GRAY 1614 BENJAMIN MOORE

3 STUCCO WALL TRIM SUPER WHITE PM-1 BENJAMIN MOORE


IMPACT RESISTANT STOREFRONT.
MTL. FINISH: ALUMINUM COLOR

[Opp _2 L 4 2 SOUTH ELEVATION SCALE: 1/8" = 1'-0"

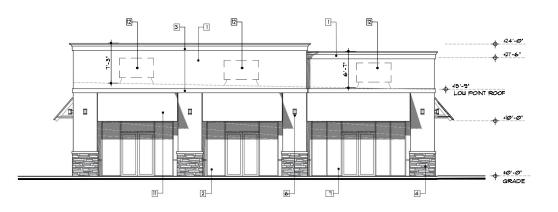

EAST ELEVATION SCALE: 1/8" = 1'-0'



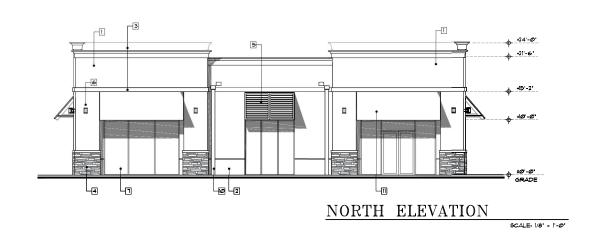

& LOZANO ARCHITECTS

2830 W. STATE ROAD 84, SUITE 117
FT. LAUDERDALE, FL. 33312
PHONE: (954) 321—3442
FAX: (954) 321—3864
WWW.GUTIERREZLOZANO.COM

REVISIONS

MANUEL GUTIERREZ
STATE OF FLA. REG. No. 8253 SEAL CARLOS LOZANO STATE OF FLA. REG. No. 0014722

FLORIDA HOLLYWOOD THE PLACE AT 1
AT:
333 S. SR-7
HOLLYWOOD, PHASE VI FOR


SHEET TITLE : ELEVATIONS 6CALE: 1'=1/8'

JOB No.: DATE: 08/04/16 SHEET A2.0

DACAR HOLLYWOOD/ LocalShops

SCALE: 1/8' = 1'-0'

WEST ELEVATION

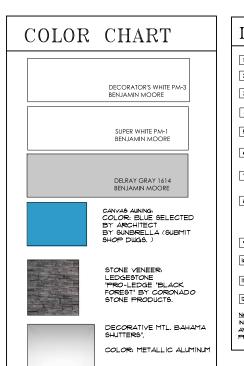







EAST ELEVATION

NORTH ELEVATION

ARCHITECTS

2830 W. STATE ROAD 84, SUITE 117 FT. LAUDERDALE, FL. 33312 PHONE: (954) 321—3442 FAX: (954) 321—3484 WWW.GUTIERREZLOZANO.COM

REVISIONS

MANUEL GUTIERREZ
STATE OF FLA. REG. No. 8253 SEAL CARLOS LOZANO
STATE OF FLA. REG. No. 0014722

FLORIDA HOLLYWOOD ATAT: 333 S. SR-7 HOLLYWOOD, THE PLACE PHASE

FOR

IΛ

SCALE: 1/8" = 1'-0'

SCALE: 1/8' = 1'-@'

SHEET TITLE : COLOR ELEVATIONS SCALE: 1'=1/8'

JOB No.: DATE: 08/04/16 SHEET A2.

DACAR HOLLYWOOD/ LocalShops

LEGEND STUCCO FINISH WALL DECORATOR'S WHITE PM-3 BENJAMIN MOORE 2 STUCCO FINISH WALL DELRAY GRAY 1614 BENJAMIN MOORE STUCCO WALL TRIM SUPER WHITE PM-I BENJAMIN MOORE STONE VENEER: LEDGESTONE 'PRO-LEDGE 'BLACK FOREST' BY CORONADO STONE PRODUCTS. DECORATIVE MTL. SHUTTER ALUMINUM COLOR IMPACT RESISTANT STOREFRONT. MTL, FINISH: ALUMINUM COLOR 9 TUBULAR FIXED LADDER WITH CAGE PROVIDE SHOP DIGS MTL. DOWNSPOUT, PAINT TO MATCH ADJACENT WALL 12 RTJJ BY TENANT. NOTE:
INSTALL COLOR PAINT SAMPLES IN AN AREA OF 100 S.F. APPROX.
AND CALL ARCHITECT/ OWNER FOR SITE APPROVAL BEFORE
PROCEEDING WITH PAINT JOB.

THE PLACE AT HOLLYWOOD

SR7 STREET VIEW RENDERING

Kimley » Horn

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445 24TH STREET, SUITE 200, VERO BEACH, FL 32960
PHONE: 772-794-4100





