
ATTACHMENT A

Application Package

PLANNING DI	VISION						
2600 Hollywood Boulev Hollywood, FL							
	APPLICATION TYPE (CHECK ONE):						
Heilywood FLORIDA	□ Technical Advisory Committee ☑ Historic Preservation Board □ City Commission ☑ Planning and Development Board □ Date of Application: □ - 13 - 2000						
Tel: (954) 921-3471	Location Address: <u>845</u> N. NORTH LAKE DRIVE, HOLLYWOOD, FL 33019 Lot(s): Block(s): Subdivision:						
Fax: (954) 921-3347	Lot(s):Block(s):Subdivision: Folio Number(s):Sリイン 14 02 3850						
	Zoning Classification: <u>R-03</u> Land Use Classification: <u>RESIDENTIAL</u>						
This application must be completed in full and	Existing Property Use: <u>RESIDENTIAL</u> Sq Ft/Number of Units: <u>1,990</u> SR, FT.						
submitted with all documents to be placed on a Board or	Is the request the result of a violation notice? () Yes (XNo If yes, attach a copy of violation. Has this property been presented to the City before? If yes, check al that apply and provide File						
Committee's agenda.	Number(s) and Resolution(s): $21 - C - 69$						
The applicant is responsible	Economic Roundtable Technical Advisory Committee K Historic Preservation Board City Commission K Planning and Development						
for obtaining the appropriate checklist for each type of	Explanation of Request: RESIDENTIAL ADDITION						
application.							
Applicant(s) or their authorized legal agent must be	A REAL AND A REAL AND A REAL AND A						
present at all Board or Committee meetings.	Number of units/rooms: <u>3 EXIST, + I NEW</u> Sq Ft: <u>2, 200 SQ, FT- (NEW)</u> Value of Improvement: Estimated Date of Completion: <u>AUGUST 2023</u>						
Committee meetings.	Will Project be Phased? NYes ()No If Phased, Estimated Completion of Each Phase PHASE 1 - FRONT OF HOUSE - APRIL 2023						
At least one set of the submitted plans for each	PHASE 2 - BACK OF HOUSE - AUGUST 2023						
application must be signed and sealed (i.e. Architect or	Name of Current Property Owner: ANTHONY HANDLEY						
Engineer).	Address of Property Owner: <u>845</u> N. NORTH LAKE DRIVE, 150000, FL 33019 Telephone: 954 600 3940 Fax: Email Address: TONY @INTERNATIONALACOUSTICS, COM						
Documents and forms can be	Name of Consultant/Representative/Tenant (circle one): ROBERTS ARCHITECTURE + CONSTRUCTION						
accessed on the City's website at	Address: 6511 NOVA DR, SUITE 268, DAVIE, FL Telephone: 954 600 1422 Fax: Email Address: BLAINE @ ROBE/CTS DESIGNBUILD, COM						
http://www.hollywoodfl.org/Do cumentCenter/Home/View/21	Date of Purchase: Is there an option to purchase the Property? Yes () No ()						
content centent tomer view/21	If Yes, Attach Copy of the Contract.						
18.8	List Anyone Else Who Should Receive Notice of the Hearing:						
	Email Address:						
	1						

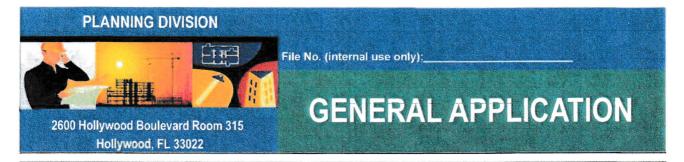

CERTIFICATION OF COMPLIANCE WITH APPLICABLE REGULATIONS

The applicant/owner(s) signature certifies that he/she has been made aware of the criteria, regulations and guidelines applicable to the request. This information can be obtained in Room 315 of City Hall or on our website at www.hollywoodfl.org. The owner(s) further certifies that when required by applicable law, including but not limited to the City's Zoning and Land Development Regulations, they will post the site with a sign provided by the Office of Planning and Development Services. The owner(s) will photograph the sign the day of posting and submit photographs to the Office of Planning and Development Services as required by applicable law. Failure to post the sign will result in violation of State and Municipal Notification Requirements and Laws.

(I)(We) certify that (I) (we) understand and will comply with the provisions and regulations of the City's Zoning and Land Development Regulations, Design Guidelines, Design Guidelines for Historic Properties and City's Comprehensive Plan as they apply to this project. (I)(We) further certify that the above statements and drawings made on any paper or plans submitted herewith are true to the best of (my)(our) knowledge. (I)(We) understand that the application and attachments become part of the official public records of the City and are not returnable.

Signature of Current Owner Anthony Handhard	Date: 12-13-22
PRINT NAME: Anthony Handler	Date:
Signature of Consultant/Representative:	Date: 12-13-2022
PRINT NAME: BLAINE ROBERTS	Date:
Signature of Tenant:	Date:
	Date:

Current Owner Power of Attorney

Sworn to and subscribed before me this 13 day of december 2022 rent Owner Signature of C ULYSSE VENET Notary Public - State of Florida Commission # GG 964817 Notary Public My Comm. Expires Mar 3, 2024 State of Florida (Check One) Personally known to me; OR ____ Produced Identification My Commission Expires:

Prepared by : Tony Pornprinya, Esq. Deluxe Title and Escrow, Inc. 1555 NE 123 Street North Miami, FL 33161 305-893-8989 File Number: 2021-379 Parcel Identification No. 494108-DA-0200

[Space Above This Line For Recording Data]_

Warranty Deed

This Indenture made this ______ day of May, 2021 between Anthony Handley, a single man whose post office address is 845 N. Northlake Drive, Hollywood, FL 33019 of the County of Broward, State of Florida, grantor*, and Kam Ming Wong and Suet Fan Wong, husband and wife whose post office address is 3225 NW 104 Terrace, Sunrise, FL 33351 of the County of Broward, State of Florida, grantee*,

Witnesseth that said grantor, for and in consideration of the sum of TEN AND NO/100 DOLLARS (\$10.00) and other good and valuable considerations to said grantor in hand paid by said grantee, the receipt whereof is hereby acknowledged, has granted, bargained, and sold to the said grantee, and grantee's heirs and assigns forever, the following described land, situate, lying and being in Broward County, Florida, to-wit:

Unit 2204, HAMPTON HILLS, a Condominium, according to the Declaration of Condominium thereof, as recorded in Official Records Book 41345, Page 781, of the Public Records of Broward County, Florida, and all amendments thereto, together with its undivided share in the common elements.

SUBJECT TO:

- 1. Taxes for the 2021 and subsequent years.
- 2. Conditions, restrictions, reservations, easements and limitations and zoning ordinances, if any, but not to reimpose same.

TOGETHER with all the tenements, hereditament and appurtenances thereto belonging or in any wise appertaining.

TO HAVE AND TO HOLD, the same in fee simple forever,

AND the Grantor hereby covenants with said Grantee that the Grantor is lawfully seized of said land in fee simple; that the Grantor has good right and lawful authority to sell and convey said land; that the Grantor hereby fully warrants the title to said land and will defend the same against the lawful claims of all persons whomsoever; and that said land is free of all encumbrances.

* "Grantor" and "Grantee" are used for singular or plural, as context requires.

REMAINDER OF PAGE INTENTIONALLY LEFT BLANK

In Witness Whereof, grantor has hereunto set grantor's hand and seal the day and year first above written.

Signed, sealed and delivered in our presence:

Witness Name: Ingred Costilion

Witness Name: _____

Anthony Handle

State of Florida County of _____


The foregoing instrument was acknowledged before me by means of [X] physical presence or [] online notarization, this $_15$ day of May, 2021 by Anthony Handley, who $[\]$ is <u>personally known</u> or [X] has produced a driver's license as identification.

[Notary Seal]

Ulyne Venet Notary Public

Printed Name: Ulysse Venet

My Commission Expires: **33 - 3 - 2024**

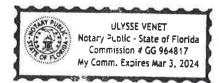



Site Address	845 N NORTHLAKE DRIVE, HOLLYWOOD FL 33019-1111	ID #	5142 14 02 3850
Property Owner	HANDLEY, ANTHONY	Millage	0513
Mailing Address	845 N NORTHLAKE DR HOLLYWOOD FL 33019-1111	Use	01- <mark>01</mark>
Abbr Legal Description	HOLLYWOOD LAKES SECTION 1-32 B LOT 2 E1/2,3 BLK 69		

The just values displayed below were set in compliance with Sec. 193.011, Fla. Stat., and include a reduction for costs of sale and other adjustments required by Sec. 193.011(8).

	* 20	23 valu	ies are c	onsidere	d "working values	" and a	re subject to cl	nange.		
				Prope	rty Assessment	Values				
Year	Land			ding / vement		Just / Market Value		Assessed / SOH Value		IX
2023*	\$131,250		\$497	7,310	\$628,5	60	\$424,04	40		
2022	\$131,250		\$497	7,310	\$628,5	60	\$411,69	90	\$7,97	1.64
2021	\$131,250		\$411	,350	\$542,6	00	\$399,70	00	\$7,76	9.71
		2023	* Exemp	tions an	d Taxable Value	s by Ta	xing Authority	/		
	County School Board Municipal Independent									
Just Value			\$6	628,560	\$62	28,560	\$628,5	60	\$	628,560
Portability				0		0		0		0
Assessed/	SOH 20		\$4	24,040	\$4:	24,040	\$424,0	940	\$424,040	
Homestead	100%		9	\$25,000	\$2	25,000	\$25,0	000	\$25,000	
Add. Home	estead		9	625,000		0	\$25,000			\$25,000
Wid/Vet/Di	5			0		0		0		0
Senior				0		0	0			0
Exempt Ty	ре			0		0		0		0
Taxable			\$3	374,040	\$39	99,040	\$374,0	40	\$	374,040
		Sales	History				Land (Calcula	ations	
Date	Туре	Р	rice	Book	/Page or CIN		Price	F	actor	Туре
3/1/1994	D	\$	100	2	1891 / 48		\$14.00	g	,375	SF
11/1/1993	SWD	\$16	0,000							
6/1/1986	QCD	\$	100							
4/1/1977	WD	\$85	5,000							
2/1/1965	WD	\$9	,500	İ		Ad	j. Bldg. S.F. (0	Card, S	Sketch)	1825
	n					"	Units/Bed	s/Bath	S	1/3/2
							Eff./Act. Yea	r Built	:: 1998/197	7
				Spe	cial Assessmer	nts				
			1		<u>т т</u>			r	1	

	Special Assessments								
Fire	Garb	Light	Drain	Impr	Safe	Storm	Clean	Misc	
05									
R									
1									

ACCURATE LAND SURVEYORS, INC.

1150 E ATLANTIC BLVD - POMPANO BEACH, FLORIDA 33060 TEL. (954) 782-1441 FAX (954) 782-1442

Invoice

INVOICE #: 21-1579

INVOICE DATE : 6/16/2021

TONY HANDLEY 845 N NORTHLAKE DRIVE HOLLYWOOD FL 33019 Attn: TONY

REFERENCE

Buyer..... N/A
Owner..... HANDLEY
Client File #..... HANDLEY

DUE DATE 6/16/2021 TERMS........ On Demand

JOB ADDRESS

845 NORTHLAKE DRIVE HOLLYWOOD, FL 33019

DESCRIPTION OF ITEM OR SERVICE

UPDATE & TOPOGRAPHICAL SURVEY (REF#93-4011)

COST OF ITEM

\$400.00

6/16/21 PAID BY VISA	INVOICE TOTAL:	\$400.00
	PAYMENTS & ADJUSTMENTS:	\$400.00
	BALANCE DUE:	\$0.00

1150 E. ATLANTIC BLVD. POMPANO BEACH FLORIDA 33060

ACCURATE LAND SURVEYORS, INC. L.B. #3635

TEL. (954) 782-1441 FAX. (954) 782-1442

SHEET 1 OF 2

TYPE OF SURVEY: BOUNDARY TOPO, 93-4011,21-1579

JOB NUMBER: SU-17-0925

LEGAL DESCRIPTION:

LOT 3 AND THE EAST ½ OF LOT 2, BLOCK 69 OF HOLLYWOOD LAKES SECTION, ACCORDING TO THE PLAT THEREOF, AS RECORDED IN PLAT BOOK 1, PAGE 32, OF THE PUBLIC RECORDS OF BROWARD COUNTY, FLORIDA.

ADDRESS: 845 N. NORTHLAKE DRIVE HOLLYWOOD, FL 33019

FLOOD ZONE: AE **BASE FLOOD ELEVATION:** 5'NAVD 125113-12011C0588-H CONTROL PANEL NUMBER: **EFFECTIVE: 8/18/2014 REVISED**:

LOWEST FLOOR ELEVATION: SEE PAGE 2 OF 2 GARAGE FLOOR ELEVATION: SEE PAGE 2 OF 2 LOWEST ADJACENT GRADE : SEE PAGE 2 OF 2 HIGHEST ADJACENT GRADE : SEE PAGE 2 OF 2

REFERENCE BENCH MARK: SEE COMMENTS

CERTIFY TO:

1. ANTHONY HANDLEY


- 2.
- 3.
- 4.
- 5.
- 6.

COMMENTS: CITY OF HOLLYWOOD NORTH RIM ON SEWER MANHOLE AT CENTERLINE OF N.N LAKE DRIVE & 9TH AVE., ELEVATION: 1.71' NAVD 1988.

NOTES:

THIS SURVEY CONSISTS OF A MAP AND A TEXT REPORT. ONE IS NOT VALID WITHOUT THE OTHER. OWNERSHIP OF FENCE AND WALLS IF ANY, NOT DETERMINED. THIS SURVEY IS MADE FOR THE EXCLUSIVE USE OF THE CERTIFIED HEREON. TO BE VALID ONE YEAR FROM THE DATE OF SURVEY AS SHOWN HEREON. 2.3.

			-04	~ 1	LEGEND OF ABBR	FVA		121	- F	RO	WARD COUNTY NAVD1988
Δ		CENTRAL ANGLE	199	è I	LEGEND OF ADDI			10.		5110	
A	=	ARC LENGTH	2 1					NORTHANERICAN		-	PAGE
A/C	=	AIR CONDITIONER	/ OR +=	E	ELEVATIONS BASED ON NAVD 1988	N.A.V.D.	=	NORTH AMERICAN	P.G.		
AD	=	ASSUMED DATUM	FND =	: F	FOUND			VERTICAL DATUM	P.O.B.	=	POINT OF BEGINNING
A.E.	=	ANCHOR EASEMENT	FF =	E F	FINISHED FLOOR	O/S	=	OFFSET	P.O.C.	=	POINT OF COMMENCEMENT
AF	=	ALUMINUM FENCE	FH =	F	FIRE HYDRANT	O.R.B.	=	OFFICIAL RECORDS BOOK	P.R.C.	=	POINT OF REVERSE
B.C.R.	=	BROWARD COUNTY	F.P.L. =	F	FLORIDA POWER & LIGHT	он	=	OVERHANG			CURVATURE
		RECORDS	GAR. =		GARAGE	(P)	=	PLAT	P.R.M.	=	PERMANENT REFERENCE
BLVD	=	BOULEVARD	I.D. =	i ii	DENTIFICATION	P.B.	=	PLAT BOOK			MONUMENT
B.M.	=	BENCHMARK	I.P. =		RON PIPE	P.B.C.R.	=	PALM BEACH COUNTY	P.T.	=	POINT OF TANGENCY
(C)	-	CALCULATED	I.P.C. =		RON PIPE & CAP			RECORDS	PVC	=	POLYVINYL CHLORIDE
CB	-	CHORD BEARING	I.R. =		RON ROD	P.C.	=	POINT OF CURVATURE	R	=	RADIUS CEAI
	-	CHATTAHOOCHEE	I.R.C. =		RON ROD & CAP	P.C.P.	=	PERMANENT	RNG.	=	RANGE
CHATT.	-					1.0.1		CONTROL POINT	R/W	=	RIGHT OF WAY / NOT VALID WITHOUT \
CLF	=	CHAIN LINK FENCE	LP =		LIGHT POLE			001111021 01111	s	=	SOUTH THE SIGNATURE AND
C/L	=	CENTERLINE	(M) =		MEASURED		×	- = CHAIN LINK FENCE	SEC.	=	SECTION THE ORIGINAL RAISED
D.B.	=	DEED BOOK	M.DR. =		MIAMI DADE COUNTY		<u></u>	- = WOOD FENCE	SQ. FT.	-	SQUARE FEET SEAL OF A FLORIDA
D.E.	=	DRAINAGE EASEMENT			RECORDS/		·		TWP.	-	TOWNSHIP LICENSED SURVEYOR /
E	=	EAST	MAINT. =	: N	MAINTENANCE	<u> </u>	_	= METAL FENCE			
ELEC.	=	ELECTRIC	MF =	- N	METAL FENCE	00-	C	PVC FENCE	U.E.	=	UTIENT EAGEMENT
ELEV.	=	ELEVATION	MH =	- N	MANHOLE			— = CONCRETE FENCE	W	=	WEST
ENCH.	=	ENCROACH/	N =		NORTH	11111	-77		WF	=	WOOD FENCE
		ENCROACHMENT	N/A =	N	NOT APPLICABLE			= WIRE FENCE	WM	=	WATER METER
ESMT	-	EASEMENT	N&D =		NAIL & DISC						

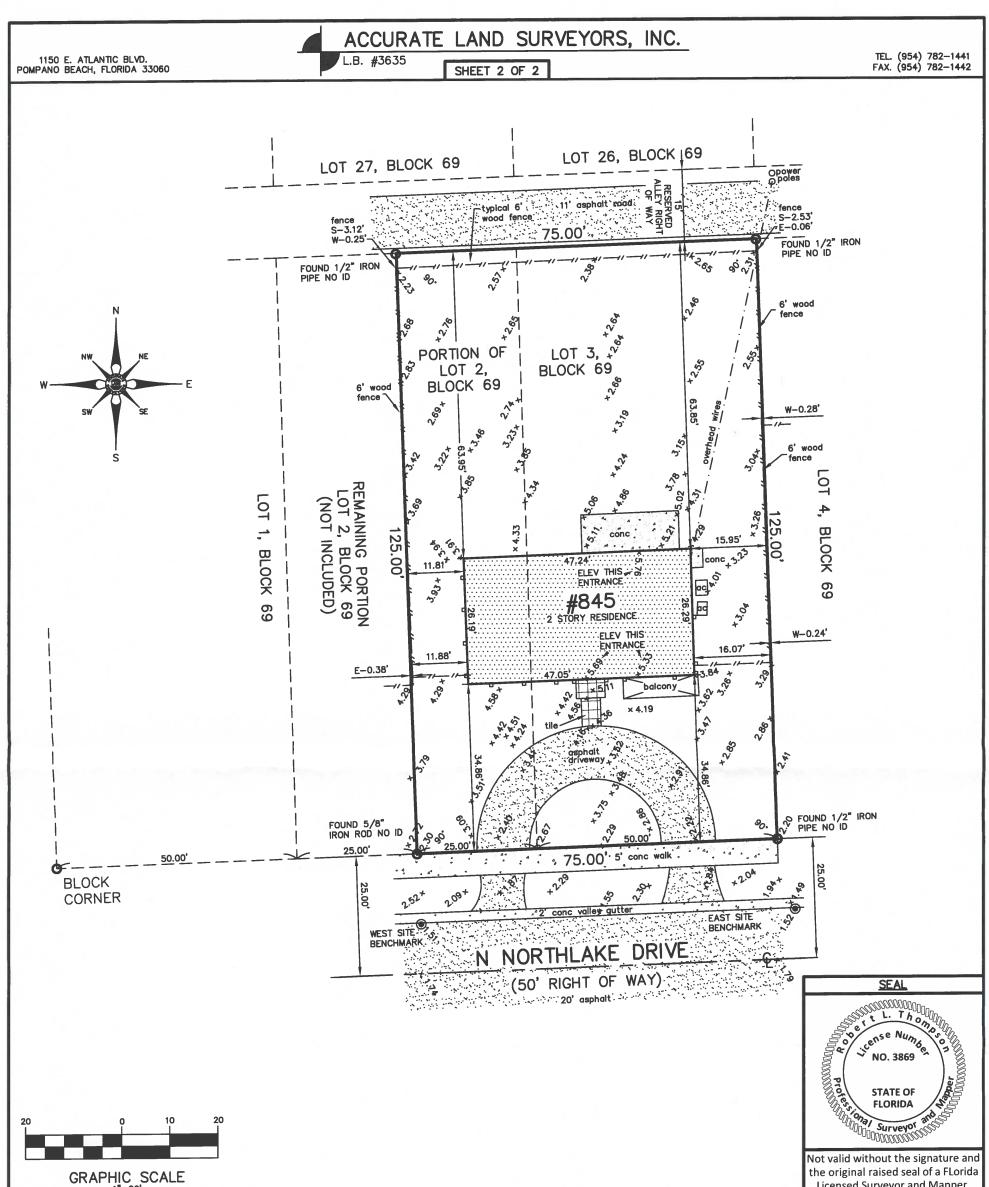

GRAPHIC SCALE

NOTES:	field measurements or	o in agroomont with	record	REVISIONS & SURVEY UPDATES		F SURVEY BY ASIONS		
1. Unless otherwise noted	neid measurements ar	e in agreement with	record .					
measurements. 2. Angles shown hereon are	ner Plat hook 1 Page	32 Broward County	/ Records.					
3. The lands shown hereor	were not abstracted	for ownership, rights	of way.					
easements, or other matte	rs of records by Accura	ate Land Surveyors, I	nc.	UPDATE/TOPO SURVEY SU-21-1579	07-22-2	021 AL/RLT		
4. Ownership of fences an	d walls if any are not d	etermined.		SET CORNERS 20-1105	06-25	-20 MLW		
5. This survey is the prope	erty of Accurate Land S	Surveyors, Inc. and sh	all not be					
used or reproduced in who	le or in part without w	ritten authorization.		CERTIFICATION: This is to certify that this above ground sketch of boundary survey w	as made unde	ar my responsible charge		
6. Any and all undergroun	d features such as four	ndations, utility lines,	Ext. were	and is accurate and correct to the best of my knowledge and belief.	l further certif	w that this sketch meets the		
not located on this survey.	This is an above groun	d survey only.		current Standards of Practice, established by the Board of Profession	al Surveyors a	and Mappers. Chapter		
7. The flood zone informat		or the dwellable stru	cture only	5J-17, Florida Administrative Codes, pursuant to current Section 472.	027, Florida S	statutes.		
unless otherwise indicated.			a to thoir					
 The location of overhea proximity above ground. si 	d utility lines are appro	point are in nature up	to design or					
construction.	ze, type and quantity i	nust be vermed prior	to design of		-			
9. Accuracy statement: Thi	s survey meets or exce	eds the horizontal a	curacy for					
SUBURBAN LINEAR : 1 FOO				ALT IL	07	70 3,71		
				latt and	$-O(\cdot)$	-29-2021		
10. $\dot{q}^{\dot{q}}$ Denotes ele	vations based on the N	lorth American Datu	m of 1988.	ROBERT L. THOMPSON (PRESIDENT)				
+**				PROFESSIONAL SURVEYOR AND MAPPER No.3869 - STATE OF	FLORIDA			
ORIGINAL DATE OF SURVEY	DRAWN BY	CHECKED BY	FIELD BOOK	SCALE	1"=20'	SKETCH SU-17-0925		
03-28-2017	ER	RLT	17-0	925				









845 N. NORTHLAKE DRIVE

SITE DATA

RESIDENTIAL ADDITION HOLLYWOOD, FL

DRAWING INDEX

G-001 G-002	GENERAL NOTES & DRAWING INDEX SITE ZONING ANALYSIS	GOVERNING CODE:	FLORIDA RESIDENTIAL BUILDING 7TH EDITION (2020)
G-003 D-001 A-001	SITE CONDITION ANALYSIS DEMOLITION PLAN PROPOSED SITE PLAN	BUILDING HEIGHT:	+/- 24'-0"
A-100 A-101	EXISTING FLOOR PLAN PROPOSED GROUND FLOOR PLAN	PROJECT AREA:	+/- 2,257 S.F.
A-101 A-102 A-103	PROPOSED GROUND FLOOR PLAN PROPOSED SECOND FLOOR PLAN PROPOSED GROUND FLOOR RCP	TYPE OF CONSTRUCTION:	TYPE III-B - UNPROTECTED
A-103 A-104 A-105	PROPOSED GROUND FLOOR RCP PROPOSED SECOND FLOOR RCP PROPOSED ROOF PLAN	OCCUPANCY CLASSIFICATION:	R-03
A-105 A-200 A-201 A-202 A-203 A-500	EXISTING EXTERIOR ELEVATIONS EXISTING EXTERIOR ELEVATIONS PROPOSED EXTERIOR ELEVATIONS PROPOSED EXTERIOR ELEVATIONS WALL TYPES & SECTIONS	SETBACKS:	FRONT: 25'-0" REAR: 15% LOT DEPTH SIDE: 25% LOT WIDTH; 7'-6" MIN. ONE SIDE
A-500 A-600 A-700 A-701	DOOR & WINDOW SCHEDULE DETAILS DETAILS	OPEN SPACE REQ.:	40% OPEN SPACE TO BE LANDS 20% MIN. FRONT YARD
A-702	DETAILS	ID #:	5142 14 02 3850
		LEGAL DESCRIPTION:	HOLLYWOOD LAKES SECTION 1 B LOT 2 E1/2 3 BLK 69
		SCOPE OF WORK:	TWO STORY ADDITION INCLUDI TWO CAR GARAGE, GREAT ROO BATHROOM, SAUNA, STAIRWELI BEDROOM SUITE, ROOFTOP TEI AND POOL WITH ACCESS TO EX STRUCTURE.

SYMBOLS

OTMBOLO			
IDENTIFICATION NUMBER A-000 SHEET NUMBER	SECTION SYMBOL		CHANGE IN ELEVATION SYMBOL
IDENTIFICATION NUMBER			KEY NOTE SYMBOL
A-000 SHEET NUMBER	DETAIL SYMBOL	$\underline{\land}$	REVISION SYMBOL
A-000 A-000 SHEET NUMBER	BUILDING ELEVATION SYMBOL		DOOR TAG SYMBOL
		Â	WINDOW TAG SYMBOL
3 A-000 1 ELEVATION NUMBER	INTERIOR ELEVATION SYMBOL	G4C-I	WALL TAG SYMBOL
IDENTIFICATION NUMBER A-000 SHEET NUMBER	ENLARGED PLAN/CALL-OUT SYMBOL	DESCRIPTION ELEV. = 0'-0"	CEILING ELEVATION SYMBOL

LOCATION MAP



	GENERAL NOTES	
DING CODE	THE CONTRACTOR SHALL VISIT THE SITE AND FAMILIARIZE HIMSELF WITH THE EXISTING CONDITIONS AND NOTIFY THE ARCHITECT OF ANY DISCREPANCIES IN WRITING PRIOR TO SUBMITTING BIDS AND	THE CONTRACTOR SHALL MAINTAIN THE JOB SITE FRE RUBBISH AND DEBRIS. DISPOSAL OF ALL CONSTRUCT SHALL CONFORM TO BUILDING REGULATIONS.
	COMMENCING WORK. THE CONTRACTOR SHALL VISIT THE PROJECT SITE PRIOR TO THE SUBMISSION OF ANY BIDS, AND FIELD VERIFY THE ARCHITECTS DIMENSIONS, DETAILS, AND INFORMATION PERTAINING TO THE PROJECT. IF ANY DISCREPANCIES, CONFLICTING INFORMATION, ERRORS, OR OMISSIONS ARE PRESENT, THE CONTRACTOR SHALL	THE CONTRACTOR SHALL RUN FIRE RATED WALLS AN TO UNDERSIDE OF RATED ROOF/CEILING ASSEMBLY A AND SEAL ALL JOINTS. PROVIDE FIRE DAMPERS, IF AP DUCT PENETRATIONS AS REQUIRED BY CODE. TAPE A PENETRATIONS TO MAINTAIN INTEGRITY OF FIRE RATI USING ONLY UL APPROVED MATERIAL.
	NOTIFY THE ARCHITECT AND OWNER IMMEDIATELY IN WRITING. ANY DISCREPANCY OR CONFLICT NOT BROUGHT TO THE ATTENTION OF THE ARCHITECT AND OWNER PRIOR TO FINAL BIDS AND COMMENCEMENT OF WORK SHALL BE CORRECTED BY THE CONTRACTOR AT NO ADDITIONAL COST TO THE OWNER.	THE CONTRACTOR SHALL FINISH GYPSUM WALLBOAR OTHER MATERIAL WITH VINYL TEAR-OFF BEAD. ALL PI DUCTWORK, AND CONDUITS ARE TO BE CONCEALED I ABOVE FINISHED CEILINGS.
NDSCAPE	THE CONTRACTOR SHALL NOT SCALE THE DRAWINGS. WRITTEN DIMENSIONS TAKE PRECEDENCE OVER SCALED DIMENSIONS.	THE CONTRACTOR SHALL PROVIDE BACKING AT ALL E CABINETS, MILLWORK CABINETS, AND ANY OTHER RE SEMI-RECESSED EQUIPMENT LOCATED IN FIRE RATED
N 1-32	THE GENERAL CONTRACTOR AND ALL SUBCONTRACTORS SHALL CARRY GENERAL LIABILITY, PROPERTY, AND WORKERS COMPENSATION INSURANCE; CONTRACTOR TO PROVIDE VALID CERTIFICATES OF INSURANCE, IN ADVANCE, TO OWNER.	5%" TYPE 'X' GYPSUM BOARD AS REQUIRED TO MAINTA THE CONTRACTOR SHALL PROVIDE BRACING OR BLOG REQUIRED TO SUPPORT WALL MOUNTED EQUIPMENT.
JDING NEW ROOM, HALF /ELL, TERRACE,	THE CONTRACTOR SHALL INCLUDE ALL WORK NECESSARY TO ASSURE THE PROJECTS COMPLIANCE WITH THE MOST STRINGENT REQUIREMENTS OF THE FLORIDA BUILDING CODE, CURRENT LOCAL EDITION, NFPA-101, AND ALL OTHER REGULATORY CODES.	CABINETS, HOODS, GRILLES, DOORS, WINDOWS, ETC. BLOCKING SHALL BE FIRE RETARDANT TREATED. MET BE USED IN LIEU OF WOOD BLOCKING, UNLESS NOTED DRAWINGS OR BY APPROVED NOA REQUIREMENTS.
EXISTING	THE CONTRACTOR SHALL OBTAIN ALL PERMITS, AND SECURE ALL CERTIFICATES OF INSPECTION AND OCCUPANCY THAT ARE REQUIRED BY THE GOVERNING AUTHORITY HAVING JURISDICTION. THE OWNER	THE CONTRACTOR SHALL NOT CUT ANY STEEL, WOOD MAIN STRUCTURAL MEMBERS WITHOUT WRITTEN APP STRUCTURAL ENGINEER.
	SHALL RECEIVE A COPY OF THE PERMIT UPON ISSUANCE. THE CONTRACTOR SHALL REFERENCE ALL EXISTING BUILDING DRAWINGS FOR ALL INFORMATION RELATIVE TO THE EXISTING CONDITIONS OF THE BUILDING AND FOR COORDINATION OF NEW	ANY ROOM, WALL, FLOOR, OR CEILING FINISH NOT SC BE ASSUMED TO BE IDENTICAL TO THE CLOSEST ROO USE AND TYPE FOR PURPOSES OF BIDDING AND CONS NOTIFY THE ARCHITECT OF ANY OBSERVED APPAREN DISCREPANCIES IN WRITING PRIOR TO COMMENCEME
	WORK. THE GENERAL CONTRACTOR AND ALL SUBCONTRACTORS /VENDORS SHALL FAMILIARIZE THEMSELVES WITH AND CONFORM TO ALL REQUIREMENTS SET FORTH BY THE BUILDING OWNER OR MUNICIPALITY RELATIVE TO THE HOURS OF WORK.	ANY DETAILED NOT SPECIFICALLY REFERENCED SHAL TO BE SIMILAR TO THAT SHOWN IN THE CLOSEST POS SIMILAR CONDITION OCCURS FOR THE PURPOSES OF CONSTRUCTION. NOTIFY THE ARCHITECT OF ANY OBS APPARENT DISCREPANCIES IN WRITING PRIOR TO CO OF WORK.
	THE CONTRACTOR SHALL SUBMIT A DETAILED CONSTRUCTION SCHEDULE AND COORDINATE SCHEDULE WITH ALL SUBCONTRACTORS, SUPPLIERS, AND VENDORS. THE CONTRACTOR SHALL NOT BRING OR ALLOW ON THE PROJECT	WHERE TWO OR MORE DETAILS, MATERIALS, OR CON IN APPARENT CONFLICT, THE CONTRACTOR SHALL IN MOST COSTLY SOLUTION IN HIS BID AND NOTIFY THE ANY APPARENT DISCREPANCIES PRIOR TO START OF
	SITE ANY MATERIALS CONTAINING ASBESTOS, PETROLEUM, OR PCB.	CONSTRUCTION.
	THE CONTRACTOR SHALL BE RESPONSIBLE FOR OBTAINING AND DISTRIBUTING ALL CURRENT DRAWINGS TO THE SUBCONTRACTORS/VENDORS, AS WELL AS, SUPERVISING AND COORDINATING THE WORK OF ALL TRADES IN ACCORDANCE WITH THE SPECIFICATIONS AND MAKING ADJUSTMENTS IN LAYOUT AS REQUIRED. THE ARCHITECT SHALL BE NOTIFIED PRIOR TO THE EXECUTION OF ALL REVISIONS TO AVOID CONFLICT BETWEEN	THE CONTRACTOR SHALL PROVIDE UPON COMPLETIC WORK A SET OF "AS-BUILT" DRAWINGS SHOWING CHA CONSTRUCTION DOCUMENTS DURING COURSE OF CO INCLUDING CHANGES TO MECHANICAL, ELECTRICAL, A DOCUMENTS. THESE DRAWINGS SHALL BE TRANSMIT AND ARCHITECT UPON COMPLETION OF THE PROJECT
	TRADES FOR PROPER EXECUTION OF THE WORK. THE CONTRACTOR SHALL INSTALL ANY APPARATUS, APPLIANCE, MATERIAL OR WORK NOT SHOWN ON THE DRAWINGS BUT MENTIONED IN THE SPECIFICATIONS, OR VICE VERSA, OR ANY INCIDENTAL ACCESSORIES NECESSARY FOR COMPLETION OF THE WORK FOR	GENERAL CONTRACTOR AND ALL SUBCONTRACTORS VERIFY ALL DIMENSIONS AND REVIEW EXISTING CONE JOBSITE AND COORDINATE FINDINGS IN REFERENCE CONSTRUCTION DOCUMENTS AND SPECIFICATIONS P COMMENCEMENT OF ANY WORK, AND WITHIN (7) SEVE DAYS OF GENERAL CONTRACTOR'S RECEIPT OF THES
	OPERATION WITHOUT ADDITIONAL EXPENSE TO THE OWNER. THE CONTRACTOR SHALL COORDINATE ALL OWNER SUPPLIED ITEMS AND INCORPORATE THE INSTALLATION INTO THE CONSTRUCTION SCHEDULE.	NOTIFY THE ARCHITECT IN WRITING OF ANY AND ALL I IF NO DISCREPANCIES ARE BROUGHT FORTH, THE AR ASSUME NO RESPONSIBILITY FOR ANY ERRORS, AND CONTRACTOR AND ALL SUBCONTRACTORS SHALL AS RESPONSIBILITY FOR ANY ERRORS AND OMISSIONS A
	THE CONTRACTOR SHALL PROVIDE ANY TEMPORARY UTILITIES INCLUDING ELECTRICAL AND WATER REQUIRED FOR THE COMPLETION OF THE PROJECT.	CORRECT SUCH ERRORS AT NO EXPENSE TO OWNER DIMENSIONS ARE TO FACE OF FINISH WALLS AND SUR OTHERWISE NOTED. THE ARCHITECT SHALL NOT BE R FOR FIELD SUPERVISION OR CONSTRUCTION ADMINIS
327_	THE CONTRACTOR SHALL HAVE A DIGITAL CAMERA ON SITE TO DOCUMENT ALL EXISTING CONDITIONS PRIOR TO COMMENCMENT OF CONSTRUCTION, AND SHARE PHOTOS WITH OWNER AND ARCHITECT FOR DOCUMENTATION PURPOSES. CONTRACTOR SHALL TAKE PHOTOS OF ANY ISSUES THAT MAY NEED TO BE CLARIFIED, AND	UNLESS OUTLINED IN OWNER-ARCHITECT AGREEMEN CONTRACTOR, SUBCONTRACTORS, VENDORS, AND SU SHALL HOLD HARMLESS THE ARCHITECT FOR ANY PE OR DAMAGE TO THE PROJECT OR TO ADJACENT PROF TO AND DURING COURSE OF CONSTRUCTION.
	PROVIDE PHOTOS TO ARCHITECT ALONG WITH AN RFI FOR CLARIFICATION. THE CONTRACTOR SHALL PROVIDE AT ALL TIMES PROTECTION FROM	OWNER RESPONSIBLE FOR PROVIDING GEOTECHNICA NEEDED, FOR PURPOSES OF ENGINEERING AND CALC FOUNDATION WORK AT OR BELOW GRADE. GENERAL AND ALL SUBCONTRACTORS SHALL FOLLOW THE DES
	THE WEATHER AND EXCESSIVE DUST THAT MAY IN ANY WAY DAMAGE THE WORK, MATERIAL, FIXTURES, AND EQUIPMENT, OR PRESENT DANGER TO PERSONNEL. ANY WORK UNDER CONTRACT BY THE GENERAL CONTRACTOR DAMAGED BY A FAILURE TO PROVIDE	CALCULATIONS PROVIDED BY ENGINEER IN REFERENT WORK BEING PERFORMED AT AND/OR BELOW GRADE ALL CONCRETE TO HAVE A COMPRESSIVE STRENGTH
	ADEQUATE PROTECTION SHALL BE REMOVED AND REPLACED WITH NEW WORK AT THE SOLE EXPENSE OF THE CONTRACTOR.	28 DAYS UNLESS NOTED OTHERWISE BY STRUCTURA


PROJECT INFORMATION


ROBERTS ARCHITECTURE & CONSTRUCTION, INC.

6511 NOVA DRIVE, SUITE 268 DAVIE, FL 33317 954.600.1422

> CGC1522456 AR100680

		OWNER: TONY HANDLEY 845 N. NORTHLAKE DRIVE HOLLYWOOD, FL 33019
REE FROM CTION DEBRIS AND PARTITIONS Y ABOVE; TAPE APPLICABLE, AT	ANY CHANGES, REVISIONS, ALTERATIONS, ETC. REQUIRED TO THESE PLANS, DRAWINGS, SPECIFICATIONS, ETC. SHALL BE REQUESTED IN WRITING ONLY BY THE GENERAL CONTRACTOR OR THE OWNER TO THE ARCHITECT. ANY CHANGES, REVISIONS, ALTERATIONS, DEVIATIONS, ETC. NOT MADE BY THE ARCHITECT WILL FULLY, UNCONDITIONALLY, AND TOTALLY RELEASE THE ARCHITECT FROM ANY AND ALL RESPONSIBILITY, CLAIMS, OR	MEP ENGINEER: JOSEPH SIMHON, P.E. NOHMIS 1985 S. OCEAN DR. SUITE GL-3 HALLANDALE BEACH, FL 33009 STRUCTURAL ENGINEER:
E AND SEAL OTHER ATED PARTITION	LIABILITIES AGAINST THE ARCHITECT FOR CULPABILITY, ETC. FROM DATE SHOWN ON PLANS ORIGIN UNTIL THE END OF TIME.	JOSEPH SIMHON, P.E. NOHMIS 1985 S. OCEAN DR. SUITE GL-3 HALLANDALE BEACH, FL 33009
ARD ABUTTING PIPING, D IN WALLS AND	ALL REINFORCEMENT STEEL TO BE PLACED IN ACCORDANCE WITH STRUCTURAL ENGINEERING DRAWINGS. CONTRACTOR IS RESPONSIBLE FOR ALL STRUCTURAL	
L ELECTRICAL RECESSED OR	COORDINATION AND SHALL NOTIFY ARCHITECT OF ANY DISCREPANCIES PRIOR TO POURING OF FLOOR SLABS, FOOTINGS, PADS, COLUMNS, ETC.	
ED WALLS WITH TAIN FIRE RATING. OCKING AS NT, INCLUDING C. WOOD	THESE CONSTRUCTION DOCUMENTS COMPLY WITH THE BUILDING ENVELOPE ENERGY REQUIREMENTS OF THE FLORIDA MODEL ENERGY CODE. CONTRACTOR SHALL FAMILIARIZE HIMSELF WITH GOVERNING CODE IN ITS ENTIRETY AND BUILD IN ACCORDANCE WITH ALL PROVISIONS OF THIS CODE WHICH MAY BE SPECIFICALLY ADDRESSED ON THE PLANS AND NOTES.	
ETAL STUDS MAY ED OTHERWISE IN OD, OR OTHER PPROVAL OF THE	LUMBER USED FOR JOISTS, RAFTERS, TRUSSES, COLUMNS, BEAMS, AND/OR STRUCTURAL MEMBERS SHALL BE STRESS GRADE NOT LESS THAN fb = 1000 PSI UNLESS OTHERWISE SPECIFIED; REFER TO STRUCTURAL ENGINEERING DRAWINGS. ALL LUMBER IN CONTACT WITH MASONRY OR CONCRETE TO BE PRESSURE TREATED.	Seal BLAINE F. ROBERTS
SCHEDULED SHALL DOM OR SIMILAR DNSTRUCTION.	APPLY AND/OR INSTALL ALL PRODUCTS AND MATERIALS ACCORDING TO MANUFACTURERS PUBLISHED INSTRUCTIONS OR, IF NO INSTRUCTIONS EXIST, INSTALL PER STANDARD INDUSTRY PRACTICES.	ARCHITECT FL. LIC. NO. AR100680
ENT MENT OF WORK.	SMOKE DETECTORS TO BE POWERED BY HOUSE ELECTRIC SERVICE AND HAVE BATTERY BACKUP. MULTIPLE DETECTORS	
IALL BE ASSUMED OSITION WHERE A OF BIDDING AND BSERVED COMMENCEMENT	MUST BE INTERCONNECTED AS PER F.B.C. SECTION 905.2.5. MIRRORS WITH A SURFACE AREA GREATER THAN 9 S.F. SHALL BE ANCHORED TO WOOD STUDS OR BACKING.	AKE DR ADDITI(
ONDITIONS OCCUR INCLUDE THE E ARCHITECT OF OF		NORTHL
TION OF THE HANGES TO CONSTRUCTION, _, AND PLUMBING ITTED TO OWNER ECT.		845 N. RESID
RS SHALL FIELD INDITIONS OF THE E TO S PRIOR TO EVEN CALENDAR		COPYRIGHT ROBERTS ARCHITECTURE & CONSTRUCTION, INC. THESE DOCUMENTS ARE THE PROPERTY OF ROBERTS © ARCHITECTURE & CONSTRUCTION, INC, ANY REPRODUCTION WITHOUT THE
ESE PLANS, SHALL L DISCREPANCIES; ARCHITECT WILL ID THE GENERAL ASSUME FULL S AND SHALL ER. ALL URFACES UNLESS E RESPONSIBLE NISTRATION,		WRITTEN CONSENT OF ROBERTS ARCHITECTURE & CONSTRUCTION, INC. IS PROHIBITED. Revisions: COMMENTS (MM/DD/YYYY) 2 3 4 5 6 7 8 9 10
ENT. GENERAL SUPPLIERS, PERSONAL INJURY OPERTIES PRIOR		Submittal: CONSTRUCTION DOCUMENTS Scale: Date: AS NOTED JAN. 16, 2023 RAC - Job No. 22 00 08 CAD File Name:
CAL REPORT, AS LCULATING AL CONTRACTOR ESIGN AND ENCE TO ALL DE		845 N. NORTHLAKE DRIVE Drawn by: Checked by: BR BR Sheet title: GENERAL NOTES & DRAWING INDEX
TH OF 2500 PSI AT RAL ENGINEER.		Sheet no: G-001

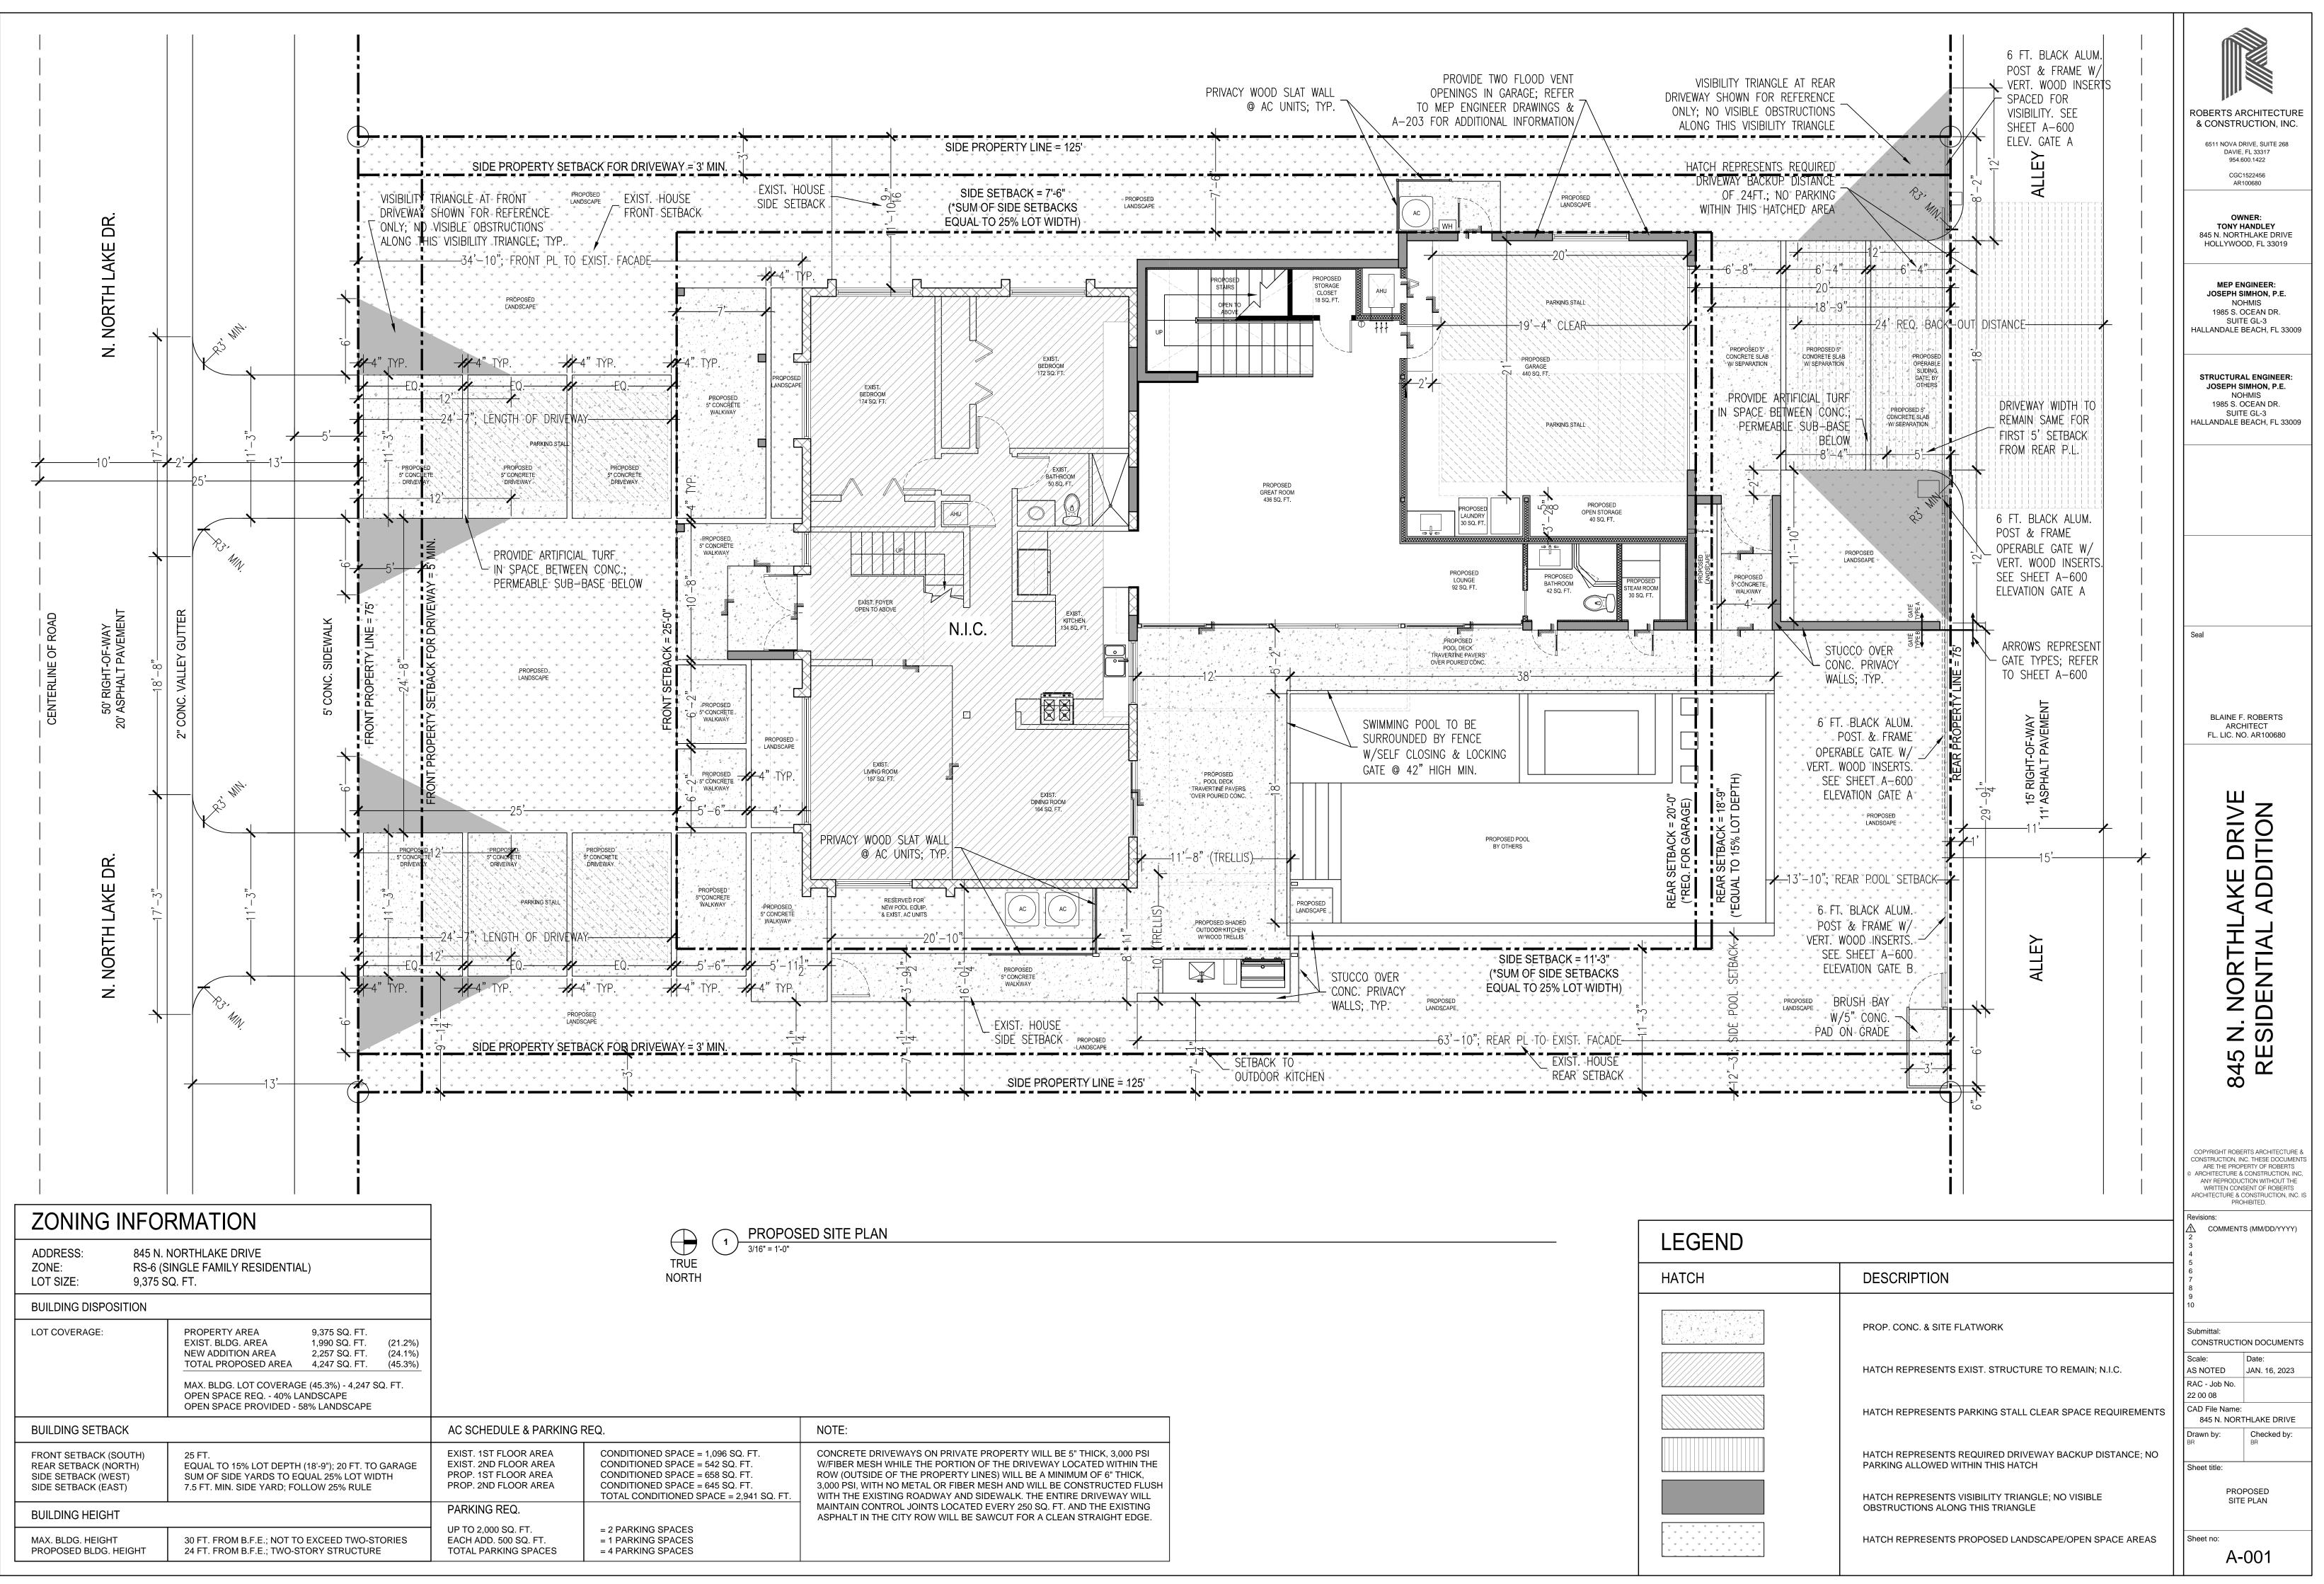

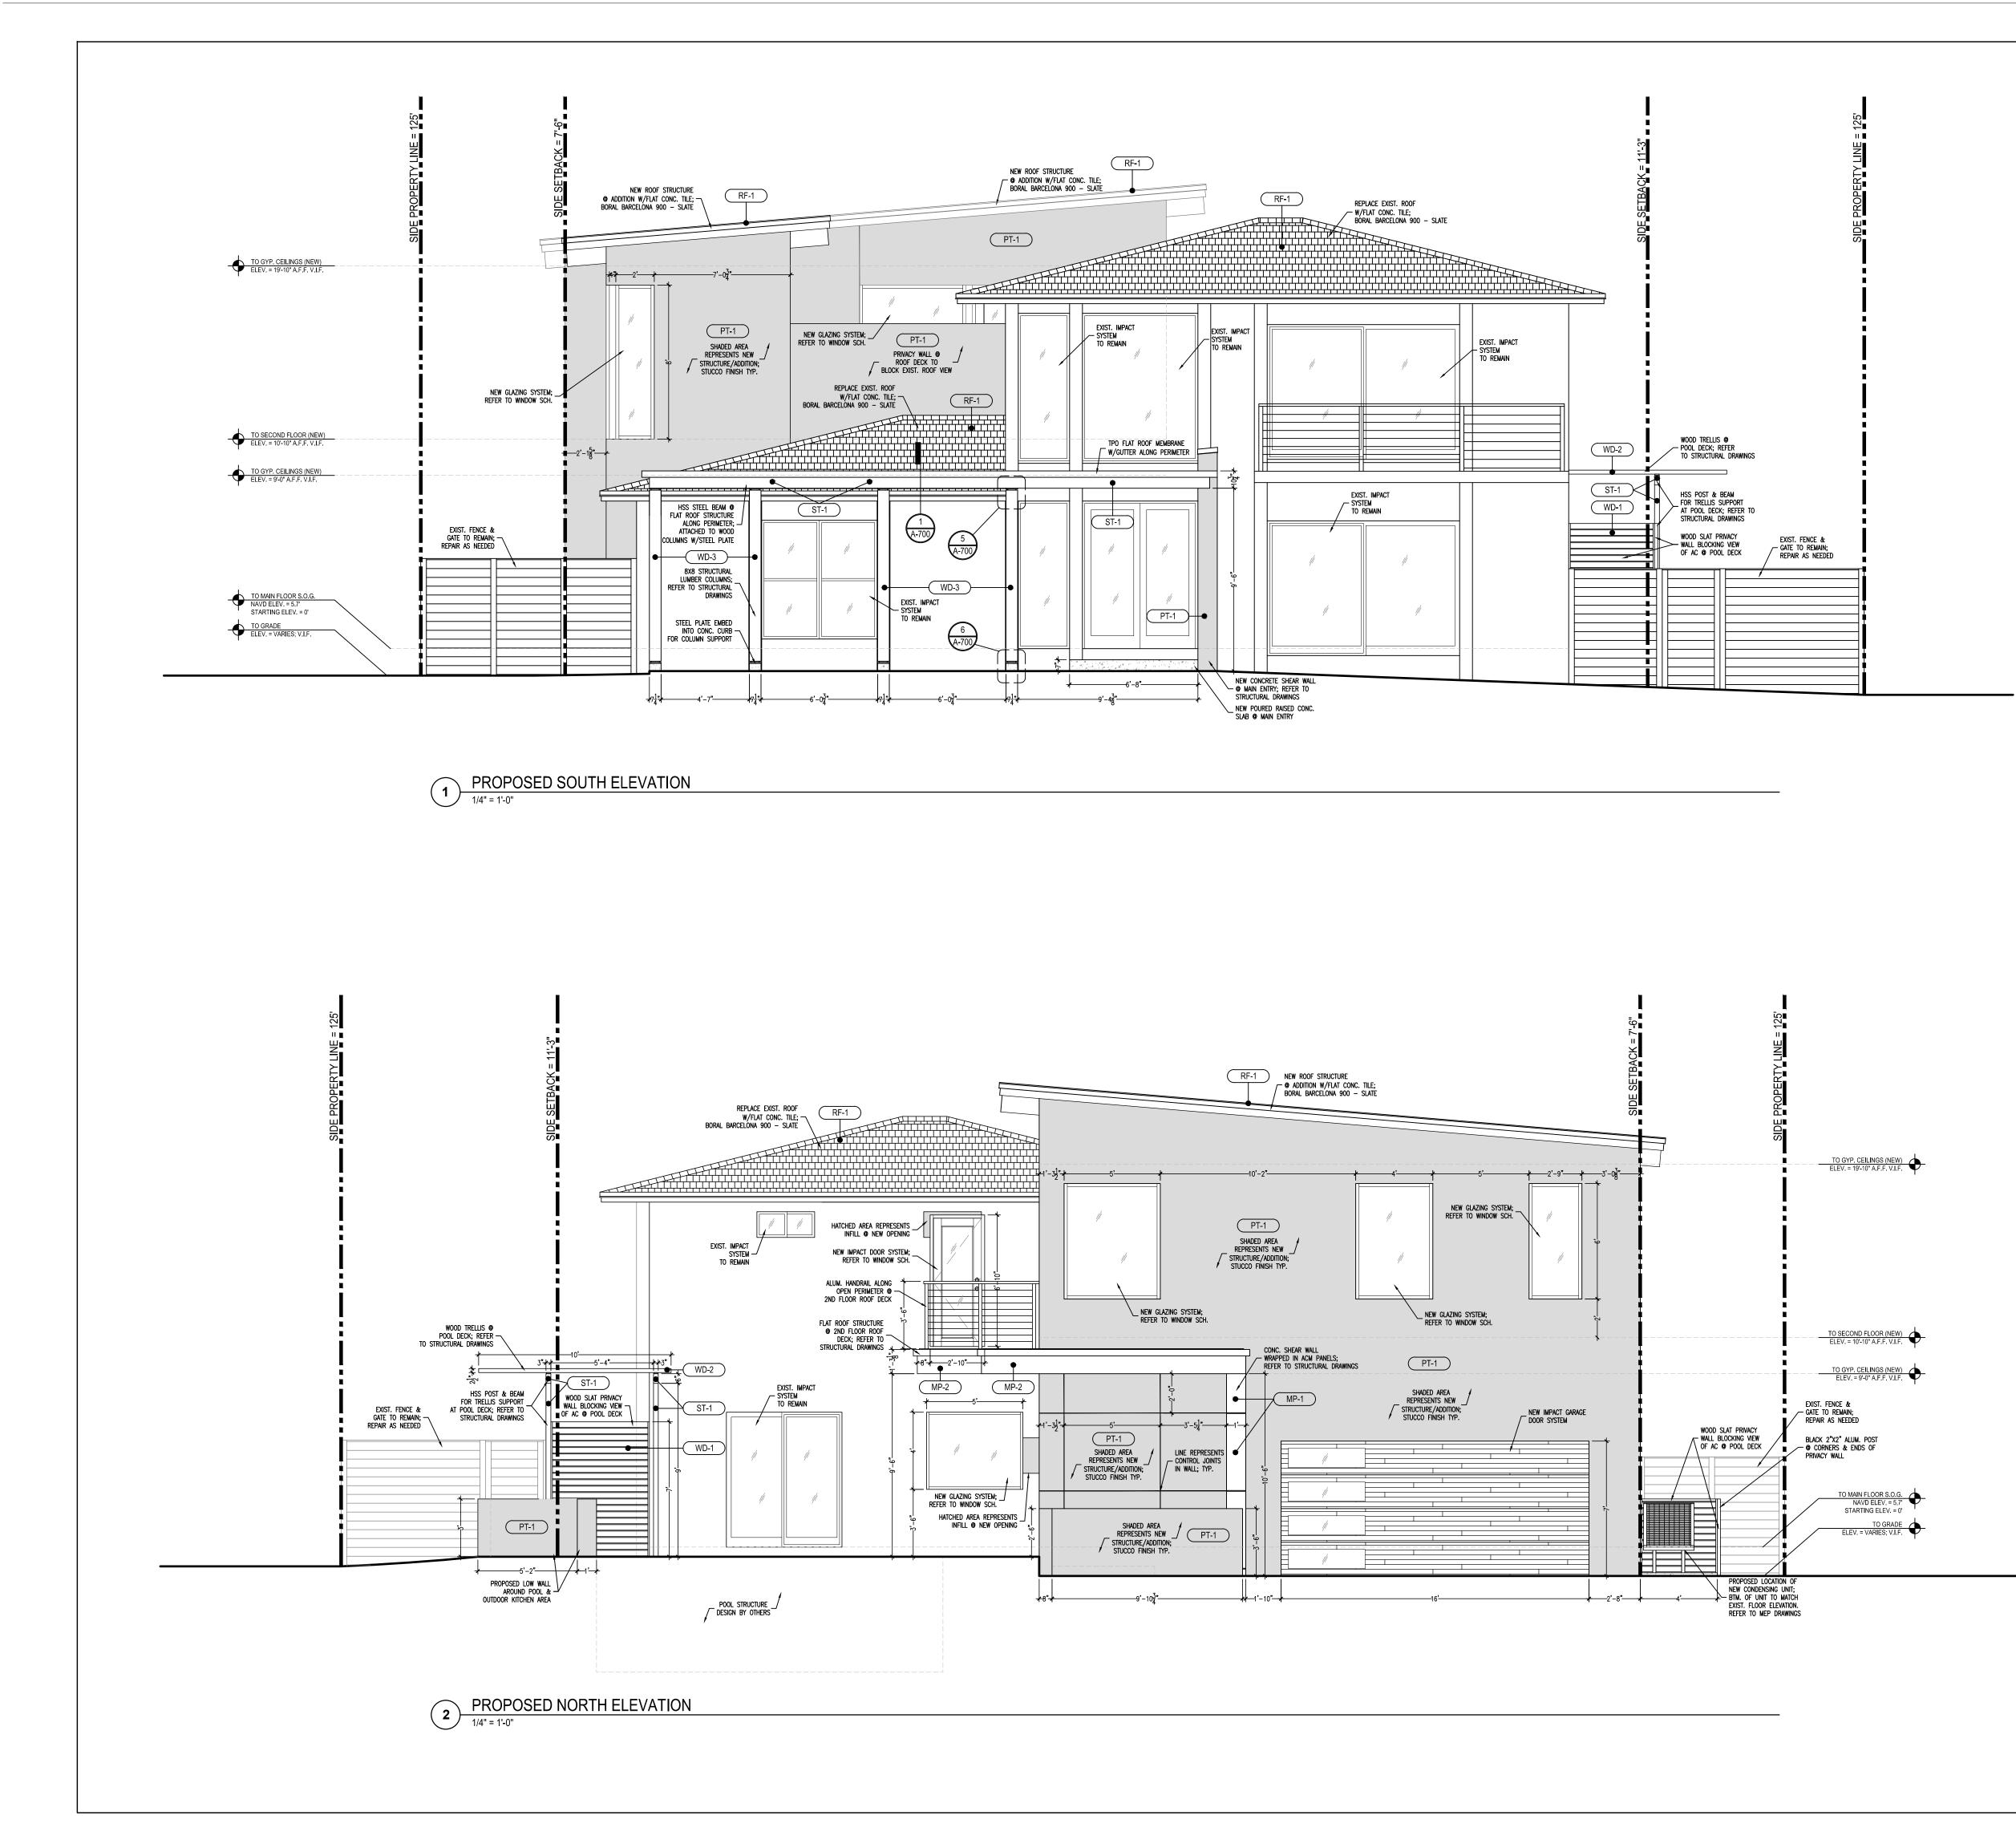

GENERAL NOTES

- A. ALL DIMENSIONS TO BE FIELD VERIFIED AND HELD PER DRAWING, UNLESS OTHERWISE NOTED. GC TO NOTIFY ARCHITECT IMMEDIATELY IF ANY DISCREPANCIES ARISE PRIOR TO COMMENCEMENT OF CONSTRUCTION DUE TO AS-BUILT CONDITIONS
- B. ALL DIMENSIONS ARE TO FACE OF FINISHED WALLS OR STRUCTURE, UNLESS OTHERWISE NOTED
- C. EXIST. BUILDING MATERIALS TO REMAIN UNLESS NOTED OTHERWISE. PROTECT EXISTING CONDITIONS DURING DEMOLITION AND CONSTRUCTION OF ADJACENT AREAS OF WORK. PATCH AND REPAIR EXISTING MATERIALS TO LIKE NEW CONDITION, AS REQUIRED.


ELEV. FINISHES LEGEND:

PT-1	PAINT OVER STUCCO FINISH - SHERWIN WILLIAMS - COLOR - MATCH EXIST.
MP-1	ACM (ALUM. COMPOSITE PANEL) ALUCOBOND, CENTRIA, OR APPROVED EQUAL - COLOR - BRONZE
MP-2	ALUM. BREAK METAL PANEL - COLOR - BRONZE
RF-1	FLAT CONCRETE TILE BORAL OR APPROVED EQUAL - COLOR - BARCELONA 900 SLATE
WD-1	1X4 PT WOOD SLAT BOARD @ PRIVACY WALL - COLOR - STAIN TO BE SELECTED AND APPROVED BY OWNER
WD-2	1X3 PT WOOD @ TRELLIS - COLOR - STAIN TO BE SELECTED AND APPROVED BY OWNER
WD-3	8X8 STRUCTURAL WOOD POST (REFER TO STRUCTURAL DRAWINGS) - COLOR - STAIN TO BE SELECTED AND APPROVED BY OWNER

ST-1 STRUCTURAL STEEL (REFER TO STRUCTURAL DRAWINGS) - COLOR - SHOP FINISHED BRONZE

ROBERTS ARCHITECTURE & CONSTRUCTION, INC. 6511 NOVA DRIVE, SUITE 268 DAVIE, FL 33317 954.600.1422 CGC1522456 AR100680 OWNER: TONY HANDLEY 845 N. NORTHLAKE DRIVE HOLLYWOOD, FL 33019 MEP ENGINEER: JOSEPH SIMHON, P.E. NOHMIS 1985 S. OCEAN DR. SUITE GL-3 HALLANDALE BEACH, FL 33009 STRUCTURAL ENGINEER: JOSEPH SIMHON, P.E. NOHMIS 1985 S. OCEAN DR. SUITE GL-3 HALLANDALE BEACH, FL 33009 Seal BLAINE F. ROBERTS ARCHITECT FL. LIC. NO. AR100680 DRIVE AKE N. NORTHL, SIDENTIAL 845 RE COPYRIGHT ROBERTS ARCHITECTURE & CONSTRUCTION, INC. THESE DOCUMENTS ARE THE PROPERTY OF ROBERTS ARCHITECTURE & CONSTRUCTION, INC ANY REPRODUCTION WITHOUT THE WRITTEN CONSENT OF ROBERTS ARCHITECTURE & CONSTRUCTION, INC. IS PROHIBITED. Revisions COMMENTS (MM/DD/YYYY) Submittal: CONSTRUCTION DOCUMENTS Scale: Date: AS NOTED JAN. 16, 2023 RAC - Job No. 22 00 08 CAD File Name: 845 N. NORTHLAKE DRIVE Drawn by: Checked by: Sheet title: PROPOSED ELEVATIONS Sheet no:

A-202

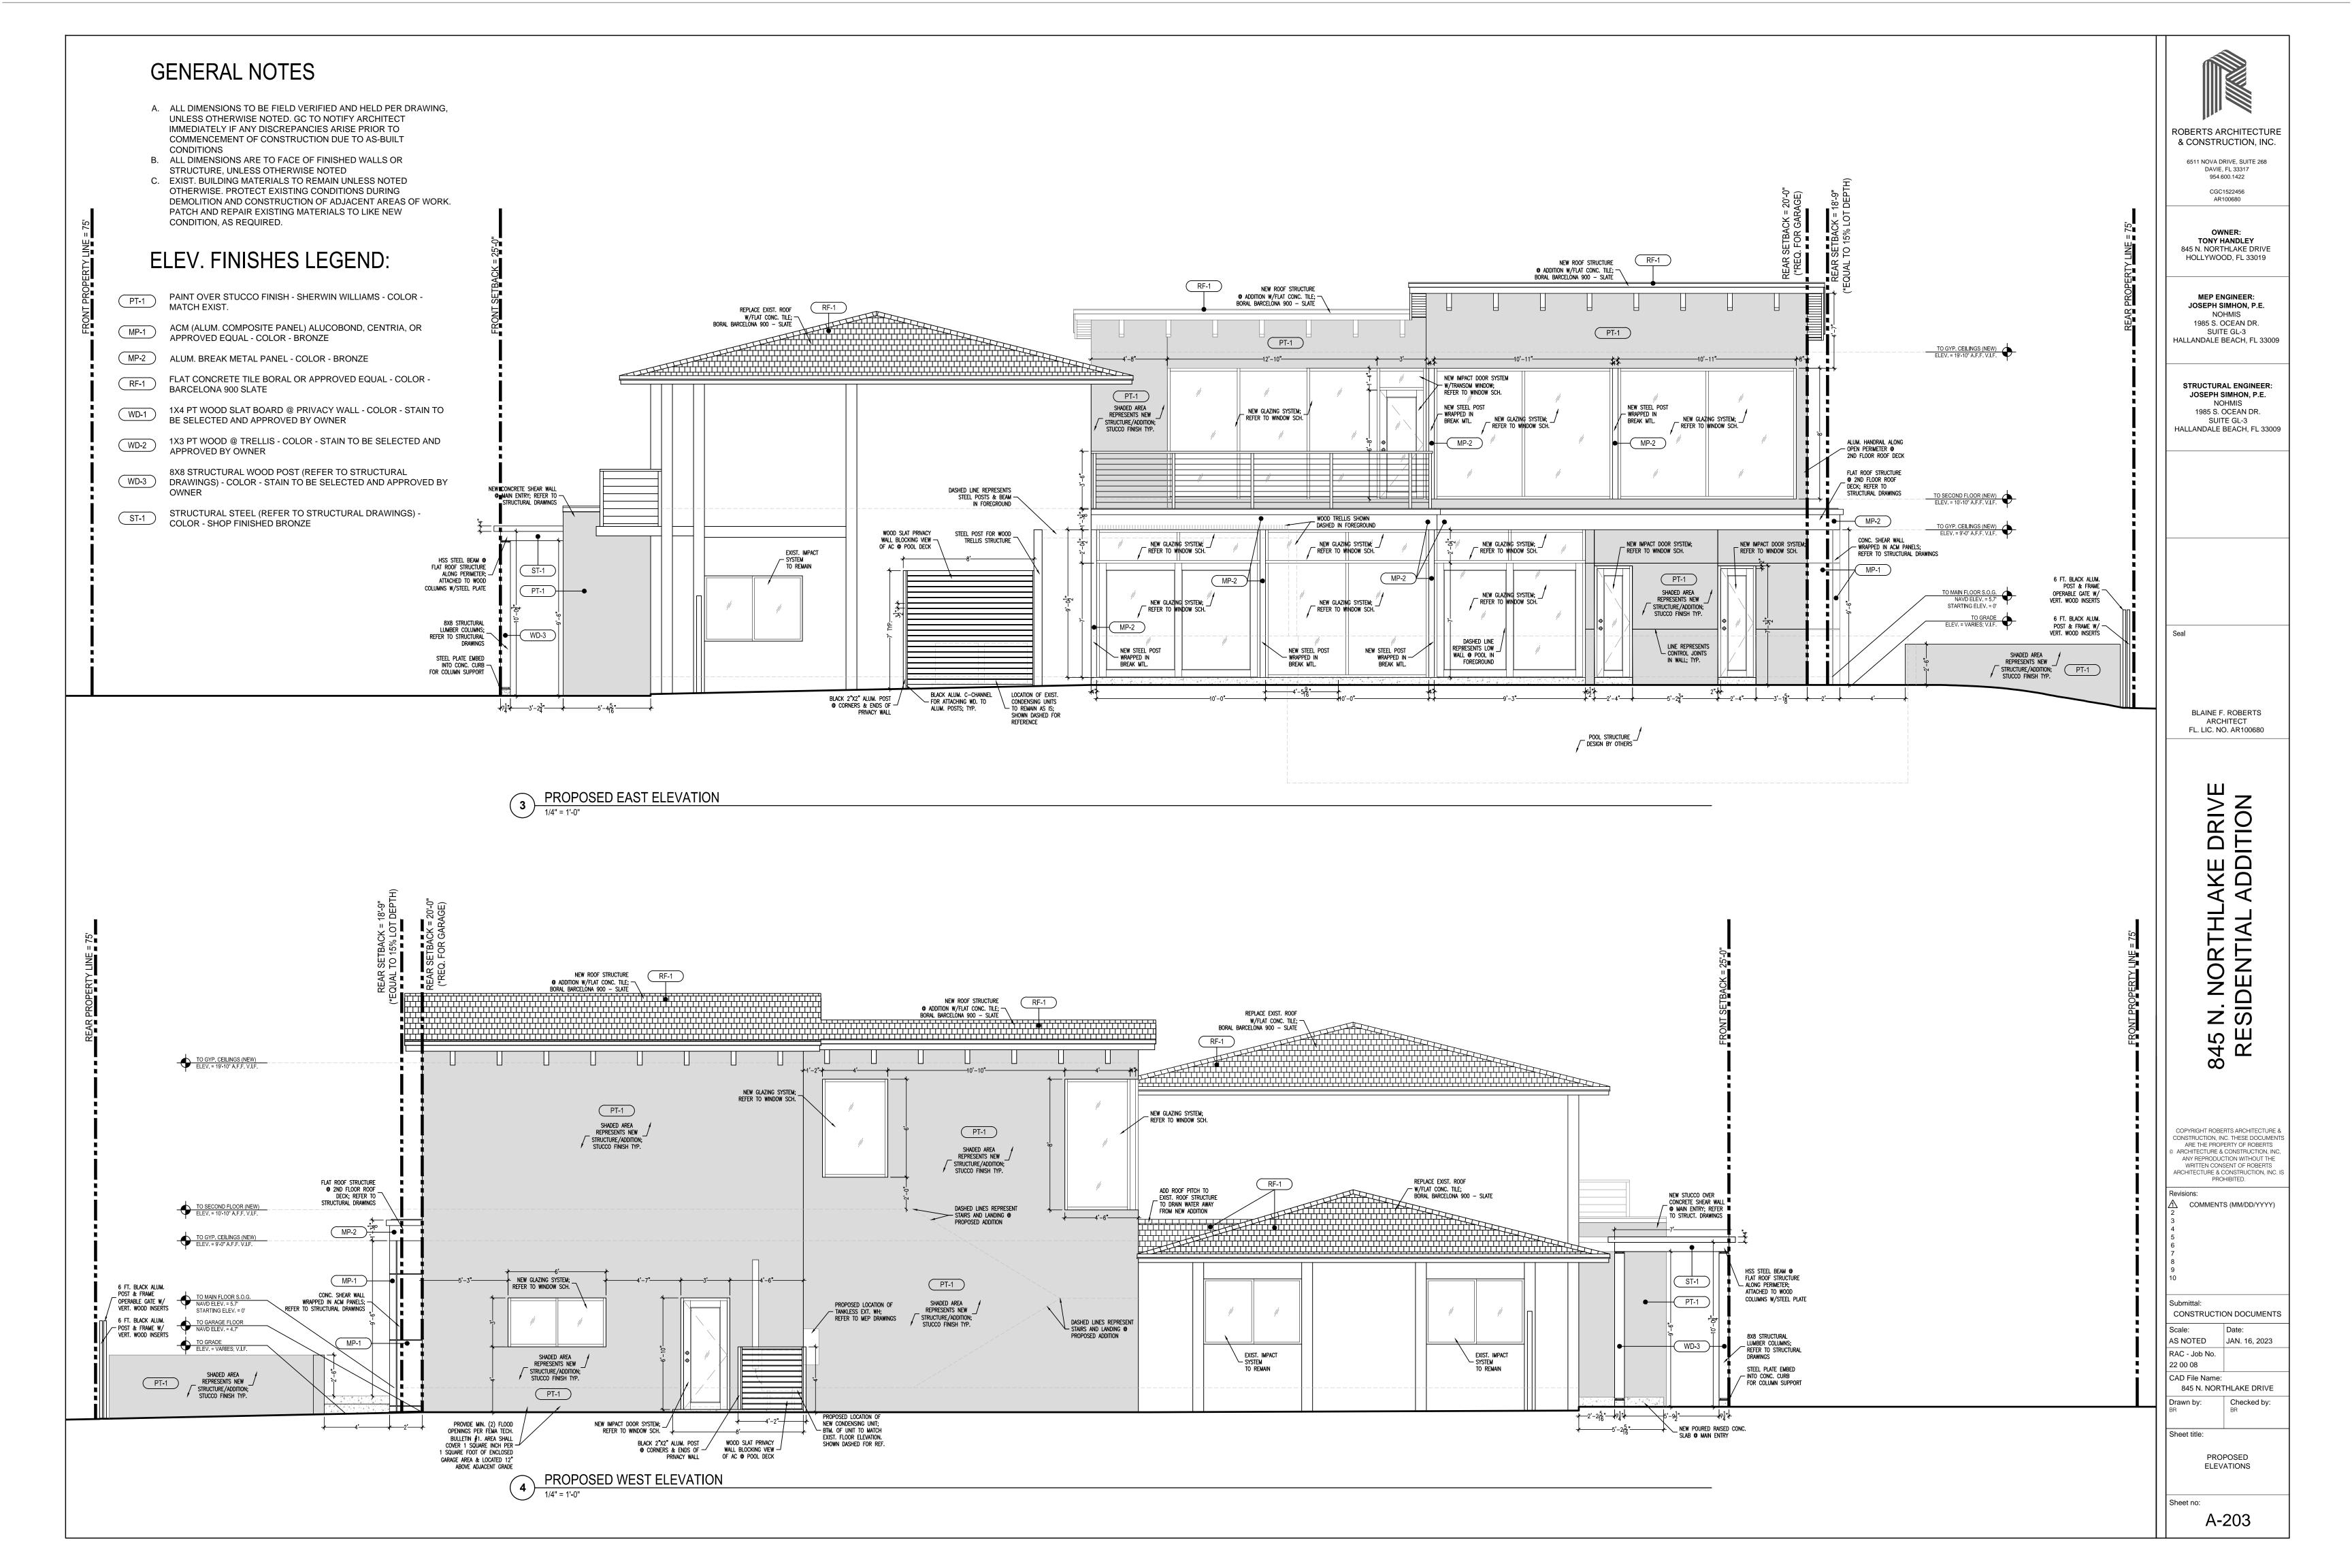

SITE CONDITION ANALYSIS

CRITERIA ANALYSIS

INTEGRITY OF LOCATION:

THE PROPERTY LOCATED AT 845 N. NORTH LAKE DRIVE WAS BUILT IN THE LATE 1970'S IN THE LAKES AREA HISTORIC MULTIPLE RESOURCE LISTING DISTRICT. THIS DISTRICT IS DESIGNATED MOSTLY FOR RESIDENTIAL PROPERTIES AND THIS SPECIFIC PROPERTY IS CLASSIFIED AS A SINGLE FAMILY RESIDENCE. THE SINGLE FAMILY STRUCTURE LOCATED TOWARDS THE FRONT OF THE PROPERTY IS SCHEDULED TO REMAIN AS IS, WITH LITTLE TO NO EXTERIOR MODIFICATIONS OR IMPROVEMENTS. THE ADDITION PROPOSED TOWARDS THE REAR OF THE PROPERTY IS DEFINED WITHIN THE SPECIFIED SETBACKS AND COMPLIMENTS SCALE AND SHAPE OF EXISTING STRUCTURE UTILIZING SAME STRUCTURE AND SIMILAR FINISHES.

DESIGN:

THE PROPOSED DESIGN OF THE NEW STRUCTURE IS MEANT TO COMPLIMENT AND NOT OVERPOWER THE EXISTING STRUCTURE'S FEATURES, MATCHING THE SCALE OF THE EXISTING STRUCTURE. THE PROPOSED STRUCTURE WILL BE CONSTRUCTED IN THE SAME WAY AS EXISTING STRUCTURE, WITH CONCRETE FOUNDATION AND PERIMETER CMU BLOCK CONSTRUCTION. THE MAJORITY OF VISIBLE FINISHES TO THE PUBLIC ON THE PROPOSED EXTERIOR FACADES WILL BE STUCCO, TO MATCH FINISH OF EXISTING STUCCO AT EXISTING STRUCTURE. THE PROPOSED STRUCTURE IS SCHEDULED TO BE PAINTED UPON COMPLETION TO MATCH EXISTING COLOR OF EXISTING STRUCTURE. THE DESIGN OF THE PROPOSED STRUCTURE UTILIZES THE NORTHWEST PORTION OF PROPERTY TO ADD NEW STRUCTURE, CREATING OPEN SPACE ON THE NORTHEAST TO BUILD NEW IN-GROUND POOL, RIGHT OFF THE EXISTING KITCHEN AND LIVING ROOM. THIS LOCATION ALLOWS FOR THE PROPOSED STRUCTURE TO MATCH THE SCALE OF EXISTING STRUCTURE AND ADJACENT STRUCTURE TO THE WEST ON THE CORNER LOT, WHEREAS, THE STRUCTURE ADJACENT TO THE EAST IS A SINGLE STORY STRUCTURE, AND WOULD BE OVERPOWERED BY THE SCALE OF A TWO STORY STRUCTURE.

SETTING:

THE PROPOSED SETTING OF THE NEW STRUCTURE WILL BE LOCATED ON THE REAR OF THE PROPERTY, SITUATED ON THE NW CORNER OF LOT. THIS LOCATION MINIMIZES THE IMPACT TO THE EXISTING STRUCTURE AND KEEPS THE FOCUS ON THE EXISTING STRUCTURE WHEN DRIVING ALONG N. NORTH LAKE DRIVE. THE SCALE OF THE PROPOSED STRUCTURE IS DESIGNED TO BLEND WITH THE SCALE OF BOTH THE EXISTING TWO STORY STRUCTURE AND THE ADJACENT TWO STORY STRUCTURE TO THE WEST. THE PROPOSED TWO STORY ADDITION ON THE REAR OF THE PROPERTY ALLOWS FOR PRIVATE ENTRY THROUGH THE ALLEY AND RESERVES REQUIRED SPACE FOR LANDSCAPE AND PERMEABLE SURFACES.

MATERIALS:

THE EXISTING STRUCTURE IS SCHEDULED TO REMAIN AS IS, WITH LITTLE TO NO CHANGES TO THE EXTERIOR AND STRUCTURAL COMPONENTS. THE ONLY MODIFICATIONS TO THE EXISTING STRUCTURE WOULD BE ON THE REAR OF THE PROPERTY, AWAY FROM PUBLIC EYE, TO ACCOMMODATE ACCESS TO NEW STRUCTURE. ALL FINISHES AT EXISTING PROPERTY ARE SCHEDULED TO REMAIN, AND THE INTEGRITY OF EXISTING STRUCTURE AND OVERALL AESTHETICS WILL BE UNDISTURBED. THE PROPOSED STRUCTURES DESIGN INTENT WILL BE TO BEST MATCH THE EXISTING FINISHES OF THE EXISTING STRUCTURE THROUGH QUALITY STANDARDS AND PROCEDURES IMPLEMENTED DURING CONSTRUCTION. THE FACADES OF THE PROPOSED STRUCTURE WILL BE STUCCO OVER CMU AND CONCRETE, WITH A FINISH TO MATCH EXISTING, EXISTING AND PROPOSED STRUCTURES WILL BE PAINTED TO MATCH, TO AVOID NEW STRUCTURE TAKING FOCUS OFF OF EXISTING STRUCTURE. THE PROPOSED DRIVEWAYS WILL BE POURED CONCRETE WITH SPACING IN BETWEEN SLABS TO ALLOW FOR WATER TO PERMEATE. SURROUNDING AREAS WILL BE PERMEABLE SURFACES, INCLUDING DESIGNATED LANDSCAPING AREAS AT FRONT AND REAR OF PROPERTY TO ASSIST IN RUNOFF CONTROL THROUGHOUT PROPERTY.



WORKMANSHIP:

THE KEY TO A SUCCESSFUL BUILD, AND MEETING THE DESIGN GUIDELINES WITHIN A HISTORIC DISTRICT, IS QUALITY CONSTRUCTION MANAGEMENT, AND QUALITY LABOR WHOM SPECIALIZES IN THE WORK BEING PERFORMED. OUR TEAM WILL BE CONTRACTING WITH LOCAL TRADES WITH A FOCUS ON EXPERIENCED LABOR AND QUALITY MATERIALS TO ACHIEVE SUCCESS IN MEETING THE DESIGN GUIDELINES FOR THIS HISTORIC NEIGHBORHOOD. ALL TRADES WILL BE REQUIRED TO BE LICENSED AND INSURED, AND EXTENSIVE RESEARCH WILL BE IMPLEMENTED TO SOURCE THE RIGHT TRADES WHOM CAN MATCH THE QUALITY OF WORK EXPECTED IN THIS HISTORIC DISTRICT. WE WILL AIM TO MINIMIZE DISTURBANCE TO THE SITE AND ELIMINATE DISTURBANCE OFF SITE. WE WILL STRIVE TO MINIMIZE OUR IMPACT TO THE SITE IN THE MACHINERY AND EQUIPMENT WE USE, AND MAINTAIN ACCEPTABLE NOISE IMPACT LEVELS TO ADJACENT RESIDENCES.

ASSOCIATION:


OUR INTENT IS TO MAINTAIN INTEGRITY BETWEEN WHAT IS BEING PROPOSED AND BUILT AND WHAT CURRENTLY EXISTS, NOT JUST ON SITE, BUT WITHIN ADJACENT PROPERTIES. WE WERE CONSCIOUS IN THE DESIGN PROCESS, IDENTIFYING KEY FEATURES AND COMPONENTS AND THEIR VISIBILITY TO THE PUBLIC AND HOW THAT AFFECTS THE OVERALL AESTHETICS OF THE EXISTING STRUCTURE, PROPERTY AND ADJACENT SITES. THE LOCATION OF THE ADDITION ON THE NORTH SIDE OF THE PROPERTY ENSURES THE EXISTING STRUCTURE ON SOUTH SIDE OF PROPERTY REMAINS THE FOCAL POINT, AND THE VIEW ALONG N. NORTH LAKE DRIVE REMAINS UNDISTURBED.

STREET AND ADJACENT PROFILE ELEVATION

ROBERTS ARCHITECTURE & CONSTRUCTION, INC. 6511 NOVA DRIVE, SUITE 268 DAVIE, FL 33317 954.600.1422 CGC1522456 AR100680 OWNER: TONY HANDLEY 845 N. NORTHLAKE DRIVE HOLLYWOOD, FL 33019 MEP ENGINEER: JOSEPH SIMHON, P.E. NOHMIS 1985 S. OCEAN DR. SUITE GL-3 HALLANDALE BEACH, FL 33009 STRUCTURAL ENGINEER: JOSEPH SIMHON, P.E. NOHMIS 1985 S. OCEAN DR. SUITE GL-3 HALLANDALE BEACH, FL 33009 Seal BLAINE F. ROBERTS ARCHITECT FL. LIC. NO. AR100680 Ш **Z** DR шΩ $\overline{\Delta}$ D 1 \triangleleft Т Н ____ 0 R F žЪ Ш z <u>v</u> SШ 4 K ∞ COPYRIGHT ROBERTS ARCHITECTURE & ONSTRUCTION, INC. THESE DOCUMENT ARE THE PROPERTY OF ROBERTS ARCHITECTURE & CONSTRUCTION, IN ANY REPRODUCTION WITHOUT THE WRITTEN CONSENT OF ROBERTS ARCHITECTURE & CONSTRUCTION, INC. IS PROHIBITED COMMENTS (MM/DD/YYYY Submittal: CONSTRUCTION DOCUMENTS Scale AS NOTED JAN. 16, 2023 RAC - Job No 22 00 08 CAD File Name: 845 N. NORTHLAKE DRIVE Checked by: Drawn bv Sheet title: SITE CONDITION ANALYSIS

Sheet no

G-003

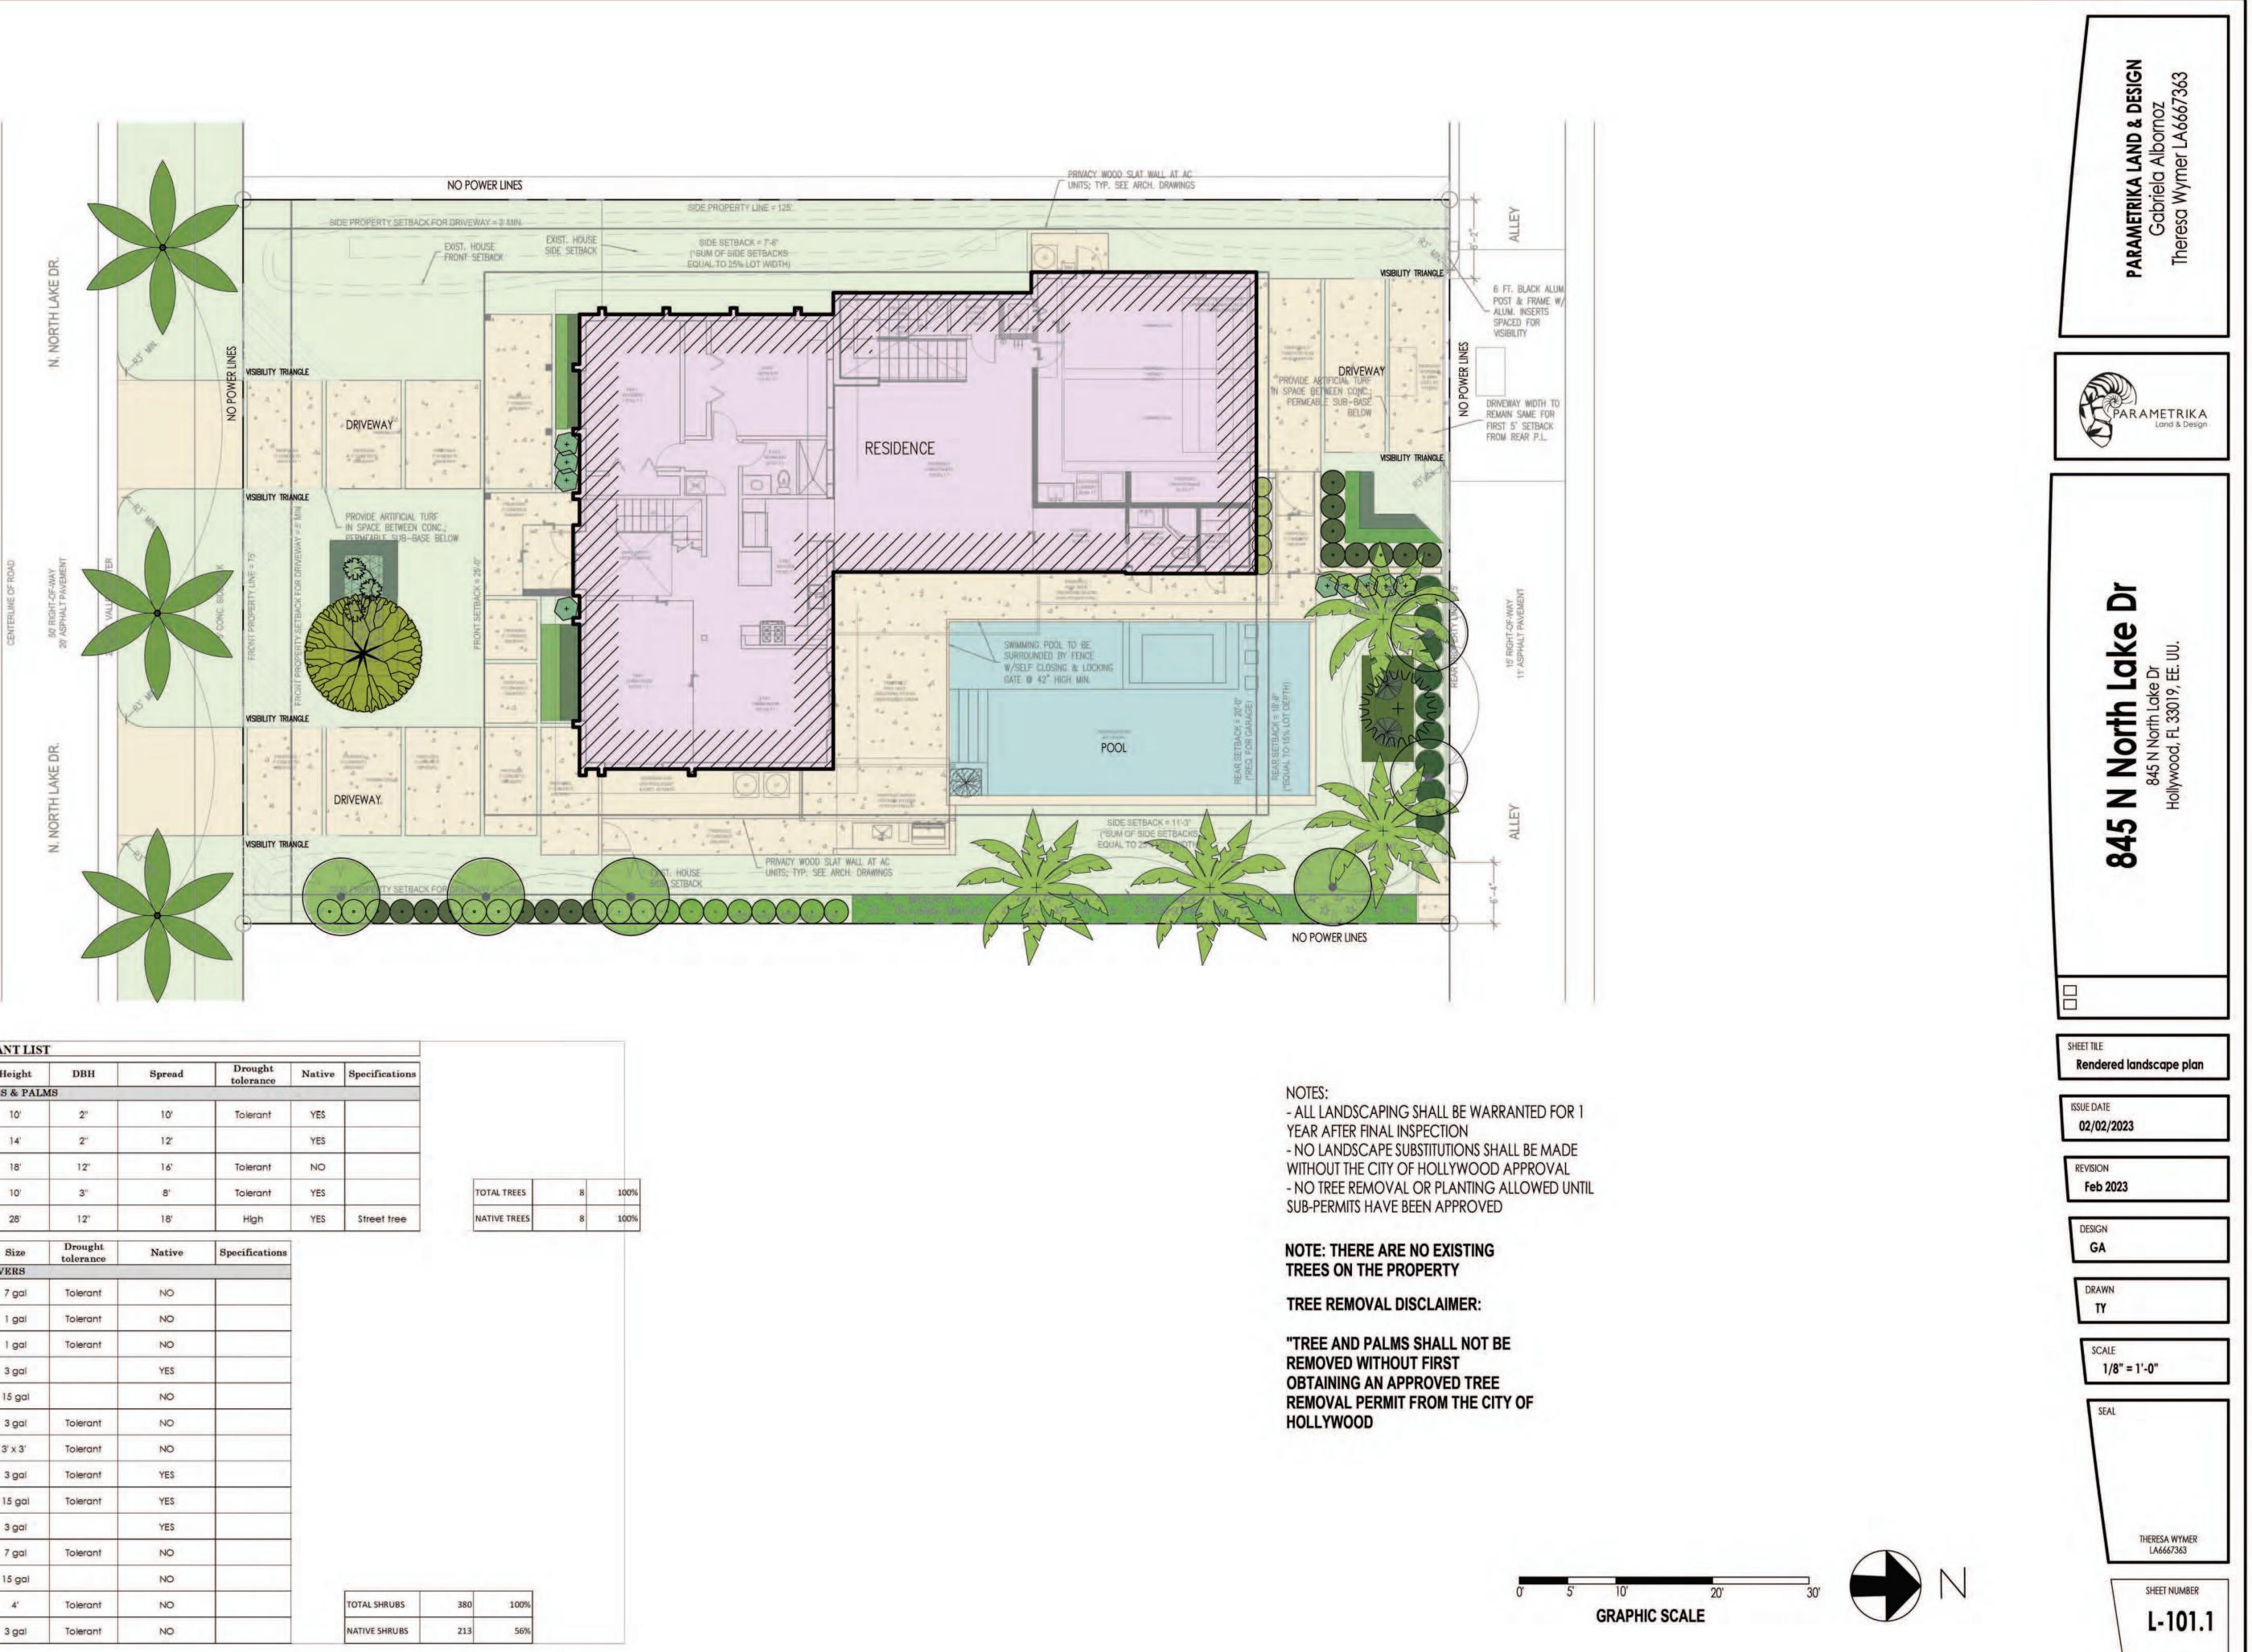

		1	PLANT LIST	r				
Qty.	Common name	Botanical Name	Height	DBH	Spread	Drought tolerance	Native	Specifications
		TI	REES & PALI	MS				-
1	Satin Leaf	Chrysophyllum ollviforme	10'	2"	10'	Tolerant	YES	
1	Orange Geiger	Cordia sebestena	14'	2"	12		YES	
4	Coconut Palm	Cocos nucifera	18'	12"	16'	Tolerant	NO	
6	Green Buttonwood	Conocarpus erectus	10'	3"	8'	Tolerant	YES	
3	Florida Royal Palm	Roystonea elata	28'	12"	18'	High	YES	Street tree
Qty.	Common name	Botanical Name	Size	Drought tolerance	Native	Specifications		
-		SHRUBS & GROUND	COVERS	tolerance	1// 2-0/			
3	Bromelia Odorata	Alcantarea Odorata	7 gal	Tolerant	NO			
91	Corol Creeper	Antigonon leptopus	1 gal	Tolerant	NO			
14	Ornamental peanuts	Arachis glabrata	1 gal	Tolerant	NO			
51	Green cocoplum	Chrysobalanus icaco 'Green'	3 gal		YES			
9	Small Leaf Clusia	Clusia guttifera	15 gal		NO			
52	Cotoneaster	Cotoneaster dammeri	3 gal	Tolerant	NO			
3	King sago	Cycad revoluta	3' × 3'	Tolerant	NO			
42	Firebush	Hamelia patens	3 gal	Tolerant	YES			
10	Simpson's stopper	Myrclanthes frangans	15 gal	Tolerant	YES			
110	Fakahatchee Grass	Tripsacum dacty loides	3 gal		YES			
5	Xanadu	Philodendron xanadu	7 gal	Tolerant	NO			
20	Podocarpus	Podocarpus macrophyllus	15 gal		NO			
9	Lady palm	Rhapis excelsa	4'	Tolerant	NO			TOTAL SHRUBS
66	Ground Orchid	Spathoglottis plicata	3 gal	Tolerant	NO			NATIVE SHRUBS



GENERAL NOTES AND SPECIFICATIONS:

I. APPLICABLE CODES

1. ALL WORK AND MATERIALS SHALL CONFORM TO CURRENT CITY OF HOLLYWOOD PUBLIC WORKS DEPARTMENT, CITY OF HOLLYWOOD BUILDING DEPARTMENT, BROWARD COUNTY PUBLIC WORKS DEPARTMENT, BROWARD COUNTY ENVIRONMENTAL PROTECTION & GROWTH MANAGEMENT, FLORIDA DEPARTMENT OF TRANSPORTATION (FDOT) STANDARDS AND SPECIFICATIONS AS WELL AS ALL LOCAL, STATE, AND NATIONAL CODES AND REGULATORY REQUIREMENTS, AS APPLICABLE.

2. THE CONTRACTOR SHALL BE RESPONSIBLE FOR ENSURING THAT ALL CONSTRUCTION AND DITCH EXCAVATION SHALL BE DONE IN A SAFE MANNER AND IN STRICT COMPLIANCE WITH ALL THE REQUIREMENTS OF FEDERAL OCCUPATIONAL SAFETY AND HEALTH ACT OF 1970, AND ALL STATE AND LOCAL SAFETY AND HEALTH REGULATIONS.

3. PROPOSED ELEVATIONS SHOWN ARE FINISHED GRADES REFERENCED TO NORTH AMERICAN VERTICAL DATUM, N.A.V.D., 1988.

3A. LOCATIONS AND ELEVATIONS OBTAINED FROM TOPOGRAPHIC SURVEY PREPARED BY: ACCURATE LAND SURVEYORS, INC. LB # 3635

4. EXISTING UTILITIES TO BE ADJUSTED IN ACCORDANCE WITH PROPOSED GRADES AND REQUIREMENTS OF UTILITY OWNERS, AS REQUIRED.

5. EXISTING STRUCTURES, TREES, UTILITIES, AND OTHER IMPROVEMENTS WHICH ARE TO REMAIN IN PLACE SUCH AS BUILDING SEWERS, DRAINS, WATER OR GAS PIPES, CONDUITS, POLES, WALLS, COLUMNS, ETC., WHETHER OR NOT SHOWN ON THE PLANS, ARE TO BE CAREFULLY PROTECTED FROM DAMAGE. IF DAMAGE OCCURS FROM WORK PERFORMED UNDER THIS CONTRACT, THE CONTRACTOR SHALL PROMPTLY REPAIR THE DAMAGED ITEM(S) TO THE CONDITION OF THE ITEM(S) PRIOR TO THE DAMAGE. THIS WORK SHALL BE AT NO ADDITIONAL COST TO THE OWNER.

6. THE CONTRACTOR IS TO USE CAUTION WHEN WORKING IN OR AROUND AREAS OF OVERHEAD TRANSMISSION LINES AND UNDERGROUND UTILITIES.

7. CONTRACTOR SHALL PRESERVE ALL STREET SIGNS, PARKING METERS, BENCHES, TRAFFIC CONTROL SIGNS, TRAFFIC LOOPS, ETC. WHEN DIRECTED BY THE ENGINEER, THE CONTRACTOR SHALL REINSTALL OR DELIVER SAID PUBLIC PROPERTY TO THE COUNTY YARD.

8. THE CONTRACTOR SHALL TAKE SPECIAL NOTE OF SOIL CONDITIONS THROUGHOUT THIS PROJECT. ANY SPECIAL SHORING, SHEETING, OR OTHER PROCEDURES NECESSARY TO PROTECT ADJACENT PROPERTY, EITHER PUBLIC OR PRIVATE, DURING EXCAVATION OF SUBSOIL MATERIAL OR DURING THE FILLING OF ANY AREA, OR FOR ANY OPERATION DURING CONSTRUCTION, SHALL BE THE SOLE RESPONSIBILITY OF THE CONTRACTOR.

9. THE CONTRACTOR AND SUBCONTRACTORS SHALL OBTAIN A COPY OF THE HOLLYWOOD PUBLIC WORKS MANUAL, BROWARD COUNTY PUBLIC WORKS MANUAL, THE BROWARD WATER AND SEWER DEPARTMENT STANDARDS AND SPECIFICATIONS, THE FLORIDA DEPARTMENT OF TRANSPORTATION "STANDARD SPECIFICATIONS FOR ROAD AND BRIDGE CONSTRUCTION", AND THE FLORIDA BUILDING CODE (LATEST EDITIONS), AND BECOME FAMILIAR WITH THE CONTENTS PRIOR TO COMMENCING WORK, AND, UNLESS OTHERWISE NOTED, ALL WORK SHALL CONFORM AS APPLICABLE TO THESE STANDARDS AND SPECIFICATIONS.

10. THE CONTRACTOR SHALL BE RESPONSIBLE FOR FURNISHING ALL MATERIAL AND LABOR TO CONSTRUCT THE FACILITY AS SHOWN AND DESCRIBED IN THE CONSTRUCTION DOCUMENTS IN ACCORDANCE WITH THE APPROPRIATE APPROVING AUTHORITIES, SPECIFICATIONS, AND REQUIREMENTS. CONTRACTOR SHALL CLEAR AND GRUB ALL AREAS UNLESS OTHERWISE INDICATED, REMOVING TREES, STUMPS, ROOTS, MUCK, EXISTING PAVEMENT, AND ALL OTHER DELETERIOUS MATERIAL.

11. EXISTING UTILITIES SHOWN ARE LOCATED ACCORDING TO THE INFORMATION AVAILABLE TO THE ENGINEER AT THE TIME OF THE TOPOGRAPHIC SURVEY AND HAVE NOT BEEN INDEPENDENTLY VERIFIED BY THE OWNER OR THE ENGINEER. GUARANTEE IS NOT MADE THAT ALL EXISTING UNDERGROUND UTILITIES ARE SHOWN OR THAT THE LOCATION OF THOSE SHOWN ARE ENTIRELY ACCURATE. FINDING THE ACTUAL LOCATION OF ANY EXISTING UTILITIES IS THE CONTRACTOR'S RESPONSIBILITY AND SHALL BE DONE BEFORE COMMENCING ANY WORK IN THE VICINITY. FURTHERMORE, THE CONTRACTOR SHALL BE FULLY RESPONSIBLE FOR ANY AND ALL DAMAGES DUE TO THE CONTRACTOR'S FAILURE TO EXACTLY LOCATE AND PRESERVE ANY AND ALL UNDERGROUND UTILITIES. THE OWNER OR ENGINEER WILL ASSUME NO LIABILITY FOR ANY DAMAGES SUSTAINED OR COST INCURRED BECAUSE OF THE OPERATIONS IN THE VICINITY OF EXISTING UTILITIES OR STRUCTURES, NOR FOR TEMPORARY BRACING AND SHORING OF SAME. IF IT IS NECESSARY TO SHORE, BRACE, SWING, OR RELOCATE A UTILITY, THE UTILITY COMPANY OR DEPARTMENT AFFECTED SHALL BE CONTACTED AND THEIR PERMISSION OBTAINED REGARDING THE METHOD TO USE FOR SUCH WORK.

12. IT IS THE CONTRACTOR'S RESPONSIBILITY TO CONTACT THE VARIOUS UTILITY COMPANIES WHICH MAY HAVE BURIED OR AERIAL UTILITIES WITHIN OR NEAR THE CONSTRUCTION AREA BEFORE COMMENCING WORK. THE CONTRACTOR SHALL PROVIDE 48 HOURS MINIMUM NOTICE TO ALL UTILITY COMPANIES PRIOR TO BEGINNING CONSTRUCTION.

13. THE CONTRACTOR SHALL BE RESPONSIBLE FOR OBTAINING ALL REQUIRED CONSTRUCTION PERMITS AND BONDS IF REQUIRED PRIOR TO CONSTRUCTION.

14. THE CONTRACTOR SHALL HAVE AVAILABLE AT THE JOB SITE AT ALL TIMES ONE COPY OF THE CONSTRUCTION DOCUMENTS INCLUDING PLANS, SPECIFICATIONS, GEOTECHNICAL REPORT, AND SPECIAL CONDITIONS AND COPIES OF ANY REQUIRED CONSTRUCTION PERMITS.

15. ANY DISCREPANCIES ON THE DRAWINGS SHALL BE IMMEDIATELY BROUGHT TO THE ATTENTION OF THE OWNER AND ENGINEER BEFORE COMMENCING WORK. NO FIELD CHANGES OR DEVIATIONS FROM DESIGN ARE TO BE MADE WITHOUT PRIOR APPROVAL OF THE OWNER AND NOTIFICATION TO THE ENGINEER.

16. THE CONTRACTOR SHALL BE RESPONSIBLE FOR SUBMITTING TO THE OWNER AND ENGINEER A CERTIFIED RECORD SURVEY (AS-BUILT) SIGNED AND SEALED BY A PROFESSIONAL LAND SURVEYOR REGISTERED IN THE STATE OF FLORIDA DEPICTING THE ACTUAL FIELD LOCATION OF ALL CONSTRUCTED IMPROVEMENTS. ALL SURVEY COSTS WILL BE THE CONTRACTOR'S RESPONSIBILITY.

17. ANY WELLS DISCOVERED ON SITE THAT WILL HAVE NO USE MUST BE PLUGGED BY A LICENSED WELL DRILLING CONTRACTOR IN A MANNER APPROVED BY ALL JURISDICTIONAL AGENCIES. CONTRACTOR SHALL BE RESPONSIBLE FOR OBTAINING ANY WELL ABANDONMENT PERMITS REQUIRED.

18. ANY WELL DISCOVERED DURING EARTH MOVING OR EXCAVATION SHALL BE REPORTED TO THE APPROPRIATE JURISDICTIONAL AGENCIES WITHIN 24 HOURS AFTER DISCOVERY IS MADE.

19. ANY WELL TO REMAIN SHALL BE ADJUSTED TO GRADE BY THE CONTRACTOR.

20. ALL COPIES OF COMPACTION, CONCRETE, AND OTHER REQUIRED TEST RESULTS ARE TO BE SENT TO THE OWNER AND DESIGN ENGINEER OF RECORD DIRECTLY FROM THE TESTING AGENCY.

21. THE CONTRACTOR SHALL BE RESPONSIBLE FOR VERIFYING THAT THE PROPOSED IMPROVEMENTS SHOWN ON THE PLANS DO NOT CONFLICT WITH ANY KNOWN EXISTING OR OTHER PROPOSED IMPROVEMENTS. IF ANY CONFLICTS ARE DISCOVERED, THE CONTRACTOR SHALL NOTIFY THE OWNER PRIOR TO INSTALLATION OF ANY PORTION OF THE SITE WORK THAT WOULD BE AFFECTED. FAILURE TO NOTIFY OWNER OF AN IDENTIFIABLE CONFLICT PRIOR TO PROCEEDING WITH INSTALLATION RELIEVES OWNER OF ANY OBLIGATION TO PAY FOR A RELATED CHANGE ORDER.

22. THE CONTRACTOR SHALL BE RESPONSIBLE FOR DOCUMENTING AND MAINTAINING AS-BUILT INFORMATION WHICH SHALL BE RECORDED AS CONSTRUCTION PROGRESSES OR AT THE COMPLETION OF APPROPRIATE CONSTRUCTION INTERVALS AND SHALL BE RESPONSIBLE FOR PROVIDING AS-BUILT DRAWINGS TO THE OWNER FOR THE PURPOSE OF CERTIFICATION TO JURISDICTIONAL AGENCIES AS REQUIRED. ALL AS-BUILT DATA SHALL BE COLLECTED BY A STATE OF FLORIDA PROFESSIONAL LAND SURVEYOR WHOSE SERVICES ARE ENGAGED BY THE CONTRACTOR.

II. PRECONSTRUCTION RESPONSIBILITIES

1. THE INFORMATION PROVIDED IN THESE PLANS IS TO ASSIST THE CONTRACTOR IN ASSESSING THE NATURE AND EXTENT OF THE CONDITIONS WHICH MAY BE ENCOUNTERED DURING THE COURSE OF THE WORK. ALL CONTRACTORS ARE DIRECTED, PRIOR TO BIDDING, TO CONDUCT ANY INVESTIGATIONS THEY DEEM NECESSARY TO ARRIVE AT THEIR OWN CONCLUSIONS REGARDING THE ACTUAL CONDITIONS THAT WILL BE ENCOUNTERED AND UPON WHICH THEIR BIDS WILL BE BASED.

THE PRESENCE OF GROUNDWATER SHOULD BE ANTICIPATED ON THIS PROJECT. THE CONTRACTOR'S BID SHALL INCLUDE CONSIDERATION FOR ADDRESSING THIS ISSUE. THE CONTRACTOR SHALL PREPARE AND SUBMIT THE NECESSARY PERMIT APPLICATIONS AND SUPPORTING DOCUMENTS IN ORDER TO OBTAIN A DEWATERING PERMIT FROM THE SOUTH FLORIDA WATER MANAGEMENT DISTRICT AND THE BROWARD COUNTY DEPARTMENT OF ENVIRONMENTAL PROTECTION & GROWTH MANAGEMENT. 2. UPON THE RECEIPT OF THE "NOTICE TO PROCEED", THE CONTRACTOR SHALL CONTACT THE ENGINEER OF RECORD AND ARRANGE A PRE-CONSTRUCTION CONFERENCE TO INCLUDE ALL INVOLVED GOVERNMENTAL AGENCIES, UTILITY OWNERS, THE OWNER, AND THE ENGINEER(S) OF RECORD, AS APPLICABLE.

3. THE CONTRACTOR SHALL APPLY FOR AND PROCURE ALL PERMITS AND LICENSES, PAY ALL CHARGES, TAXES, ROYALTIES & FEES, AND GIVE ALL NOTICES NECESSARY TO COMPLETE THIS PROJECT.

4. THE CONTRACTORS SHALL COORDINATE WITH UTILITY COMPANIES TO ARRANGE FOR ANY REMOVAL, RELOCATION, AND TEMPORARY SUPPORT OF UTILITY FEATURES, ETC. AS NECESSARY TO COMPLETE THE WORK, IF APPLICABLE.

5. THE LOCATIONS OF THE UTILITIES SHOWN IN THE PLANS ARE APPROXIMATE ONLY. THE CONTRACTOR SHALL LOCATE AND EXPOSE ALL EXISTING UTILITIES TO BE CONNECTED SUFFICIENTLY AHEAD OF CONSTRUCTION TO ALLOW REDESIGN BY THE ENGINEER IF SUCH UTILITIES ARE FOUND TO BE DIFFERENT THAN THOSE SHOWN ON THE PLANS.

III. TYPICAL ENGINEER OBSERVATIONS AND 3RD PARTY TEST REPORTS REQUIRED

1. TYPICAL ENGINEER OBSERVATIONS: CONTRACTOR SHALL NOTIFY ENGINEER 48 HOURS IN ADVANCE OF THE FOLLOWING ACTIVITIES:

A. <u>SANITARY SEWER SYSTEM</u> – INFILTRATION/EXFILTRATION TEST OF THE NEW SANITARY SEWER COLLECTION SYSTEM UP TO THE POINT OF CONNECTION WITH THE EXISTING SYSTEM, AND INCLUDING ALL NEW SERVICE LATERALS.

B. <u>SANITARY SEWER MAINS</u> – LAMPING OF NEW SANITARY SEWER MAINS BETWEEN ALL NEW MANHOLES UP TO AND INCLUDING THE CONNECTION MANHOLE ON THE EXISTING SYSTEM.

- C. <u>POTABLE WATER DISTRIBUTION MAINS:</u>
 1) LIVE TAP CONNECTIONS TO EXISTING MAINS
 2) PRESSURE TEST IN ACCORDANCE WITH AWWA STANDARD C600
- D. <u>STORM DRAINAGE:</u>
- 1) DRAINAGE WELLS COMPLETED WELL PUMP TEST
- 2) DRAINAGE PIPE AND STRUCTURES PRIOR TO BACKFILL
- E. <u>LIMEROCK BASE</u> PRIOR TO AND DURING PLACEMENT OF LIMEROCK BASE

F. <u>FINISHED PAVEMENT</u> – PRIOR TO PLACEMENT OF ANY FINISHED ASPHALT, CONCRETE, AND/OR BRICK PAVING.

- G. SUBSTANTIAL COMPLETION
- H. FINAL INSPECTION

REGARDLESS OF WHETHER OR NOT THE ABOVE ARE WITNESSED BY OTHERS, IF THE CONTRACTOR FAILS TO NOTIFY THE ENGINEER OF RECORD AT LEAST 48 HOURS PRIOR AND THESE ARE COMPLETED WITHOUT THE ENGINEER OF RECORD PRESENT, THE CONTRACTOR SHALL AGAIN EXPOSE THE WORK AND REPEAT ALL TESTS AS REQUESTED BY THE ENGINEER OF RECORD AT NO ADDITIONAL COST TO THE CONTRACT. OTHERWISE, THE ENGINEER OF RECORD RESERVES THE RIGHT TO REFUSE ISSUANCE OF ANY CERTIFICATIONS.

2. THE CONTRACTOR SHALL BE RESPONSIBLE FOR COORDINATING AND CALLING FOR ANY TESTING AND INSPECTIONS REQUIRED BY CITY, COUNTY, STATE, AND FEDERAL AGENCIES HAVING JURISDICTION OVER THE CONTRACTOR'S WORK.

IV. SHOP DRAWINGS

PRIOR TO FABRICATION OR CONSTRUCTION, SHOP DRAWINGS SHALL BE SUBMITTED BY THE CONTRACTOR TO THE ENGINEER OF RECORD FOR REVIEW OF THE FOLLOWING ITEMS:

1. DRAINAGE:

A. DRAINAGE INLETS, CATCH BASINS, MANHOLES, AND STRUCTURES, INCLUDING TOP/BOTTOM SLABS, FRAMES, GRATES, RIMS, AND POLLUTANT RETARDANT BAFFLES.

- B. TRENCH OR SLOT DRAINS INCLUDING CHANNELS, ANCHORS, GRATES, OUTLETS, ETC.
- C. DRAINAGE WELL STRUCTURES, CASING, AND GRATES.
- D. DRAINAGE PIPE AND FITTINGS.
- E. CLEANOUTS

2. WATER DISTRIBUTION:

- A. PIPE AND FITTINGS
- B. VALVES AND AIR RELEASE VALVES C. FIRE HYDRANTS
- D. BACKFLOW PREVENTION DEVICES
- E. METER VAULTS & BOXES
- F. TAPPING SLEEVES AND CORPORATION STOPS
- 3. <u>SANITARY SEWER:</u>

A. MANHOLES, INCLUDING STRUCTURES, TOP/BOTTOM SLABS, FRAMES AND RIMS

- B. PIPE AND FITTINGSC. CLEANOUTS
- D. VALVES AND AIR RELEASE VALVES
- E. PUMP STATION AND ALL RELATED EQUIPMENT
- 4. ASPHALT MIX
- A. SUBGRADE AND LIMEROCK BASE SECTIONS TO BE INCLUDED

V. TEMPORARY FACILITIES

1. TEMPORARY FACILITIES

A. IT SHALL BE THE CONTRACTOR'S RESPONSIBILITY TO ARRANGE FOR OR SUPPLY TEMPORARY WATER SERVICE, SANITARY FACILITIES, AND ELECTRICITY, DURING CONSTRUCTION.

B. IT IS THE CONTRACTOR'S RESPONSIBILITY TO COORDINATE MAINTENANCE OF TRAFFIC CIRCULATION FOR THE ADJACENT PROPERTY DURING CONSTRUCTION.

C. THE CONTRACTOR SHALL MAINTAIN AT LEAST ONE ACCESS ENTRANCE TO COMMERCIAL PROPERTIES AT ALL TIMES, IF APPLICABLE.

D. THE CONTRACTOR SHALL MAINTAIN A CLEAR PATH FOR ALL SURFACE WATER DRAINAGE STRUCTURES AND DITCHES DURING ALL PHASES OF CONSTRUCTION, IF APPLICABLE.

2. TRAFFIC REGULATION

A. THE CONTRACTOR SHALL PROVIDE ALL WARNING SIGNALS, SIGNS, LIGHTS, AND FLAG PERSONS AS NECESSARY FOR THE MAINTENANCE OF TRAFFIC WITHIN PUBLIC RIGHTS-OF-WAY IN ACCORDANCE WITH M.U.T.C.D. AND THE CITY OF HOLLYWOOD PUBLIC WORKS DEPARTMENT.

B. ALL OPEN TRENC PROPERLY MAI PEDESTRIAN TRAFFIC.

C. NO TRENCHES O LEFT OPEN DURING NIGH HOLLYWOOD PUBLIC WORI

VI. PROJECT CLOSE-OUT

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B. THE CONTRACTOR PRIVATE PROPERTY DAM AT LEAST EQUAL TO THA

C. THE CONTRACTOR SIDEWALKS, FENCES, CONSTRUCTION WITH PRIOR TO THE BEGINNING

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F. IMMEDIATELY PRI ALL DEBRIS AND F CURB, SIDEWAL

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3. PROJECT RECORD DOC

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4. CONTRACTOR TO REPL

5. REFER TO CITY OF HO

VII. PAVING

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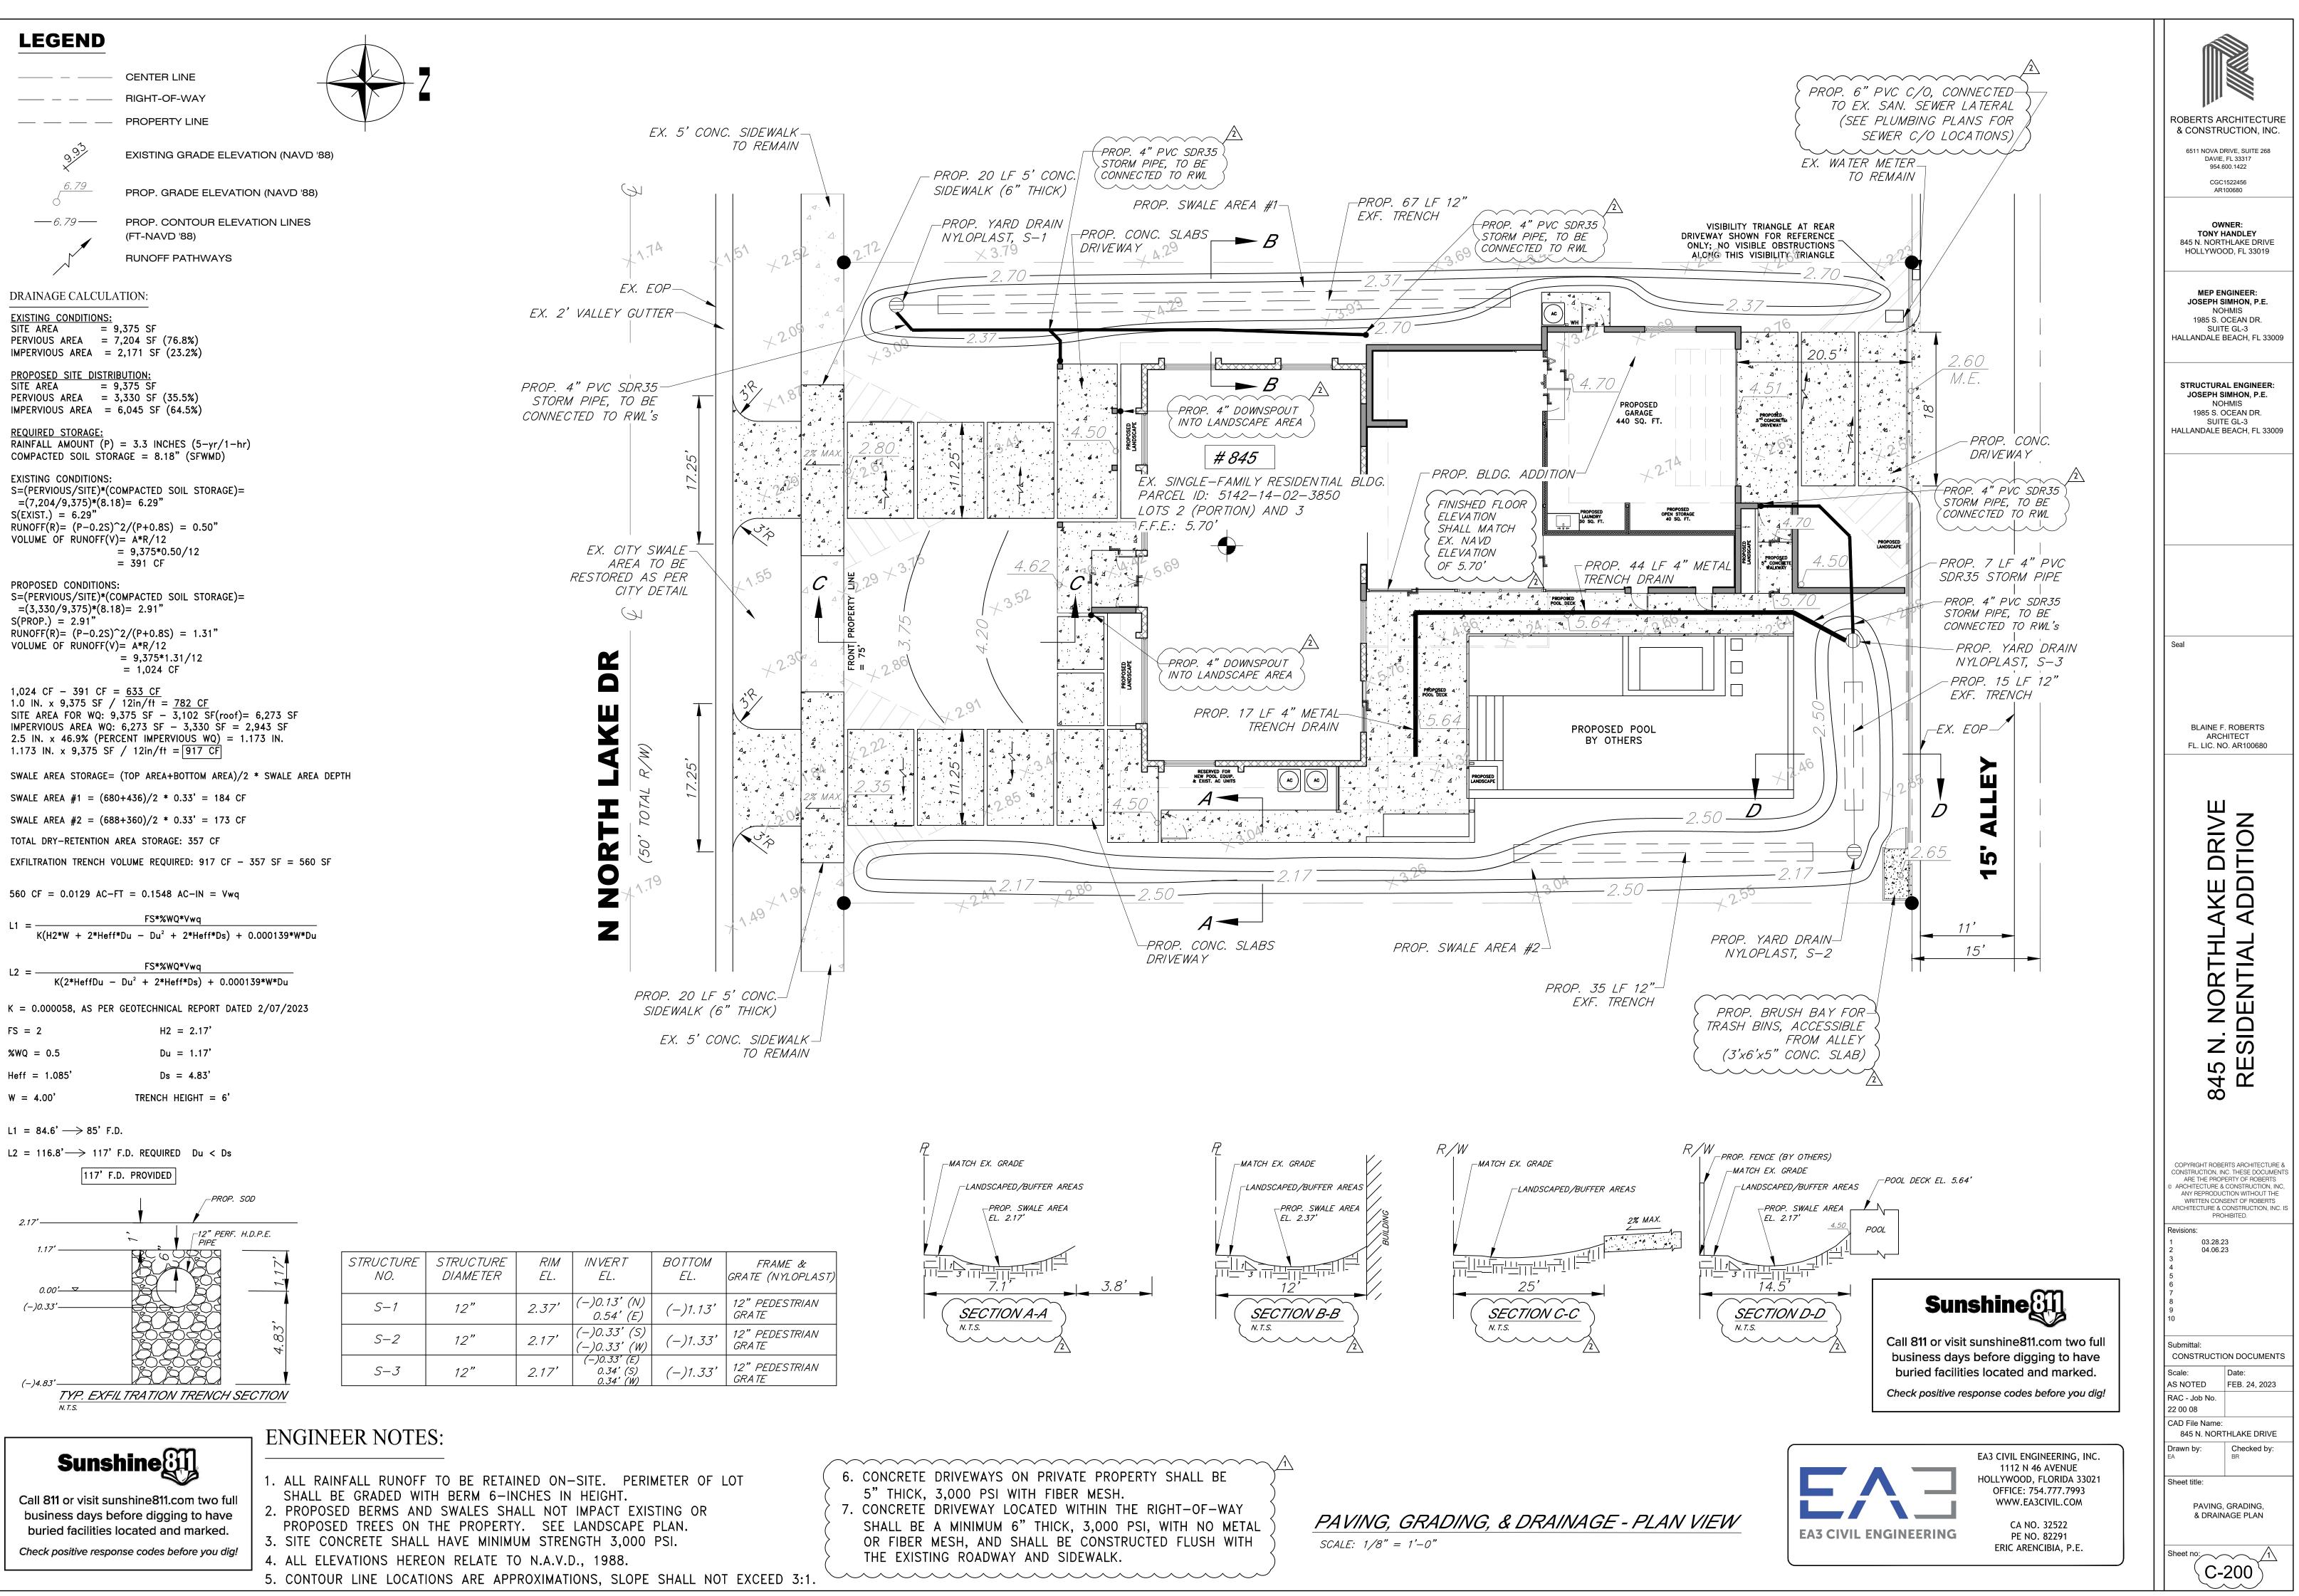
D. PROPOSED ASPH OF HOLLYWOOD PUBLIC V NEW SIDEWALK OR NEW


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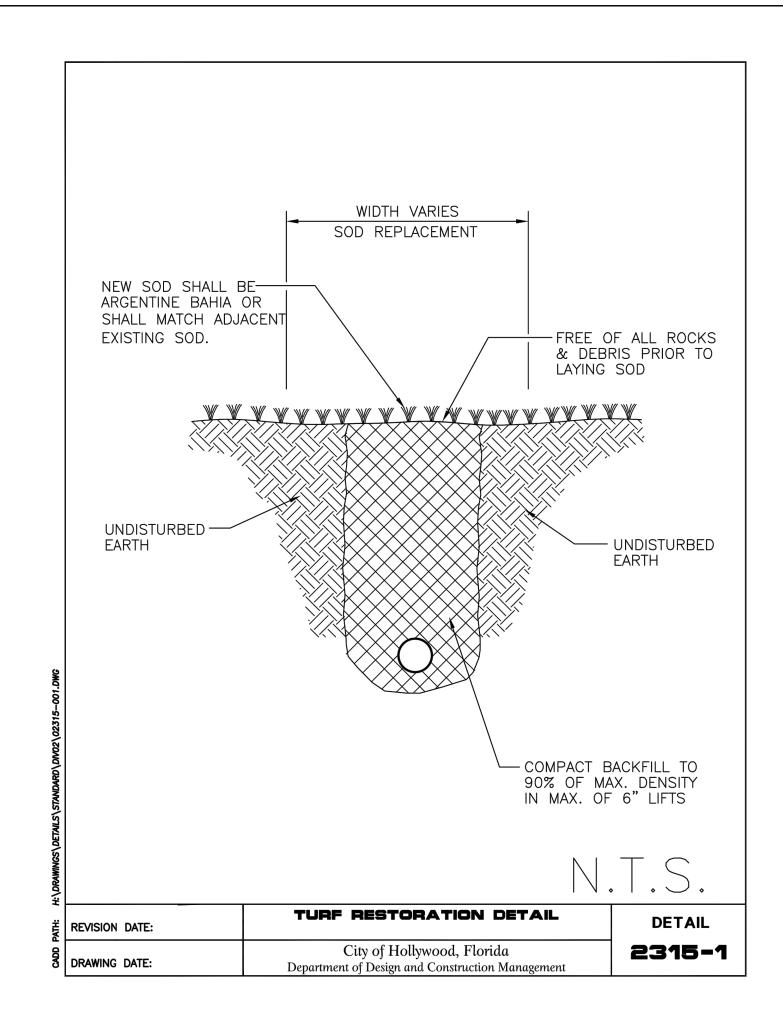
F. NONE OF THE EX THE PROPOSED LIMEROCK


CHE'S AND HOLES ADJACENT TO ROADWAYS OR WALKWAYS SHALL BE REFER AND BRARKARD TO ASSURE THE SAFETY OF DRITH YERULUR ADD OR HOLES MEAR WALKWAYS, IN ROADWAYS, OR THER SHOULDERS ARE TO RE THIS HOULS WHOUT THE EXPRESS PERMISSION OF THE CITY OF THE SOFARMENT, AND/OR THE FLORDA DEPARTMENT OF TRANSPORTATION. WOTTON THE PRODUCT STIE AND ALL ADJACENT AREAS SHALL BE MAINTAINED THE SAFE ALL OR TASKI. THE PRAYD AREAS SHALL BE BROAD CLEAN. IN SHALL RESIDE OR REPLACE, WHEN AND AS DRUCED, ANY PUBLIC OR MAGED BY HEX/HER WORK, 200HMANT, AND/OR EMELOYES TO A CONTION THE SOSTIM MAINTAILT. PHAND AT ALL ADJACENT AREAS SHALL BE MAINTAINED THE SASTIM MAINTAILT. PHAND AT ALL ADJACENT AREAS SHALL BE MAINTAINED IN SHALL RESIDE OR REPLACE, WHEN AND AS DRUCED, ANY PUBLIC OR MALEDRES, STORE OR REPLACE, WHEN AND AS DRUCED, ANY PUBLIC OR THE SASTIM MAINTAILT. PHAND AT ALL ADJACENT AREAS SHALL BE MAINTAINED THE SASTIM MAINTAILT. PHAND AT ALL ADJACENT AREAS SHALL BE MAINTAINED THE SASTIM MAINTAILT. PHAND AND THE REACH AND THE STREMATION THE SASTIM AREAS AND ANY ON THE MAND AREA AREAN THE REMAINS, SUCH MATERIAL OR DEAKS SHALL BE CONTROL AND DO OF OF CHEATIONS. LO OR DEAKS CART BASING, CONTRACTOR IS TO BE SHALL AND ADD OF OF CHEATIONS. LO OR DEAKS CART BASING, CONTRACTOR IS TO SWEEP ENTRE SITE, ELIMINAT HE CONTRACTORS CONTRACTOR IS TO SWEEP ENTRE SITE, ELIMINATION SHALL BE MADE OUTSIDE THE LINTS OF CONSTRUCTION AT A LEGAL DISFORM HE CONTRACTORS SHALL BE RESTRED BY A STATE OF FLORIDA. REGISTERED DO DUNG THE FLORING, CONTRACTOR IS ALL RECORD ON HS SET OF REMAINS OR PRANKENT PROPERENCES, REMOVED OR DESTROYED BY THE CONTRACTORS ENDERNE. CUMMENT OF THE REAR THECKED TO PRACTED THE SITE, CHANNEL MUNICATION THE REARCT LECATION SHALL BE PROPERLY. MUNICATION THE REARCH SECONDERING SHALL MAD DISKS. CLEVENTS ON PRANKENT PROPEREND TO ADD DISKS. CUMUNCTION THE REARCH SECONDERING CONCRETE CHER, CHER AND DO STANDARDS, CONTRACTOR SHALL MACH EXISTING FLEVATIONS ON MULTICES SHALL BE COMPLETED TO RECTED TO EXISTING AS PER FEDT AND D		
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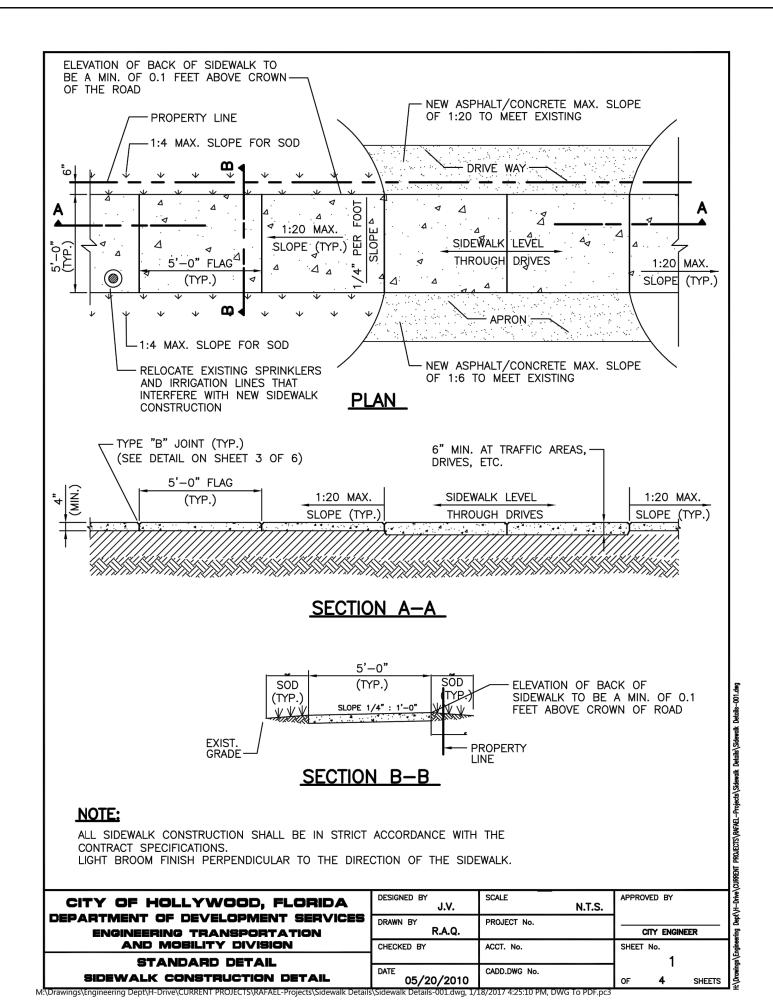











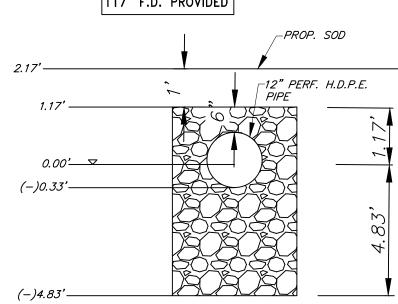

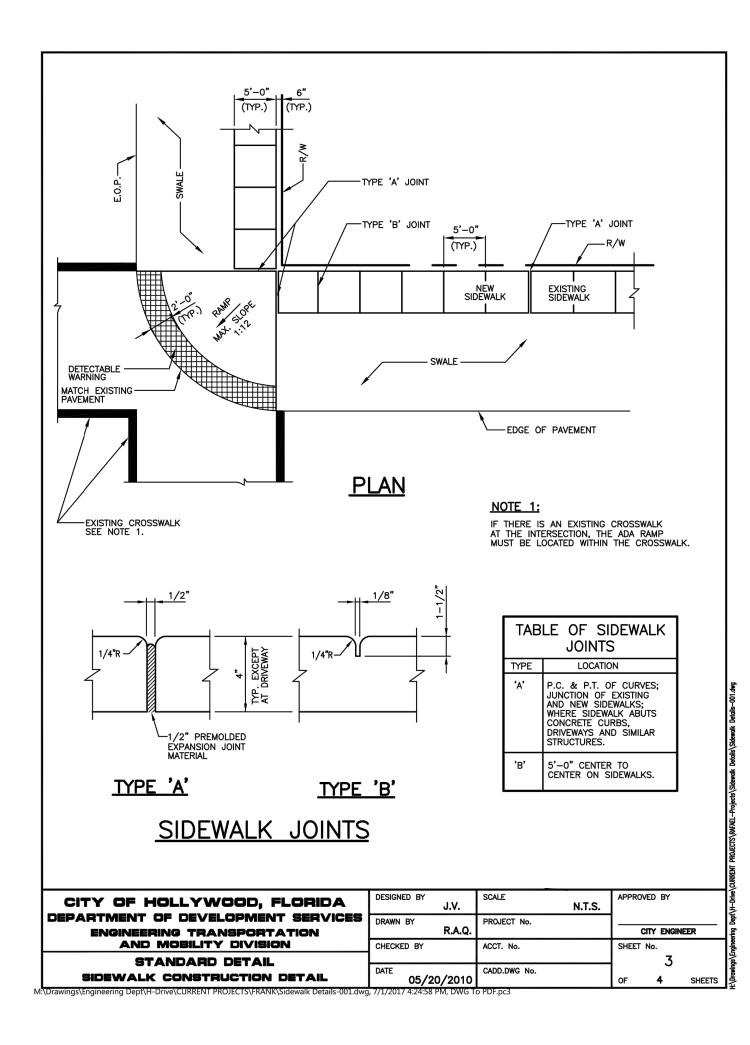

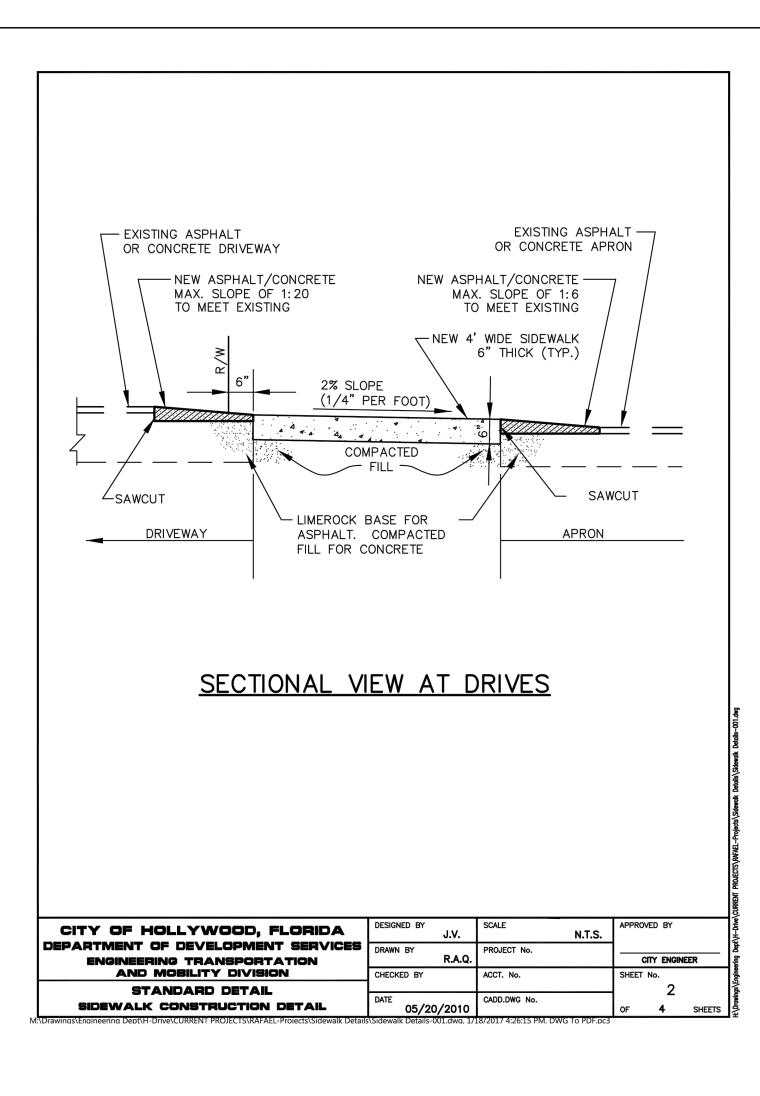

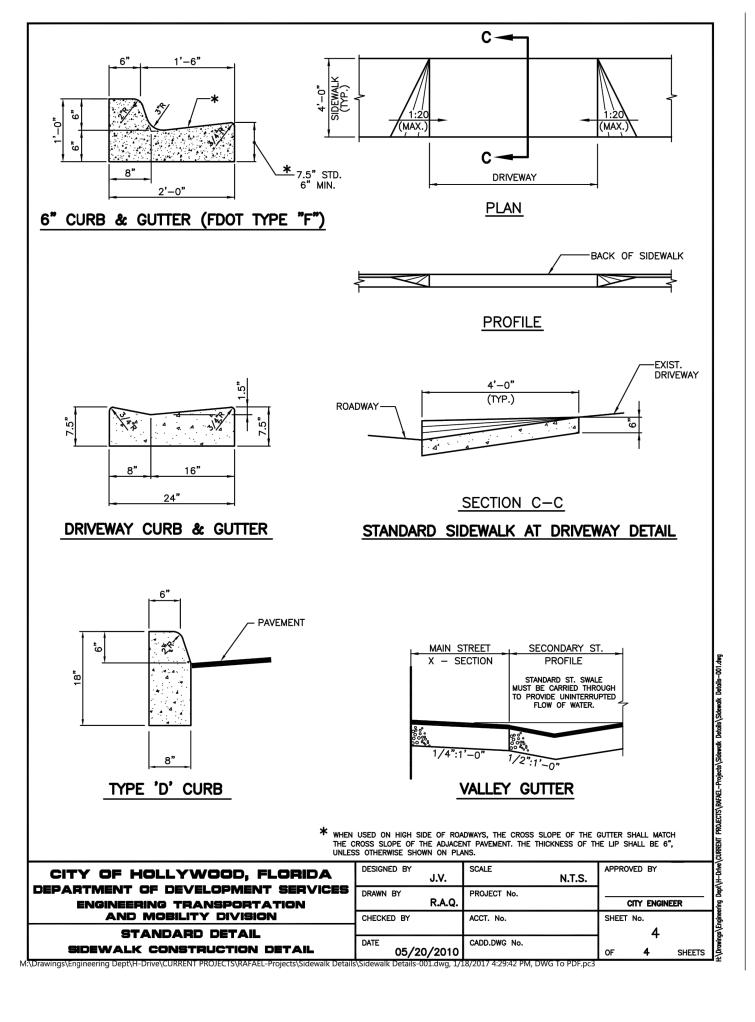

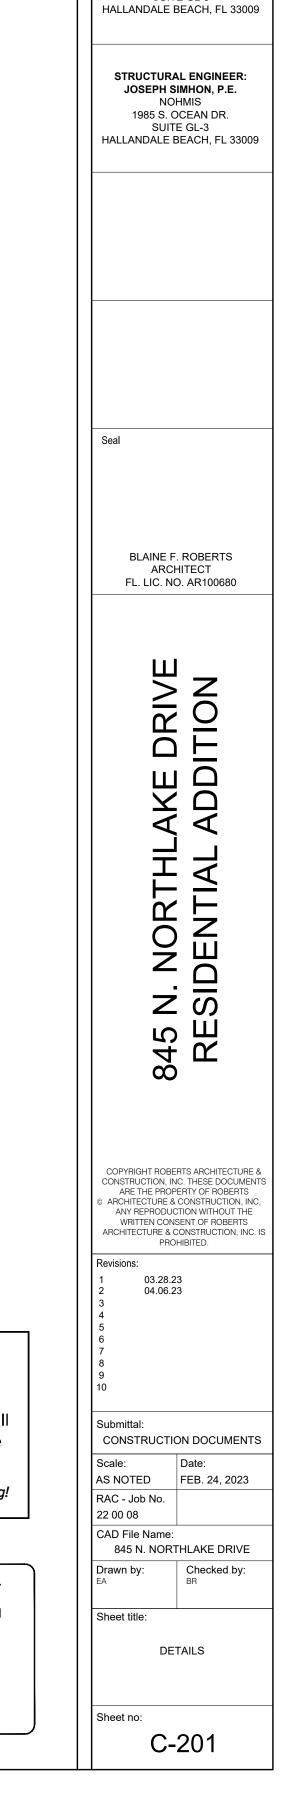

ROBERTS ARCHITECTURE & CONSTRUCTION, INC.

6511 NOVA DRIVE, SUITE 268

DAVIE, FL 33317

954.600.1422

CGC1522456

AR100680

OWNER:

TONY HANDLEY

845 N. NORTHLAKE DRIVE

HOLLYWOOD, FL 33019

MEP ENGINEER:

JOSEPH SIMHON, P.E.

NOHMIS 1985 S. OCEAN DR.

SUITE GL-3




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> CA NO. 32522 PE NO. 82291 ERIC ARENCIBIA, P.E.





BEST MANAGEMENT PRACTICES (BMPS):

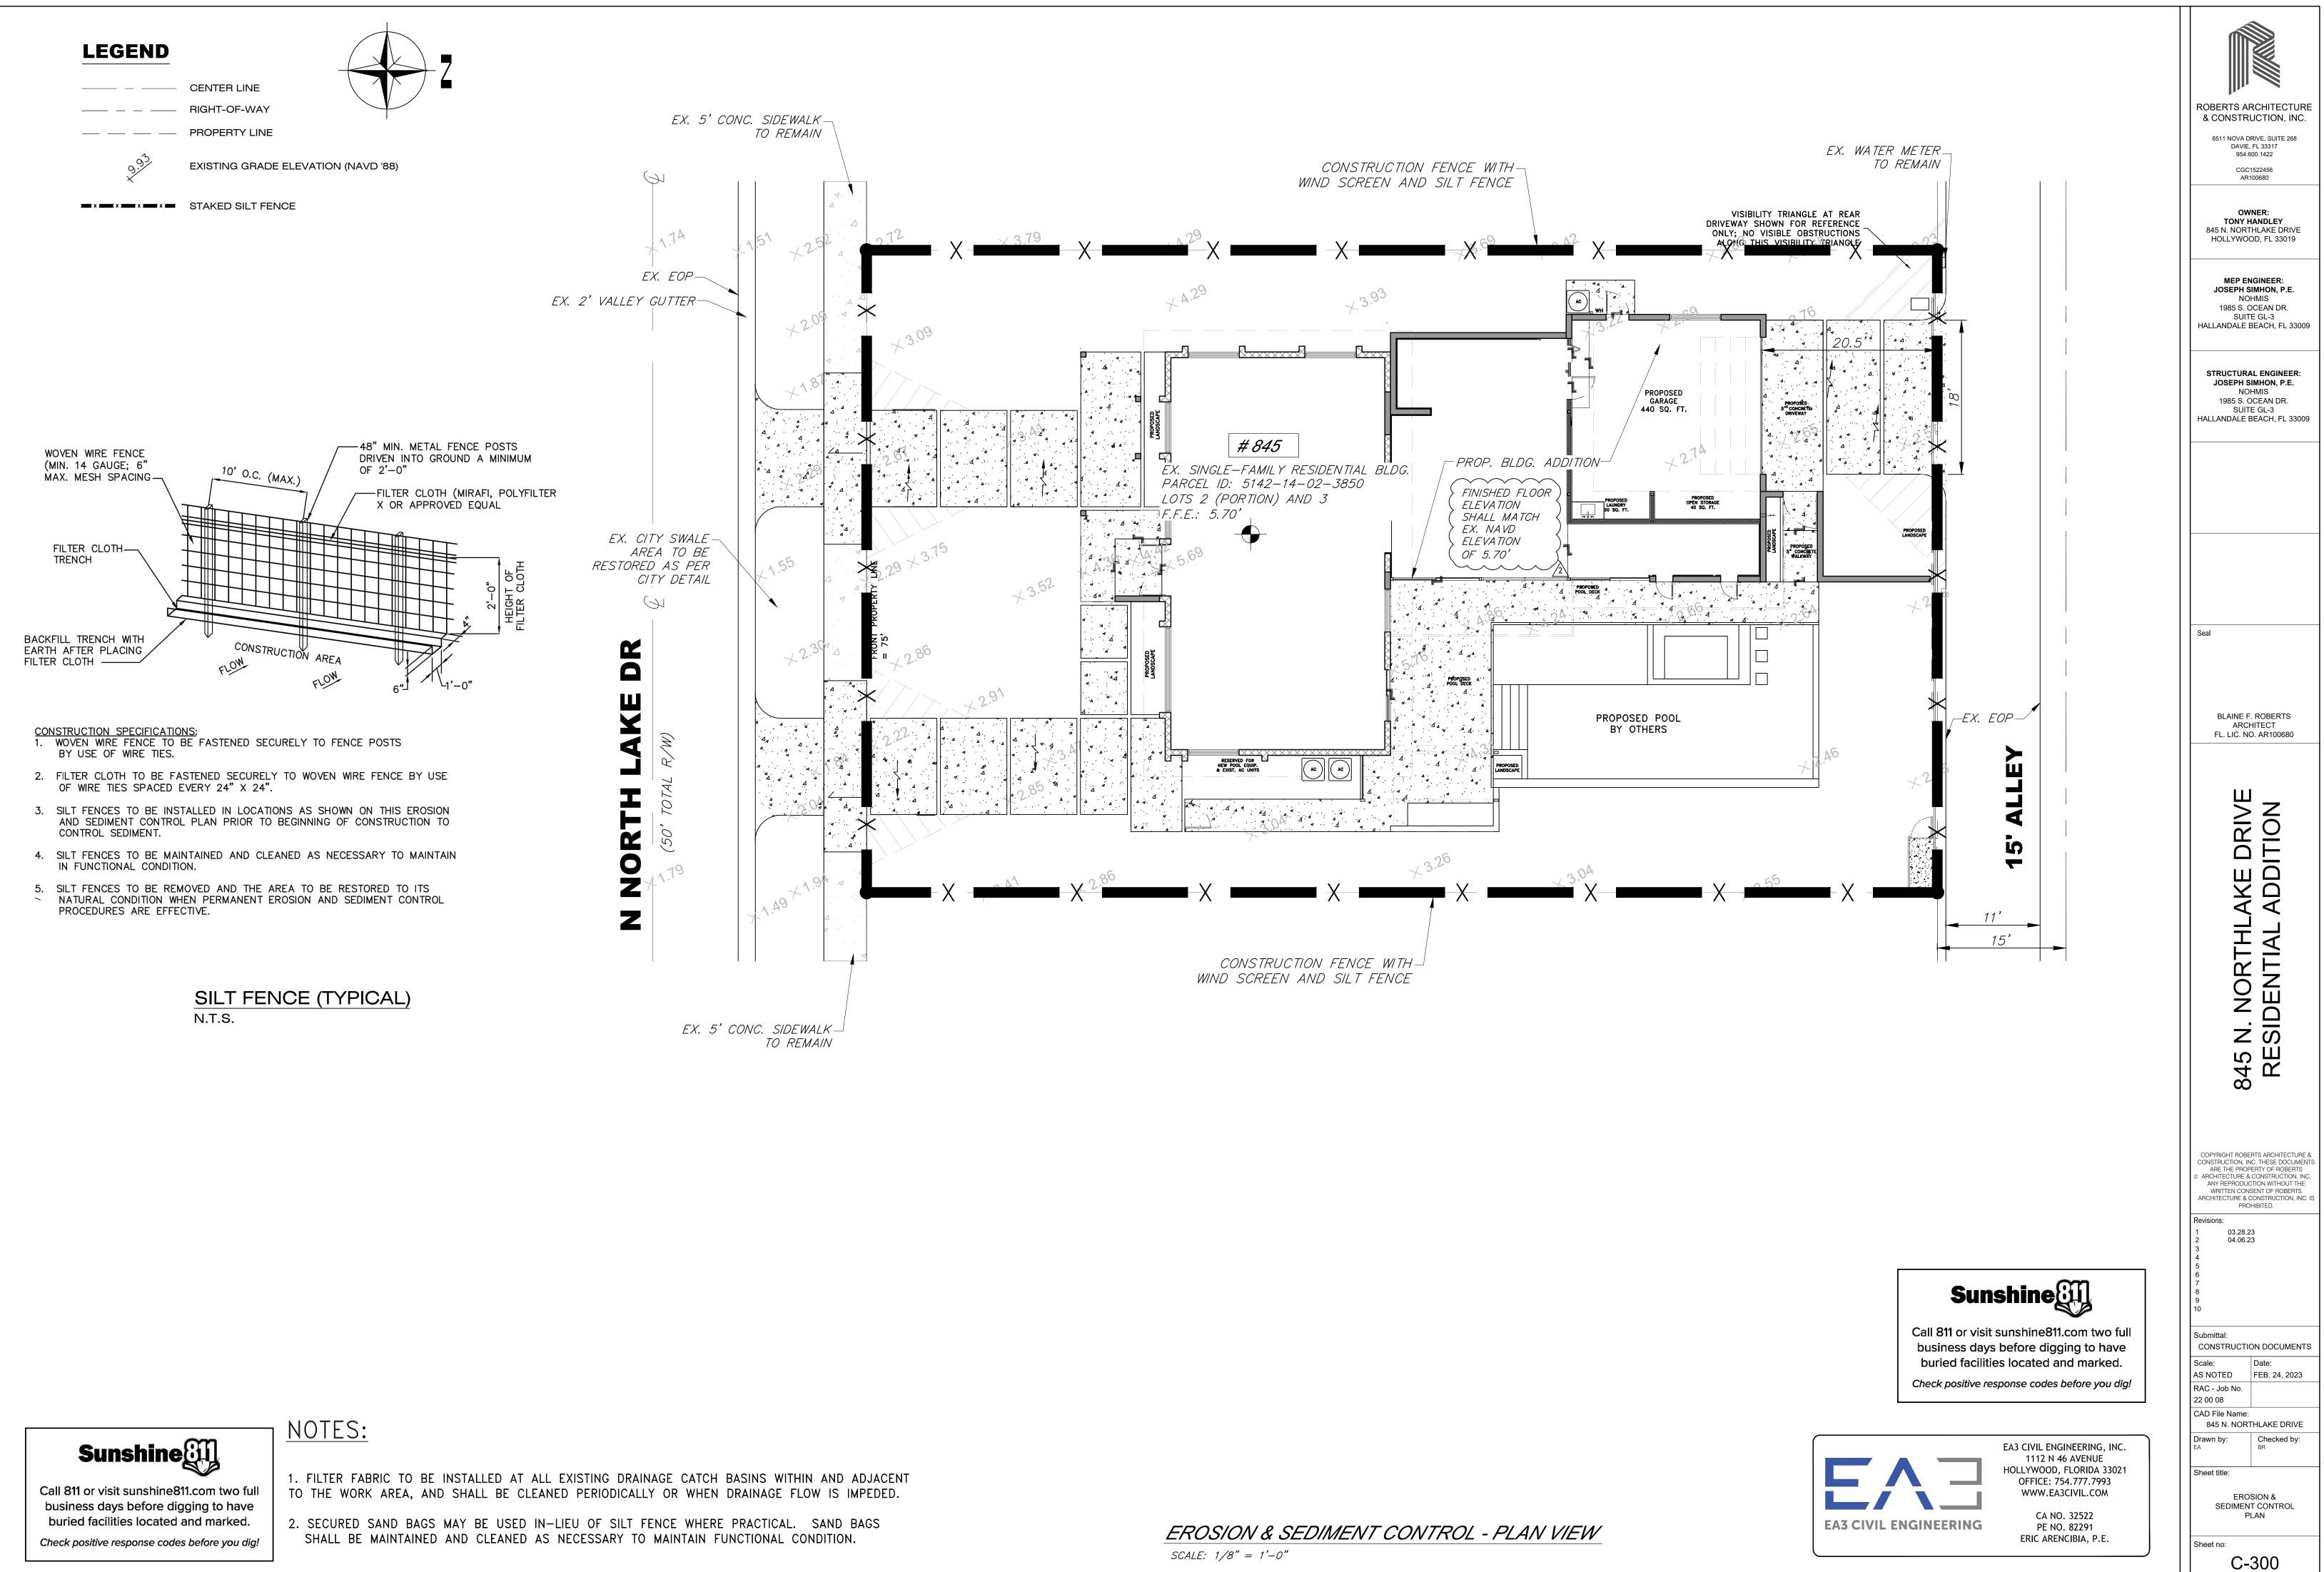THIS PLAN HAS BEEN PREPARED TO ENSURE COMPLIANCE WITH APPROPRIATE CONDITIONS OF BROWARD COUNTY DEPARTMENT OF ENVIRONMENTAL PROTECTION & GROWTH MANAGEMENT, THE RULES OF THE FLORIDA DEPARTMENT OF ENVIRONMENTAL PROTECTION (FDEP), CHAPTER 17-25, F.A.C., THE SOUTH FLORIDA WATER MANAGEMENT DISTRICT (SFWMD), CHAPTER 400-4, F.A.C., AND THE UNITED STATES ENVIRONMENTAL PROTECTION AGENCY (EPA) DOCUMENT NO. EPA 832/R-92-005 (SEPTEMBER 1992). THE PLAN ADDRESSES THE FOLLOWING:

1. PREVENT LOSS OF SOIL DURING CONSTRUCTION BY STORMWATER RUNOFF AND/OR WIND EROSION, INCLUDING PROTECTING TOPSOIL BY STOCKPILING FOR REUSE.

2. SEDIMENTATION PROTECTION OF STORM SEWER OR RECEIVING STREAM. 3. PREVENT POLLUTING THE AIR WITH DUST AND PARTICULATE MATTER. THE VARIOUS TECHNIQUES OR ACTIONS IDENTIFIED UNDER EACH SECTION INDICATE THE APPROPRIATE SITUATION WHEN THE TECHNIQUES SHOULD BE EMPLOYED. ALSO IDENTIFIED IS A CROSS-REFERENCE TO A DIAGRAM OR FIGURE REPRESENTING THE TECHNIQUE. IT SHOULD BE NOTED THAT THE MEASURES IDENTIFIED ON THIS PLAN ARE ONLY SUGGESTED BMP(S). THE CONTRACTOR SHALL PROVIDE POLLUTION PREVENTION AND EROSION CONTROL MEASURES AS SPECIFIED IN ACCORDANCE WITH THE CURRENT FLORIDA DEPARTMENT OF ENVIRONMENTAL PROTECTION NATIONAL POLLUTION DISCHARGE ELIMINATION SYSTEM (NPDES) REQUIREMENTS. CONTRACTOR SHALL PREPARE REQUIRED NPDES DOCUMENTATION AND OBTAIN PERMIT PRIOR TO COMMENCEMENT OF CONSTRUCTION. IT IS THE SOLE RESPONSIBILITY OF THE CONTRACTOR TO PREPARE THE REQUIRED NPDES DOCUMENT AND OBTAIN THE NPDES PERMIT. ALL COSTS ASSOCIATED WITH SUCH WORK SHALL BE DEEMED INCIDENTAL TO THE PROJECT LUMP SUM COST.

GENERAL EROSION CONTROL NOTES:

1. THE STORM WATER POLLUTION PREVENTION PLAN (SWPPP) IS COMPRISED OF THESE EROSION CONTROL DRAWINGS, THE STANDARD DETAILS, THE NPDES PERMIT (TO BE OBTAINED BY THE CONTRACTOR), AND ALL SUBSEQUENT REPORTS AND RELATED DOCUMENTS. 2. ALL CONTRACTORS AND SUBCONTRACTORS INVOLVED WITH STORM WATER POLLUTION PREVENTION SHALL OBTAIN

A COPY OF THIS DRAWING AND THE STATE OF FLORIDA NATIONAL POLLUTANT DISCHARGE ELIMINATION SYSTEM GENERAL PERMIT (NPDES PERMIT) AND BECOME FAMILIAR WITH THEIR CONTENTS. 3. CONTRACTOR SHALL IMPLEMENT BEST MANAGEMENT PRACTICES (BMP) IN ALL CONSTRUCTION ACTIVITIES INCLUDING, BUT NOT LIMITED TO, THE FOLLOWING:

- A. FUEL SPILLS AND LEAKS PREVENTION
- B. PREVENT/REDUCE VEHICLE AND EQUIPMENT WASHING AND STEAM CLEANING
- C. VEHICLE AND EQUIPMENT MAINTENANCE AND REPAIR
- D. PROPER OUTDOOR LOADING/UNLOADING OF MATERIALS
- E. PREVENT/REDUCE OUTDOOR STORAGE OF RAW MATERIALS, PRODUCTS, AND BY-PRODUCTS
- F. SOLID WASTE MANAGEMENT
- G. HAZARDOUS WASTE MANAGEMENT
- H. CONCRETE WASTE MANAGEMENT
- I. SANDBLASTING WASTE MANAGEMENT J. STRUCTURE CONSTRUCTION AND PAINTING
- K. SPILL PREVENTION AND CONTROL
- L. CONTAMINATED SOIL MANAGEMENT
- M. SANITARY/SEPTIC WASTE MANAGEMENT
- N. SOIL EROSION CONTROL
- O. STORM WATER TURBIDITY MANAGEMENT

4. ADDITIONAL BEST MANAGEMENT PRACTICES SHALL BE IMPLEMENTED AS DICTATED BY CONDITIONS AT NO ADDITIONAL COST TO THE OWNER THROUGHOUT ALL PHASES OF CONSTRUCTION.

A. BEST MANAGEMENT PRACTICES (BMPS) AND CONTROLS SHALL CONFORM TO FEDERAL, STATE, OR LOCAL REQUIREMENTS OR MANUAL OF PRACTICE, AS APPLICABLE. CONTRACTOR SHALL IMPLEMENT ADDITIONAL CONTROLS AS DIRECTED BY PERMITTING AGENCY OR OWNER.

B. SITE MAP MUST CLEARLY DELINEATE ALL STATE WATERS. CONTRACTOR MUST MAINTAIN ALL PERMITS FOR ANY CONSTRUCTION ACTIVITY IMPACTING STATE WATERS OR REGULATED WETLANDS ON SITE AT ALL TIMES. C. CONTRACTOR SHALL MINIMIZE CLEARING TO THE MAXIMUM EXTENT PRACTICAL OR AS REQUIRED BY THE GENERAL PERMIT.

D. CONTRACTOR SHALL BEGIN CLEARING AND GRUBBING THOSE PORTIONS OF THE SITE NECESSARY TO IMPLEMENT PERIMETER CONTROL MEASURES. CLEARING AND GRUBBING FOR THE REMAINING PORTIONS OF THE PROPOSED SITE SHALL COMMENCE ONCE PERIMETER CONTROLS ARE IN PLACE. PERIMETER CONTROLS SHALL BE ACTIVELY MAINTAINED UNTIL SAID AREAS HAVE BEEN STABILIZED AND SHALL BE REMOVED ONCE FINAL STABILIZATION IS COMPLETE.

E. GENERAL EROSION CONTROL BMPS SHALL BE EMPLOYED TO MINIMIZE SOIL EROSION AND POTENTIAL LAKE SLOPE CAVE-INS. WHILE THE VARIOUS TECHNIQUES REQUIRED WILL BE SITE AND PLAN SPECIFIC, THEY SHOULD BE EMPLOYED AS SOON AS POSSIBLE DURING CONSTRUCTION.

F. ON-SITE & OFF-SITE SOIL STOCKPILE AND BORROW AREAS SHALL BE PROTECTED FROM EROSION AND SEDIMENTATION THROUGH IMPLEMENTATION OF BEST MANAGEMENT PRACTICES. STOCKPILE AND BORROW AREA LOCATIONS SHALL BE NOTED ON THE SITE MAP AND PERMITTED IN ACCORDANCE WITH GENERAL PERMIT REQUIREMENTS.

G. SURFACE WATER QUALITY SHALL BE MAINTAINED BY EMPLOYING THE FOLLOWING BMP'S IN THE CONSTRUCTION PLANNING AND CONSTRUCTION OF ALL IMPROVEMENTS.

STORMWATER EROSION CONTROL NOTES:

1. CONTRACTORS OR SUBCONTRACTORS WILL BE RESPONSIBLE FOR REMOVING SEDIMENT FROM DETENTION PONDS AND ANY SEDIMENT THAT MAY HAVE COLLECTED IN THE STORM SEWER DRAINAGE SYSTEMS IN CONJUNCTION WITH THE STABILIZATION OF THE SITE.

2. SLOPES SHALL BE LEFT IN A ROUGHENED CONDITION DURING THE GRADING PHASE TO REDUCE RUNOFF VELOCITIES AND EROSION.

3. DUE TO THE GRADE CHANGES DURING THE DEVELOPMENT OF THE PROJECT, THE CONTRACTOR SHALL BE RESPONSIBLE FOR ADJUSTING THE EROSION CONTROL MEASURES (COMPOST SOCK DEVICES, ETC.) TO PREVENT EROSION.

4. WHERE PRACTICAL, STORMWATER SHALL BE CONVEYED BY SWALES. 5. EROSION CONTROL MEASURES SHALL BE EMPLOYED TO MINIMIZE TURBIDITY OF SURFACE WATERS LOCATED DOWNSTREAM OF ANY CONSTRUCTION ACTIVITY. WHILE THE VARIOUS MEASURES REQUIRED WILL BE SITE SPECIFIC, THEY SHALL BE EMPLOYED AS NEEDED IN ACCORDANCE WITH THE FOLLOWING:

A. IN GENERAL, EROSION SHALL BE CONTROLLED AT THE FURTHEST PRACTICAL UPSTREAM LOCATION. B. STORMWATER INLETS SHALL BE PROTECTED DURING CONSTRUCTION. PROTECTION MEASURES SHALL BE EMPLOYED AS SOON AS PRACTICAL DURING THE VARIOUS STAGES OF INLET CONSTRUCTION. SILT BARRIERS SHALL REMAIN IN PLACE UNTIL SODDING AROUND INLETS IS COMPLETE.

C. WHEN NEEDED A TEMPORARY SEDIMENT TRAP SHOULD BE CONSTRUCTED TO DETAIN SEDIMENT-LADEN RUNOFF FROM DISTURBED AREAS.

6. SILT BARRIERS, ANY SILT WHICH ACCUMULATES BEHIND THE BARRIERS, AND ANY FILL USED TO ANCHOR THE BARRIERS SHALL BE REMOVED PROMPTLY AFTER THE END OF THE MAINTENANCE PERIOD SPECIFIED FOR THE BARRIERS.

7. SOD SHALL BE PLACED, IN ACCORDANCE WITH PLANS, FOR A 2-FOOT WIDE STRIP ADJOINING ALL CURBING AND AROUND ALL INLETS. SOD SHALL BE PLACED BEFORE SILT BARRIERS ARE REMOVED. 8. WHERE REQUIRED TO PREVENT EROSION FROM SHEET FLOW ACROSS BARE GROUND FROM ENTERING A LAKE OR SWALE, A TEMPORARY SEDIMENT SUMP SHALL BE CONSTRUCTED 9. FILTER FABRIC SHOULD BE USED FOR STORM DRAIN INLET PROTECTION BEFORE FINAL STABILIZATION.

REPAIRED.

1. STABILIZED CONSTRUCTION ENTRANCE SHALL BE PROVIDED TO REDUCE SEDIMENT TRACKING OFF-SITE. THE MAJOR ROAD CONNECTED TO THE PROJECT SHALL BE CLEANED ONCE A DAY TO REMOVE ANY EXCESS MUD, DIRT, OR ROCK RESULTING FROM CONSTRUCTION TRAFFIC. ALL TRUCKS HAULING MATERIALS OFFSITE SHALL BE COVERED WITH A TARPAULIN. 2. GENERAL CONTRACTOR SHALL DENOTE ON PLAN THE TEMPORARY PARKING AND STORAGE AREA WHICH SHALL ALSO BE USED AS THE EQUIPMENT MAINTENANCE AND CLEANING AREA, EMPLOYEE PARKING AREA, AND AREA FOR LOCATION PORTABLE FACILITIES. OFFICE TRAILERS. AND TOILET FACILITIES. HEAVY CONSTRUCTION EQUIPMENT PARKING AND MAINTENANCE AREAS SHALL BE DESIGNED TO PREVENT OIL, GREASE, AND LUBRICANTS FROM ENTERING SITE DRAINAGE FEATURES INCLUDING STORMWATER COLLECTION AND TREATMENT SYSTEMS. CONTRACTORS SHALL PROVIDE BROAD DIKES, HAY BALES, OR SILT SCREENS AROUND, AND SEDIMENT SUMPS WITHIN, SUCH AREAS AS REQUIRED TO CONTAIN SPILLS OF OIL, GREASE, OR LUBRICANTS. CONTRACTORS SHALL HAVE AVAILABLE, AND SHALL USE, ABSORBENT FILTER PADS TO CLEAN UP SPILLS AS SOON AS POSSIBLE AFTER OCCURENCE. 3. ALL WASH WATER FROM CONCRETE TRUCKS, VEHICLE CLEANING, EQUIPMENT CLEANING, ETC. SHALL BE DETAINED ON SITE AND SHALL BE PROPERLY TREATED OR DISPOSED. 4. IF THE ACTION OF VEHICLES TRAVELING OVER THE GRAVEL CONSTRUCTION ENTRANCES IS NOT SUFFICIENT TO REMOVE THE MAJORITY OF DIRT OR MUD. THEN THE TIRES MUST BE WASHED BEFORE THE VEHICLES ENTER A PUBLIC ROAD. IF WASHING IS USED, PROVISIONS MUST BE MADE TO INTERCEPT THE WASH WATER AND TRAP THE SEDIMENT BEFORE IT IS CARRIED OFF THE SITE. 5. ALL MATERIALS SPILLED, DROPPED, WASHED, OR TRACKED FROM VEHICLES ONTO ROADWAYS OR INTO STORM DRAINS MUST BE REMOVED IMMEDIATELY.

STORED

STABILIZATION NOTES:

SHALL BE IN ACCORDANCE WITH DEP DOCUMENT NO. 62-621.300(4)(a)

STRUCTURAL NOTES:

SHALL BE IN ACCORDANCE WITH DEP DOCUMENT NO. 62-621.300(4)(a)

WASTE DISPOSAL NOTES:

1. WASTE MATERIALS - ALL WASTE MATERIALS SHALL BE COLLECTED AND STORED IN A METAL DUMPSTER WITH A SECURE LID IN ACCORDANCE WITH ALL LOCAL AND STATE LAWS. ALL TRASH AND CONSTRUCTION DEBRIS FROM THE SITE SHALL BE DEPOSITED IN THE DUMPSTER. THE SUPERINTENDENT SHALL COORDINATE WITH THE LOCAL UTILITIES TO HAVE THE DUMPSTER EMPTIED AT LEAST TWICE A WEEK AND THE WASTE TAKEN TO AN APPROPRIATE LANDFILL. NO CONSTRUCTION WASTE MATERIALS SHALL BE BURIED ON SITE. THE SUPERINTENDENT SHALL ORGANIZE TRAINING FOR THE EMPLOYEES IN THE PROPER PRACTICES WHEN DEALING WITH WASTE MATERIALS. THE SUPERINTENDENT SHALL BE RESPONSIBLE FOR POSTING AND ENFORCING WASTE MATERIAL PROCEDURES.

2. HAZARDOUS WASTE - HAZARDOUS WASTE MATERIALS SHALL BE DISPOSED OF IN ACCORDANCE WITH ALL LOCAL AND STATE LAWS OR AS DIRECTED BY THE MANUFACTURER. THE SUPERINTENDENT SHALL ORGANIZE THE PROPER TRAINING FOR EMPLOYEES IN THE PROPER PRACTICES WHEN DEALING WITH HAZARDOUS WASTE MATERIALS. THESE PROCEDURES SHALL BE POSTED ON THE SITE. THE PERSON WHO MANAGES THE SITE SHALL BE RESPONSIBLE FOR ENFORCING THE PROCEDURES. 3. SANITARY WASTE - SANITARY WASTE SHALL BE COLLECTED AND DISPOSED OF IN ACCORDANCE WITH ALL LOCAL AND STATE LAWS. THE SUPERINTENDENT SHALL COORDINATE WITH THE LOCAL UTILITY FOR COLLECTION OF THE SANITARY WASTE AT LEAST THREE TIMES A WEEK TO PREVENT SPILLAGE ONTO THE SITE.

4. RUBBISH, TRASH, GARBAGE, LITTER, OR OTHER SUCH MATERIALS SHALL BE DEPOSITED INTO SEALED CONTAINERS. MATERIALS SHALL BE PREVENTED FROM LEAVING THE PREMISES THROUGH THE ACTION OF WIND OR STORM WATER DISCHARGE INTO DRAINAGE DITCHES OR WATERS OF THE STATE.

MAINTENANCE NOTES:

ALL MEASURES STATED ON THIS EROSION AND SEDIMENT CONTROL PLAN, AND IN THE STORM WATER POLLUTION PREVENTION PLAN, SHALL BE MAINTAINED IN FULLY FUNCTIONAL CONDITION UNTIL NO LONGER REQUIRED FOR A COMPLETED PHASE OF WORK OR FINAL STABILIZATION OF THE SITE. ALL EROSION AND SEDIMENTATION CONTROL MEASURES SHALL BE CHECKED BY A QUALIFIED PERSON AT LEAST ONCE EVERY SEVEN CALENDAR DAYS AND WITHIN 24 HOURS OF THE END OF A 0.5" RAINFALL EVENT, AND CLEANED AND REPAIRED IN ACCORDANCE WITH THE FOLLOWING:

1. INLET PROTECTION DEVICES AND BARRIERS SHALL BE REPAIRED OR REPLACED IF THEY SHOW SIGNS OF UNDERMINING, OR DETERIORATION.

2. ALL SEEDED AREAS SHALL BE CHECKED REGULARLY TO SEE THAT A GOOD STAND IS MAINTAINED, AREAS SHOULD BE FERTILIZED, WATERED, AND RESEEDED AS NEEDED

3. THE COMPOST SOCK FILTRATION DEVICE SHALL BE INSPECTED PERIODICALLY FOR HEIGHT OF SEDIMENT AND CONDITION OF DEVICE. COMPOST SOCK SHALL BE REPAIRED TO ITS ORIGINAL CONDITIONS IF DAMAGED. SEDIMENT SHALL BE REMOVED FROM THE COMPOST SOCK WHEN IT REACHES ONE-THIRD THE HEIGHT OF THE COMPOST SOCK.

4. THE CONSTRUCTION ENTRANCES SHALL BE MAINTAINED IN A CONDITION WHICH WILL PREVENT TRACKING OR FLOW OF MUD ONTO PUBLIC RIGHTS-OF-WAY. THIS MAY REQUIRE PERIODIC TOP DRESSING OF THE CONSTRUCTION ENTRANCES AS CONDITIONS DEMAND.

5. THE TEMPORARY PARKING AND STORAGE AREA SHALL BE KEPT IN GOOD CONDITION (SUITABLE FOR PARKING, AND

STORAGE). THIS MAY REQUIRE PERIODIC TOP DRESSING OF THE TEMPORARY PARKING AS CONDITIONS DEMAND. 6. OUTLET STRUCTURES IN THE SEDIMENTATION BASINS SHALL BE MAINTAINED IN OPERATIONAL CONDITIONS AT ALL TIMES. THE SEDIMENT BASINS/DITCHES SHALL BE CHECKED MONTHLY FOR DEPTH OF SEDIMENT. SEDIMENT SHALL BE REMOVED FROM SEDIMENT BASINS OR TRAPS WHEN THE DESIGN CAPACITY HAS BEEN REDUCED BY 10% AND AFTER CONSTRUCTION IS

COMPLETE. 7. ALL MAINTENANCE OPERATIONS SHALL BE DONE IN A TIMELY MANNER, BUT IN NO CASE LATER THAN SEVEN CALENDAR DAYS FOLLOWING THE INSPECTION. DIVERSION DIKES SHALL BE INSPECTED MONTHLY. ANY BREACHES SHALL BE PROMPTLY

8. A MAINTENANCE REPORT SHALL BE COMPLETED DAILY AFTER EACH INSPECTION OF THE SEDIMENT AND EROSION CONTROL METHODS. THE REPORTS SHALL BE FILED IN AN ORGANIZED MANNER AND RETAINED ON-SITE DURING CONSTRUCTION. AFTER CONSTRUCTION IS COMPLETED. THE REPORTS SHALL BE SAVED FOR AT LEAST THREE YEARS. THE REPORTS SHALL BE AVAILABLE FOR ANY AGENCY THAT HAS JURISDICTION OVER EROSION CONTROL.

9. ALL REPAIRS MUST BE MADE WITHIN 24 HOURS OF REPORT.

10. THE SUPERINTENDENT SHALL ORGANIZE THE TRAINING FOR INSPECTION PROCEDURES AND PROPER EROSION CONTROL METHODS FOR EMPLOYEES THAT COMPLETE INSPECTIONS AND REPORTS.

11. SILT FENCES SHALL BE REPAIRED TO THEIR ORIGINAL CONDITIONS IF DAMAGED. SEDIMENT SHALL BE REMOVED FROM THE SILT FENCES WHEN IT REACHES ONE-HALF THE HEIGHT OF THE SILT FENCE.

OFF-SITE TRACKING:

SPILL PREVENTION AND CONTROL:

THE FOLLOWING ARE THE MATERIAL MANAGEMENT PRACTICES THAT WILL BE USED TO REDUCE THE RISK OF SPILLS OR OTHER ACCIDENTAL EXPOSURE OF MATERIALS AND SUBSTANCES TO STORM WATER RUNOFF.

1. GOOD HOUSEKEEPING

A. SUPERINTENDENT SHALL INSPECT PROJECT AREA DAILY FOR PROPER STORAGE, USE, AND DISPOSAL OF CONSTRUCTION MATERIALS.

- B. STORE ONLY ENOUGH MATERIAL ON-SITE FOR PROJECT COMPLETION.
- C. ALL SUBSTANCES SHOULD BE USED BEFORE DISPOSAL OF CONTAINER.

D. ALL CONSTRUCTION MATERIALS STORED SHALL BE ORGANIZED AND IN THE PROPER CONTAINER AND, IF POSSIBLE, UNDER A ROOF OR PROTECTIVE COVER.

E. PRODUCTS SHALL NOT BE MIXED UNLESS DIRECTED BY THE MANUFACTURER.

F. ALL PRODUCTS SHALL BE USED AND DISPOSED OF ACCORDING TO THE MANUFACTURER'S RECOMMENDATIONS.

2. HAZARDOUS PRODUCTS

CONTAINERS CANNOT MANUFACTURER AND

VEHICLES CONTAINING ORDER TO LIMIT CONCRETE OR DRUM

SPILL CLEANUP:

AND TRASH CONTAINERS. SPILLS AND LEAKS. SPILL.

1. WIND EROSION SHALL BE CONTROLLED BY EMPLOYING THE FOLLOWING METHODS AS NECESSARY AND APPROPRIATE:

A. BARE EARTH AREAS SHALL BE WATERED DURING CONSTRUCTION AS NECESSARY TO OF FUGITIVE DUST. IT MAY BE NECESSARY TO LIMIT MINIMIZE THE TRANSPORT CONSTRUCTION VEHICLE SPEED IF BARE EARTH HAS NOT BEEN EFFECTIVELY WATERED. CONSTRUCTION. IN NO CASE SHALL FUGITIVE DUST BE ALLOWED TO LEAVE THE SITE UNDER B. DISTURBED PORTIONS OF THE SITE WHERE CONSTRUCTION ACTIVITY HAS PERMANENTLY PERMANENTLY SEEDED. THESE AREAS SHALL BE SEEDED NO LATER STOPPED SHALL BE CONSTRUCTION ACTIVITY OCCURRING IN THESE THAN 14 DAYS AFTER THE LAST AREAS. REFER TO THE GRADING PLAN AND/OR LANDSCAPE PLAN. CLEARED SITE DEVELOPMENT AREAS NOT CONTINUALLY SCHEDULED FOR CONSTRUCTION ACTIVITIES SHALL BE COVERED WITH HAY OR OVERSEEDED AND PERIODICALLY WATERED SUFFICIENTLY TO STABILIZE THE TEMPORARY GROUNDCOVER.

C. AT ANY TIME BOTH DURING AND AFTER SITE CONSTRUCTION THAT WATERING AND/OR VEGETATION ARE NOT EFFECTIVE IN CONTROLLING WIND EROSION AND/OR TRANSPORT NECESSARY FOR SUCH CONTROL SHALL BE OF FUGITIVE DUST. OTHER METHODS AS ARE EMPLOYED. THESE METHODS SHOULD INCLUDE ERECTION OF DUST CONTROL FENCES. A 6-FT GEOTEXTILE FILTER FABRIC SHOULD BE HANGING AGAINST THE EXISTING CHAIN LINK FENCE AND GATE.

EA3 CIVIL ENGINEERING

2. ALL DUST ON THE SITE SHALL BE CONTROLLED. THE USE OF MOTOR OILS AND OTHER PETROLEUM BASED OR TOXIC LIQUIDS FOR DUST SUPPRESSION OPERATIONS IS PROHIBITED.

A. MATERIALS SHOULD BE KEPT IN ORIGINAL CONTAINER WITH LABELS UNLESS THE ORIGINAL BE RESEALED. IF ORIGINAL CONTAINERS CANNOT BE USED, LABELS AND PRODUCT INFORMATION SHALL BE SAVED. B. PROPER DISPOSAL PRACTICES SHALL ALWAYS BE FOLLOWED IN ACCORDANCE WITH

LOCAL/STATE REGULATIONS.

3. PRODUCT SPECIFIC PRACTICES

A. PETROLEUM PRODUCTS MUST BE STORED IN PROPER CONTAINERS AND CLEARLY LABELED. PETROLEUM PRODUCTS SHALL BE PERIODICALLY INSPECTED FOR LEAKS. PRECAUTIONS SHALL BE TAKEN TO AVOID LEAKAGE OF PETROLEUM PRODUCTS ON-SITE. B. THE MINIMUM AMOUNT OF FERTILIZER SHALL BE USED AND MIXED INTO THE SOIL IN

EXPOSURE TO STORM WATER. FERTILIZERS SHALL BE STORED IN A COVERED SHED, THE CONTENTS OF ANY PARTIALLY USED BAGS OF FERTILIZER SHALL BE TRANSFERRED TO A SEALABLE PLASTIC BIN TO AVOID SPILLS. C. PAINT CONTAINERS SHALL BE SEALED AND STORED WHEN NOT IN USE. EXCESS PAINT

MUST BE DISPOSED OF IN AN APPROVED MANNER. D. CONCRETE TRUCKS SHALL NOT BE ALLOWED TO WASH OUT OR DISCHARGE SURPLUS WASH WATER ON THE SITE.

IN ADDITION TO THE GOOD HOUSEKEEPING AND MATERIAL MANAGEMENT PRACTICES DISCUSSED ABOVE, THE FOLLOWING PRACTICES SHALL BE FOLLOWED FOR SPILL PREVENTION AND CLEANUP:

1. SPILL CLEANUP INFORMATION SHALL BE POSTED ON SITE TO INFORM EMPLOYEES ABOUT CLEANUP PROCEDURES AND RESOURCES.

2. THE FOLLOWING CLEANUP EQUIPMENT MUST BE KEPT ON-SITE NEAR THE MATERIAL STORAGE AREA: GLOVES, MOPS, RAGS, BROOMS, DUST PANS, SAND, SAWDUST, LIQUID ABSORBER, GOGGLES,

3. SUFFICIENT OIL AND GREASE ABSORBING MATERIALS AND FLOTATION BOOMS SHALL BE MAINTAINED ONSITE AND READILY AVAILABLE TO CONTAIN AND CLEAN-UP FUEL OR CHEMICAL

4. ALL SPILLS SHALL BE CLEANED UP AS SOON AS POSSIBLE.


5. WHEN CLEANING A SPILL. THE AREA SHOULD BE WELL VENTILATED AND THE EMPLOYEE SHALL WEAR PROPER PROTECTIVE COVERING TO PREVENT INJURY.

6. TOXIC SPILLS MUST BE REPORTED TO THE PROPER AUTHORITY REGARDLESS OF THE SIZE OF THE

7. AFTER A SPILL, THE PREVENTION PLAN SHALL BE REVIEWED AND CHANGED TO PREVENT FURTHER SIMILAR SPILLS FROM OCCURRING. THE CAUSE OF THE SPILL, MEASURES TO PREVENT IT, AND HOW TO CLEAN THE SPILL UP SHALL BE RECORDED.

8. THE SUPERINTENDENT SHALL BE THE SPILL PREVENTION AND CLEANUP COORDINATOR AND IS RESPONSIBLE FOR THE DAY-TO-DAY SITE OPERATIONS. THE SUPERINTENDENT ALSO OVERSEES THE SPILL PREVENTION PLAN AND SHALL BE RESPONSIBLE FOR EDUCATING THE EMPLOYEES ABOUT SPILL PREVENTION AND CLEANUP PROCEDURES.


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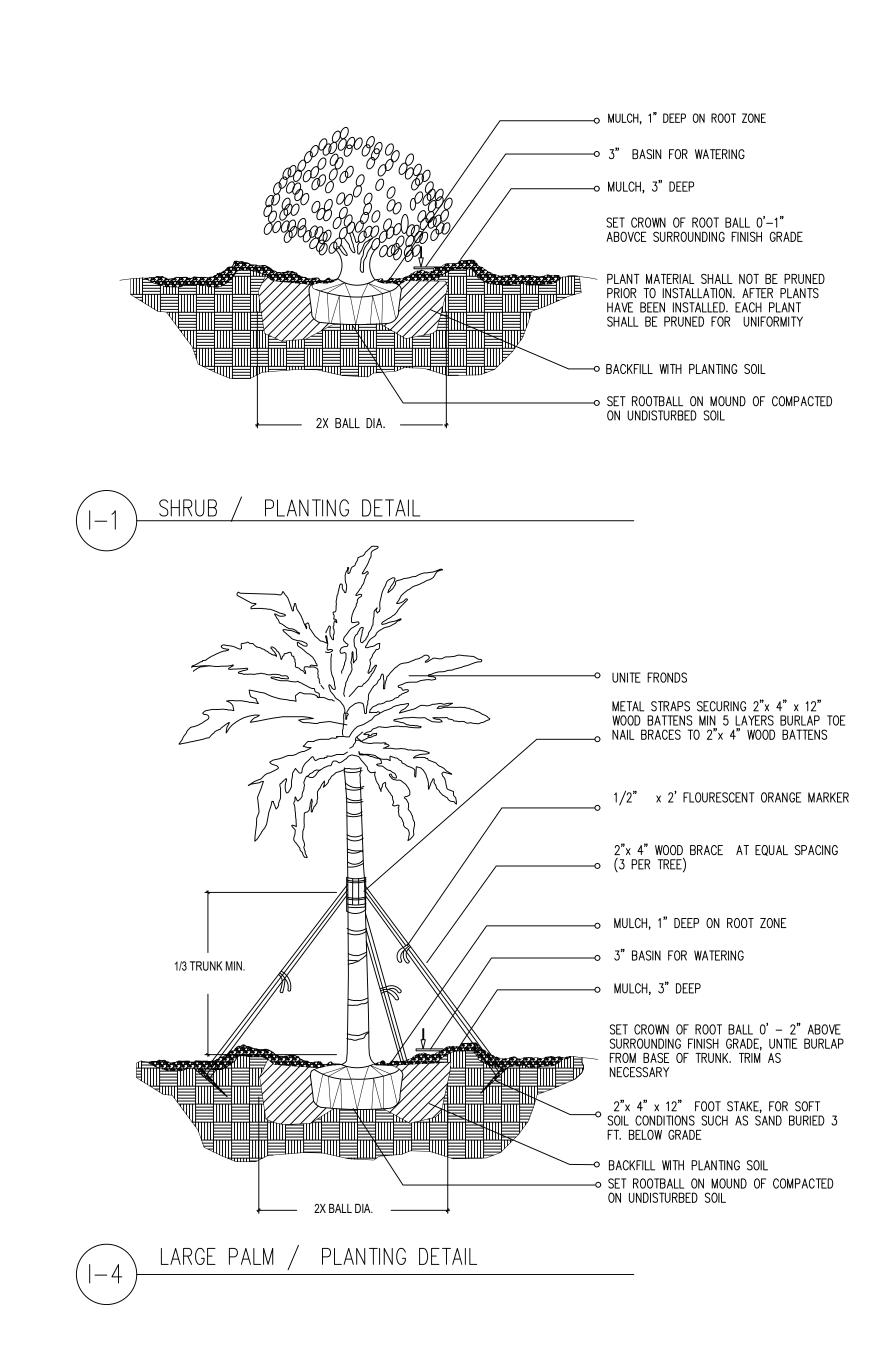
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ROBERTS ARCHITECTURE & CONSTRUCTION, INC 6511 NOVA DRIVE, SUITE 268 DAVIE, FL 33317 954.600.1422 CGC152245 AR100680 OWNER: TONY HANDLEY 845 N. NORTHLAKE DRIVE HOLLYWOOD, FL 33019 MEP ENGINEER: JOSEPH SIMHON, P.E. NOHMIS 1985 S. OCEAN DR. SUITE GL-3 HALLANDALE BEACH, FL 33009 STRUCTURAL ENGINEER: JOSEPH SIMHON, P.E. NOHMIS 1985 S. OCEAN DR. SUITE GL-3 HALLANDALE BEACH, FL 33009 **BLAINE F. ROBERTS** ARCHITECT FL. LIC. NO. AR100680 $\geq Z$ $\overline{\Omega}$ ШΟ $\overline{\Delta}$ $\overline{\Box}$ 4 4 ORTHLENTIAL Ш N. N. OPYRIGHT ROBERTS ARCHITECTURE ONSTRUCTION, INC. THESE DOCUMENT ARE THE PROPERTY OF ROBERTS ARCHITECTURE & CONSTRUCTION, IN

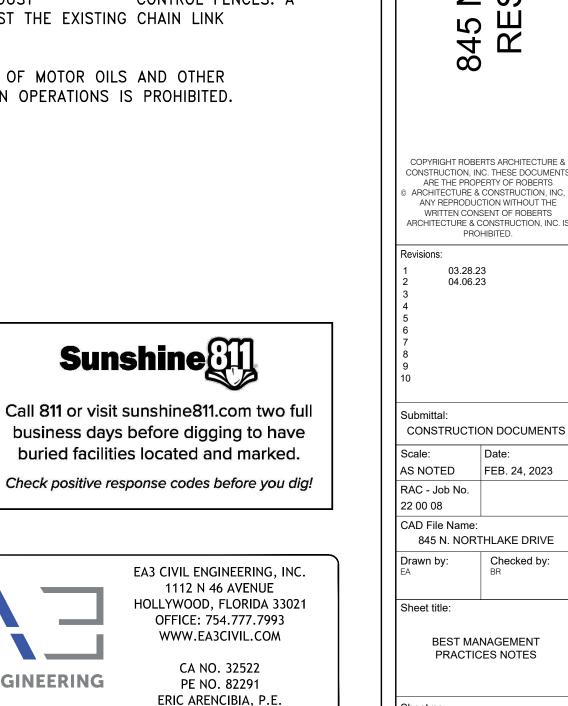


			PLANT LIST	Г				
Qty.	Common name	Botanical Name	Height	DBH	Spread	Drought tolerance	Native	Specifications
		T	REES & PAL	MS				
1	Satin Leaf	Chrysophyllum oliviforme	10'	2"	10'	Tolerant	YES	
1	Orange Geiger	Cordia sebestena	14'	2"	12'		YES	
4	Coconut Palm	Cocos nucifera	18'	12"	16'	Tolerant	NO	
6	Green Buttonwood	Conocarpus erectus	10'	3"	8'	Tolerant	YES	
3	Florida Royal Palm	Roystonea elata	28'	12"	18'	High	YES	Street tree
Qty.	Common name	Botanical Name	Size	Drought tolerance	Native	Specifications	1	
		SHRUBS & GROUND	COVERS	tolerance				
3	Bromelia Odorata	Alcantarea Odorata	7 gal	Tolerant	NO			
91	Coral Creeper	Antigonon leptopus	1 gal	Tolerant	NO			
14	Ornamental peanuts	Arachis glabrata	1 gal	Tolerant	NO			
51	Green cocoplum	Chrysobalanus icaco 'Green'	3 gal		YES			
9	Small Leaf Clusia	Clusia guttifera	15 gal		NO			
52	Cotoneaster	Cotoneaster dammeri	3 gal	Tolerant	NO			
3	King sago	Cycad revoluta	3' x 3'	Tolerant	NO			
42	Firebush	Hamelia patens	3 gal	Tolerant	YES			
10	Simpson's stopper	Myrclanthes frangans	15 gal	Tolerant	YES			
110	Fakahatchee Grass	Tripsacum dacty loides	3 gal		YES			
5	Xanadu	Philodendron xanadu	7 gal	Tolerant	NO			
20	Podocarpus	Podocarpus macrophy llus	15 gal		NO			
9	Lady palm	Rhapis excelsa	4'	Tolerant	NO			TOTAL SHRUBS
66	Ground Orchid	Spathoglottis pilcata	3 gal	Tolerant	NO			NATIVE SHRUBS



LANDSCAPE LEGEND CIT	TY OF HOLLYWOOD
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_ot area: 9375 sq. ft. / Acre 0.22			
Street tree distance 50 linear feet			
TREES:	REQUIRED	PROVIDED	
A. No. Trees required			
3 trees in front half of plot	4 8		
1 tree in rear half of plot		0	
(One tree per 1250 sq.ft. of front yard area)			
B. Percentage palms allowed			
Palms permitted count as 3 palms = 1 tree	4 4		
Up to 50%, but more than 20% all trees must be shade natives			
C. Street trees (maximun spacing 50' o.c.)	2	3	
75 linear feet along street / 50 lf = 2 trees		5	
D. Parking buffer trees (maximun spacing 20' o.c.)	N/A	N/A	
0 linear feet along buffer / 20 lf = 0 trees	IN/A	IN/A	
E. Total trees required	6	11	
A+C+D = Total trees (NATIVE REQUIRED)	Ö	11	
F. Percentage native required	5	8	
60% of total trees required must be native species	5	o	
SHRUBS			
A. No. Shrubs required	25 382		
15 shrubs in front half of plot	25	302	
10 shrubs in rear half of plot			
B. Percentage native required	191	213	
50% of total shrubs required must be native species	191	213	
NOTES			
IRRIGATION: 100% coverage as required by City of Hollywood			
Plant material will not be planted into root balls of trees and palms			
No subtitutions without the approval of Hollywood's landscape plan reviewer			

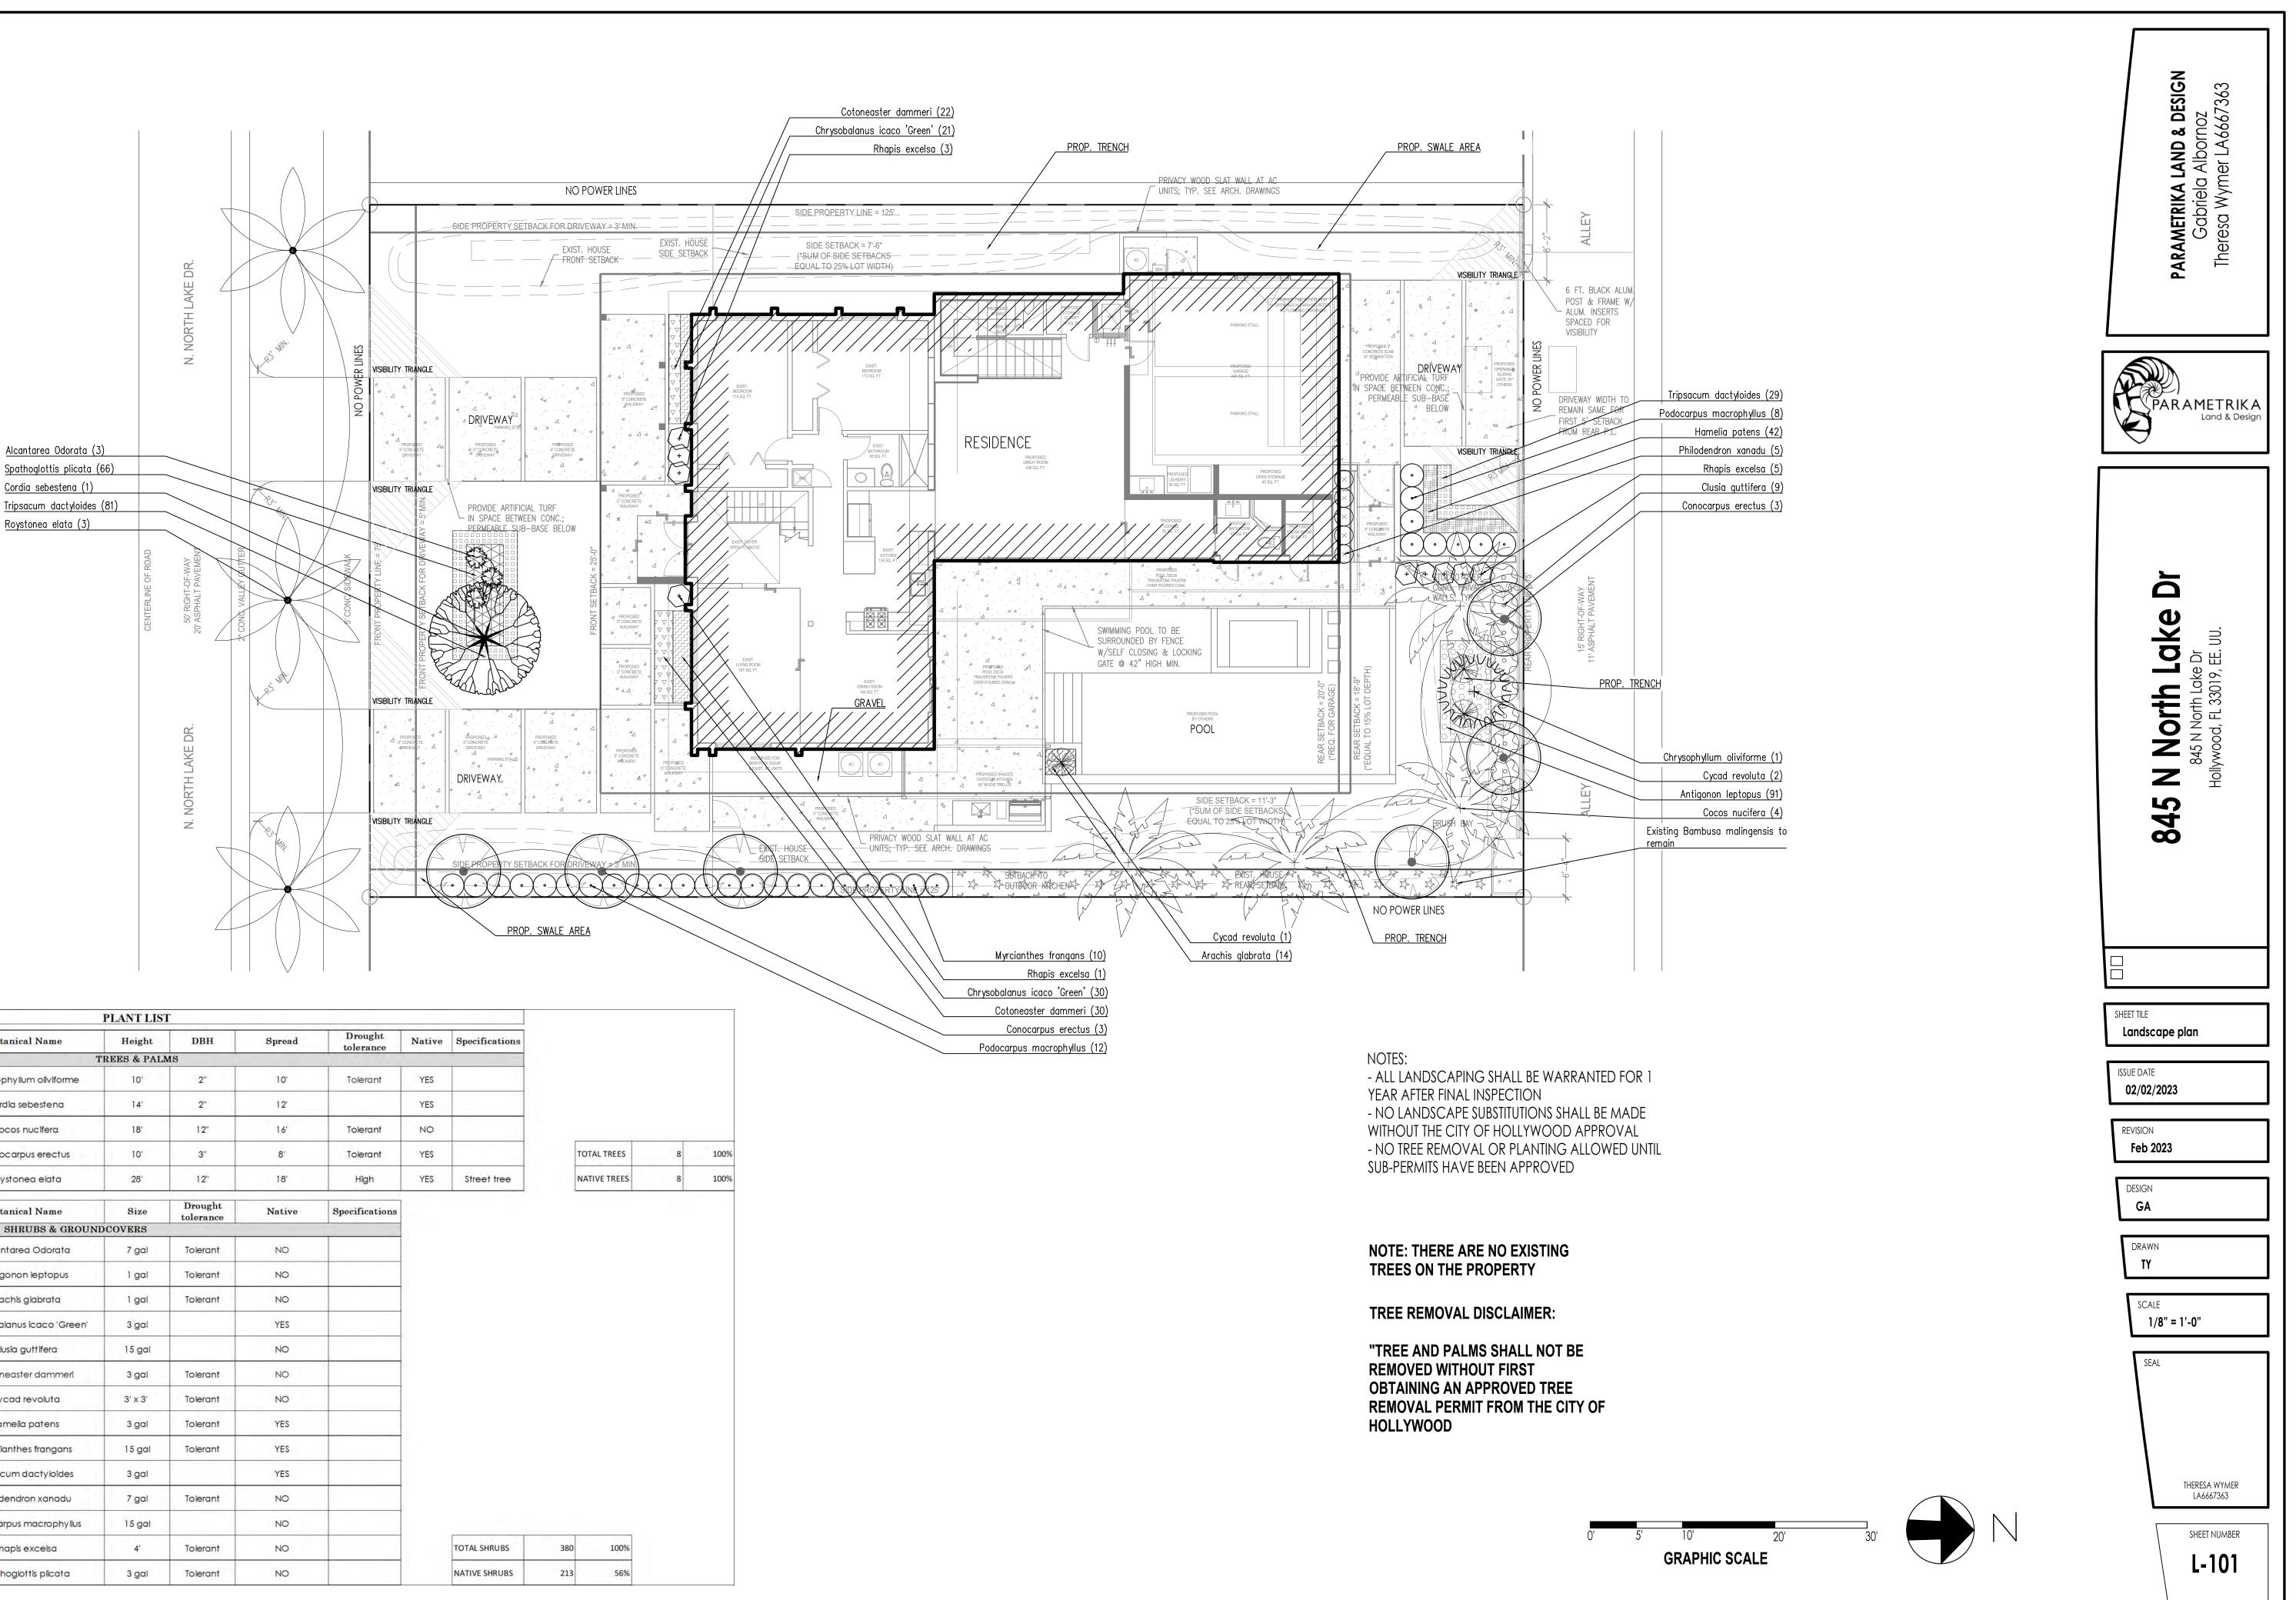

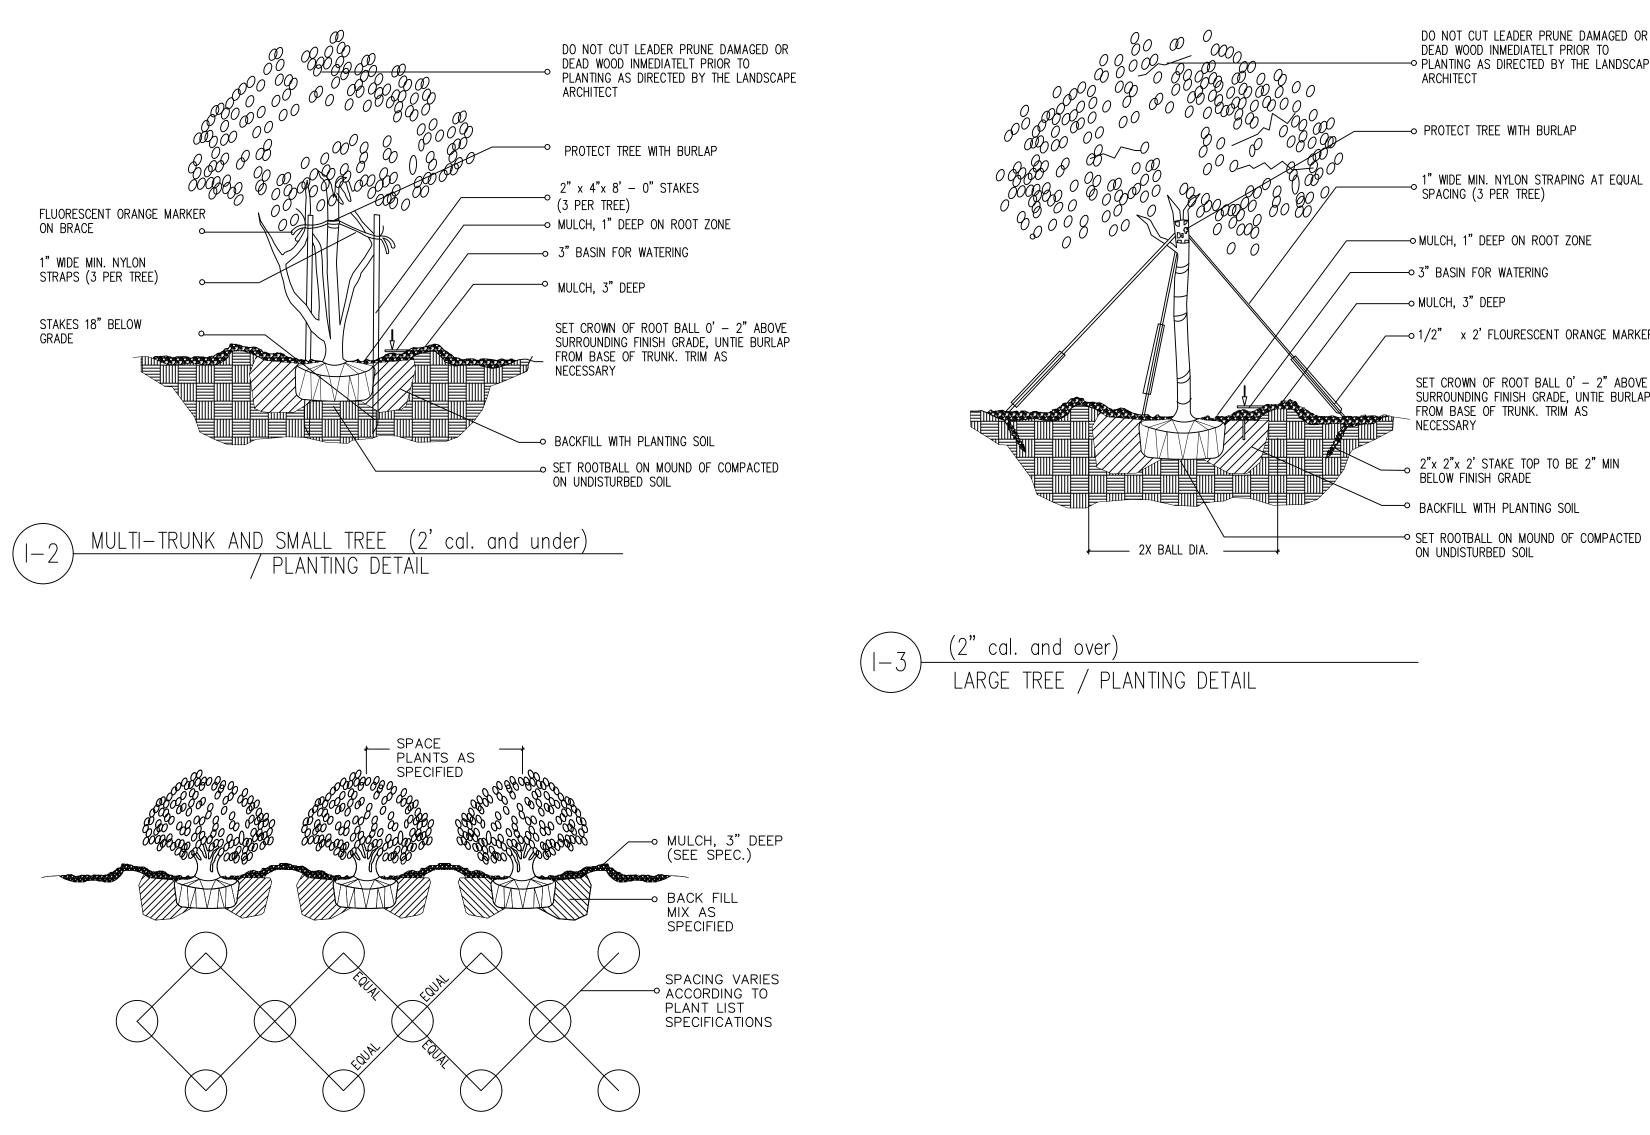SHRUB / GROUNDCOVER SPACING PLANTING DETAIL

LANDSCAPE NOTES

 Non Cypress variety mulch shall extend under all trees, shrubs and ground cover beds to the closest hard edge or sod border, in a minimum of 3^{''} depth. All plants shall meet the minimum standard of Florida No. 1 or better as specified in Grade and Standards for Nursery Plants as published by the Division of
Plant Industry, Florida Department of Agriculture, latest edition.
3. All shrubs to be planted a minimum of 24 ^{''} , and ground covers a minimum of 12 ^{''} from the edge of walks, building walls, pond's edge, etc Ixora Nora
Grant
and Raphiolepsisi Indica to be planted 30 ⁷⁷ form edge of walkways.
4. All tees and palms over 8" in height shall be braced to prevent lateral movement for a period of six months from the date of planting. Either wood braces
as shown in the planting detail, or the wire and turnbuckle method shall be used. No nails, screws, metal straps or wires are to be used directly against the trees or
palms trunks.
5. All palms except for species sush as Cocos, Acoelorraphe. Raphis, and other multitrunk palms, shall have straight trunks, free of scars, decay or anu
damage
caused by digging, transport or planting handling of the same.
6. All work by the Landscape Contractor shall be performed in a professional and sound manner in accordance with established standards of landscape
installation practices and workmanship. 7. Landscape Contractor is responsible for verifying plant quantities prior to bidding. Quantities shown in the plans may vary due to actual site scale, job
conditions, etc Landscape Architect assumes no responsability for the actual plant count necessary for the successful completion of the work.
8. Landscape Contractor and his subcontractors shall be licensed and insured as requierd by the municipality, country, state or any toher governmental
agency requiring a license or insurance in order for the Landscape Contractor to perform his work.
9. Landscape Contractor is requierd to procure and obtain any necessary permits aplicable for the sucesful completion of this project, if applicable.
10. Landscape material shall not be allowed to grow in such a manner as to impede streetfront triangle of visibility to property owner or neighboors, so as to
materially impede vission between a height of 3 feet and 8 feet.
11. Landscape Contractor shall call Sunshine State One Call Center of Florida at 1-800-432-4770 (Toll Free) 48 hours before digging.
12. Landscape Contractor is responsible for inspecting the site and physically observing all the site conditions proir to entering into Agreements or Contract with
Owner. Landscape Contractor shall coordinate his work with the General Contractor of Construction Manager in such a manner as to allowed for a speedy and
orderly completion of all work on the site.
13. Any excess soil, landscape materials and debris from the landscape Contractor's work shall be removed from the site inmediately upon completion of his
work.
14. Landscape Contractor shall coordinate the proposed planting in the Planting Plan with the work requierd in recolacting and removal of trees in sheet L-1
(Existing Trees). 16. One year warranty

TREE AND PALM PROTECTION NOTES:

1. Before beginning work, the Contractor is required to meet with the Landscape Architect at the site to review all work procedures, access routes, storage areas, and tree protection measures. 2. Chain Link Fences shall be erected to protect trees to be preserved. Chain Link Fences define a specific protection zone from each tree or group of trees. Chain Link Fences are to remain until all site work has been completed. Chain Link Fences may not be relocated or removed without the written permission of the Landscape Architect. Refer to tree & Palms Protection Detail. 3. Construction trailers, traffic and storage areas must remain outside fenced areas at all times. 4. All underground utilities and drain or irrigation lines shall be routed outside the tree protection zone. If lines must traverse the

protection area, they shall be funneled or bored under the tree line. (fenced area).

construction personnel.

on site must be tree—safe and not easily transported by water.

and the Landscape Architect should be notified immediately. 9. Any grading, construction, demolition, or other work that is expected to encounter tree roots must be monitored by the Landscape Contractor.

depth of 30 inches.

erosion and siltation situations and/or erosion within the tree protection zone. 12. Before grading, pad preparation, or excavation for foundations, footings, walls, or trenching near trees the trees shall be root pruned 12 inches outside the tree protection zone by cutting all roots cleanly to a depth of 36 inches. Roots shall be cut manually by digging a trench and cutting exposed roots with a saw, vibrating knife, rock saw, narrow trencher with sharp blades, or other approved root-pruning equipment.

13. Any roots damaged during grading or construction shall be exposed to sound tissue and cut cleanly with a saw. 14. If temporary haul or access roads must pass over the root area of trees to be retained, a road bed of 6 inches of mulch or gravel shall be created to protect the soil. The road bed material shall be replenished as necessary to maintain a 6 inch depth. 15. Spoil from trenches, basements, or other excavations shall not be placed within the tree protection zone, either temporary or permanently.

16. No burn piles or debris pits shall be placed within the tree protection zone. no ashes, debris, or garbage may be dumped or buried within the tree protection zone.

17. Maintain fire—safe areas around the fences. Also, no heat sources, flames, ignition sources, or smoking is allowed near mulch or trees.

DEAD WOOD INMEDIATELT PRIOR TO → PLANTING AS DIRECTED BY THE LANDSCAPE ARCHITECT - PROTECT TREE WITH BURLAP 1" WIDE MIN. NYLON STRAPING AT EQUAL ŚPACING (3 PER TREE) ── MULCH, 1" DEEP ON ROOT ZONE

/----- 1/2" x 2' FLOURESCENT ORANGE MARKER

SET CROWN OF ROOT BALL O' – 2" ABOVE SURROUNDING FINISH GRADE, UNTIE BURLAP FROM BASE OF TRUNK. TRIM AS

2"x 2"x 2' STAKE TOP TO BE 2" MIN BELOW FINISH GRADE

- BACKFILL WITH PLANTING SOIL

→ SET ROOTBALL ON MOUND OF COMPACTED ON UNDISTURBED SOIL

5. No materials, equipment, spoil, or waste or washout water may be deposited, stored, or parked within the tree protection zone

6. Additional tree pruning required for clearance during construction must be performed by a qualified arborist and not by

7. Any herbicides placed under paving materials must be safe for use around trees and labeled for that use. Any pesticides used

8. If injury should occur to any tree during construction, it should be evaluated as soon as possible by the Landscape Contractor

10. All trees shall be irrigated three times a week. Each irrigation procedure shall wet the soil within the tree protection zone to a

11. Erosion control devices such as silt fencing, debris basins, and water diversion structures shall be installed to prevent site





Callophyllum brasiliense



Chrysophyllum oliviforme




Cordia sebestena



Antigonon leptopus



Arachis glabrata

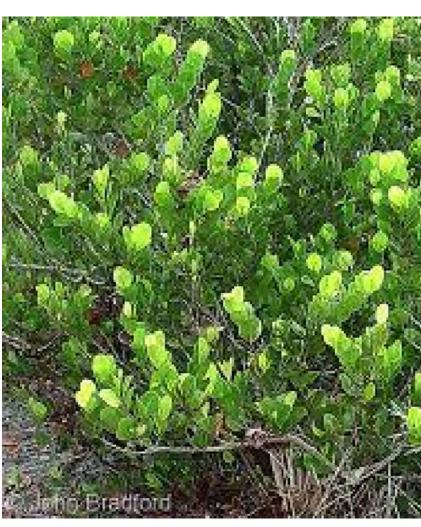

Chrysobalanus icaco 'Green'



Myrcianthes frangans



Tripsacum dactyloides



Cocos nucifera



Conocarpus erectus







Clusia guttifera



Cotoneaster dammeri





Philodendron xanadu



Podocarpus macrophyllus



Rhapis excelsa

Quercus virginiana

Alcantarea Odorata

Cycad revoluta




Hamelia patens





Spathoglottis plicata

PARAMETRIKA LAND & DESIGN Gabriela Albornoz Theresa Wymer LA6667363
PARAMETRIKA Land & Design
845 N North Lake Dr 845 N North Lake Dr Hollywood, FL 33019, EE. UU.
SHEET TILE Plant material
ISSUE DATE 02/02/2023
REVISION Feb 2023
DESIGN GA
DRAWN TY
SCALE N/A
SEAL THERESA WYMER LA6667363
SHEET NUMBER

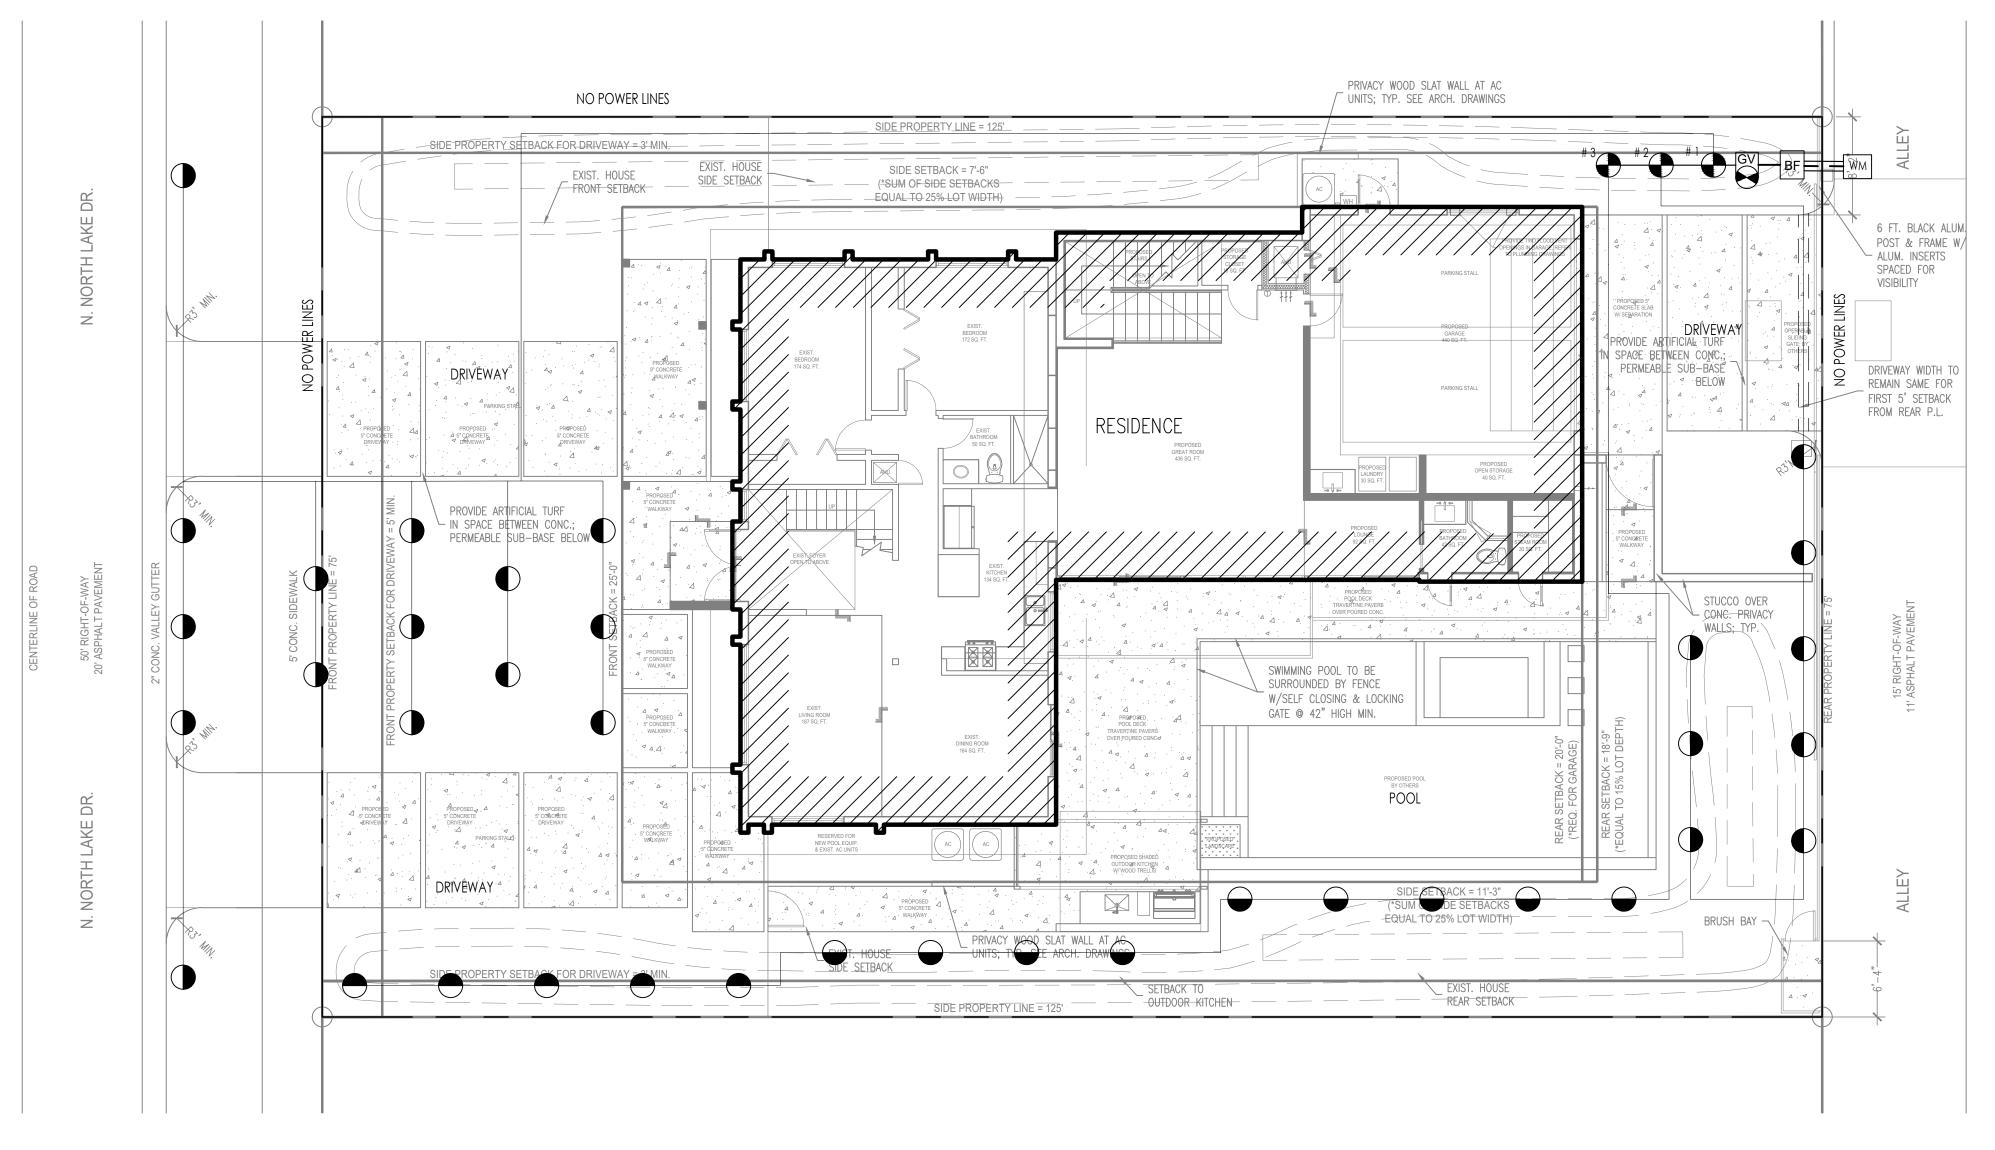

NOTE: PROVIDE 100% COVERAGE

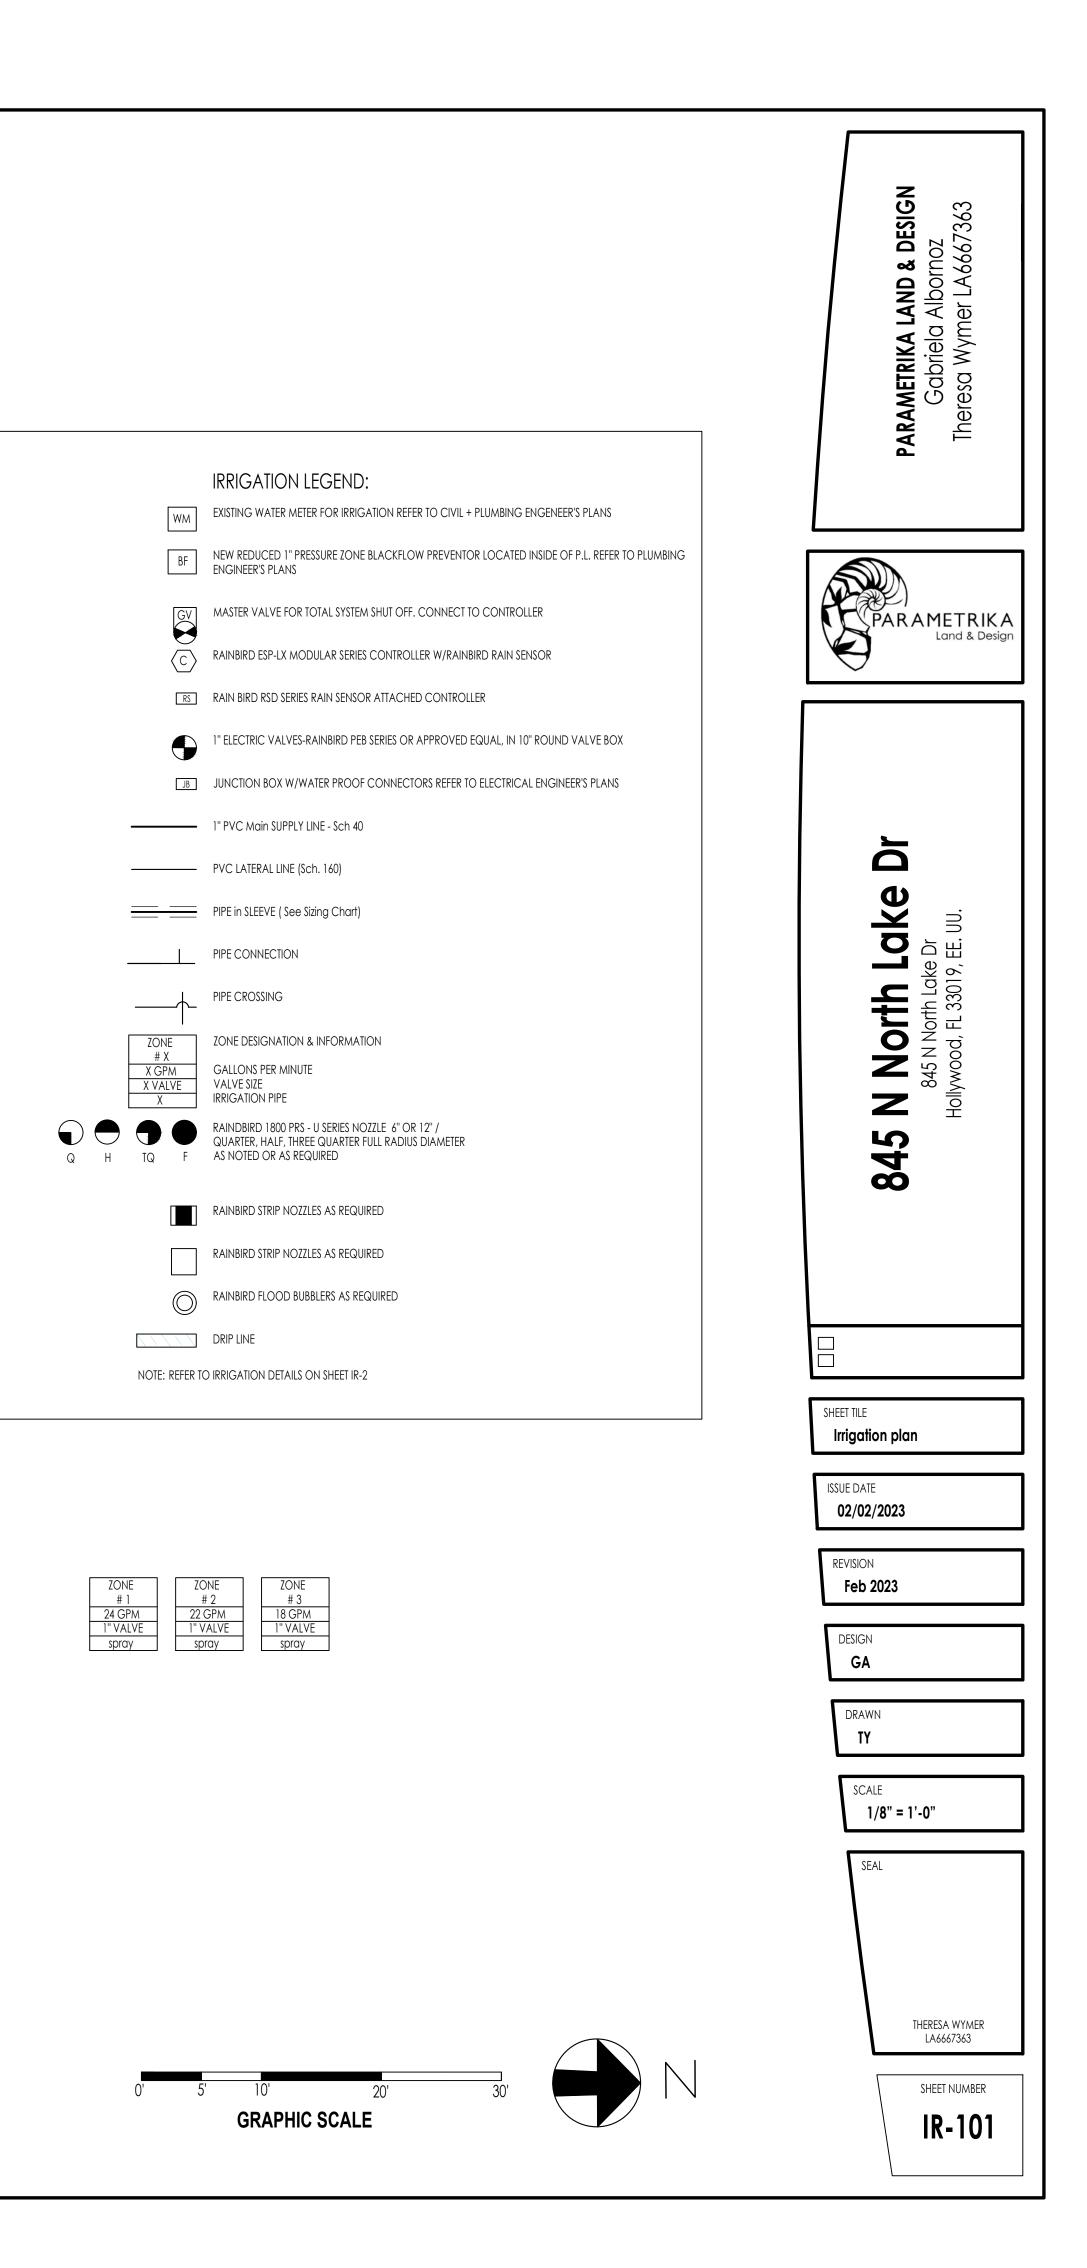

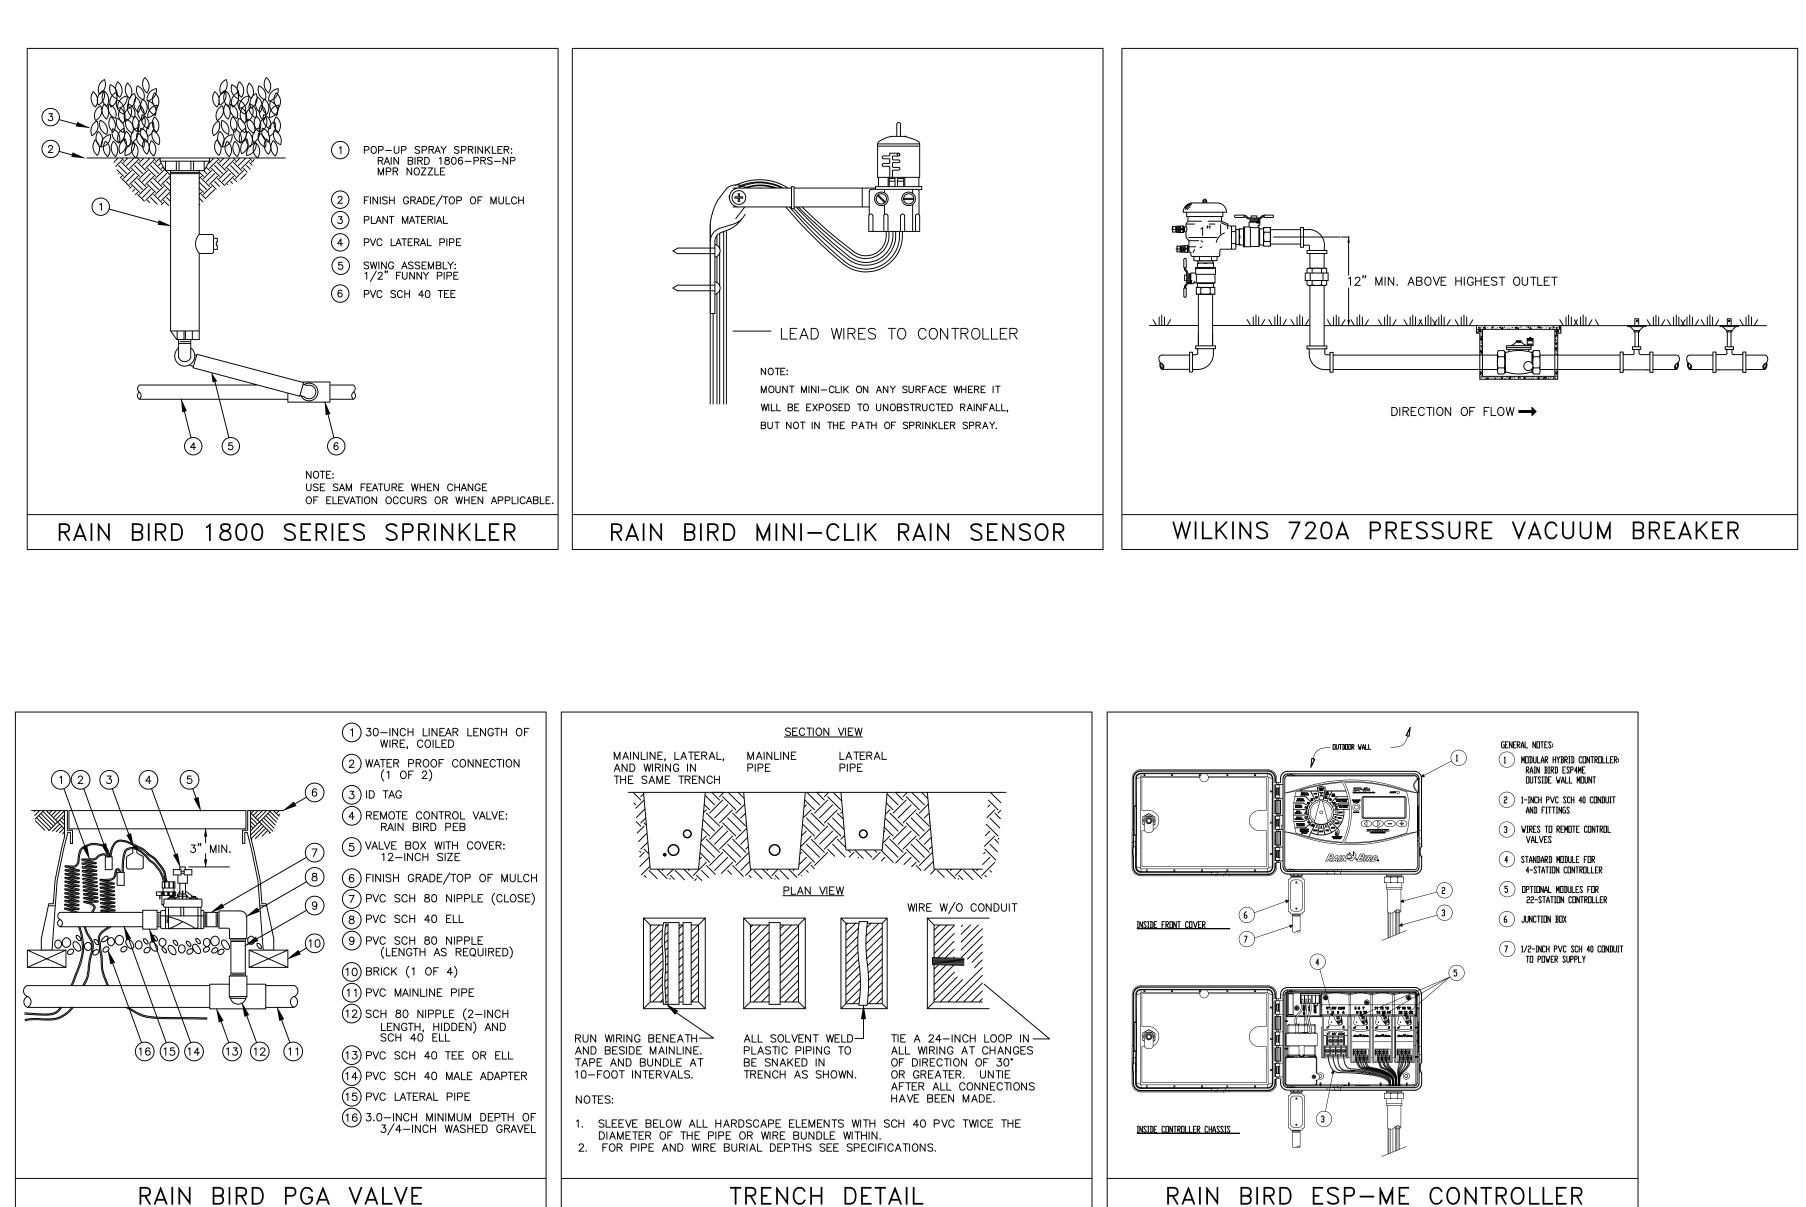



All newly-planted and relocated plant material shall be watered by temporary or permanent irrigation systems until such time as they are established and subsequently on as-needed basis to prevent stress and die-off in compliance with existing water use restrictions. (2) Irrigation shall be prohibited within native plant communities and natural forest communities, except for temporary systems needed to establish newly planted material. Temporary irrigation systems shall be disconnected immediately after establishment of plant communities. Irrigation systems shall be designed, operated and maintained to: (3) Meet the needs of all the plants in the landscape. (a) Conserve water by allowing differential operation schedules (b) (C) based on hydrozone. Consider soil, slope and other site characteristics in order (d) to minimize water waste, including overspray or overflow on to impervious surfaces and other non-vegetated areas, and off-site runoff. (e) Minimize free flow conditions in case of damage or other mechanical failure. Use low trajectory spray heads, and/or low volume water

(f) distributing or application devices.

Maximize uniformity, considering factors such as: (g) (1) Emitters types,

(2) Head spacing,

(3) Sprinkler pattern, and

Water pressure at the emitter. (4)

Use the lowest quality water feasible (graywater shall be (g)

used where approved systems are available).

Rain switches or other devices, such as soil moisture (h) sensors, shall be used with automatic controls. Where feasible, drip irrigation or micro-sprinklers shall be (i) used.

During dry periods, irrigation application rates of between one (1) (4) and one and one-half $(1\frac{1}{2})$ inches per week are recommended for turf areas.

(5) If an irrigation system is not provided, a hose bib shall be provided within seventy-five (75) feet of any landscape area.

Irrigation Notes

layout

LAYOUT IRRIGATION SYSTEM MAINLINES AND LATERAL LINES. MAKE ALL NECESSARY ADJUSTMENTS AS REQUIRED TO TAKE INTO ACCOUNT ALL SITE OBSTRUCTIONS AND LIMITATIONS PRIOR TO EXCAVATING TRENCHES. FLAG ALL SPRINKLER HEAD LOCATIONS. ADJUST LOCATION AND MAKE THE NECESSARY MODIFICATIONS TO NOZZLE TYPES ETC. AS REQUIRED TO INSURE 100% COVERAGE AND 50% OVERLAP. LOW ANGLE TRAJECTORY NOZZLES SHALL BE USED WHEN ALL SPRINKLERS AND ROTORS ARE LOCATED WITHIN 100' OF POOLS OR PUBLIC GATHERING AREAS.

PIPE LOCATIONS SHOWN ON PLAN ARE SCHEMATIC ONLY AND SHALL BE ADJUSTED IN THE FIELD. WHEN LAYING-OUT MAINS AND LATERALS, LOCATE PIPE NEAR EDGES OF PAVEMENT OR AGAINST BUILDINGS WHEREVER POSSIBLE TO ALLOW SPACE FOR PLANT ROOT BALLS. PIPING UNDER HARDSCAPES SUCH AS ROADS, WALKS, AND PATIOS ARE TO BE SLEEVED USING SCH. 40 PIPE. PIPES 4" AND UNDER TO BE SOLVENT WELD. LARGER PIPES TO BE GASKETED 'O' RING PIPES AND USE THRUST BLOCKS OR MEGA LUGS AND DUCTILE IRON FITTINGS AT TURNING LOCATIONS.

*INSTALL RAIN SENSOR AS PER LOCAL CODE

*SIZE ALL PIPE SO NOT TO EXCEED 5' PER SECOND

WIRE SIZED AND COLORED AS FOLLOWS:

#12 WHITE FOR COMMON

#14 RED HOT WIRES


RECOMMENDATIONS.

Flushing

TRENCHING

WIRES

BOX.

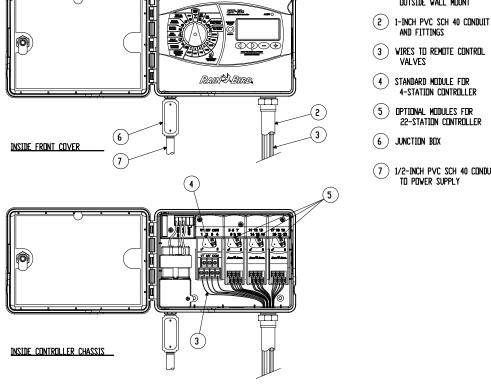

RAIN BIRD ESP-ME CONTROLLER

PIPES CONVEYING RECLAIM WATER SHALL HAVE A 3' HORIZONTAL DISTANCE SEPARATION FROM OTHER PIPING OR UTILITY SERVICES. AN 18" VERTICAL SEPARATION SHALL BE MAINTAINED WHEN APPLICABLE. AIR RELEASE VALVES TO BE USED AT THE END OF ALL MAINLINE RUNS.

ALL PIPES TO BE IN ACCORDANCE WITH APPENDIX F OF THE 2017 FLORIDA BUILDING CODE.

LOW VOLTAGE WIRE TO BE INSTALLED ALONG MAINLINE INSTALLATION. USE 2" SCH. 40 PVC WITH SWEEP ELBOWS AT TURNING LOCATIONS WHEN SLEEVING IS REQUIRED. ALL SPLICES SHALL BE ENCLOSED WITHIN A VALVE/SPLICE

#12 SPARE BLACK COMMON (1 SPARE NEEDED PER 10 HOT WIRES)

#14 SPARE YELLOW HOT WIRE (1 SPARES NEEDED PER 10 HOT WIRES, 3 SPARE MINIMUM) WHEN WIRE RUNS EXCEEDS 3,500 LINEAR FEET, USE #10 FOR COMMON WIRES AND #12 FOR HOT/SPARE WIRES.

ALL IRRIGATION CONTROLLERS TO BE PROPERLY GROUNDED IN ACCORDANCE WITH MANUFACTURE'S

PRIOR TO PLACEMENT OF HEADS FLUSH ALL LINES UNTIL LINES ARE COMPLETELY CLEAN OF DEBRIS.

TRENCH BOTTOM TO BE UNIFORM AND FREE OF DEBRIS. NATIVE EXCAVATED MATERIAL USED TO BACKFILL TRENCH SHALL BE FREE FROM ROCKS OR STONES LARGER THAN 1" IN DIAMETER.

PRESSURE TEST MAINLINE AS PER FLORIDA BUILDING CODE. INSTALL IRRIGATION SYSTEM AS PER LATEST EDITION OF THE FLORIDA BUILDING CODE, APPENDIX F., AND ALL PERTINENT LOCAL CODES. SPRAY HEADS INSTALLED IN SHRUB AREAS TO BE 12 INCH POP-UPS OR INSTALLED ON RISERS.

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SHEET TILE
Irrigation details and notes ISSUE DATE 02/02/2023
REVISION Feb 2023
design GA DRAWN
TY SCALE N/A
SEAL THERESA WYMER LA6667363
SHEET NUMBER



Roberts Architecture and Construction, Inc.

A Design-Build Company 6511 Nova Drive, Suite 268 Davie, FL 33317

CRITERIA STATEMENT

845 N. NORTHLAKE DR. RESIDENCE

Anthony Handley

845 N. Northlake Drive

Hollywood, FL 33019

ID #: 5142 14 02 3850

Legal Description: HOLLYWOOD LAKES SECTION 1-32 B LOT 2 E1/2,3 BLK 69

PROPOSAL

RESIDENTIAL ADDITION

SINGLE-FAMILY RESIDENCE

TWO-STORY STRUCTURE

4 BEDROOMS (1 NEW) & 4 BATHROOMS (2 NEW)



February 15, 2023

City of Hollywood Historic Preservation Board

2600 Hollywood Blvd., Room 315

Hollywood, FL 33022

Re: 845 N. Northlake Drive

Hollywood, FL 33019

CRITERIA APPROPRIATENESS FOR DESIGN

845 N. Northlake Drive

Hollywood, FL 33019

CRITERION: INTEGRITY OF LOCATION

The property located at 845 N. Northlake Drive was built in the late 1970's in the Lakes Area Historic Multiple Resource Listing District. This district is designated mostly for residential properties and this specific property is classified as a single-family residence. The single-family structure located towards the front of the property is scheduled to remain as is, with little to no exterior modifications or improvements. The addition proposed towards the rear of the property is defined within the specified setbacks and compliments scale and shape of existing structure utilizing same structure and similar finishes.

CRITERION: DESIGN

The proposed design of the new structure is meant to compliment and not overpower the existing structure's features, matching the scale of the existing structure. The proposed structure will be constructed in the same way as existing structure, with concrete foundation and perimeter CMU block construction. The majority of visible finishes to the public on the proposed exterior facades will be stucco, to match finish of existing strucco at existing structure. The proposed structure is scheduled to be painted upon completion to match existing color of existing structure. The design of the proposed structure utilizes the Northwest portion of property to add new structure, creating open space on the Northeast to build new in-ground pool, right off the existing structure and adjacent structure to the West



on the corner lot, whereas the structure adjacent to the East is a single-story structure and would be overpowered by the scale of a two-story structure.

CRITERION: SETTING

The proposed setting of the new structure will be located on the rear of the property, situated on the Northwest corner of lot. This location minimizes the impact to the existing structure and keeps the focus on the exiting structure when driving along N. Northlake Drive. The scale of the proposed structure is designed to blend with the scale of both the existing two-story structure and the adjacent two-story structure to the West. The proposed two-story addition on the rear of the property allows for private entry through the alley and reserves required space for landscape and permeable surfaces.

CRITERION: MATERIALS

The existing structure is scheduled to remain as is, with little to no changes to the exterior and structural components. The only modifications to the existing structure would be on the rear of the property, away from public eye, to accommodate access to new structure. All finishes at existing property are scheduled to remain, and the integrity of existing structure and overall aesthetics will be undisturbed. The proposed structures design intent will be to best match the existing finishes of the existing structure through quality standards and procedures implemented during construction. The facades of the proposed structure will be stucco over CMU and concrete, with a finish to match existing. Existing and proposed structures will be painted to match, to avoid new structure taking focus off of existing structure. The proposed driveways will be poured concrete with spacing in between slabs to allow for water to permeate. Surrounding areas will be permeable surfaces, including designated landscaping areas at front and rear of property to assist in runoff control within property limits.

CRITERION: WORKMANSHIP

The key to a successful build, and meeting the design guidelines within a historic district, is quality construction management, and quality labor who specializes in the work being performed. Our team will be contracting with local trades with a focus on experienced labor and quality materials to achieve success in meeting the design guidelines for this historic neighborhood. All trades are required to be licensed and insured, and extensive research will be implemented to source the right trades who can match the quality of work expected in this historic district. We will aim to minimize disturbance to the site and eliminate disturbance off site. We will strive to minimize our impact to the site in the machinery and equipment we use, and maintain acceptable noise impact levels to adjacent residences.



CRITERION: ASSOCIATION

Our intent is to maintain integrity between what is being proposed to build and pre-existing structures, not just on site, but within adjacent properties. We were conscious in the design process, identifying key features and components and their visibility to the public and how that affects the overall aesthetics of the existing structure, property and adjacent sites. The location of the addition on the North side of the property ensures the existing structure on south side of property remains the focal point, and the view along N. Northlake Drive remains undisturbed.

Please don't hesitate to contact me with questions or requests for additional information.

Regards,

Blaine Roberts, President **ROBERTS** Architecture and Construction, Inc.