HOLLYWOOD BEACH GOLF CLUB

HOLLYWOOD, FLORIDA

DESIGN DEVELOPMENT

JUNE 3, 2022

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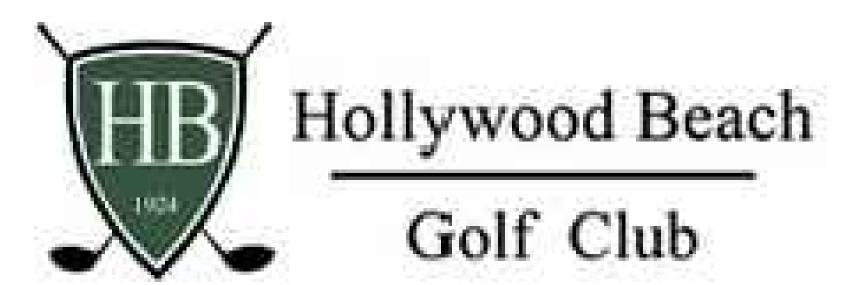
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Design and Construction Management

PO Box 229045 Hollywood, Florida 33022-9045

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camacho

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DESIGN
DEVELOPMENT
INDEX

06.03.2022

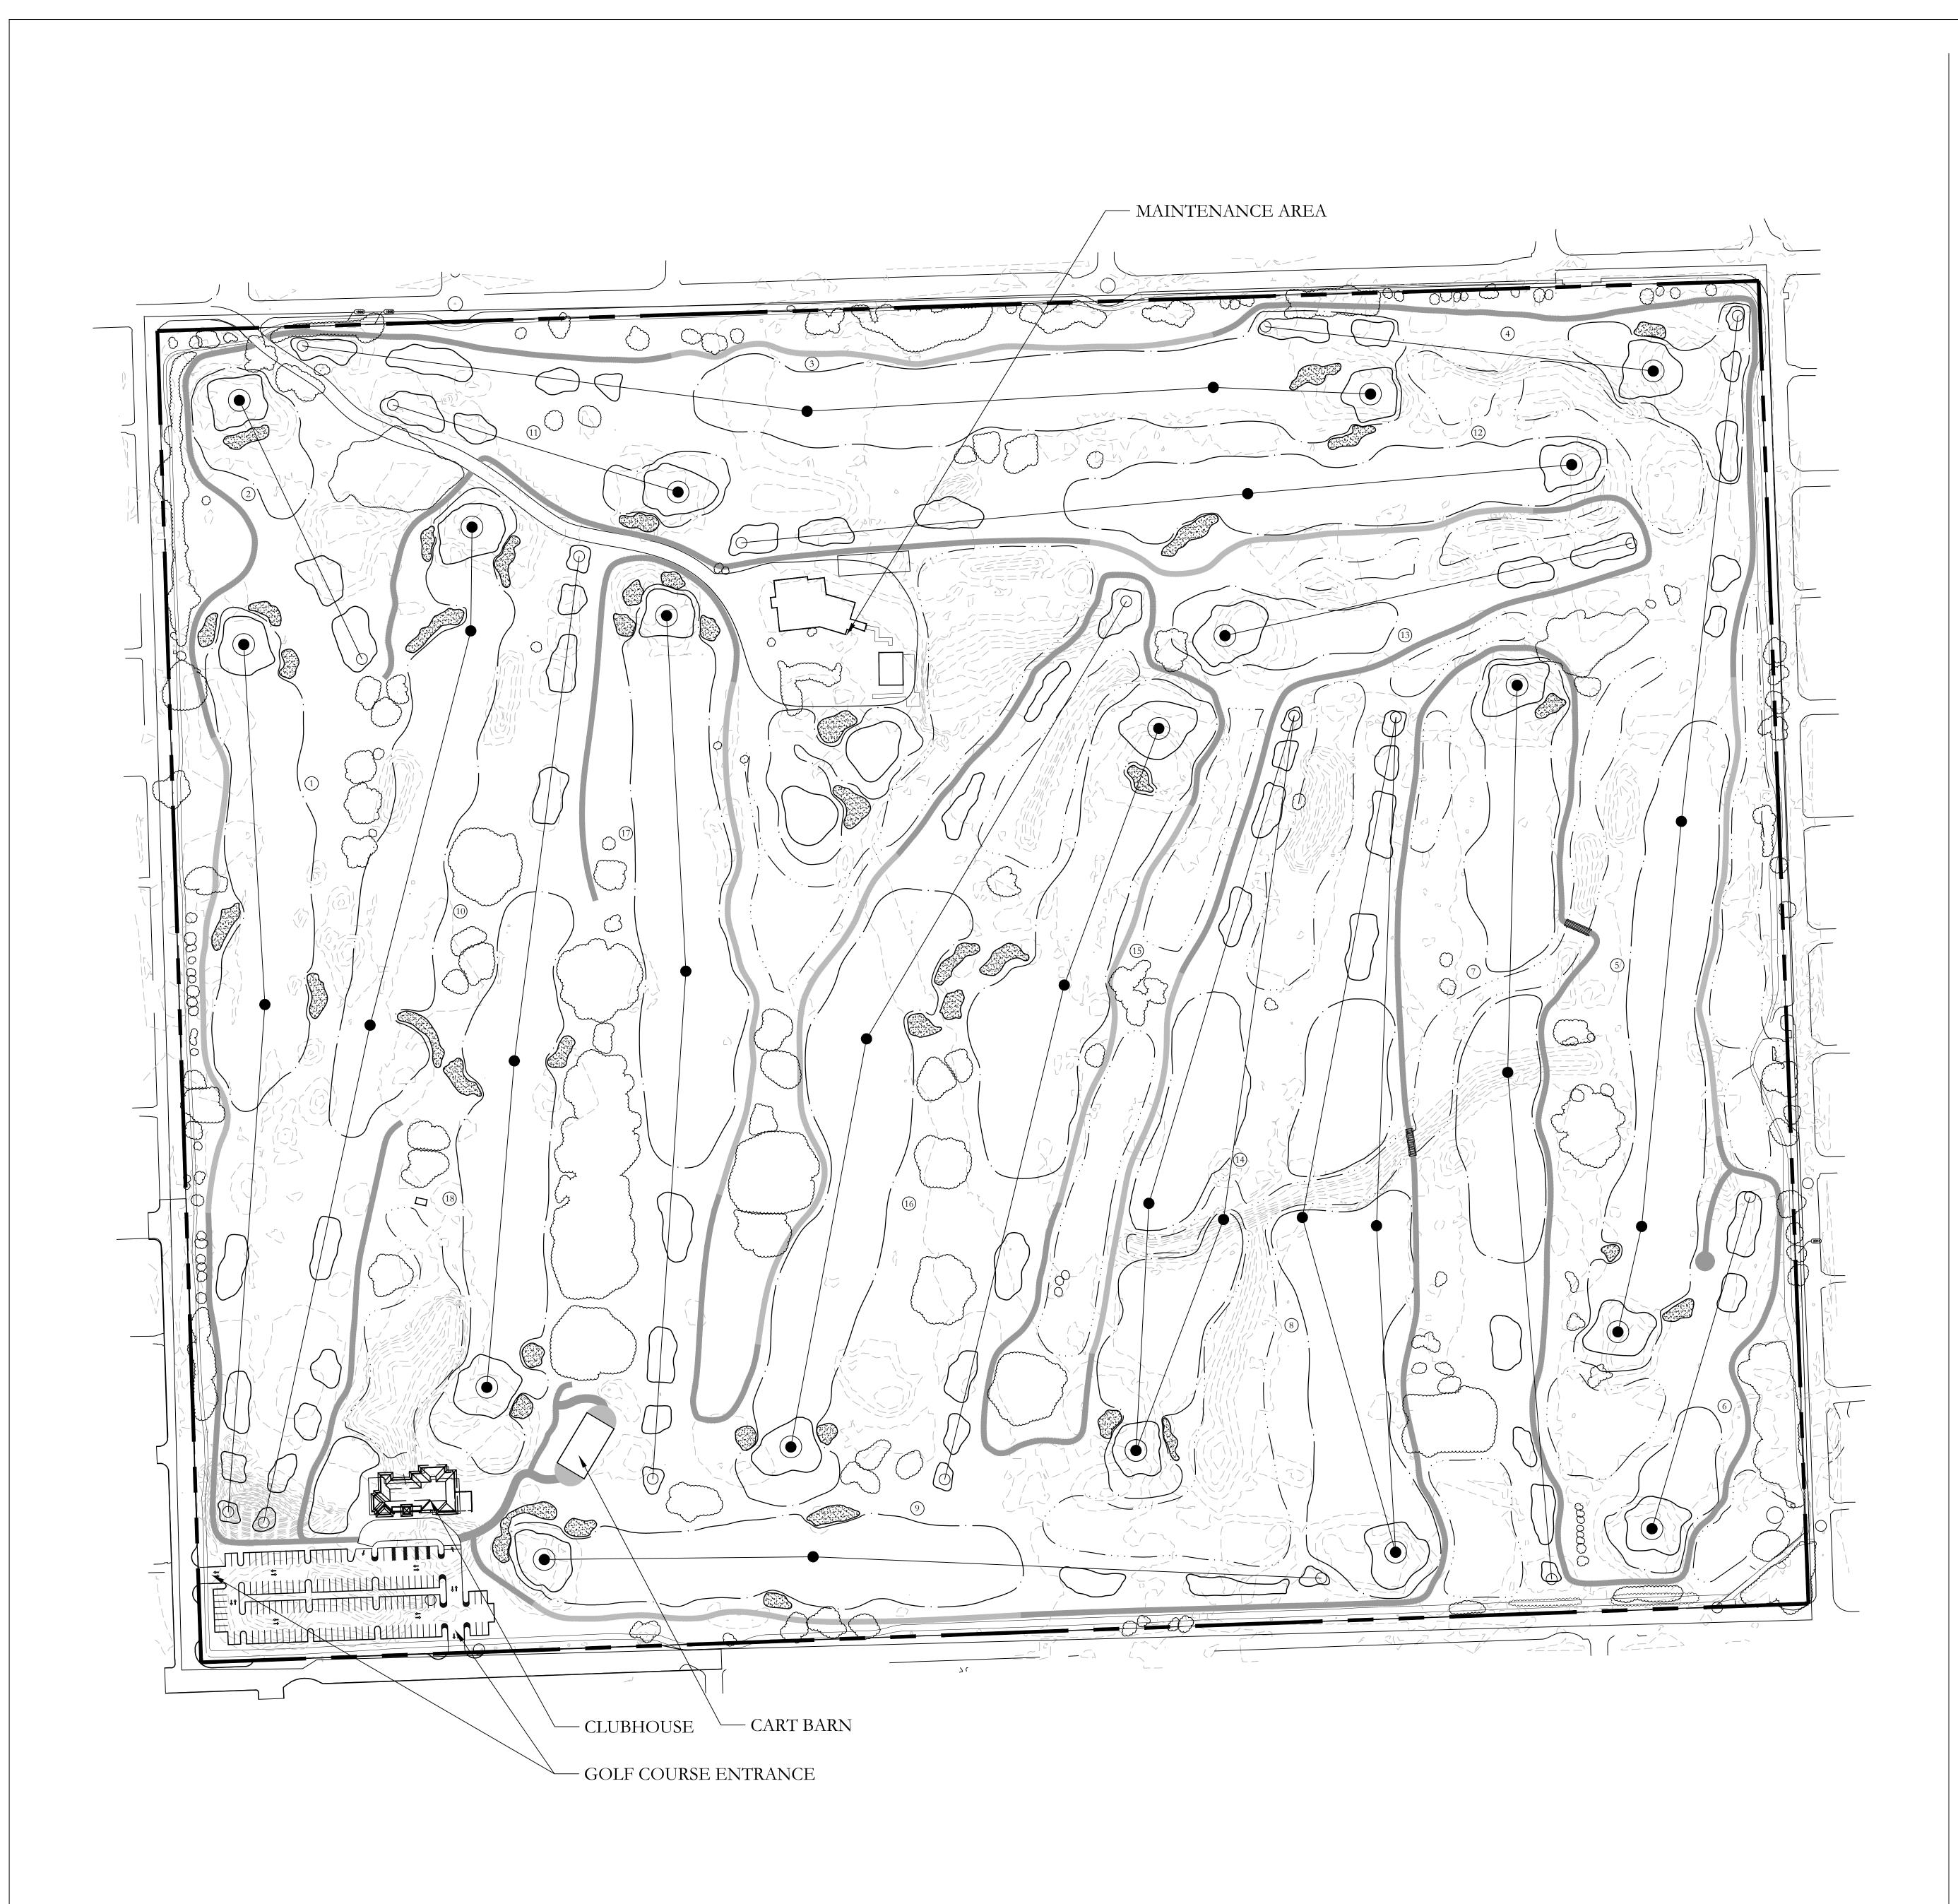
PROJECT NAME:
HOLLYWOOD BEACH GOLF
COURSE AND CLUBHOUSE
PROJECT ADDRESS:

PROJECT ADDRESS: 1600 Johnson Street Hollywood, FL 33020 PROJECT NO.: 02141.000

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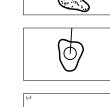


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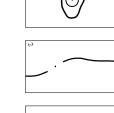
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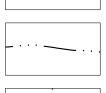
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SAND BUNKER

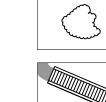


FAIRWAY



WATER

TEE



BRIDGE

TREE TO REMAIN

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DESIGN DEVELOPMENT MASTER PLAN

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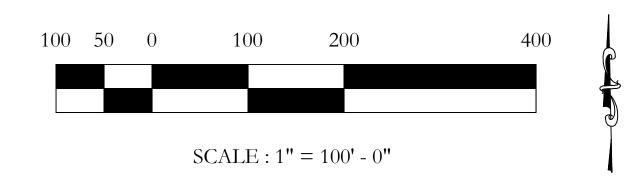
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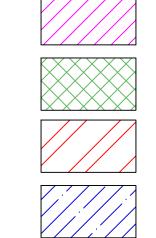
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- 1. CONTRACTOR SHALL ADHERE TO ALL TREE PROTECTION REQUIREMENTS LISTED IN THESE SPECIFICATIONS AND/OR THOSE LISTED IN THE CITY OR COUNTY ZONING CODE, TREE PROTECTION (LATEST EDITION). WHICHEVER IS MORE STRINGENT SHALL APPLY. 2. CONTRACTOR SHALL COORDINATE ALL CONSTRUCTION PROCEDURES WITH THE PROJECT ARBORIST PRIOR TO BEGINNING WORK. ANY AREAS SUBJECT TO EROSION MUST BE ADEQUATELY STABILIZED WITH VEGETATION
- MATERIAL THAT WILL, WITHIN A REASONABLE TIME FRAME, DETER SOIL DISTURBANCE. 4. NO SIGNS, BUILDING PERMITS, WIRES OR OTHER ATTACHMENTS OF ANY KIND SHALL BE ATTACHED TO ANY TREE OR PALM. GUY WIRES DESIGNED TO PROTECT TREES ARE EXCLUDED FROM THIS PROHIBITION. 5. EXISTING TREE LOCATIONS AND SIZES ARE ESTIMATES AND ARE BASED ON SURVEY
- PROVIDED BY THE CITY- SELECTED SURVEYOR. CONTRACTOR SHALL COORDINATE TREE REMOVAL WITH PERMITTING AGENCY AND PROJECT ARBORIST PRIOR TO CONSTRUCTION. NO PERSON MAY REMOVE OR CAUSE TO BE REMOVED ANY PROTECTED TREE OR PALM WITHOUT FIRST HAVING PROCURED A PERMIT AS PROVIDED BY THE APPROPRIATE PERMITTING AGENCY. 7. FOR PROTECTED TREES OR PALMS BEING REMOVED, THE CONTRACTOR MUST GIVE THE PERMITTING AGENCY REASONABLE OPPORTUNITY TO RELOCATE TREES DESIGNATED FOR
- REMOVAL TO ANOTHER SITE AT THE PERMITTING AGENCY'S EXPENSE. CONTRACTOR IS RESPONSIBLE FOR POSSESSING ALL REQUIRED APPLICATOR LICENSES, BUSINESS REGISTRATIONS AND INSURANCE, PESTICIDE LABELS, AND MATERIAL DATA SAFETY SHEETS. THE CONTRACTOR IS ALSO RESPONSIBLE FOR HAVING ALL SPILL CONTAINMEN'T MATERIALS AND REQUIRED PERSONAL PROTECTIVE EQUIPMENT FOR PESTICIDE APPLICATIONS AND ACCIDENTAL SPILLS ON SITE AT ALL TIMES. THE CITY
- RESERVES THE RIGHT TO INSPECT EACH APPLICATOR AND HAVE THESE MATERIALS PRESENTED BEFORE AND DURING ANY PESTICIDE TREATMENT. 9. TREE WELLS OF AN APPROVED DESIGN SHALL BE CONSTRUCTED AROUND ALL TREES TO BE PRESERVED WHEN MORE THAN FOUR INCHES OF FILL IS TO BE DEPOSITED WITHIN THE
- DRIP LINE AREA OF THOSE TREES. COORDINATE WITH PROJECT ARBORIST. THE SEQUENCE OF PRESERVATION MEASURES IS IMPERATIVE TO THE HEALTH AND SURVIVABILITY OF THE SUBJECT TREES AND SHALL BE COORDINATED WITH THE CITY-SELECTED PROJECT ARBORIST. THE DESIRED SEQUENCE IS OUTLINED BELOW: a. TREE PROTECTION FENCING.
- ROOT PRUNING AND ROOT BARRIERS. c. CLEARING. TREE CANOPY PRUNING. e. IRRIGATION.
- B. TREE PROTECTION FENCING
- 1. PRIOR TO THE ERECTION OF ANY TREE PROTECTION FENCING. ALL FOREIGN SURFACE MATERIAL, TRASH OR DEBRIS SHALL BE REMOVED FROM THE AREA TO BE ENCLOSED BY THE FENCING. AFTER ERECTION OF THE FENCING NO SUCH MATERIAL OR LITTER SHALL BE PERMITTED TO REMAIN WITHIN THE PROTECTED AREA.
- TREE PROTECTION FENCING SHALL BE PLACED AROUND ALL PROTECTED TREES TO CREATE A PROTECTIVE ROOT ZONE AND SHALL REMAIN IN PLACE UNTIL SITE CLEARING, LAND ALTERATION, AND CONSTRUCTION ACTIVITIES ARE COMPLETE.
- 3. NATIVE GROUND COVER AND UNDERSTORY VEGETATION EXISTING WITHIN THE PROTECTED AREA SHALL REMAIN THROUGHOUT CONSTRUCTION. OTHER DESIGNATED VEGETATION AND INVASIVE PLANT SPECIES SHALL BE REMOVED ONLY BY MANUAL LABOR
- UTILIZING HAND TOOLS, OR BY OTHER METHODS APPROVED BY THE PROJECT ARBORIST. TREE PROTECTION FENCING TYPES AND LOCATIONS SHALL BE ERECTED AS SHOWN ON THE TREE MITIGATION PLANS AND DETAILS, OR AS REQUESTED BY LOCAL AGENCY. FINAL LOCATIONS SHALL BE COORDINATED WITH AND APPROVED BY THE PROJECT
- 6. NO MATERIALS, EQUIPMENT, SPOIL, WASTE OR WASHOUT WATER MAY BE DEPOSITED, STORED, OR PARKED WITHIN 20 FEET OF ANY TREE PROTECTION ZONE. EROSION CONTROL DEVICES SUCH AS SILT FENCING, DEBRIS BASINS, AND WATER DIVERSION
- STRUCTURES SHALL BE INSTALLED TO PREVENT SILTATION AND/OR EROSION WITHIN THE TREE PROTECTION ZONE. 8. CONSTRUCTION ACTIVITY SHALL NOT DESTROY OR IRREVERSIBLY HARM THE ROOT SYSTEM OF PROTECTED TREES. POST HOLES AND TRENCHES LOCATED CLOSE TO PROTECTED TREES
- SHALL BE ADJUSTED TO AVOID DAMAGE TO MAJOR ROOTS. 9. DO NOT INSTALL CONDUIT, DRAIN OR IRRIGATION LINES, OR ANY UTILITY LINE WITHIN THE TREE PROTECTION ZONE WITHOUT THE APPROVAL OF THE PROJECT ARBORIST. IF LINES MUST TRAVERSE THE PROTECTION AREA, THEY SHALL BE TUNNELED OR BORED
- UNDER THE TREE. 10. CONTRACTOR'S ACCESS TO FENCED TREE PROTECTION AREAS WILL BE PERMITTED ONLY WITH APPROVAL OF THE PROJECT ARBORIST.
- EXCAVATION OR GRADING WITHIN THE PROTECTED AREA SHALL NOT BE ALLOWED. STRUCTURES AND UNDERGROUND FEATURES TO BE REMOVED WITHIN THE TREE PROTECTION ZONE SHALL BE COORDINATED WITH THE PROJECT ARBORIST. 13. IF ANY DAMAGE TO TREE PROTECTION FENCING SHOULD OCCUR BY ACCIDENT OR
- NEGLIGENCE. THE CONTRACTOR SHALL BE RESPONSIBLE FOR IMMEDIATE REPAIRS. 14. NO TEMPORARY HAUL OR ACCESS ROADS MUST PASS OVER THE PROTECTED AREA OF TREES
- CONTRACTOR SHALL COORDINATE WITH THE PROJECT ARBORIST PRIOR TO REMOVAL OF ALL TREE PROTECTION FENCING. C. ROOT PRUNING/TRENCHING
- TRENCHING LOCATIONS SHALL BE APPROVED IN THE FIELD BY THE PROJECT ARBORIST. TRENCHING EQUIPMENT THAT WILL TURN AT HIGH RPM'S IS PREFERRED, AND SHALL BE APPROVED BY THE PROJECT ARBORIST. APPROVED EQUIPMENT WILL BE USED TO PERFORM ALL ROOT PRUNING OPERATIONS. A MINIMUM DEPTH OF THREE FEET IS REQUIRED. INSTALL ROOT BARRIER WHERE DESIGNATED. SEE TREE MITIGATION PLAN AND DETAIL
- THE TRENCH SHALL BE BACKFILLED WITH PREVIOUSLY EXCAVATED SOIL AND COMPACTED WHEN THE TREE ROOT ZONE WILL BE DISTURBED, AFFECTED ROOTS MUST BE SEVERED BY CLEAN PRUNING CUTS AT THE POINT WHERE CONSTRUCTION IMPACTS THE ROOTS.
- ANY BRUSH CLEARING REQUIRED WITHIN THE TREE PROTECTION ZONE SHALL BE ACCOMPLISHED WITH HAND-OPERATED EQUIPMENT ONLY. CONTRACTOR SHALL CLEAR ALL TREE PROTECTION AREAS OF VINES, SHRUBS, GROUND COVERS, WEEDS, SAPLINGS, AND INVASIVES LISTED ON THE LATEST EDITION OF THE FLORIDA EXOTIC PEST PLANT COUNCIL'S LIST OF INVASIVE SPECIES.
- 3. CONTRACTOR SHALL BE RESPONSIBLE FOR REMOVING ALL EXCESS DEBRIS ON A DAILY
- 1. EVERY EFFORT SHALL BE MADE TO WATER THE PRESERVED TREES. CONTRACTOR SHALL IRRIGATE BY HAND OR BY TEMPORARY IRRIGATION UNTIL ACCEPTANCE BY THE CITY. IRRIGATE AS REQUIRED BY PROJECT ARBORIST UNTIL PERMANENT IRRIGATION IS INSTALLED AND OPERATING. UNDERGROUND IRRIGATION SHALL NOT BE INSTALLED WITHIN THE DRIP LINES OF EXISTING TREES UNLESS ROOT PROTECTION MEASURES ARE PROVIDED AND APPROVED BY PROJECT ARBORIST.
- 1. PRIOR TO AND DURING LAND CLEARING, INCLUDING GRUBBING, ALL TREES TO BE REMOVED SHALL BE CLEARLY MARKED BY PROJECT ARBORIST WITH RED SURVEY RIBBONS AT 36 INCHES MINIMUM ABOVE GRADE. CONTRACTOR SHALL REMOVE ALL TREES AS SHOWN ON THE TREE MITIGATION PLANS
- AFTER THE TREE PROTECTION FENCING IS INSTALLED AND AFTER SECURING THE TREE 3. ALL TREES SHOWN TO BE REMOVED SHALL BE FELLED WITH A CHAIN SAW AND STUMP
- REMOVED BY CONTRACTOR. 4. ALL BURN PITS IF APPLICABLE MUST BE APPROVED BY THE PROJECT ARBORIST AND OWNER.
- REPAIR OF DAMAGED TREES IF DAMAGE TO ANY TREE SHOULD OCCUR BY ACCIDENT OR NEGLIGENCE DURING THE CONSTRUCTION PERIOD, THE PROJECT ARBORIST SHALL APPRAISE THE DAMAGE AND MAKE RECOMMENDATIONS TO THE OWNER FOR REPAIR BY THE CONTRACTOR. IF ANY TREE DESIGNATED TO BE SAVED IS REMOVED FROM THE SITE WITHOUT PERMISSION OF THE OWNER'S REPRESENTATIVE, THE PROJECT ARBORIST SHALL APPRAISE THE TREE AND MAKE RECOMMENDATIONS TO THE OWNER FOR REPLACEMENT BY THE CONTRACTOR. THE CONTRACTOR SHALL BE RESPONSIBLE FOR REPLACEMENT OF THE TREE AND ANY FEES THAT MAY BE ASSESSED TO THE OWNER BY THE GOVERNING AGENCY.

LEGEND



INVASIVE TREES TO BE REMOVED

NON-INVASIVE TREES TO BE REMOVED

LIVE OAK TO BE REMOVED

BANYAN TO BE REMOVED

GENERAL VEGETATION TO BE REMOVED

400 SCALE : 1" = 100' - 0"

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> **DESIGN DEVELOPMENT** TREE CLEARING **PLAN**

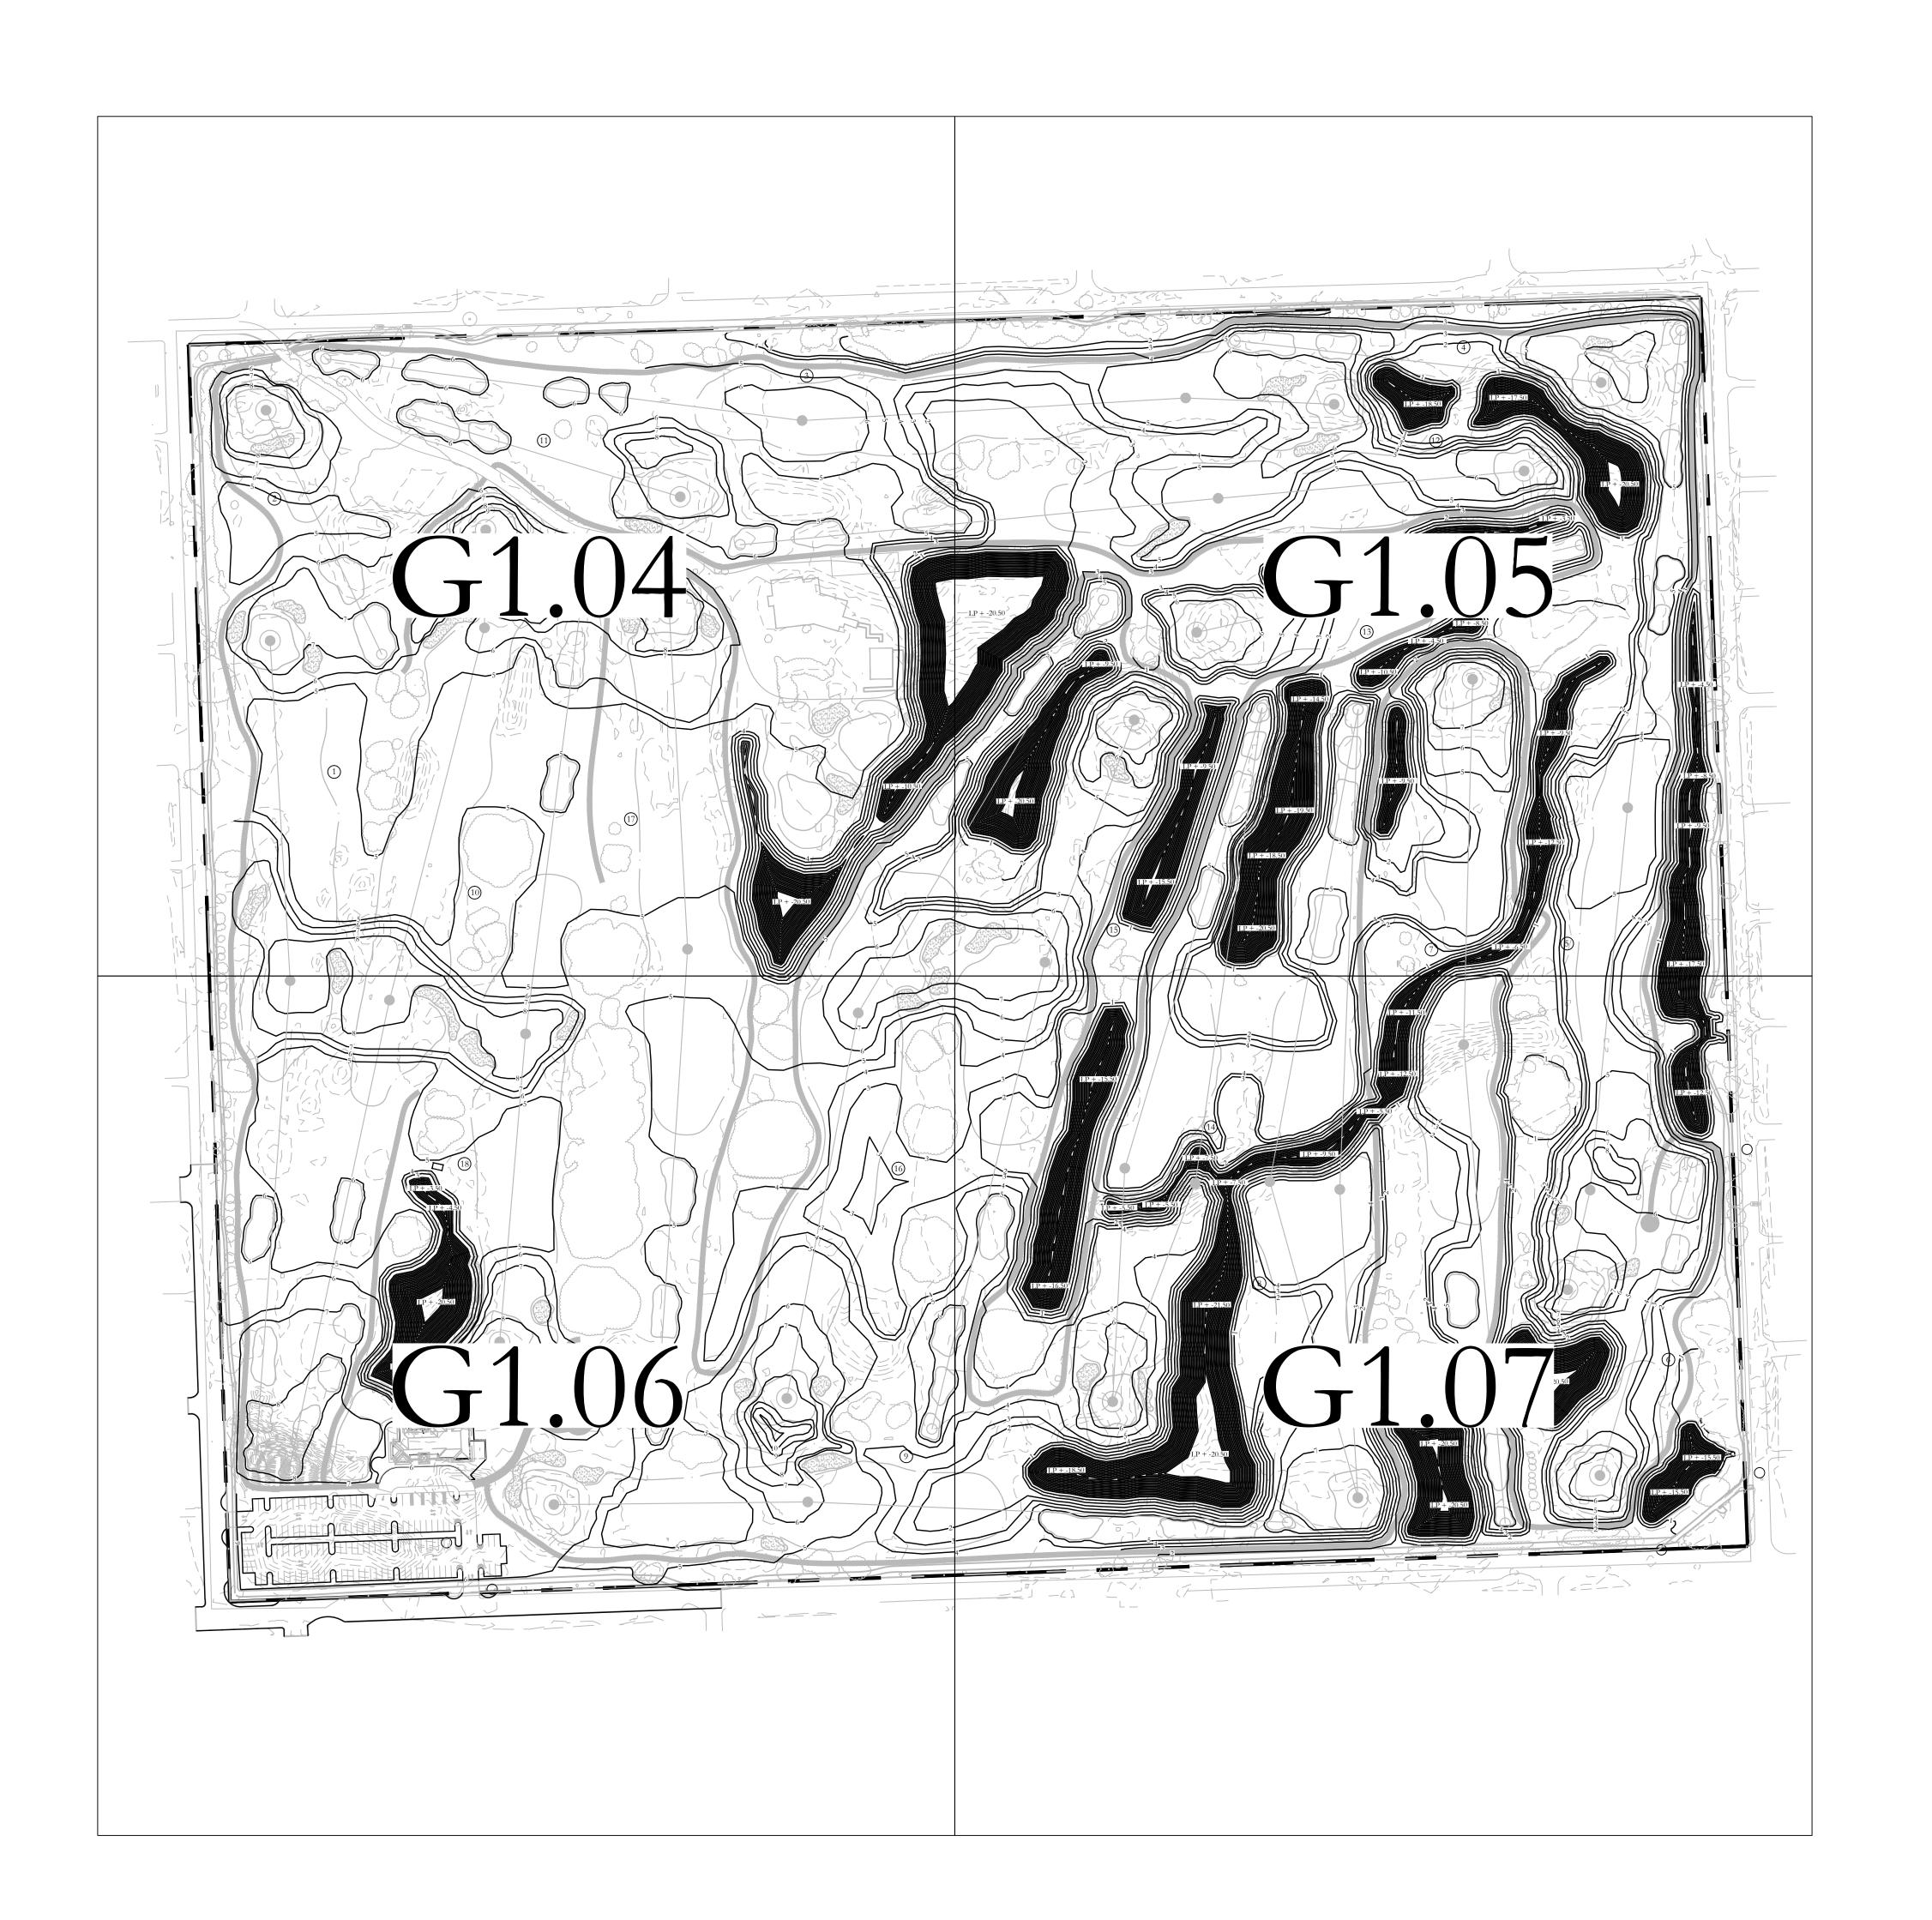
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PROJECT NAME: HOLLYWOOD BEACH GOLF **COURSE AND CLUBHOUSE PROJECT ADDRESS:** 1600 Johnson Street Hollywood, FL 33020 PROJECT NO.: 02141.000

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DESIGN DEVELOPMENT TREE CLEARING PLAN

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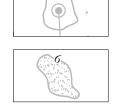


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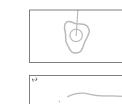
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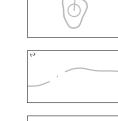


TEE

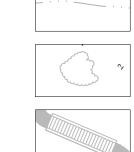
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SAND BUNKER



FAIRWAY



MAP KEY

WATER

TREE TO REMAIN

BRIDGE



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NOT TO SCALE

DESIGN DEVELOPMENT OVERALL GRADING PLAN

06.03.2022

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PROJECT ADDRESS: 1600 Johnson Street Hollywood, FL 33020 PROJECT NO.: 02141.000

SHEET NAME

DESIGN DEVELOPMENT OVERALL GRADING PLAN

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G1.03

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GREEN

SAND BUNKER

TEE FAIRWAY

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Bermello Ajamil & Partners

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Architecture Engineering Planning Interior Design Landscape Architecture 2601 South Bayshore Drive, 10th Floor Miami, Florida 33133 T: (305) 859-2050 F: (305) 860-3700

MEP ENGINEERING:



Delta-G Consulting Engineers, Inc. 707 NE 3rd Ave. Suite. 200 Fort Lauderdale, FL 33304 T: (954) 527-1112

STRUCTURAL ENGINEERING:



Bliss & Nyitray, Inc. 5835 Blue Lagoon Drive, Suite 400 Miami, FL 33126 T: (305) 442-7086

CIVIL ENGINEER:



Miller-Legg 5747 Andrews Way Fort Lauderdale, FL 33309 T: (954) 436-7000

FOOD & BEVERAGE:

Camacho 3103 Medlock Bridge road Norcross, Georgia 30071 T: (770) 582-1144

NOT TO SCALE

200

SCALE: 1" = 50' - 0"

DESIGN DEVELOPMENT GRADING PLAN

06.03.2022

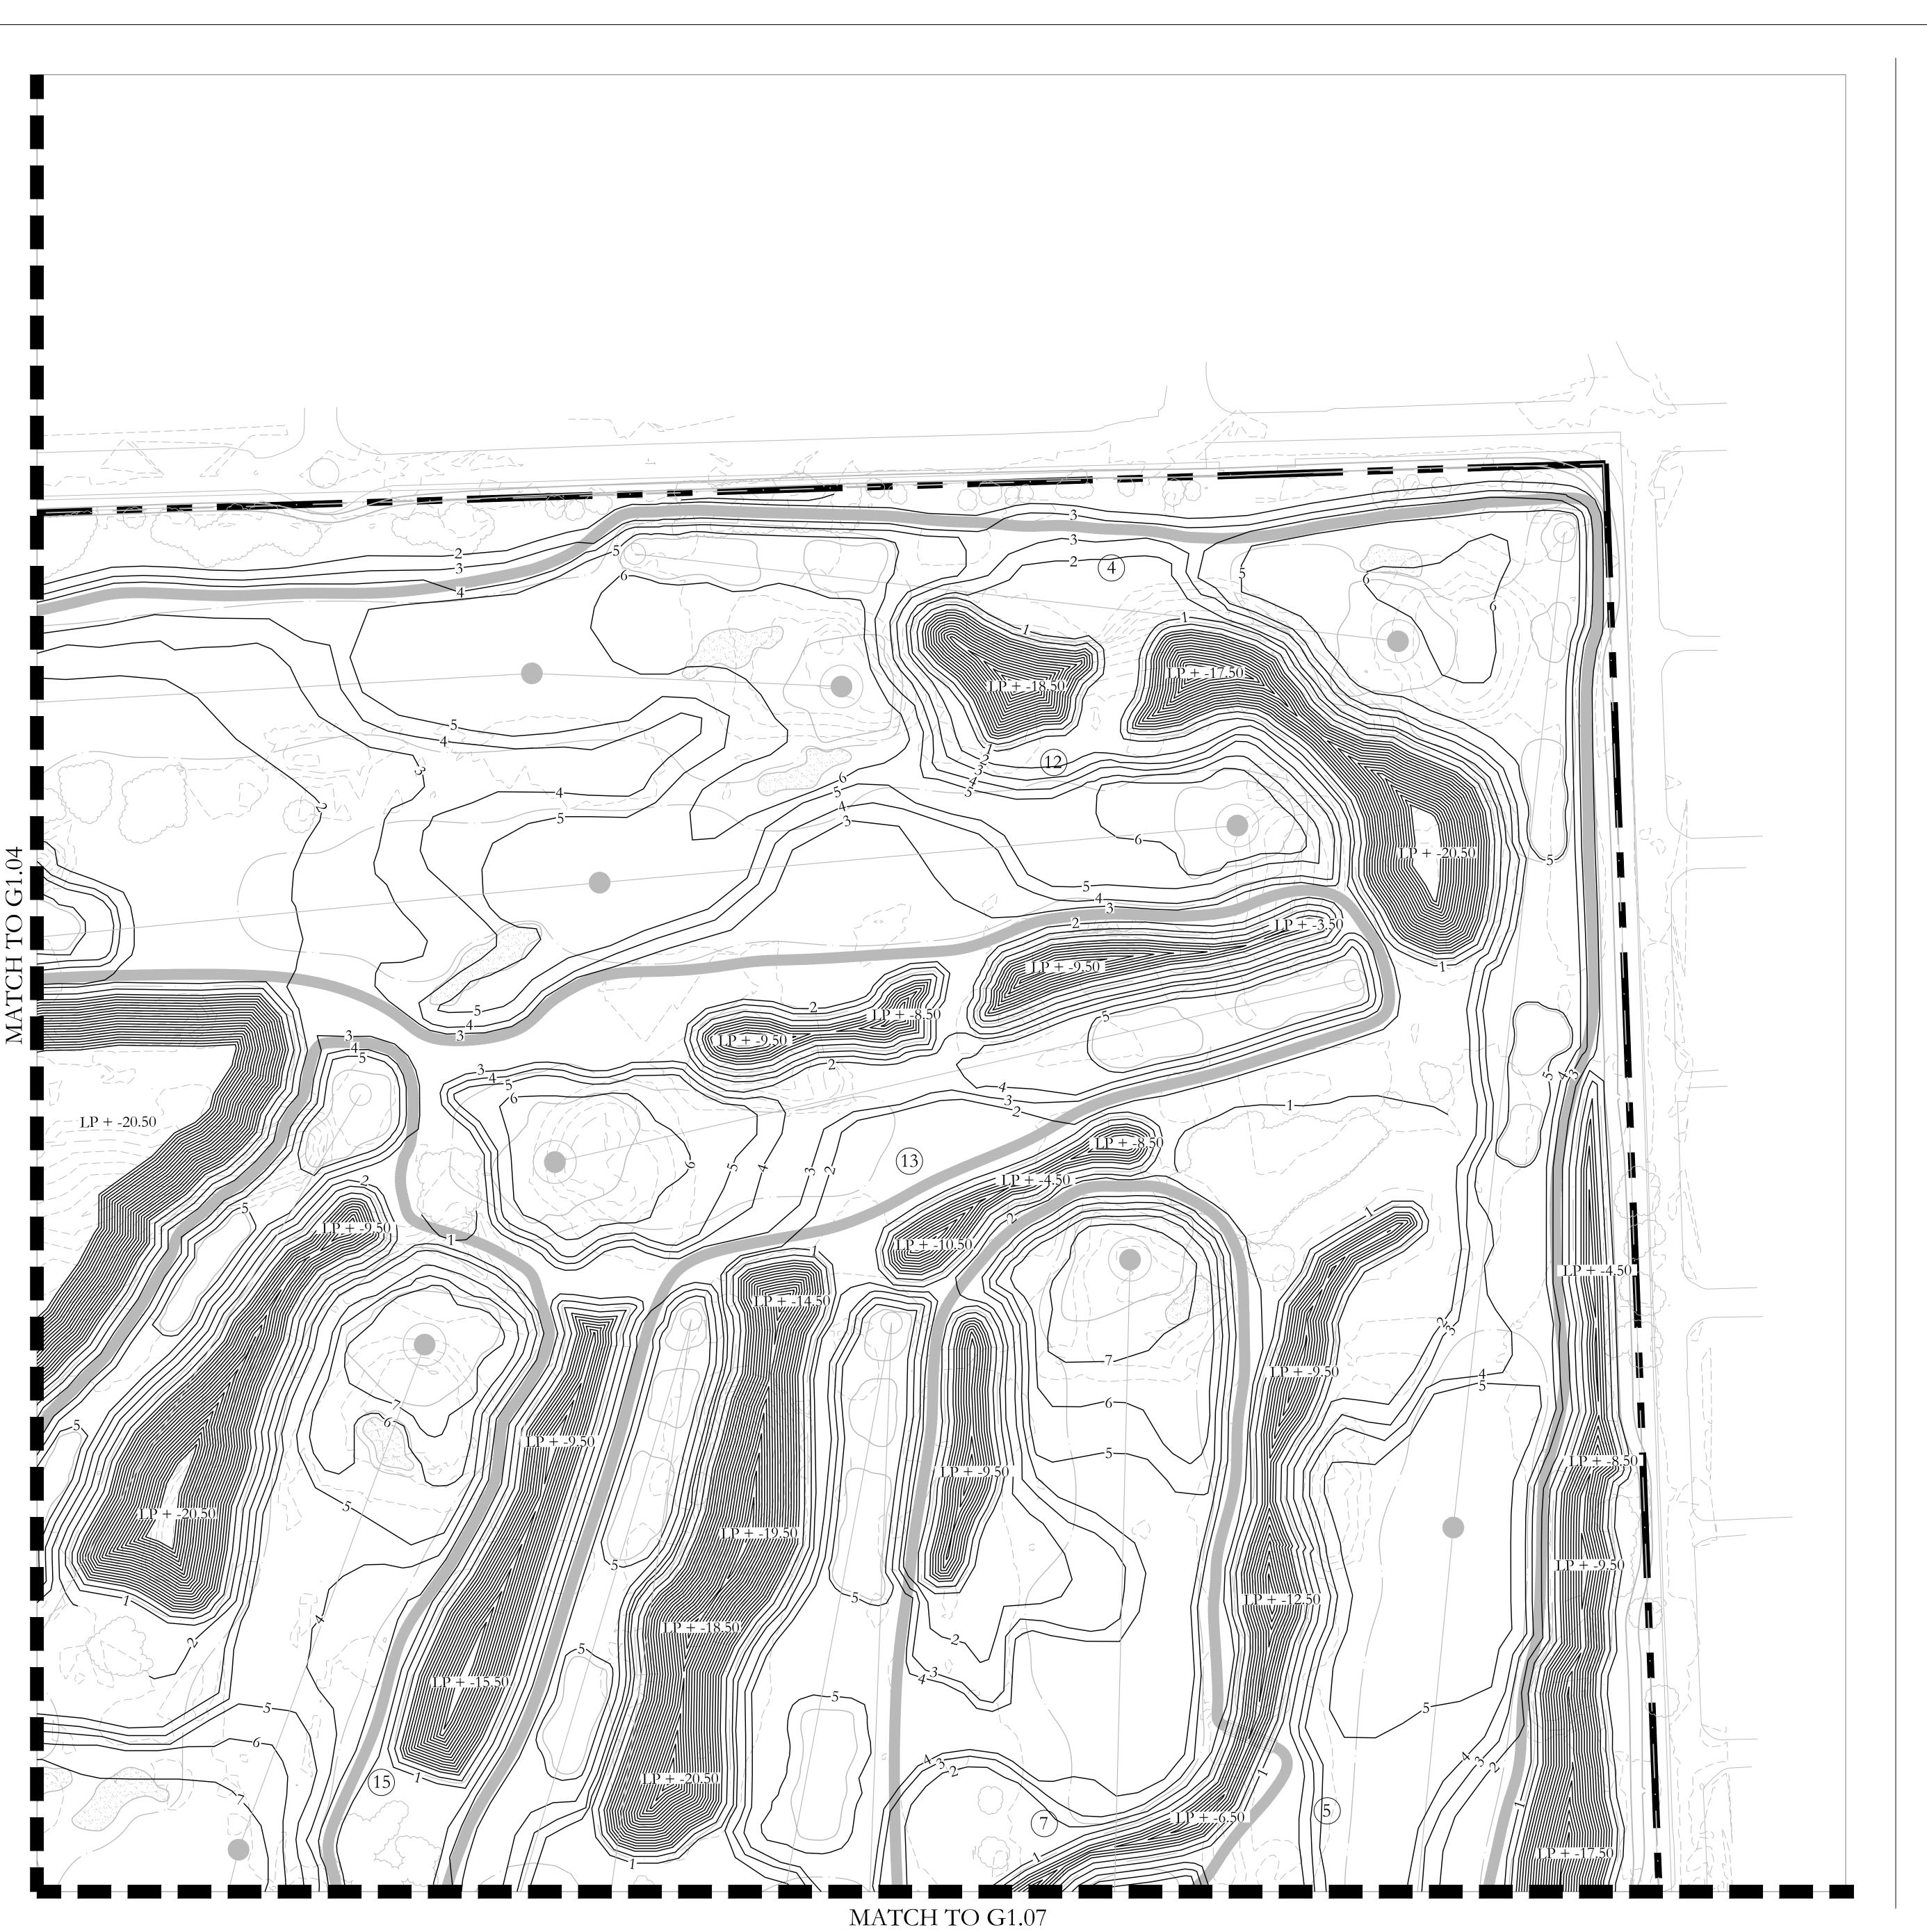
PROJECT NAME: HOLLYWOOD BEACH GOLF **COURSE AND CLUBHOUSE**

PROJECT ADDRESS: 1600 Johnson Street Hollywood, FL 33020 PROJECT NO.: 02141.000

SHEET NAME

DESIGN DEVELOPMENT GRADING PLAN

SHEET NO.

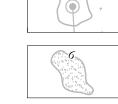


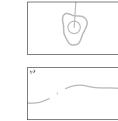
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AND ADJACENT LANDOWNERS OUTSIDE THE LIMITS OF DISTURBANCE.

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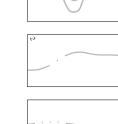
LEGEND





TEE

SAND BUNKER



FAIRWAY



WATER

TREE TO REMAIN

BRIDGE

CLIENT:



City of Hollywood

Design and Construction Management PO Box 229045

Hollywood, Florida 33022-9045 T: (954) 921-3410

GOLF COURSE & LANDSCAPE **ARCHITECTURE:**

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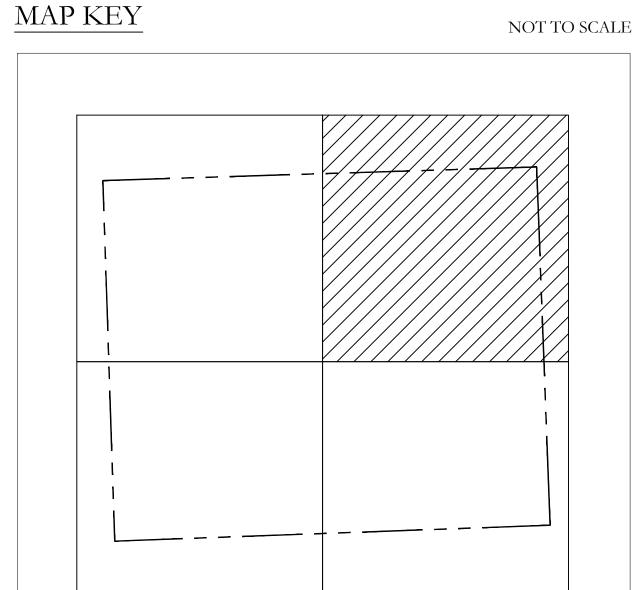
PROJECT NAME: HOLLYWOOD BEACH GOLF **COURSE AND CLUBHOUSE**

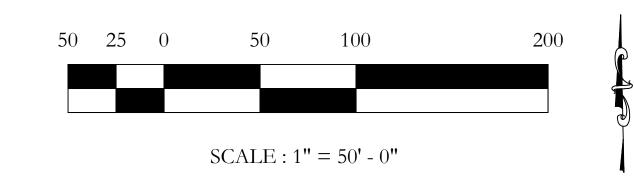
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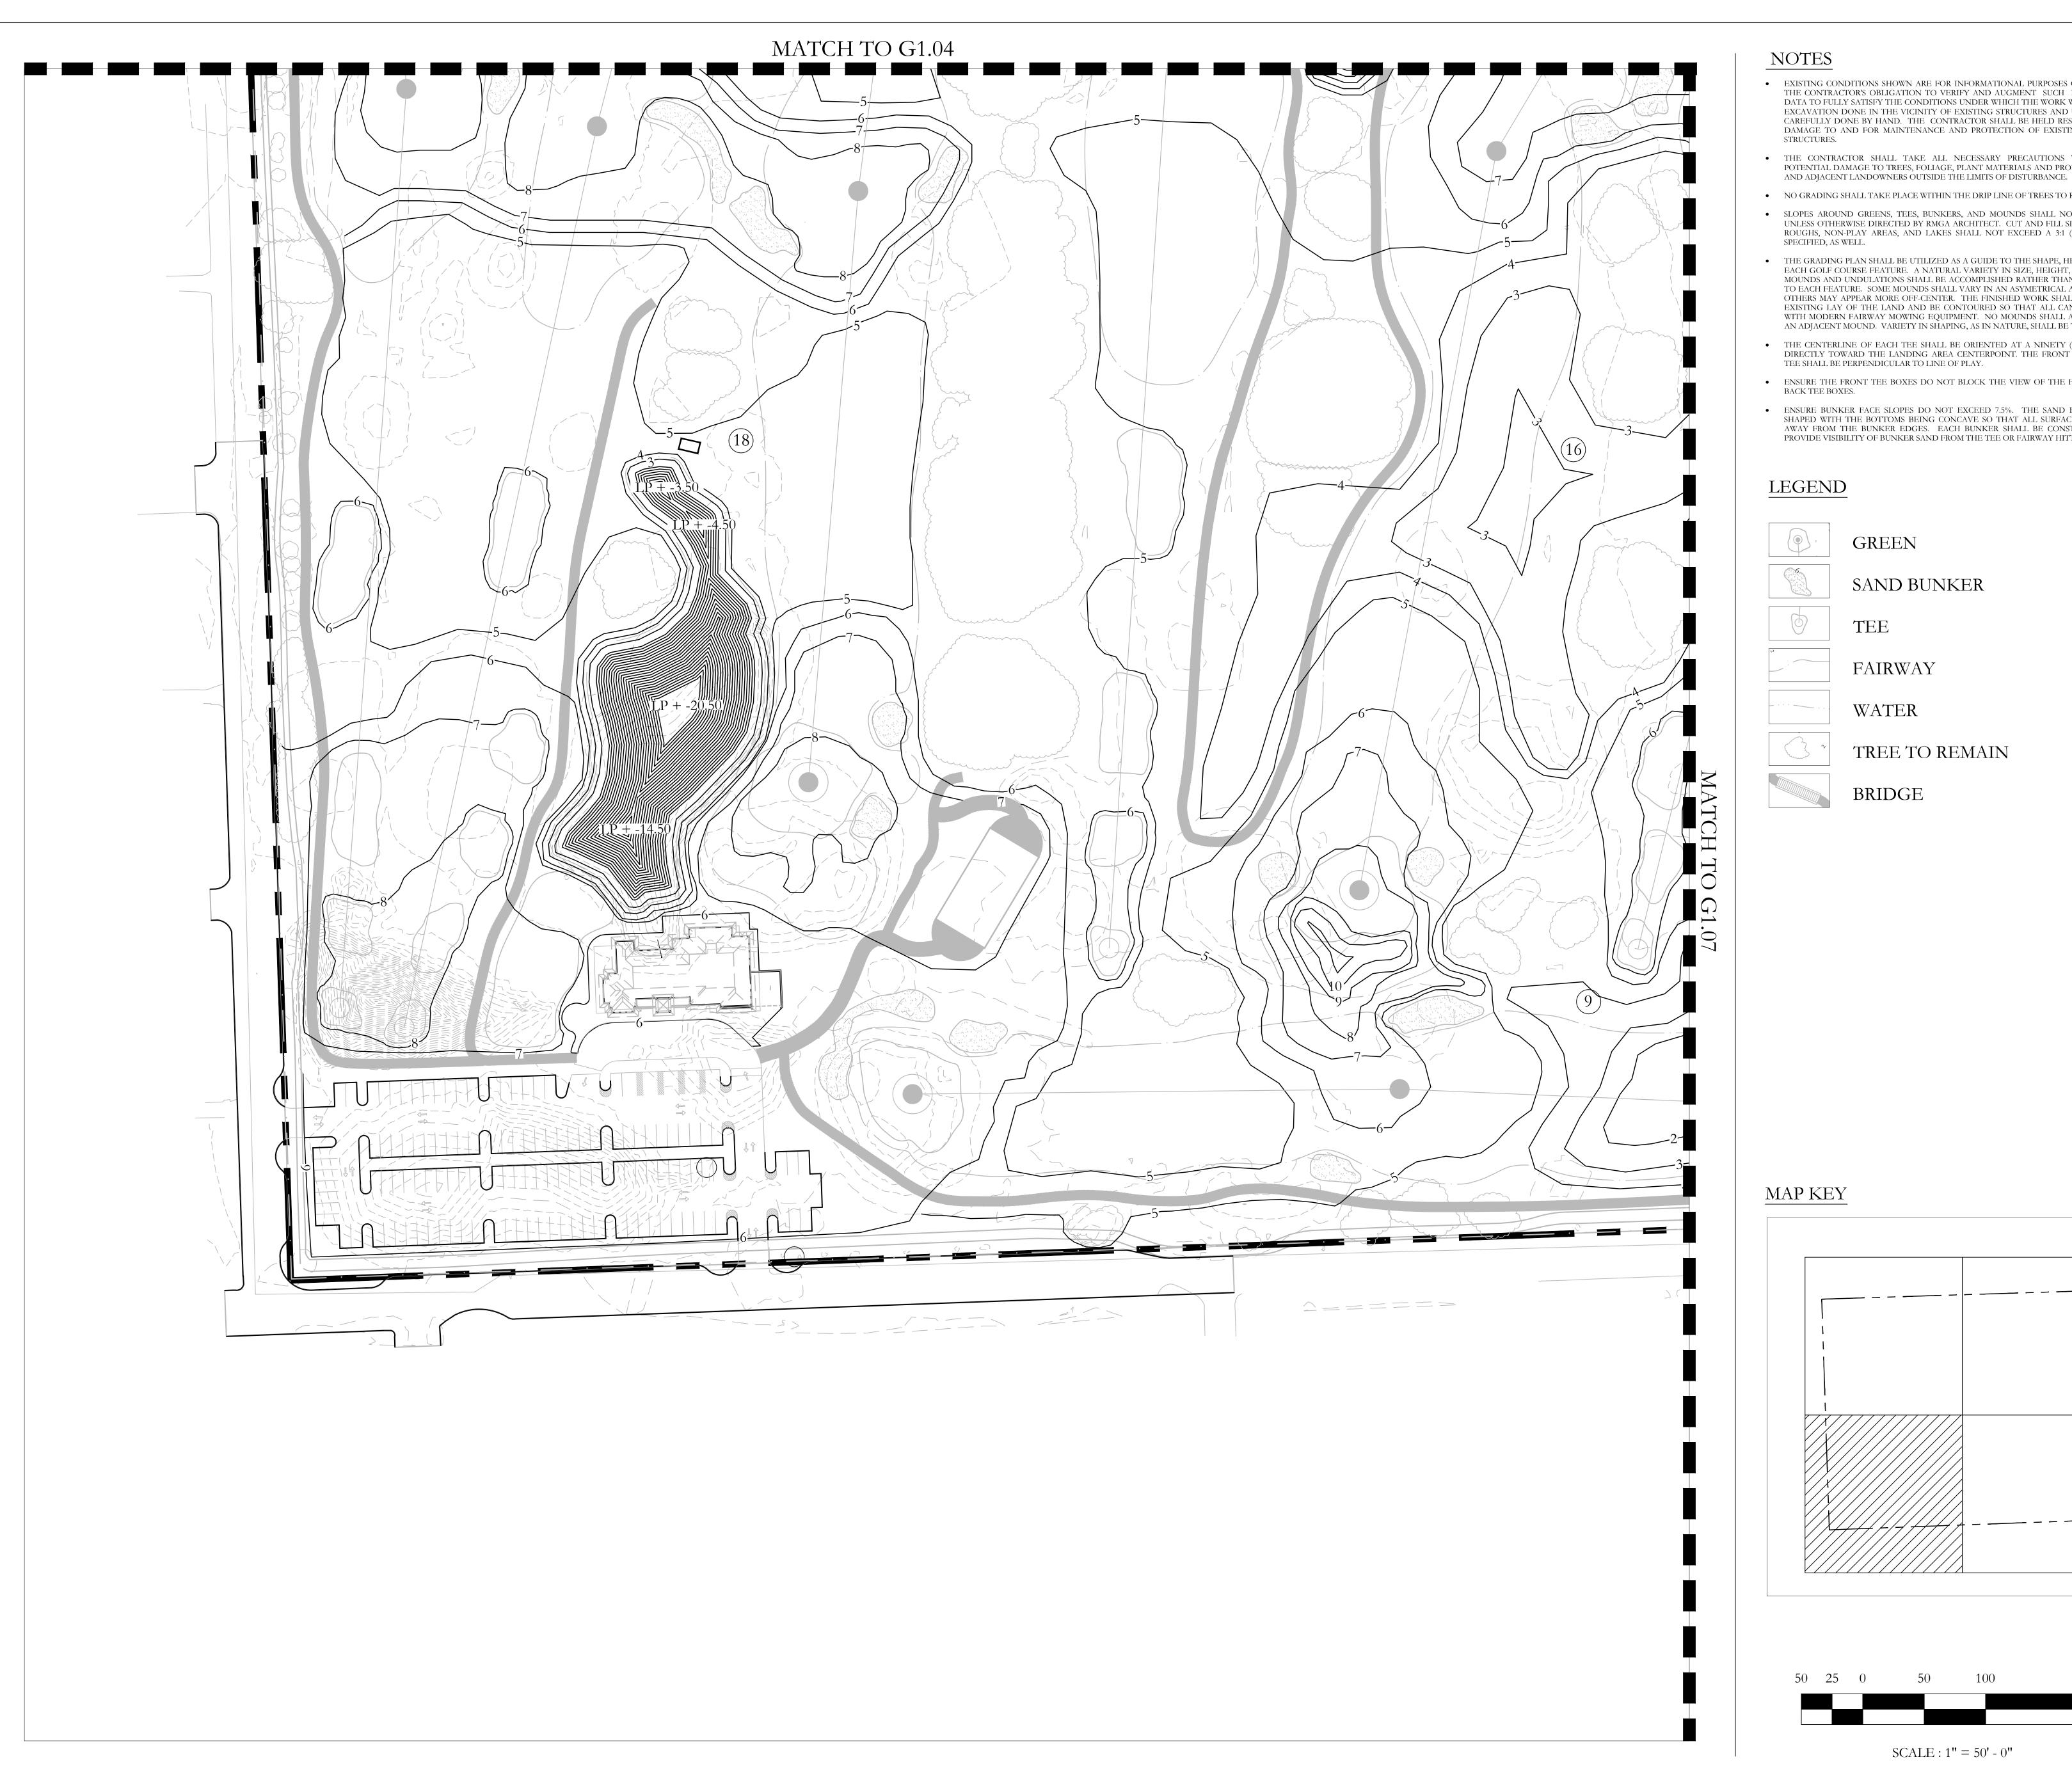
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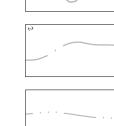


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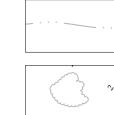
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TEE

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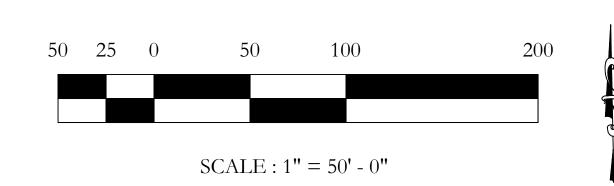
PROJECT NAME: HOLLYWOOD BEACH GOLF **COURSE AND CLUBHOUSE**

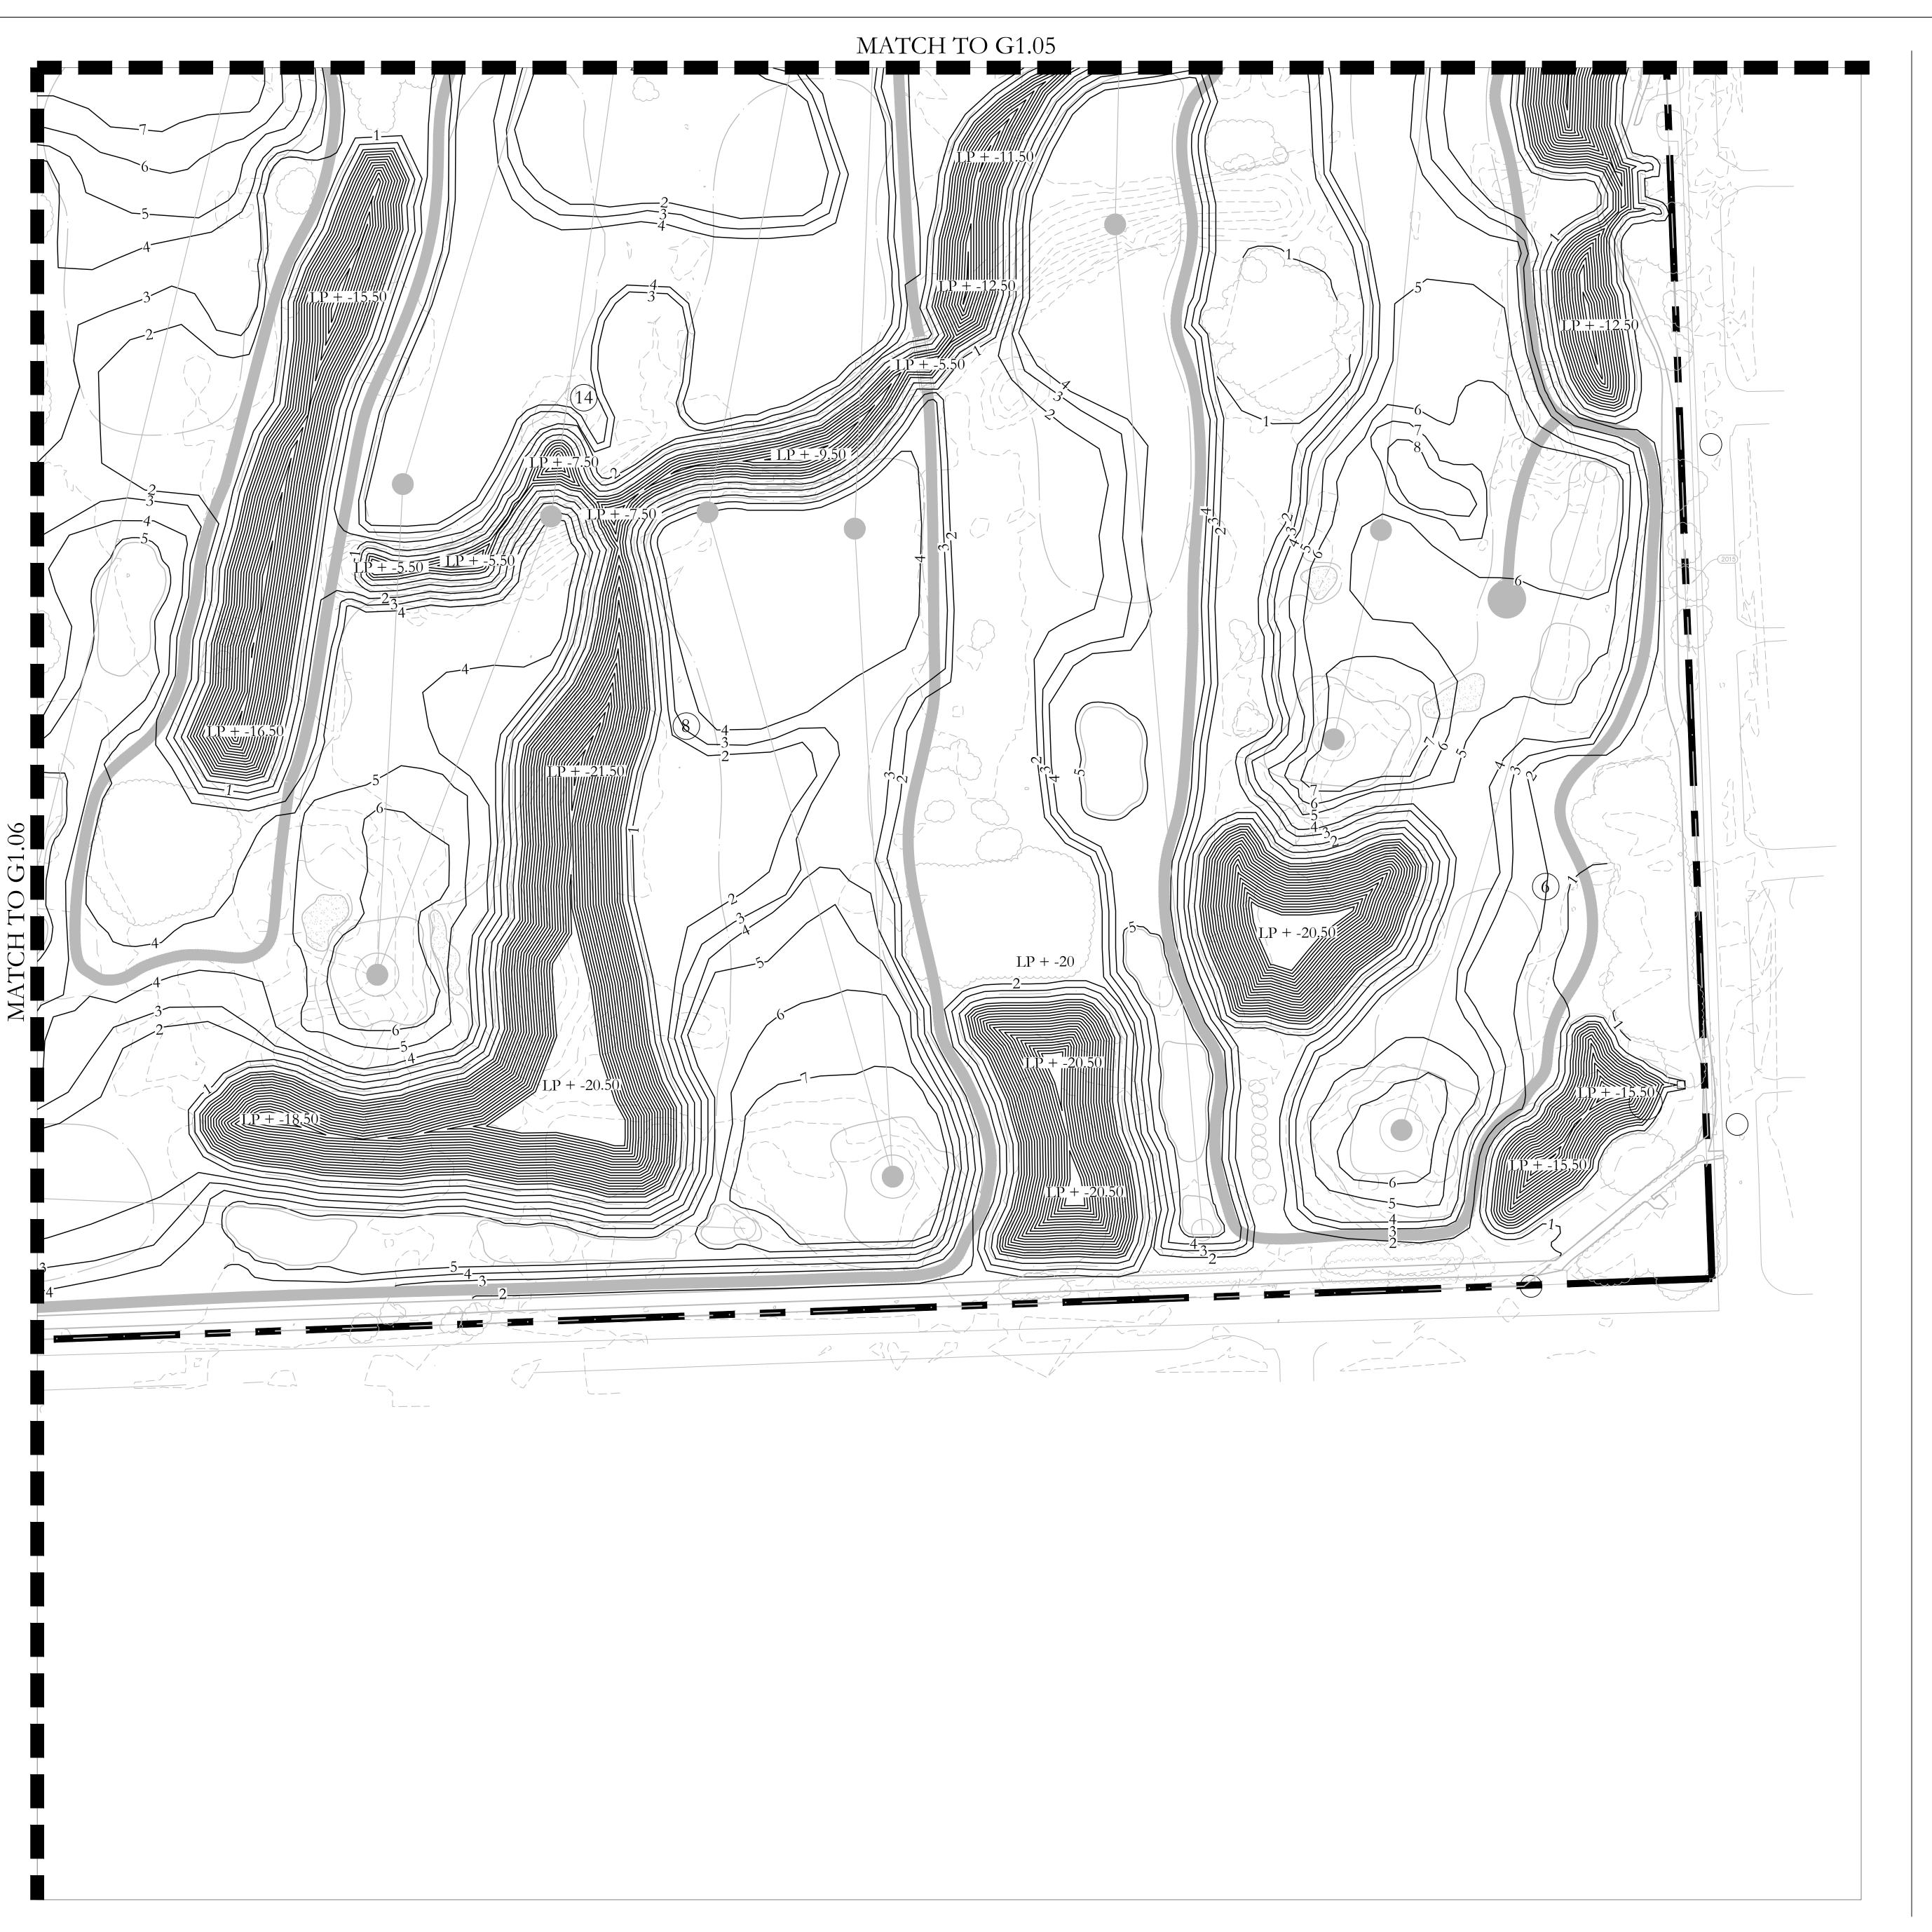
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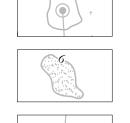


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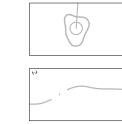
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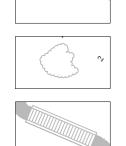
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NOTES

City of Hollywood

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DESIGN DEVELOPMENT

PLAN

GRADING

06.03.2022

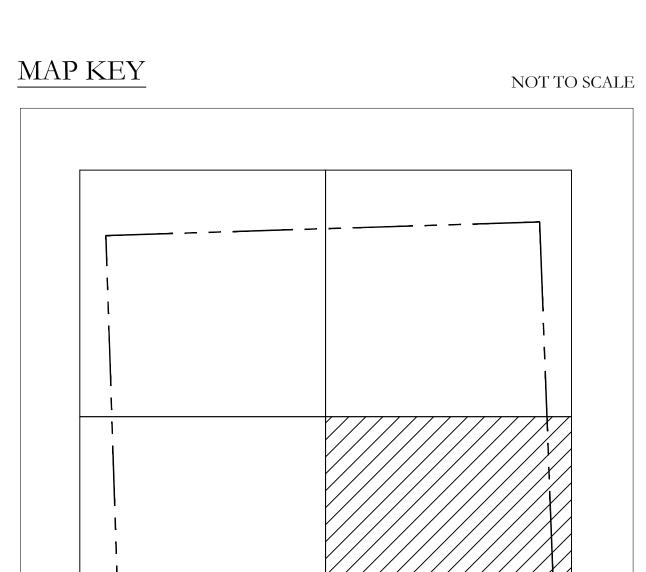
PROJECT NAME: HOLLYWOOD BEACH GOLF **COURSE AND CLUBHOUSE**

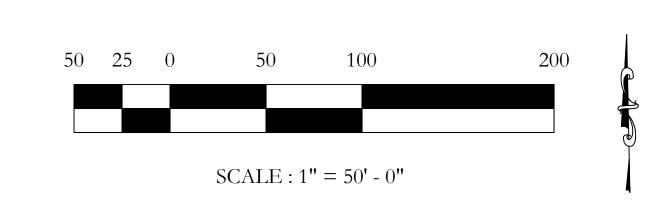
PROJECT ADDRESS: 1600 Johnson Street Hollywood, FL 33020 PROJECT NO.: 02141.000

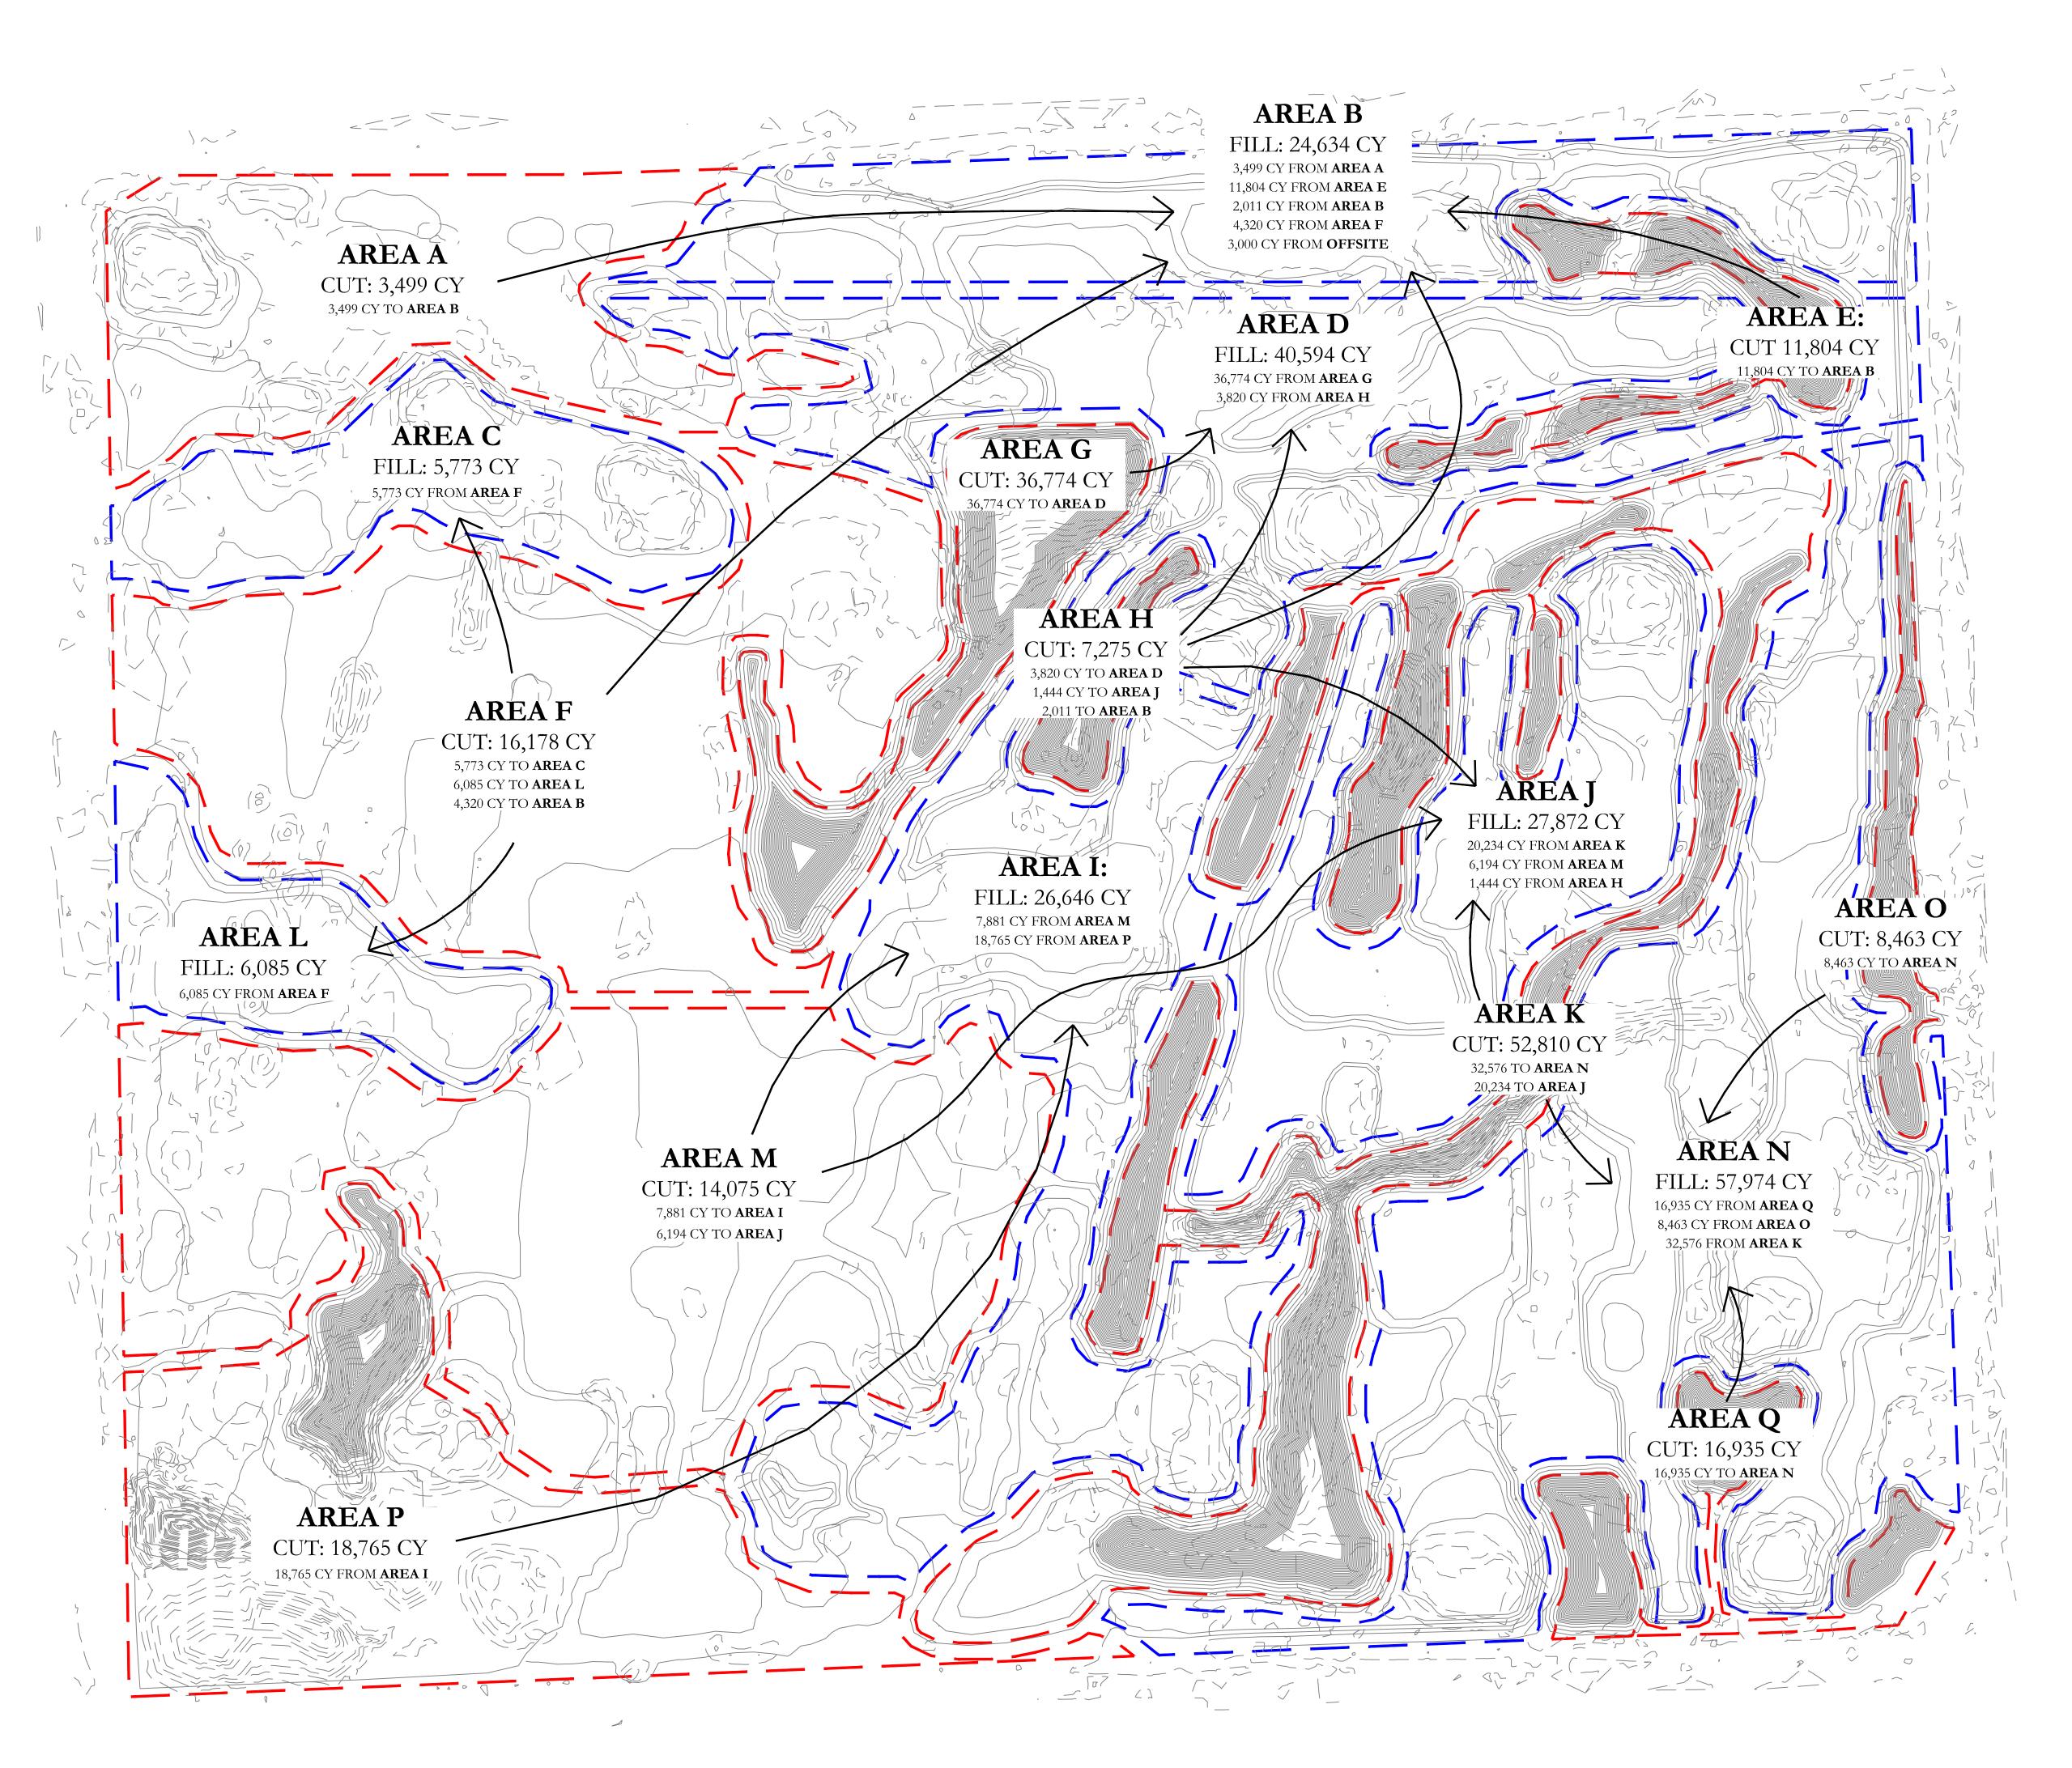
SHEET NAME

DESIGN DEVELOPMENT GRADING PLAN

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- THIS PLAN DESIGNATES AREAS OF CUT AND FILL FOR THE ENTIRE PROPERTY. AREAS OF GRADING SHOWN THAT ARE NOT WITHIN THE AREAS OF CUT AND FILL REQUIRE NO ADDED OR REMOVED MATERIAL TO ACHIEVE THE SPECIFIED
- ELEVATIONS AND SHAPING. • NO EXTRA MATERIAL SHALL BE BROUGHT FROM OFF-SITE, NOR SHALL ANY SURPLUS OF MATERIAL BE REMOVED FROM THE SITE.
- INITIAL BULK EARTH SHALL BE HAULED TO WITHIN FIFTEEN FEET(15') OF FINAL PLACEMENT AND ROUGH SHAPED TO WITHIN SIX INCHES (6") OF PROPOSED GRADE AS SPECIFIED ON APPROPRIATE GRADING PLANS. IN THE INITIAL GRADING OF ALL GOLF COURSE FEATURES (GREENS, TEES, BUNKERS, MOUNDS, ETC.) IT IS MORE APPROPRIATE TO EXAGGERATE THE ELEVATIONS OF THESE
- FILL SHALL BE PLACED IN SIX INCH (6") LIFTS AND COMPACTED WITH A TRACTOR TOLLER, OR SIMILAR EQUIPMENT, FILL MATERIAL SHALL CONTAIN NO STONES MORE THAN FOUR INCHES (4") IN DIAMETER. FILL SHALL BE COMPACTED TO NOT LESS THAN NINETY-FIVE PERCENT (95%) MAXIMUM DENSITY AS DETERMINED BY ASTM - 698. MOISTURE CONTENT SHALL BE ADJUSTED AS NEEDED FOR PROPER COMPACTION.

CUT/ FILL SUMMARY

Area	Net
AREA A	3,499 CY CUT
AREA B	24,634 CY FILL
AREA C	5,773 CY FILL
AREA D	40,594 CY FILL
AREA E	11,804 CY CUT
AREA F	16,178 CY CUT
AREA G	36,774 CY CUT
AREA H	7,275 CY CUT
AREA I	26,646 CY FILL
AREA J	27,872 CY FILL
AREA K	52,810 CY CUT
AREA L	6,085 CY FILL
AREA M	14,075 CY CUT
AREA N	57,974 CY FILL
AREA O	8,463 CY CUT
AREA P	18,765 CY CUT
AREA Q	16,935 CY CUT
TOTAL:	186,578 CY CUT
	189,578 CY FILL

*NOTE:

3,000 CY TO BE BROUGHT TO

CLIENT:



City of Hollywood

- Design and Construction Management PO Box 229045
- Hollywood, Florida 33022-9045 T: (954) 921-3410

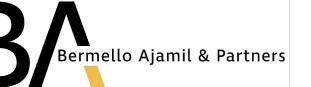
GOLF COURSE & LANDSCAPE ARCHITECTURE:

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DESIGN DEVELOPMENT CUT & FILL PLAN

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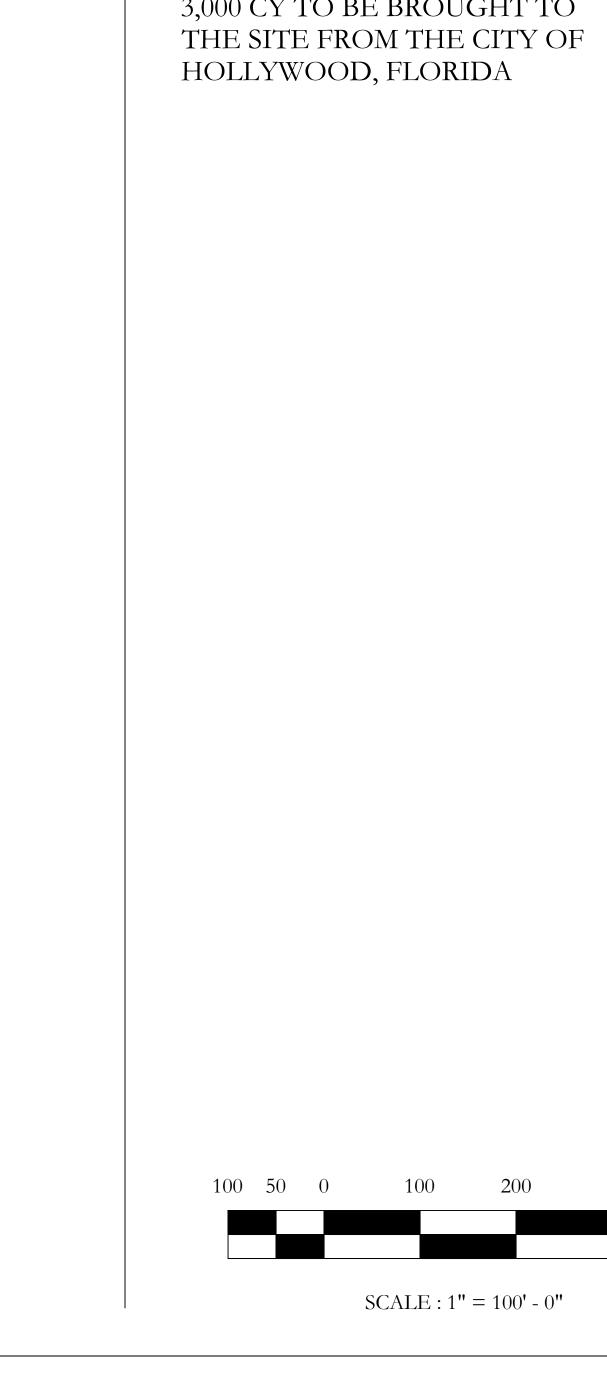
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DESIGN DEVELOPMENT CUT & FILL PLAN

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400



50 0 100 200 400 SCALE: 1" = 100' - 0"

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camacho

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DESIGN
DEVELOPMENT
SOIL REMEDIATION
PLAN

06.03.2022

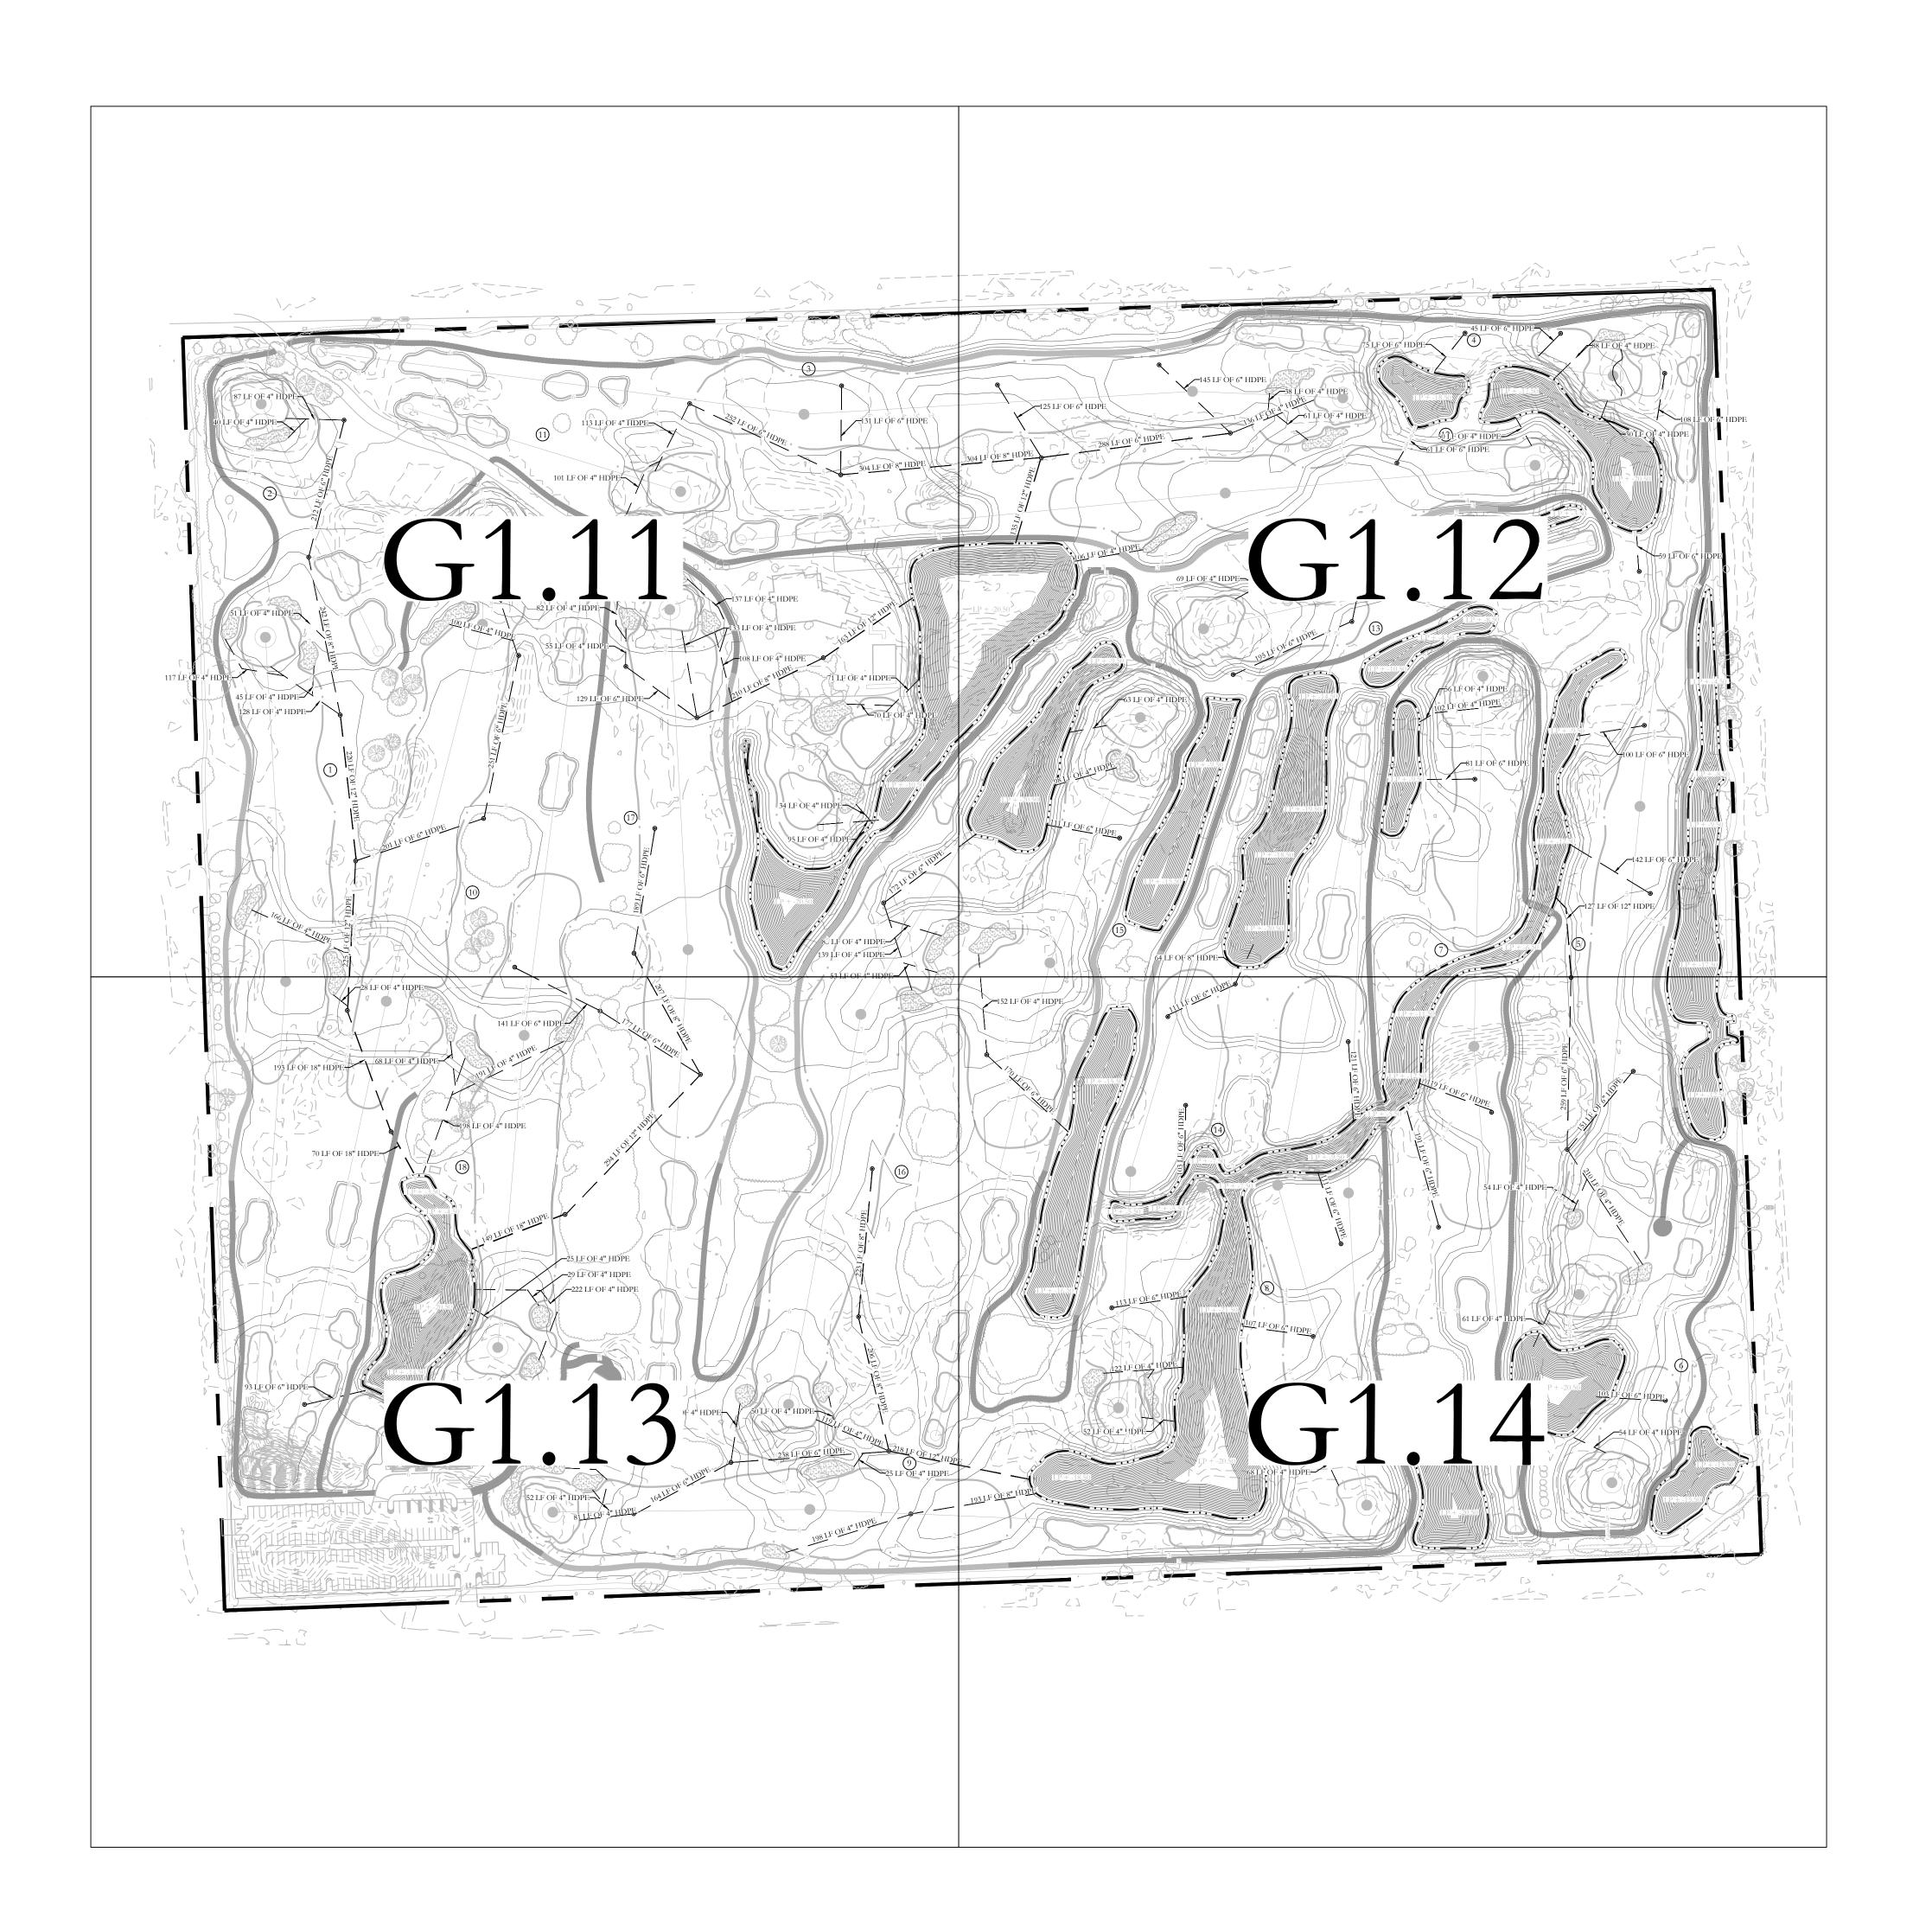
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- ALL PIPE AND DRAINAGE STRUCTURES SHALL BE INSTALLED, PROPERLY BEDDED, COUPLED AND BACKFILLED IN ACCORDANCE WITH THE GRADING PLANS AS WELL AS THE OVERALL DRAINAGE PLAN WITHIN THE CONSTRUCTION DOCUMENTS. THEIR EXACT LOCATION, LENGTH, AND SIZE REQUIREMENTS SHALL BE ADJUSTED PER EXISTING SITE CONDITIONS AND APPROVED BY THE RMGA ARCHITECT.
- THE INVERTS OF SWALES SHALL BE GRADED TO A SMOOTH AND UNIFORM GRADE IN ORDER TO PROVIDE A CONSTANT FLOW OF DRAINAGE WITH A MINIMUM SLOPE OF TWO PERCENT (2%). SIDE SLOPES SHALL BE BLENDED INTO EXISTING CONTOURS TO ALLOW FOR PROPER MOWING OPERATIONS WITH NO SCALPING AND ENSURING ALL RIDGES AND DEPRESSIONS ARE PROPERLY MOWED. MATERIAL EXCAVATED FROM SWALES SHALL BE USED AS FILL IN ADJACENT AREAS OR AS OTHERWISE DIRECTED BY THE RMGA ARCHITECT.
- EXCAVATION OF EVERY DESCRIPTION, REGARDLESS OF MATERIAL ENCOUNTERED WITHIN THE GRADING LIMITS OF THE PROJECT SHALL BE PERFORMED TO THE LINES AND GRADES INDICATED AND, IN GENERAL, SHALL BE KEPT WITHIN TWO (2) FEET OF THE NEAT LINES FOR STRUCTURES. EXCESS MATERIAL FROM THE EXCAVATION NOT REQUIRED FOR FILL OR BACKFILL SHALL BE WASTED ON THE SITE AT LOCATIONS INDICATED BY THE ARCHITECT, AND SHALL BE SPREAD AND LEVELED OR GRADED AS DIRECTED WITHOUT CREATING ADDITIONAL DRAINAGE DIFFICULTIES.
- EXCAVATION AND BACKFILLING SHALL BE PERFORMED IN A MANNER AND SEQUENCE THAT WILL PROVIDE DRAINAGE AT ALL TIMES. GRADING SHALL BE DONE AS NECESSARY TO PREVENT SURFACE WATER FROM FLOWING INTO TRENCHES OR OTHER EXCAVATION, AND ANY WATER ACCUMULATING HEREIN SHALL BE REMOVED BY PUMPING OR BY OTHER REPRIEVED METHODS. SHEETING AND SHORING SHALL BE DONE AS NECESSARY TO PREVENT SURFACE WATER FROM FLOWING INTO TRENCHES OR OTHER EXCAVATIONS, AND ANY WATER ACCUMULATING THEREIN SHALL BE REMOVED BY PUMPING OR BY OTHER APPROVED METHODS.
- TRENCH EXCAVATION TRENCH EXCAVATION SHALL BE BY OPEN CUT AND TRENCHES SHALL BE OF THE NECESSARY WIDTH FOR PROPER LAYING OF PIPE. ALL TRENCH CONSTRUCTION SHALL PROCEED UPHILL FROM THE LOWEST POINT OF THE TRENCH. THE BANKS OF THE TRENCHES SHALL BE AS NEARLY VERTICAL AS PRACTICAL. CARE SHALL BE TAKEN NOT TO OVER-EXCAVATE. NO GREATER LENGTH OF TRENCH IN ANY LOCATION SHALL BE LEFT OPEN, IN ADVANCE OF THE COMPLETED WORK, THAN SHALL BE AUTHORIZED OR DIRECTED. DURING EXCAVATION, MATERIALS SUITABLE FOR BACKFILLING SHALL BE PILED IN AN ORDERLY MANNER SUFFICIENT DISTANCE FROM THE BANKS OF THE TRENCH TO AVOID OVERLOADING.
- IN THE EVENT THE CONTRACTOR ENCOUNTERS MATERIAL BENEATH THE GROUND SURFACE WHICH PROHIBITS THE PROPER INSTALLATION OF THE WORK AS SPECIFIED, HE SHALL IMMEDIATELY NOTIFY THE CITY AND RMGA ARCHITECT TO DETERMINE THE BEST REMEDY FOR SUCH OCCURRENCE.

LEGEND

DRAINAGE PIPE SIZE VARRIES

DROP INLET



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CIVIL ENGINEER:



Miller-Legg 5747 Andrews Way Fort Lauderdale, FL 33309

T: (954) 436-7000

FOOD & BEVERAGE:

Camacho 3103 Medlock Bridge road Norcross, Georgia 30071 T: (770) 582-1144

DESIGN DEVELOPMENT OVERALL DRAINAGE PLAN

06.03.2022

PROJECT NAME:

HOLLYWOOD BEACH GOLF **COURSE AND CLUBHOUSE**

PROJECT ADDRESS: 1600 Johnson Street Hollywood, FL 33020 PROJECT NO.: 02141.000

SHEET NAME

DESIGN DEVELOPMENT OVERALL DRAINAGE PLAN

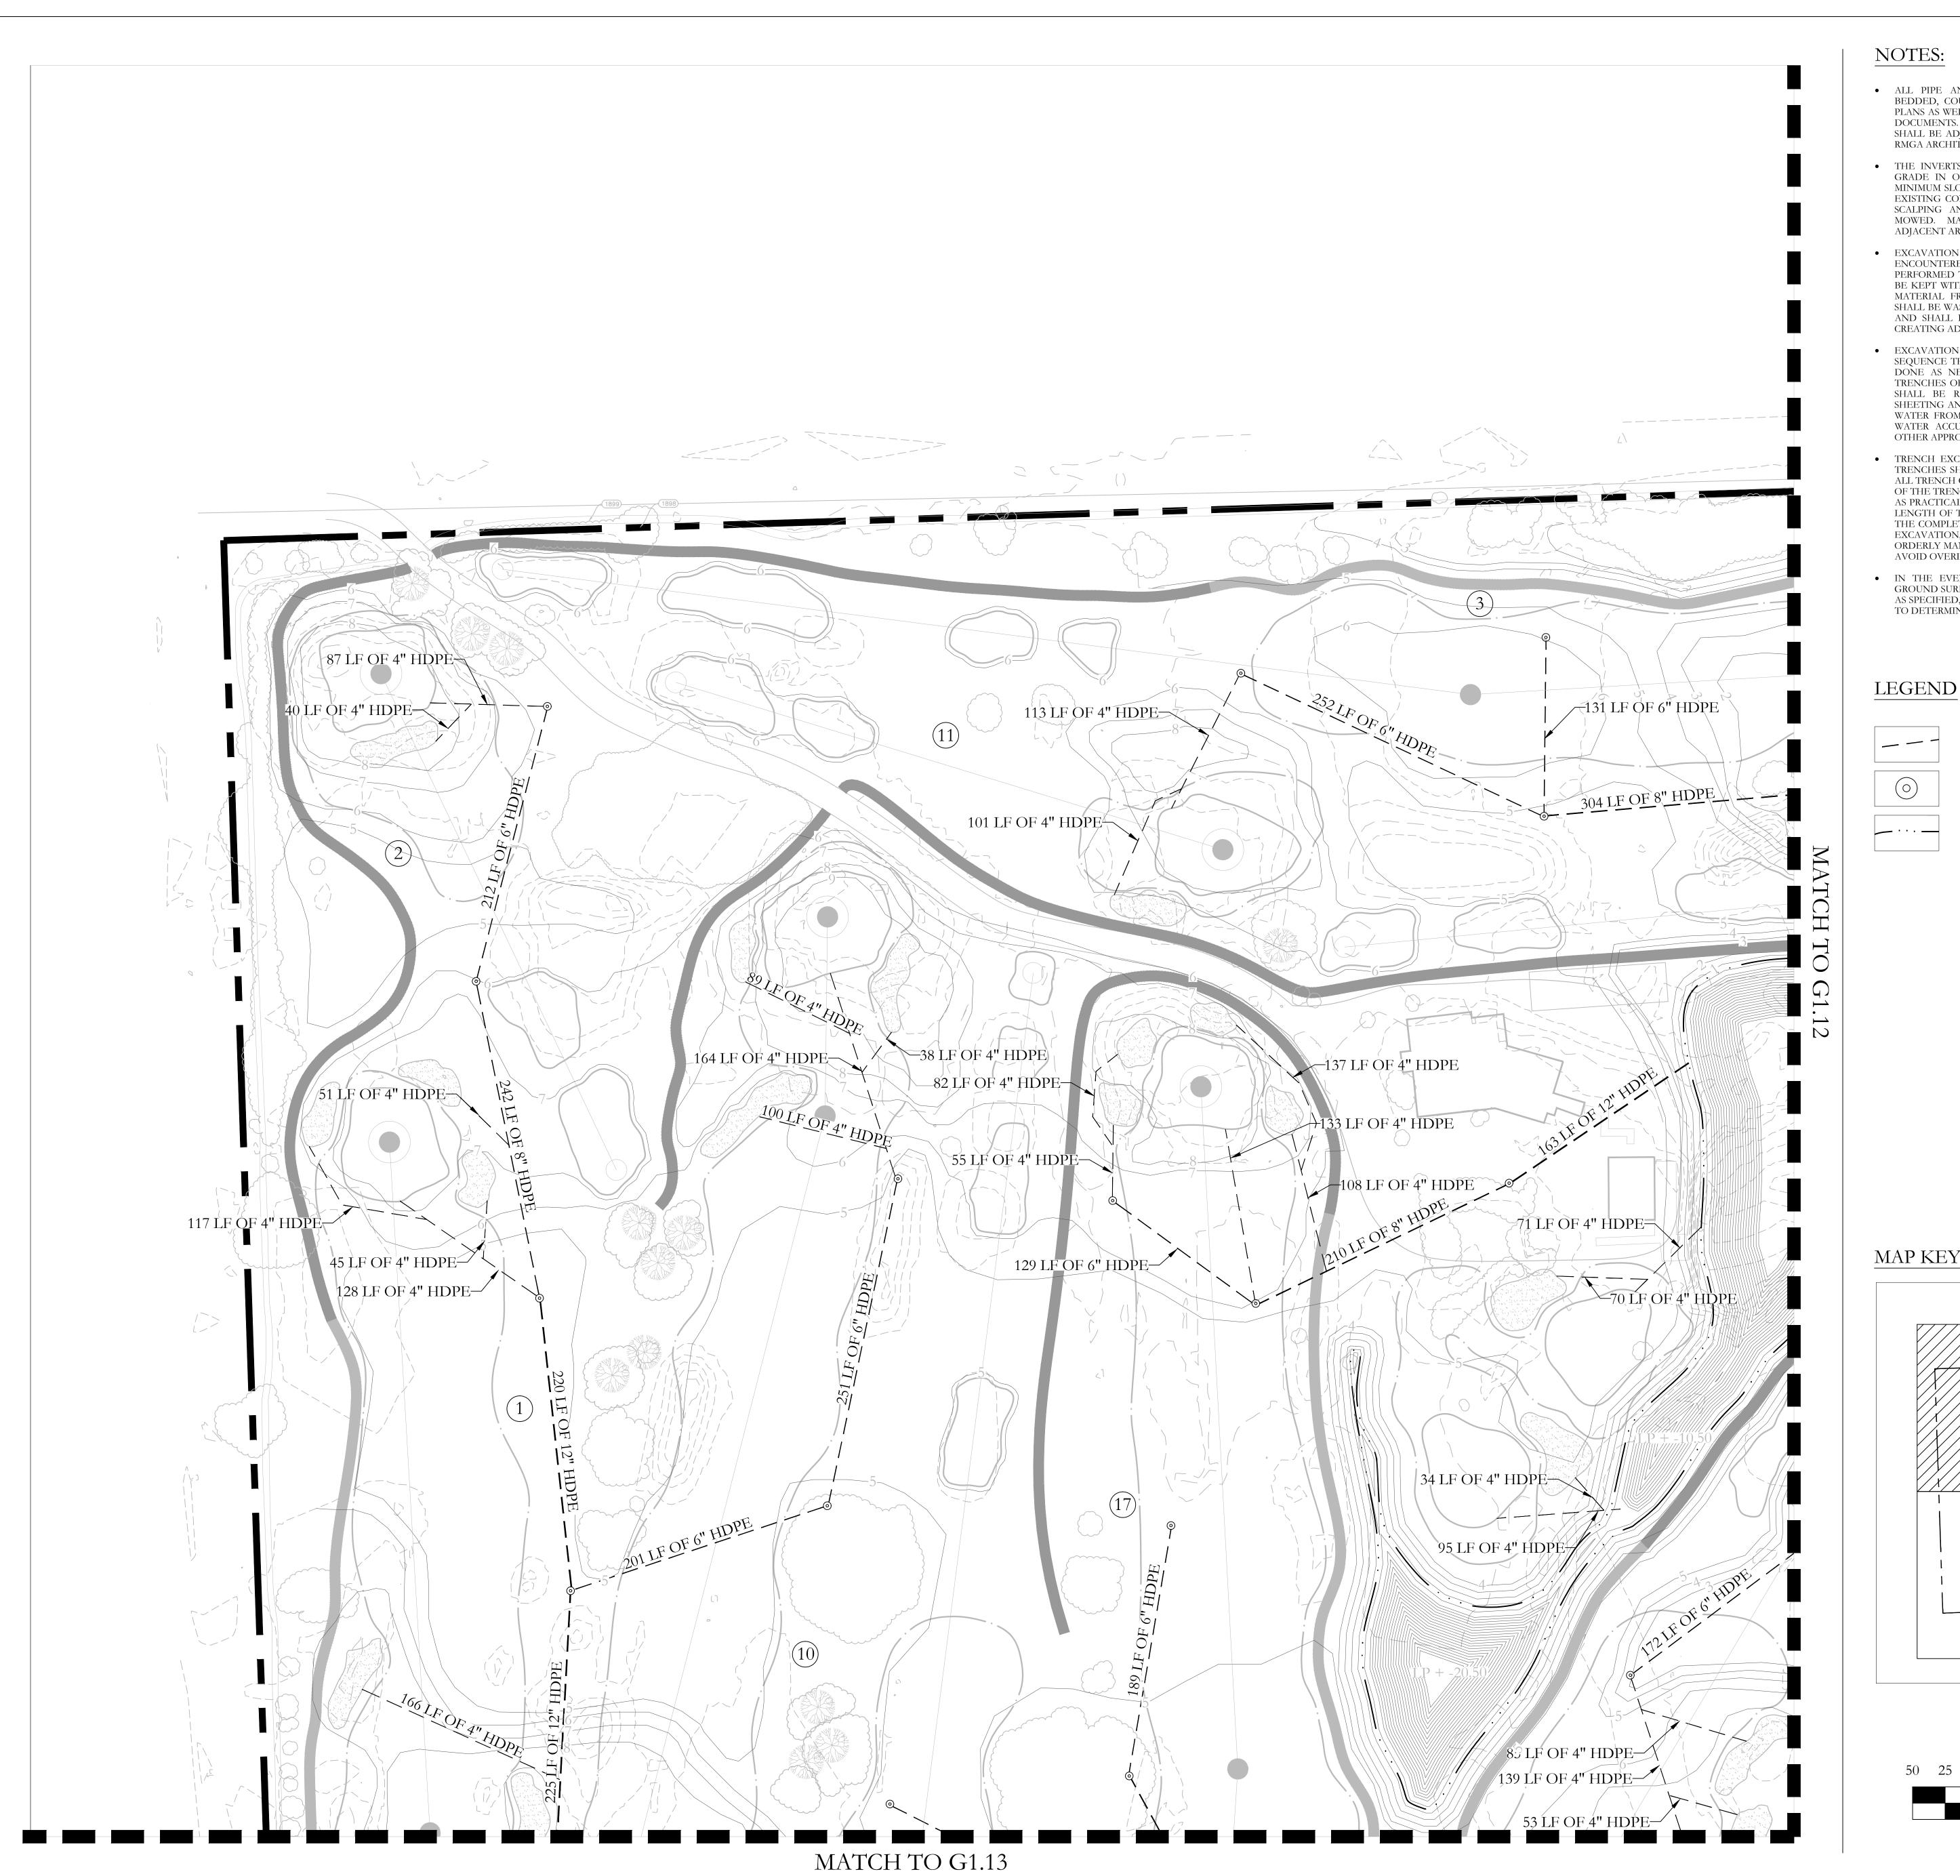
SHEET NO.

G1.10

MAP KEY

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LEGEND

DRAINAGE PIPE SIZE VARRIES DROP INLET WATER

CLIENT:



City of Hollywood

Design and Construction Management PO Box 229045

Hollywood, Florida 33022-9045 T: (954) 921-3410

GOLF COURSE & LANDSCAPE **ARCHITECTURE:**

Richard Mandell Golf Architecture 2208 Midland Road

Pinehurst, North Carolina 28374

T: (910) 255-3111

ARCHITECTURE & INTERIOR DESIGN:

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Bermello Ajamil & Partners, Inc.

Architecture Engineering Planning Interior Design Landscape Architecture 2601 South Bayshore Drive, 10th Floor Miami, Florida 33133

MEP ENGINEERING:

T: (305) 859-2050 F: (305) 860-3700

DELTA G CONSULTING ENGINEERS, INC.

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707 NE 3rd Ave. Suite. 200 Fort Lauderdale, FL 33304 T: (954) 527-1112

STRUCTURAL ENGINEERING:

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FOOD & BEVERAGE:

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NOT TO SCALE

200

100

SCALE: 1'' = 50' - 0''

50 25 0

DESIGN DEVELOPMENT DRAINAGE

06.03.2022

PLAN

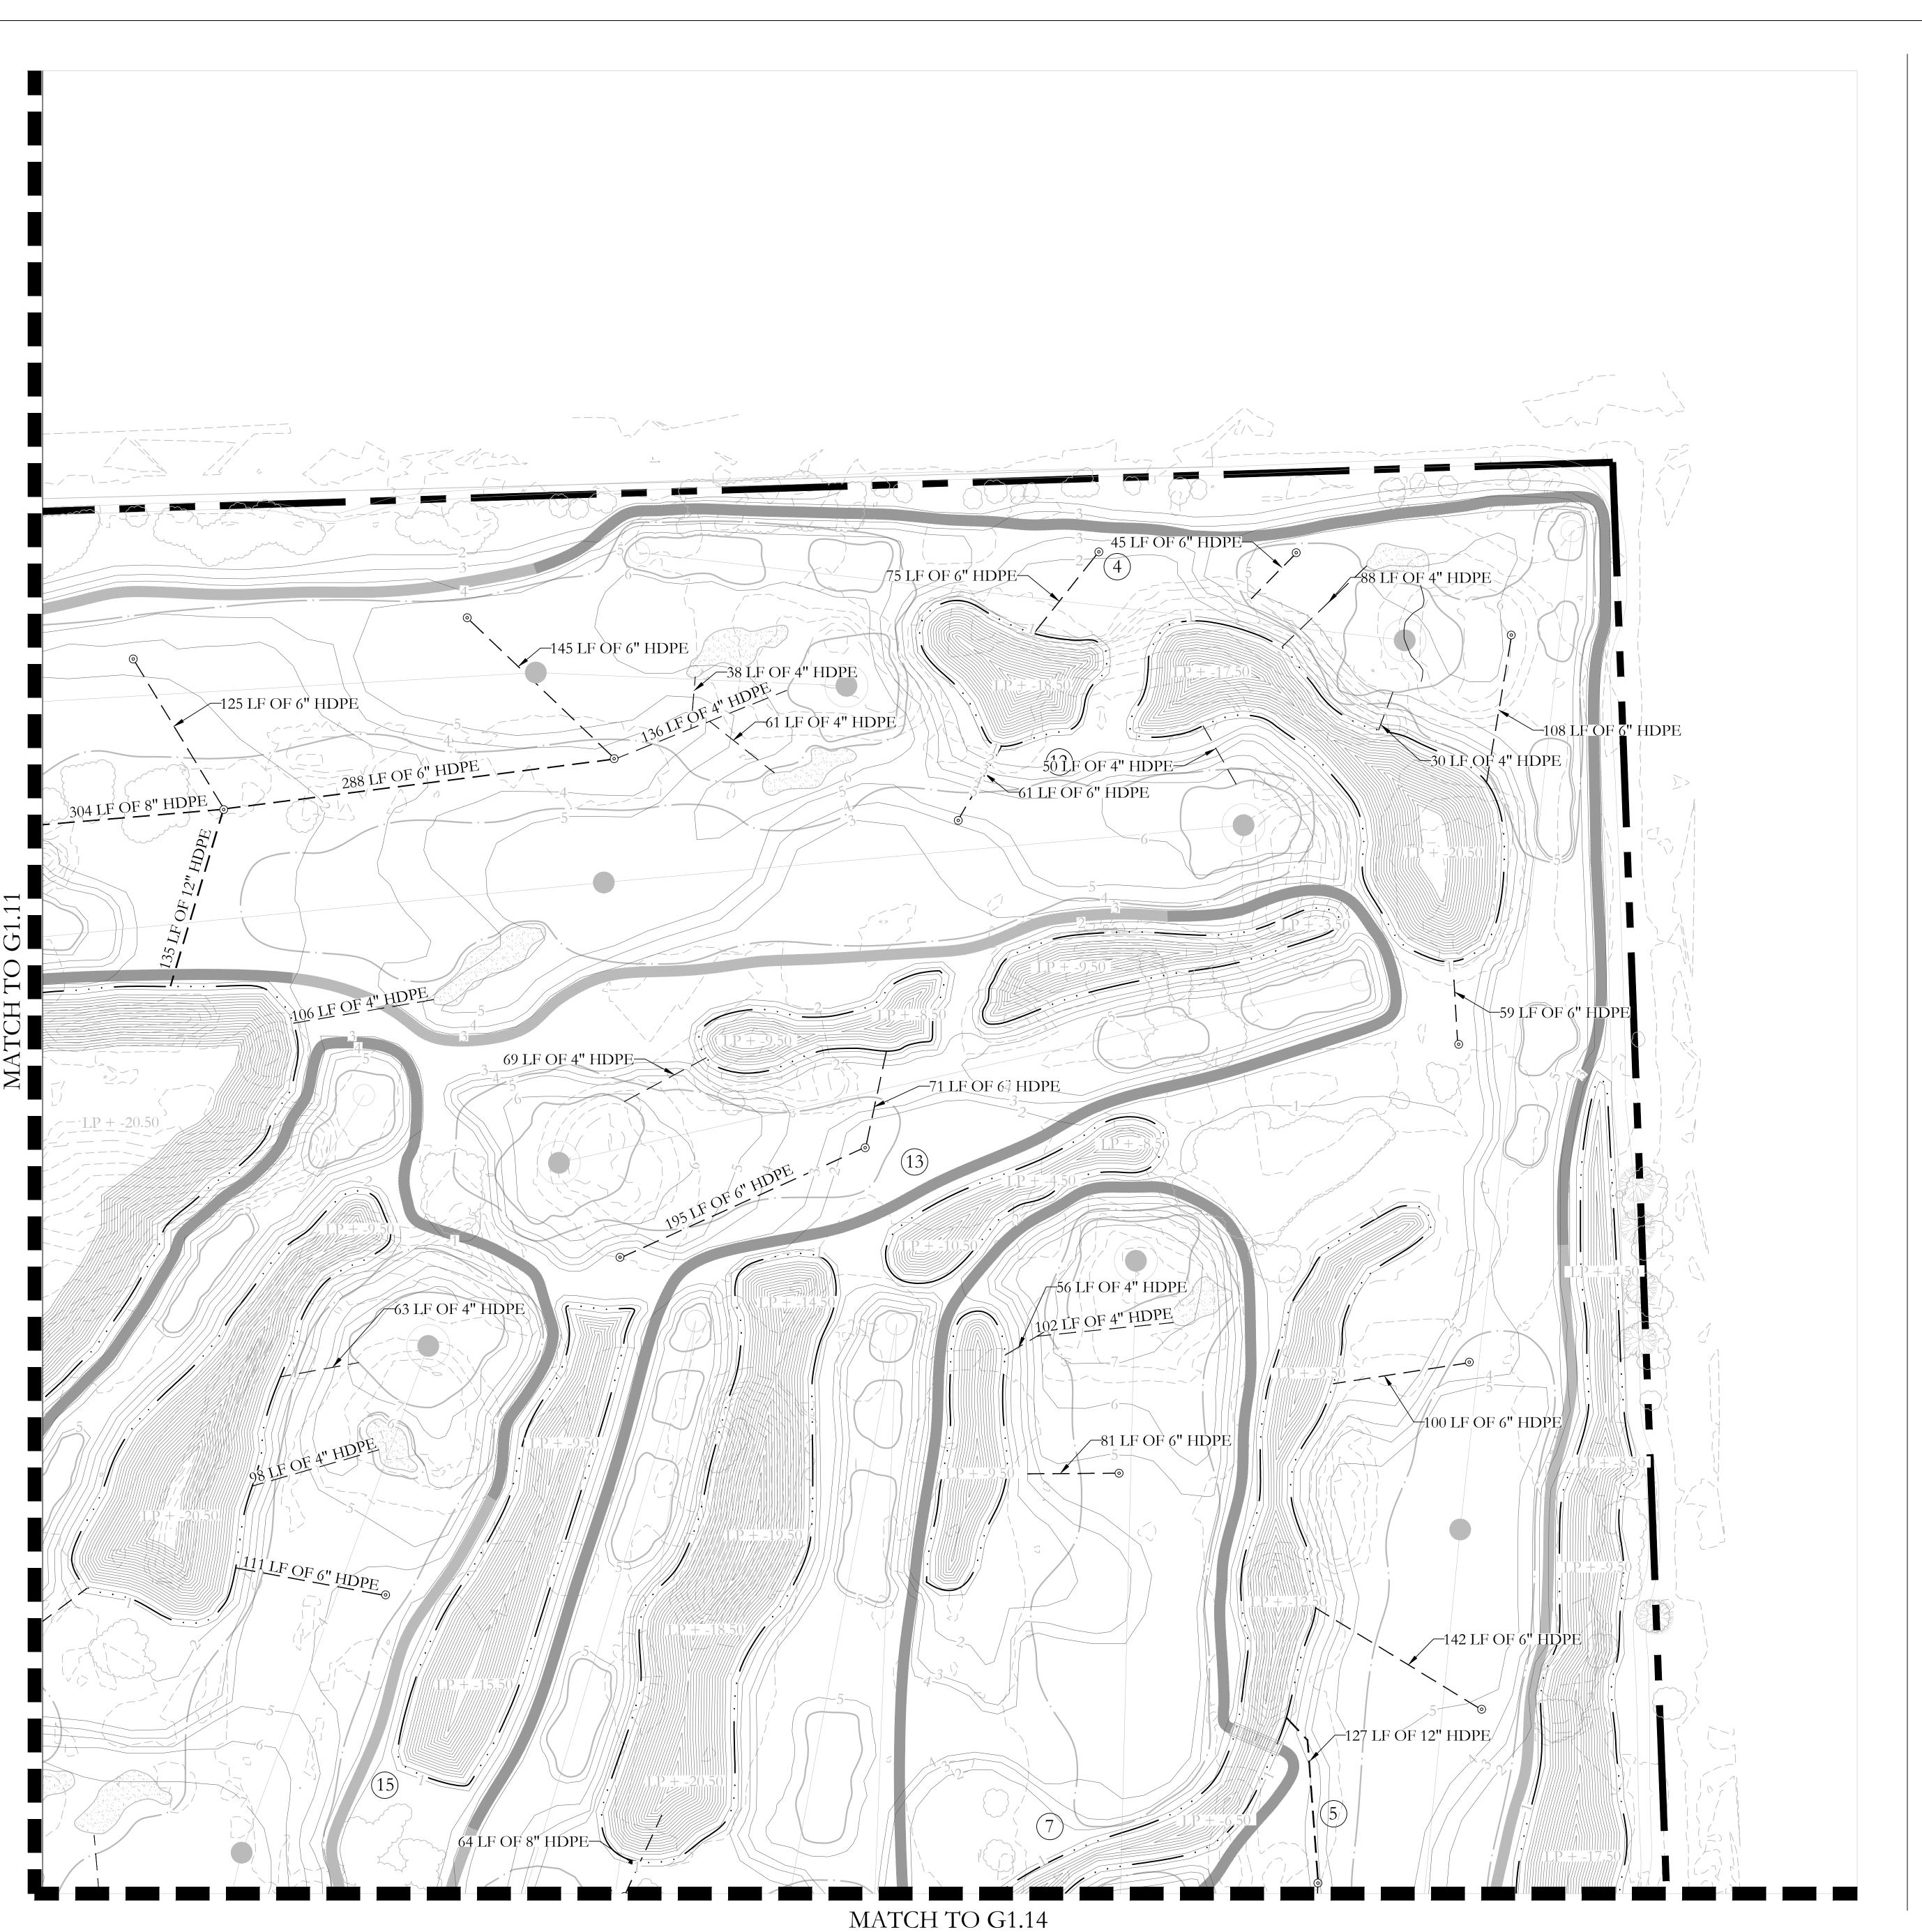
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PROJECT ADDRESS: 1600 Johnson Street Hollywood, FL 33020 PROJECT NO.: 02141.000

SHEET NAME

DESIGN DEVELOPMENT DRAINAGE PLAN

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LEGEND

MAP KEY

50 25 0

SCALE: 1'' = 50' - 0''

DRAINAGE PIPE SIZE VARRIES

DROP INLET

CLIENT:



City of Hollywood

Design and Construction Management PO Box 229045

Hollywood, Florida 33022-9045 T: (954) 921-3410

GOLF COURSE & LANDSCAPE

ARCHITECTURE:

Richard Mandell Golf Architecture

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DESIGN DEVELOPMENT DRAINAGE

PLAN

06.03.2022

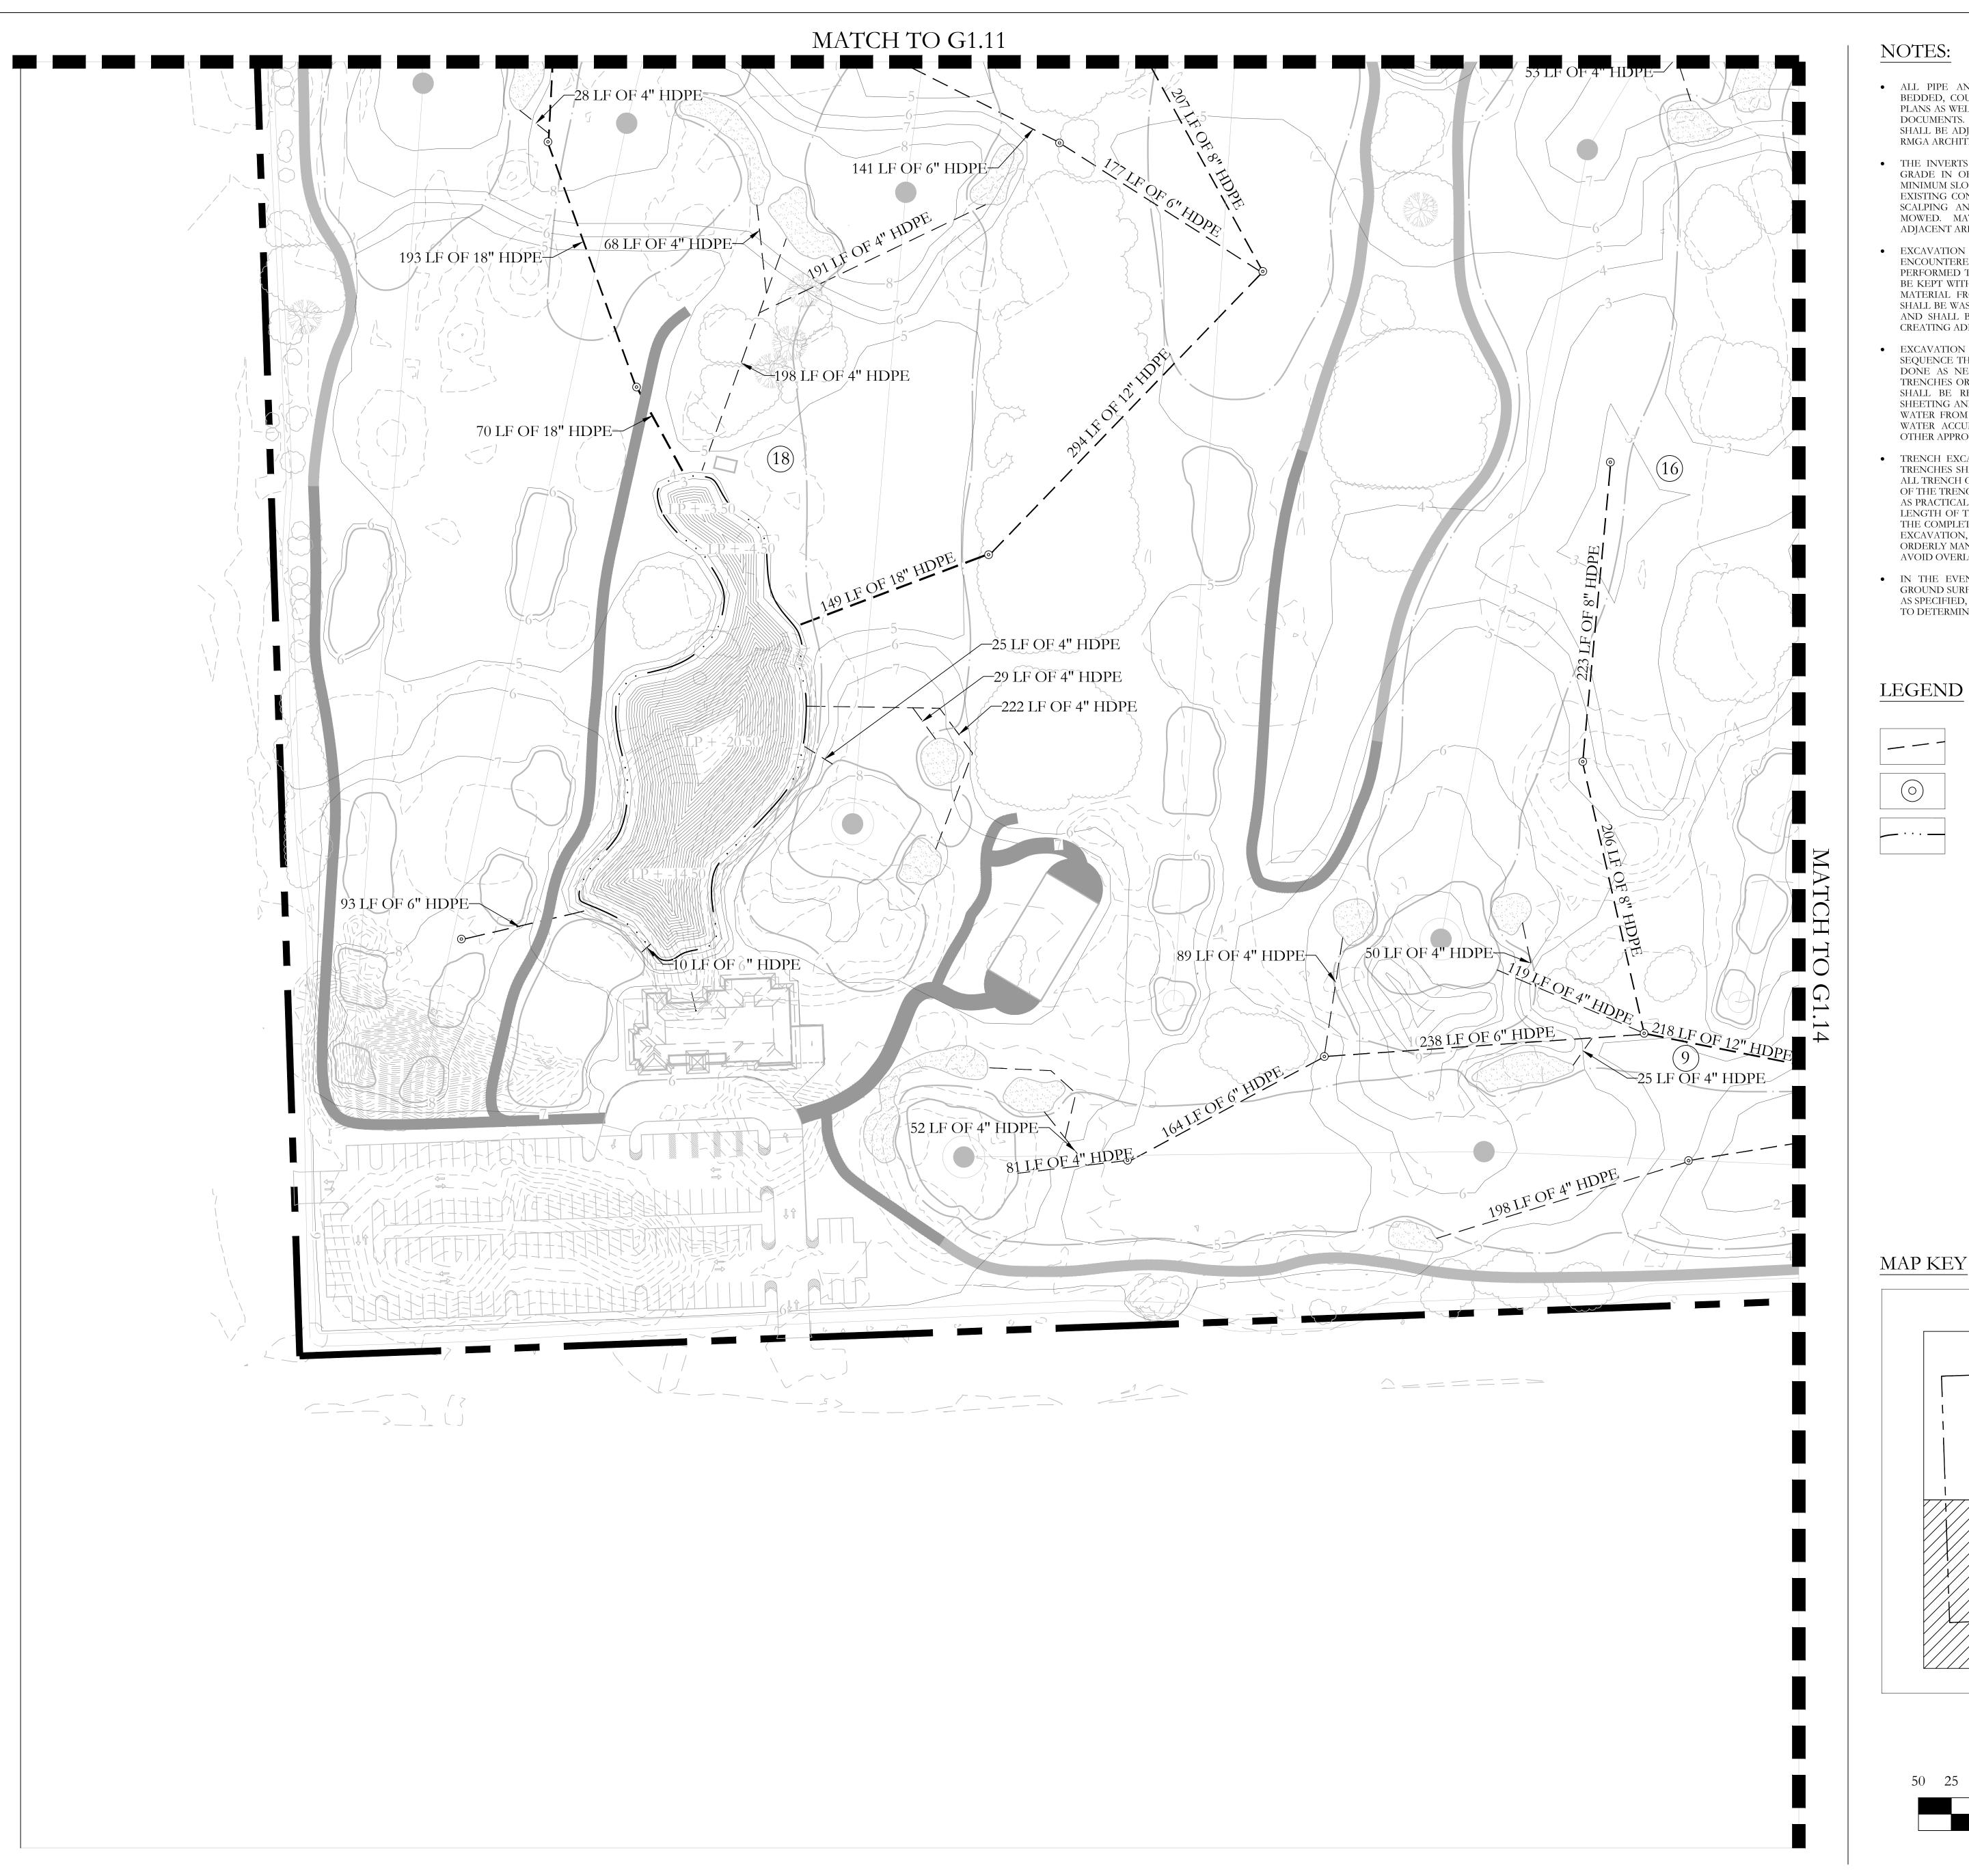
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LEGEND

DRAINAGE PIPE SIZE VARRIES

WATER

DROP INLET

CLIENT:



City of Hollywood

Design and Construction Management PO Box 229045 Hollywood, Florida 33022-9045

T: (954) 921-3410 **GOLF COURSE & LANDSCAPE ARCHITECTURE:**

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WATER

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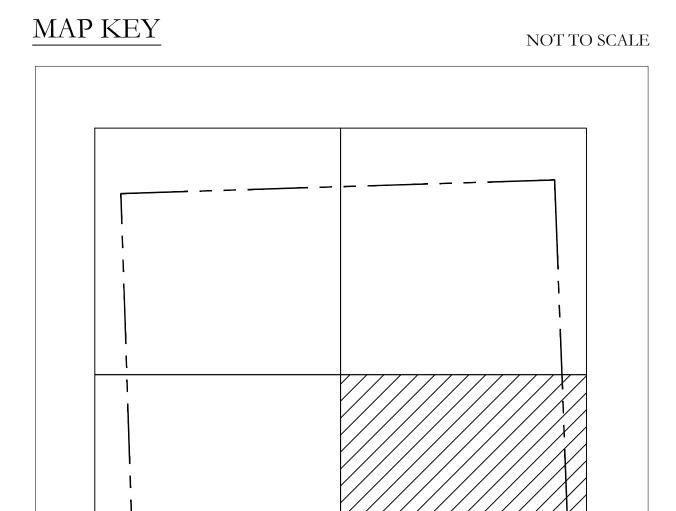
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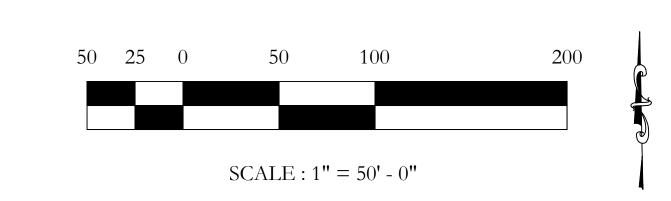
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- DRIVEWAY - MAINTENANCE AREA – CART BARN — CLUBHOUSE — PARKING LOT 100 50 0 100 200

NOTES

- FERTILIZER SHALL BE MANUFACTURED FROM QUALITY MATERIALS, BE FREE FROM IMPURITIES, UNIFORM IN COMPOSITION, MEET RECOGNIZED STANDARDS FOR EFFECTIVENESS AND BE FREE-FLOWING AND SUITABLE FOR APPLICATION WITH APPROVED EQUIPMENT. THE BASIC FERTILIZERS SHALL BE OF A TURFGRASS GRADE, CONTAINING MONO-AMMONIUM PHOSPHATE AS THE PHOSPHOROUS SOURCE. THE FERTILIZER ANALYSIS FOR TEES, FAIRWAYS, AND ROUGH SHALL BE A 4-5-1 THAT IS FINE PARTICLE, CHEMICALLY HOMOGENOUS, HAVE A MINIMUM OF SEVENTY-FIVE PERCENT (75%) OF THE TOTAL NITROGEN (19%) DERIVED FROM UREA AND METHYLENE UREAS, A MINIMUM OF TWENTY-SIX PERCENT (26%) MONO-AMMONIUM PHOSPHATE.
- THE GRASS TYPE FOR ALL PUTTING GREEN SURFACES SHALL BE TIFEAGLE BERMUDA GRASS. THIS GRASS SHALL BE SPRIGGED AT THE RATE OF FORTY (40) BUSHELS/1,000 S.F.
- THE GRASS TYPE FOR ALL TEE TOPS SHALL BE CELEBRATION BERMUDA GRASS. THIS GRASS SHALL BE SPRIGGED AT THE RATE OF TWENTY (20) BUSHELS/1,000 S.F. • THE GRASS TYPE FOR ALL FAIRWAYS SHALL BE CELEBRATION BERMUDA GRASS.
- THIS GRASS SHALL BE SPRIGGED AT THE RATE OF 600 BUSHELS/ACRE. • THE GRASS TYPE FOR ALL IRRIGATED ROUGHS SHALL BE CELEBRATION
- BERMUDA GRASS. THIS GRASS SHALL BE SPRIGGED AT THE RATE OF 600 BUSHELS/ACRE. • SOD SHALL CONSIST OF LIVE, GROWING PLANTS SECURED FROM SOURCES CERTIFIED BY THE STATE'S DEPARTMENT OF AGRICULTURE AND THE SOUTHERN

SEED CERTIFICATION ASSOCIATION WHERE THE SOIL IS FERTILE AND SHALL HAVE A HEALTHY, VIRILE ROOT SYSTEM THROUGHOUT THE SOIL OF THE SOD

- FOR A MINIMUM OF ONE INCH. ALL SOD SHALL BE FREE OF UNCONTROLLABLE, FOREIGN WEEDS AND GRASSES, STRONGLY ROOTED AND CUT IN UNIFORM. AFTER BEING HARVESTED, SOD SHALL BE DELIVERED TO THE PLANTING SITE WITHIN TWENTY-FOUR (24) HOURS. BEFORE OBTAINING ANY SOD, THE CONTRACTOR SHALL PROVIDE THE SOURCE AND LOCATION TO THE RMGA ARCHITECT AND CITY FOR INSPECTION AND APPROVAL. IF SOD IS UTILIZED FOR GREENS, THAT PARTICULAR SOD MUST BE GROWN ON A SAND BASE WHICH IS
- COMPATIBLE WITH THE ROOT-ZONE MIXTURE. • SOD FOR ALL FAIRWAYS AND ROUGH AREAS, INCLUDING SAND BUNKER SURROUNDS AND TEE SLOPES SHALL BE CELEBRATION BERMUDA GRASS.
- SOD FOR GREEN COLLARS SHALL BE TIFTUF BERMUDA GRASS. • IN QUANTIFYING THE NUMBER OF SPRIGS IN A BUSHEL, THE U.S. STANDARD OF 1.25 CUBIC FEET SHALL BE THE ONLY ACCEPTED MEASUREMENT FOR ONE (1)
- BUSHEL OF GRASS SPRIGS. • STOLONS SHALL NOT HAVE A LENGTH LONGER THAN ONE AND ONE-HALF
- INCHES (1 ½") PER STOLON. • IMMEDIATELY PRIOR TO PLANTING, THE FAIRWAY AND ROUGH AREAS SHALL BE FERTILIZED AT A RATE OF POUNDS PER ACRE. THE STARTER FERTILIZER SHALL BE APPLIED TO THE TOP THREE INCHES (3") OF THE SEEDBED SURFACE WITH A MECHANICAL SPREADER AND THOROUGHLY MIXED IN BY RAKING OR OTHER APPROVED METHOD. FERTILIZER MUST BE DRY AND FREE FLOWING WHEN
- DISTRIBUTION AREAS WILL BE SMOOTHED OUT IN PREPARATION FOR PLANTING. IF THE GROUND BECOMES WET OR CAKES OVER BEFORE PLANTING, IT WILL BE RE-HARROWED. THE HARROWING AND FLOATING WILL ENSURE A SMOOTH, LEVEL, AND MELLOW PLANT BED.
- ON ALL TEE SLOPES, STEEP SLOPES OF 3:1 OR MORE, AND AREAS AS DIRECTED BY THE RMGA ARCHITECT, SOD SHALL BE UTILIZED. THE AREAS TO BE SODDED SHALL BE LIGHTLY MOISTENED IMMEDIATELY PRIOR TO LAYING THE SOD. A FIRST STARTER ROW SHALL BE LAID WITH SUBSEQUENT ROWS PLACED PARALLEL TO AND TIGHTLY AGAINST EACH OTHER. LATERAL JOINTS SHALL BE STAGGERED TO PROMOTE MORE UNIFORM GROWTH AND STRENGTH. ANY SOD LAID IN HIGHLY ERODIBLE AREAS OR ON SLOPES EXCEEDING 3:1 IN GRADE SHALL BE STAPLED TO PREVENT MOVEMENT OF THE SOD UNTIL THE GRASS IS ESTABLISHED. • SOD WHOSE ROOTS HAVE DRIED DUE TO EXPOSURE FROM AIR AND SUN, OR
- FROM WHERE GRASS HAS THINNED FROM THESE OR OTHER REASONS SHALL
- SOD TRANSPORTED TO THE SITE SHALL BE LAID NO LATER THAN WITHIN 24
- ALL SODDED AREAS SHALL BE KNOTTED NEATLY AND FIRMLY TOGETHER, ALLOWING NO SPACES, GAPS, VOIDS, OR DEPRESSIONS WITHIN SODDED AREAS.
- BEFORE SPREADING SAND BUNKER SAND, SOD SHALL BE PLACED AROUND THE OUTSIDE EDGE OF THE BUNKER AND COMPLETELY COVER ALL SLOPES THAT WOULD ERODE INTO THE BUNKER WITH AN AMOUNT OF SOD EQUIVALENT TO FOUR PALLETS (PALLET SQUARE FOOTAGE IS PER ACCEPTABLE INDUSTRY STANDARDS) OF SOD PER BUNKER. AT A MINIMUM, A THREE FOOT (3') STRIP SHALL COMPLETELY SURROUND THE BUNKER. IF THE MINIMUM OF THREE FEET AROUND THE BUNKER REQUIRES MORE THAN AN AMOUNT EQUIVALENT TO THE REQUIRED SOD AMOUNT, THEN CONTRACTOR SHALL SUPPLEMENT AS
- CELEBRATION BERMUDA GRASS SHALL BE SPRIGGED AT THE RATE OF 600 BUSHELS PER ACRE ON FAIRWAYS AND ROUGH. • IMMEDIATELY AFTER THE SPRIGS ARE PLACED ON THE SURFACE, THEY SHOULD
 - BE INSERTED TO A DEPTH OF ONE-HALF INCH (1/2") TO ONE AND ONE-HALF INCHES (1 ½") AT TWO INCH (2") CENTERS. WHEN DRAWING THE DISK AND ROLLER ACROSS THE PLANTING SURFACE, APPROPRIATE ACTION SHALL BE TAKEN TO NOT CONTAMINATE.
- IN THE PLANTING OPERATION, GRASS STOLONS SHALL BE UNIFORMLY DISTRIBUTED OVER THE AREAS TO BE PLANTED AND THEN BE ANCHORED INTO THE SOIL WITH AN APPROVED DISC TYPE PLANTER. THE PLANTER SHOULD BE RUN OVER THE STOLONS AT LEAST TWICE, EACH AT RIGHT ANGLES TO EACH
- SPRIGS MUST BE WATERED AS SOON AS PRACTICAL AFTER INSTALLATION BUT IN NO CASE SHALL THEY BE LEFT NOT WATERED FOR MORE THAN THIRTY (30) MINUTES. IT IS ESSENTIAL THAT THE STOLONS BE KEPT MOIST UNTIL NEW GROWTH IS EVIDENT. THIS MAY REQUIRE WATERING LIGHTLY MORE THAN
- MAINTENANCE OF THE GRASSED AREAS: IMMEDIATELY AFTER ALL AREAS HAVE BEEN SEEDED, THE CONTRACTOR SHALL WATER THE SEEDBED AREAS SUFFICIENTLY TO SEAL THE SOIL AROUND ALL SEEDS, SOD, AND/OR STOLONS. WATERING SHALL BE UNDER CONSTANT SUPERVISION OF THE CONTRACTOR IN ORDER TO ACHIEVE SATISFACTORY GERMINATION OF THE GRASS. IT SHALL BE THE CONTRACTOR'S RESPONSIBILITY TO MAINTAIN THE SEEDED AREAS BY KEEPING THE SOIL CONSTANTLY MOIST AFTER PLANTING TO ACHIEVE PROPER GERMINATION.
- UPON A VARIETY OF FACTORS BEYOND THE CONTROL OF THE CONTRACTOR, THE CONTRACTOR WILL NOT BE RESPONSIBLE FOR FAILURE OF PLANTED AREAS TO DEMONSTRATE SATISFACTORY SPROUTING IF HIS OPERATIONS ARE IMPAIRED BY ACTS OF GOD, EXTREMELY UNUSUAL WEATHER CONDITIONS (TWENTY PERCENT (20%) ABOVE AVERAGE RAINFALL), AND/OR UNUSUAL OR UNCONTROLLABLE DISEASE OR INSECT ATTACKS. SATISFACTORY GERMINATION: THIRTY (30) DAYS AFTER ALL AREAS HAVE BEEN

SINCE THE PROPER GROWTH AND CULTIVATION OF TURFGRASS IS DEPENDENT

- SEEDED, A CHECK SHALL BE MADE TO SEE THAT ALL WATERED AREAS DEMONSTRATE ADEQUATE GERMINATION. AREAS OUTSIDE OF THE SPRINKLING AREAS OF THE IRRIGATION SYSTEM SHALL NOT BE EXPECTED TO BE CONSISTENT IF SUFFICIENT RAINFALL HAS NOT OCCURRED. WARRANTY: THE CONTRACTOR SHALL BE RESPONSIBLE FOR RESEEDING ALL AREAS WHICH DO NOT GERMINATE WITHIN 30 DAYS OF FINAL ACCEPTANCE OF
- THE WORK. IT WILL BE THE CITY'S RESPONSIBILITY TO MAINTAIN ALL AREAS FOLLOWING FINAL ACCEPTANCE OF THE WORK BY THE GOLF COURSE • IT MAY BE NECESSARY TO NOTCH THE SOD IN PLACES TO PROPERLY MIMIC THE EXACT BUNKER EDGE SHELL-OUT LINES. IT MAY ALSO BE NECESSARY TO CUT AWAY THE EXCESS SOD WHERE OVERLAPS OCCUR TO PROPERLY FIT AND

LEGEND

GREEN COLLAR- TIFGRAND BERMUDA

GREEN- TIFEAGLE BERMUDA

PRESERVE THE BUNKER EDGE LINES AS WELL.

FAIRWAY- CELEBRATION BERMUDA

ROUGH- CELEBRATION BERMUDA

TEE- CELEBRATION BERMUDA

SAND BUNKERS

CART PATH- CONCRETE

WATER

CART PATH- COQUINA SHELL

SCALE : 1" = 100' - 0"

TREES TO REMAIN- NO GRASSING UNDER

CLIENT:



City of Hollywood

Design and Construction Management PO Box 229045 Hollywood, Florida 33022-9045

T: (954) 921-3410 GOLF COURSE & LANDSCAPE

ARCHITECTURE:

Richard Mandell Golf Architecture 2208 Midland Road Pinehurst, North Carolina 28374

T: (910) 255-3111

ARCHITECTURE & INTERIOR DESIGN:

Bermello Ajamil & Partners

Bermello Ajamil & Partners, Inc.

Architecture Engineering Planning Interior Design Landscape Architecture 2601 South Bayshore Drive, 10th Floor Miami, Florida 33133

T: (305) 859-2050 F: (305) 860-3700

MEP ENGINEERING: DELTA G CONSULTING ENGINEERS, INC.

Delta-G Consulting Engineers, Inc.

707 NE 3rd Ave. Suite. 200 Fort Lauderdale, FL 33304 T: (954) 527-1112

STRUCTURAL ENGINEERING:

BLISS & NYITRAY, INC. ENGINEERS

Bliss & Nyitray, Inc. 5835 Blue Lagoon Drive, Suite 400

Miami, FL 33126 T: (305) 442-7086

CIVIL ENGINEER:



5747 Andrews Way Fort Lauderdale, FL 33309 T: (954) 436-7000

FOOD & BEVERAGE:

3103 Medlock Bridge road Norcross, Georgia 30071 T: (770) 582-1144

> **DESIGN DEVELOPMENT GRASSING PLAN**

06.03.2022

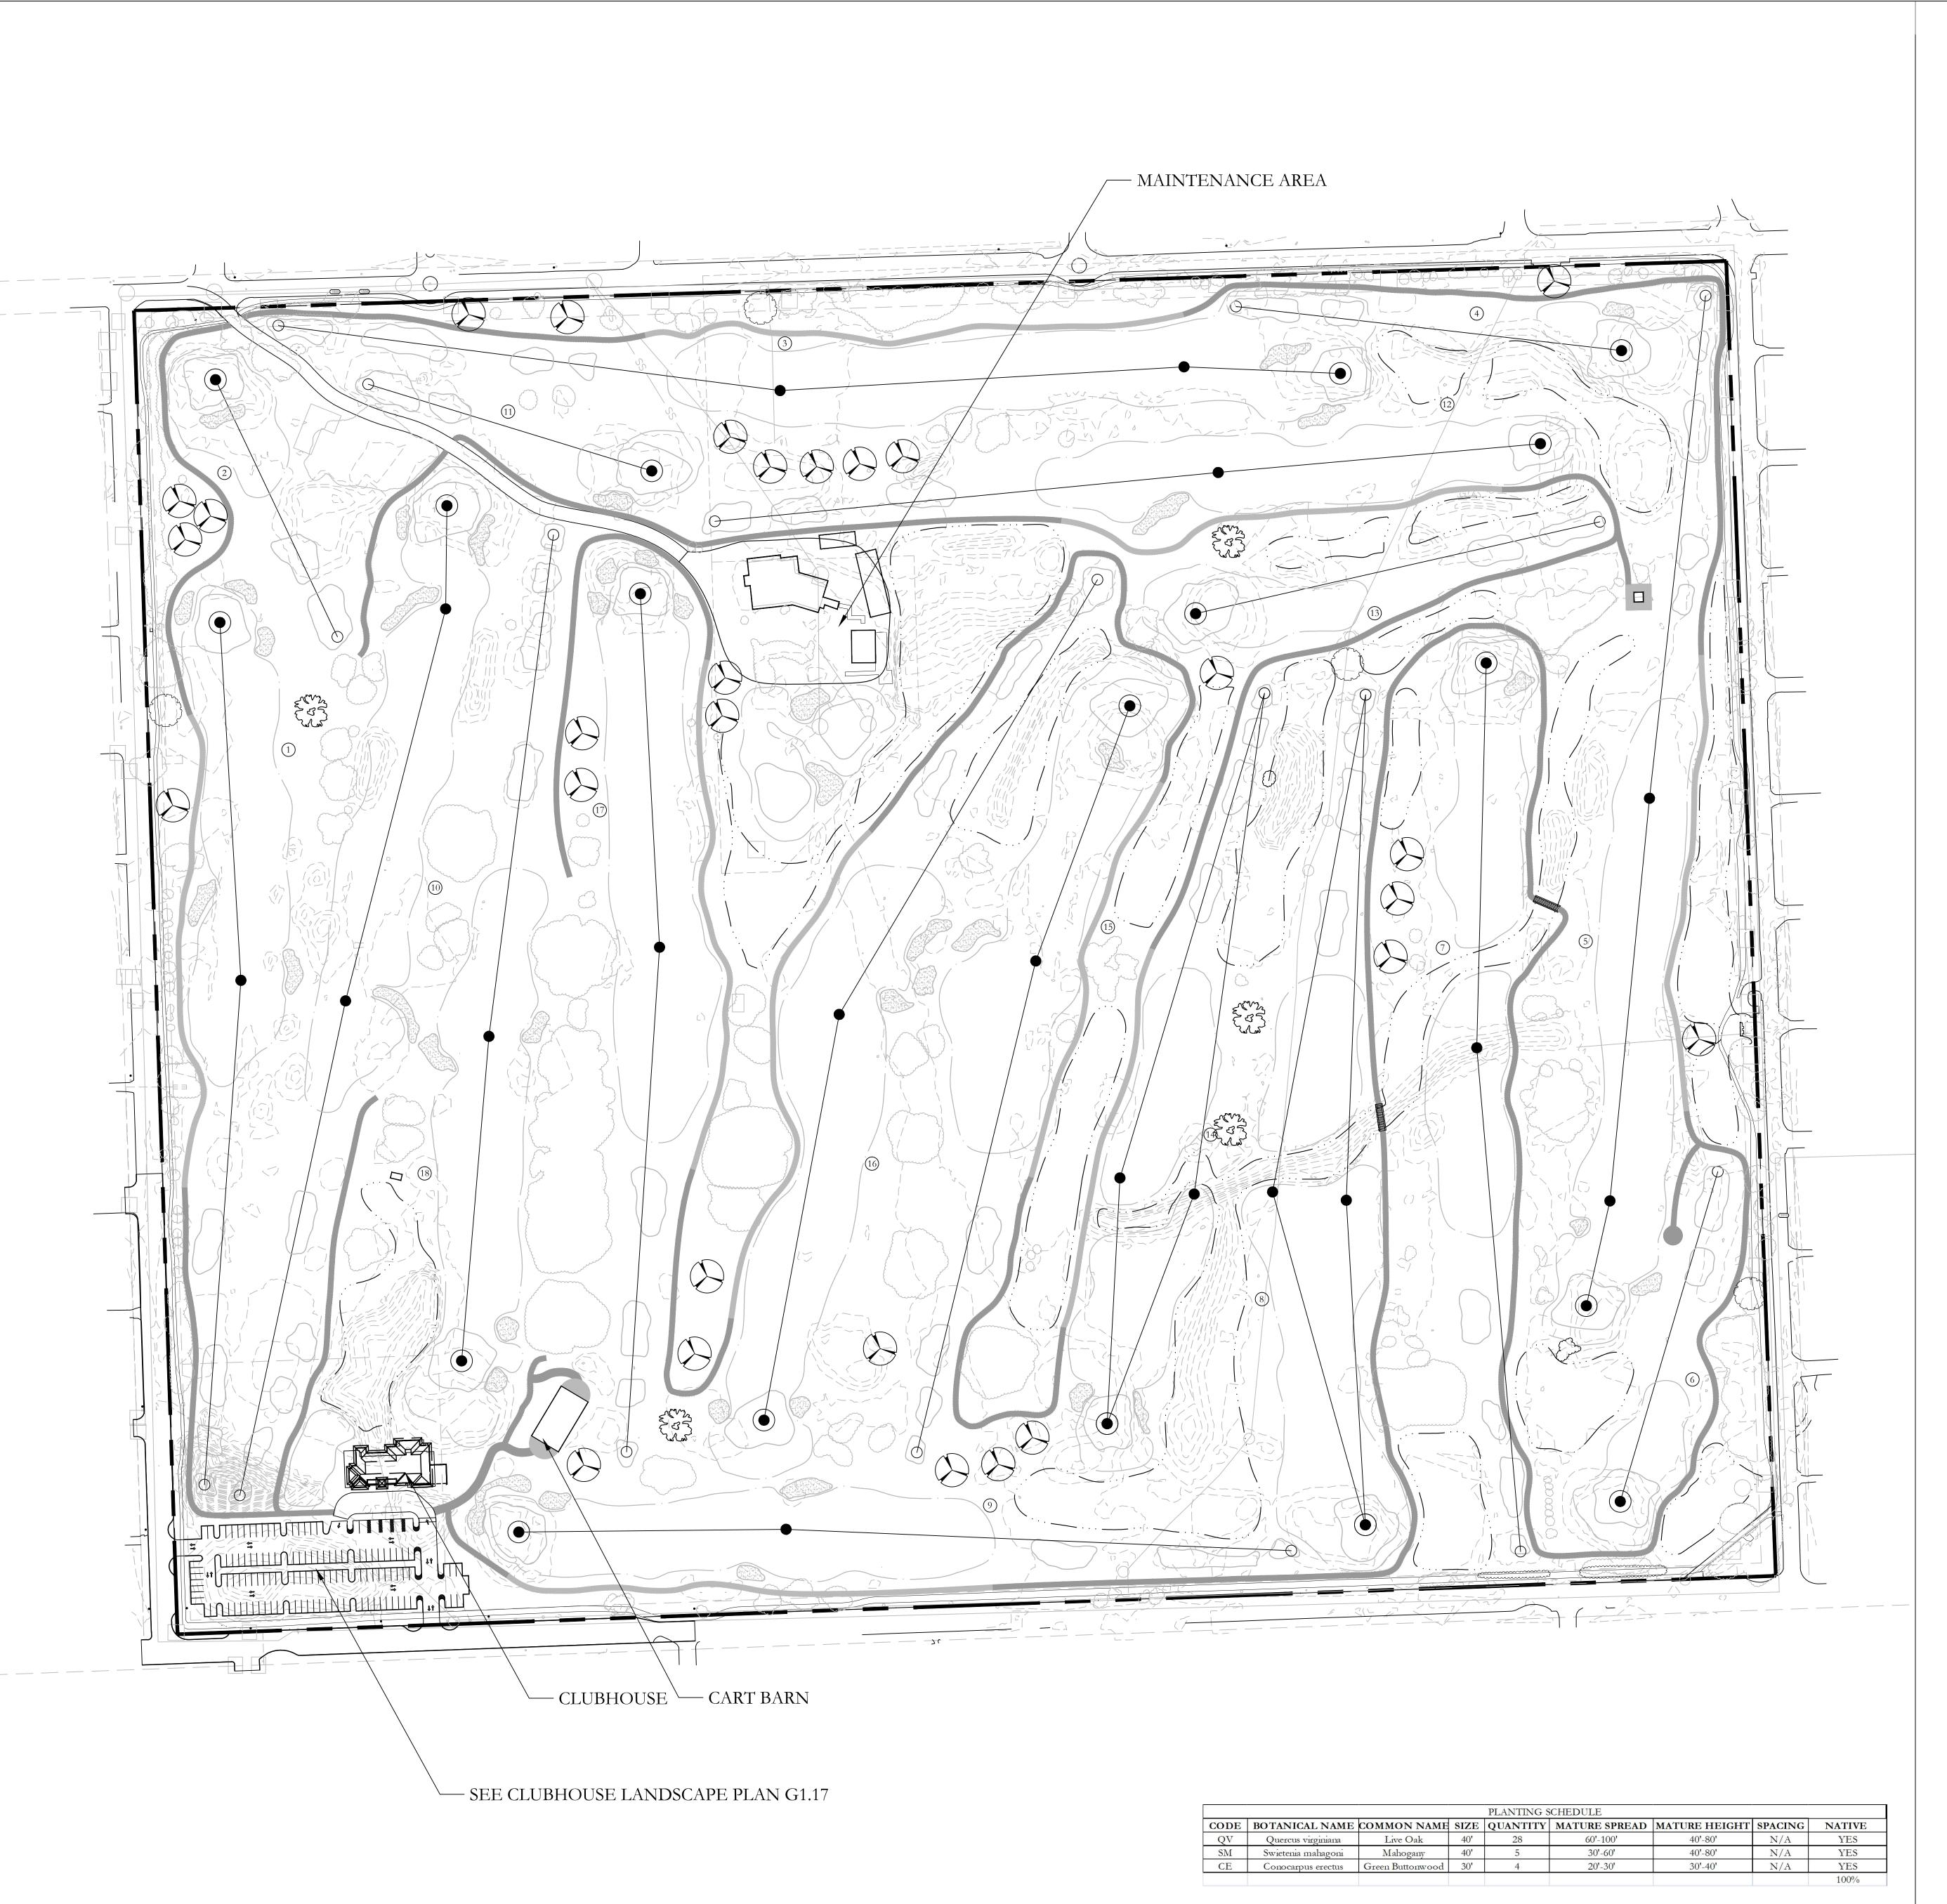
PROJECT NAME: HOLLYWOOD BEACH GOLF **COURSE AND CLUBHOUSE**

PROJECT ADDRESS: 1600 Johnson Street Hollywood, FL 33020 PROJECT NO.: 02141.000

SHEET NAME

DESIGN DEVELOPMENT GRASSING PLAN

SHEET NO.



- 1. ALL SPECIFIED HEIGHTS IN COMPOSITE PLANT LIST ARE RECOMMENDED PLANT HEIGHTS TO ACHIEVE PROPER DESIGN EFFECT. THIS WILL REQUIRE ANNUAL
- 2. REQUIRED PRUNING SHALL NOT BE ACCOMPLISHED WITH SHEARS. PRUNING SHALL BE ACCOMPLISHED USING LARGE CLIPPERS.
- 3. PRUNING OF ALL PLANT MATERIAL SHALL ACHIEVE A NATURAL APPEARANCE. PLANTS SHALL NOT BE PRUNED TO ACHIEVE A UNIFORM FORMAL APPEARANCE
- 4. TREES WHICH ARE PYRAMIDAL IN FORM SHALL NOT BE LIMBED UP TO APPEAR AS "LOLLIPOP" SHAPES.
- 5. ALL SHRUBS SHALL NOT BE PRUNED TO EXPOSE LOWER LIMBS. SHRUBS SHALL HAVE BRANCHES EXTENDED TO THE GROUND.

6. THE CONTRACTOR SHALL LOCATE AND VERIFY THE EXISTENCE OF ALL

- UTILITIES PRIOR TO STARTING WORK.
- 7. NO PLANT SHALL BE PUT INTO THE GROUND BEFORE GRADING HAS BEEN FINISHED AND APPROVED BY THE PROJECT LANDSCAPE ARCHITECT OR EQUAL.
- 8. NO PLANT SHALL BE PUT INTO THE GROUND BEFORE GRADING HAS BEEN FINISHED AND APPROVED BY THE PROJECT LANDSCAPE ARCHITECT OR EQUAL.
- 9. ALL PLANTS SHALL BEAR THE SAME RELATIONSHIP TO FINISHED GRADE AS THE PLANT'S ORIGINAL GRADE BEFORE DIGGING.
- 10. ALL PLANTS SHALL BE BALLED AND WRAPPED OR CONTAINER GROWN AS SPECIFIED. NO CONTAINER GROWN STOCK WILL BE ACCEPTED IF IT IS ROOT BOUND. ALL ROOT WRAPPING MATERIAL MADE OF SYNTHETICS OR PLASTICS SHALL BE REMOVED AT TIME OF PLANTING.

11. WITH CONTAINER GROWN STOCK, THE CONTAINER SHALL BE REMOVED AND THE CONTAINER BALL SHALL BE CUT THROUGH THE SURFACE IN TWO VERTICAL

- 12. AT PLANTING TIME, ALL PLANTS SHALL BE THINNED BY REMOVING A BALANCED ONE-THIRD OF THE VEGETATIVE MATERIAL.
- 13. ALL PLANTS SHALL BE SPRAYED WITH AN ANTIDESSICANT WITHIN 24 HOURS
- 14. ALL PLANTS AND STAKES SHALL BE SET PLUMB. 15. ALL PLANTS SHALL BE WATERED THOROUGHLY TWICE DURING THE FIRST

24-HOUR PERIOD AFTER PLANTING. ALL PLANTS SHALL THEN BE WATERED WEEKLY OR MORE OFTEN, IF NECESSARY, DURING THE FIRST GROWING SEASON.

16. ALL PLANT MATERIAL SUBSTITUTIONS SHALL BE APPROVED BY THE LANDSCAPE ARCHITECT.

17. 100% IRRIGATION COVERAGE BY MEANS OF AN AUTOMATIC SPRINKLER SYSTEM DESIGNED AND CONSTRUCTED IN ACCORDANCE WITH THE CITY OF HOLLYWOOD CODE OF ORDINANCES AND REGULATIONS OF THE SOUTH FLORIDA WATER MANAGEMENT DISTRICT.

LEGEND

5" LIVE OAK

5" MAHOGANY

5" GREEN BUTTONWOOD

SCALE : 1" = 100' - 0"

TREES TO REMAIN

CLIENT:

- City of Hollywood Design and Construction Management
- PO Box 229045 Hollywood, Florida 33022-9045
- T: (954) 921-3410

GOLF COURSE & LANDSCAPE **ARCHITECTURE:**

Richard Mandell Golf Architecture

2208 Midland Road Pinehurst, North Carolina 28374

T: (910) 255-3111

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Camacho 3103 Medlock Bridge road Norcross, Georgia 30071 T: (770) 582-1144

DESIGN DEVELOPMENT GOLF COURSE LANDSCAPE

09.06.2022

PLAN

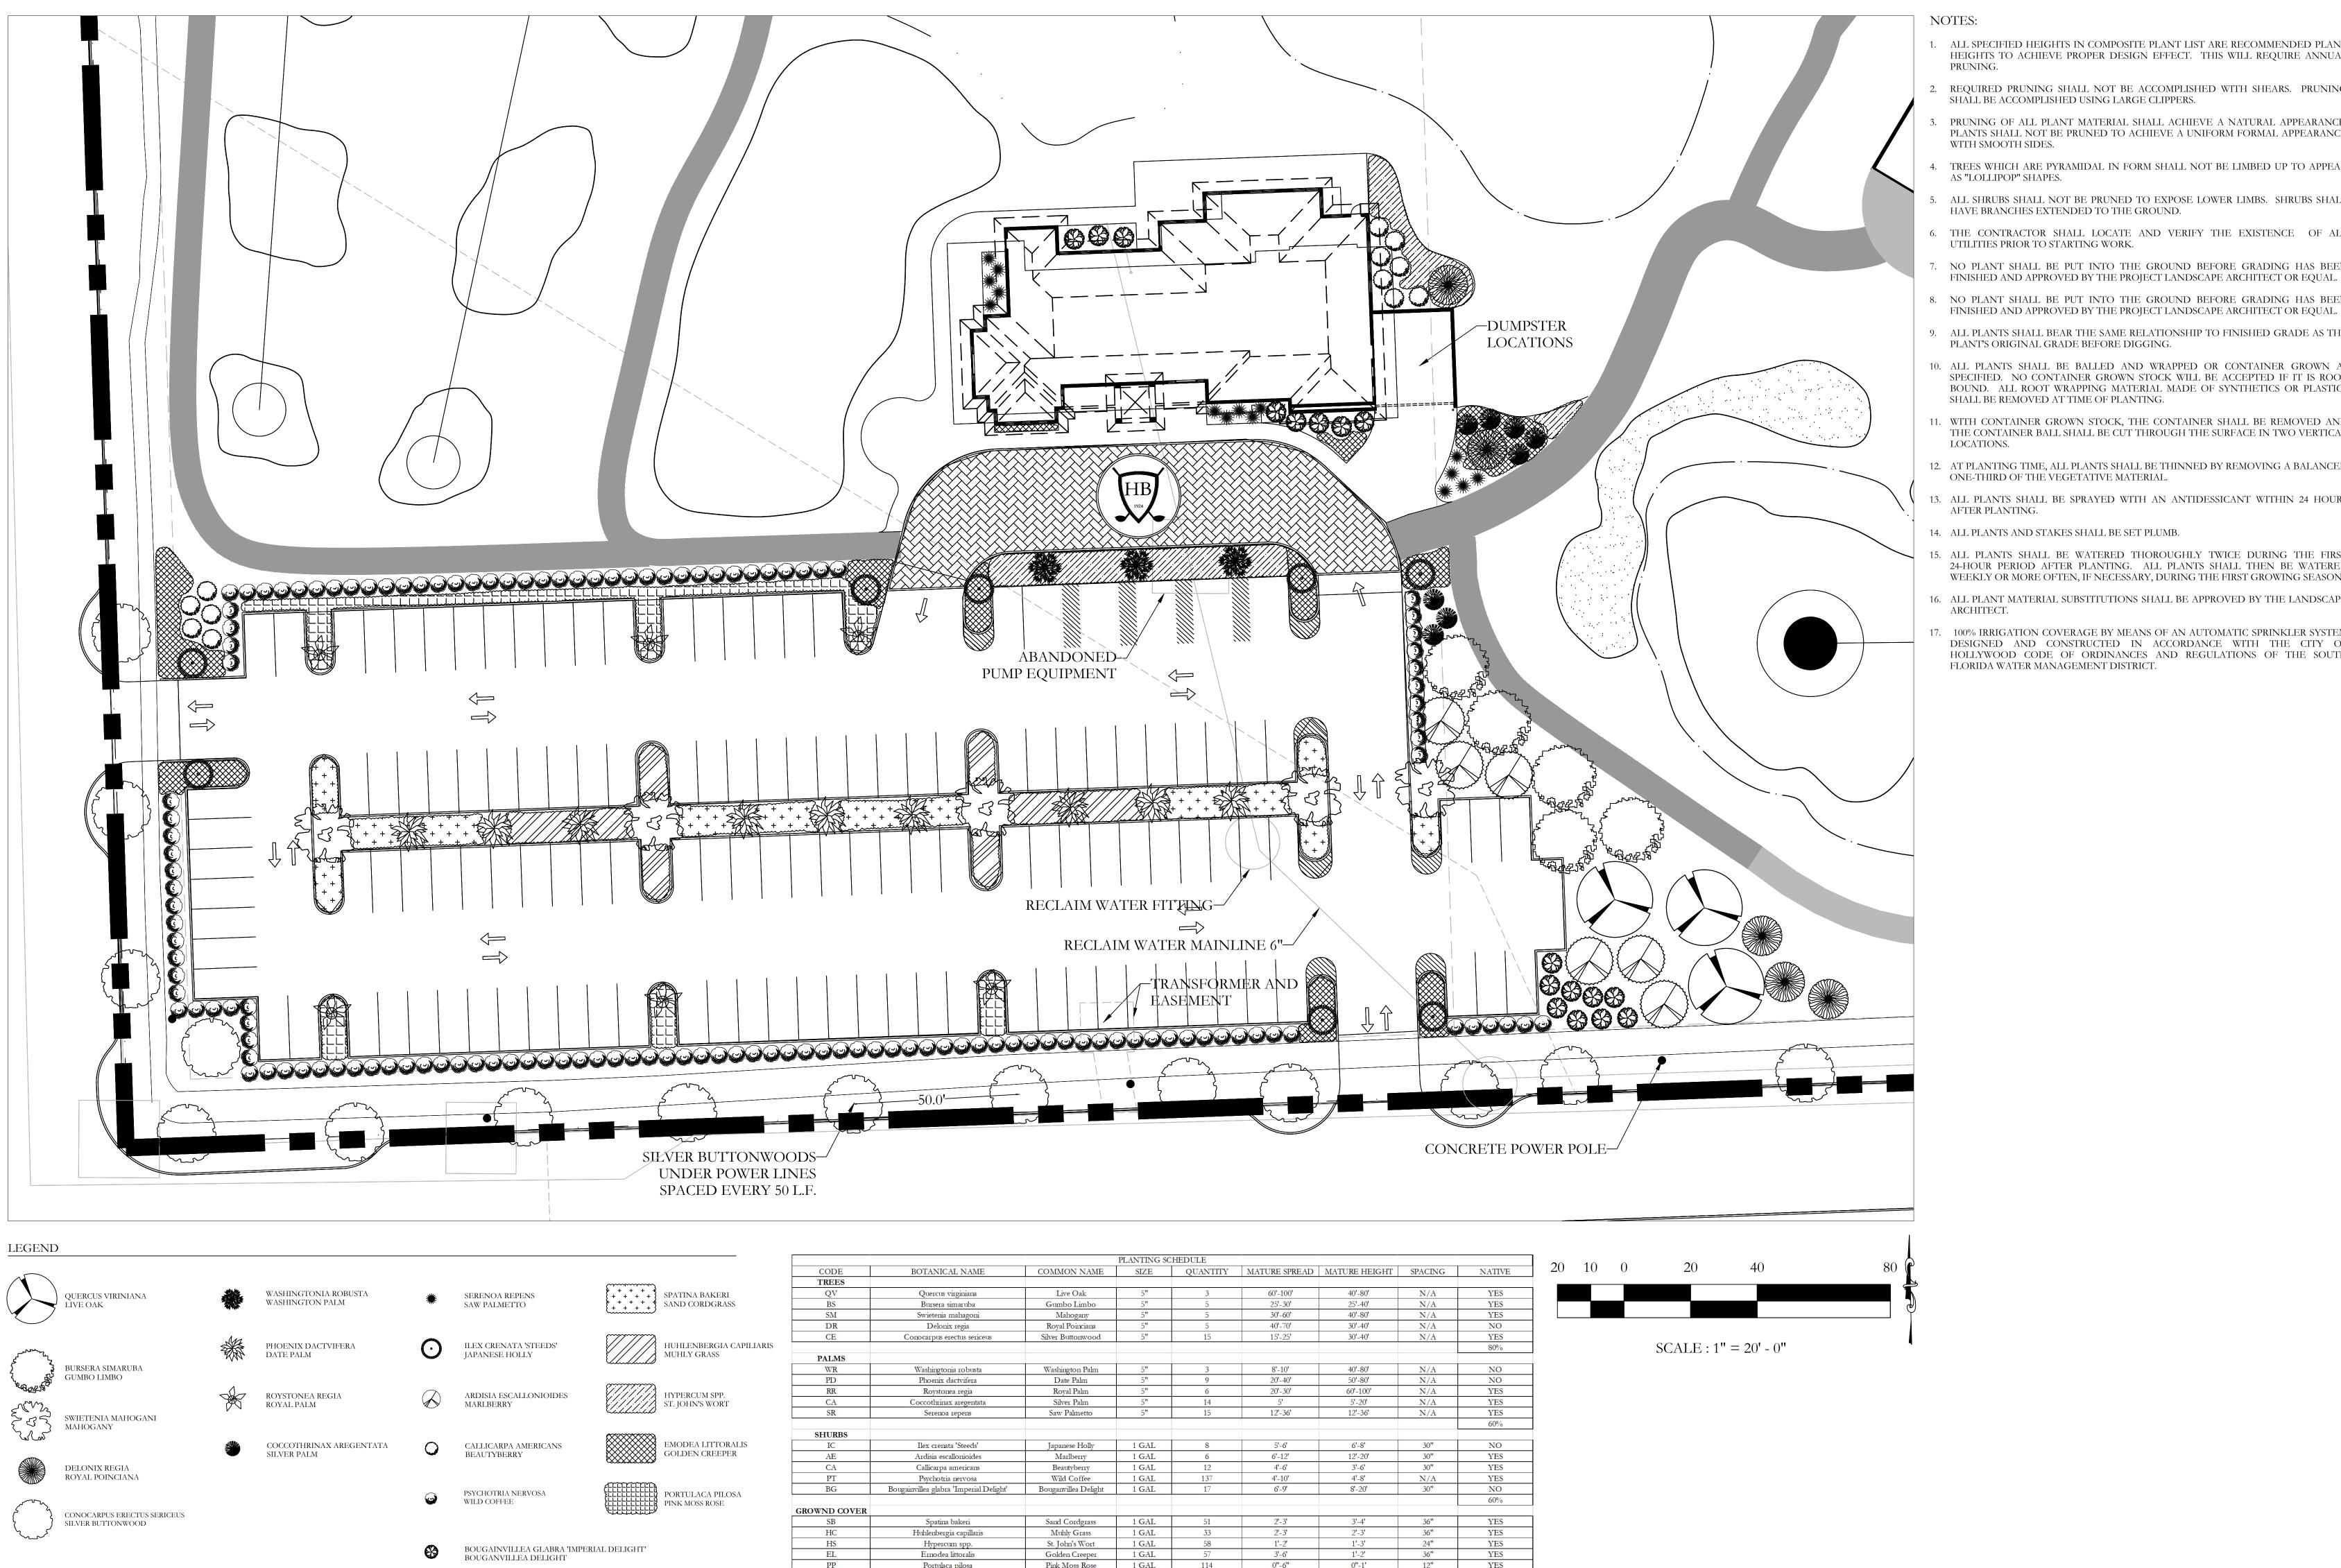
PROJECT NAME: HOLLYWOOD BEACH GOLF **COURSE AND CLUBHOUSE** PROJECT ADDRESS: 1600 Johnson Street Hollywood, FL 33020

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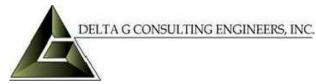
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DESIGN

DEVELOPMENT CLUBHOUSE LANDSCAPE

PLAN

10.10.2022

PROJECT NAME: HOLLYWOOD BEACH GOLF **COURSE AND CLUBHOUSE**

PROJECT ADDRESS: 1600 Johnson Street Hollywood, FL 33020 PROJECT NO.: 02141.000

SHEET NAME

DESIGN DEVELOPMENT CLUBHOUSE LANDSCAPE PLAN

SHEET NO.