

FORMS CHECKLISTS & MEETING DATES

A:


DEVELOPMENT SERVICES
PLANNING DIVISION

 $(q_{1},q_{2},q_{3},q_{4},q_{5},q_{$ 

# **GENERAL APPLICATION**

PLANNII	NG DIVISION	GENERAL.	AFFLICA	ION
APPLICATION DATE:			DE DESCRIPTION OF THE REAL PROPERTY.	
2600 Hollywood Blvd Room 315 Hollywood, FL 33022	APPLICATION TYPE (CHECK ALL Technical Advisory Committee Planning and Development Board City Commission	THAT APPLIES):  Art in Public Places Committee  Historic Preservation Board  Administrative Approval	☐ Variance ☐ Special Exception	
Tel: (954) 921-3471	PROPERTY INFORMATION			
Email: Development@	Location Address: 6190 Hollywood	Boulevard		
Hollywoodfl.org	Lot(s): 1-3 Bloo	ck(s): N//A S	Subdivision: Lydon Park	
SUBMISSION REQUIREMENTS	Folio Number(s): 5141 131 8 010			
One set of signed & sealed plans	Zoning Classification: S-MU	Land Use Class	sification:	
(i.e. Architect or Engineer)	Existing Property Use: Auto Repair	Sq Ft/Num	ber of Units: 14,730 sq. f	it.
One electronic     combined PDF	Is the request the result of a viola	ation notice? 🗆 Yes 🗹 No	o <b>If yes</b> , attach a copy o	of violation.
submission (max 25mb)	Has this property been presented t	to the City before? If yes, c	heck al that apply and p	orovide File
Completed Application     Checklist	Number(s) and Resolution(s): No			
Application fee	DEVELOPMENT PROPOSAL			
	Explanation of Request: To allow a le	egal non-conforming use to be in	istansified and/or to allow or	Instruction
	to a bull ding	. (8)		
	Phased Project: Yes 🔲 No 🗹 Num	iber of Phases1		
	Project	Proposal		EXTENSION OF THE PARTY OF THE P
NOTE:	Units/rooms (# of units)	# UNITS:	0 #Rooms	
NOTE:	Proposed Non-Residential Uses		14,790	]S.F.)
This application must be completed in full	Open Space (% and SQ.FT.)	Required %: N/A	(Area: N/A	S.F.)
and submitted with all documents to be placed	Parking (# of spaces)	PARK. SP	PACES: (# N/A	)
on a Board or Committee's agenda.	Height (# of stories)	(# STORIES)	1 (	FT.)
The applicant is	Gross Floor Area (SQ. FT)	Lot(s) Gr	oss Area ( 14,790	]FT.)
responsible for obtain- ing the appropriate	Name of Current Property Owner	: Westover Hollywood LLC c	do Animesh Rayani	
checklist for each type	Address of Property Owner: 1133 Wo			
of application.	Telephone: 312-3613449 Em	nail Address: ani@northstone. I	lav	
<ul> <li>Applicant(s) or their authorized legal agent</li> </ul>	Applicant Rod A. Feiner, Esq.	Consultant F	Representative 🗹 Te	enant 🗖
<u>must</u> be present at all Board or Committee	Address: 1404 South Andrews Ave., Ft.		lephone: 954-761-3636	,,,a,,,
meetings.	Email Address: rafeiner@coker-feiner.			
<b>传鉴</b> "特别是是	Email Address #2:			
<b>数别是基础</b> 。14	Date of Purchase: Under Contract	s there an option to purchas	se the Property? Yes [	☑ No □
OLION HERE FOR	If Yes, Attach Copy of the Contract.		d A '- t	
CLICK HERE FOR	Noticing Agent (FTAC & Board su	ubmissions only) : Cutro and	<u>u Associates</u>	

E-mail Address: cutroplanning@yahoo.com

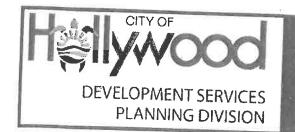

# **GENERAL APPLICATION**

# CERTIFICATION OF COMPLIANCE WITH APPLICABLE REGULATIONS

The applicant/owner(s) signature certifies that he/she has been made aware of the criteria, regulations and guidelines applicable to the request. This information can be obtained in Room 315 of City Hall or on our website at <a href="www.hollywoodfl.org">www.hollywoodfl.org</a>. The owner(s) further certifies that when required by applicable law, including but not ilmited to the City's Zoning and Land Development Regulations, they will post the site with a sign provided by the Office of Planning and Development Services. The owner(s) will photograph the sign the day of sign will result in violation of State and Municipal Notification Requirements and Laws.

(I)(We) certify that (I) (we) understand and will comply with the provisions and regulations of the City's Zoning and Land Development Regulations, Design Guidelines, Design Guidelines for Historic Properties and City's Comprehensive Plan as they apply to this project. (I)(We) further certify derstand that the application and attachments become part of the official public records of the City and are not returnable.

Signature of Current Owner: Shae Wolkewki	Date: 4/28/2025
PRINT NAME:	Date:
Signature of Consultant/Representative:	Date: 5/0/25
PRINT NAME: Rod A. Feiner, Esq.	Date;
Signature of Tenant:	Date:
PRINT NAME:	Date:
Current Owner Power of Attorney	
l am the current owner of the described real property and that I am aware of the expansion of legal non-conforming use to my property, which is hereby made Rod A. Feiner and Coker & Feiner to be my legal representative before the Planni Committee) relative to all matters concerning this application.	e nature and effect the request for by me or I am hereby authorizing ing and Development (Board and/or
Sworn to and subscribed before me this 28 day of April Sign  KAYLYN ELIZABETH FOX Notary Public, State of Inlinois	hai Welknucke nature of Current Owner
Notary Public  Commission Rep. 1603058  My Commission Expires January 72, 2029  Print  Print	hai Wolkowicki Name
State of Flerida 1111/1615  My Commission Expires: 1/22/24 (Check One) Personally known to me; OR Production	ced Identification

### **LEGAL DESCRIPTION**

Lots 1, 2 and 3, of LYNDON PARK, according to the Plat thereof, as recorded in Plat Book 29, Page 25, of the Public Records of Broward County, Florida.

A/K/A: 6190 Hollywood Boulevard, Hollywood, FL 33023

Folio No. 5141-13-18-0010

### Law Offices

### **COKER & FEINER**

1404 South Andrews Avenue Fort Lauderdale, FL 33316-1840

Telephone: (954) 761-3636 Facsimile: (954) 761-1818

Richard G. Coker, Jr., P.A. Rod A. Feiner Kathryn R. Coker

rgcoker@coker-feiner.com rafeiner@coker-feiner.com krcoker@coker-feiner.com

### **MEMORANDUM**

To:

Cameron Palmer, Principal Planner

City of Hollywood

From:

Rod A. Feiner, Esq.

Date:

May 16, 2025

Subject:

Request to Allow Intensification of Legal Non-Conforming Use

Request to Allow Changes to Building of Non-Conforming Use

6190 Hollywood Boulevard

### Request

To allow a legal non-conforming use to be intensified pursuant to Section 3.12(G)(3) of the Code and/or to allow construction to a building pursuant to Section 3.12(G)(5) of the Code.

### General Background Applicable to All Criteria

Take 5 Properties SPV LLC ("Owner) is currently under contract to purchase the property which has a mailing address of 6190 Hollywood Boulevard (the "Property"). The Property has been continuously used as a minor auto repair use. The Property is currently zoned S-MU and this zoning district does not permit an auto repair use as a permitted use. This means that the auto repair use is a legal non-conforming use.

The Applicant proposes to use the property and its existing building for a Take 5 business. Take 5 is an oil change, oil and air filter change and other assorted minor automobile repairs. No auto body work or painting occurs as part of the Take 5 use. Additionally, while a minor automotive repair use Take 5 does not engage in repairing upholstery, muffler installation or tire repair. This means that Take 5 is actually less intensive than the prior auto repair use which was occurring on

### the Property.

What makes Take 5 different is that that a customer enters the Property and drives to the rear of the building. The vehicle then enters the back of the building through a roll up door such that the customer and its vehicle enter the building, much like a vehicle would do for a garage use, and the minor automative repair then occurs to the vehicle. The customer leaves the building from the front of the building through another roll up door. For the convenience of the customer, however, the client does not exit the vehicle while services are performed on the automobile. Rather the service personnel are located under the vehicle and within the 4 walls of the building. The average service time for a vehicle receiving the minor automative repair is approximately 15-20 minutes. A copy of the site plan and the building elevations are attached.

Because customers enter the building in their vehicles and stay in their vehicle while service is being performed the use has been determined to have a drive-thru component. In fact, service only occurs through this drive-thru component and it is not possible for a customer to leave their vehicle at the site and then come back and pick it up later. The prior automobile service use did not have a drive-thru component associated with its use. Thus, while it is anticipated that either the same number or a lesser number of vehicles will be serviced by the Take 5 use the addition of the drive-thru component has been deemed to be an intensification of the use.

In addition to the above, while Take 5 will be using the same building which currently exists on the Property it will be making modifications to the building. It will be adding some additional roll up doors to the rear of the building and updating the look/exterior elevations of the building and the site as a whole. Section 3.12 of the Code allows a non-conforming use to continue "provided no structural alterations" are made to the building. In this case, even though the building is not being expanded and the Owner is adding landscaping to the site, because the Owner is adding additional roll up doors (with the appropriate permits) to the rear of the building the Owner is deemed to be making structural alterations to the building and it is necessary to obtain approval to continue the legal non-conforming use.

Section 312(G) of the Code states that the Planning and Development Board can grant approval to allow the automotive repair as proposed by Take 5 by analyzing the criteria contained in Section 3.12(H).

### Specific Criteria

1. The approval of the application is necessary for the preservation and enjoyment of substantial property rights of the applicant.

The approval of the application is necessary for the preservation and enjoyment of substantial property rights of the applicant. It is not possible for Take 5 to utilize the site without the drivethru facility being added. In making the drive-thru facility the Owner has ensured compliance with the supplemental requirements for a drive-thru applicable to this use. This includes adding stacking lanes and an escape lane.

Furthermore, the size of the property and its prior use mandate the continuation of the legal non-

conforming use. The Property is only 14,730 sq ft. (.33 acres) large. This small size directly impacts the types of uses which can be located on the Property. The Owner has, however, updated the look of the site through improved building elevations and the installation of additional landscape areas such that the enjoyment and preservation of property rights occurs.

2. The approval will not, under any circumstances of the particular case, be detrimental to the health, safety and general welfare of persons working or residing within the vicinity.

The approval will not be detrimental to the health, safety and general welfare of persons working or residing in the vicinity of the Property. In fact, the opposite could be said to occur. While the Property has always involved an auto repair use and the Take 5 auto repair use is far less intense than a traditional auto repair use. For instance, Take 5 does not engage in battery replacement or tire repair or replacement. In fact, Take 5 is a national business and knows how to handle the materials it uses such that it can ensure that Take 5 operates safely and in accordance with all laws. In addition to this, the Property is surrounded by commercial businesses such that there will not be any detriment to the public.

3. The approval will not be detrimental or injurious to property and improvements in the vicinity or to the general welfare of the city.

The approval will not be detrimental or injurious to property and improvements in the vicinity or to the general welfare of the City. Besides the factors set forth in response to criteria 2, the proposed use will not be detrimental or injurious to other properties in the vicinity. As part of the proposed use Take 5 is making substantial improvements to the Property which will benefit properties in the vicinity. These improvements involve updating the look of the building and adding additional landscaping to the site. All of this will actually be a benefit to the properties in the vicinity.

4. The approval will, to the maximum extent possible, bring the use or building and the site upon which it is located into compliance with city regulations.

The approval will, to the maximum extent possible, bring the use into compliance with City regulations. While the Take 5 auto repair use would continue the legal non-conforming auto repair use the types of auto repair that Take 5 performs are less intense than the typical and previous auto repair use which occurred on this property. This makes the auto repair use proposed by Take 5 less intense while Take 5 will also be bringing the Property closer to compliance with the City's Zoning regulations. In addition to this, by adding additional landscaping to the site and restoring the swale Take 5 is also bringing the Property closer to compliance with the City's Zoning regulations.

### Law Offices

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rgcoker@coker-feiner.com rafeiner@coker-feiner.com krcoker@coker-feiner.com

### **MEMORANDUM**

To:

City of Hollywood

From:

Rod A. Feiner, Esq.

Date:

May 16, 2024

Subject:

Variance Request for Stacking Spaces Associated with a Drive-Thru Facility

Request and Justification for Variance

Property Address: 6190 Hollywood Boulevard

### Variance Requested

The Applicant is requesting a variance from Section 4.22(R) of the Unified Land Development Code ("Code")<sup>1</sup> in order to provide 4 inbound stacking spaces per drive-thru lane and 0 outbound stacking spaces per drive-thru lane for a drive-thru facility when Code requires 6 inbound parking spaces and 4 outbound stacking spaces.

### General Statement Applicable to All Criteria

This Property has been continuously used as a minor auto repair use which is a legal non-conforming use. The Applicant proposes to use the property and its existing building for a Take 5 auto repair business. Take 5 is an oil change, oil and air filter change and other assorted minor automobile repairs business. No auto body work or painting occurs as part of the Take 5 use. Additionally, Take 5 does not engage in repairing upholstery, muffler installation or tire repair.

What makes Take 5 different is that that a customer enters the Property and drives to the rear of

<sup>&</sup>lt;sup>1</sup> Which cross-references Section 7.6 of the Code, Stacking Space, which requires different stacking spaces (both inbound and outbound) for various uses.

the building. The vehicle then enters the back of the building through a roll up door such that the customer and its vehicle enter the building, much like a vehicle would do for a garage use, and the minor automative repair then occurs to the vehicle. The vehicle then leaves the building from the front of the building through another roll up door. For the convenience of the customer, however, the client does not exit the vehicle while services are performed on the automobile. Rather the service personnel are located under the vehicle and within the 4 walls of the building. The average service time for a vehicle receiving the minor automative repair is approximately 15-20 minutes.

The City's drive-thru regulations, Section 4.22 (and, through that provision, Section 7.6), establish the stacking spaces which are required for different drive-thru uses. The Code specifies both inbound and outbound stacking spaces. A minor auto repair use is not an enunciated use under the drive-thru regulations, which means the Staff is to determine which enumerated use the proposed use most closely resembles and then those are the stacking spaces required for the new and/or unenumerated use. The Applicant believes that this use is more akin to a dry cleaning use which would only require 3 inbound stacking spaces and one outbound stacking space. However, the City has said that they view the Take 5 use as more closely resembling that of an automatic car wash. An automatic car wash requires 6 inbound stacking spaces and four outbound stacking spaces. The Applicant is requesting a variance with regard to the number of both inbound stacking spaces and outbound stacking spaces.

### Specific Criteria

1. That the request variance maintains the basic intent and purpose of the subject regulations, particularly as it affects the stability and appearance of the City.

The requested variance maintains the basic intent and purpose of the subject regulations. The Applicant is providing four outbound stacking spaces per drive-thru lane as part of its plan. The Applicant asserts that these will be a sufficient number of stacking The number of inbound stacking spaces provided would satisfy the Code if the Take 5 use were characterized as a dry cleaning establishment. In addition, the four inbound stacking spaces per drive-thru lane would be sufficient to satisfy the stacking requirements for the Take 5 use in other municipalities which have determined that a use like Take 5 does not require more than three inbound stacking spaces and no outbound stacking spaces. Take 5 asserts that no outbound stacking spaces are required because here will be no outbound stacking. Once the vehicle clears the bay the vehicles then proceeds to vacate the site. There is no reason for an outbound stacking space with this particular use.

In addition to the above, Take 5 has been in business and has operated its business in various states and locations (including within Florida) for over 5 years. In that period of time Take 5 has determined the volume of cars which are typically associated with its use. Since the average service time for a vehicle is between 15-20 minutes the four inbound staking spaces per drive-thru lane is more than enough to accommodate the use and the projected volumes which this use will generate. Take 5 also asserts that no outbound stacking spaces are required as the vehicles pay for the services while being serviced and when services are finished the vehicle just leaves the site immediately without any need for outbound stacking.

The variance also meets the intent and purpose of the Code as to stability and appearance of the

City. The variance will still allow Take 5 to provide what it believes will be sufficient stacking spaces for its use. These stacking spaces means that vehicles will be able to be retained onsite without impacting both site circulation or spilling outward onto the adjacent street. Additionally, the variance allows for stability in the City as it allows the automobile repair use to continue rather than this small property becoming vacant and underdeveloped and underutilized. The purpose of stacking spaces is to ensure that these goals are accomplished and the variance satisfies such goals of stability and appearance.

2. That the requested variance is otherwise compatible with the surrounding land uses and would not be detrimental to the community.

The requested variance is otherwise compatible with the surrounding land uses. The site is surrounded by commercial uses and this use mimics the use which has been taking place on the property for the past several years. The Applicant is still proposing and providing inbound stacking spaces as part of its plan and those stacking spaces will be enough to handle the volume which Take 5 anticipates which will be needed for the use. Thus, the variance is compatible with the community. In addition, the variance will not be detrimental to the community as the stacking spaces and escape lane allow both adequate on-site circulation and are sufficient to contain all automobile stacking on the property without any overflow onto adjacent streets.

3. That the requested variance is consistent with and in furtherance of the Goals, Objectives and Policies of the adopted Comprehensive Plan, the applicable neighborhood plan (if applicable) and all other similar plans adopted by the City.

The requested variance is consistent with the and in furtherance of the City's Comprehensive Plan. In particular the variance is consistent with the following provisions of the City's Comprehensive Plan:

General Statements: The proposed variances are consistent with the provisions which discuss platting and the land development regulations. The request made by the Applicant is consistent with both the platting requirements and the requirements of what is allowed under the City's Land Development Regulations.

Intensity Standard for Non-Residential Land Uses. The proposed variance is permitted and allowed under the City's Land Development Regulations and the Land Development Regulations specifically contemplate that at certain times and based upon particular circumstances that relief from the Land Development Regulations may be requested by variances.

- Policy 4.7: Evaluate nonconforming and grandfathered properties through proper procedures such as to include, but not be limited to future land use map amendment and official zoning map amendments.
- Policy 5.9: Maintain the Zoning and Development Regulations regarding non-conforming uses and amend these regulations to reduce the impact of these uses on surrounding areas and to require maximum consistency with the Zoning & Development Regulations.

Policy 8.5: Development permits granted by the City shall be consistent with the Development Review Requirements subsection.

The requested variance is also consistent with these Policies set forth in the City's Comprehensive Plan as the variance allows a legal non-conforming use to continue while allowing the use to adapt to modern times while also making improvements to the overall property which will be of a benefit to the local area.

To the best knowledge of the Applicant, there is no neighborhood plan or any other similar plan for the property in questions.

4. That the need for the variance is not economically based or self-imposed.

The need for the variance is not economically based or self-imposed. The need for the variance arises due to the City's interpretation of the number of stacking spaces that are required for a non-enumerated use. The City's drive-thru regulations do not contemplate the type of use that Take 5 proposes which is the variance is not economically based or self-imposed. The Take 5 use does not really require any staking spaces but the Code anticipates that both outbound stacking spaces are required and that more than 3 stacking spaces are necessary.

Furthermore, the need for the variance arises from the fact that the use is a legal non-conforming use and that impacts how development on the property has to occur. For instance, it means that the Applicant must utilize the building in its existing location and that the Applicant cannot fully redevelop the property. In addition, the size of the lot and the location of the building on the lot also impact the design of the site. These are elements that are beyond the control of the Applicant. The Applicant did not build the existing building.

Lastly, the size of the lot is overly small. The property is .33 acres which is smaller than a commercial lot. The undersized lot and the location of the building impact where the stacking spaces could be located and the size of the building necessitates where the stacking spaces could be located. All of this necessitates the variance but the variance is not economically based nor does this mean that the variance is self-imposed.

5. That the variance is necessary to comply with state or federal law and is the minimum variance necessary to comply with the applicable law.

While the variance is not necessary to comply with state or federal law, it is the minimum variance necessary. The Applicant is providing inbound stacking spaces and an escape lane as part of the proposed drive-thru facility which will be sufficient for the use. The Applicant has also added additional landscaping to the site. Thus, the Applicant has endeavored to meet all requirements of code, including those supplemental requirements associated with the drive-thru facility, and the variance is the minimum variance necessary while still meeting the intent of the Code. The stacking spaces provided by the Applicant will be sufficient to meet the actual stacking needs associated with the use.

# **SURROUNDING PROPERTIES**



6140-6144 Hollywood Blvd. (east)




6200 Hollywood Blvd. (west)



6171 Hollywood Blvd. - Checkers (north)

# SUBJECT PROPERTY

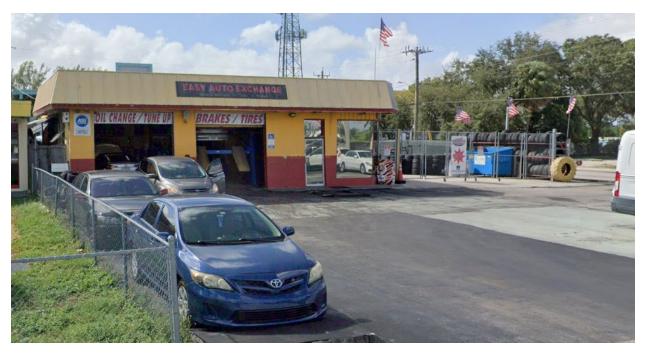


6190 Hollywood Blvd.

# VARIANCE REQUEST FOR PROPOSED TAKE 5

6190 HOLLYWOOD BLVD HOLLYWOOD, FL. 33023

DTI PROJECT #: 24050.01

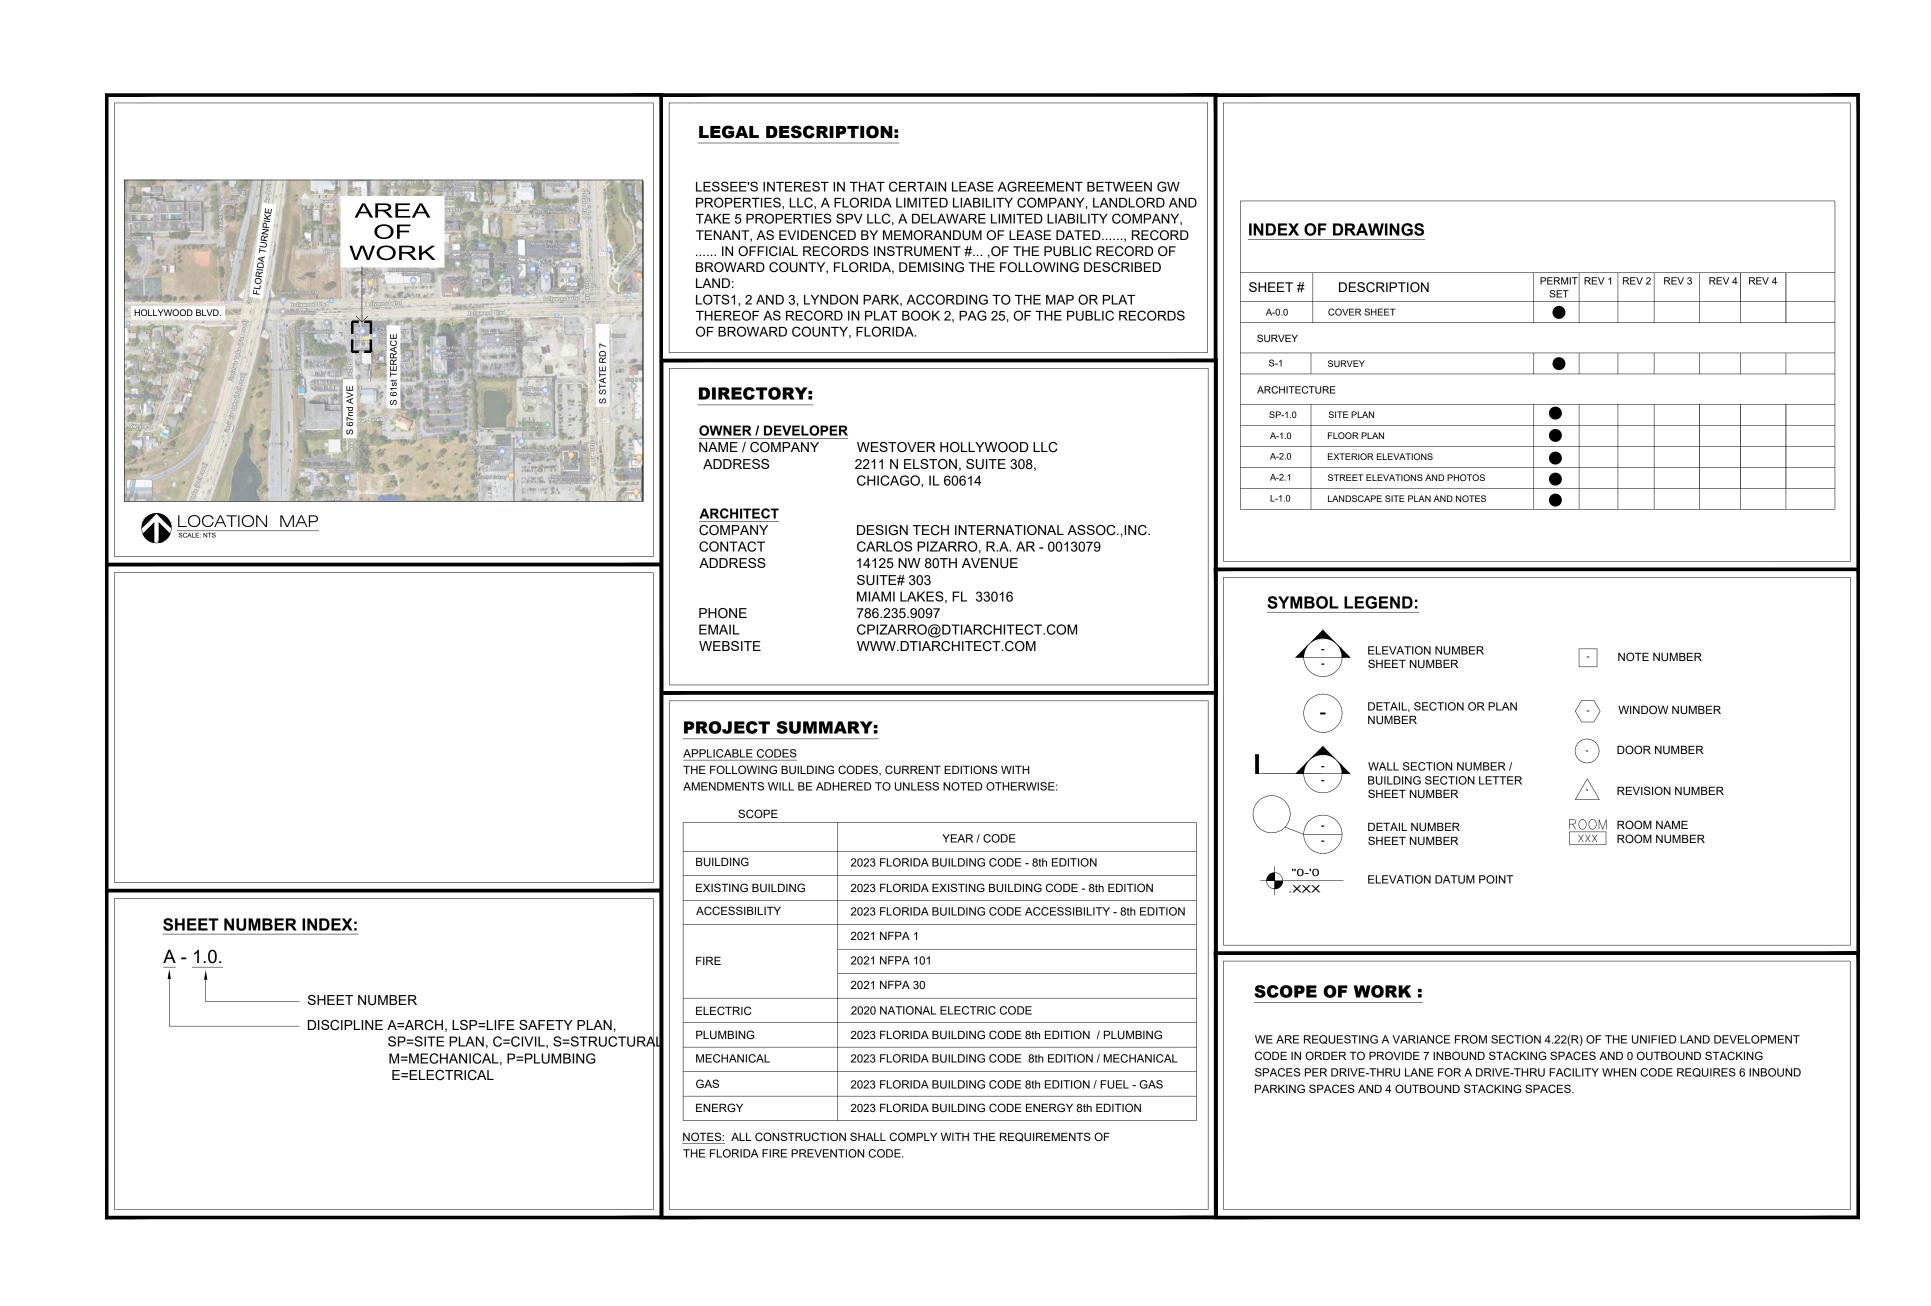

ARCHITECTS
Associates, Inc. AA26001933

ARCHITECTURE | PLANNING | INTERIOR DESIGN

14125 NW 80th Avenue Suite 303
Miami Lakes - Florida -33016
info@dtiarchitect.com
www.dtiarchitect.com



**O PLANTA**3D BLVD 33024

IANCE REQUEST FOR PROPOSED TAKE 5
6190 HOLLYWOOD BLVD

Job Number: 24050.01

File name:

Issued Date: 04-28-2025

Drawn by: J.M.


Checked by: T.R.


SHEET NAME

COVER

SHEET NUMBER

**A-0.0** 

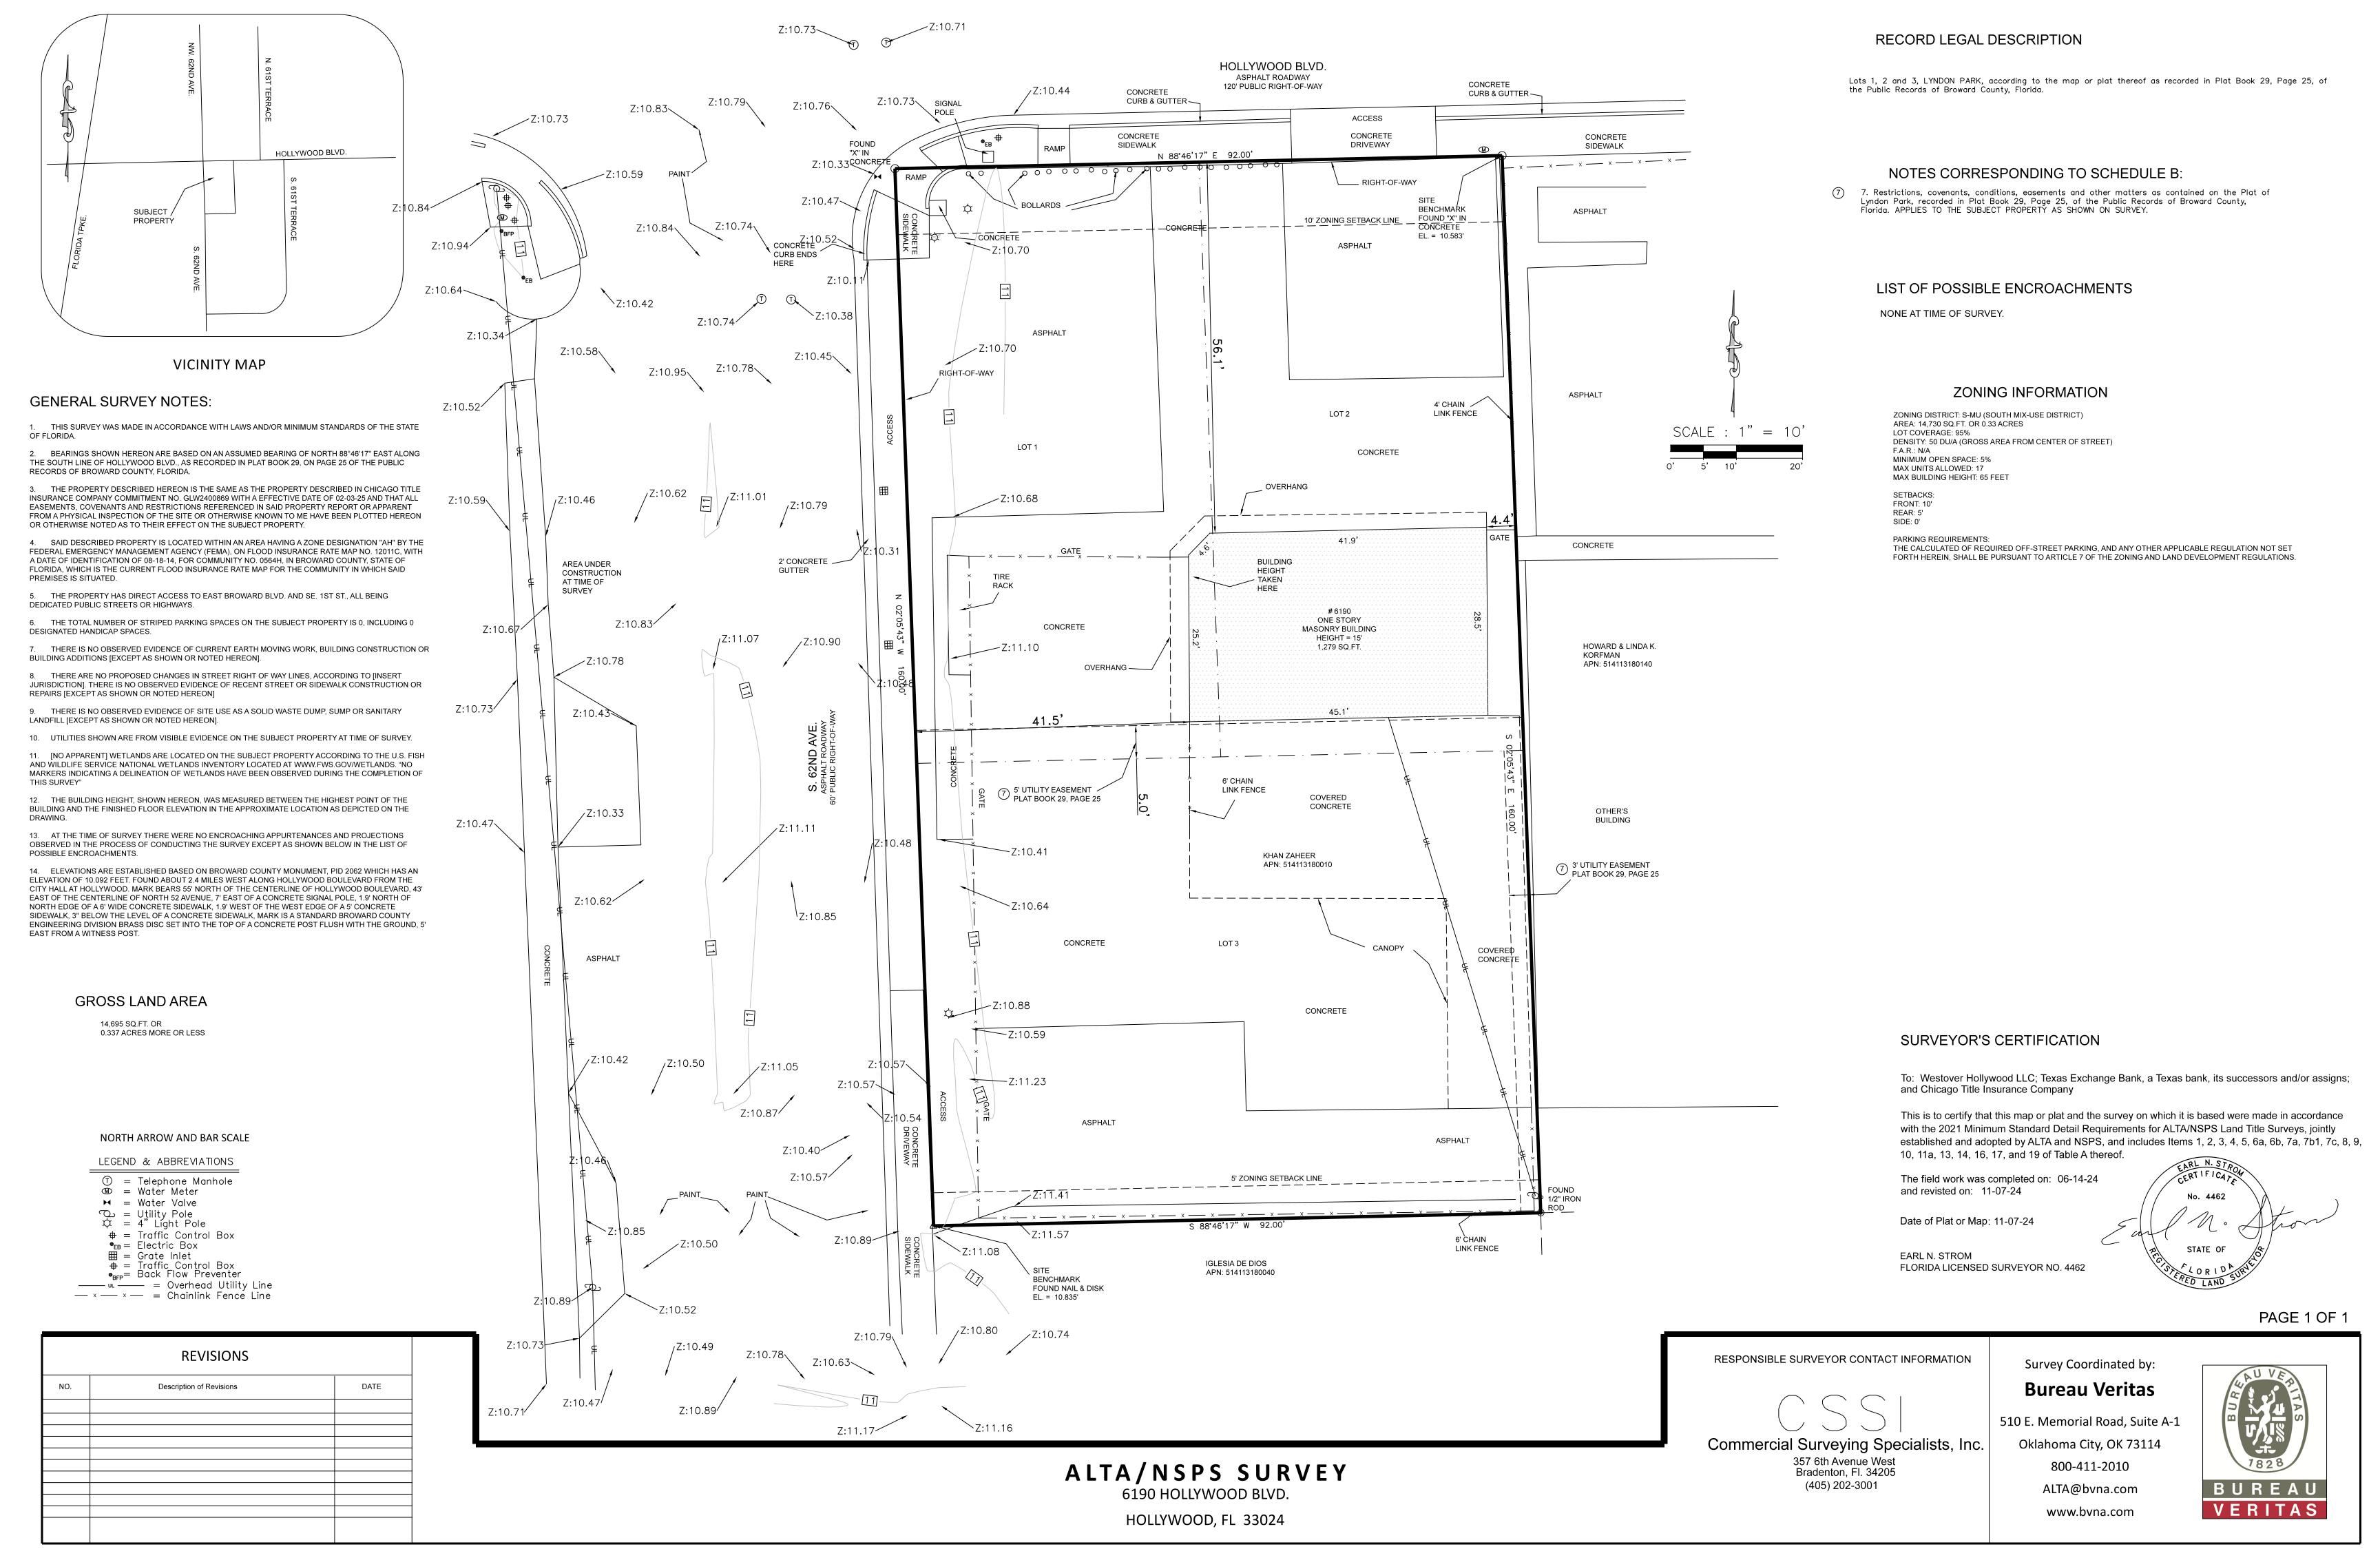

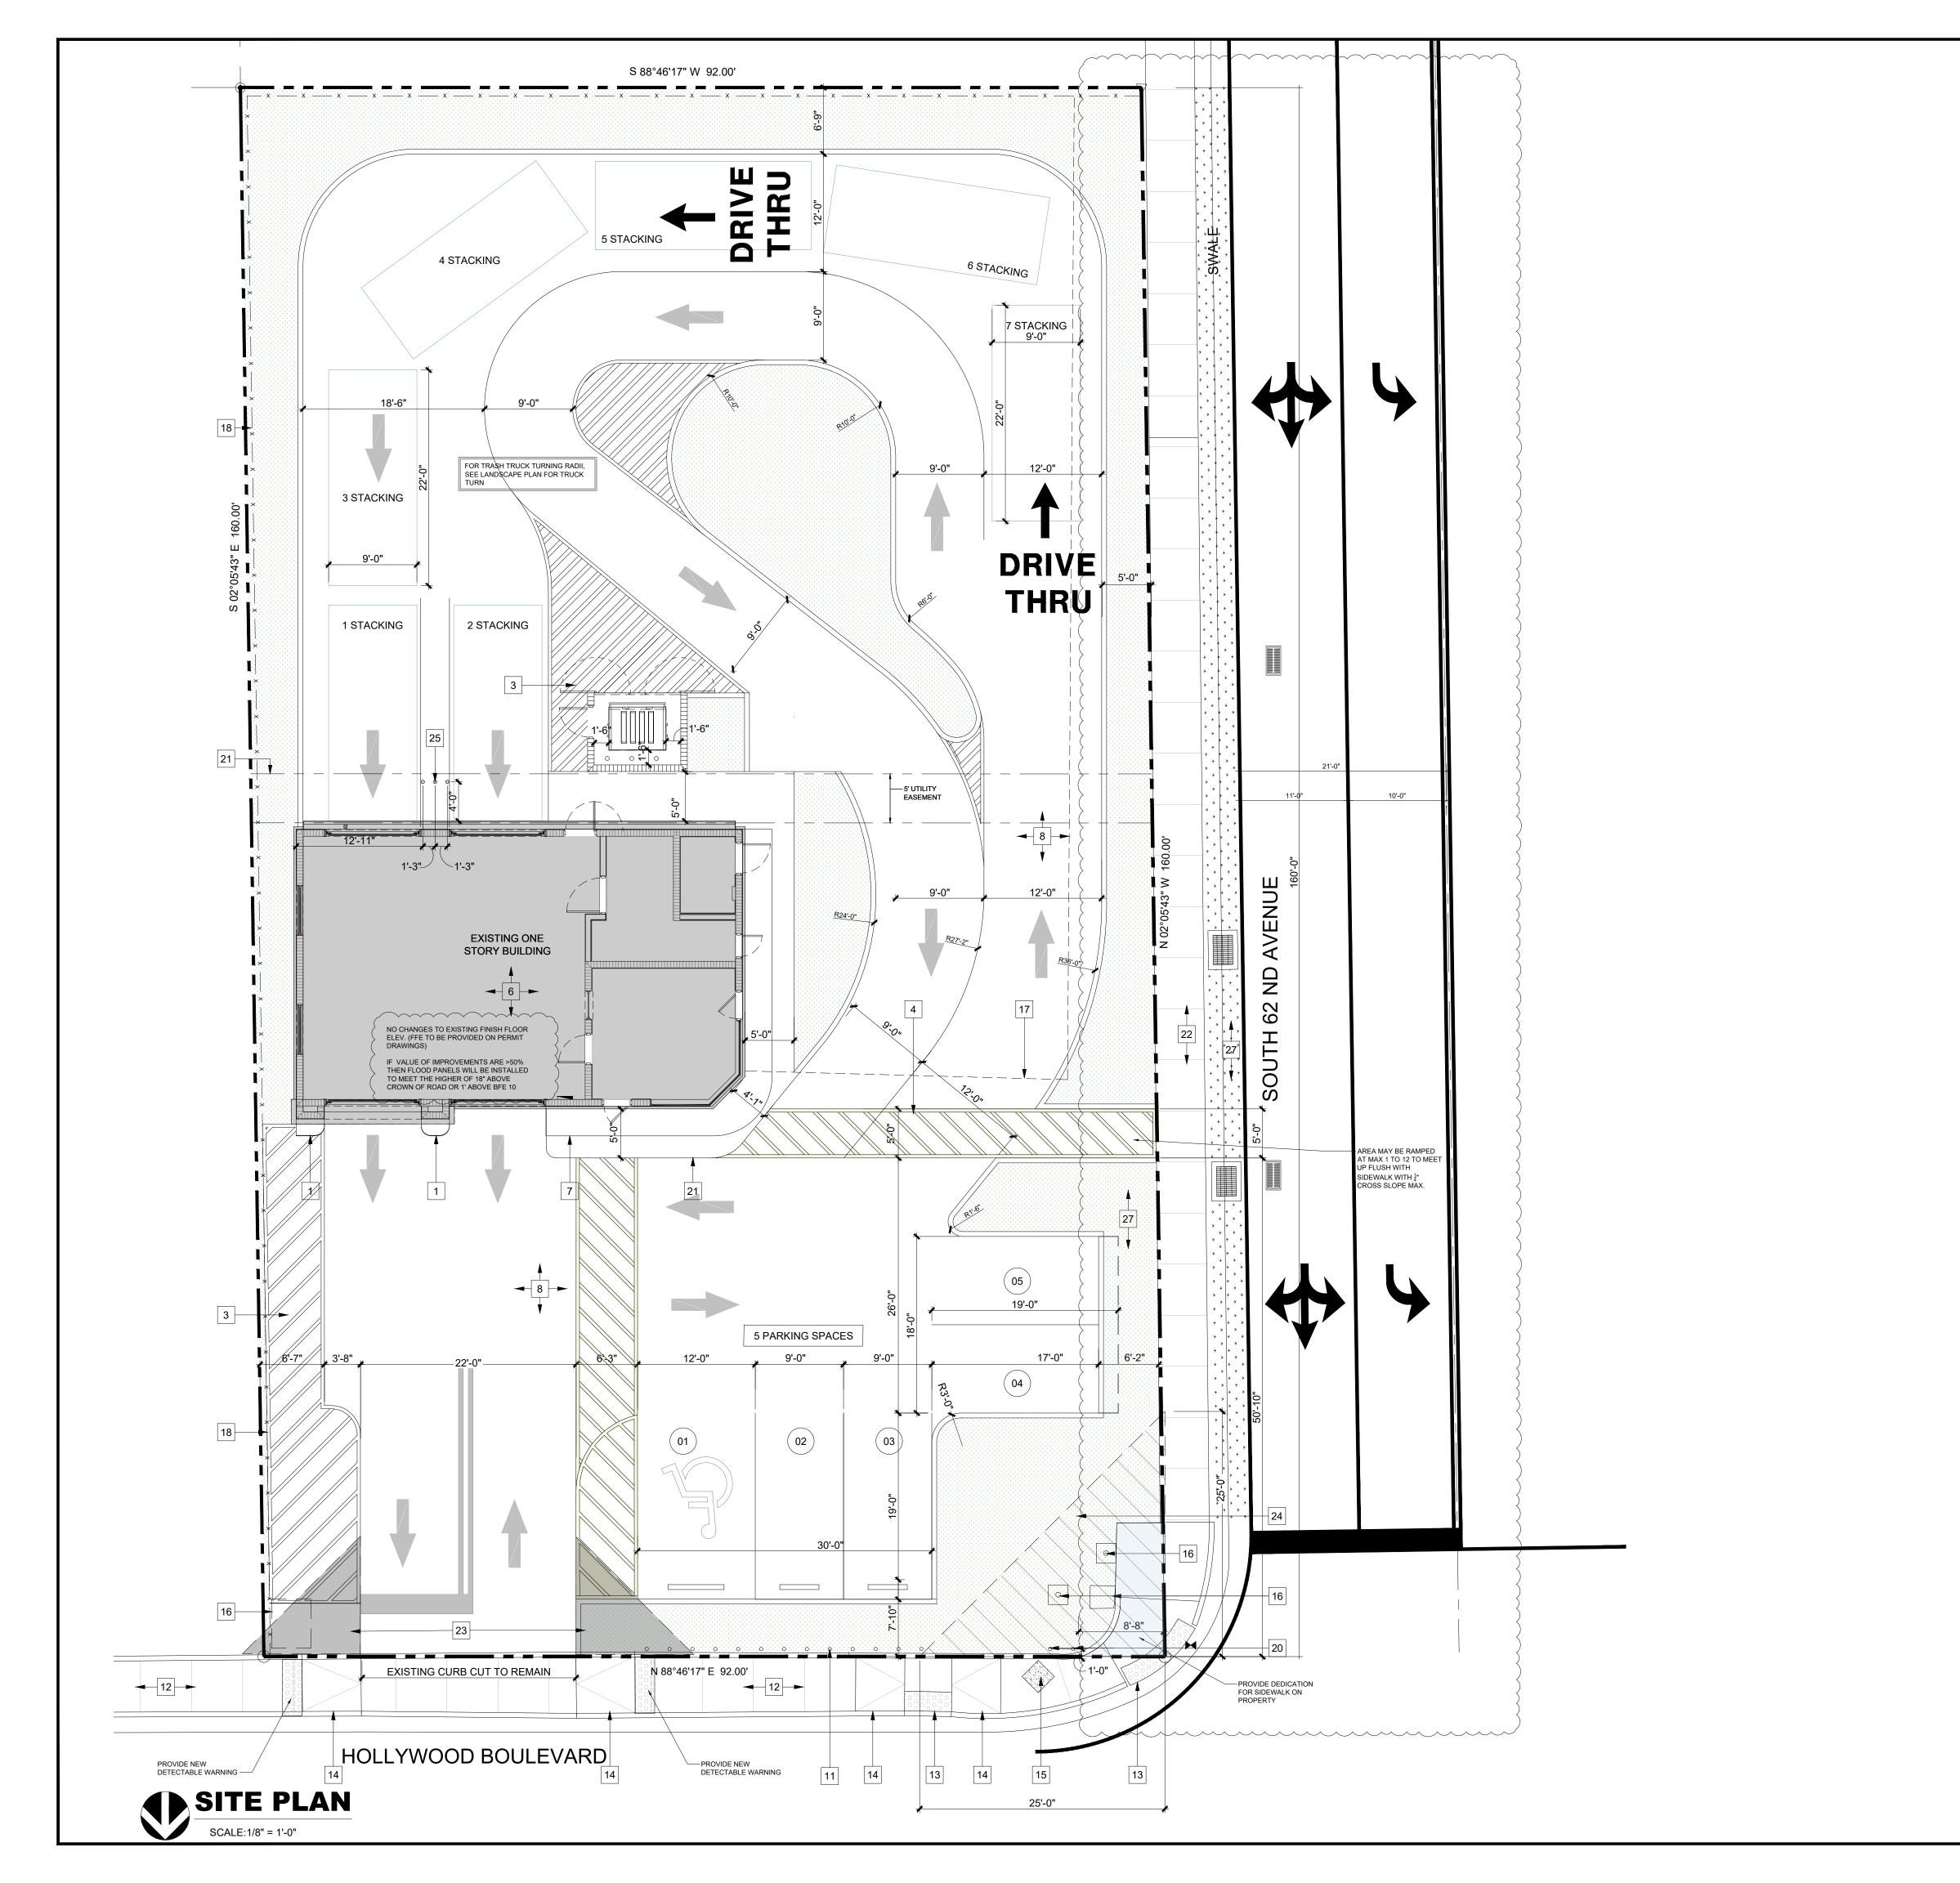

# **ZONING INFORMATION**

**ZONING:** S-MU (SOUTH MIX - USE DISTRICT 2)

**LAND AREA:** 14,730 SF = 0.338 ACRE

**BUILDING AREA:** 1,279 SF

X 0.2 PERCENT ANNUAL

CHANCE FLOOD HAZARD

FEMA FLOOD ZONE:
AH 0.2 PERCENT ANNUAL CHANCE
FLOOD HAZARD, AH COASTAL FLOODPLAIN,

**PROPERTY ID:** 514113180010

**CURRENT USE:** REPAIR GARAGE (NO CHANGES IN USE)

# **PARKING REQUIRMENTS:**

AUTO REPAIR - 1 PER 400 SF BUILDING SQFT: 1,027 SQFT REQUIRED PARKING: 3

1 PER 250 SF OFFICE SQFT: 230 SQFT **REQUIRED PARKING: 1** TOTAL REQUIRED PARKING: 4

TOTAL PROPOSED PARKING: 5

ANY LIP FROM 1/4" BUT NOT GREATER THAN 1/2" WILL BE BEVELED TO MEET ADA REQUIREMENTS

THE SCOPE OF WORK ON THE PROJECT IS FOR A FACADE AND INTERIOR RENOVATION. DUE TO THE REQUEST FOR STACKING BEING PROVIDED ON SITE, PAVEMENT MARKINGS AND CURBS HAVE BEEN PROVIDED.

SITE DRAINAGE IS NOT BEING MODIFIED, HOWEVER ADDITIONAL LANDSCAPE IS BEING PROVIDED WHICH WILL HELP THE EXISTING DRAINAGE ON SITE.

THE EXISTING BUILDING HAS A ROOF THAT IS COLLECTED BY A GUTTER AND DOWNSPOUT WHICH IS DISPELLED BY A SPLASHBLOCK ON GRADE. NO CHANGES HAVE BEEN MADE.

# **SITE PLAN KEYED NOTES:**

- 1 EXISTING CURB
- 2 EXISTING LANDSCAPE AREA TO BE RESODDED
- 4" WIDE WHITE STRIPES, VEHICULAR PAINT, TYPICAL. (SEE SITE DETAILS ON SHEET SP-1.1)
- ACCESSIBLE PEDESTRIAN AREA, 4" WIDE YELLOW STRIPES, VEHICULAR PAINT, MAX 1:20 SITE SLOPE CONTRACTOR TO VERIEVE EXCESSION. MAX 1:20 SITE SLOPE CONTRACTOR TO VERIFY IF EXCEEDED, NOTIFY ARCHITECT, CROSS SLOPE MAX AT 1:48
- 5 CONCRETE TRASH ENCLOSURE (SEE SITE PLAN DETAILS)
- 6 EXISTING ONE STORY BUILDING
- 7 EXISTING CONCRETE SIDEWALK TO BE DEMOLISHED
- 8 EXISTING ASPHALT/ CONCRETE DRIVE NO CHANGES.
- 9 ACCESSIBLE PARKING SPACE TO BE LEVEL 1/4" MAX SLOPE PER FOOT. IF NOT, NOTIFY ARCHITECT.
- ADA PARKING STALL (SEE SITE PLAN DETAILS)
- 11 EXISTING BOLLARDS TO REMAIN
- 12 EXISTING CONCRETE SIDEWALK (NO CHANGES )
- | 13 | EXISTING DETECTABLE WARNING SURFACE (NO CHANGES)
- 14 EXISTING RAMPS
- 15 EXISTING STREET LIGHT
- 16 EXISTING CONCRETE FOUNDATIONS, LIGHT POLES TO BE DEMOLISHED
- 17 EXISTING FENCE/ GATE TO BE DEMOLISHED
- EXISTING CHAIN LINKED FENCE WITH SCREENING TO REMAIN.
- 19 NEW LIGHT POLE (SEE ELECTRICAL )
- REPLACE 2 DAMAGED BOLLARDS WITH NEW 6" CONCRETE FILLED BOLLARDS. SEE DETAIL SP- 1/1.1
- 21 5' UTILITY EASEMENT
- 22 NEW CONCRETE SIDEWALK.
- 12' X 12' VISIBILITY TRIANGLE. NO GATES, FENCES OR WALLS INSIDE THIS AREA, LANDSCAPING SHALL BE NO TALLER THAN 72".
- 25' X 25' CORNER SETBACK. NO FENCE INSIDE THIS ARE, LANDSCAPING SHALL BE NO TALLER THAN 2'-0".
- NEW 4" STEEL BOLLARDS PAINTED CAUTION YELLOW (SEE SITE PLAN DETAILS SP- 4/1.1)
- 26 NEW CONCRETE CURB.
- NEW TO BE GRADED AND SLOPED TO EXISTING CATCH BASINS

Associates, Inc. AA26001933

14125 NW 80th Avenue Suite 303 Miami Lakes - Florida -33016 info@dtiarchitect.com

www.dtiarchitect.com



Carlos Pizarro, R.A. AR - 0013079

Revisions:

10-17-2024

04-08-2025

07-18-2025

V.

Job Number: 24050.01

File name:

Issued Date: 04-28-2025


Drawn by: J.M. Checked by: T.R.

SHEET NAME

SITE PLAN

SHEET NUMBER

**SP-1.0** 

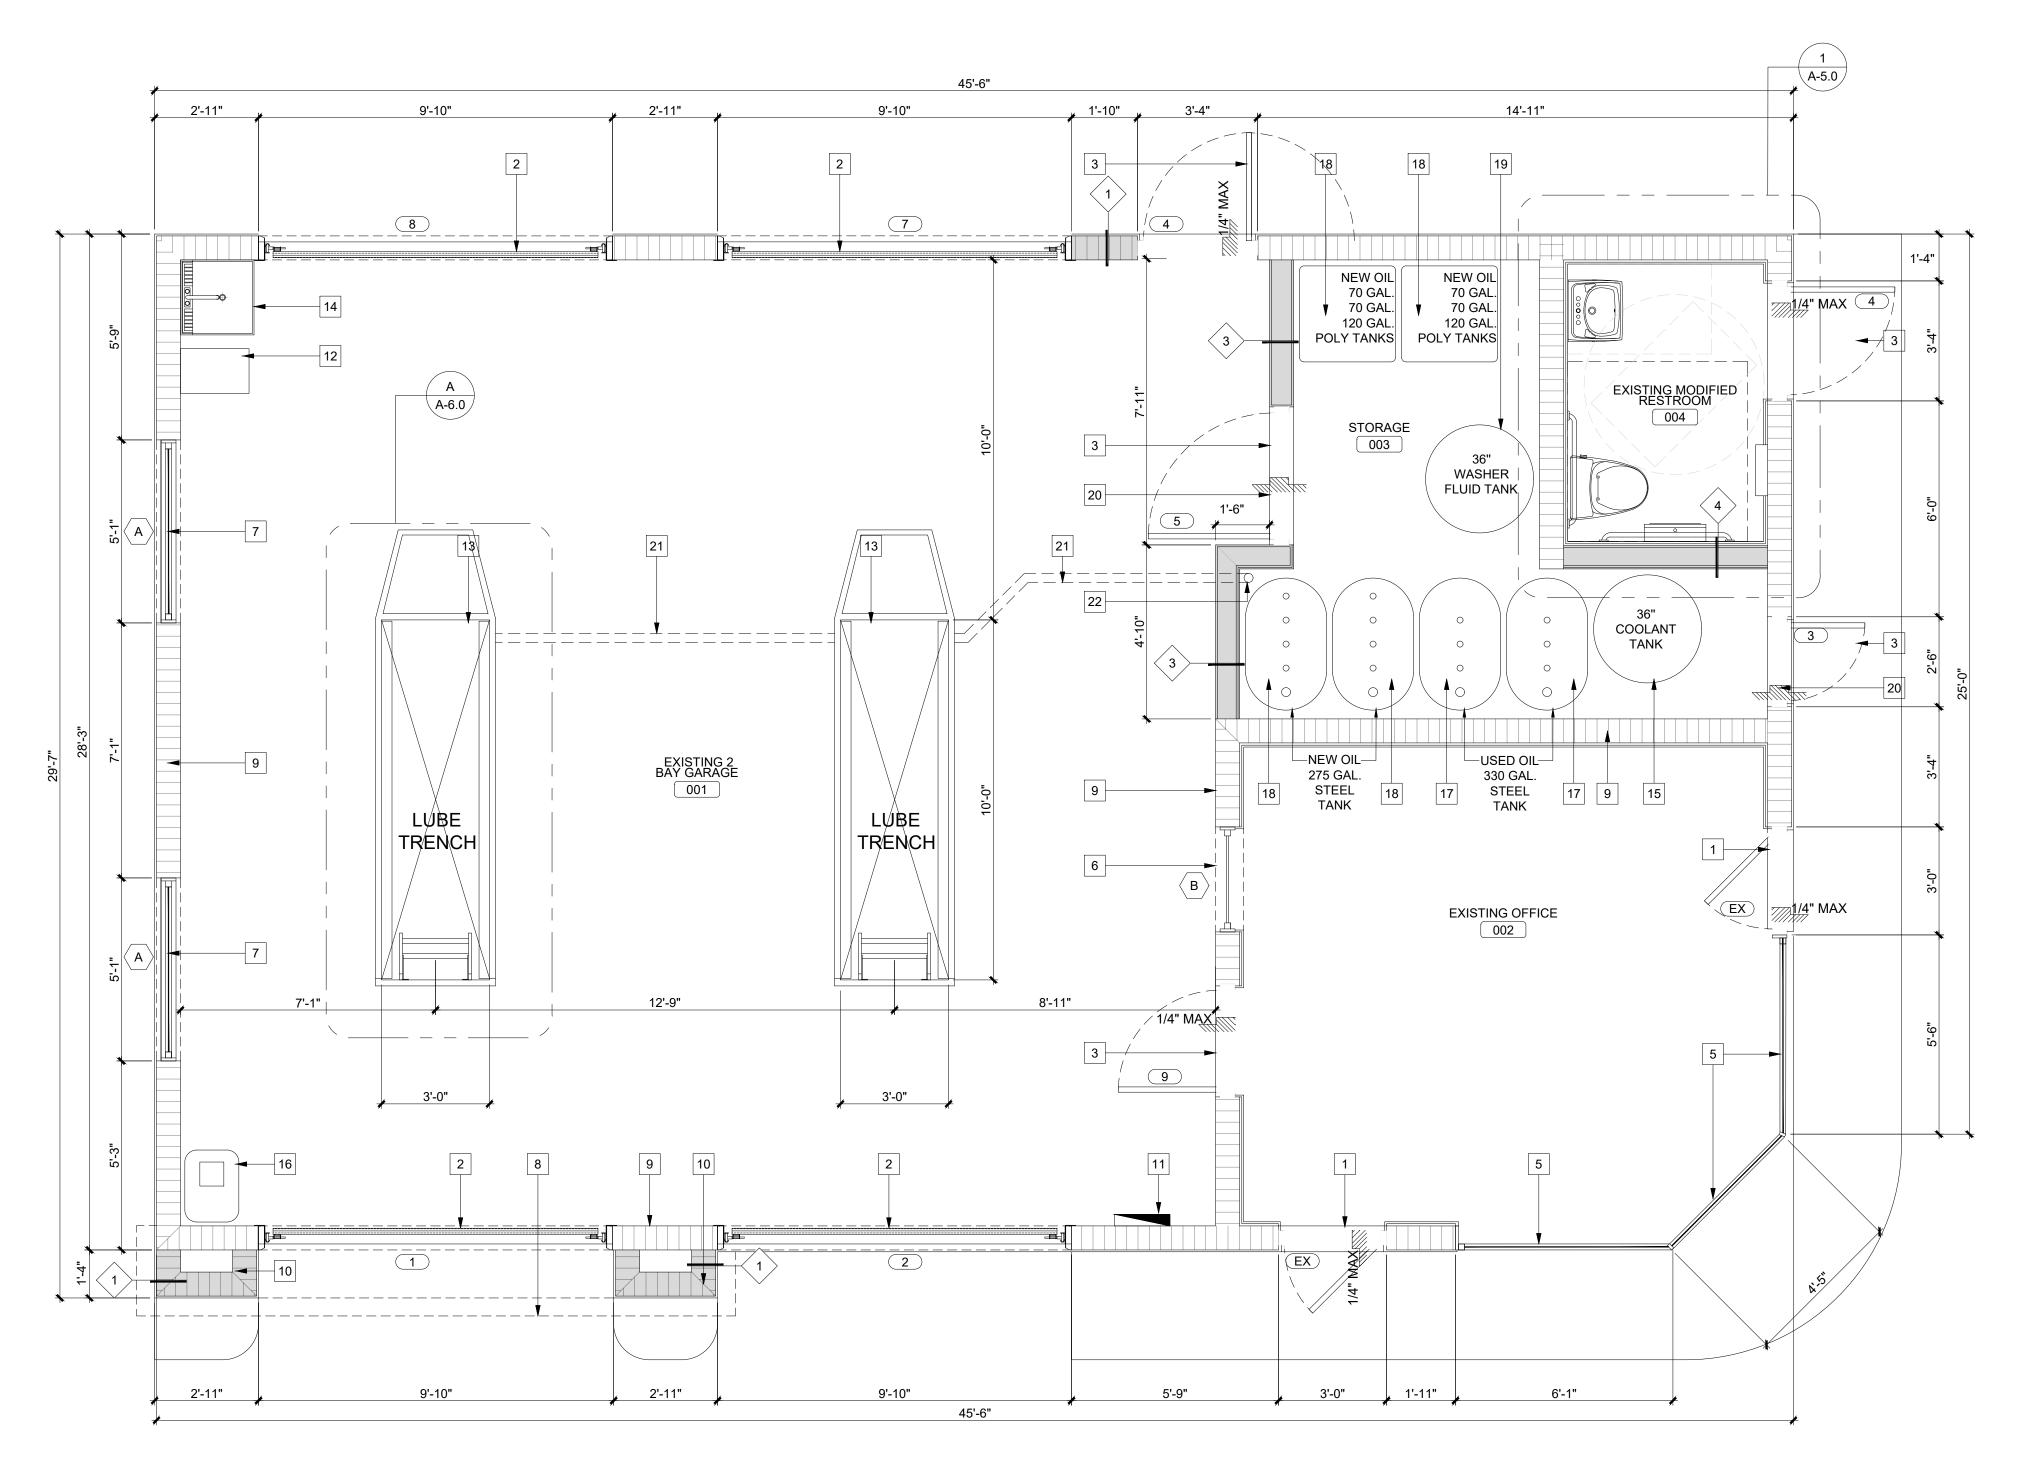

# PROPOSED GROUND FLOOR PLAN SCALE:3/8" = 1'-0"

### PER 803.1.1 FBC INTERIOR WALL AND CEILING FINISH MATERIALS SHALL BE CLASSIFIED IN ACCORDANCE WITH ASTM E84 OR UL 723. SUCH INTERIOR FINISH MATERIALS SHALL BE GROUPED IN THE FOLLOWING CLASSES IN ACCORDANCE WITH THEIR FLAME SPREAD AND SMOKE-DEVELOPED

CLASS C:FLAME SPREAD INDEX 76-200; SMOKE DEVELOPED INDEX 0-450.

GC SHALL BE REQUIRED TO COORDINATE W/ SECURITY CONTRACTOR INSTALLING CAMERA'S AND OTHERS SECURITY DEVICES. SECURITY CONTRACTED DIRECTLY TO OWNER.

# **WALL TYPES LEGEND:**

NEW 8" CMU/CONC. WALL W/ 5/8" STUCCO FINISH OUTSIDE, AND TRIPLE COAT PAINTED FINISH IN SIDE WHERE NECESSARY.

EXISTING 8" CMU/CONC. WALL W/ 5/8" STUCCO FINISH OUTSIDE

NEW PAINTED  $\frac{5}{8}$ " DENSARMOR OVER 6" METAL STUD W/ PAINTED  $\frac{1}{2}$ " PLYWOOD 4' HIGH OVER 5" DENSARMOR, INTERIOR OIL STORAGE SIDE.

NEW PAINTED  $\frac{5}{8}$ " DENSARMOR OVER 6" METAL STUD W/ PAINTED  $\frac{1}{2}$ " PLYWOOD 4' HIGH OVER  $\frac{5}{8}$ " DENSARMOR OVER TILE & GROUT.

# **STUCCO NOTES:**

1-STUCCO OVER FRAMING SHALL BE 3 COATS STUCCO OVER PAPER BACKED METAL LATH (1) LAYER 30 LB ON 3 /4" EXTERIOR GRADE FIRE RETARDANT TREATED PLYWOOD SHEATHING W/ # 10-16 SCREWS AT 4" O.C.

2-STUCCO OVER MASONRY OR CONCRETE SHALL BE 2 COATS STUCCO. WHERE NEW STUCCO IS A CONTINUATION OF EXISTING, NEW STUCCO SHALL BE SAME THICKNESS, AS FLUSH SURFACE WITH AND FINISH TO MATCH EXISTING. NOTE: PLYWOOD TO BE RETARDANT TREATED WOOD BY SECTION 603.1 FBC. G.C. PROVIDE SEALED ENGINEERED METAL STUD SHOP DWG , RE: SECTION 106.3.5 OF THE SCC CH. 40 APP. A

# **METAL FRAME NOTES:**

1-MTL. STUDS BY SPECIALITY ENGINEER SUBMIT S&S CALCULATION & SHOP DRAWINGS FOR REVIEW. 2-CONNECTION OF METAL STUDS TO STRUCTURE BY SPECIALITY ENGINEER.

# NOTE:

GENERAL CONTRACTOR VERIFY IN FIELD ALL INFORMATION GIVEN IN THIS PLAN TO MEET FBC AND FLORIDA NFPA CODE AND STANDARDS.

# **FLOOR PLAN LEGEND:**

EXISTING MASONRY WALL TO REMAIN

**NEW MASONRY WALL** 

DOOR TAG. REFER TO DOOR SCHEDULE.

WINDOW TAG. REFER TO WINDOW SCHEDULE

WALL TYPE TAG. REFER TO WALL TYPES LEGEND ON THIS SHEET.

# **FLOOR PLAN KEY NOTES:**

1 EXISTING DOOR TO BE REMAIN

2 NEW OVERHEAD GARAGE DOOR, SEE A-4.0

3 NEW HOLLOW METAL SWING DOOR

4 EXISTING ALUMINUM-GLASS DOOR TO REMAIN

5 EXISTING ALUMINUM-GLASS STORE FRONT TO REMAIN. REMOVE PAINT & RE CAULK SYSTEM

6 EXISTING INTERIOR WINDOW (SEE WINDOW SCHEDULED)

7 NEW FIXED WINDOW (SEE WINDOW SCHEDULED)

8 EDGE OF OVERHANG ROOF LINE ABOVE

9 EXISTING WALL

10 PROPOSED CMU BUMP-OUT

11 EXISTING ELECTRICAL PANEL TO REMAIN

12 GREASE INTERCEPTOR, (SEE MECHANICAL DRAWINGS)

OIL PIT (SEE STUCT. PLANS.)

14 NEW UTILITIES (SEE PLUMBING)

COOLANT TANK, PROVIDED BY OWNER GC TO INSTALL

AIR COMPRESSOR PROVIDED BY OWNER GC TO INSTALL

USED OIL TANK PROVIDED BY OWNER GC TO INSTALL NEW OIL POLY TANK PROVIDED BY OWNER GC TO INSTALL

WASHER FLUID TANK PROVIDED BY OWNER GC TO INSTALL


6" HIGH CONCRETE CURB SURROUNDING STORAGE ROOM

3" DIAMETER PVC OVER FLOW PIPE. USE SWEEPS AT TURNS.

3" DIAMETER PVC FLOOR DRAIN, TERMINATE 2" ABOVE FLOOR. REFER TO PLUMBING

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Carlos Pizarro, R.A. AR - 0013079

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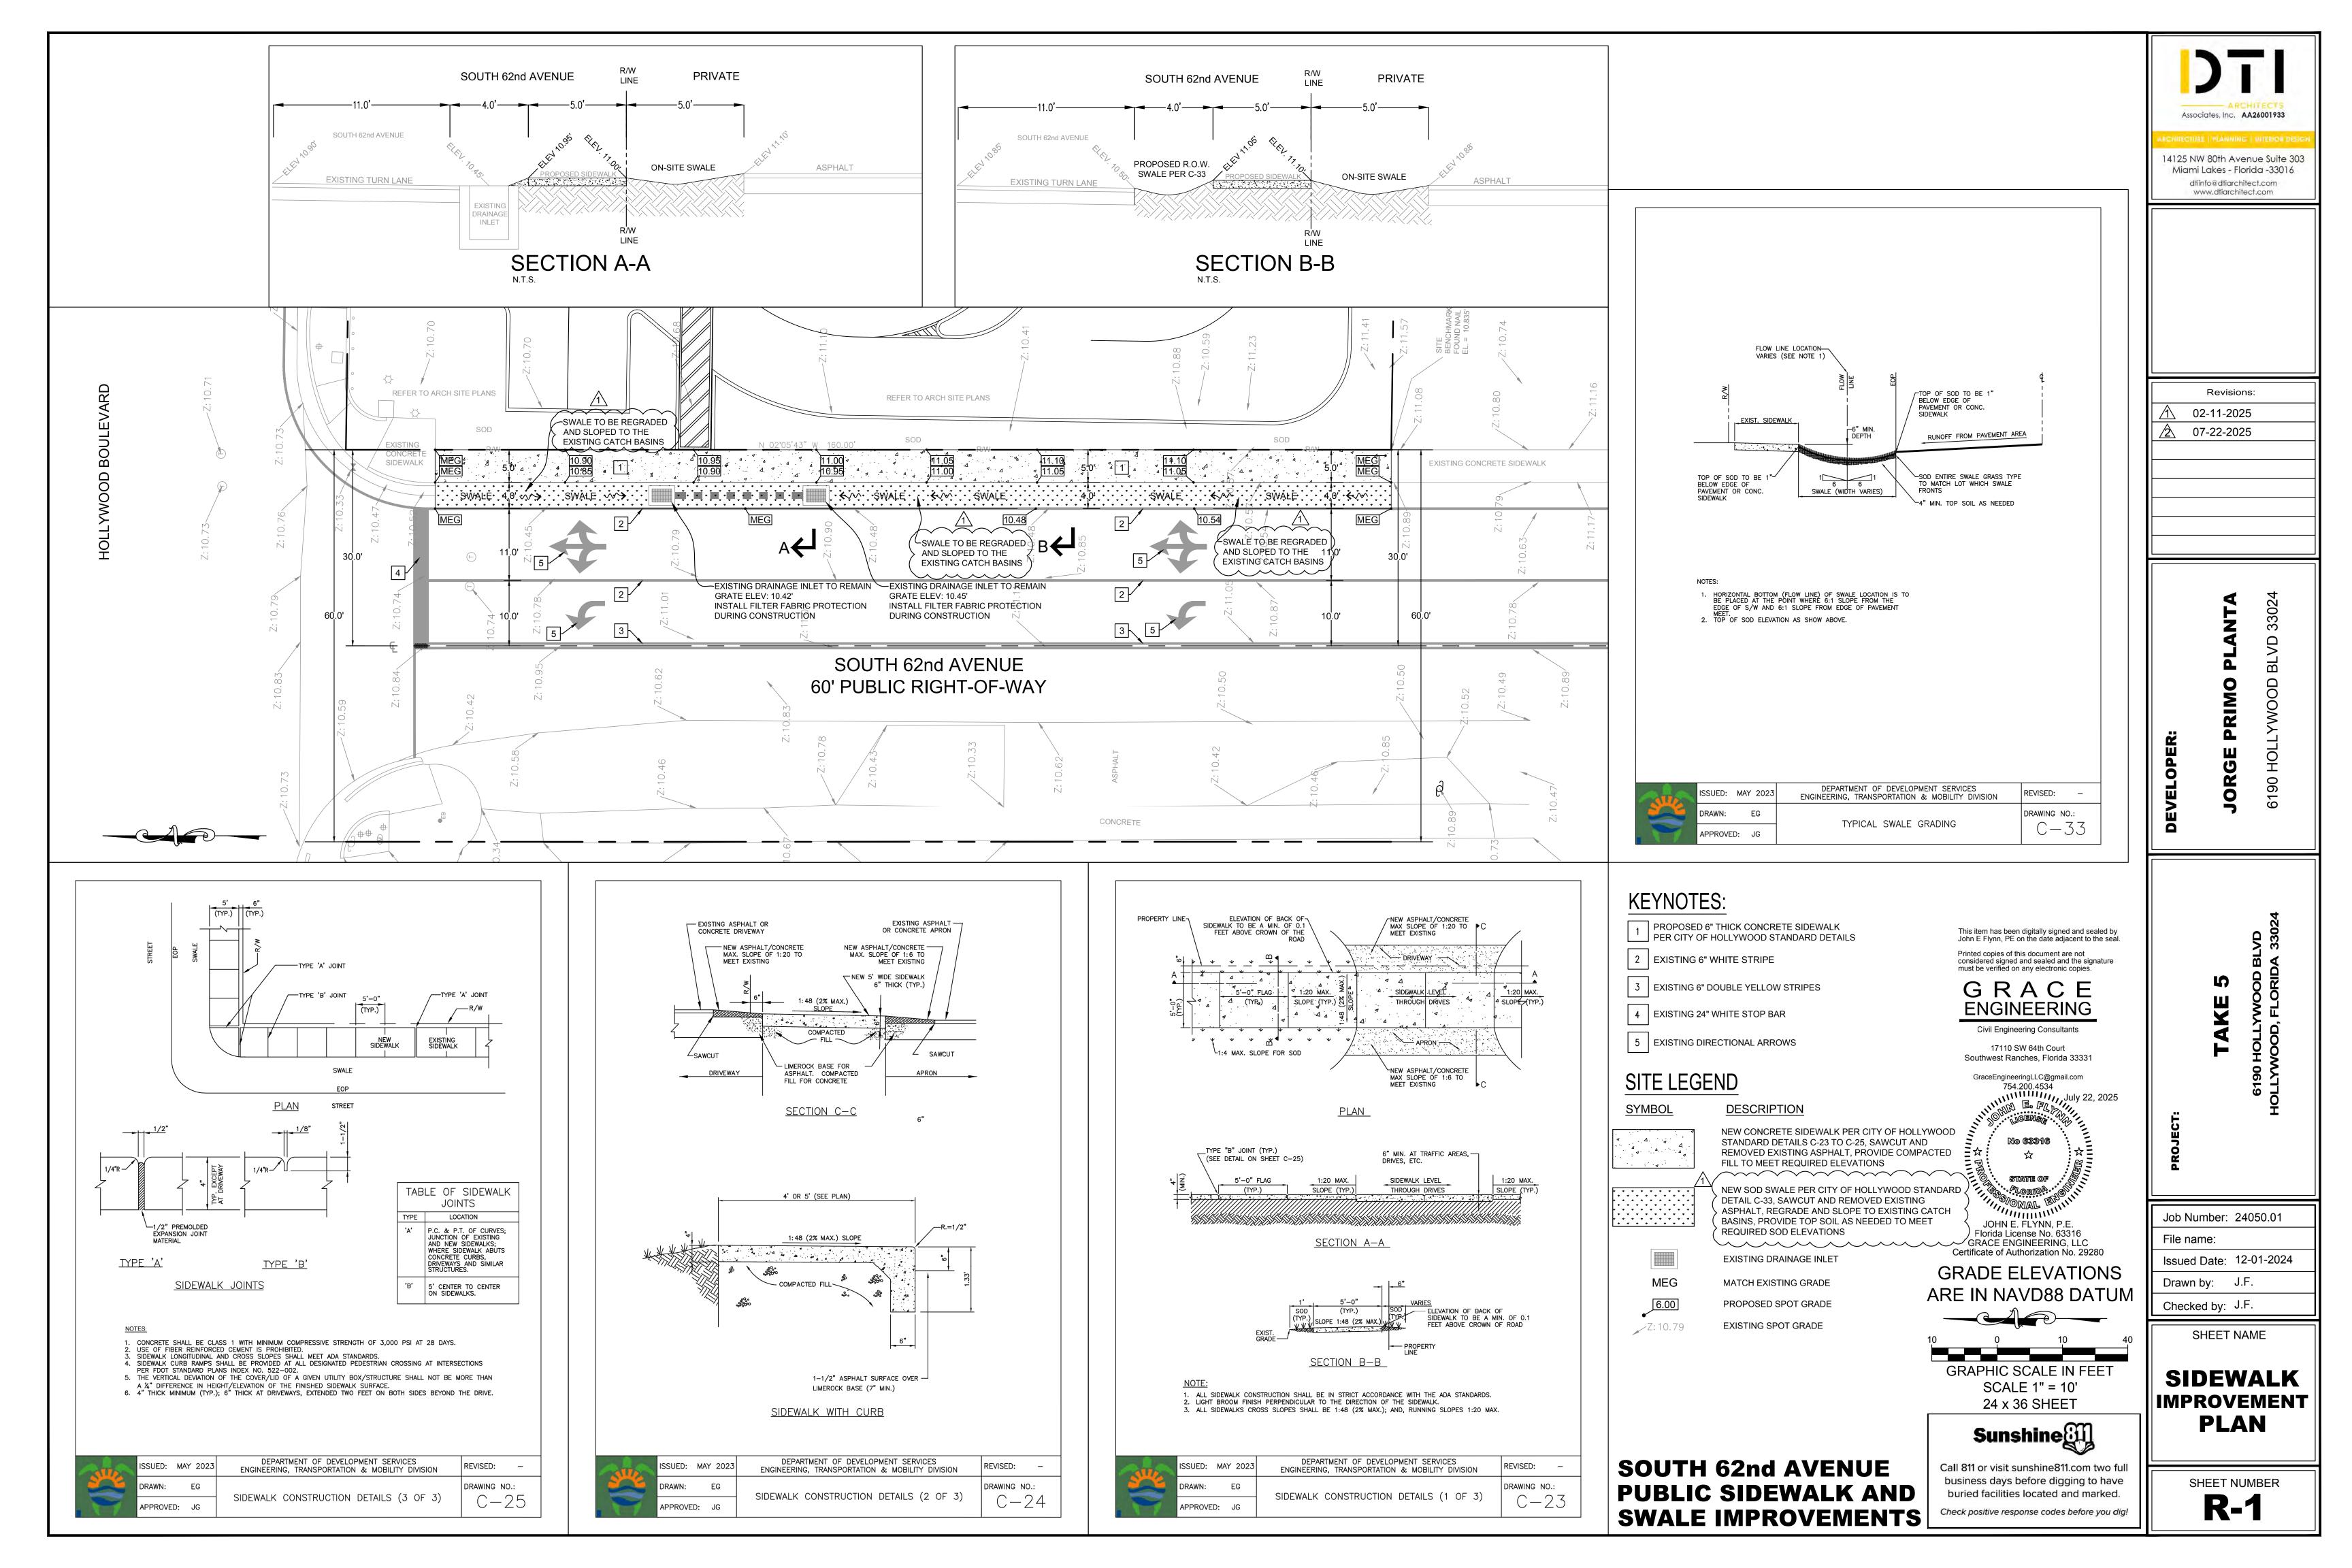
Checked by: T.R.

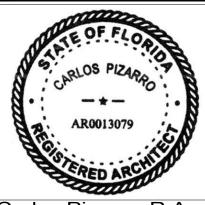SHEET NAME

**GROUND FLOOR PLANS** 

SHEET NUMBER

**A-1.0** 



### GENERAL NOTES

1. THE INFORMATION PROVIDED IN THESE DRAWINGS IS SOLELY TO ASSIST THE CONTRACTOR IN ASSESSING THE NATURE AND EXTENT OF CONDITIONS WHICH WILL BE ENCOUNTERED DURING THE COURSE OF THE WORK. THE CONTRACTORS ARE DIRECTED, PRIOR TO BIDDING, TO CONDUCT WHATEVER INVESTIGATIONS THEY DEEM NECESSARY TO ARRIVE AT THEIR OWN CONCLUSION REGARDING THE ACTUAL CONDITIONS THAT WILL BE ENCOUNTERED. AND UPON WHICH BIDS WILL BE BASED.

2. ALL CONSTRUCTION AND MATERIALS SHALL CONFORM TO APPLICABLE STANDARDS AND SPECIFICATIONS OF THE CITY OF HOLLYWOOD DEPARTMENT OF DEVELOPMENT SERVICES, ENGINEERING, TRANSPORTATION & MOBILITY DIVISION, AND ALL OTHER LOCAL, STATE AND NATIONAL CODES, WHERE APPLICABLE.

3. LOCATIONS, ELEVATIONS, SIZES, MATERIALS, ALIGNMENTS, AND DIMENSIONS OF EXISTING FACILITIES, UTILITIES AND OTHER FEATURES ARE SHOWN ACCORDING TO THE BEST INFORMATION AVAILABLE AT THE TIME OF THE PREPARATION OF THESE PLANS; AND DO NOT PURPORT TO BE ABSOLUTELY CORRECT. ALSO, THERE MAY HAVE BEEN OTHER IMPROVEMENTS, UTILITIES, ETC., WITHIN THE PROJECT AREA WHICH WERE CONSTRUCTED AFTER THE PREPARATION OF THESE PLANS AND/OR THE ORIGINAL SITE SURVEY. THE CONTRACTOR SHALL VERIFY THE LOCATIONS, ELEVATIONS, AND OTHER FEATURES AFFECTING HIS/HER WORK PRIOR TO CONSTRUCTION, AND NOTIFY THE ENGINEER IMMEDIATELY WHEN CONFLICT BETWEEN DRAWINGS AND ACTUAL CONDITIONS ARE DISCOVERED. THE ENGINEER ASSUMES NO RESPONSIBILITY FOR ANY FACILITIES SHOWN OR NOT SHOWN ON THE PLANS. THE CONTRACTOR SHALL WORK AS NEEDED TO AVOID CONFLICT WITH EXISTING UTILITIES (NO ADDITIONAL COST SHALL BE PAID FOR THIS WORK). EXISTING UTILITIES SHALL BE MAINTAINED IN SERVICE DURING CONSTRUCTION UNLESS OTHERWISE APPROVED BY THE RESPECTIVE UTILITY

4. THE CONTRACTOR IS REQUIRED TO OBTAIN ALL APPLICABLE CONSTRUCTION AND ENVIRONMENTAL PERMITS PRIOR TO THE START OF CONSTRUCTION.

5. THE CONTRACTOR SHALL NOTIFY PUBLIC UTILITIES AT LEAST 48 HOURS PRIOR TO BEGINNING 6. PRIOR TO THE COMMENCEMENT OF CONSTRUCTION AND INSTALLATION OF THE PROPOSED IMPROVEMENTS, IT IS THE CONTRACTOR'S RESPONSIBILITY TO OBTAIN ANY OTHER AGENCY SHOP DRAWING APPROVAL, IF

7. ELEVATIONS SHALL BE IN FEET AND REFERENCED TO THE NORTH AMERICAN VERTICAL DATUM OF 1988

8. CITY OF HOLLYWOOD SHALL NOT PROVIDE STAGING/STORAGE AREA. CONTRACTOR SHALL SECURE STAGING/STORAGE AREA AS NECESSARY FOR CONSTRUCTION WORK.

9. CONTRACTOR SHALL HAUL AWAY EXCESSIVE STOCKPILE OF SOIL FOR DISPOSAL EVERY DAY. NO STOCKPILE SOIL IS ALLOWED TO BE LEFT ON THE CONSTRUCTION SITE OVER NIGHT. 10. CONTRACTOR SHALL CLEAN/SWEEP THE ROAD AT LEAST ONCE A DAY OR AS REQUIRED BY THE

11. CONTRACTOR SHALL PROTECT CATCH BASINS WITHIN/ADJACENT TO THE CONSTRUCTION SITE AS REQUIRED BY NPDES REGULATIONS.

12. CITY OF HOLLYWOOD HAS A NOISE ORDINANCE (CHAPTER 100) WHICH PROHIBITS EXCAVATION AND CONSTRUCTION BEFORE 8:00 A.M. AND AFTER 6:00 P.M., MONDAY THROUGH SATURDAY AND ALL DAY SUNDAY. 13. SUITABLE EXCAVATED MATERIAL SHALL BE USED IN FILL AREAS. NO SEPARATE PAY ITEM FOR THIS WORK, INCLUDE COST IN OTHER ITEMS.

14. THE CONTRACTOR SHALL REPLACE ALL PAVING, STABILIZING EARTH, DRIVEWAYS, PARKING LOTS, SIDEWALKS, ETC. TO SATISFY THE INSTALLATION OF THE PROPOSED IMPROVEMENTS WITH THE SAME TYPE OF MATERIAL THAT WAS REMOVED DURING CONSTRUCTION.

15. THE CONTRACTOR SHALL NOT ENCROACH INTO PRIVATE PROPERTY WITH PERSONNEL, MATERIAL OR EQUIPMENT. IN CASE WORK ON PRIVATE PROPERTY IS NEEDED, A CITY OF HOLLYWOOD "RIGHT OF ENTRY" FORM MUST BE SIGNED BY PROPERTY OWNER AND THE DIRECTOR OF DEVELOPMENT SERVICES. THE CONTRACTOR IS RESPONSIBLE TO MAINTAIN ACCESS AT ALL TIMES TO PRIVATE HOMES/BUSINESSES. 16. THE CONTRACTOR SHALL BE RESPONSIBLE FOR DAMAGE, REMOVAL OR MODIFICATION, CAUSED TO ANY IRRIGATION SYSTEM (PRIVATE OR PUBLIC) ACCIDENTALLY OR PURPOSELY. THE CONTRACTOR SHALL REPLACE ANY DAMAGED, REMOVED OR MODIFIED IRRIGATION PIPES, SPRINKLER HEADS OR OTHER PERTINENT

APPURTENANCES TO MATCH OR EXCEED EXISTING CONDITIONS AT NO ADDITIONAL COST TO THE CITY. 17. MAIL BOXES, FENCES OR OTHER PRIVATE PROPERTY DAMAGED DURING THE CONSTRUCTION OF THE PROPOSED IMPROVEMENTS SHALL BE REPLACED TO MATCH OR EXCEED EXISTING CONDITION.

AUA	ISSUED:	MAY 2023	DEPARTMENT OF DEVELOPMENT SERVICES ENGINEERING, TRANSPORTATION & MOBILITY DIVISION	REVISED: -
	DRAWN:	EG	GENERAL NOTES (1 OF 2)	DRAWING NO.:
	APPROVE	D: JG	GENERAL NOTES (1 OF 2)	C-01

18. CONTRACTOR SHALL PROVIDE MAINTENANCE OF TRAFFIC IN ACCORDANCE WITH FDOT STANDARD PLANS INDEX, LATEST EDITION, AND CITY OF HOLLYWOOD DEPARTMENT OF DEVELOPMENT SERVICES STANDARDS. 19. NO TREES ARE TO BE REMOVED OR RELOCATED WITHOUT PRIOR APPROVAL FROM THE CITY ENGINEER.

20. THE CONTRACTOR IS RESPONSIBLE FOR OBTAINING THE NECESSARY TREE REMOVAL OR RELOCATION PERMITS FROM THE CITY OF HOLLYWOOD BUILDING DEPARTMENT FOR TREES LOCATED IN THE PUBLIC RIGHT 21. IT IS THE INTENT OF THESE PLANS TO BE IN ACCORDANCE WITH APPLICABLE CODES AND AUTHORITIES

HAVING JURISDICTION. ANY DISCREPANCIES BETWEEN THESE PLANS AND APPLICABLE REGULATORY STANDARDS/REQUIREMENTS SHALL BE IMMEDIATELY BROUGHT TO THE ATTENTION OF CITY ENGINEER. 22. THE CONTRACTOR SHALL BE RESPONSIBLE FOR MAINTAINING THE INTEGRITY OF AND MAKING THE REPAIRS TO EXISTING PAVEMENT, SIDEWALKS, PIPES, CONDUITS, CURBS, CABLES, ETC., WHETHER OR NOT SHOWN ON THE PLANS DAMAGED AS A RESULT OF THE CONTRACTORS OPERATIONS AND/OR THOSE OF HIS SUBCONTRACTORS, AND SHALL RESTORE THEM PROMPTLY AT NO ADDITIONAL EXPENSE TO THE OWNER.

23. WHERE NEW PAVEMENT MEETS EXISTING, CONNECTION SHALL BE MADE IN A NEAT STRAIGHT LINE AND FLUSH WITH EXISTING PAVEMENT TO MATCH EXISTING CONDITIONS. 24. UNDER NO CIRCUMSTANCES SHALL THE CONTRACTOR LEAVE EXCAVATED TRENCHES, OR PARTS OF, EXPOSED OR OPENED AT THE END OF THE WORKING DAY, WEEKENDS, HOLIDAYS OR OTHER TIMES, WHEN

CONTRACTOR SHALL REPORT ANY DAMAGE TO SIDEWALK, DRIVEWAY, ETC., PRIOR TO BEGINNING WORK IN ANY

THE CONTRACTOR IS NOT WORKING, UNLESS OTHERWISE DIRECTED. ALL TRENCHES SHALL BE COVERED, FIRMLY SECURED AND MARKED ACCORDINGLY FOR PEDESTRIAN/VEHICULAR TRAFFIC. 25. ALL EXCAVATED MATERIAL REMOVED FROM THIS PROJECT SHALL BE DISPOSED OF OFF THE PROPERTY

BY THE CONTRACTOR AT THE CONTRACTOR'S EXPENSE. 26. ALL RAMPS, SIDEWALK CURB RAMPS, AND, ACCESSIBLE ROUTES SHALL BE ADA COMPLIANT AND SHALL BE IN ACCORDANCE WITH FDOT STANDARD PLANS INDEX, LATEST EDITION.

27. ALL GRASSED AREAS AFFECTED BY CONSTRUCTION SHALL BE RE-SODDED. 28. THE CONTRACTOR SHALL BE RESPONSIBLE FOR THE PROVISION, INSTALLATION AND MAINTENANCE OF ALL TRAFFIC CONTROL AND SAFETY DEVICES, IN ACCORDANCE WITH SPECIFICATIONS OF THE LATEST REVISION OF FDOT DESIGN STANDARDS. IN ADDITION, THE CONTRACTOR IS RESPONSIBLE FOR THE RESETTING OF ALL TRAFFIC CONTROL AND INFORMATION SIGNAGE REMOVED DURING THE CONSTRUCTION PERIOD.

29. EXCAVATED OR OTHER MATERIAL STORED ADJACENT TO OR PARTIALLY UPON A ROADWAY PAVEMENT SHALL BE ADEQUATELY MARKED FOR TRAFFIC SAFETY AT ALL TIMES. 30. TEMPORARY PATCH MATERIAL MUST BE ON THE JOB SITE WHENEVER PAVEMENT IS CUT, OR THE CITY'S INSPECTOR WILL SHUT THE JOB DOWN.

31. CONTRACTOR MUST PROVIDE FLASHER ARROW SIGNAL FOR ANY LANE THAT IS CLOSED OR DIVERTED. 32. THE CITY PREFERS THAT IT'S OWN POLICE OFFICERS PROVIDE TRAFFIC CONTROL TO ENSURE SAFE AND EFFICIENT INTERSECTION OPERATIONS IS MAINTAINED THROUGHOUT THE DURATION OF CONSTRUCTION, THEREFORE, PLEASE CONTACT MR. JANEL DIXON TO ARRANGE FOR A DETAIL TO PROVIDE THIS SERVICE. HE MAY BE REACHED AT 954-967-4500 OR VIA EMAIL AT jdixon@hollywoodfl.org.

33. CONTRACTOR TO RESTORE PAVEMENT TO ORIGINAL CONDITION AS REQUIRED, REFER TO BCTED, PAVING MARKINGS AND SIGNS DETAILS PLAN, LATEST EDITION.

34. THE CONTRACTOR SHALL GIVE AT LEAST 48 HOURS NOTICE TO UTILITY COMPANIES TO PROVIDE FOR THE LOCATION OF EXISTING UNDERGROUND UTILITIES IN ADVANCE OF CONSTRUCTION. CONTACT UTILITIES NOTIFICATION CENTER AT 811 OR 1-800-432-4770 (SUNSHINE ONE-CALL OF FLORIDA).




AU.	ISSUED:	MAY 2023	DEPARTMENT OF DEVELOPMENT SERVICES ENGINEERING, TRANSPORTATION & MOBILITY DIVISION	REVISED: -
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APPRO	APPROVE	D: JG	GENERAL NOTES (2 OF 2)	C-02


# <u>STANDARD PROCEDURE FOR ROW PERMITS:</u>

- 1. ENGINEERING DIVISION WILL NOT ISSUE R.O.W. PERMITS UNTIL THE UTILITY COMPANY SCHEDULE AND ATTEND A PRE-CONSTRUCTION MEETING.
- 2. A REPRESENTATIVE FROM THE UTILITY COMPANY MUST ATTEND THE PRE-CONSTRUCTION MEETING, ALONG WITH THE CONTRACTOR AND/OR SUB-CONTRACTOR ACTUALLY PERFORMING THE WORK. CONTACT INFORMATION FOR THE UTILITY COMPANY REPRESENTATIVE AND THE CONTRACTOR PERFORMING THE WORK MUST BE PROVIDED FOR EACH PROJECT DURING THE PRE-CONSTRUCTION MEETING.
- 3. PERMITS WILL BE ISSUED FOR A DEFINED PERIOD OF TIME, AND ARE ONLY VALID DURING THE SPECIFIED TIME. THE PERMIT DURATION WILL BE DETERMINED DURING PLAN REVIEW AND WILL BE BASED ON THE SCOPE OF WORK. THE PERMIT WILL ONLY BE VALID DURING THE TIME PERIOD STATED ON THE APPROVED PLANS.
- 4. WHEN CROSSING OF THE CITY'S CRITICAL OPERATIONAL INFRASTRUCTURE, WHICH IS GENERALLY ANY UTILITY PIPE SIZES 12" AND GREATER, UTILITY COMPANY MUST SUBMIT A SIGNED LETTER FROM AN AUTHORIZED PERSON FROM THE COMPANY, ACKNOWLEDGING THAT THE PROJECT PROPOSES TO CROSS SUCH INFRASTRUCTURE. THIS LETTER SHOULD BE SUBMITTED DURING INITIAL PERMIT SUBMITTAL TO PREVENT DELAYS IN ISSUANCE OF R.O.W. PERMIT. THE LETTER SHALL BE ACCOMPANIED BY A MAP SHOWING THE LOCATION OF ALL SUCH CRITICAL INFRASTRUCTURE BEING CROSSED AND SUCH MAP SHALL BE ON THE COVER PAGE OF THE PERMIT PLAN SET.
- 5. PERMITS MUST BE ONSITE DURING CONSTRUCTION. ANY CITY EMPLOYEE WITH PROPER IDENTIFICATION CAN STOP AND ASK A CONTRACTOR FOR THEIR PERMITTED SET OF PLANS, AND STOP WORK FOR ANY CONTRACTOR WHO DO NOT PRESENT A VALID PERMITTED SET OF PLANS. A CONTRACTOR WORKING OUTSIDE OF THE PERMIT ISSUANCE WINDOW IS CONSIDERED TO BE WORKING WITHOUT A PERMIT, AND WILL BE SUBJECT TO ISSUANCE OF A VIOLATION FOR DOING WORK WITHOUT A PERMIT. VIOLATIONS FOR WORK WITHOUT A PERMIT CAN RESULT IN SUSPENSION OF A CONTRACTOR'S ABILITY TO OBTAIN PERMITS TO WORK WITHIN THE CITY.
- 6. WHEN A PROPOSED UTILITY CROSSES AN EXISTING CITY GRAVITY SANITARY SEWER OR DRAINAGE PIPE, THE UTILITY COMPANY MUST TELEVISE THE PIPE, AND PROVIDE VIDEO AT THE POINT OF CROSSING. A CLEAR SKETCH WITH DIMENSIONS MUST BE PROVIDED IDENTIFYING THE CROSSING POINT. THIS HAS TO BE DONE PRIOR TO SCHEDULING FINAL INSPECTION.
- 7. WHENEVER A PROPOSED UTILITY CROSSES EXISTING CITY UTILITIES, THE DEPTH OF THE EXISTING CITY UTILITIES MUST BE FIELD VERIFIED VIA SOFT DIGS, OR OTHER ACCEPTABLE METHODS THAT CAN ACCURATELY DETERMINE THE TRUE DEPTH OF THE EXISTING UTILITY. IF A METHOD OTHER THAN SOFT DIG IS UTILIZED TO IDENTIFY THE DEPTH OF EXISTING UTILITIES. THE PERMITTEE MUST NOTIFY THE CITY OF THE METHOD, AND PROVIDE INFORMATION ATTESTING TO THE ACCURACY OF THE METHOD. MINIMUM VERTICAL AND HORIZONTAL SEPARATIONS NOTED ON THE APPROVED PLANS MUST BE PROVIDED.
- 8. PRIOR TO FINAL INSPECTION, AN AS-BUILT PLAN AND BORE LOG MUST BE SUBMITTED TO THE CITY FOR REVIEW. THE AS-BUILT PLAN MUST CLEARLY IDENTIFY THE DEPTH OF THE CITY'S EXISTING UTILITY AT THE POINT WHERE THE NEWLY INSTALLED UTILITY CROSSES IT, AND THE DEPTH AT WHICH THE NEW UTILITY WAS INSTALLED. THIS IS TO VERIFY THAT PROPER SEPARATION DISTANCES HAVE BEEN PROVIDED.

The same	ISSUED: MAY 2023	DEPARTMENT OF DEVELOPMENT SERVICES ENGINEERING, TRANSPORTATION & MOBILITY DIVISION	REVISED: -
	DRAWN: EG	ROW PERMITS STANDARD PROCEDURE	DRAWING NO.:
	APPROVED: JG		C - 03

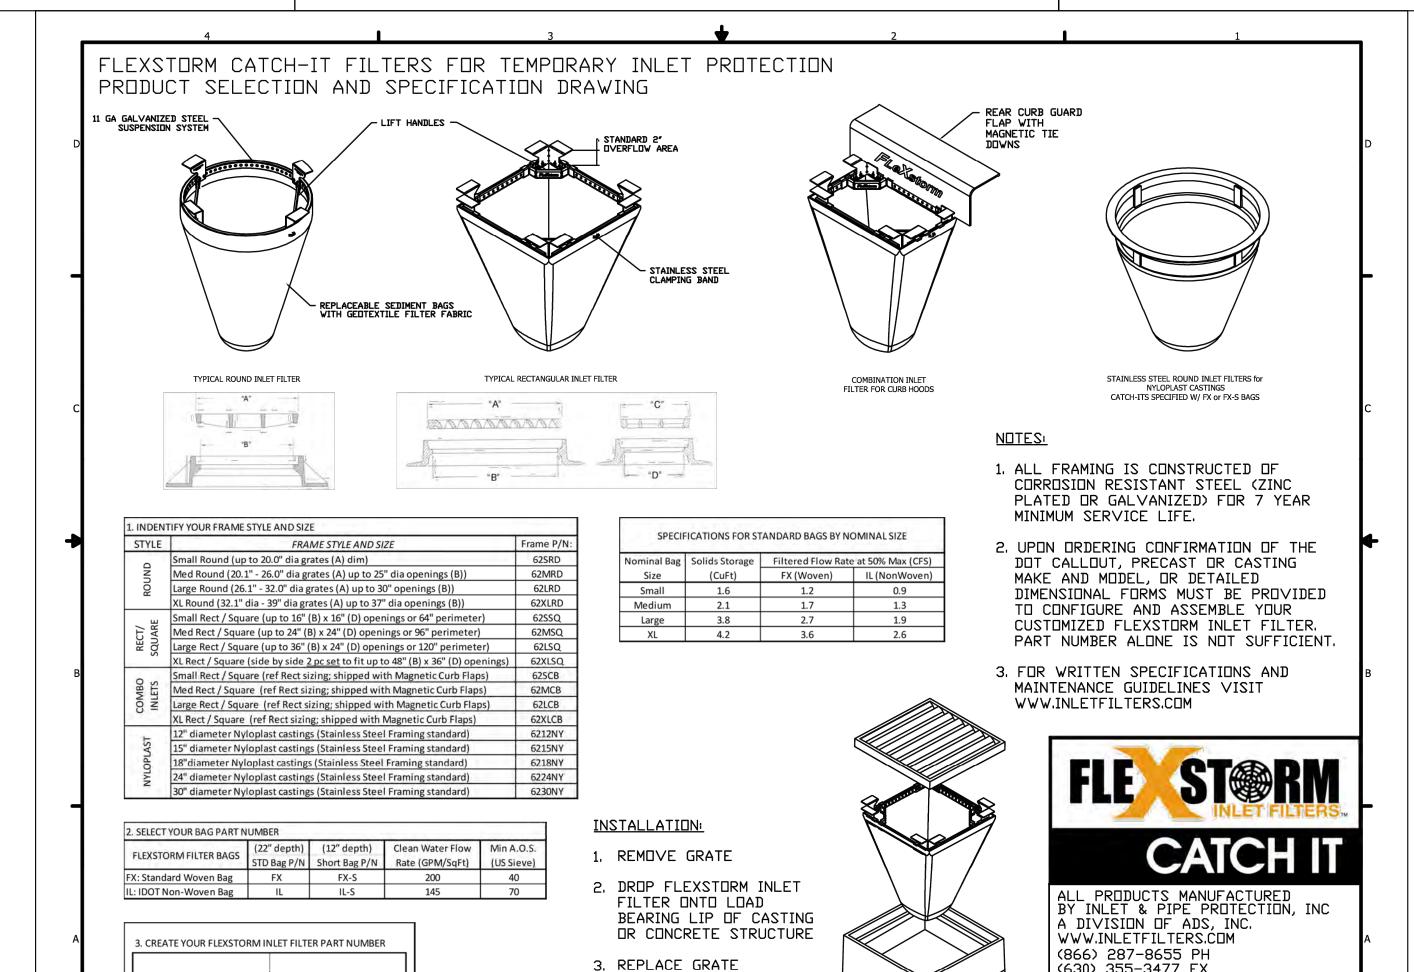

Frame P/N from Step 1. Filter Bag P/N from Step 2.

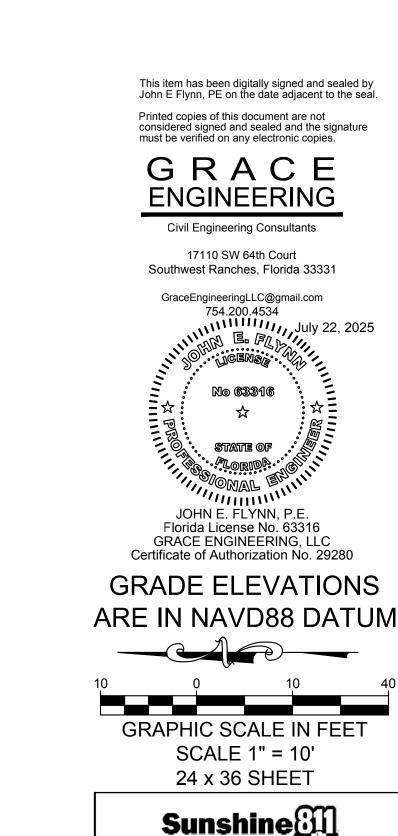

Call 811 or visit sunshine811.com two full

business days before digging to have

buried facilities located and marked.


Check positive response codes before you dig!

(630) 355-3477 FX

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FLEXSTORM CATCH IT

SHEET 1 OF 1

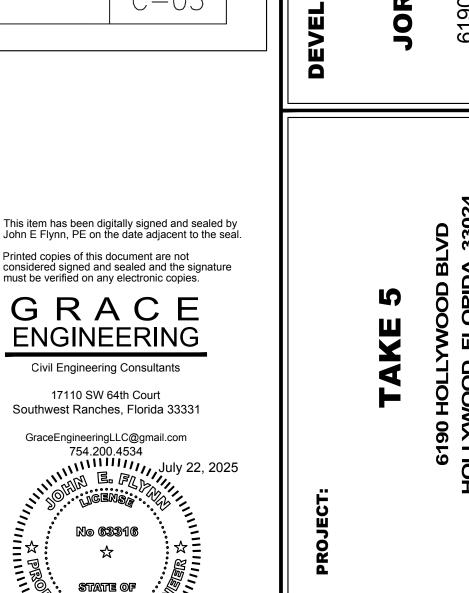

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**DETAILS & NOTES** 

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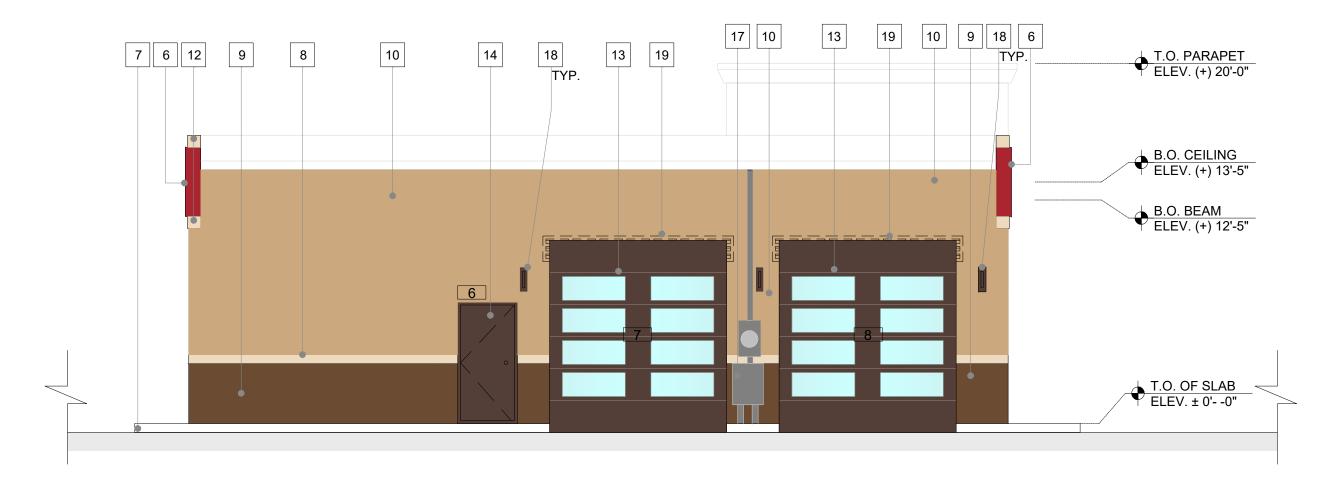
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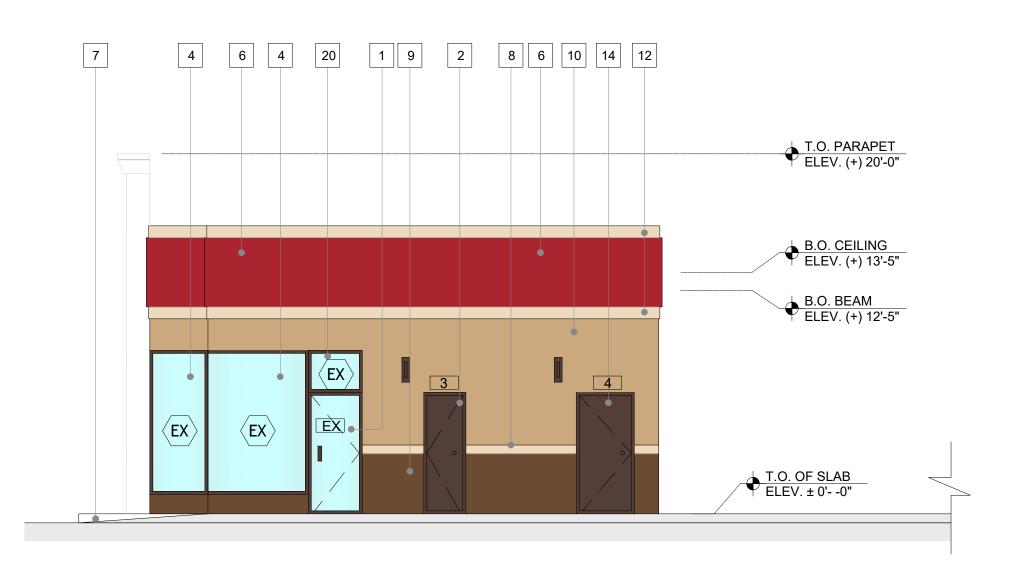
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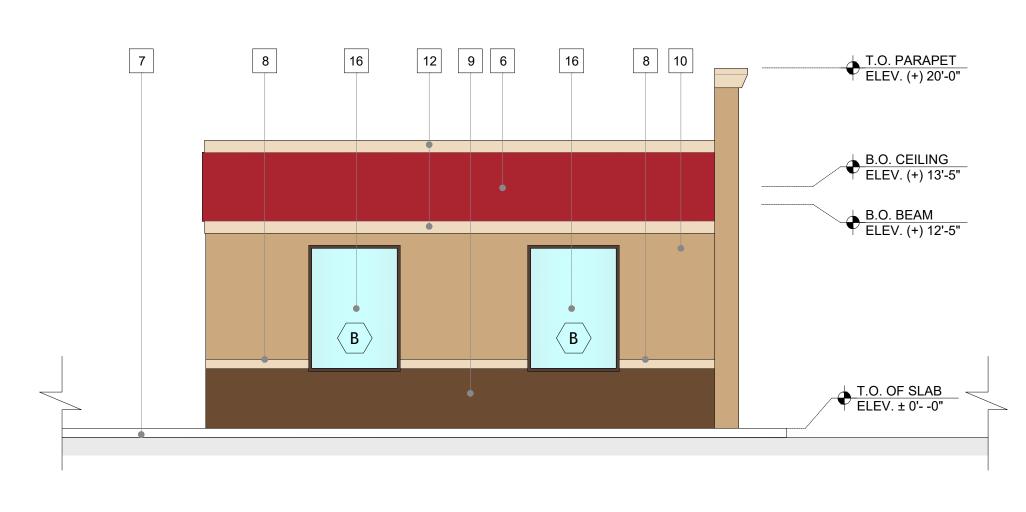




**SOUTH ELEVATION** SCALE: 3/16" = 1'-0"







NOTE: ALL EXPOSED CONCRETE FLOOR TO BE

DEMOLITION AND OR BEGINNING OF

CONSTRUCTION.

SEALED AND FINISHED W/ NON SLIP EXTERIOR GRADE GRITTED HIGH TRAFFIC EPOXY PAINT

**EAST ELEVATION** SCALE: 3/16" = 1'-0"

# FLOOR PLAN LEGEND:

- # DOOR TYPE, SEE DOOR SCHEDULE (SHEET A-4.0)

- A > WINDOW TYPE, SEE WINDOW SCHEDULE (SHEET A-4.0)
- # | SEE THIS SHEET
- NOTE: ALL EXISTING MEASUREMENTS TO BE CHECKED & VERIFY IN FIELD PRIOR TO ANY # ) WALL TYPE, SEE WALL SCHEDULE

# **ELEVATION KEY NOTES:**

- 1 EXISTING ALUMINUM GLASS DOOR
- 2 EXISTING ALUMINUM DOOR
- 3 EXISTING GARAGE DOOR
- 4 EXISTING ALUMINUM FRAME GLASS WINDOW
- 5 EXISTING TRANSOM WINDOW ABOVE DOOR
- 6 NEW EIFS BANDING LING... # SW 6871 POSITIVE RED NEW EIFS BANDING FINISH - COLOR SHERWIN WILLIAMS
- 7 EXISTING SIDEWALK CONCRETE SLAB
- 8" STUCCO BANDING FINISH COLOR SHERWIN WILLIAMS # SW 7678 COTTAGE CREAM
- SMOOTH STUCCO FINISH COLOR BOTTOM WAINSCOT
- 9 SMOOTH STUCCO FINISH COLOR BOTTOM SHERWIN WILLIAMS # SW 6097 STURDY BROWN
- SMOOTH STUCCO FINISH COLOR NILLIAMS SHERWIN WILLIAMS # SW 7693 STONE BRIAR SMOOTH STUCCO FINISH - COLOR MAIN BODY
- SMOOTH STUCCO FINISH COLOR SHERWIN WILLIAMS #
- NEW EIFS BANDING FINISH COLOR SHERWIN WILLIAMS # SW 7678 COTTAGE CREAM

- 13 NEW GARAGE OPENING & GARAGE DOOR.
- 14 NEW HOLLOW METAL DOOR SMOOTH STUCCO FINISH - COLOR SHERWIN WILLIAMS # SW
- 7678 COTTAGE CREAM
- 16 NEW FIX GLASS WINDOWS
- 17 EXISTING ELECTRICAL METER BOX
- 18 WALL SCONCE EXTERIOR LIGHT FIXTURE
- 19 EXISTING WALL LOUVERS TO BE DEMOLISHED AND DISPOSED OF.
- 20 NEW WINDOW TRANSOM NOA # XXX

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Checked by: T.R.

SHEET NAME

**ELEVATIONS** 

SHEET NUMBER

**A-2.0** 



Corner view – Intersection of Hollywood Blvd and S 62nd Ave

Subject Property – East Façade

View to the East from 62nd Ave

View to the west from 62nd Ave

SHEET NUMBER

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**A-2.1** 

SHEET NAME

**ELEVATIONS** 

