

### **GENERAL APPLICATION**

	PLANNING L	IVISION						
AP	PLICATION DATE:			DV : 6 :15 :: 5 ::				
Ro	00 Hollywood Blvd om 315 Ilywood, FL 33022	APPLICATION TYPE:  ☑ Technical Advisory Committe ☐ City Commission		□ Variance/Special Exception Requested □ Administrative Approvals □ Historic Preservation Board □ Planning and Development Board				
Tel: (954) 921-3471 Email: Development@ Hollywoodfl.org  SUBMISSION REQUIREMENTS:  One set of digitally signed & sealed plans (i.e. Architect or Engineer)		PROPERTY INFORMATION  Location Address: 1942 Taylor Street, Hollywood, FL 33020  Lot(s): 25 & 26						
•	One electronic combined PDF submission (max. 25mb)	Is the request the result of a violation	on notice? to the City	Sq Ft/Number of Units: 18 units  Yes No If yes, attach a copy of violation y before? If yes, check all that apply and provid				
	Completed Application Checklist				=			
	Application fee (per review)	DEVELOPMENT PROPOSAL  Explanation of Request: Multi Family Dwelling						
		Phased Project: Yes / No Number of Phases:						
		Project	Proposal					
		Units/rooms (# of units)	18 units	(Area:15,363 S.F.)				
NO	<u>)TE:</u>	Proposed Non-Residential Uses		S.F.				
•	This application must be completed in full	Open Space (% and SQ.FT.)	13%	(Area: 1,362 S.F.)				
	and submitted with all	Parking (# of spaces)	29 spac	es (Area:4,500 S.F.)				
	documents to be placed on a Board or	Height (# of stories)	4 Storie	s (46 FT.)				
	Committee's agenda.	Gross Floor Area (SQ. FT)	35,791					
<ul> <li>The applicant is responsible for obtaining the appropriate checklist for each type of application.</li> <li>Applicant(s) or their authorized legal agent must be present at all Board or Committee meetings.</li> </ul>		Telephone: (305) 216-0461 Er	Poinciana mail Addres	a Island Dr., Sunny Isles Beach, FL ss:thespecialistinc2002@yahoo.com				
		Address: 334 Poinciana Island Email Address: 334 Poinciana Email Address #2:	d Dr., Su Island Dr		_			
CLICK HERE FOR FORMS, CHECKLISTS, & MEETING DATES		15 Van Allank Carring 11 - Carl			If Yes, Attach Copy of the Contract.  Noticing Agent (FTAC & Board submissions only):  E-mail Address:			

#### PLANNING DIVISION



2600 Hollywood Boulevard Room 315 Hollywood, FL 33022 File No. (internal use only):

### **GENERAL APPLICATION**


### **CERTIFICATION OF COMPLIANCE WITH APPLICABLE REGULATIONS**

The applicant/owner(s) signature certifies that he/she has been made aware of the criteria, regulations and guidelines applicable to the request. This information can be obtained in Room 315 of City Hall or on our website at <a href="www.hollywoodfl.org">www.hollywoodfl.org</a>. The owner(s) further certifies that when required by applicable law, including but not limited to the City's Zoning and Land Development Regulations, they will post the site with a sign as approved by the Division of Planning & Urban Design. The owner(s) will photograph the sign the day of posting and submit photographs to the Office of Planning and Development Services as required by applicable law. Failure to post the sign will result in violation of State and Municipal Notification Requirements and Laws.

(I)(We) certify that (I) (we) understand and will comply with the provisions and regulations of the City's Zoning and Land Development Regulations, Design Guidelines, Design Guidelines for Historic Properties and City's Comprehensive Plan as they apply to this project. (I)(We) further certify that the above statements and drawings made on any paper or plans submitted herewith are true to the best of (my)(our) knowledge. (I)(We) understand that the application and attachments become part of the official public records of the City and are not returnable.

Signature of Current Owner: Man Lipusa	Date: 64 1011 2024
PRINT NAME: Mignel Insignares	Date:
Signature of Consultant/Representative:	Date:
PRINT NAME:	Date:
Signature of Tenant:	Date:
PRINT NAME:	Date:
Current Owner Power of Attorney	
am the current owner of the described real property and that I am aware of to my property, which is hereby ma	the nature and effect the request for de by me or I am hereby authorizing
	(Board and/or
Sworn to and subscribed before me this day of Apr.: L 2024	Signature of Current Owner
hn	Migue / Insignames Print Name
	oduced Identification



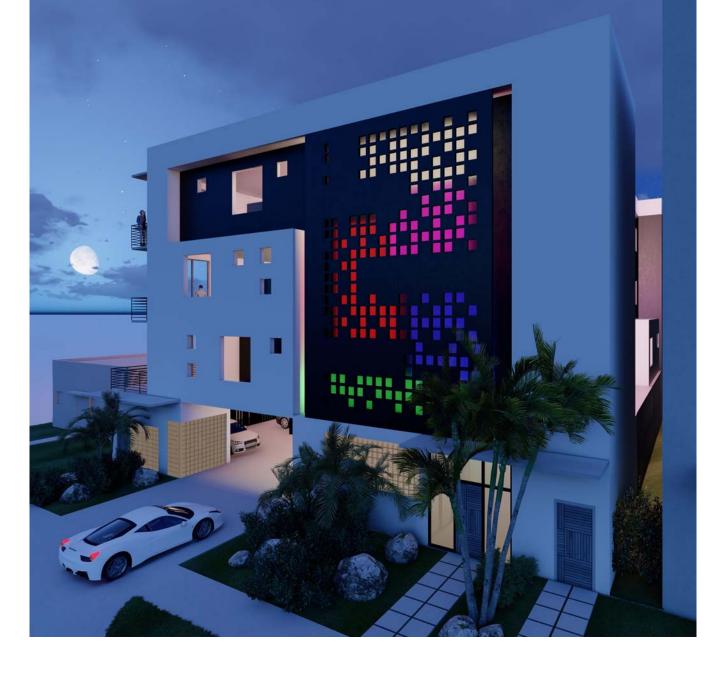

### SHEET INDEX

COVER SHEET SURVEY **GENERAL NOTES** PROJECT DATA SITE PLAN GROUND FLOOR PLAN SECOND FLOOR PLAN THIRD LEVEL PLAN FOURTH LEVEL PLAN **EAST ELEVATION** EAST ELEVATION RENDERING NORTH ELEVATION

NORTH ELEVATION RENDERING WEST ELEVATION WEST ELEVATION RENDERING SOUTH ELEVATION

SOUTH ELEVATION RENDERING CONTEXT ELEVATION CONTEXT RENDERINGS

SITE PLAN DETAILS/SECTIONS DETAILS/SECTION

STANDARD DETAILS & PUBLIC NOTES STANDARD DETAILS & PUBLIC NOTES

EXISTING TREE DISPOSITION LAPL-1 PLANTING PLAN
LAPL-2 PLANTING DETAIL AND NOTES

URBINIA 1942 TAYLOR STREET HOLLYWOOD, FLORIDA 33020

PROPOSED MULTI-FAMILY DEVELOPMENT

JURISDICTION CITY OF HOLLYWOOD BROWARD COUNTY STATE OF FLORIDA

P.A.C.O - JUNE 20, 2023 PRELIMINARY TAC - DECEMBER 18, 2023 FINAL TAC -

## PROJECT TEAM

MIGUEL INSIGNARES THE SPECIALIST INC. 334 POINCIANA ISLAND DR.

PHONE **EMAIL** 

**DESIGNER** COMPANY **ADDRESS** 

OWNER

COMPANY ADDRESS

PHONE

**EMAIL** 

SUNNY ISLES BEACH, FL 33160 (305) 216-0461 THESPECIALISTINC2002@YAHOO.COM

**GIUSEPPE NEDIANI** ENERGYNEERING CORP.

2301 COLLINS AV. MIAMI BEACH, FL 33139 (305) 532-4499 GIUŚEPPENEDIANI@GMAIL.COM SURVEYOR ADRESS PHONE FAX


LANDSCAPE ADRESS PHONE

**EMAIL** 

**EMAIL** 

PINNELL SURVEY, INC. 5300 W. HILLSBORO BLVD. COCONUT CREEK, FL 33073 (954) 418-4940 (954) 418-4941 ORDER@SFLAND.NET

ECOPLAN, INC. 310 SOUTHEAST 18TH STREET FT. LAUDERDALE, FL 33316 (954) 524-3722 JOHN@ECOPLAN-INC.COM

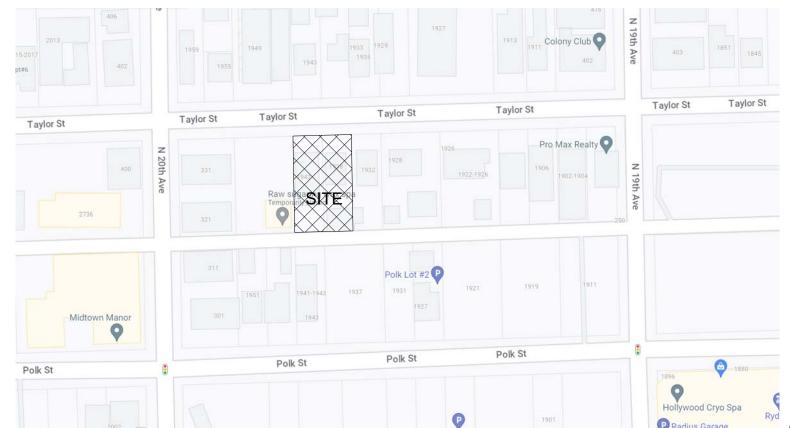

LOCATION MAP

SEAL / SIGNATURE / DATE

PROJECT ADDRESS:

1942 Taylor St, Hollywood, FL 33020

CONTACT INFORMATION DESIGN PROFESSIONAL GIUSEPPE NEDIANI


PE #59435 2301 COLLINS AV. #1207 MIAMI BEACH, FL, 33139 (305) 532-4499 GIUSEPPENEDIANI@GMAIL.COM

ISSUED FOR

SHEET TITLE

COVER SHEET


SHEET NUMBER

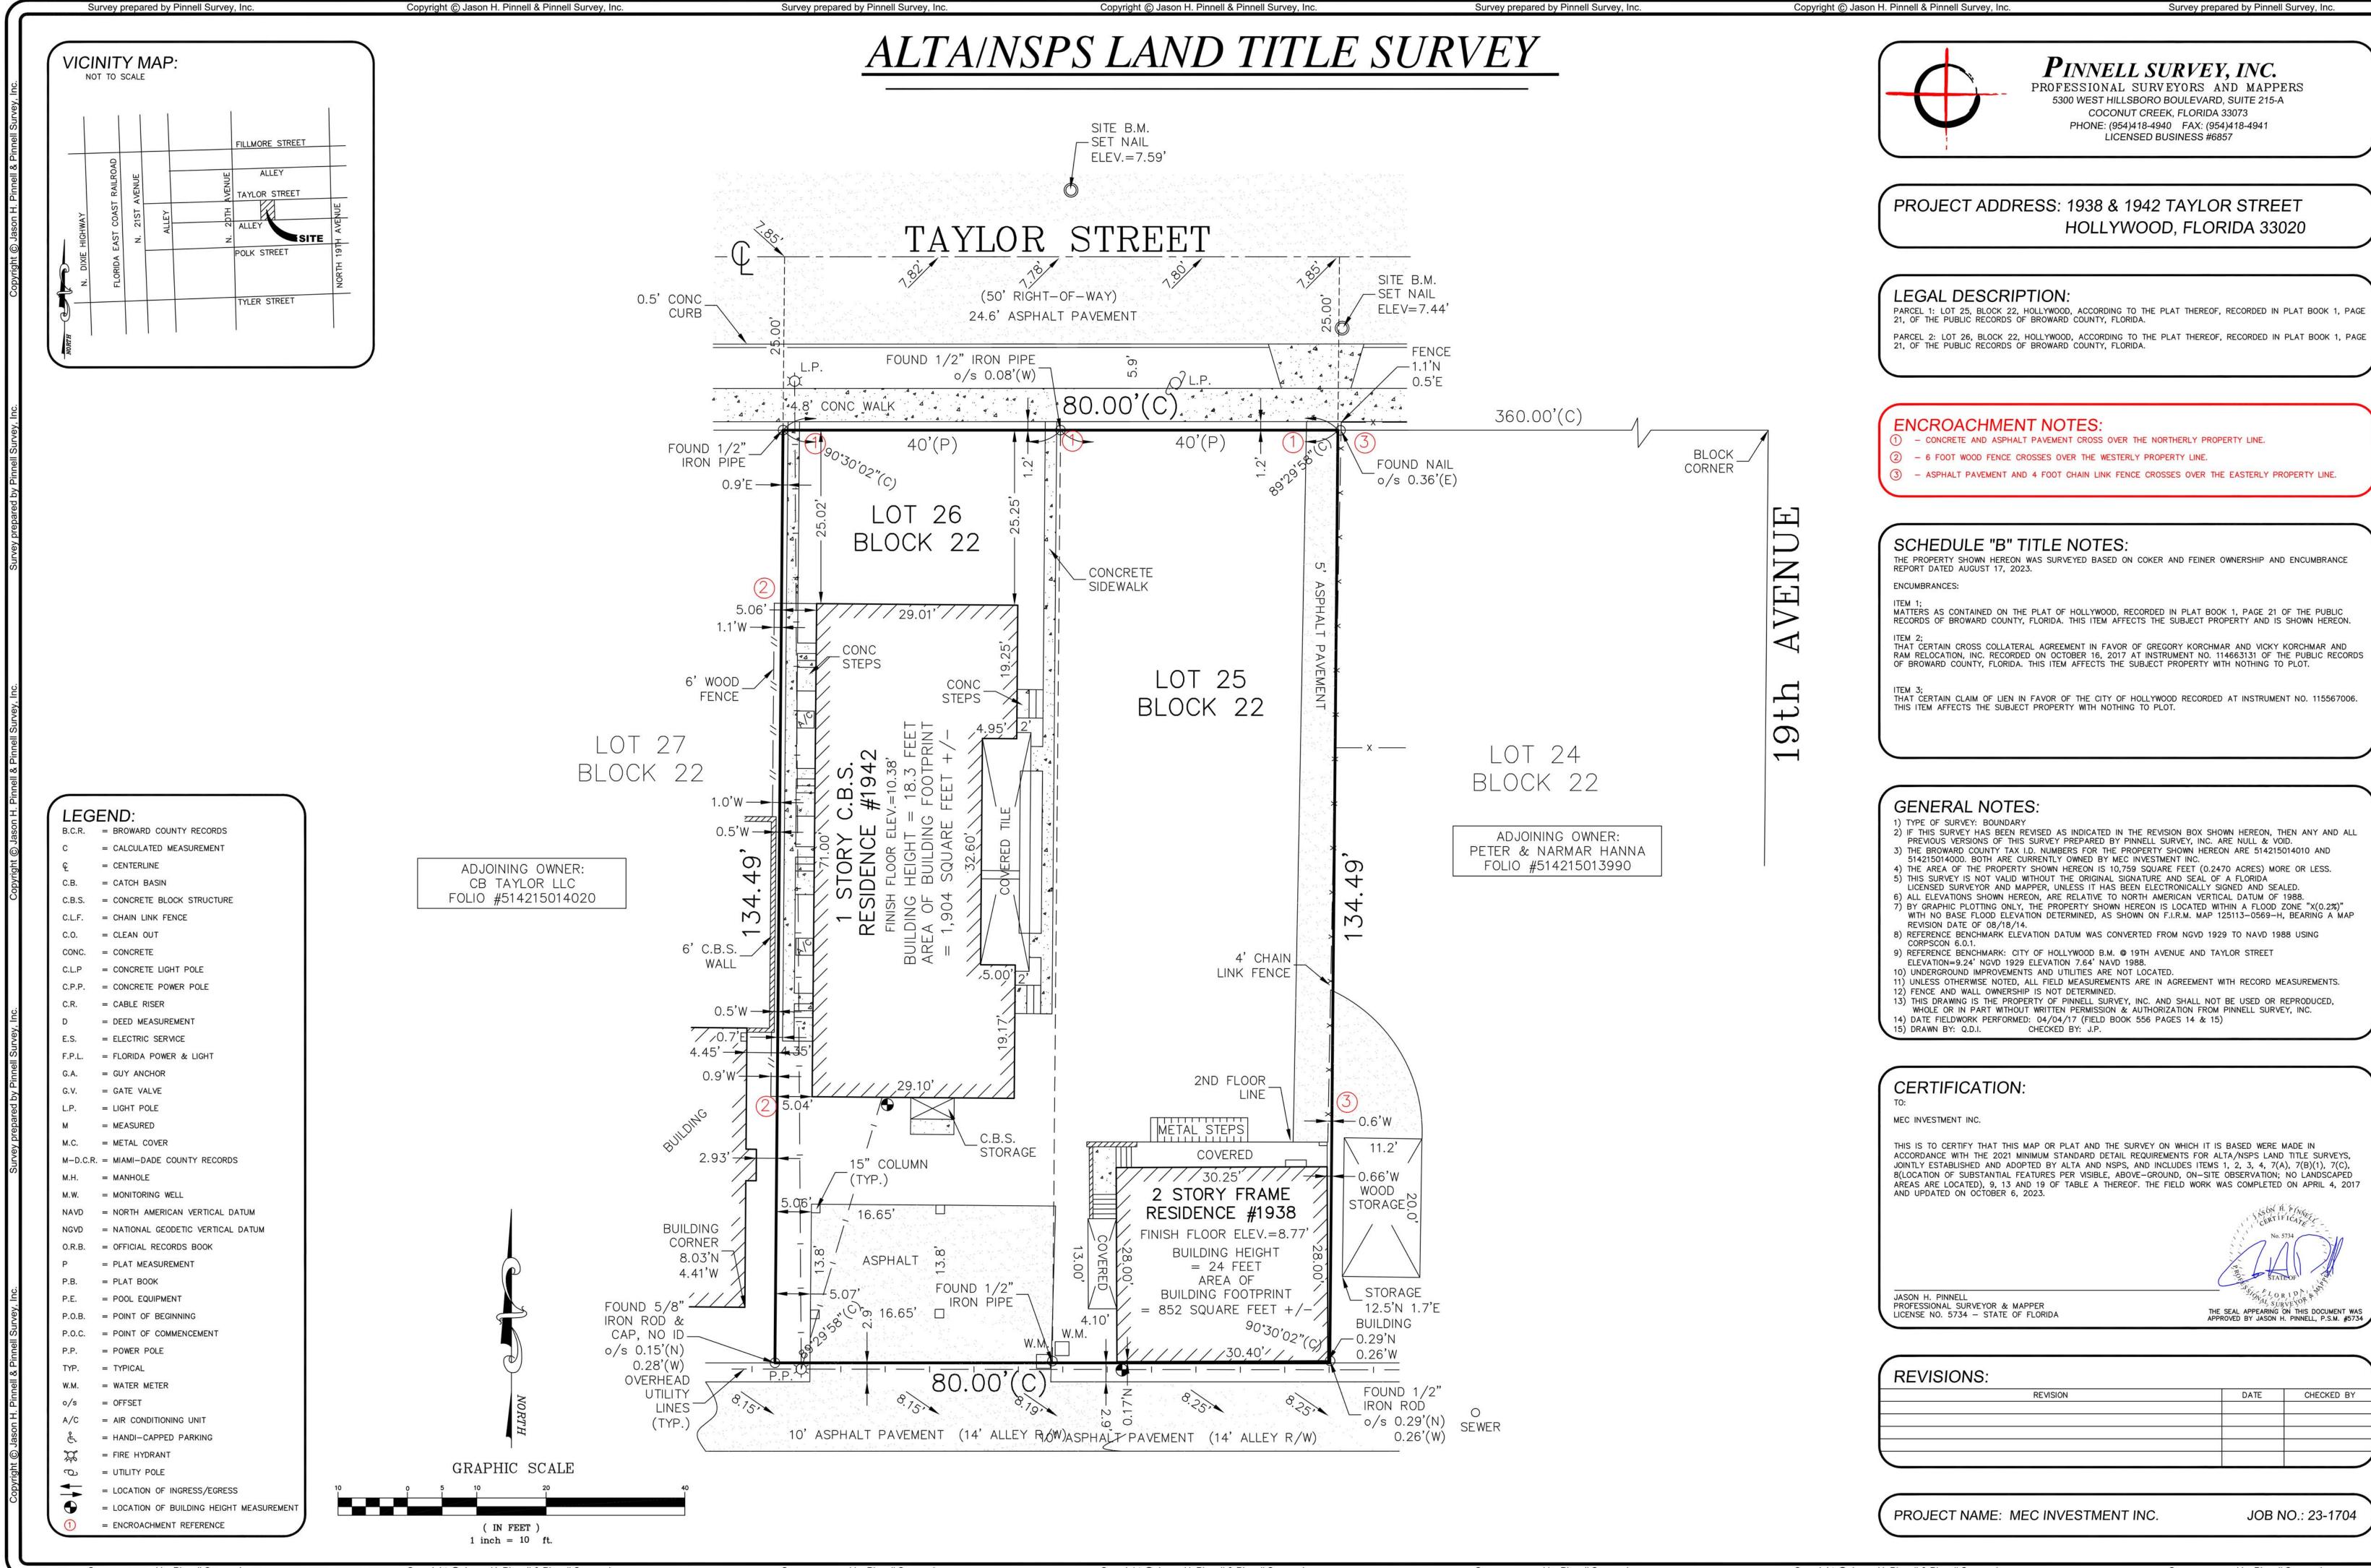

Survey prepared by Pinnell Survey, Inc

REVISIONS:		1
REVISION	DATE	CHECKED BY

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PROJECT ADDRESS: 1942 Taylor St, Hollywood, FL 33020

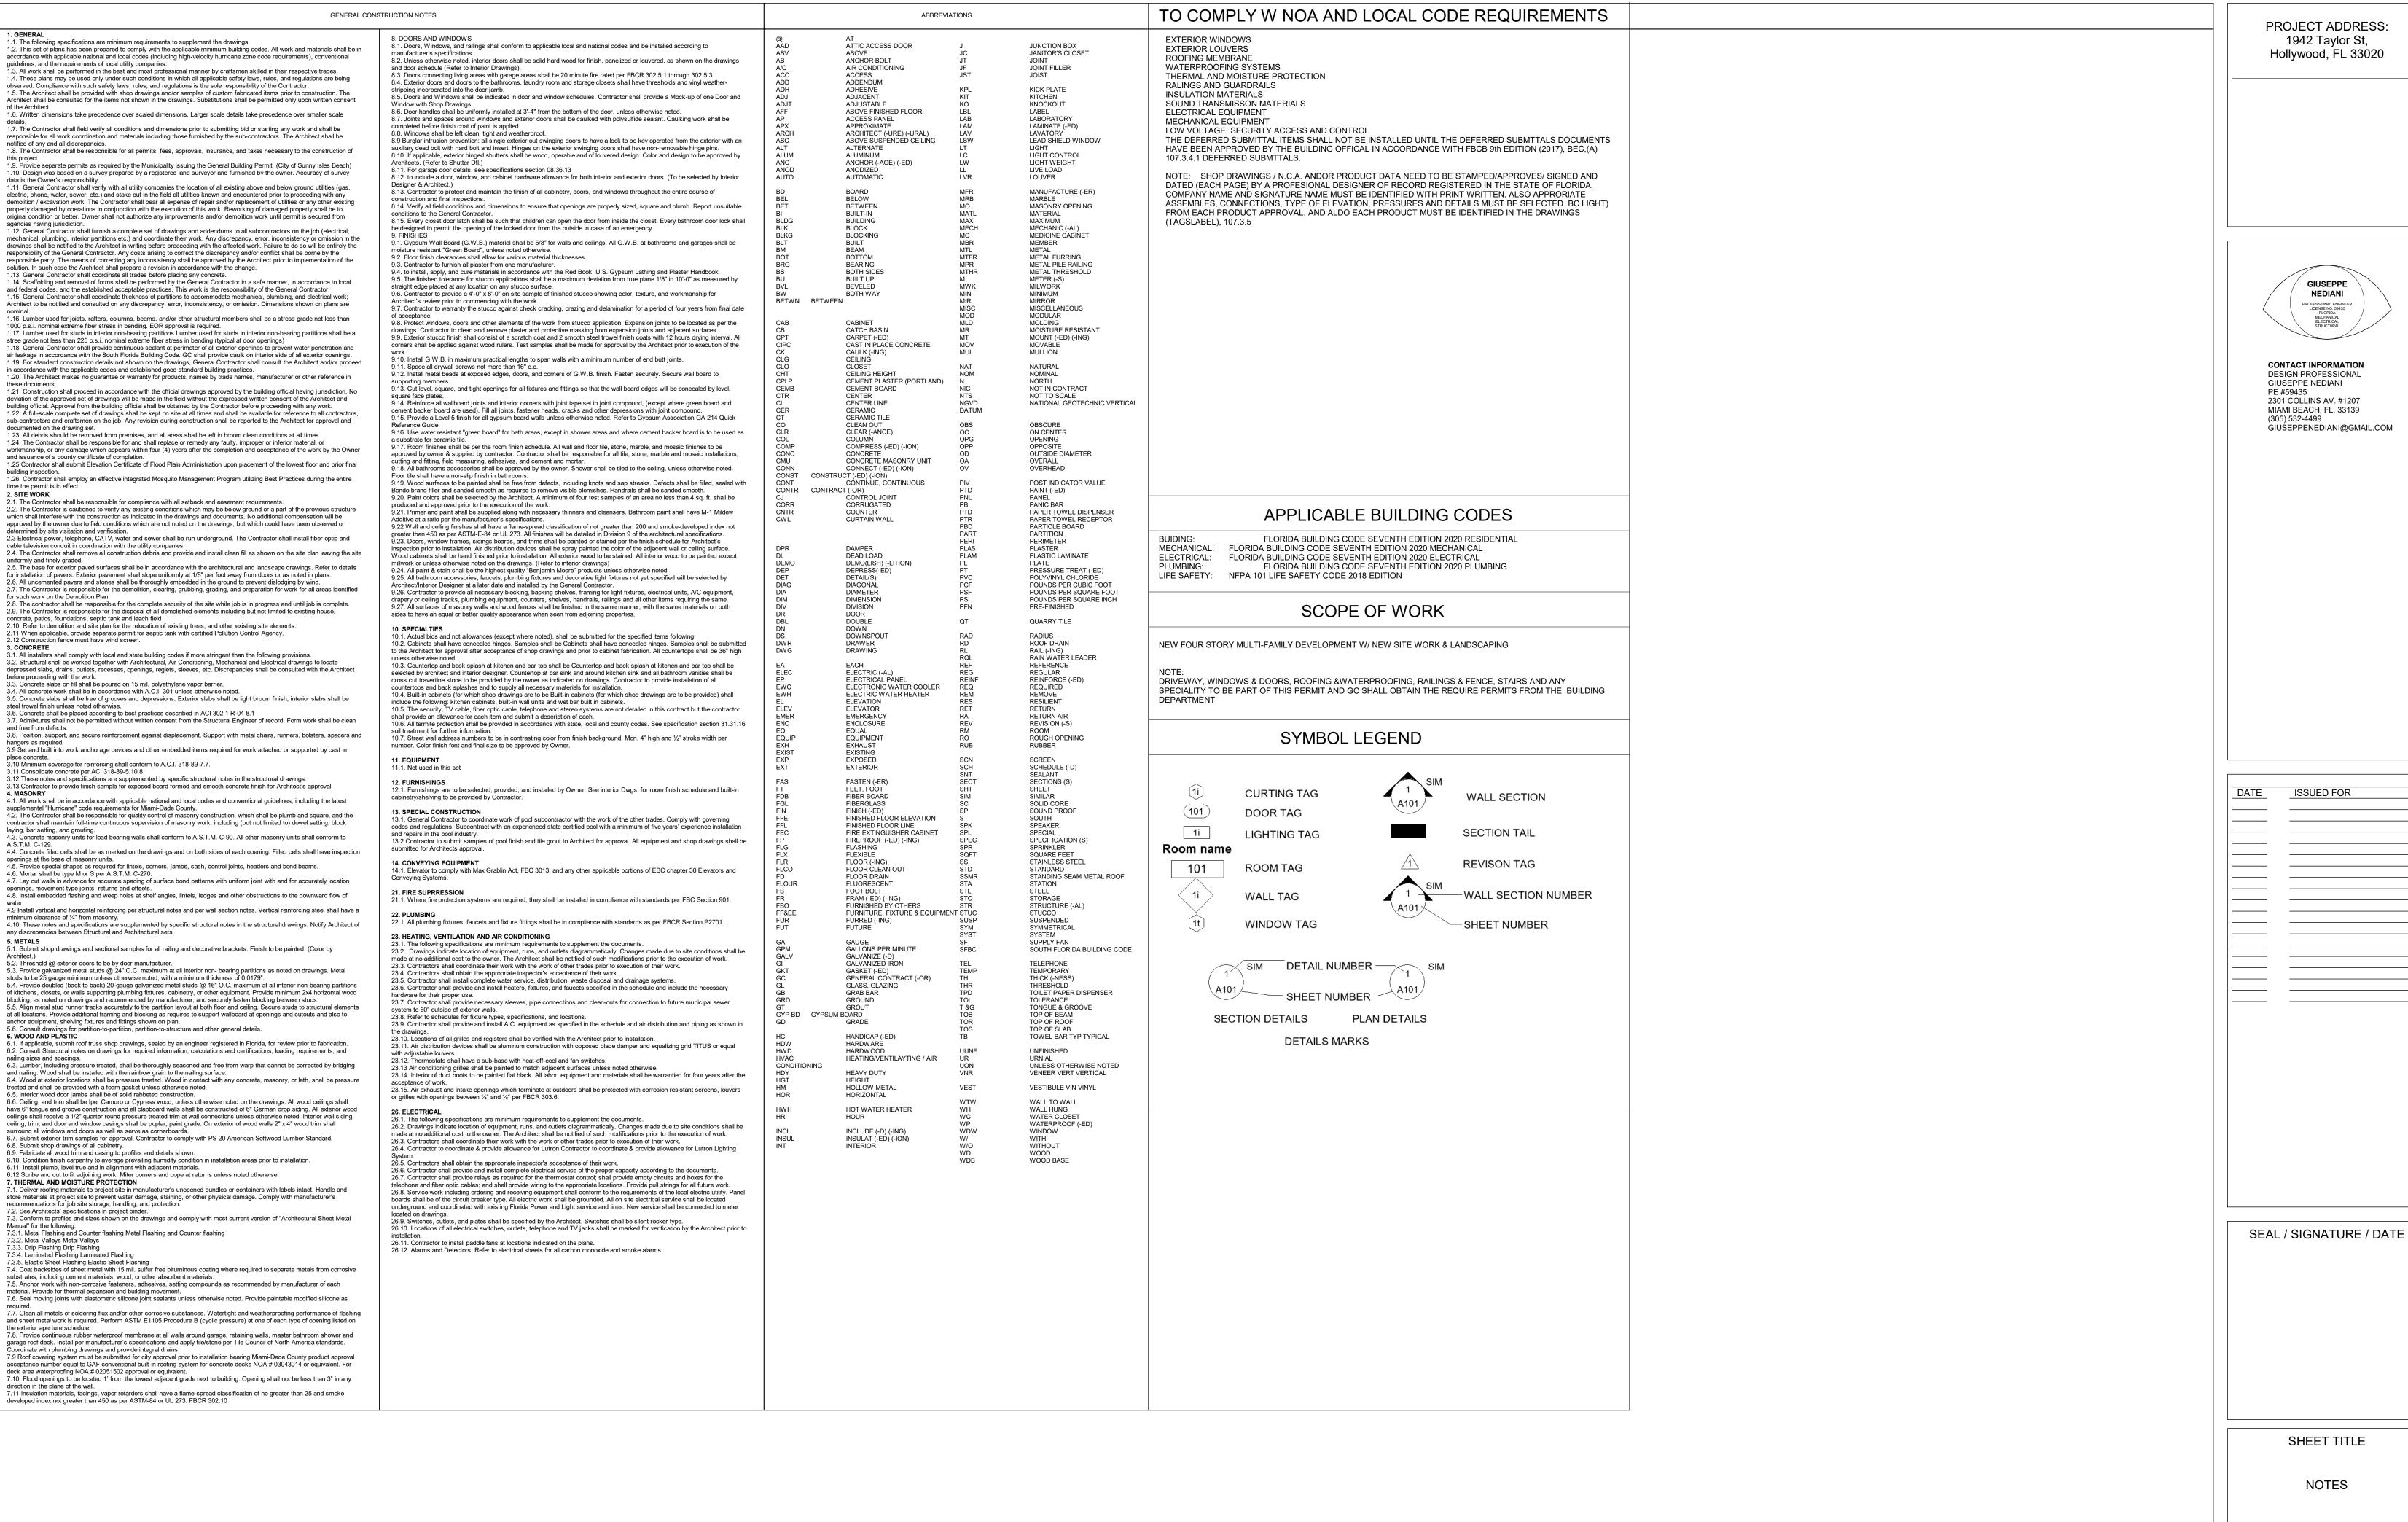**NEDIANI** 

**ISSUED FOR** 

SHEET TITLE

SHEET NUMBER

### DESIGN GUIDELINES

This structure has been designed to meet or exceed the wind load requirements of the 2020 Florida building code residential edition, section R301 design criteria and ASCE 7-02.

- 1. Basic wind speed 146 mph (3 second gust)
- 2. Wind importance factor 1.0
- 3. Construction type single family residence
- 4. Wind exposure category C
- 5. Internal pressure coefficient for enclosed buildings is 0.18; height and exposure adjustment coef. is 1.0; and directionality factor is KD=0.85

### **TYPICAL GENERAL NOTES:**

1. All noted are typical unless otherwise noted.

2. G.C. to familiarize themselves with existing site conditions and approved construction drawings and notify Architect of any discrepancies prior to commencing

3. Do not scale drawings.

4. Shop drawings to be provided for all speciality items and all millwork and

submitted to Architect for approval prior to any construction.

5. All floor plan dimensions are from face of masonry to the rough stud. all reflected

ceiling plan dimensions are from finished gypsum board.
6. G.C. to provide sound insulation in new partitions

7. G.C. to use 5/8" glass mat cementitious board (durra) in all wet areas.

8. G.C. to coordinate location, electrical requirements, and installation of all new millwork with Architect and provide shop drawings for approval prior to fabrication.
9. All plumbing fixtures shall confirm to the standards set forth in section P2701, Florida Building Code 2020 residential

10. G.C. to coordinate heights and locations of all decorative lighting with Architect prior to construction

11. G.C. to provide blocking at all accessory locations and at all chandelier and/or ceiling mounted lighting locations

12. All new light fixtures shall be U.L. listed.

### TYPICAL FINISH NOTES:

1. All interior finishes to be selected by Owner. G.C. to confirm selections and provide samples prior to purchase and installation.

2. All finishes shall comply with NFPA 101 section 18.3.3 interior finishes.3. All back splashes at kitchen shall extend to underside of upper cabinets and all

tile in the tub/shower shall extend to underside of ceiling.4. All GWB & plaster finishes shall be finished smooth, primed and painted.5. Stud gauge shall be as specified, except at locations where cabinets, plumbing

fixtures, or accessories shall be hung a min 20 gauge at 16" o.c. shall be used 6. Provide category ii safety glass at shower enclosures, windows adjacent to tubs or showers, glass panels adjacent to doors, and all other hazardous locations as pe

or showers, glass panels adjacent to doors, and all other hazardous locations as per FBC 2411.6.2. and 2405.2.1(3)(4).

7. Bathtub and shower floors and walls above bathtubs with installed shower heads

and in shower compartments shall have tile finish up to a height of not less than 6 feet above the floor.

8. Wall and ceiling finishes shall have a flame-spread classification of not greater

8. Wall and ceiling finishes shall have a flame-spread classification of not greater than 200 and a smoke-developed index not greater than 450 as per ASTM e-84 or UL 273.

9. Foam plastic to have a flame-spread index not more than 75, smoke-developed index not more than 450 as per ASTM e 84 or UL 723.

10. All finishes below B.F.E. Shall be flood damage resistant materials

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8. Wall and ceiling finishes shall have a flame-spread classification of not greater than 200 and a smoke-developed index not greater than 450 as per ASTM e-84 or UL 273.

9. Foam plastic to have a flame-spread index not more than 75, smoke-developed index not more than 450 as per ASTM e 84 or UL 723.10. All finishes below B.F.E. Shall be flood damage resistant materials

### PLAN NOTES:

1. All habitable rooms to meet the minimum light and ventilation requirements of section R303.1 of the 2020 Florida building code residential.

2. Stairs and handrails:A.- All stairs to meet the requirements of section 311.5 of the 2020 Florida building

code residential.

B.- guardrails shall be in accordance with section r4403.7.3 of the 2020 Florida building code residential

- Shall be minimum 42" AFF

- Intermediate rails shall have aff than a 4" gap rejecting 4" sphere
- Bottom rail to floor shall be less than a 2" gap rejecting 2" sphere

- Strength, durability, and attachment for 200# min or # required by local code load in any direction. G.C. shall verify design with Architect prior to fabrication and installation

C.- Handrails shall be in accordance with section r311.5.6 of the 2020 Florida building code residential

- 34" to 38" high above leading edge of tread

Triangle at tread, riser, & rail less than 6" gap
Cross section: circular = 1 1/4" to 2" dia, noncircular = equivalent gaspability
Edges = min 1/8" radius

- Clear space between handrail and wall shall be a min 2 1/4"

- May be interrupted by post at turn

- Strength, durability, and attachment for # 200 min or # required by local code.

3. Provide smoke detection in all bedrooms (inside room & outside) adjacent to bedroom door. Also provide smoke detectors at first and second floor in close proximity to stairs as per section R313 of the 2020 Florida building code residential.

### INTERIOR DESIGN

G.C. to coordinate with the Architect and Owner for exact heights and locations including, but not limited to, A/C supply/return, outlets, switches, fixtures. etc. prior to installation. Any installation made without consulting with design consultants may need to be relocated at G.C.'s time and expense.

### WATERPROOFING NOTES

1. ROOFING

a. Roof dry-in shall prevent any water penetrating through the roof system, including gable ends and penetrations. maintenance of dry-in is required until permanent roofing is installed. any roof dry-in shall go up any abutting wall a minimum of 8" behind metal wall flashing.

b. Eve drip at roof edge shall be installed beneath dry-in felt. roofing cement shall be applied between the drip edge and felt dry-in or per manufacturer's recommendation.

c. Metal wall flashing shall be a minimum of 6" up the wall and on roof deck. all flashing shall be set in roof mastic on horizontal & vertical surfaces

flashing shall be set in roof mastic on horizontal & vertical surfaces.
d. Roofing mastic shall be applied and used to seal all plumbing vent stacks and any other roof vent flashing including but not limited to all ridge vents, dryer vents

e. Pipe vent or other vent shall not be installed closer than 24" of any valley, ridge,

hip or other penetration f. Flashing to be in accordance with NRCA, the national sheet metal contractors' association.

2. STUCCO

a. Stucco shall be fogged for three days with verification log and job superintendent sign-off

b. Bonding agent shall be applied to any wall that is unlathed where a permanent bond would be required.

c. Sand proportioning for stucco mix shall be done to exacting measures including building 1 cubic foot boxes if necessary to control the actual quality of sand introduced into the stucco mix.

d. Caulking grooves shall be created either with nail heads or similar items between dissimilar materials to achieve a "v" joint for caulking.

e. Lath shall continue behind expansion joints.
f. Outside & inside corners to have lath lap a minimum of 12" beyond corner.

g. Tyvek and stucco building wrap shall be furnished and installed at all areas by sub-contractor.

h. Scrape and clean all vertical and horizontal control joints.
i. 15 lb felt shall be installed over building wrap and non-paper back lath applied horizontally over the felt. all accessories shall be applied over the full coverage lath drip screed to be installed prior to the lathing operation. drip screed to be no less than 1/2" and not more than 1" below finish floor. do not caulk drip screed.
j. Submittals shall include all info. required for product installation, including

3. PAIN

a. Use the appropriate sealer as recommended for each application to seal off

b. Painter shall submit proof from paint supplier of ph testing prior to applying paint.c. Prior to any exterior caulking, proper paint or primer for caulk will be completed.d. Surfaces must be free of oil, scle, dust, and other deleterious material prior to

caulking.
e. All foam features that are hard coated must be sealed.

manufacturer's mixing instructions for the stucco.

f. Acrylic urethane sealant shall be used at all exterior applications included to be sealed by this contract.

4. PLUMBING - Pipe vents shall not be located any closer than 24" of any valley, ridge, hip, or other penetration.

5. HVAC

a. Roof vents shall not be located any closer than 24" of any valley, ridge, hip, or other penetration.

b. Wall vent piping to slope down to vent cap and have seam on upper side.

6. GUTTERS AND DOWNSPOUTS

a. Roof drip edge shall not be cut or otherwise altered during the installation of gutters.

b. All fasteners through drip edge used to attach gutters at building fascia shall be sealed with acrylic urethane caulking. verify nail spacing.

### WATERPROOFING APPLIED APPLICATIONS NOTES

The following are specifications for water proofing applied applications. Subcontractor must submit to the contractor and Architect all product information for review and approval. All applications are on top of concrete slabs. All roofing applications to be 20 years bondable.

1.- Roofing system.
3-Ply modified bitumen roofing system membrane, over light weight insulating concrete, sloped to drain at 1/4" per foot w/ uplift tie-downs pressure resistant.
2.- Concrete slab @ second level terraces

Sopralene flam 180 waterproofing membrane by soprema noa#09-0112.02i. provide 10 year warranty. Installation:

<u>Installation:</u>

Prior to installation moisture test on deck. dryout with torch. then add primer as indicated.

1. Elastocol 500 (2 coats) primer, applied with roller 2. Sopralene flam 180 base sht, torch applied

2. Sopralene flam 180 base sht, torch applied3. Sopralene flam 180 fr gr top sht., torch applied

After top membrane is installed 24 hr flood test prior to tile installation.

### **BUILDING INSULATION**

Minimum insulation values required:

Exterior CMU walls

R-5 foil insulation

Between level 2 and roof R-30

Notes:

1. Insulation materials, facings, vapor retarders shall have a flame-spread classification of not greater than 25 and a smoke-developed index not greater than 450 as per ASTM E-84 or UL 273

### **ROOF FLASHING**

1. Base cap and flashing: base and cap flashing shall be installed in accordance with manufacturer's installation instructions. base flashing shall be of either corrosion-resistant metal of minimum nominal 0.019" thickness or mineral surface roll roofing weighing a minimum of 77 lbs per 100 sf. cap flashing shall be corrosion resistant metal of minimum nominal 0.019" thickness.

2. Drip edge: drip edge shall be provided at eaves and gables of shingle roofs, flat roof edge and balconies edges, and overlapped a minimum of 2". eve drip edges shall extend 1/4" below sheathing and extend back on the roof a minimum of 2". drip edge shall be mechanically fastened a maximum of 12" on center.

Crickets or saddles: a cricket or saddle shall be installed on the ridge side of any chimney greater than 30" wide. cricket or saddle coverings shall be sheet metal or of the same material as the roof covering.

### FBC 2010. R703.7.5 FLASHING

Flashing shall be located beneath the first course of masonry above finished ground level above the foundation wall or slab and at other points of support, including structural floors, shelf angles and lintels when masonry veneers are designed in accordance with section R703.7.

### RAIN WATER LEADERS

G.C. shall insulate and soundproof around all rain water leaders that occur inside of ceiling and walls.

### FBC 2010, R703.8 FLASHING

Approved corrosion-resistive flashing shall be provided in the exterior wall envelope in such a manner as to prevent entry of water into the wall cavity or penetration of water to the building structural framing components. the flashing shall extend to the surface of the exterior wall finish an shall be installed to prevent water from reentering the exterior wall envelope. approved corrosion-resistant flashing shall be installed at all of the following locations:

1. At top of all exterior window and door openings in such a manner as to be leakproof, except that self-flashing windows having a continuous lap of not less than 1-1/8" over the sheathing material around the perimeter of the opening, including corner, do not require additional flashing; jamb flashing may also be omitted when specifically approved by the building official.

2. At the intersection of chimneys or other masonry construction with frame or stucco walls, with projecting lips on both sides under stucco copings.

3. Under and at the ends of masonry, wood or metal copings and sills.
4. Continuously above all projecting wood trim.

5. Where exterior porches, decks or stairs attach to a wall or floor assembly of wood frame construction.

6. At wall and roof intersections.

7. At built-in gutters.

### TERMITE TREATMENT

As per 2020 Florida building code sections 1816.1.7, 105.10, and 105.11 and the 2010 Florida building code, residential section r4409.13.5 - the building shall have preconstruction treatment against subterranean termites. the rules and laws as established by the Florida dept. of agriculture and consumer services shall be deemed as approved with respect to pre-construction soil treatment. a certificate of compliance shall be issued to the building department be the licensed pest control company. a certificate of protective treatment for prevention of termites according to F.B.C. section 104.2.6 shall be acquired.

### MOLD MITIGATION

adjacent run of stairs of the run.

The general contractor shall take measures to deliver to the owner a continuous water tight building envelope which will provide a solid shield to water entry.
 Provide weeps at masonry system which may collect moisture.

3. Provide necessary site work to move water away from the building during construction.

4. General contractor shall complete and seal the building envelope prior to installing wall board or any finish material.5. The contractor shall establish procedures to provide deliver and store materials so as to prevent water damage. all materials shall be inspected for water damage

prior to accepting delivery

6. The contractor shall take reasonable steps to maintain effective dry-in conditions during the "controlled" phase of construction.

7. The contractor shall ensure that all surfaces are dry and unexposed to sources of humidity prior to covering them with finish materials.8. The contractor shall establish a protocol for dealing with any large and

unexpected water intrusion into completed portions of the building.

9. Upon completion of construction, the general contractor shall deliver to the owner all available material, including but not limited to manufacturer's recommendation so

# as to facilitate the development of a building operations and maintenance plan. FBC 2010. R4409.7 HIGH VELOCITY HURRICANE ZONE-FIRESTOPPING

1. R4409.7.2. firestopping shall be installed in wood frame construction in the locations specified in section R4409.7.2.1 through R4409.7.2.6.
2. R4409.7.2.1. in concealed spaces of stud walls and partitions including furred

spaces at ceiling and floor levels to limit the maximum dimension of any concealed space to 8 feet (2438 mm).

3. R4409.7.2.2. at all interconnections between concealed vertical and horizontal spaces such as occur at soffits, drop ceilings, cove ceilings and similar features.

4. R4409.7.2.3. in concealed spaces between stair stringers at least once in the middle of each run, at the top and bottom, and between studs along and in line with

TO THE BEST OF THE ARCHITECTS' KNOWLEDGE, THE PLANS AND SPECIFICATIONS COMPLY WITH THE APPLICABLE MINIMUM BUILDING CODES AND THE APPLICABLE FIRE-SAFETY STANDARDS AS DETERMINED BY THE LOCAL AUTHORITY IN ACCORDANCE WITH THE FBC, 109.3.6.4.4 AND CHAPTER 633, FLORIDA STATUTES.

THE 2020 FLORIDA BUILDING CODE, RESIDENTIAL, IS THE BASED CODE FOR DESIGN

### FLOOD INFORMATION

1. All electrical, mechanical, plumbing will be placed at or above the base flood

2. All areas below B.F.E. shall be provide with a minimum of two (2) openings having a total net area of no less than one square inch. of opening for every square foot of enclosed area subject to flooding the bottom of the opening will be no higher than one (1) foot above grade and located on different sides of the enclosed area, openings will be equipped with screens or louvers, flood resistant materials will be used below B.F.E.

3. The side will be graded in a manner to prevent the flooding of adjacent properties. where necessary interceptor swales will be constructed on-site with no encroachment over adjacent properties.

4. 0'-0" = 8.6' N.A.V.D.

5. Area adjacent to lake or canal to be graded so as to prevent direct overland discharge of storm water into lake or canal.

6. Lot will be graded so as to prevent direct overland discharge of storm water onto adjacent property.

7. Applicant will provide certification prior to final inspection.

8. In addition to the requirements of this permit, there may be additional restrictions applicable to this property that may be found in the public records of this county. section 553.79 (10), Florida statutes effective 7/10/87.

9. The beam elevation certificate is required before making any inspections above the lowest floor and a final elevation certificate is required before issuance of certification of occupancy or completion (completion hold 186) ( IC-3D3 ) call 372-6685.

10. O.S.F.H. - (outside special flood hazard) all electrical, plumbing and mechanical equipment must be located at or above the required lowest floor elevation S.F.H. - (special flood hazard) all electrical, plumbing and mechanical equipment must be located at or above the base flood elevation or the required lowest floor elevation whichever is higher.

11. Lowest floor - 11 C-2(BB) "shall mean the lowest floor of the lowest enclosed area (including basement). an unfinished or flood resistant enclosure, usable for parking or vehicle, building access or storage in a area other than a basement area, is not considered a building's lowest floor; provided that such enclosure is not built as to render the structure in violation of the applicable non - elevation design requirements in 60.3 of CFR CH.((10-1)-88 edition)". Dade county code sections LI. C-3, 11 C-4, 11 C-5.

12. Garage / storage - ( SFHA (1 1 C-5 (F)) fully enclosed areas below the base flood elevation shall be designed to preclude finished living space except allowable uses i.e. parking, limited storage and building access and shall be designed to allow for the entry and exit of flood - waters to automatically equalize hydrostatic flood forces on exterior walls, the interior portion of such enclosed area sha no be portioned of finished ( flood resistant materials only ) into separate rooms or air conditioned. design for complying with this requirement must be either certified by a professional engineer or architect or meet the following criteria; (1) provide a minimum of two (2) openings having a total net area of no less than one (1) square inch for every square foot of enclosed area size. bottom of all openings shall be not higher than one (1) foot above grade.

13. Highest adjacent grade - 11 C-2(2) "shall mean the highest finished grade elevation of the ground surface next to the proposed walls of the structure". 1 1c-2(gg) "minimum finished grade shall mean the elevation established in Dade county flood criteria map at a specific development site or crown of road elevation of an existing adjacent road, whichever is higher (or waiver must be obtained). site grading must be provided in a manner so as to retain run - off within the site and prevent run - off into adjacent property as well as direct surface water run - off into lakes or canals.

PROJECT ADDRESS: 1942 Taylor St, Hollywood, FL 33020

GIUSEPPE NEDIANI
PROFESSIONAL ENGINEER LICENSE NO. 59435 LICENSE NO. 59435 MECHANICAL ELECTRICAL STRUCTURAL

DESIGN PROFESSIONAL GIUSEPPE NEDIANI PE #59435 2301 COLLINS AV. #1207 MIAMI BEACH, FL, 33139 (305) 532-4499 GIUSEPPENEDIANI@GMAIL.COM

ISSUED FOR

**CONTACT INFORMATION** 

SEAL / SIGNATURE / DATE

SHEET TITLE

GENERAL NOTES

AND 2

### <u>FOLIO</u>

#514215014010 #514215014000

### LEGAL DESCRIPTION

PARCEL 1: LOT 25, BLOCK 22, HOLLYWOOD, ACCORDING TO THE PLAT THEREOF, RECORDED IN PLAT BOOK 1, PAGE 21, OF THE PUBLIC RECORDS OF BROWARD COUNTY FLORIDA

PARCEL 2: LOT 26, BLOCK 22, HOLLYWOOD, ACCORDING TO THE PLAT THEREOF, RECORDED IN PLAT BOOK 1, PAGE 21, OF THE PUBLIC RECORDS OF BROWARD COUNTY FLORIDA

SITE INFORMATION	<u>EXISTING</u>	PROPOSED
ZONING: SUB-DISTRICT: BUILDING USE	ND-3 N/A SINGLE FAMILY & DUPLEX	ND-3 N/A MULTIFAMILY DWELLING
LAND USE DESIGNATION:	N/A	N/A
NET LOT AREA: GROSS LOT AREA: BASE FLOOD ZONE:	2,756 SQ.FT. 10,759 SQ.FT. ZONE X(0.2%)	8,437 SQ.FT. 10,759 SQ.FT. ZONE X(0.2%)

BUILDING INTENSITY	<u>ALLOWED</u>	PROVIDED
LOT COVERAGE: FAR: A/G AREA:	N/A 3.00 32,277 SQ.FT.	N/A 1.84 19,887 SQ.FT.
PROPOSED NO. OF UNITS: NUMBER OF FLOORS:	UNLIMITED 10	18 UNITS 4
BUILDING HEIGHT:	140 FEET	46 FEET

BUILDING INFORMATION	PROVIDED
TYPE OF CONSTRUCTION SPRINKLER (REQUIRED) FIRE ALARM (REQUIRED)	TBD YES YES

PARKING CALCULATION	REQUIRED	<u>PROVIDED</u>

MIN. REQ. PER UNIT (1) PARKING SPACE PER UNIT UNITS EXCEEDING ONE BEDROOM INCLUDING DENS (1.5) PARKING PER UNIT

1 BEDROOM UNITS (10 CT)	10	9
2 BEDROOM UNITS (8 CT)	12	16
GUESTS: 1 PER EVERY 10	2	2
HANDICAPPED SPACE	0	1
TOTAL	=24 SPACES	=28 SPACES
LOADING:		
RESIDENTIAL 1 FOR		
(60-100 UNITS)	NOT REQ.	0 SPACE

8 TANDEM SPACES (16 SINGLE SPACES)
PROVIDED FOR THE 8 CT. 2 BED. UNITS, 2 INDIVIDUAL
TANDEM SPACES SHALL BE FOR EACH UNIT

<u>SETBACKS</u>	REQUIRED	<u>PROVIDED</u>
FRONTAGE AT TAYLOR (NORTH) SIDE INTERIOR (EAST) SIDE INTERIOR (WEST) REAR (SOUTH)	15'-0" 0'-0" 0'-0" 5'-0"	15'-0" 10'-0" 4'-0" 5'-0"

### AT-GRADE PARKING LOT AND VEHICULAR USE AREAS SETBACK REQUIREMENTS

FRONTAGE AT TAYLOR (NORTH)	15'-0"	15'-0
SIDE INTERIOR (EAST)	0'-0"	0'-0"
SIDE INTERIOR (WEST)	0'-0"	4'-0"
REAR (SOUTH)	5'-0"	5'-0"

### **GREEN BUILDING CERTIFICATION**

LEED GREEN BUILDING CERTIFICATION SHALL BE OBTAINED FOR THIS PROJECT.

### **NET AREA**

LOCATION	UNIT #	UNIT TYPE	AREA		NET AREA	
LOCATION	OINIT #		AC	TERRACE/BALCONY	AC	BALCONY
	201	2/2	970	385		
	202	2/2	959	375		
	203	2/2	867	375	E 11E	1 125
2ND FLOOR	204	1/1	759		5,115	1,135
	205	1/1	800			
	206	1/1	760			
	301	2/2	972	99	5,118	
	302	2/2	1023	51		198
2DD EL 00D	303	2/2	962	48		
3RD FLOOR	304	1/1	729			
	305	1/1	707			
	306	1/1	725			
	401	2/2	857	150	4,904	
	402	2/2	1025	51		
4TU FLOOD	403	1/1	870	48		240
4TH FLOOR	404	1/1	738			249
	405	1/1	707			
	406	1/1	707			
TOTAL NET AREA				15,137	1,582	


MIN. DWELLING UNIT SIZE	REQUIRED	PROVIDED
PER UNIT CUMULATIVE AVERAGE	300 SQ.FT. 500 SQ.FT.	707 SQ.FT. (MIN.) 841 SQ.FT.
LANDSCAPE	REQUIRED	PROVIDED

IMPERVIOUS AREA PARKING, SIDEWALKS & DRIVES PERVIOUS AREA LANDSCAPING AREAS (TOTAL) FRONT YARDS LANDSCAPE BUFFERS OPEN AREA VEHICULAR AREA	N/A 1,178 SQ.FT. (10.9%) MIN 1,200 SQ.FT. (11.2%) MIN N/A	9,362 SQ.FT. (87.0% 1,362 SQ.FT. (13.0% 1,200 SQ.FT. (11.2% N/A 13,045 SQ.FT. 7,853 SQ.FT.
GROSS BUILDING AREA	FIRST FLOOR SECOND FLOOR THIRD FLOOR FOURTH FLOOR ROOF	INTERIOR 8,437 SQ.FT. 7,512 SQ.FT. 6,575 SQ.FT. 6,575 SQ.FT. 6,692 SQ.FT.

TOTAL 35,791 SQ.FT.


## FAR ANALYSIS

	LOBBY	Al	REA	GROS	AREA	
		AC	NON AC	AC	NON AC	FAR
1ST FL	LOBBY	90				
	TRASH ROOM		79			
	STAIR WELLS		251			
1ST FL	ELEVATORS	51		141	8,296	505
	PUMP ROOM		113		- ,— - •	
	GARAGE		7,853	- -		
	CORRIDOR	954				
	UNITS	5,121		_		
	STAIRWELLS	,	251	-		
2ND FL	ELEVATOR	51		6,126	1,386	6,377
	BALCONIES		1,135	_		
		054				
3RD FL	CORRIDOR	954		_	449	
	UNITS	5,121		_		
	STAIRWELLS	<b>54</b>	251	6,126		6,377
	ELEVATOR	51		- -		
	BALCONIES		198			
	CORRIDOR	954				
	UNITS	5,121				
471151	STAIRWELLS		251	0.400	4.40	6,377
4TH FL	ELEVATOR	51		6,126	449	
	BALCONIES		198	-		
	STAIRWELLS		251			
	ELEVATOR			-		
ROOF	ROOF AREA		6,441	-	6,692	251
				18,519	17,272	
				10,515	11,212	
OTAL GROS	SS AREA			35,7	'91 SF	
OTAL FAR A	ΔDEΛ					19,88

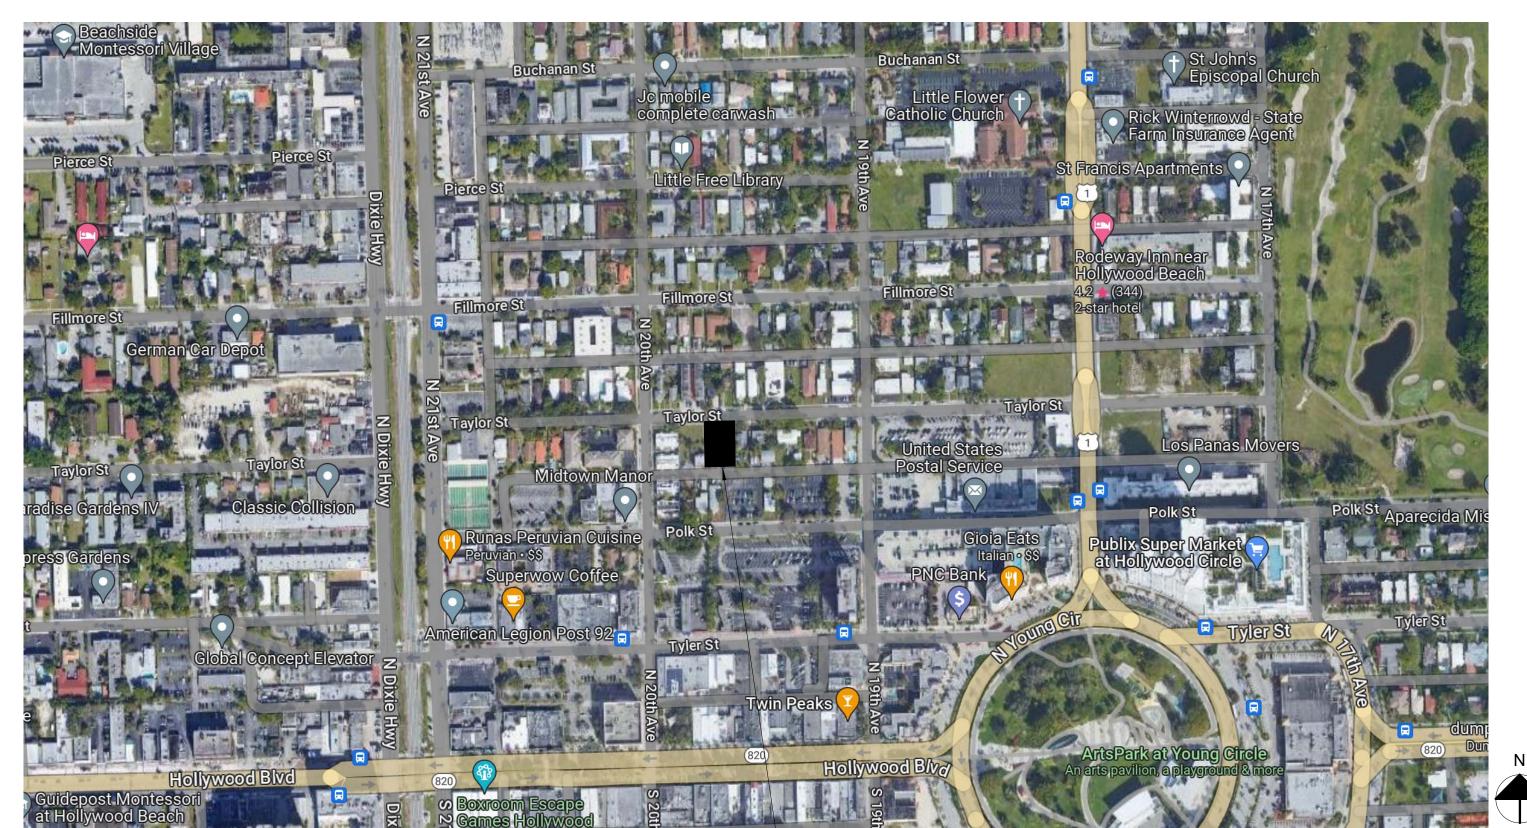

**LOCATION MAP** 

PROJECT ADDRESS: 1942 Taylor St, Hollywood, FL 33020

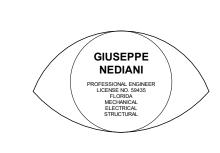

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ISSUED FOR

SEAL / SIGNATURE / DATE

SHEET TITLE

PROJECT DATA

SHEET NUMBER



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PARKING SPACES TYPE

TANDEM SPACES

SINGLE SPACES ADA SPACES

**GUEST SPACES** 

TOTAL


<u>COUNT</u>

8 (16 SINGLE)

SHEET TITLE

SITE PLAN

SHEET NUMBER

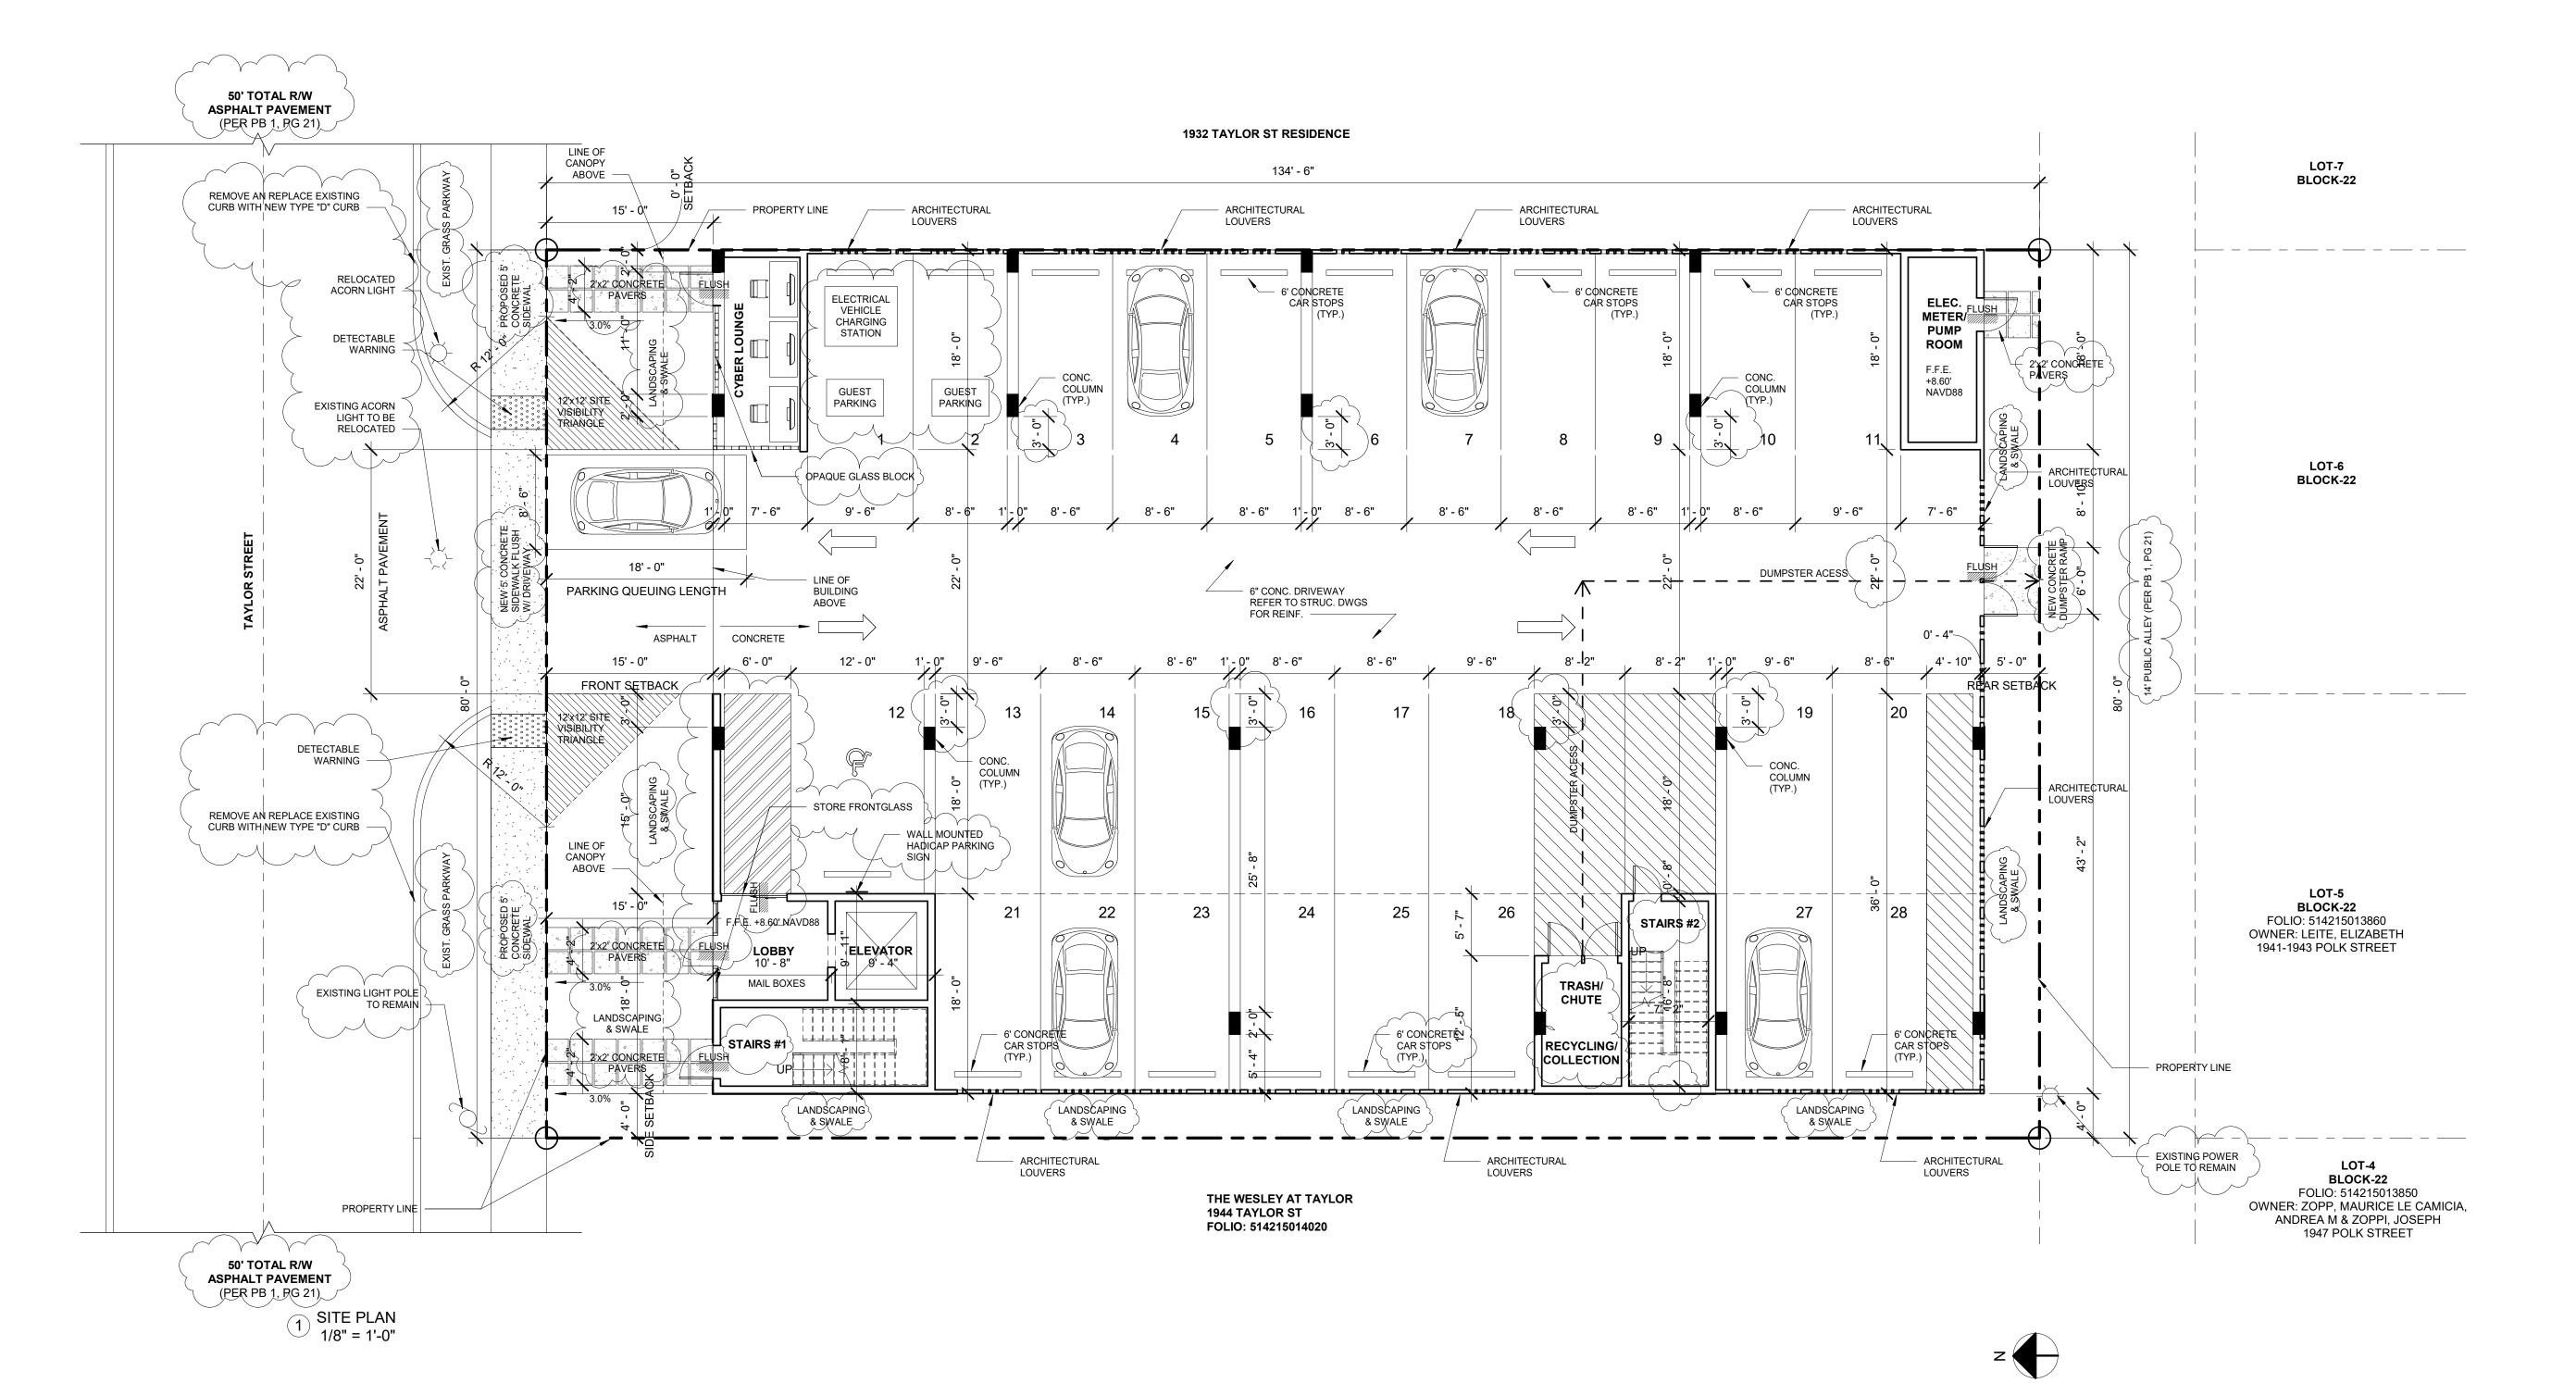

SITE PLAN NOTES:

1. PROVIDE SOIL TREATMENT FOR TERMITE PROTECTION, TYP. FOR ENTIRE SITE.

2. SIDE YARDS LOW RETENTION WALLS WITH SMOOTH STUCCO FINISH PAINTED. COORDINATE SITE GRADE CHANGE TRANSITION REFER TO LANDSCAPE & STRUCTURAL DRAWINGS FOR RETAINING WALL DETAILS.

3. REFER TO LANDSCAPING DWGS FOR PLANTING. REFER TO CIVIL DWGS FOR GRADING.

4. FLOOD ELEVATION 8.6' N.A.V.D.

5. DURING CONSTRUCTION GC TO PREVENT ANY VEHICLE TRACKING ON ROADWAYS BY CREATING WASH DOWN AREAS ON SITE AS REQUIRED. ALL NEAR BY STORM DRAIN CATCH BASINS TO BE PROTECTED WITH FILTER FABRIC. PORTABLE TOILET TO BE 5' FROM PROPERTY LINES AND TO NOT BE NEAR ANY CATCH BASINS OR BODY OF WATER.

6. ALL CHANGES TO THE DESIGN WILL REQUIRE PLANNING REVIEW AND MAY BE SUBJECT TO BOARD APPROVAL.

7. ALL SIGNAGE SHALL BE IN COMPLIANCE WITH THE ZONING AND LAND DEVELOPMENT REGULATIONS.

8. ALL SIGNS, WHICH ARE ELECTRICALLY ILLUMINATED BY NEON OR OTHER MEANS, SHALL REQUIRE A SEPARATE ELECTRICAL PERMIT AND INSPECTION. SEPARATE PERMITS AER REQUIRED FOR EACH SIGN.

11. NO GARAGE ENTRY DOOR SHALL BE USED TO ALLOW FOR QUEUING.

12. TANDEM SPACES SHALL COUNT TOWARDS A SINGLE UNIT.

14. FOR UTILITIES WORK WITHIN RIGHT-OF-WAY, ROW PERMIT WILL BE REQUIRED AT THE TIME OF PERMIT

15. ALL OUTSIDE AGENCY PERMITS ARE REQUIRED AT THE TIME OF CITY BUILDING PERMIT REVIEW.

16. IMPACT PAYMENT FEES (INCLUSIVE OF PARK PAYMENT FEE) TO BE MADE AT TIME OF CITY BUILDING PERMIT ISSUANCE.


17. COORDINATION WITH BUILDING DEPARTMENT SHALL OCCUR DURING PERMITTING TO ENSURE ADEQUATE VENTILATION IS PROVIDED FOR THE PARKING GARAGE.


18. ANY LIP FROM 1/4" BUT NOT GREATER THAN 1/2" WILL BE BEVELED TO MEET ADA REQUIREMENTS.


9. MAXIMUM FOOT CANDLE LEVEL AT ALL PROPERTY LINES MAXIMUM 0.5 IF ADJACENT TO RESIDENTIAL.


10. 36' OF ACTIVE USE PROVIDED AT GROUND LEVEL (45%).

13. MOT PLANS TO BE PROVIDED AT TIME OF PERMIT.

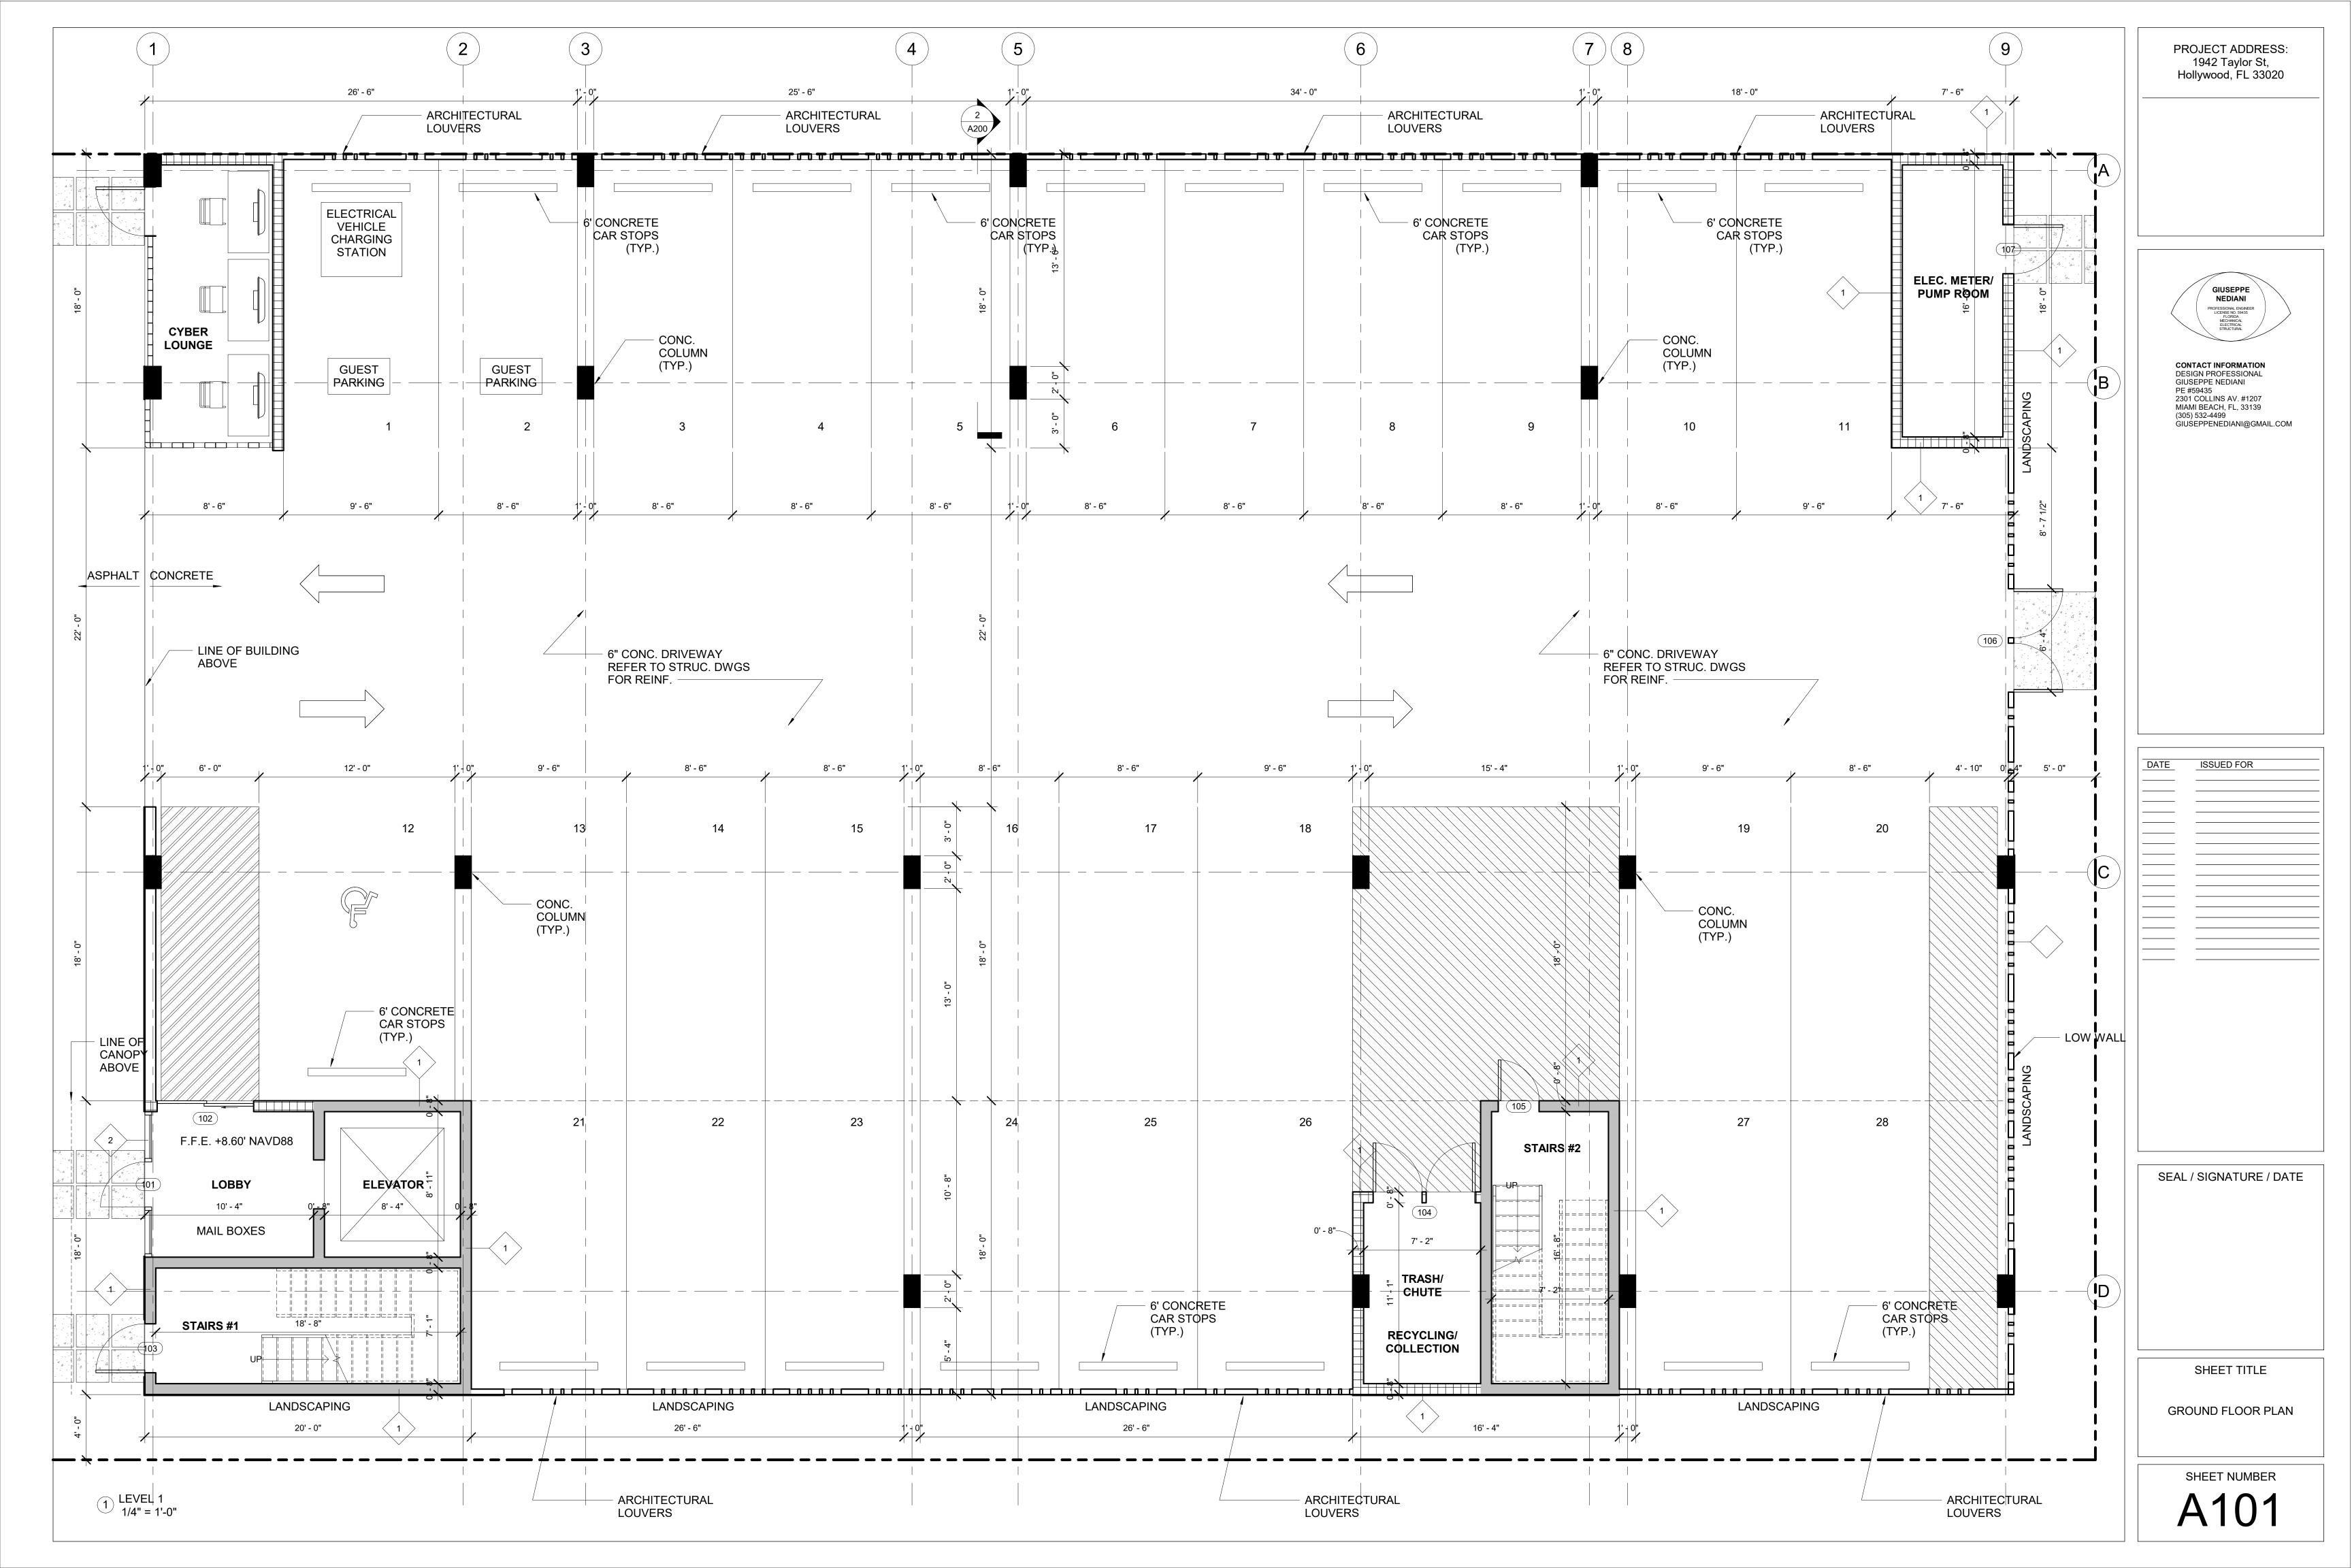

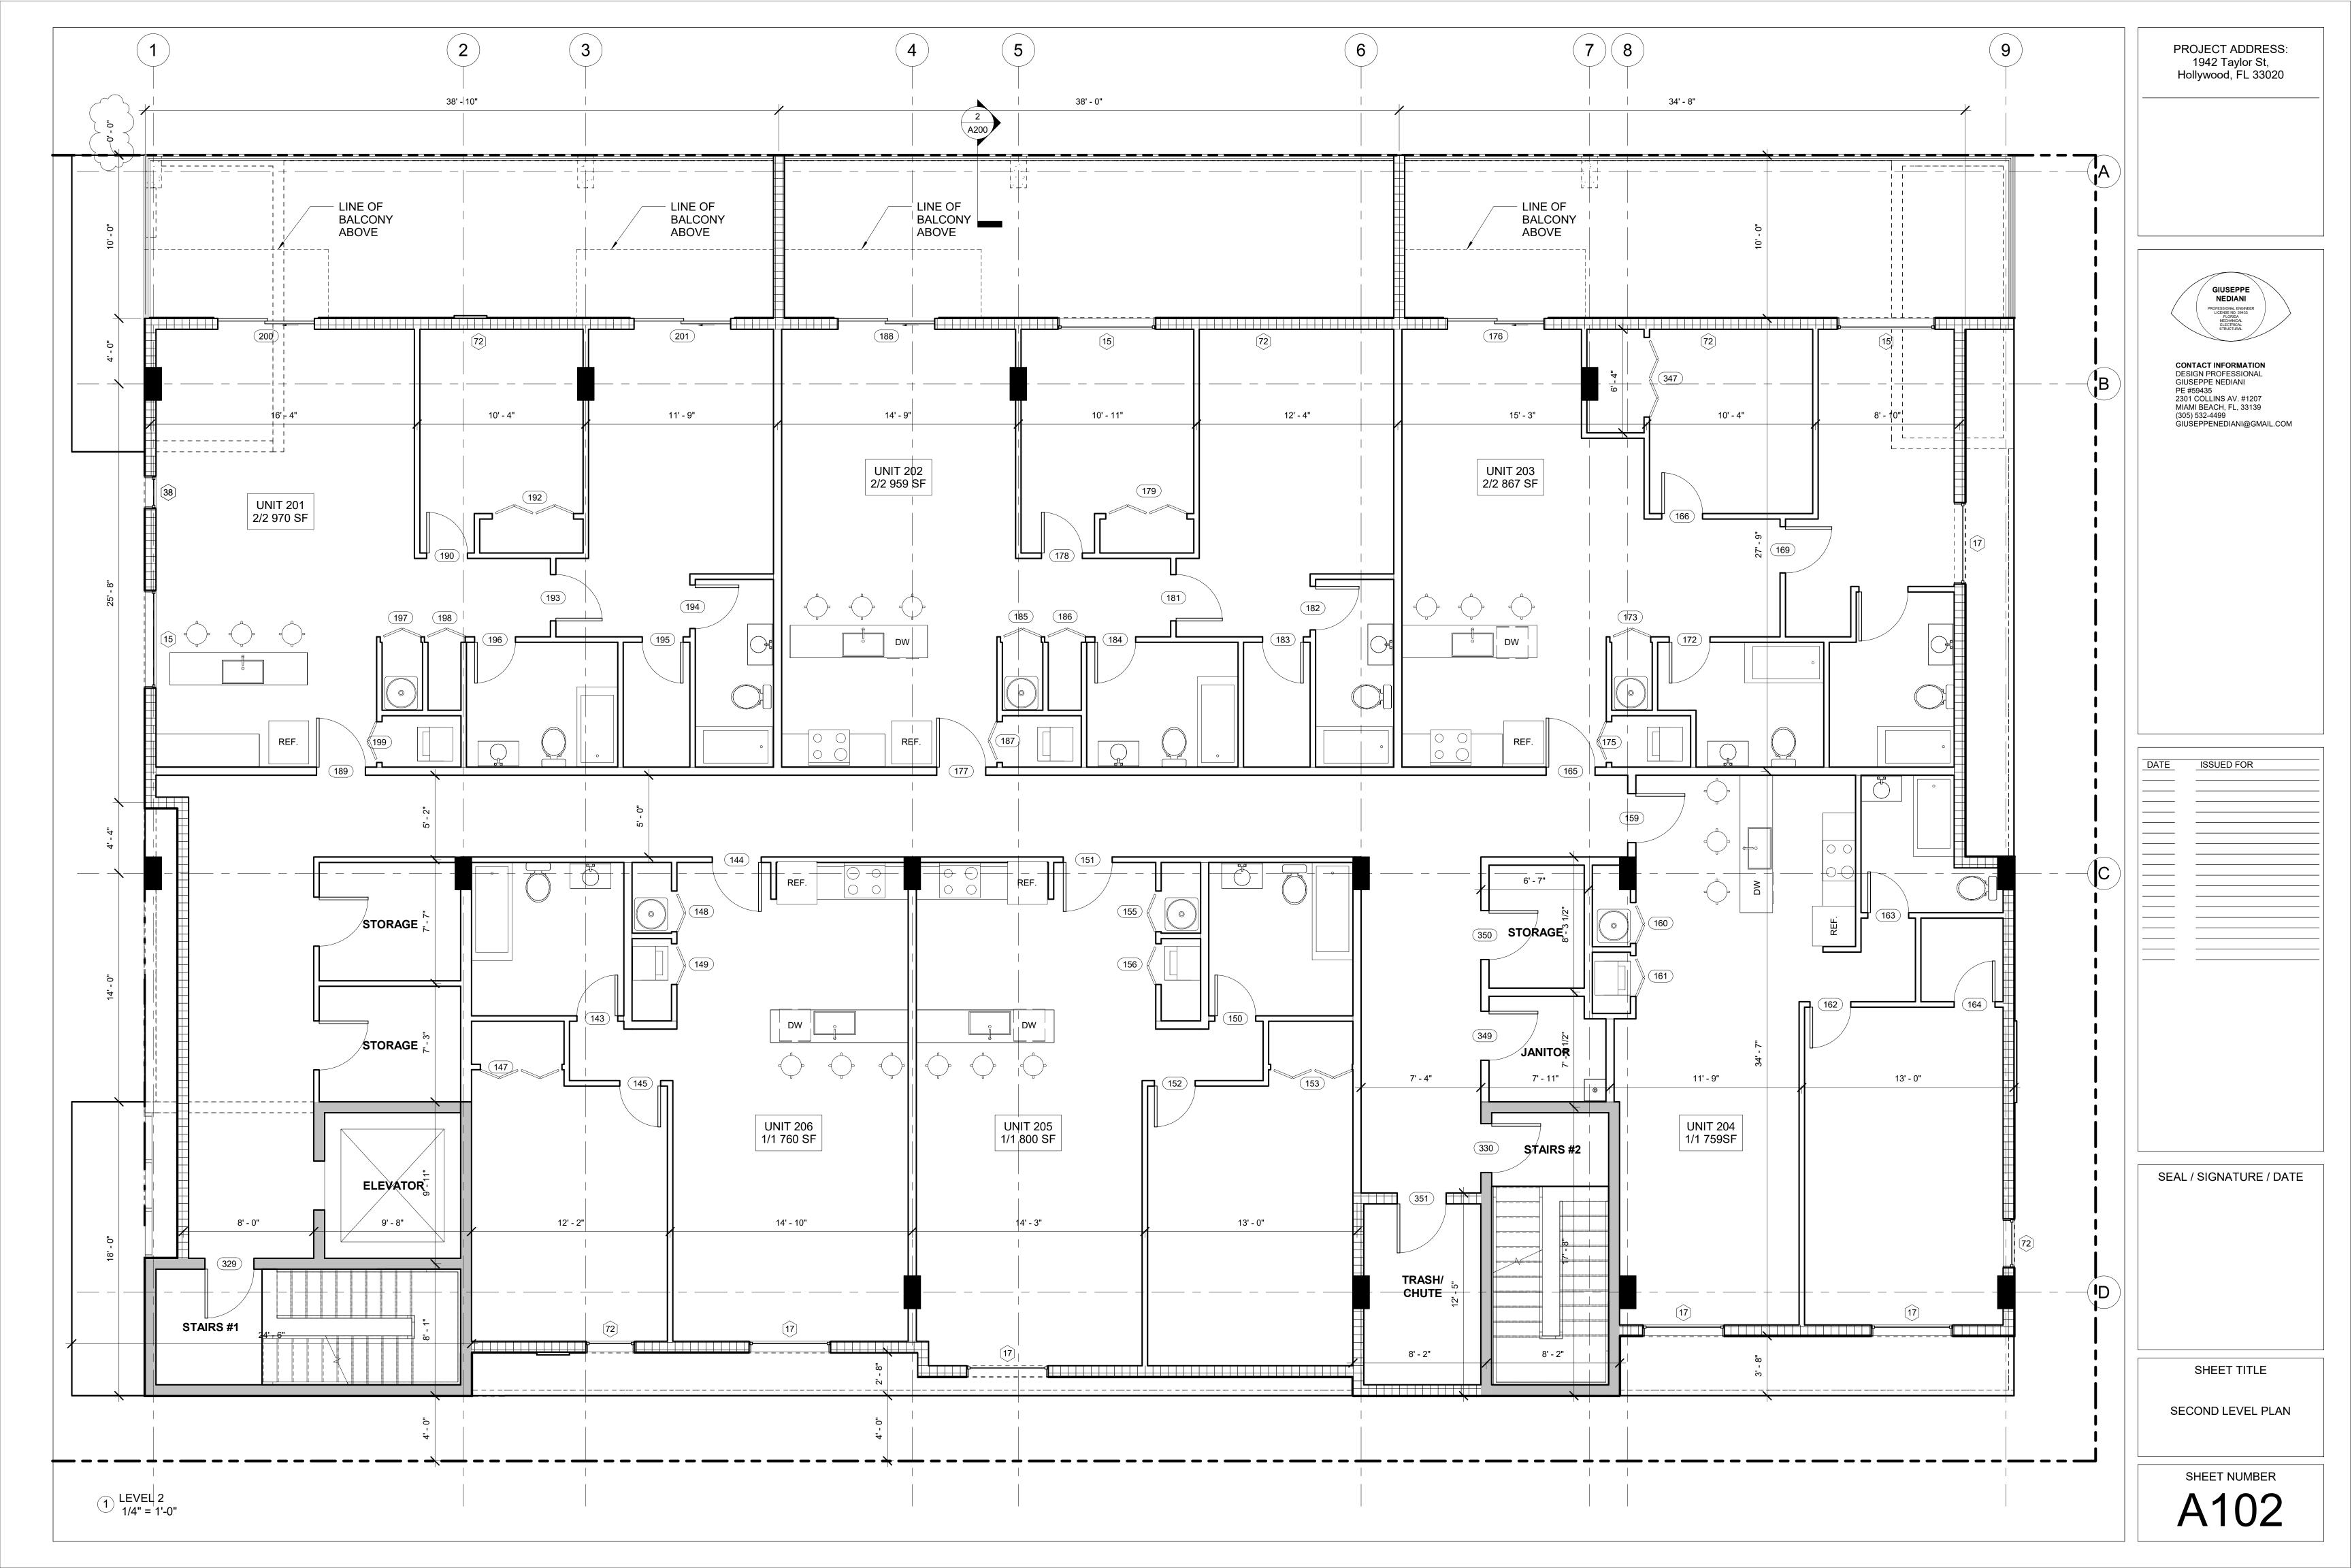

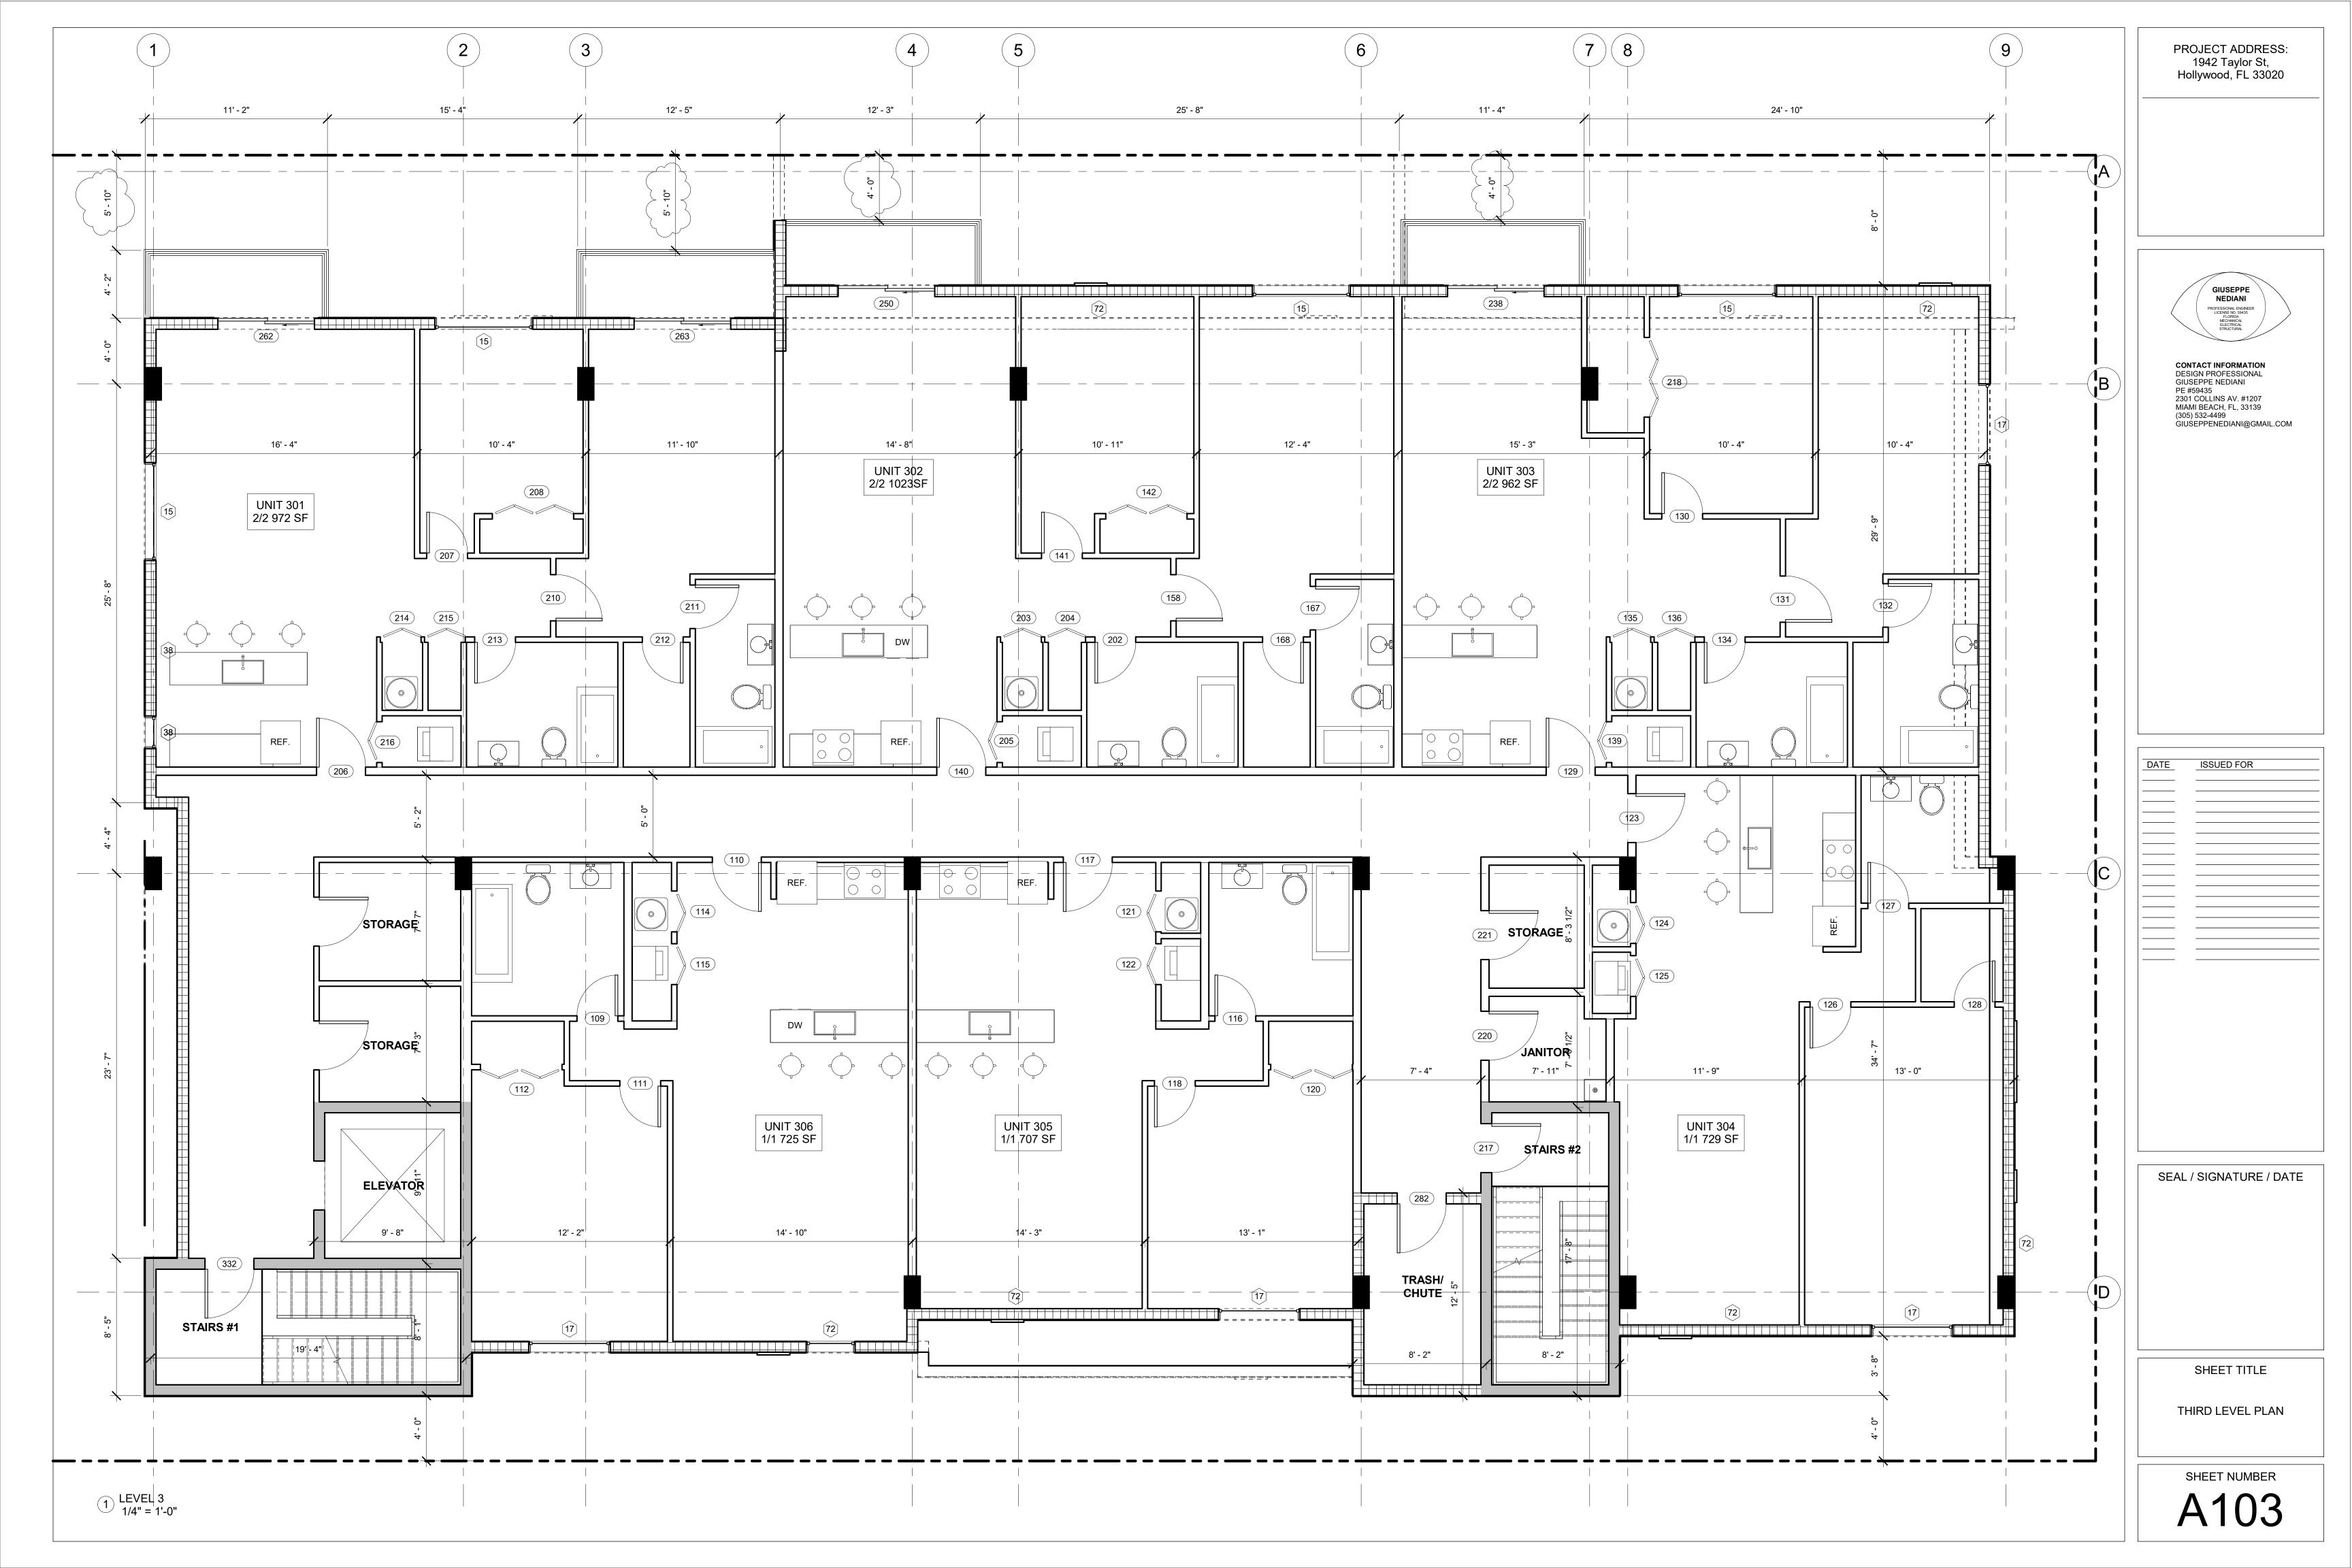

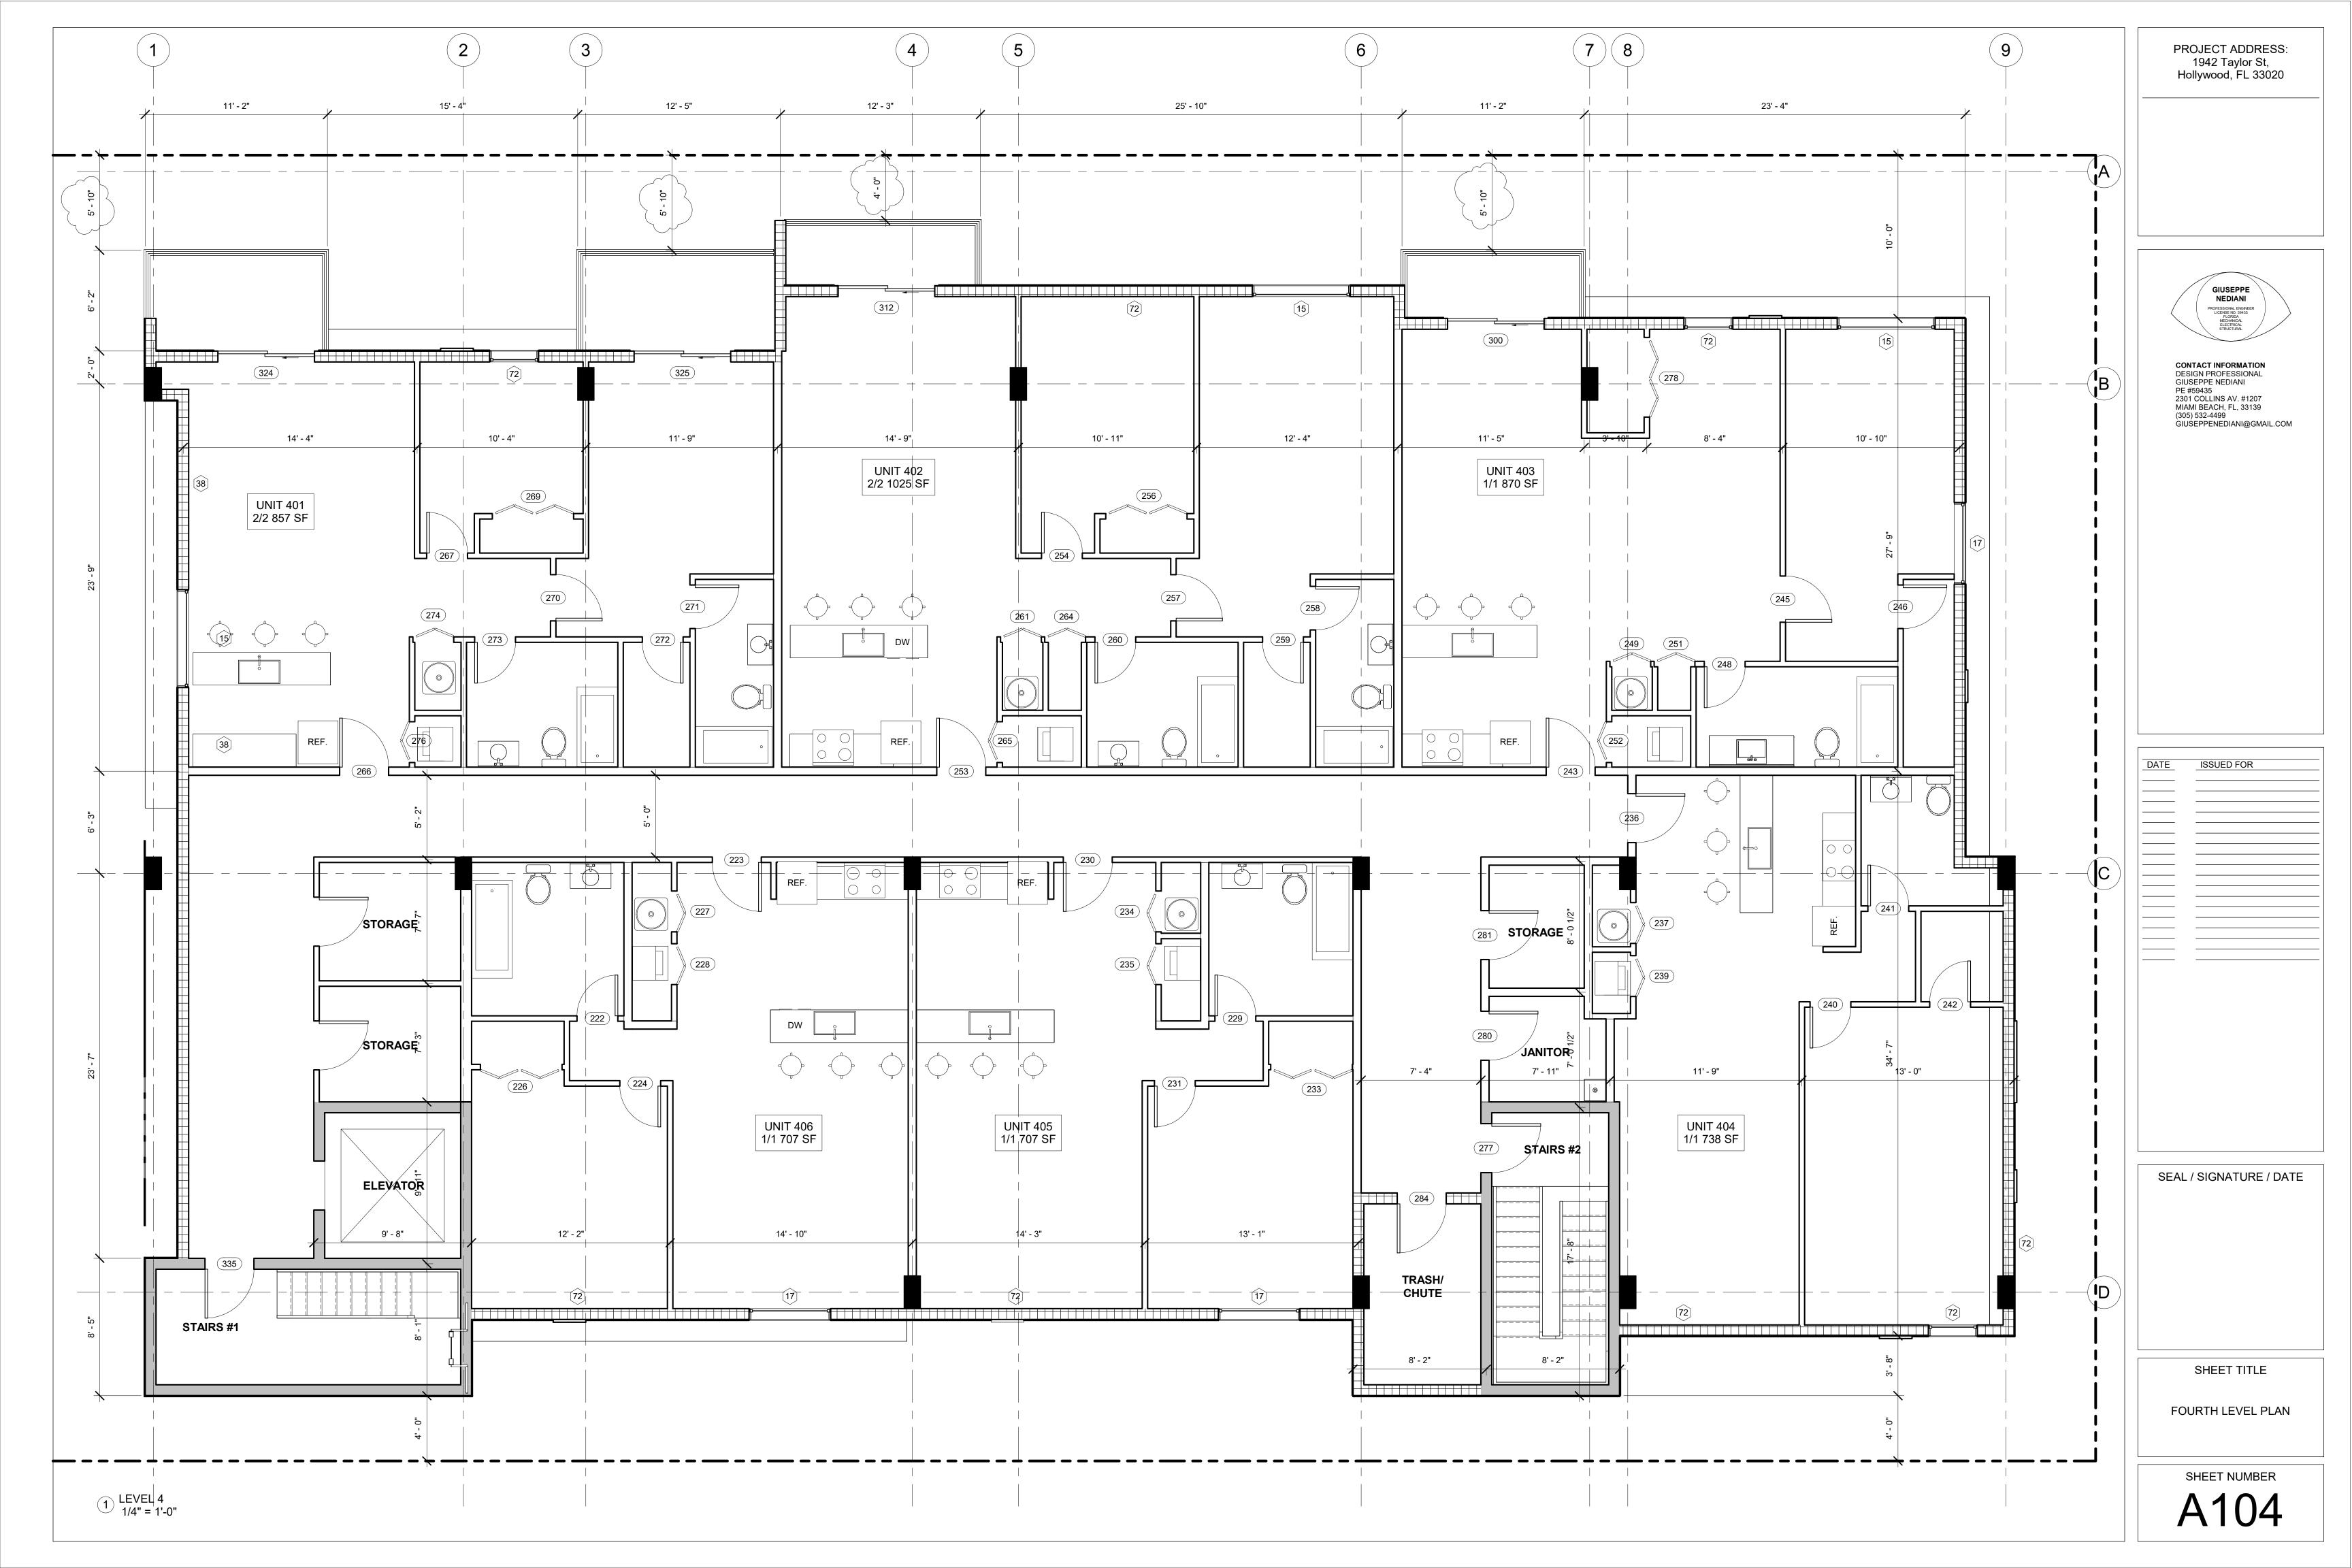

PROJECT ADDRESS: 1942 Taylor St, Hollywood, FL 33020 15' - 0" REAR SETBACK FRONT SETBACK GIUSEPPE NEDIANI ROOF LEVEL 45' - 4" CONTACT INFORMATION DESIGN PROFESSIONAL GIUSEPPE NEDIANI GIOSEPPE NEDIANI
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GIUSEPPENEDIANI@GMAIL.COM LEVEL 4 34' - 0" 7' - 11" \_LEVEL 3 22' - 8" 10' - 6" 4' - 6" LEVEL 2 11' - 4" ISSUED FOR OPEN VENTILATION OPEN VENTILATION |-—— OPEN VENTILATION —  $(\mathsf{B})$ - 4" REINF. CONC. SLAB SEAL / SIGNATURE / DATE 16" PRECAST JOISTS FOR SPACING REFER TO STRC. DWGS. LEVEL 1 0' - 0" SHEET TITLE EAST ELEVATION THICKENED EDGE SHEET NUMBER ISOLATED FOOTING (BEYOND) 2 SECTION 2/A200 1/4" = 1'-0"

PROJECT ADDRESS: 1942 Taylor St, Hollywood, FL 33020



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ISSUED FOR

\_\_\_\_

SEAL / SIGNATURE / DATE

SHEET TITLE

EAST ELEVATION RENDERING

SHEET NUMBER
A200a



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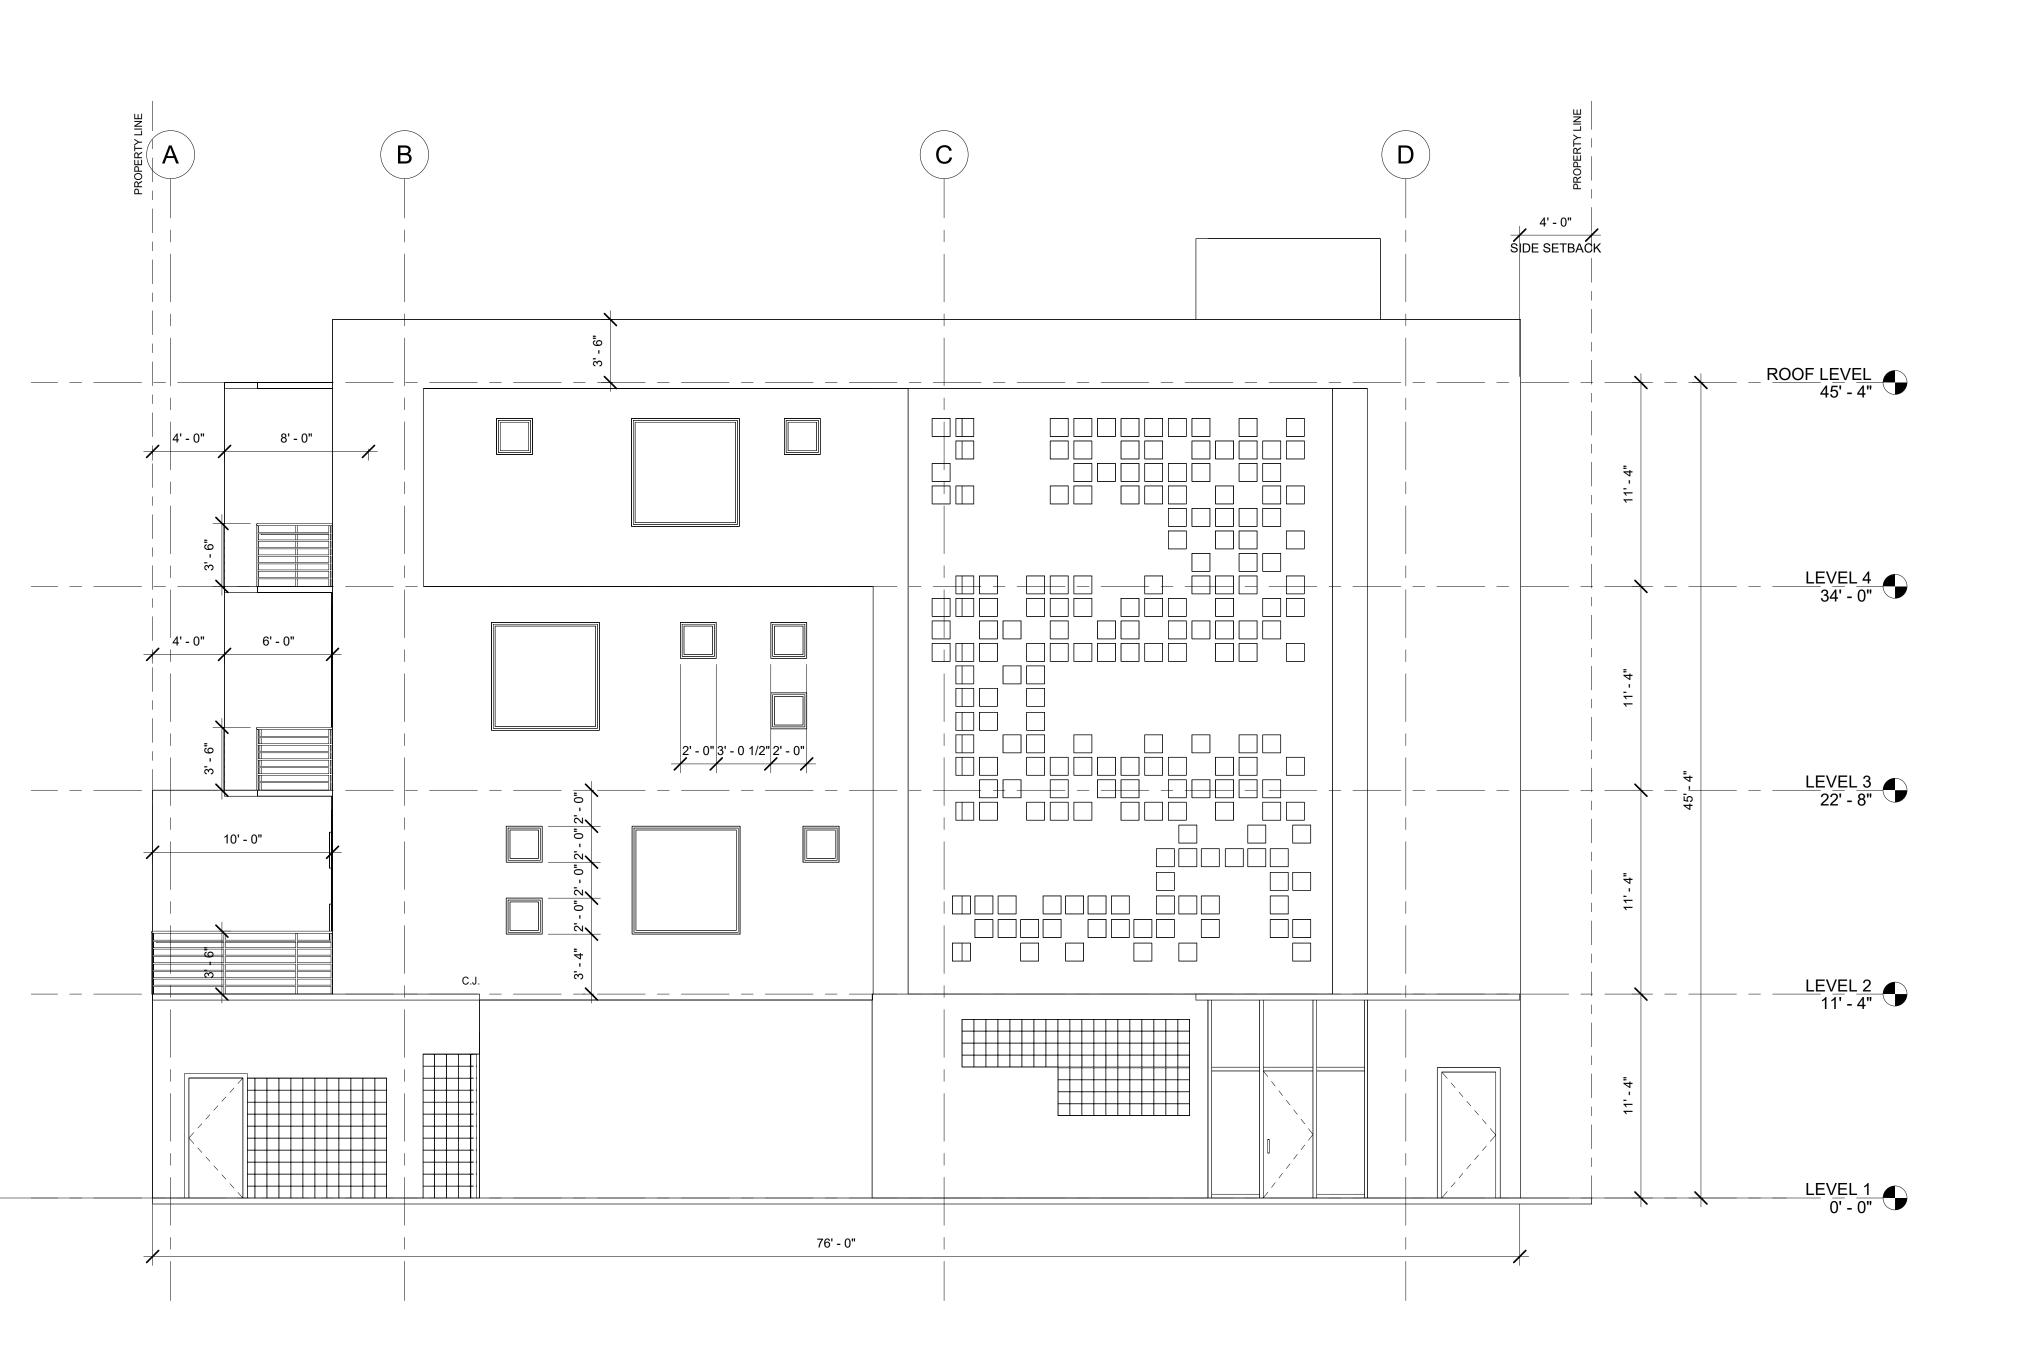
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SHEET TITLE


NORTH ELEVATION

SHEET NUMBER
A201



NORTH ELEVATION 3/16" = 1'-0"

PROJECT ADDRESS: 1942 Taylor St, Hollywood, FL 33020

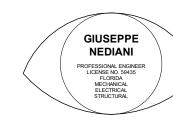

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ISSUED FOR

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SHEET TITLE

NORTH ELEVATION RENDERING

SHEET NUMBER

A201a

OPEN VENTILATION

OPEN VENTILATION

1 WEST ELEVATION 3/16" = 1'-0"

PROJECT ADDRESS: 1942 Taylor St, Hollywood, FL 33020



CONTACT INFORMATION
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DATE ISSUED FOR

SEAL / SIGNATURE / DATE

SHEET TITLE

WEST ELEVATION

Δ202

SHEET NUMBER



PROJECT ADDRESS: 1942 Taylor St, Hollywood, FL 33020



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SEAL / SIGNATURE / DATE


SHEET TITLE

WEST ELEVATION RENDERING

SHEET NUMBER
A202a

1 SOUTH ELEVATION 3/16" = 1'-0"

PROJECT ADDRESS: 1942 Taylor St, Hollywood, FL 33020

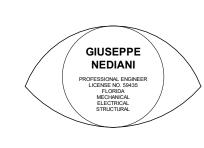

CONTACT INFORMATION
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SHEET TITLE

SOUTH ELEVATION

**A203** 

SHEET NUMBER



PROJECT ADDRESS: 1942 Taylor St, Hollywood, FL 33020



CONTACT INFORMATION
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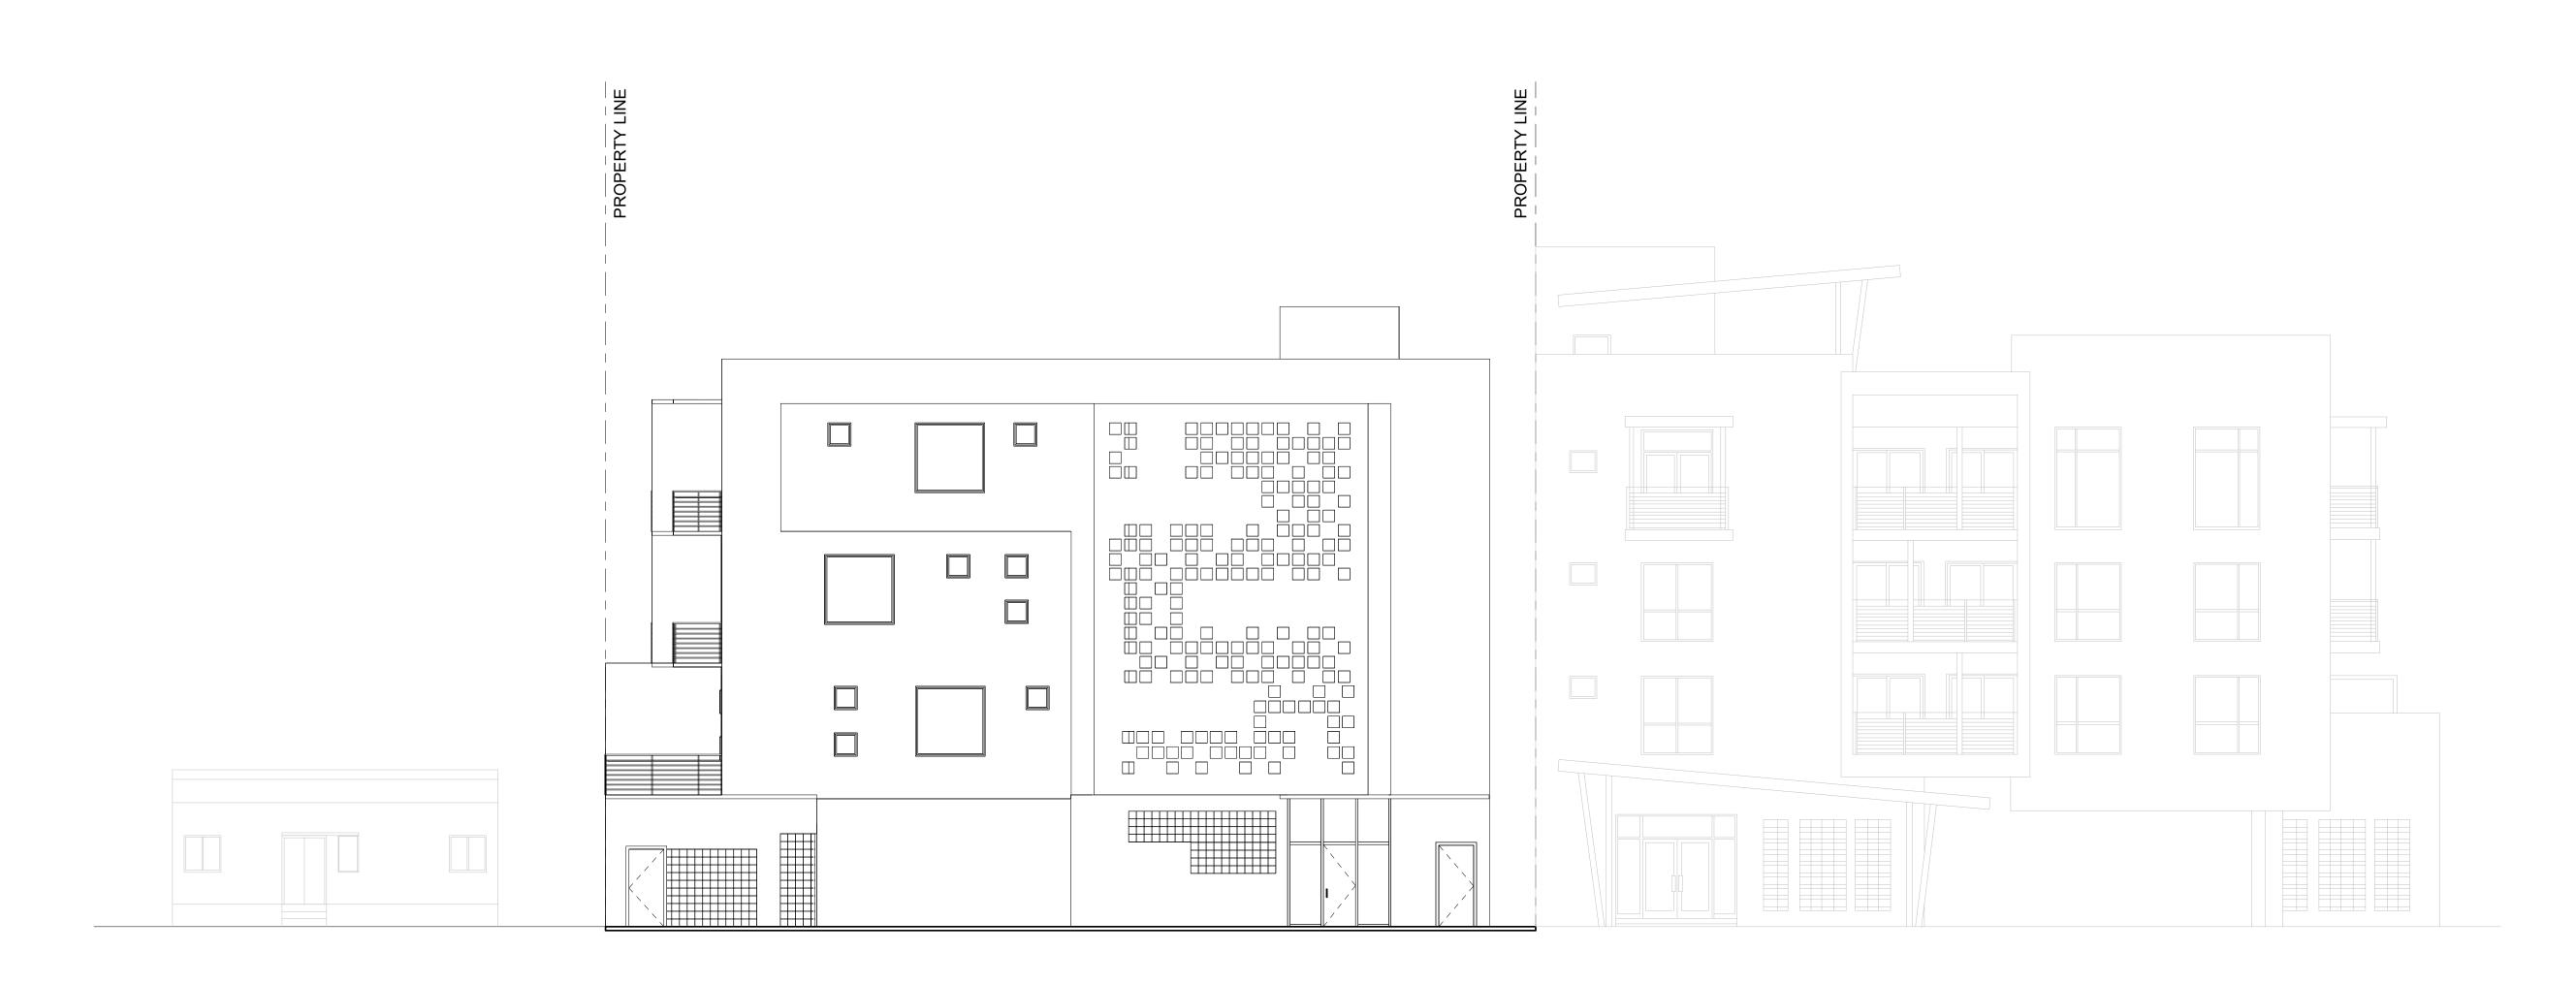
ISSUED FOR

SEAL / SIGNATURE / DATE


SHEET TITLE

SOUTH ELEVATION RENDERING

SHEET NUMBER
A203a



1 CONTEXT 1/8" = 1'-0" PROJECT ADDRESS: 1942 Taylor St, Hollywood, FL 33020

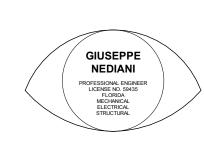

CONTACT INFORMATION
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DATE ISSUED FOR

SEAL / SIGNATURE / DATE

SHEET TITLE

CONTEXT ELEVATION


SHEET NUMBER

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PROJECT ADDRESS: 1942 Taylor St, Hollywood, FL 33020



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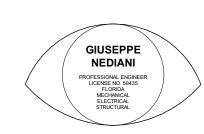
SHEET TITLE

CONTEXT RENDERINGS

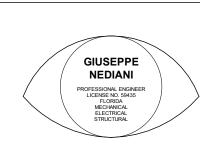SHEET NUMBER

A205

PROJECT ADDRESS: 1942 Taylor St, Hollywood, FL 33020



CONTACT INFORMATION
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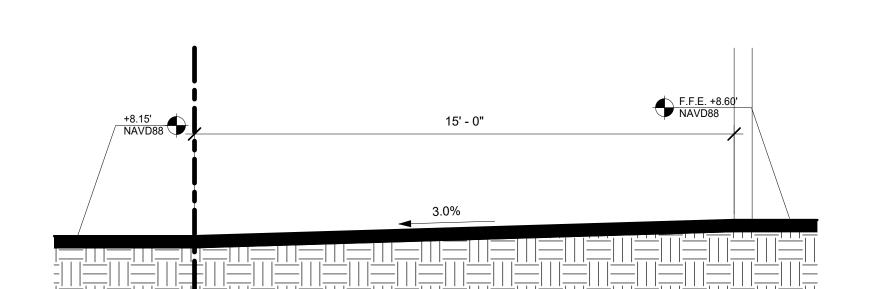
SEAL / SIGNATURE / DATE


SHEET TITLE


SITE PLAN


SHEET NUMBER

1) SITE PLAN 1/8" = 1'-0"



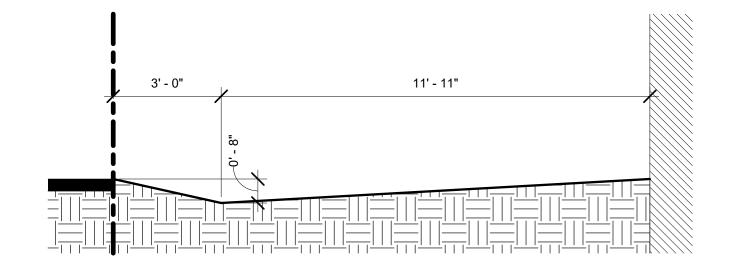

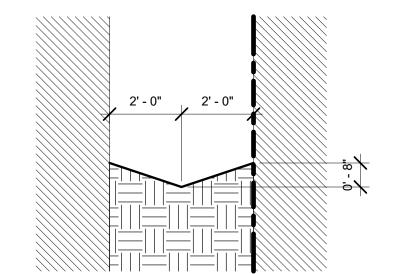

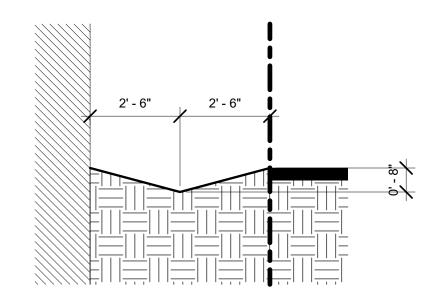

1 SECTION 1 3/8" = 1'-0"

2 SECTION 2 3/8" = 1'-0"

3 SECTION 3 3/8" = 1'-0"


4 SECTION 4 3/8" = 1'-0"


CONTACT INFORMATION DESIGN PROFESSIONAL GIUSEPPE NEDIANI PE #59435 2301 COLLINS AV. #1207 MIAMI BEACH, FL, 33139 (305) 532-4499 GIUSEPPENEDIANI@GMAIL.COM


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PROJECT ADDRESS: 1942 Taylor St, Hollywood, FL 33020






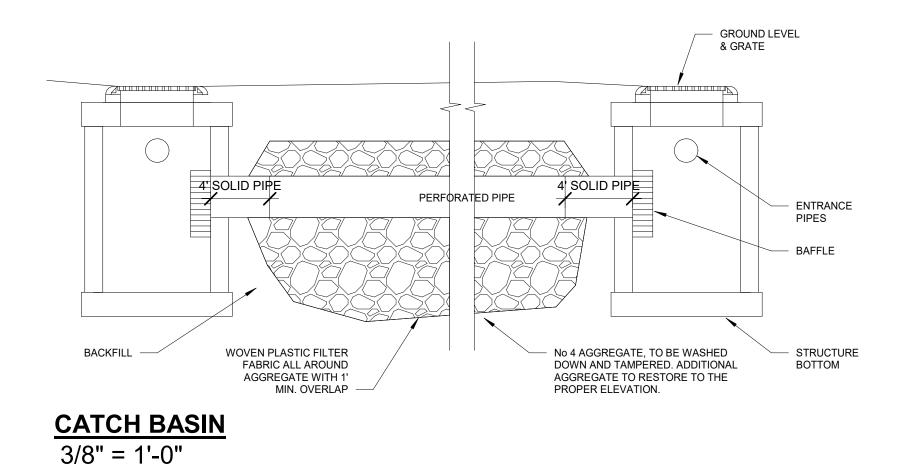


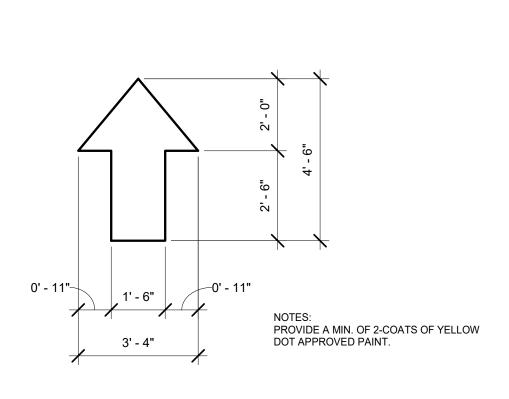TRAFFIC CONTROL
ARROW DETAIL
3/8" = 1'-0"

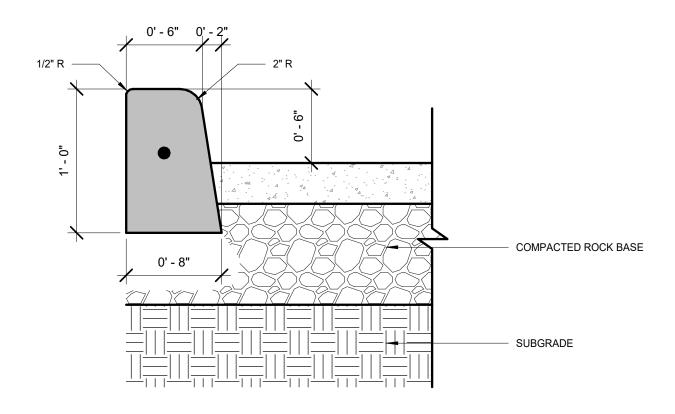
TYP. TYPE D CONC. CURB 1 1/2" = 1'-0"

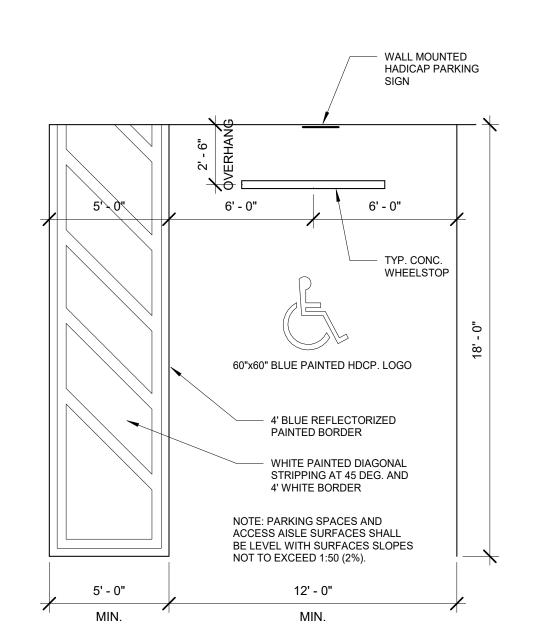

TYP. PARKING HANDICAP
STALL DETAIL
1/4" = 1'-0"

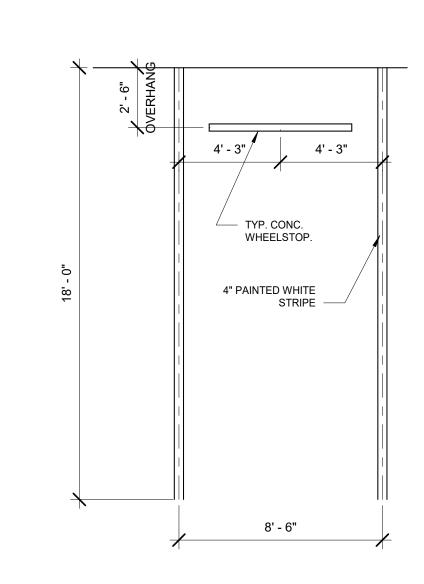


TYP. PARKING STALL
DETAIL
1/4" = 1'-0"

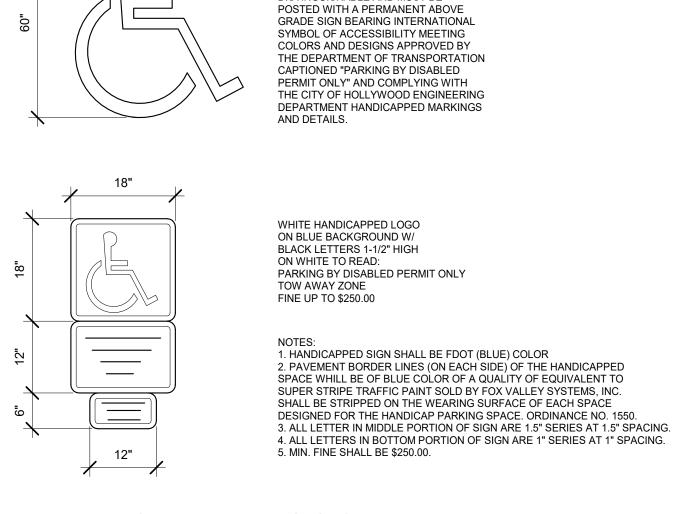

EACH ACCESSIBLE PARKING SPACE MUST BE PROMINENTLY OUTLINED WITH BLUE PAINT AND REPAINTED AS

NECESSARY TO BE CLEARLY DISTINGUISHABLE AND MUST BE

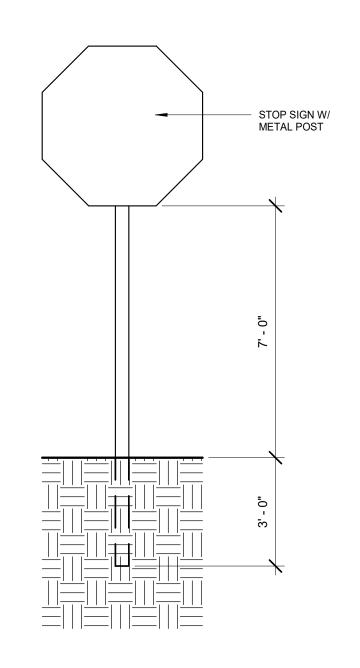

HANDICAP PARKING SIGN
DETAILS
3/8" = 1'-0"


**TYP. STOP SIGN DETAIL** 3/8" = 1'-0"

SHEET TITLE


SEAL / SIGNATURE / DATE

DETAILS/SECTIONS

SHEET NUMBER

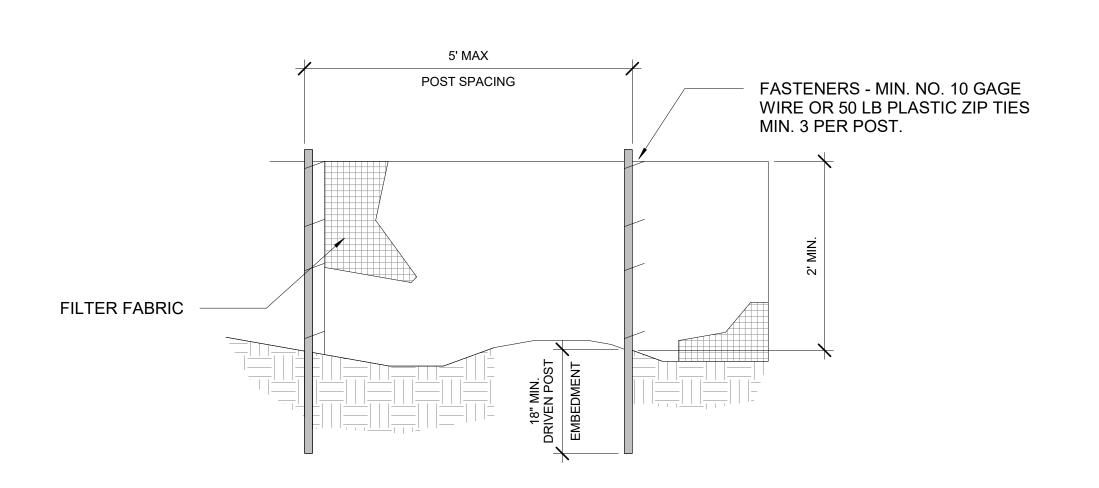


DIVERSION RIDGE REQUIRED WHERE GRADE EXCEEDS 2%

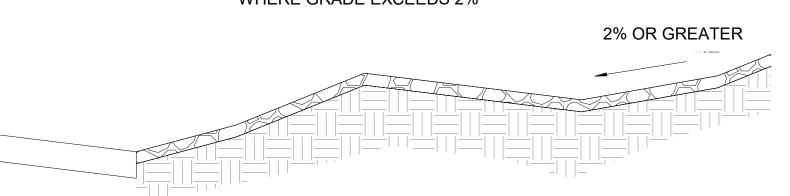


EXISTING PAVED ROADWAY

SECTION A-A

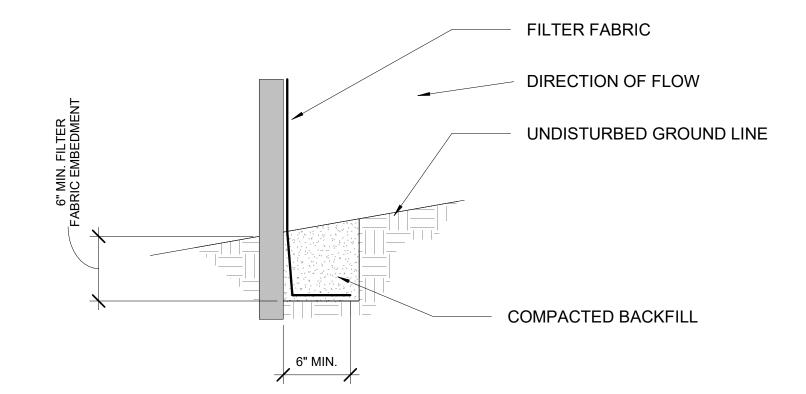

**FABRIC ANCHOR DETAIL** 


**ELEVATION** 

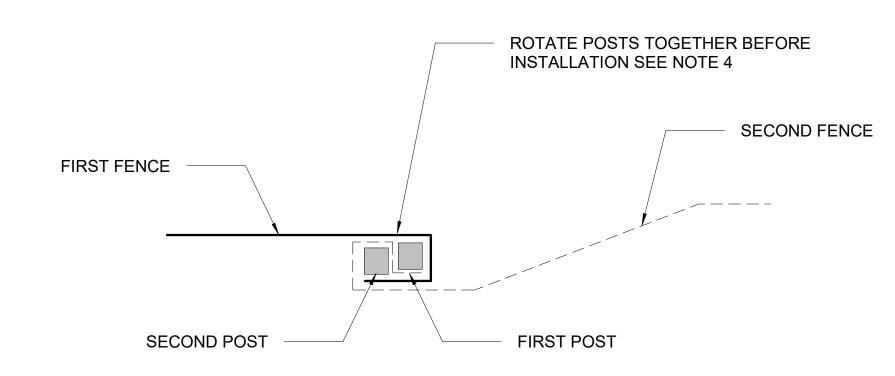

WHEN SPLICES ARE NECESSARY MAKE SPLICE AT POST ACCORDING TO SPLICE DETAIL. PLACE THE END POST OF THE SECOND FENCE INSIDE THE END POST OF THE FIRST FENCE. ROTATE BOTH POSTS TOGETHER AT LEAST 180 DEGREES TO CREATE A TIGHT SEAL WITH THE FABRIC MATERIAL. CUT THE FABRIC NEAR THE BOTTOM OF THE POSTS TO ACCOMODATE THE 6 INCH FLAP. THEN DRIVE BOTH POSTS AND BURY THE FLAP. COMPACT BACKFILL WELL.

SPLICE DETAIL-PLAN VIEW

**STORMWATER POLLUTION PREVENTION DETAILS** 

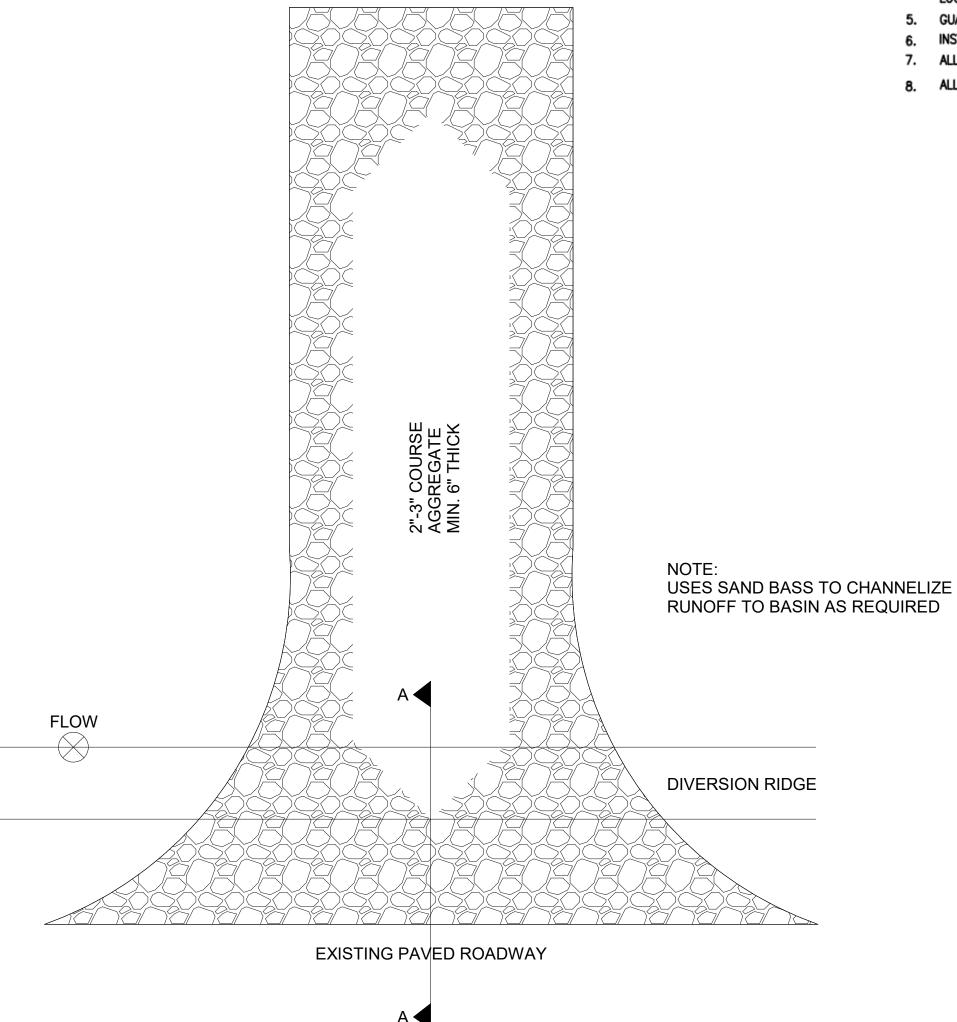

TEMPORARY CONSTRUCTION ENTRANCE

**BACKFLOW PREVENTER** 

VARIABLE

CLEARANCE

(SEE NOTE#1)

UNISTRUT & COPPER CLAMP FOR PIPE-SUPPORT (AS NEEDED)

THREADED BRASS OR

PIPE & FITTINGS ONLY

THREADED BRASS OR —

WELDED COPPER PIPE & FITTINGS ONLY

OR COUNTY PLUMBING—/

₩ELDED COPPER

PLUMBING AS APPROVED BY CITY

REDUCED PRESSURE ZONE BACKFLOW PREVENTION ASSEMBLY (SEE NOTE #4)

CONC. SLAB

\_W/#4@12"

CONC. SLAB

OF ASSEMBLY

6" THK CONCRETE SLAB

TO EXTEND 24" ON BOTH

SIDES & 12" ON BOTH ENDS

TEST COCK (TYP)

6" LONG THRD

1. THE ASSEMBLY MUST BE INSTALLED WITH MINIMUM HORIZONTAL CLEARANCE OF 18" MINIMUM TO 30" MAXIMUM, FREE FROM OBSTRUCTIONS IN ALL

2. THE BACKFLOW PREVENTION ASSEMBLY SHALL BE ON THE APPROVED LIST OF FOUNDATION FOR CROSS CONNECTION AND HYDRAULIC RESEARCH CONTROL OF THE UNIVERSITY OF SOUTHERN CALIFORNIA. CONTRACTOR TO PROVIDE MANUFACTURERS CERTIFICATION OF U.S.C.

ALL BACKFLOW PREVENTION ASSEMBLIES 3" AND SMALLER SHALL BE FACTORY ASSEMBLED INCLUDING SHUT OFF VALVE AS REQUIRED BY U.S.C. FOUNDATION FOR CROSS CONNECTION CONTROL STANDARDS. ON DEVICES.

4. BACKFLOW PREVENTION ASSEMBLIES SHALL BE INSTALLED IN AN ACCESSIBLE LOCATION APPROVED BY CITY OF NORTH MIAMI BEACH PUBLIC UTILITIES. LOCATIONS INSIDE BUILDING OR WITH OTHERWISE RESTRICTED ACCESS WILL NOT BE APPROVED.

5. GUARDPOSTS OR PROTECTIVE ENCLOSURE MAY BE REQUIRED DEPENDING ON SITE CONDITIONS.

INSTALL PIPE SUPPORTS AS NEEDED.

ALL PIPE AND FITTINGS 2" AND SMALLER SHALL BE BRASS OR COPPER.

CNMB - PRIVATE PROPERTY

GUARDPOST TO BE GALV. STEEL PIPE SCH. 40, 4" DIA. x 5'

(BURIED 2.5'±)~

(4 REQUIRED)

INDEPENDENT

?\*


CONÇ. SLAB

INDEPENDENT OF SLAB (SEE NOTE 5)

8. ALL EXPOSED METALLIC THREADS SHALL BE PAINTED WITH BITUMASTIC PAINT. ALL OUTLETS SHALL BE PLUGGED WITH BRASS.

Hollywood, FL 33020

PROJECT ADDRESS: 1942 Taylor St,

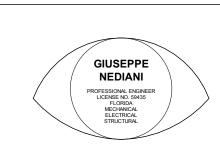

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ISSUED FOR

3229 NE 169TH ST, NORTH MIAMI BEACH, FL 33160

SEAL / SIGNATURE / DATE

SHEET TITLE

DETAILS SECTIONS

SHEET NUMBER

#### **GENERAL NOTES:**

- 1. THE INFORMATION PROVIDED IN THESE DRAWINGS IS SOLELY TO ASSIST THE CONTRACTOR IN ASSESSING THE NATURE AND EXTENT OF CONDITIONS WHICH WILL BE ENCOUNTERED DURING THE COURSE OF THE WORK. THE CONTRACTORS ARE DIRECTED, PRIOR TO BIDDING, TO CONDUCT WHATEVER INVESTIGATIONS THEY DEEM NECESSARY TO ARRIVE AT THEIR OWN CONCLUSION REGARDING THE ACTUAL CONDITIONS THAT WILL BE ENCOUNTERED, AND UPON WHICH BIDS WILL BE BASED.
- 2. ALL CONSTRUCTION AND MATERIALS SHALL CONFORM TO APPLICABLE STANDARDS AND SPECIFICATIONS OF THE CITY OF HOLLYWOOD DEPARTMENT OF PUBLIC UTILITIES, ENGINEERING AND CONSTRUCTION SERVICES DIVISION (ECSD), AND ALL OTHER LOCAL, STATE AND NATIONAL CODES, WHERE APPLICABLE.
- 3. LOCATIONS, ELEVATIONS, SIZES, MATERIALS, ALIGNMENTS, AND DIMENSIONS OF EXISTING FACILITIES, UTILITIES AND OTHER FEATURES ARE SHOWN ACCORDING TO THE BEST INFORMATION AVAILABLE AT THE TIME OF THE PREPARATION OF THESE PLANS; AND DO NOT PURPORT TO BE ABSOLUTELY CORRECT. ALSO, THERE MAY HAVE BEEN OTHER IMPROVEMENTS, UTILITIES, ETC., WITHIN THE PROJECT AREA WHICH WERE CONSTRUCTED AFTER THE PREPARATION OF THESE PLANS AND/OR THE ORIGINAL SITE SURVEY. THE CONTRACTOR SHALL VERIFY THE LOCATIONS, ELEVATIONS, AND OTHER FEATURES AFFECTING HIS/HER WORK PRIOR TO CONSTRUCTION, AND NOTIFY THE ENGINEER IMMEDIATELY WHEN CONFLICT BETWEEN DRAWINGS AND ACTUAL CONDITIONS ARE DISCOVERED. THE ENGINEER ASSUMES NO RESPONSIBILITY FOR ANY FACILITIES SHOWN OR NOT SHOWN ON THE PLANS. THE CONTRACTOR SHALL WORK AS NEEDED TO AVOID CONFLICT WITH EXISTING UTILITIES (NO ADDITIONAL COST SHALL BE PAID FOR THIS WORK). EXISTING UTILITIES SHALL BE MAINTAINED IN SERVICE DURING CONSTRUCTION UNLESS OTHERWISE APPROVED BY THE RESPECTIVE UTILITY OWNER.
- 4. THE CONTRACTOR SHALL COORDINATE WITH ALL UTILITIES TO ARRANGE FOR THE RELOCATION AND TEMPORARY SUPPORT OF UTILITY FEATURES, ETC. AS NECESSARY TO COMPLETE THE WORK.
- 5. IT SHALL BE THE CONTRACTOR'S RESPONSIBILITY TO LOCATE AND PROTECT ANY AND ALL EXISTING UTILITIES ON THIS PROJECT, AND TO ENSURE THAT EXISTING UTILITIES ARE MAINTAINED IN SERVICE DURING CONSTRUCTION UNLESS APPROVED OTHERWISE BY THE UTILITY OWNER.
- 6. CONTRACTOR SHALL ADJUST ALL EXISTING UTILITY CASTINGS INCLUDING VALVE BOXES, MANHOLES, HAND-HOLES, PULL-BOXES, STORMWATER INLETS, AND SIMILAR STRUCTURES IN CONSTRUCTION AREA TO BE OVERLAID WITH ASPHALT PAVEMENT.
- 7. THE CONTRACTOR IS REQUIRED TO OBTAIN ALL APPLICABLE CONSTRUCTION AND ENVIRONMENTAL PERMITS PRIOR TO THE START OF CONSTRUCTION.
- 8. THE CONTRACTOR SHALL NOTIFY ECSD AT LEAST 48 HOURS PRIOR TO BEGINNING CONSTRUCTION.
- 9. PRIOR TO THE COMMENCEMENT OF CONSTRUCTION AND INSTALLATION OF THE PROPOSED IMPROVEMENTS, SHOP DRAWINGS SHALL BE SUBMITTED TO ECSD IN ACCORDANCE WITH THE CONTRACT DOCUMENT'S REQUIREMENTS, FOR APPROVAL. IN ADDITION, IT IS THE CONTRACTOR'S RESPONSIBILITY TO OBTAIN ANY OTHER AGENCY SHOP DRAWING APPROVAL, IF REQUIRED.
- 10. THE CONTRACTOR SHALL NOTIFY ECSD IMMEDIATELY FOR ANY CONFLICT ARISING DURING CONSTRUCTION OF ANY IMPROVEMENTS SHOWN ON THESE DRAWINGS. THIS WORK BY THE CONTRACTOR SHALL BE CONSIDERED INCIDENTAL TO THE CONTRACT AND NO ADDITIONAL COMPENSATION SHALL BE ALLOWED.
- 11. ELEVATIONS SHOWN ARE IN FEET AND ARE REFERENCED TO THE NORTH AMERICAN VERTICAL DATUM OF 1988 (NAVD 88).

4	A HOLLYWOOD ATO	ISSUED:	03/01/1994	DEPARTMENT OF PUBLIC UTILITIES STANDARD DETAIL	REVISED: 06/08/2014
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### **GENERAL NOTES (CONTINUED):**

40. THE CONTRACTOR SHALL GIVE AT LEAST 48 HOURS NOTICE TO UTILITY COMPANIES TO PROVIDE FOR THE LOCATION OF EXISTING UNDERGROUND UTILITIES IN ADVANCE OF CONSTRUCTION. CONTACT UTILITIES NOTIFICATION CENTER AT 811 OR 1-800-432-4770 (SUNSHINE ONE-CALL OF FLORIDA).




- 41. WHEN PVC PIPE IS USED, A METALLIZED MARKER TAPE SHALL BE INSTALLED CONTINUOUSLY 18"
  ABOVE THE PIPE. THE MARKER TAPE SHOULD BE IMPRINTED WITH A WARNING THAT THERE IS
  BURIED PIPE BELOW. THE TAPE SHALL BE MAGNA TEC, AS MANUFACTURED BY THOR ENTERPRISES
  INC. OR APPROVED EQUAL.
- 42. ALL CONNECTIONS TO EXISTING MAINS SHALL BE THE RESPONSIBILITY OF THE CONTRACTOR. WATER CONNECTIONS SHALL BE METERED, AND THE COST OF WATER AND TEMPORARY METER SHALL BE BORNE BY THE CONTRACTOR.
- 43. A COMPLETE AS-BUILT SURVEY SHALL BE ACCURATELY RECORDED OF THE UTILITY SYSTEM DURING CONSTRUCTION. AS-BUILT SURVEY SHALL BE SUBMITTED TO ECSD SIGNED AND SEALED BY A FLORIDA REGISTERED SURVEYOR PRIOR TO FINAL INSPECTION AND ACCEPTANCE OF PROJECT. THE COST OF SIGNED AND SEALED AS-BUILTS SHALL BE COVERED IN OVERALL BID. THE AS-BUILT SURVEY SHALL INCLUDE:
  - a. PLAN VIEW SHOWING THE HORIZONTAL LOCATIONS OF EACH MANHOLE, INLET, VALVE, FITTING, BEND AND HORIZONTAL PIPE DEFLECTIONS WITH COORDINATES AND IN REFERENCE TO A SURVEY BASELINE OR RIGHT-OF-WAY CENTERLINE.
- b. THE PLAN VIEW SHALL ALSO SHOW SPOT ELEVATIONS OF THE TOP OF THE MAIN (WATER MAIN AND FORCE MAIN) OR PIPE INVERTS (GRAVITY MAINS) AT INTERVALS NOT TO EXCEED 100 FEET AS MEASURED ALONG MAIN. THE PLAN VIEW SHALL ALSO INCLUDE SPOT ELEVATIONS AT EACH MANHOLE, INLET, VALVE, FITTING, BEND AND VERTICAL PIPE DEFLECTION.
- c. THE PLAN VIEW SHALL ALSO SHOW THE HORIZONTAL SEPARATION FROM UNDERGROUND UTILITIES IMMEDIATELY ADJACENT OR PARALLEL TO THE NEW MAIN.
- PROFILE VIEW WITH SPOT ELEVATIONS OF THE TOP OF THE MAIN (WATER MAIN AND FORCE MAIN) OR PIPE INVERT (GRAVITY MAIN) AND OF THE FINISHED GRADE OR MANHOLE RIM DIRECTLY ABOVE THE MAIN AT INTERVALS NOT TO EXCEED 100 FEET AS MEASURED ALONG THE MAIN. THE PROFILE VIEW SHALL ALSO INCLUDE SPOT ELEVATIONS AT EACH MANHOLE, INLET, VALVE, FITTING, BEND AND VERTICAL PIPE DEFLECTION.
- e. THE PROFILE VIEW SHALL SHOW ALL UNDERGROUND UTILITIES CROSSING THE NEW MAIN AND THE VERTICAL SEPARATION PROVIDED BETWEEN THAT UNDERGROUND UTILITY AND THE NEW MAIN.
- f. ALL CADD FILES MUST BE CREATED FOLLOWING THE CITY OF HOLLYWOOD "SURVEY / AS-BUILT CAD DRAWING STANDARDS"

OKHOLLYWOOD AIL	ISSUED:	03/01/1994	DEPARTMENT OF PUBLIC UTILITIES STANDARD DETAIL	REVISED: 11/06	5/2017
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GOLD COAST	APPROVED	): XXX	(CONTINUED)	G-00.	3

### GENERAL NOTES (CONTINUED):

- 12. CITY OF HOLLYWOOD SHALL NOT PROVIDE STAGING / STORAGE AREA. CONTRACTOR SHALL SECURE STAGING / STORAGE AREA AS NECESSARY FOR CONSTRUCTION WORK.
- 13. CONTRACTOR SHALL HAUL AWAY EXCESSIVE STOCKPILE OF SOIL FOR DISPOSAL EVERY DAY. NO STOCKPILE SOIL IS ALLOWED TO BE LEFT ON THE CONSTRUCTION SITE OVER NIGHT.
- 14. CONTRACTOR SHALL CLEAN / SWEEP THE ROAD AT LEAST ONCE DAY OR AS REQUIRED BY THE ENGINEER.
- 15. CONTRACTOR SHALL PROTECT CATCH BASINS WITHIN / ADJACENT TO THE CONSTRUCTION SITE AS REQUIRED BY NPDES REGULATIONS.
- 16. THE CITY OF HOLLYWOOD HAS A NOISE ORDINANCE (CHAPTER 100) WHICH PROHIBITS EXCAVATION AND CONSTRUCTION BEFORE 8:00 A.M. AND AFTER 6:00 P.M., MONDAY THROUGH SATURDAY AND ALL DAY
- 17. SUITABLE EXCAVATED MATERIAL SHALL BE USED IN FILL AREAS. NO SEPARATE PAY ITEM FOR THIS WORK, INCLUDE COST IN OTHER ITEMS.
- 18. ALL ROAD CROSSINGS ARE OPEN CUT AS PER THE REQUIREMENTS OF THE ECSD UNLESS OTHERWISE NOTED ON THE DRAWINGS.
- 19. THE CONTRACTOR SHALL REPLACE ALL PAVING, STABILIZING EARTH, DRIVEWAYS, PARKING LOTS, SIDEWALKS, ETC. TO SATISFY THE INSTALLATION OF THE PROPOSED IMPROVEMENTS WITH THE SAME TYPE OF MATERIAL THAT WAS REMOVED DURING CONSTRUCTION OR AS DIRECTED BY ECSD FIELD ENGINEER.
- 20. THE CONTRACTOR SHALL NOT ENCROACH INTO PRIVATE PROPERTY WITH PERSONNEL, MATERIAL OR EQUIPMENT. IN CASE WORK ON PRIVATE PROPERTY IS NEEDED, A CITY OF HOLLYWOOD "RIGHT OF ENTRY" FORM MUST BE SIGNED BY PROPERTY OWNER AND THE DIRECTOR OF PUBLIC UTILITIES. THE CONTRACTOR IS RESPONSIBLE TO MAINTAIN ACCESS AT ALL TIMES TO PRIVATE HOMES/BUSINESSES.
- 21. THE CONTRACTOR SHALL BE RESPONSIBLE FOR DAMAGE, REMOVAL OR MODIFICATION, CAUSED TO ANY IRRIGATION SYSTEM (PRIVATE OR PUBLIC) ACCIDENTALLY OR PURPOSELY. THE CONTRACTOR SHALL REPLACE ANY DAMAGED, REMOVED OR MODIFIED IRRIGATION PIPES, SPRINKLER HEADS OR OTHER PERTINENT APPURTENANCES TO MATCH OR EXCEED EXISTING CONDITIONS AT NO ADDITIONAL COST TO
- 22. MAIL BOXES, FENCES OR OTHER PRIVATE PROPERTY DAMAGED DURING THE CONSTRUCTION OF THE PROPOSED IMPROVEMENTS SHALL BE REPLACED TO MATCH OR EXCEED EXISTING CONDITION.
- 23. CONTRACTOR SHALL PROVIDE MAINTENANCE OF TRAFFIC IN ACCORDANCE WITH FDOT STANDARDS AND CITY OF HOLLYWOOD DEPARTMENT OF PUBLIC UTILITIES STANDARDS.
- 24. NO TREES ARE TO BE REMOVED OR RELOCATED WITHOUT PRIOR APPROVAL FROM THE ECSD FIELD ENGINEER.
- 25. THE CONTRACTOR IS RESPONSIBLE FOR OBTAINING THE NECESSARY TREE REMOVAL OR RELOCATION PERMITS FROM THE CITY OF HOLLYWOOD BUILDING DEPARTMENT FOR TREES LOCATED IN THE PUBLIC RIGHT OF WAY.
- 26. IT IS THE INTENT OF THESE PLANS TO BE IN ACCORDANCE WITH APPLICABLE CODES AND AUTHORITIES HAVING JURISDICTION. ANY DISCREPANCIES BETWEEN THESE PLANS AND APPLICABLE REGULATORY STANDARDS / REQUIREMENTS SHALL BE IMMEDIATELY BROUGHT TO THE ATTENTION OF ECSD.


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### GENERAL NOTES (CONTINUED):

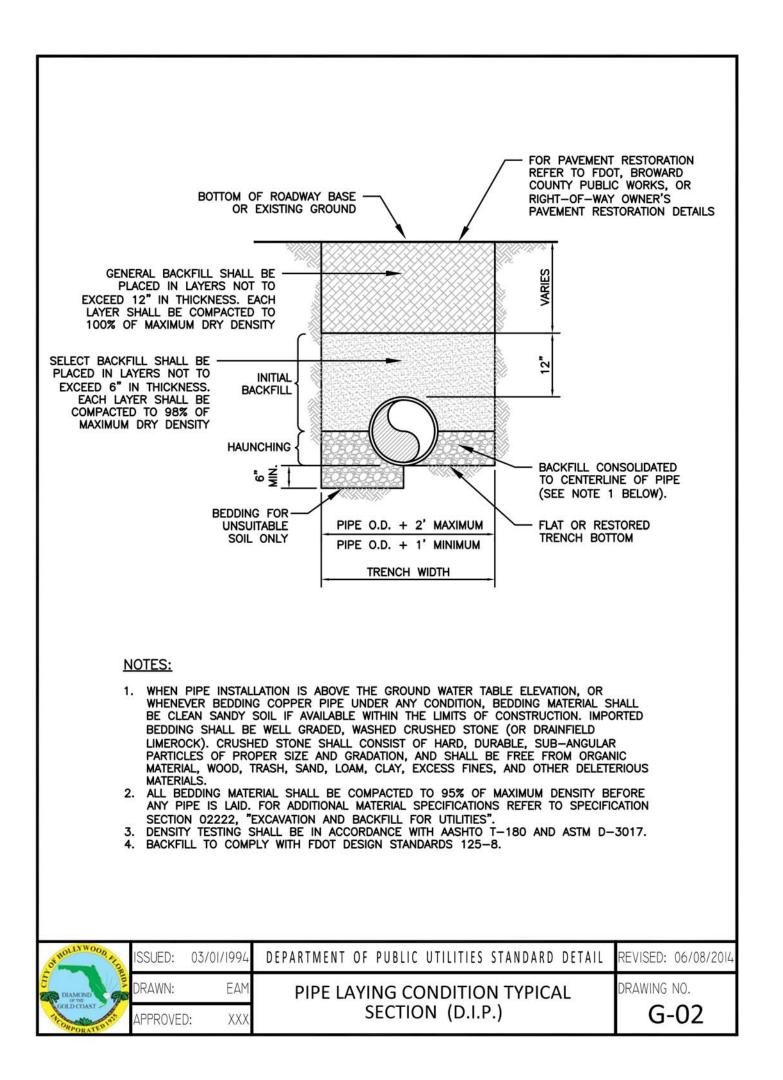- 27. THE CONTRACTOR SHALL BE RESPONSIBLE FOR MAINTAINING THE INTEGRITY OF AND MAKING THE REPAIRS TO EXISTING PAVEMENT, SIDEWALKS, PIPES, CONDUITS, CURBS, CABLES, ETC., WHETHER OR NOT SHOWN ON THE PLANS DAMAGED AS A RESULT OF THE CONTRACTORS OPERATIONS AND/OR THOSE OF HIS SUBCONTRACTORS, AND SHALL RESTORE THEM PROMPTLY AT NO ADDITIONAL EXPENSE TO THE OWNER. CONTRACTOR SHALL REPORT ANY DAMAGE TO SIDEWALK, DRIVEWAY, ETC., PRIOR TO BEGINNING WORK IN ANY AREA.
- 28. WHERE NEW PAVEMENT MEETS EXISTING, CONNECTION SHALL BE MADE IN A NEAT STRAIGHT LINE AND FLUSH WITH EXISTING PAVEMENT TO MATCH EXISTING CONDITIONS.
- 29. UNDER NO CIRCUMSTANCES SHALL THE CONTRACTOR LEAVE EXCAVATED TRENCHES, OR PARTS OF, EXPOSED OR OPENED AT THE END OF THE WORKING DAY, WEEKENDS, HOLIDAYS OR OTHER TIMES, WHEN THE CONTRACTOR IS NOT WORKING, UNLESS OTHERWISE DIRECTED. ALL TRENCHES SHALL BE COVERED, FIRMLY SECURED AND MARKED ACCORDINGLY FOR PEDESTRIAN / VEHICULAR TRAFFIC.
- ALL EXCAVATED MATERIAL REMOVED FROM THIS PROJECT SHALL BE DISPOSED OF OFF THE PROPERTY BY THE CONTRACTOR AT THE CONTRACTOR'S EXPENSE.
- 31. ALL DUCTILE IRON PRODUCTS SHALL BE DOMESTIC MADE HEAVY DUTY CLASSIFICATION SUITABLE FOR HIGHWAY TRAFFIC LOADS, OR 20,000 LB.
- 32. ALL GRASSED AREAS AFFECTED BY CONSTRUCTION SHALL BE RE-SODDED.
- 33. THE CONTRACTOR SHALL BE RESPONSIBLE FOR THE PROVISION, INSTALLATION AND MAINTENANCE OF ALL TRAFFIC CONTROL AND SAFETY DEVICES, IN ACCORDANCE WITH SPECIFICATIONS OF THE LATEST REVISION OF FDOT DESIGN STANDARDS. IN ADDITION, THE CONTRACTOR IS RESPONSIBLE FOR THE RESETTING OF ALL TRAFFIC CONTROL AND INFORMATION SIGNAGE REMOVED DURING THE CONSTRUCTION PERIOD.
- 34. EXCAVATED OR OTHER MATERIAL STORED ADJACENT TO OR PARTIALLY UPON A ROADWAY PAVEMENT SHALL BE ADEQUATELY MARKED FOR TRAFFIC SAFETY AT ALL TIMES.
- 35. TEMPORARY PATCH MATERIAL MUST BE ON THE JOB SITE WHENEVER PAVEMENT IS CUT, OR THE CITY'S INSPECTOR WILL SHUT THE JOB DOWN.
- 36. CONTRACTOR MUST PROVIDE FLASHER ARROW SIGNAL FOR ANY LANE THAT IS CLOSED OR DIVERTED.
- 37. CONTRACTOR SHALL NOTIFY LAW ENFORCEMENT AND FIRE PROTECTION SERVICES TWENTY-FOUR (24) HOURS IN ADVANCE OF TRAFFIC DETOUR IN ACCORDANCE WITH SECTION 336.07 OF FLORIDA STATUTES.
- 38. CONTRACTOR TO RESTORE PAVEMENT TO ORIGINAL CONDITION AS REQUIRED.
- 39. CONTRACTOR SHALL BE RESPONSIBLE FOR PROVIDING DEWATERING PER SPECIFICATION SECTION 02140 DEWATERING.

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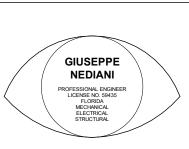


- ALL BEDDING MATERIAL SHALL BE COMPACTED TO 95% OF MAXIMUM DENSITY BEFORE ANY PIPE IS LAID. FOR ADDITIONAL MATERIAL SPECIFICATIONS REFER TO
- SPECIFICATION SECTION 02222, "EXCAVATION AND BACKFILL FOR UTILITIES".

  3. DENSITY TESTING SHALL BE IN ACCORDANCE WITH AASHTO T-180 AND ASTM
- 4. BACKFILL TO COMPLY WITH FDOT DESIGN STANDARD 125-8.

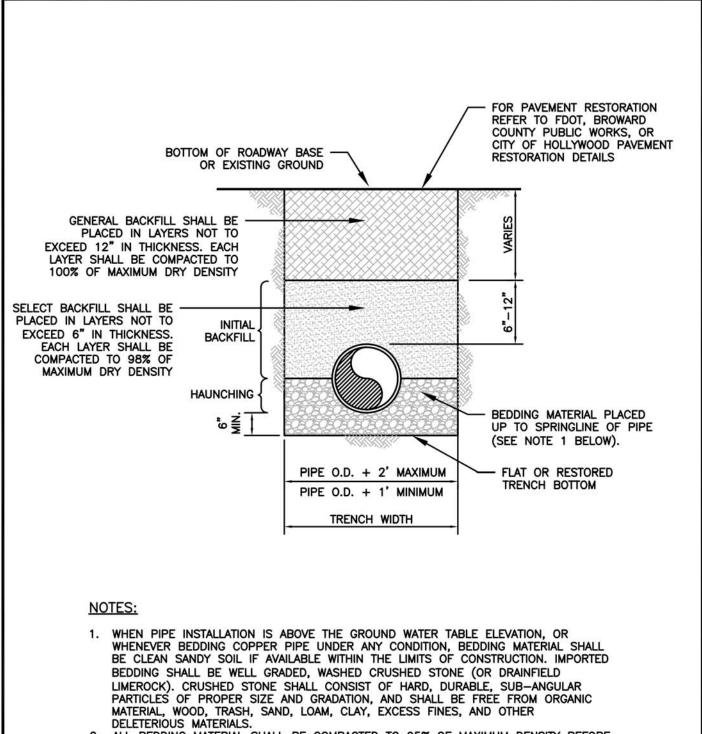OF HOLLYWOOD THE	ISSUED:	03/01/1994	DEPARTMENT OF PUBLIC UTILITIES STANDARD DETAIL	REVISED: 06/08/2014
DIAMOND OF THE	DRAWN:	EAM	PIPE LAYING CONDITION TYPICAL	DRAWING NO.
GOLD COAST	APPROVED	): XXX	SECTION (P.V.C.)	G-03

PROJECT ADDRESS: 1942 Taylor St, Hollywood, FL 33020



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ISSUED FOR


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SHEET TITLE

STANDARD DETAILS & PUBLIC NOTES

SHEET NUMBER


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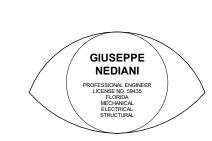
### **FLEXIBLE PAVEMENT RESTORATION NOTES:**

- 1. THE ABOVE DETAILS APPLY ONLY TO ASPHALT PAVEMENT RESTORATION OVER UTILITY TRENCHES CUT WITHIN CITY OF HOLLYWOOD RIGHTS-OF-WAY. FOR PAVEMENT RESTORATION WITHIN BROWARD COUNTY OR FDOT RIGHTS-OF-WAY REFER TO THE CORRESPONDING DETAILS FOR THOSE AGENCIES.
- 2. LIMEROCK BASE MATERIAL SHALL HAVE A MINIMUM L.B.R. OF 100 AND A MINIMUM CARBONATE CONTENT OF 70%. REPLACED BASE MATERIAL OVER TRENCH SHALL BE A MINIMUM OF 12" THICK".
- 3. LIMEROCK BASE MATERIAL SHALL BE PLACED IN 12" MAXIMUM (LOOSE MEASUREMENT) THICKNESS LAYERS WITH EACH LAYER THOROUGHLY ROLLED OR TAMPED AND COMPACTED TO 100% OF MAXIMUM DENSITY, PER AASHTO T-180, PRIOR TO THE PLACEMENT OF THE SUCCEEDING LAYERS.
- 4. STABILIZED SUBGRADE MATERIAL SHALL BE GRANULAR AND SHALL HAVE A MINIMUM L.B.R. OF 40.
- 5. BACKFILL SHALL BE PLACED AND COMPACTED IN ACCORDANCE WITH THE PIPE LAYING CONDITION TYPICAL SECTIONS IN DETAILS G-02 AND G-03, AND THE SPECIFICATIONS, BUT TESTING WILL BEGIN 12" ABOVE THE INSTALLED FACILITY.
- 6. ALL EDGES AND JOINTS OF EXISTING ASPHALT PAVEMENT SHALL BE SAW CUT TO STRAIGHT LINES, PARALLEL TO OR PERPENDICULAR TO THE ROADWAY, PRIOR TO THE RESURFACING.
- RESURFACING MATERIAL SHALL BE FDOT SUPERPAVE, AND SHALL BE APPLIED A MINIMUM OF TWO INCH IN THICKNESS.
- 8. MILL AND BUTT JOINT TO EXISTING PAVEMENT.
- 9. IF THE TRENCH IS FILLED TEMPORARILY, IT SHALL BE COVERED WITH A 2" ASPHALTIC CONCRETE PATCH TO KEEP THE FILL MATERIAL FROM RAVELING UNTIL REPLACED WITH A PERMANENT PATCH.
- 10. REFER TO SPECIFICATIONS FOR DETAILED PROCEDURES.
- 11. WHERE THE UTILITY TRENCH CROSSES EXISTING ASPHALT DRIVEWAYS, THE LIMEROCK BASE THICKNESS MAY BE A MINIMUM OF 6 INCHES THICK. REGARDLESS OF THE EXTENT OF IMPACT, THE ENTIRE DRIVEWAY SURFACE BETWEEN THE EDGE OF THE ROADWAY PAVEMENT AND PROPERTY LINE OR FRONT OF SIDEWALK SHALL BE OVERLAID USING 2-INCH THICK MINIMUM ASPHALTIC CONCRETE SURFACE COURSE WHERE INDICATED ON THE PLANS OR AS DIRECTED BY THE CITY/ENGINEER.

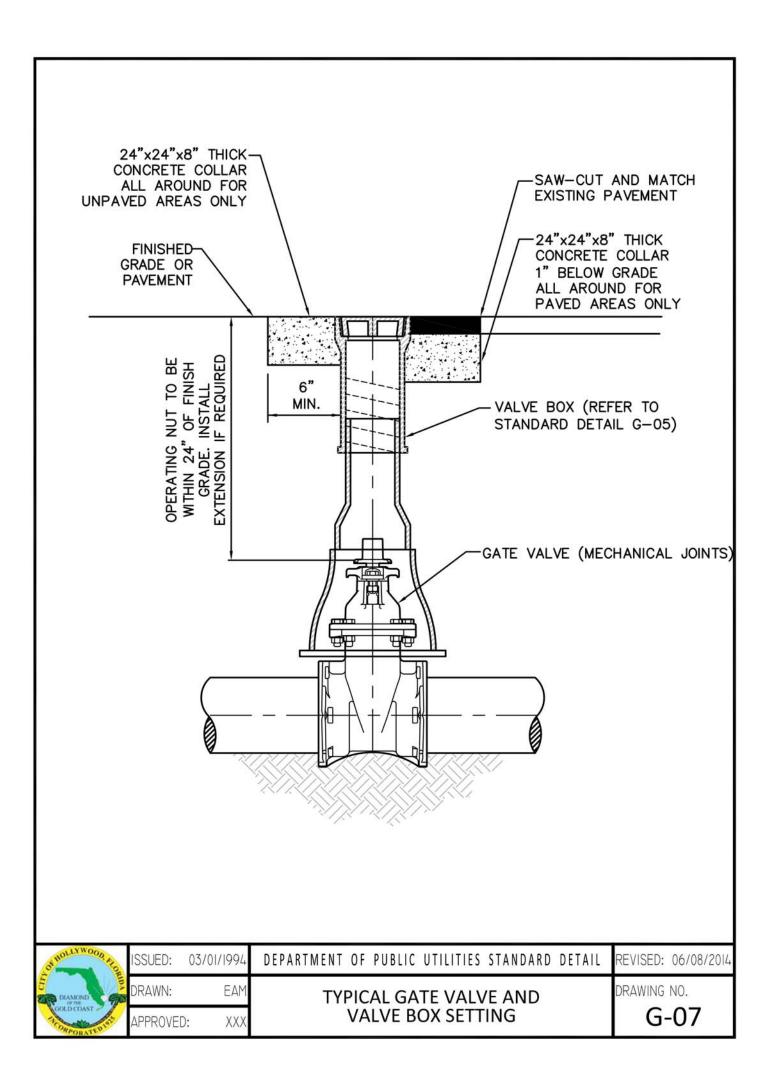OF HOLLYWOOD, AND	ISSUED:	03/01/1994	DEPARTMENT OF PUBLIC UTILITIES STANDARD DETAIL	REVISED: 11/06/2017
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GOLDCOAST	APPROVE	D: XXX	NOTES	G-12



PROJECT ADDRESS: 1942 Taylor St, Hollywood, FL 33020

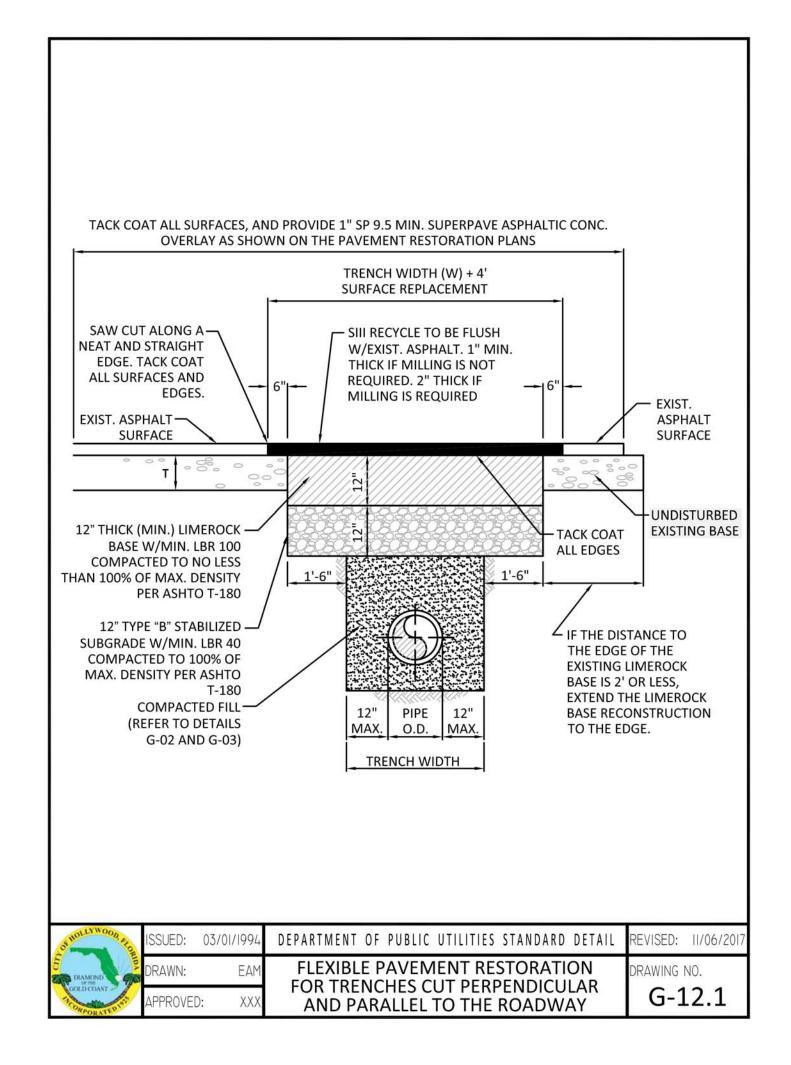

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DATE ISSUED FOR


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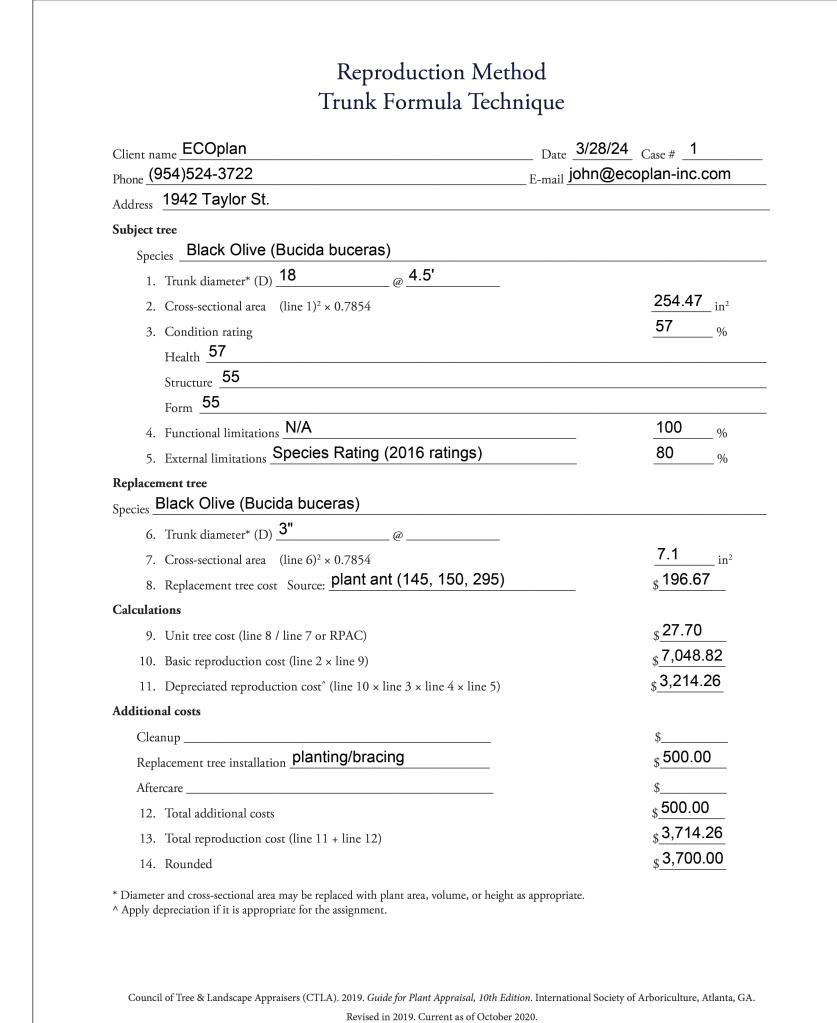
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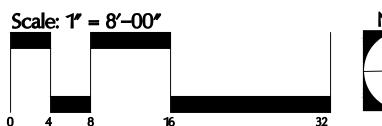



	3/28/2024	1942 Taylor St. Hollywood	d, FL									
TREE #	COMMON NAME	BOTANICAL NAME	HEIGHT (ft)	WIDTH (ft)	DBH (in)	CLEAR TRUNK (ft)	HEALTH CONDITION	HEALTH CONDITION %	E	TLA 10TH EDITION PRAISAL (\$)	RELOCATION CANDIDATE (Y/N)	OBSERVATIONS
1	Black Olive	Bucida buceras	37.1	38	18		Fair	57%	\$	3,700.00	Y	Poor structure, compacted root zone, water sprouts, minor deadwood, mechanical root zone damage
2	Mango	Magnifiera indica	33.4	46	26.25		Fair	54%			IN .	Poor structure, deadwood, canopy dieback,mechanical root zone damage, galls
3	Sabal Palm	Sabal palmetto	16	8	16	12	Good	65%			Υ	

\*I certify that all statements of fact in this appraisal are true, complete and correct to the best of my knowledge and belief and that they are made in good faith.

Mark C. Williams FL-5221 AM, ISA Certified Arborist Municipal Specialist (Treemendous Consulting Group LLC)

DRAFT

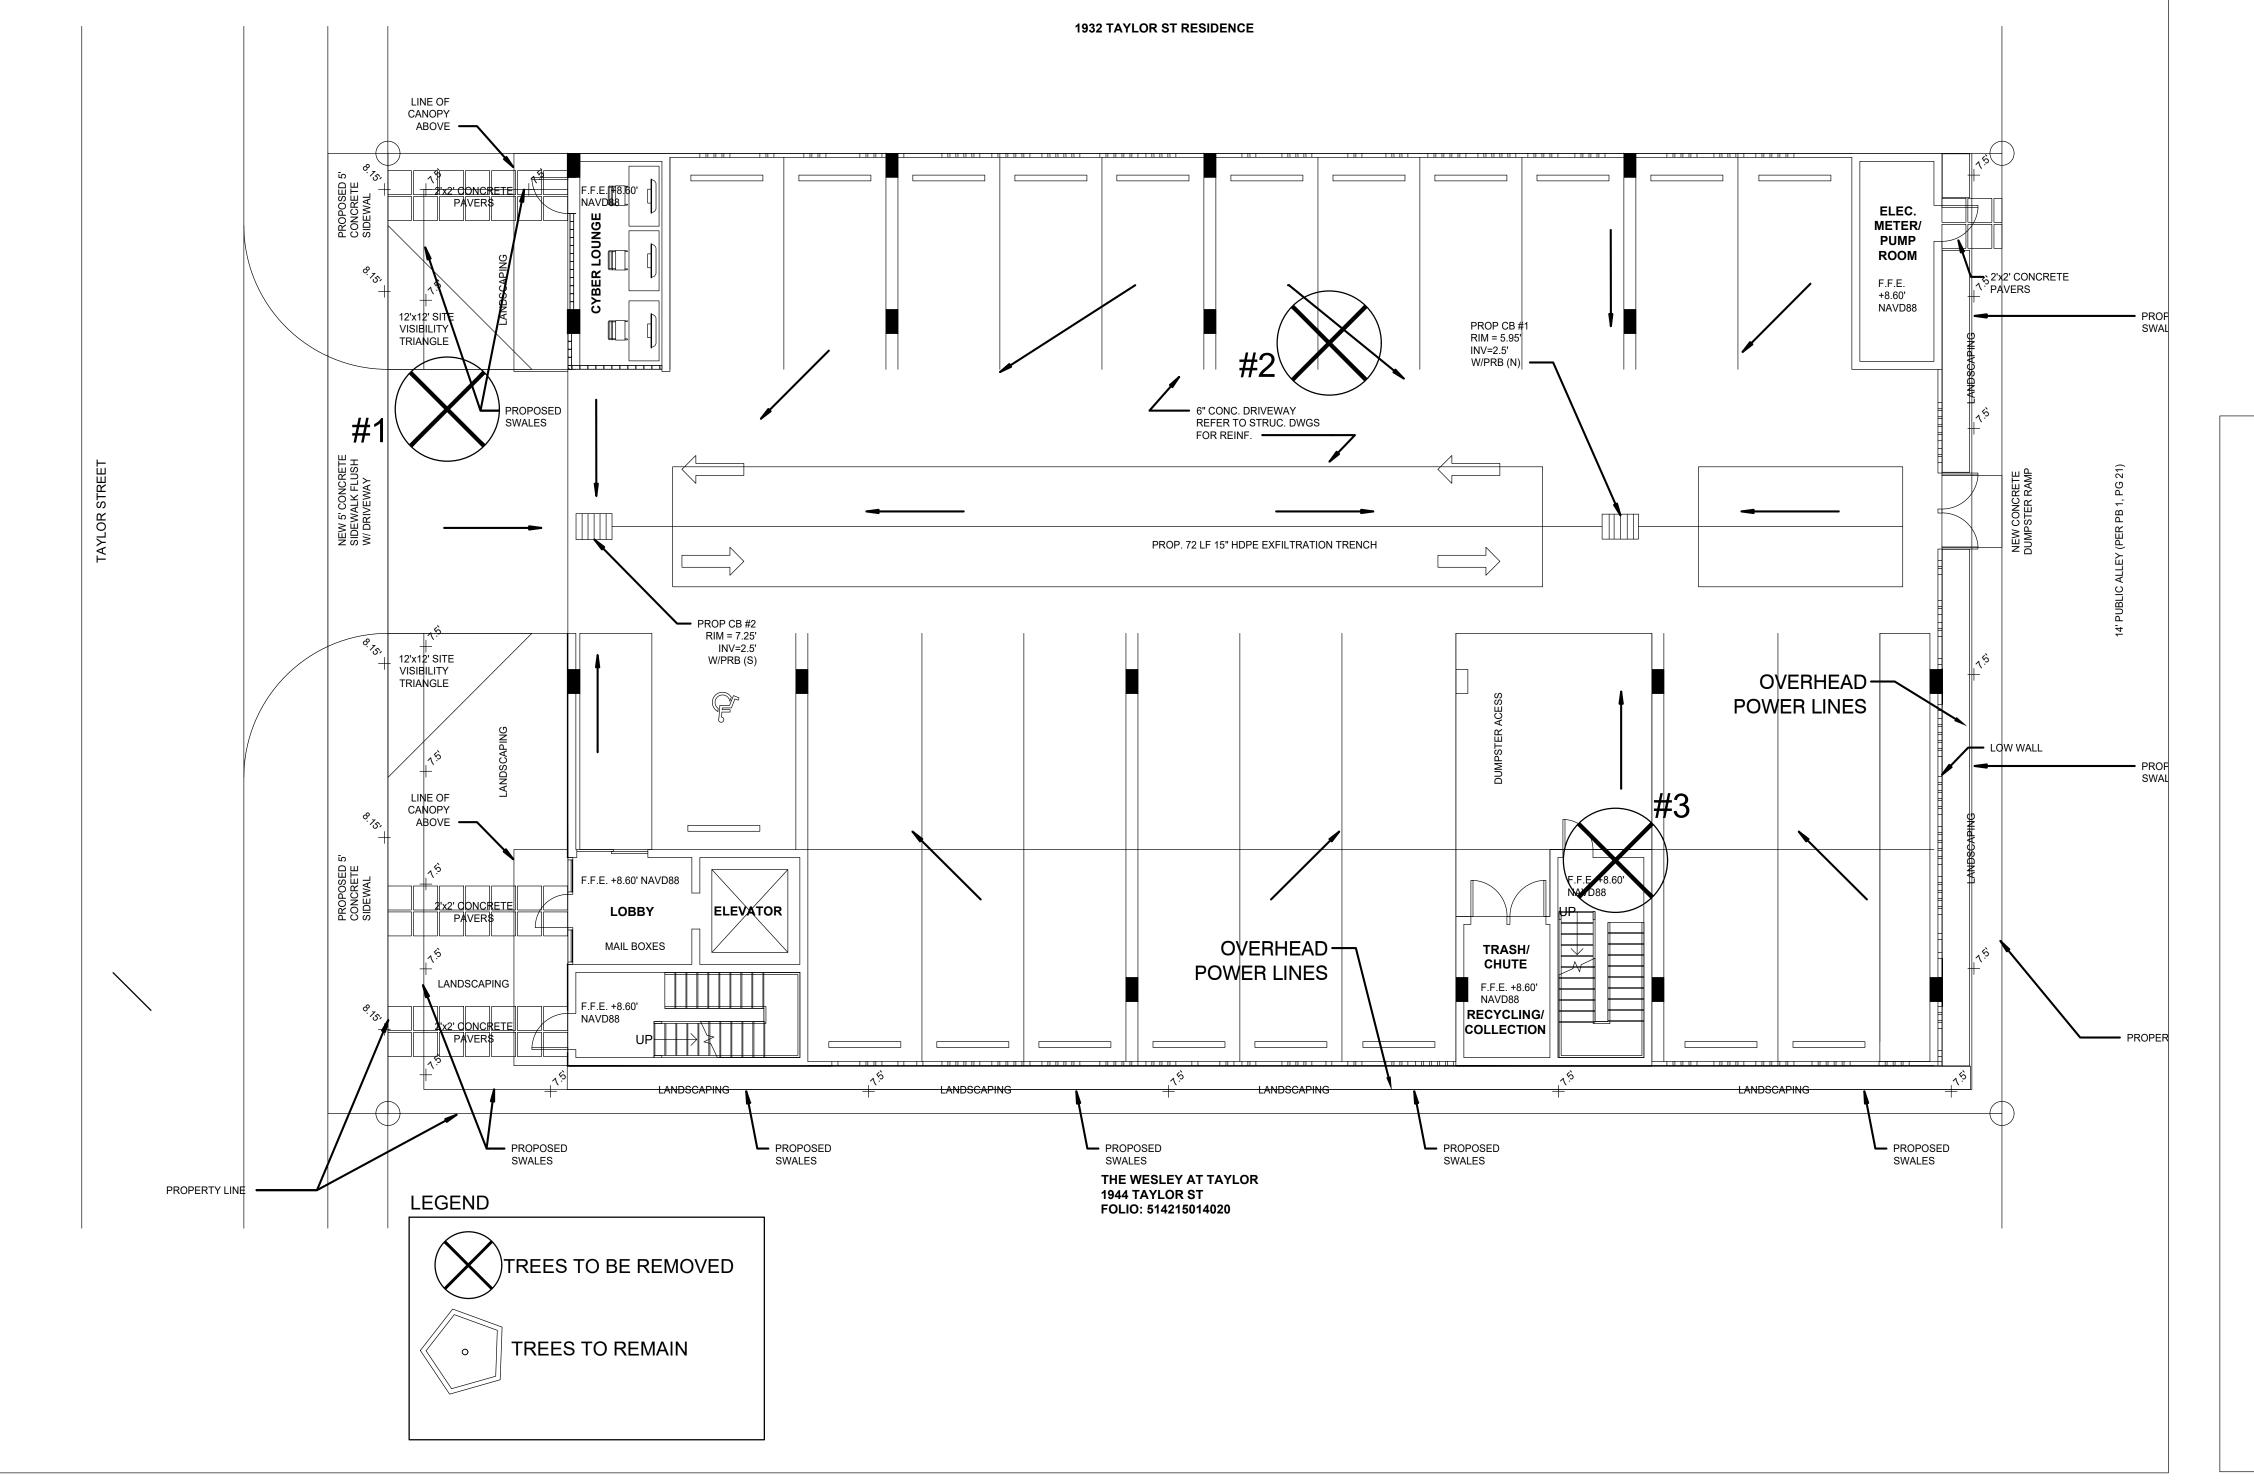

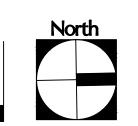



EPARED BY:

ECOLOGICAL / BNROWENTAL LAND FLANNIC
LIND USE ANALYSS LANDSCAFE ARCHITECTURE
370 SOUTHEAST 18TH STREET
FT. LAUDREDALE, FLORIDA 33316

DRC SUBMITTAL

Taylor Street

94


EXISTING TREE DISPOSITION

DATE: 3/28/2024
PROJECT #: 2404
DRAWN BY: jh
CHECKED BY: JH
SCALE:

REVISIONS:


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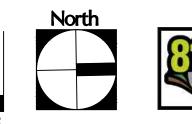
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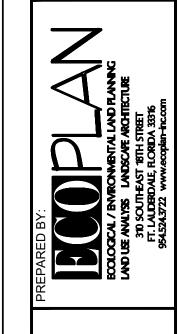


LANT S	6CHEE	DULE						
MBOL	CODE	QTY	BOTANICAL NAME	COMMON NAME	CONTAINER	SIZE	CALIPER	
EES	BS	3	Bursera simaruba	Gumbo Limbo	B & B	14` HT, 6` SPR, 6` CT	2" CAL MIN	
LM TREES	SP	5	Sabal palmetto	Cabbage Palmetto	В&В	8`-12`CT, VARY HEIGHTS	HEAVY SPECIMEN	
MAN NO SERVICE MAN NO	TR	14	Thrinax radiata	Florida Thatch Palm				
MBOL	CODE	QTY	BOTANICAL NAME	COMMON NAME	CONTAINER	SIZE	NATIVE	
RUBS ( • )	MF2 ZF	2	Myrcianthes fragrans  Zamia furfuracea	Simpson's Stopper Cardboard Palm	25 gal. 15 gal	8' HT, Standard 36" HT x 42"SPR		
MBOL	CODE	QTY	BOTANICAL NAME	COMMON NAME	CONTAINER	SIZE	SPACING	SPACING
RUB AREA	_							
<u> </u>	CI	99	Chrysobalanus icaco `Redtip`	Red Tip Cocoplum	3 gal.	24" HT x 24" SPR	24" O.C.	24" o.c.
	CS4	35	Clusia guttifera	Small-Leaf Clusia	3 gal.	30" HT x 24" W	24" O.C.	24" o.c.
	FM	212	Ficus microcarpa `Green Island`	Green Island Ficus	3 gal.	18" X 18"		24" o.c.
MBOL	CODE	QTY	BOTANICAL NAME	COMMON NAME	CONTAINER	SIZE	NATIVE	SPACING
OUND CO	VERS							
<u></u>	DT	42	Dianella tasmanica	Blueberry Flax Lily	1 gal	12"X15"		18" o.c.
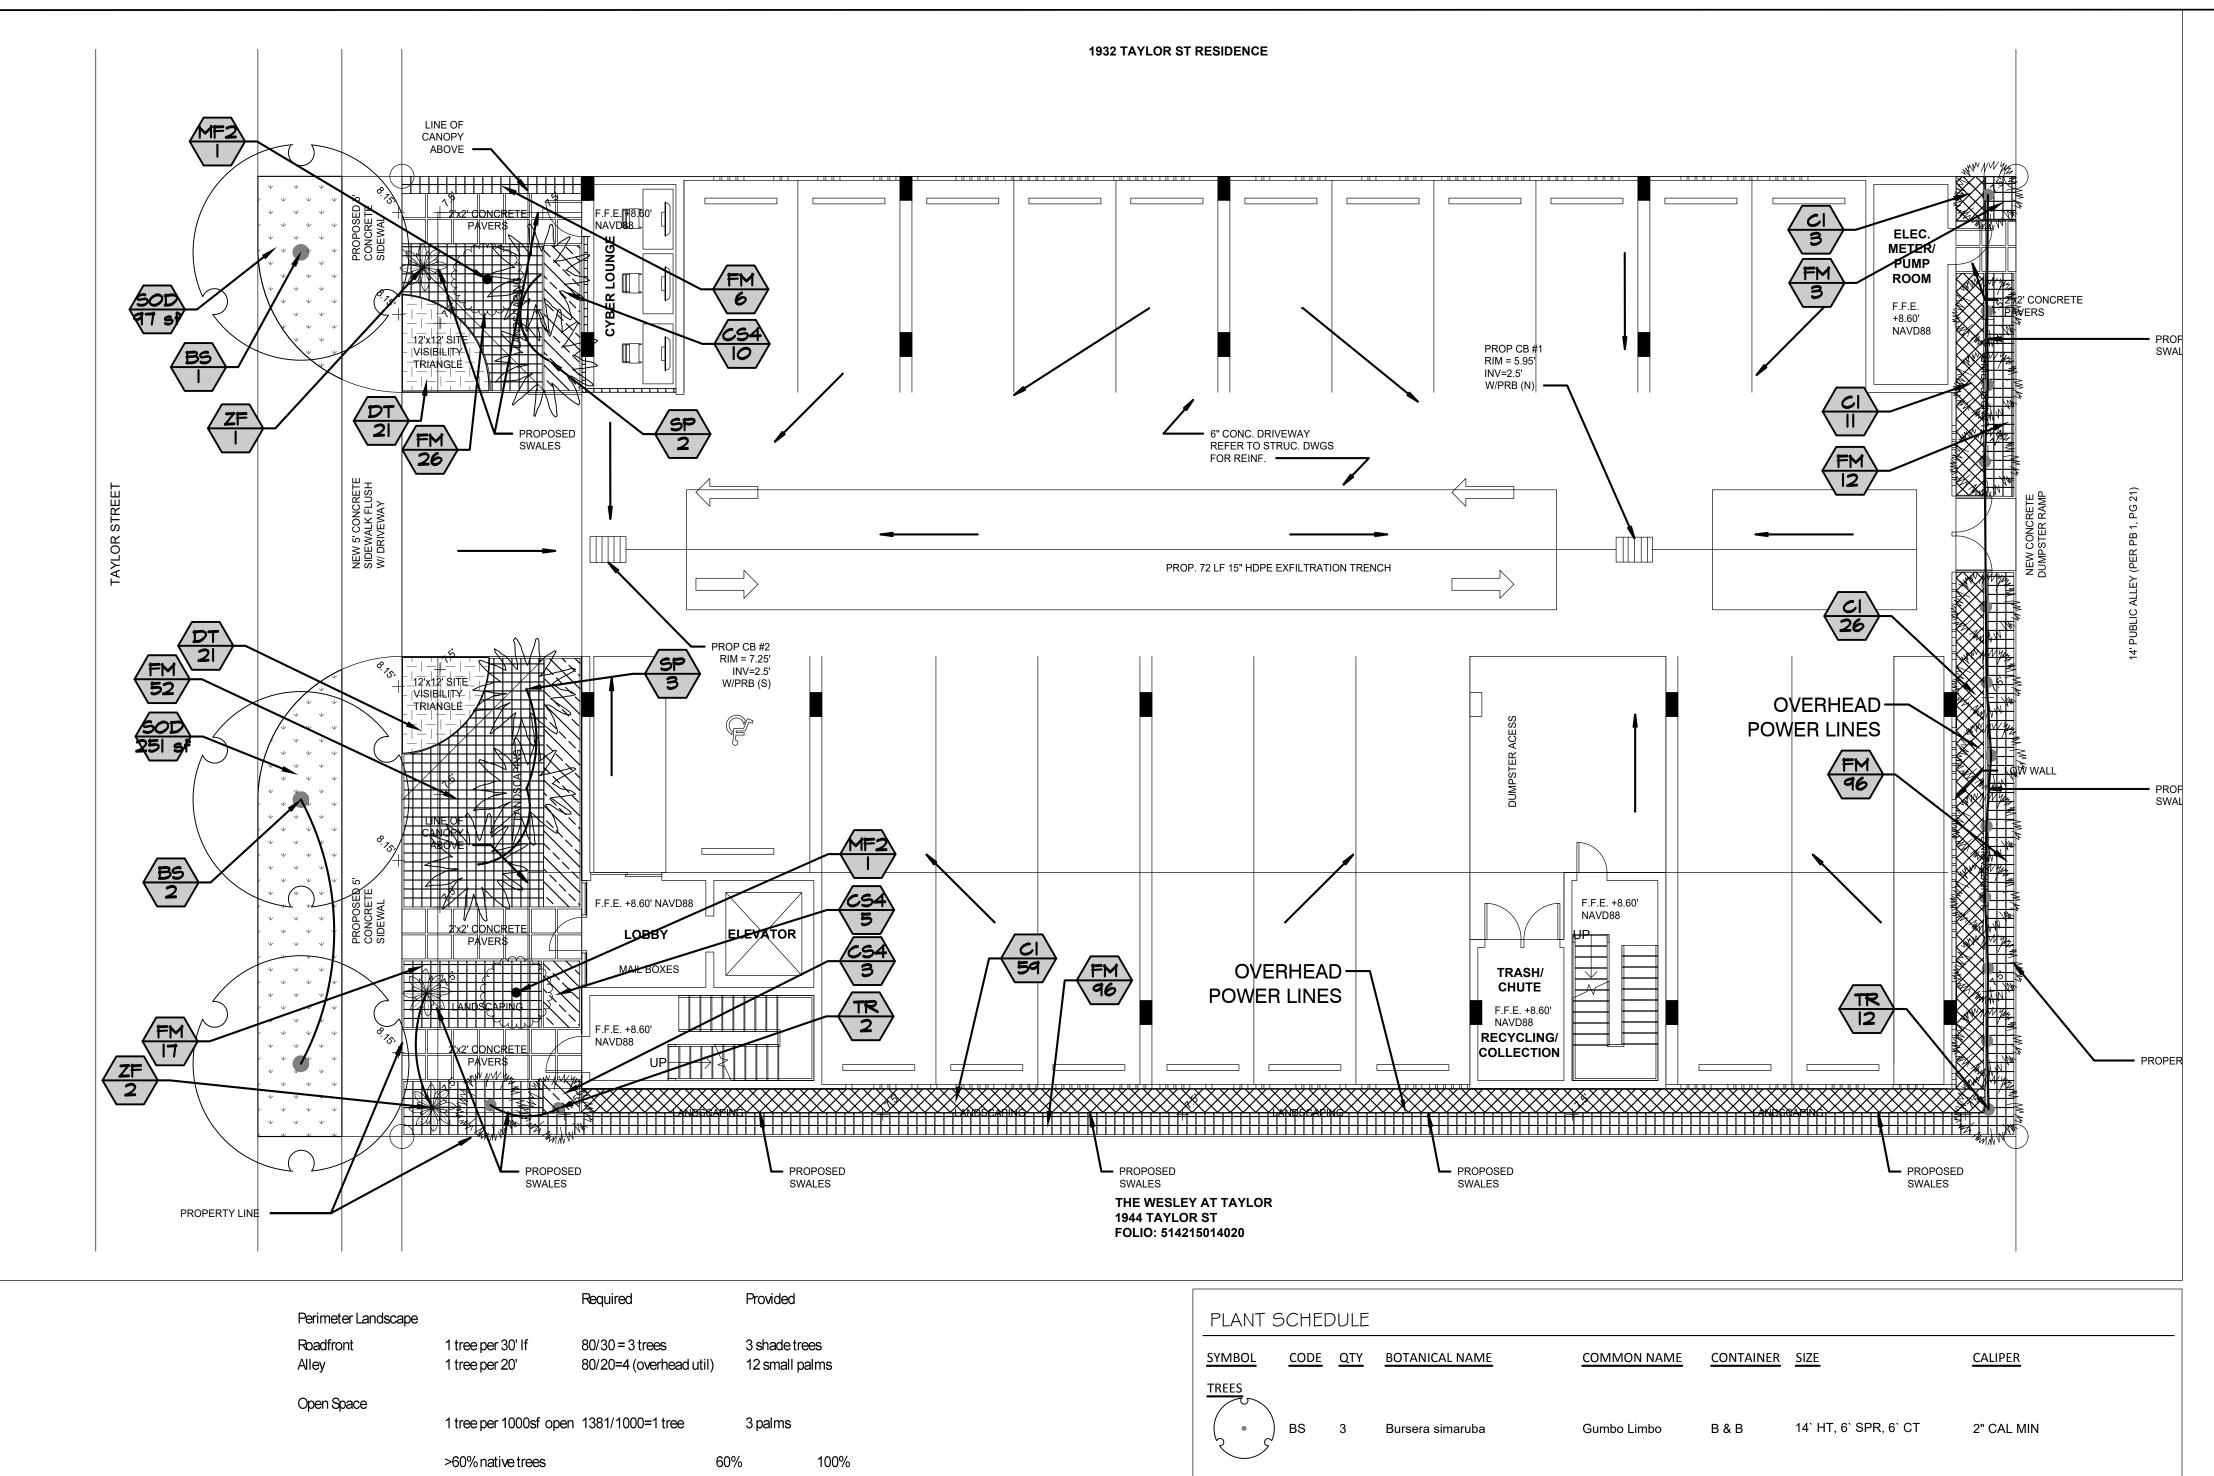
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SUBMITTAL

Street Taylor 2 94


PLANTING

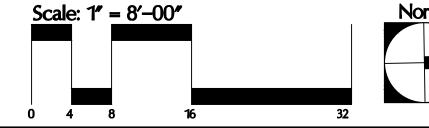DATE: 3/28/2024 PROJECT #: 2404 DRAWN BY: jh CHECKED BY: JH

REVISIONS:

SHEET NUMBER:

LAPL-1

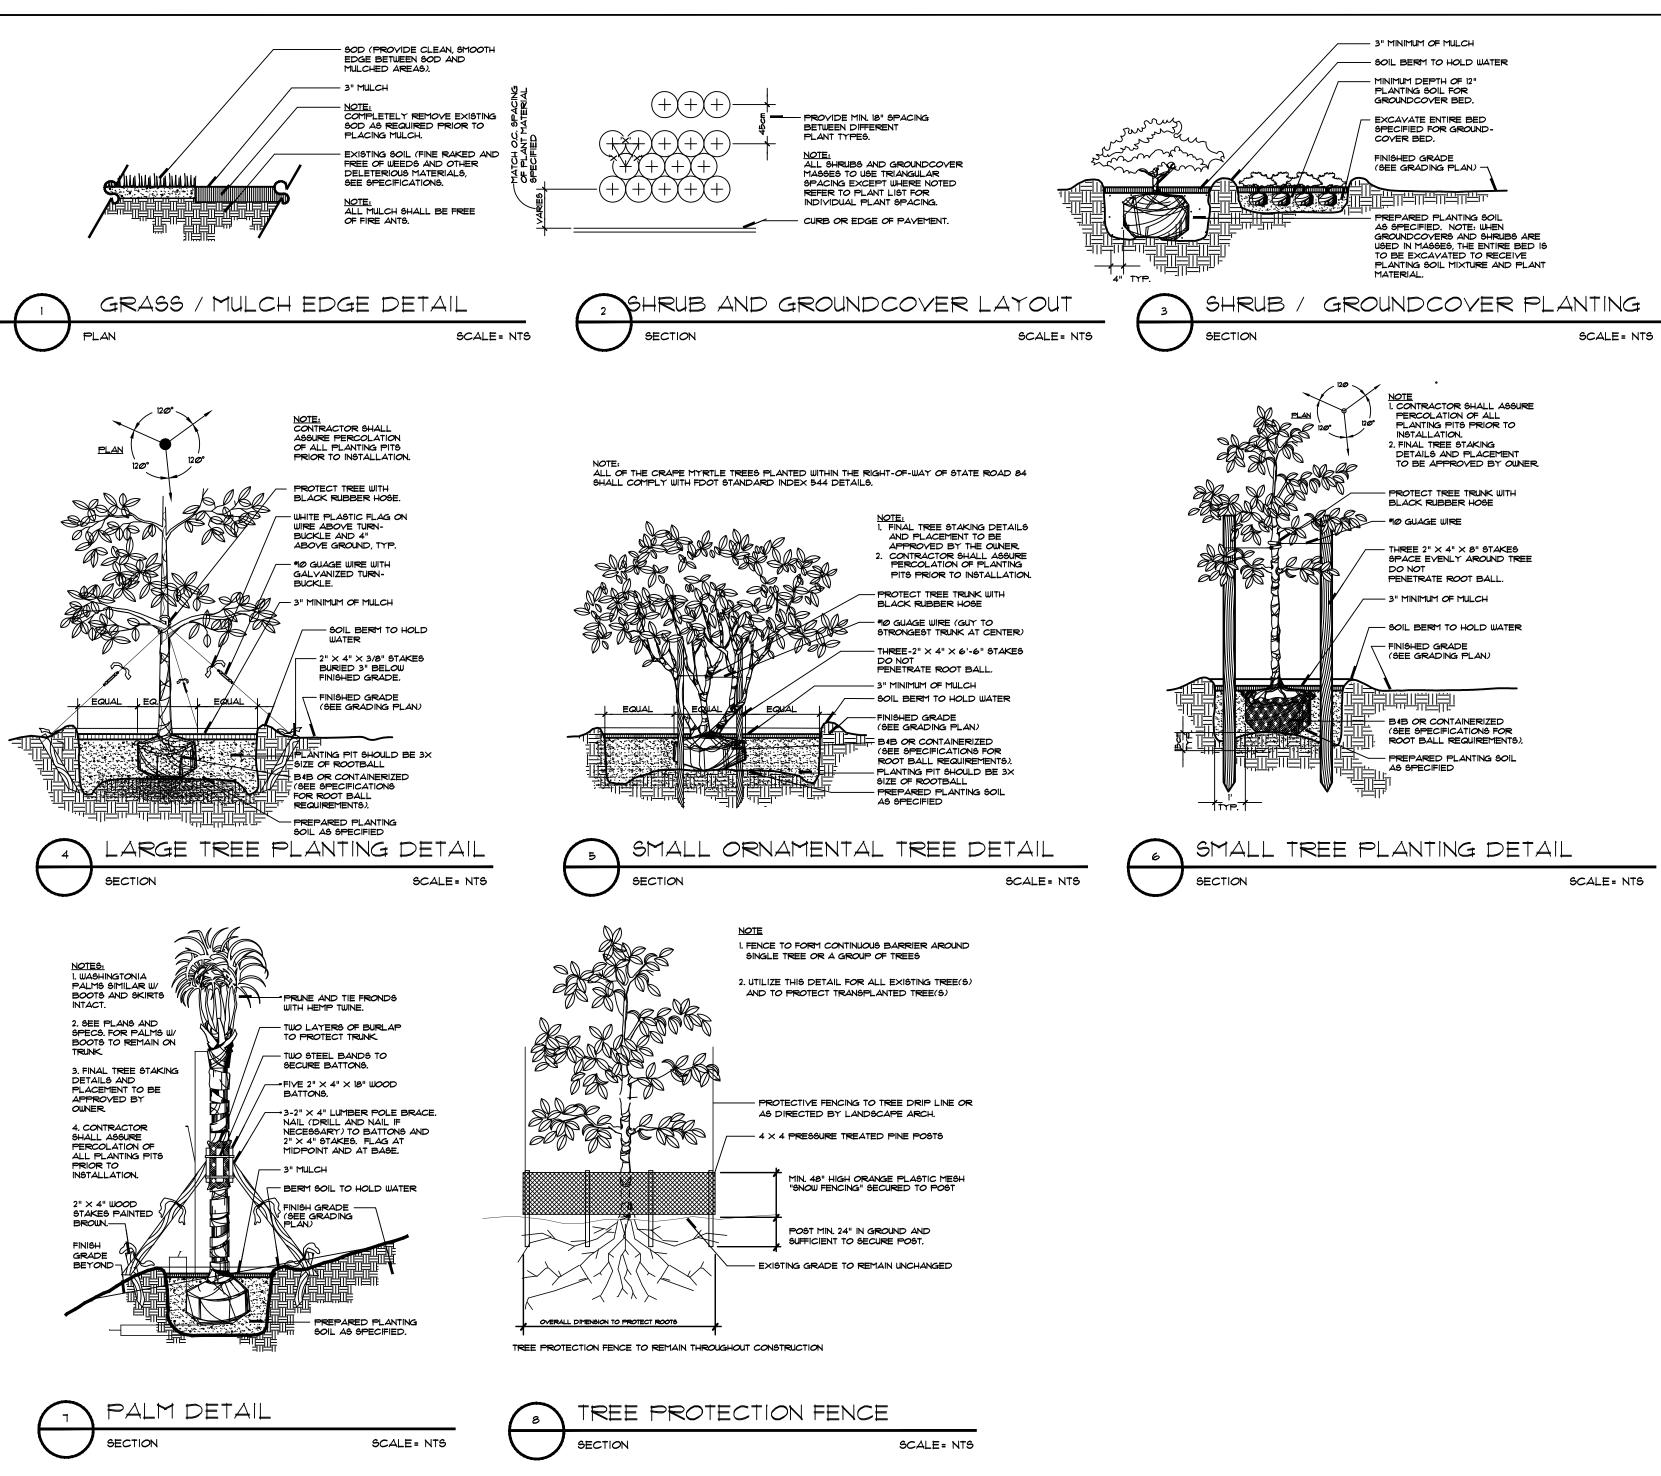

### LANDSCAPE NOTES

- 1. THE WORK CONSISTS OF THE COMPLETE PLANT MATERIAL INSTALLATION ON THE DRAWINGS AND AS HEREIN SPECIFIED. THIS WORK SHALL INCLUDE, BUT IS NOT LIMITED TO, THE SUPPLYING OF ALL PLANT MATERIAL SPECIFIED, THE FURNISHING OF LABOR, EQUIPMENT, APPLIANCES AND ALL MATERIALS CALLED FOR, AND IN PERFORMING ALL OPERATIONS IN CONNECTION WITH THE LANDSCAPE INSTALLATION ON THESE PLANS. FURTHER, THE WORK SHALL INCLUDE THE MAINTAINING OF ALL PLANTS AND PLANTING AREAS UNTIL ACCEPTANCE BY THE OWNER, AND THE FULFILLING OF ALL GUARANTEE PROVISIONS AS HEREIN SPECIFIED.
- 2. NO SUBSTITUTIONS SHALL BE MADE WITHOUT WRITTEN PERMISSION OF THE LANDSCAPE ARCHITECT.
- 3. IN THE EVENT OF VARIATION BETWEEN THE PLANT LIST AND THE ACTUAL NUMBER OF PLANTS SHOWN ON THE PLANS, THE PLANS SHALL CONTROL.
- 4. PLANT MATERIALS WILL BE INSPECTED BY THE OWNER'S REPRESENTATIVE AT THE JOB SITE PRIOR TO INSTALLATION. WHEN INSPECTION WORK DOES NOT COMPLY WITH THE REQUIREMENTS, REPLACE REJECTED WORK AND CONTINUE SPECIFIED MAINTENANCE UNTIL REINSPECTED AND FOUND TO BE ACCEPTABLE. REMOVE REJECTED PLANTS AND MATERIALS FROM THE PLANTING SITE WITHIN 48 HOURS AND REPLACE WITH ACCEPTABLE MATERIALS.
- 5. ALL MATERIALS AND EQUIPMENT SHALL BE INSTALLED IN A NEAT AND WORKMANLIKE MANNER. THE OWNER OR HIS REPRESENTATIVE RESERVES THE RIGHT TO DIRECT THE REMOVAL AND REPLACEMENT OF ANY ITEMS WHICH, IN HIS OPINION, DO NOT PRESENT AN ORDERLY AND REASONABLE NEAT OR WORKMANLIKE APPEARANCE, PROVIDED SUCH ITEMS CAN BE PROPERLY INSTALLED IN AN ORDERLY WAY BY TYPICAL INSTALLATION METHODS.
- 6. ALL PLANTING BEDS SHALL BE MULCHED WITH 3" NON-CYPRESS MULCH 100% ORGANIC, FIBEROUS-TYPE GRADE 'B' OR BETTER.
- 1. ALL TREES 6' TALL OR LARGER SHALL BE STAKED AND GUYED WITH VERTICAL 2" X 2" PINE STAKES OR 4" 18. CONTRACTOR TO NOTIFY/VERIFY WITH LANDSCAPE ARCHITECT, THE AVAILABILITY (QUANTITY & QUALITY) DIAMETER POST IN DETAILS. NO DEVIATIONS UNLESS APPROVED IN WRITING.
- 8. PLANTING SOIL FOR ALL PLANT MATERIALS SHALL CONSIST OF TWO (2) PARTS OF TOPSOIL WITH ONE (1) PART PEAT MOSS AND .9 kg FERTILIZER PER CUBIC METER, WELL MIXED.
- 9. ALL PLANT MATERIALS SHALL BE WATERED BY THE CONTRACTOR THOROUGHLY WHEN PLANTED AND DURING THE PLANTING TIME PERIOD UP TO FINAL ACCEPTANCE BY OWNER.

- BLACK IN COLOR, FRIABLE, NATURAL LOAM, SURFACE SOIL, REASONABLY FREE OF SUBSOIL, CLAY LUMPS, BRUSH, WEEDS AND OTHER LITTER, AND FREE OF ROOTS, STUMPS, STONES LARGER THAN 3 cm IN ANY DIMENSION, AND OTHER EXTRANEOUS OR TOXIC MATTER HARMFUL TO SOD GROWTH. OBTAIN TOPSOIL ONLY FROM NATURALLY, WELL DRAINED SITES WHERE TOPSOIL OCCURS IN A DEPTH OF NOT LESS THAN 10 cm. DO NOT OBTAIN FROM BOGS OR MARSHES. THE CONTRACTOR SHALL PROVIDE A SOILS TEST REPORT SHOWING PH AND NUTRIENTS + - PH SHALL BE 5.5 TO 6.0. IF NOT THEN USE THE APPROPRIATE SOIL AMENDMENTS TO REACH 5.5 TO 6.0.
- 11. CONTRACTOR TO VERIFY ALL EXISTING UNDERGROUND UTILITIES PRIOR TO ANY DIGGING.
- PRIOR TO PERFORMING ANY WORK IN THE AFFECTED AREA.
- AND RUBBISH FROM HIS CONSTRUCTION.
- 14. ALL SHRUBS, GROUNDCOVERS, AND SOD SHALL BE GUARANTEED FROM NINETY (90) DAYS AFTER FINAL ACCEPTANCE BY OWNER. ALL TREES SHALL BE GUARANTEED FOR ONE (1) YEAR AFTER FINAL ACCEPTANCE BY OWNER.
- 15. FINAL INSPECTION WILL NOT TAKE PLACE UNTIL ALL MATERIALS ARE PLANTED/INSTALLED CORRECTLY. CONTRACTOR WILL REQUEST A FINAL INSPECTION BY WRITTEN LETTER TO OWNER.
- WARRANTY PERIOD BEGINS.
- PRESCRIBED IN THE DRAWINGS) OF ALL PLANT MATERIAL SPECIFIED AT THE TIME OF THE BID.
- 19. CONTRACTOR INSTALLING THE PLANT MATERIAL AT THE SITE WILL BE RESPONSIBLE FOR MAINTAINING THE CONDITION AND HEALTH OF THE MATERIAL (AS DOCUMENTED IN THE PHOTOGRAPHS AT THE TIME OF INSPECTION) FROM THE TIME OF INSTALLATION TO THE TIME OF TURNING OVER THE PROJECT TO THE OWNER OR OPERATOR. IF THE CONTRACTOR FAILS TO MAINTAIN THE MATERIAL AS SPECIFIED, THAT PLANT MATERIAL WILL BE REJECTED.
- 21 PLANT MATERIAL SHALL NOT BE PLANTED IN THE ROOT BALLS OF ANY TREES.

10. PROVIDE NEW TOPSOIL FOR TURF IN ALL SODDED AND SEEDED AREAS. TOPSOIL SHALL BE FERTILE,

12. THE CONTRACTOR SHALL NOTIFY THE LANDSCAPE ARCHITECT OF ANY CONFLICT OR DISCREPANCY IN PLANS

13. CONTRACTOR SHALL CLEAN UP AND REMOVE FROM THE PREMISES ALL SURPLUS AND DISCARDED MATERIALS

- 16. UPON NOTICE OF FINAL ACCEPTANCE, THE OWNER WILL ASSUME MAINTENANCE AND THE GUARANTEE/
- 17. ALL SODDED AREAS SHALL BE HAND WATERED UNTIL TURF IS ESTABLISHED.
- 20 REPLACE EXISTING SOD WHERE DAMAGED BY CONSTRUCTION ACTIVITIES.

Scale: 1'' = 10' - 00''





SHEET NUMBER: LAPL-2

SUBMITTAL

S

ylo

**PLANTING** 

**DETAILS AND** NOTES

DATE: 3/28/2024

DRAWN BY: jh

REVISIONS:

PROJECT #: 2404

CHECKED BY: JH



February 26, 2024

Miguel Insignares
MEC Investments, Inc.
334 Poinciana Island Drive
Sunny Isles Beach, Florida 33160

Via Email Only

Dear Mr. Insignares:

Re: Platting requirements for a parcel legally described as Lots 25 and 26, Block 22, "Hollywood," according to the Plat thereof, as recorded in Plat Book 1, Page 21, of the Public Records of Broward County, Florida. This parcel is generally located on the south side of Taylor Street, between North 19 Avenue and North 20 Avenue, in the City of Hollywood.

This letter is in response to your correspondence regarding the Broward County Land Use Plan's platting requirements for a proposed multi-family residential development on the above referenced parcel.

Planning Council staff has determined that replatting <u>would not be required</u> by Policy 2.13.1 of the Broward County Land Use Plan (BCLUP) for the proposed development, subject to compliance with any applicable Broward County Trafficways Plan requirement.

As per the criteria of Policy 2.13.1, replatting is required for the issuance of building permits when constructing a non-residential or unified residential development, unless all of the following conditions are met:

- a. The lot or parcel is smaller than 10 acres and is unrelated to any adjacent development;
- b. A majority of the lot or parcel has been specifically delineated in a recorded plat;
- c. All land within the lot or parcel which is necessary to comply with the County Trafficways Plan has been conveyed to the public by deed or easement; and
- d. The proposed development is in compliance with the applicable land development regulations.

The subject parcel is less than 10 acres (approximately 0.25 acres) and meets the specifically delineated requirement. This platting interpretation is subject to the municipality finding that the proposed development is unrelated to any adjacent development, as noted in "a." above.

#### Miguel Insignares February 26, 2024 Page Two

Some jurisdictions may be more restrictive and require platting in more situations than the BCLUP. The City of Hollywood's platting requirements should be investigated.

The contents of this letter are not a judgment as to whether this development proposal complies with State or local vehicular access provisions, the Broward County Trafficways Plan, permitted uses and densities, local zoning, the land development regulations of the municipality or the development review requirements of the BCLUP, including concurrency requirements.

If you have any additional questions concerning the BCLUP's platting requirements, please contact Dawn Teetsel at your convenience.

Respectfully,

Barbara Blake Boy Executive Director

**BBB:DBT** 

cc/email: George R. Keller, Jr., CPPT, City Manager

City of Hollywood

Andria Wingett, Director, Development Services

City of Hollywood



This Instrument Prepared by:

Rod A. Feiner, Esq. Coker & Feiner 1404 S. Andrews Ave. Ft. Lauderdale, FL 33316 Phone: (954) 761-3636

Folio No: 5142 1501 4000 5142 1501 4010

#### **DECLARATION OF UNITY OF TITLE**

KNOW ALL MEN BY THESE PRESENTS, that pursuant to the ordinances of the City of Hollywood pertaining to zoning, the issuance of building permits and regulating building construction activities, the undersigned, being the fee owner(s) of the following described real property situated in the City of Hollywood, County of Broward and State of Florida, do hereby make the following declaration of conditions, limitations and restrictions on said lands, hereinafter to be known and referred to as a DECLARATION OF UNITY OF TITLE, as to the following particulars:

- 1. The undersigned is the owner in fee simple of the properties described as follows:
  - Parcel 1: Lots 25, Block 22, HOLLYWOOD, according to the Plat thereof, as recorded in Plat Book 1, Page 21 of the Public Records of Broward County, Florida.
  - Parcel 2: Lot 26, Block 22, HOLLYWOOD, according to the Plat thereof, as recorded in Plat Book 1, Page 21 of the Public Records of Broward County, Florida.
- 2. The aforesaid plot or combination of separate lots, plots, parcels, acreage or portions thereof shall hereafter be regarded and is hereby declared to be unified under one title as an indivisible building site (hereinafter referred to as "Property").
- 3. The said Property, for the purpose of building, zoning and other applicable codes and regulations, shall henceforth be considered as one parcel of land and that no portion shall be sold, assigned, transferred, conveyed or devised except in its entirety as one plot or parcel of land, with the sole exception being that if the Property is developed as a condominium then the condominium units may be sold, transferred, devised or assigned subject to being part of a condominium and subject to the declaration of condominium pursuant to which they are established; provided, however, that recordation of a mortgage on any portion of the Property shall not be deemed to be in contravention of this Declaration.

- 4. The undersigned further agrees that this Declaration of Unity of Title shall constitute a covenant to run with the land, as provided by law, and shall be binding upon the undersigned, their successors and assigns, and all parties claiming under them until such time as the same may be released in writing under the approval of the City Manager of the City of Hollywood or his designee.
- 5. The undersigned also agrees that this instrument shall be recorded in the Public Records of Broward County.

IN WITNESSS WHEREOF, the said property owner has signed and sealed these presents this day of March, 2024. **WITNESSES** OWNER(S) MEC INVESTMENT INC., a Florida Signature corporation By: Miguel Insignares Printed Name Its: President Signature Printed Name STATE OF FLORIDA :) :) SS COUNTY OF BROWARD :) The foregoing instrument was acknowledged before me by means of physical presence online notarization, this day of March, 2024, by Miguel Insignares, as the President of MEC Investment Inc., a Florida corporation □ who is personally known to me or □ who has as identification and who did not take an produced oath. Signature of Notary Public Print, type or stamp name of Notary and (SEAL) Commission No.

### TECHNICAL ADVISORY COMMITTEE REPORT

March 30, 2024

Miguel Insignares 334 Poinciana Island Dr Sunny Isles Beach, Florida

**FILE NUMBER:** 23-DP-97

**SUBJECT:** Preliminary Site Plan review for an 18-unit residential development

Owner/Applicant: MEC INVESTMENTS INC

Address/Location: 1942 Taylor St

Net Size of Property: 10,759 sq. ft. (0.25 acres)
Land Use: Regional Activity Center (RAC)

**Zoning:** North Downtown High Intensity Mixed-Use District (ND-3)

Present Use of Land: Residential Year Built: 1925 - 1954

SITE DATA

#### **ADJACENT LAND USE**

North: Regional Activity Center (RAC)
South: Regional Activity Center (RAC)
East: Regional Activity Center (RAC)
West: Regional Activity Center (RAC)

#### **ADJACENT ZONING**

North: North Downtown High Intensity Mixed-Use District (ND-3)

South: North Downtown High Intensity Mixed-Use District (ND-3)

East: North Downtown High Intensity Mixed-Use District (ND-3)

West: North Downtown High Intensity Mixed-Use District (ND-3)

APPLICANTS MUST ADDRESS ALL COMMENTS AND FINDINGS AS IDENTIFIED BY MEMBERS OF THE TECHNICAL ADVISORY COMMITTEE BOTH IN WRITING (IDENTIFY PAGE NUMBER OF THE CORRECTION) AND ON THE SITE PLAN (ALL CHANGES MUST BE IDENTIFIED, I.E. BUBBLED)

#### A. <u>APPLICATION SUBMITTAL</u>

Reginald White, Planning Administrator (rwhite@hollywoodfl.org) 954-921-3471

#### 1. Application Form:

- a. The project address should be the same as what is indicated on the Alta Survey. Indicate both addresses on the application. New application form provided.
- b. Put the correct date of the Preliminary TAC meeting date on the cover sheet. New application form provided.
- c. Indicate the date of the ALTA Survey. Must be within 30 days of O&E Report. New application form provided.
- 2. Ownership & Encumbrance Report (O&E):

- a. The O&E for 1942 Taylor Street needs to be dated prior ALTA Survey. Provide the date on the Alta Survey. Refer to O&E report.
- Indicate the report was searched from the time of platting or 1953 (earliest of the two).
   Refer to O&E report.
- c. Work with Engineering Division to ensure the O&E is accurate and all easements and dedications are indicated. Refer to engineering comments.
- d. Indicate the listed encumbrances are abutting the property boundary necessary for legal access to the property. Refer to O&E report.
- e. Ensure O&E addresses the requirements on the TAC submittal checklist: http://www.hollywoodfl.org/ArchiveCenter/ViewFile/Item/453 N o t e d .

#### 3. Alta Survey:

- a. Alta survey shall be based on and dated after O&E. It shall make reference of the O&E report. A000a, under Certification states that it was updated October 6, 2023. Under Schedule "B" Title Notes it references O&E report dated August 17, 2023.
- Work with the Engineering Division to ensure the survey includes the appropriate elements such as all easements and dedications are indicated. Refer to Engineering comments.
- 4. Provide plat determination letter from the County. Should platting be necessary, prior to Final TAC submittal County Plat comments are required. Plat shall be submitted for recordation prior to submitting for Planning and Development Board. Plat determination letter shall be for all properties in this project. Platting letter provided.
- Indicate past, current and future meeting dates as they happen (not submittal dates) on Cover Sheet. Indicate specific Board/Committee (i.e. TAC, PDB, etc.) For future Board/Committee dates not known, leave blank until staff has advised of next meeting date. Refer to A000, dates updated.
- 6. A public participation outreach meeting shall be required for Land Use, Rezoning, Special Exception, and Site Plan requests. Applicants shall conduct at least one public participation outreach meeting and provide mailed written notice to all property owners and certified/registered civic and neighborhood association(s) within 500 feet of the proposed project. Fifteen days prior to the meeting, the applicant shall mail such notice and post a sign on the property, including the date, time, and place of the public participation outreach meeting. Such meeting shall occur prior to the applicable Committee, Board or City Commission submittal and the Applicant shall include in its application packet a letter certifying the date(s), time(s), location(s), a copy of the sig-in sheet, presentation material and general summary of the discussion, including comments expressed during the meeting(s).
  - a. Royal Poinciana Civic Association

- 7. Additional comments may be forthcoming. Noted.
- 8. Provide written responses to all comments with next submittal. Provided.

#### B. ZONING

Reginald White, Planning Administrator (rwhite@hollywoodfl.org) 954-921-3471

 Indicate past, current, and future meeting dates as they happen (in addition to submittal dates) on Cover Sheet. Indicate specific Board/Committee (i.e. TAC, PDB, etc.) For future Board/Committee dates not known, leave blank until staff has advised of next meeting date. Refer to A000, dates updated.

#### 2. Site Plan:

- a. Include a note on the site plan indicating that all changes to the design will require planning review and may be subject to Board approval. Refer to A100 notes, note added.
- b. Clearly indicate the property line, with a darker line weight. Refer to A100, line weight increased.
- c. Dimension all balcony setbacks to all property lines. Per Sec. 4.6.B.3.a.(9)(i), balconies may encroach a maximum of 75% into the required setback. Side setbacks are zero lot lines; refer to A102, A103 & A104.
- d. Indicate columns are at least 3ft from the entrance to a parking space for both sides of parking lot. Refer to A100, dimensions added.
- e. Indicate concrete car stops (6ft long) for parking spaces on the site plan. Refer to A100, car stops added.
- f. All walkways and green areas shall be labeled. Refer to A100, walkways & green areas labeled.
- g. Label the guest parking spaces, handicap and electric vehicle charging stations. Refer to A100, spaces labeled.
- h. Parking space 1 requires an additional foot due to it being located adjacent to a wall or obstruction. Parking space 1 width is 9'-6", which is sufficient for solid obstruction such as walls as per local ordinance.
- i. Indicate on-site plan and renderings a minimum of 40% ground level active use. Refer to A100 notes, 36' of active use provided (45%).
- j. Proving the minimum queuing length of 18 ft at the entrance of the parking garage. Refer to A100 notes, no garage entry door shall be used to allow for queuing.

#### 3. Site calculations:

a. Per Sec. 4.6.B.3.a.(7), include the minimum required and provided dwelling unit sizes and cumulative averages. Provide a breakdown of all units per floor, including balcony area. Refer to A003, Net Area, breakdown provided.

- b. Include the provided FAR as a ratio, not just the overall provided square footage. Refer to A003, FAR analysis, ratio included.
- c. The common areas: corridors, stairs, elevators, gym, all shall be counted towards FAR. Refer to A003, FAR analysis, breakdown provided.
- d. Tandem spaces can only be counted toward one unit, ensure tandem spaces are called out on parking statistics table. Refer to A003, parking calculation table, note added.
- e. Provide VUA calculation. Please see section 4.6(3)(d)(3) of the code. Refer to A003, parking calculation table added.
- 4. Work with the City's Landscape Architect to ensure that all landscape requirements are met. Refer to Lanscaping comments.

#### C. ARCHITECTURE AND URBAN DESIGN

Laura Gomez, Associate Planner (Igomez@hollywoodfl.org) 954-921-3471

- 1. Provide a rendering of all the sides. Refer to A000, A200a, A201a, A202a, A203a & A205.
- 2. Provide a note: All changes to the design will require Planning review and may be subject to Board approval. Refer to A100 notes, note added.
- 3. Indicate and demonstrate access to the dumpster on site plan. Label dumpster pad/ramp that provides access. Refer to A100, path lines added.
- 4. Work with the Building Department to ensure that adequate ventilation is provided for the parking garage. Refer to A100 notes, note added.

#### D. SIGNAGE

Reginald White, Planning Administrator (rwhite@hollywoodfl.org) 954-921-3471

- 1. Provide the following note: "All signage shall be in compliance with the Zoning and Land Development regulations". Refer to A100 notes, note added.
- 2. Provide note on Site Plan: "All signs, which are electrically illuminated by neon or other means, shall require a separate electrical permit and inspection. Separate permits are required for each sign." Refer to A100 notes, note added.

#### E. <u>LIGHTING</u>

Reginald White, Planning Administrator (<a href="mailto:rwhite@hollywoodfl.org">rwhite@hollywoodfl.org</a>) 954-921-3471

1. Provide note on Site Plan: "Maximum foot candle level at all property lines maximum 0.5 if adjacent to residential". Refer to A100 notes, note added.

#### F. GREEN BUILDING & ENVIRONMENTAL SUSTAINABILITY

Reginald White, Planning Administrator (<a href="mailto:rwhite@hollywoodfl.org">rwhite@hollywoodfl.org</a>) 954-921-3471

1. As per the City of Hollywood's green building ordinance in Chapter 151, the project will require a third party green building certification since this project has more than 20,000 square feet of total floor area. USGBC's LEED certification or Florida Green Building Coalition certification are the minimum standards. Include which third party certification program this project has chosen

in a note on the site plan and provide green registration documentation with next submittal. Refer to A003, Green Building Cert., LEED certification started.

- 1. Indicate on the site plan where the infrastructure necessary for future installation of electric vehicle-charging equipment will be located. (See 151.154, Ordinance O-2016-02) Consider placing it adjacent to a handicapped space so that the future charger will be accessible from both types of spaces. Recommend to locate the charging stations on the visitor parking spaces. Refer to A100, parking space 1 to be EV station.
- Work with Building Department to ensure compliance with Green Building Ordinance. Review
  and adjust drawings as necessary. Indicate on drawings Green Building certification to be
  achieved and remove the list of Green Building Practices. Refer to A003, Green Building Cert.

#### G. ENGINEERING

Azita Behmardi, Deputy Director (abehmardi@hollywoodfl.org) 954-921-3251 Clarissa Ip, City Engineer (cip@hollywoodfl.org) 954-921-3915 Rick Mitinger, Transportation Engineer (rmitinger@hollywoodfl.org) 954-921-3990

- 1) For the survey, please update information under "General Notes", i.e. Item 1 states that survey is a Boundary survey and confirm the actual field work date. Refer to ALTA survey title, upper middle title.
- 2) Provide plat determination letter from the Broward County Planning Council. Provided.
- 3) Please provide a Unity of Title. Provided.
- 4) Provide site plan for the project with the following information:
  - a. Dimension and label all features of the existing right-of-way and show limits of the rights-of-way on both sides of Taylor Street. Refer to A100.
  - b. Include and show all surrounding elements as applicable, i.e. adjacent alley, road, properties, limits of rights-of-way on both sides of adjacent streets or alleys including any curb cuts, edge of pavement, swale, sidewalks etc. Refer to A100.
  - c. Provide dimension for column setback from drive aisle on the east side of the parking area, minimum 3' is required. Refer to A100.
  - d. Please provide dimensions to show the electric meter/pump room will not encroach into the required drive aisle. Reduce this size of this room. Provide clear space dimension in drive aisle (minimum 22 feet.) Refer to A100, 22' achieved.
  - e. Indicate and label property line on all sides of the site. Refer to A100.
  - f. Demonstrate that perimeter wall footing/wall does not encroach into adjacent property or ROW. i.e. provide wall cross-section or show setback. Refer to A200, Section 2/A200 added.
  - g. Provide dimensions for all setbacks, applicant has a door exiting to the west that may require a landing/walkway all walkways are to be setback a minimum of 3 feet from the side property lines. Please ensure this requirement is met. Refer to A100, door removed.
  - h. Identify all material types proposed (i.e. apron, parking lot, sidewalk, and walkways, etc.)

    Refer to A100, all materials called out.
  - i. Please number and label each stairwell on site plan. Refer to A100, stairs numbered.
  - j. Identify the vertical clearance and opening of the garage on the site plan and elevations. Refer to A200, Section 2/A200

- 5) Please provide a detectable warning at the driveway, a spec/detail for the proposed FDOT detectable warnings is to be provided in the plans. Refer to A100, detectable warning added, refer to civil for specs.
- 6) Sheet A-100, the vehicle queueing space entering the garage is in conflict with parking Stall 1, vehicle queueing space shall not overlap into the parking backout space. Refer to A100, previous parking stall 1 replaced with cyber lounge.
- 7) Please indicate on plans if a garage door/gate is being proposed. If so, please show the type of gate being proposed and how it operates, i.e. keypad, fod, barcode scanner, etc. will be in place to allow entrance and exit from the parking garage. If not, indicate on plans that no garage door/gate is being proposed. Refer to A100 notes, no garage door shall be installed.
- 8) Please dimension the length and width of all proposed walkways and ramps. (i.e., front concrete walkway.) Refer to A100, dimensions added.
- 9) Parking stalls 1, 21 and 29 shall be 9.5' width as there is obstruction on one side. Refer to A100, current parking stall 1, 11, 21, 26 & 27 are 9.5' (29 has been removed).
- 10) Provide ADA accessible routes between ADA accessible parking and building access and accessible route to the public rights-of-way. Please add a note on the site plan stating ANY LIP FROM 1/4" BUT NOT GREATER THAN ½" WILL BE BEVELED TO MEET ADA REQUIREMENTS. Identify any elevation differences or slopes from the sidewalk in the ROW and accessible parking stall to the entrance of the building. If there is no difference state, the transition is flush. Show the accessible routes on site plan. Provide a detail for the proposed ramps showing how they achieve ADA compliance. Refer to A100, elevation changes & ramp slopes added. For note refer to site plan notes.
- 11) Please provide a parking table showing the number of tandem spaces, regular spaces, ADA spaces and guest spaces. Ensure guest spaces are labeled on site plan and pavement markings are provided to identify guest spaces provided. Refer to A100.
- 12) Please identify the location of the ADA signage, please consider wall mounting the signage to not encroach into the clear space of the parking stall. Refer to A100, ADA signage added.
- 13) All non-vehicular areas shall be stripped and clearly identified. This stripping shall not be the same stripping as the ADA accessible aisle. Please show on plan. (i.e. next to Stalls 21/29 and trash area.). Refer to A100, ADA stripping pattern changed.
- 14) Provide civil plans for the proposed project. Indicate items such as but not limited to drainage improvements, curbing, drive aisle widths, vehicular circulation, sight visibility triangle, vehicular turning radii, pavement marking and signage plans and details. Show location of existing water and sewer mains on plans and show the project is planning to connect to the city system. For water and sanitary sewer connection, show any pavement restoration and details required for connections within City rights-of-way. Full road width asphalt pavement mill and resurface is
  - required for all adjacent road / alley to the parcel. Provide City of Hollywood pavement, sidewalks and swale grading details in plan set. In this case, coordination will be required with the City CRA. Refer to civil plans.
- 15) Add note on civil and site plans for full road width pavement mill and resurfacing will be required for all streets / roadway adjacent to the project site. Refer to civil plans.

- 16) Please provide a pavement marking and signage plan for all onsite and off-site pavement markings. All pavement marking and signage within City rights-of-way requires review and stamped approved plans by Broward County Traffic Engineering Division. BCTED approval required at the time of permitting. Refer to civil plans.
- 17) Please include all applicable Standard City of Hollywood details: https://www.hollywoodfl.org/1459/Standard-Details-for-Engineering-and-Lan Refer to civil plans.
- 18) Please note that the City, in conjunction with the Downtown Community Redevelopment Agency, is working on developing a manual setting forth requirements for rights-of-way design and improvements guidelines in the RAC area. Continued coordination will be required. Noted.
- 19) For utilities work within City rights-of-way, ROW permit will be required at the time of permit. Refer to A100 notes, note added.
- 20) MOT plans required at the time of City Building Permit review. Refer to A100 notes, note added.
- 21) All outside agency permits are required at the time of City building permit review. Refer to A100 notes, note added.
- 22) This project will be subject to impact fees (inclusive of park impact fee) under the new City Ordinance PO-2022-17, effective September 21, 2022. Impact fees payments to be made at the time of City Building Permit issuance. Refer to A100 notes, note added.

More comments may follow upon review of the requested information.

#### H. LANDSCAPING

Favio Perez, Landscape Reviewer (fperez@hollywoodfl.org) 954-921-3900 Clarissa Ip, City Engineer (cip@hollywoodfl.org) 954-921-3915

- -no landscape plan submitted on set.
- 1. Satellite images show existing trees/palms. Refer to Landscaping drawings.
- 2. Provide a Tree disposition plan and landscape plan on separate sheets by a registered professional licensed Landscape Architect in the State of Florida that compliments the building architecture and uses, provides for shade, beautifies the site, accentuates site features, and serves as a buffer where appropriate. Refer to Landscaping drawings.
- 3.According to Chapter 155.52 of the Code of Ordinances and the City of Hollywood Landscape Manual, Shade trees to be installed at a minimum size of 2" DBH/ 12' height. Existing trees meeting this criteria may be used as credit toward total requirement. Palm trees count toward tree requirements on a 3:1 basis, meaning 3 palms equal 1 broadleaf tree. Palms must be 8' CT min. Refer to Landscaping drawings.
- 4.Provide sight triangles on plans at intersection of driveway and property line Sec. 155.12 (d) Refer to Landscaping drawings.
- 5. Native plant requirements; 60% trees, 50% shrubs Sec. 3.4. Refer to Landscaping drawings.

6.Label all sides of property weather there are 'Existing Overhead Powerlines' or 'No Overhead Powerlines'. Provide FPL approved trees for planting under powerlines. Refer to Landscaping drawings.

7.Add note: 'Trees and Palms shall not be removed without first obtaining an approved Tree Removal Permit from the City of Hollywood.' Refer to Landscaping drawings.

8. Above ground equipment: Where required for screening purposes, hedge shall be planted at equipment height for visual screening. Refer to Landscaping drawings.

9.Add note: All landscaping shall be warranted for 1 year after final inspection. Refer to Landscaping drawings.

- 10. Provide site requirements as per project zoning. RAC requirements Refer to Landscaping drawings.
- 11. Add note: 100% irrigation coverage shall be provided. Refer to Landscaping drawings.

More comments may follow upon review of the requested information.

#### I. UTILITIES

Alicia Verea-Feria, Floodplain Development Review Administrator (averea-feria@hollywoodfl.org) 954-921-3302

- 1. Submit civil engineering plans indicating existing and proposed Water, Fire, Sewer, and Drainage for initial review. Refer to civil drawings, C-1.
- 2. Show Water and Sewer demand calculations on proposed utilities plans. Refer to civil drawings, C-1.
- Include the City's latest applicable standard Water and Sewer details. The details are available on the City's website via the following link: http://www.hollywoodfl.org/1169/Standard-Details-and-Public-Notices . Refer to civil drawings, C-4 & C-5.
- 4. This site resides currently within FEMA Flood Zone X. The proposed Finished Floor Elevations (FFE) = 8.6' NAVD88 shall comply with the **greatest** of the following three (3) conditions, as applicable. Refer to civil drawings, C-1.
  - a. Section 154.50 of the City's Code of Ordinances requires the minimum FFE for residential shall be, at a minimum, 18-inches above the elevation of the crown of the adjacent road or 6-inches, at a minimum, for non-residential use.
  - b. Broward County Preliminary 2019 FEMA Flood Maps (as recommended), available online via the following link:
     <a href="https://bcgis.maps.arcgis.com/apps/View/index.html?appid=ea44837317bd47">https://bcgis.maps.arcgis.com/apps/View/index.html?appid=ea44837317bd47</a>
     eaa5373ce3e2f01b6e; OR
  - Broward County Future Conditions 100-year Flood Map 2060 (in effect as of July 2021), available online via the following

link: https://bcgis.maps.arcgis.com/apps/webappviewer/index.html?id=ec160 b81e7f84bdeacda62575e817380. Floodproofing may need to be considered.

- 5. Indicate FFE for all enclosed areas on the ground floor. Refer to civil drawings, C-1.
- 6. Provide perimeter cross sections across all property limits including transition areas meeting adjacent property grades. Refer to civil drawings, C-2.
- 7. Ensure all stormwater is retained onsite. Refer to civil drawings, C-1 notes.
- 8. Indicate how roof drainage will be collected and connected to the on-site drainage system. Refer to civil drawings, C-1.
- 9. Provide preliminary drainage calculations. Refer to civil drawings, C-1.
- 10. Submit Erosion Control Plan. Refer to civil drawings, C-3.
- 11. Permit approval from outside agencies will be required. Refer to civil drawings, C-1 notes.
- 12. Landscape plans to be submitted should coordinate with civil plans to accommodate for drainage features. Noted.
- 13. Additional comments may follow upon further review of requested items. Noted.

#### J. BUILDING

Russell Long, Chief Building Official (rlong@hollywoodfl.org) 954-921-3490
Daniel Quintana, Assistant Building Official (dquintana@hollywoodfl.org) 954-921-3335

1. No comments received. Noted.

#### K. FIRE

Chris Clinton, Fire Marshal (cclinton@hollywoodfl.org) 954-967-4404 Marcy Hofle, Deputy Fire Marshall (mhofle@hollywoodfl.org) 954-967-4404

- 1 Fire review for TAC is limited to fire department access and minimum fire flow requirements for water supply for firefighting purposes. --- A complete architectural review will be completed during formal application of architectural plans to the building department. Noted.
- 2 Water supply shall meet the requirements of NFPA 1 (2018 Ed.) Section 18.4.5.3. --- To determine the minimum fire flow required for firefighting purposes, a Hydrant Flow Test will

need to be scheduled through our Underground Utilities Department via email. --- underground@hollywoodfl.org

After the results are completed, the civil engineer shall show on civil drawings the calculations using table 18.4.5.2.1 showing that the project meets the minimum fire flow requirements for the building.

For your convenience, I have attached a sample Fire Flow Calculation letter which can be used as a template. Refer to civil drawings, C-1.

- 3 Water supply and any new hydrants shall be in place prior to accumulation of combustible materials per NFPA 1 (2018 Ed.) Section 16.4.3.1.1. --- Provide a note on the plans. Refer to civil drawings, C-1 notes.
- 4 Provide civil drawings for the underground fire main. --- Provide such including the location of the fire department connection, DDCV, and size and type of the fire line from the water supply. --- Check with our water department for city requirements in addition to fire.

Ensure on the plans that there is a fire hydrant within 100 feet of fire department connections a required by NFPA 14 (2016 Ed.) Section 6.4.5.4 --- "Fire department connections shall be located not more than 100 ft (30.5 m) from the nearest fire hydrant connected to an approved water supply." Refer to civil drawings, C-1.

5 - Provide a note on civil drawing all underground fire main work must be completed by fire protection contractor holding a Class I, II, or V license per FS 633.102. Refer to civil drawings, C-1 notes.

#### L. PUBLIC WORKS

Annalie Holmes, Public Works Director (aholmes@hollywoodfl.org) 954-967-4207 Daniel Millien, Environmental Services Manager (dmillien@hollywoodfl.org) 954-967-4207

1. According to Sheet no.: A100, the dumpster enclosure outlined as "Trash Chute" is approved. Simply make a note, recycling collection is also required per the code. We do not want to the applicant or property owner assuming trash ONLY. We are requesting "Recycling" on the plans and labeled along with "Trash" reflecting the necessary requirement for both materials. Refer to A100, notes added.

#### M. PARKS, RECREATION AND CULTURAL ARTS

David Vazquez, Assistant Director (dvazquez@hollywoodfl.org) 954-921-3404

1. Park Impact Fee application required. Refer to A100, Site plan notes.

#### N. COMMUNITY DEVELOPMENT

Ryon R. Coote, Community Development Manager (<u>RCoote@hollywoodfl.org</u>) 954-924-2958 Liliana Beltran, Housing inspector (<u>Ibeltran@hollywoodfl.org</u>) 954-921-2923

1. There's an existing Acorn Street Light within the frontage of the property along Taylor Street. If the Acorn Street Light is in conflict with the new proposed development, the applicant shall be responsible for the relocation or replacement of the street light.

Refer to A100, Acorn light relocated.

- 2. Please develop additional renderings with alternative views of the proposed development. Renderings shall depict existing and proposed conditions, i.g., adjacent buildings, ROW elements, proposed landscape, etc. Refer to A000, A200a, A201a, A202a, A203a & A205.
- The proposed architecture of the building appears to be flat with almost no articulation.
   The CRA would like to recommend adjusting the massing of the building and/or incorporating additional architectural elements to help improve the architecture of all four elevations. Facades modified, refer to A000, A200a, A201a, A202a, A203a & A205.

#### O. ECONOMIC DEVELOPMENT

Joann Hussey, Interim Director (jhussey@hollywoodfl.org) 954-924-2922 Herbert Conde-Parlato, Economic Development Manager (hconde-parlato@hollywoodfl.org) 954-924-2922

1. Application is substantially compliant. Noted.

#### P. POLICE DEPARTMENT

Christine Adamcik, Police (cadamcik@hollywoodfl.org) 954-967-4371 Steven Bolger, Police (sbolger@hollywoodfl.org) 954-967-4500 Doreen Avitabile, Police (davitabile@hollywoodfl.org) 954-967-4371

Application is substantially compliant. Noted.

#### Q. DOWNTOWN AND BEACH CRA

Jorge Camejo, Executive Director (jcamejo@hollywoodfl.org) 954-924-2980 Susan Goldberg, Deputy Director (sgoldberg@hollywoodfl.org) 954-924-2980 Francisco Diaz-Mendez, Project Manager (fdiaz-mendez@hollywoodfl.org) 954-924-2980

1. There's an existing Acorn Street Light within the frontage of the property along Taylor Street. If the Acorn Street Light is in conflict with the new proposed development, the applicant shall be responsible for the relocation or replacement of the street light.

#### Refer to A100, Acorn light relocated.

- 2. Please develop additional renderings with alternative views of the proposed development. Renderings shall depict existing and proposed conditions, i.g., adjacent buildings, ROW elements, proposed landscape, etc. Refer to A000, A200a, A201a, A202a, A203a & A205.
- 3. The proposed architecture of the building appears to be flat with almost no articulation. The CRA would like to recommend adjusting the massing of the building and/or incorporating additional architectural elements to help improve the architecture of all four elevations. Facades modified, refer to A000, A200a, A201a, A202a, A203a & A205.

#### R. PARKING

Angela Kelsheimer, Parking Manager (akeisheimer@hollywoodfl.org) 954-921-3548

1. No comments received. Noted.

#### S. ADDITIONAL COMMENTS

Reginald White, Planning Administrator (rwhite@hollywoodfl.org) 954-921-3471

1. Additional comments may be forthcoming. Noted.

The Technical Advisory Committee finds this application substantially compliant with the requirements of Preliminary Review; therefore, the Applicant should submit for Final TAC review.

Please be advised, in the future any additional review by the TAC may result in the payment of additional review fees.

If these comments have not been addressed within 120 days of this dated report the application will expire. As a result, a new application and fee will be required for additional review by the TAC.

Note that any use proposed for the site shall be consistent with Zoning and Land Development Regulations.

Should you have any questions, please do not hesitate to contact your Project Planner at 954-921-3471.

Sincerely,

Reginald White Planning Administrator

C: Miguel Insignares; Miguel Insignares <thespecialistinc2002@yahoo.com>