

Attachment I
First Application
Package

APPLICATION DATE: _____

2600 Hollywood Blvd

Room 315

Hollywood, FL 33022

Tel: (954) 921-3471

Email: Development@
Hollywoodfl.org

SUBMISSION REQUIREMENTS:

- One set of signed & sealed plans
(i.e. Architect or Engineer)
- One electronic **combined** PDF submission (max. 25mb)
- Completed Application Checklist
- Application fee

NOTE:

- This application must be **completed in full** and submitted with all documents to be placed on a Board or Committee's agenda.
- The applicant is responsible for obtaining the appropriate checklist for each type of application.
- Applicant(s) or their authorized legal agent must be present at all Board or Committee meetings.

**CLICK HERE FOR
FORMS, CHECKLISTS, &
MEETING DATES**

APPLICATION TYPE (CHECK ALL THAT APPLIES):

- | | | |
|---|---|--|
| <input type="checkbox"/> Technical Advisory Committee | <input type="checkbox"/> Art in Public Places Committee | <input type="checkbox"/> Variance |
| <input type="checkbox"/> Planning and Development Board | <input type="checkbox"/> Historic Preservation Board | <input type="checkbox"/> Special Exception |
| <input type="checkbox"/> City Commission | <input type="checkbox"/> Administrative Approval | |

PROPERTY INFORMATION

Location Address: 834 Polk Street

Lot(s): 26 Block(s): 72 Subdivision: SECTION 1-32 B

Folio Number(s): 514214024271

Zoning Classification: RS-6 Land Use Classification: RESIDENTIAL

Existing Property Use: RESIDENTIAL - VACANT LAND Sq Ft/Number of Units: 6,400 SQFT

Is the request the result of a violation notice? ☐ Yes ☐ No **If yes**, attach a copy of violation.

Has this property been presented to the City before? If yes, check all that apply and provide File Number(s) and Resolution(s): YES / RESOLUTION PENDING / LOT DIVISION APPROVED #24-V-17

DEVELOPMENT PROPOSAL

Explanation of Request: NEW SINGLE FAMILY HOME

Phased Project: Yes ☐ No ☒ Number of Phases:

Project	Proposal
Units/rooms (# of units)	# UNITS: <input type="text" value="1"/> #Rooms <input type="text" value="5"/>
Proposed Non-Residential Uses	<input type="text"/> S.F.)
Open Space (% and SQ.FT.)	Required %: <input type="text" value="45.69"/> (Area: <input type="text" value="2,922"/> S.F.)
Parking (# of spaces)	PARK. SPACES: (# <input type="text" value="5"/>)
Height (# of stories)	(# STORIES) <input type="text" value="2"/> (<input type="text" value="30"/> FT.)
Gross Floor Area (SQ. FT)	Lot(s) Gross Area (<input type="text" value="3,465"/> FT.)

Name of Current Property Owner: BIDASK LADRILLO LLC

Address of Property Owner: 2501 S OCEAN DR STE 105, HOLLYWOOD, FL 33019

Telephone: (786) 262-7546 Email Address: oscar@lobainc.com

Applicant YOANN ANDREU Consultant ☐ Representative ☐ Tenant ☐

Address: 1025 92ND ST, #701, BAY HARBOR IS., FL 33154 Telephone: (786) 218-3072

Email Address: yoann@andreustudio.com

Email Address #2: _____

Date of Purchase: _____ Is there an option to purchase the Property? Yes ☐ No ☐

If Yes, Attach Copy of the Contract.

Noticing Agent (FTAC & Board submissions only) : _____

E-mail Address: _____



CERTIFICATION OF COMPLIANCE WITH APPLICABLE REGULATIONS

The applicant/owner(s) signature certifies that he/she has been made aware of the criteria, regulations and guidelines applicable to the request. This information can be obtained in Room 315 of City Hall or on our website at www.hollywoodfl.org. The owner(s) further certifies that when required by applicable law, including but not limited to the City's Zoning and Land Development Regulations, they will post the site with a sign provided by the Office of Planning and Development Services. The owner(s) will photograph the sign the day of posting and submit photographs to the Office of Planning and Development Services as required by applicable law. Failure to post the sign will result in violation of State and Municipal Notification Requirements and Laws.

(I)(We) certify that (I) (we) understand and will comply with the provisions and regulations of the City's Zoning and Land Development Regulations, Design Guidelines, Design Guidelines for Historic Properties and City's Comprehensive Plan as they apply to this project. (I)(We) further certify that the above statements and drawings made on any paper or plans submitted herewith are true to the best of (my)(our) knowledge. (I)(We) understand that the application and attachments become part of the official public records of the City and are not returnable.

Signature of Current Owner: Christian Rene Gardel Date: 05/17/2024

PRINT NAME: Christian Rene Gardel Date: 05/17/2024

Signature of Consultant/Representative: YOANN ANDREU Date: 5/14/2024

PRINT NAME: _____ Date: _____

Signature of Tenant: _____ Date: _____

PRINT NAME: _____ Date: _____

Current Owner Power of Attorney

I am the current owner of the described real property and that I am aware of the nature and effect the request for _____ to my property, which is hereby made by me or I am hereby authorizing _____ to be my legal representative before the _____ (Board and/or Committee) relative to all matters concerning this application.

Sworn to and subscribed before me
this 17 day of May

Bruce Toledo



Signature of Current Owner

Print Name

My Commission Expires: 9-26 (Check One) ☐ Personally known to me; OR ☒ Produced Identification Passport



October 29, 2024

Leonard Robinson Rev Tr Robinson

RE: Address Designation - Folio No. 5142-14-02-4271

To whom it may concern:

The City of Hollywood will designate the below address for the parcel described as Lot 26, Block 72, subdivision Hollywood Lakes, according to the plat thereof as recorded in Plat Book 1 Page 32 of the Public Records of Broward County, Florida. The address is as follows:

FROM: **Vacant**
TO: **834 Polk Street**


We will amend City of Hollywood records to reflect this change and will notify the below listed entities. You are required to provide a copy to your USPS regional address management office. Furthermore, we encourage you to furnish a copy to any utility service provider with connection to your property (e.g.: FPL, Teco Peoples Gas Company, and any relevant cable or internet service provider).

Sincerely,




Laura Gomez
Planner II

Cc via e-mail: Broward County
City of Hollywood Internal Departments

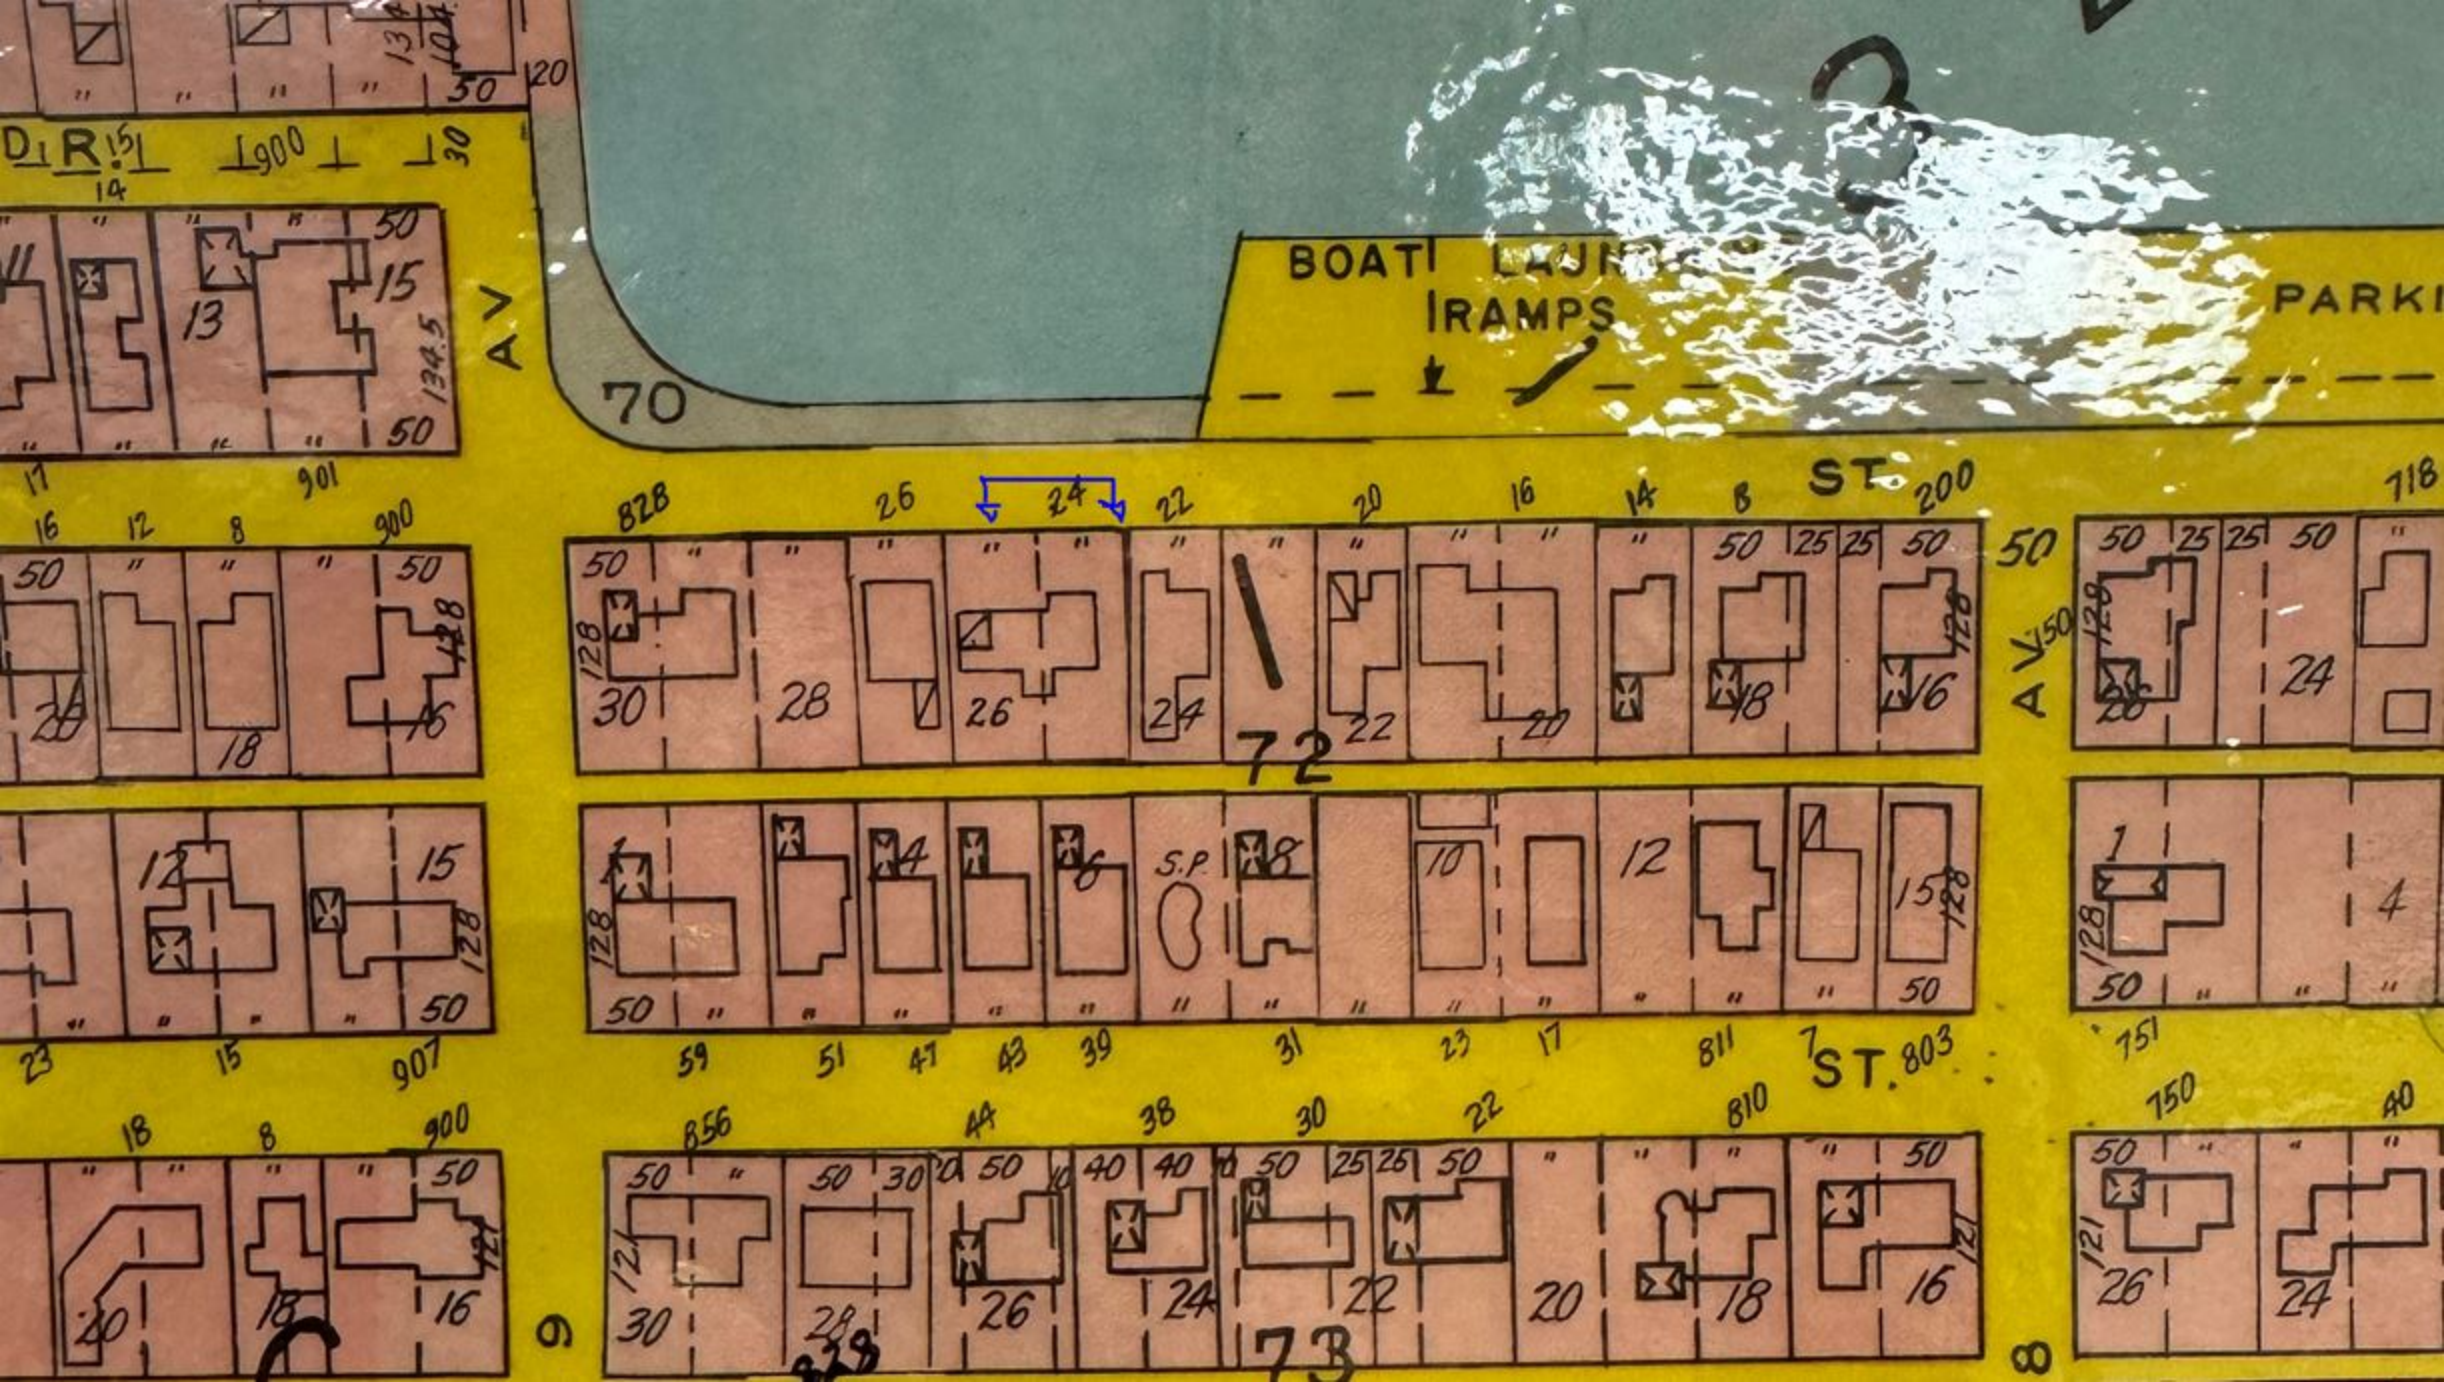

LOCATION SKETCH

SCALE: NTS

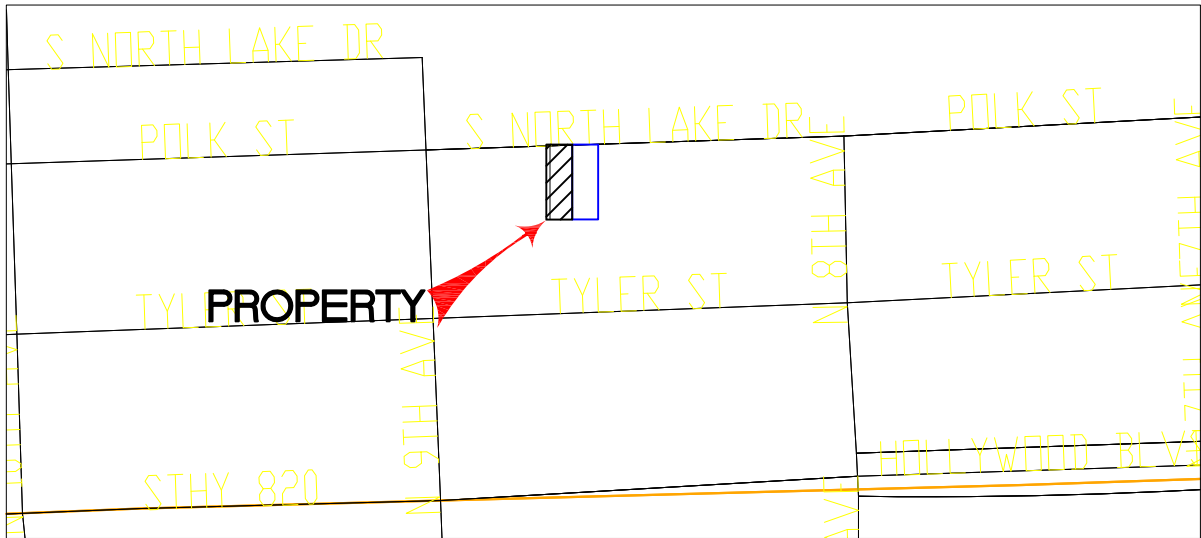

JOB No. 24-03824L26 CLIENT: BIDASK LADRILLO LLC
PROPERTY ADDRESS POLK ST HOLLYWOOD FL 33019 FOLIO: 514214024271
LEGAL DESCRIPTION: (FURNISHED BY CLIENT)
LOT 26, BLOCK 72
SUBDIVISION HOLLYWOOD LAKES
ACCORDING TO THE PLAT THEREOF AS RECORDED IN PLAT BOOK 1 AT PAGE 32
OF THE PUBLIC RECORDS OF BROWARD COUNTY, FLORIDA.
SUBJECT TO ALL RESTRICTIONS, RESERVATIONS, EASEMENTS AND RIGHT-OF-WAY OF RECORD, UNDERGROUND ENCROACHMENTS IF ANY, NOT LOCATED.
SURVEYOR'S NOTES:

- 1-) IF SHOWN, BEARINGS AND ANGLES ARE REFEREED TO SAID PLAT IN LEGAL DESCRIPTION.
- 2-) THE RELATIVE CLOSURE IN THE FIELD MEASURED BOUNDARY IS BETTER THAN: 1 FOOT IN 7,500 FEET; LINEAR (SUBURBAN).
- 3-) A TITLE REPORT WAS NOT PROVIDED FOR THIS SURVEY. THEREFORE, THERE MAY BE RESTRICTIONS ON THIS PARCEL THAT ARE NOT SHOWN THAT MAY BE FOUND IN THE PUBLIC RECORDS OF BROWARD COUNTY, FLORIDA. NO EXPRESSED OR IMPLIED DETERMINATION OF TITLE OR OWNERSHIP TO THE LAND DESCRIBED IS MADE.
- 4-) THERE MAY BE UNDERGROUND UTILITY LOCATIONS AND SUBSURFACE FEATURES WITHIN THE PARCEL THAT ARE NOT SHOWN. THERE IS NO VISIBLE SURFACE OR OVERHEAD ENCROACHMENT, OTHER THAN SHOWN ON THIS SURVEY.
- 5-) IT IS A VIOLATION OF RULE 5J-17 OF THE FLORIDA ADMINISTRATIVE CODE TO ALTER THIS SURVEY DRAWING WITHOUT THE PRIOR WRITTEN CONSENT OF THE SURVEYOR.
- 6-) INFORMATION OF TREE IF PROVIDED: DIAMETER (Ø), HEIGHT (H), CANOPY SHADE (CS). ALL NAMES ARE NOTED TO SURVEYORS ABILITY. SURVEYOR IS NOT AN ARBORIST AND CANNOT PROVIDE SCIENTIFIC NAMES OF TREE AND OR PLANTS.
- 7-) SURVEYOR DOES NOT DETERMINE OWNERSHIP OF FENCE, ONLY EXISTING LOCATION IS REPRESENTED.
- 8-) FLOOD ZONE DETERMINATION MUST BE CONFIRMED BY AUTHORIZED OFFICIAL PRIOR TO CONSTRUCTION AND/OR DESIGN.
- 9-) ELEVATION INFORMATION: (IF APPLICABLE): THESE ELEVATIONS WERE MEASURED USING SURVEY- GRADE GLOBAL POSITION SYSTEM EQUIPMENT, THAT UTILIZES THE F.D.O.T. PERMANENT REFERENCE NETWORK AS ITS HIGH ACCURACY REFERENCE NETWORK (H.A.R.N)

ELEVATION INFORMATION:

BASED ON THE FLOOD INSURANCE RATE MAP OF THE FEDERAL EMERGENCY MANAGEMENT AGENCY DATED OR
REVISED ON 08-18-14 THE HEREIN DESCRIBED PROPERTY IS SITUATED WITHIN ZONE AE
BASE FLOOD ELEVATION 5.0 COMMUNITY 125113 PANEL NUMBER 0588 SUFFIX H
ELEVATIONS(WHEN SHOWN) REFER TO N.A.V.D. 1988 DATUM,
COUNTY BENCHMARK USED #1915 ELEVATIONS 1.67' FEET B.M. LOCATION HWY A-1-A
SR 820

CERTIFIED TO:

BIDASK LADRILLO LLC


Professional Land Surveyors, Mapper
CERTIFICATE No.L.B. 8064
STATE OF FLORIDA
Main Line: (305) 901-1317
Fax: (305) 901-1323

BY: _____
LEONARDO MAQUEIRA, P.S.M
CERTIFICATE No.L.S.-6992
STATE OF FLORIDA


SURVEY DATE: 03-05-2024




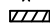
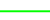


MAQ SERVICES, INC.
Professional Land Surveyors, Mapper
CERTIFICATE No.L.B. 8064
STATE OF FLORIDA
Main Line: (305) 901-1317
Fax: (305) 901-1323

PAGE 2 OF 2
NOT VALID WITHOUT PAGE 1 OF 2
JOB No. 24-03824L26
SCALE: 1" = 20'

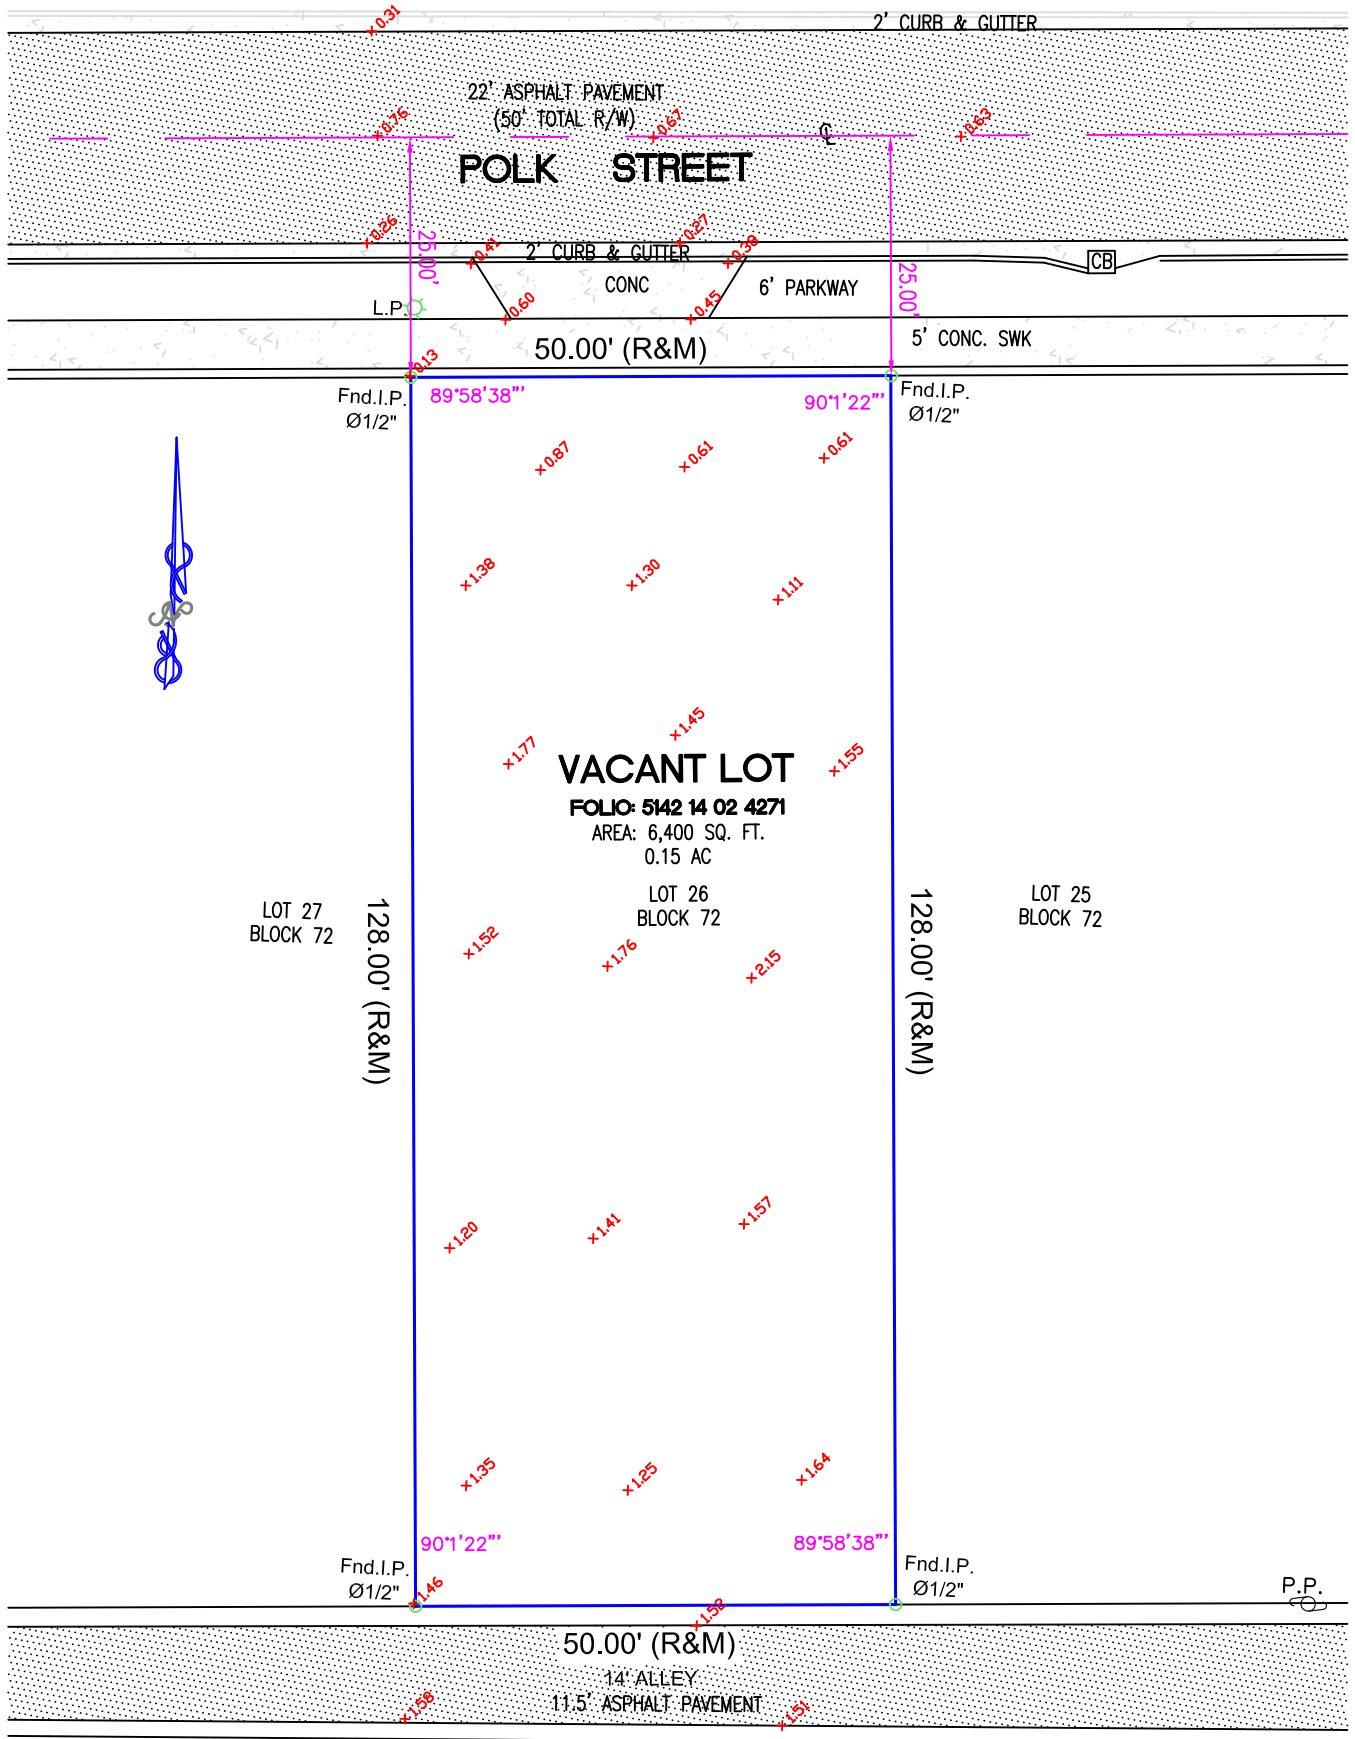BOUNDARY SURVEY



LEGEND AND ABBREVIATIONS

0.00 = ELEVATION	F.N. = FOUND NAIL	E.M. = ELECTRIC METER	 = CONCRETE FOUNDATION
DRWY. = DRIVEWAY	P.O.C. = POINT OF COMMON-CEMENT	P.I. = POINT OF INTERSECTION	Δ = CENTRAL ANGLE
U.P. = UTILITY POLE	F.D.H. = FOUND DRILL HOLE	P.R.C. = POINT OF REVERSE CURVE	-// = WOOD FENCE
B.O.B. = BASIS OF BEARINGS	P.T. = POINT OF TANGENCY	P.C. = POINT OF CURVATURE	-X- = CHAIN LINK FENCE
A/C = AIR CONDITIONING PAD	E.N.C. = ENCROACHMENT	F.N.D. = FOUND NAIL/DISK	 = C.B.S. WALL
A = ARC DISTANCE	F.H. = FIRE HYDRANT	P.C.C. = POINT OF COMPOUND CURVE	B/C = BLOCK CORNER
BLDG. = BUILDING	F.I.P. = FOUND IRON PIPE	M/L = MONUMENT LINE	R = RADIUS
C.B. = CATCH BASIN	F.I.R. = FOUND REBAR	N.G.V.D. = NATIONAL GEODETIC VERTICAL DATUM	RAD. = RADIAL
C.B.S. = CONCRETE BLOCK STRUCTURE	I.F.E. = LOWEST FLOOR ELEVATION	O.E. = OVERHEAD ELECTRIC LINE	RES. = RESIDENCE
CH. = CHORD DISTANCE	I.P. = LIGHT POLE	P.G. = PAGE	R/W = RIGHT OF WAY
CL. = CLEAR	(M) = MEASURED	P.O.B. = POINT OF BEGINNING	SEC. = SECTION
C/L = CENTER LINE	(R) = RECORD	P/L = PROPERTY LINE	S.I.P. = SET IRON PIPE
CONC. = CONCRETE	(R & M) = RECORD & MEASURED	N.T.S. = NOT TO SCALE	STY = STORY
			SWK = SIDEWALK
			UE. = UTILITY EASEMENT
			 = OVERHEAD ELECTRIC
			 = UTILITY CONC. POLE
			 = WATER METER

BELLE COAST GROUP, Inc.

2475 NE 135th Street, North Miami, FL 33181

Phone: (786) 218-3072 www.bellecoast.com

License #AR102136

CERTIFICATE OF APPROPRIATENESS FOR DESIGN

The applicant is proposing the construction of a new two-story single-family residence located at 834 Polk Street in the Single Family Residential District (RS-6).

According to information from the Broward County Property Appraiser, the subject property is a vacant lot and does not contain any existing structures.

The proposed design consists of a two-story modern subtropical residence totaling approximately 3,500 square feet of air-conditioned space, featuring layered horizontal planes, a landscaped courtyard, a pool and deck, and integrated outdoor living areas.

Vehicular access is provided from both the front street and the rear alleyway in compliance with design guidelines.

The proposed residence conforms to all current zoning, floodplain, and life-safety regulations, and is designed to promote architectural harmony within the Lakes Area District while introducing a refined subtropical modern aesthetic consistent with Belle Coast's design standards.

DECISIONS ON CERTIFICATES OF APPROPRIATENESS FOR DESIGN

A decision on an application for a Certificate of Appropriateness for Design for **new building construction** shall be based on evaluation of the compatibility of the physical alteration or improvement with and adherence to the **criteria for designation listed in Section 5.6.F** of the City of Hollywood Zoning and Land Development Regulations.

CONSISTENCY WITH THE COMPREHENSIVE PLAN

The proposed new residence supports the goals of the Comprehensive Plan by promoting **contextual residential development** consistent with the **Low Residential** land use designation.

The project enhances the architectural quality of the neighborhood and contributes to the continued **revitalization of the Lakes Area District** through compatible scale, material integrity, and environmental responsiveness.

CONSISTENCY WITH THE CITY-WIDE MASTER PLAN

The proposed project aligns with the City-wide Master Plan by encouraging **high-quality residential design, sustainability, and context-sensitive construction**.

The home's site orientation, fenestration, and landscape integration promote natural ventilation, daylighting, and a **pedestrian-friendly streetscape** consistent with the district's character.

CONSISTENCY WITH THE LAKES AREA MULTIPLE RESOURCE LISTING DISTRICT NEIGHBORHOOD PLAN

The design for 834 Polk Street supports the Lakes Area's mission to maintain its **eclectic yet cohesive architectural identity**.

The project introduces a **subtropical modern residence** that emphasizes **horizontal planes, screened terraces, and material honesty**—principles aligned with the neighborhood's contemporary evolution.

MANDATORY CRITERIA: INTEGRITY OF LOCATION, DESIGN, SETTING, MATERIALS, WORKMANSHIP, AND ASSOCIATION

Criteria: Integrity of Location

Analysis:

The integrity of the location remains intact as the lot is currently vacant. The proposed residence meets all zoning and flood elevation standards, ensuring compliance with the City of Hollywood's design and safety requirements.

The structure's siting and setbacks are proportionate to adjacent homes, maintaining the street rhythm and massing consistent with the surrounding context.

Finding: Consistent

Criteria: Design

Analysis:

The proposed design employs a refined subtropical modern vocabulary that features clean massing, light-filtering elements, recessed planes, and sculptural roof forms.

The home's design is compatible with other new modern residences within the Lakes District while maintaining its own distinct architectural expression through proportion, rhythm, and spatial composition.

The project's horizontal emphasis and material articulation enhance the architectural integrity of the block without imitating historical styles.

Finding: Consistent

Criteria: Setting**Analysis:**

The proposed home preserves the district's open front yard pattern and integrates lush subtropical landscaping.

The massing transitions with setback upper levels, shaded terraces, and cantilevered overhangs that soften the facade and mitigate verticality.

This composition reinforces the low-density residential character of the neighborhood while enhancing its architectural sophistication.

Finding: Consistent

Criteria: Materials**Analysis:**

Primary materials include smooth stucco, architectural concrete, and aluminum-framed window systems.

Secondary materials such as natural wood soffits, stone pavers, and permeable grass block driveways reinforce the subtropical design intent and meet sustainability objectives.

The proposed design incorporates 40% green space at grade level, with energy-efficient glazing, solar preparation, and low-impact landscape materials.

Finding: Consistent

Criteria: Workmanship**Analysis:**

Construction will be performed by licensed and insured contractors in accordance with the Florida Building Code and the City of Hollywood inspection standards.

The project's workmanship will meet or exceed the minimum quality requirements for residential construction, ensuring longevity, safety, and architectural fidelity.

Finding: Consistent

Criteria: Association

Analysis:

The proposed residence maintains an architectural relationship with the broader Lakes Area District through scale, massing, and material continuity.

The project's modern design language complements existing neighboring homes and contributes positively to the area's evolving architectural narrative.

The balanced horizontal rhythm, proportional facade, and tropical landscaping reinforce the district's distinctive coastal identity.

Finding: Consistent

CONCLUSION

The proposed new residence at 834 Polk Street satisfies all criteria for a Certificate of Appropriateness for Design under the City of Hollywood's Historic Preservation Ordinance.

The project demonstrates contextual compatibility, architectural integrity, and compliance with applicable zoning and design standards.

Recommendation: Approval of Certificate of Appropriateness for Design.

HOLLYWOOD RESIDENCE

834 POLK ST, HOLLYWOOD, FL 33019
FOLIO: 514214024271, HOLLYWOOD LAKES SECTION 1-32 B LOT 26 BLK 72



PROJECT TEAM

DESIGNER
BELLE COAST GROUP, Inc.
Yoann Andreu
1025 92nd St #701
Bay Harbor Islands, FL 33154
andreu@bellecteam.com
(786) 218-3072

ARCHITECT OF RECORD
Dennis Lytkine
lytkinedennis@gmail.com
16 Monroe St #J0D3
New York, NY 10002
(347) 830-5763
License #AR102136

CIVIL ENGINEER
Catarina Engineering, LLC
Enelise Michaels
6330 N Andrews Ave #271
Fort Lauderdale, FL 33309
emichaels@catarinaengineering.com
(561) 929-0876
License #84162

LANDSCAPE ARCHITECT
Flora Landscape Architecture, Inc.
Shaylin Castillo
11431 Northwest 21st Street
Pembroke Pines, FL 33026
ShayC@floraladesign.com
(786) 660-1097
License #LA6667593

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LOCATION MAP



AERIAL



BELLE COAST
LIFESTYLE PROPERTIES

THE DRAWINGS AND INFORMATION CONTAINED
HEREIN ARE THE PROPERTY OF BELLE COAST GROUP, INC.
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BELLE COAST GROUP, Inc.

1025 92nd St #701
Bay Harbor Islands, FL 33154
andreu@bellecteam.com
(786) 218-3072

PROJECT:

834 POLK ST
HOLLYWOOD, FL 33019

FOLIO NUMBER: 514214024271

DATE: 11/15/2024

REVISION

DATE:

DRAFTED BY:

SCALE:


CONSULTANTS:

COVER SHEET +
PROJECT
INFORMATION

T-1

DRAWN BY:

B.C.

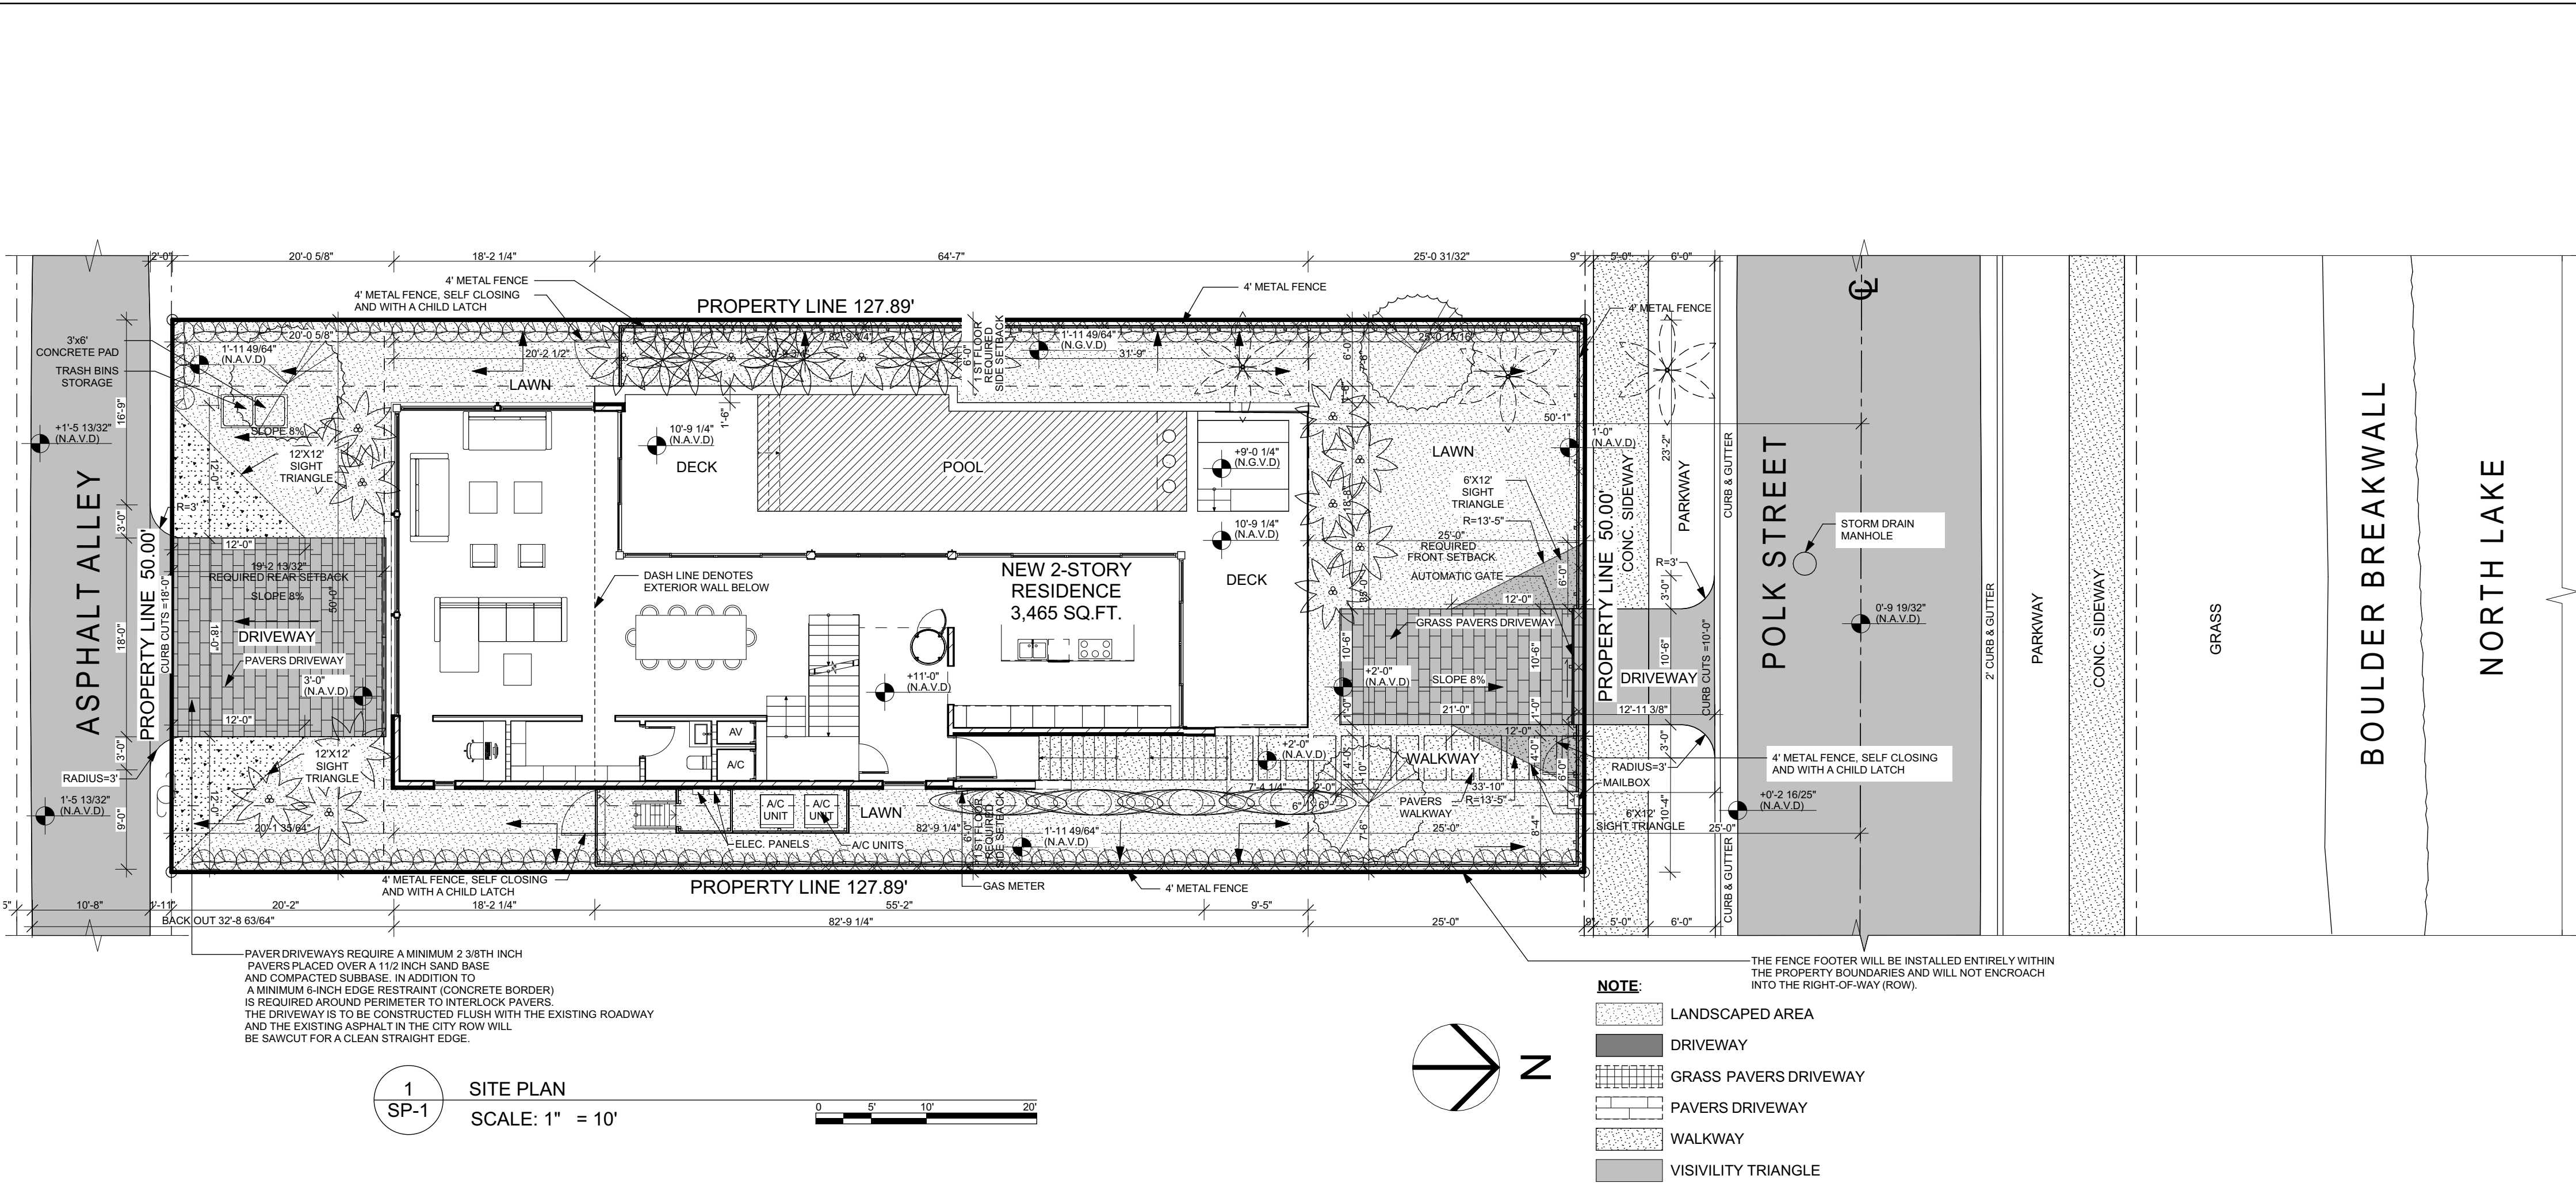

<div><div>GREEN BUILDING PRACTICES FROM CITY OF HOLLYWOOD ORDINANCE #0-2015-06</div><div><div>1. RADIANT BARRIER ROOF - SEALOFLEX COOL ROOF - REFLECTO WHITE. WALLS - AL-FOIL REFLECTIVE</div><div>2. WINDOWS AND GLAZING LOW E, TINTED DOUBLE GLAZING- U FACTOR 0.56, SHGC 0.25</div><div>3. DOORS INSULATED AND FIRE RATED</div><div>4. ENERGY STAR ROOFING SEALOFLEX COOL ROOF - REFLECTO WHITE.</div><div>5.PROGRAMMABLE THERMOSTATS</div><div>6. OCCUPANCY SENSORS</div><div>7. DUAL FLUSH TOILETS</div><div>8. 80% OF PLANT MATERIAL NATIVE</div><div>9. ENERGY EFFICIENT OUTDOOR LIGHTING</div><div>10. INSULATED PIPING</div><div>11. RECYCLING AREA</div><div>12. ENERGY STAR APPLIANCES</div><div>13. ONE LOW FLOW SHOWERHEAD</div><div>14. ENERGY EFFICIENT OUTDOOR LIGHTING</div><div>15. ENERY EFFICIENCY 10% BETTER THAN STANDARD ESTABLISHED BY ASHRAE.</div><div>16. MERV 8 AC FLITERS</div></div></div> <tr><td><div><div>SITE LIGHTING LEVELS SHALL NOT EXCEED 0.5 FC AT THE PROPERTY LINE ADJACENT TO RESIDENTIALLY ZONED OR RESIDENTIALLYUSED AREAS.</div></div></td></tr> <tr><td><div><div>SITE LIGHTING NOTE: SITE LIGHTING LEVELS SHALL NOT EXCEED 0.5 FC AT THE PROPERTY LINE ADJACENT TO RESIDENTIALLY ZONE OR RESIDENTIALLYUSED AREAS.</div></div></td></tr>	<div><div>SITE LIGHTING LEVELS SHALL NOT EXCEED 0.5 FC AT THE PROPERTY LINE ADJACENT TO RESIDENTIALLY ZONED OR RESIDENTIALLYUSED AREAS.</div></div>	<div><div>SITE LIGHTING NOTE: SITE LIGHTING LEVELS SHALL NOT EXCEED 0.5 FC AT THE PROPERTY LINE ADJACENT TO RESIDENTIALLY ZONE OR RESIDENTIALLYUSED AREAS.</div></div>
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<div><div>PER NFPA 1, 12.3.2* A QUALITY ASSURANCE PROGRAM FOR THE INSTALLATION OF DEVICES AND SYSTEMS INSTALLED TO PROTECT PENETRATION AND JOINTS SHALL BE PREPARED AND MONITORED BY THE REGISTERED DESIGN PROFESSIONAL RESPONSIBLE FOR DESIGN. INSPECTIONS OF FIRE STOP SYSTEMS AND FIRE-RESISTIVE JOINT SYSTEMS SHALL BE IN ACCORDANCE WITH 12.3.2.1 AND 12.3.2.1.</div></div>
<div><div>NFPA 1(2015 EDITOR) CHAPTER 11.10 REQUIERS THAT MINIMUM RADIO SIGNAL STRENGTH FROM FIRE DEPARTMENT COMMUNICATIONS BE MAINTANED ATA LEVEL DETERMINED BY THE AHJ FROM ALL NEW AND EXISTING BUILDINGS INCLUDING COMPLYNG WITH NFPA T2 (2013 EDITOR) BDA SYSTEM MAY BE REQUIERED</div></div>
<div><div>A PRE-HEAT MAP PLAN, CONCEPTUAL DRAWINGS AND CUT SHEETS WILL BE REQUIRED TO BE SUBMITTED WITH THE MAIN SET OF ARCHITECTURAL DRAWINGS FOR THE BDA SYSTEM</div></div>
<div><div>ALL CHANGES TO THE DESIGN WILL REQUIRE PLANING REVIEW AND MAY BE SUBJECT TO BOARD APPROVAL.</div></div>
<div><div>FEMA NOTE: THE NATIONAL FLOOD INSURANCE PROGRAM IS IN THE PROCESS OF ISSUING NEW FLOOD MAPS. AT TIME OF BUILDING PERMIT THE FEMA BASE FLOOD ELEVATION SHOULD BE CHECKED TO ENSURE IT IS STILL COMPLIANT.</div></div>
<div><div>ALL MECHANICAL EQUIPMENT SHALL BE SCREENED FROM PUBLIC VIEW.</div></div>

<div><div>NOTE: BUILDING TO COMPLY WITH CHAPTER 108 REGARDING ALL MARINE TURTLE PROTECTION</div></div>
<div><div>ALL SIGNAGE TO COMPLY WITH THE REQUIREMENTS OF THE CITY OF HOLLYWOOD ZONING AND LAND DEVELOPMENT CODE BASED ON THE MC-1 ZONING DISTRICT. SEPARATE PERMIT ARE REQUIRED FOR EACH SIGN. ALL SIGNS, WHICH ARE ELECTRICALLY ILLUMINATED, SHALL REQUIRE A SEPARATE ELECTRICAL PERMIT AND INSPECTION.</div></div>
<div><div>NOTE: PRIOR TO POURING THE FIRST FLOOR TIE BEAM A SPOT SURVEY OF THE FINISHED FLOOR ELEVATION MUST BE SUBMITTED TO THE BUILDING DEPT.</div></div>
<div><div>FEMA NOTE: THE NATIONAL FLOOD INSURANCE PROGRAM IS IN THE PROCESS OF ISSUING NEW FLOOD MAPS . AT TIME OF BUILDING PERMIT THE FEMA BASE FLOOD ELEVATION SHOULD BE CHECKED TO ENSURE IT IS STILL COMPLIANT.</div></div>
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<div><div>TWO WAY RADIO COMPLIANCE: BUILDING WILL BE IN COMPLIANCE WITH N.F.P.A. 1, 11.10 AND BROWARD COUNTY CODE AMENDMENT 118.2 FOR TWO WAY RADIO COMMUNICATION.</div></div>
<div><div>NOTE: TRASH AND RECYCLE BIN TO BE INDIVIDUAL PER UNIT</div></div>
<div><div>ALL SIGNAGE TO COMPLY WITH THE REQUIREMENTS OF THE CITY OF HOLLYOOD ZONING AND LAND DEVELOPMENT CODE BASED ON THE HOLLYWOOD LAKES SECTION 1-32 B LOT 12.13 BLK 74 RS-6 ZONING DISTRICT</div></div>

<div><div>PROPERTY ADDRESS</div><div>834 POLK STREET HOLLYWOOD, FL 33019</div><div>FOLIO # 514214024271</div><div>LEGAL DESCRIPTION HOLLYWOOD LAKES SECTION 1-32 B LOT 26 BLK 72</div></div>		
<div><div>SITE INFORMATION</div></div>	<div><div>EXISTING</div></div>	<div><div>PROPOSED</div></div>
<div><div>ZONING SUB-DISTRICT BUILDING USE</div></div>	<div><div>RS-6 N/A VACANT LOT</div></div>	<div><div>RS-6 N/A SINGLE FAMILY HOME</div></div>
<div><div>LAND USE DESIGNATION COUNTY USE DESIGNATION</div></div>	<div><div>RESIDENTIAL RESIDENTIAL</div></div>	<div><div>RESIDENTIAL RESIDENTIAL</div></div>
<div><div>NET LOT AREA</div></div>	<div><div>6,395 SQFT- 0.146 ACRES 6,395 SQFT- 0.146 ACRES</div></div>	<div><div>6,395 SQFT- 0.146 ACRES 6,395 SQFT- 0.146 ACRES</div></div>
<div><div>BASE FLOOD ZONE</div></div>	<div><div>AE - 8'-0" NAVD</div></div>	
<div><div>BUILDING INTENSITY</div></div>	<div><div>ALLOWED</div></div>	<div><div>PROVIDED</div></div>
<div><div>FAR A/C AREA BUILDING FOOTPRINT PROPOSED DWELLING NUMBER OF FLOORS BUILDING HEIGHT</div></div>	<div><div>N/A 1000 SF N/A 1 2 30'-0"</div></div>	<div><div>N/A 3465.65 SF 2912.00 SF 1 2 26'-2 1/2"</div></div>
<div><div>PARKING CALCULATION</div></div>	<div><div>REQUIRED</div></div>	<div><div>PROVIDED</div></div>
<div><div>PARKING SPACE</div></div>	<div><div>5</div></div>	<div><div>5</div></div>
<div><div>SETBACKS:</div></div>	<div><div>REQUIRED</div></div>	<div><div>PROVIDED</div></div>
<div><div>FRONT (NORTH) REAR (SOUTH) EAST SIDE 1ST FLOOR EAST SIDE 2ND FLOOR WEST SIDE 1ST FLOOR WEST SIDE 2ND FLOOR</div></div>	<div><div>25'-0" 19.17' 6'-0" 7'-6" 6'-0" 7'-6"</div></div>	<div><div>25'-0" 19.17' 7'-6" 7'-6" 6'-0" 7'-6"</div></div>
<div><div>LANDSCAPE</div></div>	<div><div>REQUIRED</div></div>	<div><div>PROVIDED</div></div>
<div><div>IMPERVIOUS AREA BUILDING FOOTPRINT, WALKWAYS & DRIVEWAYS PERVIOUS AREA LANDSCAPE AREAS FRONT LANDSCAPE AREA</div></div>	<div><div>N/A 2238.25 SF (40%) 250.00 SF (20%)</div></div>	<div><div>3584.08 SF (56.04%) 3426.00 SF (53.57%) 923.00 SF (73.84%)</div></div>
<div><div>BUILDING AREA</div></div>	<div><div>REQUIRED</div></div>	<div><div>PROVIDED</div></div>
<div><div>FIRST FLOOR (A/C AREA) SECOND FLOOR (A/C AREA) TOTAL (A/C AREA)</div></div>	<div><div>N/A N/A</div></div>	<div><div>1,578.87 SF 1,923.12 SF 3501.99 SF</div></div>

BELLE COAST
LIFESTYLE PROPERTIES

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1025 92nd St #701
Bay Harbor Islands, FL 33154
andreu@bellectoast.com
(786) 218-3072

PROJECT:
834 POLK ST
HOLLYWOOD, FL 33019

FOLIO NUMBER: 514214024271

DATE: 11/15/2024

REVISION

DATE:
DRAFTED BY:
SCALE:

CONSULTANTS:

SITE PLAN AND SITE
DATA

SP-1

DRAWN BY: B.C.



1 826 S NORTH LAKE DR, HOLLYWOOD, FL 33019
NTS



3 830 S NORTH LAKE DR, HOLLYWOOD, FL 33019
NTS



5 820 S NORTH LAKE DR, HOLLYWOOD, FL 33019
NTS



7 816 S NORTH LAKE DR, HOLLYWOOD, FL 33019
NTS



2 828 S NORTH LAKE DR, HOLLYWOOD, FL 33019
NTS




4 822 S NORTH LAKE DR, HOLLYWOOD, FL 33019
NTS



6 818 S NORTH LAKE DR, HOLLYWOOD, FL 33019
NTS



8 814 S NORTH LAKE DR, HOLLYWOOD, FL 33019
NTS

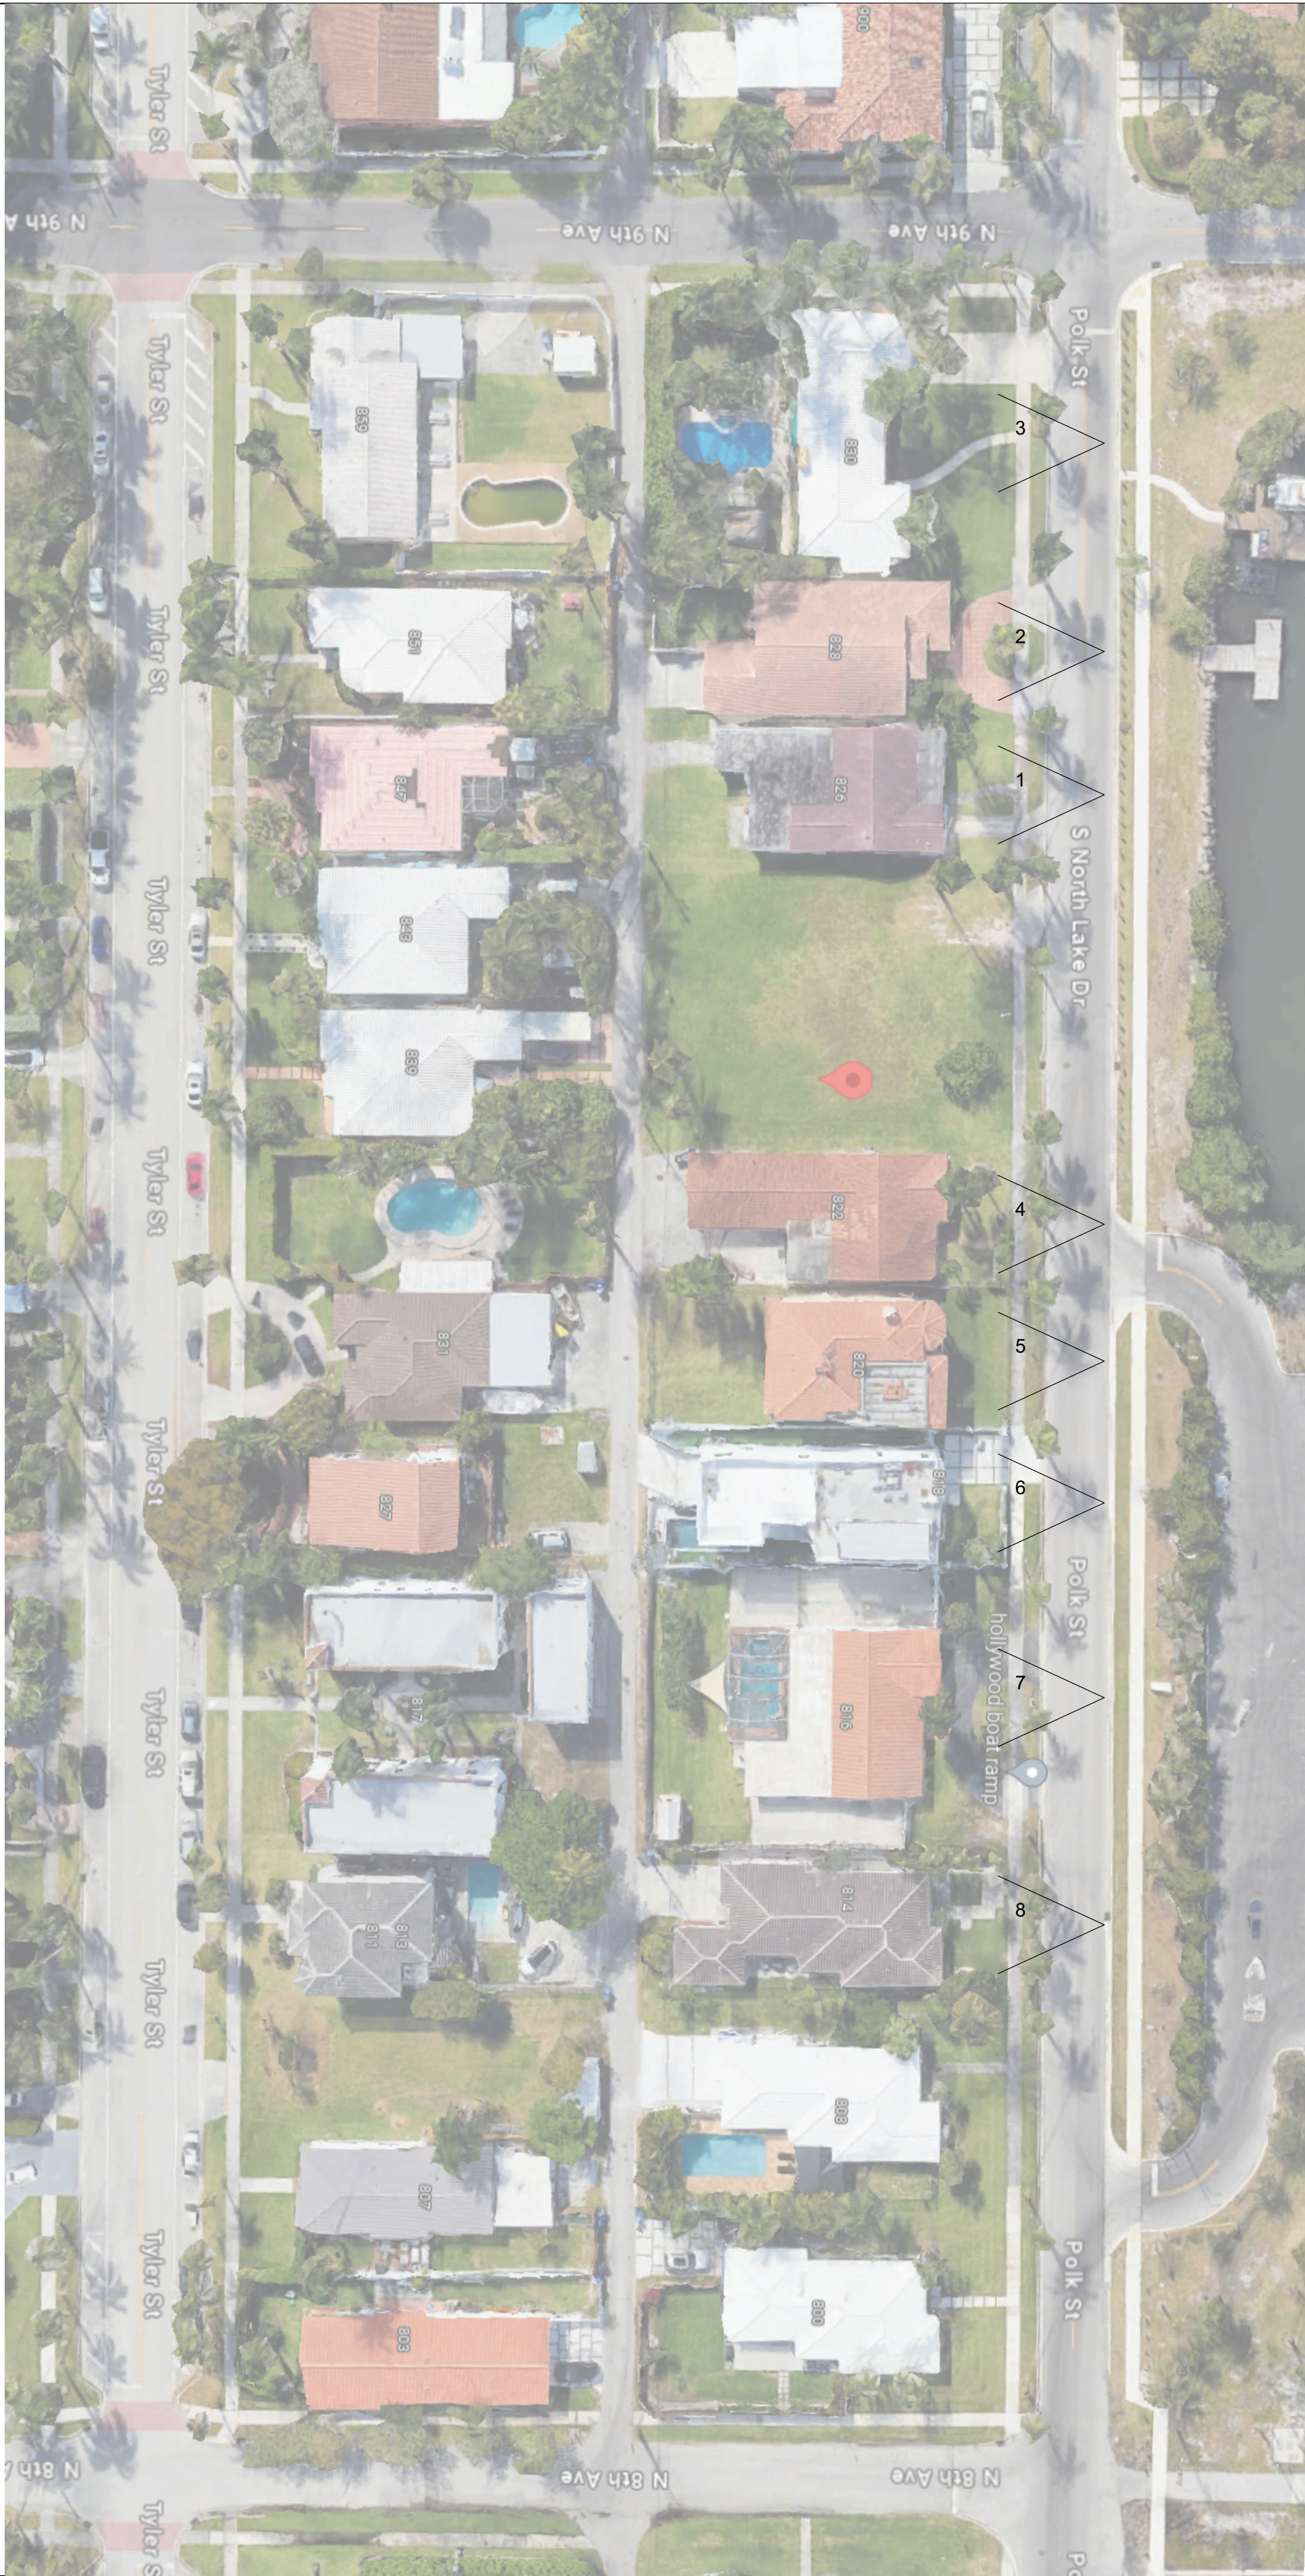

BELLE COAST
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REVISION	

DATE:
DRAFTED BY:
SCALE:

CONSULTANTS:

NEIGHBORS
PHOTOGRAPHY


SP-2

DRAWN BY: B.C.



1 SOUTH-EAST - RENDER

2 SOUTH-WEST - RENDER

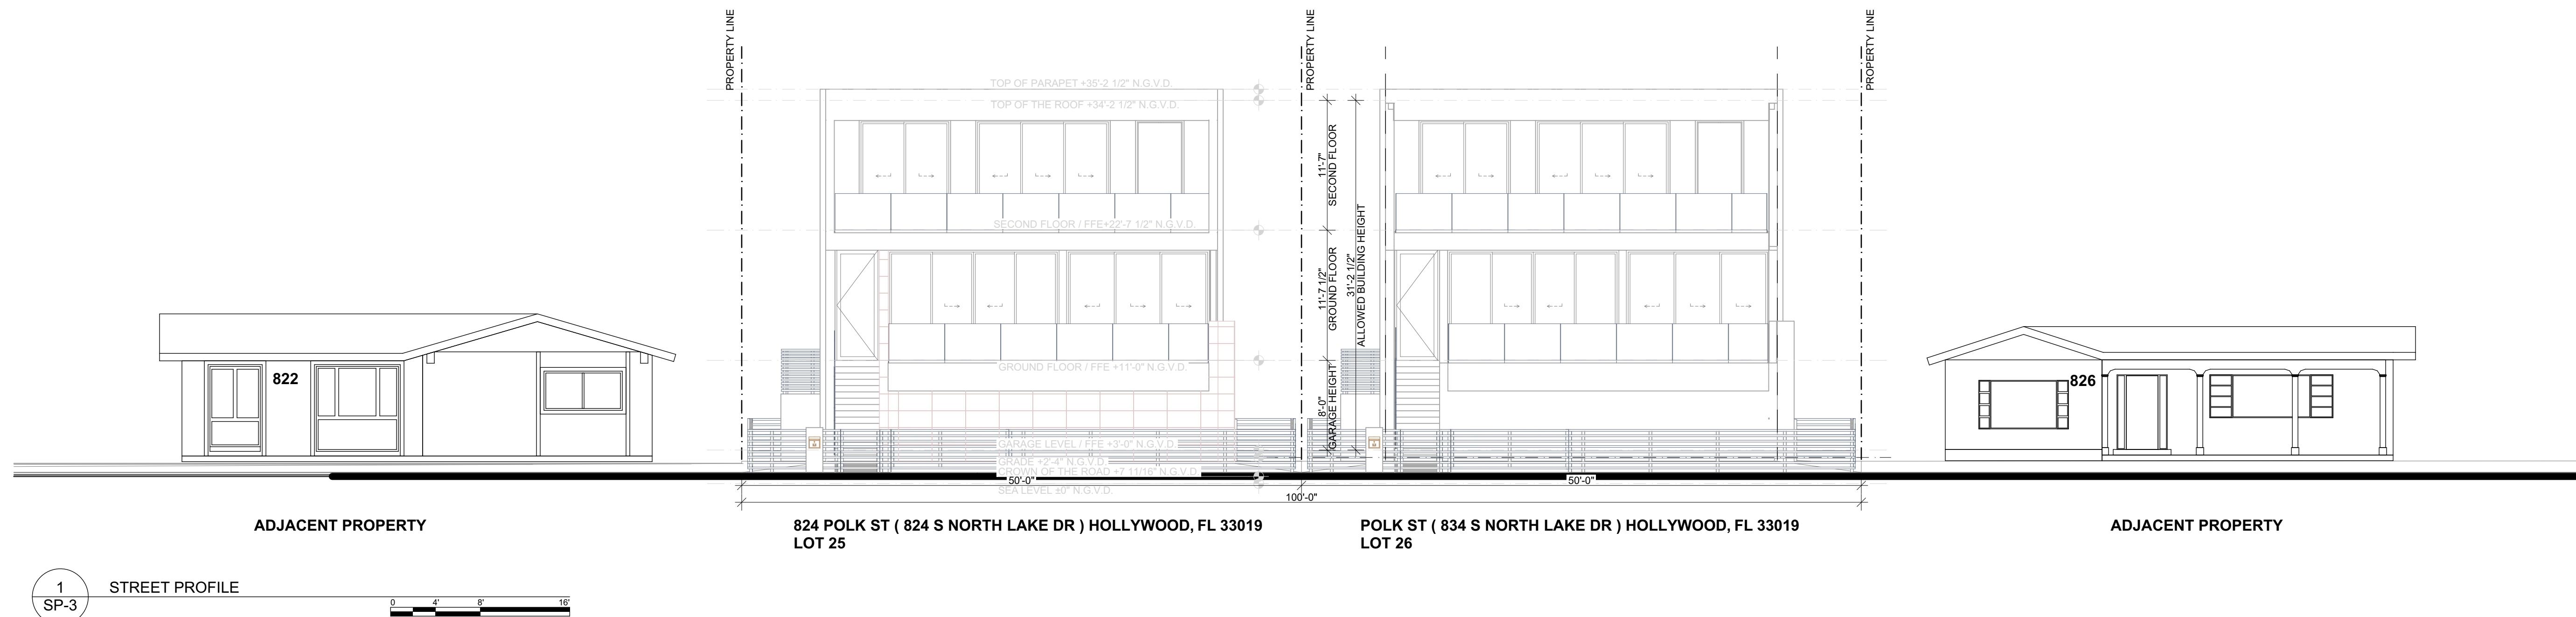

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REVISION	

DATE:
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SCALE:

CONSULTANTS:

STREET VIEW

SP-3.1

DRAWN BY: B.C.



822 POLK STREET

824 POLK STREET

834 POLK STREET

826 POLK STREET

STREET VIEW ALONG POLK STREET



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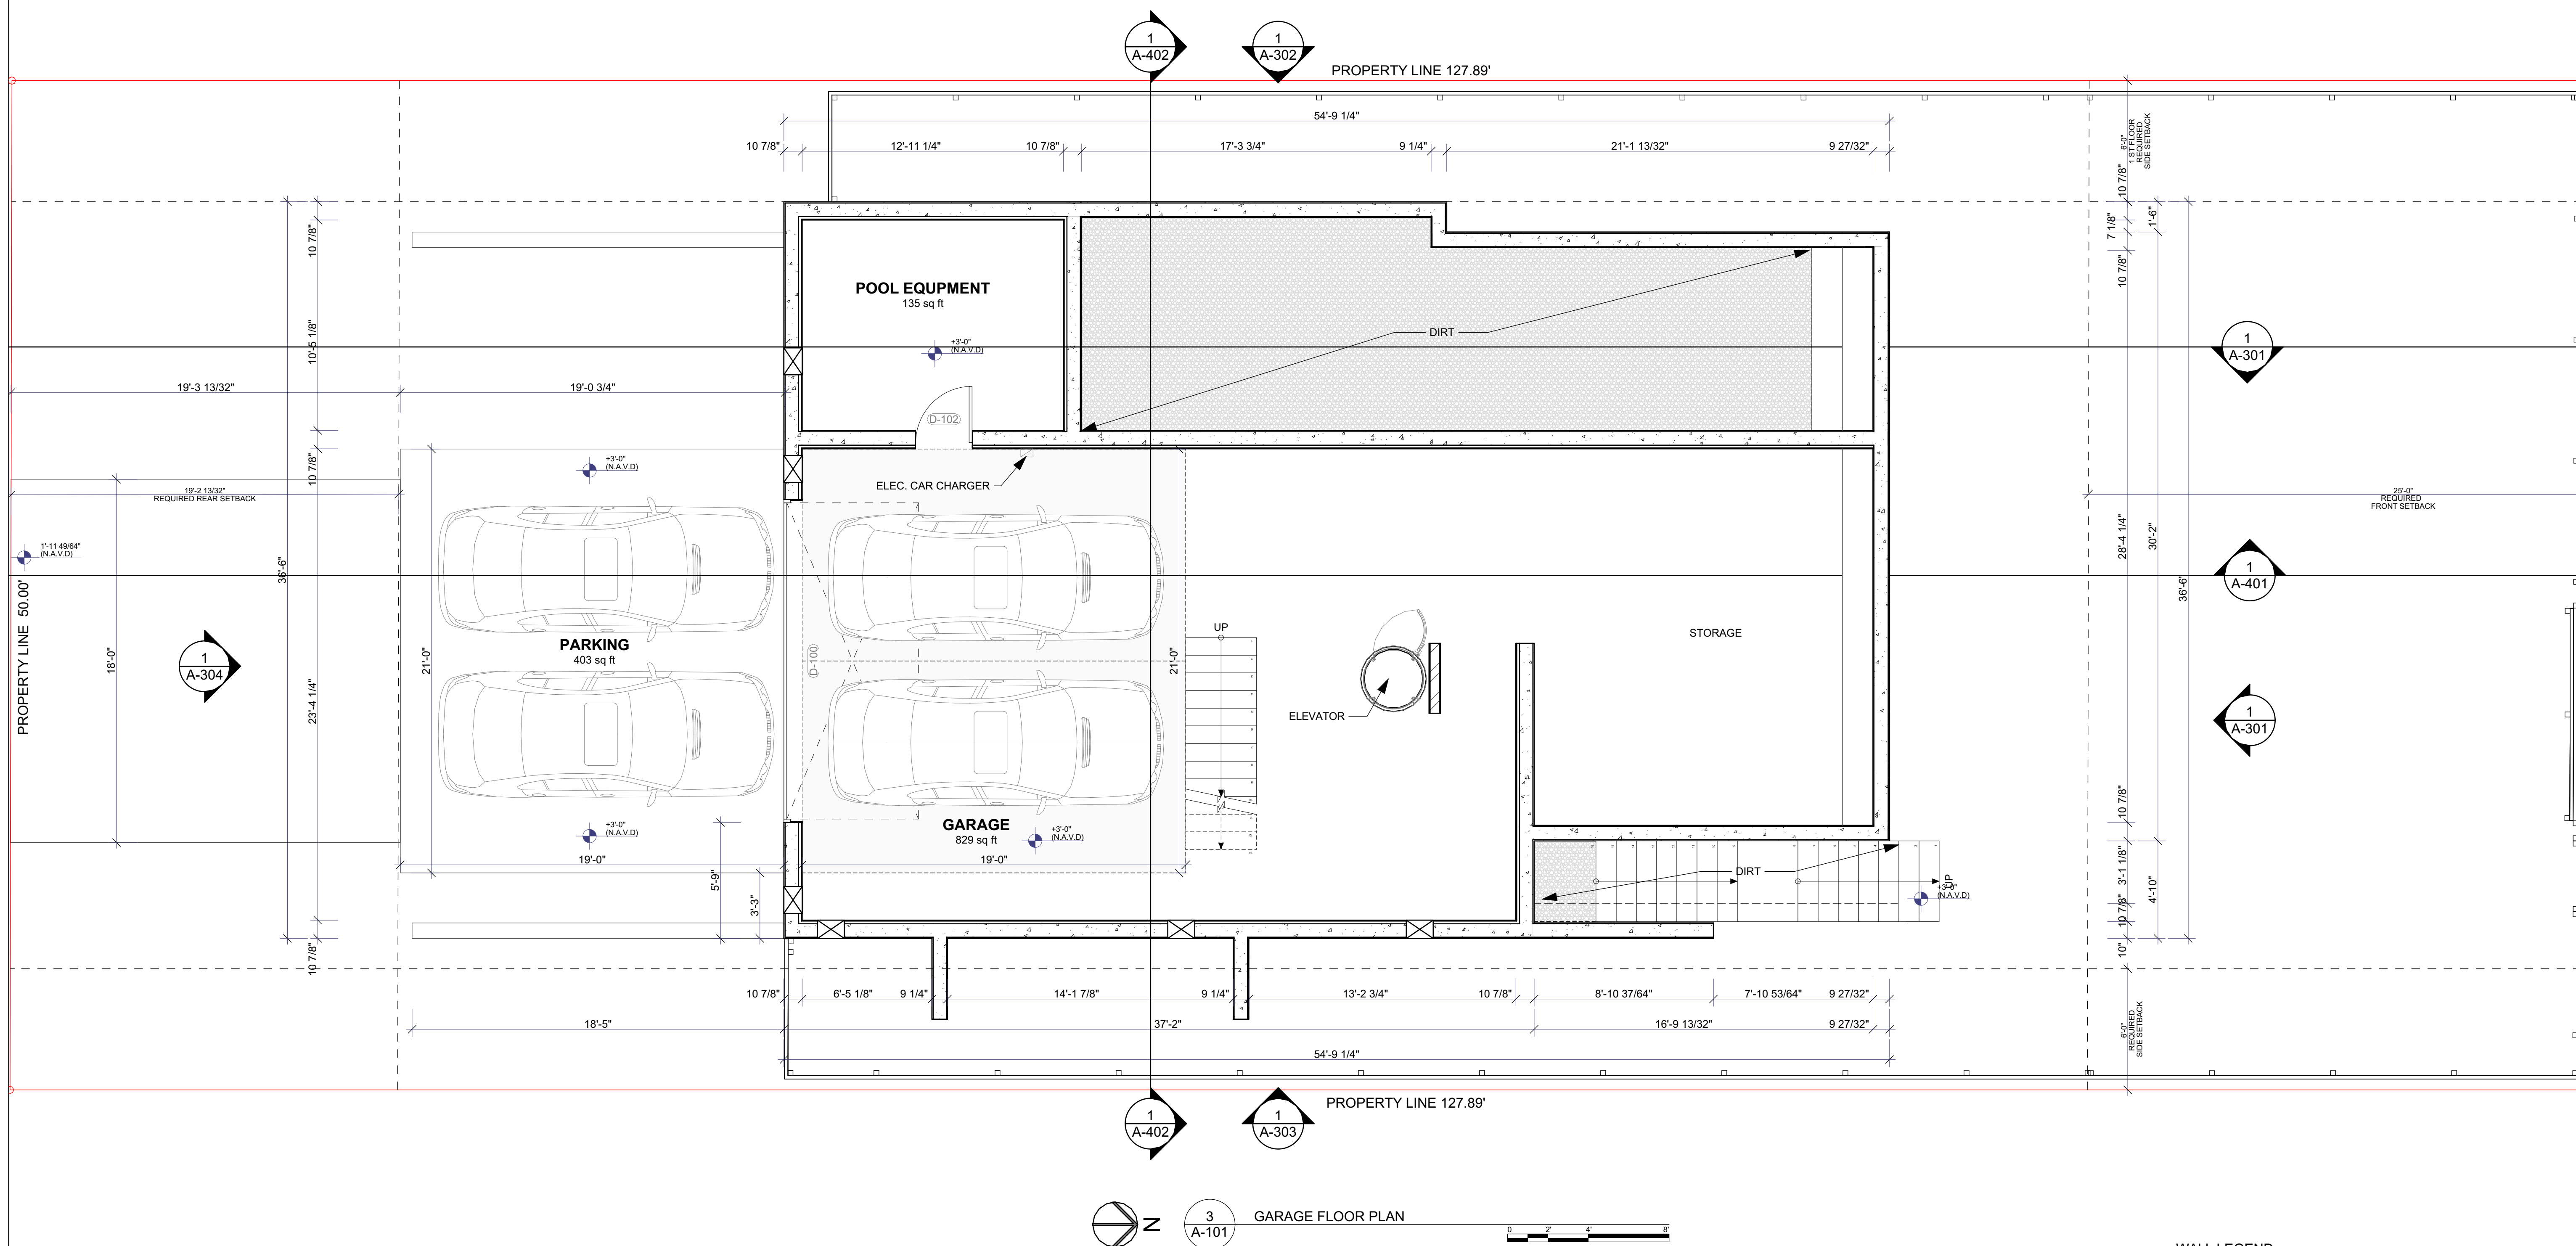
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CONSULTANTS:






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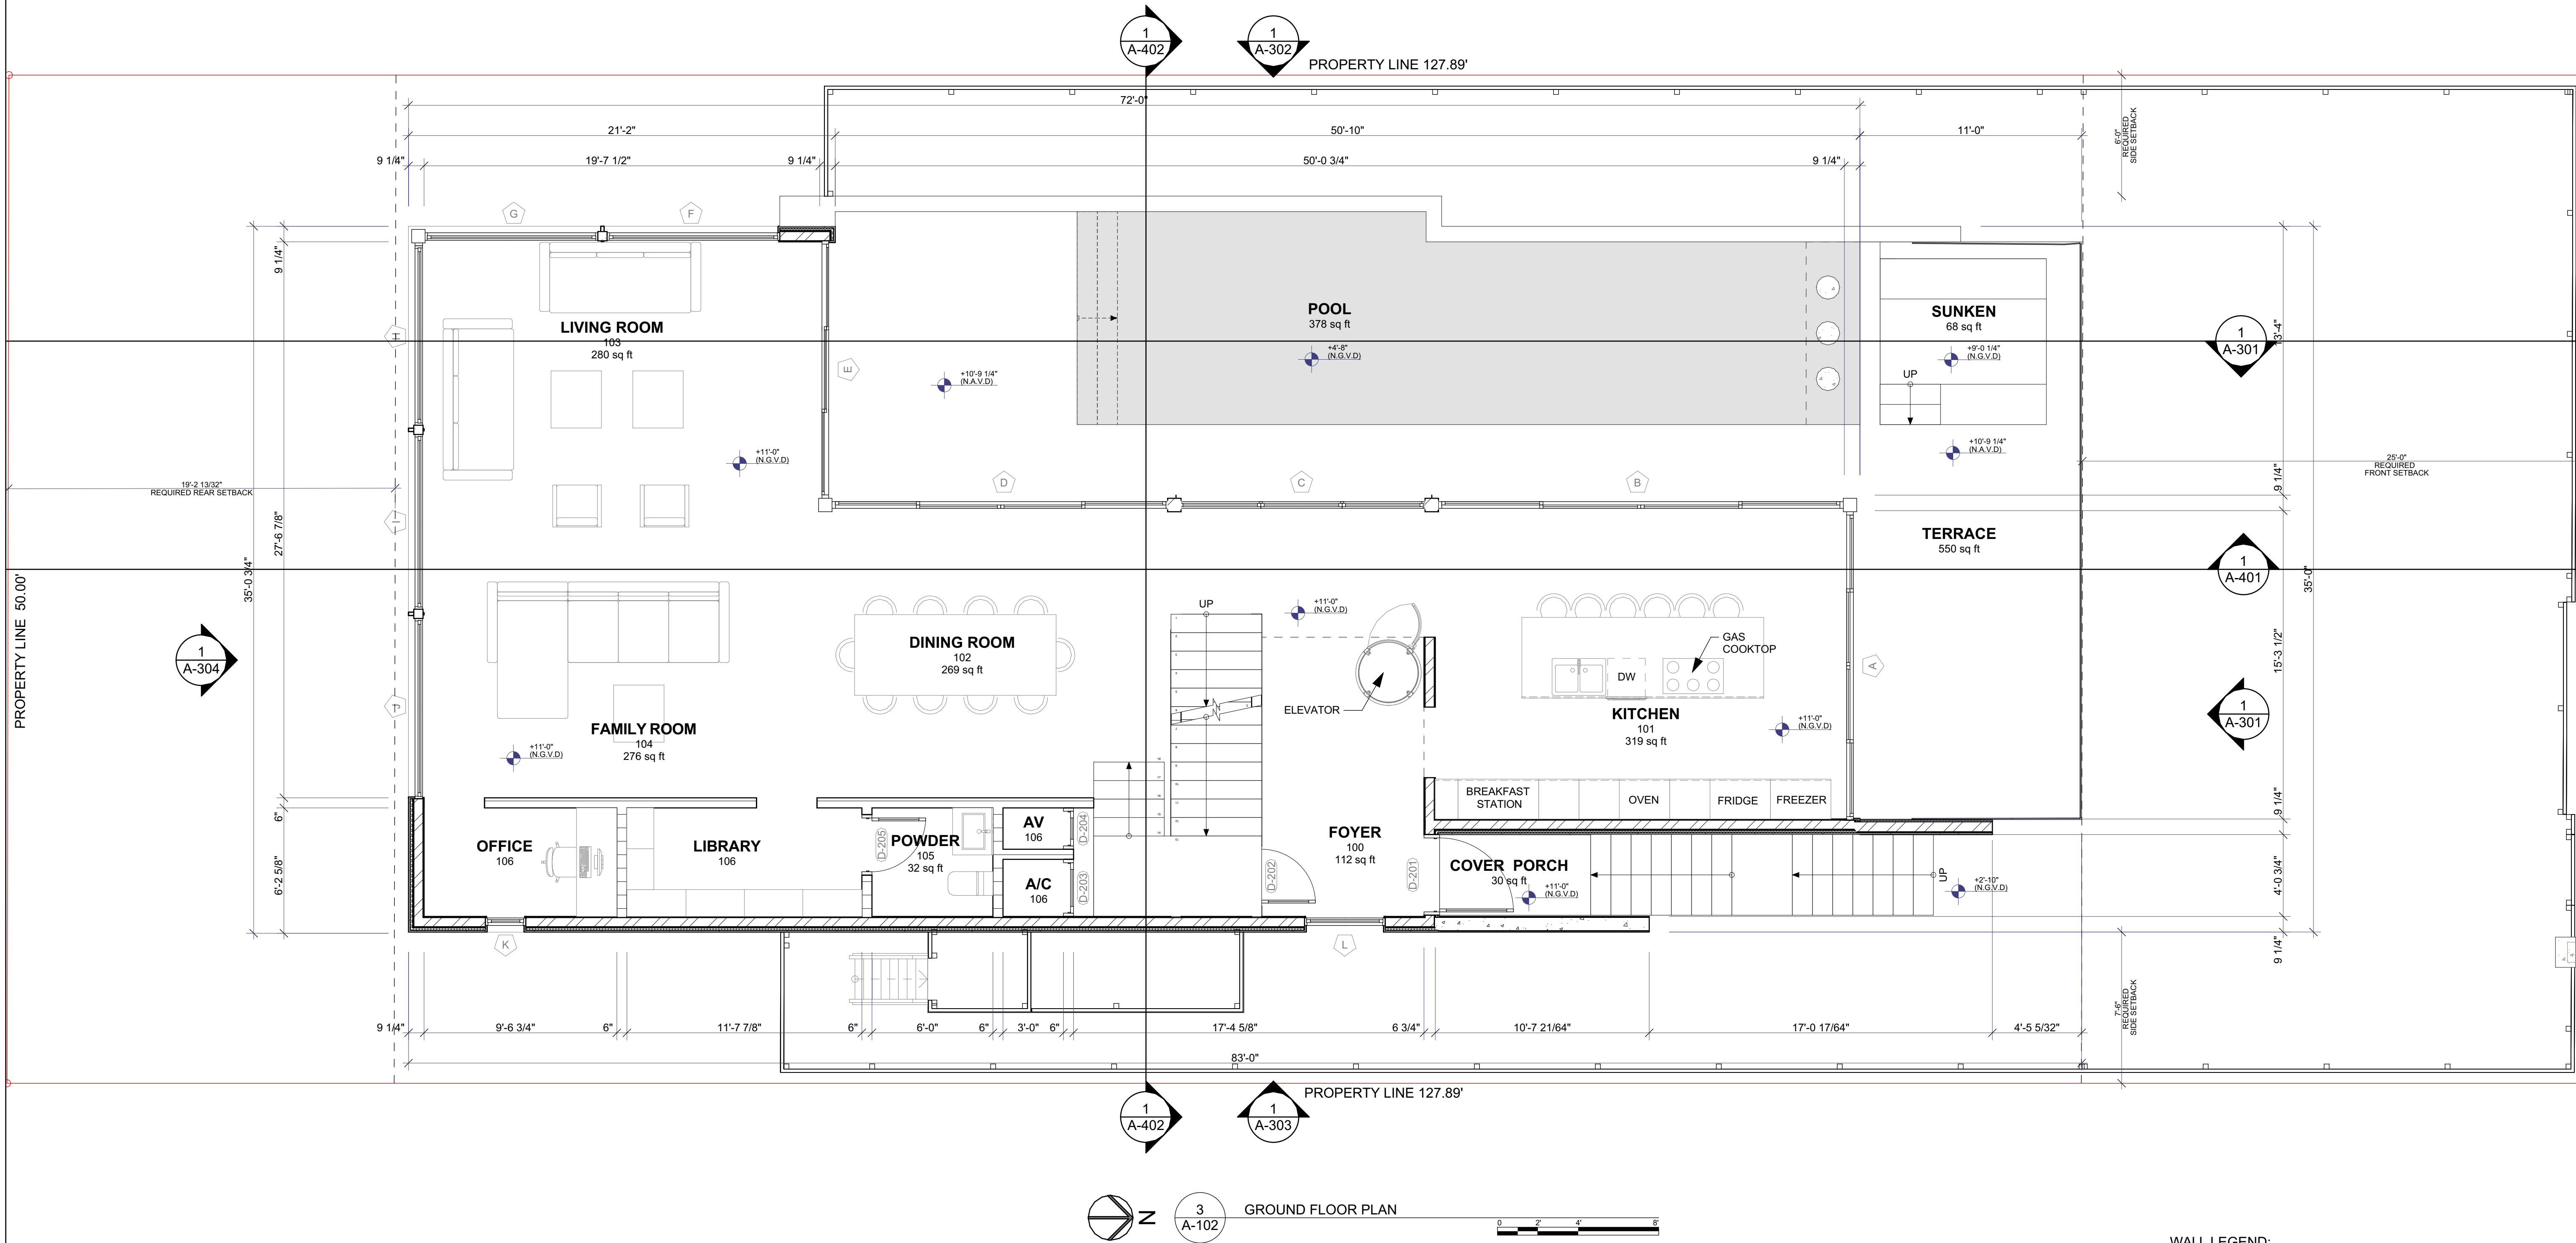
SP-4

DRAWN BY: B.C.



WALL LEGEND:

-  - EXTERIOR WALL
-  - INTERIOR WALL
-  - RETAINING WALL
-  - INTERIOR WALL
-  - STRUCTURAL WALL



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DATE: 11/15/2024

REVISION

DATE:

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SCALE:


CONSULTANTS:

SECOND FLOOR
PLAN

A-103

DRAWN BY:

B.C.

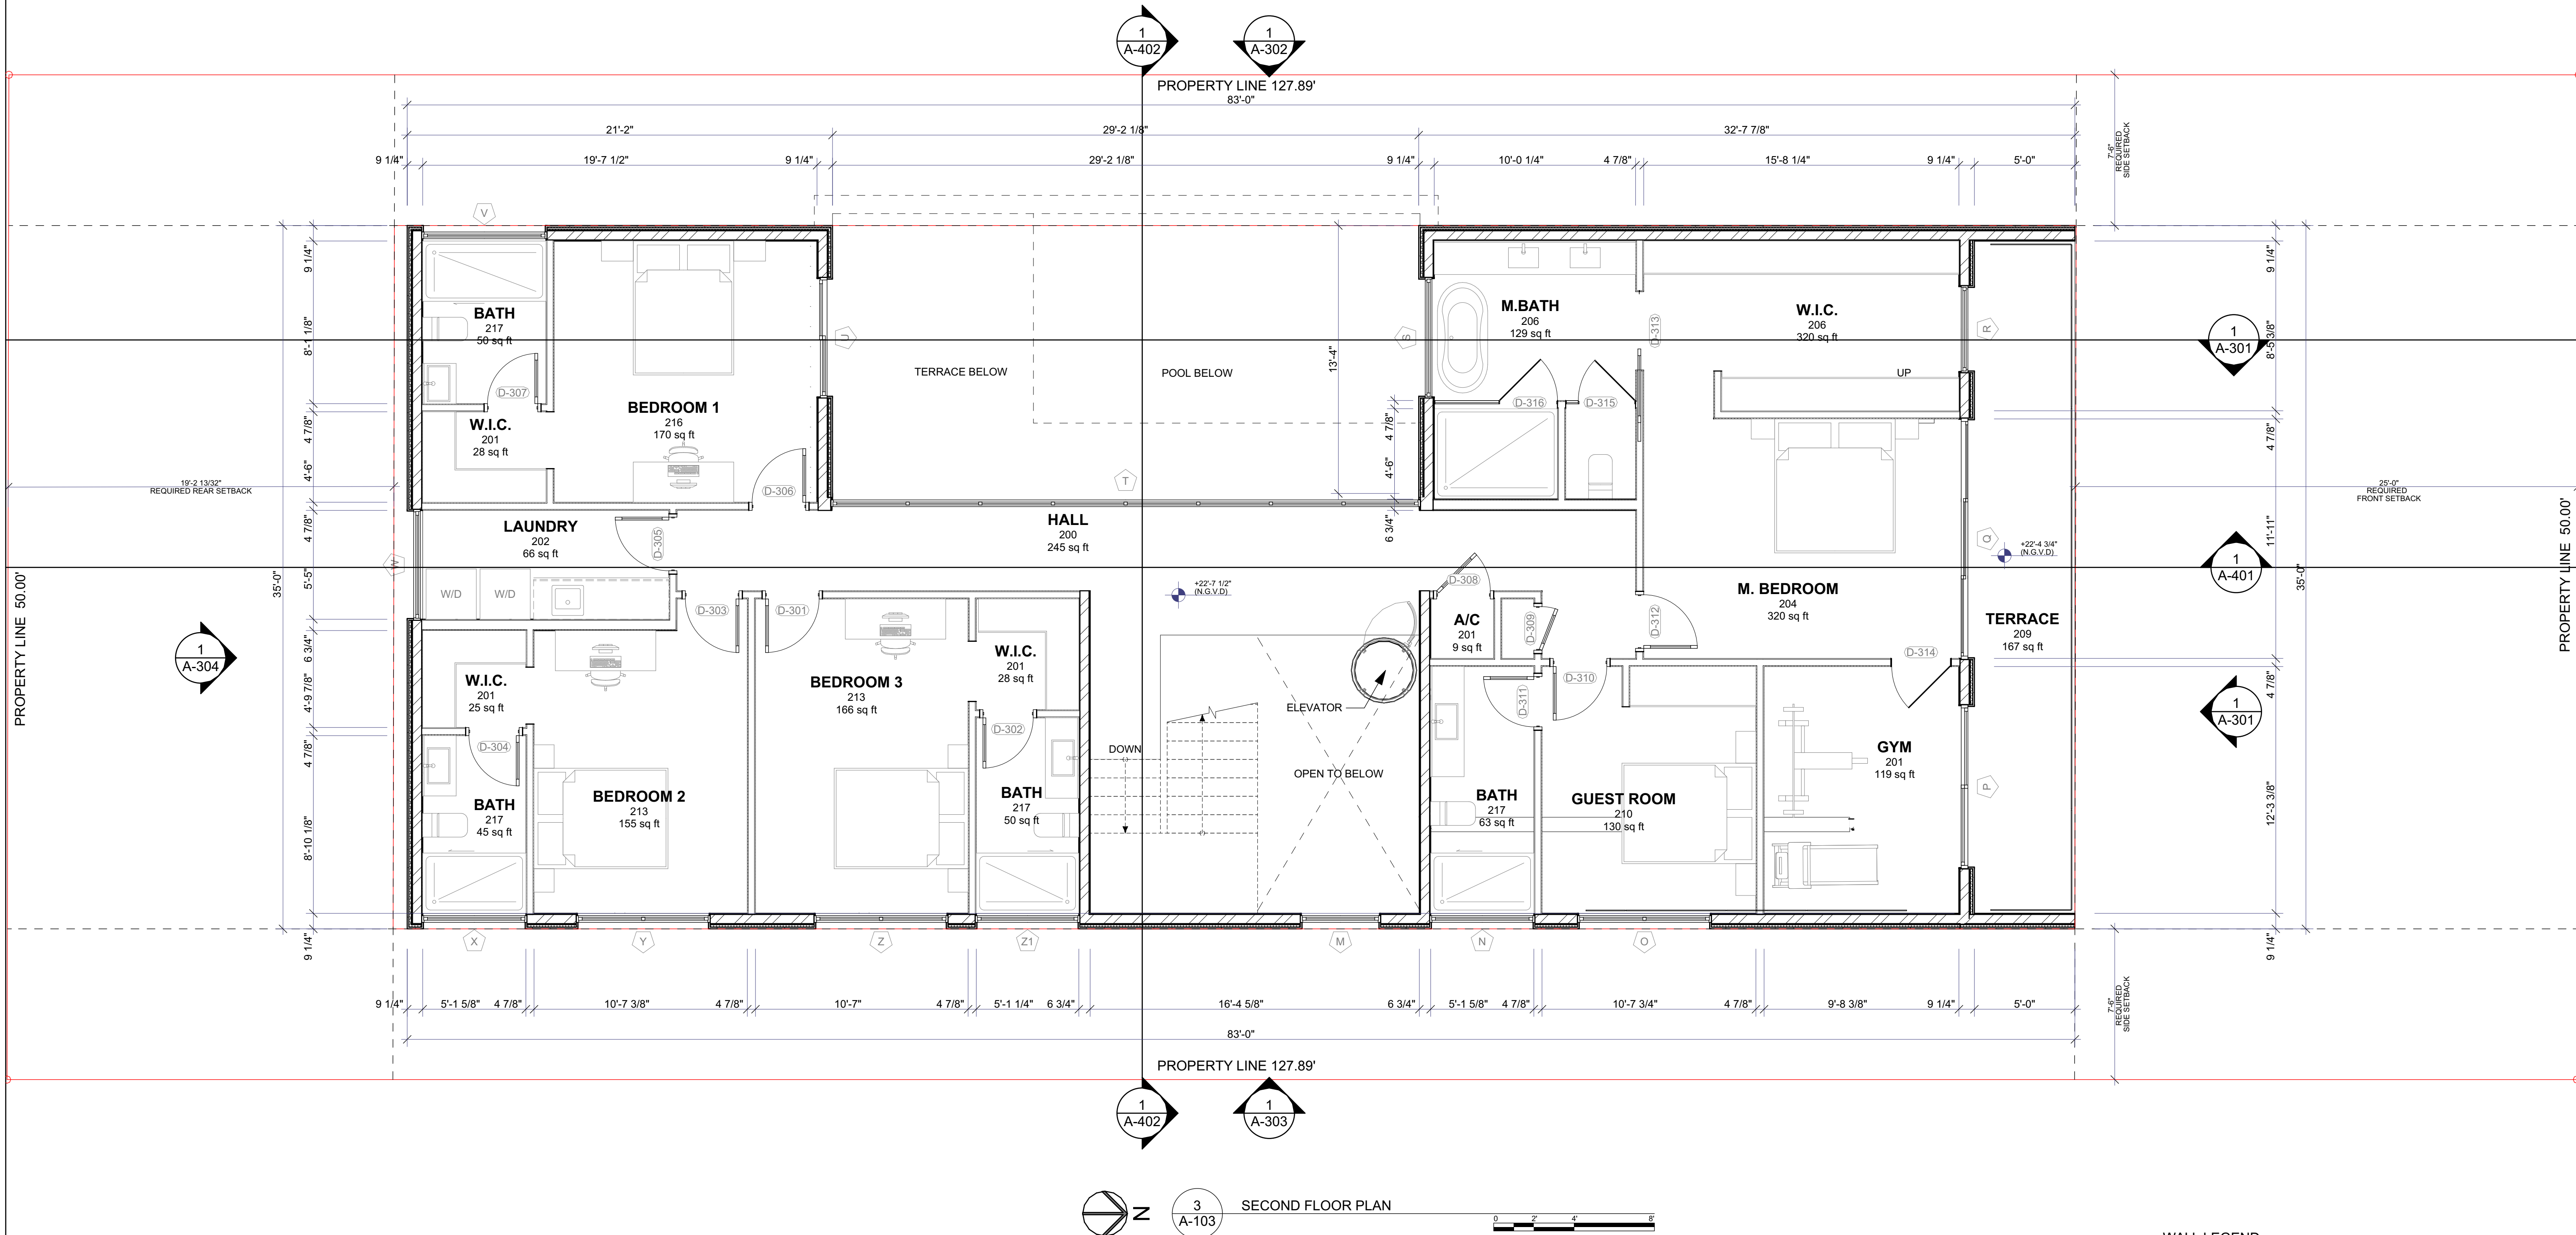

WALL LEGEND:

- EXTERIOR WALL
- INTERIOR WALL
- RETAINING WALL
- INTERIOR WALL
- STRUCTURAL WALL

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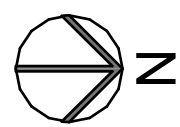
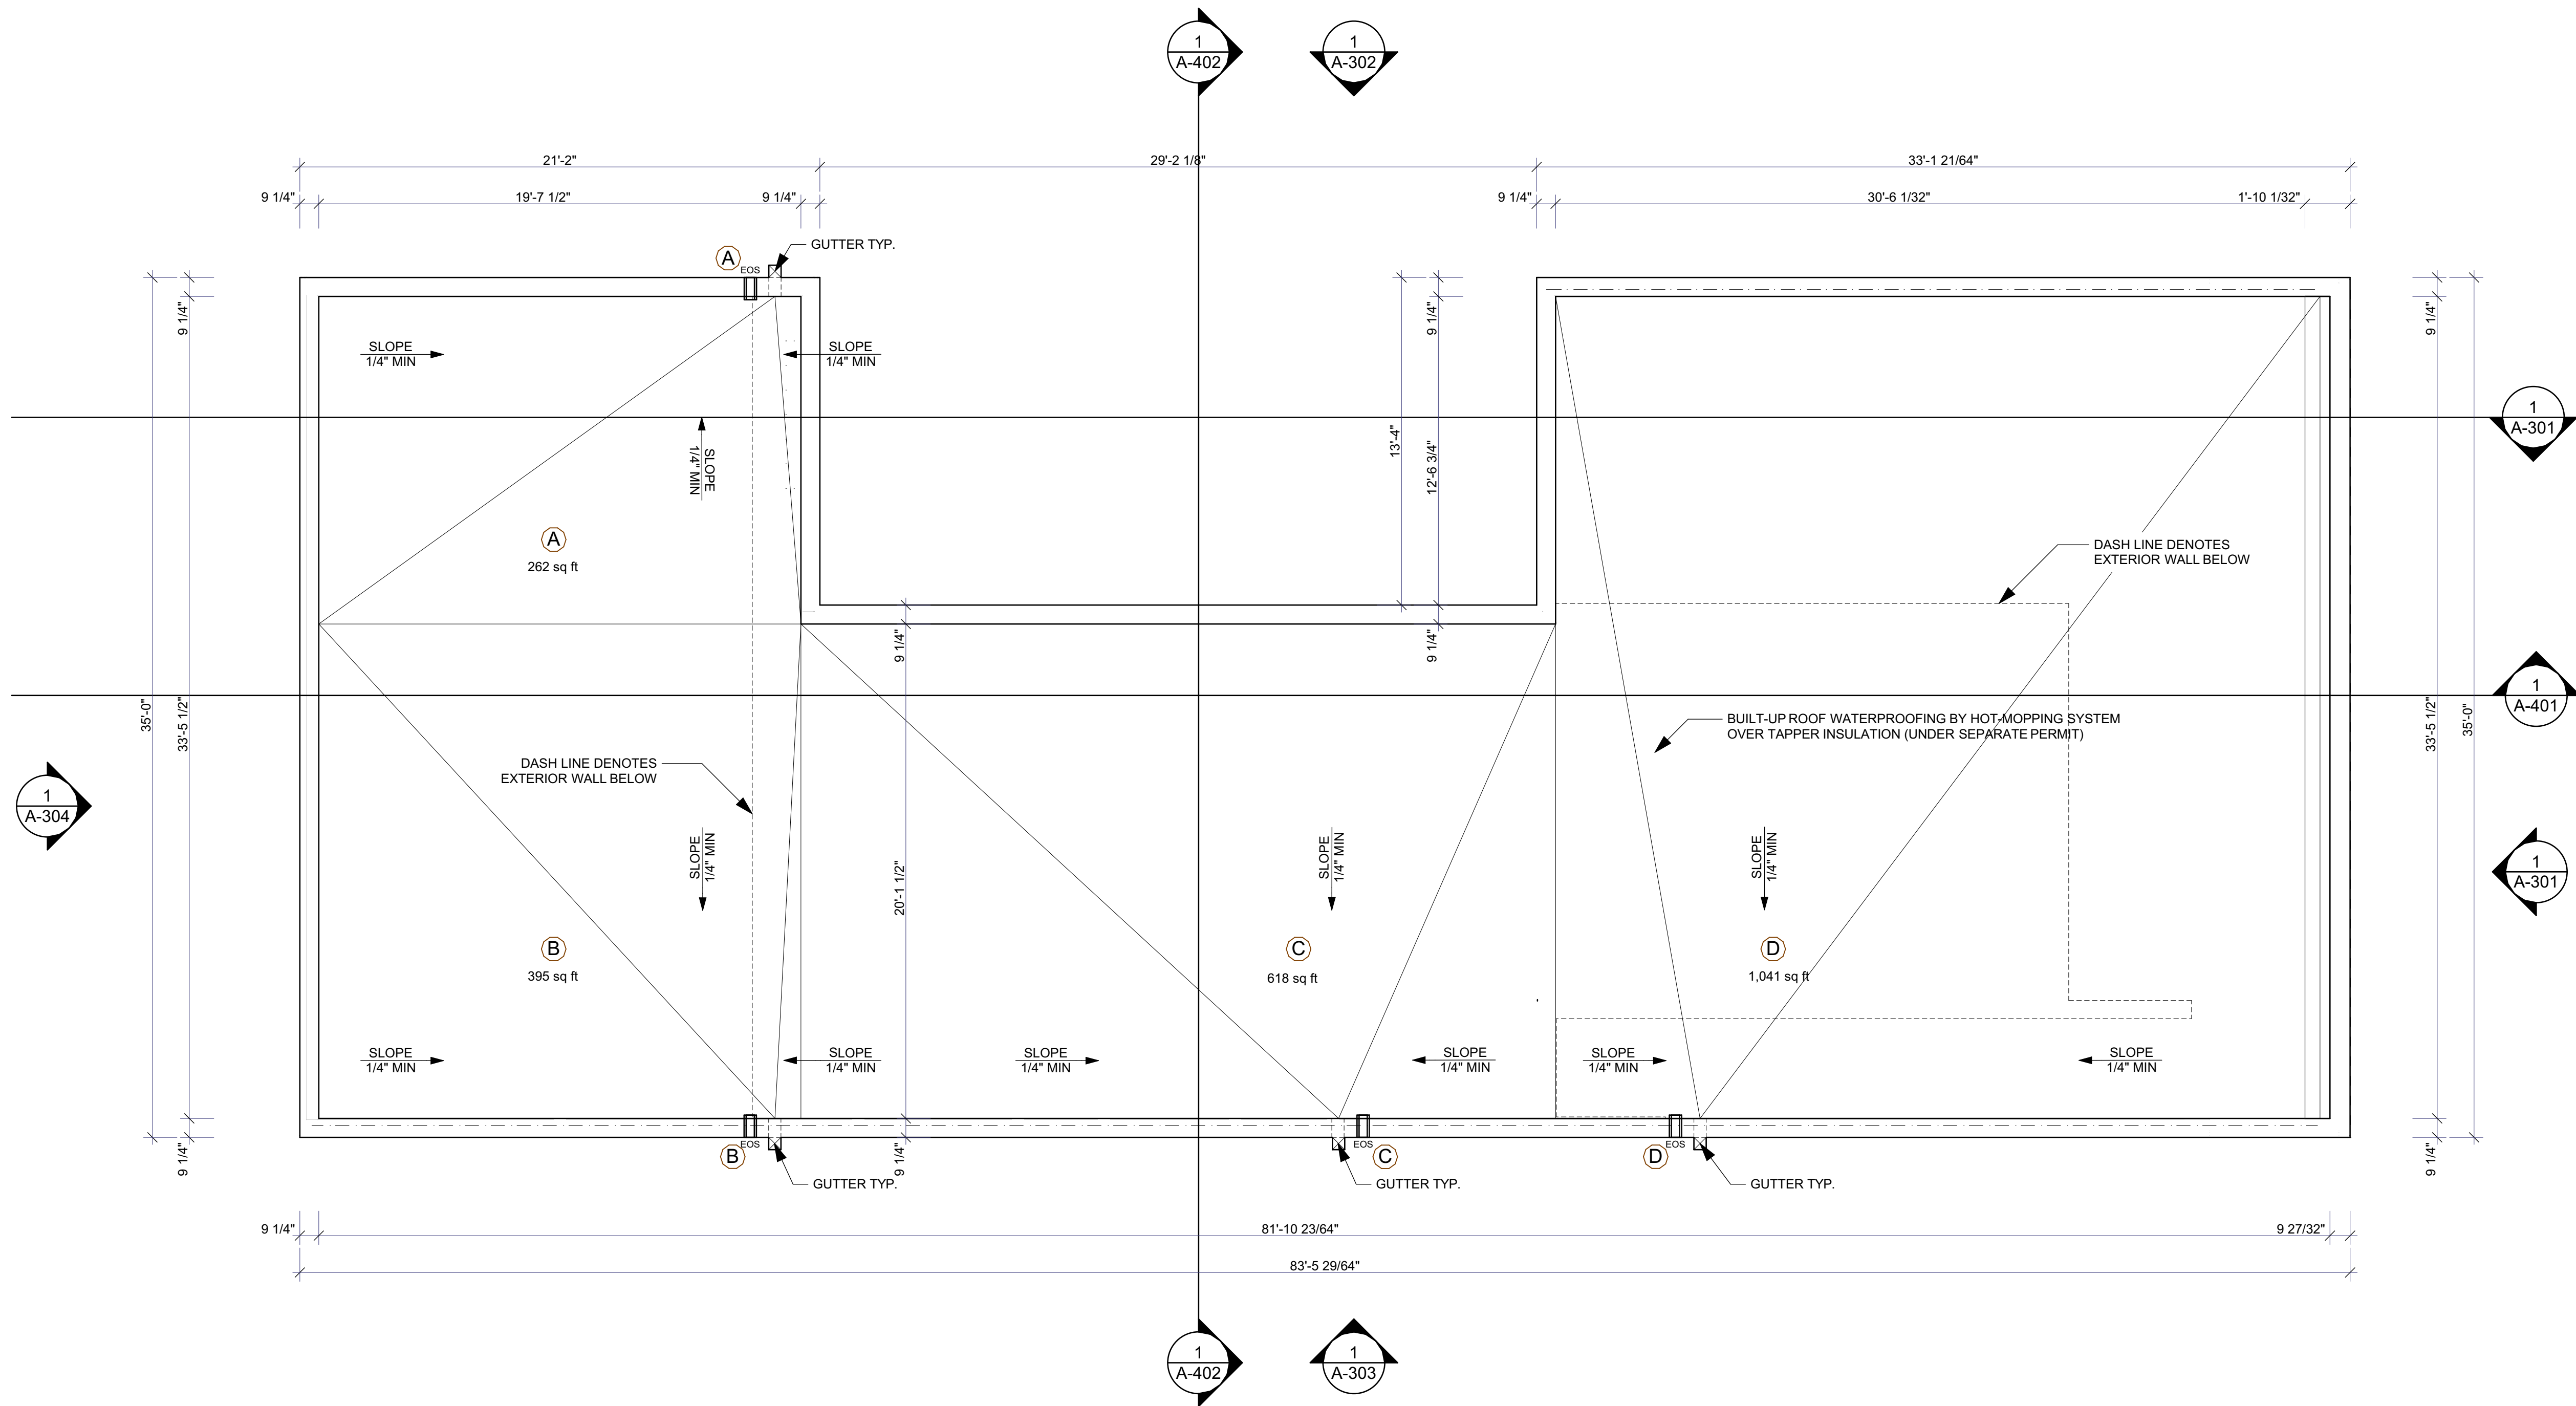
CONSULTANTS:

ROOF PLAN

A-104

DRAWN BY:




B.C.



1
A-104

ROOF PLAN

SCALE: 1/4" = 1'-0"

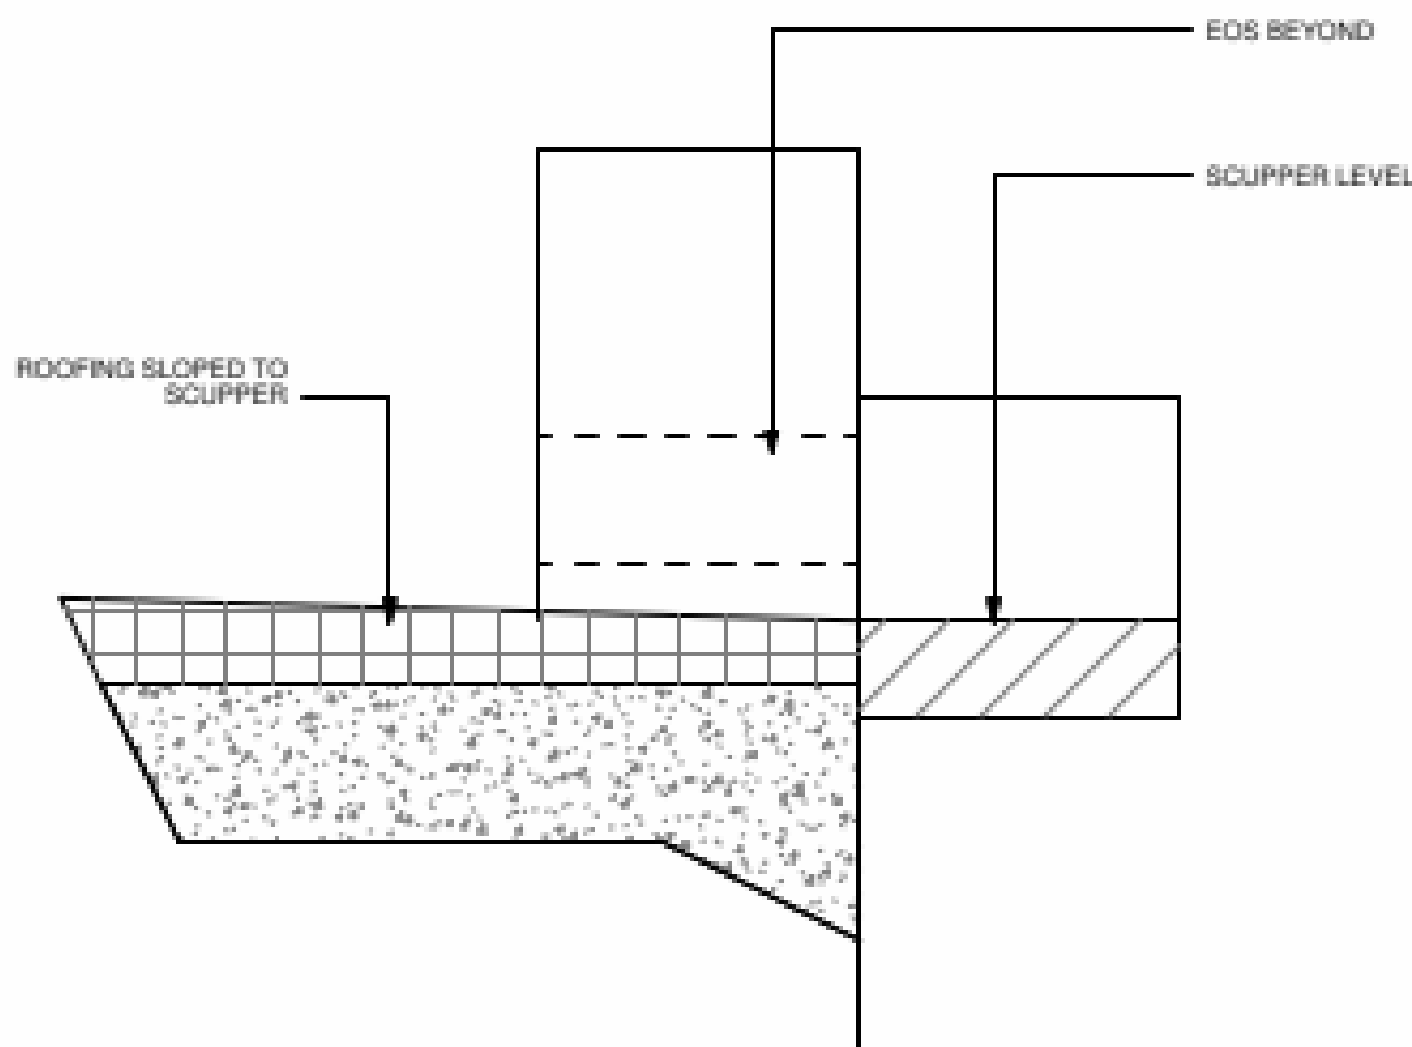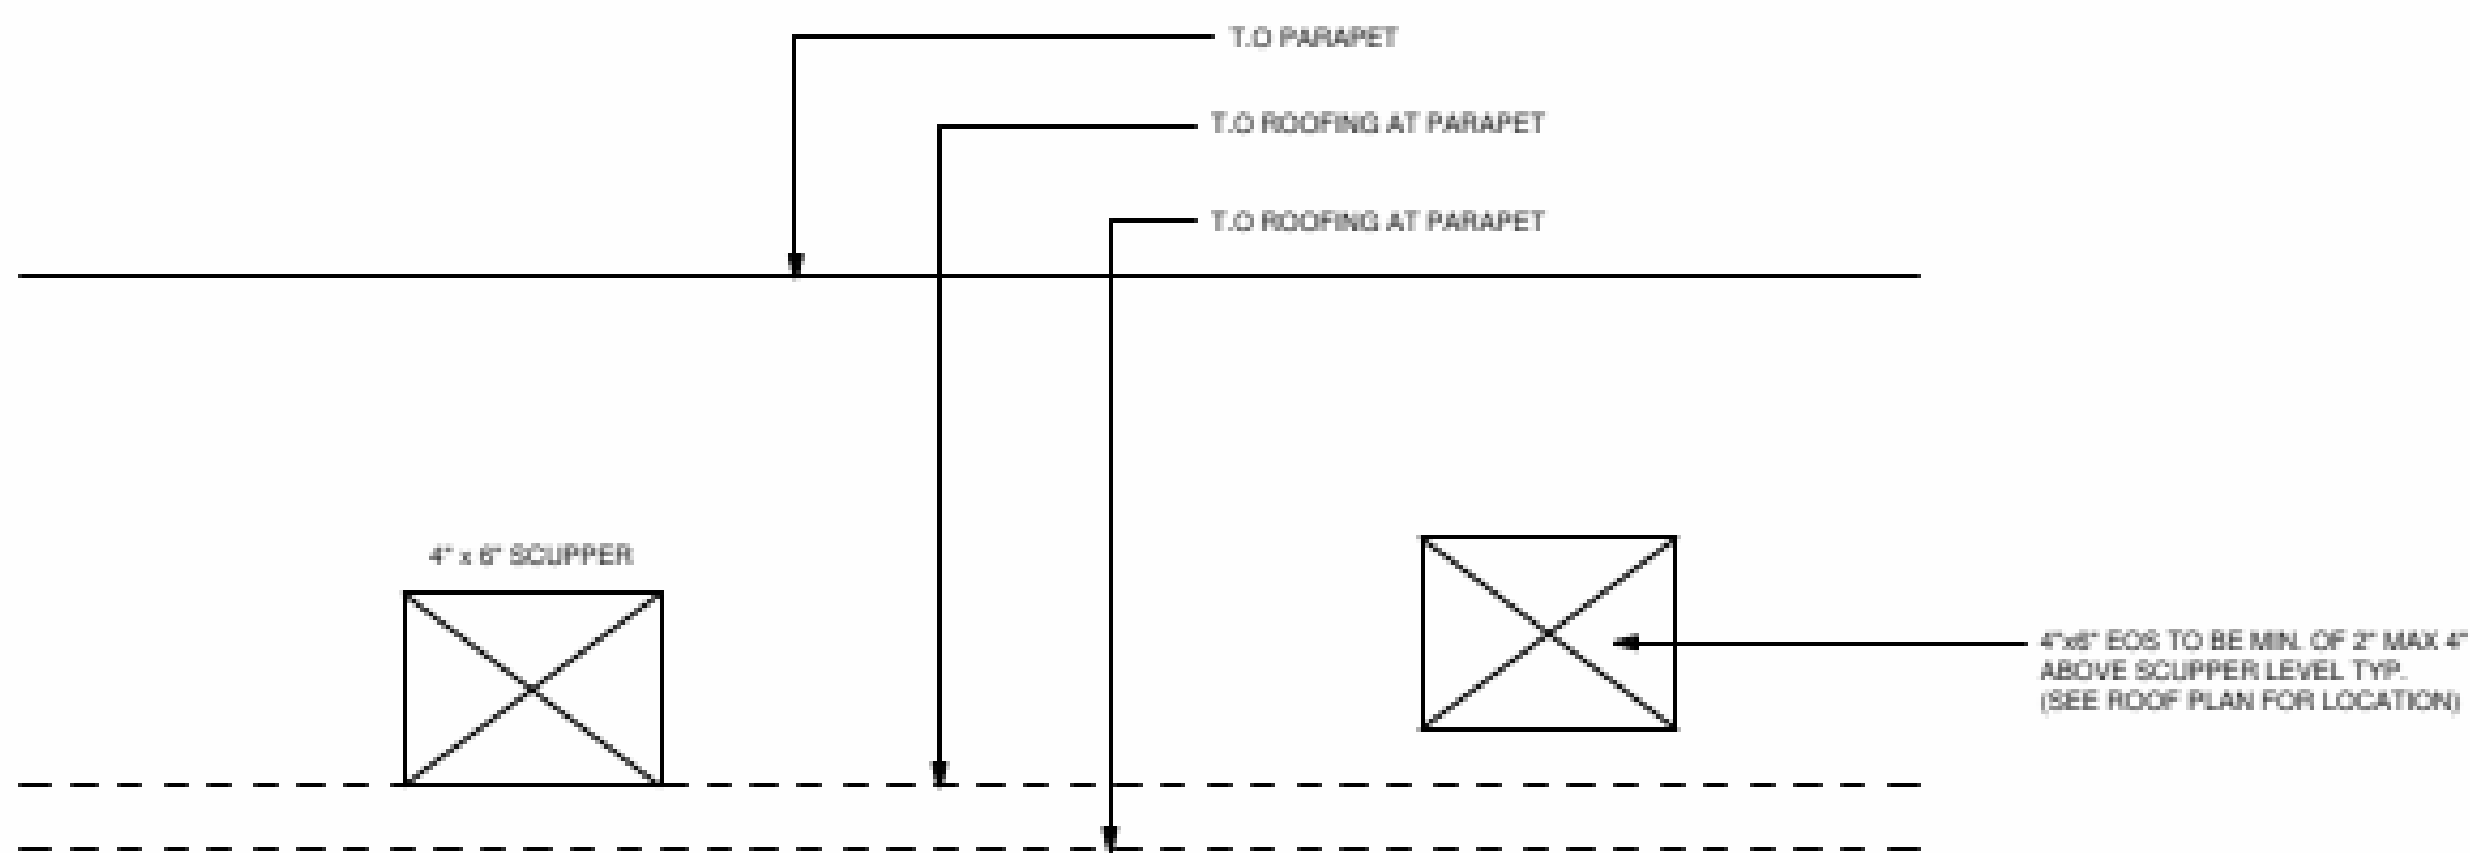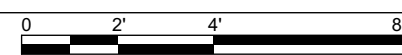

ROOF DRAINAGE CALCULATIONS
(100 YEAR, 1-HOUR RAINFALL - 5 INCHES AS PER PFBC2020) 5 INCHES = 0.0520 GPM PER 1 SQ.FT. HORIZONTAL 1/4" PER LF
ROOF AREA A-262 SF x 0.0520 = 13.62 GPM PROVIDED: 6" DIA. HORIZONTAL 487 GPM
ROOF AREA B-395 SF x 0.0520 = 20.54 GPM PROVIDED: 6" DIA. HORIZONTAL 487 GPM
ROOF AREA C-618 SF x 0.0520 = 32.14 GPM PROVIDED: 6" DIA. HORIZONTAL 487 GPM
ROOF AREA D-1041 SF x 0.0520 = 54.13 GPM PROVIDED: 6" DIA. HORIZONTAL 487 GPM
PER TABLE 1106.7, ROOF AREAS A,B,C,D. "4h x 6w" SCOOPE DRAINS W/4h x 6w EMERGENCY SCUPPER DRAINS.

NOTES:


ENCLOSED AREAS BELOW THE DESIGN FLOOD ELEVATION SHALL BE USED SOLELY FOR PARKING,
BUILDING ACCESS OR STORAGE AS PER ASC 4.6.

ROOFING SYSTEM NOTES:

ALL ROOFING SYSTEM SHALL BE PAINTED "WHITE" AS PER URBAN HEAT ISLAND ORDINANCE.

WATERPROOFING NOTE:

- WATERPROOFING TESTED SHALL BE FLOOD TESTED IN ACCORDANCE WITH ASTM D5957 .
- WATERPROOFING WILL COMPLY WITH F.B.C. 1519.16.6
- WATERPROOFING WILL BE SUBMITTED WITH A SEPARATE PERMIT
- FLASHING SHALL BE INSTALLED IN ACCORDANCE TO THE MANUFACTURERS PUBLISHED STANDARD DETAILS, SPECIFIC DETAILS, APPROVED BY THE MANUFACTURE; AND SHALL COMPLY WITH F.B.C. 1519.16

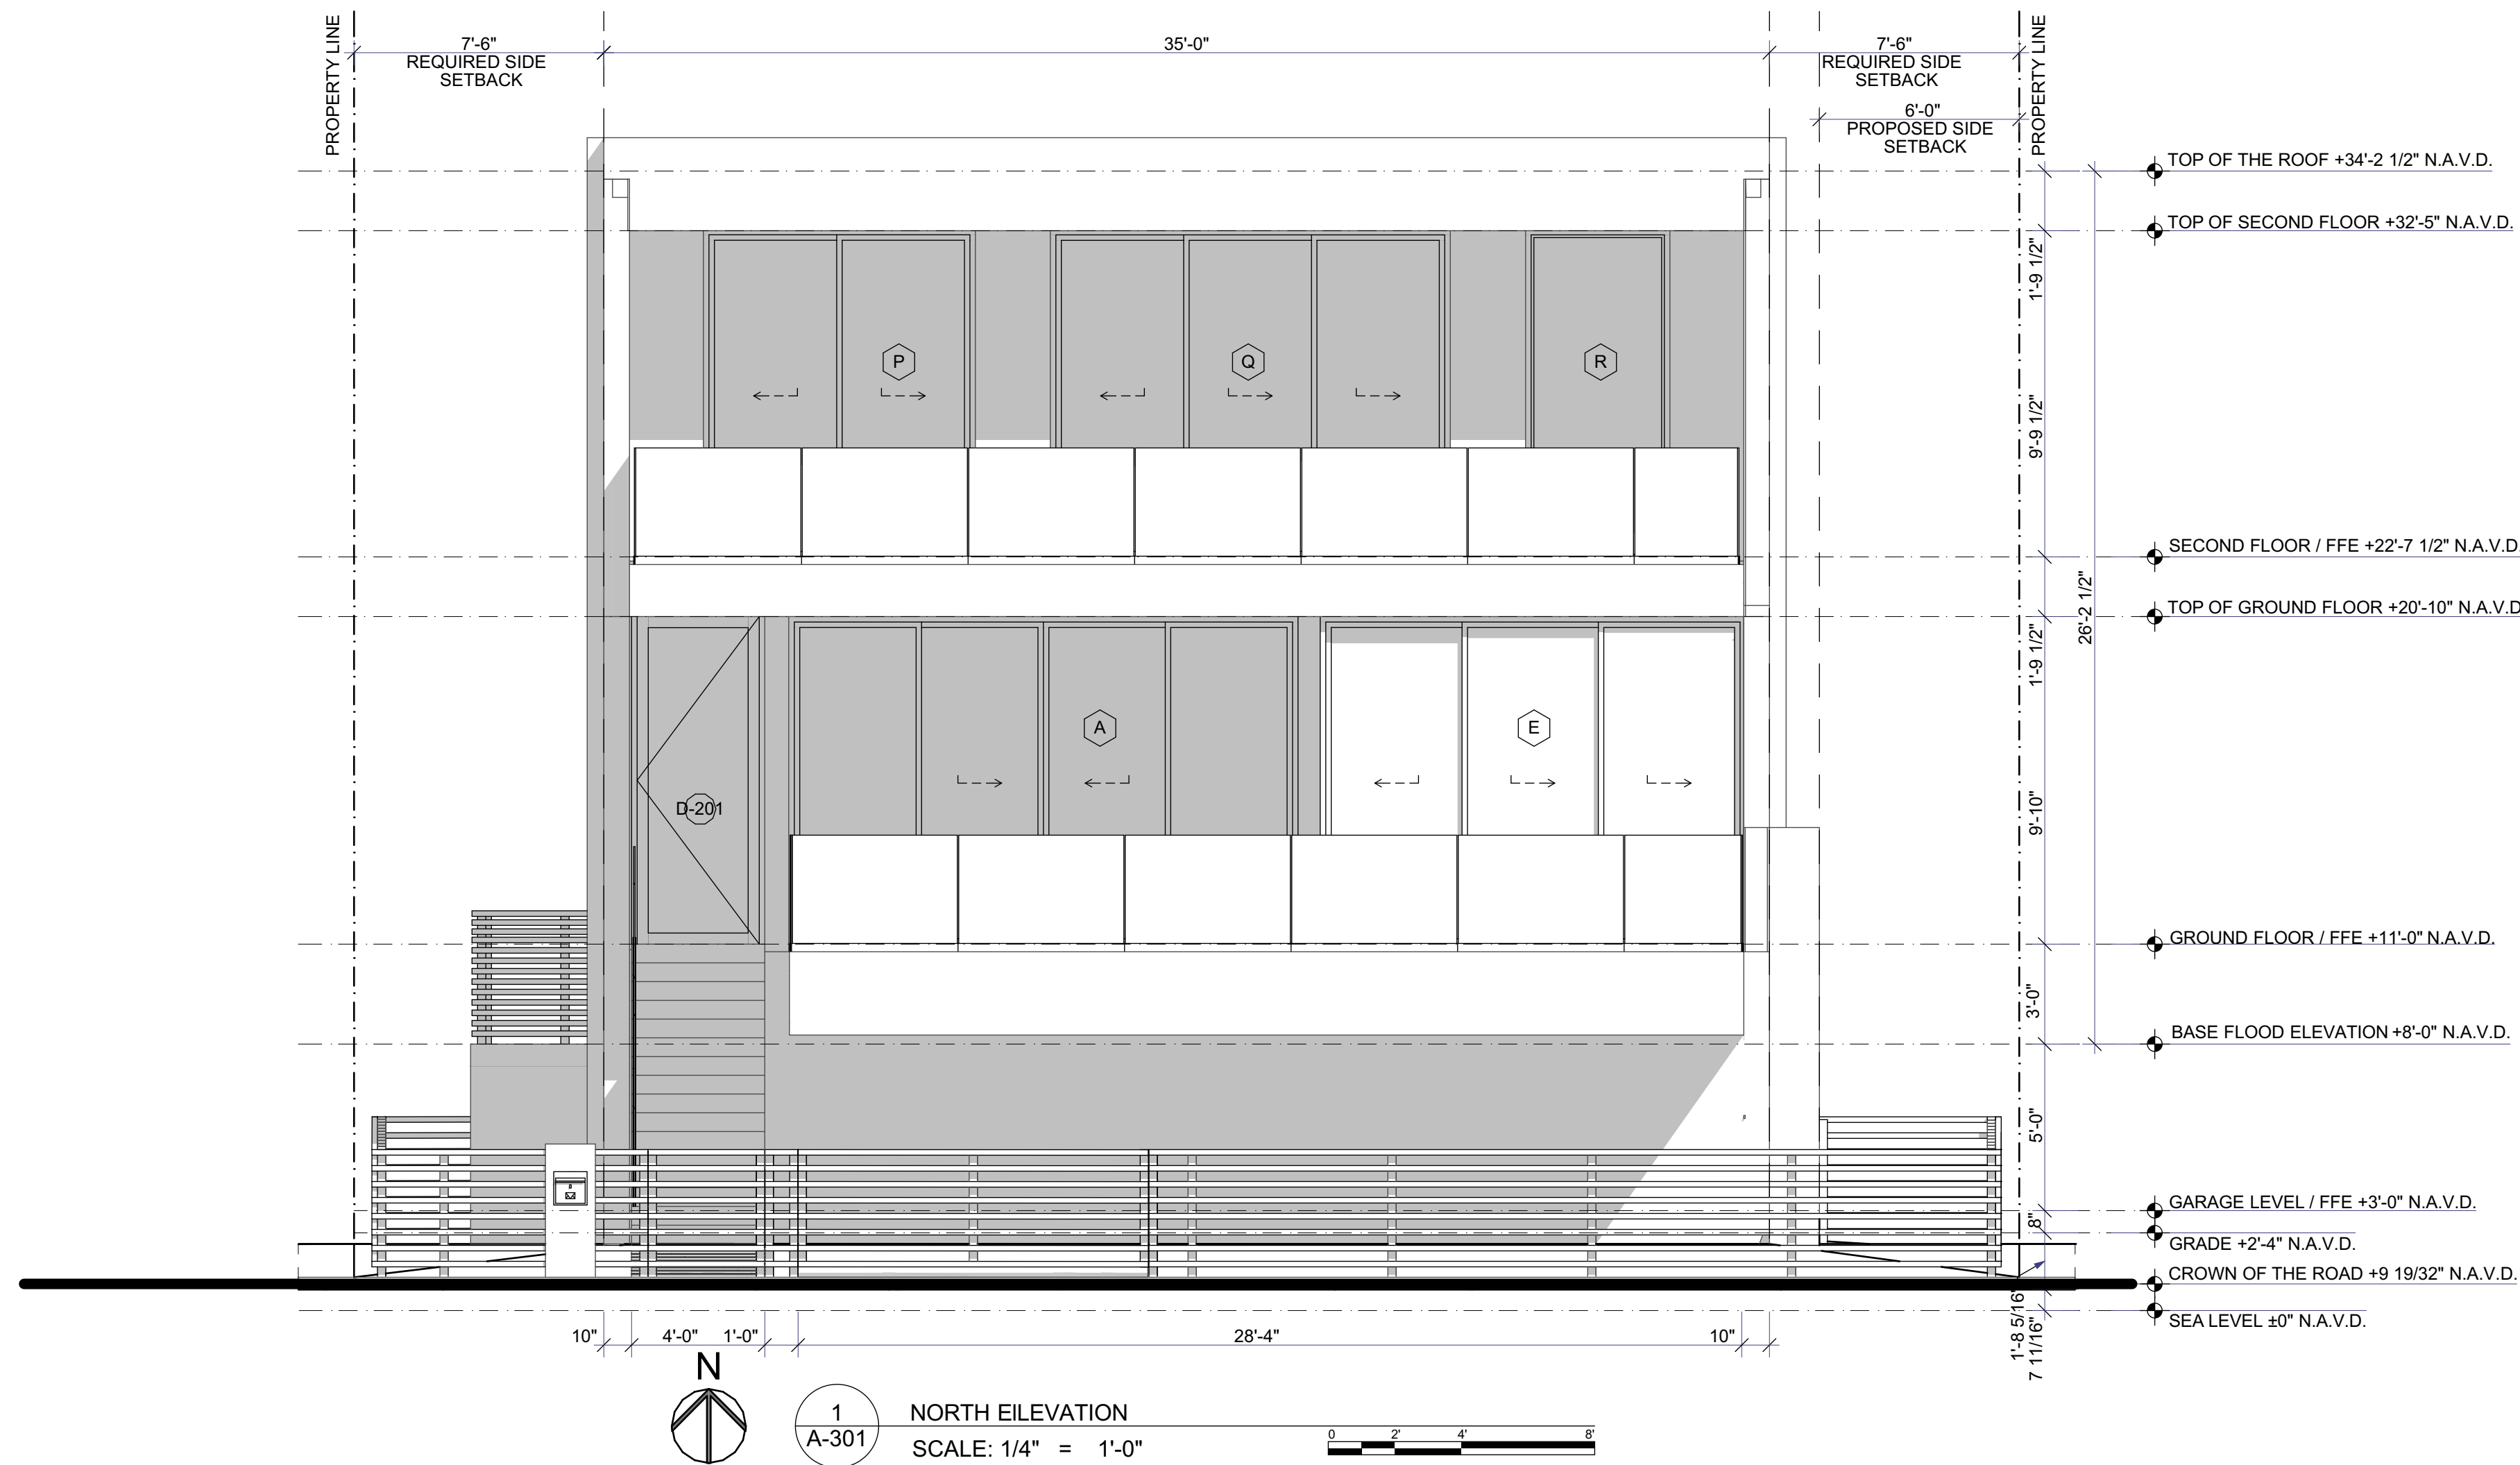

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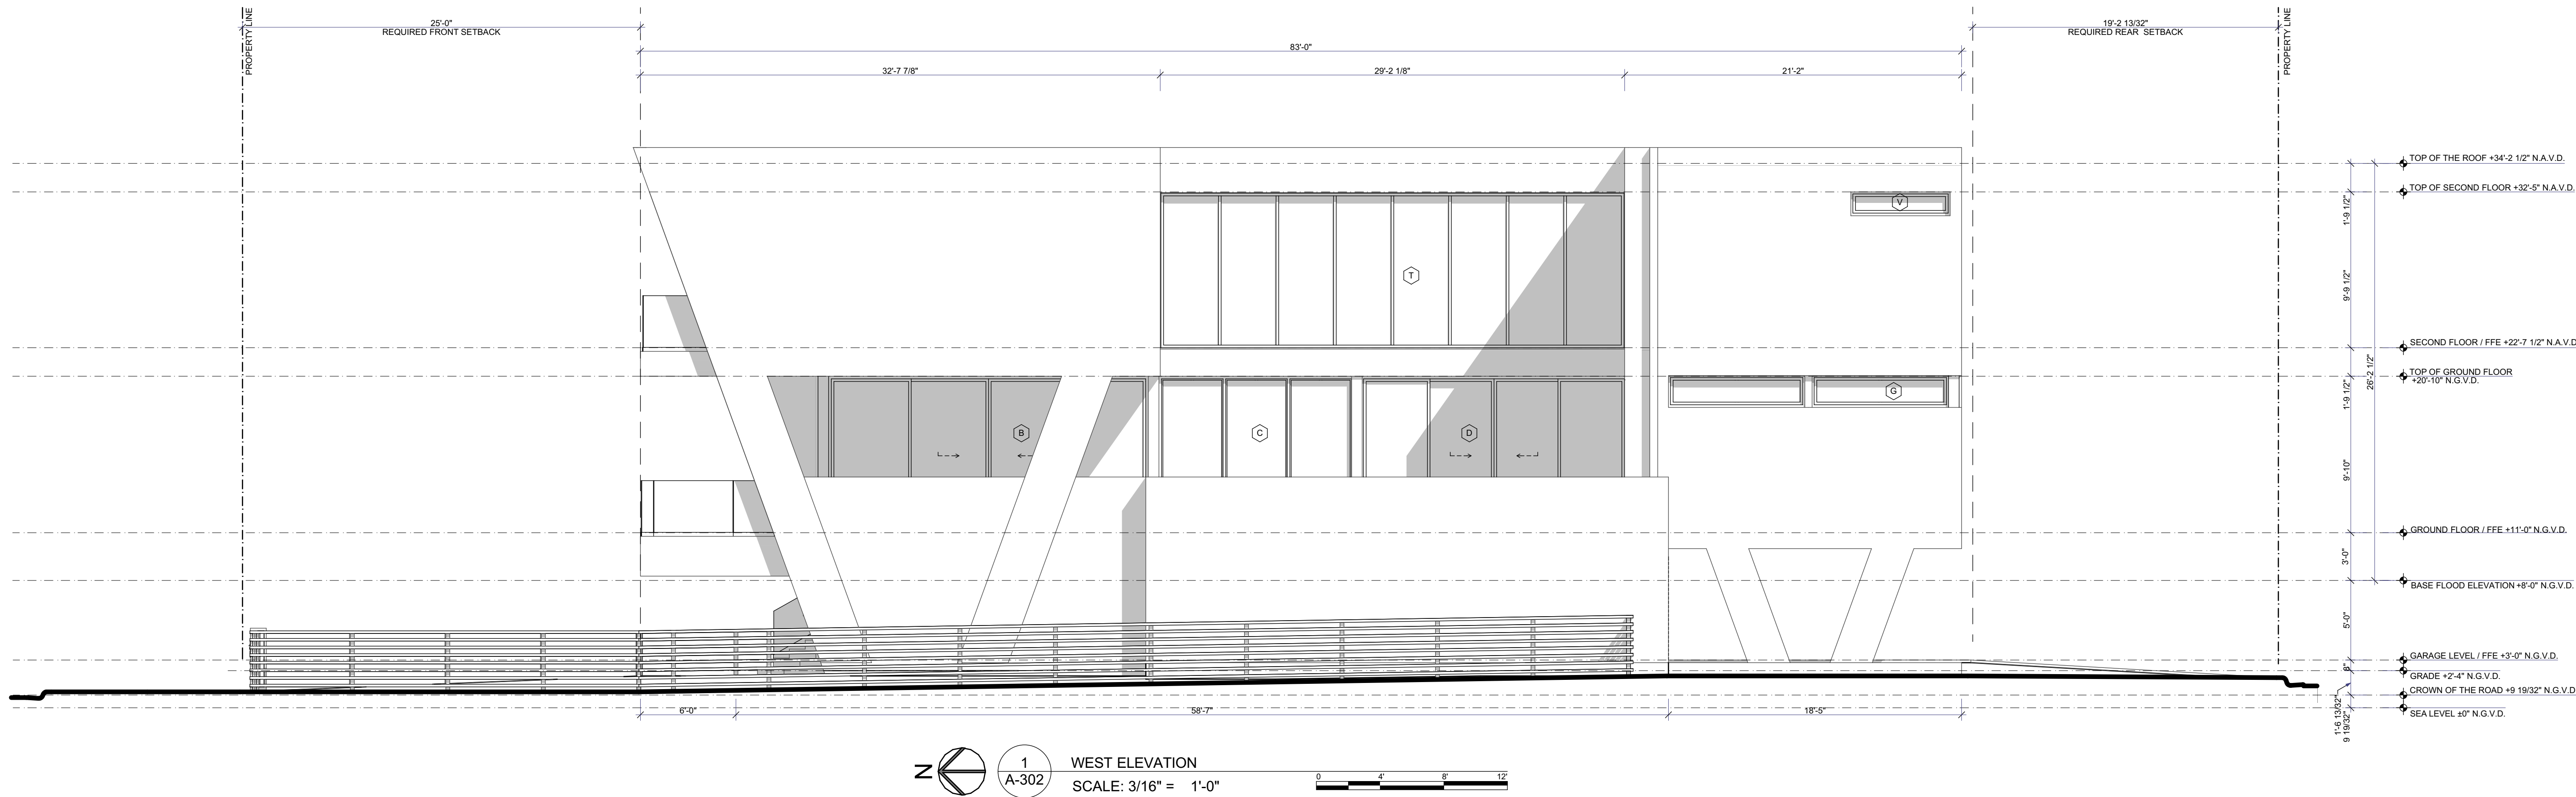
DATE:
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SCALE:

CONSULTANTS:

WEST ELEVATION

A-302

DRAWN BY: B.C.



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SCALE:


CONSULTANTS:

EAST ELEVATION

A-303

DRAWN BY:

B.C.

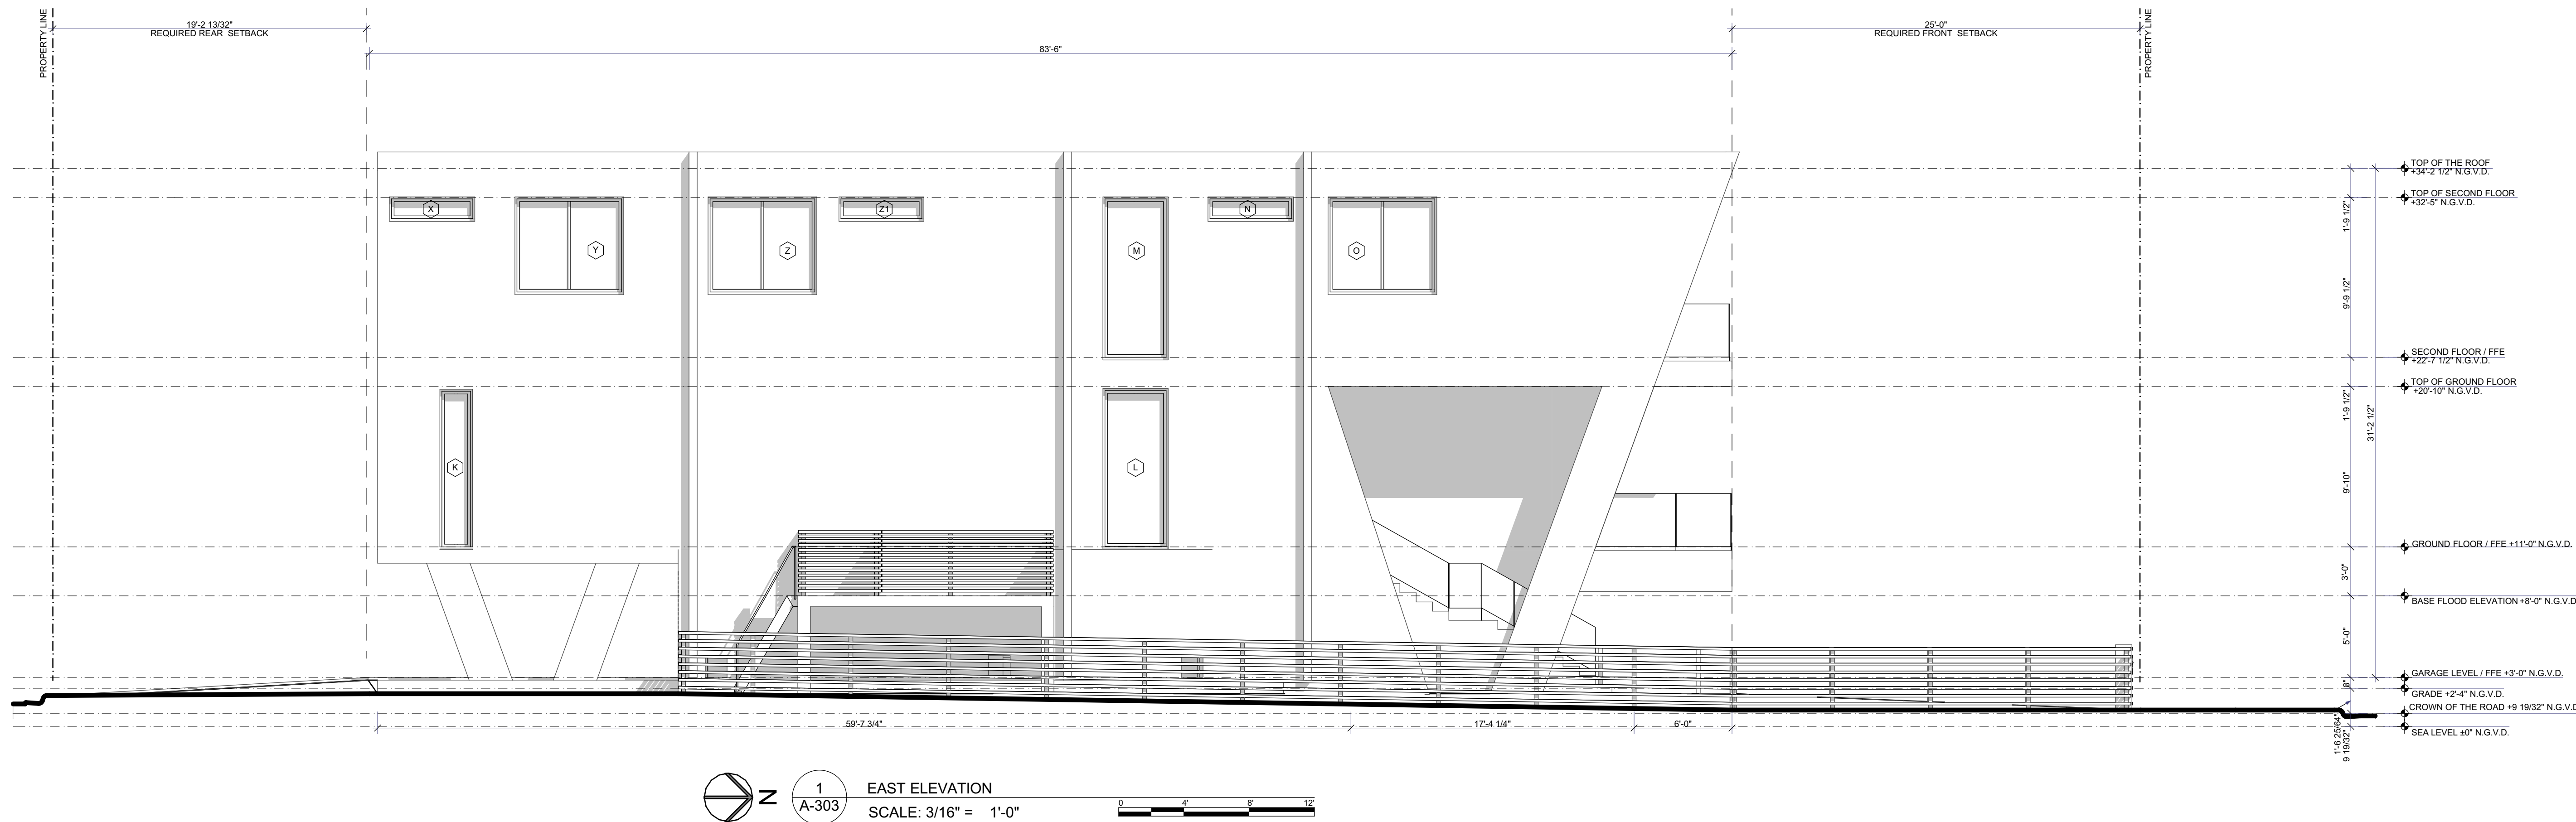

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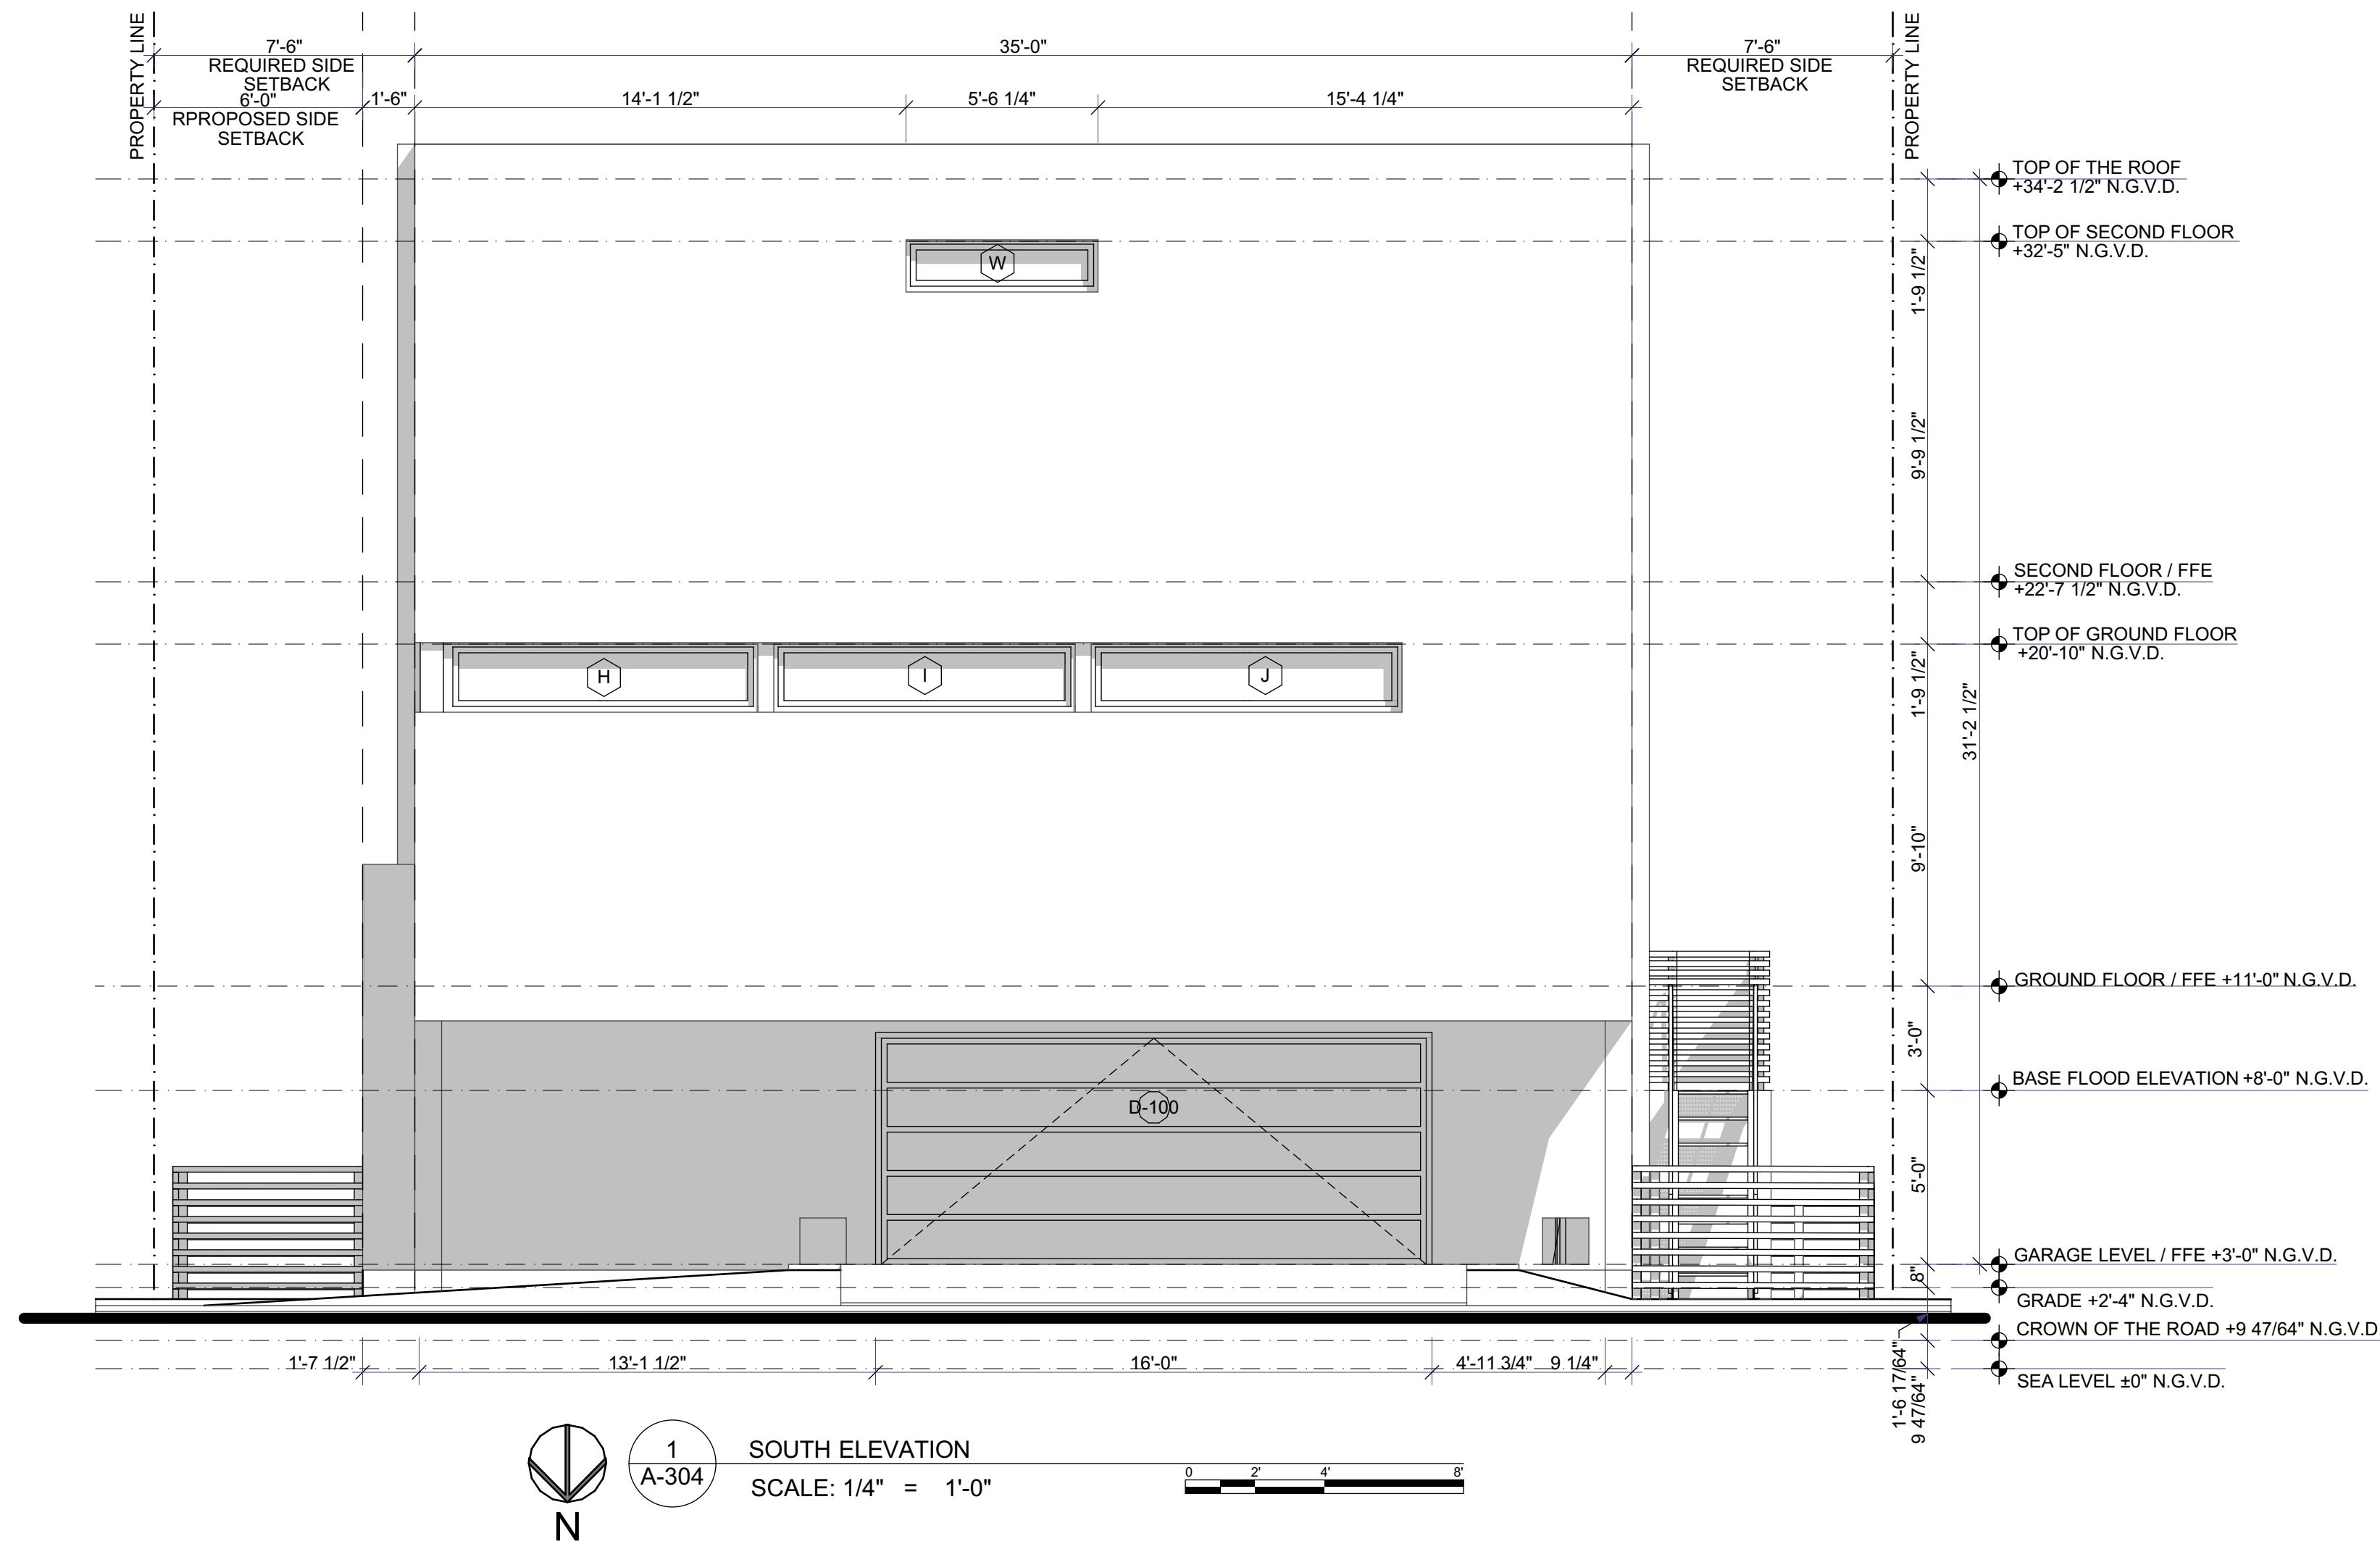
DATE:
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SCALE:

CONSULTANTS:

SOUTH ELEVATION

A-304

DRAWN BY: B.C.



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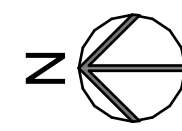
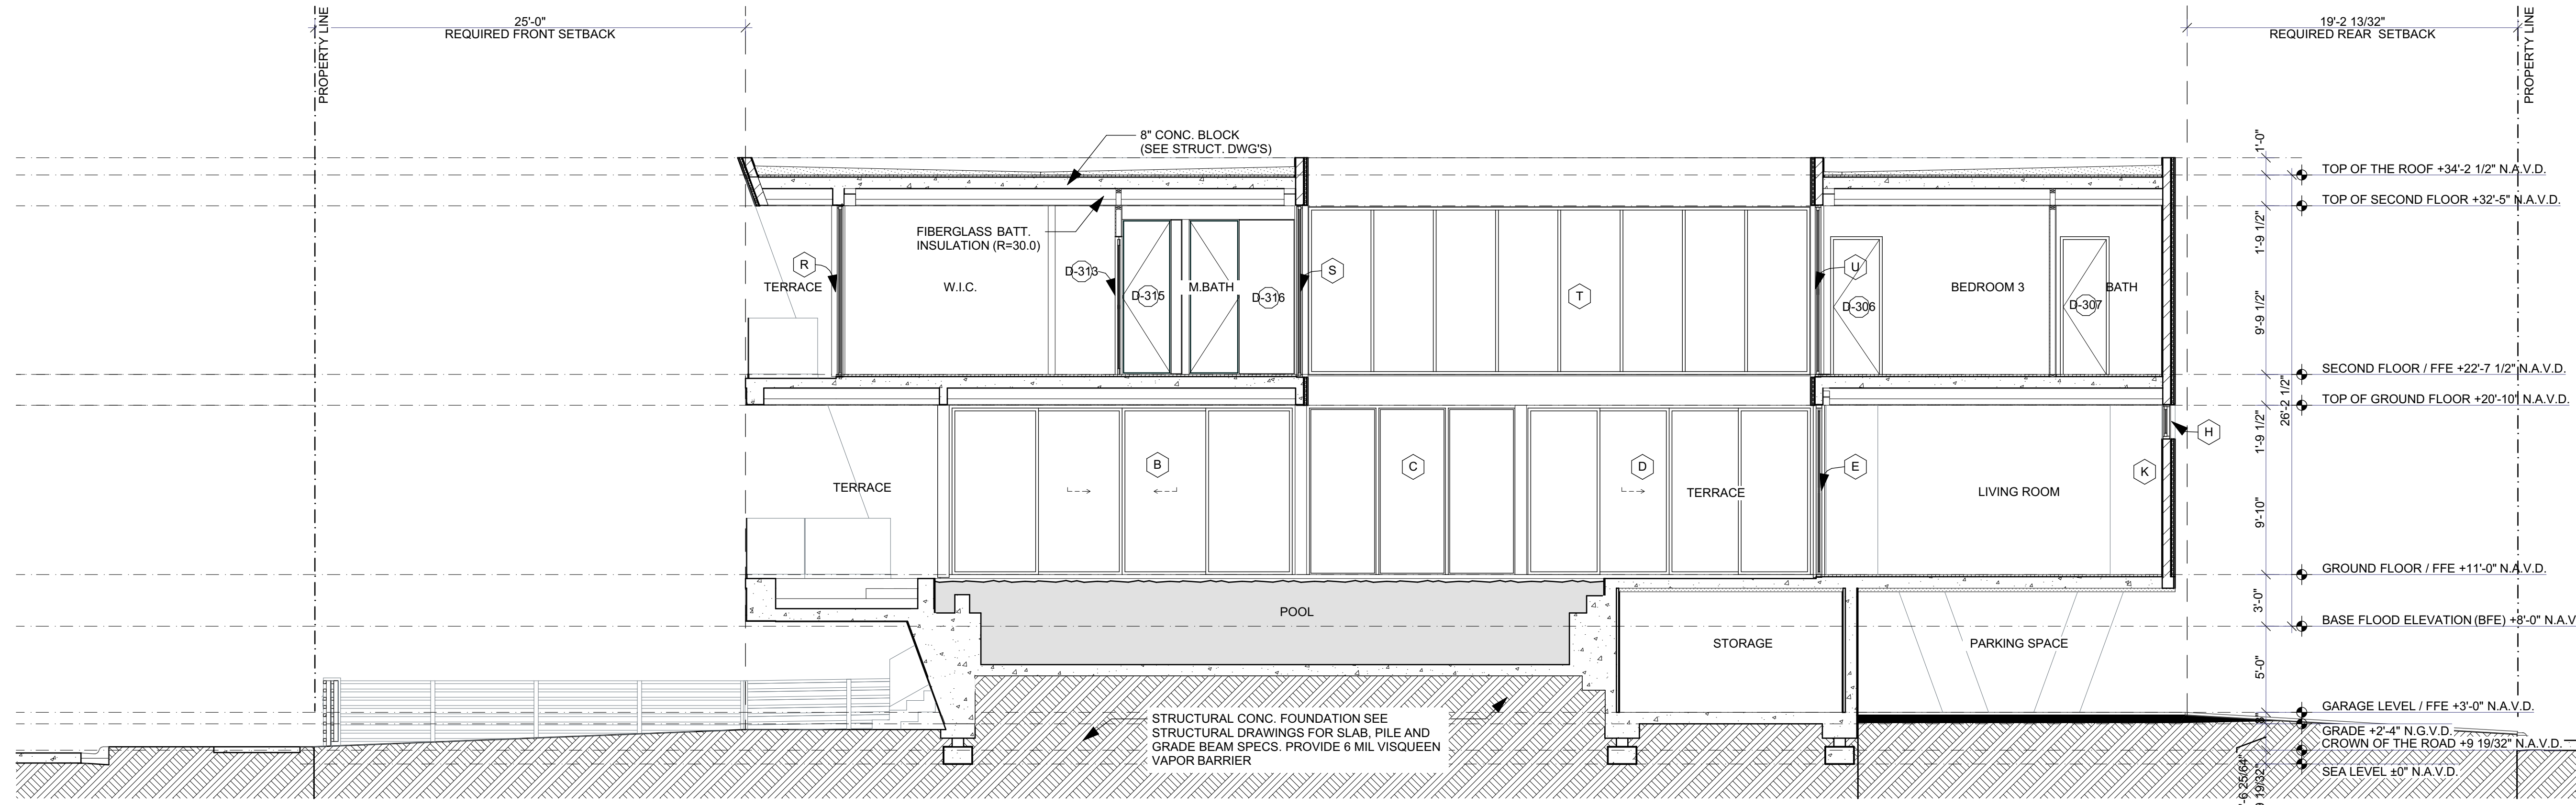
CONSULTANTS:

SECTION VIEWS

A-401

DRAWN BY:




B.C.



2
A-401

BUILDING SECTION A


SCALE: 3/16" = 1'-0"

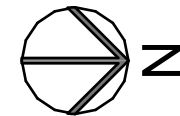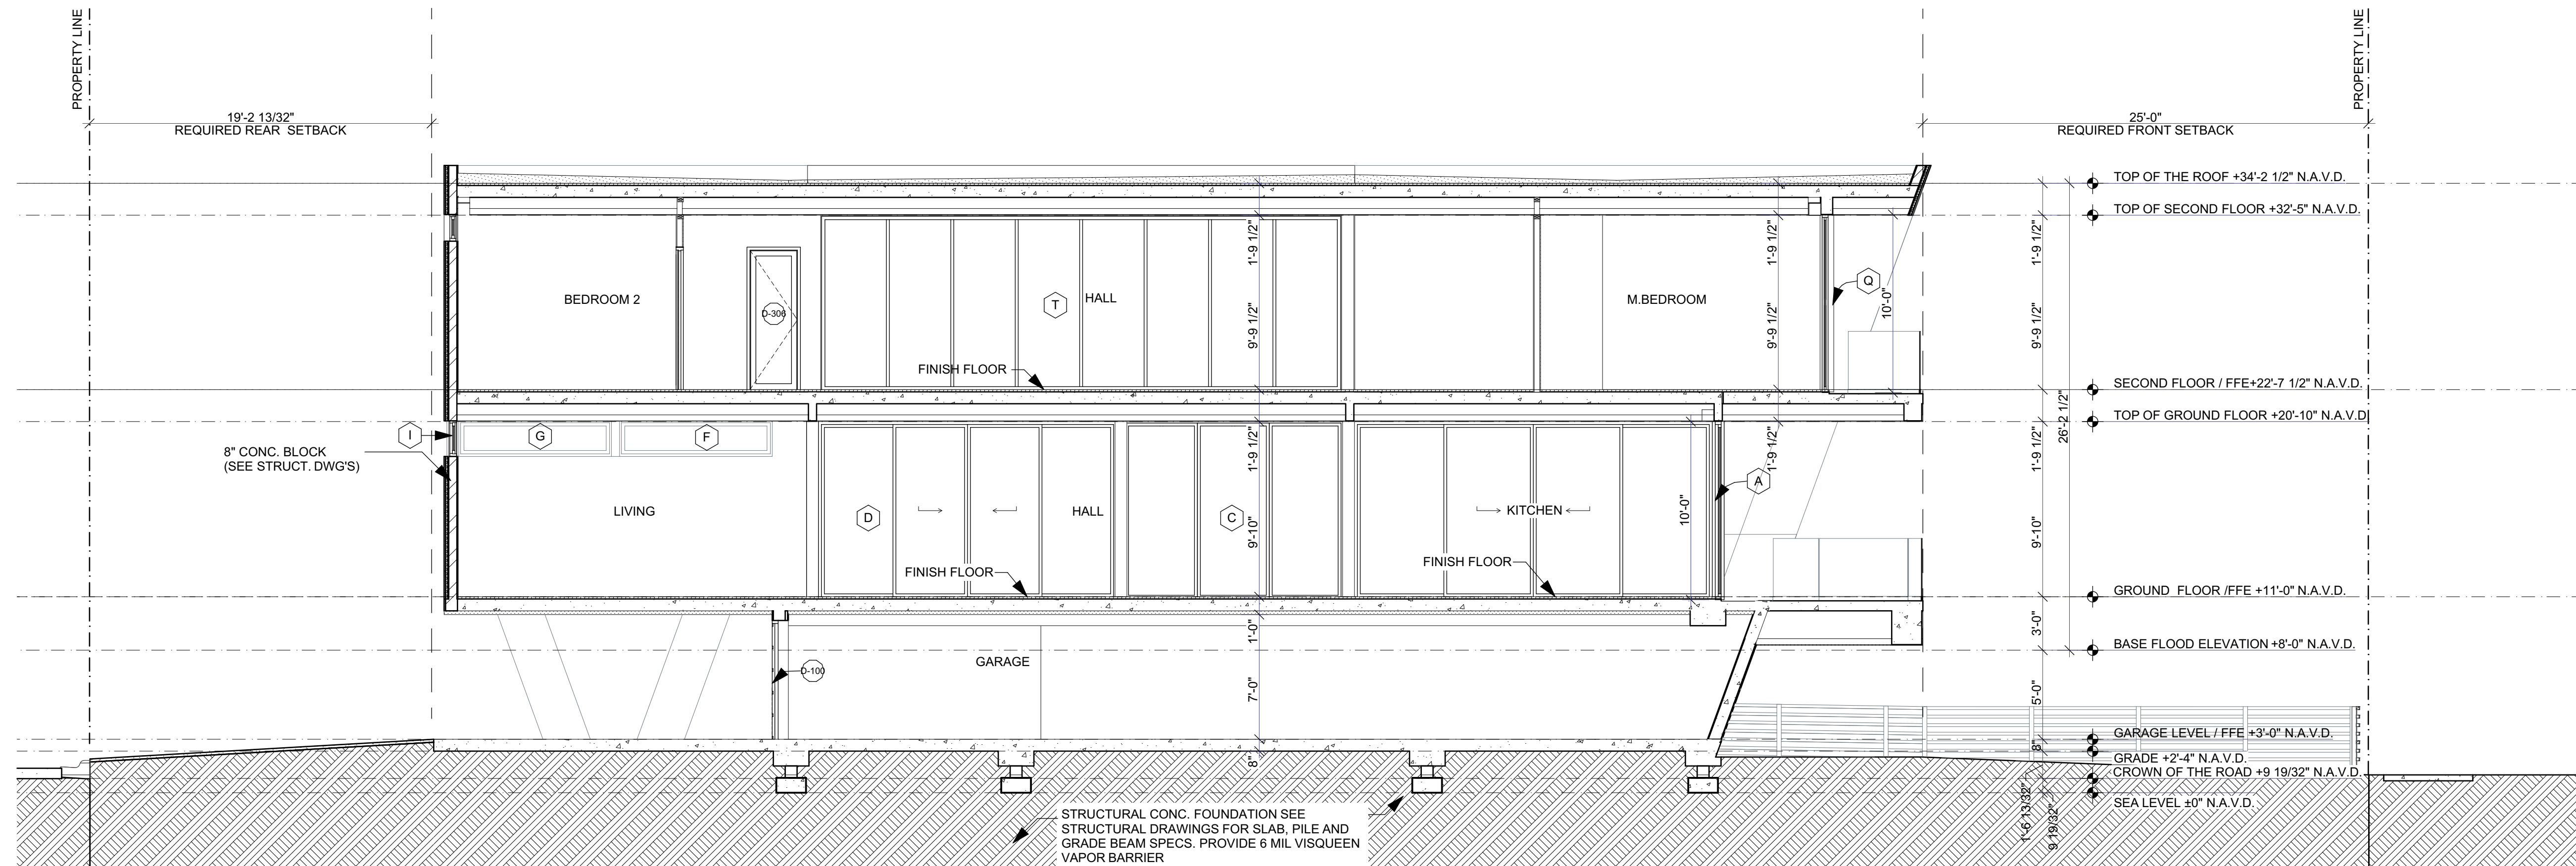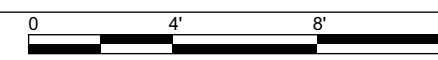


1
A-401

BUILDING SECTION C

SCALE: 3/16" = 1'-0"

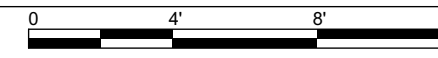

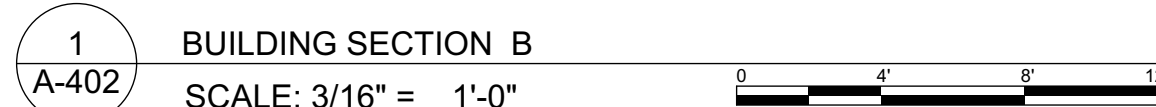



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DRAFTED BY:

SCALE:

CONSULTANTS:

RENDERINGS

A-501

DRAWN BY:

B.C.



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SCALE:

CONSULTANTS:

RENDERINGS

A-502

DRAWN BY: B.C.

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SCALE:

CONSULTANTS:


MATERIAL SCHEDULES

A-503

B.C



the 1990s, the number of people in the United States who are 65 years of age or older has increased by 50 percent. The number of people aged 75 and older has increased by 100 percent. The number of people aged 85 and older has increased by 200 percent. The number of people aged 95 and older has increased by 400 percent. The number of people aged 100 and older has increased by 800 percent. The number of people aged 105 and older has increased by 1,600 percent. The number of people aged 110 and older has increased by 3,200 percent. The number of people aged 115 and older has increased by 6,400 percent. The number of people aged 120 and older has increased by 12,800 percent. The number of people aged 125 and older has increased by 25,600 percent. The number of people aged 130 and older has increased by 51,200 percent. The number of people aged 135 and older has increased by 102,400 percent. The number of people aged 140 and older has increased by 204,800 percent. The number of people aged 145 and older has increased by 409,600 percent. The number of people aged 150 and older has increased by 819,200 percent. The number of people aged 155 and older has increased by 1,638,400 percent. The number of people aged 160 and older has increased by 3,276,800 percent. The number of people aged 165 and older has increased by 6,553,600 percent. The number of people aged 170 and older has increased by 13,107,200 percent. The number of people aged 175 and older has increased by 26,214,400 percent. The number of people aged 180 and older has increased by 52,428,800 percent. The number of people aged 185 and older has increased by 104,857,600 percent. The number of people aged 190 and older has increased by 209,715,200 percent. The number of people aged 195 and older has increased by 419,430,400 percent. The number of people aged 200 and older has increased by 838,860,800 percent. The number of people aged 205 and older has increased by 1,677,721,600 percent. The number of people aged 210 and older has increased by 3,355,443,200 percent. The number of people aged 215 and older has increased by 6,710,886,400 percent. The number of people aged 220 and older has increased by 13,421,772,800 percent. The number of people aged 225 and older has increased by 26,843,545,600 percent. The number of people aged 230 and older has increased by 53,687,091,200 percent. The number of people aged 235 and older has increased by 107,374,182,400 percent. The number of people aged 240 and older has increased by 214,748,364,800 percent. The number of people aged 245 and older has increased by 429,496,729,600 percent. The number of people aged 250 and older has increased by 858,993,459,200 percent. The number of people aged 255 and older has increased by 1,717,986,918,400 percent. The number of people aged 260 and older has increased by 3,435,973,836,800 percent. The number of people aged 265 and older has increased by 6,871,947,673,600 percent. The number of people aged 270 and older has increased by 13,743,895,347,200 percent. The number of people aged 275 and older has increased by 27,487,790,694,400 percent. The number of people aged 280 and older has increased by 54,975,581,388,800 percent. The number of people aged 285 and older has increased by 109,951,162,777,600 percent. The number of people aged 290 and older has increased by 219,902,325,555,200 percent. The number of people aged 295 and older has increased by 439,804,651,110,400 percent. The number of people aged 300 and older has increased by 879,609,302,220,800 percent. The number of people aged 305 and older has increased by 1,759,218,604,441,600 percent. The number of people aged 310 and older has increased by 3,518,437,208,883,200 percent. The number of people aged 315 and older has increased by 7,036,874,417,766,400 percent. The number of people aged 320 and older has increased by 14,073,748,835,532,800 percent. The number of people aged 325 and older has increased by 28,147,497,671,065,600 percent. The number of people aged 330 and older has increased by 56,294,995,342,131,200 percent. The number of people aged 335 and older has increased by 112,589,990,684,262,400 percent. The number of people aged 340 and older has increased by 225,179,981,368,524,800 percent. The number of people aged 345 and older has increased by 450,359,962,737,049,600 percent. The number of people aged 350 and older has increased by 900,719,925,474,099,200 percent. The number of people aged 355 and older has increased by 1,801,439,850,948,198,400 percent. The number of people aged 360 and older has increased by 3,602,879,701,896,396,800 percent. The number of people aged 365 and older has increased by 7,205,759,403,792,793,600 percent. The number of people aged 370 and older has increased by 14,411,518,807,585,587,200 percent. The number of people aged 375 and older has increased by 28,823,037,615,171,174,400 percent. The number of people aged 380 and older has increased by 57,646,075,230,342,348,800 percent. The number of people aged 385 and older has increased by 115,292,150,460,684,697,600 percent. The number of people aged 390 and older has increased by 230,584,300,921,369,395,200 percent. The number of people aged 395 and older has increased by 461,168,601,842,738,790,400 percent. The number of people aged 400 and older has increased by 922,337,203,685,477,580,800 percent. The number of people aged 405 and older has increased by 1,844,674,407,370,955,161,600 percent. The number of people aged 410 and older has increased by 3,689,348,814,741,910,323,200 percent. The number of people aged 415 and older has increased by 7,378,697,629,483,820,646,400 percent. The number of people aged 420 and older has increased by 14,757,395,258,967,641,292,800 percent. The number of people aged 425 and older has increased by 29,514,790,517,935,282,585,600 percent. The number of people aged 430 and older has increased by 59,029,581,035,870,565,171,200 percent. The number of people aged 435 and older has increased by 118,059,162,071,741,130,342,400 percent. The number of people aged 440 and older has increased by 236,118,324,143,482,260,684,800 percent. The number of people aged 445 and older has increased by 472,236,648,286,964,521,369,600 percent. The number of people aged 450 and older has increased by 944,473,296,573,929,042,739,200 percent. The number of people aged 455 and older has increased by 1,888,946,593,147,858,085,478,400 percent. The number of people aged 460 and older has increased by 3,777,893,186,295,716,170,956,800 percent. The number of people aged 465 and older has increased by 7,555,786,372,591,432,341,913,600 percent. The number of people aged 470 and older has increased by 15,111,572,745,182,864,683,827,200 percent. The number of people aged 475 and older has increased by 30,223,145,490,365,729,367,654,400 percent. The number of people aged 480 and older has increased by 60,446,290,980,731,458,735,308,800 percent. The number of people aged 485 and older has increased by 120,892,581,961,462,917,470,617,600 percent. The number of people aged 490 and older has increased by 241,785,163,922,925,834,941,235,200 percent. The number of people aged 495 and older has increased by 483,570,327,845,851,669,882,470,400 percent. The number of people aged 500 and older has increased by 967,140,655,691,703,339,764,940,800 percent. The number of people aged 505 and older has increased by 1,934,281,311,383,406,679,529,881,600 percent. The number of people aged 510 and older has increased by 3,868,562,622,766,813,359,059,763,200 percent. The number of people aged 515 and older has increased by 7,737,125,245,533,626,718,119,526,400 percent. The number of people aged 520 and older has increased by 15,474,250,491,067,253,436,239,052,800 percent. The number of people aged 525 and older has increased by 30,948,500,982,134,506,872,478,105,600 percent. The number of people aged 530 and older has increased by 61,897,001,964,269,013,744,956,211,200 percent. The number of people aged 535 and older has increased by 123,794,003,928,538,027,489,912,422,400 percent. The number of people aged 540 and older has increased by 247,588,007,857,076,054,979,824,844,800 percent. The number of people aged 545 and older has increased by 495,176,015,714,152,109,959,649,689,600 percent. The number of people aged 550 and older has increased by 990,352,031,428,304,219,919,299,379,200 percent. The number of people aged 555 and older has increased by 1,980,704,062,856,608,439,838,598,758,400 percent. The number of people aged 560 and older has increased by 3,961,408,125,713,216,879,677,197,516,800 percent. The number of people aged 565 and older has increased by 7,922,816,251,426,433,759,354,395,033,600 percent. The number of people aged 570 and older has increased by 15,845,632,502,852,867,518,708,790,067,200 percent. The number of people aged 575 and older has increased by 31,691,265,005,705,735,037,417,580,134,400 percent. The number of people aged 580 and older has increased by 63,382,530,011,411,470,074,835,160,268,800 percent. The number of people aged 585 and older has increased by 126,765,060,022,822,940,149,670,320,537,600 percent. The number of people aged 590 and older has increased by 253,530,120



A close-up photograph of a dark grey, textured surface. The surface is composed of rectangular blocks arranged in a repeating pattern, similar to a brick or tile design. The blocks are dark grey with a slightly rough, matte texture. The lighting is even, highlighting the subtle variations in the material's surface.

06 - PAVERS DRIVEWAY



NOTE:

- **Flat Roof:** The clean, flat roof reflects Mid-Century Modern’s emphasis on simplicity and straight lines, giving the building a sleek, low-profile look.
- **Angled Concrete Columns:** The bold, angled concrete columns add a sculptural and dynamic element, inspired by Mid-Century Modern’s use of strong geometric forms.
- **Large Black-Framed Windows:** Expansive glass windows with black frames emphasize clean, linear aesthetics and create a sharp contrast, enhancing the modern look while connecting indoor and outdoor spaces—a key Mid-Century Modern principle.
- **Neutral Tones & Travertine Stone Accents:** The use of travertine stone introduces natural warmth and texture, aligning with Mid-Century Modern’s preference for organic materials that integrate harmoniously with the surroundings.

This concept reinterprets Mid-Century Modern’s distinct style, combining bold, innovative architecture with materials and details that respect the district’s historic character.



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BELLE COAST GROUP, Inc.

1025 92nd St #701
Bay Harbor Islands, FL 33154
andreu@bellectoast.com
(786) 218-3072

PROJECT:

834 POLK ST
HOLLYWOOD, FL 33019

FOLIO NUMBER: 514214024271

DATE: 11/15/2024

REVISION

DATE:

DRAFTED BY:

SCALE:







CONSULTANTS:

MID-CENTURY
MODERN
INSPIRATIONS

A-504

DRAWN BY:



B.C.

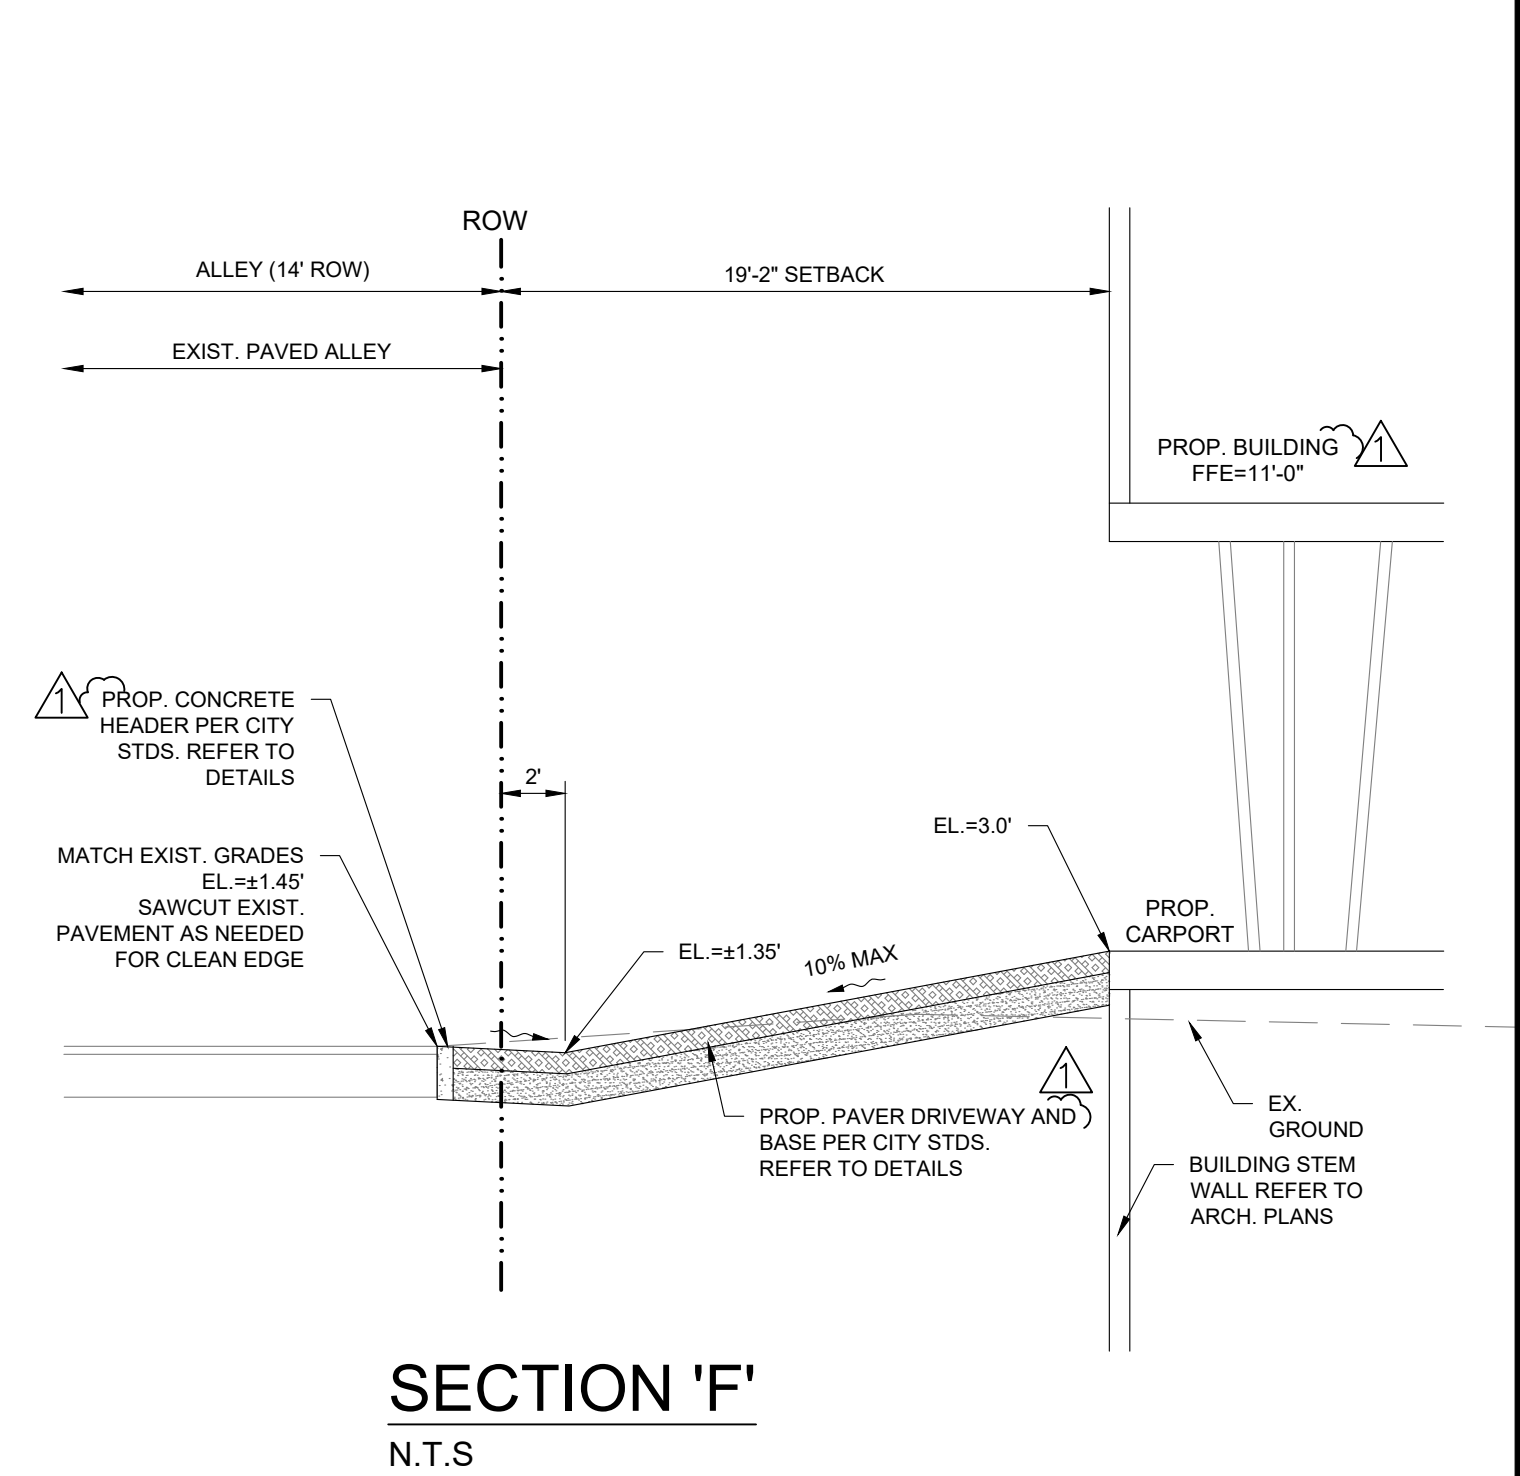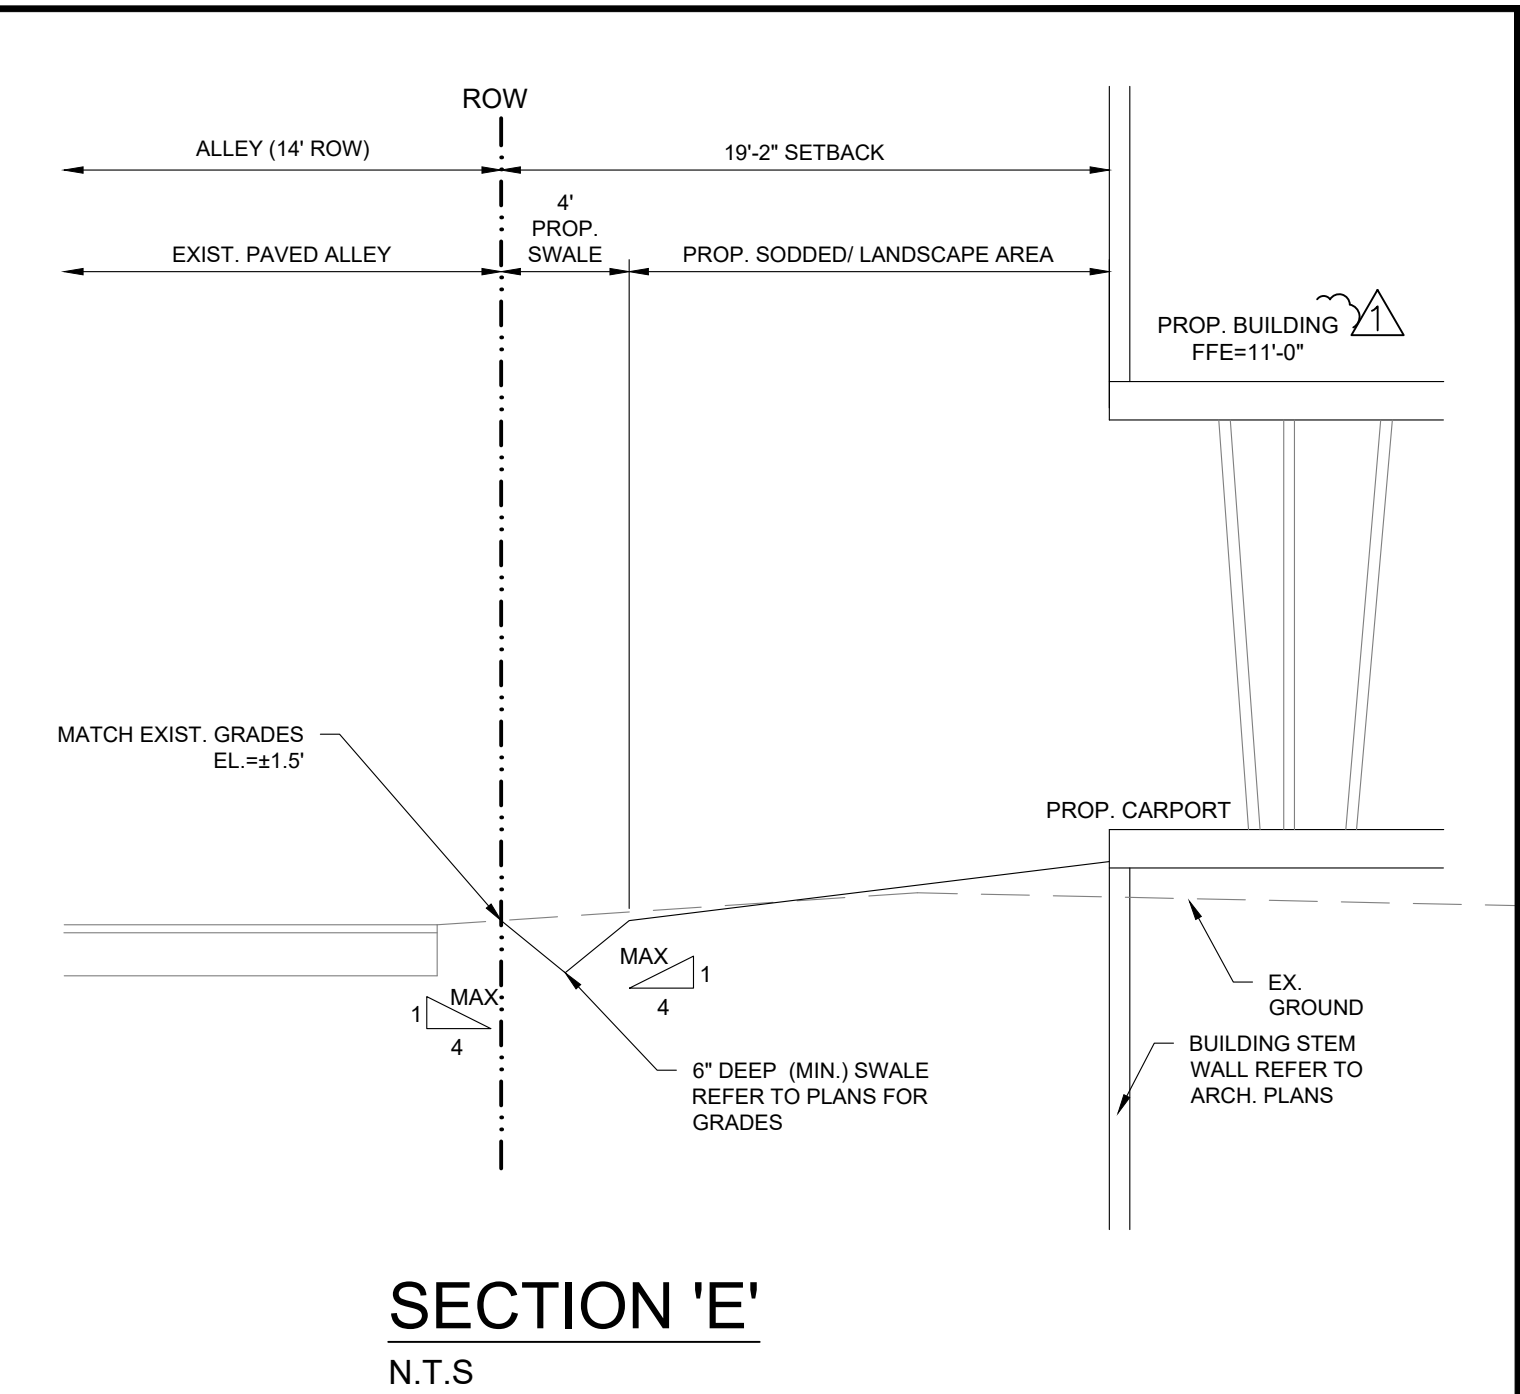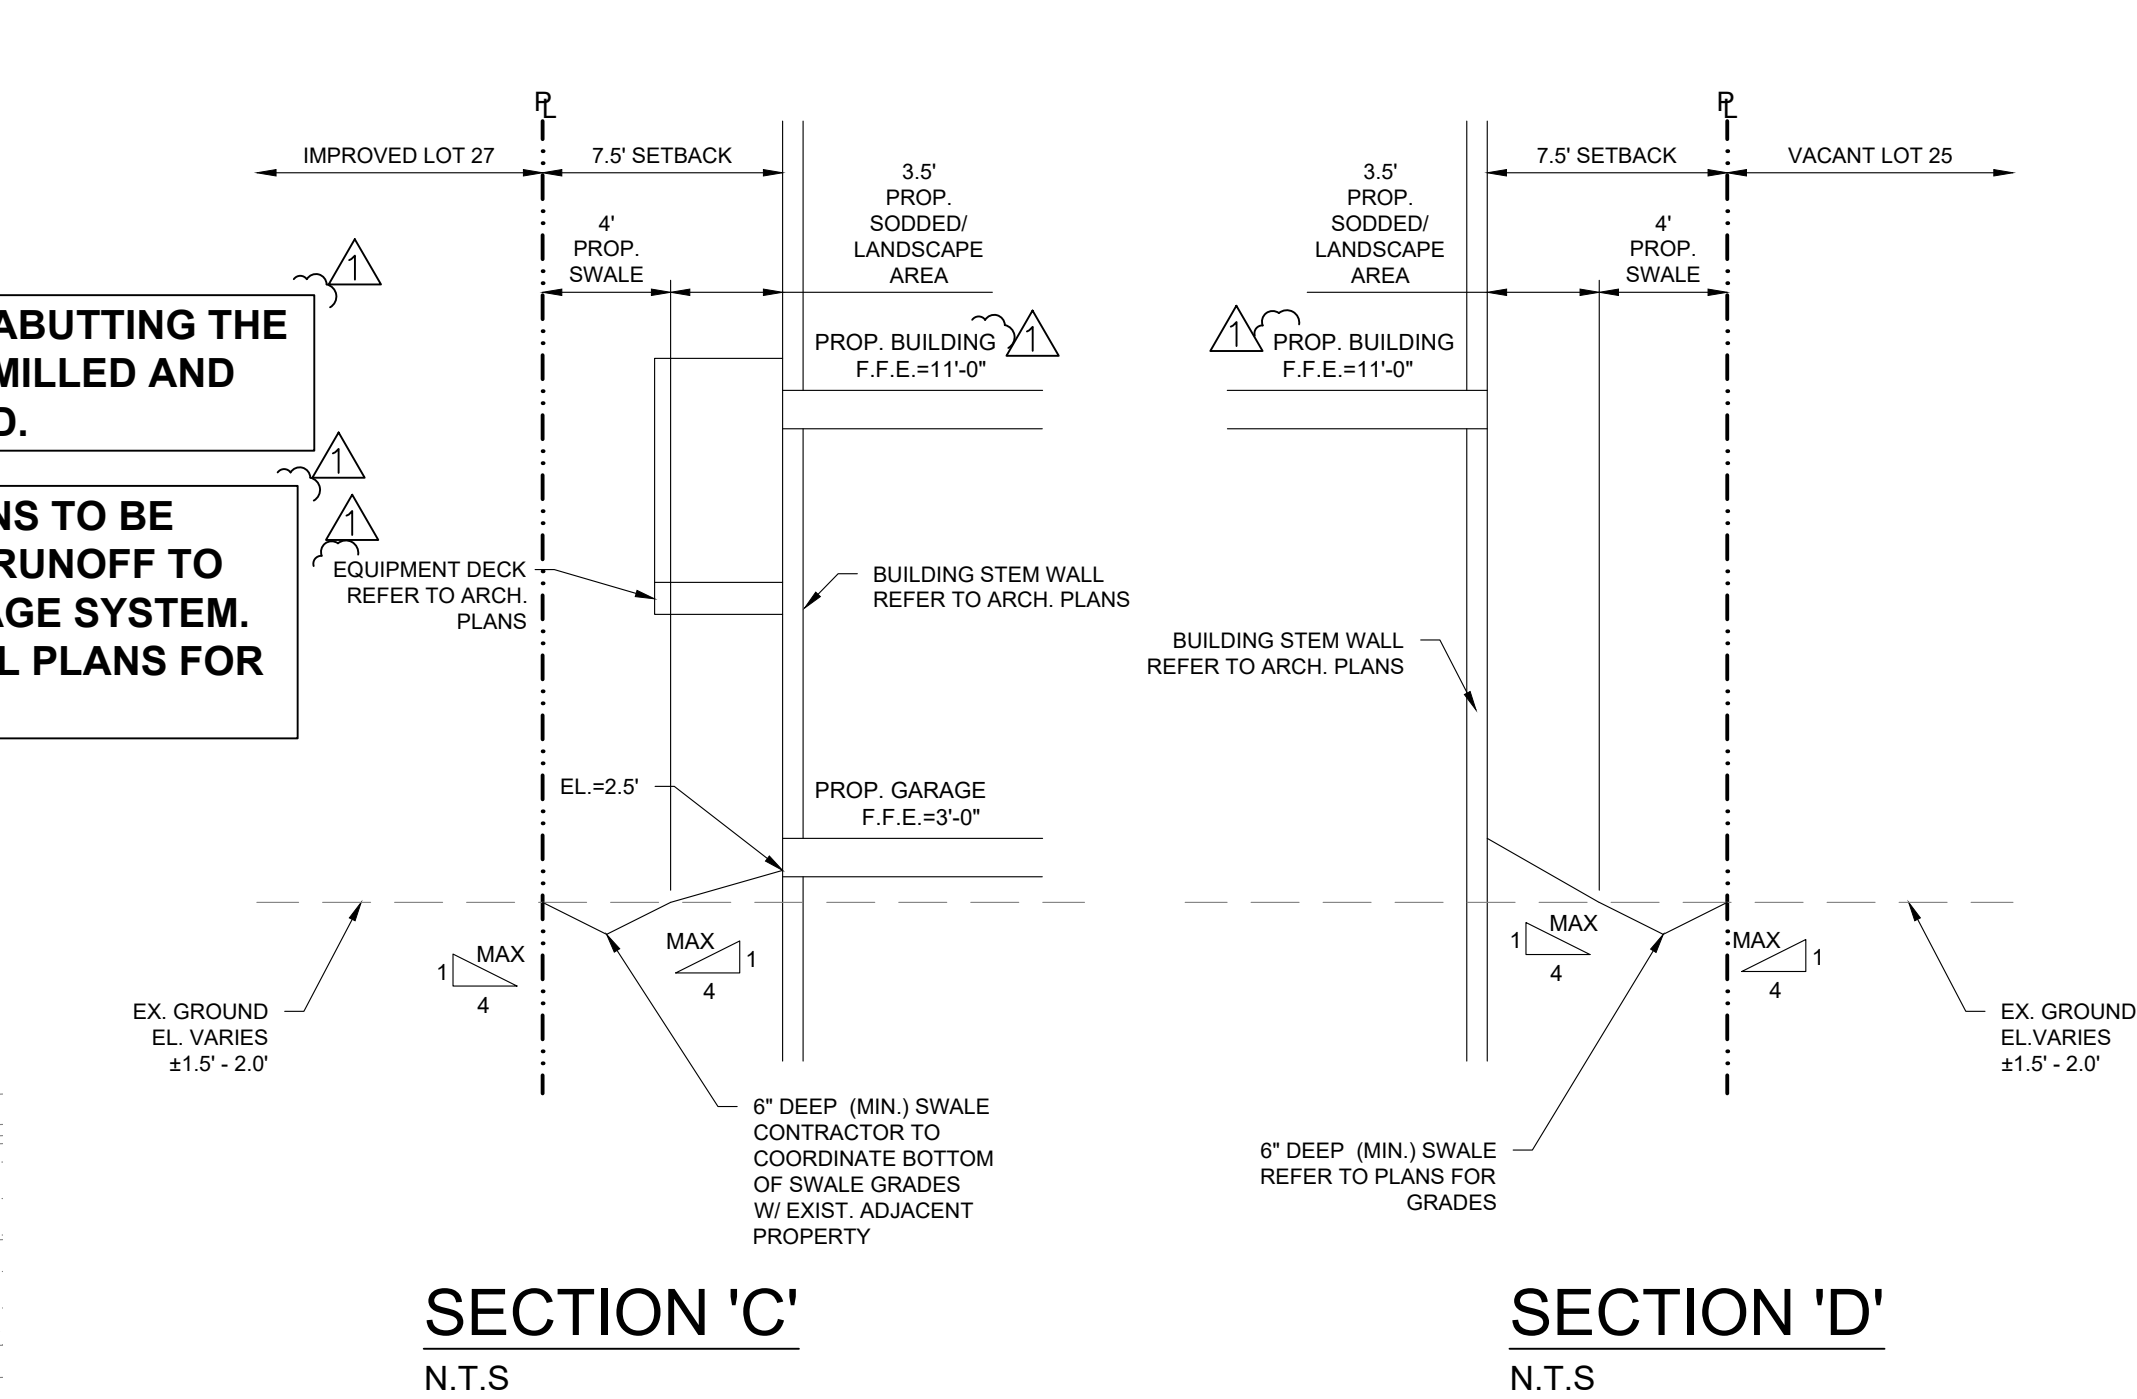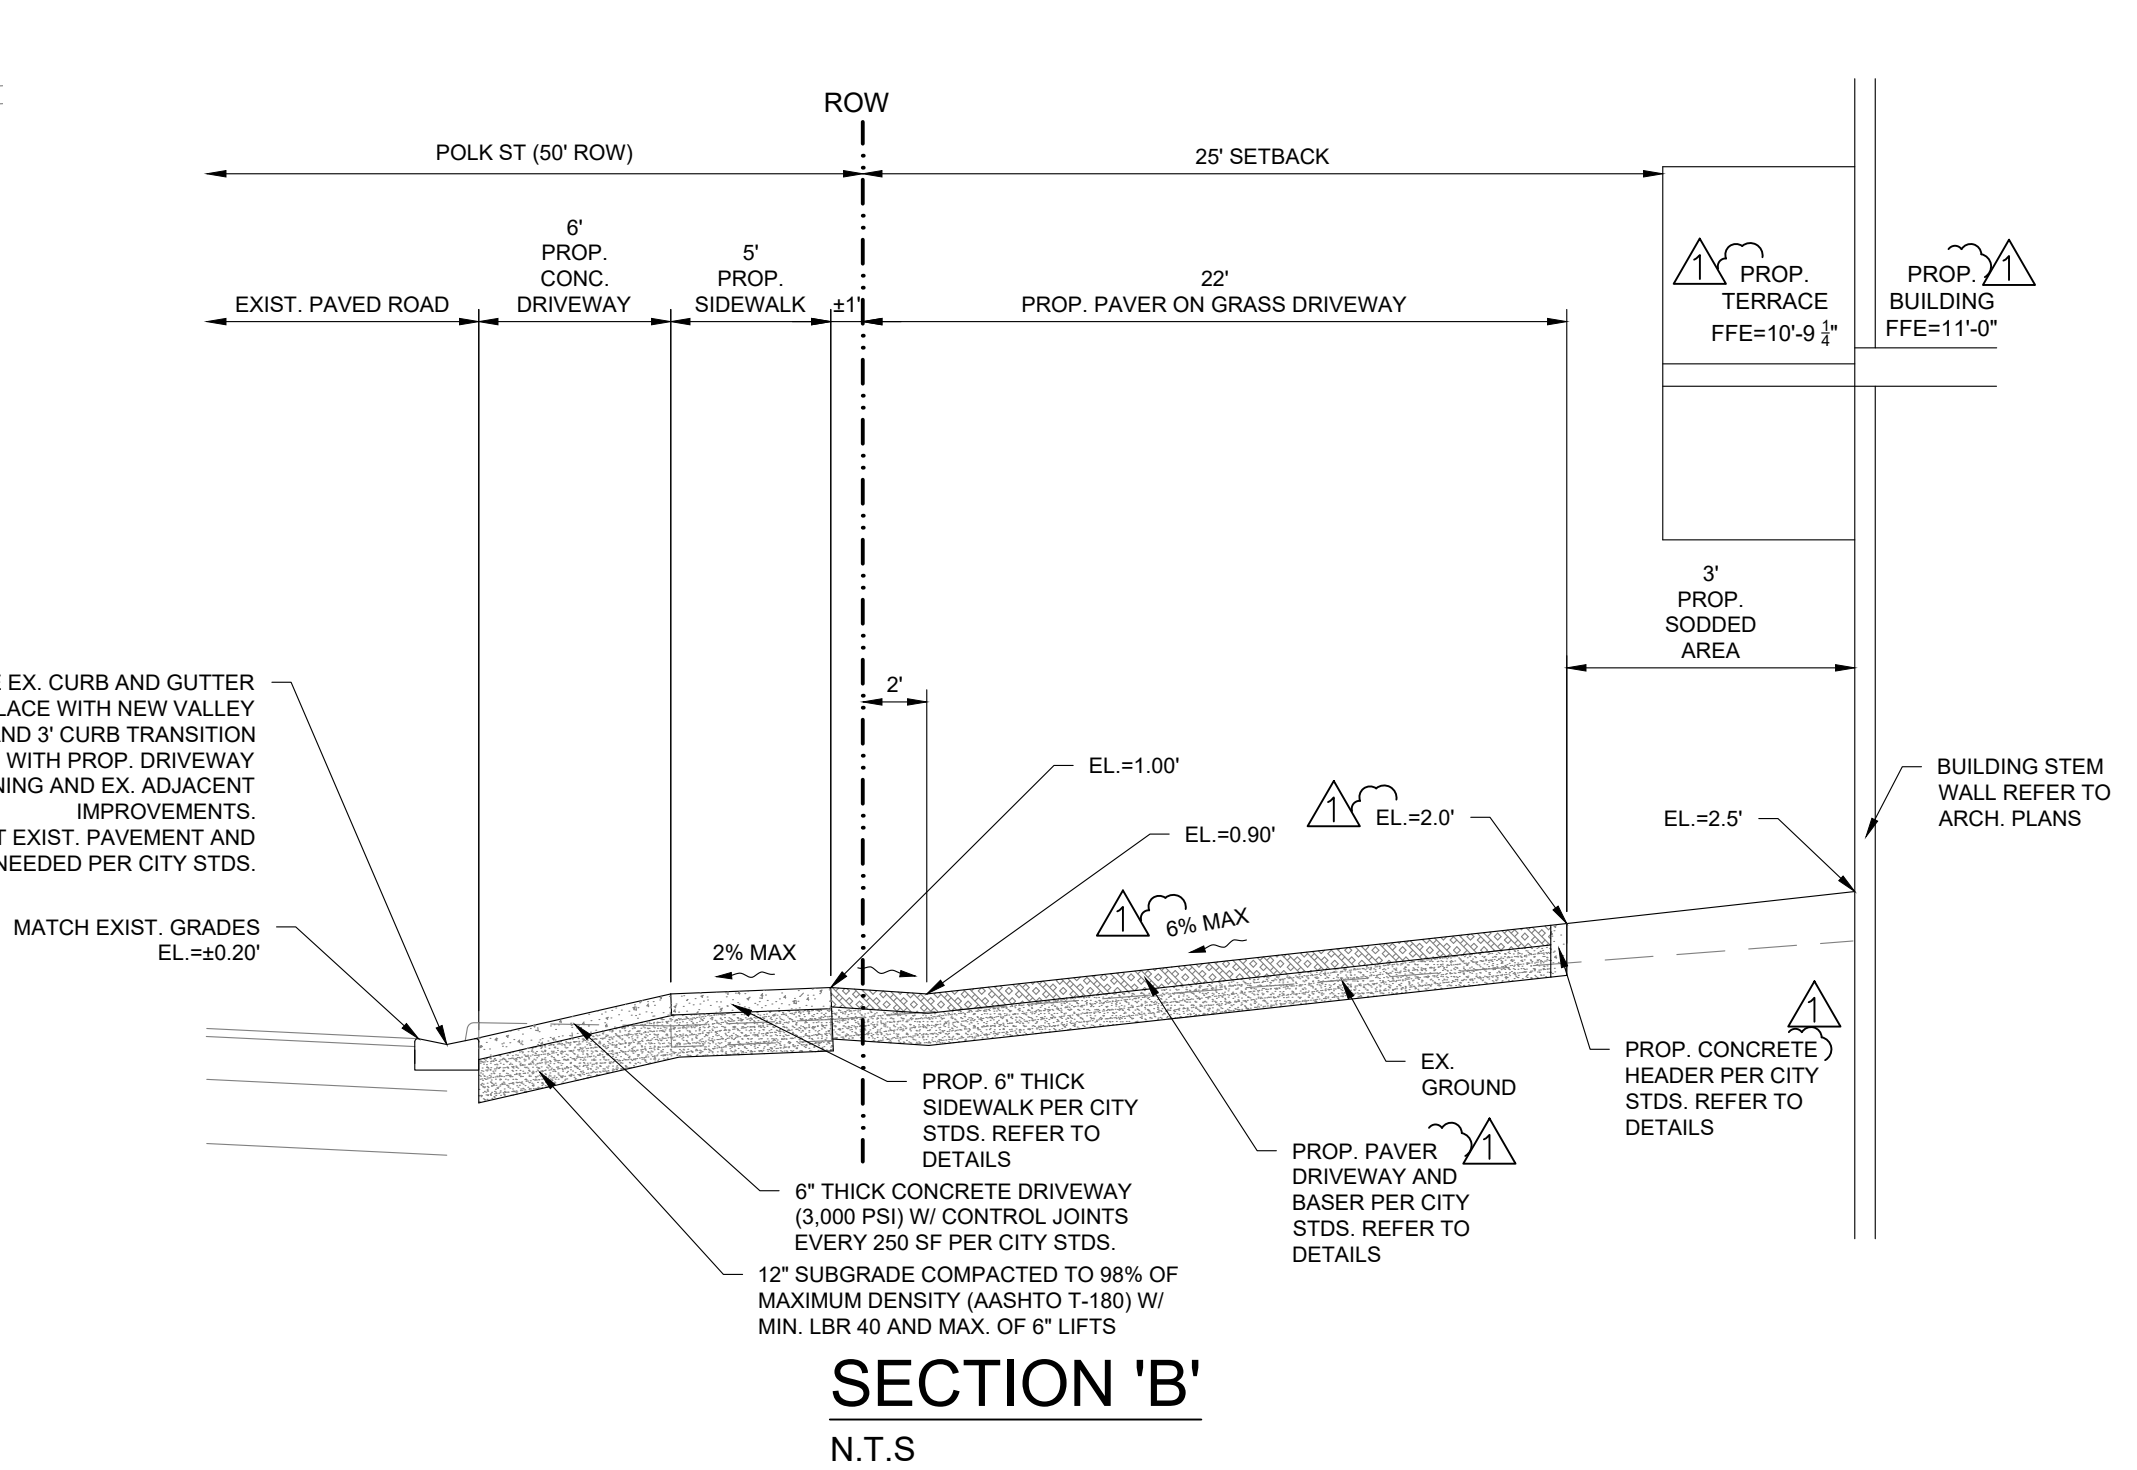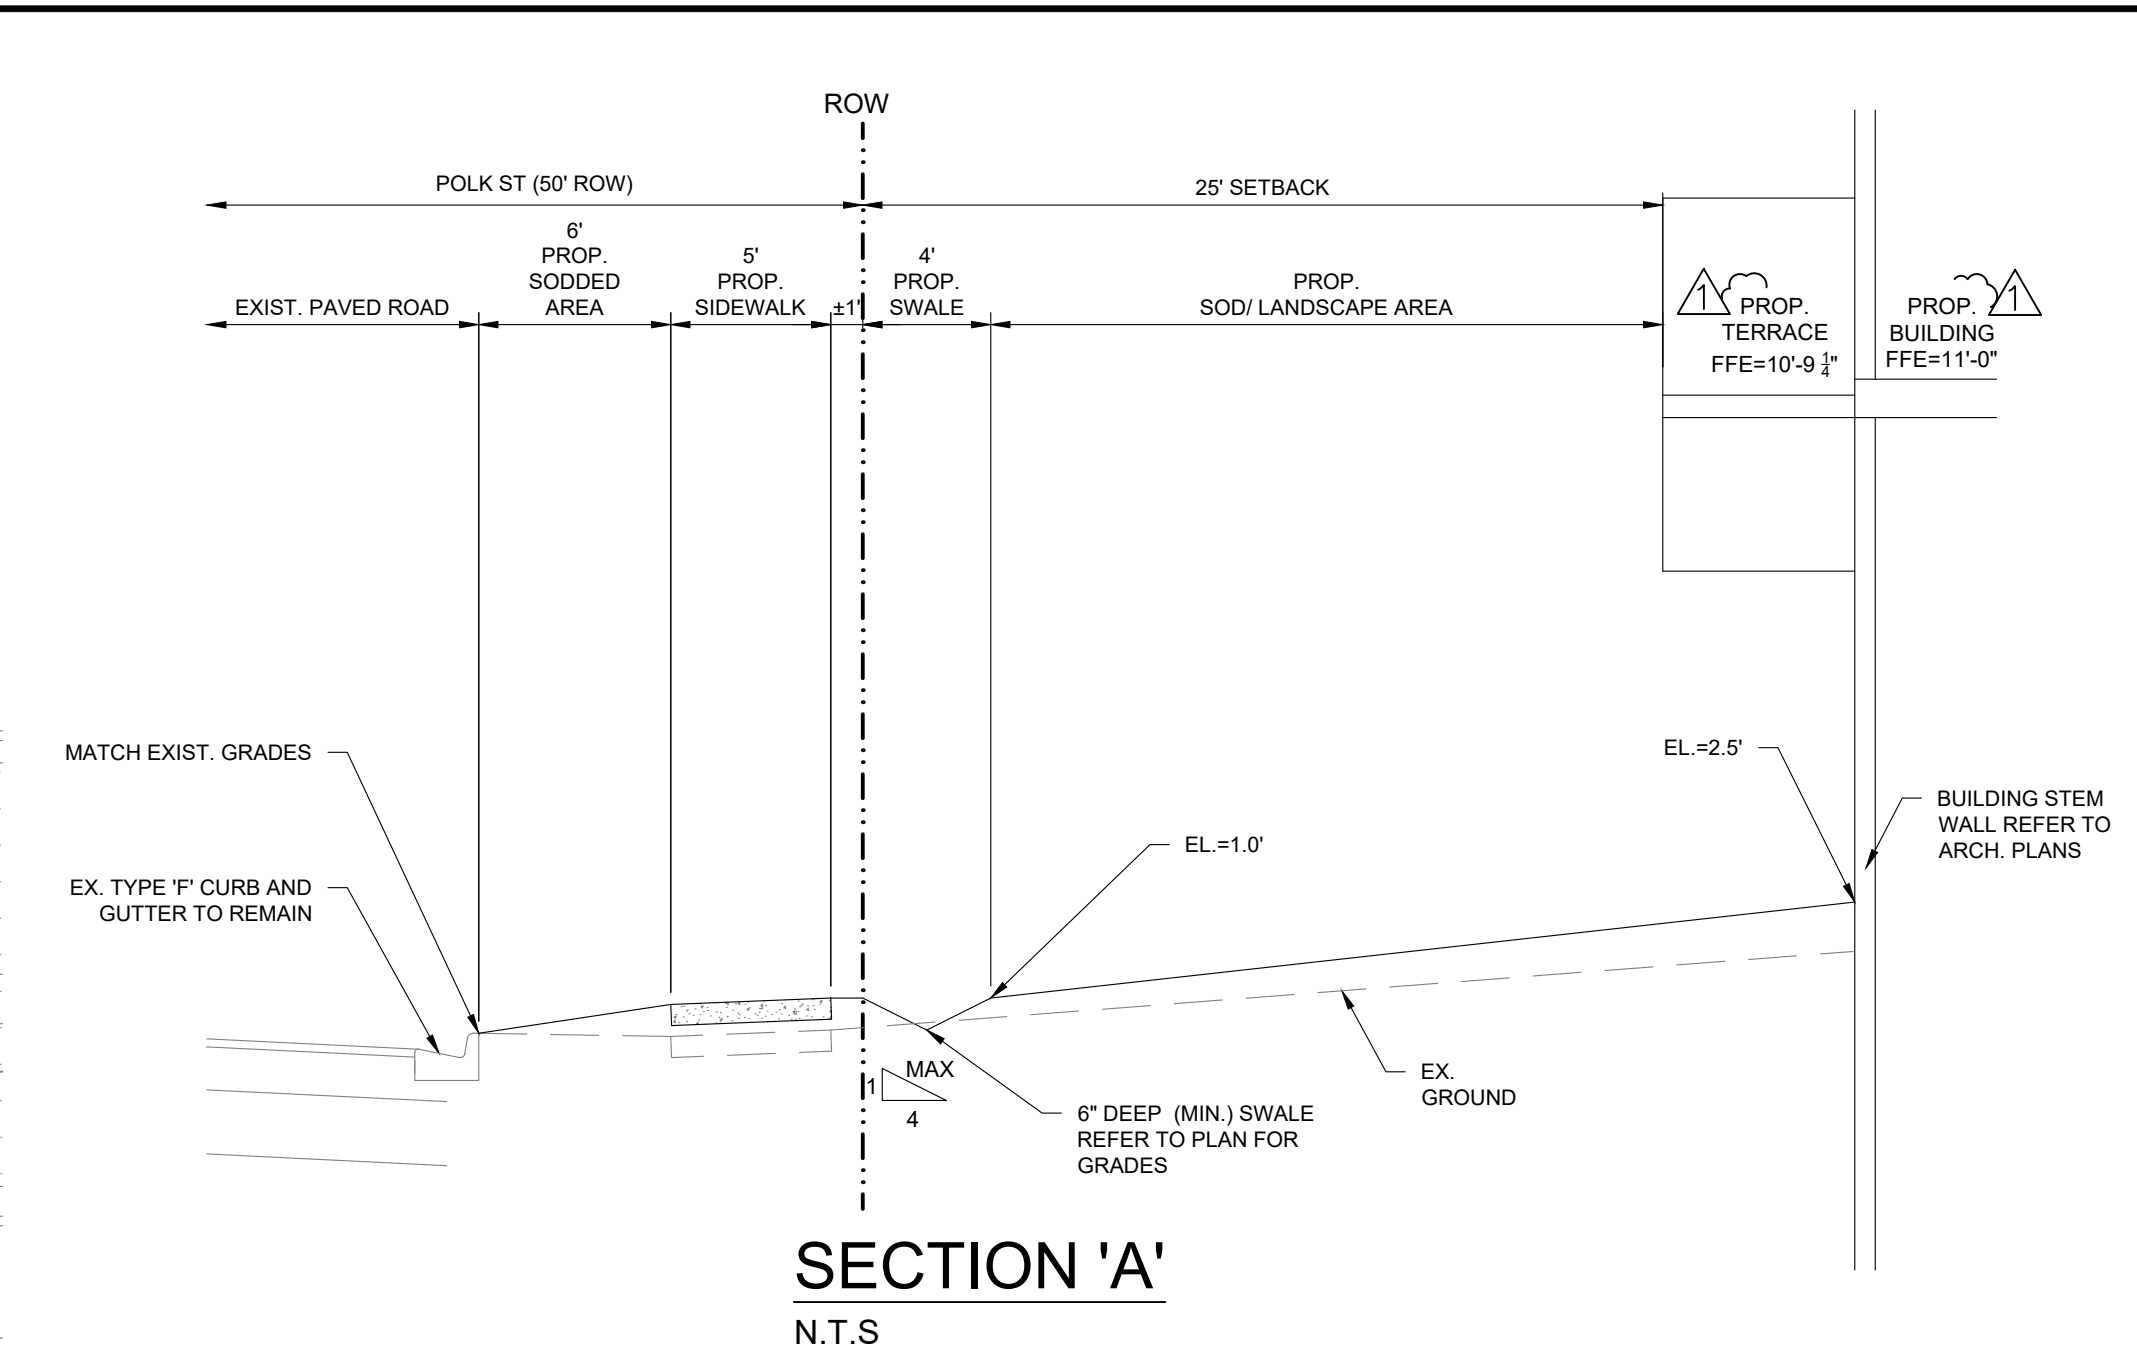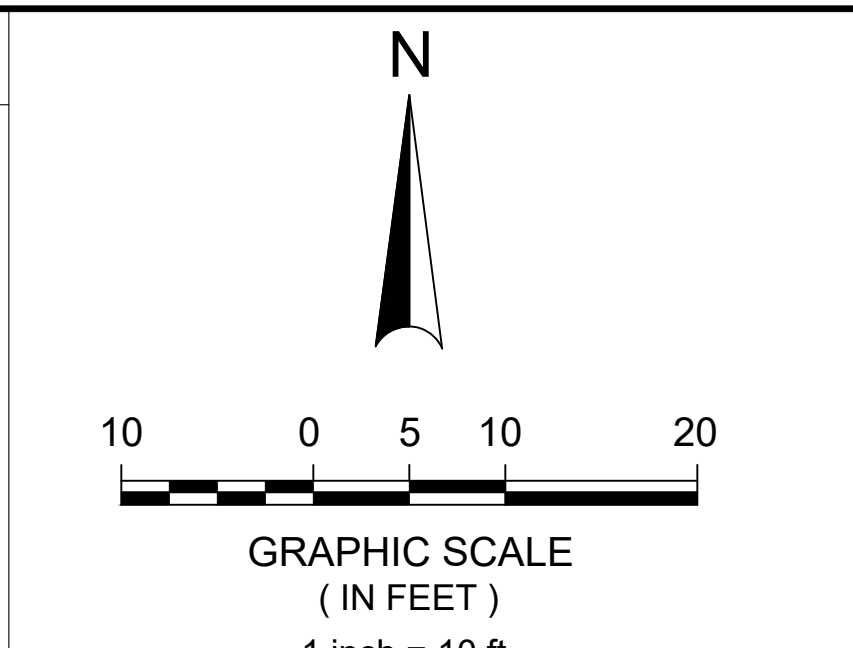

STORMWATER CALCULATIONS				
PROPOSED SITE INFORMATION				
Impervious Area (Ai)	3,600 sf	0.083 ac	Ai%	56%
Roof Area (RA)=	2,921 sf	0.067 ac		
Other Impervious Area (OIA)=	679 sf	0.016 ac		
Pervious Area (Ap)	2,800 sf	0.064 ac	Ap%	44%
Landscape Area (LA)=	2,800 sf	0.064 ac		
Water Area (WA)=	- sf	0.000 ac		
Total Area (A)=	6,400 sf	0.147 ac	A%	100%
% Impervious for Water Quality (%WQ)=	OIA = 19.5%			
	OIA+LA			
SWFMD WATER QUALITY REQUIREMENTS				
Retain the greater runoff volume of:				
1" inch of runoff from the entire site, or	1"xA= 0.147 ac-in	533 ft ³		
2.5 inches times the percentage of imperviousness	2.5"x%WQxA= 0.072 ac-in	260 ft ³		
WQ Volume required (wet retention) =	533 ft³			
WQ Volume required (dry retention) = 50% wet retention	267 ft³			
PROPOSED RETENTION AREAS				
Swales 1 and 2				
Area (A)	1228.0 sf			
Depth (D)	0.5 ft			
Volume= (AxD)/2	307 ft³			
Total Volume Provided=	307 ft³			
The required dry retention volume will be provided within the proposed swales.				

ALL EXISTING/PROPOSED ELEVATIONS
SHOWN ARE BASED ON NAVD 1988

Drawing name: C:\Catarina Engineering\00_Projects\26_Yoarm Andreu\03 824 Polk St - Hollywood\CAD\24-026-03-CP-Paving Grading and Drainage Plans.dwg C-3.1 lot 26 Nov 15, 2024 12:23pm by: eneli

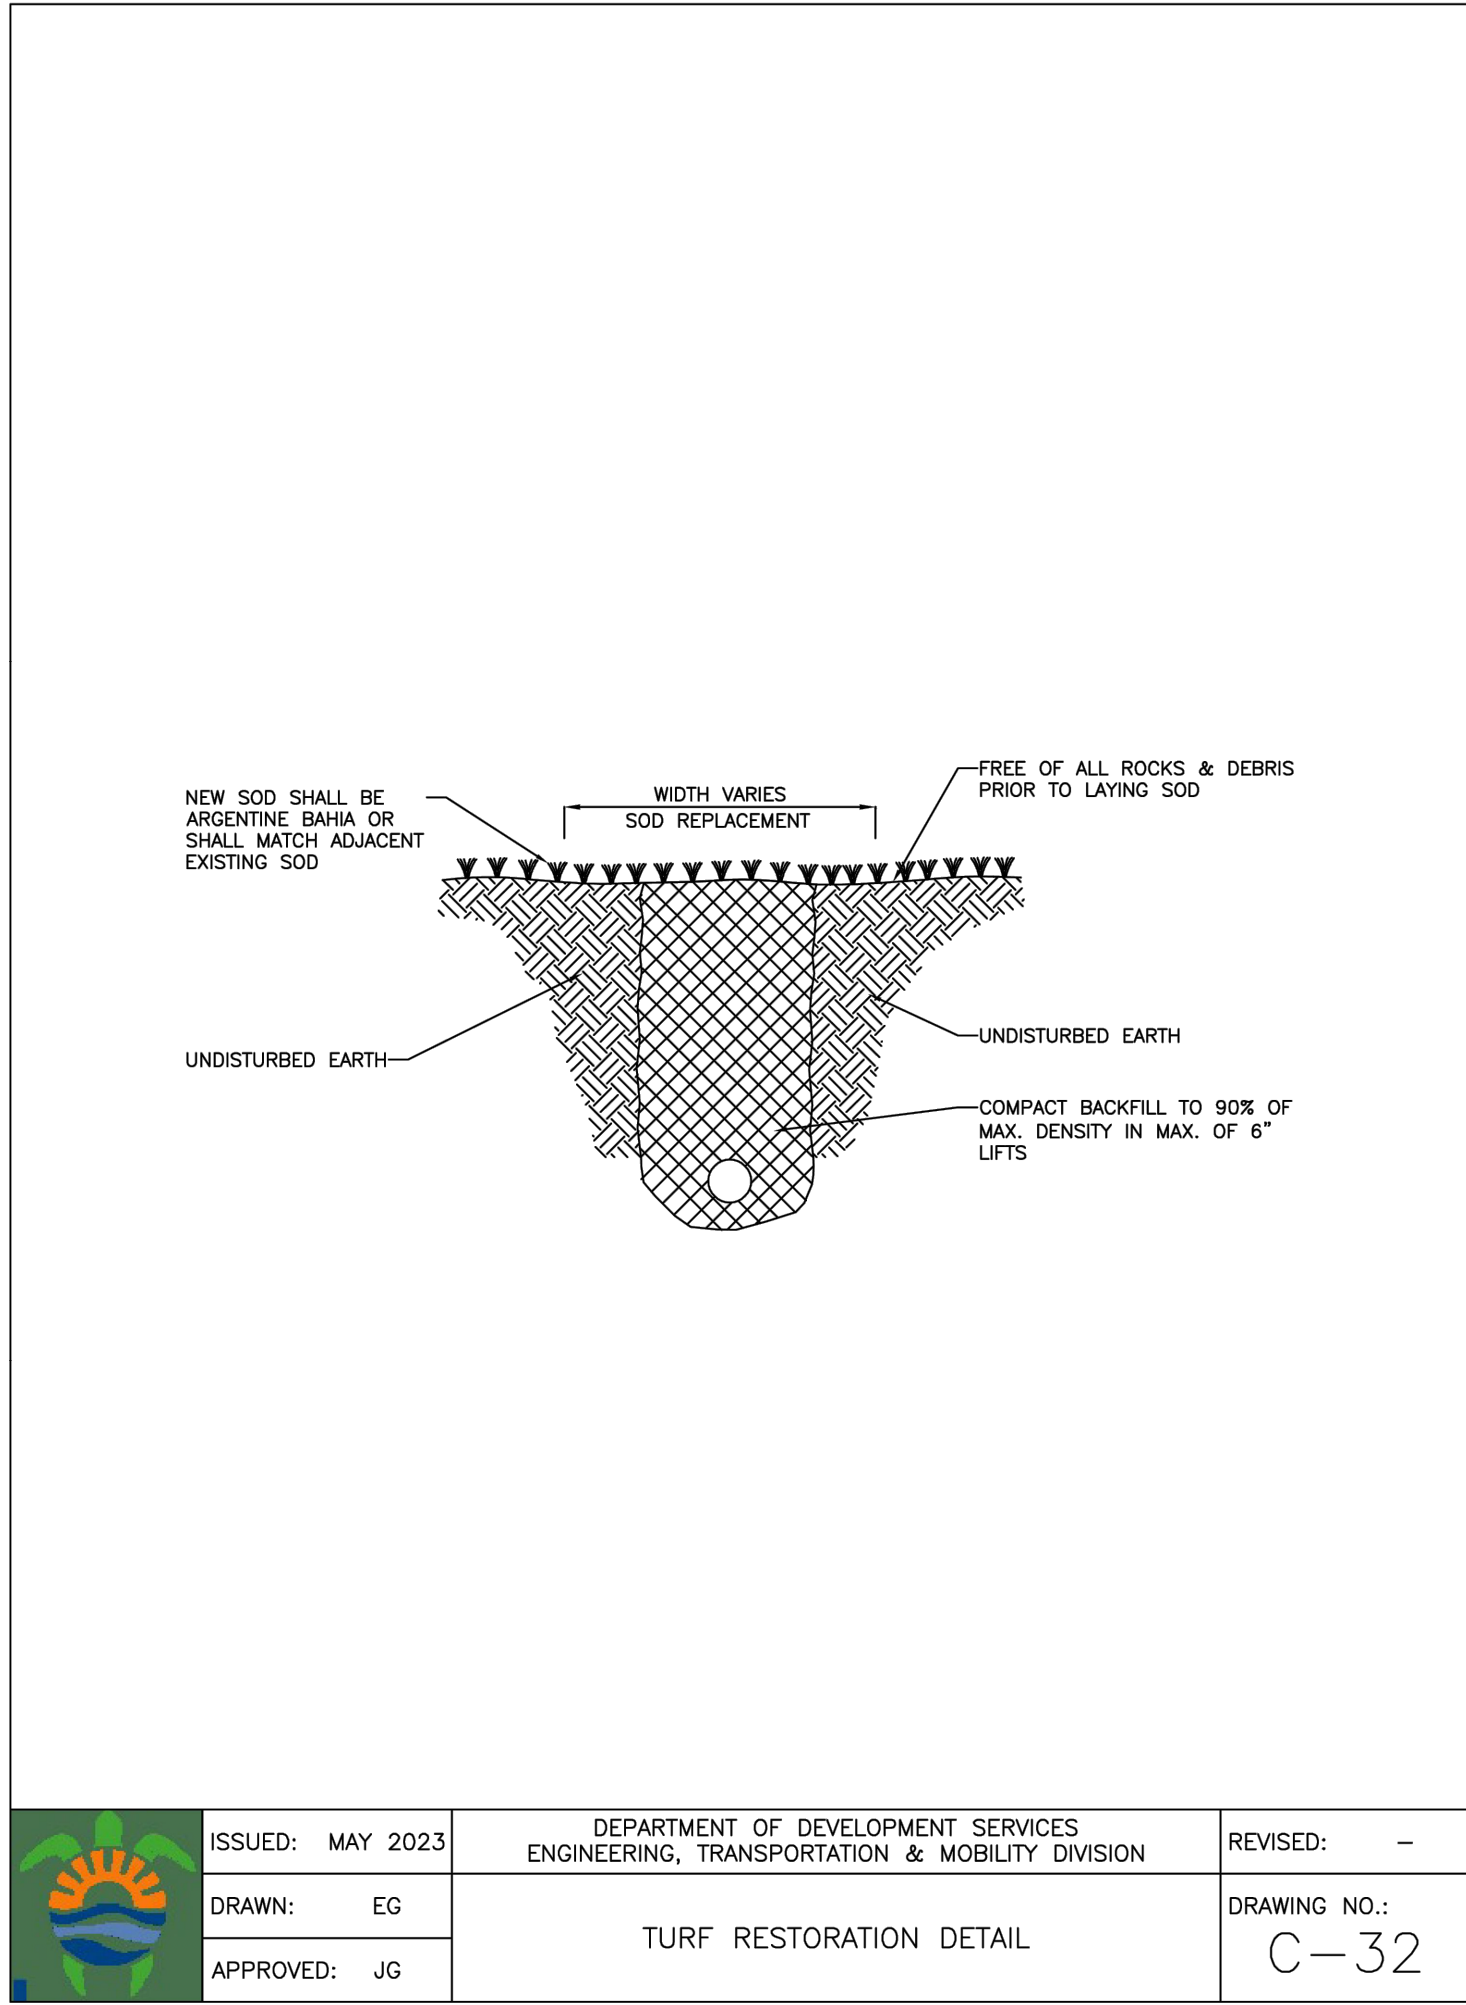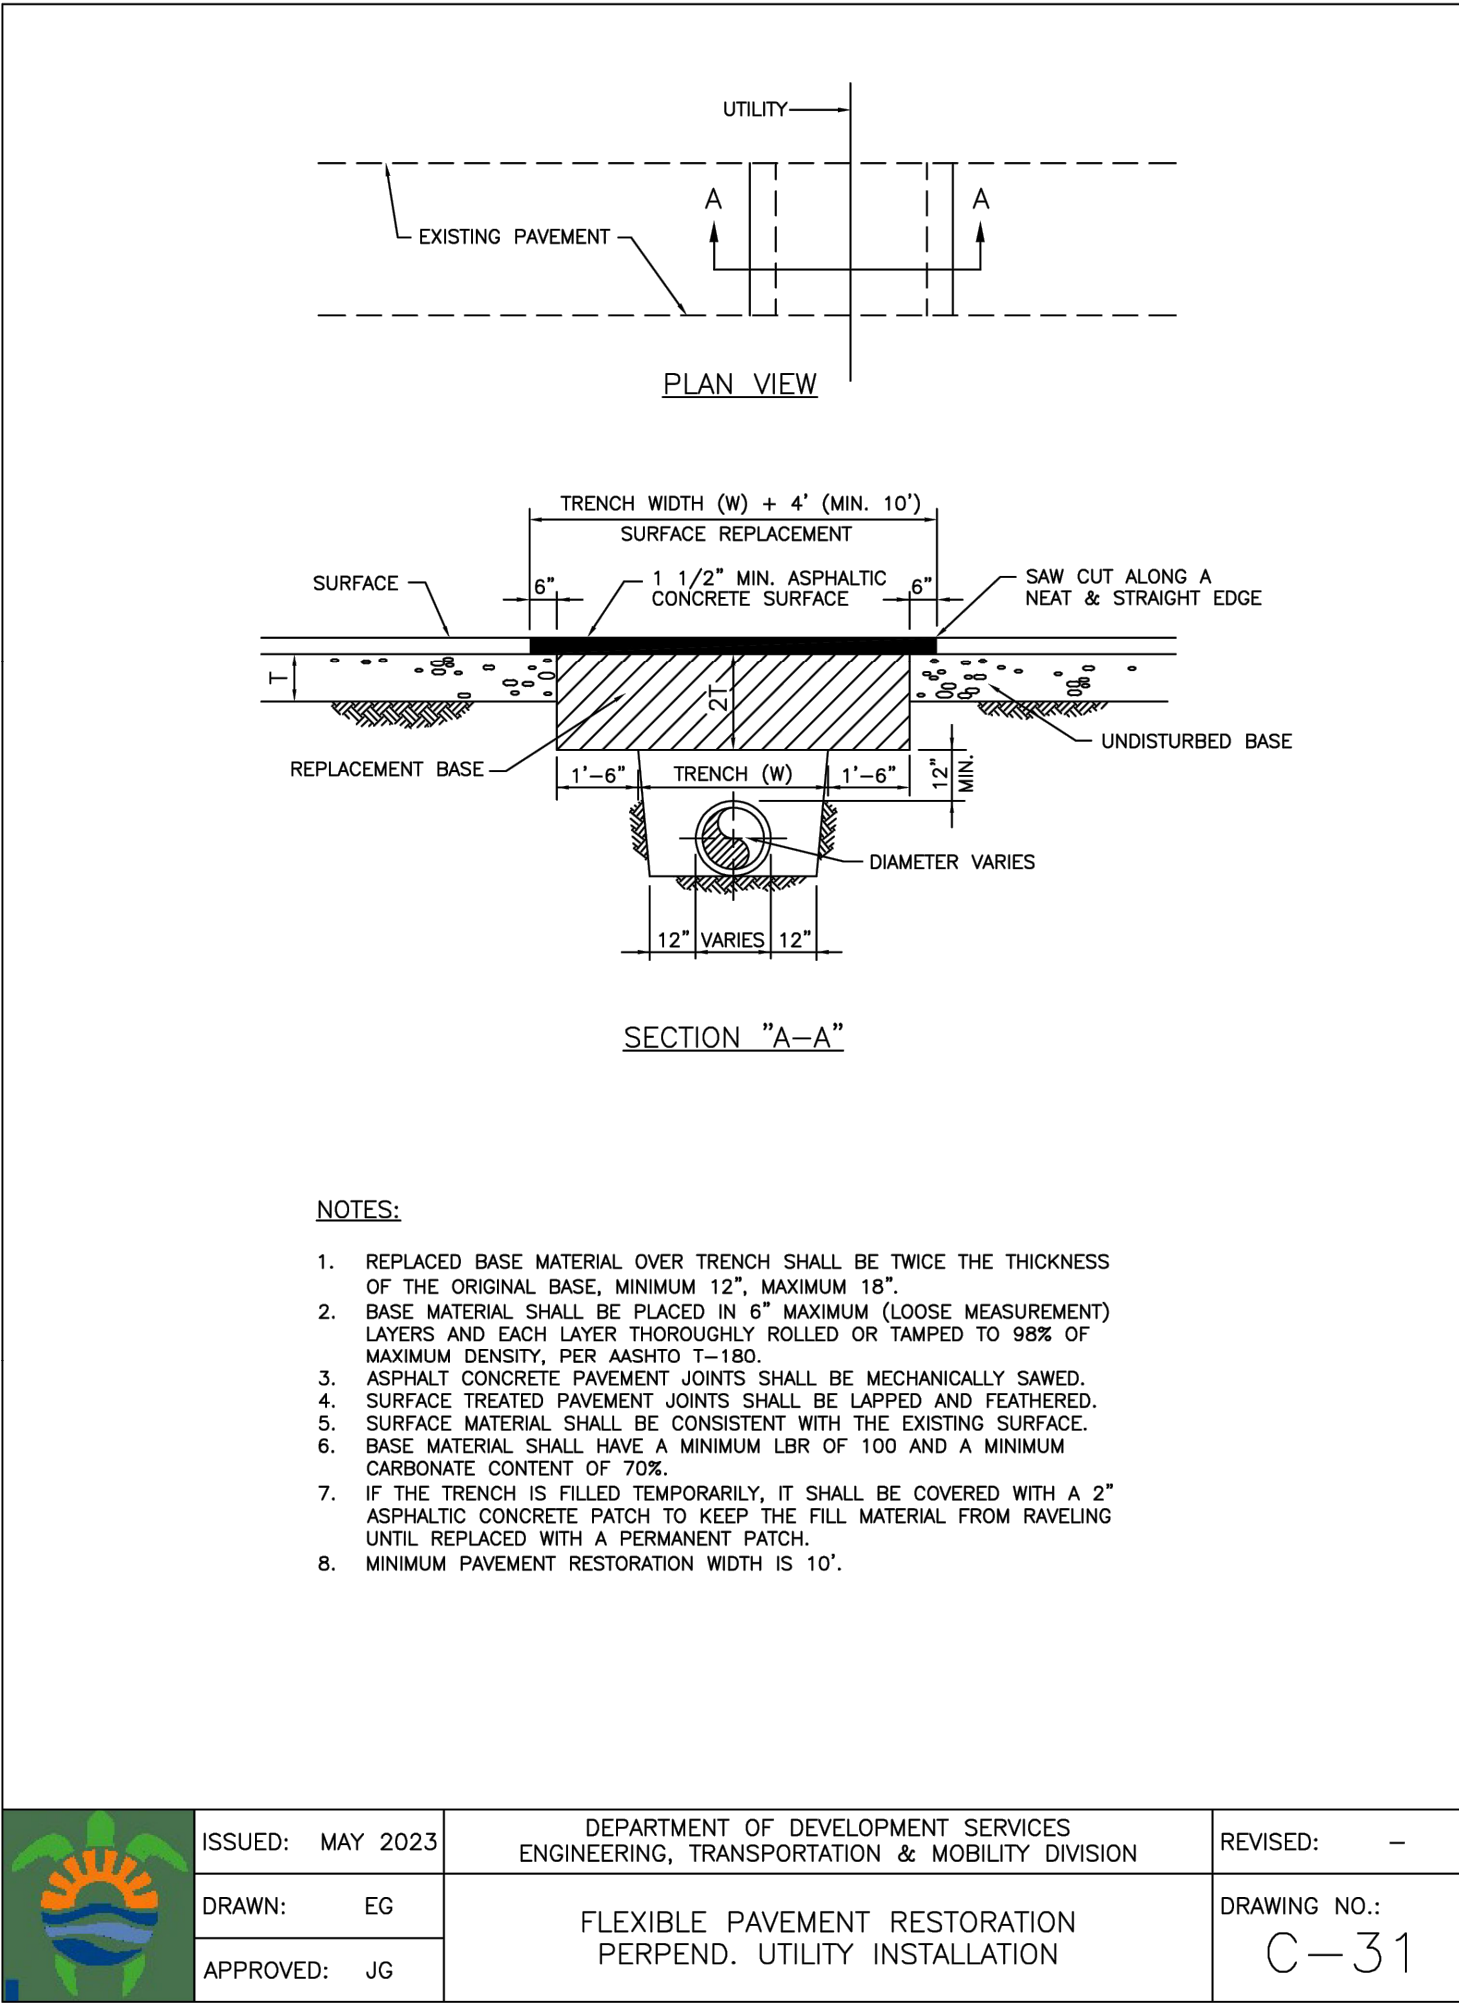

CATARINA
ENGINEERING

Fort Lauderdale, FL
(561) 929-0876
emichaels@catarinaengineering.com

ENELISE L. MICHAELS, P.E.
FLORIDA LICENSE # 84162

This item has been digitally signed and sealed by Enelise L. Michaels, P.E., on the date above.
Printed copies of this document are not considered signed and sealed and the signature must be verified on any electronic copies.

Client:

**BELLE
COAST**

Project Name and Address:

CUSTOM HOME

834 POLK ST
LOT 26
CITY OF HOLLYWOOD
BROWARD COUNTY

Rev.	Date	Description
△	CITY COMMENTS	10/31/2024

Sheet Title:

**CONSTRUCTION
NOTES AND
DETAILS**

CONSTRUCTION DRAWINGS

Date: 08/08/24

Scale: AS NOTED

Drawn by: EM



Designed/ Approved by: EM

Project Number: 24-026-03

Sheet Number:

C-3.1

1. THE ABOVE DETAILS APPLY ONLY TO ASPHALT PAVEMENT RESTORATION OVER UTILITY TRENCHES CUT WITHIN CITY OF HOLLYWOOD RIGHTS-OF-WAY. FOR PAVEMENT RESTORATION WITHIN BROWARD COUNTY OR FDOT RIGHTS-OF-WAY REFER TO THE CORRESPONDING DETAILS FOR THOSE AGENCIES.
2. LIMEROCK BASE MATERIAL SHALL HAVE A MINIMUM L.B.R. OF 100 AND A MINIMUM CARBONATE CONTENT OF 70%. REPLACED BASE MATERIAL OVER TRENCH SHALL BE A MINIMUM OF 12" THICK.
3. LIMEROCK BASE MATERIAL SHALL BE PLACED IN 12" MAXIMUM (LOOSE MEASUREMENT) THICKNESS LAYERS WITH EACH LAYER THOROUGHLY ROLLED OR TAMPED AND COMPACTED TO 100% OF MAXIMUM DENSITY, PER AASHTO T-180, PRIOR TO THE PLACEMENT OF THE SUCCEEDING LAYERS.
4. STABILIZED SUBGRADE MATERIAL SHALL BE GRANULAR AND SHALL HAVE A MINIMUM L.B.R. OF 40.
5. BACKFILL SHALL BE PLACED AND COMPACTED IN ACCORDANCE WITH THE PIPE LAYING CONDITION TYPICAL SECTIONS IN DETAILS G-02 AND G-03, AND THE SPECIFICATIONS, BUT TESTING WILL BEGIN 12" ABOVE THE INSTALLED FACILITY.
6. ALL EDGES AND JOINTS OF EXISTING ASPHALT PAVEMENT SHALL BE SAW CUT TO STRAIGHT LINES, PARALLEL TO OR PERPENDICULAR TO THE ROADWAY, PRIOR TO THE RESURFACING.
7. RESURFACING MATERIAL SHALL BE FDOT SUPERPAVE, AND SHALL BE APPLIED A MINIMUM OF TWO INCH IN THICKNESS.
8. MILL AND BUTT JOINT TO EXISTING PAVEMENT.
9. IF THE TRENCH IS FILLED TEMPORARILY, IT SHALL BE COVERED WITH A 2" ASPHALTIC CONCRETE PATCH TO KEEP THE FILL MATERIAL FROM RAVELING UNTIL REPLACED WITH A PERMANENT PATCH.
10. REFER TO SPECIFICATIONS FOR DETAILED PROCEDURES.
11. WHERE THE UTILITY TRENCH CROSSES EXISTING ASPHALT DRIVEWAYS, THE LIMEROCK BASE THICKNESS MAY BE A MINIMUM OF 6 INCHES THICK. REGARDLESS OF THE EXTENT OF IMPACT, THE ENTIRE DRIVEWAY SURFACE BETWEEN THE EDGE OF THE ROADWAY PAVEMENT AND PROPERTY LINE OR FRONT OF SIDEWALK SHALL BE OVERLAID USING 2-INCH THICK MINIMUM ASPHALTIC CONCRETE SURFACE COURSE WHERE INDICATED ON THE PLANS OR AS DIRECTED BY THE CITY/ENGINEER.

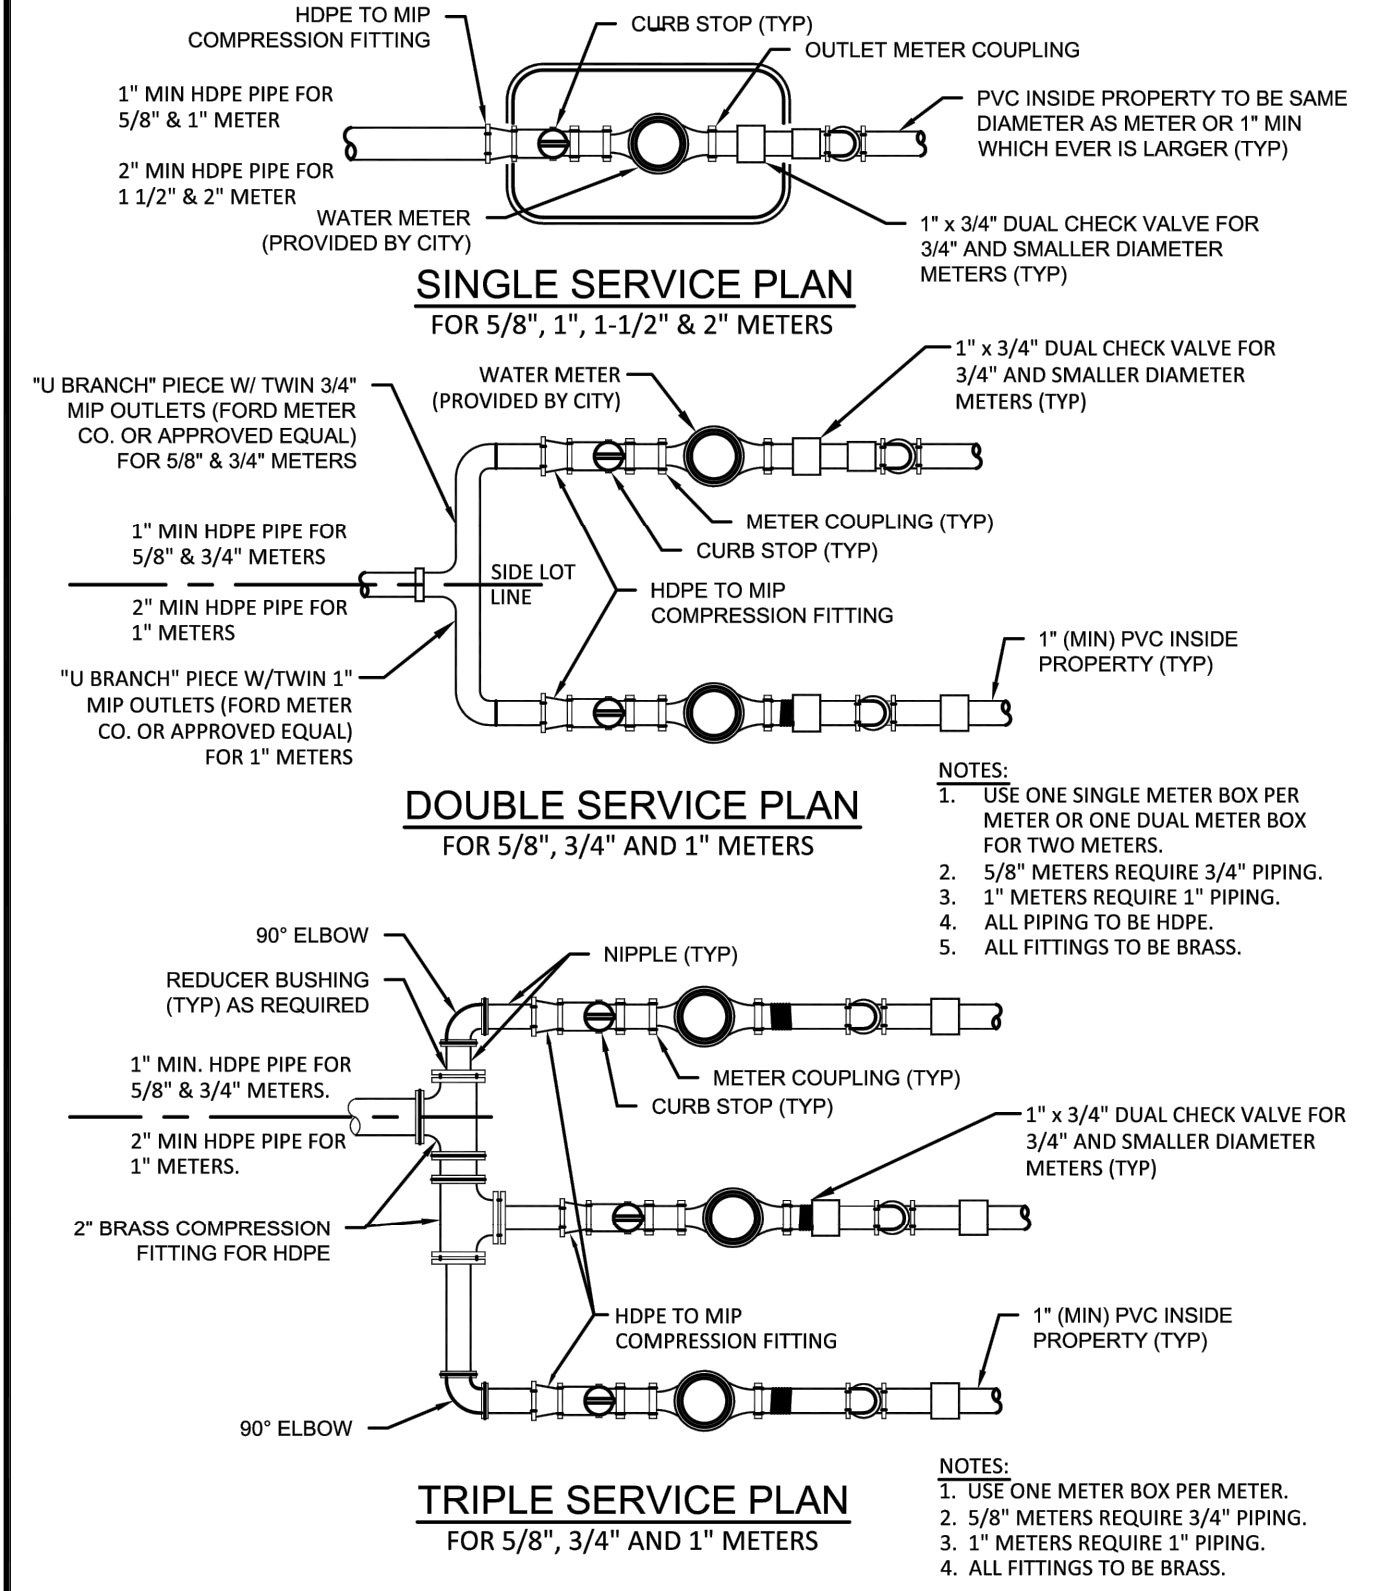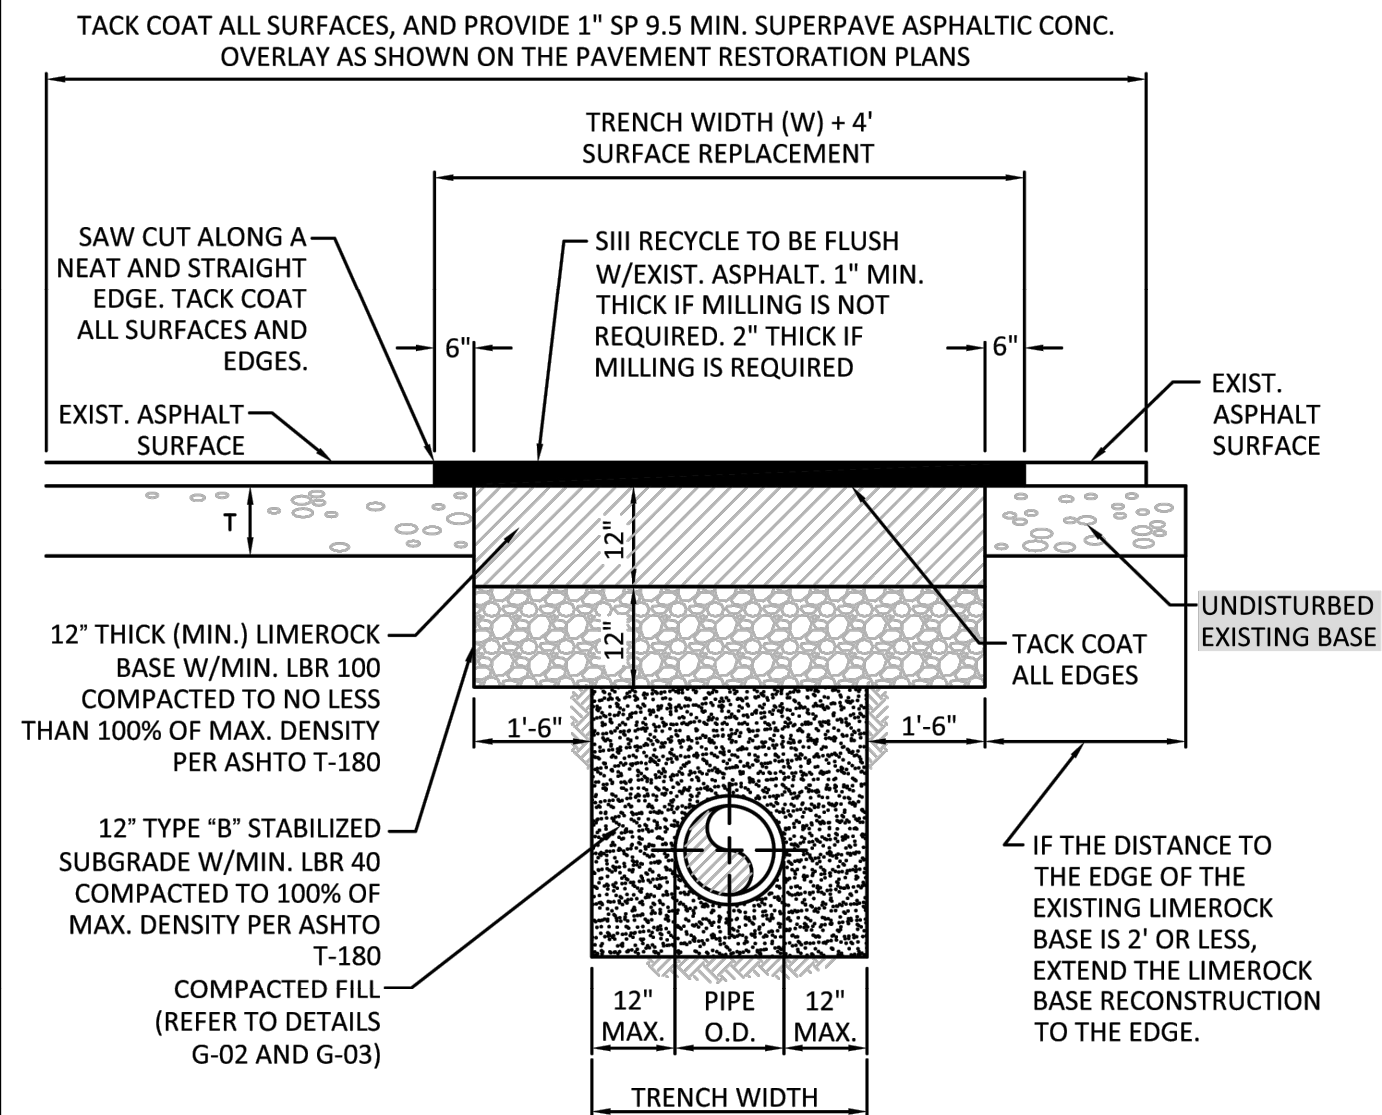

3. SUCCESSIVE TAPS INTO THE WATER MAIN SHALL BE SPACED NOT LESS THAN 18" ON CENTER.
2. P. E. TUBING SHALL BE IN ACCORDANCE WITH THE LATEST EDITION OF AWWA STANDARD C901, "POLYETHYLENE (PE) PRESSURE PIPE AND TUBING, 1/2 IN. (13mm) THROUGH 3 IN. (76 mm), FOR WATER SERVICE".
3. MINIMUM SERVICE PIPE DIAMETER SHALL BE 1" FOR SINGLE OR DUAL 3/8" OR SINGLE 1" DIAMETER METERS.
4. MINIMUM SERVICE PIPE DIAMETER SHALL BE 2" FOR SINGLE OR DUAL 1-1/2" OR SINGLE 2" DIAMETER METERS.
5. FOR METER DIAMETERS LARGER THAN 2", THE MINIMUM SERVICE PIPE DIAMETER SHALL BE THE SAME AS THE METER DIAMETER.
6. APPROVED COPPER TUBING MAY BE USED AT THE CITY'S DISCRETION.
7. FOR NEW METER INSTALLATIONS, ALL SADDLES, VALVES, PIPING, FITTINGS, CURB STOPS, METER VALVES, METER COUPLINGS, METER VAULTS AND COVERS SHALL BE FURNISHED AND INSTALLED BY THE CONTRACTOR. THE WATER METERS WILL BE PROVIDED AND INSTALLED BY THE CITY OF HOLLYWOOD (NEW ACCOUNTS).
8. FOR METER RELOCATIONS, ALL SADDLES, VALVES, PIPING, FITTINGS, CURB STOPS, METER VALVES, METER COUPLINGS, METER VAULTS AND COVERS SHALL BE FURNISHED AND INSTALLED BY THE CONTRACTOR. THE EXISTING WATER METER TO BE RELOCATED AND INSTALLED BY CONTRACTOR.
9. FOR EXISTING METERS ABUTTING THE RIGHT-OF-WAY THAT ARE BEING DISCONNECTED FROM EXISTING MAINS AND RECONNECTED TO NEW MAINS, THE CONTRACTOR SHALL:
 - a. CUT AND PLUG THE EXISTING SERVICE LINE AT THE MAIN AND AT THE METER, AND REMOVE THE EXISTING BALL VALVE CURB STOP.
 - b. FURNISH AND INSTALL SERVICE SADDLE, CORPORATION STOP OR SERVICE VALVE AND VALVE BOX, PIPING AND FITTINGS UP TO AND INCLUDING THE BALL VALVE CURB STOP.
12. THE ELEVATION AT THE TOP OF THE METER BOX SHALL MATCH THE ELEVATION OF THE BACK OF SIDEWALK, WHENEVER PRACTICAL.
13. AS PART OF THE SERVICE INSTALLATION, THE CONTRACTOR SHALL RESTORE THE RIGHT-OF-WAY TO MATCH EXISTING CONDITIONS, INCLUDING ROADWAY PAVEMENT, PAVEMENT MARKINGS AND RPMs, CONCRETE CURBS, SIDEWALKS, RAMPS (INCLUDING DETECTABLE WARNING SURFACE), SODDING, AND ALL OTHER IMPROVEMENTS REMOVED OR DAMAGED DURING THE SERVICE INSTALLATION.
14. FOR UNPAVED AREAS, THE MINIMUM GROUND COVER ACCEPTED BY THE CITY IS SODDING.



ENELISE L. MICHAELS, P.E.
FLORIDA LICENSE # 84162

This item has been digitally signed
and sealed by Enelise L. Michaels,
P.E., on the date above.

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and the signature must be verified or
any electronic copies.

Client:

BELLE
COAST

Project Name and Address:

CUSTOM HOME

834 POLK ST

LOT 26

CITY OF HOLLYWOOD

BROWARD COUNTY

[illegible]

Sheet Title:

CONSTRUCTION NOTES AND DETAILS

CONSTRUCTION DRAWINGS

Date: 08/08/24

Scale: AS NOTED


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Designed/ Approved by: EM

Project Number: 24-026-03


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C-4



26: NO ADDITIONAL DISPOSITION FEE
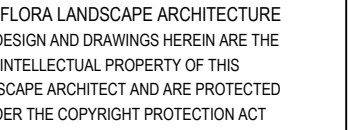
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Date: 2024.11.18 14:25:08 -05'00'

Sheet Description:

**TREE
DISPOSITION
PLAN**

Release Date:


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2024-15


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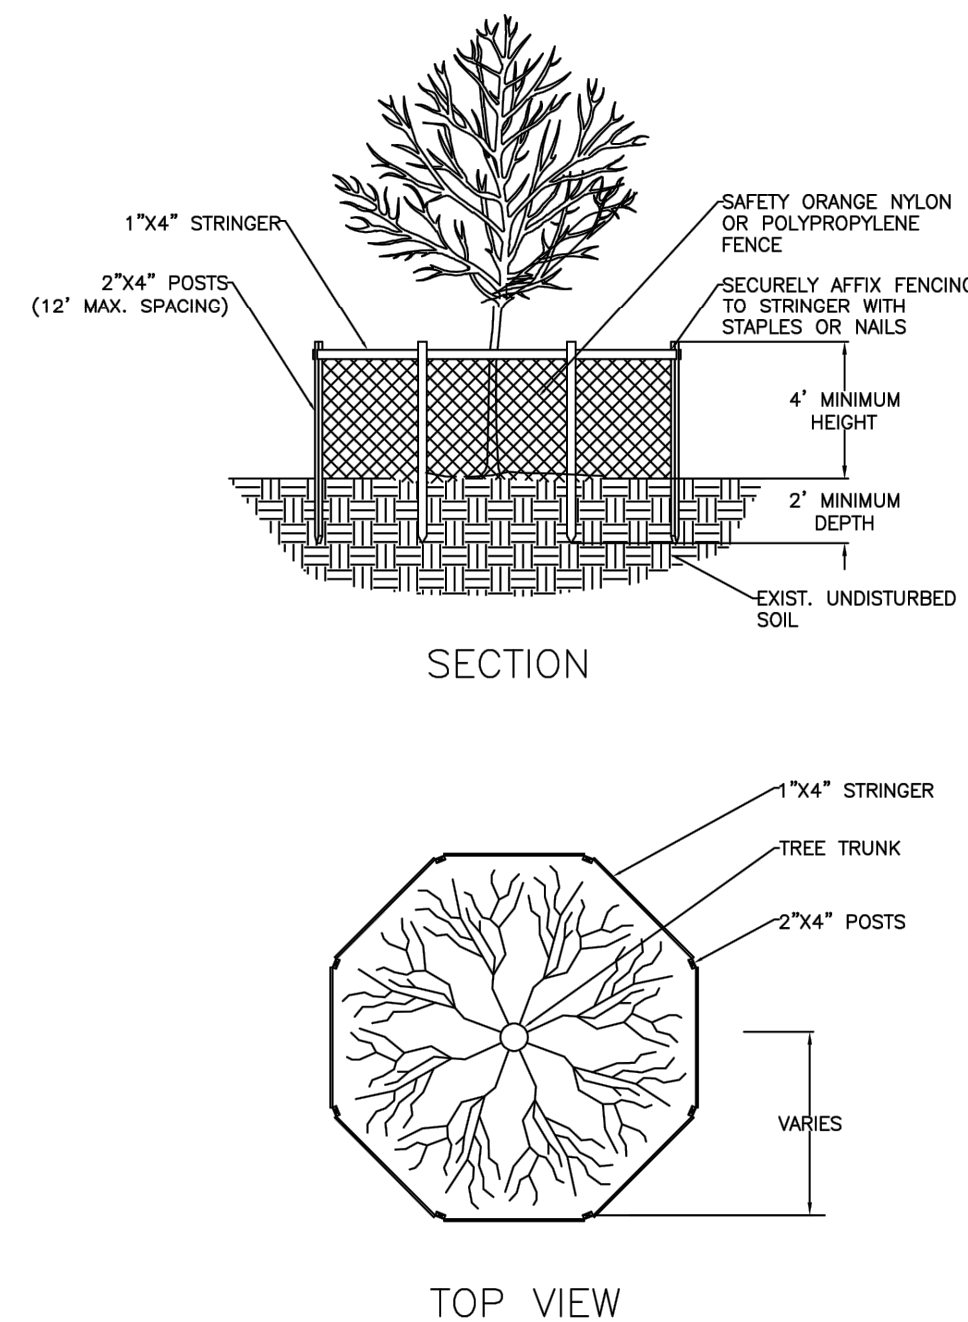
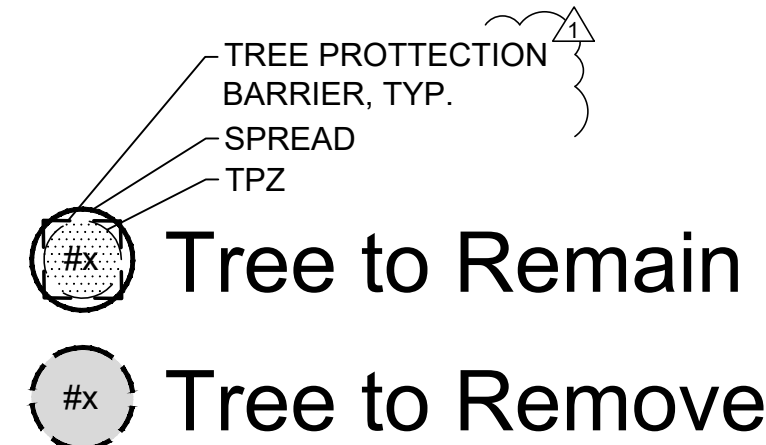


TREE DISPOSITION PLAN - LOT 02

Scale: 1" = 8'-0"

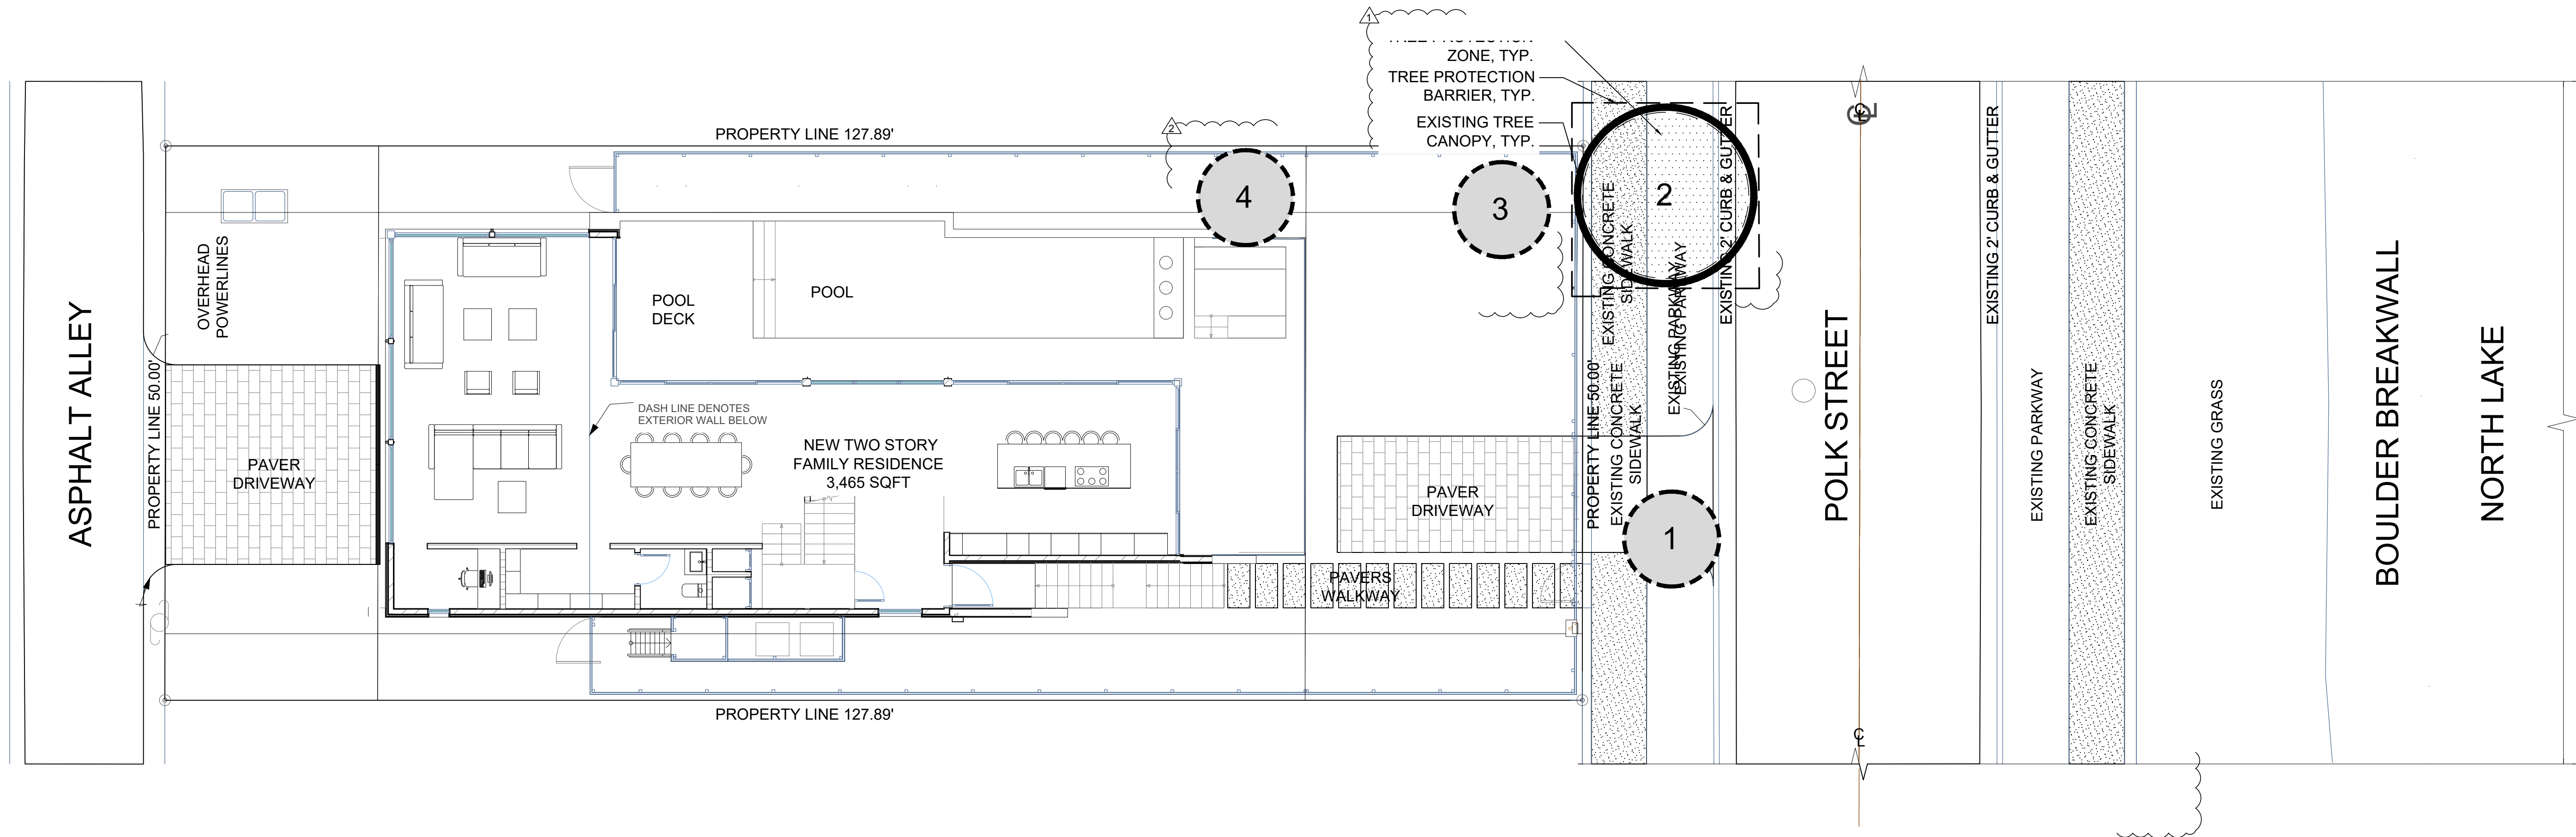

SYMBOL LEGEND

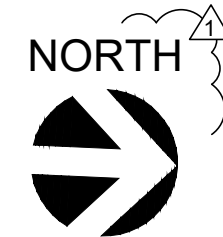

NOTES:

1. BARRICADE CIRCLE TO BE CENTERED ON TREE TRUNK(S). FOR GROUPS OF TREES, PLACE BARRICADES BETWEEN TREES AND CONSTRUCTION ACTIVITY.
2. TREE PROTECTION BARRICADES SHALL BE LOCATED TO PROTECT EXISTING, RELOCATED AND NEW TREES IN CONSTRUCTION AREAS. THE PROTECTIVE BARRIER SHALL BE PLACED AROUND THE TREE AT A DISTANCE OF 6 FEET FROM THE TREE TRUNK OR AT THE CANOPY DRIP LINE, WHICHEVER IS GREATER OR AS SHOWN ON LANDSCAPE PLAN.


TREE SURVEY CHART									
TREE #	SCIENTIFIC NAME	COMMON NAME	DBH (INCHES)	CT HEIGHT (FEET)	CANOPY (FEET)	TREE PROTECTION ZONE (TPZ)	DISPOSITION	CONDITION	NOTES
1	Roystonea regia	Royal Palm	24"	25'	10'	--	REMOVE	GOOD	IN CONFLICT WITH PROPOSED DRIVEWAY
2	Roystonea regia	Royal Palm	24	30'	15'	15'	REMAIN	GOOD	
3	Roystonea regia	Royal Palm	24	35'	15'	15'	REMOVE	GOOD	
4	Roystonea regia	Royal Palm	24	50'	15'	15'	REMOVE	GOOD	

MITIGATION REQUIRED: 0" TREE DBH REMOVED, 3 PALMS REMOVED = 0" DBH AND (3) 8' CLEAR TRUNK PALMS

MITIGATION BREAKDOWN		REQ.	PROV.
TREE DBH REPLACEMENT: No trees will be removed therefore there is no DBH needed towards mitigation.		0" DBH	
PALM REPLACEMENT: We are using (8) 8' C.T. towards mitigation.		3 PALMS	3 PALMS

TREE PROTECTION NOTES:

1. PROTECTION AREA SHALL BE KEPT UP AT ALL TIMES DURING THE CONSTRUCTION PHASE.
2. NO ENCROACHMENT OR CONSTRUCTION DEBRIS SHALL BE ALLOWED IN THE PROTECTION ZONE.
3. ZONE SHALL EXTEND TO THE TREE CANOPY DRIPLINE.
4. KEEP IN PLACE ALL TREE PROTECTION BARRIERS UNTIL THE PROJECT IS COMPLETED.

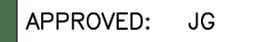

TREE PROTECTION DETAIL

DRAWING

DRAWING NO.: L-08

