STAR TOWER HOLLYWOOD TECHNICAL ADVISORY COMMITTEE

LANDSCAPE DRAWINGS JULY 3RD, 2023



			FINALOS	TA TACL	
INDE	X OF SHEETS	1	/🖟		
SHEET IDENTIFICATION	SHEET TITLE				
LANDSCAPE					
CVR-000	COVER SHEET				
LD-101	TREE DISPOSITION PLAN				
LH-001	GENERAL NOTES, LEGEND, & SCHEDULE				
LH-101	HARDSCAPE PLAN				
LH-501	HARDSCAPE DETAILS				
LP-001	PLANTING NOTES				
LP-101	PLANTING PLAN				
LP-501	PLANTING DETAILS				
LI-101	IRRIGATION PLAN				
LI-501	IRRIGATION DETAILS				
LL-101	EXTERIOR LIGHTING & PHOTOMETRICS PLAN				

TECHNICAL ADVISORY SUBMITTAL: JULY 3RD. 2023

TECHNICAL ADVISORY REVIEW: JULY 17TH, 2023

FINAL TAC - PLANNING & ZONING **RESUBMITTAL:** NOVEMBER 30TH, 2023


> PDB APPROVAL: DECEMBER 12TH, 2023



PROJECT No. 13778.00 JULY 3RD, 2023

410 N. FEDERAL HIGHWAY, HOLLYWOOD BROWARD COUNTY, FLORIDA 33020


> PREPARED FOR: 1817 TAYLOR DEVELOPMENT LLC.

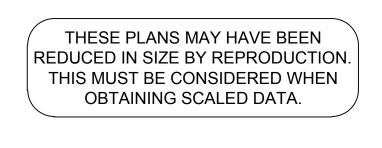





PAUL H. WEINBERG, R.L.A

FLORIDA REG. NO. LA6666804 (FOR THE FIRM)

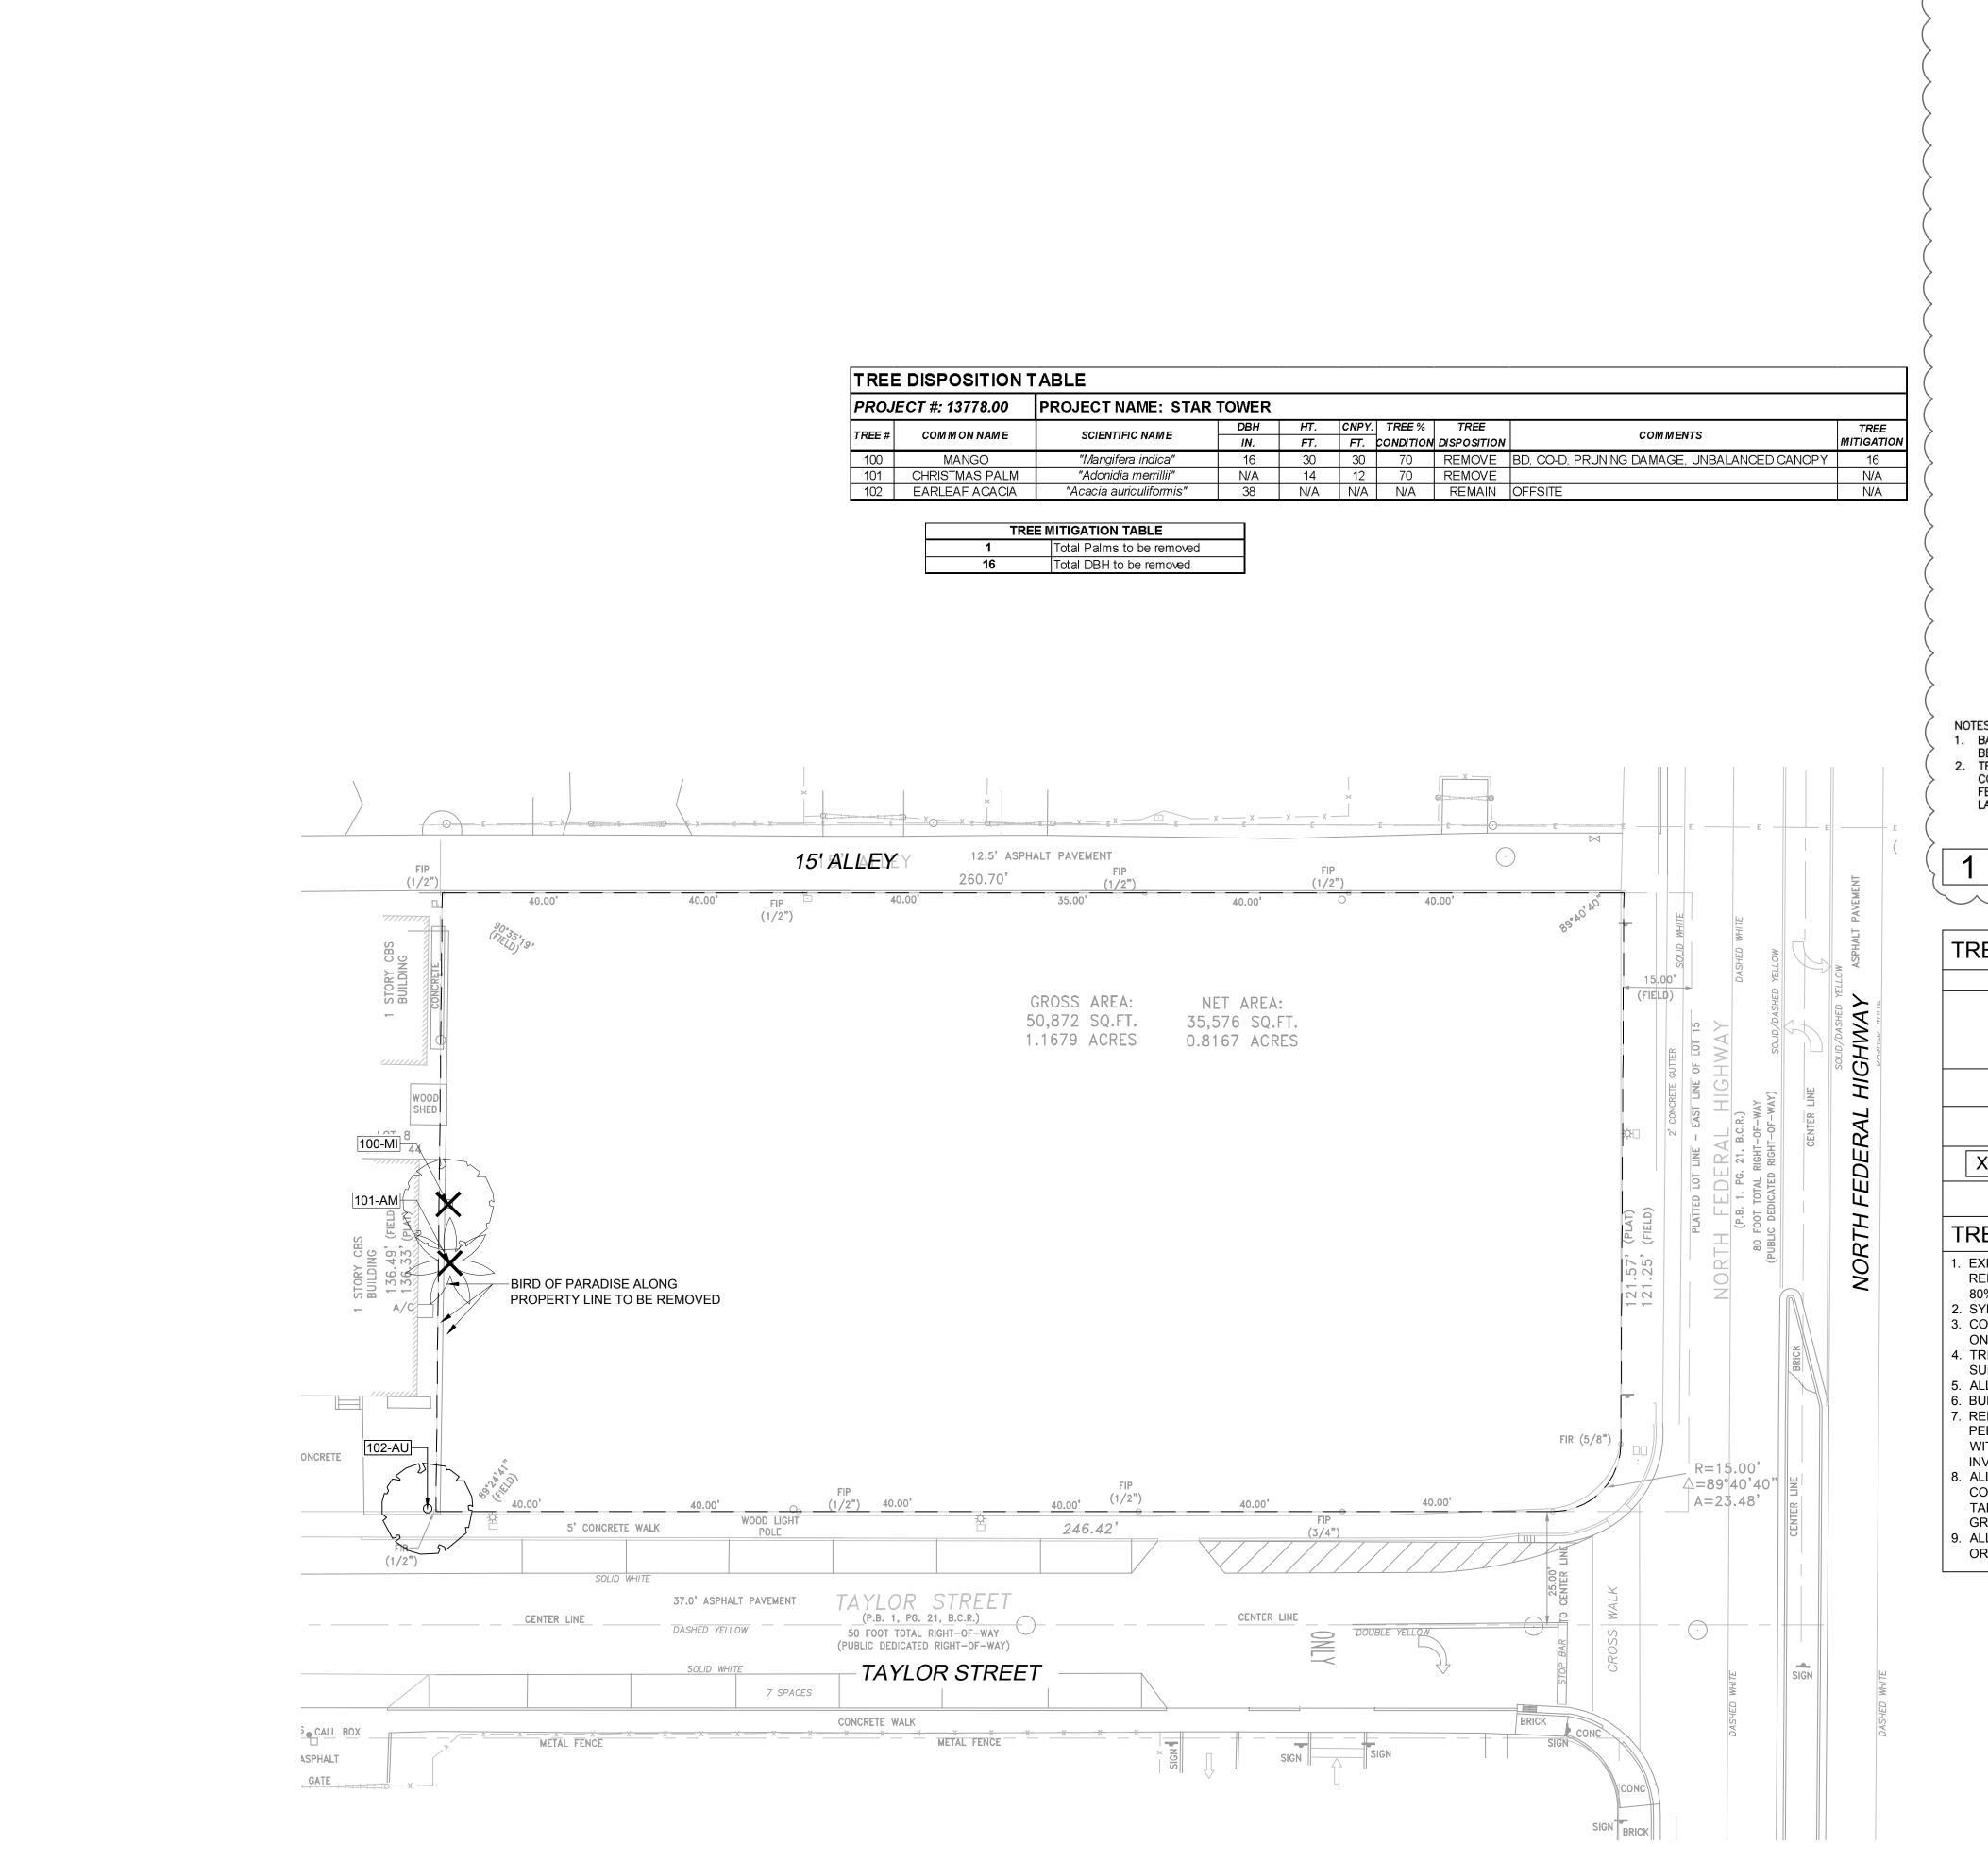

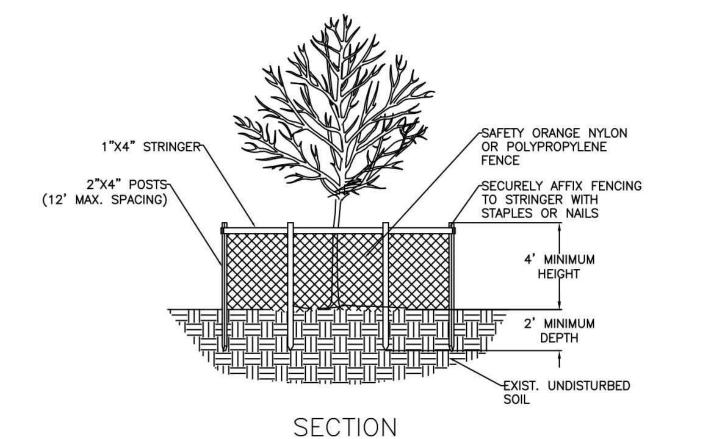

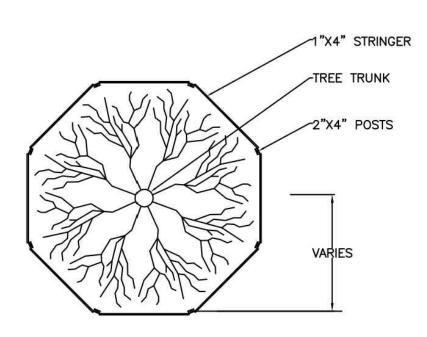

TOP VIEW

1. BARRICADE CIRCLE TO BE CENTERED ON TREE TRUNK(S). FOR GROUPS OF TREES, PLACE BARRICADES

BETWEEN TREES AND CONSTRUCTION ACTIVITY. TREE PROTECTION BARRICADES SHALL BE LOCATED TO PROTECT EXISTING, RELOCATED AND NEW TREES IN CONSTRUCTION AREAS. THE PROTECTIVE BARRIER SHALL BE PLACED AROUND THE TREE AT A DISTANCE 6 FEET FROM THE TREE TRUNK OR AT THE CANOPY DRIP LINE, WHICHEVER IS GREATER OR AS SHOWN ON LANDSCAPE PLAN.

CITY OF HOLLYWOOD TREE PROTECTION

TREE DISPOSITION LEGEND SYMBOL DESCRIPTION EXISTING TREE / PALM TO REMAIN (NO SYMBOL) TO BE PROTECTED DURING CONSTRUCTION NO RELOCATIONS ARE ANTICIPATED AS OF DRAWINGS DATED EXISTING TREE / PALM TO RELOCATE. REFER TO LANDSCAPE PLAN FOR NEW LOCATION EXISTING TREE / PALM TO REMOVE. REMOVE ALL CAT 1 INVASIVE EXOTICS. (EX: BRAZ, PEPPER) EXISTING TREE / PALM NUMBER. REFER TO TREE DISPOSITION XXX-xx

TREE DISPOSITION NOTES


TABLE ON THIS SHEET

PLAN / SECTION

- EXISTING TREES TO REMAIN SHALL BE TRIMMED PER ANSI-A300 STANDARDS, REMOVING WEAKEST RUBBING BRANCHES AND DEAD BRANCHES, BUT RETAINING 80% OF FOLIAGE. LARGE TREES SHALL HAVE LOWER BRANCHES CLEARED UP TO 8' . SYMBOLS MAY BE SHOWN OFFSET FROM ACTUAL TREE LOCATION FOR CLARITY.
- CONTACT LANDSCAPE ARCHITECT / ISA CERTIFIED ARBORIST FOR CLARIFICATION ON ANY DISCREPANCIES.
- . TRIMMING AND ANY NECESSARY ROOT PRUNING SHALL BE PERFORMED OR SUPERVISED BY A CERTIFIED ARBORIST.
- ALL TREE WORK REQUIRE PERMITTING BY A REGISTERED COUNTY TREE TRIMMER. 6. BUBBLERS SHALL BE PROVIDED FOR ALL RELOCATED TREES AND PALMS.
- REMOVAL OF ANY TREES OR PALMS WILL REQUIRE A WRITTEN "TREE REMOVAL PERMIT" FROM THE LOCAL GOVERNING AGENCY PRIOR TO REMOVAL. CONFIRM WITH LOCAL GOVERNING AGENCY THAT TREES CLASSIFIED AS NUISANCE/EXOTIC INVASIVE MAY BE EXEMPT.
- B. ALL TREES AND PLANT MATERIAL TO REMAIN SHALL BE PROTECTED DURING CONSTRUCTION. REFER TO TREE PROTECTION DETAIL. THE CONTRACTOR SHALL TAKE EXTRA CAUTION TO PREVENT ANY DAMAGE TO THE TRUNK, ROOT ZONES AND
- 9. ALL CATEGORY 1 EXOTIC/INVASIVE TREES TO BE REMOVED PER LOCAL
- ORDINANCE.

ADDITIONAL CITY OF HOLLYWOOD NOTE:

NO TREE REMOVAL OR PLANTING ALLOWED UNTIL SUB-PERMITS ARE FULLY APPROVED BY CITY.

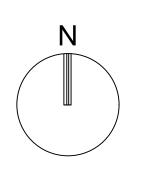

GRAPHIC SCALE

SCALE: 1" = 20 '

NOTE: PRINTED DRAWING SIZE MAY HAVE CHANGED FROM ORIGINAL. VERIFY SCALE USING BAR SCALE ABOVE.

301 East Atlantic Blvd

Pompano Beach, FL 33060


PH: (954) 788-3400 Florida Engineering Business License: CA7928 Florida Surveyor and Mapper Business License: LB6860

Florida Landscape Architecture Business License: LC26000457				
REVISIONS				
NO.	DESCRIPTION	DATE		
	TAC - P&Z	09/13/2023		
	FINAL TAC - P&Z	11/15/2023		
	FINAL TAC-RESUBMITTAL	11/30/2023		
	PDB APPROVAL	12/12/2023		
	I .			

PRELIMINARY PLAN NOT FOR CONSTRUCTION

THESE PLANS ARE NOT FULLY PERMITTED AND ARE SUBJECT TO REVISIONS MADE **DURING THE PERMITTING PROCESS.** RESPONSIBILITY FOR THE USE OF THESE PLANS PRIOR TO OBTAINING PERMITS FROM ALL AGENCIES HAVING JURISDICTION OVER THE PROJECT WILL FALL SOLELY UPON THE

ISSUE DATE:	06/30/2023
DESIGNED BY:	СР
DRAWN BY:	CP, RP
CHECKED BY:	KS, PW
BID-CONTRACT:	

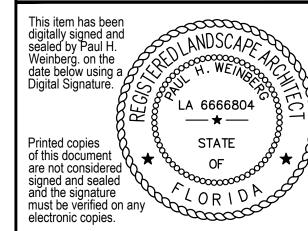

PAUL H. WEINBERG, PLA FLORIDA REG. NO. LA6666804 (FOR THE FIRM)

CLIENT

1817 TAYLOR DEVELOPMENT LLC

PROJECT

STAR TOWER HOLLYWOOD

410 N. FEDERAL HWY HOLLYWOOD, FL 33020

SHEET TITLE

TREE DISPOSITION PLAN

SHEET LD-101 NUMBER PROJECT 13778.00 NUMBER

GENERAL NOTES:

1.) LOCATE AND VERIFY THE CONDITION OF EXISTING UTILITIES PRIOR TO EXCAVATION. TAKE RESPONSIBILITY OF CONTACTING LINE LOCATION SERVICES AND ANY COST INCURRED FOR BODILY INJURY AND / OR DAMAGE OF OWNER'S PROPERTY OR SAID UTILITIES.

2.) THE LANDSCAPE ARCHITECT SHALL BE NOTIFIED BY THE CONTRACTOR OF ANY DISCREPANCIES DISCOVERED BETWEEN THE PLANS AND ACTUAL SITE CONDITIONS BEFORE PROCEEDING WITH THE WORK. THE CONTRACTOR SHALL BE LIABLE FOR ALL MODIFICATIONS AND DAMAGES IF WORK PROCEEDS WITHOUT THIS NOTIFICATION AND APPROVAL.

TRAFFIC CONTROL, INSTALLATION AND PLACEMENT OF FENCING AND BARRICADES, EXCAVATION AND TRENCH PROTECTION, AND COMPLIANCE WITH ALL FEDERAL AND LOCAL REGULATIONS AND CODES. ALL SAFETY EXPOSURES OR VIOLATIONS SHALL BE RECTIFIED IMMEDIATELY.

3.) THE CONTRACTOR IS RESPONSIBLE FOR ALL ASPECTS OF MAINTAINING A SAFE WORK SITE INCLUDING BUT, NOT LIMITED TO PROVIDING FOR

4.) THE CONTRACTOR IS RESPONSIBLE FOR PROTECTION OF ALL EXISTING IMPROVEMENTS BOTH ON SITE AND ADJACENT TO THE WORK SITE AND SHALL REPAIR ANY DAMAGE TO THESE IMPROVEMENTS TO THE SATISFACTION OF THE OWNER.

5.) THE CONTRACTOR SHALL NOTIFY OWNER AND LANDSCAPE ARCHITECT 72 HOURS PRIOR TO COMMENCEMENT OF WORK TO COORDINATE PROJECT INSPECTION SCHEDULES.

6.) ANY ALTERNATES AND OR SUBSTITUTIONS PROPOSED BY THE CONTRACTOR SHALL BE SUBMITTED TO THE LANDSCAPE ARCHITECT FOR APPROVAL. CHANGES TO THE SCOPE OF WORK AND / OR CONTRACT DOCUMENTS RESULTING FROM THE ACCEPTANCE OF THE CONTRACTOR'S ALTERNATES AND / OR SUBSTITUTIONS SHALL BE THE RESPONSIBILITY OF THE CONTRACTOR.

7.) THE CONTRACTOR IS RESPONSIBLE FOR REMOVAL OF TRASH ON A DAILY BASIS.

8.) THE CONTRACTOR SHALL COMPLY WITH ALL APPLICABLE CODES, REGULATIONS AND ORDINANCES. PRIOR TO CONSTRUCTION, ALL PERMITS AND APPROVALS REQUIRED FOR CONSTRUCTION OF THE PROJECT SHALL BE PAID FOR AND OBTAINED BY THE CONTRACTOR.

9.) COORDINATE WORK WITH SUBCONTRACTORS TO ACCOMPLISH THE SCOPE OF WORK AS SHOWN AND NOTED IN THE CONTRACT DOCUMENTS AS WELL AS, COORDINATE CONSTRUCTION WITH OTHER CONTRACTORS WORKING ON THE SITE.

10.) THE CONTRACTOR SHALL COORDINATE THE STORING OF MATERIALS, PARKING OF VEHICLES, AND RESTRICTIONS OF WORK AND ACCESS WITH THE OWNER. UNDER NO CIRCUMSTANCES SHALL ANY CONTRACTOR STORE MATERIALS, PARK VEHICLES OR EQUIPMENT UNDER THE CANOPY OF EXISTING TREES.

11.) UNLESS SPECIFIED OTHERWISE, THE CONTRACTOR IS RESPONSIBLE FOR PROVIDING AND PAYING ALL TEMPORARY UTILITIES AND SERVICES NECESSARY TO COMPLETELY INSTALL ALL WORK AS SHOWN AND NOTED IN THE CONTRACT DOCUMENTS.

12.) THE CONTRACTOR IS RESPONSIBLE FOR THE LEGAL OFF-SITE DISPOSAL OF SURPLUS MATERIAL AND DEBRIS.

13.) UPON COMPLETION OF CONSTRUCTION AND PRIOR TO FINAL APPROVAL, THE CONTRACTOR SHALL THOROUGHLY CLEAN THE PROJECT SITE OF ALL TRASH, REPAIR ALL DAMAGE TO FINISH GRADE, INCLUDING TAILINGS FROM EXCAVATIONS, WHEEL RUTS AND ANY SETTLING OR EROSION THAT HAS OCCURED PRIOR TO COMPLETION. ALL AREAS OF THE PROJECT SITE SHALL BE LEFT IN A NEAT AND PRESENTABLE CONDITION SATISFACTORY TO THE OWNER PRIOR TO SUBMITTAL OF THE FINAL PAYMENT.

GENERAL LEGEND					
SYMBOL	DESCRIPTION				
REF:	ENLARGEMENT AREA REFERENCE				
MATCHLINE: XX-XXX	SHEET MATCHLINE				
L.O.C.	LIMIT OF CONSTRUCTION				
	PROPERTY LINE				
SITE	WORK				
XX LS-50X	DETAIL REFERENCE				
(XX)	MATERIAL OR FINISH REFERENCE SYMBOL				
X LS-50X	SECTION CUT REFERENCE				
X-50X	ELEVATION OR AERIAL VIEW REFERENCE				
PLANTING					
XX XX	PLANT LABEL				
DIMENSIONING					
ALIGN	ALIGN ELEMENTS				
Ę.	CENTERLINE				

ABBREVIATIONS		
B&B	BALLED AND BURLAPPED	
BLDG.	BUILDING	
B.O.C.	BACK OF CURB	
CAL.	CALIPER	
CJ	CONTROL JOINT	
CL	CENTERLINE	
CLR	CLEAR	
СТ	CLEAR TRUNK	
CRZ	CRITCAL ROOT ZONE	
EJ	EXPANSION JOINT	
EQ	EQUAL	
FFE	FINISHED FLOOR ELEVATION	
FG	FIELD GROWN	
F.O.B.	FACE OF BUILDING	
GAL.	GALLON	
GW	GREY WOOD	
HT	HEIGHT	
H.P.	HIGH POINT	
L.A.	LANDSCAPE ARCHITECT	
L.O.C.	LIMIT OF CONSTRUCTION	
L.P.	LOW POINT	
MIN.	MINIMUM	
MULTI	MULTI-TRUNK	
N.I.C.	NOT IN CONTRACT	
OA	OVERALL	
O.C.	ON CENTER	
O.C.E.W.	ON CENTER EACH WAY	
PA (OR P.A.)	PLANTING AREA	
QTY	QUANTITY	
R.O.W.	RIGHT OF WAY	
SIM.	SIMILAR DETAIL	
SPRD.	SPREAD	
TD	TOP OF DRAIN	
T.O.C.	TOP OF CURB	
TS	TOP OF STAIR	
TW	TOP OF WALL	
TYP.	TYPICAL	
U.N.O.	UNLESS NOTED OTHERWISE	

I/\I\	DSCAPE MATERIALS	3 SCHEDUL	L		
CONCI	RETE				
KEY	DESCRIPTION / MODEL	COLOR	FINISH	CONTACT	REMARKS
(C.1)	CONCRETE SIDEWALKS -HAND TOOLED PICTURE FRAME JOINTS	STANDARD GREY	MEDIUM BROOM WITH PICTURE FRAME JOINTS	LOCAL SOURCE	
(C.2)	CONCRETE - FINISH TO BE DETERMINED	STANDARD GREY	MEDIUM BROOM WITH SAW CUT CONTROL JOINTS	LOCAL SOURCE	
PRECA	AST CONCRETE PAVERS				
P.1	PRECAST CONCRETE PAVERS - PLANK PAVERS	TO BE DETERMINED	STANDARD	TO BE DETERMINED	-SUBMIT PRODUCT DATA FOR REVIEW
P.2	STAMPED ASPHALT - STREETBRICK XL - 8"x8" PAVER (PATTERNED)	PEWTER AND GRANITE	STANDARD	COMPANY: ATLANTIC PAVING OFFICE PHONE: (305) 513-8632 ATLANTICPAVING.COM	- MUST COMPLY FDOT STANDARDS
MISCE	LLANEOUS				
(M.1)	LITTER RECEPTACLE - DISPATCH LITTER RECEPTACLES - 45 GALLON, SINGLE-STREAM, ONE 45 GALLON LINER	ALUMINUM TEXTURE	POWDERCOAT ALUMINUM	COMPANY: FORMS+SURFACESCONTACT: FORMS-SURFACES.COM	-SUBMIT PRODUCT DATA AND FINISH SAMPLE FOR REVIEW
M.2	BIKE RACKS - BRHS-101 BIKE RACK	TITANIUM	TUBULAR STEEL	COMPANY: VICTOR STANLEY CONTACT: WWW.VICTORSTANLEY.COM	-SUBMIT PRODUCT DATA AND FINISH SAMPLE FOR REVIEW
M.3	TREE GRATE - OBLIO 6'X6' HEEL PROOF - 71.88"X71.88"x1.25"	CAST IRON	POWDERCOAT	COMPANY: IRON AGE DESIGNS CONTACT: KATHLEEN ARMSTRONG OFFICE PHONE: (206) 276-0925 CELL PHONE: (206) 550-8268 EMAIL: KATHLEEN@IRONAGEGRATES .COM	-SUBMIT PRODUCT DATA FOR REVIEW



PH: (954) 788-3400 Florida Engineering Business License: CA7928 Florida Surveyor and Mapper Business License: LB6860

	REVISIONS	
NO.	DESCRIPTION	DATE
	TAC - P&Z	09/13/2023
	FINAL TAC - P&Z	11/15/2023
	FINAL TAC-RESUBMITTAL	11/30/2023
	PDB APPROVAL	12/12/2023

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PLANS PRIOR TO OBTAINING PERMITS FROM ALL AGENCIES HAVING JURISDICTION OVER THE PROJECT WILL FALL SOLELY UPON THE ISSUE DATE:

ISSUE DATE:	06/30/2023
DESIGNED BY:	СР
DRAWN BY:	CP, RP
CHECKED BY:	KS, PW
BID-CONTRACT:	
This item has been digitally signed and sealed by Paul H. Weinberg. on the date below using a Digital Signature.	LA 6666804

of this document $\begin{cases} \begin{cases} \beaton & begin{cases} \begin{cases} \begin{cases} \begin{cases} \be$ signed and sealed and the signature must be verified on any electronic copies.

PAUL H. WEINBERG, PLA FLORIDA REG. NO. LA6666804 (FOR THE FIRM)

CLIENT

1817 TAYLOR DEVELOPMENT LLC


PROJECT

STAR TOWER HOLLYWOOD

410 N. FEDERAL HWY HOLLYWOOD, FL 33020

SHEET TITLE

	RAL NOTES, , & SCHEDULE	: PRELIMINARY
SHEET NUMBER	LH-001	STATUS:
PROJECT NUMBER	13778.00	STA

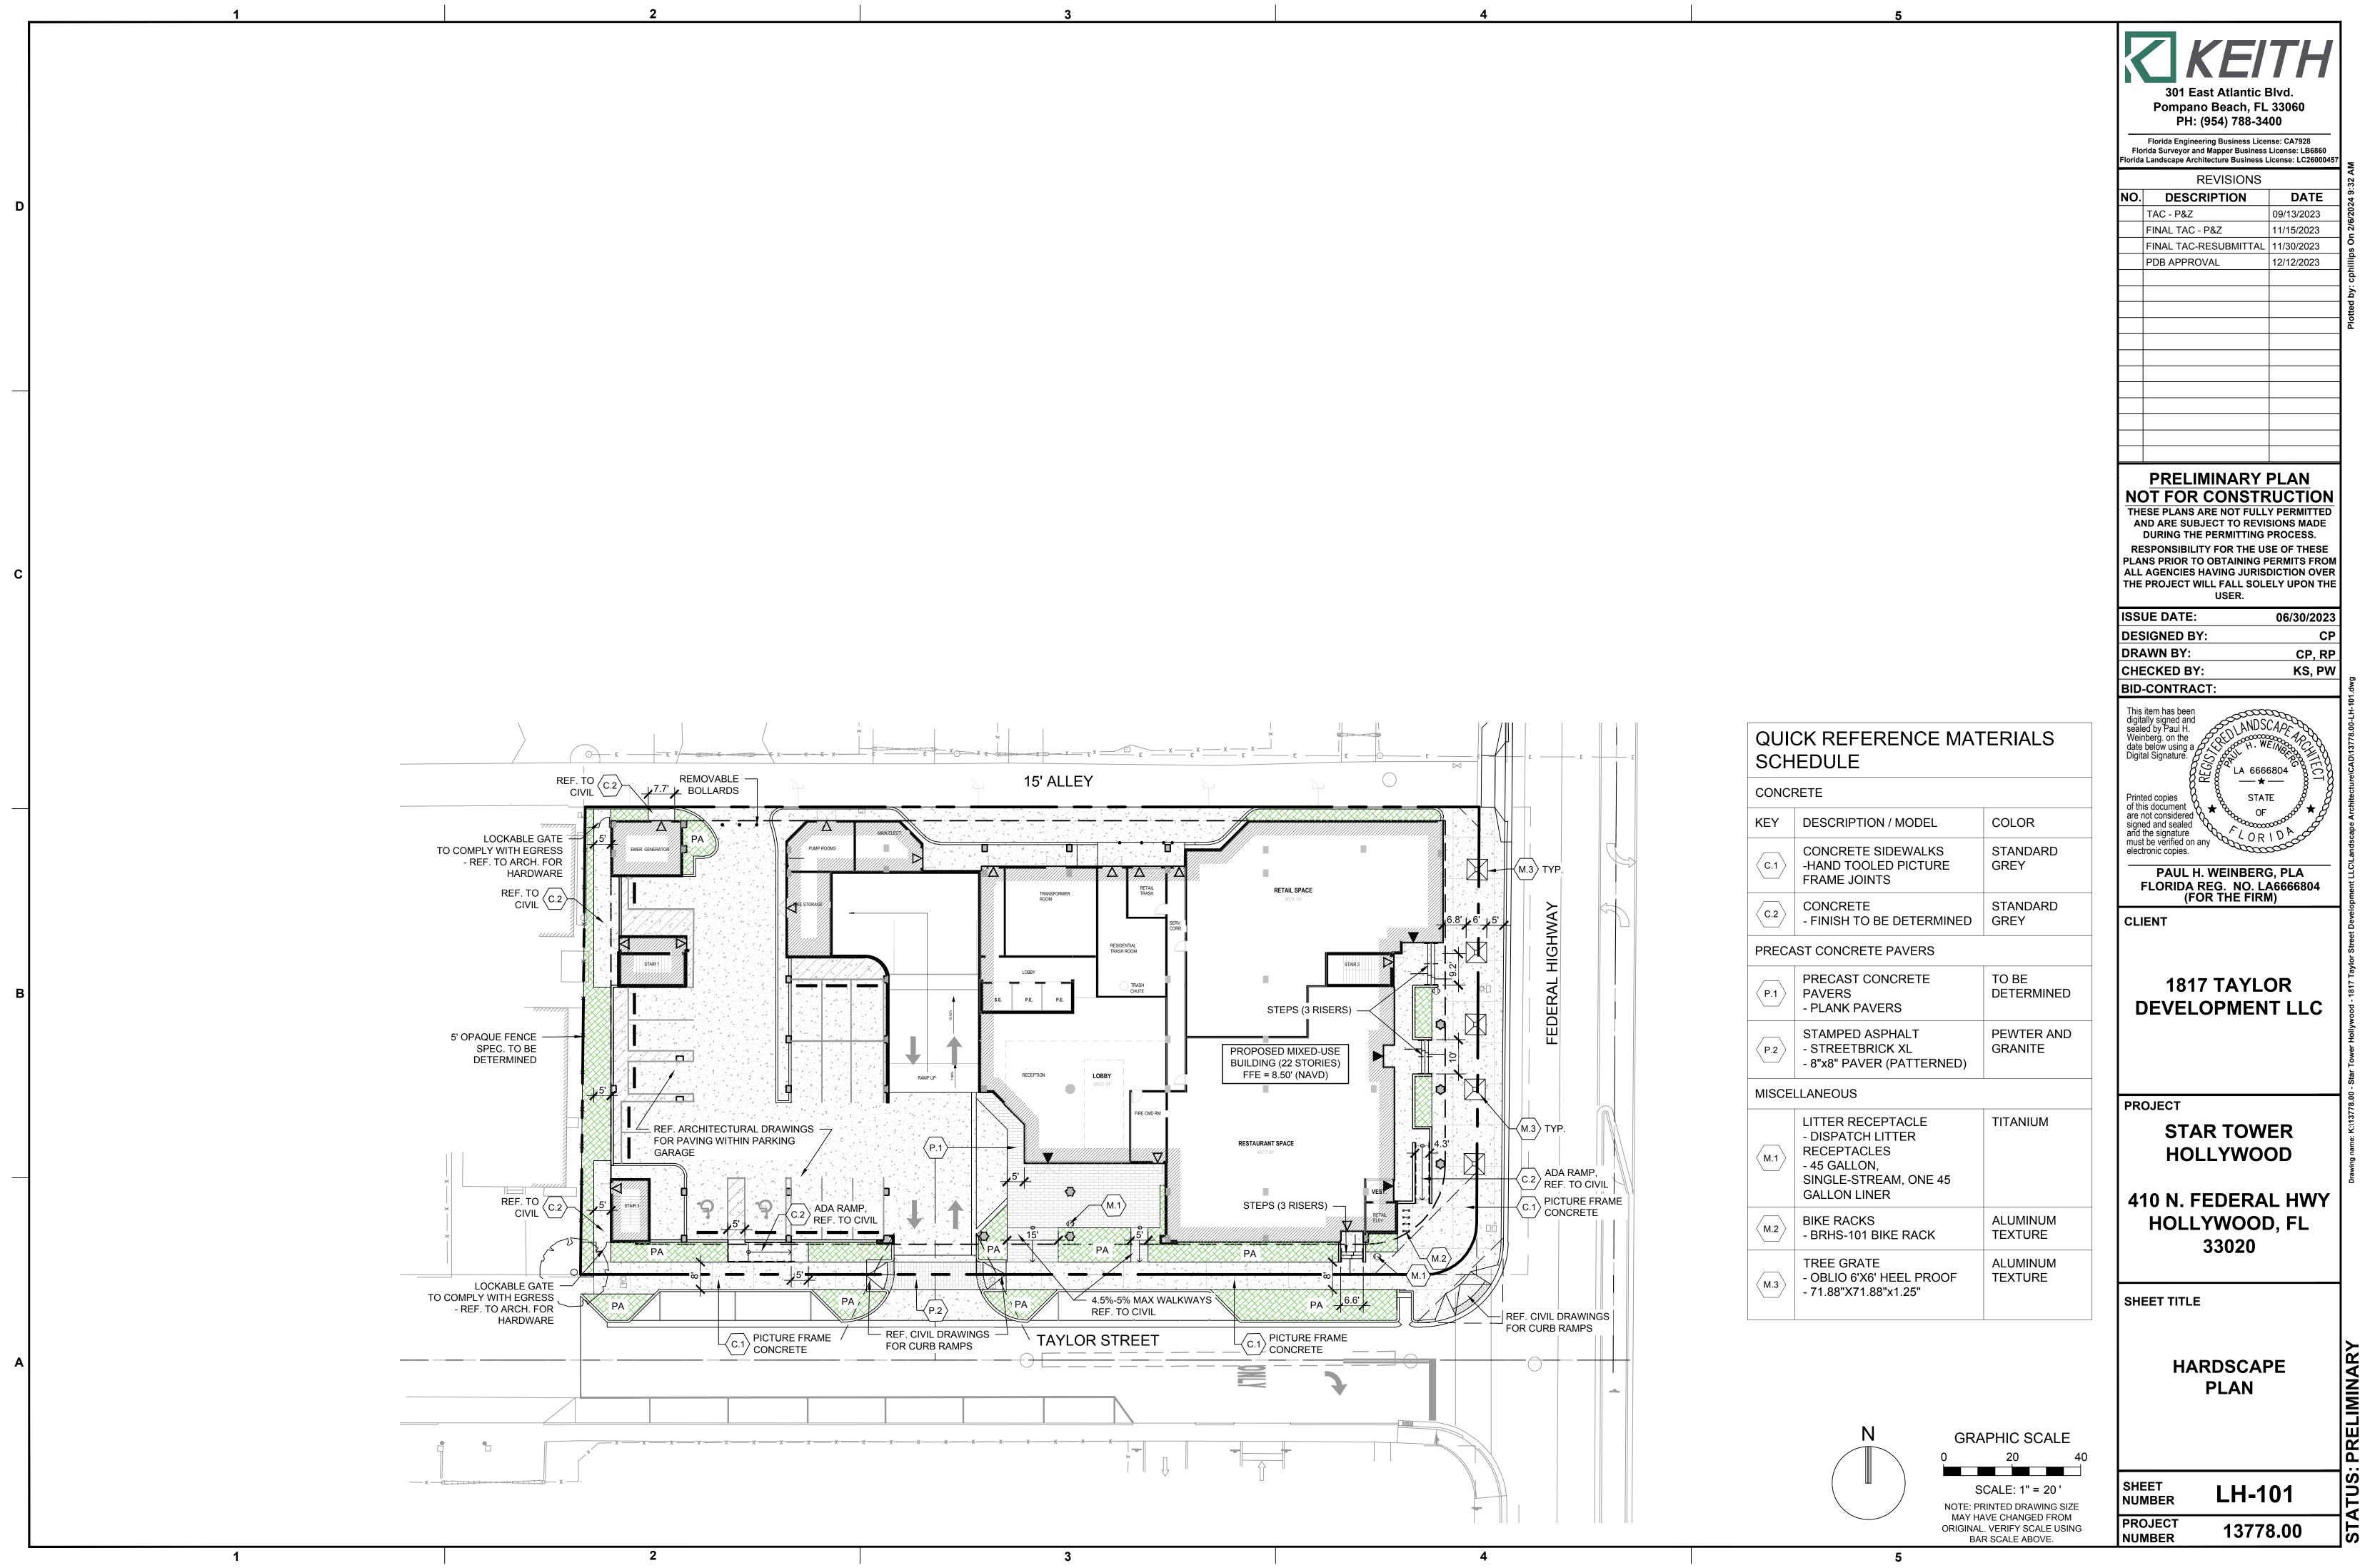

ΑM	orida Landscape Architecture Business License: LC26000457				
9:32 A		REVISIONS			
	DATE	DESCRIPTION	Ю.		
2/6/2024	09/13/2023	TAC - P&Z			
n 2/6	11/15/2023	FINAL TAC - P&Z			
s On	11/30/2023	FINAL TAC-RESUBMITTAL			
cphillips	12/12/2023	PDB APPROVAL			
by:					
otted					
0					





	BRHS-101 Bike Rack	
Manufasturer;	Victor Stanley	
Model:	BRHS-101 Bike Rack	
Material:	Tubular Steel	
Colon	Black	-
Website	https://wictorstanley.com/oroduct/hebs-204/	

(M.2) BIKE RACK 5 SPECIFICATION - IMAGES

NOT TO SCALE



-C-0-0-1-0-1-0-1-0-1-0-1-0-1-0-1-0-1-0-1	Ohilo Tree Grate
Manufacturer	Iron Age Designs
Model:	Oblie 6' x 6' Heel Proof
Siaw;	71.88" x 71.88" x 1.45"
Materials	Cast Icon
ADA Compliant:	Yes
Website:	Website: https://www.ironagegrates.com/product/tree-grates-oblis/#specs

NOT TO SCALE


6 (M.3) TREE GRATE





Dispatch Litter Receptacle		
anufacturer;	Forms + Surfaces	
odel:	Dispatch Litter Receptacles	
ze/ ecification:	45 Gallon, single-stream, one 45 gallon liner	
aterial:	Powdercoat aluminum	
lor;	Black	
ebsite:	https://www.forms-surfaces.com/dispatch-litter-recycling- receptacle	


(M.1) TRASH RECEPTACLE SPECIFICATION - IMAGES NOT TO SCALE

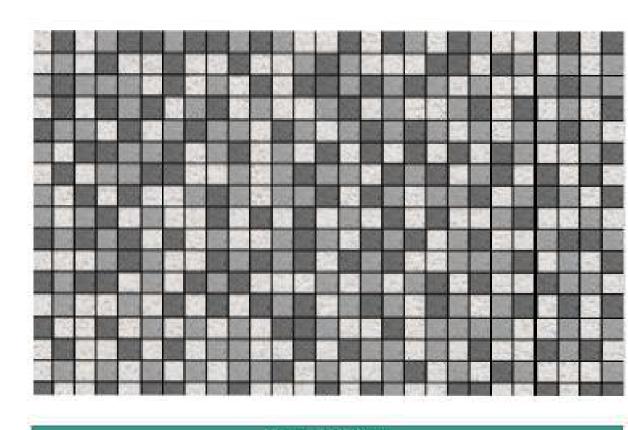


	Shellstone Paver	•
Manufacturer:	Old Castle- Relgard	
Model:	Oceanside Shellstone Pavers	
Sixe:	8" x 8" paver	
	White	
Colort	Pewter	
78.78.75.75.74	Charcoal	
Finish Edge:	Standard	
	Application Area	-4/4
	Pedestrian Sidewalks -	N
	Crosswalks -	PA*
Application	Intersection Corners -	Y
Area:	Public Open Spaces -	Υ
	On-Street Parking -	N
	Transit Stops	N

(P.1) PAVING PATTERN PLAN ENLARGEMENT

SCALE: 1"=1'-0"

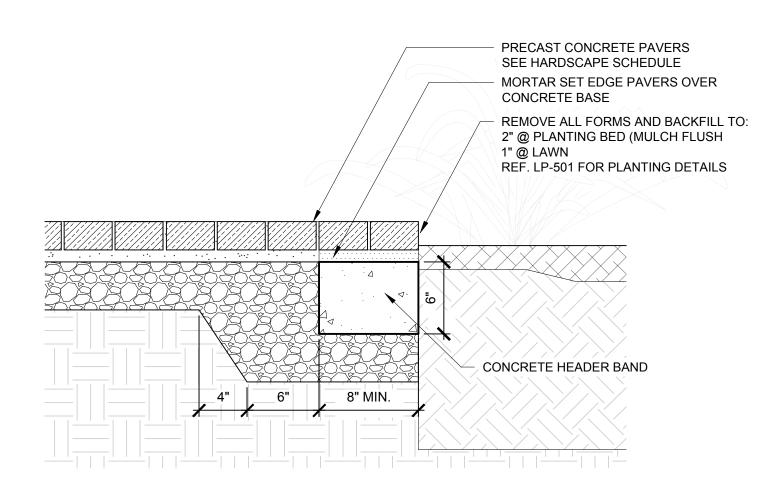

¬ PRECAST PAVERS AT LANDSCAPE

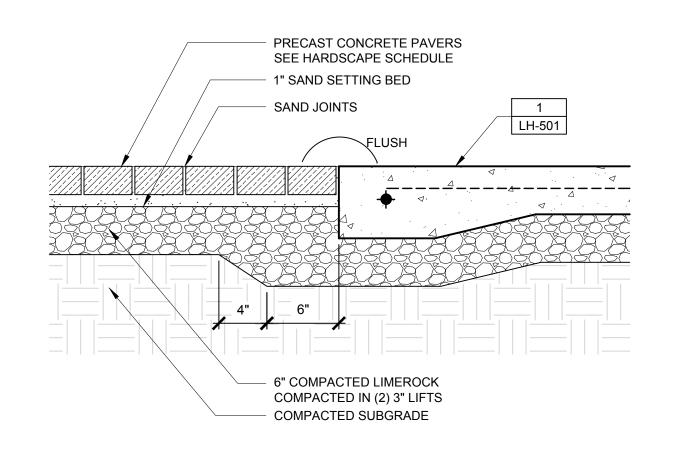

PRECAST PAVERS AT CONCRETE SCALE: 1-1/2"=1'-0"

301 East Atlantic Blvd. Pompano Beach, FL 33060 PH: (954) 788-3400


Florida Engineering Business License: CA7928
Florida Surveyor and Mapper Business License: LB6860
Florida Landscape Architecture Business License: LC2600045

NO	DECODIDATION	DATE
NO.	DESCRIPTION	DATE
	TAC - P&Z	09/13/2023
	FINAL TAC - P&Z	11/15/2023
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ISSUE DATE:	06/30/2023
DESIGNED BY:	CP, VC, MP
DRAWN BY:	1200 , IR P
CHECKED BY:	KS, FND
BID-CONTRACT:	



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FLETORADARE EN ON Q A**66528**04
(FOR THE FIRM)

CLIENT

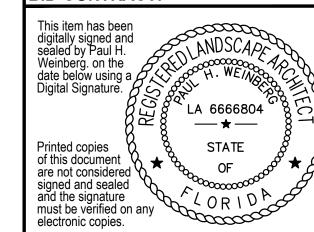1817 TAYLOR DEVELOPMENT LLC

PROJECT

STAR TOWER HOLLYWOOD

410 N. FEDERAL HWY HOLLYWOOD, FL 33020

SHEET TITLE

HARDSCAPE DETAILS		PRELIMINARY
SHEET NUMBER	LH-501	TATUS
PROJECT NUMBER	13778.00	STA

4

Contractor to have liability insurance including Owner and Landscaper as insured's in excess of \$10,000 as well

5. Landscape contractor shall verify all estimated quantities of material shown on the drawings prior to submitting their bid. Plant list pricing (if shown) is for permitting / mitigation comparison purposes only, any prices shown are to be disregarded by Landscape Contractor. i. All Plant Material shall meet or exceed height and spread requirement. Heights are local code requirement and /

or design intent related and always governs over container size. Container size given for reference only and must be sized-up to meet height requirements of plant list. Plant material available with excessive height beyond specifications must be consulted with Landscape Architect for design intent. 7. All landscape material was confirmed to be available at time of design. Landscape contractor understands that some material may not be available locally, however is available in Tri-County Region. Plant material supply is the responsibility of the Landscape Contractor that is awarded the contract and he/she shall take steps to ensure

availability at the time of installation. Bring to the attention of Landscape Architect if specific material is no longer available at the time of bidding and / or prior to actual construction. Substitutions must be approved prior to construction. 8. Pre-inspections of site required prior to bidding.

9. The plant list is intended only as an aid to bidding. Any discrepancies found between the quantities on the plan and the quantities on the plant list shall be brought to the attention of the Landscape Architect for clarification. 10. All labor and material for soil amendments and fertilizer that is required to ensure the successful establishment and survival of the proposed vegetation, as well as all the cost for the removal of unsuitable or excess backfill material from plant beds, in addition to fine grading and mulching all plant beds and individual trees shall be included in the contractor's bid to perform the work represented in this plan set.

11. Bid shall be itemized for possible value engineering. 12. Sod and Rocks (if specified) shall be estimated by scaling plans. Include price per square foot for sod. Rocks (include price per ton). Small rocks and gravel beds shall have landscape fabric material and minimum 4" depth. Boulders to be bid by unit.

13. All S.F. if noted is approximate and shall not be considered all inclusive; it is the contractor's responsibility to do his or her take off, submit price per S.F. and in the end, sod all areas that are not covered either by plants, mulch and/or rocks. It shall be the responsibility of the contractor to include in the bid, the repair of any existing sod which may be damaged during construction.

14. Final payment to the Contractor shall be for actual plants installed on the project. 15. Contractor shall be responsible for obtaining and paying for costs of all permits described in bid whether permit costs are reimbursable by owner or included in bid. Research permit status and research all permits and additional documentation and certifications required such as separate tree removal permit for example, and

16. General / Landscape Contractor shall leave a 5% unforeseen conditions allowance such as for additional root barriers determined to be needed on site and as job progresses. 17. Refer to Section T, Watering, for supplemental watering requirement.

18. Landscape contractor is responsible for verifying all plant quantities prior to bidding and within 7 calendar days of receipt of these plans shall notify the landscape architect in writing of any and all discrepancies. In case of discrepancies, planting plans shall take precedence over plant list. No substitutions are to be made without prior consent of the Landscape Architect.

Plants grown in containers prior to installation shall be removed from their containers before they are planted in the ground and have circling roots removed. All screening shrubs shall be planted for proper operation of equipment being screened and/or per the requirements of the utility as necessary. All hedge material required for screening purposes shall be planted with branches touching. Adjust spacing as necessary and/or provide additional plants to provide an adequate screen as required by code. Leave access to utility or clearance as

2. All landscaping shall be installed according to sound nursery practices. Contractor shall comply with federal, state and local laws and regulations pertaining to the inspection for plant disease and insect infestation. 3. All ideas, designs and plans indicated or represented by this drawing are owned by and are the exclusive property of Keith and Associates and may not be duplicated without authorization or used for other projects than

the intended. 4. The Landscape Contractor shall exercise caution to protect any existing sod, electrical and irrigation. Any damage to the sod, electrical or irrigation shall be replaced or repaired to the original state by the Landscape

Contractor at no additional cost to the owner. 5. Tree, palm, accent shrubs and bed lines are to be located in the field and approved by the Landscape Architect / owner prior to planting. Landscape Contractor acknowledges that material planted without approval of location may be subject to relocation by Landscape Architect to maintain design intent if not followed properly.

All trees must be pruned as per Landscape Architect's direction. 7. In areas where asphalt is removed in order to receive landscape material, the lime rock sub-base material must also be removed and replaced with approved planting soil mix. 8. Landscape contractor is responsible for sending photographs to the landscape architect to pre-approve all trees,

palms, and shrubs prior to delivery to project site. . Landscape contractor shall coordinate his or her work with that of the irrigation, landscape lighting, and hardscape contractor if different.

10. The landscape contractor shall treat plant areas with pre-emergence herbicide after weeds and grass have been removed. Landscape contractor shall wait 7 days after pre-emergence treatment prior to planting.

PERMITS & REGULATIONS

Contractor(s) must obtain separate landscape, irrigation and tree relocation/removal permits from the governing authority prior to the issuance of the first building permit for the project. 2. Landscape contractor to call the local Landscape Inspector to schedule a pre-construction meeting prior to

installation if required. 3. All mandatory requirements by local Landscape Departments and their inspectors shall govern and landscape contractor commits by accepting contract to comply promptly for builder/owner to obtain C.O.

TREE REMOVAL

Removal of any trees or palms will require a written "tree removal permit" from the local governing agency prior to removal. Non-native trees classified as "prohibited" trees may be exempt from the permit if listed as Category 1 by Florida Exotic Pest Plant Council. Confirm with Local Municipality.

2. Landscape Contractor is responsible to remove ALL invasive nuisance trees such as Brazilian Pepper, Melaleuca, Australian Pine and all invasive trees as categorized by the governing agencies, whether listed on

The Landscape Contractor is responsible for coordinating tree and palm removals and transplants shown on the tree/palm Disposition Plan. The Landscape Contractor is to remove and discard from site existing unwanted trees, palms, shrubs, ground covers, sod and weeds within landscape areas.

EXISTING TREES

Existing trees designated to remain shall be protected during all construction phases. Any trees or shrubs designated to remain that are scarred or destroyed will be replaced at the contractor's expense, per the 2. Existing plant material not shown on the plan and in conflict with new planting shall be evaluated at the time of

new planting installation by the Landscape Architect. Trees and plant material indicated to be relocated with no new location provided in plans shall be moved to a location on site designated as a nursery holding area with the root ball protected from direct sunlight, maintained and irrigated until new location is determined. Prune trees to remove damaged branches and improve natural shape and thin out structure. Do not remove

more than 15% of branches. Do not prune back terminal leader.

4. Prune existing shrubs to remove damaged branches and improve natural shape.

5. Existing trees to remain shall be trimmed per Ansi-A300 standards. Supervision of the trimming shall be performed by an ISA Certified Arborist to ensure quality work. 6. All existing trees shall be "lifted and thinned" to provide an 8' minimum clearance for sidewalks and pedestrian

walkways and a 14' minimum clearance for roadways, driveways and all vehicular use areas. Selective canopy and root pruning of existing trees can be conducted (only as necessary and in no event more than 35%) to accommodate for new approved construction. Pruning shall be conducted / supervised by an ISA

8. If plans call for relocation of trees, palms or plants. High level of care should be exercised to assure that they are not damaged in the process and that they are promptly replanted upon being dug up.

9. All underground utilities and drain or irrigation lines shall be routed outside the tree protection zone. If lines must

traverse the protection area, they shall be tunneled or bored under the tree. 10. Erosion control devices such as silt fencing, debris basins, and water diversion structures shall be installed to

prevent siltation and/or erosion within the tree protection zone. 11. Roots shall be cut manually by digging a trench and cutting exposed roots with a saw, vibrating knife, rock saw, narrow trencher with sharp blades, or other approved root pruning equipment.

TREE RELOCATION (These notes for relocation trees only and if applicable) Flag all trees and palms to be transplanted with differentiating color than those to be saved or removed. Tree Relocation process must be performed or supervised by ISA Certified Arborist. Water the root zones to field capacity for 5 continuous days before root pruning. At a minimum soak the soil to a

Root prune a minimum of six weeks before relocation. Prune away all dead or damaged limbs or fronds. For trees, prune out 1/3 of the existing canopy by selectively trimming small internal branches. For palms, gather fronds above the bud and tie them loosely with jute twine to avoid damage. 4. Brace root pruned trees awaiting relocation.

5. Root prune ⁴/₃rd of the root system, irrigate daily for 2 weeks then root prune another $\frac{1}{2}$ rd, irrigate daily and prune last $\frac{1}{2}$ rd on actual relocation date, no less than two weeks (six weeks total minimum) root pruning by stages). ISA Arborist on staff shall observe for intense shock. Canopy pruning may be deemed necessary by Arborist on staff to balance for intense root ball loss, canopy shall be trimmed only as necessary to

Root prune with proper clean equipment to sever roots. Ensure roots are not torn or pulled apart. With hand tools, dig a 2'-0" wide by 3'-0" deep trench at a minimum distance as determined by the consulting arborist to expose roots. Cut all roots 1.5" and larger in diameter with a clean, sharp pruning saw. Treat all cuts with a fungicidal barrier. Backfill the trench, within 4 hours of digging, with a 1:1 mixture of site soil and sawdust or other fine organic material. Do not compact.

8. Form a rootball size in compliance with Florida grades and Florida standards number 1 or better. 9. Maintain the soil moisture at field capacity throughout the six weeks. 10. Allow the plant to regenerate roots over a period of six weeks.

4'-0" depth within a 6' radius

11. At the end of six weeks, prepare the planting pit at the new location. Overdig the hole diameter a minimum of 2' beyond the root ball, with the recipient hole to be at least 1/3 larger than the area that was trenched for

12. With the consulting arborist present, undercut the entire root ball of the plants to be transplanted at a depth specified by the arborist. The undercutting method may be a choker cable drawn through the root ball with

13. At the direction of a professional rigger, assemble slings, padding, guiding ropes and cables for attachment to the crane or backhoe. The professional rigger shall determine the size of machinery necessary to execute the lifting and moving operation. 14. Install trees within 24 hours of removal from their original location to locations provided by Landscape Architect

or Developer with approval of municipal / Landscape Inspector. 15. Recipient site to be within 4" of finished grade. Tree pit excavation to mathch the size of root ball. Top of root ball to match the finished grade

16. Maintain trees in a healthy and vigorous condition during installation and throughout the plant establishment period. Replace trees that do not meet this requirement with the same species, size, and quality or per mitigation requirements specific to the governing authority with jurisdiction. 17. Fertilize the plant as directed by the consulting arborist. 18. When the plant is placed in the new location, backfill the planting pit with topsoil and water thoroughly to

eliminate air pockets and compact the soil. Set the tree no deeper than its original condition. 19. Cover the root ball area with 3" depth of organic mulch. 20. Provide fungicide and fertility applications at the direction of the consulting arborist. 21. Post transplant watering to provide moisture and reduce any excessive stress due to root desiccation. Watering

to be adjusted according to conditions and at the supervision and direction of the ISA certified arborist-22. The diameter of the root--pruning or transplanting circle shall be at a distance away from the trunk equal to 12 times each inch of trunk diameter at breast height. 23. For all palms except Sabal palmetto, the lower fronds shall be pruned leaving 9-11 fronds that can be tied

without an extensive amount of weight that may damage the heart of the palm. The Sabal palmetto shall have all fronds cut without damaging the bud. 24. Digging and preparation of the new hole for the transplant shall be done prior to removing the tree from the

existing location. 25. The landscape Contractor is to verify that all new holes have appropriate percolation 26. Over the guarantee period the Landscape contractor shall be responsible for resetting any trees or palms that are not in a vertical position.

27. After transplanting trees and palms, the landscape contractor shall be responsible for obtaining water and watering to maintain soil moisture during the guarantee period at a minimum of: First month-daily, Second month - three times per week, Third and Fourth months - two times per week, Last eight months - one time per

SITE PREPARATION & GRADING Landscape contractor shall loosen and till compacted soils that are overly compacted in all planting areas of the project to provide for proper soil aeration for plant establishment.

health of the plants. Lime rock base material shall be removed within planting pits and adjacent to pavement. The planting areas should be clean to a depth equal to the root ball of the trees/palms proposed for the area. Planting area soils shall be tested for ph before planting. Soils showing high (alkaline) ph (over 7.5) shall be amended or replaced with native soil having a ph range of 6.5 - 7.5, as approved by Landscape Architect. 3. All planting areas and planting pits shall be tested for sufficient percolation prior to final planting and irrigation installation to ensure proper drainage. Plant beds in parking lots and in areas compacted by heavy equipment

2. Planted areas shall be cleared of underground rocks, construction debris and other materials detrimental to the

shall be de-compacted so that drainage is not impeded. 4. Landscape Contractor shall treat plant areas with pre-emergence herbicide after weeds and grass have been removed. Landscape Contractor shall wait (7) seven days after pre-emergence treatment prior to planting. 5. Site preparation shall include the eradication and removal of any weeds, clean-up of any dead material, debris, and rubbish.

6. General site and berm grading to +/- 1 inch (1") shall be provided by the general contractor. All finished site grading shall be provided by the Landscape Contractor. All planting beds shall be free of all rocks 1/2" or larger, sticks, and objectionable material including weeds and weed seeds. All lime rock shall be removed/cleaned down

The Landscape contractor shall ensure the planting areas are at finish grade prior to installing plant materials. 8. All trees and plant material to remain shall be protected during construction. Contractor shall install protective barriers such as "Tenax" orange safety fencing or similar, to be installed before the beginning of the project. Barriers shall be located to include the drip line of the trees, palms and plant material. The contractor shall take

extra caution to prevent any damage to the trunk, root zones and grade. 9. Final grade within planting areas to be 4" below adjacent paved areas or top of curb. Sod areas to be 2" below. 10. All planting beds shall be shaped and sloped to provide proper drainage away from building and structures and to swales, if applicable.

Any Irrigation Notes and specifications included in Irrigation Sheets govern over the following Irrigation Notes. 2. The Landscape Contractor shall coordinate with the irrigation contractor if not the same and leave provisions for all individual trees in turf areas and all planting beds.

3. Irrigation / Landscape contractor to guarantee 100% coverage and 50% overlap (head to head coverage) to all landscaped areas and furnish and install a rain sensor. 4. Irrigation Contractor to adapt design to onsite conditions adjusting heads and changing nozzles as required to avoid overspray onto buildings or paved areas.

5. The contractor shall ensure that the irrigation system is operational and free of leaks prior to any planting being finalized. Plant material that is installed prior to the irrigation system being operational shall be watered by the contractor at his or her expense. Water for plant establishment should be included in the cost of the plant. 6. All guidelines as outlined by the South Florida Water Management District (SFWMD) or water management district with jurisdiction shall be strictly adhered to.

7. Irrigation water whether pumped from a lake or a well shall be treated for algae, rust, etc. to provide clean treated irrigation water that will not clog or stain property or components.

8. Any existing irrigation system shall be retrofitted to comply with the specifications as outlined above.

HARDSCAPE & OTHER MATERIALS

Face of trees and palms to be located a minimum of 2' setback from all fences, walkways, walls, and paved surfaces, unless otherwise indicated on the plans. Refer to details.

1. The contractor shall be responsible for determining the location of and avoid and protect utility lines, buried cables, and other utilities. The owner or Landscape Architect shall not be responsible for damage to utility or irrigation lines 2. Trees shall be placed a minimum of 5 ft. from underground utilities, unless otherwise approved in writing by

Landscape Architect and Owner. 3. All canopy trees to be planted min. of 15' from light source/poles. Unless otherwise approved by the governing authority / Landscape Architect and Owner.

4. Landscape contractor shall contact the county, governing authority and/or utility companies to locate all underground utilities or structures prior to digging. Landscape contractor shall repair all damage to underground utilities, and/or construction caused by utility damage, at no cost to the owner.

5. All plant material symbols shown on landscape plan shall be considered diagrammatic and should be adjusted in the field by contractor to avoid all utilities, and all other obstructions. 6. If/ When digging in right of way needed: Two (2) full business days before digging, call toll free 1-800-432-4770,

or 811, Sunshine State One Call of Florida, inc. Notification Center. In addition, call the Governing Agency's Utilities/Public Works Department. Contractors are responsible for coordinating with the owners and appropriate public agencies to assist in locating and verifying all underground utilities prior to excavation. All existing utilities

shown on the plans are to be considered approximate and should be verified by the contractor prior to the start

7. Above and below ground utilities shall be verified and located in the field by the contractor prior to commencing work in the project area. The contractor shall examine available utility plans and confirm conflicts between indicated or located utilities and landscape work. The contractor shall then notify the Project Engineer of said conflicts and the Engineer will coordinate any necessary adjustments with the utility provider. Tree locations will be adjusted as necessary when in conflict with existing utilities.

8. The final plant locations may be adjusted, as approved / directed by the Landscape Architect in writing, to

accommodate utilities compliance. Excavations within 5' of known utilities should be done by hand. 9. Contractor shall familiarize himself with the location of and avoid and protect utility lines, buried cables, and all other utilities, noted or not, on plans.

10. Leave clearance and access to all above ground or at grade meters and equipment. 11. Landscape planting shall be in conformance with FPL guidelines for setbacks from overhead utility lines.

12. Landscaping shall not interfere with light poles, fire hydrants, electrical/mechanical equipment access, signs, drainage structures, etc. Bring to the attention of Landscape Architect any conflicts. ROOT BARRIERS

material and utilities from existing large trees or proposed new trees that are within 5' of existing or new approved construction or as may be deemed necessary as job progresses. 2. Mechanical Root barriers will be used for large existing Canopy Trees and chemical type barriers will be used for

Root barriers will be installed to protect building foundations, curbing, walkways, paved areas, roadway base

3. Mechanical Root barriers will be "DeepRoot" and Chemical Root barriers will be "Biobarrier". Substitutions must be of approved equal or better quality.

4. Root barriers will be installed per manufacturer specifications. 5. Root barrier depths will be determined by the manufacturer recommended depth chart and as required by on-site conditions in a case by case basis as deemed necessary by Landscape Architect Architect / ISA Arborist and Landscape Inspector.

LANDSCAPE BACKFILL & SOIL AMENDMENT

All building construction material and foreign material shall be removed from the planting areas and replaced with 70/30 mix (70% sand / 30% organic compost) or amend existing soils per section H.2. 2. Planting soil mix shall be delivered to the site in a clean loose and friable condition and is required around the root ball of all trees and shrubs, the top 6" of all shrubs and ground cover beds and top 2" of all grassed areas. This soil shall be tilled into the existing soil after the existing soil has been cleaned of all undesirable foreign

materials. Recycled compost is encouraged as a soil amendment alternative. Planting soil to be weed free. Planting backfill for palms shall be clean coarse native sand unless specified elsewhere. 4. Do not allow air pockets to form when backfilling. All trees shall be watered-in utilizing water probe or a tree bar.

PLANT SIZE & QUALITY 1. All plant material must meet or exceed the minimum size requirements as specified on the plant list. Height specification governs over container size if both specifications given cannot be met. Any other requirements for

specific shape or effect as noted on the plan shall also be required for acceptance. 2. Material specified as Balled and Burlapped (B&B) can be accepted in container if not available as B&B at the discretion of Landscape Architect; if so, root bound and/or circling roots shall be removed and root ball must be proportionate to Tree / Palm.

3. U.O.N, All trees designated as single trunk shall have a single, relatively straight, dominant leader, proper structural branching and even branch distribution. Trunks on palms shall be uniform in thickness for the entire length of the palm and shall not taper off to disproportionate thinness towards the crown. Trees with bark inclusion, tipped branches, and co-dominant trunks will not be accepted. Trees with girdling, circling and/or

plunging roots will be rejected. 4. Use nursery grown plant materials that complies with all required inspection, grading standards, and plant regulations in accordance with the latest edition of Florida Department of Agriculture, "Grade & Standards for

Nursery Plants" 5. All trees and palms shall be free of open wounds and unsightly visible scars. 6. All substitutions must be approved by the governing authority if it is required Canopy and by Landscape Architect

/ Owner if supplementary accent material. 7. Contractor shall comply with Federal, State, and Local laws and regulations pertaining to the inspection for plant disease and insect infestation.

8. Trees, palms, shrubs, ground covers: Plant species and sizes shall conform to those indicated on the drawings. All nursery stock shall be in accordance with grades and standards for nursery plants parts 1 and 2, latest edition published by the Florida Department of Agriculture and Consumer Services, unless specified otherwise. All plants shall be Florida grade number 1 or better as determined by the Florida Division of Plant Industry and tightly knit plant, so trained or favored in its development that first appearance is unquestionable and it is outstandingly superior in form, number of branches, compactness and symmetry. All plants shall be freshly dug, sound, healthy, vigorous, well branched and free of disease and insect eggs and larvae and shall have adequate root systems. Trees and palms shall be uniform in size and shape. All materials shall be subject to approval by the Landscape architect.

Plants shall be pruned prior to delivery only upon the approval of the Landscape Architect. 9. All container grown material shall be healthy, vigorous, well-rooted plants and established in the container in which they are sold. The plants shall have tops of good quality and be in a healthy growing condition. An established container grown plant shall be transplanted into a container and grown in that container sufficiently long enough for the new fibrous roots to have developed so that the root mass will retain its shape and hold together when removed from the container.

10. Field grown trees and palms previously root pruned shall obtain a root ball with sufficient roots for continued growth without resulting shock

11. Root suckers on any tree are not acceptable and must be properly pruned. 12. Contractor shall coordinate with Landscape Architect and Owner to obtain prior approval for the selection of the specific specimens of all palms and any trees of more than six feet in height. Contractor to supply photograph of trees prior to purchase and installation.

PLANTING NOTES

1. At the discretion of the Landscape Architect, plants are subject to review for approval for size, variety, condition and appropriateness to the design intent. 2. All synthetic burlap, synthetic string or cords, or wire baskets shall be removed before any trees are planted. All synthetic tape (i.e. tagging tape, nursery tape) shall be removed from trunks, branches, etc. before inspection. The top 1/3 of any natural burlap shall be removed or tucked into the planting hole before the trees are back

3. All "groundcover" requires 75% coverage and 100% within 3 months of installation. Bring to the attention of Landscape Architect in writing before commencing if this is not achievable with the design. 4. Set tree no deeper than it was in its original growing condition with the top of the root ball even with, or slightly

higher (+/- 1") than the finished grade. 5. All trees/palms shall be planted so the top of the root ball, root flair are slightly above final grade. Shrub material shall be planted such that the top of the plant ball is flush with the surrounding grade.

6. All trees and palms shall be braced / staked per accepted standards by the Florida Nursery, Growers & Landscape Association (FNGLA). Nailing into trees and palms for any reason is prohibited and the material will be rejected. Please refer to the planting details. All trees, new or relocated, to be staked and guyed as detailed.

8. Layout shrubs to create a continuous smooth front line and fill in behind with triangular spacing. 9. Excavate pit or trench to 1-1/2 times the diameter of the balls or containers or 1' wider than the spread of roots and 3" deeper than required for positioning at proper height. Compact a layer of topsoil in bottom before placing

plants. Backfill around plants with planting mixture, compacted to eliminate voids and air pockets. Form grade slightly dished and bermed at edges of excavation. Apply 3" of mulch. 10. Groundcover and shrubs to be spaced in a uniform and consistent pattern per planting details.

11. All mechanical equipment, irrigation pumps, FPL transformers, pool pumps, etc. shall be screened on a minimum of three sides by landscape shrubs. 12. Contractor shall not mark or scar trunks in any fashion.

13. When requested by Landscape Architect, demonstration of healthy root system if not previously approved, can include tree removal and re-installation for inspection at no additional cost to the owner.

14. Remove rejected Plant material from the Site immediately and replace with acceptable plants.

FERTILIZATION

1. All Fertilization shall comply with state fertilization laws. Fertilization shall be Agriform "20-10-5 Plus minors" or similar approved slow-release tablets applied per manufacturer suggested application rate chart: Agriform® 21-gm Tablets (SKU# 90026*; 500 tablets/case)

NEW Tree / Shrub Container Size 1 Gal 2 Gal 3 Gal 5 Gal 7 Gal 15 Gal 24" Box Installation: 1 1 to 2 2 to 3 2 to 3 3 to 5 7 to 10 15 to 24

· Place plant in the hole and backfill to halfway point. • Do not place tablets in the bottom of the planting hole. Place Agriform Tablets in the hole about 1to 2 inches away from root tips. Finish filling the hole around the plant to grade level. SCOTTS: 1-800-492-8255 or visit www.scottspro.com

3. Sod shall be machine stripped no more than 24 hours prior to laying.

1. All areas disturbed during construction shall be sodded with St. Augustine 'Seville' unless otherwise noted. These disturbed areas shall have proper irrigation established or re-established if they were disrupted or

non-functional. Landscape Contractor to supply and install 2" soil layer 50/50 mix blanket for all new sod areas. 2. All open areas not covered by trees, palms, shrubs, vines, ground covers or existing sod in good condition to remain, shall receive Stenotaphrum Secundatum, St. Augustine 'Seville' sod, whether labeled on the plans or not, unless a different species is indicated on the planting plan. Sod shall be strongly rooted, free from weed, fungus, insects and disease. Contractor shall be paid by the total sodded area x the unit price submitted (field verified).

4. Lay sod strips with tight joints, do not overlap, stagger strips to offset joints in adjacent courses. Work sifted soil mix into minor cracks between pieces of sod and remove excess soil deposits from sodded areas. Sod on slopes greater than 3:1 shall be immediately staked after planting.

1. Submit 1 gallon container of all planting media for landscape architect review. Samples to include specified

planting mix, topsoil, container planting mix (if applicable) and mulch. 2. Submit representative nursery photos of all Trees and Palms for review prior to delivery to the site. Include scale

3. Submit representative nursery photos of all shrub and groundcover material for review prior to delivery to the site.

 Notify the governing Agency if required and Landscape Architect of commencement 2. Onsite plant deliveries shall occur on Monday through Friday only unless otherwise directed by the Landscape Architect / Owner. The contractor shall ensure that plant material is delivered undamaged from transportation or digging operations. The Landscape Architect may reject material that has been damaged or rendered unacceptable due to relocation or transportation from the point of origin. All plant material shall be available for inspection and approval by the Landscape Architect prior to final installation.

3. There shall be one final inspection for approval by each of the presiding governing agency, Landscape Architect and owner. Contractor shall ensure that the plans, details, specifications and notes have been adhered to and that the landscape and irrigation installation is compliant to all items as directed on the plans prior to scheduling of the final inspection

4. Upon completion of the work, the Landscape Contractor shall notify the Landscape Architect and request a final inspection. Any items that are judged incomplete or unacceptable by the Landscape Architect or owner shall be

promptly corrected by the Landscape Contractor. 5. No substitution of plant material, type or sizes will be permitted without prior written authorization from the

Landscape Architect and owner. 6. To obtain final payment, Contractor must provide release of all mechanic's liens and material liens.

1. All planting beds shall be mulched to a depth of 3" with an organic mulch approved by Landscape Architect. No heavy metals, such as arsenic, etc. are to be contained in the mulch. The contractor shall provide certification if

requested or proof that all mulch is free of heavy metals or similar environmental contaminants. 2. Shredded approved organic mulch to be used beyond trunk in all directions and throughout all hedges and plant

4. Preferred mulch is shredded melaleuca. Cypress, red, gold and green mulch is prohibited. 5. All mulch shall have a minimum 3" separation from the trunk of the tree/palm trunk to avoid rotting.

3. All trees in sodded areas shall have a clean cut 4' diameter mulch ring.

U. WATERING

1. All plant material shall be watered in thoroughly at the time of planting. 2. It is the sole responsibility of the Landscape Contractor to ensure that all new plantings receive adequate water during the installation and until completion of contract. Deep watering of all new trees and palms and any supplemental watering that may be required to augment natural rainfall and site irrigation is mandatory to ensure proper plant establishment and development and shall be provided by Contractor as a part of this contract.

1. The Landscape Contractor is responsible for maintaining all landscape planting areas until final acceptance of the owner. 2. The contractor is responsible for mowing the entire project during planting and establishment periods, based on

mowing project once a month from October to April, and twice a month from April to October (During installation and plant establishment only and until final inspection and owner accepts and takes ownership). 3. Any excess soil, undesired stones or debris resulting from landscape operations shall be removed promptly,

keeping the site clean as work progresses. 4. The Landscape Contractor shall at all times keep the premises free from accumulation of waste material or debris caused by their crews during the performance of the work. Upon completion of the work, the contractor shall promptly remove all waste materials, debris, unused plant material, empty plant containers, and all equipment from the project site.

W. MAINTENANCE

choose to retain 5% of payment to ensure compliance. 2. The Landscape Contractor shall water, mulch, weed, prune, and otherwise maintain all plants, including sod, until completion of contract or acceptance by landscape architect. Settled plants shall be reset to proper grade, planting saucers restored, and defective work corrected. 3. Trees and shrubs shall be maintained to keep clearance of stop signs and safety clearance for visibility at traffic

1. Landscape Contractor to return to job site 12 months after tree bracing and remove all tree braces. Owner may

intersection.

GUARANTEE & REPLACEMENT 1. By accepting the contract, the Contractor is thereby guaranteeing all plant materials and design for a period of not less than one (1) year from the time of final acceptance by the owner. Contractor shall replace any plants which die or wither within such period with healthy plants that meet specifications of the same species and size without additional cost to the owner unless such death or withering is due to Owner's failure to do ordinary maintenance on such plants after final acceptance in accordance with any maintenance instructions given by Landscape Architect for such plants. Such replacement shall include all plants and labor to plant the replacement plants. Any plant materials damaged by lightning, storms, freeze damage or other "acts of God" as well plants damaged by vehicles, vandalism or neglect are not included in this replacement agreement. If requested, the Landscape Architect may act as a mediator between owner and Landscape Contractor on a time material basis.

"Plants" includes all trees, palms, shrubs, grass and other plants provided or planted by Contractor.

document shall control.

MISCELLANEOUS. 1. All work to be done in a professional manner. 2. No change order shall be valid, due or paid unless it is approved by Owner in writing in advance. 3. These notes shall be an integral part of the contract of Contractor and shall be deemed incorporated therein by reference. In the event of a conflict among the terms among the plans and these notes, the terms of this

ISA CA or ISA Arborist = International Society of Arboriculture Certified Arborist

ABBREVIATIONS IN NOTES AND PLANS

UNO = Unless Otherwise Noted L.A = Landscape Architect S.F. = Square Feet STD = Standard (single trunk) B&B = Balled and Burlapped BLDG DEP = Building Department RFI = Request for Information FPL= Florida Power & Light C.O. = Certificate of Occupancy

301 East Atlantic Blvd Pompano Beach, FL 33060

PH: (954) 788-3400 Florida Engineering Business License: CA7928 Florida Surveyor and Mapper Business License: LB6860

Iorida Landscape Architecture Business License: LC26000457


REVISIONS DESCRIPTION DATE TAC - P&Z 09/13/2023 FINAL TAC - P&Z 11/15/2023 FINAL TAC-RESUBMITTAL 11/30/2023 PDB APPROVAL 12/12/2023

PRELIMINARY PLAN NOT FOR CONSTRUCTION

THESE PLANS ARE NOT FULLY PERMITTED

AND ARE SUBJECT TO REVISIONS MADE DURING THE PERMITTING PROCESS. RESPONSIBILITY FOR THE USE OF THESE PLANS PRIOR TO OBTAINING PERMITS FROM ALL AGENCIES HAVING JURISDICTION OVER THE PROJECT WILL FALL SOLELY UPON THE

ISSUE DATE: 06/30/2023 DESIGNED BY: DRAWN BY: CP, RP KS, PW CHECKED BY: BID-CONTRACT:

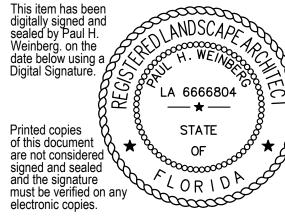

PAUL H. WEINBERG, PLA FLORIDA REG. NO. LA6666804 (FOR THE FIRM)

CLIENT

1817 TAYLOR DEVELOPMENT LLC

PROJECT

STAR TOWER HOLLYWOOD


410 N. FEDERAL HWY HOLLYWOOD, FL 33020

SHEET TITLE

NUMBER

PLANTING NOTES

LP-001 NUMBER 13778.00

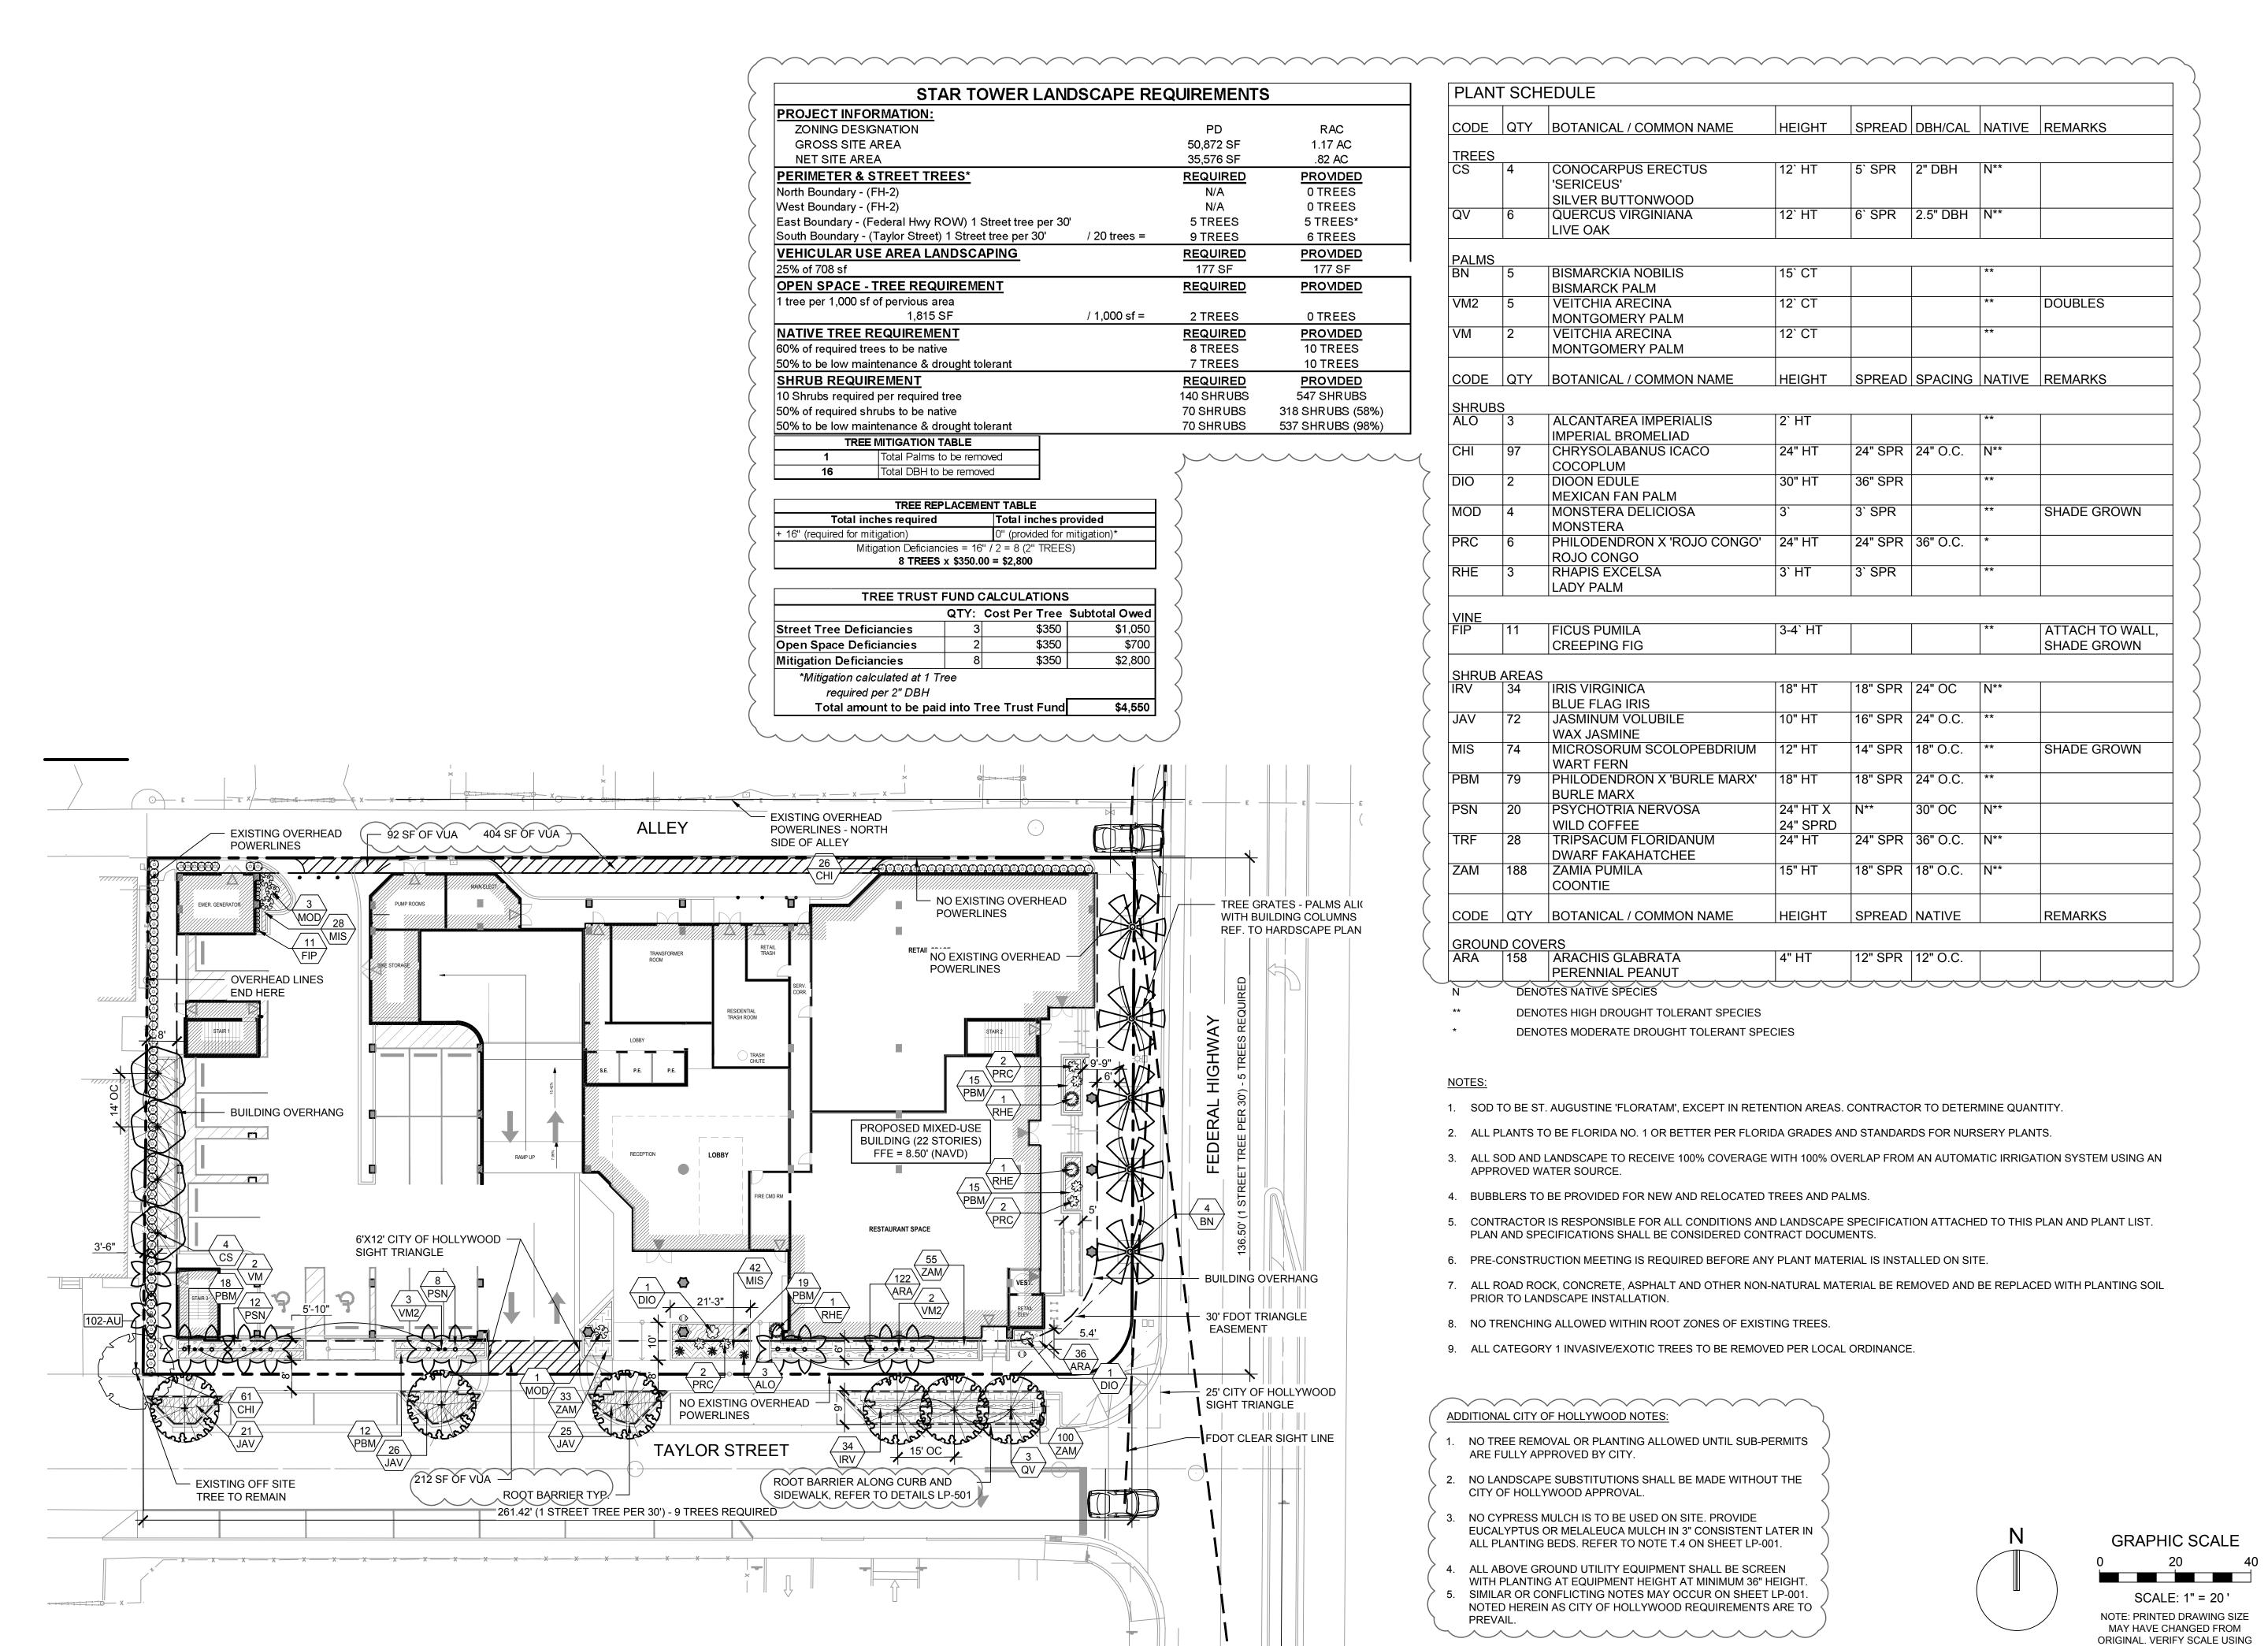

Pompano Beach, FL 33060

PH: (954) 788-3400 Florida Engineering Business License: CA7928

Florida Surveyor and Mapper Business License: LB6860 Florida Landscape Architecture Business License: LC2600045 **REVISIONS**


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	TAC - P&Z	09/13/2023
	FINAL TAC - P&Z	11/15/2023
	FINAL TAC-RESUBMITTAL	11/30/2023
	PDB APPROVAL	12/12/2023

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ISSUE DATE:	06/30/2023
DESIGNED BY:	СР
DRAWN BY:	CP, RP
CHECKED BY:	KS, PW
BID-CONTRACT:	



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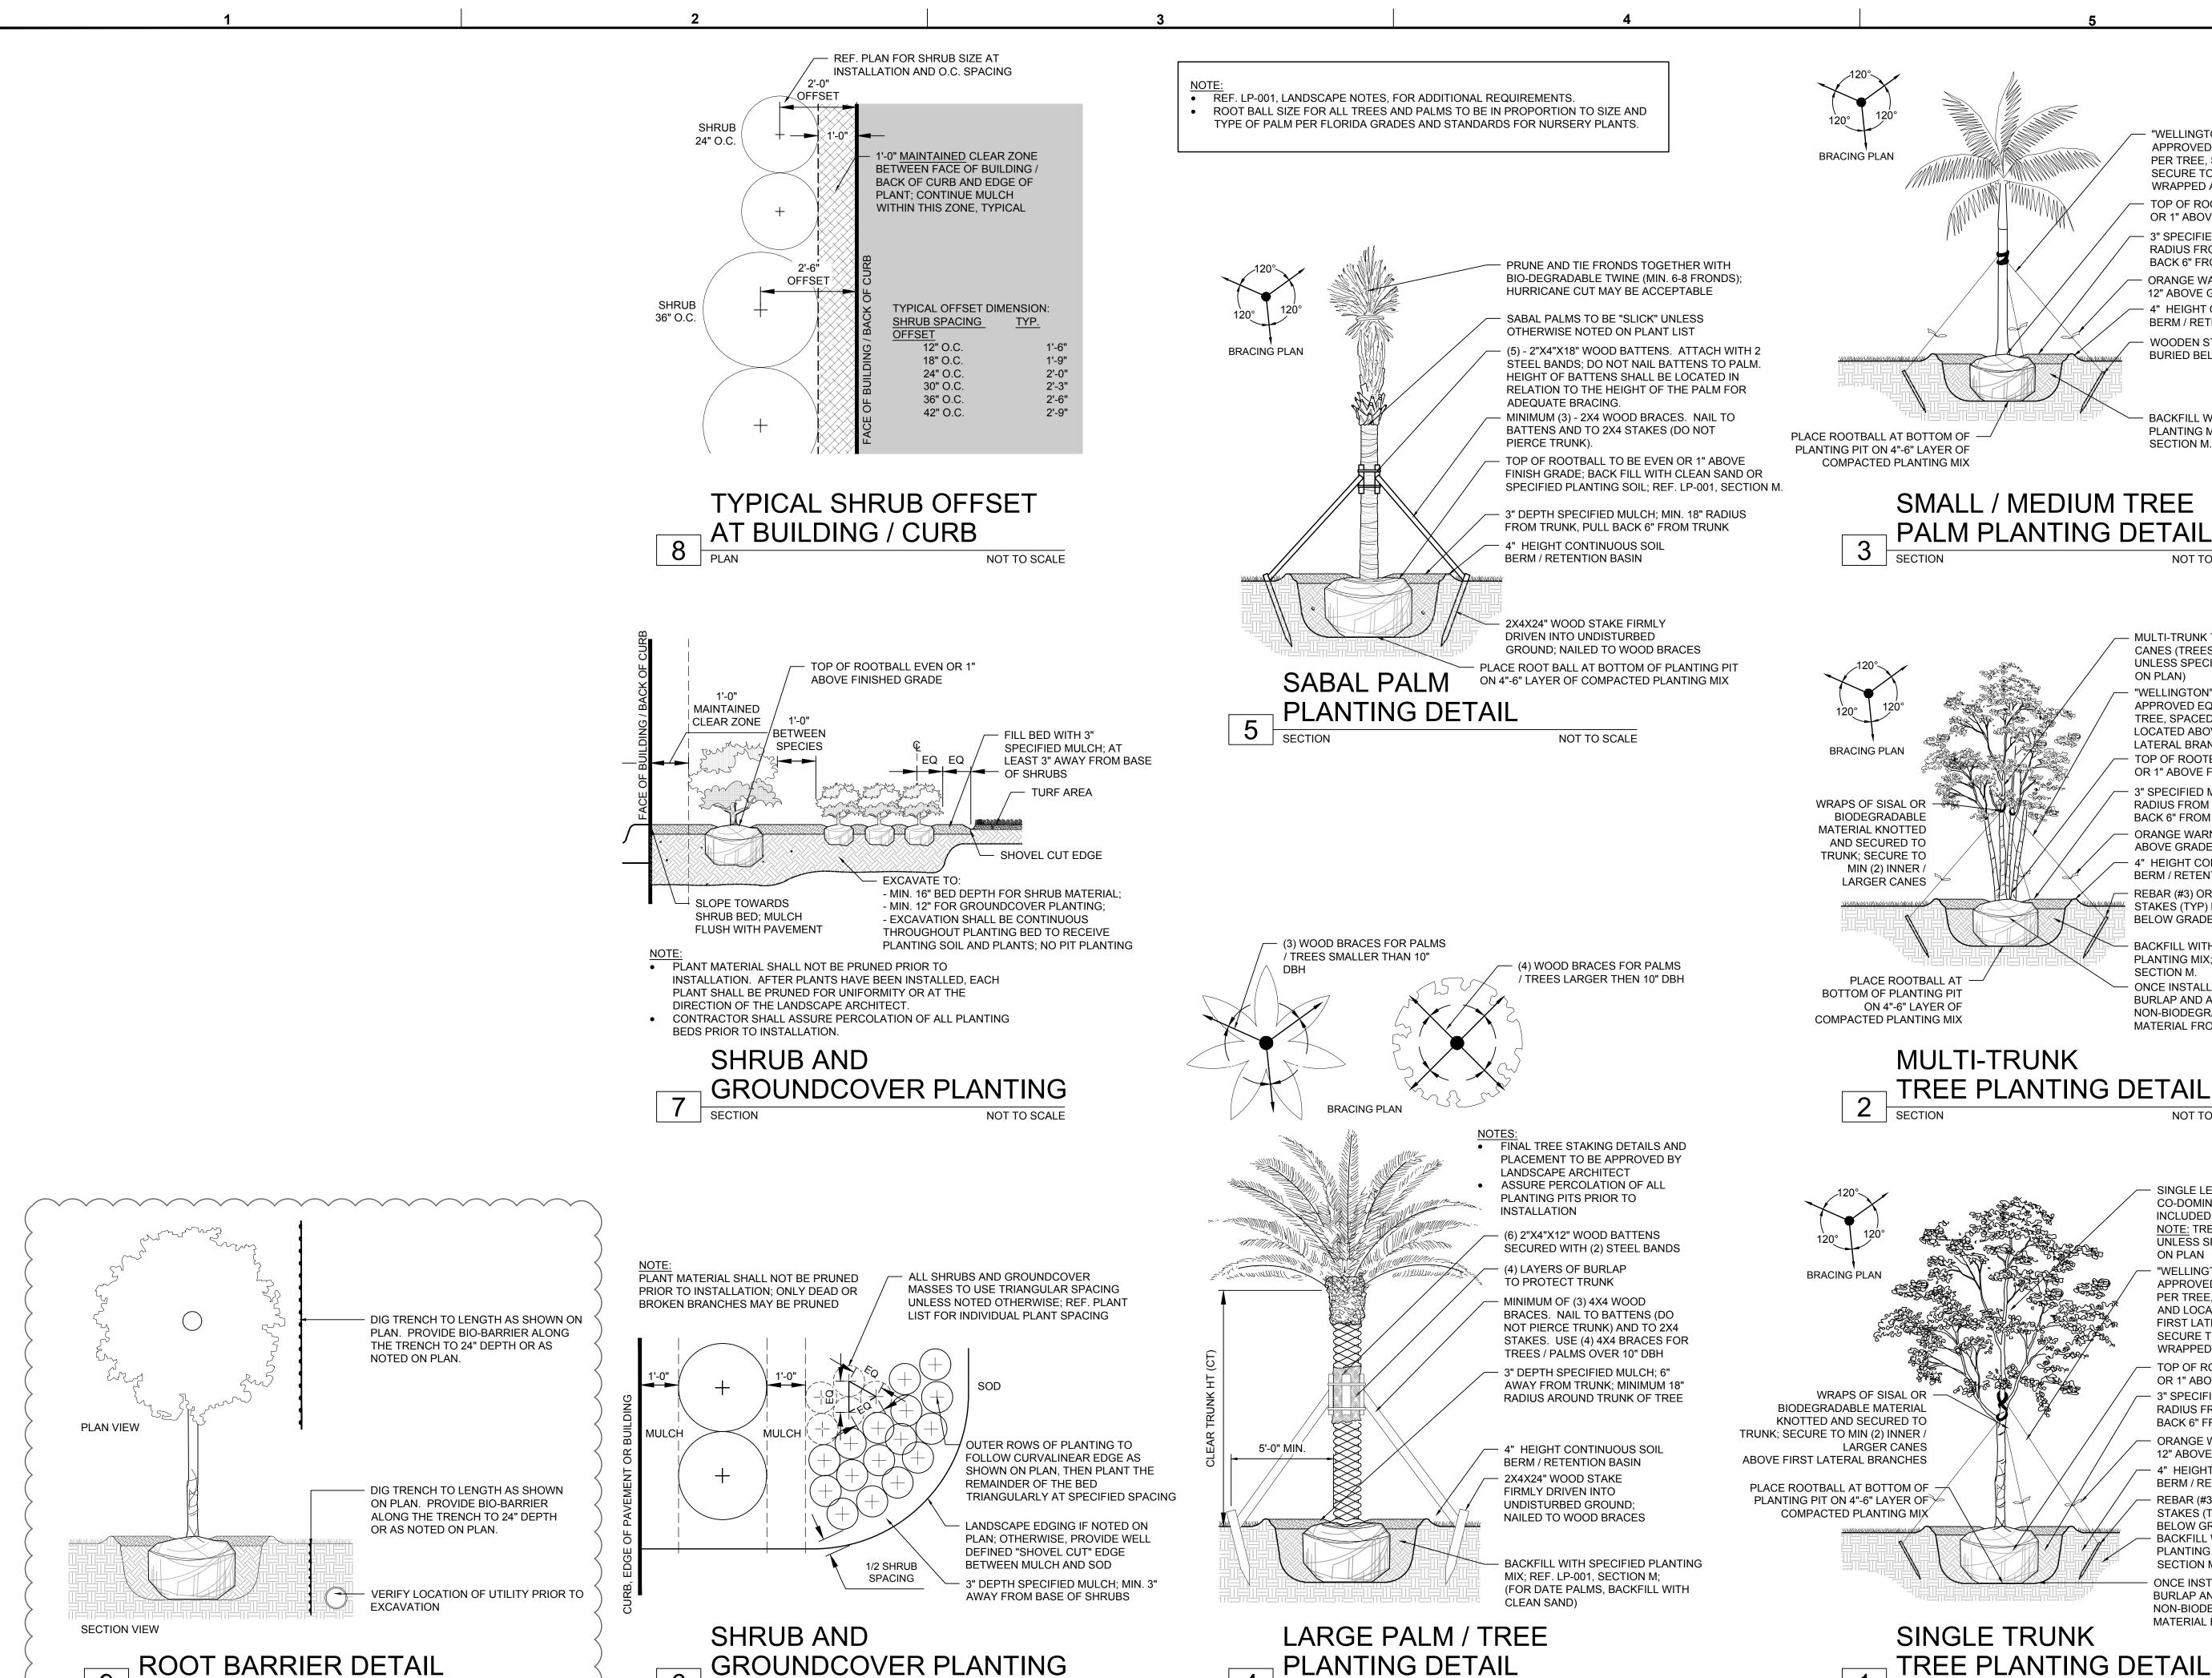
410 N. FEDERAL HWY HOLLYWOOD, FL 33020

SHEET TITLE

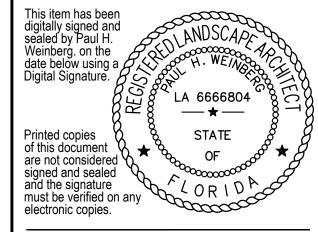PLANTING PLAN


LP-101 NUMBER PROJEC1 13778.00 NUMBER

BAR SCALE ABOVE.



NOT TO SCALE

NOT TO SCALE

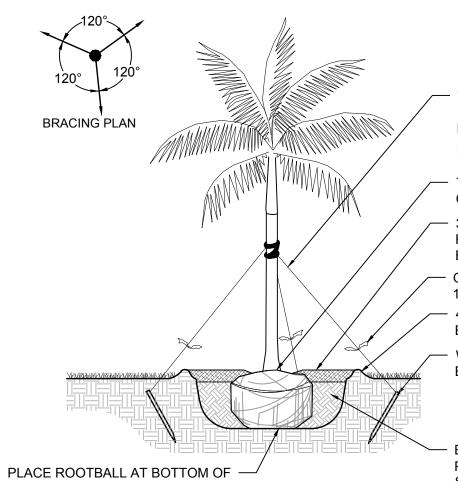

"WELLINGTON" TAPE OR APPROVED EQUAL. 3 GUYS PER TREE, SPACED EQUALLY; SECURE TO SISAL ROPE WRAPPED AROUND TRUNK OR 1" ABOVE FINISH GRADE

TOP OF ROOTBALL TO BE EVEN 3" SPECIFIED MULCH; MIN. 18" RADIUS FROM TRUNK, PULL BACK 6" FROM TRUNK - ORANGE WARNING TAPE 12" ABOVE GRADE 4" HEIGHT CONTINUOUS SOIL BERM / RETENTION BASIN WOODEN STAKES (TYP) **BURIED BELOW GRADE**

BACKFILL WITH SPECIFIED PLANTING MIX; REF. LP-001, SECTION M.

SMALL / MEDIUM TREE PALM PLANTING DETAIL

NOT TO SCALE

ON PLAN)

- MULTI-TRUNK TREE, MIN. 3-5 CANES (TREES TO BE B&B UNLESS SPECIFIED OTHERWISE

TREE, SPACED EQUALLY AND LOCATED ABOVE THE FIRST LATERAL BRANCHES TOP OF ROOTBALL TO BE EVEN OR 1" ABOVE FINISH GRADE 3" SPECIFIED MULCH; MIN. 18" RADIUS FROM TRUNK, PULL BACK 6" FROM TRUNK - ORANGE WARNING TAPE 12"

ABOVE GRADE — 4" HEIGHT CONTINUOUS SOIL BERM / RETENTION BASIN — REBAR (#3) OR WOODEN

"WELLINGTON" TAPE OR

APPROVED EQUAL. 3 GUYS PER

STAKES (TYP) BURIED **BELOW GRADE** BACKFILL WITH SPECIFIED PLANTING MIX; REF. LP-001,

SECTION M. ONCE INSTALLED, REMOVE 1/3 BURLAP AND ALL WIRE AND NON-BIODEGRADABLE MATERIAL FROM THE ROOTBALL

NOT TO SCALE

SINGLE LEADER (NO

INCLUDED BARK)

CO-DOMINANT LEADERS, NO

NOTE: TREES TO BE B&B

APPROVED EQUAL. 3 GUYS

PER TREE, SPACED EQUALLY

AND LOCATED ABOVE THE

FIRST LATERAL BRANCHES;

WRAPPED AROUND TRUNK

SECURE TO SISAL ROPE

1817 TAYLOR

410 N. FEDERAL HWY HOLLYWOOD, FL 33020

LP-501 NUMBER **PROJECT** 13778.00 NUMBER

ON PLAN "WELLINGTON" TAPE OR TOP OF ROOTBALL TO BE EVEN OR 1" ABOVE FINISH GRADE

NOT TO SCALE

- 3" SPECIFIED MULCH; MIN. 18" RADIUS FROM TRUNK, PULL BACK 6" FROM TRUNK ORANGE WARNING TAPE 12" ABOVE GRADE - 4" HEIGHT CONTINUOUS SOIL BERM / RETENTION BASIN

REBAR (#3) OR WOODEN STAKES (TYP) BURIED **BELOW GRADE** BACKFILL WITH SPECIFIED PLANTING MIX; REF. LP-001,

SECTION M. ONCE INSTALLED, REMOVE 1/3 BURLAP AND ALL WIRE AND NON-BIODEGRADABLE MATERIAL FROM THE ROOTBALL

SINGLE TRUNK TREE PLANTING DETAIL SECTION

NOT TO SCALE

301 East Atlantic Blvd Pompano Beach, FL 33060 PH: (954) 788-3400 Florida Engineering Business License: CA7928

Florida Surveyor and Mapper Business License: LB6860 Iorida Landscape Architecture Business License: LC260004 REVISIONS DATE DESCRIPTION TAC - P&Z 09/13/2023

FINAL TAC - P&Z 11/15/2023 FINAL TAC-RESUBMITTAL 11/30/2023 PDB APPROVAL 12/12/2023

> PRELIMINARY PLAN NOT FOR CONSTRUCTION

THESE PLANS ARE NOT FULLY PERMITTED

AND ARE SUBJECT TO REVISIONS MADE **DURING THE PERMITTING PROCESS.** RESPONSIBILITY FOR THE USE OF THESE PLANS PRIOR TO OBTAINING PERMITS FROM **ALL AGENCIES HAVING JURISDICTION OVER** THE PROJECT WILL FALL SOLELY UPON THE

ISSUE DATE:	06/30/2023
DESIGNED BY:	СР
DRAWN BY:	CP, RP
CHECKED BY:	KS, PW
BID-CONTRACT:	

This item has been digitally signed and sealed by Paul H. Weinberg. on the date below using a Digital Signature. LA 6666804 STATE Printed copies of this document are not consider signed and sealed and the signature LORIDA must be verified on any electronic copies.

PAUL H. WEINBERG, PLA FLORIDA REG. NO. LA6666804 (FOR THE FIRM)

CLIENT


DEVELOPMENT LLC

UNLESS SPECIFIED OTHERWISE | PROJECT

STAR TOWER HOLLYWOOD

SHEET TITLE

PLANTING DETAILS

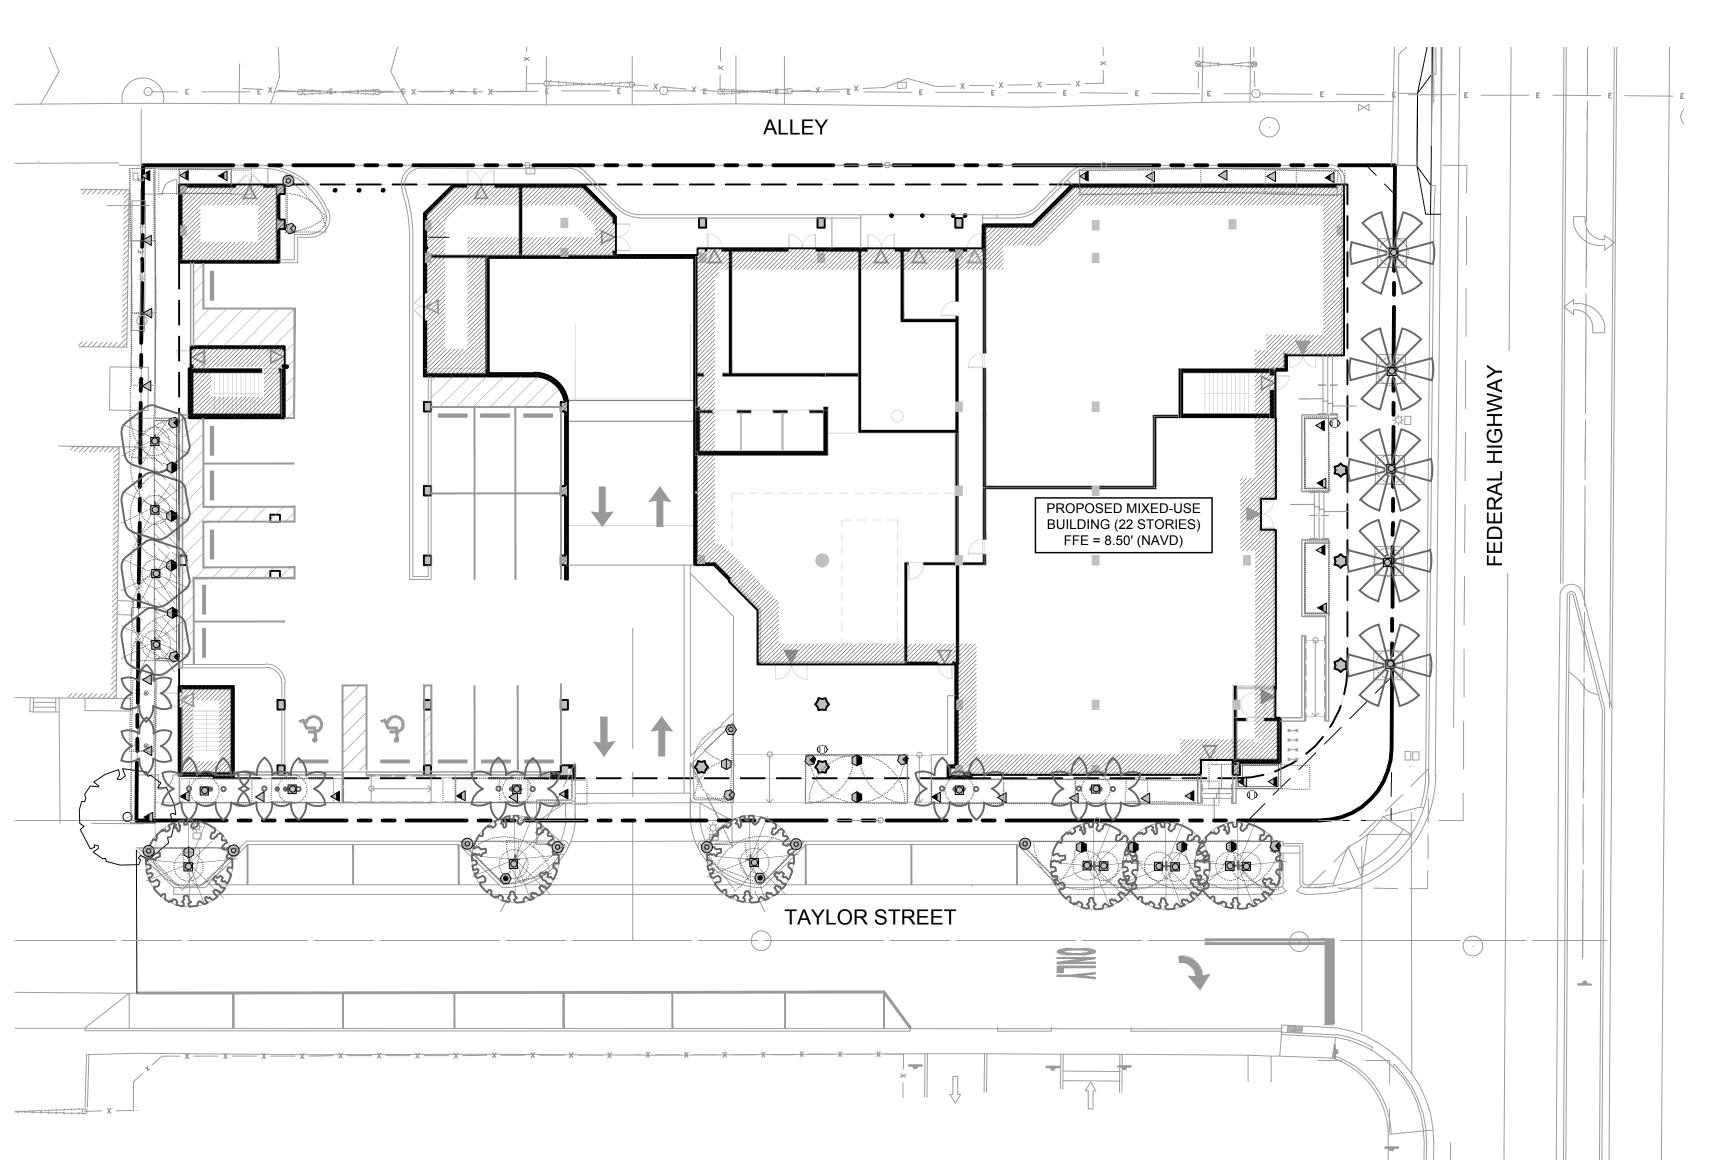


- 1. ALL SOD AND LANDSCAPE TO RECEIVE 100% COVERAGE WITH 100% OVERLAP FROM AN AUTOMATIC IRRIGATION SYSTEM USING AN APPROVED WATER SOURCE.
- 2. A RAIN SENSOR MUST BE INSTALLED TO OVER-RIDE THE CONTROLLER.
- 3. BUBBLERS TO BE PROVIDED FOR NEW AND RELOCATED TREES AND PALMS.
- 4. CONTRACTOR IS RESPONSIBLE FOR ALL CONDITIONS AND IRRIGATION SPECIFICATION ATTACHED TO THIS PLAN. PLAN AND SPECIFICATIONS SHALL BE CONSIDERED CONTRACT DOCUMENTS.
- 5. INVESTIGATE TO DETERMINE AND VERIFY THE LOCATION OF UNDERGROUND UTILITIES BEFORE EXCAVATION.
- REFER TO SHEET LI-501 FOR ADDITIONAL IRRIGATION SPECIFICATIONS AND DETAILS.
- 7. NOZZLE SELECTION BASED ON COVERAGE REQUIREMENTS.

RRIGATION	SCHEDULE
SYMBOL	MANUFAC

SYMBOL	MANUFACTURER/MODEL/DESCRIPTION	QTY	PSI
EST LCS RCS CST SST	HUNTER PROS-06 STRIP SERIES SHRUB SPRAY, 6IN. POP-UP. CO-MOLDED WIPER SEAL WITH UV RESISTANT MATERIAL.	32	30
⊕ ⇔ ⊖ ⇔ Q T H F	HUNTER PROS-06 8 SERIES SHRUB SPRAY, 6IN. POP-UP. CO-MOLDED WIPER SEAL WITH UV RESISTANT MATERIAL.	5	30
Q T H F	HUNTER PROS-06 10 SERIES SHRUB SPRAY, 6IN. POP-UP. CO-MOLDED WIPER SEAL WITH UV RESISTANT MATERIAL.	15	30
© © © © © © 4 6 8 10 12 15 17	HUNTER PROS-06 ADJ SERIES SHRUB SPRAY, 6IN. POP-UP. CO-MOLDED WIPER SEAL WITH UV RESISTANT MATERIAL.	11	30
25 50 10 20	HUNTER PCB FLOOD BUBBLER, 1/2IN. FIPT.	23	30

Valve Callout

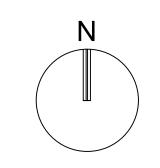

GRAPHIC SCALE

SCALE: 1" = 20 ' NOTE: PRINTED DRAWING SIZE MAY HAVE CHANGED FROM ORIGINAL. VERIFY SCALE USING BAR SCALE ABOVE.

LI-101 NUMBER PROJECT 13778.00 NUMBER

301 East Atlantic Blvd. Pompano Beach, FL 33060 PH: (954) 788-3400 Florida Engineering Business License: CA7928 Florida Surveyor and Mapper Business License: LB6860

lorida	orida Landscape Architecture Business License: LC26000457		
REVISIONS			On 2/6/2024 9:36 AM
10.	DESCRIPTION	DATE	24 9:
	TAC - P&Z	09/13/2023	3/20;
	FINAL TAC - P&Z	11/15/2023	n 2/6
	FINAL TAC-RESUBMITTAL	11/30/2023	
	PDB APPROVAL	12/12/2023	اق
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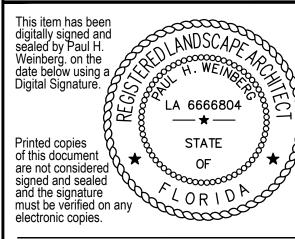
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CLIENT

1817 TAYLOR DEVELOPMENT LLC


PROJECT

STAR TOWER HOLLYWOOD

410 N. FEDERAL HWY HOLLYWOOD, FL 33020


SHEET TITLE

IRRIGATION PLAN

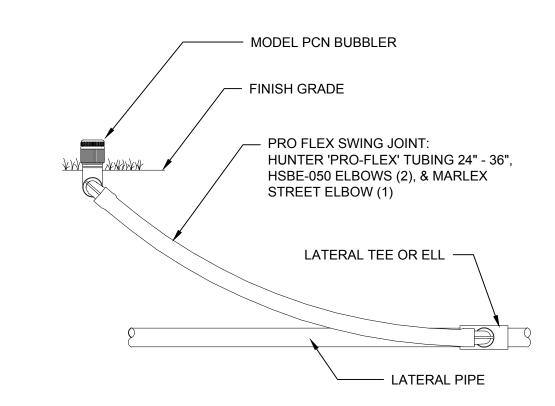


HUNTER IRRIGATION DETAIL PCN BUBBLER

NOT TO SCALE

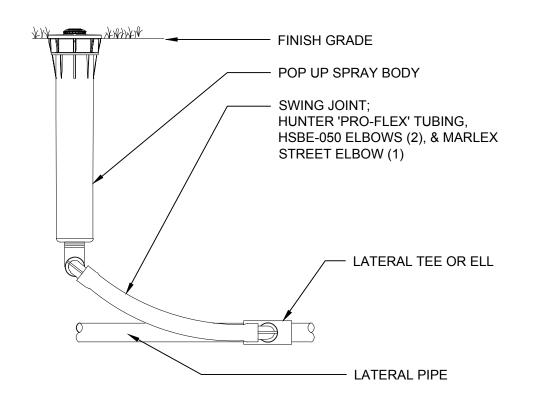


HUNTER IRRIGATION DETAIL 6" POP-UP SPRAY HEAD

NOT TO SCALE

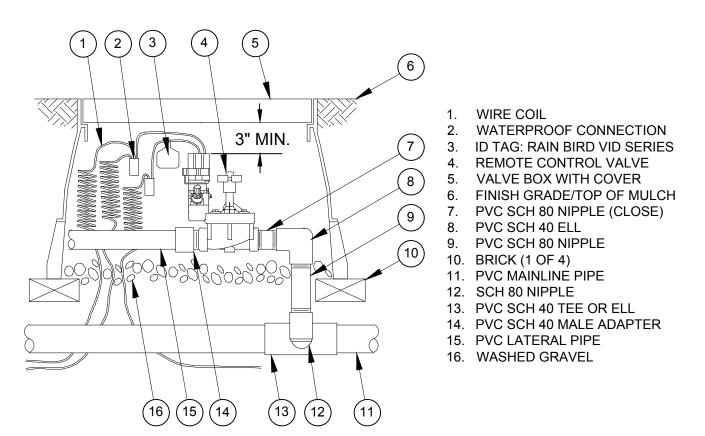


ELECTRIC ZONE VALVE/BOX NOT TO SCALE

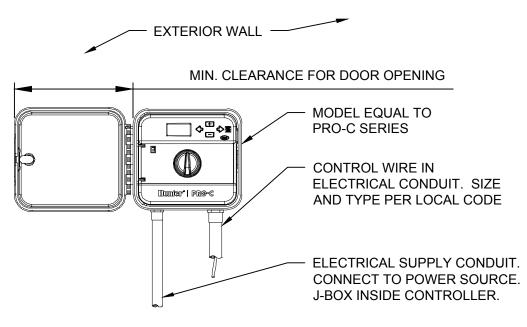

MOUNT CONTROLLER WITH LCD SCREEN AT EYE LEVEL. CONTROLLER SHALL BE HARD-WIRED TO GROUNDED 110V AC SOURCE. SOLAR SYNC (OR EQUAL RAIN SENSOR) TO BE PROVIDED.

HUNTER IRRIGATION DETAIL PROC-C CONTROLLER

NOT TO SCALE

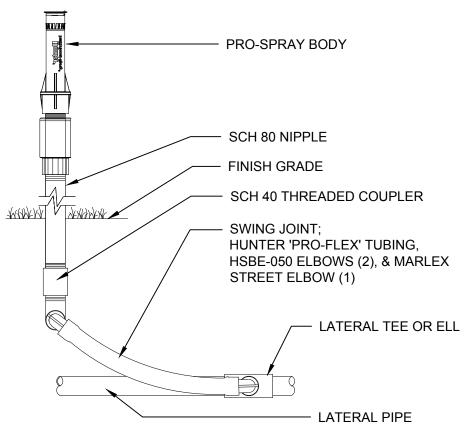


HUNTER IRRIGATION DETAIL SPRAY HEAD ON RISER NOT TO SCALE

OF HIGH FRICTION LOSS IN SWING JOINTS. — FINISH GRADE - MODEL PGP ROTOR HEAD SWING JOINT; HUNTER 'PRO-FLEX' TUBING, HSBE-075 ELBOWS (2), & MARLEX STREET ELBOW (1) - LATERAL TEE OR ELL LATERAL PIPE

*WHEN USING LARGER GPM NOZZLES, BEWARE

HUNTER IRRIGATION DETAIL PGP ROTOR HEAD

NOT TO SCALE

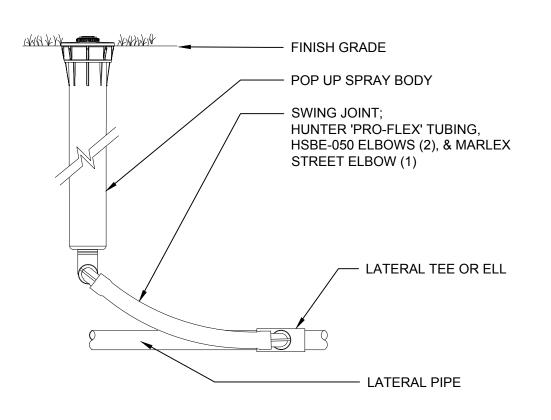

HUNTER IRRIGATION DETAIL 12" POP-UP SPRAY HEAD

NOT TO SCALE

IRRIGATION NOTES

- THE CONTRACTOR IS RESPONSIBLE FOR ALL MATERIAL REQUIRED TO MAKE THE SYSTEM FUNCTION PROPERLY. ALL IRRIGATION SHALL BE INSTALLED IN ACCORDANCE WITH MANUFACTURER'S SPECIFICATIONS AND ALSO STATE AND/OR LOCAL CODES.
- . IRRIGATION PLANS ARE SCHEMATIC AND DRAWN FOR GRAPHIC CLARITY. ALL PIPING BELOW PAVEMENT SHALL BE SLEEVED. LAYOUT OF IRRIGATION SYSTEM SHALL BE COORDINATED WITH CORRESPONDING LANDSCAPE PLAN.
- 3. THE CONTRACTOR SHALL BE RESPONSIBLE FOR CONTACTING LOCAL UNDERGROUND UTILITY PROVIDERS TO VERIFY LOCATIONS. THE CONTRACTOR IS ENCOURAGED TO VISIT THE SITE PRIOR TO INSTALLATION AND BECOME FAMILIAR WITH EXISTING CONDITIONS.
- VALVE LOCATIONS ARE SCHEMATIC ONLY AND WILL BE ADJUSTED FOR SITE CONDITIONS. EACH VALVE SHALL BE INSTALLED IN A AMETEK OR CARSON VALVE BOX. THE FLOW ADJUSTMENT FEATURE WILL BE USED TO BALANCE PRESSURE THROUGHOUT THE SYSTEM.
- 5. PIPING SHALL BE SIZED TO MINIMIZE FRICTION LOSS AND MAINTAIN FLOW VELOCITY BELOW 5
- 6. THE IRRIGATION CONTROLLER SHALL BE INSTALLED IN ACCORDANCE WITH LOCAL CODES AND MANUFACTURER'S RECOMMENDATIONS. PROPER GROUNDING EQUIPMENT AND SURGE PROTECTION SHALL BE PROVIDED. A RAIN SENSOR SHALL BE INSTALLED TO OVER-RIDE THE
- 7. ALL HEADS ON RISERS SHALL BE SET AT THE HEIGHT OF ADJACENT PLANT MATERIAL.
- 8. SPRINKLER LOCATIONS ADJACENT TO PAVEMENT, STRUCTURES, FENCES, ETC. SHALL BE OFFSET AS FOLLOWS: 12" MIN FOR POP-UP MIST HEADS, 18" FOR SHRUB RISERS, 18" FOR ROTOR HEADS, AND TYPICALLY 5 FEET FOR ROTORS ALONG UNCURBED ROADWAYS.
- 9. ALL SLEEVING SHALL BE SCH 40 PVC TO SIZE INDICATED ON PLAN, OR IF NOT INDICATED, A MIN. OF 2 PIPE SIZES LARGER THAN SUPPLY LINE CONTAINED. ALL SLEEVES SHALL BE INSTALLED A MIN. OF 24" BELOW FINISH GRADE.
- 10. CONTROL WIRES SHALL BE UL APPROVED PE IRRIGATION CONTROL WIRE. USE 14 GAGE CONTROL WIRE AND 12 GAGE GROUND WIRE. WIRE SHALL BE BUNDLED AND ATTACHED TO THE MAIN LINE IN TRENCH OR THROUGH WIRE SLEEVES AT PAVEMENT CROSSINGS 24" BELOW FIN. GRADE. ALL SPLICES SHALL BE MADE WITH WATERPROOF DIRECT-BURIAL SPLICE KITS AND CONTAINED IN VALVE BOXES. TWO EXTRA CONTROL WIRES SHALL BE INSTALLED TO THE FURTHEST VALVES IN EACH DIRECTION FROM THE CONTROLLER.
- 11. PIPING IN NARROW PLANTING AREAS, PARKING ISLANDS AND PLANTERS SHALL BE SET TO ONE SIDE TO ALLOW ROOM FOR ROOT BALLS. PIPE AS INDICATED ON PLAN IS SCHEMATIC AND SHOULD BE ADJUSTED FOR FIELD CONDITIONS.
- 12. ALL GLUE JOINTS SHALL BE CLEANED, SANDED, AND TREATED WITH A COLORED HIGH ETCH PRIMER AND JOINED USING A SOLVENT CONFORMING WITH ASTM D2564.
- 13. SYSTEM PIPE SIZE 3/4" SHALL BE CLASS 200 PVC; SYSTEM PIPE SIZE 1" OR GREATER SHALL BE CLASS 160 PVC. SYSTEM MAIN WILL BE SCH. 40 PVC TO SIZE INDICATED ON PLAN. ALL FITTINGS WILL BE SOLVENT WELD SCH 40 PVC. MAIN LINE SHALL HAVE 24" MINIMUM COVER; ALL OTHER PIPING WILL HAVE 12" MIN. COVER. ALL BACKFILL FOR PIPE TRENCHES SHALL BE CLEAN AND FREE OF FOREIGN DEBRIS AND SHARP OBJECTS; BACKFILLED TRENCHES SHALL BE PROPERLY COMPACTED. ALL MAIN LINES WILL BE INSTALLED A MIN. OF 3' FROM ANY TREE OR PALM.
- 14. WATERING TIME PER STATION WILL BE DETERMINED IN THE FIELD AND PER LOCAL REQUIREMENTS. REFER TO MANUFACTURER'S INSTRUCTIONS FOR PRECIPITATION RATES OF SPRINKLERS SPECIFIED.
- 15. IRRIGATION SYSTEM TO PROVIDE 100% COVERAGE WITH 100% OVERLAP MIN. PROVIDE
- 16. RUST CONTROL SYSTEM TO BE INSTALLED WITH PUMP STATION (IF FROM WELL).
- 17. THE IRRIGATION SYSTEM IN THE RIGHT-OF-WAY IS TO INCORPORATE LOW TRAJECTORY SPRAY

BUBBLERS FOR ALL NEW AND RELOCATED TREES AND PALMS.

HEADS TO MINIMIZE OVERSPRAY.

18. AS-BUILT DRAWINGS SHALL BE PREPARED BY THE CONTRACTOR AND GIVEN TO THE OWNER PRIOR TO FINAL ACCEPTANCE. THE SITE SHALL BE LEFT IN A NEAT AND PRESENTABLE CONDITION SATISFACTORY TO THE OWNER PRIOR TO SUBMITTAL OF THE FINAL PAYMENT.

Pompano Beach, FL 33060

PH: (954) 788-3400 Florida Engineering Business License: CA7928 Florida Surveyor and Mapper Business License: LB6860

REVISIONS			
NO.	DESCRIPTION	DATE	
	TAC - P&Z	09/13/2023	
	FINAL TAC - P&Z	11/15/2023	
	FINAL TAC-RESUBMITTAL	11/30/2023	
	PDB APPROVAL	12/12/2023	


Florida Landscape Architecture Business License: LC2600045

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CLIENT

1817 TAYLOR DEVELOPMENT LLC

PROJECT

STAR TOWER HOLLYWOOD

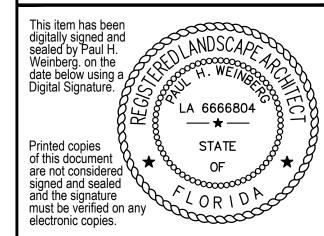410 N. FEDERAL HWY HOLLYWOOD, FL 33020

SHEET TITLE

IRRIGATION DETAILS

,	IRRIGATION DETAILS		PRELIMINA
	SHEET NUMBER	LI-501	TATUS:
	PROJECT NUMBER	13778.00	STA


Calculation Summary EASTERN RAMP_Planar EASTERN TERRACE_Top ENTRY PLAZA 0.9 7.62 12.22 GARAGE L1 4.32 15.33 1.08 LANDING_Top_1 6.0 1.12 LOADING LOADING PEDESTIRAN AREA 3.04 0.2 15.20 26.50 NORTHWEST EGRESS 3.52 SHOUTHWEST EGRESS SIDEWALK SOUTH WEST GARAGE RAMP NORTH EASTERN STAIR ON STREET PARKING 4.80 SOUTH EASTERN RAMP SOUTH EASTERN STAIR 1.77 SOUTH STAIR 1.10


Luminaire Schedule						
Symbol	Qty	Label	Description	Lum. Watts	Total Watts	LLF
\rightarrow	7	B1	LANDSCAPE FORMS BW101-T4-30K-UV1	8.0059	56.041	0.900
	16	C1	CONTECH CY3S330K12D1WWF-P	19.7	315.2	1.000
→	7	G1	BEGHELLI BS400LEDHTHOWT30120-277V	60	420	1.000
-	17	HR	WAGNER LULRxx30KA3	2.89	49.13	1.000
+	4	P1	LANDSCAPE FORMS AC-048L3-035F-30K	57.28	229.12	0.900

N

- 3. THE MAXIMUM LIGHT LEVEL ALONG THE NORTHERN AND AND
- WESTERN PROPERTY LINES IS TO BE 0.5 FOOT-CANDLE

 4. SITE LIGHTING IDENTIFIED HERE IS FOR FIXTURE SPECIFICATION
- 4. SITE LIGHTING IDENTIFIED HERE IS FOR FIXTURE SPECIFICATION AND LOCATION ONLY. ELECTRICAL ENGINEER TO PROVIDE ALL ELECTRICAL REQUIREMENTS INCLUDING CIRCUITRY.

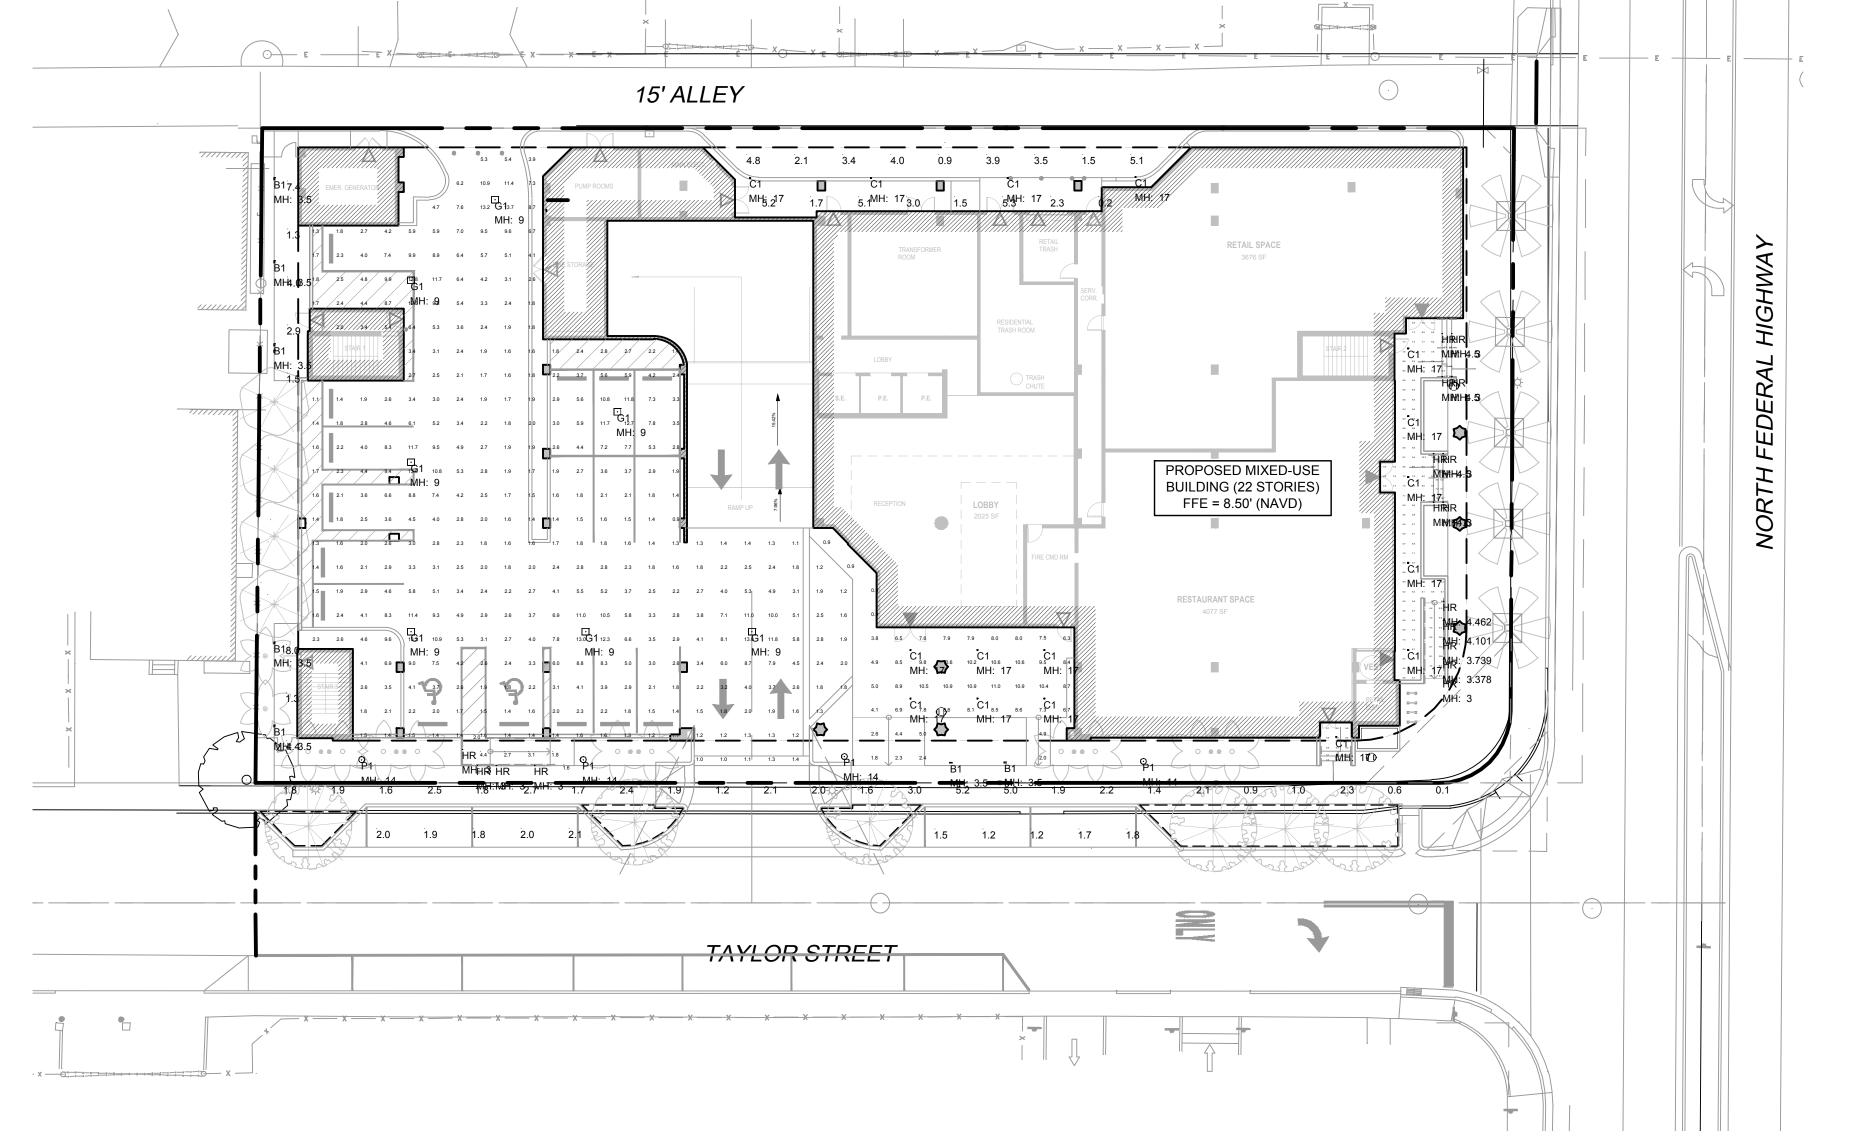

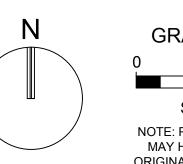

GRAPHIC SCALE

20 SCALE: 1" = 20 '

SCALE: 1" = 20 '

NOTE: PRINTED DRAWING SIZE
MAY HAVE CHANGED FROM
ORIGINAL. VERIFY SCALE USING
BAR SCALE ABOVE.

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PH: (954) 788-3400

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Florida Surveyor and Mapper Business License: LB6860

Florida Landscape Architecture Business License: LC2		
REVISIONS		
NO	DESCRIPTION	DV.


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1817 TAYLOR DEVELOPMENT LLC

PROJECT

STAR TOWER HOLLYWOOD

410 N. FEDERAL HWY HOLLYWOOD, FL 33020

SHEET TITLE

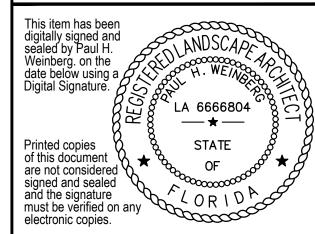EXTERIOR LIGHTING & PHOTOMETRICS PLAN

SHEET LL-101
PROJECT 13778.00