


Existing Tree	e List							
Address:	1833 Dixieanna Street, Hollywood, FL							
Date:	10/11/2023							
Appraiser:	Thomas White, ASLA-ISA.							
	ISA Arborist FL-5248A							
Tree	(Botanical Name / Common Name)	Ht.	Spread	DBH	Condition	DBH	DBH	Disposition
#	Name of the second seco	(Feet)	(Feet)	(Inches)		Removed (Inches)	To Remain (Inches)	
1	Plumeria spp. / Frangipani	8	6	2	Fair	2		Remove
2	Plumeria spp. / Frangipani	12	18	6	Fair	6		Remove
3	Senna surattensis / Glaucous Cassia	8	6	1	Fair	1		Remove
4	Cordia sebestena / Orange Geiger	18	10	3	Fair	3		Remove
5	Quercus virginiana / Live Oak	35	40	21	Poor	21		Remove
6	Plumeria spp. / Frangipani	10	8	4	Fair	4		Remove
7	Conocarpus erectus / Green Buttonwood	20	6	5	Poor	5		Remove
8	Conocarpus erectus / Green Buttonwood	20	15	16	Poor	16		Remove
	Conocarpus erectus / Green Buttonwood		1000					
9	Conocarpus electus / Green Buttonwood	20	6	5	Poor	5		Remove
	Dayment I	ata tha Tree	Truct Fund		BH Removed	63		
Foliation Dale		no the free	Trust Fund	@ <b>\$</b> 350 p	er every 2" =	\$11,025		
Existing Palr				D.D.I.I				
Palm "	(Botanical Name / Common Name)	Ht.	C.T.	DBH	Condition	Replacement		
#	0.1.1.1.1.1.0.11.0.1	(Feet)	(Feet)	(Inches)	0	Palms		In order solver
11	Sabal palmetto / Cabbage Palm	20	15	3	Good Fair	]		Remove
12 13	Dypsis lutescens / Areca Palm Dypsis lutescens / Areca Palm	20 20	0	16 16	Fair	1		Remove
14	Ptychosperma elegans / Solitaire Palm	20	15	3	Fair	1		Remove
15	Syagrus romanzoffiana / Queen palm	22	16	10	Poor	<u>'</u>		Remove
16	Syagrus romanzoffiana / Queen palm	18	12	4	Poor	1		Remove
17	Syagrus romanzoffiana / Queen palm	14	8	4	Poor	4		Remove
18	Sabal palmetto / Cabbage Palm	20	12	4	Good	i		Remove
		16	12	4	Poor	i		Remove
19	wodyetia diturcata / Foxtali Palm							
	Wodyetia bifurcata / Foxtail Palm Cocos nucifera / Coconut Palm	20	2	14	Good	1		Remove
19		2,890		14 16	Good Good	1		

Replacement Palms Required

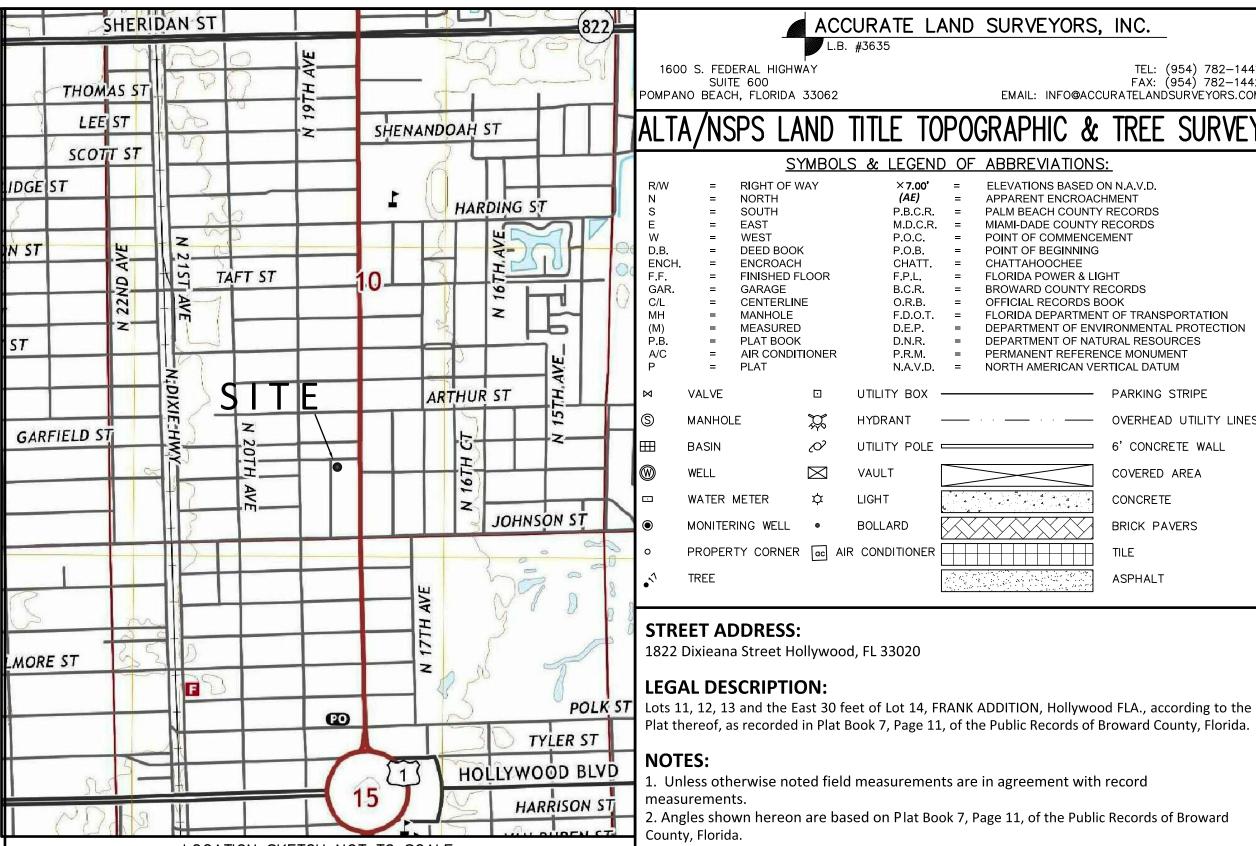

#### **ENCUMBRANCES ACCORDING TO THE AFOREMENTIONED OWNERSHIP AND ENCUMBRANCES REPORT:**

L. MORTGAGE July 14, 2023 #118979392 From GN Dixiana, LLC, a Delaware Limited Liability Company, and Lakeside Bank. (This item is not a matter of survey.)

2. ASSIGNMENT OF RENTS July 14, 2023 #118979393 Between GN Dixiana, LLC, a Delaware Limited Liability Company, and Lakeside Bank. (This item is not a matter of survey.)

3. PLAT January 27, 1925 PB 7/11 (All Streets and Avenues are dedicated to the public, all platted easements are shown hereon, and all other matters of Survey are shown hereon.)

4. ORDINANCE NO. 0-76-18 January 26, 1977 6886/89 (This item affects the subject property however it is not a plottable matter of

survey.) 5. ORDINANCE NO. 2002-61 November 21, 2002 34145/1891 (This item affects the subject property however it is not a plottable matter of

survey.) 6. GRANT OF EASEMENT April 30, 2003 35050/1319

(This item affects the subject property and is shown hereon.)

7. GRANT OF EASEMENT May 5, 2003 35089/1838

(This item affects the subject property and is shown hereon.)

8. CONDITIONAL ASSIGNMENT OF RENTALS June 19, 2003 35425/950 (This item is not a matter of survey.)

9. ORDINANCE NO. 2005-18 July 15, 2005 40082/1783 (This item affects the subject property however it is not a plottable matter of survey.)

10. ORDINANCE NO. 2005-19 July 15, 2005 40082/1789 (This item affects the subject property however it is not a plottable matter of survey.)

## **APPARENT ENCROACHMENTS:** (AE)

(AE-1) Asphalt parking in road right of way along the north boundary. (AE-2) Fence and asphalt in ingress and egress easement along the

southeast boundary.

(AE-3)overhead and utility lines, utility poles and anchors along the south boundary without the benefit of known utility easement.



. Unless otherwise noted field measurements are in agreement with record

2. Angles shown hereon are based on Plat Book 7, Page 11, of the Public Records of Broward County, Florida.

ACCURATE LAND SURVEYORS, INC.

SYMBOLS & LEGEND OF ABBREVIATIONS:

P.O.B.

CHATT

O.R.B.

F.D.O.T.

UTILITY BOX ----

LIGHT

BOLLARD

F.P.L.

TEL: (954) 782-1441 FAX: (954) 782-1442

EMAIL: INFO@ACCURATELANDSURVEYORS.COM

ELEVATIONS BASED ON N.A.V.D.

MIAMI-DADE COUNTY RECORDS POINT OF COMMENCEMENT

APPARENT ENCROACHMENT

P.B.C.R. = PALM BEACH COUNTY RECORDS

POINT OF BEGINNING

P.R.M. = PERMANENT REFERENCE MONUMENT

N.A.V.D. = NORTH AMERICAN VERTICAL DATUM

UTILITY POLE 6' CONCRETE WALL

FLORIDA POWER & LIGHT BROWARD COUNTY RECORDS

OFFICIAL RECORDS BOOK

FLORIDA DEPARTMENT OF TRANSPORTATION

PARKING STRIPE

--- OVERHEAD UTILITY LINES

CONCRETE

TILE

ASPHALT

BRICK PAVERS

DEPARTMENT OF ENVIRONMENTAL PROTECTION

DEPARTMENT OF NATURAL RESOURCES

CHATTAHOOCHEE

1600 S. FEDERAL HIGHWAY

SUITE 600

RIGHT OF WAY

NORTH

SOUTH

DEED BOOK

CENTERLINE

MANHOLE

= PLAT

VALVE

MANHOLE

WATER METER

MONITERING WELL

MEASURED PLAT BOOK

FINISHED FLOOR

AIR CONDITIONER

PROPERTY CORNER | GC | AIR CONDITIONER

FNCROACH

3. The lands shown hereon were not abstracted for ownership, rights of way, easements, or other matters of records by Accurate Land Surveyors, Inc.

4. Ownership of fences and walls if any are not determined. 5. This survey is the property of Accurate Land Surveyors, Inc. and shall not be used or reproduced in whole or in part without written authorization.

6. Any and all underground features such as foundations, utility lines, Ext. were not located on this survey. This is an above ground survey only.

7. This survey reflects all obtainable, legible, plottable, recorded matters of survey per Schedule B2 of Chicago Title Insurance Company Ownership and Encumbrance Report File Number: 11359762 Update Reference: 23-007 dated November 1, 2023 at 11:00 P.M.

8. Perimeter area of the subject property is 20995 square feet or 0.481 acres more or less. 9. Gross area of the subject property is 28,860 square feet, or 0.6625 acres, more or less.

10. Net area of the subject property is 20,995 square feet or 0.481 acres more or less. 11. Gross area was determined by extending the East and South property lines to the centerline of the existing right of way.

12. Net area is the actual perimeter area of the subject property.

13. The flood zone information shown hereon is for the dwellable structure only unless otherwise indicated.

14. The location of overhead utility lines are approximate in nature due to their proximity above ground. size, type and quantity must be verified prior to design or construction.

15. There was no evidence of recent earth moving work, building construction, or building additions observed in the process of conducting the fieldwork. 16. There was no evidence of recent street or sidewalk construction or repairs in the

process of conducting the fieldwork.

17. Accuracy statement: This survey meets or exceeds the horizontal and vertical accuracy for Alta NSPS Land Title Survey Required February 2021 18. Printed copies of this survey are not valid without the signature and original raised seal

of a Florida licensed Surveyor and Mapper.

17. PDF copies of this survey are not valid without the digital signature of a Florida licensed Surveyor and Mapper and must be verified.

18. Tree note: Surveyors responsibility is to show size & location of all trees, common and scientific name to be verified by certified arborist.

## FLOOD INFORMATION:

Community name and number: City of Hollywood 125113 Map and panel number: 12011C0569H

Panel date: 08-18-2014 Index date: 08-18-2014

Flood zone: X(0.2%) Base flood elevation: N/A

## **BENCHMARK INFORMATION:**

City of Hollywood Benchmark nail & tab at point of intersection 19th Avenue and Hayes Street Elevation = 8.94'NAVD1988

ORIGINAL DATE OF FIELD SURVEY: 04-27-2023 DRAWN BY: AL FIELD BOOK: ALS-SU-23-0579 CHECKED BY: RLT REVISIONS & SURVEY UPDATES DATE OF SURVEY & REVISIONS UPDATE O & E DATE AND ADD GROSS AND NET AREA 11-20-2023 ALTA/NSPS LAND TITLE TOPOGRAPHIC & TREE SURVEY 23-1522 | 10-17-2023 MLW 07-14-2023 MLW


#### CERTIFICATION CHANGE "NO FIELD VISIT" **CERTIFY TO:**

GN DIXIANA, LLC


## **CERTIFICATION:**

This is to certify that this map or plat and the survey on which it is based were made in accordance with the 2021 Minimum Standard Detail Requirements for ALTA/NSPS Land Title Surveys, jointly established and adopted by ALTA and NSPS, and includes Items 1, 2,

3, 4, 7(a), 7(b)(1), 8, 9, 11, 14, 16, 18 and 19 of Table A thereof. The fieldwork was completed on 10-17-2023.

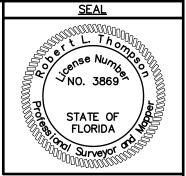

		ROBERT L. THOMPSON (PRESIDENT) PROFESSIONAL SURVEYOR AND MAPPER No.3869 - STATE OF FLORIDA
SHEET 1 OF 1	SCALE 1"=20'	SKETCH NUMBER SU-23-0579

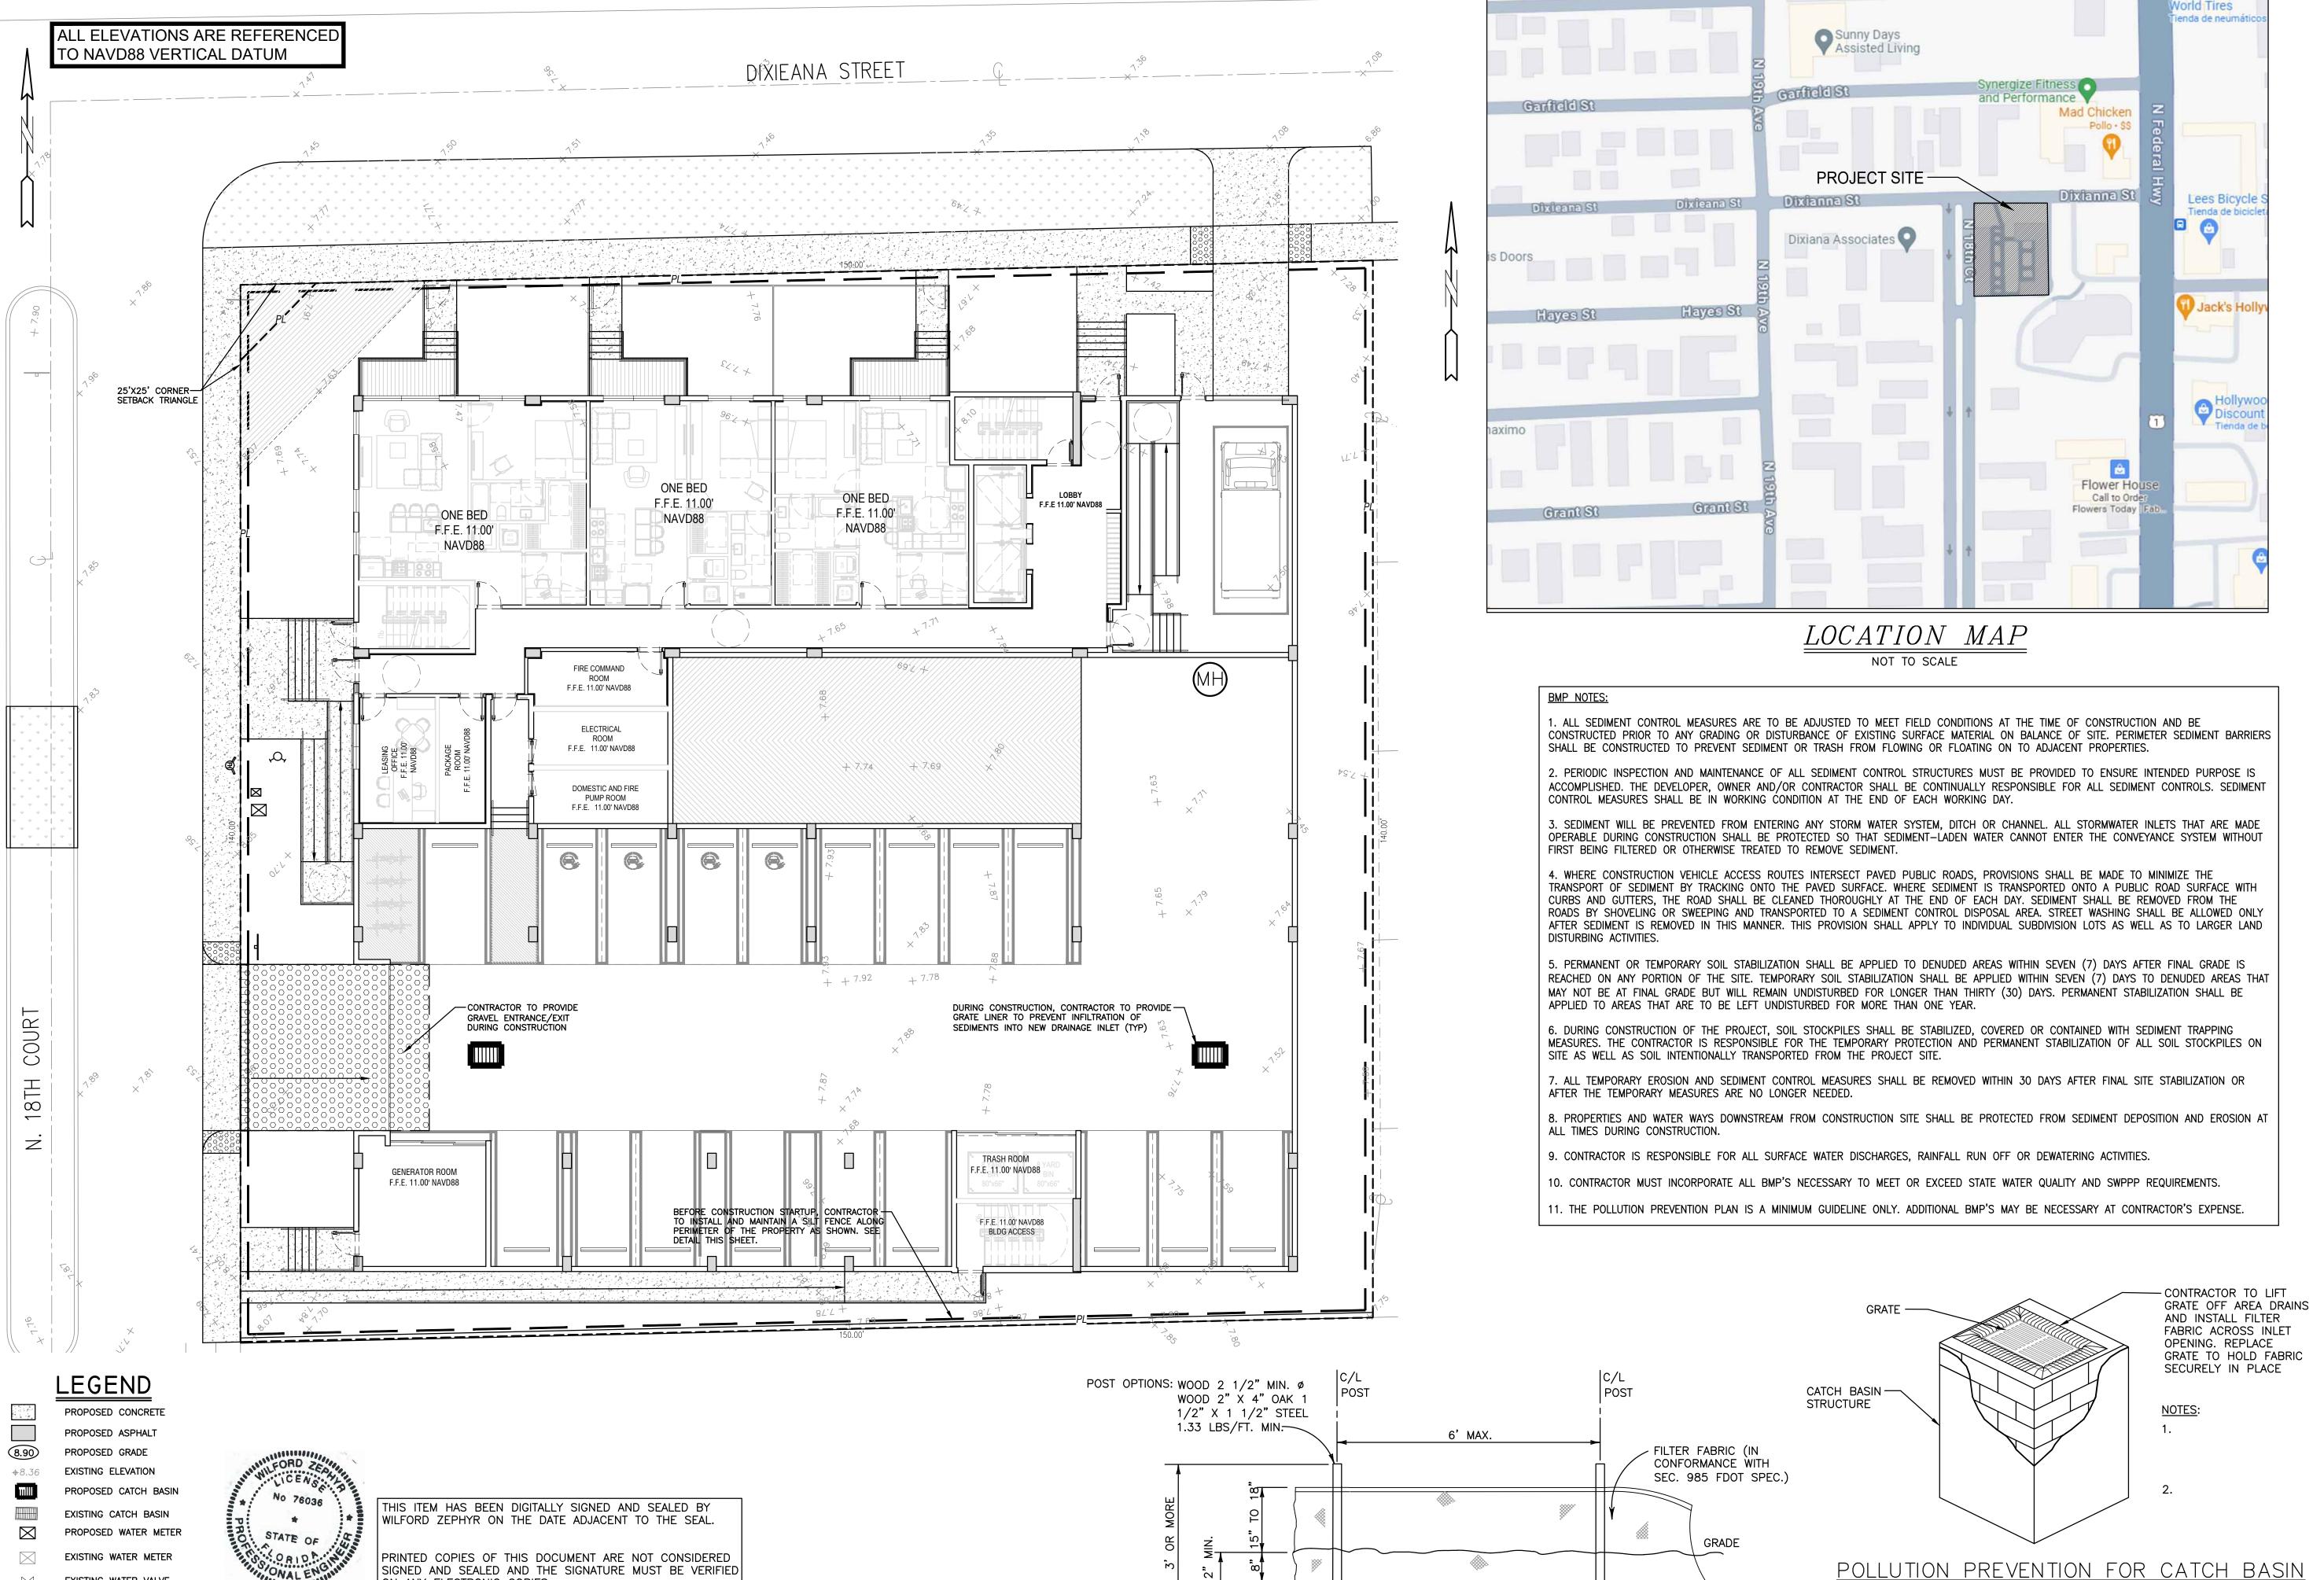

TYPE III SILT FENCE

SIGNED AND SEALED AND THE SIGNATURE MUST BE VERIFIED

ON ANY ELECTRONIC COPIES.

**EROSION & SEDIMENT CONTROL PLAN** 

EXISTING WATER VALVE

PROPOSED BFP DEVICE

EXISTING FIRE HYDRANT

EXISTING SAN. SEWER MH

3-14-24

SCALE: 1"=10'



GINEERIN PHYR, P.E.

ZEPI


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P.E.#:76036

DATE: 10/23/23 SCALE: N.T.S.

N.T.S.

1 OF 9 PROJECT NO.: 23-48



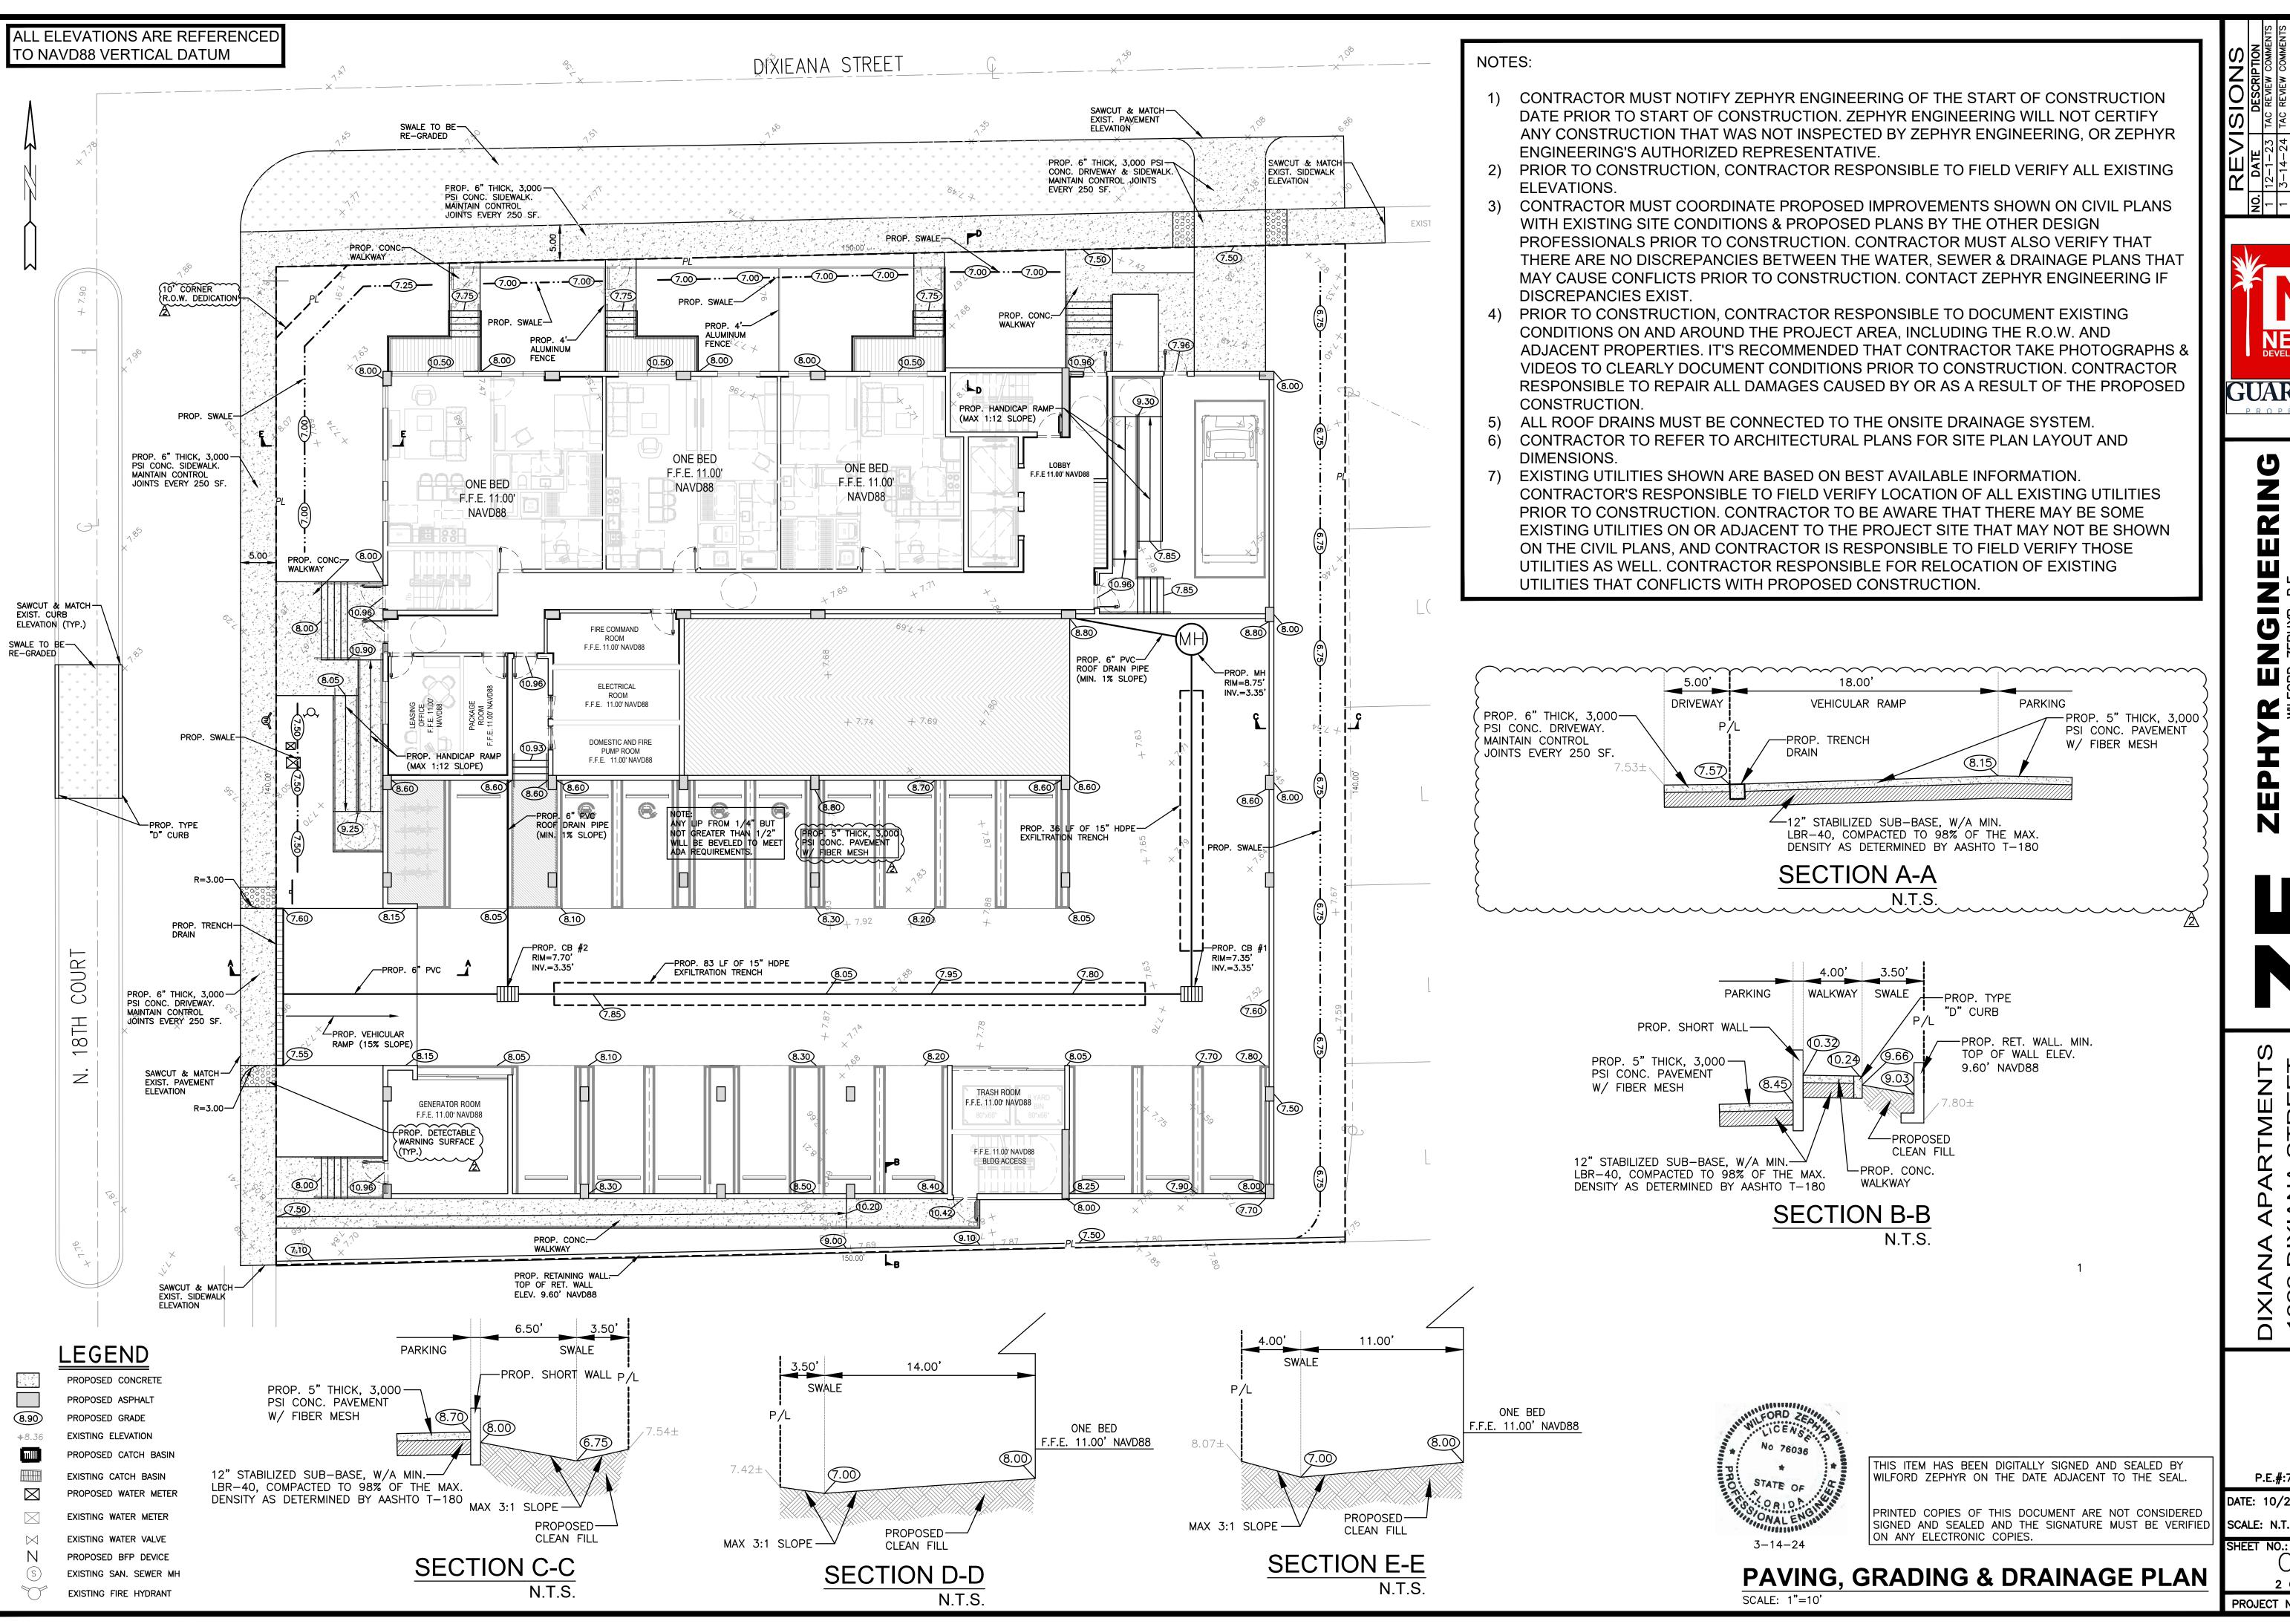

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STREET FL 33020 DIXIANA YWOOD, DIXIANA 1822 DIY HOLLYW

P.E.#:76036

DATE: 10/23/23 SCALE: N.T.S.

2 OF 9

PROJECT NO.: 23-48

#### GENERAL CONDITION NOTES

- I. THE LOCATION OF EXISTING UTILITIES AND TOPOGRAPHY HAS BEEN PREPARED FROM THE MOST RELIABLE INFORMATION AVAILABLE TO THE ENGINEER. THIS INFORMATION IS NOT GUARANTEED AND IT IS THE RESPONSIBILITY OF THE CONTRACTOR TO DETER-MINE THE EXACT LOCATION OF ALL EXISTING UTILITIES AND TOPOGRAPHY PRIOR TO CONSTRUCTION.
- 2. PRIOR TO CONSTRUCTION THE CONTRACTOR IS TO NOTIFY THE FOLLOWING

COMPANIES & AGENCIES AND ANY OTHERS SERVING THE AREA: FLORIDA POWER & LIGHT CO., CONSTRUCTION **BELLSOUTH** 

COMCAST

LOCAL CITY / COUNTY ENGINEERING & UTILITY DEPARTMENTS FLORIDA DEPARTMENT OF TRANSPORTATION (FDOT), AS APPLICABLE UNDERGROUND UTILITIES NOIFICATION CENTER OF FLORIDA (S.U.N.S.H.I.N.E.)

#### PAVING, GRADING & DRAINAGE NOTES:

- 1. ALL UNSUITABLE MATERIALS, SUCH AS MUCK, HARDPAN, ORGANIC MATERIAL & OTHER DELETERIOUS MATERIAL AS CLASSIFIED BY AASHTO M-145, FOUND WITHIN THE ROAD & PARKING LOT AREAS SHALL BE REMOVED DOWN TO ROCK OR SUITABLE MATERIAL, & REPLACED W/ THE SPECIFIED FILL MATERIAL IN MAXIMUM 12" LIFTS COMPACTED TO NOT LESS THAN 100% MAXIMUM DRY DENSITY AT OPTIMUM MOISTURE IN ACCORDANCE W/ AASHTO T-99. THICKNESS OF LAYERS MAY BE INCREASED PROVIDED THE EQUIPMENT & METHODS USED ARE PROVEN BY FIELD DENSITY TESTING TO BE CAPABLE OF COMPACTING THICK LAYERS TO SPECIFIED DENSITIES.
- ALL AREAS SHALL BE CLEARED & GRUBBED PRIOR TO CONSTRUCTION. THIS SHALL CONSIST OF THE COMPLETE REMOVAL & DISPOSAL OF ALL TREES, BRUSH, STUMPS, ROOTS, GRASS, WEEDS, RUBBISH & ALL OTHER OBSTRUCTION RESTING ON OR PROTRUDING THROUGH THE SURFACE OF THE EXIST. GROUND TO A DEPTH OF 12". ITEMS DESIGNATED TO REMAIN OR TO BE RELOCATED OR ADJUSTED SHALL BE SO DESIGNATED ON THE DWGS.
- 3. FILL MATERIAL SHALL BE CLASSIFIED AS A-1, A-3 OR A-2.4 IN ACCORDANCE W/ AASHTO M-145 & SHALL BE FREE FROM VEGETATION & ORGANIC MATERIAL, NOT MORE THAN 12% BY WEIGHT OF FILL MATERIAL SHALL PASS THE NO. 200 SIEVE.
- 4. THE CONTRACTOR SHALL BE RESPONSIBLE FOR PROVIDING CERTIFIED MATERIAL TEST RESULTS TO THE ENGINEER OF RECORD PRIOR TO THE RELEASE OF FINAL CERTIFICATION BY THE ENG. TEST RESULTS MUST INCLUDE BUT MAY NOT BE LIMITED TO, DENSITIES FOR SUBGRADE & LIME ROCK, UTILITIES, EXCAVATION, ASPHALT GRADIATION REPORTS, CONC. CYLINDERS, ETC...
- 5. ALL INLETS & PIPE SHALL BE PROTECTED DURING CONSTRUCTION TO PREVENT SILTATION IN THE DRAINAGE SYSTEMS BY WAY OF TEMPORARY PLUGS & PLYWOOD OR PLASTIC COVERS OVER THE INLETS. THE ENTIRE DRAINAGE SYSTEM TO BE CLEAN OF DEBRIS PRIOR TO FINAL
- 6. WHERE NEW ASPHALT MEETS OR ABUTS EXIST. ASPHALT, THE EXIST. ASPHALT SHALL BE SAWCUT TO PROVIDE A STRAIGHT EVEN LINE. PRIOR TO REMOVING CURB OR GUTTER, THE ADJACENT ASPHALT SHALL ALSO BE SAWCUT TO PROVIDE A STRAIGHT EVEN LINE.
- 7. ALL PROPOSED GRADES (ELEVATIONS) REFER TO ASPHALT GRADES UNLESS INDICATED
- 8. SITE GRADING SHALL BE W/IN 0.1' OF THE REQUIRED ELEVATION & ALL AREAS SHALL BE
- 9. ALL SUBGRADE SHALL HAVE AN LBR OF 40 UNLESS OTHERWISE NOTED & SHALL BE COMPACTED TO 98% MAXIMUM DRY DENSITY PER AASHTO T-99.
- 10. ALL LIMEROCK SHALL BE COMPACTED TO 98% PER AASHTO T-180 & HAVE NOT LESS THAN 60% OF CARBONATES OF CALCIUM & MAGNESIUM UNLESS OTHERWISE DESIGNATED. ALL LIMEROCK SHALL BE PRIMED.
- 11 CONCRETE & ASPHALT THICKNESS SHALL BE OF TYPE DESIGNATED ON DWGS. (SEE SECTIONS)
- 12. PLASTIC FILTER FABRIC SHALL BE MIRAFI, TYPAR OR EQUAL CONFORMING TO SECTION 985 OF THE FDOT STANDARD SPECIFICATIONS.
- 13. CONC. SIDEWALKS SHALL BE 4" THICK ON COMPACTED SUBGRADE, W/ 1/2" EXPANSION JOINTS PLACED AT A MAXIMUM OF 75'. CRACK CONTROL JOINTS SHALL BE 5' ON CENTER. THE BACK OF SIDEWALK ELEVATION SHALL EQUAL THE CROWN OF ROADWAY, UNLESS SPECIFIED OTHERWISE BY LOCAL CODES OR INDICATED ON DWGS. ALL CONC. SIDEWALKS THAT CROSS DRIVEWAYS SHALL BE 6" THICK.
- 14. PIPE SPECIFICATIONS: THE MATERIAL TYPE IS SHOWN ON THE DRAWINGS BY ONE OF THE FOLLOWING DESIGNATIONS -
  - RCP = REINFORCED CONC. PIPE. ASTM DESIGNATION C-76. TABLE III
  - CMP = CORRUGATED METAL (ALUM.) PIPE, TM DESIGNATION M-196CMP = (SMOOTH LINED) CORRUGATED METAL (ALUM.) PIPE, ASTM DESIGNATION M-196 SCP = SLOTTED CONC. PIPE, FDOT SECTIONS 941 & 942
- PVC = POLYVINYLCHLORIDE PIPE PCMP = PERFORATED CMP, FDOT SECTION 945
- DIP = DUCTILE IRON PIPE HDPE = HIGH DENSITY POLYETHYLENE PIPE.

## 15. ASPHALT -

BITUMINOUS MATERIAL SHALL BE ASPHALT CEMENT, VISCOSITY GRADE AC-20, CONFORMING TO THE REQUIREMENTS OF FDOT STANDARD SPECIFICATIONS, 1986 EDITION, SECTION 916-1. PRIME COAT SHALL BE CUT BACK ASPHALT, GRADE RC-70 OR RC-250 CONFORMING TO THE REQUIREMENTS SPECIFIED IN AASHTO DESIGNATION M-81-75 (1982). RATE - 0.10 GALS./S.Y. TACK COAT SHALL BE EMULSIFIED ASPHALT, GRADE RS-2 CONFORMING TO THE REQUIREMENTS SPECIFIED IN AASHTO DESIGNATION M-140-82. RATE - 0.02 TO 0.08

DESIGN MIX SHALL CONFORM TO FDOT SECTION 331 UNLESS OTHERWISE SPECIFIED.

## PAVEMENT MARKING & SIGNING STANDARD NOTES:

- 1. STOP SIGNS SHALL BE 30"x30" (R1-1), HIGH INTENSITY. 2. ALL SIGNS SHALL BE PLACED AT A HEIGHT NOT LESS THAN 5' & NOT GREATER THAN 7', THE HEIGHT IS MEASURED FROM THE BOTTOM OF THE SIGN TO THE EDGE OF NEAREST PAVEMENT. THE SIGN POST SHALL BE PLACED A MINIMUM OF 6' TO A MAXIMUM OF 12' FROM THE ADJACENT PAVEMENT, & A MINIMUM OF 6' FROM THE CROSS TRAFFIC PAVEMENT.
- 3. STOP BARS SHALL BE 24" WHITE.
- 4. ALL SITE PAVEMENT MARKINGS SHALL BE PAINT. (UNLESS INDICATED OTHERWISE)
- 5. ALL PAVEMENT MARKINGS AND SIGNAGE IN THE ROAD RIGHT-OF-WAY SHALL BE THERMOPLASTIC & SHALL CONFORM TO MUTCD AND PBC TYPICAL T-P-06-001.

## ALL ELEVATIONS ARE REFERENCED TO NAVD88 VERTICAL DATUM

BASIN FRAME & GRATE (SEE DETAIL) -

U.S. FOUNDRY & MFG. CORP. MODEL

42"x42" MIN.

TYPICAL CATCH BASIN DETAIL

<u>PLAN VIEW</u>

SECTION A-A

5" (MIN.)

SECTION B-B

1. SUBGRADE SHALL BE COMPACTED TO 95% MOD. PROCTOR DENSITY (AASHTO T-180)

ALTERNATIVE-A: FOR A TERMINAL CONNECTION USE ONE (1) 90° ELBOW. ALTERNATIVE-B: FOR AN IN-LINE CONNECTION USE ONE (1) 45° ELBOW

TRENCH DRAIN DETAIL

DUCTILE IRON GRATE

2. CONNECT TRENCH DRAIN TO OUTFALL PIPE IN ACCORDANCE WITH:

AND ONE (1) WYE.

(H-20 LOADING) -

SCREENING

DEVICE —

**SUMP** 

NO. 4155-6210

TO GRADE

5 MAX.)

BRICK & MORTAR -

(2 COURSE MIN.,

DRAINAGE PIPE-

SEE PGD PLANS

FOR PIPE SIZES

3" (MIN)

PROVIDE 6" GRAVEL BED

A A A A A

-CONCRETE

BASE

SUB-GRADE

(MIN. 3,000 P.S.I.)

/— ASHPALT

(TYP., FOR EACH


STRUCTURE)

18"±

SIZE VARIES,

& BASIN INV.

ELEV. (TYP.)

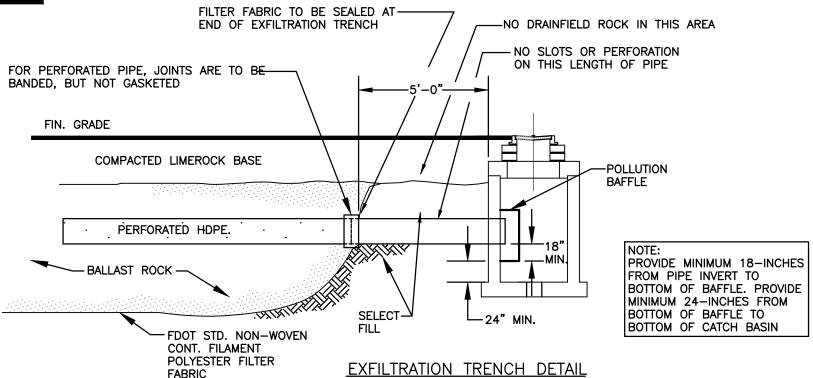

FIN. GRADE

#4 BARS @

12" O.C. (TYP)

W/ 18" HOOK

-#4 HOOPS @

4 BARS @ 12" O.C.

EACHWAY (TYP)

m◀

6" FLUME—


TRANSITION


— EXPANSION JOINT


- ACO K-100S TRENCH DRAIN OR APPROVED EQUIVALENT

CONC. PAVEMENT

12" O.C. (TYP)

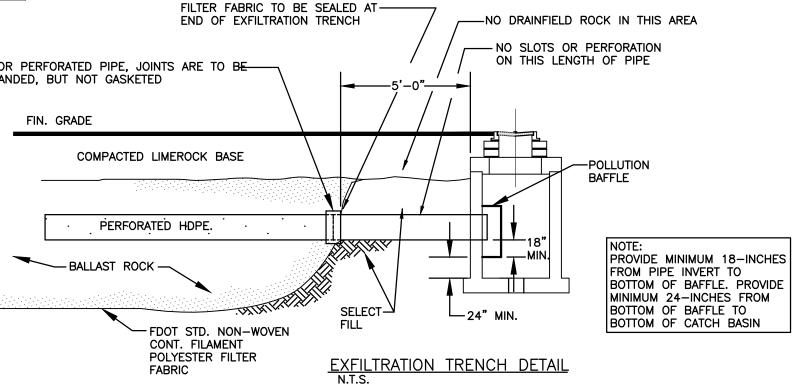


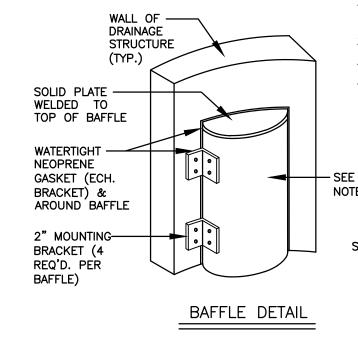


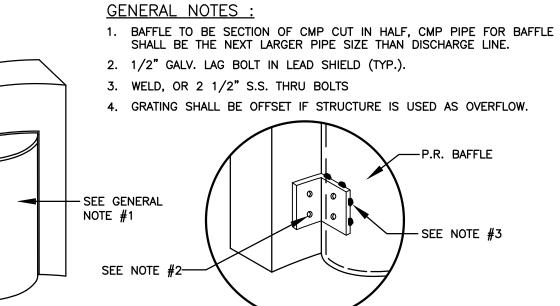


BRACKET DETAIL

POLLUTION RETARDANT BAFFLE DETAIL

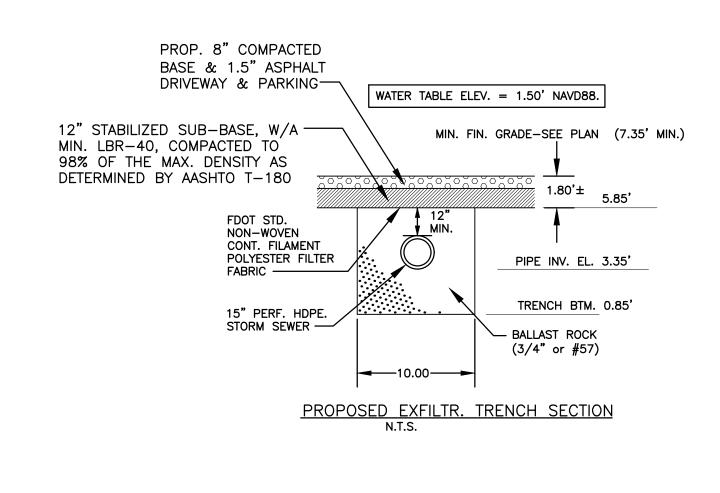

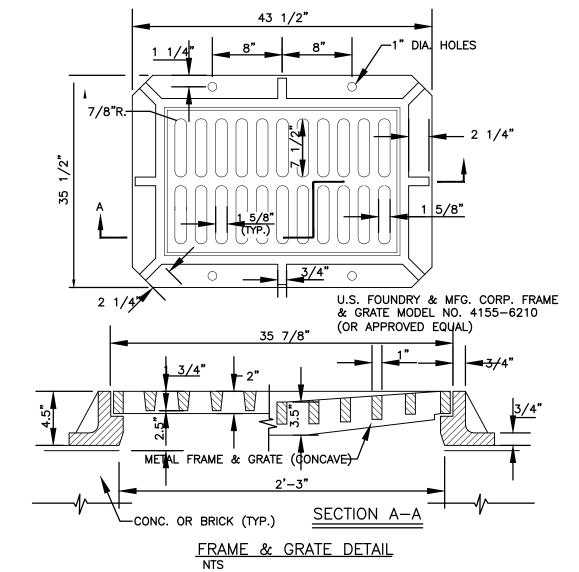

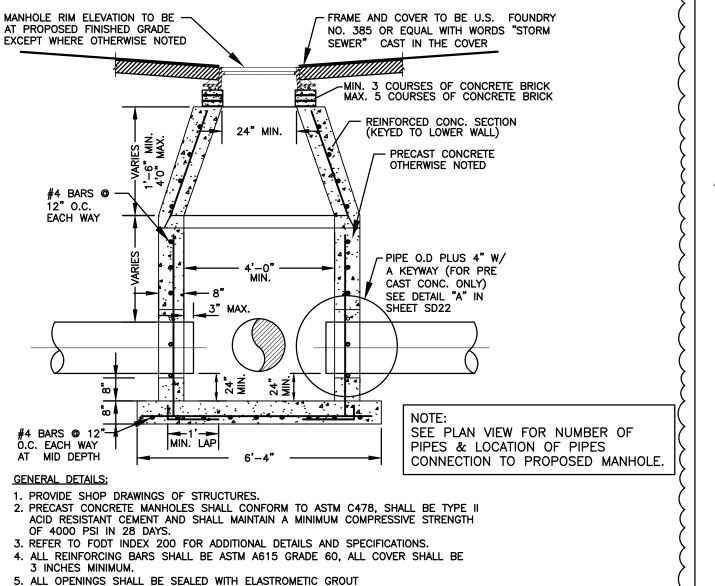

(TYPE 3 CEMENT) SEE DETAIL "A", IN SHEET SD22.

CONCENTRIC PRECAST DRAINAGE MANHOLE (4'-0" MIN. DIA.) DETAIL

STATE OF

THIS ITEM HAS BEEN DIGITALLY SIGNED AND SEALED BY WILFORD ZEPHYR ON THE DATE ADJACENT TO THE SEAL.

PRINTED COPIES OF THIS DOCUMENT ARE NOT CONSIDERED SIGNED AND SEALED AND THE SIGNATURE MUST BE VERIFIED ON ANY ELECTRONIC COPIES.

8"X12" CONCRETE TIE BEAM W/ (2)-#5 TOP & BOTTOM CONTINUOUS, & #3 STIRRUPS @ 12" O.C. SEE CIVIL PLAN T.O.GRADE SEE CIVIL PLAN 9GA JOINT REINF. 1'-6" MAX. 6 16" O.C. (LADDER TYPE) (SEE NOTE 1) COMPACTED FILL ADJACENT EXISTING GRADE (TYP.) (SEE CIVIL & SITE PLAN) 8" CMU WALL REINF'D W/ (1)−#5 @ 32" O.C.− #5 @ 12" O.C. & ALL CELLS GROUTED -TOP & BOTTOM. WITH STD. HOOK. (4)-#5 CONT. TOP & BOTTOM. 34" WIDHT 13" HEIGHT WALL FOOTING

RETAINING WALL SECTION

3-14-24

**CIVIL DETAILS** SCALE: N.T.S.

P.E.#:76036

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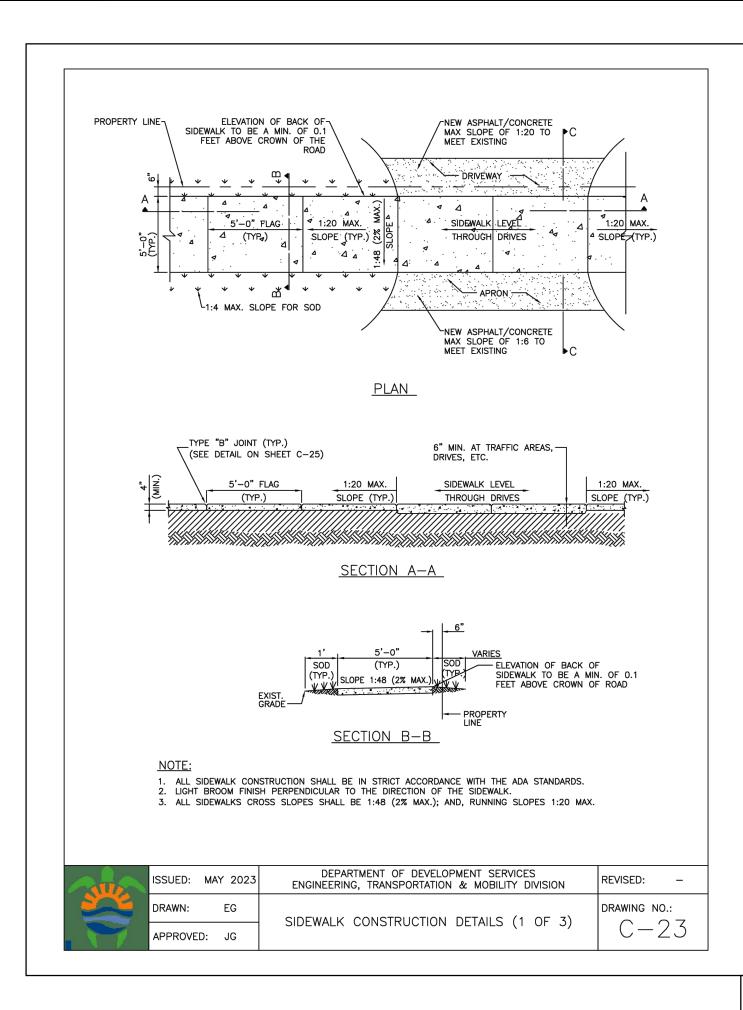
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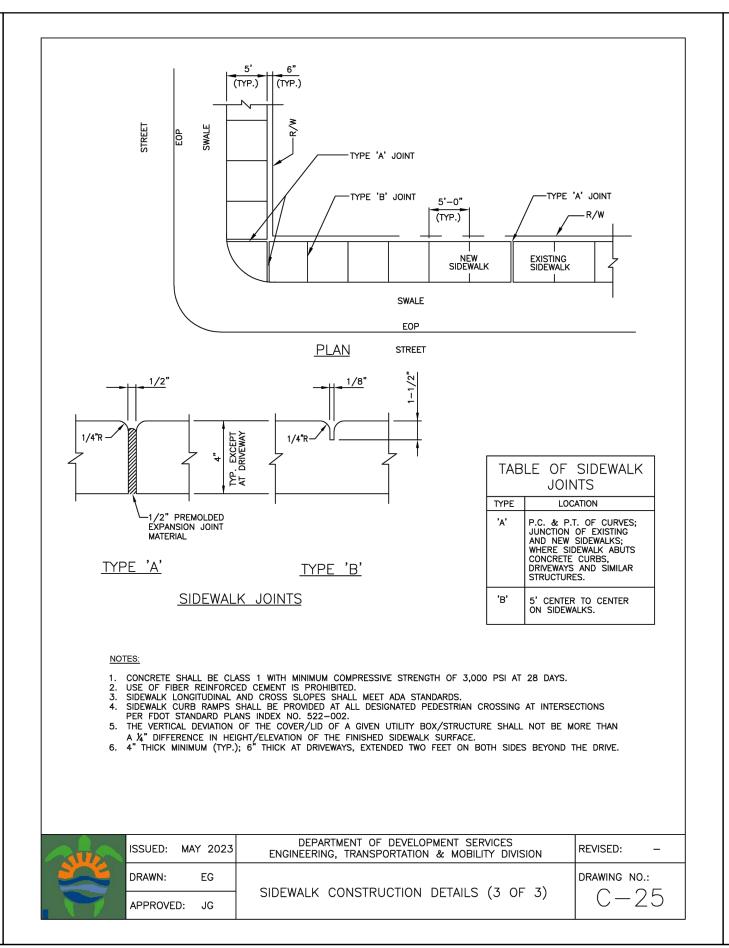
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DATE: 10/23/23 SCALE: N.T.S. SHEET NO.:

PROJECT NO.: 23-48

3 OF 9






LEGEND

REVISION

07/01/13

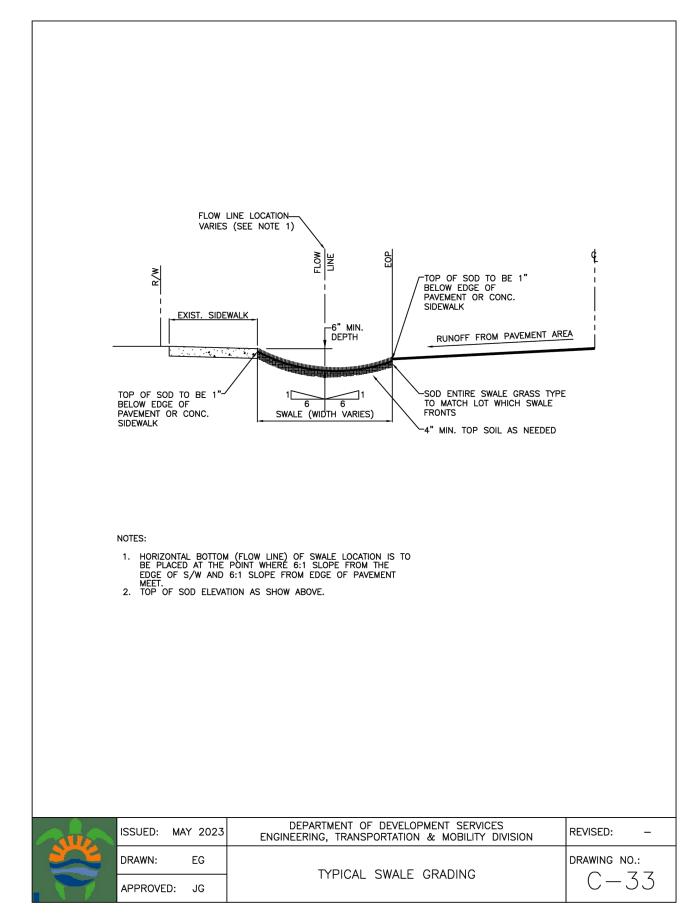

GENERAL NOTES


pedestrian circulation path to pedestrian areas, elements and facilities within the right of way and to accessible pedestrian routes on adjacent sites. Curbed facilities with sidewalks and those without sidewalks are to have curb ramps constructed for all intersections and turnouts with curbed returns. To accommodate curb ramps, partial curb returns are to extend to the limits prescribed in Index No. 515. Ramps constructed at locations without sidewalks are to have a landing constructed at the top of

accommodation of a ramp slope of 1:12, a ramp slope between 1:12 and 1:10 is permitted for a rise of 6" maximum. Where compliance with the requirements for cross slope cannot be fully met, the minimum

1. Sidewalk curb ramps shall be constructed at locations that will provide continuous unobstructed

2. When altering existing pedestrian facilities, where existing restricted conditions preclude the

each ramp, see LANDINGS FOR CURB RAMPS WITHOUT SIDEWALKS.

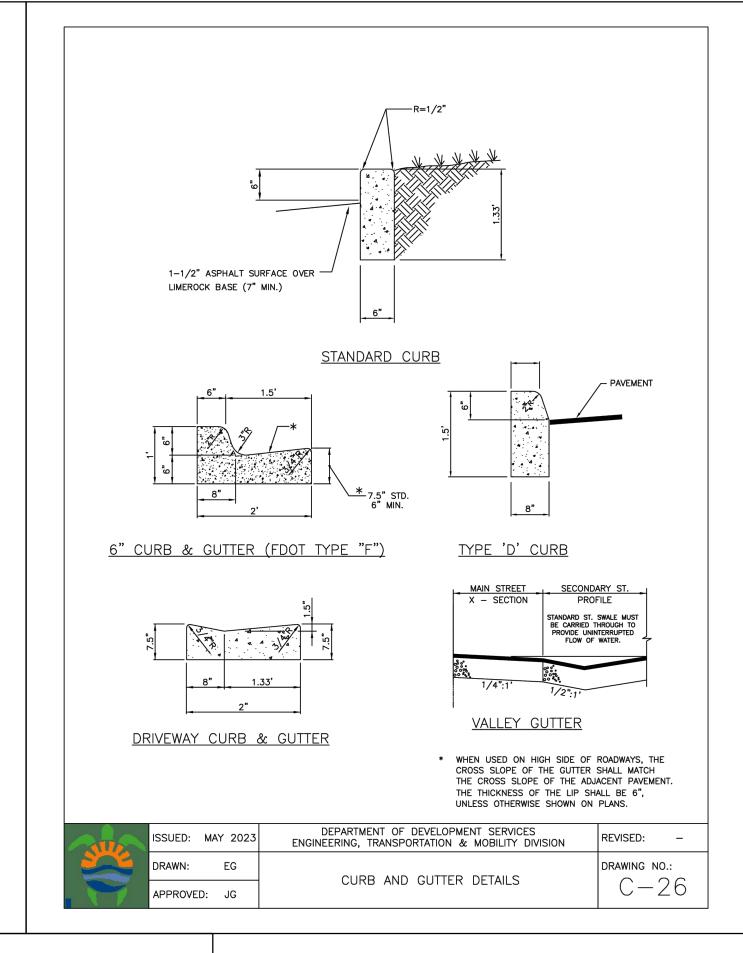



NEERIN(





P.E.#:76036 DATE: 10/23/23


3-14-24


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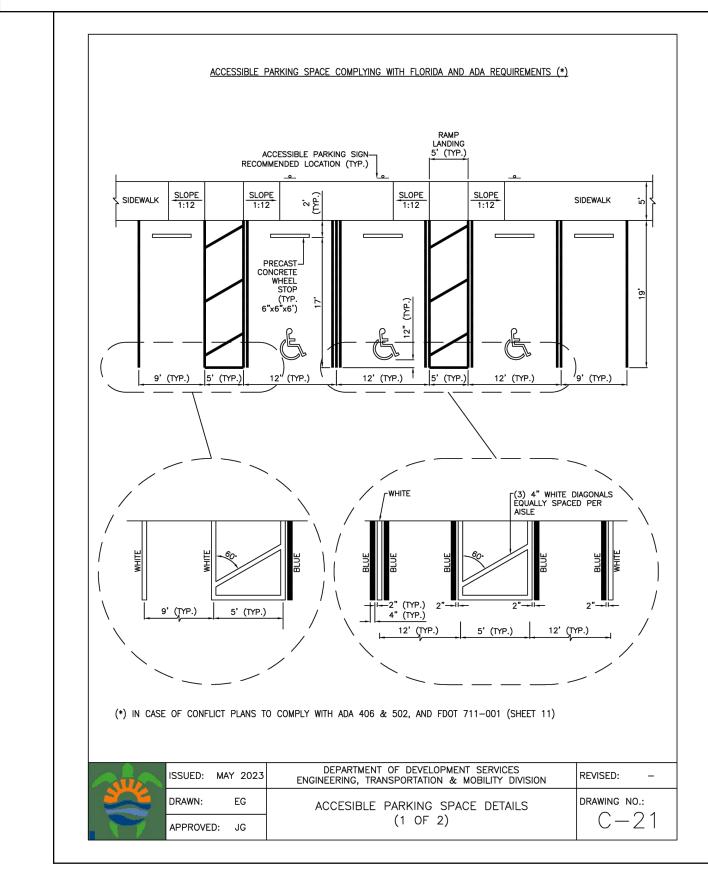
4 OF 9

PROJECT NO.: 23-48

the extent that no remaining section of curb or curb and gutter is less than 5' long. Existing sidewalks shall be removed to the nearest joint beyond the transition slope or to the extent that no remaining section of sidewalk is less than 5' long. For CONCRETE SIDEWALK details refer to Index 310. 7. Sidewalk curb ramp alpha-identifications are for reference purposes (plans, permits, etc.). Alpha-identifications CR-I and CR-J were intentionally omitted. 8. Detectable warnings shall extend the full width of the ramp and to a depth of 2'. Detectable warnings shall be constructed in accordance with Specification Section 527. For the layout of detectable warnings, refer to the TYPICAL PLACEMENT OF DETECTABLE WARNINGS details. Detectable warnings shall not be provided on transition slopes. 9. When detectable warnings are placed on a slope greater than 5%, domes shall be aligned with the centerline of the ramp; otherwise domes are not required to be aligned. 10. Detectable warnings shall be required on sidewalks at: a. Intersecting roads, b. Median Crossings greater than or equal to 6' in width, c. Railroad Crossings, d. Signalized driveways. 11. Detectable Warnings - Acceptance Criteria: a. Color and texture shall be complete and uniform. b. 90% of individual truncated domes shall be in accordance with the Americans with Disabilities Act Standards for Transportation Facilities, Section 705. c. There shall be no more than 4 non-compliant domes in any one square foot. d. Non-compliant domes shall not be adjacent to other non-compliant domes. e. Surfaces shall not deviate more than 0.10" from a true plane. 12. Detectable warnings shall be installed no greater than 5' from the back of curb or edge of pavement. 13. Detectable warnings shall not be installed over grade breaks. no. **304** DETECTABLE WARNINGS AND SIDEWALK CURB RAMPS NO. 1 of 7 THIS ITEM HAS BEEN DIGITALLY SIGNED AND SEALED BY WILFORD ZEPHYR ON THE DATE ADJACENT TO THE SEAL. PRINTED COPIES OF THIS DOCUMENT ARE NOT CONSIDERED SIGNED AND SEALED AND THE SIGNATURE MUST BE VERIFIED ON ANY ELECTRONIC COPIES.



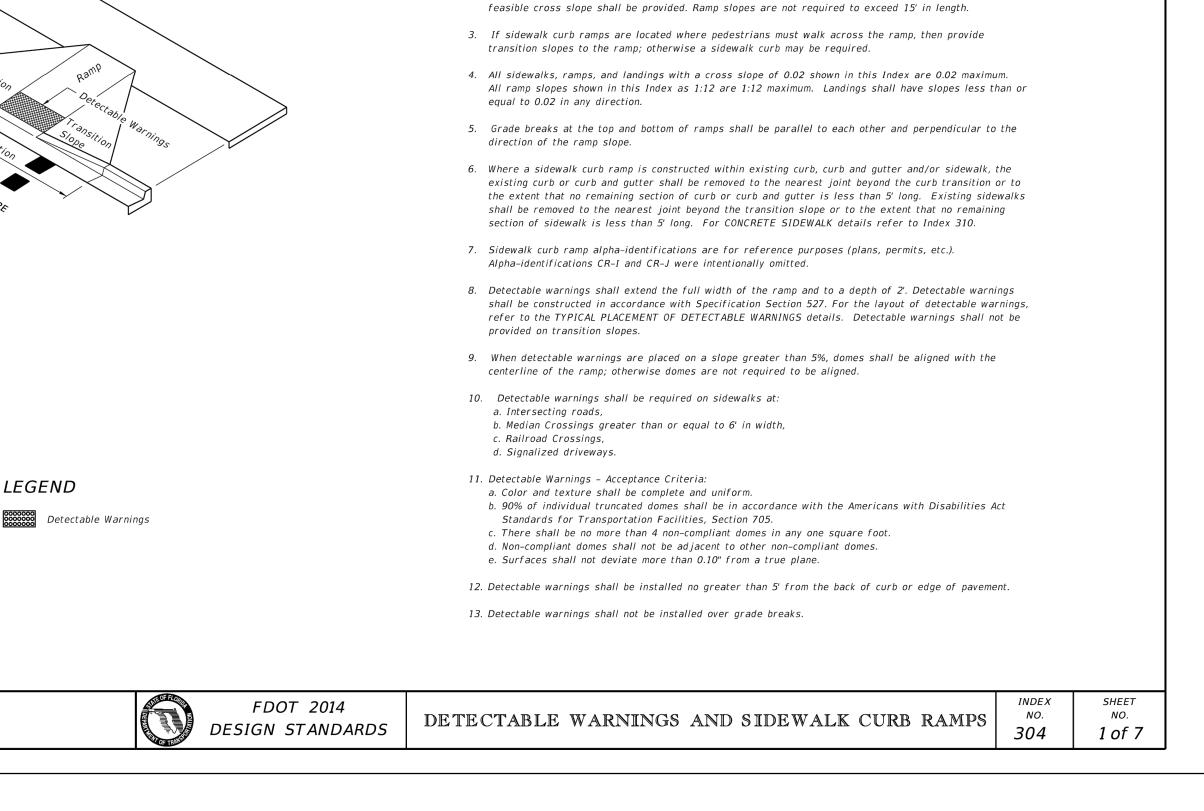

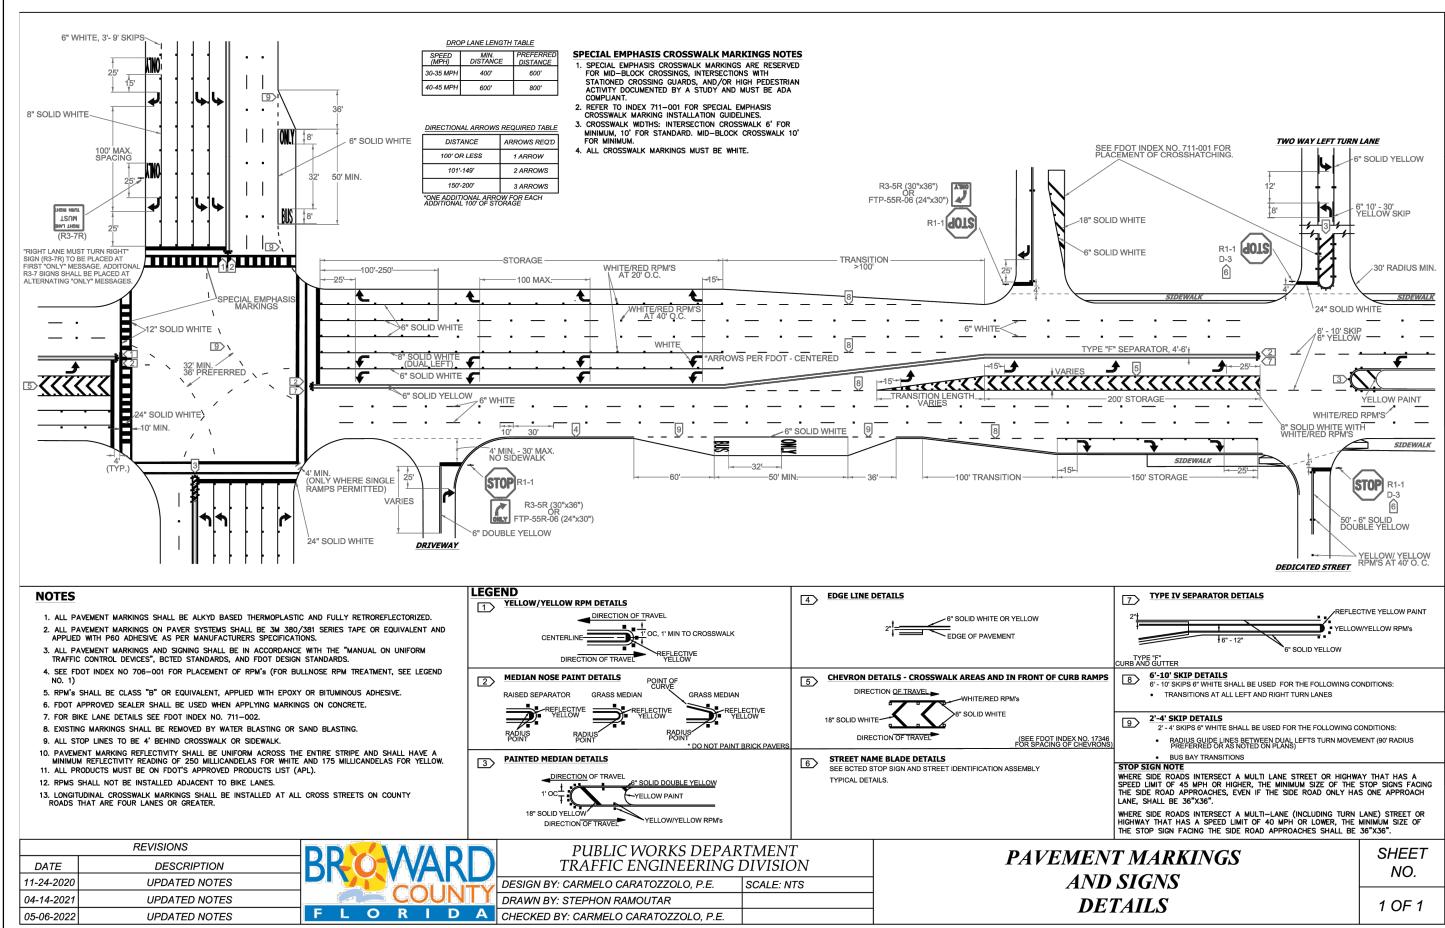




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PAVEMENT MARKINGS & SIGNAGE PLAN



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INEERIN R. P.E.

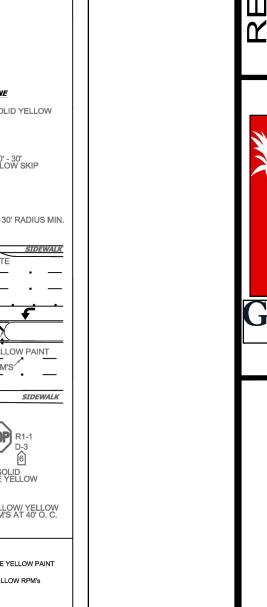DIXIANA YWOOD, IXIAN, 1822 D IOLLY

P.E.#:76036 DATE: 10/23/23 SCALE: N.T.S.

5 OF 9

PROJECT NO.: 23-48

PROPOSED CONCRETE 8.90 PROPOSED GRADE **♦**8.36


METAL SIGN POST (TYP.) → - EDGE OF PAVEMENT FIN. GRADE

—PROP. "STOP

SIGN"(R1-1)

PROP. 2-FT WIDE, WHITE THERMOPLASTIC STOP BAR

TYPICAL SIGN INSTALLATION DETAIL

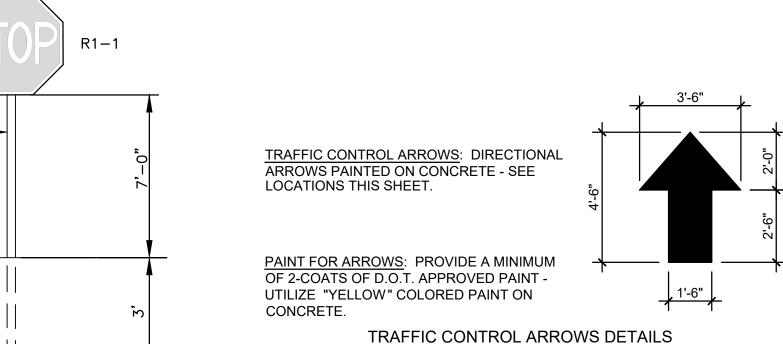

TURNING RADIIO

RADIUS

PROP. TRAFFIC

₹FLQW ARROW (TYR)

LOT 7

LOT 8

LOT 9

LOT 10

PROPOSED ASPHALT EXISTING ELEVATION PROPOSED CATCH BASIN EXISTING CATCH BASIN PROPOSED WATER METER EXISTING WATER METER

EXIST. 2-FT WIDE, WHITE-THERMOPLASTIC STOP BAR

TO REFURBISH

SIGN TO REMAIN

EXIST. "STOP" SIGN TO REMAIN


EXISTING WATER VALVE PROPOSED BFP DEVICE


LEGEND


EXISTING SAN. SEWER MH EXISTING FIRE HYDRANT


SCALE: 1"=20'

ON ANY ELECTRONIC COPIES.

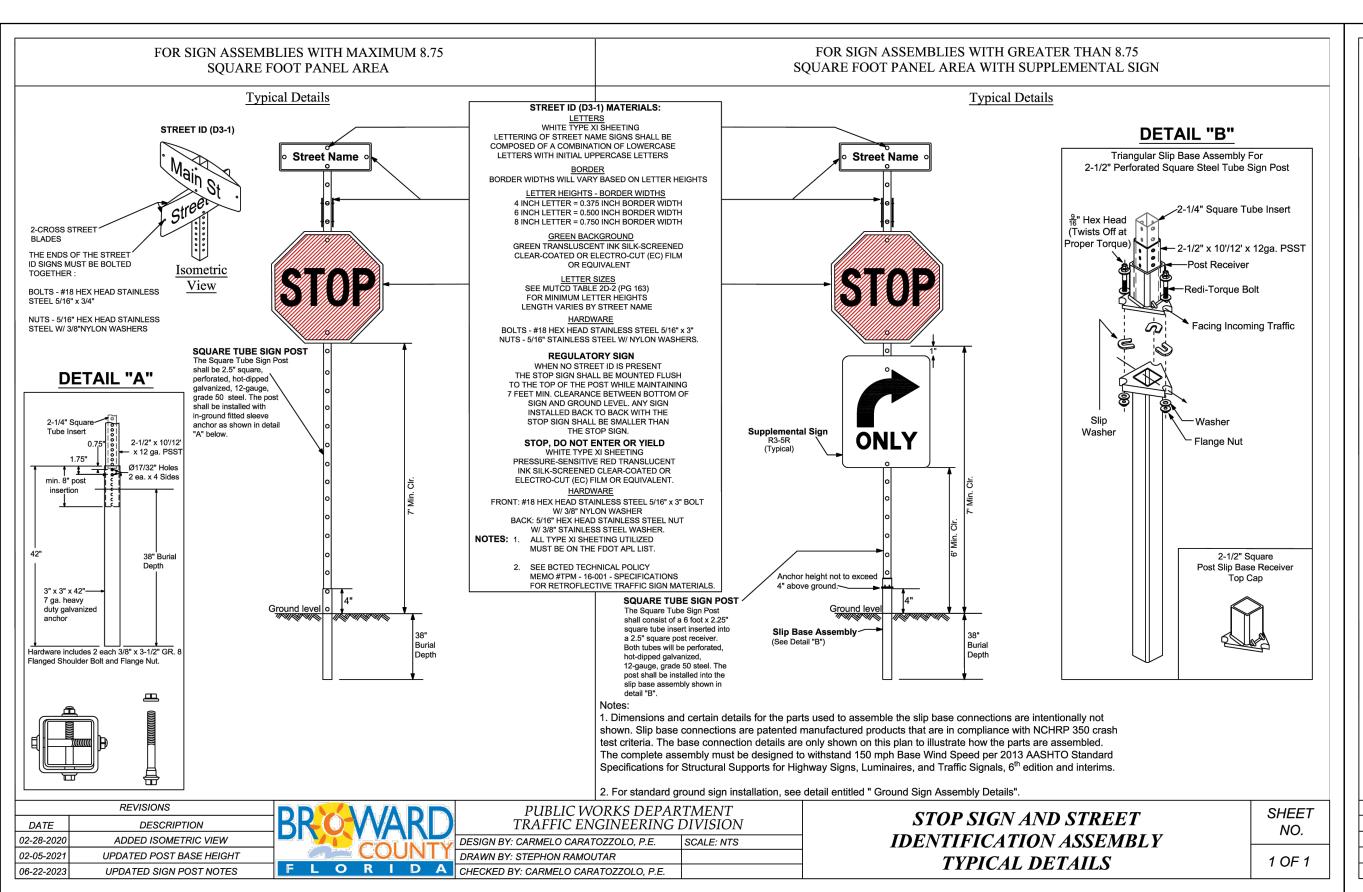

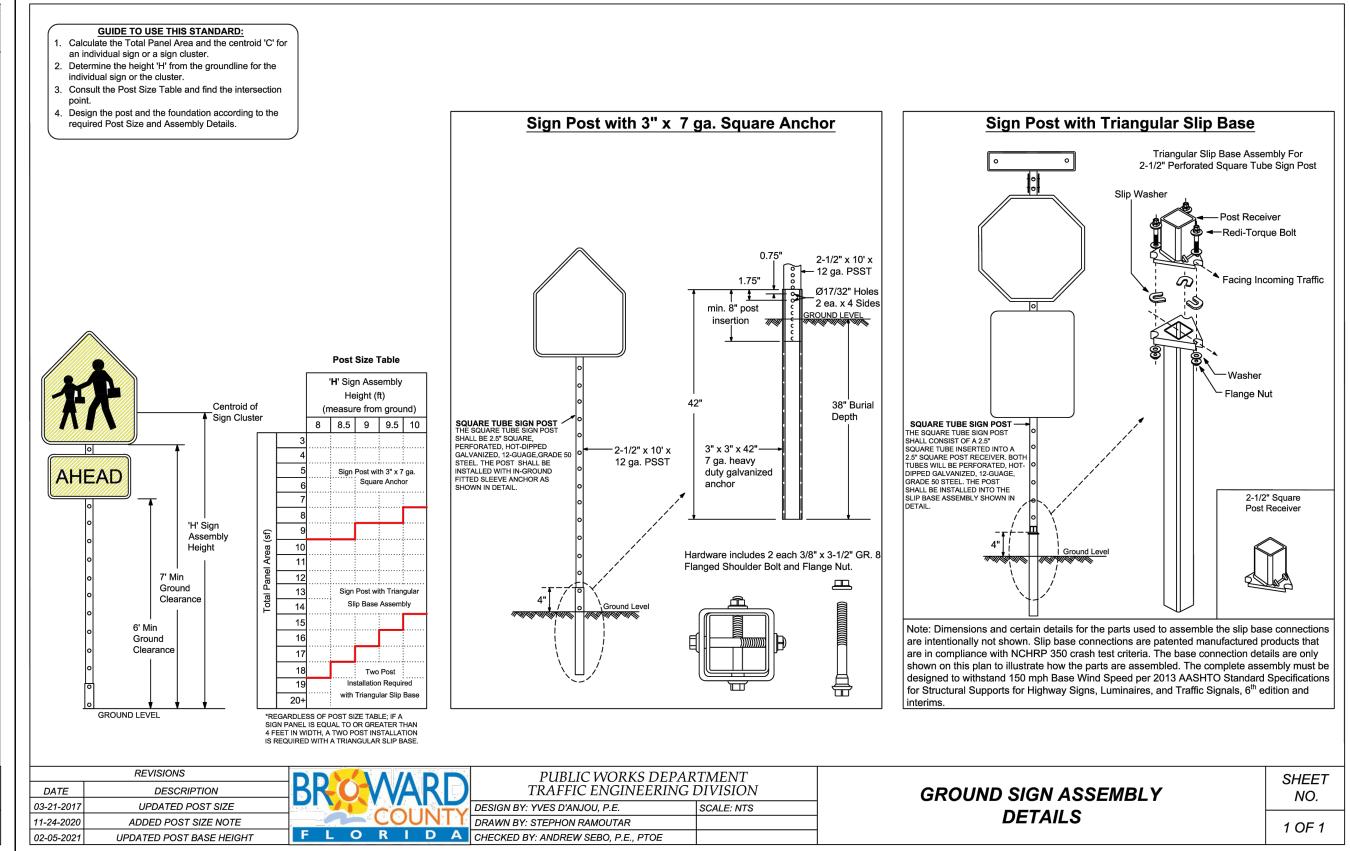

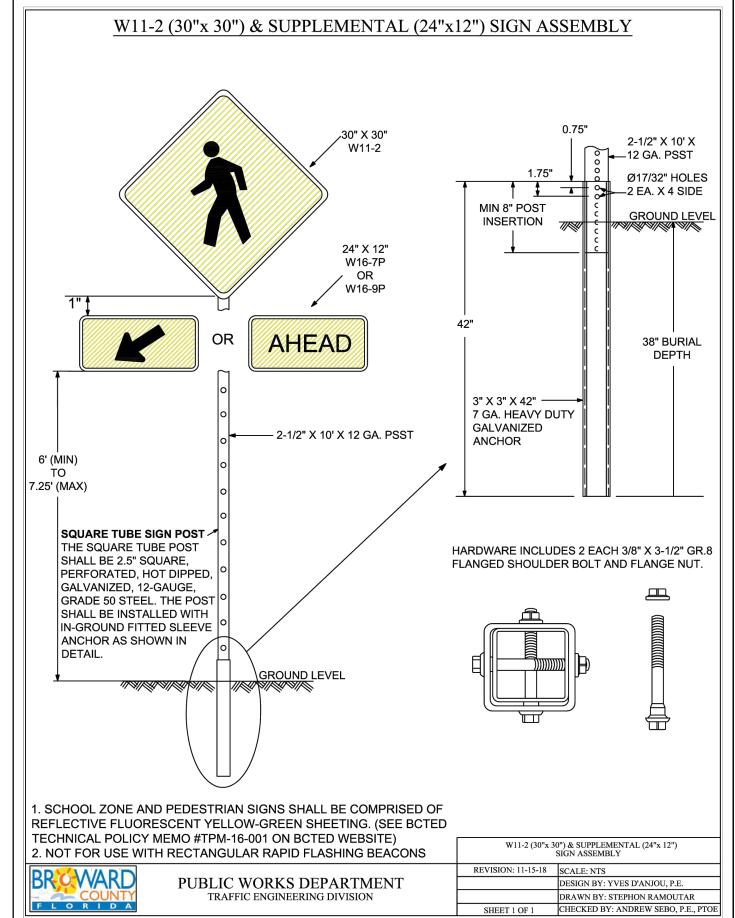

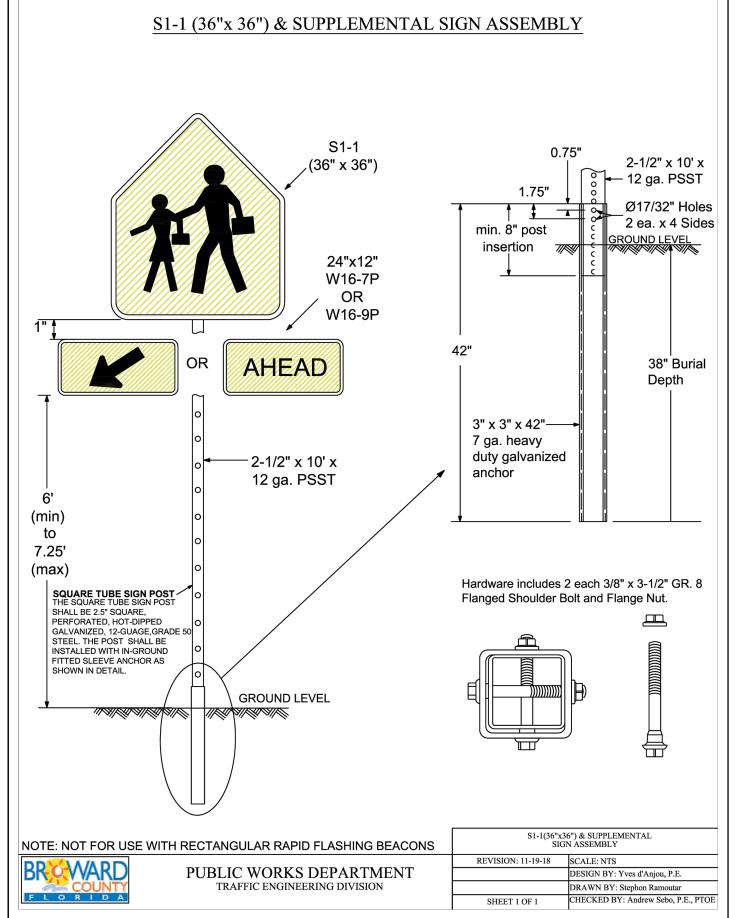




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R.O.W. PMS DETAILS

SCALE: N.T.S.



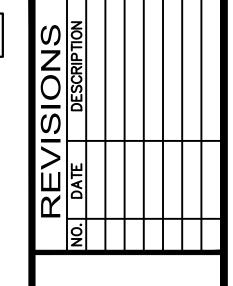

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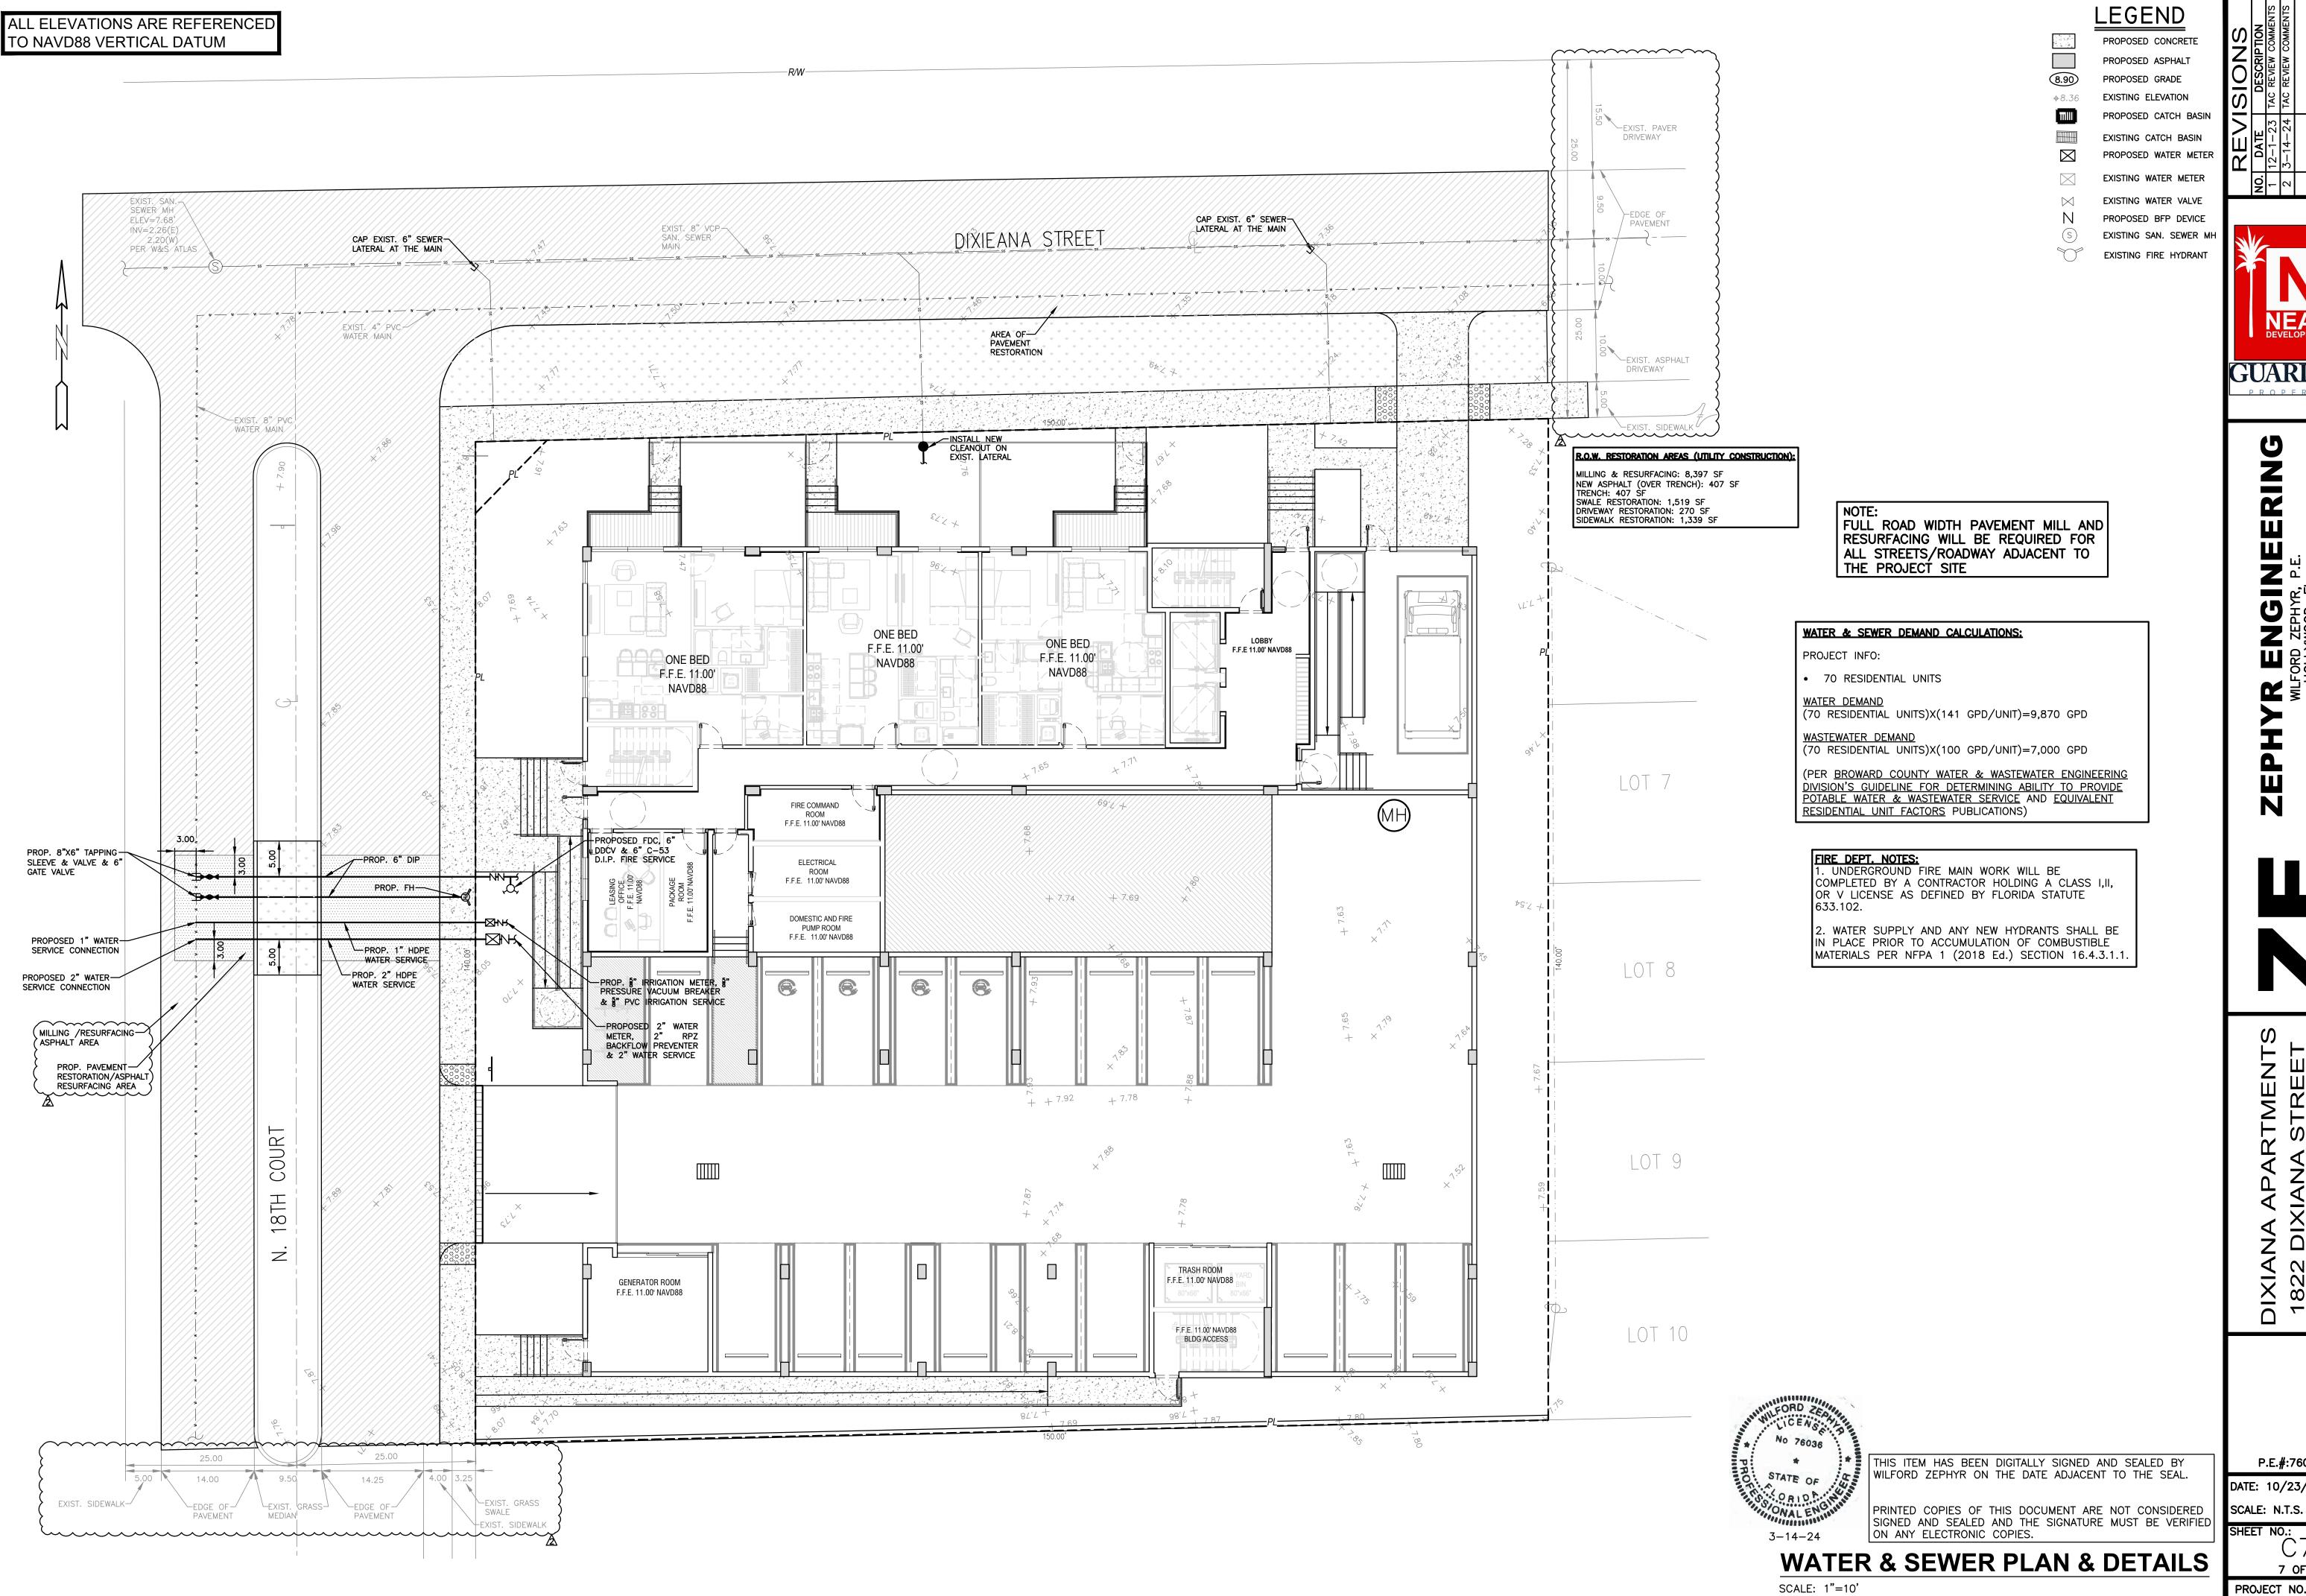
DIXIA IXIAN, 1822 D IOLLY

P.E.#:76036 DATE: 10/23/23

SCALE: N.T.S.

SHEET NO.: 6 OF 9

PROJECT NO.: 23-48




DIXIANA APAR 1822 DIXIANA HOLLYWOOD,

P.E.#:76036

DATE: 10/23/23

7 OF 9


PROJECT NO.: 23-48

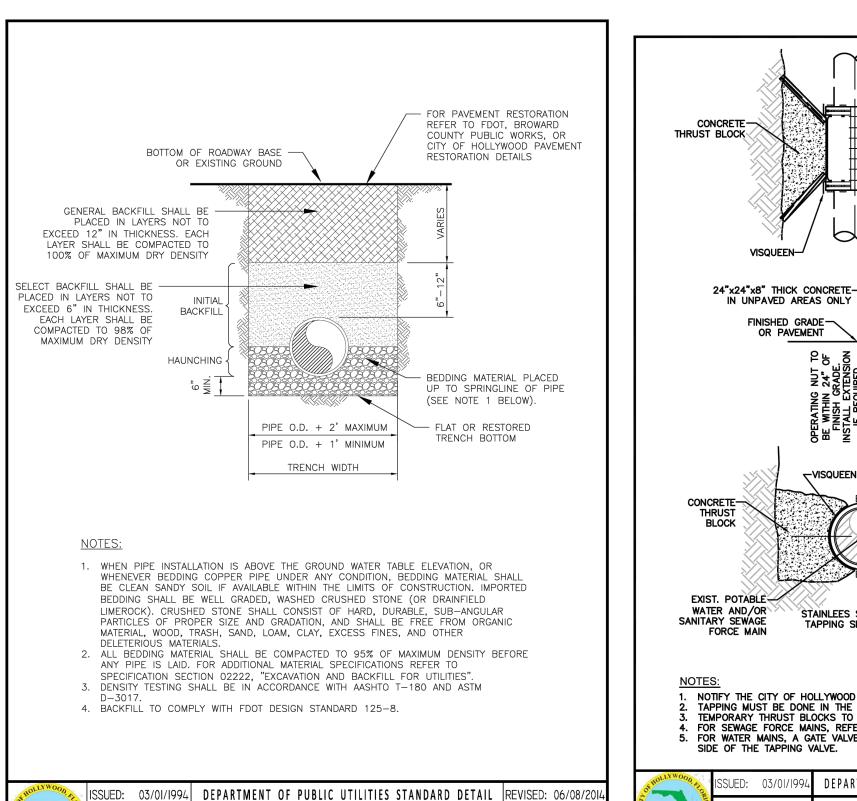



AWING NO.

G-03


W-04

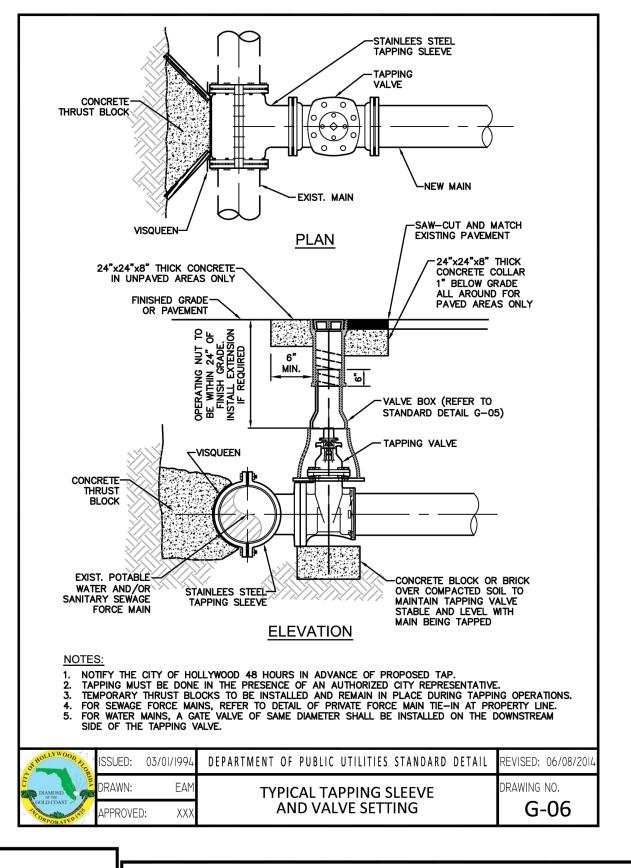

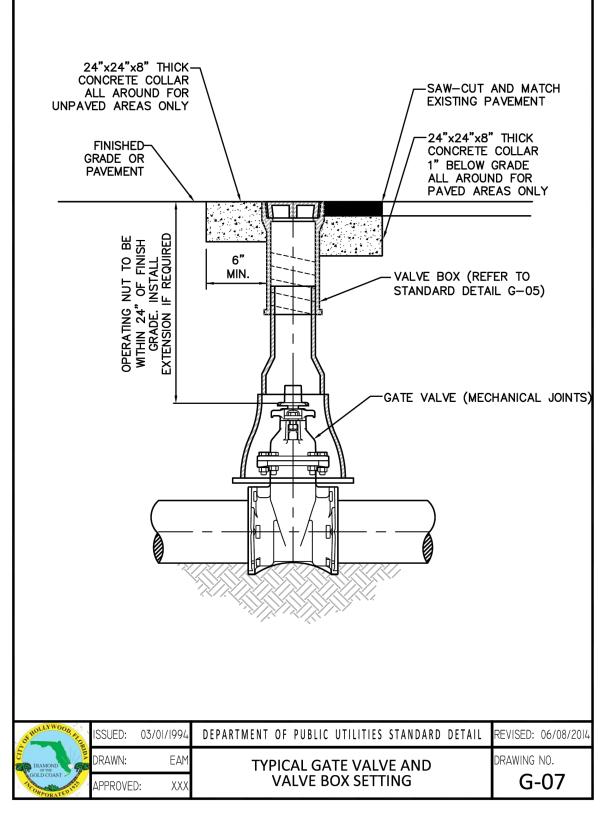

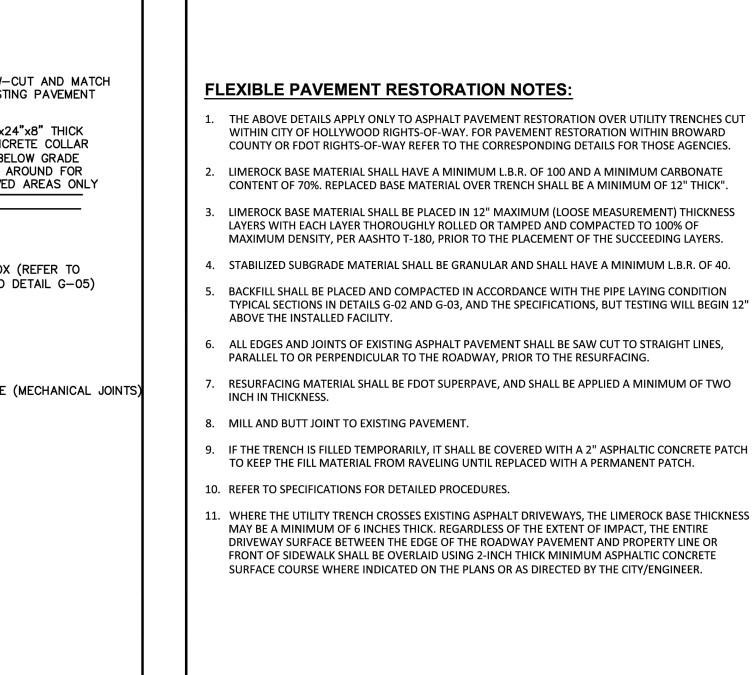

DIAMOND OF THE GOLD COAST	DRAWN:	EAM	FLEXIBLE PAVEMENT RESTORATION NOTES	DRAWING NO.
OF HOLLYWOOD, AL	ISSUED:	03/01/1994	DEPARTMENT OF PUBLIC UTILITIES STANDARD DETAIL	REVISED: 11/06/2017

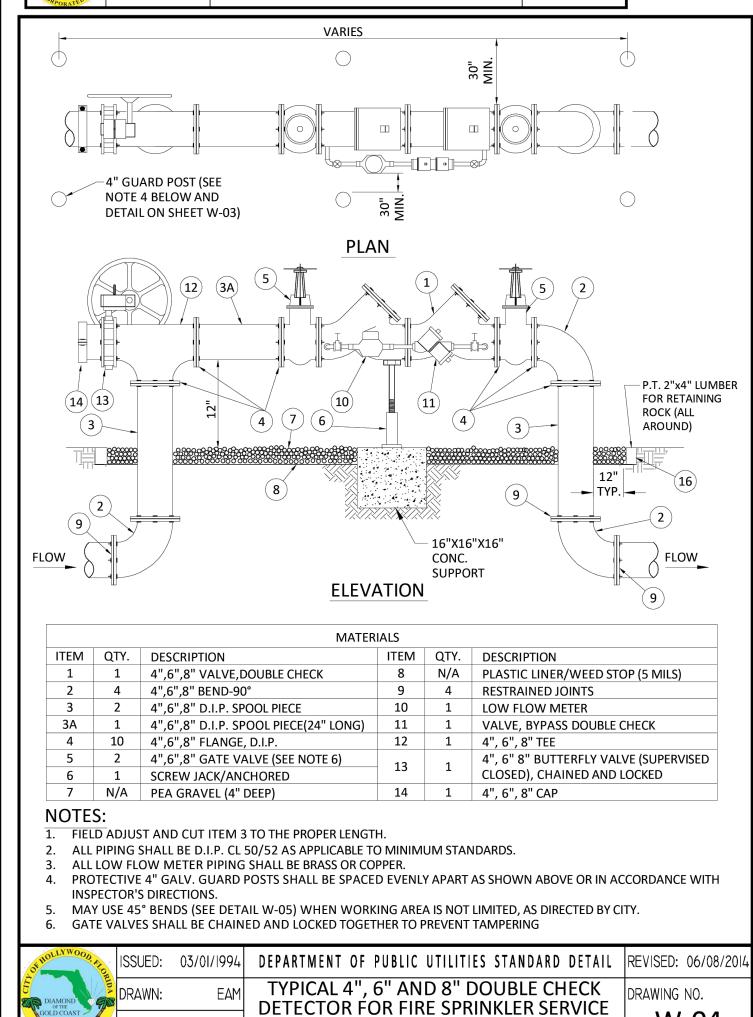



W/B.V. CONNECTION (90° BENDS)


PIPE LAYING CONDITION TYPICAL

SECTION (P.V.C.)

APPROVED:

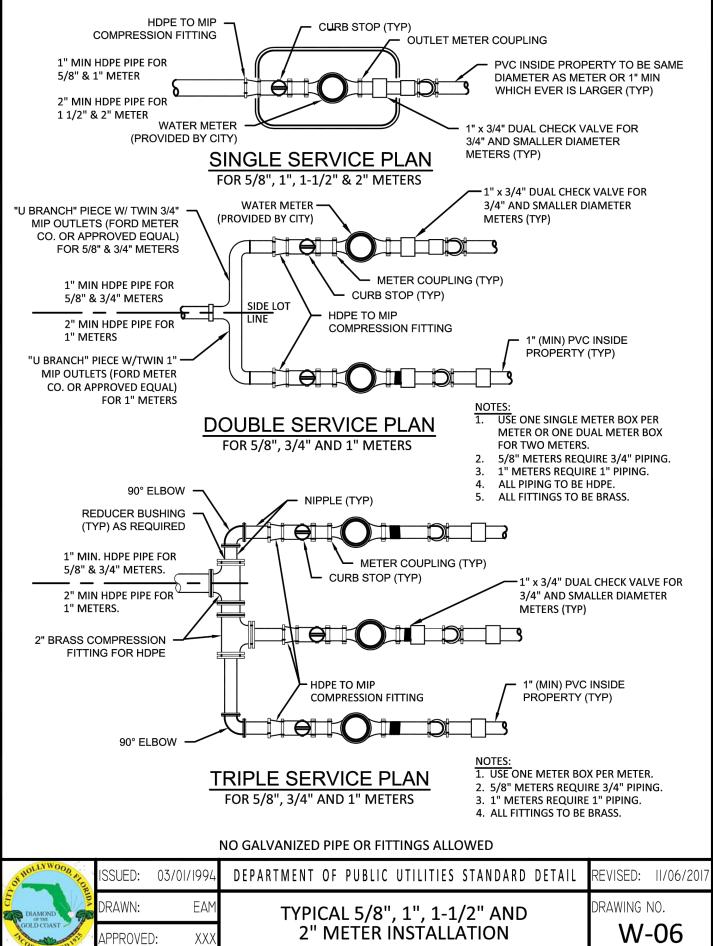

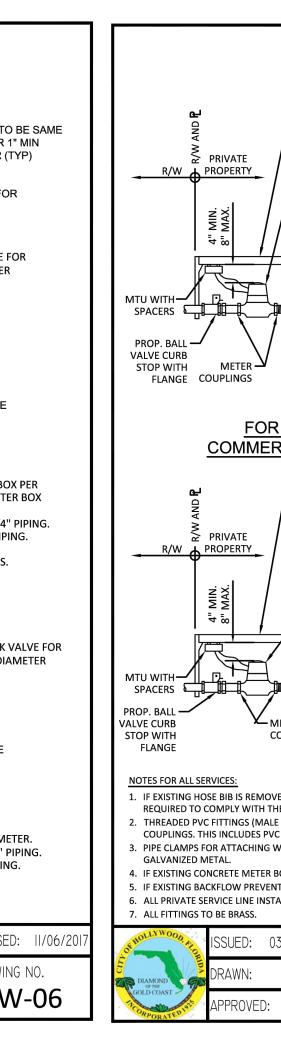

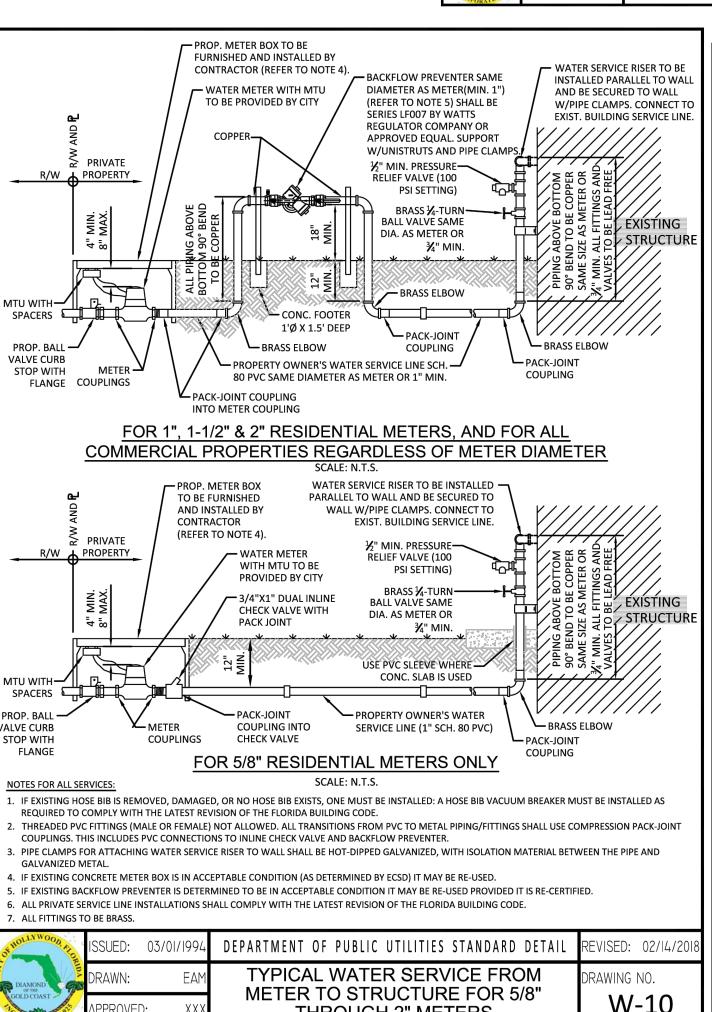

TON HOLLYWOOD, ALCE	ISSUED:	03/01/1994	DEPARTMENT OF PUBLIC UTILITIES STANDARD DETAIL	REVISED: 02/14/20
DIAMOND OF THE GOLD COAST	DRAWN:	EAM	TYPICAL WATER SERVICE FROM METER TO STRUCTURE FOR 5/8"	DRAWING NO.
TACORPORATEDIS.	APPROVED	D: XXX	THROUGH 2" METERS	W-10

#### **SEWER NOTES:**

- 1. THE MINIMUM DEPTH OF COVER OVER D.I.P. SANITARY SEWER GRAVITY OR FORCE MAINS IS 30". THE MINIMUM DEPTH OF COVER OVER PVC SANITARY SEWER OR FORCE MAINS IS 36".
- 2. ALL CONNECTIONS TO EXISTING MAINS SHALL BE THE RESPONSIBILITY OF THE CONTRACTOR.
- 3. LEAKAGE TESTS AND ALIGNMENT (LAMPING) TESTS SHALL BE PERFORMED ON ALL NEW SEWER LINES UP TO THE CONNECTION POINT WITH THE EXISTING SEWER SYSTEM. THESE TESTS SHALL BE REQUESTED AND PAID FOR BY THE CONTRACTOR.
- . LAMPING TESTS SHALL BE PERFORMED ON GRAVITY SEWERS FROM MANHOLE TO MANHOLE UP TO AND INCLUDING THE POINT OF CONNECTION TO THE EXISTING SEWER SYSTEM.
- . LEAKAGE TESTS SHALL BE PERFORMED ON ALL SEGMENTS OF A GRAVITY SEWER SYSTEM, INCLUDING SERVICE LATERALS AND MANHOLES, FOR A CONTINUOUS PERIOD OF NO LESS THAN 2 HOURS. AT THE END OF THE TEST, THE TOTAL MEASURED LEAKAGE SHALL NOT EXCEED 100 GALLONS PER INCH OF PIPE DIAMETER PER MILE PER DAY FOR ANY SECTION OF THE SYSTEM, WITH ZERO ALLOWABLE LEAKAGE FOR LATERALS AND MANHOLES. AN EXFILTRATION OR INFILTRATION TEST SHALL BE PERFORMED WITH A MINIMUM POSITIVE HEAD OF 2 FEET ON THE SECTION BEING
- 6. FORCE MAINS SHALL BE PRESSURE-TESTED IN ACCORDANCE WITH RULE 62-555.330 (FAC). THE PRESSURE TEST SHALL CONSIST OF HOLDING A TEST PRESSURE OF 150 PSI ON THE PIPELINE FOR A CONTINUOUS PERIOD OF 2 HOURS THE MAXIMUM ALLOWABLE LEAKAGE SHALL BE DETERMINED BY THE FOLLOWING FORMULA:



L = ALLOWABLE LEAKAGE FOR SYSTEM IN GALLONS PER HOUR

- D = PIPE DIAMETER IN INCHES
- S = LENGTH OF LINES IN LINEAL FEET P = AVERAGE TEST PRESSURE IN PSI
- CONTRACTOR SHALL BE RESPONSIBLE FOR IDENTYFYING CONFLICTS WITH FORCE MAINS PLACED AT MINIMUM COVER. IN CASE OF CONFLICT, FORCE MAIN SHALL BE LOWERED TO PASS UNDER CONFLICTS WITH 12" MINIMUM SEPARATION FROM WATER MAINS AND 6" MINIMUM SEPARATION FROM OTHER UTILITIES. NO ADDITIONAL PAYMENT SHALL BE DUE TO CONTRACTOR FOR LOWERING THE MAIN OR THE ADDITIONAL FITTINGS USED THEREON.
- . WHENEVER IT IS NECESSARY, IN THE INTEREST OF SAFETY, TO BRACE THE SIDES OF A TRENCH, THE CONTRACTOR SHALL FURNISH, PUT IN PLACE AND MAINTAIN SUCH SHEETING OR BRACING AS MAY BE NECESSARY TO SUPPORT THE SIDES OF THE EXCAVATION TO ENSURE PERSONNEL SAFETY, AND TO PREVENT MOVEMENT WHICH CAN IN ANY WAY DAMAGE THE WORK OR ENDANGER ADJACENT STRUCTURES. THE CONTRACTOR SHALL BE SOLELY RESPONSIBLE FOR THE SEQUENCE, METHODS AND MEANS OF CONSTRUCTION, AND FOR THE IMPLEMENTATION OF ALL OSHA AND OTHER SAFETY REQUIREMENTS.

OF HOLLYWOOD, FILE	ISSUED:	03/01/1994	DEPARTMENT OF PUBLIC UTILITIES STANDARD DETAIL	REVISED: 06/08/2014
DIAMOND OF THE	DRAWN:	EAM	SANITARY SEWER MAIN	DRAWING NO.
GOLD COAST TO USE	APPROVE	D: XXX	CONSTRUCTION NOTES	S-01



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P.E.#:76036

DATE: 10/23/23 SCALE: N.T.S.


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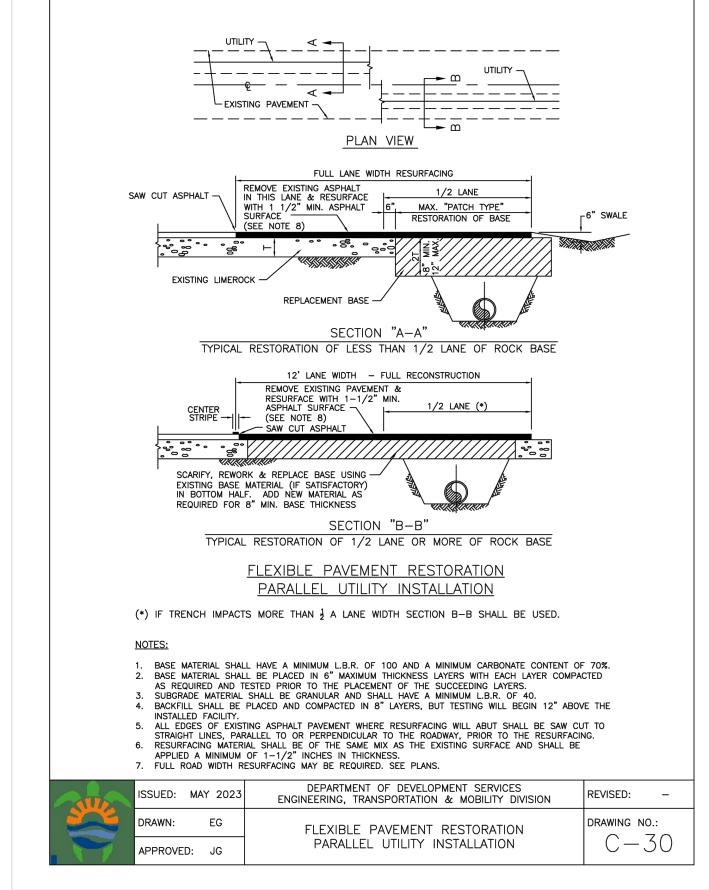
8 OF 9 PROJECT NO.: 23-48


**UTILITIES DETAILS** 


SCALE: N.T.S.

3-14-24



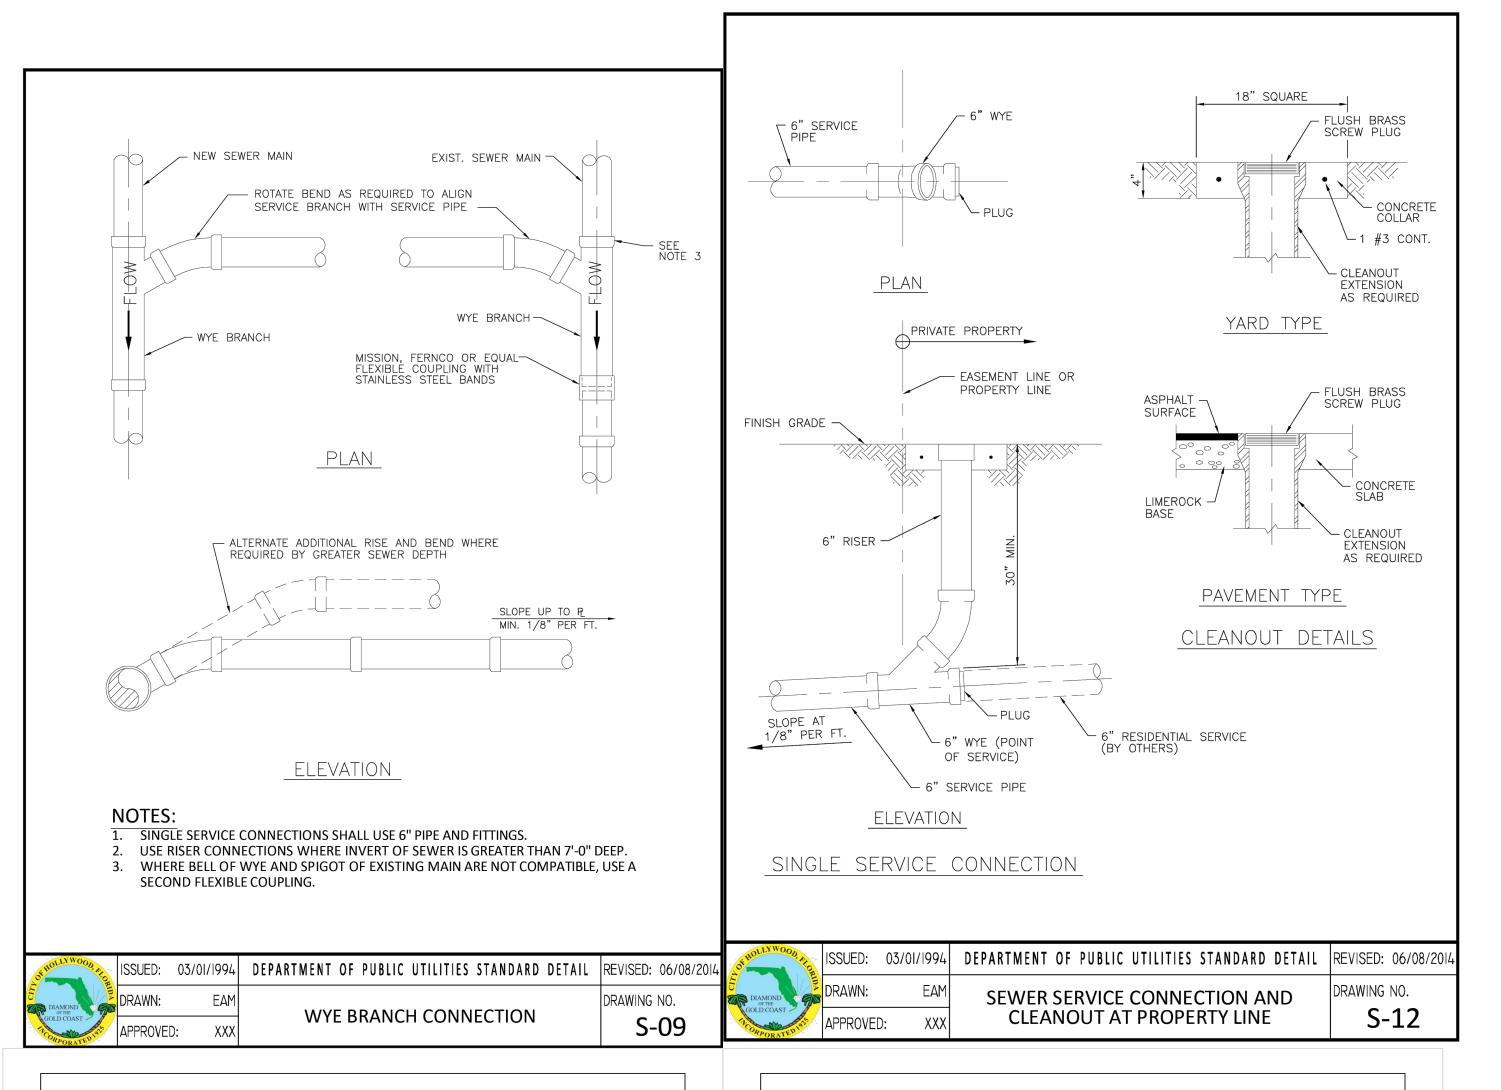

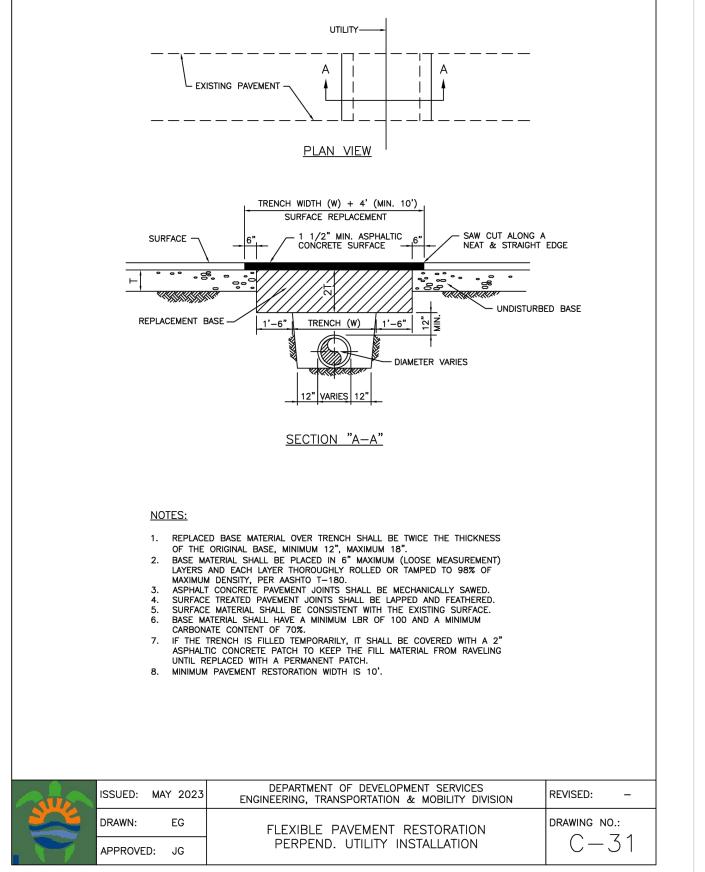

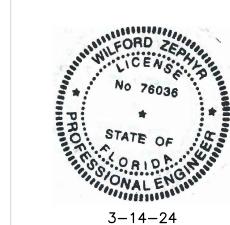


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# **UTILITIES DETAILS II**

SCALE: N.T.S.



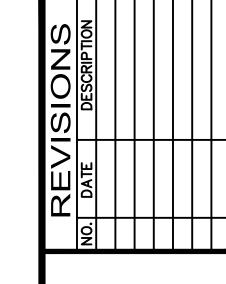

R ENGINEERING
MLFORD ZEPHYR, P.E.
HOLLYWOOD, FL
(786)302-7693


ZEPH

DIXIANA APARTMEN-1822 DIXIANA STREE HOLLYWOOD, FL 3302

P.E.#:76036

DATE: 10/23/23
SCALE: N.T.S.
SHEET NO.:

9 OF 9 PROJECT NO.: 23-48

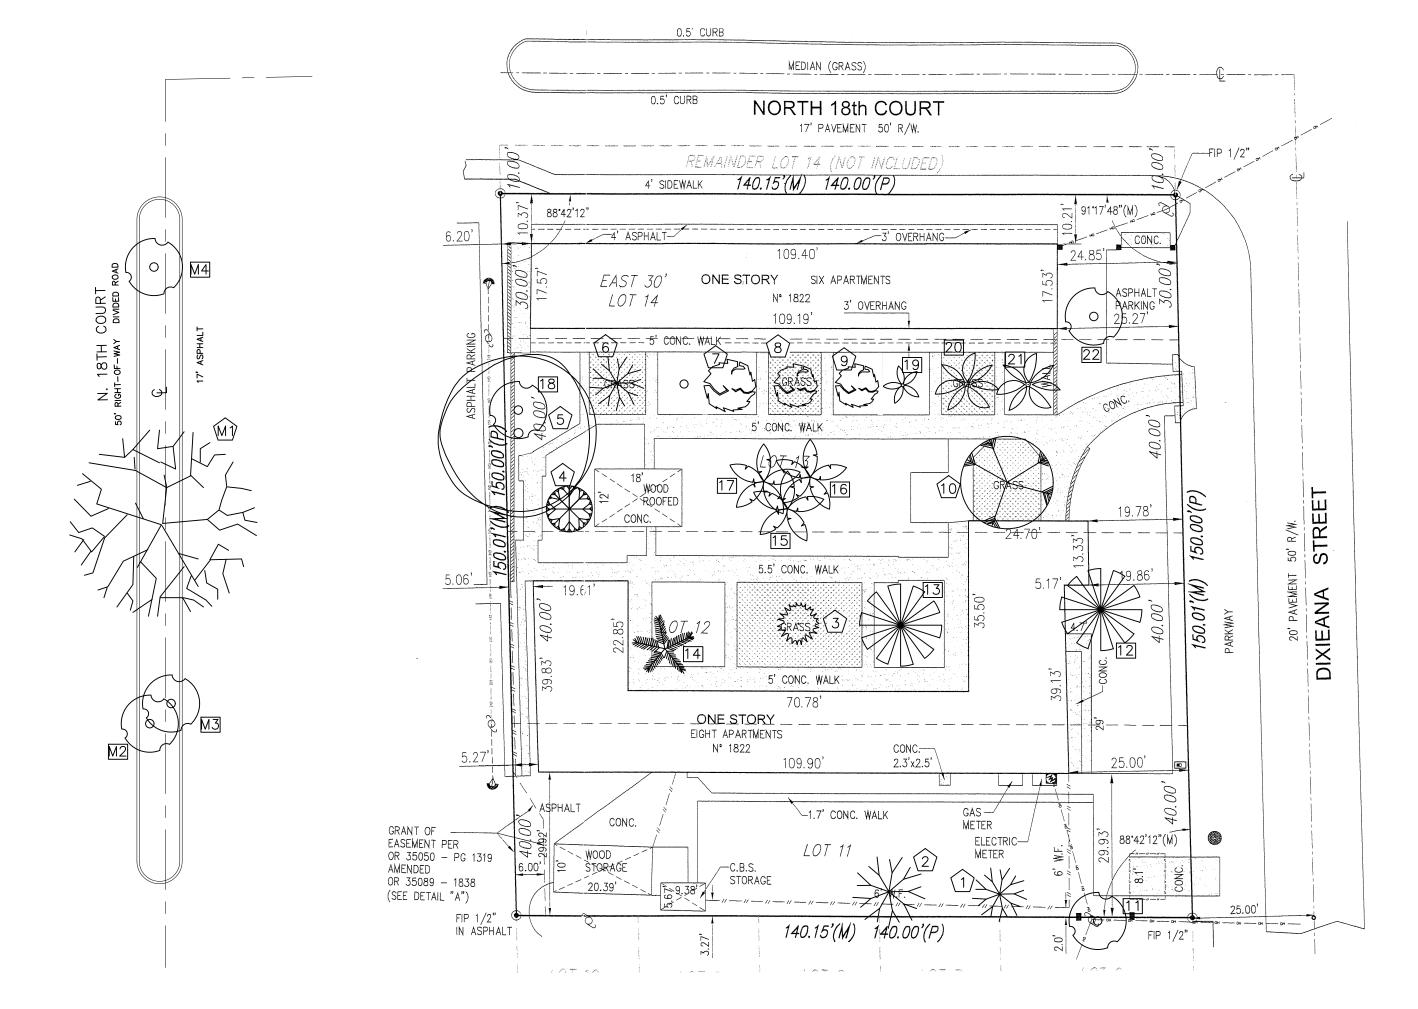


OO Denotes Existing Trees

OO Denotes Existing Palms



PROPERTIES



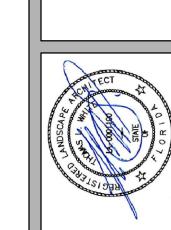

Apa anna Str

Dixieanna 1822 Dixi

REVISIONS

DRAWN:
TW
CHECKED:
TW
DATE:
10-12-2023
SCALE: 1"=20'





The plan takes precedence over the plant list.

2 Full business days before digging, call toll free 1-800-432-4770 Sunshine State One Call of Florida, Inc. Notification Center. Contractors are responsible for coordinating with the owners and appropriate public agencies to assist in locating and verifying all underground utilities prior to excavation. All existing utilities shown on the plans are to be considered approximate and should be verified by the contractor prior to the start of work operations.

General site and berm grading to +/-1 inch (1") shall be provided by the general contractor. All finished site grading and final decorative berm shaping shall be provided by the landscape contractor.

All sizes shown for plant material on the plans are to be considered Minimum. All plant material must meet or exceed these minimum requirements for both height and spread. Any other requirements for specific shape or effect as noted on the plan(s) will also be required for final acceptance.

All plant material furnished by the landscape contractor shall be Florida #1 or better as established by Grades and Standards for Florida Nursery Trees and Plants.

All trees designated as single trunk shall have a single, relatively straight, dominant leader, proper structural branching and even branch distribution. Trees with bark inclusion, tipped branches, and co-dominant trunks will not be accepted. Trees with girdling, circling and/or plunging roots will be rejected.

All planting beds shall be free of all rocks  $\frac{1}{2}$ " or larger, sticks, and objectionable material including weeds, weed seeds. All limerock shall be removed/cleaned down to the native soils. Planting soil 50/50 sand/topsoil mix shall be delivered to the site in a clean loose and friable condition and is required around the root ball of all trees and palms, the top 6" of all shrubs and ground cover beds. This soil can be tilled into the existing soil after the existing soil has been cleaned of all rocks, limestone and sticks. Recycled compost is encouraged as a soil amendment alternative. Sod 1.5—2" topsoil comes furnished.

All burlap, string, cords, wire baskets, plastic or metal containers shall be removed from the rootballs before planting. Remove all bamboo and metal nursery stakes. Remove all tagging

All trees/palms shall be planted so the top of the root ball, root flair are slightly above final grade. Shrub material shall be planted such that the top of the plant ball is flush with the surrounding grade. It is the sole responsibility of the landscape contractor to insure that all new plantings receive adequate water during the installation and during all plant warranty periods. Deep watering of all new trees and palms and any supplemental watering that may be required to augment natural rainfall and site irrigation is mandatory to insure proper plant development and shall be provided as a part of this contract.

All trees/palms shall be staked using biodegradable material. No wire, black strapping, or other synthetic material shall be used. Nailing into trees and palms for any reason is prohibited and the material will be rejected. Please refer to the planting details

All landscape areas shall be irrigated by a fully automatic sprinkler system with a minimum 100% coverage with all heads adjusted to 50% overlap. Each system shall be installed with an operational rain sensor and rust inhibitor.

#### No fertilizers are required.

All landscape areas shall be covered with Pine Straw, Pine Bark, Eucalyptus or sterilized seed free Melaleuca mulch to a minimum depth of two inches (2") of cover when settled. Spread mulch to 1" thickness 3" away from the trunks/stems of all plant material. All trees in sodded areas shall have a clean cut 4' diameter mulch ring. The 5—6" height water ring shall be made from mulch, not soil. Certain areas may receive a thicker mulch cover where noted on plans. Cypress, red, gold and green mulch is prohibited.


Please refer to the planting details for a graphic representation of the above notes. All plant material as included herein shall be warranted by the landscape contractor for a minimum period of 12 months after final inspection approval.

No landscape substitutions shall be made without the City of Hollywood approval.


No tree removal or planting allowed until sub permits are fully approved by city.

Submit all submittals to owner, general contractor and landscape architect for review.

Proposed landscaping will not adversely affect proposed onsite stormwater runoff retention swales around property perimeter.

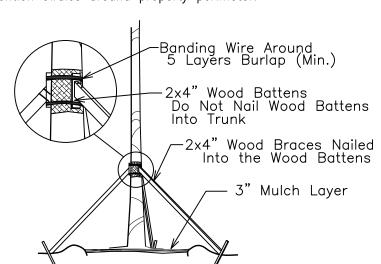


# TREE/PALM BRACING DETAIL

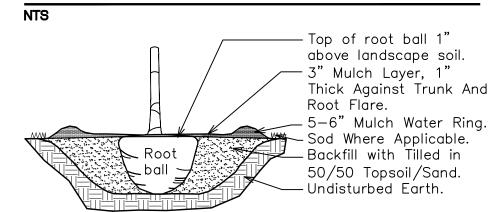


# TREE/PALM PLANTING DETAIL

	<b>√</b> l		
C: 18" for all 1 gal., 30" for all	O		— Fence, wall or structure
3 gal. or greater, vines not included	<b>\</b>		B: 18" between all 1 g and 1 gal., 24" betwee
		+++++++++++++++++++++++++++++++++++++++	- all 1 gal. and 3 gal., 3 between all 3 gal. and
<b>A:</b> 14" for all 1	4	++++++	gal. or greater. — Curb or edge
gal., 24" for all 3 gal. or greater.	<b>∢</b>		of pavement
gai. Or greater.	1*		

TYPICAL SHRUB SPACING DETAIL

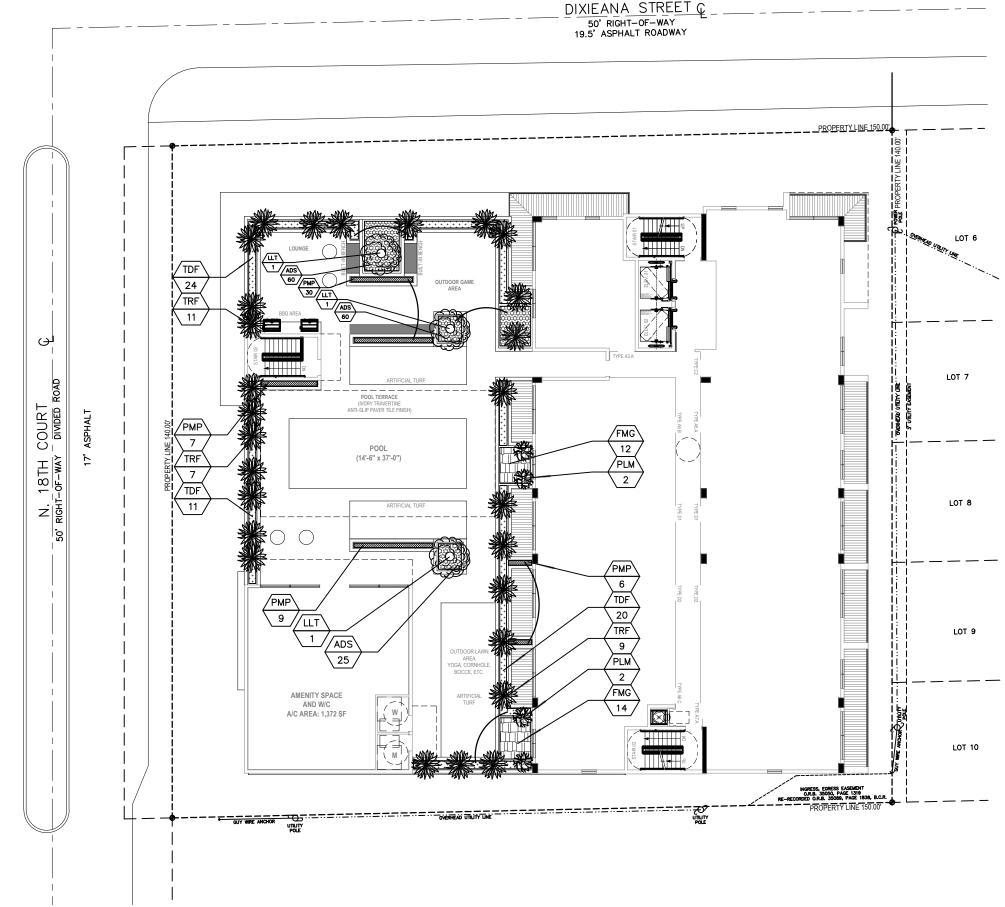



4.6 RAC						
4.d.(3)1	Stre	et Trees:	One F	Per 30 LF of Street Frontage	Required	Provided
,		150	LF	Feet of Dixieanna Street		
		140	LF	Feet of North 18th Court		
		290		Total	10	10
4.d.(3)2	5' La	andscape	Buffe	er Required and Provided. One Tree per 20 LF		
` '		290	LF	Perimeter of South and East Boundaries	15	15
4.d.(3)5	5' La	andscape	Buffe	er Required and Provided. 42" Landscape Element		
		290	LF	Perimeter of South and East Boundaries	42" Hedge	42" Hedge
4.d.(3)9	One	Tree per	ever	y 1,000 square feet of Pervious Area		
,		4,340		of Ground Floor Pervious Area.	5	5
				Total Trees	30	30

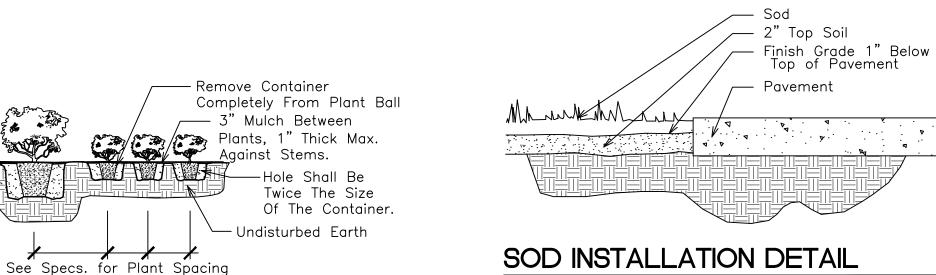

# SHRUB PLANTING DETAIL

ROOFTOP POOL AREA

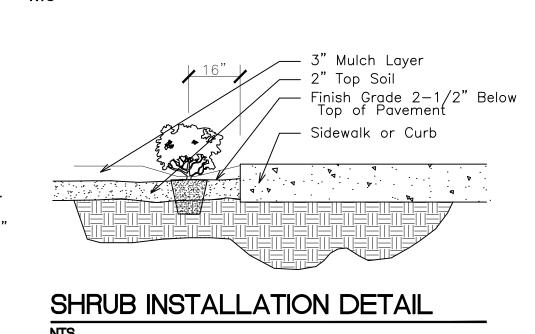

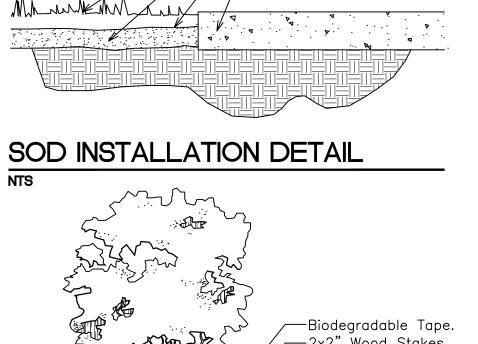


Biodegradable Tape.  2x2" Wood Stakes.  Remove Burlap, String,  Nails, Etc. From Plant  Ball Between Plants.  3" Mulch Layer, 1" Thick  Against Trunk And Root  Flare.  5-6" Mulch Water Ring.  Sod Where Applicable.  Hole Shall Be Twice The  Size Of The Container /  Root Ball.  Undisturbed Earth.
SMALL TREE PLANTING DETAIL

SOD

Drought QTY. Code Botanical Name / Common Name Specifications PROPOSED TREES / PALMS 12'x5-6', 2" DBH, Sng. Trunk Bulnesia arborea / Verawood Cordia sebestena / Orange Geiger 12'x5-6', 2" DBH, Sng. Trunk 12'x5-6', 2" DBH, Sng. Trunk Delonix regia / Royal Poinciana 12'x5-6', 2" DBH, Sng. Trunk Lagerstroemia speciosa / Queen's Crape Myrtle Myrica cerifera / Wax Myrtle 12'x5-6', 2" DBH, Sng. Trunk 12' CT Phoenix dactylifera / Medjool Date Palm Roystonea elata / Cuban-Florida Royal Palm 15-16' GW **Total Site Trees Native Trees** 47% **Native Trees** MITIGATION TREE LIST Drought QTY. Total Botanical Name / Common Name Code Specifications Lagerstroemia indica / Crape Myrtle 12'x5-6', 2" DBH, Sng. Trunk 16 12'x5-6', 2" DBH, Sng. Trunk Polyalthia longifolia 'Pendula' / Mast Tree Total DBH Added 22 Total DBH Removed DBH Deficiency 85 Payment Into the Tree Trust Fund @ \$350 per every 2" = \$14,875 MITIGATION PALM LIST Drought QTY. Total Specifications Code Botanical Name / Common Name CM 14' OA Ht., Multi Caryota mitis / Fishtail Palm CN 12' CT Cocos nucifera / Coconut Palm Total Palms Added 15 Total Palms Removed 15 Palms Deficiency 0 ACCENTS / HEDGES / SHRUBS Chrysobalanus icaco 'Red Tip' / Cocoplum 42-48"x 24-30", 30" OC CRI Crinum augustum / 'Queen Emma' Crinum 3'x3' CRS Clusia rosea / Small Leaf Clusia 48"x 24", 36" OC Hibiscus sp. / Hibiscus Std., Pink & Red 5'6' OA Ht., 2' CT, Sng. Trunk 8' Ht.x4-5' Spr., Multi Ligustrum lucidum / Tree Ligustrum Polyalthia longifolia 'Pendula' / Mast Tree 8' OA Ht. **PMP** 24"x 18", 20-24" OC Podocarpus maki / Podocarpus TDF Tripsacum dactyloides / Fakahatchee Grass 24-30"x 24-30", 42-48" OC 6' OA Ht. Thrinax radiata / Florida Thatch Palm 357 **Total Shrubs** 357 Native Shrubs 100% Native Shrubs GROUND COVERS / SOD Asparagus densiflorus 'Myers' / Foxtail Fern 18" Spr., 24" OC BRO Jasminum volubile / Wax Jasmine 18" Spr., 24" OC 18" Spr., 24" OC **FMG** Ficus microcarpa / Green Island Ficus 12" OA Ht., 10-12" OC Liriope muscari / "Evergreen Giant' Liriope **RSM** Ruellia simplex, Mexican petunia 15" OA Ht., 18" OC

By GC S.F. Stenotaphrum secundatum / St. Augustine 'Palmetto' Solid application - no gaps between seams

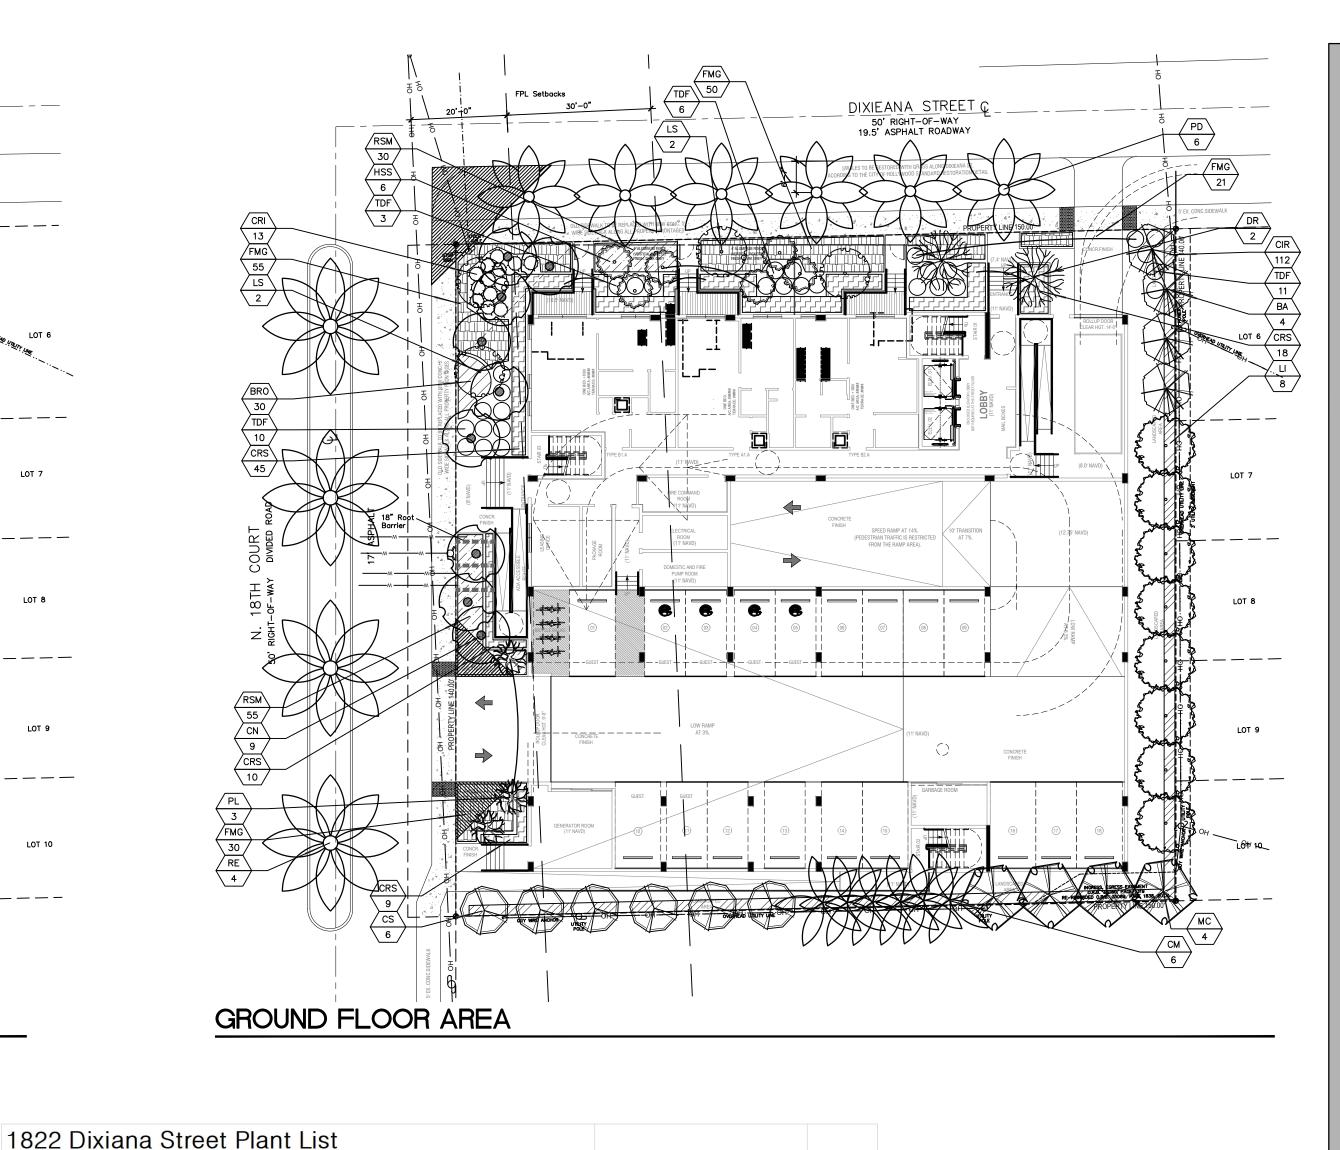







Call 811 or www.sunshine811.com two full business days before digging to have utilities located and marked. Check positive response codes before you dig!



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Dixie

REVISIONS

CHECKED: DATE: 10-12-2023 SCALE: 1"=20'









CHECKED: DATE: 10-12-2023 SCALE: 1"=20'



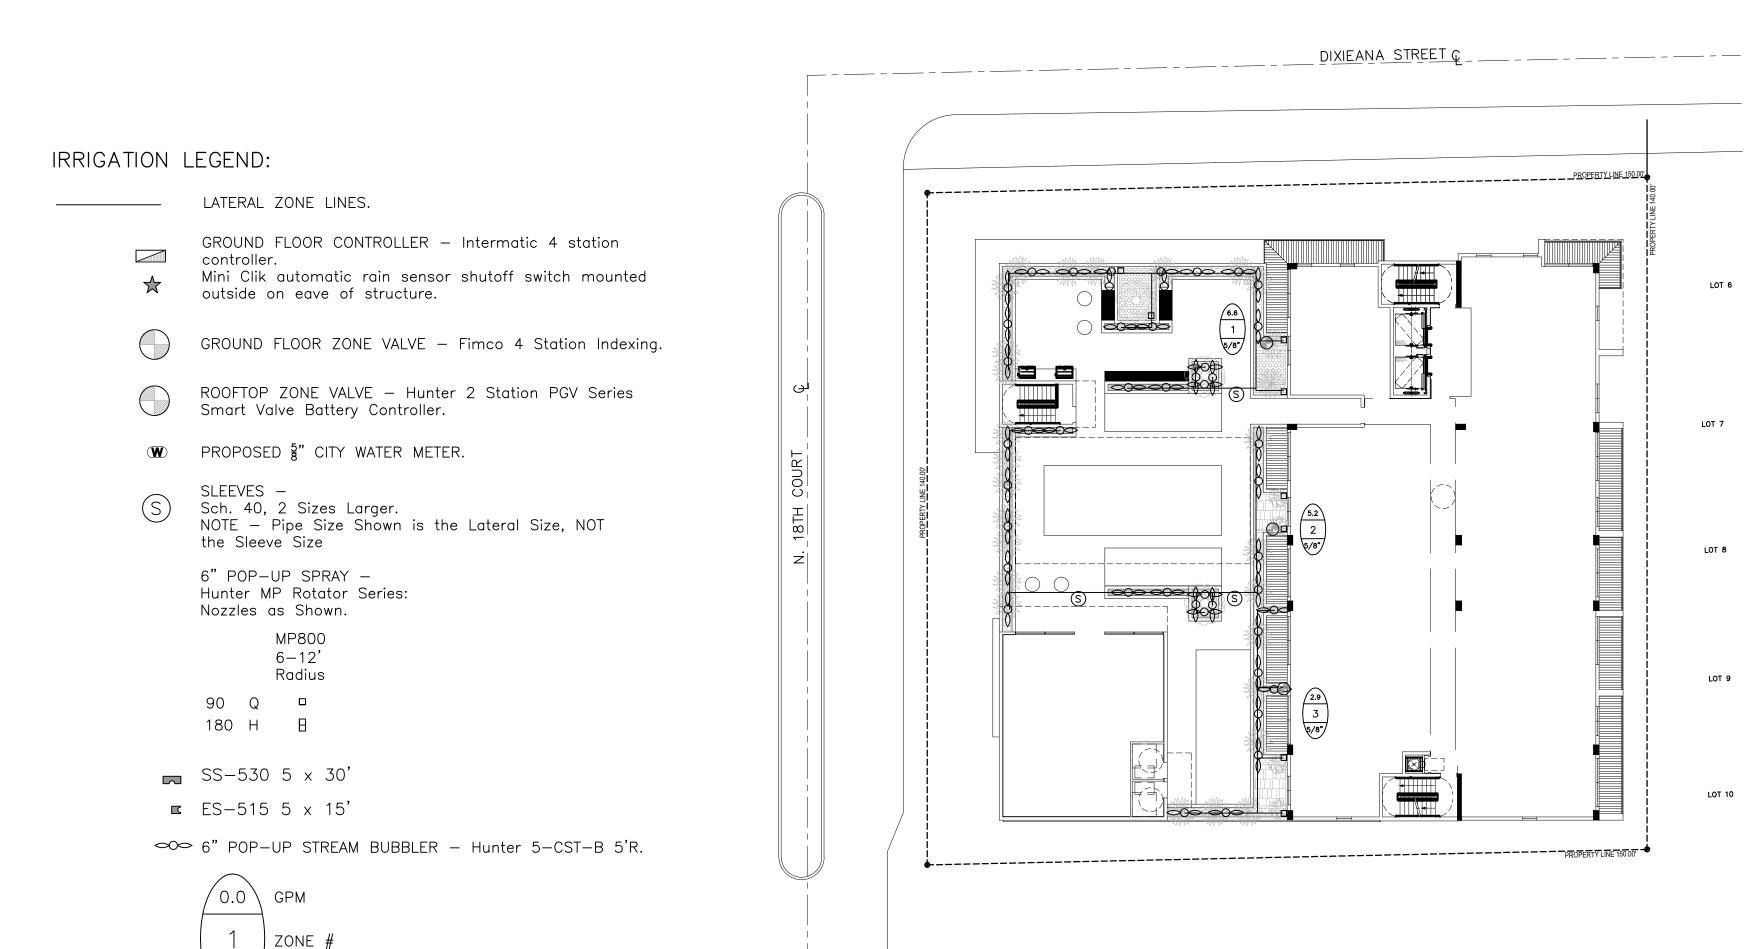

ROOFTOP POOL AREA

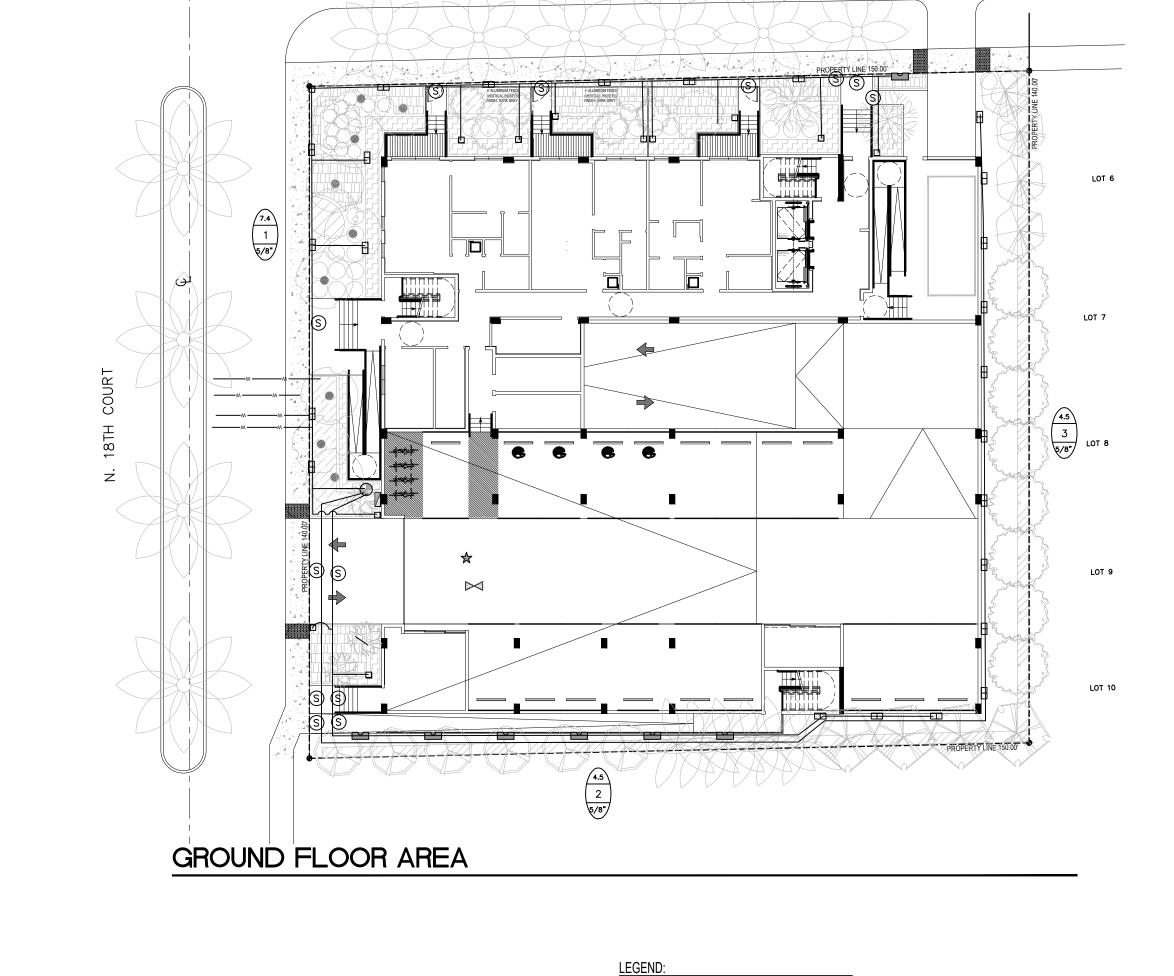

2) IRRIGATION CONTROL WIRE IN CONDUIT

CONNECT TO POWER SOURCE, J-BOX INSIDE CONTROLLER (4) ADJACENT SURFACE TO MOUNT CONTROLLER PER PLAN

SIZE AND TYPE PER LOCAL CODES (3) ELECTRICAL SUPPLY CONDUIT

**IRRIGATION NOTES:** 

VALVE SIZE

Main Lines: PVC SCH 40 Solvent Weld. Zone Lines: PVC SCH 40 Solvent Weld. 1/2 in. is not used. All pipe is 3/4 in. unless noted. Sleeves and suction Line: PVC SCH 40.

Fittings: SCH 40 PVC. 1-1/4".

Fabrication: To manufacturers specifications. Use blue or grey PVC cement, square cut, clean and prime all joints.

Allow all main lines to cure for 24 hours before pressuring.

All pipe, fittings, and solvents to conform to latest ASTM specs. Depth of Lines: Main Line and wiring = 18 in. depth, min.

Sleeving under pavement = 24 in. depth, min. Suction Line = 24 in. depth, nominal.

Zone Lines 1-1/2 in. and smaller = 10 in. depth, min.

Control Wires: AWG 14 for all hot wires and AWG 12 for common. Solid copper type UF UL listed for direct burial.

Run wires under main. Run spares, two min.

Splice wires only in a valve box. All splices shall be moisture proof using Snap tite or DBY UL connectors.

Common shall be white, hot shall be red or color coded


Spare shall be black. Run all wires in Grey Electrical SCH 40 conduit..


Backfill all trenches free of debris, compact to original density, flush all lines, use screens in all heads, adjust heads for proper coverage avoiding excess water on walls, walks, etc.


All details are graphically shown only. All quantities shall be verified by the contractor prior to installation. It shall be the contractors responsibility to assure complete overlapping coverage. Any discrepancies shall be reported to the owner and landscape architect before proceeding. Codes and local regulations shall take precedence over these plans, it is the contractors responsibility to comply. The landscape architect reserves the right to make minor field changes, the contractor may field adjust spray nozzle selection to provide for proper 100% min. coverage.

Provide owner with an accurate as installed plan(s) at completion showing main lines, wiring, valves, crossings, etc. using dimensions from fixed datums.

Contractor shall verify all underground utilities prior to commencement of work.

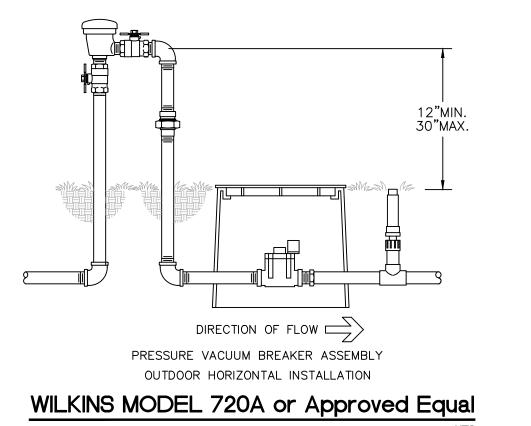

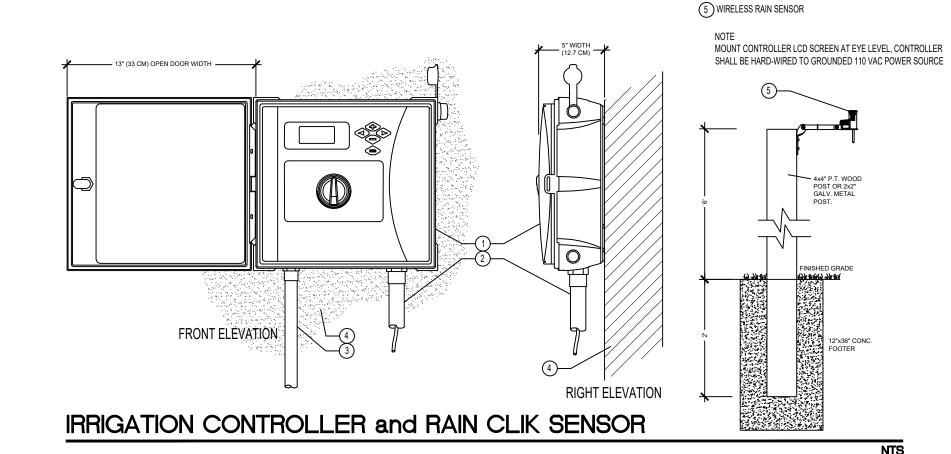

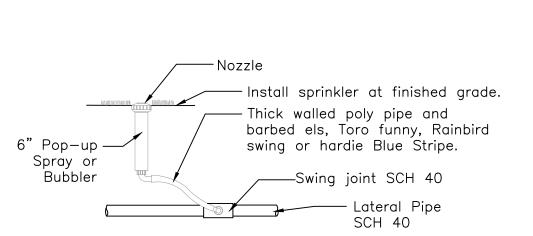

6" Pop-up Spray / Bubbler Detail

Check positive response codes before you dig! PROPERTIES



Sunshine [1]

Call 811 or www.sunshine811.com two full

business days before digging to have utilities

located and marked.