

BENCHMARK USED = NO. BCED-1915 ELEVATION =3.27' N.G.V.D.29

Accepted By:

Property Address: 1415 Madison Street

Hollywood, FLORIDA 33020

SURVEYOR'S CERTIFICATION I HEREBY CERTIFY THAT THIS BOUNDARD SURVEY IS A TRUE AND CORRECT REPRESENTATION OF A SURVEY PREPARED UNDER MY DIRECTION. THIS COMPLIES WITH THE MINIMUM TECHNICAL STANDARDS, AS SET FORTH BY THE STATE OF FLORIDA BOARD OF PROFESSIONAL LAND SURVEYOR'S IN CHAPTER 5J-17-052, FLORIDA ADMINISTRATIVE CODE PURSUANT TO 427-023 FLORIDA STATUTES.

SIGNED \_\_\_\_\_\_ FOR THE FIRM
Miguel Espinosa
STATE OF FLORIDA P.S.M. No. 5101

NOT VALID WITHOUT AN AUTHENTIC ELECTRONIC SIGNATURE AND AUTHENTICATED ELECTRONIC SEAL AND / OR THIS MAP IS NOT VALID WITHOUT THE SIGNATURE AND THE ORIGINAL RAISED SEAL OF A LICENSED SURVEYOR AND MAPPER

M.E. Land Surveying, LLC

P.O. Box 970685 Miami, FL 33197

Phone: (305) 740-3319 Fax: (305) 669-3190

LB#: 7989



Notes: PAVERS EXTEND BEYOND NORTH AND SOUTH PROPERTY LINES.

## Surveyor's Legend

	LIMITED ACCESS RIGHT-OF-WAY LINE						
	PROPERTY LINE						
120	STRUCTURE LINE	FND	FOUND IRON PIPE /	B.R.	BEARING REFERENCE	TEL.	TELEPHONE FACILITES
	CONCRETE BLOCK WALL		PIN AS NOTED ON PLAT		CENTRAL ANGLE OR DELTA	U.P.	UTILITY POLE
xx	CHAIN LINK FENCE OR WIRE FENCE	LB#	LICENSE # - BUSINESS	R	RADIUS	E.U.B.	ELECTRIC UTILITY BOX
-1111-	WOOD FENCE	LS#	LICENSE # - SURVEYOR	RAD	RADIAL	SEP.	SEPTIC
	IRON FENCE	CALC	CALCULATED POINT	N.R.	NON RADIAL	D.F.	DRAINFIELD
	EASEMENT	SET	SET PIN	TYP.	TYPICAL	AC	AIR CONDITIONER
	CENTER LINE	<b>A</b>	CONTROL POINT	l.R.	IRON ROD	SAV	SIDEWALK
		_		I.P.	IRON PIPE	DWY	DRIVEWAY
	WOOD DECK		CONCRETE MONUMENT	N&D	NAIL & DISK	SCR.	SCREENED
	ASPHALT	<b>◆</b>	BENCHMARK	PK NAIL	PARKER-KALON NAIL	GAR.	GARAGE
500000000000000000000000000000000000000		ELEV	ELEVATION	D.H.	DRILL HOLE	ENCL.	ENCLOSURE
	BRICK / TILE	P.T.	POINT OF TANGENCY	0	WELL	N.T.S.	NOT TO SCALE
	WATER	P.C.	POINT OF CURVATURE	<b>P</b>	FIRE HYDRANT	F.F.	FINNISHED FLOOR
		P.R.M.	PERMANENT REFERENCE MONUMENT	W	MANHOLE	T.O.B.	TOP OF BANK
	APPROXIMATE EDGE OF WATER	P.C.C.	POINT OF COMPOUND CURVATURE	O.H.L.	OVERHEAD LINES	E.O.W.	EDGE OF WATER
	COVERED AREA	P.R.C.	POINT OF REVERSE CURVATURE	TRANS.	TRANSFORMER	E.O.P.	EDGE OF PAVEMENT
£33		P.O.B.	POINT OF BEGINNING	CATV	CABLE TV RISER	CVG	CONCRETE VALLEY GUTTER
೭ಬ	TREE	P.O.C.	POINT OF COMMENCEMENT	×	WATER METER	B.S.L.	BUILDING SETBACK LINE
×	POWER POLE	P.C.P.	PERMANENT CONTROL POINT	P/E	POOL EQUIPTMENT	S.T.L.	SURVEY TIE LINE
	92072172VQLI	м	FIELD MEASUREMENT	CONC.	CONCRETE SLAB	Œ.	CENTER LINE
<b>=</b>	CATCH BASIN	D	DEED	ESMT	EASEMENT	R/W	RIGHT-OF-WAY
C.U.E.	COUNTY UTILITY EASEMENT	C	CALCULATED	D.E.	DRAINAGE EASEMENT	P.U.E.	PUBLIC UTILITY EASEMENT
LEJE.E.	INGRESS / EGRESS EASEMENT	L.M.E.	LAKE OR LANDSCAPE MAINTENANCE EASEMENT	LBE	LANDSCAPE BUFFER EASEMENT	C.M.E.	CANAL MAINTENANCE EASEMENT
U.E.	UTILITY EASEMENT	R.O.E.	ROOF OVERHANG EASEMENT	LAE	LIMITED ACCESS EASEMENT	AE	ANCHOR EASEMENT
EP	ELECTRIC POLE	CONC	CONCRETE	B.C.R.	BROWARD COUNTY RECORDS	ID	IDENTIFICATION
PG.	PAGE	CSW	CONCRETE SIDEWALK	EIR.	FOUND IRON PIN / REBAR	BC	BLOCK CORNER
P.B.	PLAT BOOK	L	CURVE LENGHT	WF	WOOD FENCE		

### **Property Address:**

1415 Madison Street Hollywood, FLORIDA 33020

### Flood Information:

Community Number: 125113 Panel Number: 12011C0569

Suffix: H Date of Firm Index: 08/18/2014

Flood Zone: AE

Base Flood Elevation: 7.0' Date of Field Work: 11/20/2023 Date of Completion: 12/06/2023

#### **General Notes:**

- 1.) The Legal Description used to perform this survey was supplied by others. This survey does not determine or is not to imply ownership 2.) This survey only shows above ground improvements. Underground utilities feetings or percentage are activated in the control of the con
- 2.) This survey only shows above ground improvements. Underground utilities, footings, or encroachments are not located on this survey map
  3.) The minimum relative distance accuracy for this type of Survey is 1 foot in 10,000 feet. The accuracy obtained by measurement and calculation of closed geometric figures was found to exceed this requirement. Well-identified features as depicted on the Survey Map were measure to an estimated horizontal positional accuracy of 1/10 foot.
  4.) If there is a septic tank, well, or drain field on this survey, the location of such items was shown to us by others and the information was not
- 5.) Examination of the abstract of title will have to be made to determine recorded instruments, if any, affect this property. The lands shown herein were not abstracted for easement or other recorded encumbrances not shown on the plat.
- Wall/fence ties shown are from the inside face of the wall/fence to the property line.
   Fence ownership is not determined.
- Bearings referenced to line noted B.R also are assumed.

- Bearings reterenced to line noted B.R also are assumed.
   Dimensions shown are platted and measured unless otherwise shown.
   No identification found on property corners unless noted.
   Not valid unless sealed with the signing surveyors embossed seal.
   Boundary survey means a drawing and/or graphic representation of the survey work performed in the field, could be drawn at a shown scale and/or not to scale.
   Elevations if shown are based upon NGVD 1929 unless otherwise noted.
   This is a BOUNDARY SURVEY unless otherwise noted.
   This request is explained for the parties to whom it is contified. The contifications do not extend.

- 14.) This is a BOUNDARY SURVEY unless otherwise noted.
  15.) This survey is exclusive for the use of the parties to whom it is certified. The certifications do not extend to any unnamed parties.
- 16.) This survey may be used for construction/permitting purposes

### Legal Description:

Lot 12 and 13, of Block 88, of HOLLYWOOD, according to the plat thereof, as recorded in Plat Book 1, Page 21, of the public records of Broward County, FLORIDA

### **Printing Instructions:**

While viewing the survey in any PDF Reader, select the File Drop-down and select "Print". Select a color printer, if available; or at least one with 8.5" x 14" (legal) paper.

Select ALL for Print Range, and the # of copies you would like to print out.

Under the "Page Scaling" please make sure you have selected "None"

Do not check the "Auto-rotate and Center" box.

Check the "Choose Paper size by PDF" checkbox, then click OK to print.

### Certified To:

## **PLA Holdings, LLC**

### Self

its successors and/or assigns as their interest may appear.

## Please copy below for policy preparation purposes only:

This policy does not insure against loss or damage by reason of the following exceptions: Any rights, easements, interests, or claims which may exist by reason of, or reflected by, the following facts shown on the survey prepared by

Miguel Espinosa , for M.E. Land Surveying, LLC., dated 12/06 <u>/2023</u> bearing Job # <u>B-134477</u>


a. PAVERS EXTEND BEYOND NORTH AND SOUTH PROPERTY LINES.



## M.E. Land Surveying, LLC

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1 = 1.0STREET PROFILE

SCHISM ARCHITECTURE + DESIGN

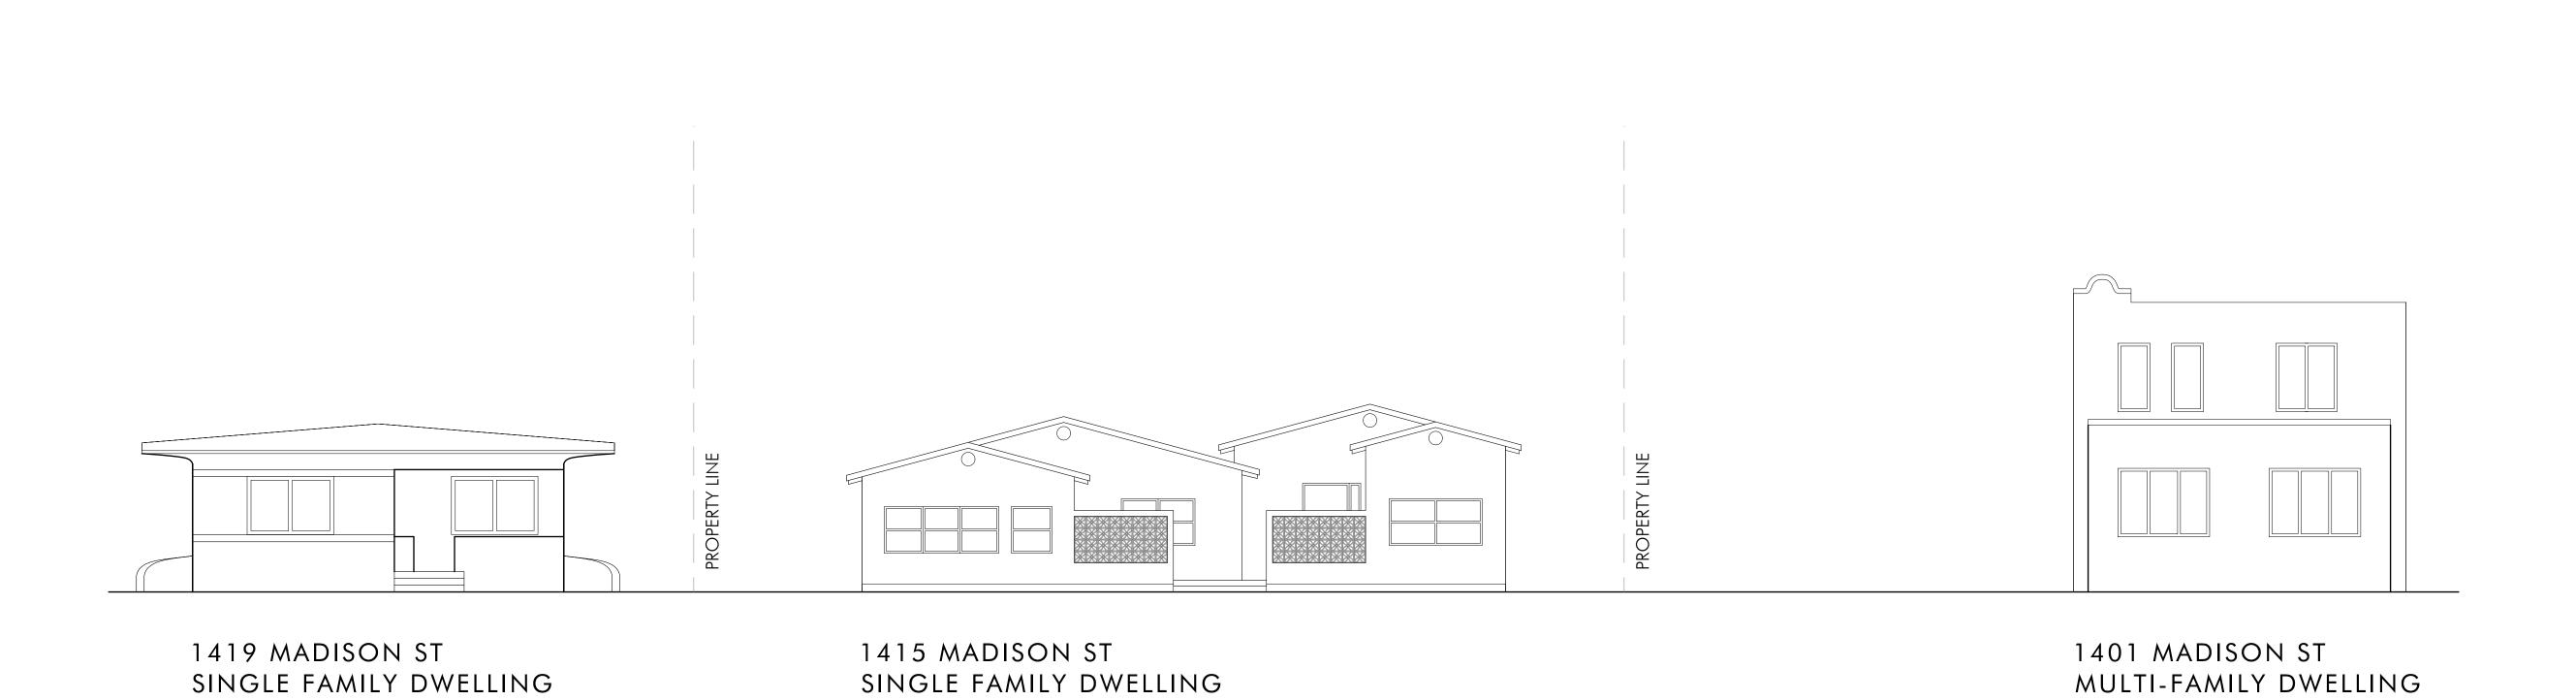SCHNEUR Z. MEYER, AIA
FL: AR101781

1622 NW 36TH ST, MIAMI FL 33142

1622 NW 36TH ST, MIAMI FL 3314 SAD-ARC.COM TEL (305) 761-2541

CHITECTURE + DESIGN

RENOVATION & ADDITION
1415 MADISON ST

PLEASE NOTE: THESE PLANS ARE FOR BUILDING DEPARTMENT REVIEW.
THEY ARE NOT TO BE CONSTRUED AS FINAL CONSTRUCTION
DOCUMENTS UNTIL ALL BUILDING DEPARTMENT APPROVALS ARE
OBTAINED AND COMMENTS ARE INCORPORATED INTO THESE DRAWINGS
DUE TO THE VARIATIONS IN INTERPRETATIONS OF THE CODE THAT
OCCUR IN DIFFERENT MUNICIPALITIES FINAL APPROVAL AND REVIEW IS
NEEDED TO ASSURE COMPLIANCE WITH THE APPLICABLE CODES AND
STANDARDS.

PLEASE NOTE: THIS DRAWING SET AND ITS SPECIFICATIONS NOTICE OF
ACCEPTANCES, PRODUCT AND EQUIPMENT BOOKS AND MANUALS, AND
SOIL REPORTS SHALL CONSTITUTE A SINGLE ENTITY NO PART OF THIS
ENTITY SHALL BE CONSIDERED WITHOUT THE OTHERS ANY
INFORMATION WITHIN THIS SET AND SPECIFICATION MUST BE
UNDERSTOOD AS PART OF THE WHOLE SET. IT IS THE RESPONSIBILITY OF
THE CONTRACTOR AND HIS SUB CONTRACTORS TO BE FAMILIAR WITH
ALL ASPECTS OF THE WORK DESCRIBED WITHIN THIS DRAWING SET. IT
ANY CONFLICTS ARISE AS WITHIN THE DESCRIPTION OF WORK IN THIS
DRAWING SET THE CONTRACTOR MUST NOTIFY THE OWNER AND
ARCHITECT PRIOR TO THE BEGINNING OF ANY BIDDING, WORK AND OR
PLIRCHASING

DRAWN BY: SZM DATE: 5/3/2024

REVISIONS:

DRAWING TITLE:

STREET PROFILE

PROJECT # 2307

DRAWING NO.

1415 MADISON ST - EXISTING PROPERTY



1414 MADISON ST - PROPERTY ACROSS THE STREET




1401 MADISON ST - ADJACENT PROPERTY EAST SIDE (EAST FACADE)



1419 MADISON ST - ADJACENT PROPERTY WEST SIDE



1425 MADISON ST - NEARBY PROPERTY

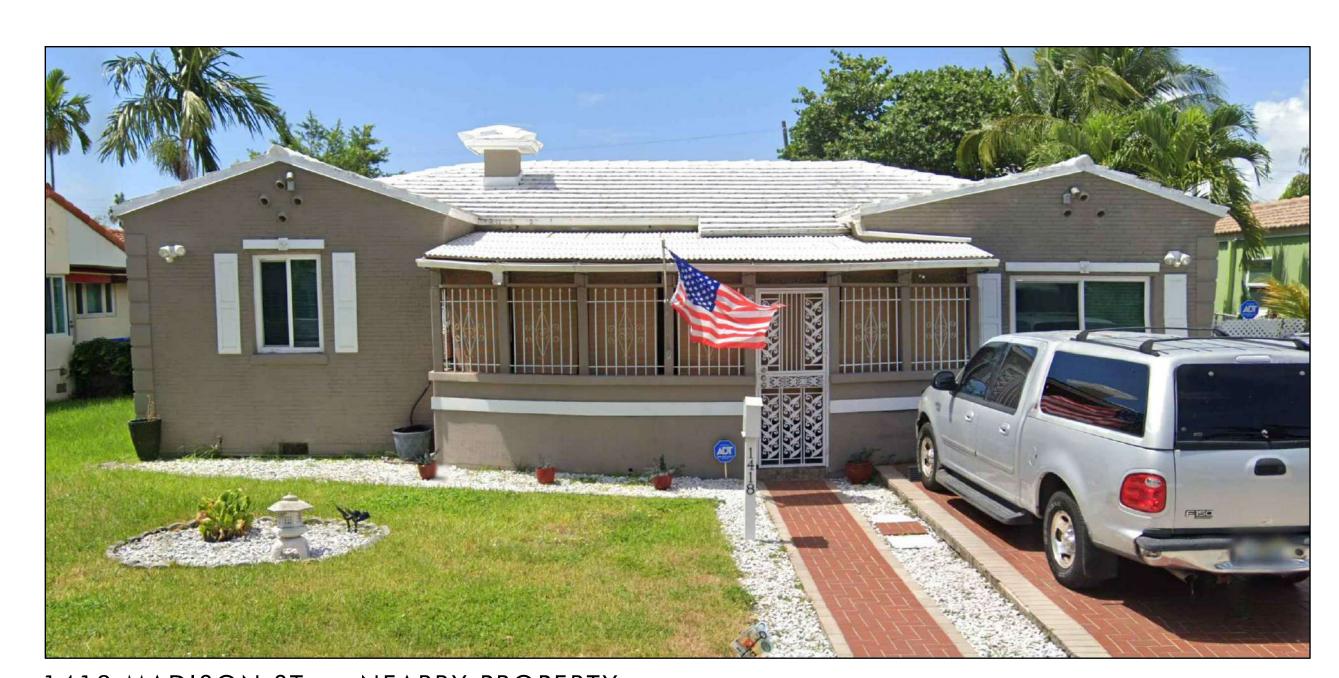

1418 MADISON ST - NEARBY PROPERTY

SCHISM ARCHITECTURE + DESIGN

SCHNEUR Z. MEYER, AIA

FL: AR101781

1622 NW 36TH ST, MIAMI FL 33142 SAD-ARC.COM

TEL (305) 761-2541

RCHITECTURE + DESIGN

RENOVATION 8 ADDITION

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DRAWN BY: SZM DATE: 5/3/2024


REVISIONS:

DRAWING TITLE:

ADJACENT PROPERTIES

PROJECT # 2307

DRAWING NO.

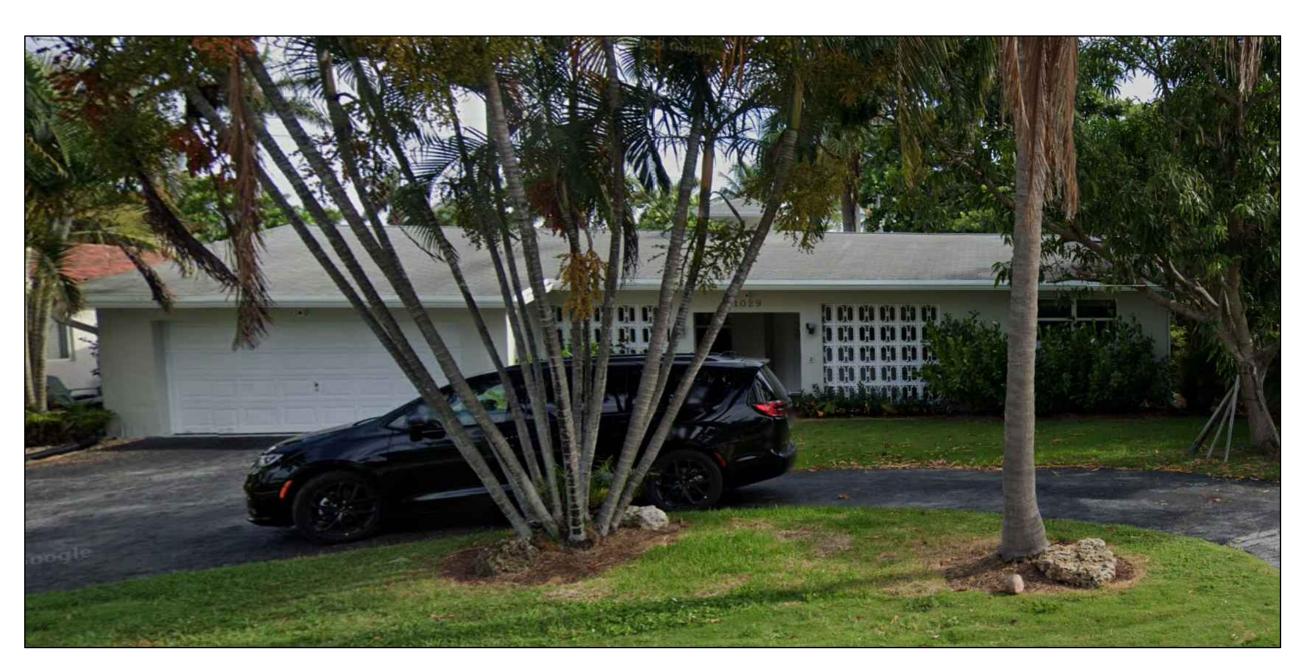

1029 WASHINGTON ST - NEARBY PROPERTY BUILT IN 1962



1447 MADISON ST - NEARBY PROPERTY BUILT IN 1950



800 TYLER ST - NEARBY PROPERTY BUILT IN 1956



1417 VAN BUREN ST - NEARBY PROPERTY BUILT IN 1952

REFERENCE HOMES BUILT WITHIN SIMILAR TIME PERIOD AND STYLE.

SCHISM ARCHITECTURE + DESIGN

SCHNEUR Z. MEYER, AIA
FL: AR101781

1622 NW 36TH ST, MIAMI FL 33142

1622 NW 36TH ST, MIAMI FL 3314 SAD-ARC.COM TEL (305) 761-2541

CHITECTURE + DESIGN

RENOVATION & ADDITION 1415 MADISON ST

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DRAWN BY: SZM DATE: 5/3/2024

REVISIONS:

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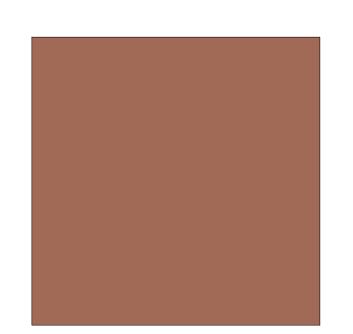
DRAWING NO.

H 1.03


**BOARD** 







EXISTING ROOF COLOR

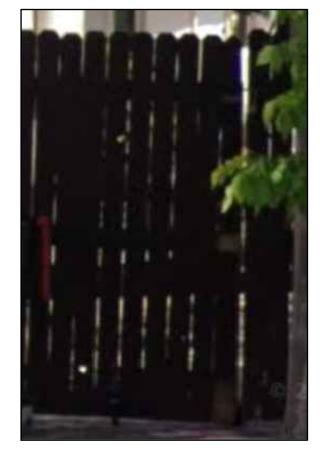

EXISTING FENCE



EXISTING LIGHTING FIXTURES TO MATCH




EXISTING WINDOW PROPOSED TO MATCH EXISTING




EXISTING HOUSE

COLOR

PROPOSED BREEZE BLOCK

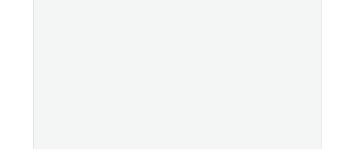

EXISTING WINDOW FRAME COLOR

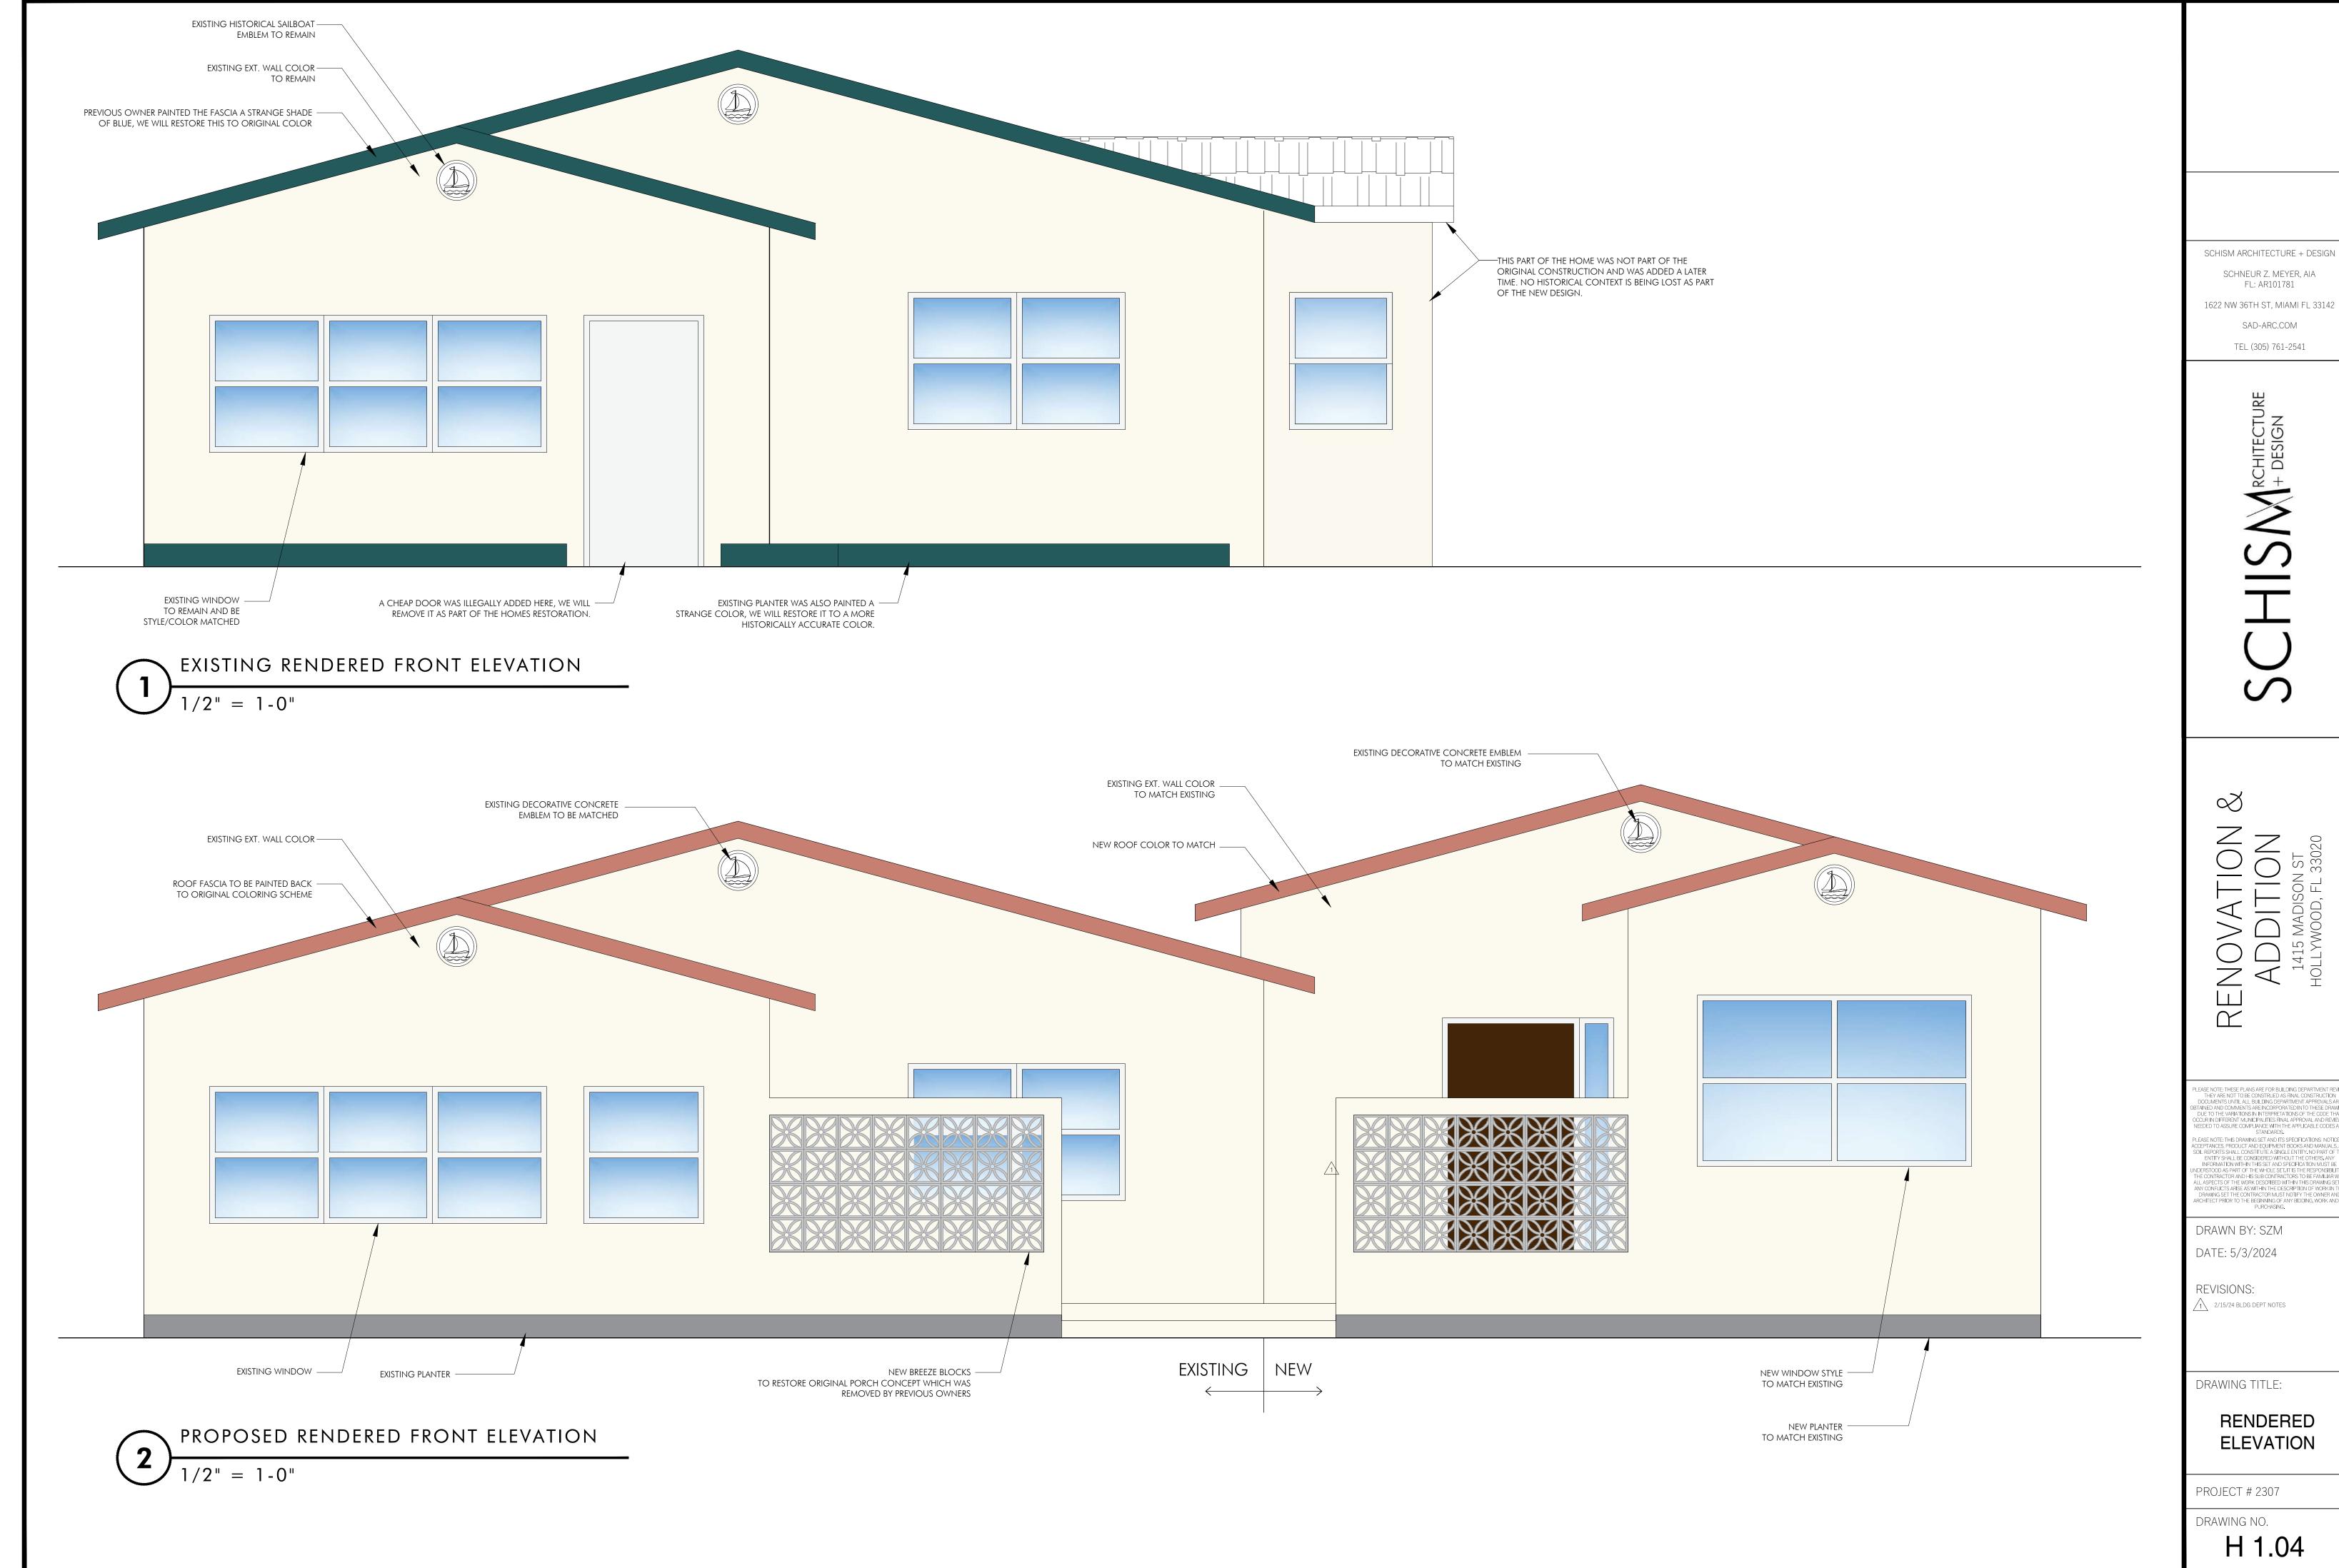

SCHNEUR Z. MEYER, AIA FL: AR101781

1622 NW 36TH ST, MIAMI FL 33142

SAD-ARC.COM

TEL (305) 761-2541

PROJECT # 2307

DRAWING NO.



PROPOSED RENDERED VIEW OF FRONT OF HOME



PROPOSED RENDERED VIEW OF FRONT OF HOME



PROPOSED RENDERED VIEW OF FRONT OF HOME

PERMIT SET: DECEMBER 05, 2023

REV1: FEBRUARY 15, 2024 REV1.5: MARCH 14, 2024

REV2: MAY 3, 2024

# RENOVATION & ADDITION

# 1415 MADISON ST, HOLLYWOOD, FL 33020

## **BUILDING INFORMATION:**

PROPERTY ADDRESS: 1415 MADISON STREET HOLLYWOOD, 33020

**PROPERTY ID:** 514215026400 **YEAR BUILT:** 1952 **LOT SIZE:** 10,916 SQ. FT. **FLOOD ZONE:** AE | 7.0 B.F.E

**ZONING:** RS-6 - SINGLE FAMILY DISTRICT

CONSTRUCTION TYPE: IIIB (CMU WALLS W/ WOOD TRUSS ROOF)

## **APPLICABLE CODES:**

- ALL DRAWINGS DONE IN ACCORDANCE WITH:
- FLORIDA BUILDING CODE 2020 (7th EDITION)
- FLORIDA FIRE PREVENTION CODE 2020 (7th EDITION)
  FLORIDA BUILDING RESIDENTIAL CODE 2020 (7th EDITION)

7. PARTIALLY CUT AND REMOVE EXISTING TRUSS AS NEEDED TO ACCOMMODATE FOR NEW ADDITION

- NATIONAL ELECTRICAL CODE (2017)

8. NEW CMU ADDITION TO EXISTING HOME

## **LEGAL DESCRIPTION:**

LOT 12 AND 13, OF BLOCK 88, OF HOLLYWOOD, ACCORDING TO THE PLAT THEREOF, AS RECORDED IN PLAT BOOK 1, PAGE 21, OF THE PUBLIC RECORDS OF BROWARD COUNTY, FLORIDA

## **SCOPE OF WORK:**

- DEMOLISH EXISTING UNSAFE OUT-OF CODE ADDITION IN THE REAR OF THE PROPERTY IN ITS ENTIRETY
- rebuild existing addition with flat roof joists. See Structural
- 3. NEW WINDOWS AND DOORS AS PER PLAN
- 4. INTERIOR RENOVATION AND MODIFICATION OF EXISTING BEDROOMS AND BATHROOMS
- GENERAL REMODEL OF INTERIOR SPACES INCLUDING CABINETRY, FLOORING, WALL FINISHES ETC...
- 4. NEW MECHANICAL, PLUMBING AND ELECTRICAL SYSTEMS AS SHOWN ON PLANS FOR NEW ADDITION
- AND RECONFIGURATION OF SPACES.
- PATCH, PAINT AND REPAIR EXISTING STUCCO AROUND HOME
- 6. REMOVAL OF CONCRETE SLABS AND NEW LANDSCAPING AROUND HOME.

THE SCOPE OF WORK DESCRIBED HERE IS INTENDED TO BE FOR GENERAL INFORMATION TO THE BUILDING DEPARTMENT AND CONTRACTOR. THE ENTIRE SCOPE OF WORK IS DESCRIBED IN THE FULL SET OF CONSTRUCTION DOCUMENTS INCLUDING ALL DRAWINGS AND SPECIFICATIONS.

## **ALTERATION LEVEL 2:**


DRAWINGS DONE IN ACORDANCE TO FLORIDA BUILDING CODE, EXISTING BUILDING 7TH EDITION (2020)

FBC EXISTING 603.1: "LEVEL 2 ALTERATIONS INCLUDE THE RECONFIGURATION OF SPACE, THE ADDITION OR ELIMINATION OF ANY DOOR OR WINDOW, THE RECONFIGURATION OF ANY SYSTEM OR THE INSTALLATION OF ANY ADDITIONAL EQUIPMENT"


## GENERAL NOTES:


- 1. GENERAL CONTRACTOR SHALL BE FAMILIAR WITH THE SITE & VERIFY ALL EXISTING UTILITY SERVICE LOCATIONS IN ALL AREAS INCLUDED IN THE SCOPE OF WORK PRIOR TO COMMENCING CONSTRUCTION.
- 2. ANY EXISTING ITEMS THAT ARE DISTURBED, DAMAGED OR REMOVED DURING CONSTRUCTION SHALL BE REPLACED WITH NEW OR REPAIRED TO THE OWNERS SATISFACTION AND LIKE NEW CONDITION.
- 3. DO NOT DISTURB ANY STRUCTURAL COMPONENTS OF EXISTING BUILDINGS WITHOUT PRIOR WRITTEN APPROVAL BY ARCHITECT.
   4. PROTECT ALL EXISTING UTILITIES FROM DAMAGE DURING ALL PHASES OF CONSTRUCTION. ANY UTILITIES ACCIDENTALLY DAMAGED DURING CONSTRUCTION SHALL BE REPLACED AT CONTRACTOR'S EXPENSE
- 4. PROTECT ALL EXISTING UTILITIES FROM DAMAGE DURING ALL PHASES OF CONSTRUCTION. ANY UTILITIES ACCIDENTALLY DAMAGED DURING CONSTRUCTION SHALL BE REPLACED AT CONTRACTOR'S EXPENSE
- 5. EACH CONTRACTOR SHALL USE ALL POSSIBLE CARE TO PROTECT ALL EXISTING MATERIALS, SURFACES, AND FURNISHINGS FROM DAMAGE DURING ALL PHASES OF CONSTRUCTION.
- 6. ALL UNANTICIPATED AND UNFORESEEN DEMOLITION AND OR NEW CONSTRUCTION CONDITIONS WHICH REQUIRE DEVIATION FROM THE PLANS AND NOTES HEREIN SHALL BE REPORTED TO THE ARCHITECT, IN WRITING, AND APPROVAL SOUGHT PRIOR TO COMMENCING SAID WORK PER CONTRACT.
- 7. ARCHITECT SHALL NOT BE LIABLE FOR PROBLEMS RELATING TO EXISTING CONDITIONS. NOTIFY ARCHITECT, IN WRITING, IMMEDIATELY IF PROBLEMS ARISE.
- 8. ALL NEW MATERIAL AND/OR PATCHWORK SHALL BE PROVIDED TO MATCH EXISTING MATERIALS AND/OR ADJOINING WORK WHERE PRACTICAL, EXCEPT AS SPECIFICALLY NOTED HEREIN.
- 9. G.C. IS TO THOROUGHLY REVIEW <u>ALL</u> DRAWINGS AND PROVIDE OVERVIEW TO ALL TRADES. ALL SUBCONTRACTORS ARE TO REVIEW <u>ALL</u> DRAWING SHEETS GENERAL CONTRACTOR TO PROVIDE COMPLETE SETS OF PLANS TO ALL SUBCONTRACTORS FOR REVIEW. ITEMS SHOWN ON ARCHITECTURAL DRAWINGS ARE REQUIRED TO BE COMPLETELY INSTALLED REGARDLESS IF THEY ARE NOT SPECIFICALLY DESIGNATED ON ELECTRICAL, MECHANICAL OR PLUMBING ENGINEERING DRAWINGS. GENERAL CONTRACTOR IS RESPONSIBLE FOR COORDINATING ALL REQUIRED ITEMS WITH ALL SUBCONTRACTORS AND THROUGHOUT ALL PHASES OF CONSTRUCTION.
- 10. ALL WORK SHALL BE DONE IN ACCORDANCE W/ ALL APPLICABLE NATIONAL, STATE, COUNTY & LOCAL CODES AND ORDINANCES. WORK SHALL BE DONE IN A WORKMANLIKE MANNER AS PER STANDARD BUILDING TECHNIQUES AND PRACTICES.
- 11. G.C. IS RESPONSIBLE TO FILE AND OBTAIN THE BUILDING DEPARTMENT PERMIT.
- 12. G.C. IS RESPONSIBLE FOR ALL SAFETY CONDITIONS PER OSHA AND ALL STATE AND LOCAL REGULATIONS RELATING TO JOB CONSTRUCTION.
- 13. G.C. IS TO VISIT THE SITE AND CAREFULLY INSPECT THE EXISTING CONDITIONS AFFECTING THE WORK. ANY DISCREPANCIES BETWEEN THE DRAWINGS AND EXISTING CONDITIONS MUST BE REPORTED TO ARCHITECT IN WRITING.
- 14. THE GENERAL CONTRACTOR IS RESPONSIBLE TO COORDINATE THE PROPER SUBMISSION OF SPECIALTY SHOP DRAWINGS. ALL SPECIALTY PRODUCTS SHALL BE DESIGNED FOR THE APPROPRIATE GRAVITY LOADS, WIND LOADS, AND LATERAL LOADS, AND SHALL INCLUDE, BUT ARE NOT LIMITED TO LIGHT GUAGE METAL FRAMING, HANDRAILS AND SAFETY RAILS, MISCELLANEOUS METALS AND HANGERS.

#### **DRAWING INDEX:** LANDSCAPE A302 SECTIONS MECHANICAL, ELECTRICAL + PLUMBING: A303 SECTIONS A304 SECTIONS G100 COVER PAGE L1 LANDSCAPE PLAN + NOTES R100 REFLECTED CEILING PLAN V100 SURVEY L2 IRRIGATION PLAN A305 SECTIONS M100 MECHANICAL NOTES + DETAILS A001 GENERAL NOTES + FINISH NOTES A501 INTERIOR DETAILS M101 MECHANICAL PLAN A502 EXTERIOR DETAILS A100 SITE PLAN + ZONING INFO A503 ROOF DETAILS E100 ELECTRICAL PLAN + DETAILS A100B SITE PLAN NOTES AND DETAILS E101 ELECTRICAL POWER PLAN A101 EXISTING FLOOR PLAN A801 DOOR SCHEDULE H101 ADJACENT PROPERTIES A102 DEMOLITION FLOOR PLAN A802 WINDOW SCHEDULE P100 SANITARY PLUMBING PLAN H102 ADJACENT PROPERTIES A103 PROPOSED FLOOR PLAN P101 DOMESTIC WATER PLAN H103 MATERIAL BOARD A104 EXISTING/DEMOLITION ROOF PLAN H104 RENDERED ELEVATIONS A105 NEW ROOF PLAN U100 UTILITIES SITE PLAN H105 RENDERED IMAGES S-1 FOUNDATION PLAN A200 EXISTING/PROPOSED WEST ELEVATION A201 EXISTING/PROPOSED SOUTH ELEVATION ROOF FRAMING PLAN S-3 SECTIONS + DETAILS A202 EXISTING/PROPOSED EAST ELEVATION EROSION & SEDIMENT CONTROL PLAN S-4 SECTIONS + DETAILS PAVING, DRAINAGE & GRADING PLAN A203 EXISTING/PROPOSED NORTH ELEVATION S-5 SECTIONS + DETAILS A301 SECTIONS S-6 SECTIONS + DETAILS

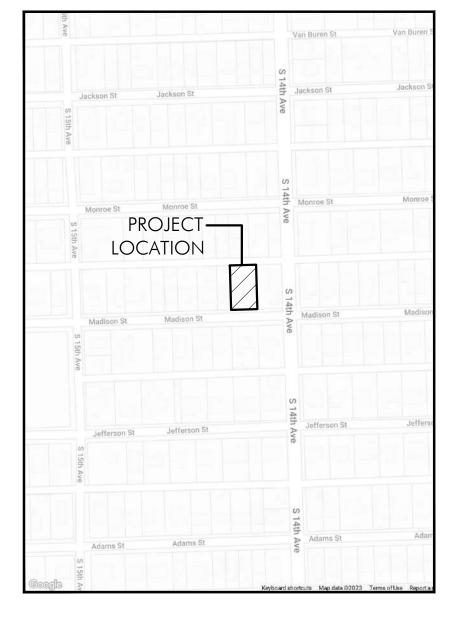



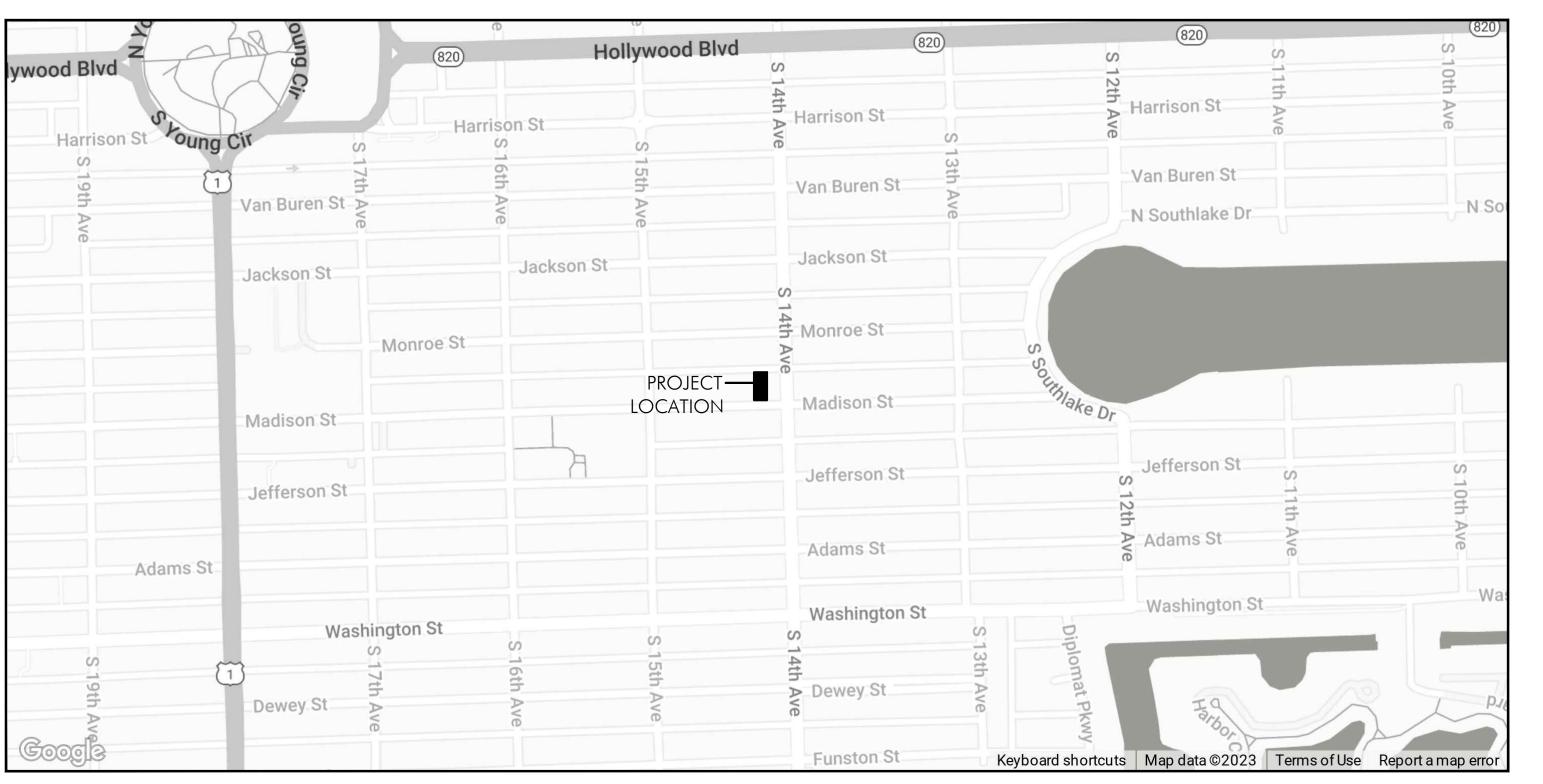

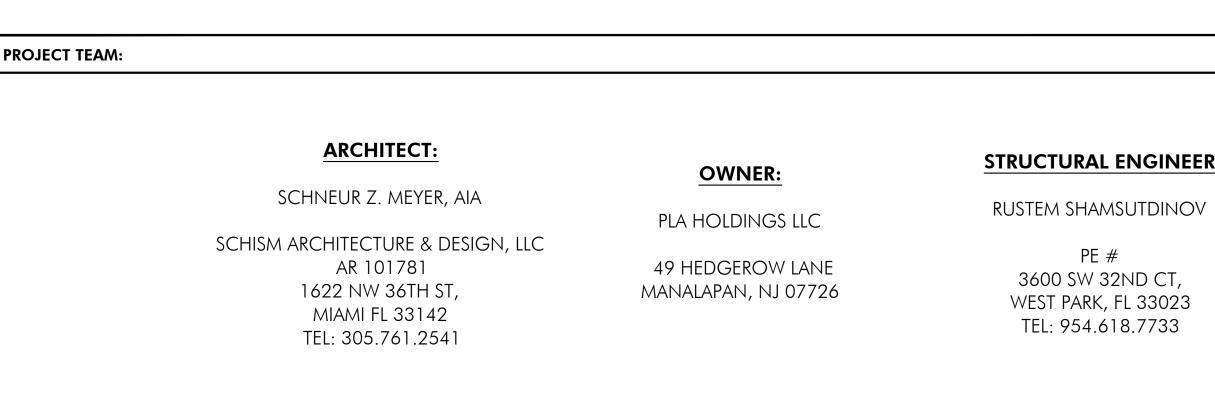

SCHISM ARCHITECTURE + DESIGN

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KENOVALION & ADDITION 1415 Madison St

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DRAWN BY: SZM
DATE: 5/3/2024

REVISIONS:

2/15/24 BLDG DEPT COMMENTS

5/3/24 BLDG DEPT COMMENTS

DRAWING TITLE:

COVER

PROJECT # 2307

DRAWING NO.

G 1.00

## **GENERAL NOTES**

1. ALL WORK SHALL BE IN ACCORDANCE WITH THE REQUIREMENTS OF THE FLORIDA BUILDING CODE, 2020 EDITION, AND THE ZONING REQUIREMENTS OF BROWARD COUNTY, FLORIDA AND OTHER APPLICABLE MUNICIPAL REQUIREMENTS, AND THE BASE BUILDING SPECIFICATIONS.

2. BEFORE PERFORMING ANY WORK OR ORDERING ANY MATERIALS, THE CONTRACTOR SHALL VERIFY ALL DIMENSIONS AND CONDITIONS OF ANY EXISTING AND NEW WORK AND SHALL BE RESPONSIBLE FOR THEIR ACCURACY. ANY DIFFERENCES FOUND SHALL BE SUBMITTED TO THE OWNER AND ARCHITECT OR ENGINEER FOR VERIFICATION BEFORE PROCEEDING WITH WORK. ANY DISCREPANCY IN DIMENSIONS OR SPECIAL MODIFICATIONS REQUIRED DUE TO FIELD CONDITIONS SHALL BE REPORTED IN WRITING TO THE ARCHITECT FOR CLARIFICATION, OR APPROVAL OR MODIFICATION BEFORE COMMENCING WORK. THE RESPONSIBILITY FOR ANY CHANGES MADE IN THE FIELD WITHOUT PRIOR NOTIFICATIONS TO THE ARCHITECT SHALL REST WITH THE CONTRACTOR OR ANY OTHER PERSON APPROVING SUCH CHANGE.

3. THE ARCHITECT SHALL NOT BE RESPONSIBLE FOR ANY DEVIATIONS FROM THESE DRAWINGS AS DATED ON THIS SHEET.

4. THE AIA GENERAL CONDITIONS, THE SUPPLEMENTARY GENERAL CONDITIONS, AND GENERAL REQUIREMENTS SHALL BE CONSIDERED AN INCLUSIVE PART OF THESE SPECIFICATIONS AND OR DRAWINGS. ALL SUBCONTRACTORS, AS WELL AS THE GENERAL CONTRACTOR, SHALL BE GOVERNED BY ALL APPLICABLE SECTIONS OF THESE DOCUMENTS WITH REFERENCE TO THEIR RESPECTIVE AREAS OF WORK. IT SHALL BE THE RESPONSIBILITY OF THE GENERAL CONTRACTOR TO ADVISE HIS SUBCONTRACTORS AND SUPPLIERS OF THESE REQUIREMENTS.

5. THE GENERAL CONTRACTOR SHALL BE HELD TO HAVE EXAMINED THE SITE WITH RESPECT TO ALL EXISTING FIELD CONDITIONS AND TO HAVE FULLY EXAMINED THE COMPLETE SET OF ARCHITECTURAL DRAWINGS AS PREPARED BY OTHERS, AND SHALL BE RESPONSIBLE FOR THE COORDINATION AND EXECUTION OF THIS DRAWING SET, AS IS INCLUDED AS PART OF THE ORIGINAL DRAWINGS PACKAGE.

6. THE GENERAL CONTRACTOR SHALL LOCATE ALL GENERAL REFERENCE POINTS AND TAKE ORDINARY PRECAUTIONS TO PREVENT THEIR DISRUPTION. EACH PRIME SUBCONTRACTOR SHALL BE RESPONSIBLE FOR ALL LINES, ELEVATIONS, MEASUREMENTS AND OTHERS AS MAY BE REQUIRED OF AND FOR HIS WORK. HE SHALL BE RESPONSIBLE FOR VERIFYING ALL FIGURES AND DETAILS SHOWN ON THE DRAWINGS, WHICH RELATE TO HIS WORK, PRIOR TO LAYING OUT THE WORK. HE SHALL BE HELD RESPONSIBLE FOR ANY ERROR RESULTING FROM HIS FAILURE TO TAKE SUCH PRECAUTIONS.

7. DIVISIONS OF THE WORK FOR SUBCONTRACTING PURPOSES SHALL BE AS PER THE GENERAL CONTRACTOR'S

8. IT SHALL BE THE RESPONSIBILITY OF ALL THE SUBCONTRACTORS TO HAVE EXAMINED AND REVIEWED THE COMPLETE SET OF WORKING DRAWINGS AND/OR SPECIFICATIONS AND TO PROVIDE ALL LABOR AND MATERIAL FOR THEIR RESPECTIVE AREA TO WORK FOR A COMPLETE AND FINISHED INSTALLATION IN COMPLIANCE WITH THE INTENT OF THE DRAWING AND/OR SPECIFICATIONS, WHETHER IT IS INDICATED OR NOT. ALL WORK WHETHER INDICATED OR NOT, SHALL BE IN COMPLIANCE WITH ALL BUILDING CODES AND ORDINANCES WHICH ARE APPLICABLE TO THE PROJECT.

9. SUBCONTRACTORS SHALL COOPERATE WITH EACH OTHER AND WITH THE GENERAL CONTRACTOR TO PROVIDE MATERIAL AND LABOR THAT ARE NECESSARY IN EACH OTHER'S WORK AT THE PROPER TIMES SO THAT THE CONSTRUCTION SCHEDULE IS NOT AFFECTED. THIS INTERFACING SHALL BE THE RESPONSIBILITY OF THE SUBCONTRACTORS WHOSE WORK IS AFFECTED AS SUCH.

10. ALL WORK SHALL BE PERFORMED BY QUALIFIED CONTRACTORS IN STRICT ACCORDANCE WITH MANUFACTURER'S SPECIFICATIONS.

11. PRODUCT MANUFACTURERS INDICATED IN SCHEDULE AND OR PLANS WERE SELECTED BASED ON QUALITY, STYLE, SIZE, COLOR, ETC, AND ARE NOT INTENDED TO RESTRICT COMPETITIVE BIDDING. PRODUCTS "EQUAL TO" INTENDED TO BE USED AS SUBSTITUTES ARE SUBJECT TO THE ARCHITECT'S APPROVAL IN WRITING PRIOR TO PRODUCT INSTALLATION

12. THIS DRAWING PACKAGE IS BASED ON DOCUMENTS, SPECIFICATIONS AND RELATED INFORMATION PROVIDED BY OWNER/TENANT AND/OR OWNER/TENANT'S AGENT.

13. THE DESIGN INFORMATION INDICATED ON PLANS IS INTENDED TO BE A COMPLETE AND WORKABLE SYSTEM IN ACCORDANCE WITH ALL PRODUCT MANUFACTURER'S SPECIFICATIONS, EXISTING AND/OR PROPOSED, BUILDING DESIGN, FIELD CONDITIONS, ETC. ALL MISCELLANEOUS MATERIALS, PARTS, DESIGN DIMENSIONS, WHETHER INDICATED ON PLANS OR NOT, SHALL BE INCLUDED AS PART OF THIS DRAWING PACKAGE.

14. ARCHITECT SHALL BE NOTIFIED PRIOR TO STARTUP OF CONSTRUCTION, SHOULD EXISTING FIELD CONDITIONS VARY FROM DRAWINGS BY GREATER THAN 2".

15. THE EXACT LOCATION OF ALL UNDERGROUND UTILITIES MUST BE VERIFIED PRIOR TO CONSTRUCTION SO THAT NO INTERFERENCE BY DISRUPTION WILL BE CAUSED.

16. ALL FINAL SURFACE GRADING SHALL BE COMPLETED TO FACILITATE POSITIVE DRAINAGE AWAY FROM THE BUILDING

AND ITS NEIGHBORING PROPERTIES.

17. THE GENERAL CONTRACTOR OR SUBCONTRACTOR SHALL BE HELD RESPONSIBLE FOR THE REMOVAL AND DISPOSAL OF ALL MATERIALS AND ITEMS COMMONLY REFERRED TO AS "DEBRIS" OR DETERMINED BY THE ARCHITECT AS REFUSE.

18. THE GENERAL CONTRACTOR SHALL HAVE HAD MADE ALL REQUIRED PROVISIONS FOR THE REMOVAL OF DEBRIS FROM THE SITE; HAVING CHARGES, DUMPING FEES, ETC..., IN HIS ORIGINAL BID SUBMISSION.

19. REMOVE ANY OTHER ITEM OR CONSTRUCTION AS REQUIRED TO ACCOMPLISH ALL NEW WORK AND/OR REVISION

WORK TO EXISTING AREAS AS SHOWN OR DESCRIBED ELSEWHERE IN THE CONTRACT DOCUMENTS.

20. THE GENERAL CONTRACTOR SHALL PROVIDE AND INSTALL SIGNAGE, BARRICADES, FENCING, LIGHTING, ETC. AS

REQUIRED FOR THE PREVENTION OF PERSONAL INJURIES TO THE OWNERS, ITS EMPLOYEES, REPRESENTATIVES, CLIENTELE, OR OTHERS WITHIN THE AREAS OF CONSTRUCTION.

21. PROTECTIVE DEVICES TO BE INSTALLED SHALL COMPLY WITH THE REQUIREMENTS OF ALL LOCAL, STATE AND NATIONAL GOVERNING CODES, THE BUILDING OWNER GUIDELINES, AND OTHER GOVERNING FORMS OF AUTHORITY. THE GENERAL CONTRACTOR SHALL TAKE ORDINARY PRECAUTIONS TO PREVENT THEIR DISRUPTION DURING THE COURSE OF WORK.

22. GENERAL CONTRACTOR SHALL TAKE ORDINARY PRECAUTIONS TO SECURE AND PROTECT MATERIALS TO BE RELOCATED OR WAREHOUSED.

23. PRIOR TO THE START OF ANY WORK, THE CONTRACTOR SHALL SECURE ALL PERMITS, LICENSES, UTILITY CONNECTION CONFIRMATIONS, GOVERNMENTAL APPROVALS, ETC., NECESSARY FOR FULL COMPLETION OF THE PROJECT

24. SEE FINISH SCHEDULE FOR STUCCO NOTES

25. SEE FINISH SCHEDULE FOR PAINT NOTES

26. GENERAL CONTRACTOR SHALL PROVIDE ALL OF THE REQUIRED METAL FRAMING, WOOD BLOCKING AND PLYWOOD BACKING NECESSARY BETWEEN CONCRETE SLABS, ROOF TRUSSES, CONCRETE BLOCK OR METAL PARTITIONS FOR THE SUPPORT OF ALL EQUIPMENT, SUSPENDED LIGHT FIXTURES, DEMISING WALLS, LIGHT TRACTS, VALANCES, PLUMBING (FIXTURES AND ACCESSORIES FOR EXACT LOCATION COORDINATE WITH OWNER ARCHITECT).

27. ANY SUBCONTRACTOR CUTTING INTO WORK ALREADY COMPLETED SUCH AS CUTTING CHASES AND OR TRENCHES FOR THE INSTALLATION OF HIS WORK AND EQUIPMENT IN THE BUILDING SHALL DO OR PAY FOR ALL BACK FILLING, REPARATION OR WALLS, FLOORS ETC OR DAMAGE BY SUCH SUBCONTRACTOR. ALL REPAIRS SHALL MATCH EXISTING SURFACES.

28. SEE DOOR SCHEDULE FOR CAULKING AND SEALANTS NOTES

29. PROVIDE A PROTECTIVE BOARD OVER ALL WATERPROOFING MEMBRANE AT ALL WALLS AND CONCRETE SLABS EXPOSED TO EARTH.

30. GENERAL CONTRACTOR SHALL PROTECT EXISTING FACILITIES, STRUCTURES AND UTILITIES. THEY MUST BE VERIFIED AS TO THEIR EXACT LOCATIONS SO THAT NO INTERFERENCE BY DISRUPTION WILL BE CAUSED. DAMAGED THAT MAY BE CAUSED BY THE CONTRACTOR OR SUBCONTRACTORS TO ANY OF THE ABOVE MENTIONED SHALL BE REPAIRED BY HIM AND LEFT IN AS GOOD CONDITION AS THE EXISTING PRIOR TO DAMAGING.

32. SEE WALL SCHEDULE FOR GYPSUM DRYWALL NOTES.

33. PROVIDE GALVANIC INSULATION BETWEEN ALL DISSIMILAR METALS.

34. THE GENERAL CONTRACTOR SHALL FILL WITH CONCRETE ALL OF THE BROKEN CONCRETE BLOCK CELLS AT ALL INTERIOR AND EXTERIOR MASONRY WALLS CAUSED BY ANY OF THE GENERAL CONTRACTOR'S OR SUB CONTRACTOR'S WORKERS DURING THE INSTALLATION OF PLUMBING, ELECTRICAL, AIR CONDITIONING OR MECHANICAL PIPES SLEEVES, CONDUITS, BOXES, EQUIPMENT AND/OR ACCESSORIES DURING THE CONSTRUCTION OF THIS PROJECT.

## PLEASE NOTE:

THIS DRAWING SET AND ITS SPECIFICATIONS NOTICE OF ACCEPTANCES, PRODUCT AND EQUIPMENT BOOKS AND MANUALS, AND SOIL REPORTS SHALL CONSTITUTE A SINGLE ENTITY. NO PART OF THIS ENTITY

SHALL BE CONSIDERED WITHOUT THE OTHERS.

NO DRAWING IN THIS SET OR SPECIFICATION MAY BE CONSIDERED ON ITS OWN. ANY INFORMATION WITHIN THIS SET AND SPECIFICATION MUST BE UNDERSTOOD AS PART OF THE WHOLE SET. IT IS THE RESPONSIBILITY OF THE CONTRACTOR AND HIS SUB CONTRACTORS TO BE FAMILIAR WITH ALL ASPECTS OF THE WORK DESCRIBED WITHIN THIS DRAWING SET. IF ANY CONFLICTS ARISE AS WITHIN THE DESCRIPTION OF WORK IN THIS DRAWING SET THE CONTRACTOR MUST NOTIFY THE OWNER AND ARCHITECT PRIOR TO THE BEGINNING OF ANY BIDDING, WORK AND OR PURCHASING.

35. ALL OF THE ITEMS BELOW SHALL HAVE PRODUCT CONTROL APPROVAL AND/OR SEPARATE BUILDING PERMIT FOR EACH ITEM (WHEN APPLICABLE) IN COMPLIANCE WITH THE FLORIDA BUILDING CODE. ALL MANUFACTURERS AND/OR SUPPLIERS SHALL ENGINEERED SUBMIT SHOP DRAWINGS TO THE ARCHITECT FOR REVIEW PRIOR TO FABRICATION.

1. ANCHORS 21. DOORS 2. AWNINGS/SUN SHADES 22. STEEL JOISTS 23. WOOD CONNECTORS 4. CANOPIES 24. PREFABRICATED FENCES 5. COOLERS AND FREEZERS 25. ROOFING, VENTILATORS, TURBINES, VENTS 7. GARAGE DOORS 8. GLASS BLOCKS 26. SCREEN ENCLOSURES 9. INSULATION (NON-ROOFING) 27. SCREEN ROOM AND WIND BREAKERS 10. METAL AND SANDWICH PANELS 28. SHEDS & MANUFACTURED BUILDINGS 11. METAL ROOF SYSTEMS 29. SHUTTERS 12. NAIL & WOOD FASTENERS 30. SKYLIGHTS SUCH 13. PASS THROUGH DEVICES 31. SOLAR HEATERS 32. SOLAR PHOTOVOLTAIC ARRAYS 14. PASSAGE DOORS 15. PLASTICS 33. SPAS (EXTERIOR) 16. PLASTIC PLUMBING FIXTURES 34. TRUSS PLATES 17. PLUMBING MATERIAL 35. VENEERED LUMBER APPLIANCES, POOL CHLORINATORS, 36. VINYL SIDING AND SOFFIT GLASS & ELECTRICAL POOL HEATERS 37. WINDOWS 18. PREFABRICATED BEAMS 38. WOOD TRUSSES 19. PREFABRICATED POOLS 39. SIGNS 20. PREFABRICATED RAILINGS

36. THE CONTRACTOR IS RESPONSIBLE FOR CONTACTING ANY GOVERNMENTAL AGENCIES NECESSARY IN ORDER TO ESTABLISH ANY UTILITY EASEMENTS OR LINES PRESENT WITHIN THE PROPERTY PRIOR TO PERFORMING ANY WORK.

37. WINDOW AND DOOR MANUFACTURER TO VERIFY ALL OPENINGS AT FIELD PRIOR TO WINDOW PLACEMENT.

38. CONTRACTOR TO OBTAIN THE LATEST SET OF DRAWINGS INCLUDING ANY REVISIONS BEFORE COMMENCING WORK. NO CHANGES OR SUBSTITUTIONS SHALL BE MADE WITHOUT THE WRITTEN PERMISSION OF THE OWNER AND ARCHITECT OR ENGINEER.

39. THE ARCHITECT IS NOT RESPONSIBLE FOR THE MISINTERPRETATIONS OF THESE PLANS BY OTHERS, THE REVIEW AND APPROVAL OF SHOP DRAWINGS PRODUCT CONTROL APPROVAL BY OTHERS.

40. THE CONTRACTOR SHALL MAINTAIN AN ACCURATE RECORD OF CHANGE REVISIONS, ORDERS AND VARIATIONS THROUGHOUT THE PROGRESS OF WORK. THE CONTRACTOR SHALL USE ONE SET OF DOCUMENTS EXCLUSIVELY FOR THIS JOR

41. THE CONTRACTOR SHALL DELIVER AND ANNOTATED JOB RECORD SET TO THE OWNER UPON COMPLETION OF WORK AS A CONDITION OF ACCEPTANCE.

42. THE CONTRACTOR IS SOLELY RESPONSIBLE FOR THE MEANS AND METHODS OF CONSTRUCTION AND FOR THE SEQUENCES AND PROCEDURES USED.

43. THE CONTRACTOR SHALL PRODUCE BY MEANS OF SHOP DRAWINGS, ALL ADDITIONAL DETAILS WHICH ARE INFERABLE FROM THESE PLANS AND WHICH ARE NECESSARY FOR THE EXECUTION AND COMPLETION OF THE CONSTRUCTION.

44. THE GENERAL CONTRACTOR SHALL BE RESPONSIBLE FOR ALL WORK EITHER IMPLIED OR REASONABLE INFERRED FROM THE CONTRACT DOCUMENTS, DRAWINGS AND SPECIFICATIONS.

45. DRAWINGS SHOWN ARE BASED ON MEASUREMENTS TAKEN DURING SITE VISITS DURING JUNE 2023 AND EXISTING DRAWINGS AS PROVIDED BY OWNER, AS THE HOME IS ALMOST 70 YEARS OLD, NORMAL STRUCTURAL SETTLING AND WEAR TO DRYWALL MAY MAKE SOME WALLS UNEVEN, ALL DIMENSIONS SHOULD BE FIELD VERIFIED BEFORE INSTALLATION OF NEW EQUIPMENT.

## **ABBREVIATIONS**

- JOINT

- KIP(s)

(STAIRS & BALCONIES)

∖B	- ANCHOR BOLT	KIP(s)	- 1000 POUNDS
ALT	- ALTERNATE	KLF	- KIPS PER LINEAR FOOT
\PPROX	- APPROXIMATELY	KJ	- CONSTRUCTION JOINT
\RCH	- ARCHITECT	L	- ANGLE
\RCH'L	- ARCHITECTURAL	LG	- LONG
3/	- BOTTOM OF	LLH	- LONG LEG HORIZONTAL
	- BOTTOM CHORD	LLV	- LONG LEG VERTICAL
BLDG	- BUILDING	LP	- LOW POINT
BM	- BEAM	LW	- LONG WAY
BOTT	- BOTTOM	MFR	- MANUFACTURER
	- BEARING	MAS	- MASONRY
	- CENTER TO CENTER	MO	- MASONRY OPENING
	- CAST IN PLACE	MAT'L	- MATERIAL
	- CONTRACTION JOINT	MAX	- MAXIMUM
	- CENTERLINE	MECH'L	- MECHANICAL
	- CLEAR	MTL	- METAL
CMU	- CONCRETE MASONRY UNIT	MIN	- MINIMUM
COL	- COLUMN - CONCRETE	MISC NS	- MISCELLANEOUS - NEAR SIDE
CONFIG	- CONFIGURATION	NIC	- NOT IN CONTRACT
CONT	- CONTINUOUS	NTS	- NOT TO SCALE
	- CONTRACTOR	OC	- ON CENTER
	- CENTER	OH	- OPPOSITE HAND
	- DOUBLE	OPNG	- OPENING
DET	- DETAIL	PAF	- POWDER ACTUATED FASTENERS
DIA	- DIAMETER	PART	- PARTITION
DIM	- DIMENSION	PART'L	- PARTIAL
	- DOWN	PCJ	- PRECAST CONCRETE JOIST
DR.	- DOOR/DRAIN	PL	- PLATE
	- DRAWING	PLF	- POUNDS PER LINEAR FOOT
	- EACH	PSF	- POUNDS PER SQUARE FOOT
	- EACH END	PSI	- POUNDS PER SQUARE INCH
F	- EACH FACE	PT	- POST TENSIONED/PRESSURE TREATED
:J	- EXPANSION JOINT	R	- RISER/RADIUS
L	- ELEVATION	REG	- REGULAR
	- ELEVATION/ELEVATOR	REINF	- REINFORCING
	- ENGINEER	REM	- REMAINDER
	- ENGINEER OF RECORD	req'd	- REQUIRED
	- EDGE OF SLAB	REV	- REVISED/REVISION
iQ	- EQUAL	RM	- ROOM
W	- EACH WAY	RO	- ROUGH OPENING
XIST	- EXISTING	RQMTS	- REQUIREMENTS
XP :v=	- EXPANSION	SCHED SECT	- SCHEDULE - SECTION
EXT FIN	- EXTERIOR - FINISH	SIM	- SIMILAR
ELR	- FLOOR	SL	- SLOPE
ND	- FOUNDATION	SOG	- SLAB-ON-GRADE
OM	- FACE OF MASONRY	SP	- SPIRAL
:5	- FAR SIDE	SQ	- SQUARE
T	- FOOT	SS	- STAINLESS STEEL
TG	- FOOTING	STD	- STANDARD
ЭΑ	- GAGE	STL	- STEEL
<b>GALV</b>	- GALVANIZED	STRUCT'L	- STRUCTURAL
ЭC	- GENERAL CONTRACTOR	SW	- SHEARWALL/SHORT WAY
<b>Э</b> T	- GIRDER TRUSS	T/	- TOP OF
HC .	- HOLLOW CORE	TB	- TIE BEAM
HCP	- HOLLOW CORE PLANK	TC	- TIE COLUMN/TOP CHORD
HDG	- HOT DIPPED GALVANIZED	TEMP	- TEMPERATURE
<del>I</del> G	- HIP GIRDER	TJ	- TIE JOIST
łΚ	- HOOK	T/O	- THRU OUT
HORIZ	- HORIZONTAL	TR	- TREAD/TRUSS
HP	- HIGH POINT	TYP	- TYPICAL
15	- HIGH STRENGTH	UNO	- UNLESS NOTED OTHERWISE
iss .	- HOLLOW STRUCT'L SECTION	VERT	- VERTICAL
J	- ISOLATION JOINT	W/	- WITH
NFO NT	- INFORMATION	W/O	- WITHOUT
NT DD	- INTERIOR	WD WB	- WOOD
RR D	- IRREGULAR	WP WWF	- WORK POINT - WELDED WIRE FABRIC
R	- JAMB REINFORCING	V V V I	- WELDED WINE I ADRIC

## FINISH NOTES:

## FINISH CARPENTRY SECTION 06200

PROVIDE MISCELLANEOUS FINISH CARPENTRY ITEMS AS SHOWN ON THE DRAWINGS.

INSTALLATION: INSTALL WORK PLUMB, LEVEL, TRUE AND STRAIGHT WITH NO DISTORTIONS. SHIM AS REQUIRED USING CONCEALED SHIMS. SCRIBE AND CUT TO FIT ADJOINING WORK. INSTALL WITH MINIMUM NUMBER OF JOINTS POSSIBLE, USING FULL-LENGTH PIECES TO THE GREATEST EXTENT POSSIBLE. COPE AT RETURNS, MITER AT CORNERS, AND USE SCARF JOINTS FOR END -TO-END JOINTS TO PROVIDE TIGHT FITTING JOINTS WITH FULL SURFACE CONTACT THROUGHOUT LENGTH OF JOINT.

ANCHOR TO BLOCKING OR DIRECTLY TO SUBSTRATE WITH COUNTERSUNK, CONCEALED FASTENERS AND BLIND NAILING WHERE POSSIBLE. ANCHOR COUNTERTOPS SECURELY TO SUPPORT SYSTEMS AS INDICATED. AT DRYWALL PARTITIONS, WHERE BLOCKING DOES NOT EXIT, USE ADHESIVE AND PER-

DRILLED COUNTERSUNK TRIM-HEAD SHEET METAL SCREWS TO ATTACH FINISH CARPENTRY TO METAL STUDS. FILL RECESS TO MATCH SURFACE COLOR OF WOOD.

## STUCCO FINISH NOTES

1. STUCCO FINISH APPLIED TO EXTERIOR MASONRY AND CONCRETE SURFACES, SCRATCHED AND FLOATED IN TWO COATS STANDARD OPERATION IN THICKNESS AND FINISH AS SHOWN ON PLANS UNLESS OTHERWISE NOTED.

A. MASONRY CEMENT: DOMESTIC ASTM C 91-66,

B. PORTLAND CEMENT: ASTM C150-67, TYPE 1,

C. WATERPROOFING AGENT: OMICRON OR EQUAL,

D. STUCCO: 1 PART PORTLAND CEMENT, 1 PART MASONRY CEMENT, 4-5 PARTS FINE SAND, ADD WATERPROOFING AGENT IN FINAL COAT.

E. AGGREGATE: ASTM C34-62, F. WATER: POTABLE.

2. FINAL STUCCO FINISH TO BE SMOOTH TYPICAL ALL CONDITIONS NO TEXTURE.
STUCCO CONTRACTOR TO SUBMIT SAMPLE FOR ARCHITECT AND OWNER APPROVAL

## METAL FRAMING SECTION 05810

MATERIALS: ALL STUD FRAMING MEMBERS SHALL BE OF THE TYPE, SIZE AND GAUGE AS SHOW ON THE PLANS AND SPECIFIED HEREIN.

ALL STUDS SHALL BE 20 GAUGE GALVANIZED (UNLESS OTHERWISE NOTED) AND SHALL BE FORMED FROM STEEL THAT CORRESPONDS TO ASTM A446

ALL GALVANIZED STUDS AND ACCESSORIES SHALL BE FORMED FROM STEEL THAT CORRESPONDS TO THE REQUIREMENTS OF ASTM A4446, GRADE A, WITH A MINIMUM

ALL FRAMING COMPONENTS SHALL BE CUT SQUARELY FOR ATTACHMENT TO PERPENDICULAR MEMBERS, OR AS REQUIRED FOR AN ANGULAR FIT AGAINST ABUTTING MEMBERS. MEMBERS SHALL BE HELD POSITIVELY IN PLACE UNTIL PROPERLY FASTENED.

INSTALLATION TRACKS SHALL BE SECURELY ANCHORED TO THE SUPPORTING STRUCTURES AS SHOWN. FLOOR TRACKS SHALL RECEIVE CONTINUOUS SILICON SEALANT EACH SIDE OF THE TRACK BEFORE INSTALLATION OF WALL SHEATHING/FINISH MATERIAL

A COMMON STRUCTURAL ELEMENT, OR THEY SHALL BE BUTT WELDED OR SPLICED TOGETHER.

AT TRACK BUTT JOINTS, ABUTTING PIECES OF TACK SHALL BE SECURELY ANCHORED TO

STUDS SHALL BE PLUMBED, ALIGNED AND SECURELY ATTACHED TO THE FLANGES OR WEBS OF BOTH UPPER AND LOWER TRACKS.

STUDS SHALL BE INSTALLED AT 16" ON CENTER UNLESS OTHERWISE NOTED ON THE PLANS.

WALL STUD BRIDGING SHALL BE ATTACHED IN A MANNER TO PREVENT STUD ROTATION. BRIDGING ROWS SHALL BE SPACED ACCORDING TO THE FOLLOWING SCHEDULE. WALL UP TO 10'-0" HEIGHT: BRIDGING AT MID-HEIGHT WALLS EXCEEDING 10'-0" HEIGHT: BRIDGING ROWS SPACED NOT TO EXCEED 4'-0" O.C.

## WALL BACKING

YIELD OF 33, 000 PSI.

FOR MOUNTING BASE AND WALL CABINETS PROVIDE 1"X6" PT WOOD BACKING IN ALL STUD WALLS AND FURRING SPACE OF ALL C.M.U. WALLS. TOP OF WOOD BACKING WILL BE AT 34" AND 84" A.F.F. - MATCH CASEWORK ELEVATIONS

## PORCELAIN TILE

PROVIDE PORCELAIN TILE FLOORING WITH MATCHING COVE BASE AND BULLNOSE EDGE TRIM, WHERE INDICATED ON THE DRAWINGS AND AS REQUIRED HEREIN.

TILE SHALL BE THIN-SET IN ADHESIVE. USE SANDED CEMENT GROUT WITH ACRYLIC ADDITIVE, IN ACCORDANCE WITH TCA HANDBOOK METHOD NO F113.

MATERIALS: OWNER TO SELECT FINAL FINISHES, CONTRACTOR TO SUBMIT SAMPLES FOR APPROVAL TO OWNER AND ARCHITECT

COMPLY WITH MANUFACTURE'S INSTRUCTIONS FOR MIXING AND INSTALLATION OF

EXTEND TILE WORK INTO RECESSES AND UNDER OR BEHIND CABINETS EQUIPMENT AND FIXTURES, TO FORM A COMPLETE COVERING WITHOUT INTERRUPTIONS, EXCEPT AS OTHERWISE SHOWN. TERMINATE WORK NEATLY AT OBSTRUCTIONS, EDGES AND CORNERS WITHOUT DISRUPTING PATTERN OR JOINT ALIGNMENT. ACCURATELY FORM INTERACTIONS AND RETURNS. PERFORM CUTTING AND DRILLING OF TILE WITHOUT MARRING VISIBLE SURFACES. CAREFULLY GRIND CUT EDGES OF TILE ABUTTING TRIM, FINISH OR BUILT-IN ITEMS FOR STRAIGHT ALIGNED JOINTS. FIT TILE CLOSELY TO ELECTRICAL OUTLETS, PIPING, FIXTURES AND OTHER PENETRATIONS SO

JOINTING PATTERNS: UNLESS OTHERWISE SHOWN, LAY TILE IN GRID PATTERN. ALIGN JOINTS WHEN ADJOINING TILES ON FLOOR, BASE, WALLS AND TRIM ARE SAME SIZE. LAYOUT TILE WORK AND CENTER TILE FIELDS IN BOTH DIRECTIONS IN EACH SPACE OR ON EACH WALL AREA. ADJUST TO MINIMIZE TILE CUTTING. PROVIDE UNIFORM JOINT WIDTHS, UNLESS OTHERWISE SHOWN.

THAT PLATES, COLORS, OR COVERS OVERLAP TILE.

PROVIDE EXPANSION JOINTS IN TILE AT ALL EXPANSION, CONSTRUCTION AND CONTROL JOINTS IN THE BUILDING STRUCTURE IN ACCORDANCE WITH TCA HANDBOOK METHOD EJ171. KEEP EXPANSION JOINTS FREE FROM ADHESIVE OR GROUT. INSTALL BACKER ROD AND SEALANT AS DETAILED ON DRAWINGS.

CLEANING: UPON COMPLETION OF PLACEMENT AND GROUTING, CLEAN ALL CERAMIC TILE SURFACES SO THEY ARE FREE OF FOREIGN MATTER. UNGLAZED TILE MAY BE CLEANED WITH ACID SOLUTIONS ONLY WHEN PERMITTED BY TILE AND GROUT MANUFACTURER'S, PRINTED INSTRUCTIONS, BUT SOONER THAN 14 DAYS AFTER INSTALLATION. PROTECT METAL SURFACES, CAST IRON AND VITREOUS PLUMBING FIXTURES FROM EFFECTS OF ACID CLEANING. FLUSH SURFACE WITH CLEAN WATER BEFORE AND AFTER CLEANING.

FINISH TILE WORK: LEAVE FINISHED INSTALLATION CLEAN AND FREE OF CRACKED, CHIPPED, BROKEN UNBONDED, OR OTHERWISE DEFECTIVE TILE WORK.

PROTECTION: WHEN RECOMMENDED BY TILE MANUFACTURER, APPLY A PROTECTIVE COAT OF NEUTRAL PROTECTIVE CLEANER TO COMPLETED TILE WALL AND FLOORS. PROTECT INSTALLED TILE WORK WITH KRAFT PAPER OF OTHER HEAVY COVERING DURING CONSTRUCTION PERIOD TO PREVENT DAMAGE AND WEAR.

PROHIBIT FOOT AND WHEEL TRAFFIC FROM USING TILED FLOORS FOR AT LEAST THREE (3) DAYS AFTER GROUTING IS COMPLETED.

BEFORE FINAL INSPECTION REMOVE PROTECTIVE COVERINGS AND RISE NEUTRAL CLEANER FROM TILE SURFACE.

## ADDITIONAL TILE NOTES

INSTALL PORCELAIN TILE TO CEILING AT ALL TUB AND SHOWER ENCLOSURES AT ALL BATHROOM WALL AT TUBS AND SHOWERS, INSTALL TILE ON ½ "
DENSHIELD OR AQUA-SHIELD, AT ALL OTHER BATHROOM WALLS INSTALL ½ "
M.R. GREEN BOARD.

ALL BATHROOM WALL TILE TO BE PORCELAIN TILE.

ALL BATHROOM FLOORS SHALL HAVE A KERDI MEMBRANE - WITH MIN 1'-0" UP WALL RETURNS

### GYPSUM DRYWALL

SECTION 09250

- A. ALL DRYWALL TO BE LEVEL 4 FINISH WITH NO MARLS, RIDGES, MARKINGS, DEFORMATIONS, WARPING OR TELEGRAPHING OF ANY DEGREE. SMOOTH SANDED FINISH READY FOR PRIMER AND PAINT FINISH
- B. GYPSUM WALLBOARD: SHALL CONFORM TO THE REQUIRED OR SPECIFIED UNDERWRITERS LABORATORY (UL) ASSEMBLY SEE PARTITION SCHEDULE. ALL GYPSUM WALLBOARD SHALL MANUFACTURED BY UL APPROVED COMPANIES. INSTALLATION SHALL MEET THE FOLLOWING: A. ½ OR 5/8 INCH THICK BY 48 WIDE BY HEIGHT REQUIRED APPLIED VERTICALLY ON FURRING STRIPS AT INSIDE OF EXTERIOR MASONRY WALLS AT CEILING AS INDICATED.
- C. GYPSUM BOARD PARTITIONS SHALL BE ERECTED AS SHOWN ON THE PLANS OR CALLED FOR IN THE WALL SCHEDULE. ALL JOINTS SHALL BE LOCATED SO THAT THE PANELS OPPOSITE ONE ANOTHER SHALL FALL ON ALTERNATE STUDS. ALL JOINTS SHALL BE TAPED SPACKLED AND FINISHED SMOOTH.
- D. ALL GYPSUM BOARD CONSTRUCTION SHALL BE ERECTED PLUMB, LEVEL, SQUARE, STRAIGHT AND SECURELY INSTALLED WITH ALL SEAMS TO BE VERTICAL. ALL JOINTS ON EXPOSED SURFACES SHALL BE FLUSH, TIGHT, AND NEATLY CUT AND CLOSELY FIT AT OPENINGS FOR THE WORK OF OTHER TRADES AT THE INTERSECTIONS OF GYPSUM BOARD AND OTHER MATERIALS.
- E. METAL CORNER BEAD SHALL BE USED AT ALL EXPOSED CORNERS AND ENDS.
- ALL AREAS WITHIN 8'-0" OF ANY PLUMBING FIXTURE.

F. ALL RESTROOMS SHALL USE MOISTURE RESISTANT BOARD "GREEN BOARD" AT

### G. INSTALL PER MANUFACTURER'S SPECIFICATIONS.

- H. PROVIDE AND INSTALL SCREW-TYPE METAL SUPPORT SYSTEM, GYPSUM WALLBOARD, AND DRYWALL FINISHING OF PARTITIONS, FURRING, CEILING AND SOFFIT DROPS WHERE SHOWN OR NOTED ON THE DRAWINGS AND AS SPECIFIED HEREIN.
- I. METAL FURRING: ASTM A525, G90, 26 GAGE MINIMUM, 1 ½" DEPTH UNLESS NOTED OTHERWISE, SCREW-TYPE ZEE-SHAPED FURRING MEMBERS DESIGNED FOR MECHANICAL ATTACHMENT OF INSULATION BOARDS TO MONOLITHIC CONCRETE AND MASONRY WALLS.
- J. TRIM ACCESSORIES: ASTM C475. PAPER REINFORCING JOINT TAPE, WITH READY MIXED VINYL-TYPE JOINT COMPOUND, MULTI-PURPOSE, GRADE.
- K. COMPLY WITH "GYPSUM CONSTRUCTION HANDBOOK" BY UNITED STATES GYPSUM CO. GYPSUM ASSOCIATION GA-216 "RECOMMENDED SPECIFICATIONS FOR APPLICATION AND FINISHING OF GYPSUM BOARD" AND ASTM C754 "INSTALLATION OF FRAMING MEMBERS TO RECEIVE SCREW ATTACHED GYPSUM WALLBOARD, BACKING BOARD, OR WATER RESISTANT BACKING BOARD" FOR ALL INSTALLATION WORK.
- L. BASE OF WATER RESISTANT GYPSUM BOARD: PROVIDE 1/2" GAP BETWEEN BOTTOM OF WATER RESISTANT GYPSUM BOARD AND FLOOR SURFACE FOR INSTALLATION OF CONTINUOUS SILICONE SEALANT.
- M. INSTALL CONTROL JOINTS ABOVE ALL DOOR JAMBS, AND AS INDICATED ON THE DRAWINGS.
- N. APPLY JOINT TREATMENT AT ALL JOINTS (BOTH DIRECTIONS), METAL TRIM FLANGES, PENETRATIONS, FASTENERS HEADS, SURFACE DEFECTS AND ELSEWHERE AS REQUIRED TO PREPARE WORK FOR FINAL FINISH. APPLY JOINT COMPOUND IN THREE (3) COATS AND SAND SMOOTH BETWEEN LAST TWO (2) COATS AND AFTER LAST COAT.
- O. INSTALL ACOUSTICAL INSULATION IN PARTITIONS INDICATED ON DRAWINGS TO ACHIEVE STC RATINGS OF 35 FOR INTERIOR WALLS AND STC RATING OF 50 BETWEEN UNITS AND HALLWAY. INSTALL ACOUSTICAL INSULATION IN PARTITIONS TIGHT WITHIN SPACES, AROUND CUT OPENINGS, BEHIND AROUND AND TIGHT TO PENETRATION ITEMS INSTALL ACOUSTICAL SEALANT IN ACCORDANCE WITH MANUFACTURER'S INSTRUCTIONS.
- P. DRYWALL MUST BE FABRICATED IN NORTH AMERICA

## PLUMBING CHASE

STEEL STUDS SUPPORTING WALL HUNG PLUMBING FIXTURES SHALL BE DOUBLED OR NOT LESS THAN 20 GA. WITH A MINIMUM EFFECTIVE MOMENT OF INERTIA EQUAL TO 0.864 IN.4

SUCH STUD SHALL BE RIGIDLY CONNECTED TOP AND BOTTOM TO PREVENT SIGNIFICANT END ROTATION OR DISPLACEMENT.

A HORIZONTAL MEMBER SECURELY FASTENED TO NOT LESS THAN TWO STUDS SHALL BE INSTALLED FOR THE ATTACHMENT OF EACH WALL HUNG PLUMBING FIXTURE.

# PAINTING

WORK INCLUDES SURFACE PREPARATION AND PAINTING OF INTERIOR AND EXTERIOR SURFACES FOR THE TOTAL PROJECT. WHERE ITEMS OR SURFACES ARE NOT SPECIFICALLY MENTIONED. POINT THE SAME AS SIMILAR ADJACENT MATERIALS OR AREAS. EXPOSED PORTIONS OF FLUSH, MOUNTED GRILLES, DIFFUSERS, AND RECESSED LIGHT FIXTURE TRIMS SHALL BE PAINTED TO MATCH THE COLOR OF THE CEILING, IF THE CEILING IS PAINTED OTHER THAN WHITE.

SECTION 09900

PAINTING NOT REQUIRED: UNLESS OTHERWISE INDICATED, PAINTING IS NOT REQUIRED ON CASEWORK, PLASTIC LAMINATE, MECHANICAL EQUIPMENT, PLUMBING FIXTURE, ELECTRICAL EQUIPMENT (EXCLUDING EXPOSED DISTRIBUTION CABINETS(S) ELECTRICAL DEVICES. PAINTING IS NOT REQUIRED ON SURFACES SUCH AS WALL OR CEILING IN CONCEALED OR INACCESSIBLE AREAS. METAL SURFACES OF ANODIZED ALUMINUM, STAINLESS STEEL, CHROMIUM PLATE AND SIMILAR FINISHED MATERIALS DO NOT REQUIRE FINISH PAINTING. DO NOT PAINT OVER CODE-REQUIRED LABELS OR EQUIPMENT IDENTIFICATION LABELS AND SPRINKLER HEADS.

JOB CONDITIONS: APPLY PAINTS ONLY WHEN TEMPERATURE OF SURFACES TO BE PAINTED AND SURROUNDING AIR TEMPERATURES ARE WITHIN RECOMMENDED RANGE PERMITTED BY THE PAINT MANUFACTURER'S PRINTED INSTRUCTIONS.

MATERIALS: PAINT AND STAIN MATERIALS AS LISTED IN THE FINISH LEGEND.

SURFACE PREPARATION: CLEAN SURFACE OF DIRT, RUST, SCALE, GREASE, MOISTURE, OR OTHER CONDITIONS OTHERWISE DETRIMENTAL TO FORMATION OF A DURABLE PAINT FILM. PERFORM PREPARATION AND CLEANING PROCEDURES IN ACCORDANCE WITH PAINT MANUFACTURER'S PRINTED INSTRUCTIONS FOR EACH PARTICULAR SUBSTRATE CONDITIONS.

REMOVE HARDWARE, ACCESSORIES, PLATES, LIGHTING FIXTURES, AND SIMILAR ITEMS IN PLACE AND NOT TO BE FINISH-PAINTED, OR PROVIDE PROTECTION PRIOR TO SURFACE PREPARATION AND PAINTING OPERATIONS. REMOVE, IF NECESSARY, FOR COMPLETE PAINTING OF ITEMS AND ADJACENT SURFACES, FOLLOWING COMPLETION OF PAINTING OF EACH SPACE OR AREA, REINSTALL REMOVED ITEMS.

COMPLY WITH MANUFACTURER'S PRINTED DIRECTIONS IN APPLYING PAINT MATERIALS. USE APPLICATORS AND TECHNIQUES BEST SUITED FOR SUBSTRATE AND TYPE OF MATERIAL BEING APPLIED.

SCHEDULING: APPLY FIRST-COAT MATERIAL TO SURFACES THAT HAVE BEEN CLEANED, PRE-TREATED OR OTHERWISE PREPARED FOR PAINTING AS SOON AS PRACTICAL AFTER PREPARATION AND BEFORE SUBSEQUENT SURFACE DETERIORATION. ALLOW SUFFICIENT TIME BETWEEN SUCCESSIVE COATINGS TO PERMIT PROPER DRYING. DO NOT RE-COAT UNTIL PAINT HAS DRIED TO WHERE IT FEELS FIRM, DOES NOT DEFORM OR FEEL STICKY UNDER MODERATE THUMB PRESSURE, AND APPLICATION OF ANOTHER COAT OF PAINT DOES NOT CAUSE LIFTING OR LOSS OF ADHESION OF THE UNDERCOAT. FORMULATE COLOR OF PRIME COAT TO MATCH COLOR OF FINISH COATS.

APPLY PAINT TO PROVIDE AN OPAQUE SMOOTH, SURFACE OF UNIFORM FINISH COLOR, APPEARANCE AND COVERAGE. CLOUDINESS, SPOTTING, HOLIDAYS, LAP MARKS, BRUSH MARKS, RUNS, SAGS, RAPIDNESS OR OTHER SURFACE

IMPERFECTIONS WILL NOT BE ACCEPTABLE.

WITH SPECIFIED REQUIREMENTS.

APPLY ADDITIONAL PAINT COATS WHEN UNDERCOATS, STAINS OR OTHER CONDITIONS SHOW THROUGH FINAL COAT OF PAINT, UNTIL PAINT FILM IS OF UNIFORM FINISH, COLOR AND APPEARANCE. GIVE SPECIAL ATTENTION TO INSURE THAT SURFACES, INCLUDING EDGES, CORNERS, CREVICES, AND EXPOSED FASTENERS RECEIVE A DRY FILM THICKNESS EQUIVALENT TO THAT OF FLAT SURFACES. REMOVE, REFINISH OR REPAINT WORK NOT IN COMPLIANCE

CLEAN UP: DURING THE PROGRESS OF THE WORK, REMOVE FROM SITE DISCARDED PAINT MATERIALS, RUBBISH, CANS AND RAGS AT END OF EACH WORK DAY. UPON COMPLETION OF PAINTING WORK, CLEAN WINDOW GLASS AND OTHER DAMAGED PAINT-SPATTERED SURFACES. REMOVE SPATTERED PAINT AND CLEAN DAMAGED FINISH SURFACES. REMOVE SPATTERED PAINT AND CLEAN DAMAGED FINISH SURFACES. TOUCH-UP AND RESTORE ALL DAMAGED OR DEFACED PAINTED SURFACES AFTER COMPLETION.

ARCHITECTURAL PAINTS AND COATINGS APPLIED TO INTERIOR WALLS AND CEILINGS MUST NOT EXCEED THE VOLATILE ORGANIC COMPOUND (VOC) CONTENT LIMITS ESTABLISHED IN GREEN SEAL STANDARD GS-11, PAINTS, 1ST EDITION, MAY 20, 1993.

PAINTING: SHERWIN WILLIAMS OR APPROVED EQUAL. (1) EXTERIOR: 1 COAT MASONRY PRIMER, 2 COATS EXTERIOR LATEX. (2) INTERIOR: (COLORS TO BE SELECTED BY OWNER/ARCHITECT) DRYWALL SURFACES: 1 COAT PRIMER-SEALER, 2 COATS FINISH LATEX. WOOD SURFACES: 1 COAT PRIMER, 2 COATS ENAMEL OR STAINED AND SEALED, SEE FINISH SCHEDULE.

# MISC NOTES:

- 1. CEILINGS TO BE 5/8" GYPSUM DRYWALL ON SUSPENDED METAL FRAMING WITH PAINT FINISH.
- 2. ALL PARTITIONS IN BATHROOMS, POWDER ROOM OR KITCHEN PLUMBING WALLS TO BE MOISTURE RESISTANT
- GYPSUM WALL BOARD FLOOR TO CEILING

  3. PARTITIONS WITH TILE TO BE 5/8" DUROCK. CO-ORDINATE WITH OWNER FOR FINISH SELECTIONS
- 4. ALL FINISHES TO BE CLASS "A" TYP.
- 5. FLAME SPREAD FOR INSULATION MAX 25, SMOKE DEVELOPED MAX 450 PER FBC R302.10
- 6. FLAME SPREAD FOR WALL AND CEILING FINISHES MAX 200, SMOKE DEVELOPED MAX 450 PER FBC R302.9
- 7. OWNER TO SELECT COLORS, CONTRACTOR TO PROVIDE SAMPLES FOR APPROVAL.
   8. PROVIDE CROSS BRACING AT ALL INTERIOR NON-BEARING PARTITIONS. SECURE TO ROOF TRUSSES ABOVE

9. PROVIDE HORIZONTAL STUDS (FIRE STOPS) AT ALL CEILING LEVELS, BOTH SIDES OF WALL/PARTITION, NOT TO EXCEED 8'-0" HORIZONTALLY

DRAWN BY: SZM
DATE: 5/3/2024

REVISIONS:

DRAWING TITLE:

GENERAL NOTES & FINISH NOTES

THEY ARE NOT TO BE CONSTRUED AS FINAL CONSTRUCTION
DOCUMENTS UNTIL ALL BUILDING DEPARTMENT APPROVALS
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LEASE NOTE: THIS DRAWING SET AND ITS SPECIFICATIONS NOTICE CCEPTANCES, PRODUCT AND EQUIPMENT BOOKS AND MANUALS, OIL REPORTS SHALL CONSTITUTE A SINGLE ENTITY, NO PART OF THE ENTITY SHALL BE CONSIDERED WITHOUT THE OTHERS, ANY

INFORMATION WITHIN THIS SET AND SPECIFICATION M

ALL ASPECTS OF THE WORN DESCRIBED WITH THIS DEVANUE OF ANY CONFLICTS ARISE AS WITHIN THE DESCRIPTION OF WORK IN TO DRAWING SET THE CONTRACTOR MUST NOTIFY THE OWNER AND ARCHITECT PRIOR TO THE BEGINNING OF ANY BIDDING, WORK AND PURCHASING.

F TO THE VARIATIONS IN INTERPRETATIONS OF T

SCHISM ARCHITECTURE + DESIGN

SCHNEUR Z. MEYER, AIA

FL: AR101781

1622 NW 36TH ST, MIAMI FL 33142


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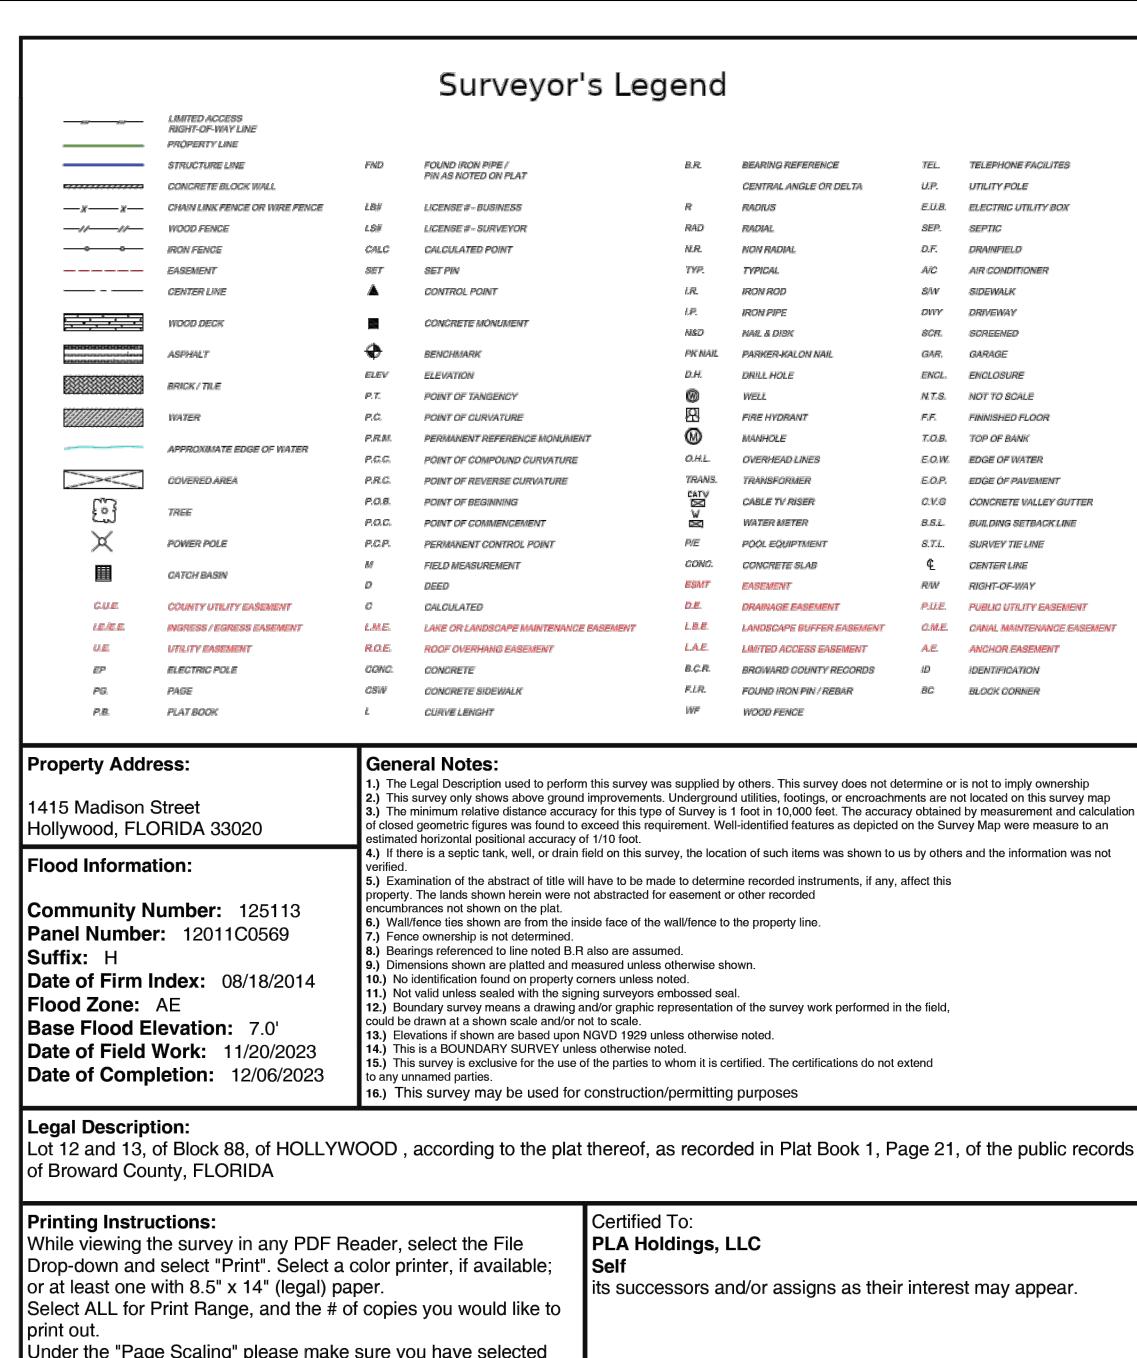
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PROJECT # 2307

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# Please copy below for policy preparation purposes only:

This policy does not insure against loss or damage by reason of the following exceptions: Any rights, easements, interests, or claims which may exist by reason of, or reflected by, the following facts shown on the survey prepared by Miguel Espinosa , for M.E. Land Surveying, LLC., dated 12/06 /2023 bearing Job # <u>B-134477</u>

a. PAVERS EXTEND BEYOND NORTH AND SOUTH PROPERTY LINES.

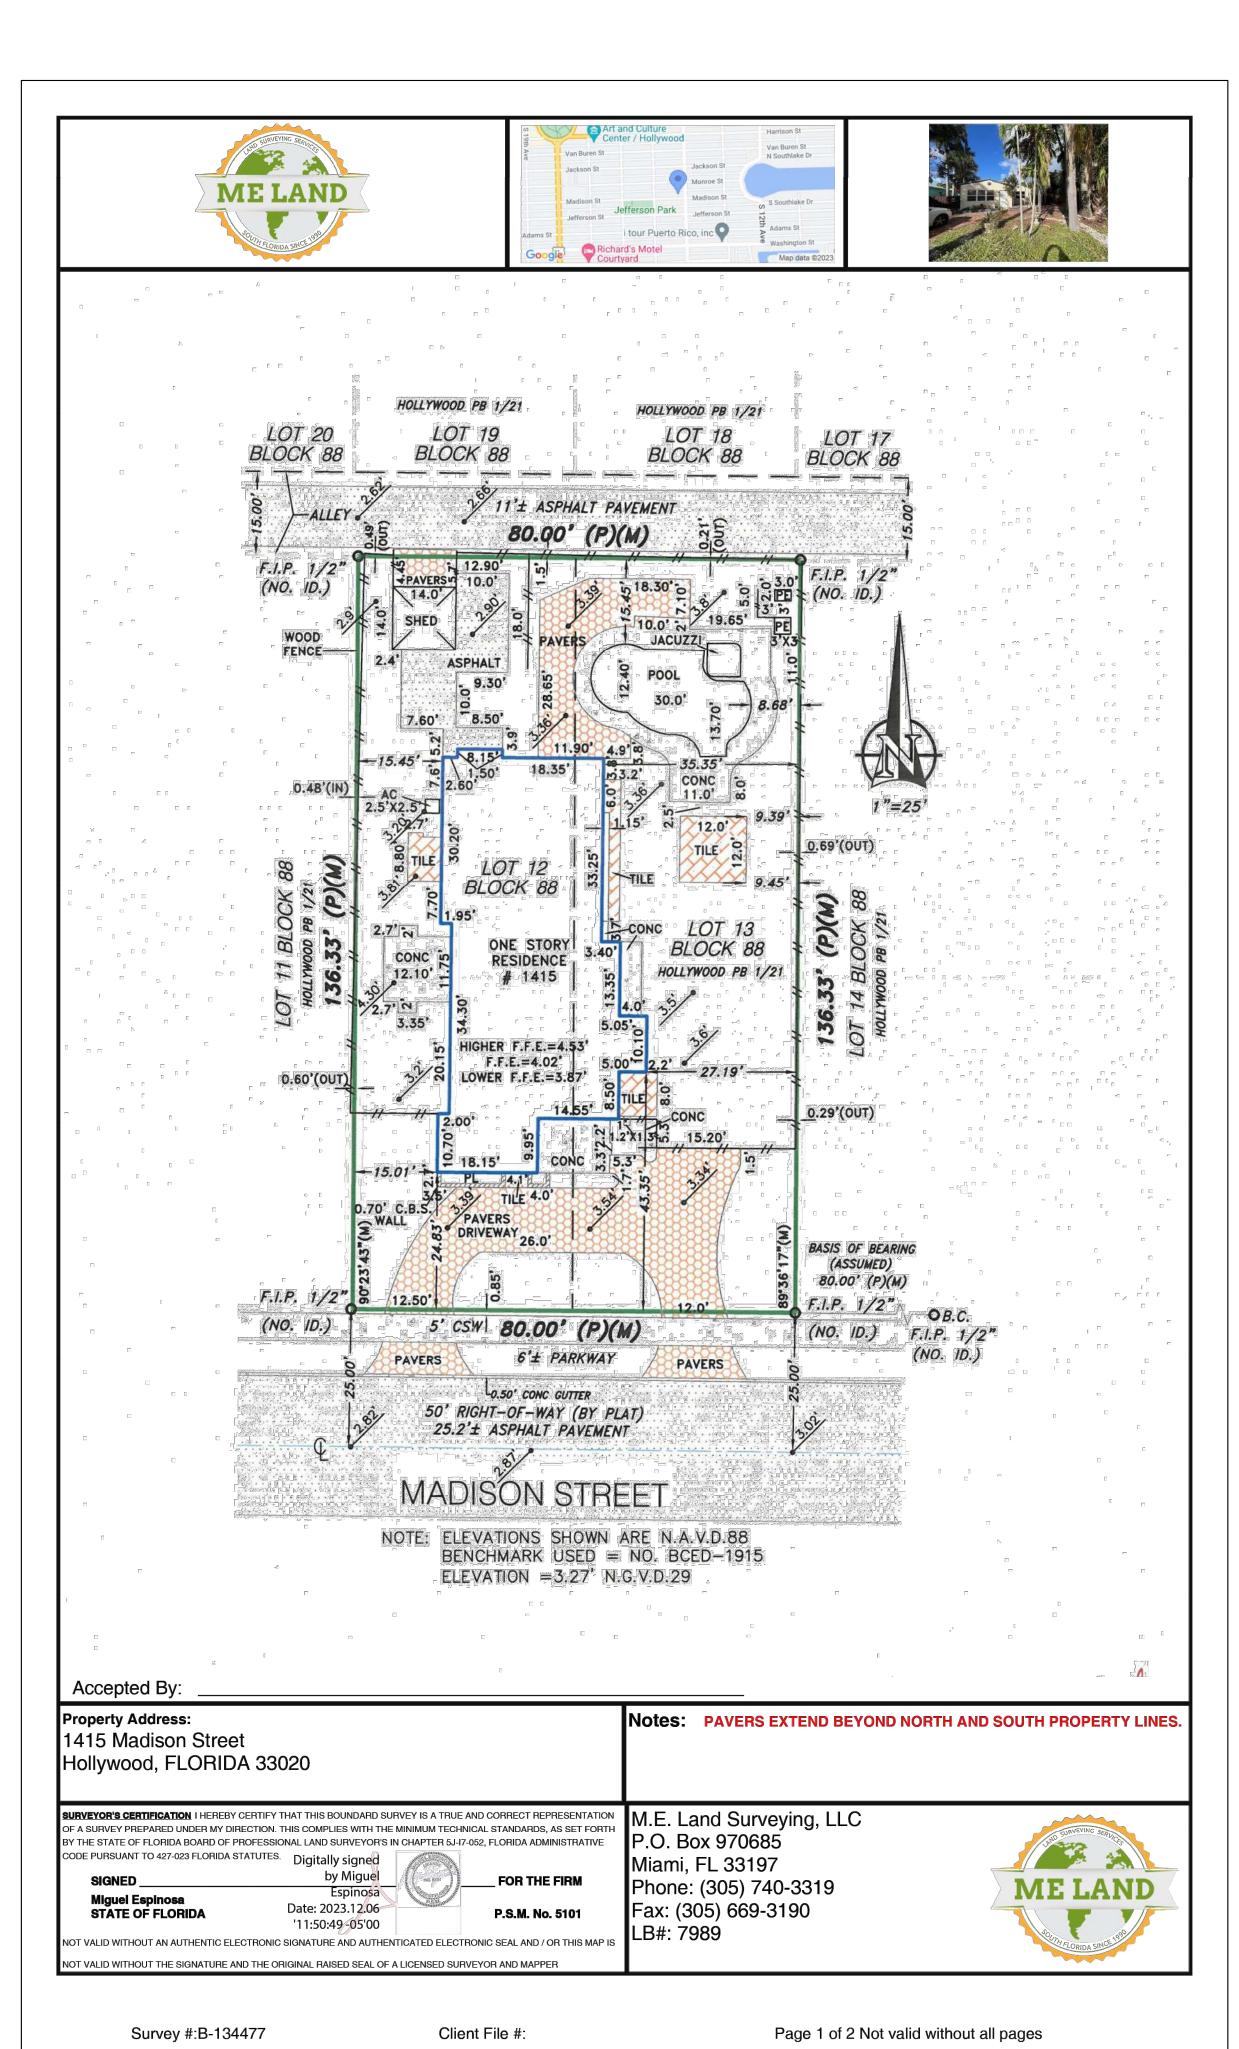

# M.E. Land Surveying, LLC

P.O. Box 970685 Miami, FL 33197 Phone: (305) 740-3319 Fax: (305) 669-3190 LB#: 7989



Survey #:B-134477 Client File #: Page 2 of 2 Not valid without all pages SCHISM ARCHITECTURE + DESIGN SCHNEUR Z. MEYER, AIA FL: AR101781

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DRAWN BY: SZM DATE: 5/3/2024

**REVISIONS:** 2/15/24 BLDG DEPT NOTES


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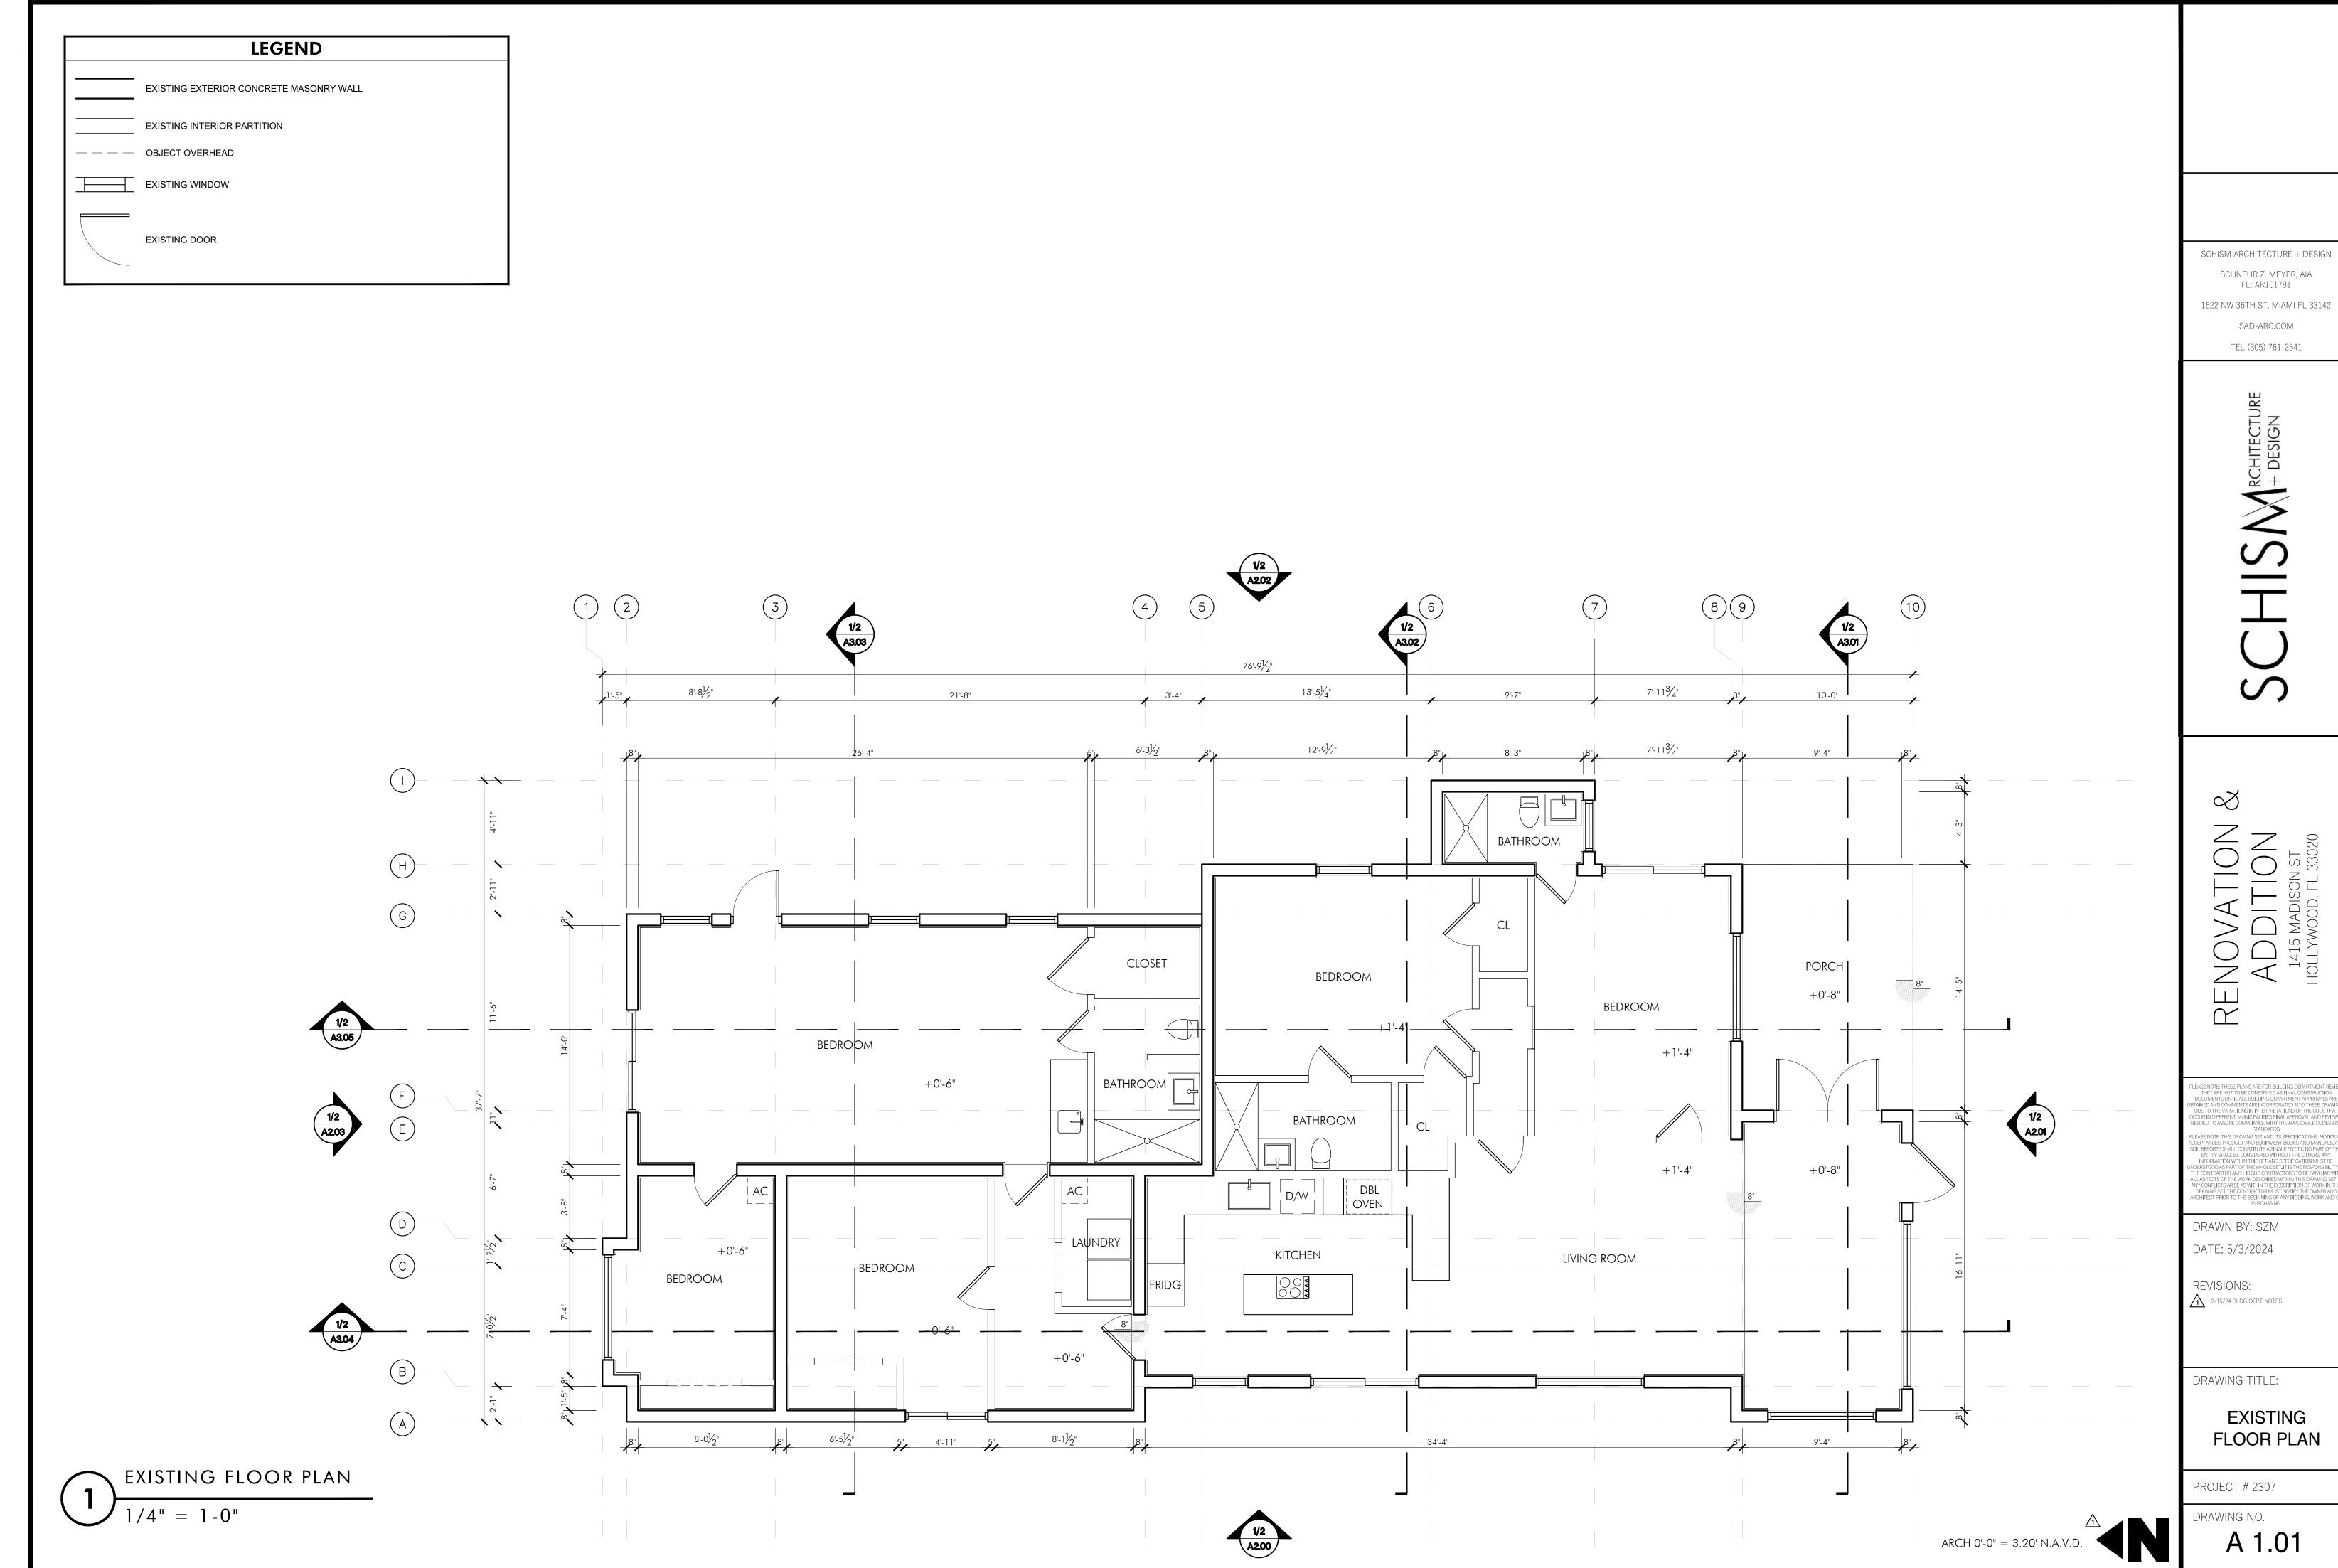
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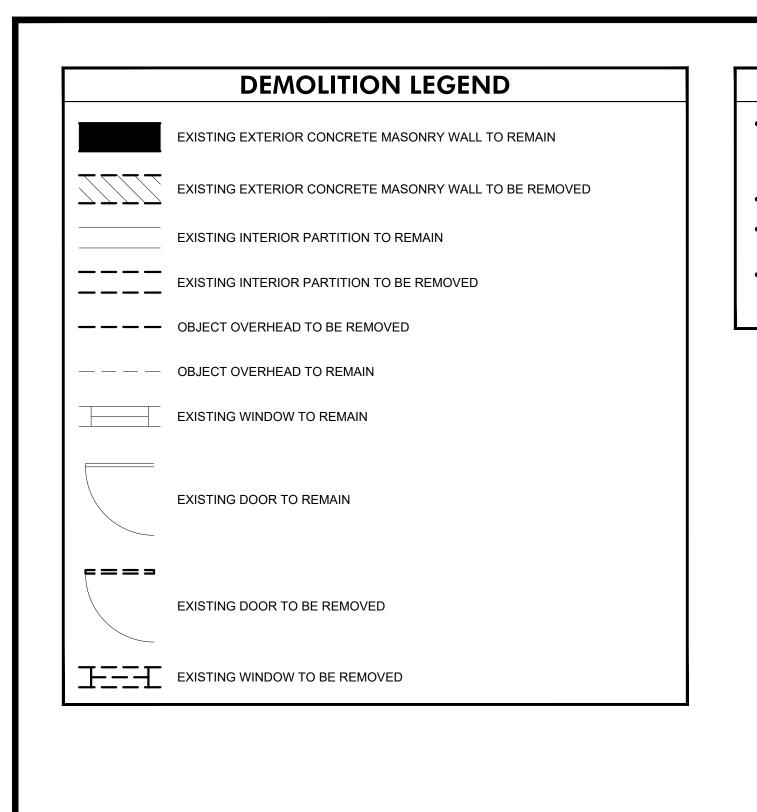
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1/2 A3.04

DEMOLITION FLOOR PLAN

# **DEMOLITION NOTES**

- CONTRACTOR TO PROTECT ALL EXISTING AREAS OUTSIDE THE LIMITS OF CONSTRUCTION (TYP.). CONTRACTOR SHALL PATCH, REPAIR OR REPLACE ANY DAMAGE, INTENTIONAL OR NOT, CAUSED BY CONSTRUCTION WORK OR WORKERS TO AREAS OUTSIDE THE LIMITS OF CONSTRUCTION (TYP.)
- REMOVE ALL EXISTING BATHROOM & KITCHEN APPLIANCES

REMOVE EXTERIOR

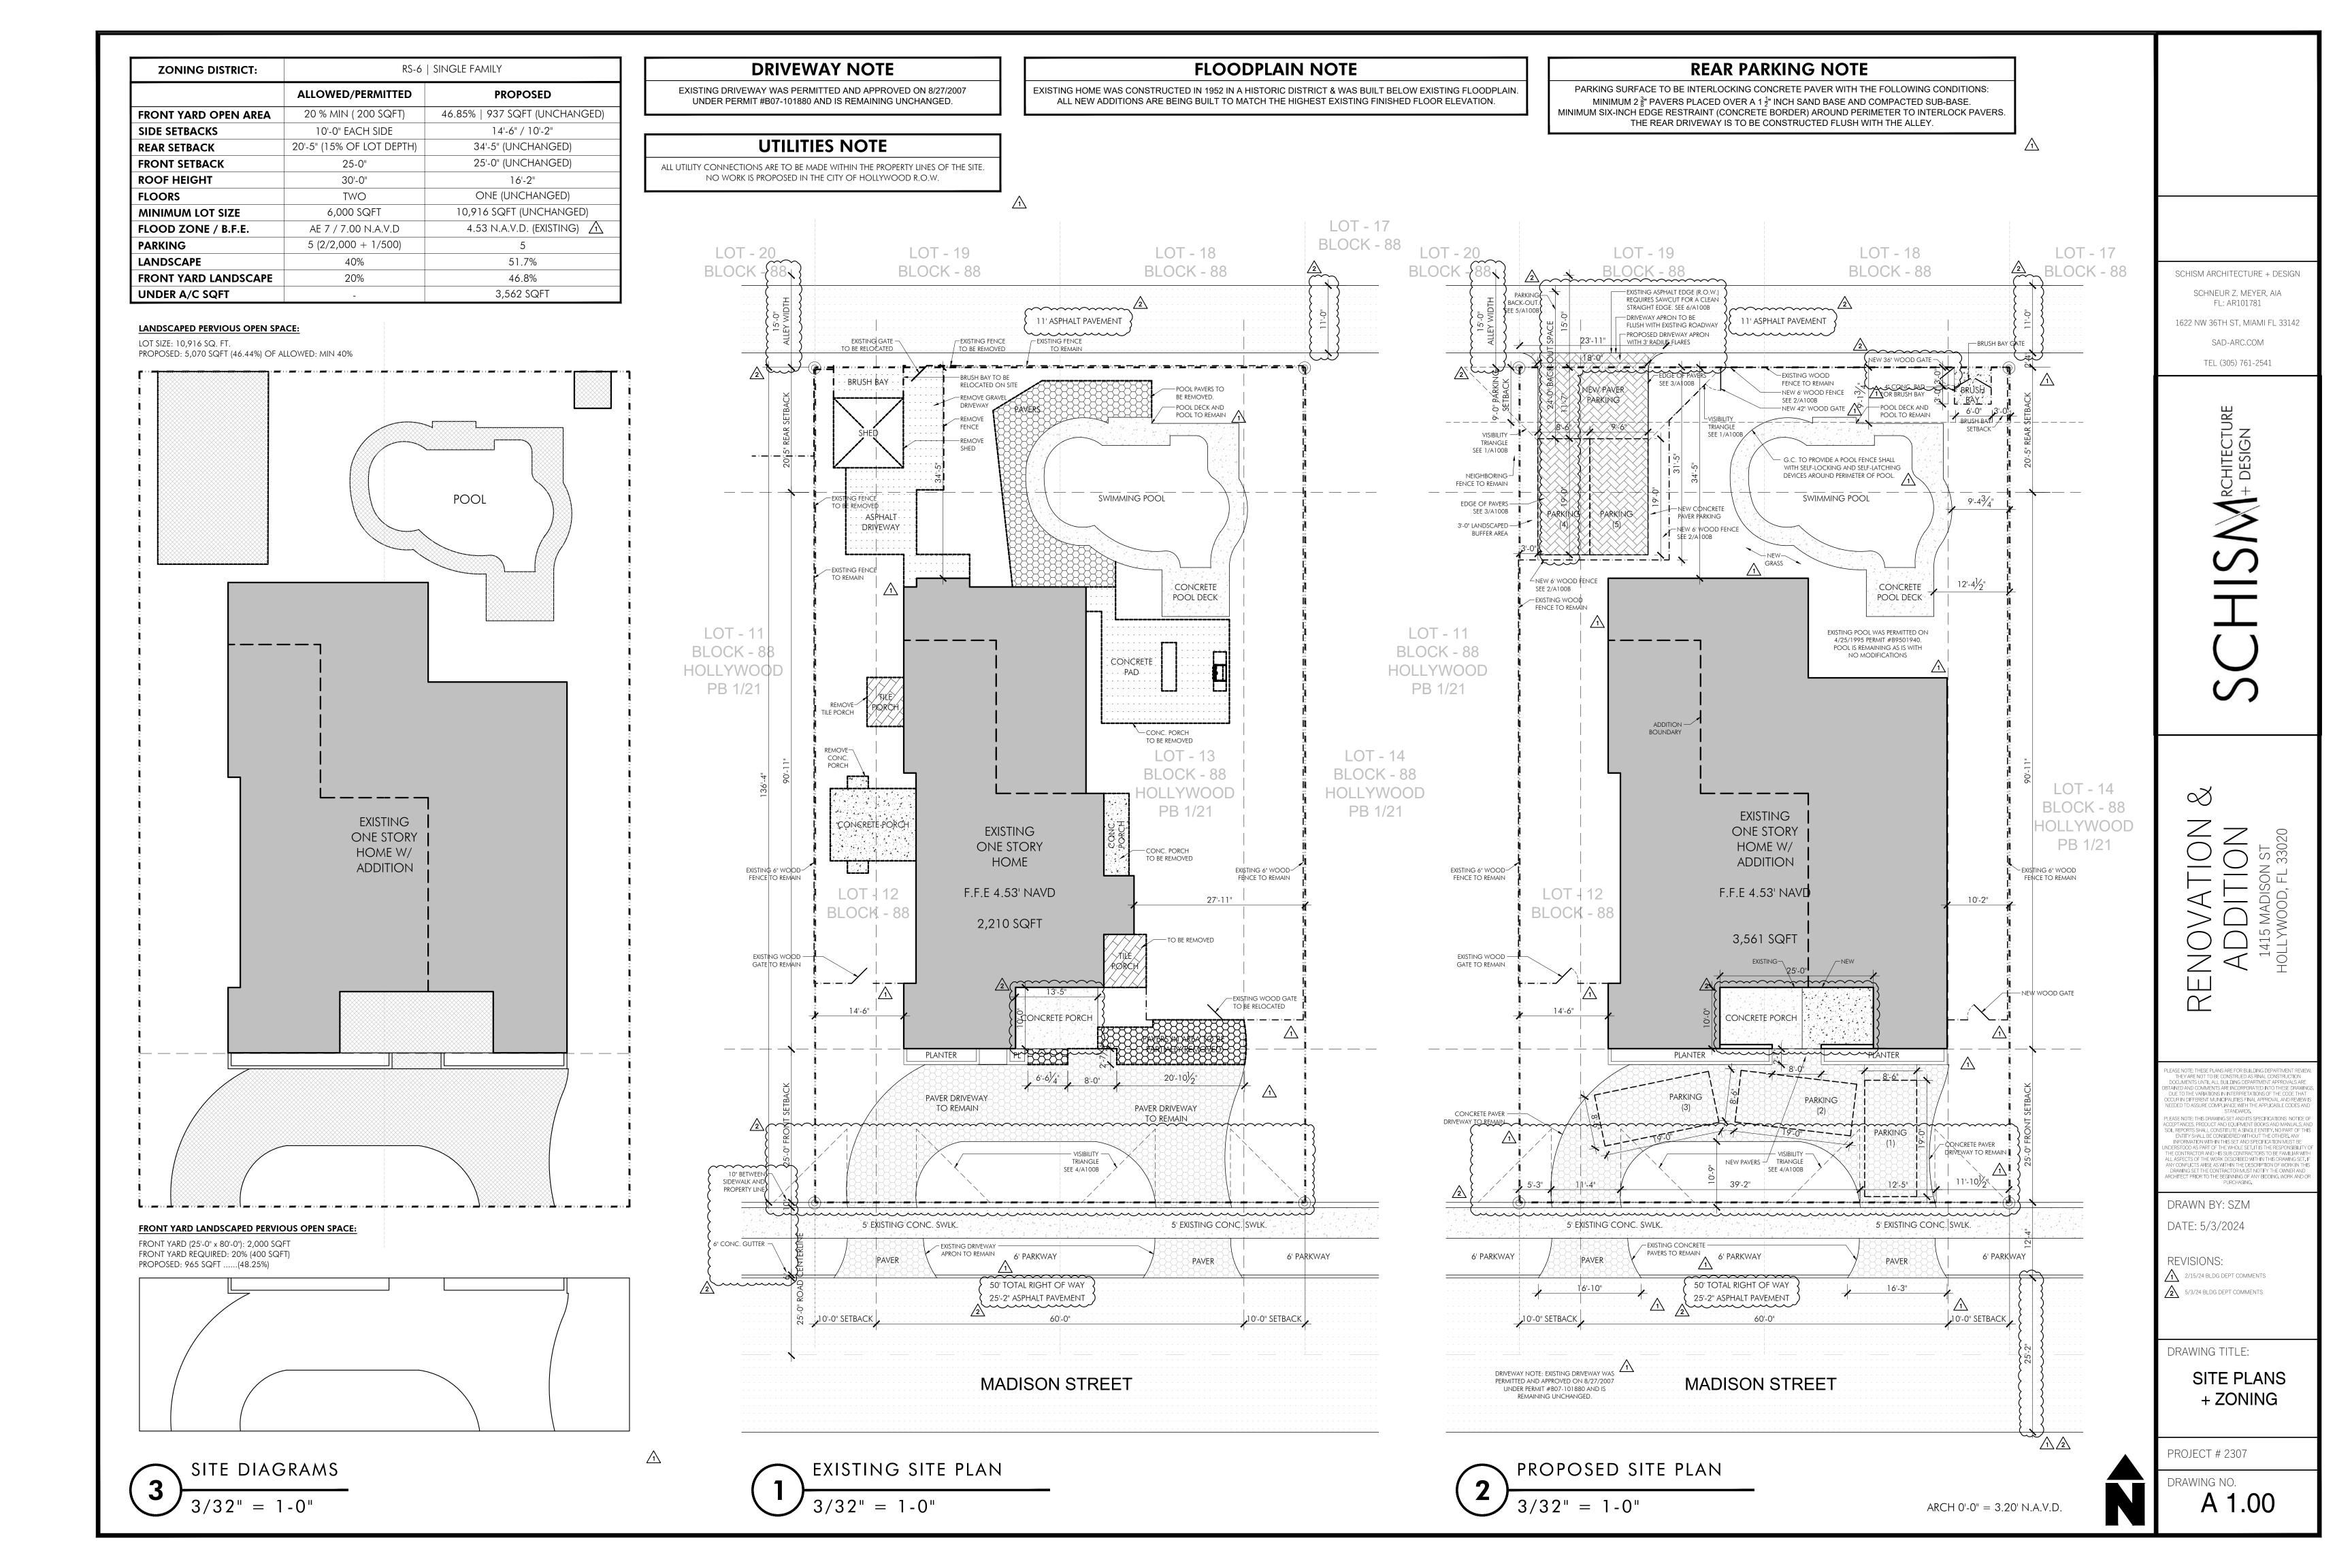REMOVE EXTERIOR WALLS + WINDOWS

BEDROOM

NOTE: VERIFY ALL EXISTING WINDOW/DOOR LOCATIONS IN FIELD BEFORE COMMENCING CONSTRUCTION

WALLS + WINDOWS

- REMOVE EXTERIOR

- EXISTING WALLS

to remain

BEDROOM

WALLS + WINDOWS

- CONTRACTOR TO PROTECT ALL EXISTING UTILITIES DURING DEMOLITION AND CONSTRUCTION.
- ALL UTILITY LINES INCLUDING, BUT NOT LIMITED TO, WATER, SEWER, ETC. SHALL BE SHUT OFF, CAPPED, OR OTHERWISE CONTROLLED BEFORE DEMOLITION WORK IS STARTED. CO-ORDINATE WITH CITY STAFF PRIOR TO ANY SHUT-DOWNS.

# SCOPE OF WORK NOTE

76'-9<sup>1</sup>/2"

T-----

BATHROOM

====

13'-5<sup>1</sup>/<sub>4</sub>"

12'-9<sup>1</sup>⁄<sub>4</sub>"

- REMOVE WALL + WINDOW

TO PREPARE FOR ADDITION

BEDROOM

EXISTING WALLS

BATHROOM -

KITCHEN

to remain

------

7'-11<sup>3</sup>⁄<sub>4</sub>"

— EXISTING WALLS

- REMOVE DOOR

to remain

BEDROOM

\_\_\_\_

LIVING ROOM

- REMOVE PORTION

OF WALL

9'-4"

BE REMOVED

BE REMOVED

1. HOME WAS RECENTLY BOUGHT BY NEW OWNER. DEMOLITION WORK TO THE REAR STRUCTURE IS TO REMOVE AND REPLACE AN UNSAFE STRUCTURE THAT WAS BUILT & ENCLOSED WITHOUT PERMITS. NEW AREA IS TO RETAIN EXISTING FOOTPRINT BUT REBUILD IN A SAFE AND CODE COMPLIANT WAY.

2. RENOVATE EXISTING HOME AND BRING ALL FLOORS UP TO GROUND LEVEL.

3. NEW 1,219 SQFT CMU ADDITION WITH NEW WOOD TRUSS.





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**REVISIONS:** 2/15/24 BLDG DEPT NOTES

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**DEMOLITION** FLOOR PLAN


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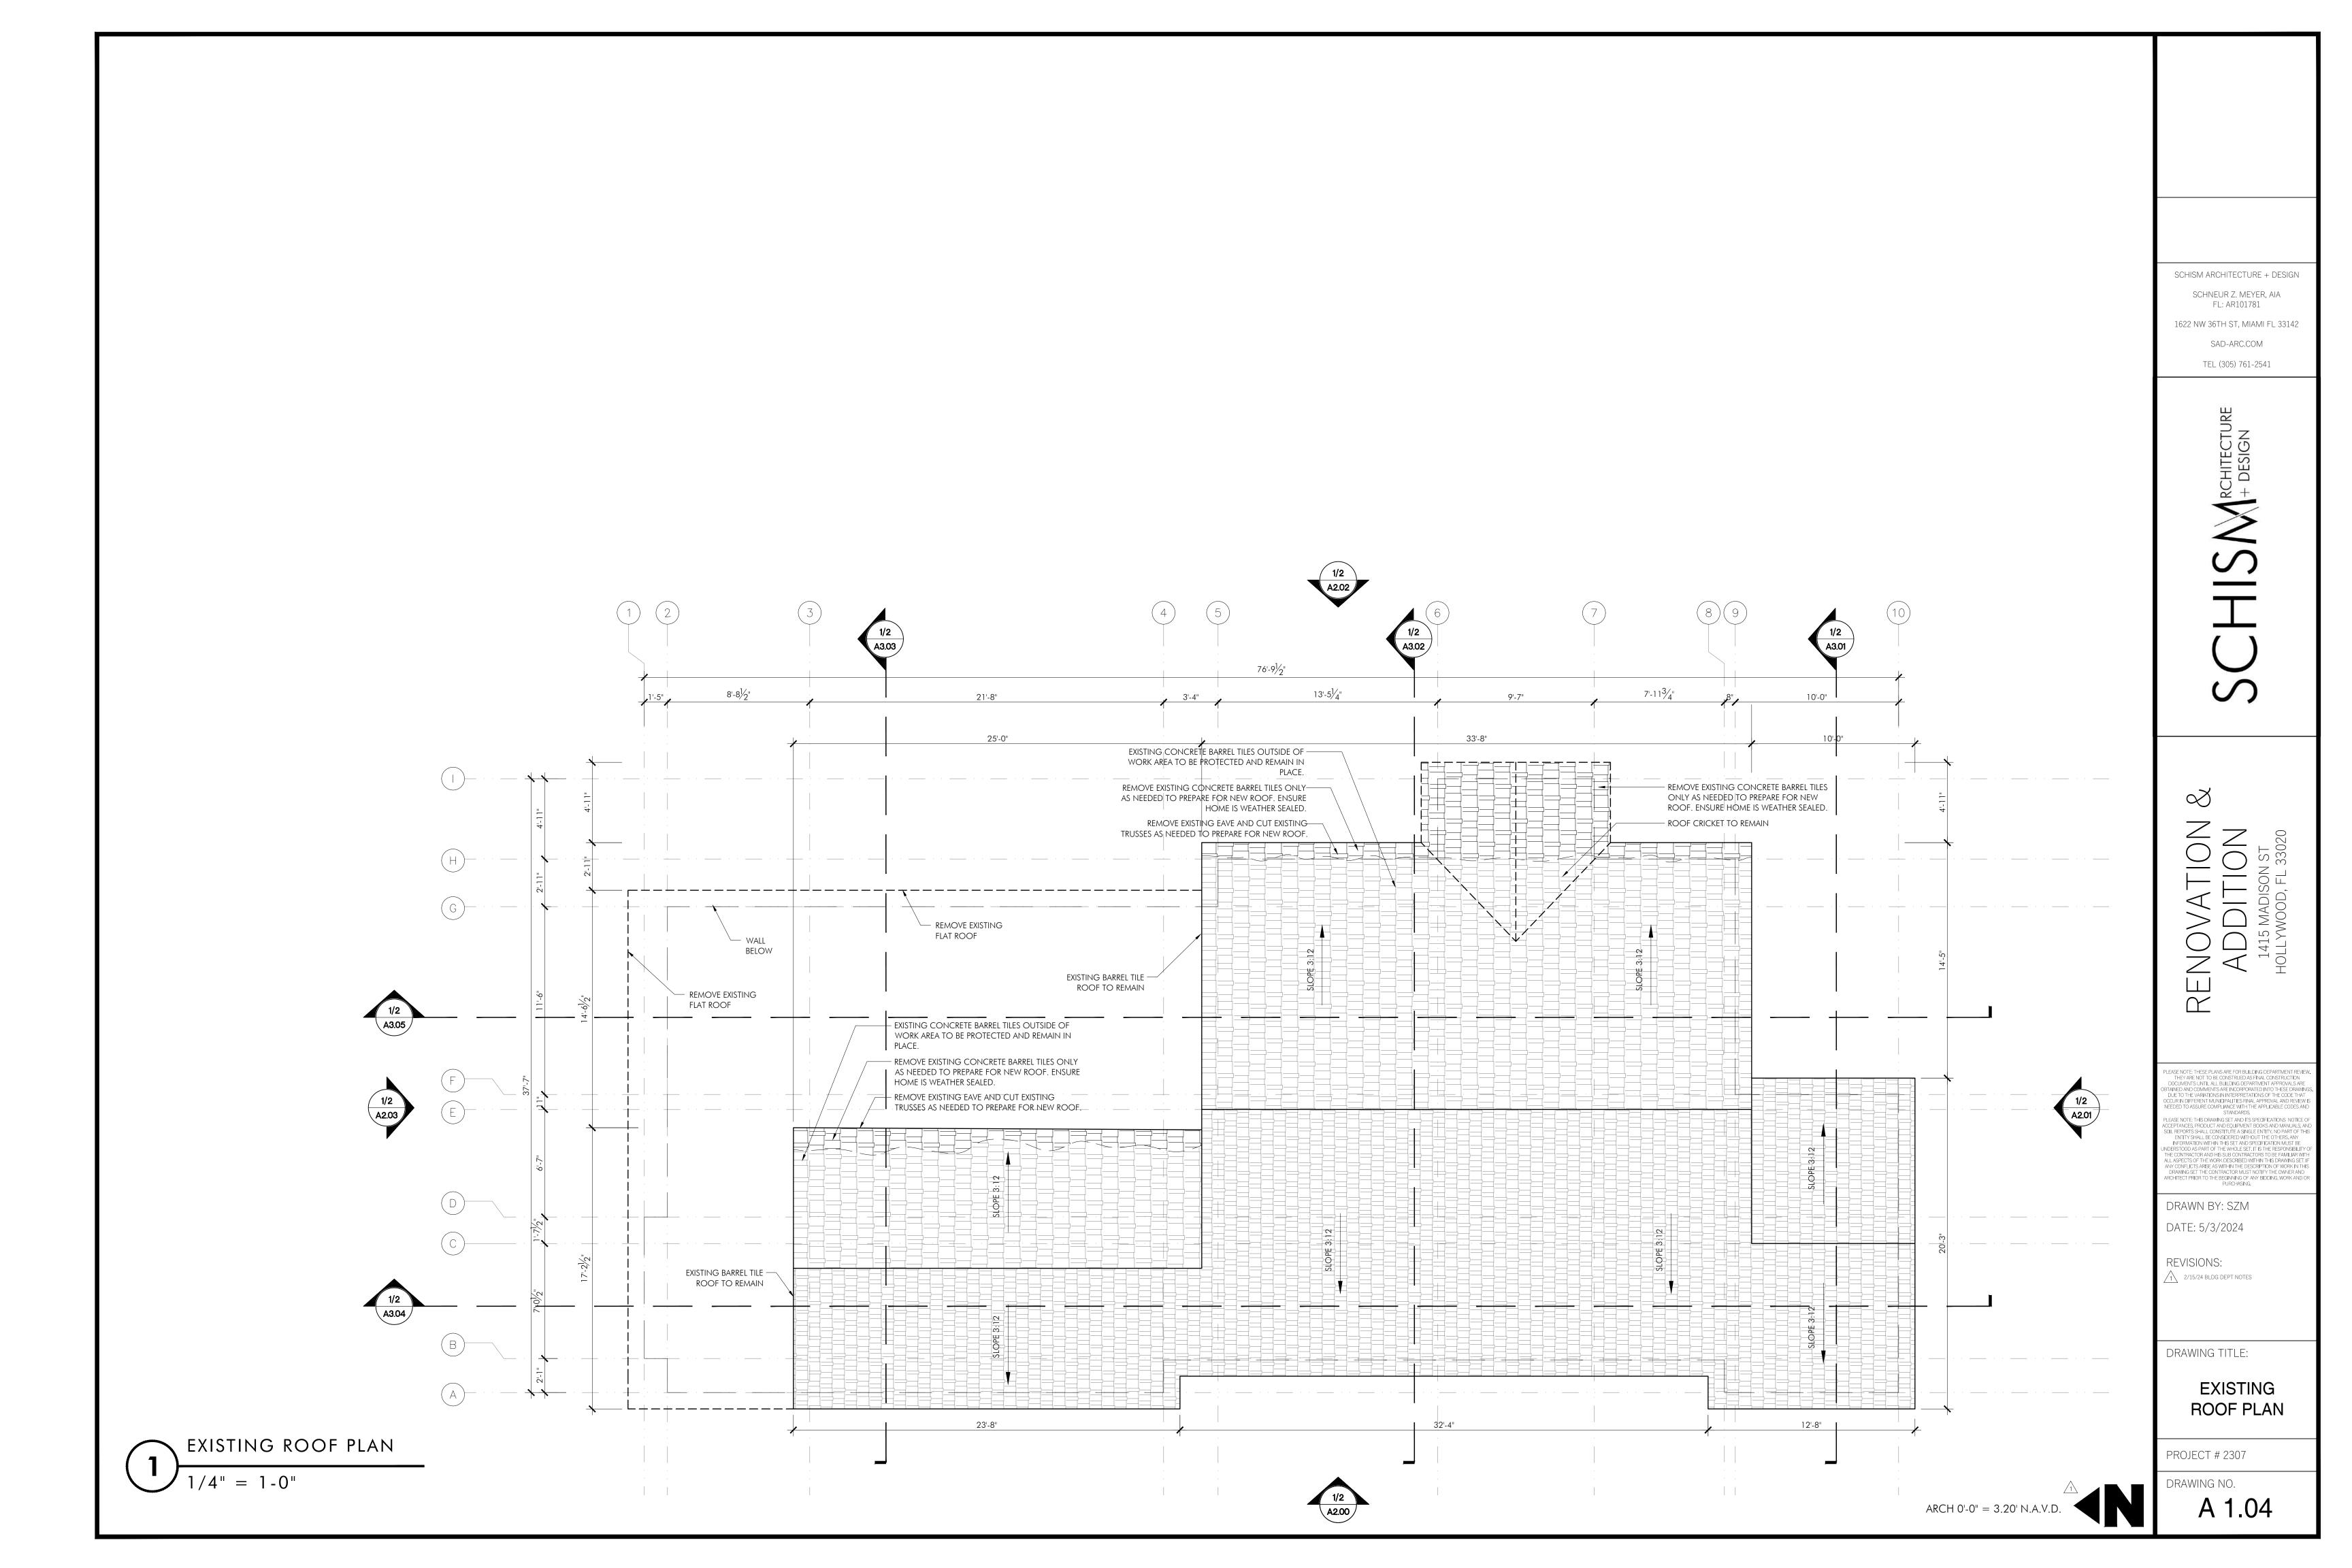
REMOVE PORTION


OF WALL


LAUNDRY




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	NOTES:		EXTERIOR GLAZING INFORMATION:
EXISTING PAINTED 5/8" SMOOTH STUCCO OVER 8" EXTERIOR MASONRY WALL. PATCH STUCCO AND PAINT AS NEEDED.	EXISTING IMPACT RATED ALUMINUM FRAME GLASS DOOR TO REMAIN. SEE DOOR SCHEDULE A801.	REMOVE AREA OF WALL FOR NEW WINDOW/DOOR	
NEW PAINTED 5/8" SMOOTH STUCCO OVER 8" EXTERIOR MASONRY WALL. PAINT TO MATCH EXISTING.	NEW IMPACT RATED ALUMINUM FRAME GLASS DOOR TO MATCH EXISTING. SEE DOOR SCHEDULE SHEET A801.	NEW IMPACT RATED SOLID WOO DENTRY DOOR SEE DOOR SCHEDULE SHEET A801.	ALL EXTERIOR GLAZING IN WINDOWS SHALL BE TEMPERED AND HAVE MIAMI-DADE PRODUCT APPROVAL FOR
<b>03</b> EXISTING BARREL TILE ROOF TO REMAIN. REPAIR AS NEEDED.	13 NEW CONCRETE STAIRS. SEE STRUCTURAL DRAWINGS.		WIND-BORNE DEBRIS PER 1626.1 AND 1626.2 LARGE MISSILE
NEW BARREL TILE ROOF. SEE STRUCTURAL DRAWINGS & ROOF SHEETS A1.04/A1.05	14 EXISTING CONCRETE PLANTER TO REMAIN.		IMPACT TESTS, FBC SEVENTH EDITION (2020).
NEW FLAT WOOD JOIST ROOF. SEE STRUCTURAL DRAWINGS & ROOF SHEETS A1.04/A1.05	15 NEW CONCRETE BREEZE BLOCK TO BE SELECTED BY OWNER, APPROVED BY ARCHITECT.		EXTERIOR GLAZING SHALL COMPLY WITH 2411.3.2.1.
METAL FLASHING ALL AROUND AT ALL ROOFS. SEE 3/A105	16 DECORATIVE CONCRETE EMBLEM TO REMAIN.		
NEW IMPACT RATED ALUMINUM FRAME WINDOW TO MATCH EXISTING. SEE WINDOW SCHEDULE SHEET A802.	17 NEW DECORATIVE CONCRETE EMBLEM TO MATCH EXISTING.		
<b>08</b> EXISTING IMPACT RATED WINDOW TO REMAIN. SEE WINDOW SCHEDULE SHEET A802.	18 NEW ROOF BEYOND.		DESIGN WIND PRESSURES:
existing but relocated impact rated window to remain. See window schedule sheet a802.	19 GUTTER / DOWNSPOUT		SEE STRUCTURAL RIVOS
10 PHANTOM LINE FOR PREVIOUS EXISTING OPENING BEYOND.	TO BE REMOVED		SEE STRUCTURAL DWGS

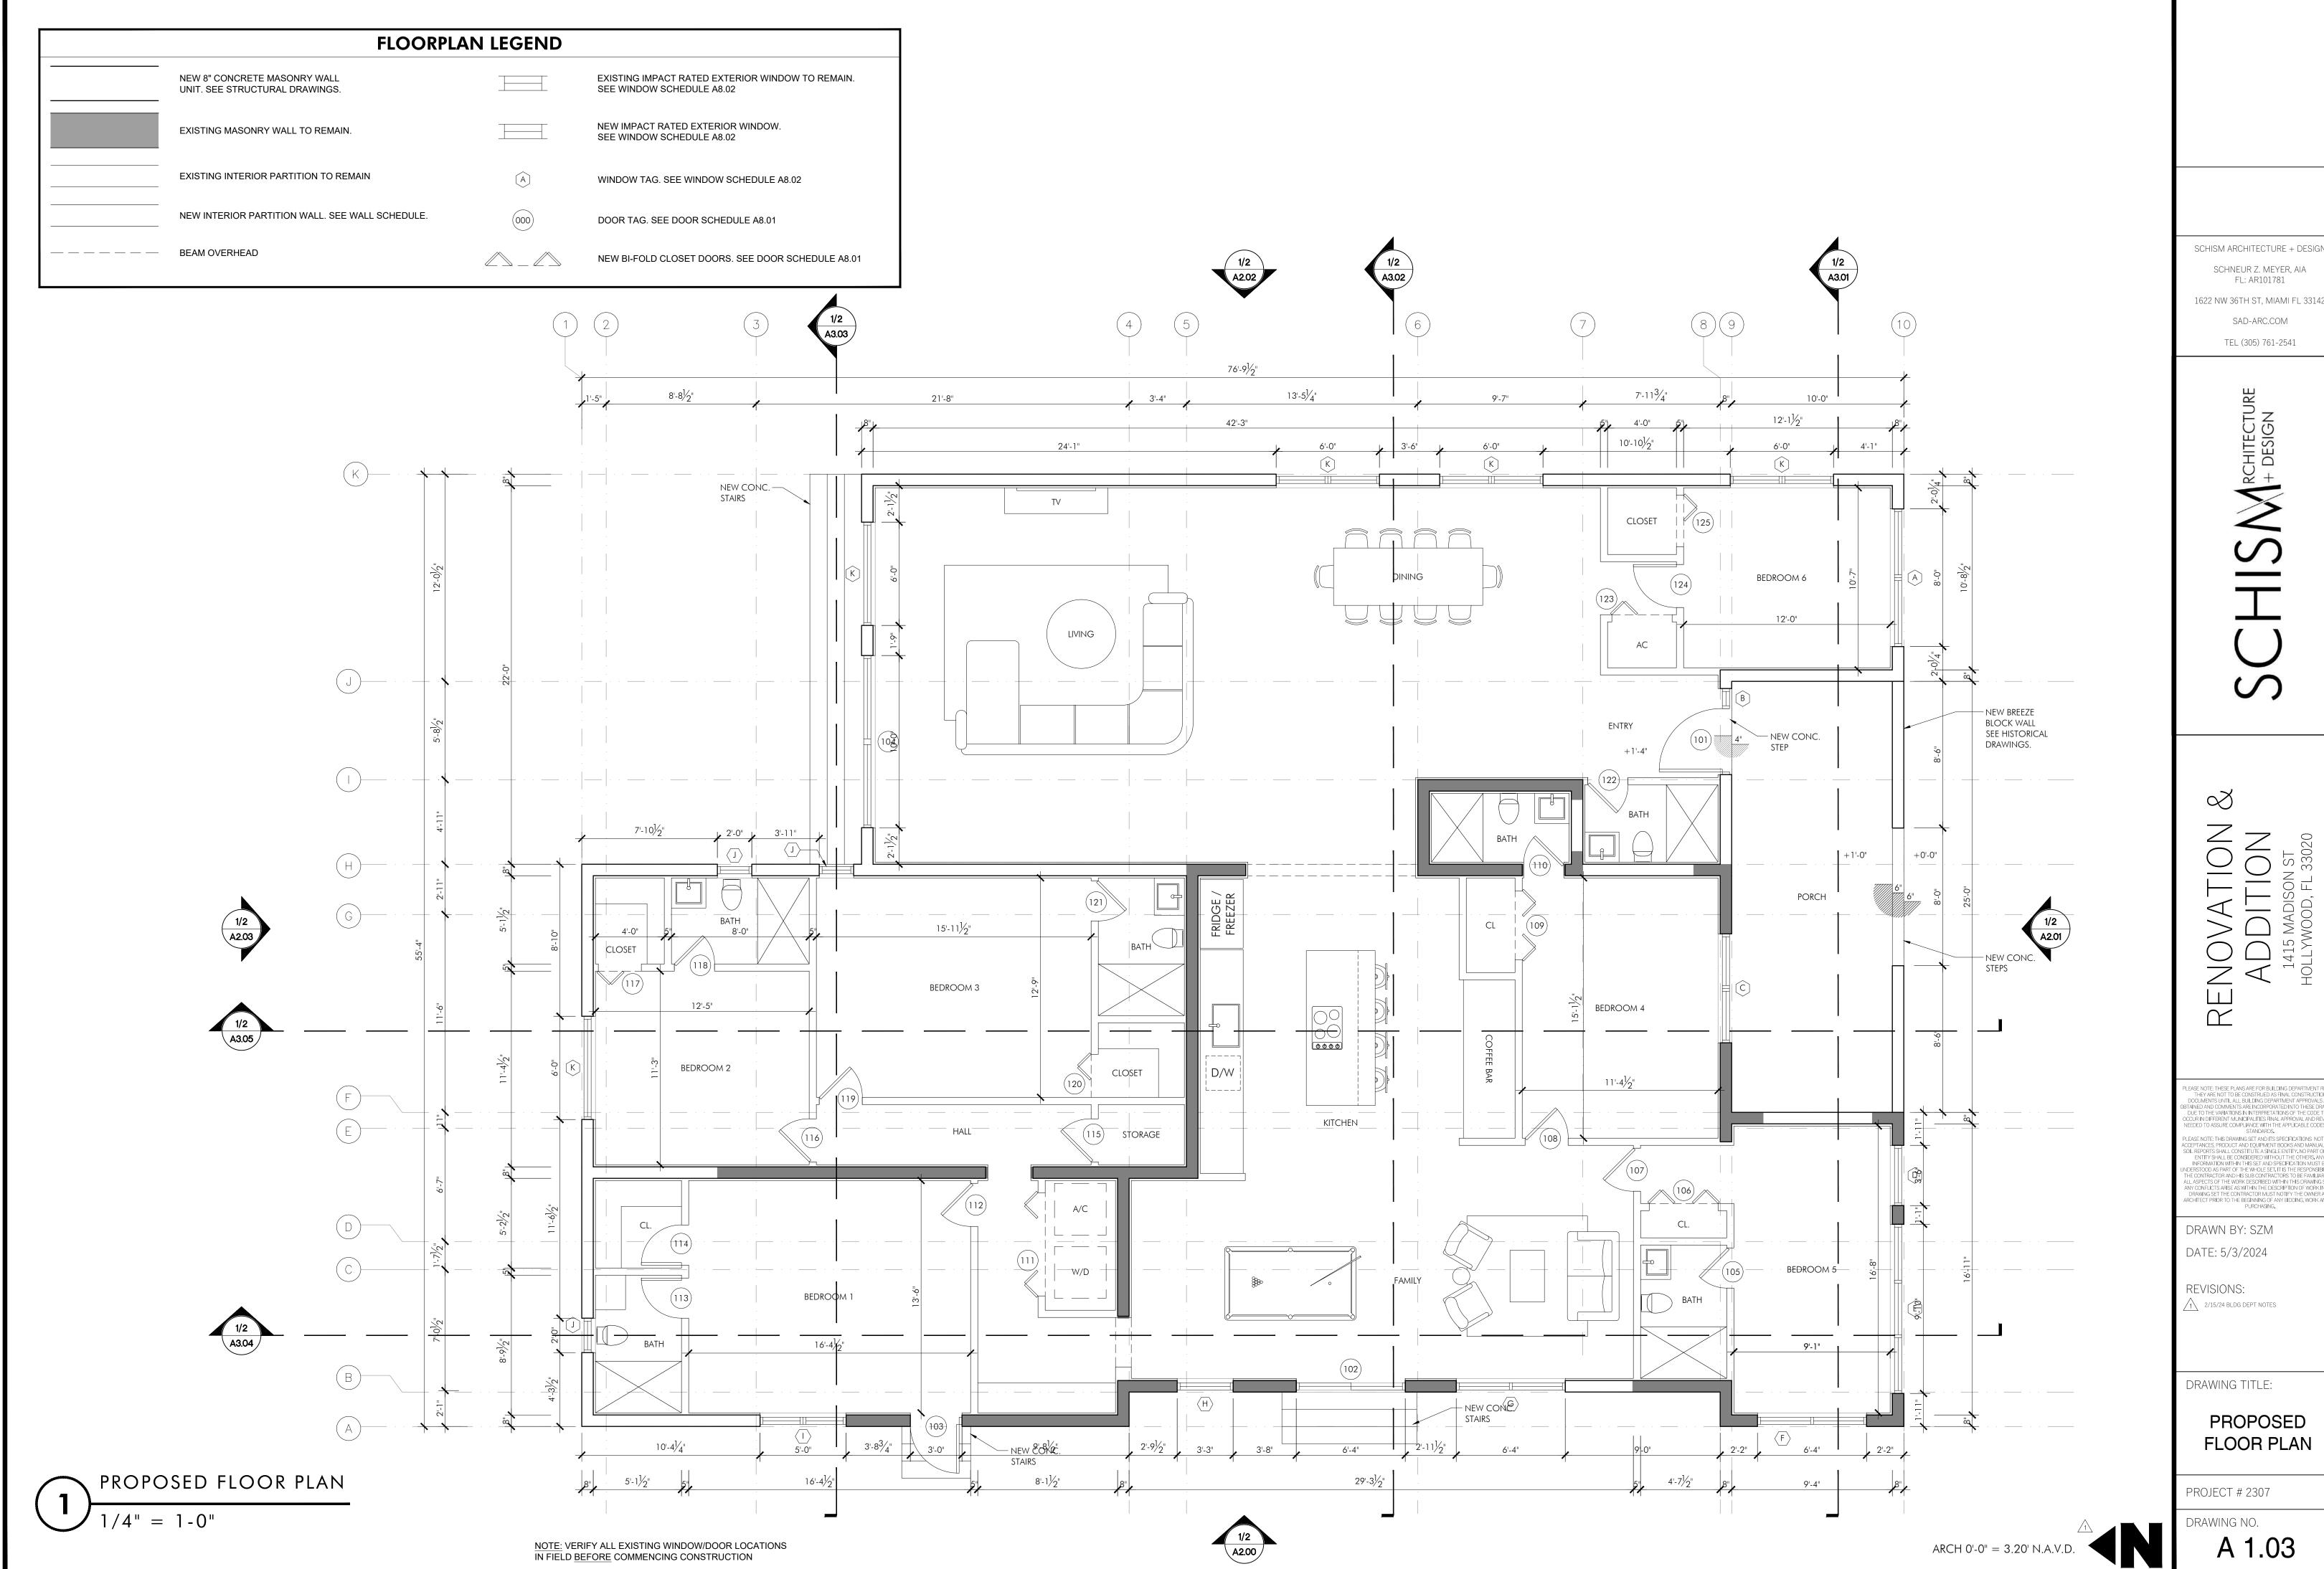SCHISM ARCHITECTURE + DESIGN

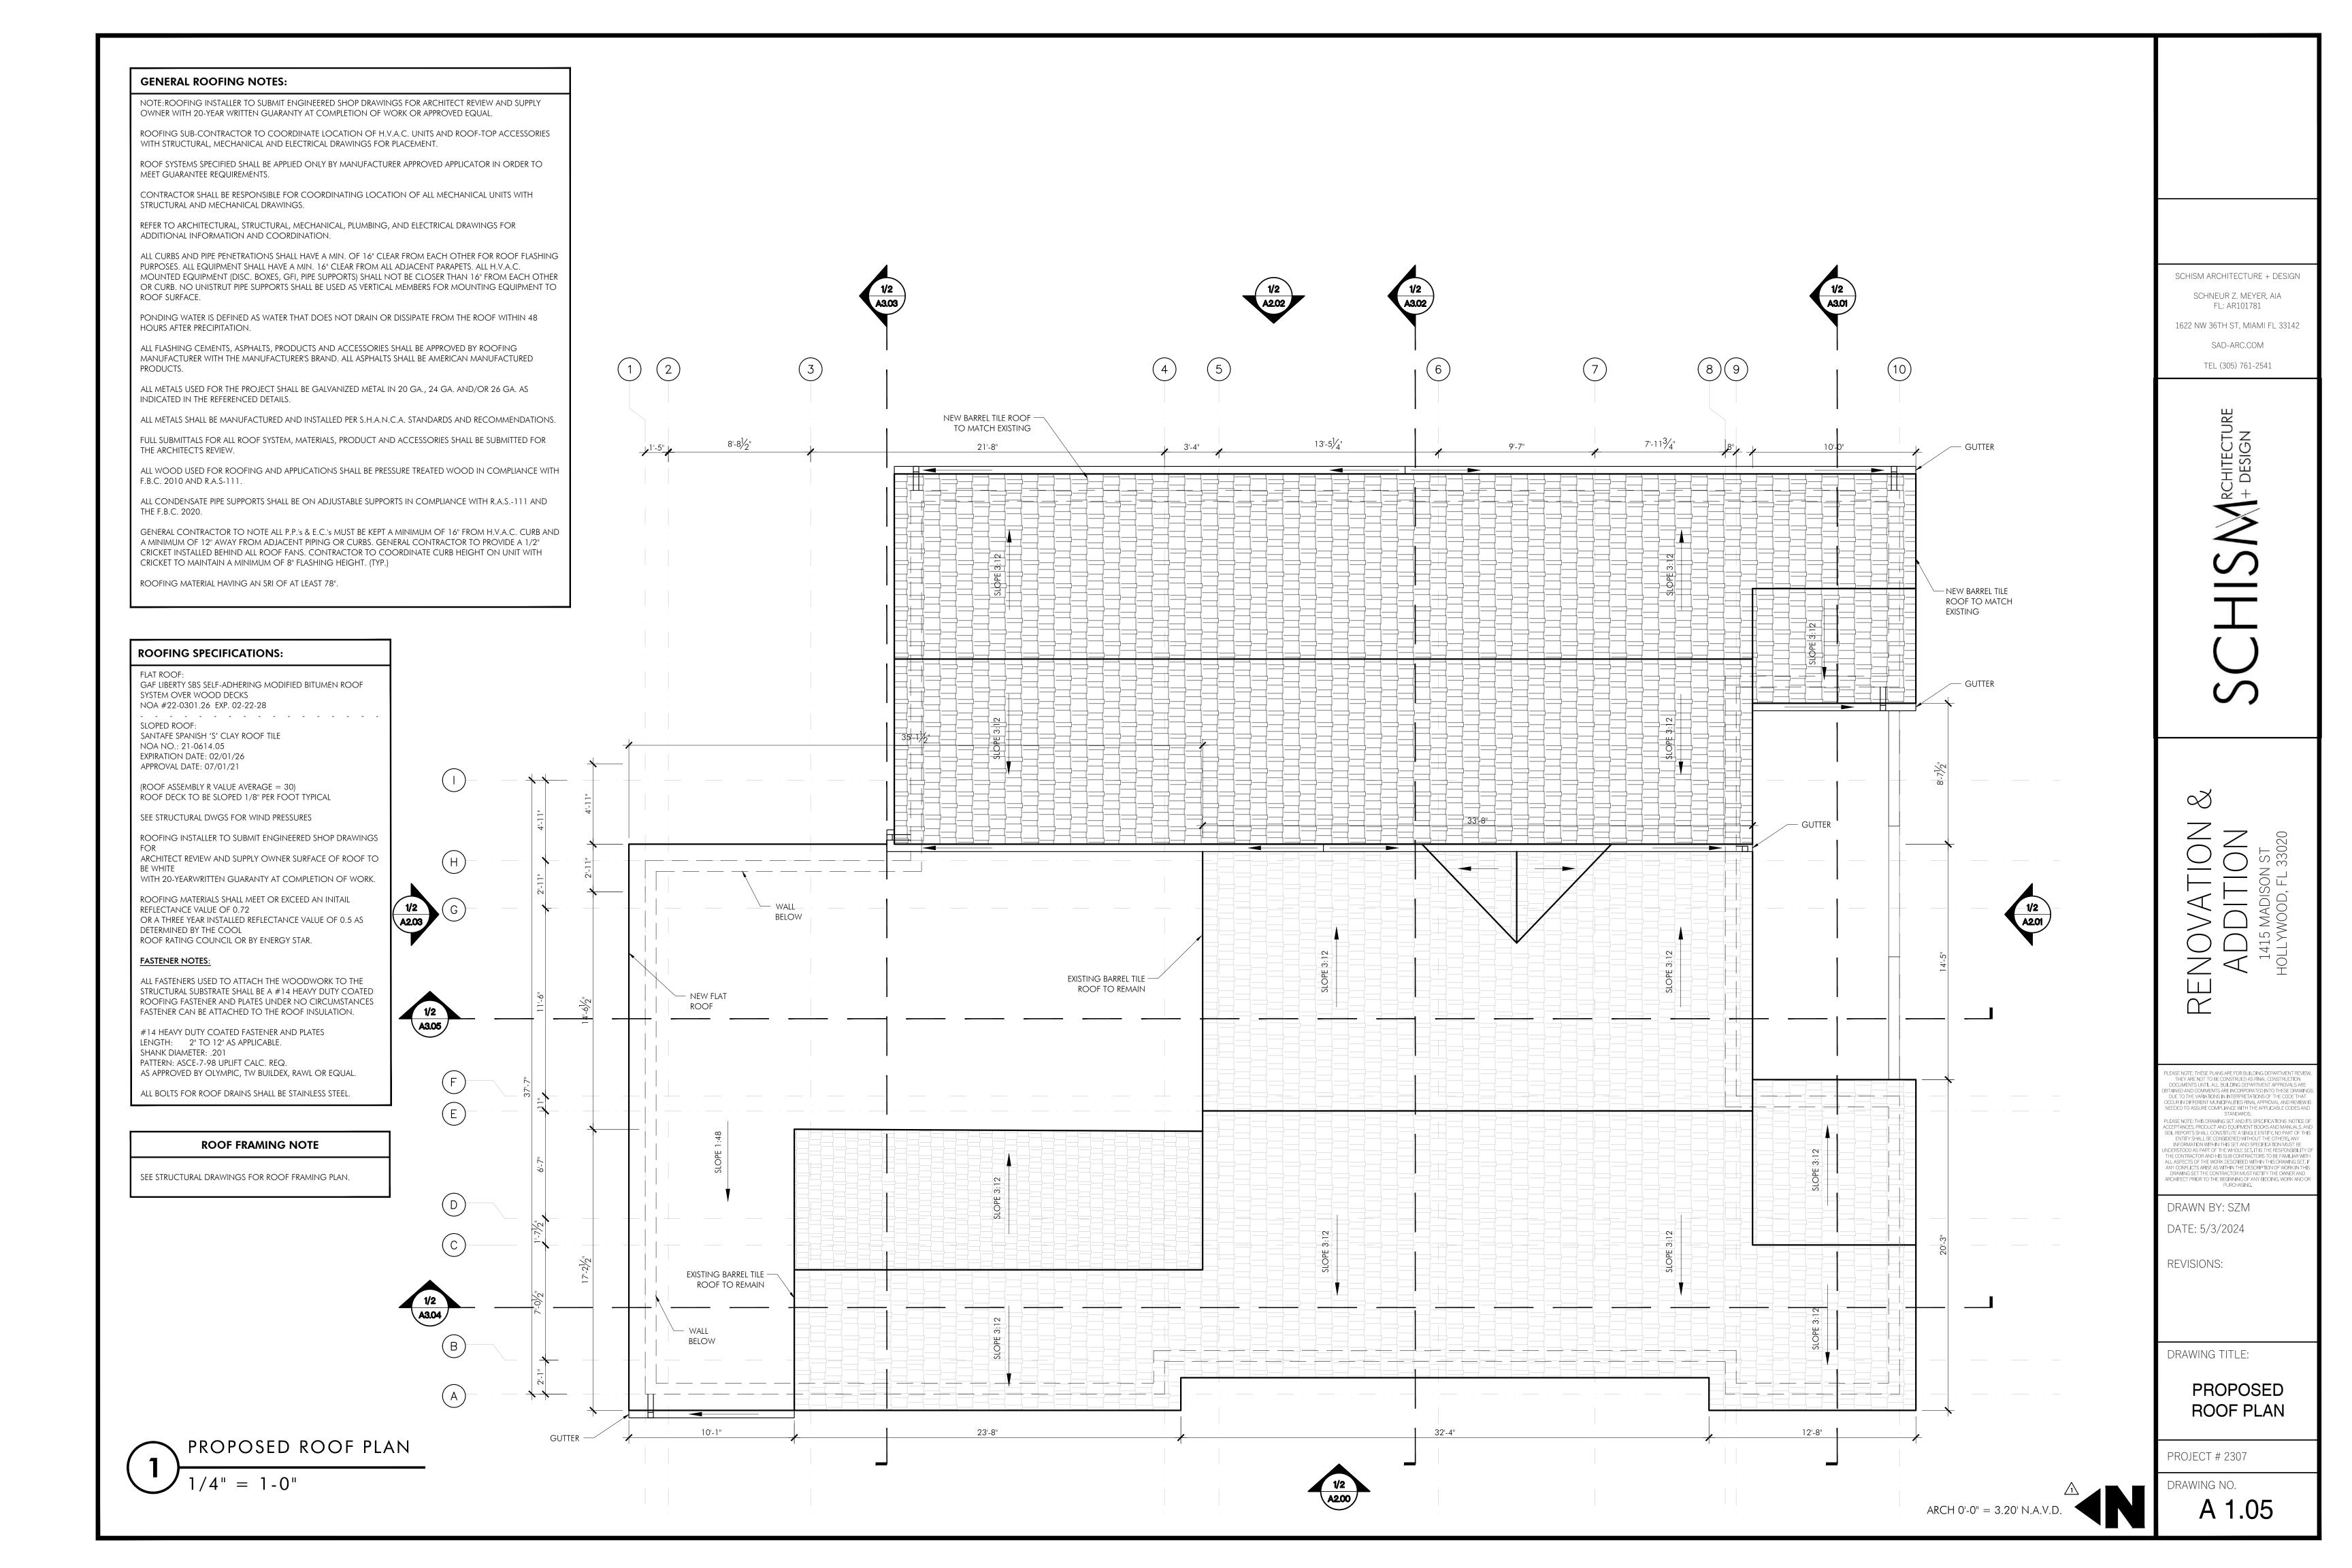SCHNEUR Z. MEYER, AIA
FL: AR101781

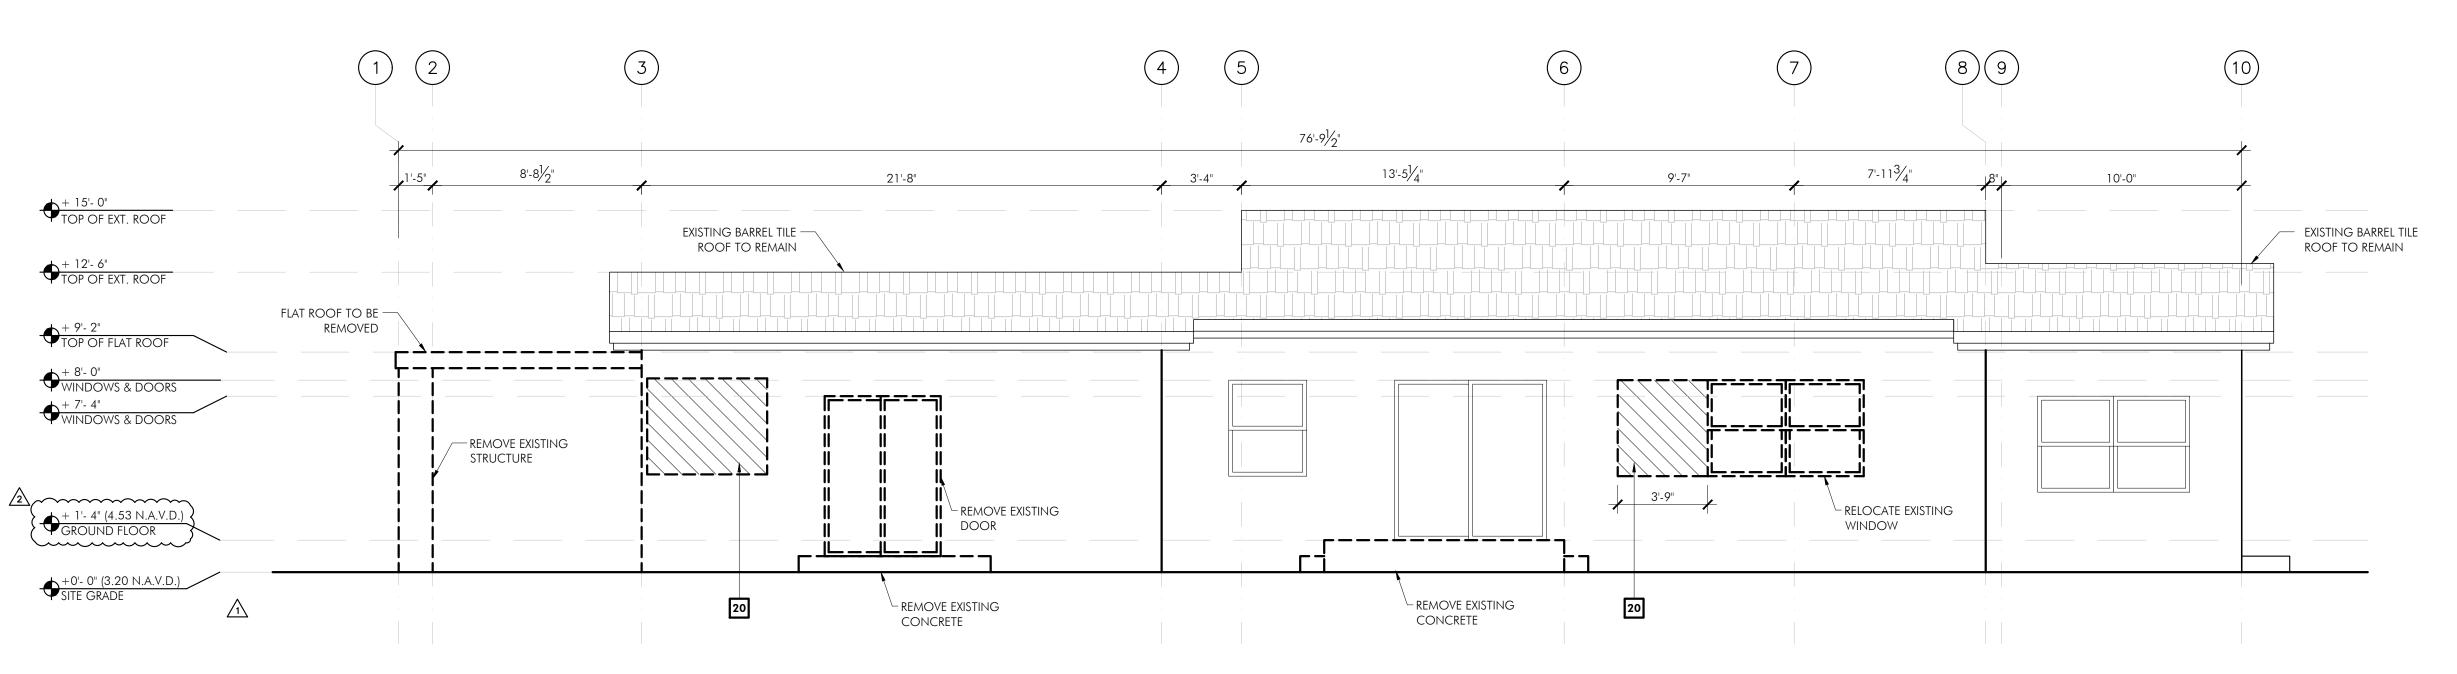1622 NW 36TH ST, MIAMI FL 33142

1622 NW 36TH ST, MIAMI FL 33: SAD-ARC.COM TEL (305) 761-2541

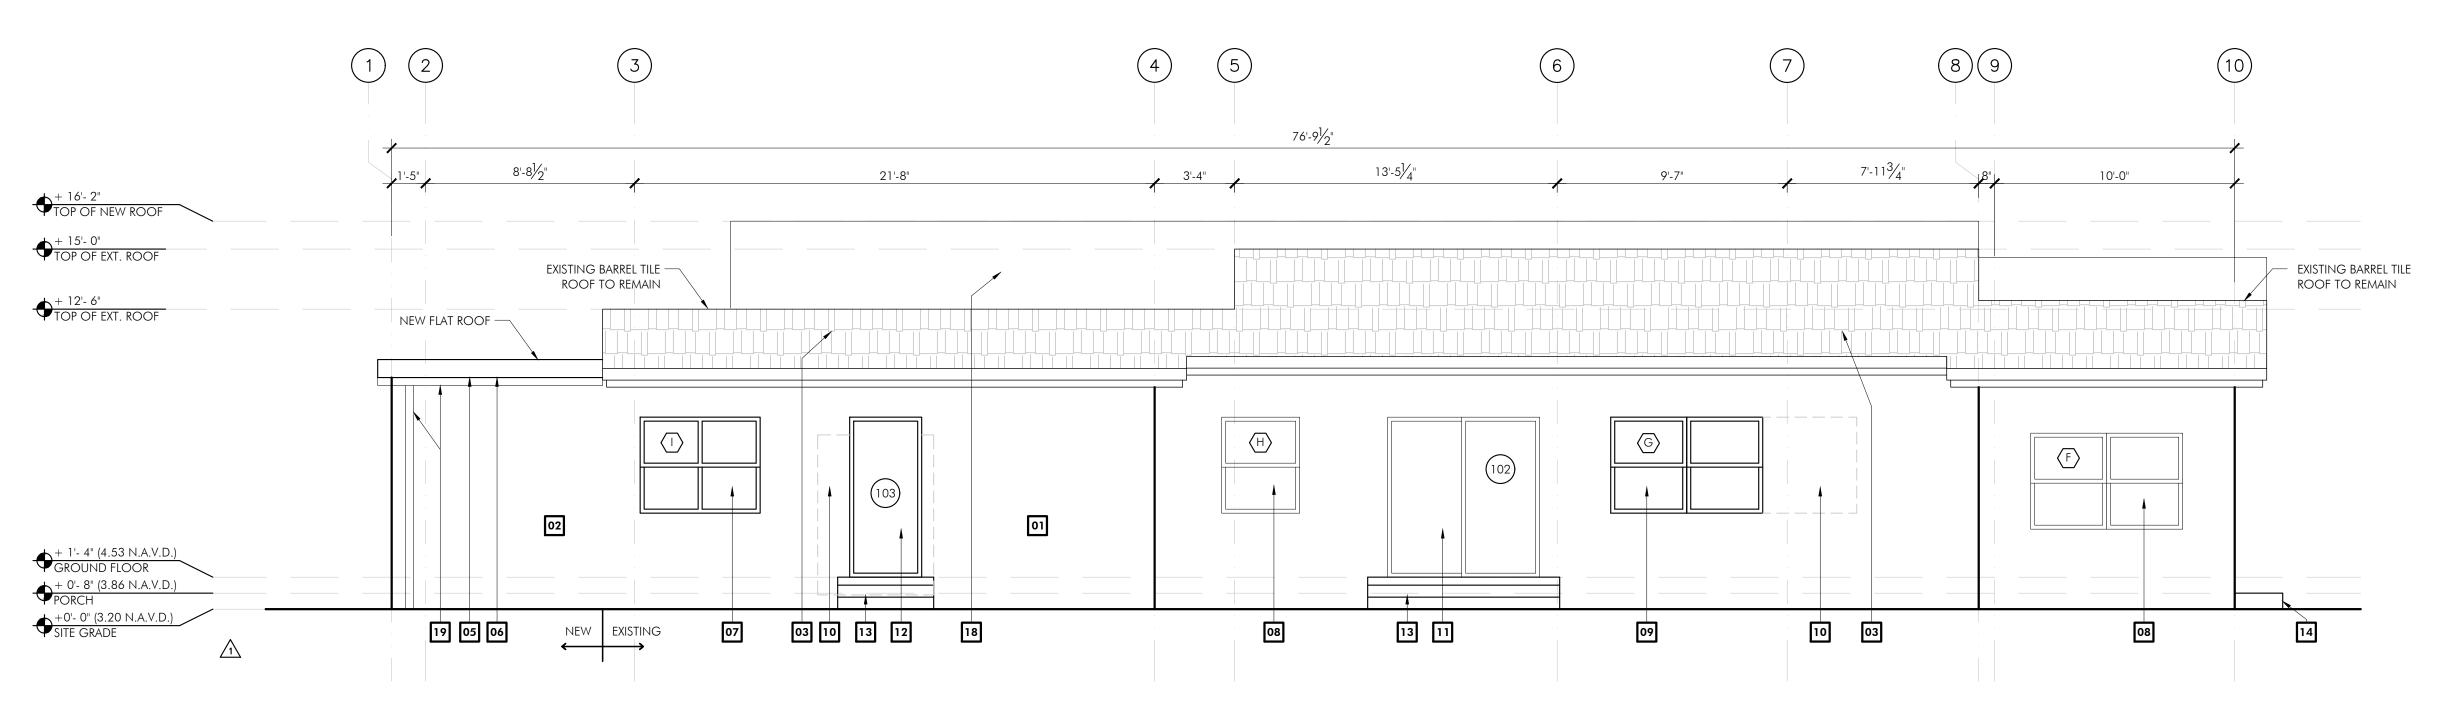CHITECTURE + DESIGN

RENOVATION & ADDITION

1415 MADISON ST
HOLLYWOOD, FL 33020

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PURCHASING.

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REVISIONS:

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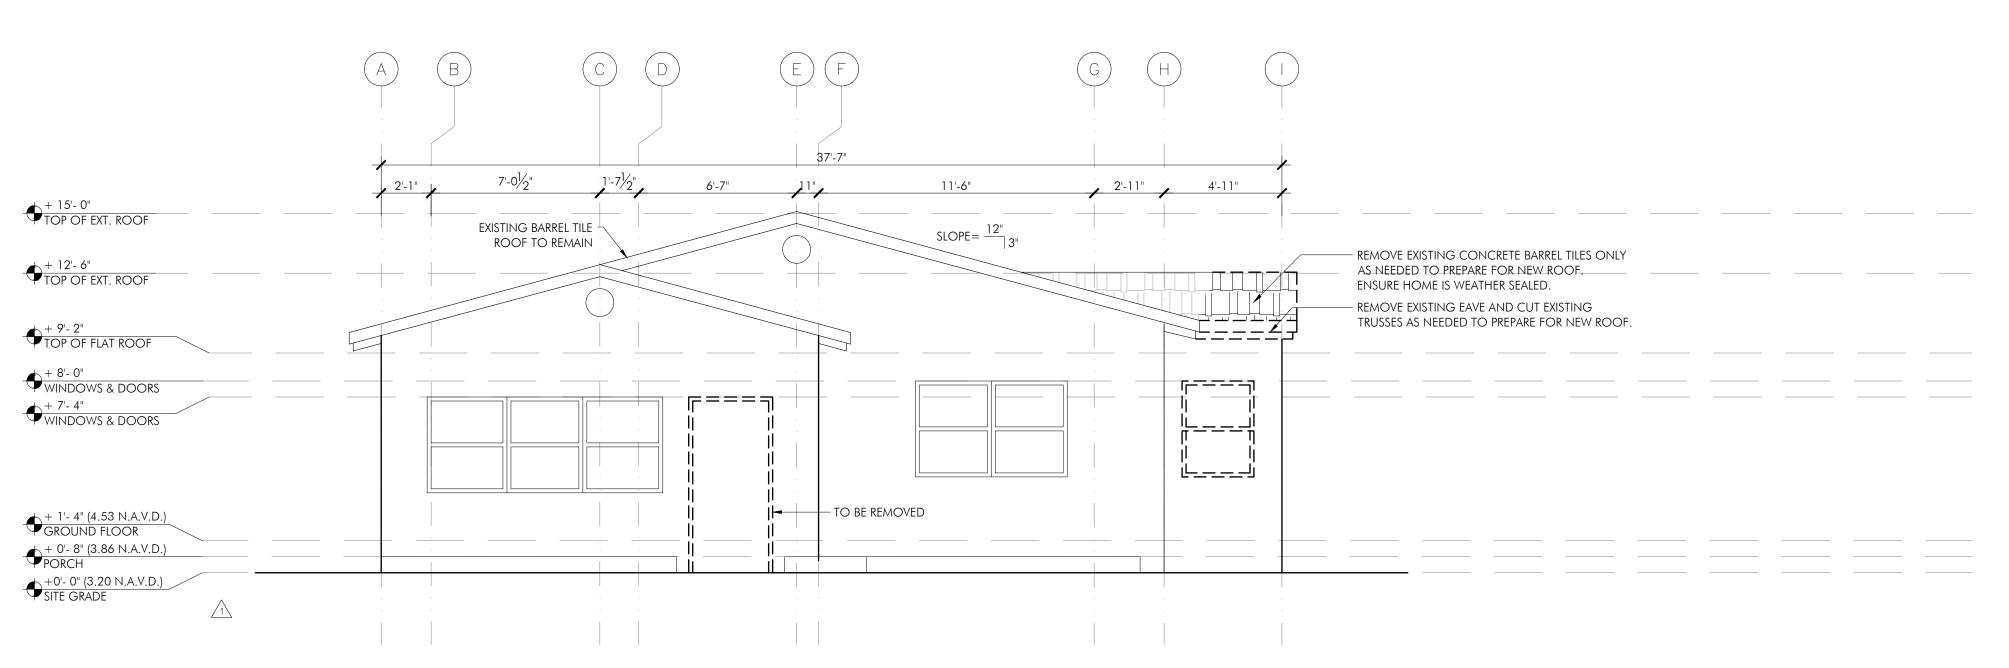
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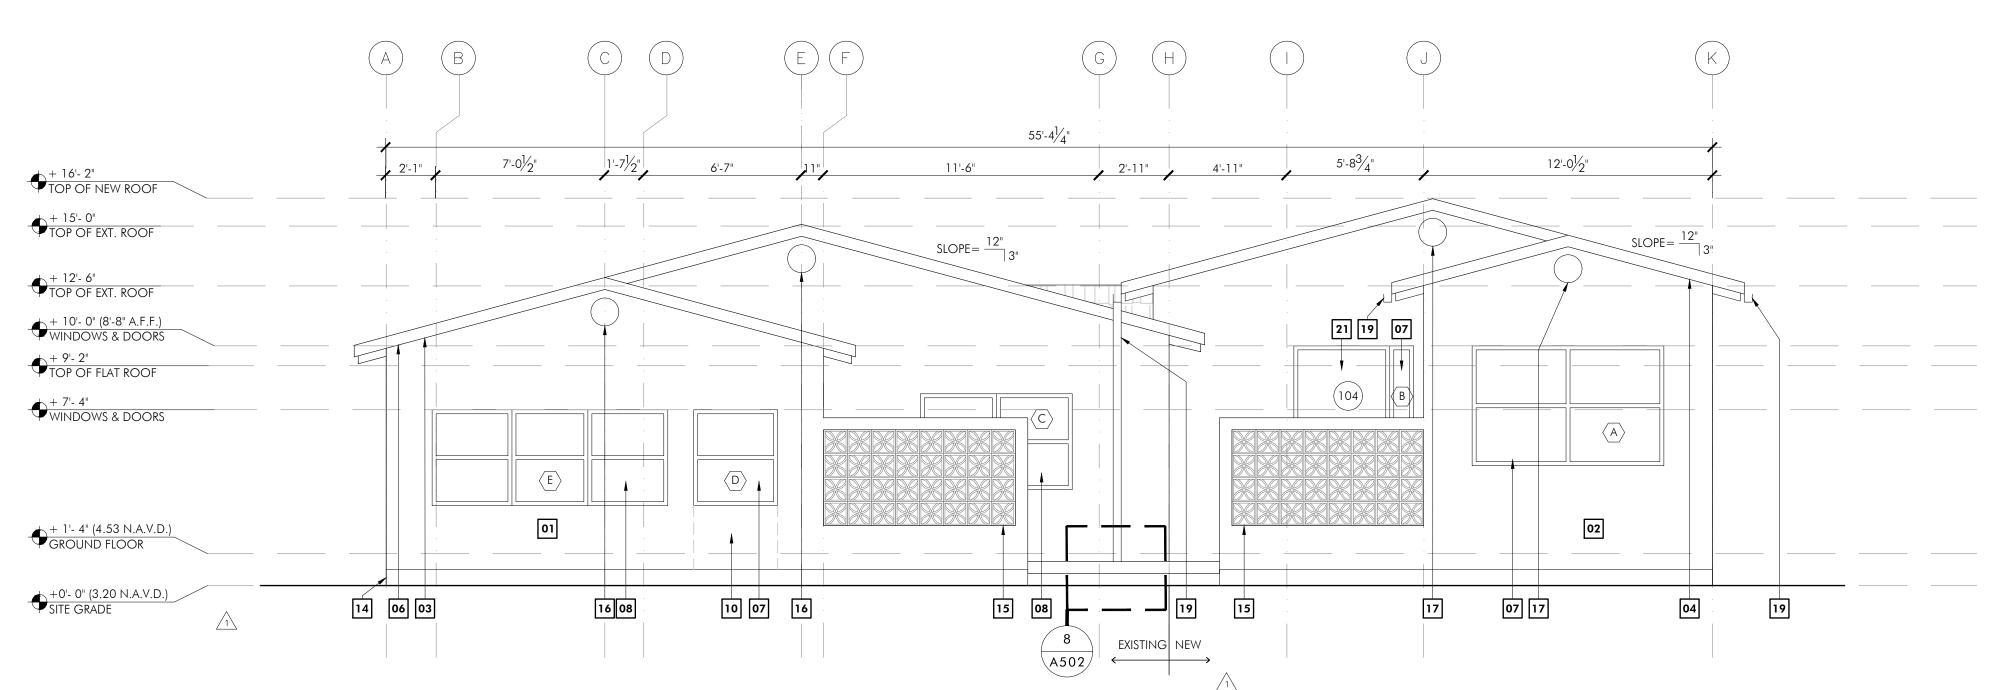
WEST ELEVATIONS

PROJECT # 2307

DRAWING NO.



# EXISTING SOUTH ELEVATION 1/4" = 1-0"



# PROPOSED SOUTH ELEVATION 1/4" = 1-0"

	NOTES:	
<b>01</b> EXISTING PAINTED 5/8" SMOOTH STUCCO OVER 8" EXTERIOR MASONRY WALL. PATCH STUCCO AND PAINT AS NEEDED.	EXISTING IMPACT RATED ALUMINUM FRAME GLASS DOOR TO REMAIN. SEE DOOR SCHEDULE A801.	REMOVE AREA OF WALL FOR NEW WINDOW/DOOR
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<b>O9</b> EXISTING BUT RELOCATED IMPACT RATED WINDOW TO REMAIN. SEE WINDOW SCHEDULE SHEET A802.	19 GUTTER / DOWNSPOUT	
10 PHANTOM LINE FOR PREVIOUS EXISTING OPENING BEYOND.	TO BE REMOVED	

## EXTERIOR GLAZING INFORMATION:

ALL EXTERIOR GLAZING IN WINDOWS SHALL BE TEMPERED AND HAVE MIAMI-DADE PRODUCT APPROVAL FOR WIND-BORNE DEBRIS PER 1626.1 AND 1626.2 LARGE MISSILE IMPACT TESTS, FBC SEVENTH EDITION (2020).

EXTERIOR GLAZING SHALL COMPLY WITH 2411.3.2.1.

DESIGN WIND PRESSURES:

SEE STRUCTURAL DWGS

SCHISM ARCHITECTURE + DESIGN

SCHNEUR Z. MEYER, AIA
FL: AR101781

1622 NW 36TH ST, MIAMI FL 33142 SAD-ARC.COM TEL (305) 761-2541

CHITECTURE + DESIGN

RENOVATION & ADDITION 1415 MADISON ST

PLEASE NOTE: THESE PLANS ARE FOR BUILDING DEPARTMENT REVIEW THEY ARE NOT TO BE CONSTRUED AS FINAL CONSTRUCTION DOCUMENTS UNTIL ALL BUILDING DEPARTMENT APPROVALS ARE OBTAINED AND COMMENTS ARE INCORPORATED INTO THESE DRAWING DUE TO THE VARIATIONS IN INTERPRETATIONS OF THE CODE THAT OCCUR IN DIFFERENT MUNICIPALITIES FINAL APPROVAL AND REVIEW INSEDED TO ASSURE COMPLIANCE WITH THE APPLICABLE CODES AND STANDARDS.

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DRAWN BY: SZM DATE: 5/3/2024

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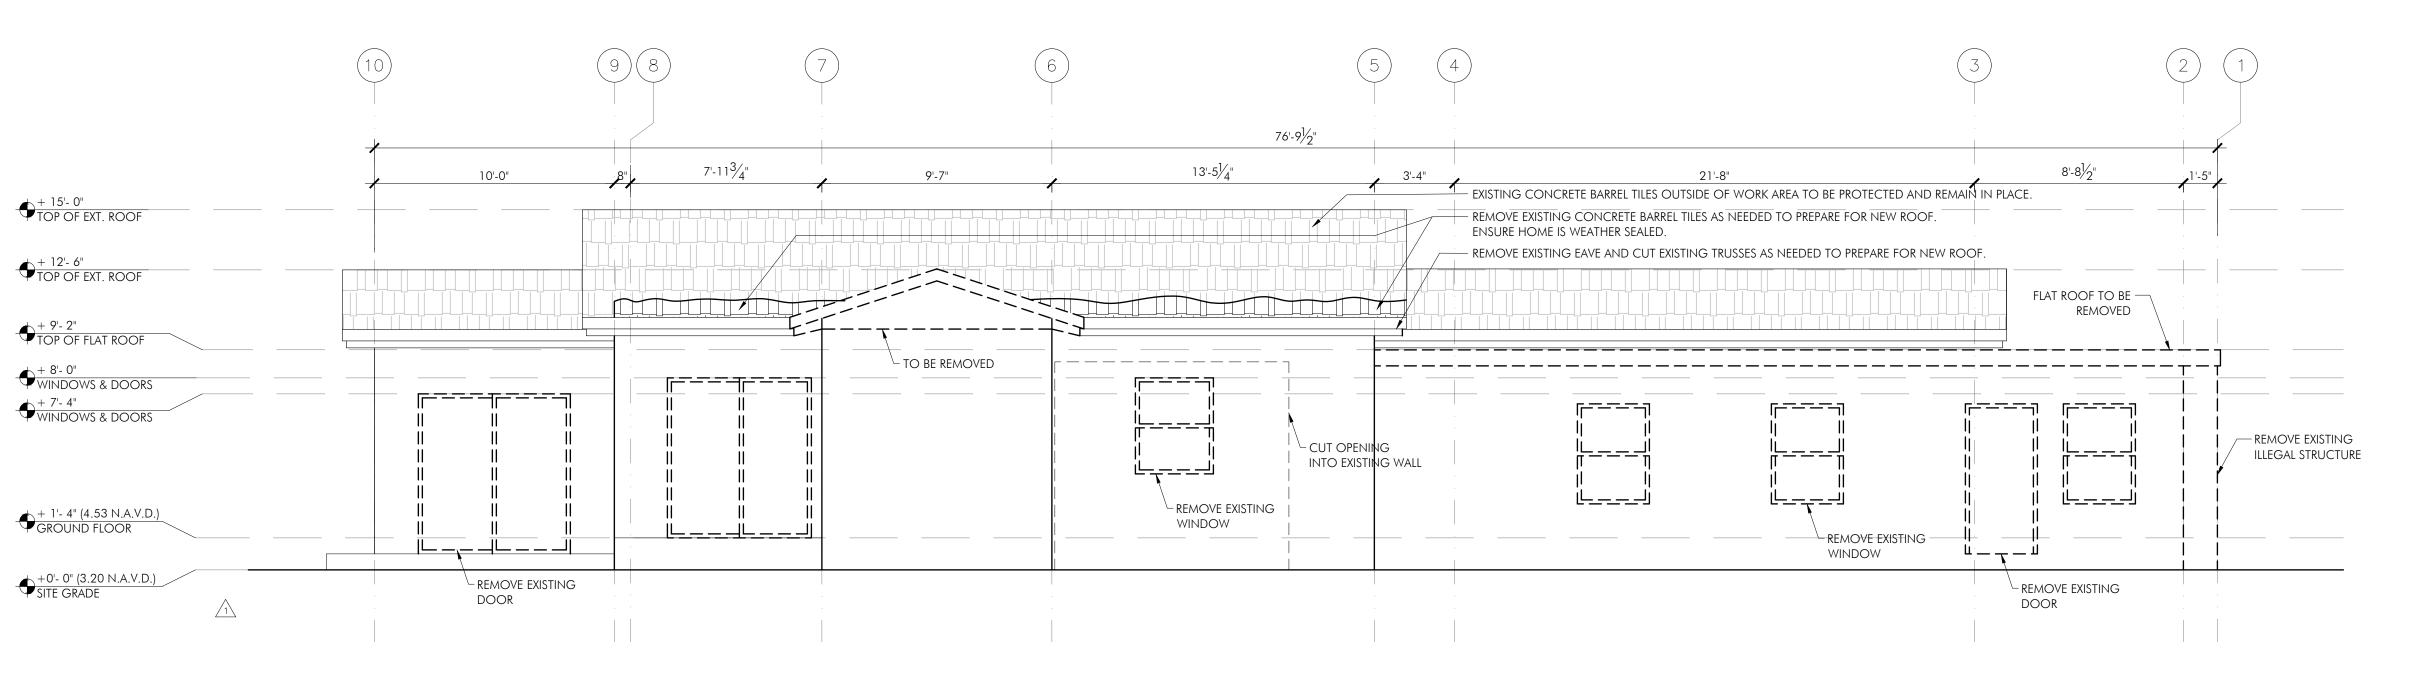
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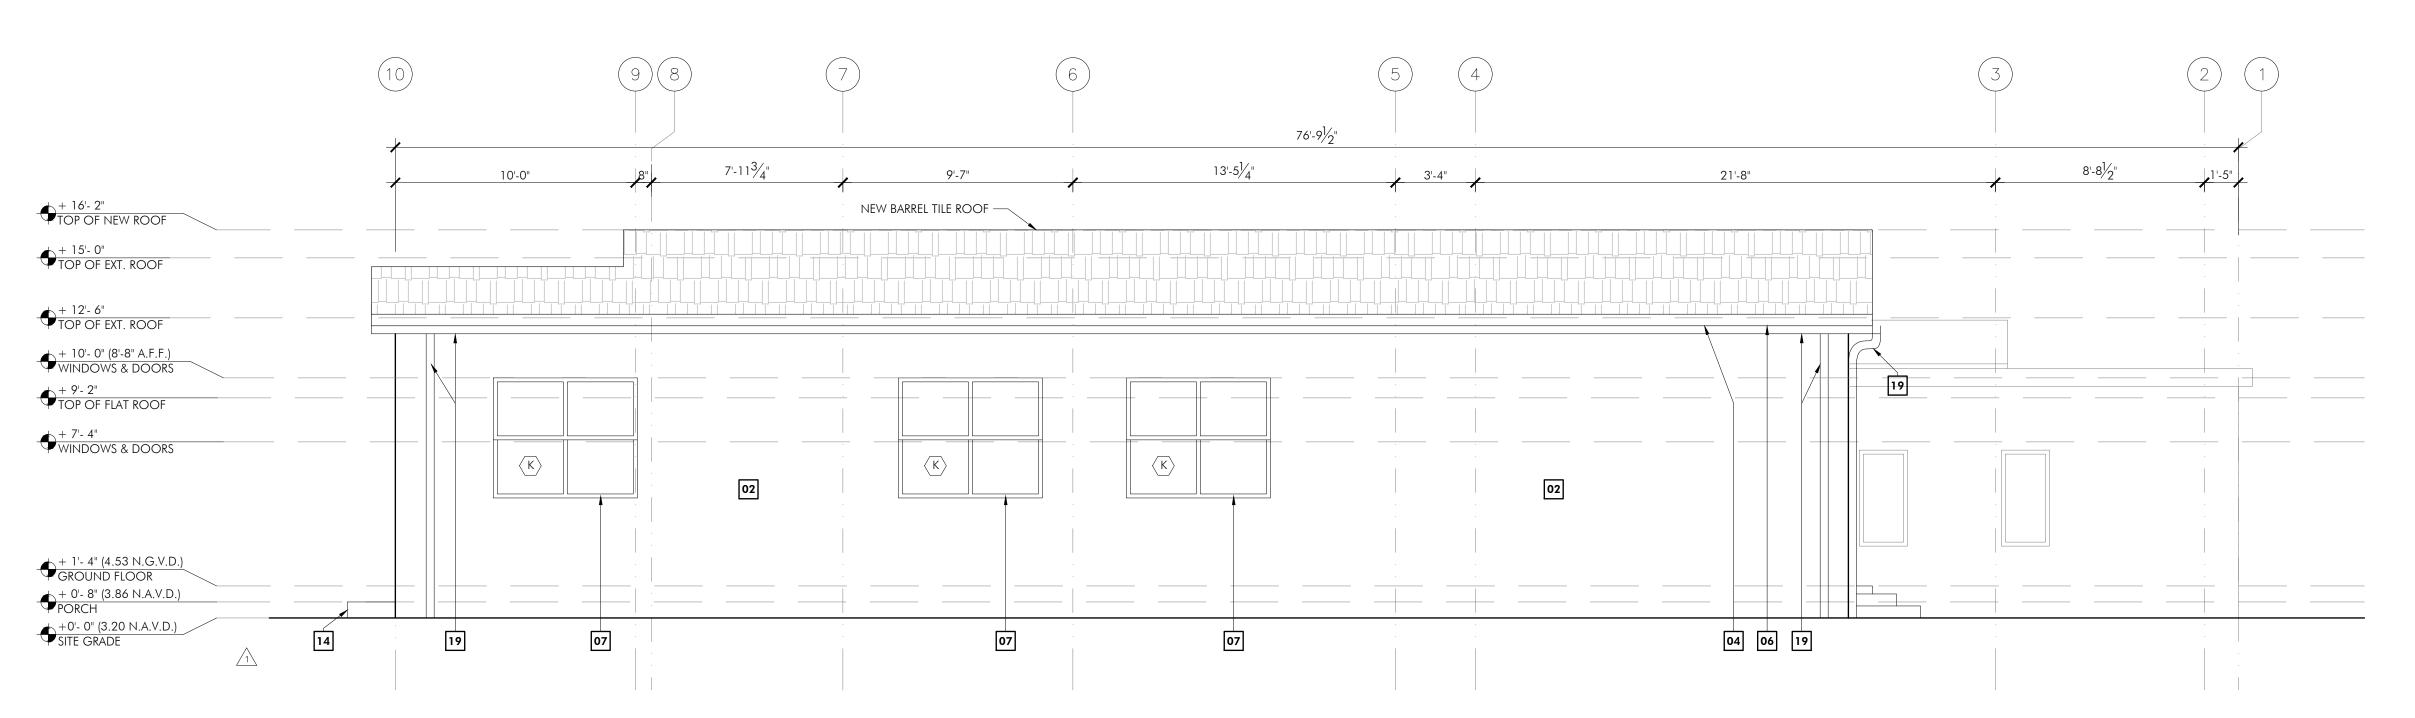
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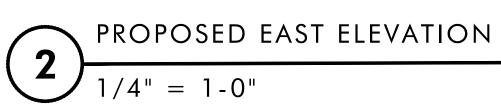
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DRAWING NO.









	EXTERIOR GLAZING INFORMATION:		
EXISTING PAINTED 5/8" SMOOTH STUCCO OVER 8" EXTERIOR MASONRY WALL. PATCH STUCCO AND PAINT AS NEEDED.	EXISTING IMPACT RATED ALUMINUM FRAME GLASS DOOR TO REMAIN. SEE DOOR SCHEDULE A801.	20 REMOVE AREA OF WALL FOR NEW WINDOW/DOOR	
NEW PAINTED 5/8" SMOOTH STUCCO OVER 8" EXTERIOR MASONRY WALL. PAINT TO MATCH EXISTING.	NEW IMPACT RATED ALUMINUM FRAME GLASS DOOR TO MATCH EXISTING. SEE DOOR SCHEDULE SHEET A801.	NEW IMPACT RATED SOLID WOO DENTRY DOOR SEE DOOR SCHEDULE SHEET A801.	all exterior glazing in windows shall be tempered
EXISTING BARREL TILE ROOF TO REMAIN. REPAIR AS NEEDED.	13 NEW CONCRETE STAIRS. SEE STRUCTURAL DRAWINGS.		AND HAVE MIAMI-DADE PRODUCT APPROVAL FOR WIND-BORNE DEBRIS PER 1626.1 AND 1626.2 LARGE MISSIL
NEW BARREL TILE ROOF. SEE STRUCTURAL DRAWINGS & ROOF SHEETS A1.04/A1.05	14 EXISTING CONCRETE PLANTER TO REMAIN.		IMPACT TESTS, FBC SEVENTH EDITION (2020).
NEW FLAT WOOD JOIST ROOF. SEE STRUCTURAL DRAWINGS & ROOF SHEETS A1.04/A1.05	15 NEW CONCRETE BREEZE BLOCK TO BE SELECTED BY OWNER, APPROVED BY ARCHITECT.		EXTERIOR GLAZING SHALL COMPLY WITH 2411.3.2.1.
METAL FLASHING ALL AROUND AT ALL ROOFS. SEE 3/A105	16 DECORATIVE CONCRETE EMBLEM TO REMAIN.		
NEW IMPACT RATED ALUMINUM FRAME WINDOW TO MATCH EXISTING. SEE WINDOW SCHEDULE SHEET A802.	NEW DECORATIVE CONCRETE EMBLEM TO MATCH EXISTING.		
EXISTING IMPACT RATED WINDOW TO REMAIN. SEE WINDOW SCHEDULE SHEET A802.	18 NEW ROOF BEYOND.		DESIGN WIND PRESSURES:
<b>O9</b> EXISTING BUT RELOCATED IMPACT RATED WINDOW TO REMAIN. SEE WINDOW SCHEDULE SHEET A802.	19 GUTTER / DOWNSPOUT		
10 PHANTOM LINE FOR PREVIOUS EXISTING OPENING BEYOND.	TO BE REMOVED		SEE STRUCTURAL DWGS

SCHNEUR Z. MEYER, AIA FL: AR101781 1622 NW 36TH ST, MIAMI FL 33142

SCHISM ARCHITECTURE + DESIGN

SAD-ARC.COM TEL (305) 761-2541

CHITECTURE + DESIGN

RENOVATION & ADDITION 1415 MADISON ST

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PURCHASING.

DRAWN BY: SZM DATE: 5/3/2024

REVISIONS:

2/15/24 BLDG DEPT NOTES


DRAWING TITLE:

EAST ELEVATIONS

PROJECT # 2307

DRAWING NO.

# EXISTING NORTH ELEVATION 1/4" = 1-0"

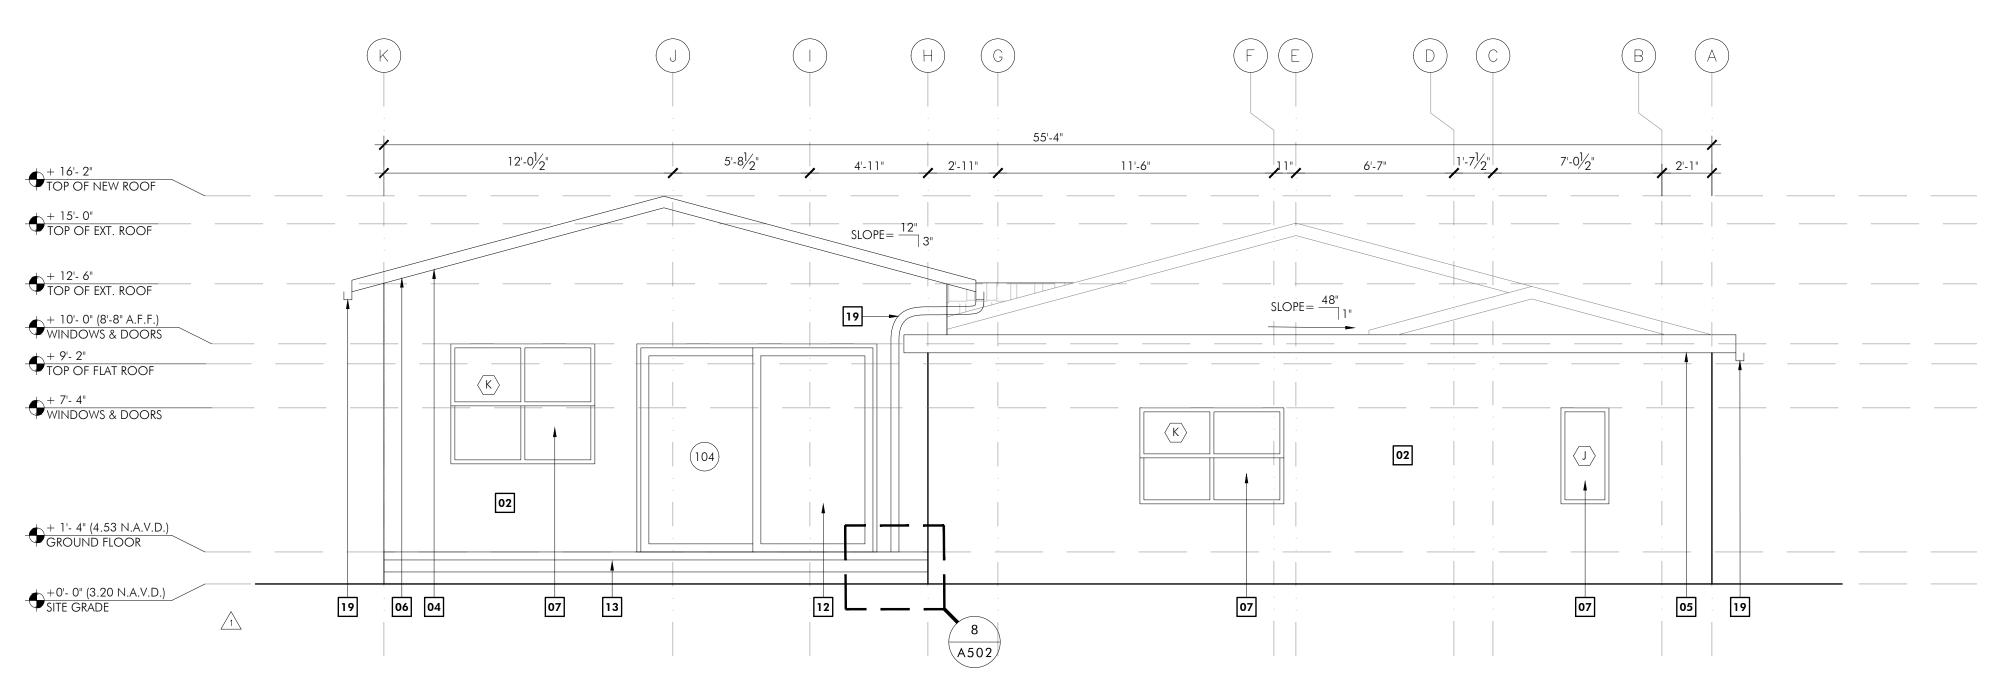

# PROPOSED NORTH ELEVATION 1/4" = 1-0"

NOTES:					
EXISTING PAINTED 5/8" SMOOTH STUCCO OVER 8" EXTERIOR MASONRY WALL. PATCH STUCCO AND PAINT AS NEEDED.	EXISTING IMPACT RATED ALUMINUM FRAME GLASS DOOR TO REMAIN. SEE DOOR SCHEDULE A801.	20 REMOVE AREA OF WALL FOR NEW WINDOW/DOOR			
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EXISTING BARREL TILE ROOF TO REMAIN. REPAIR AS NEEDED.	13 NEW CONCRETE STAIRS. SEE STRUCTURAL DRAWINGS.				
NEW BARREL TILE ROOF. SEE STRUCTURAL DRAWINGS & ROOF SHEETS A1.04/A1.05	14 EXISTING CONCRETE PLANTER TO REMAIN.				
NEW FLAT WOOD JOIST ROOF. SEE STRUCTURAL DRAWINGS & ROOF SHEETS A1.04/A1.05	15 NEW CONCRETE BREEZE BLOCK TO BE SELECTED BY OWNER, APPROVED BY ARCHITECT.				
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EXISTING IMPACT RATED WINDOW TO REMAIN. SEE WINDOW SCHEDULE SHEET A802.	18 NEW ROOF BEYOND.				
EXISTING BUT RELOCATED IMPACT RATED WINDOW TO REMAIN. SEE WINDOW SCHEDULE SHEET A802.	19 GUTTER / DOWNSPOUT				
10 PHANTOM LINE FOR PREVIOUS EXISTING OPENING BEYOND.	TO BE REMOVED				

# EXTERIOR GLAZING INFORMATION:

ALL EXTERIOR GLAZING IN WINDOWS SHALL BE TEMPERED AND HAVE MIAMI-DADE PRODUCT APPROVAL FOR WIND-BORNE DEBRIS PER 1626.1 AND 1626.2 LARGE MISSILE IMPACT TESTS, FBC SEVENTH EDITION (2020).

EXTERIOR GLAZING SHALL COMPLY WITH 2411.3.2.1.

DESIGN WIND PRESSURES:

SEE STRUCTURAL DWGS

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RENOVATION & ADDITION

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DRAWN BY: SZM DATE: 5/3/2024

REVISIONS:

2/15/24 BLDG DEPT NOTES

DRAWING TITLE:

NORTH ELEVATIONS

PROJECT # 2307

DRAWING NO.

SCHNEUR Z. MEYER, AIA

FL: AR101781


SECTIONS

PROJECT # 2307


DRAWING TITLE:

DRAWING NO.

A 3.01

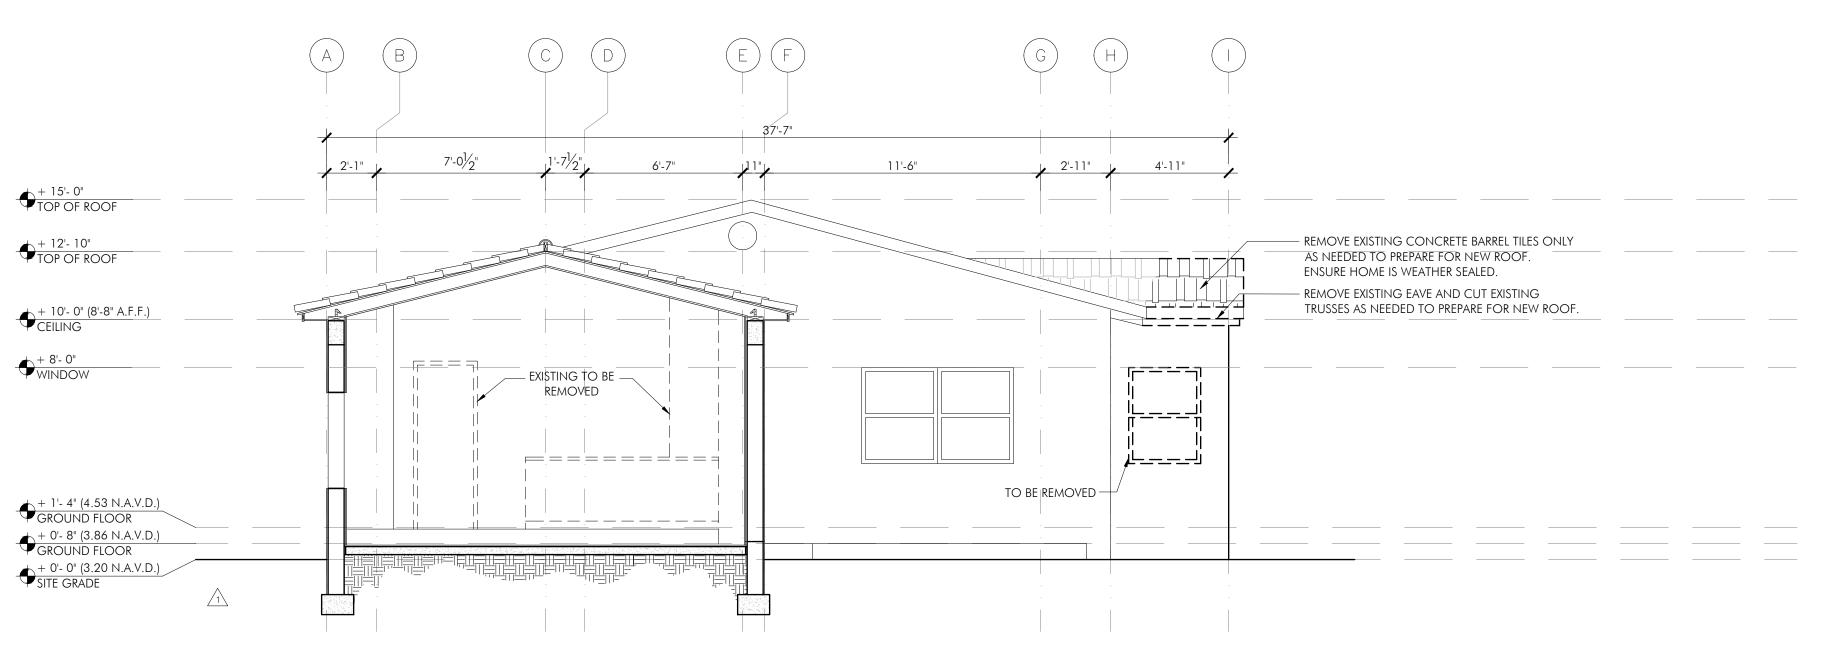



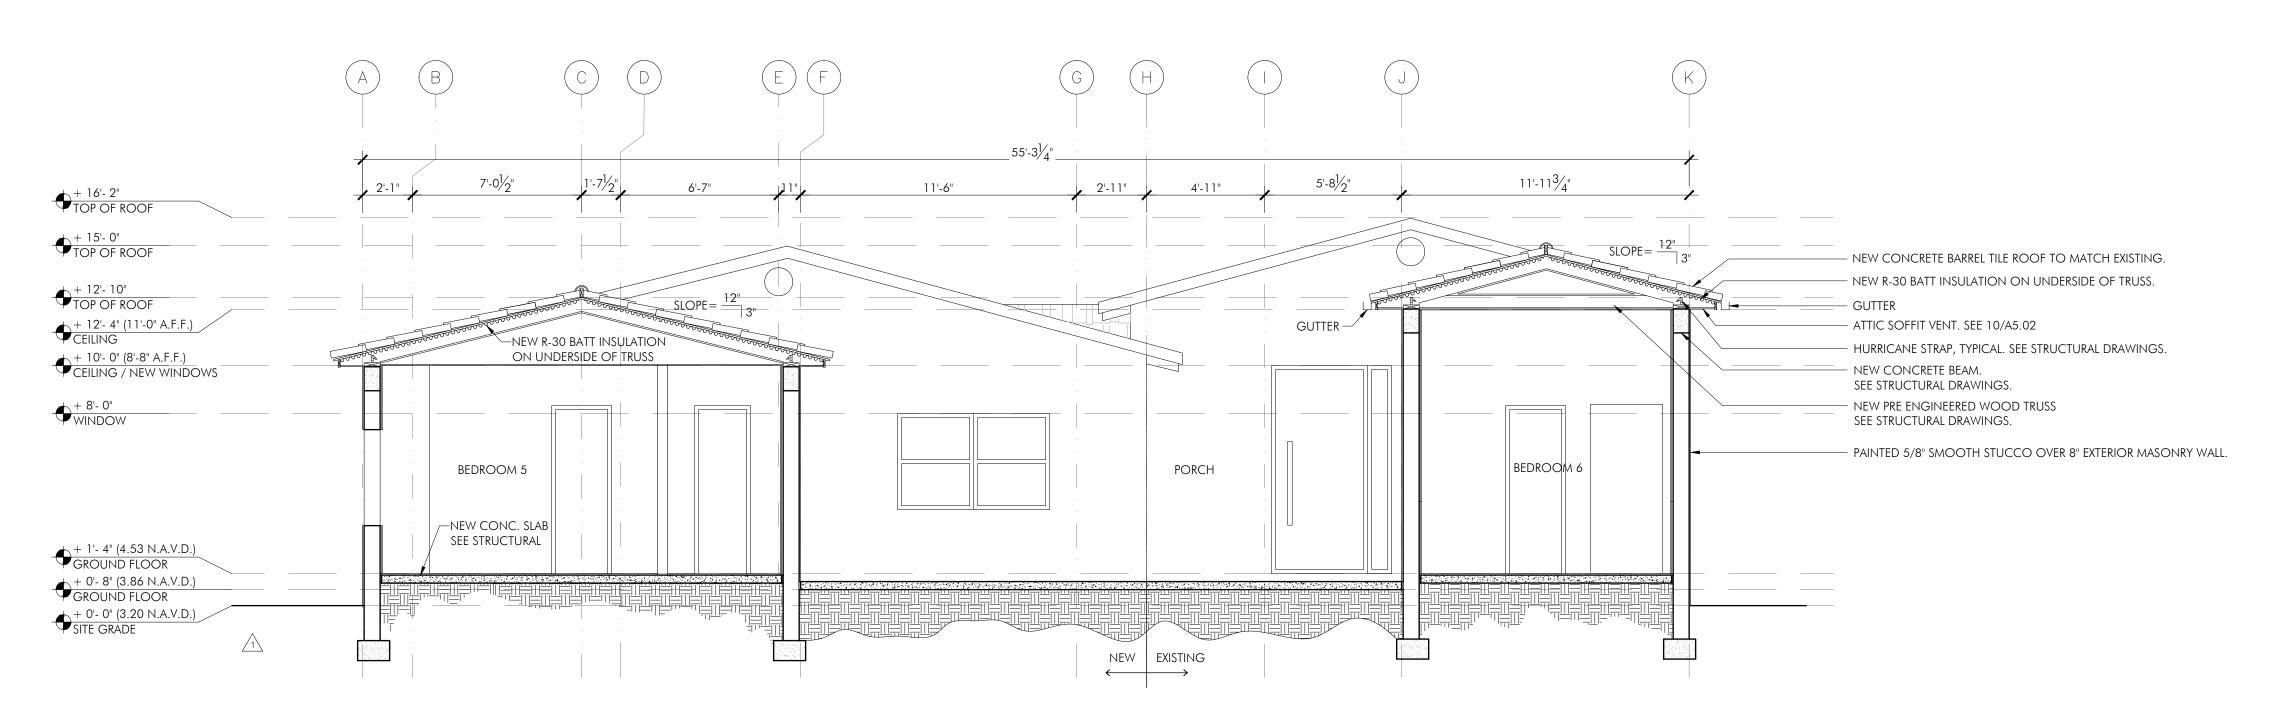


# PROPOSED SECTION 1/4" = 1-0"

DRAWING TITLE:


SECTIONS

PROJECT # 2307


DRAWING NO. A 3.02

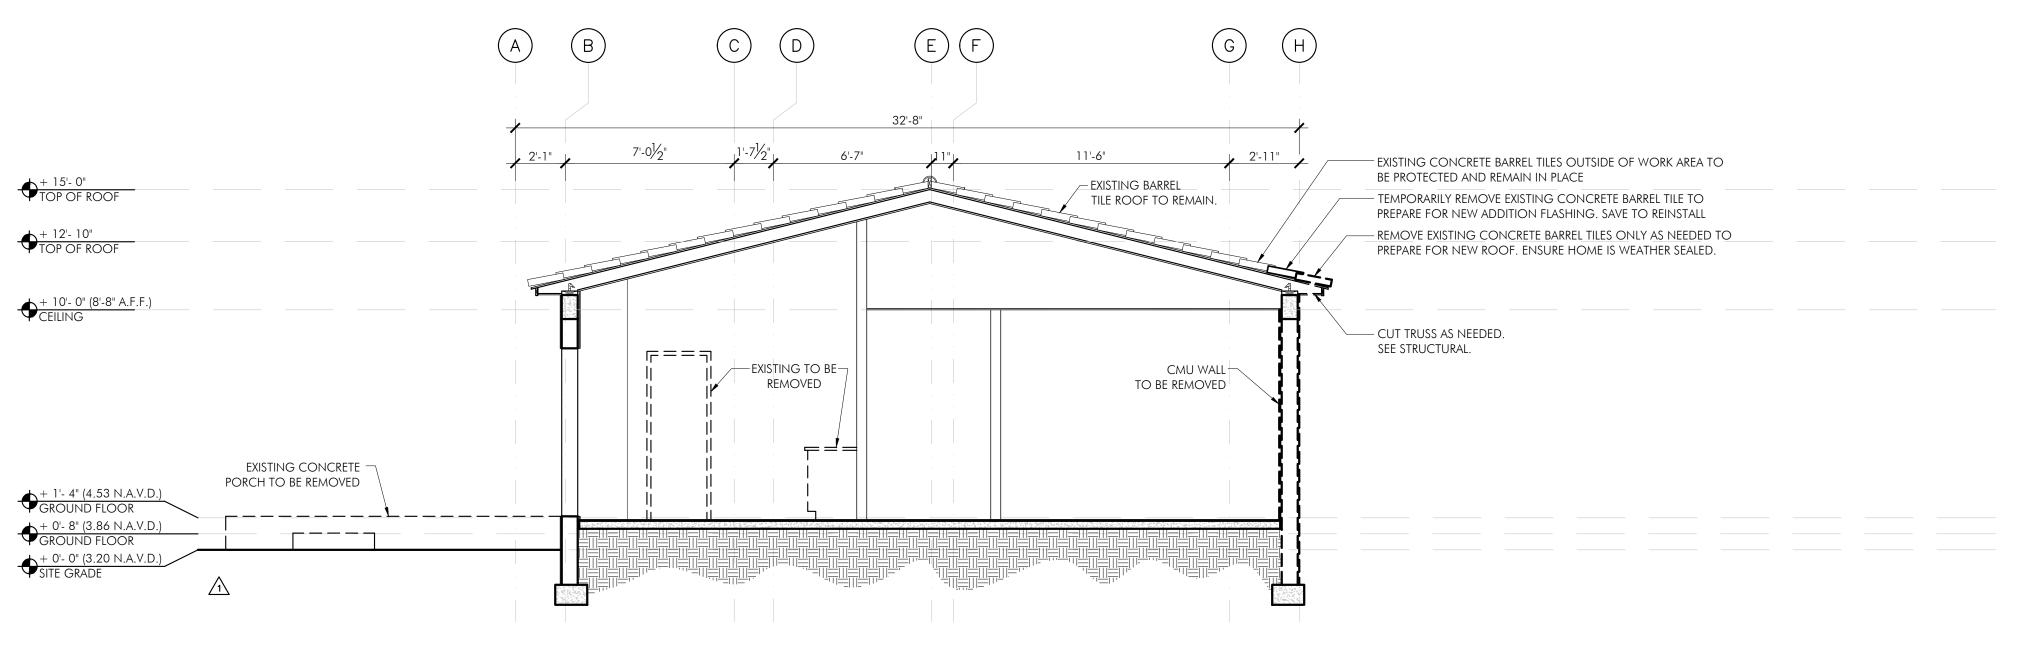




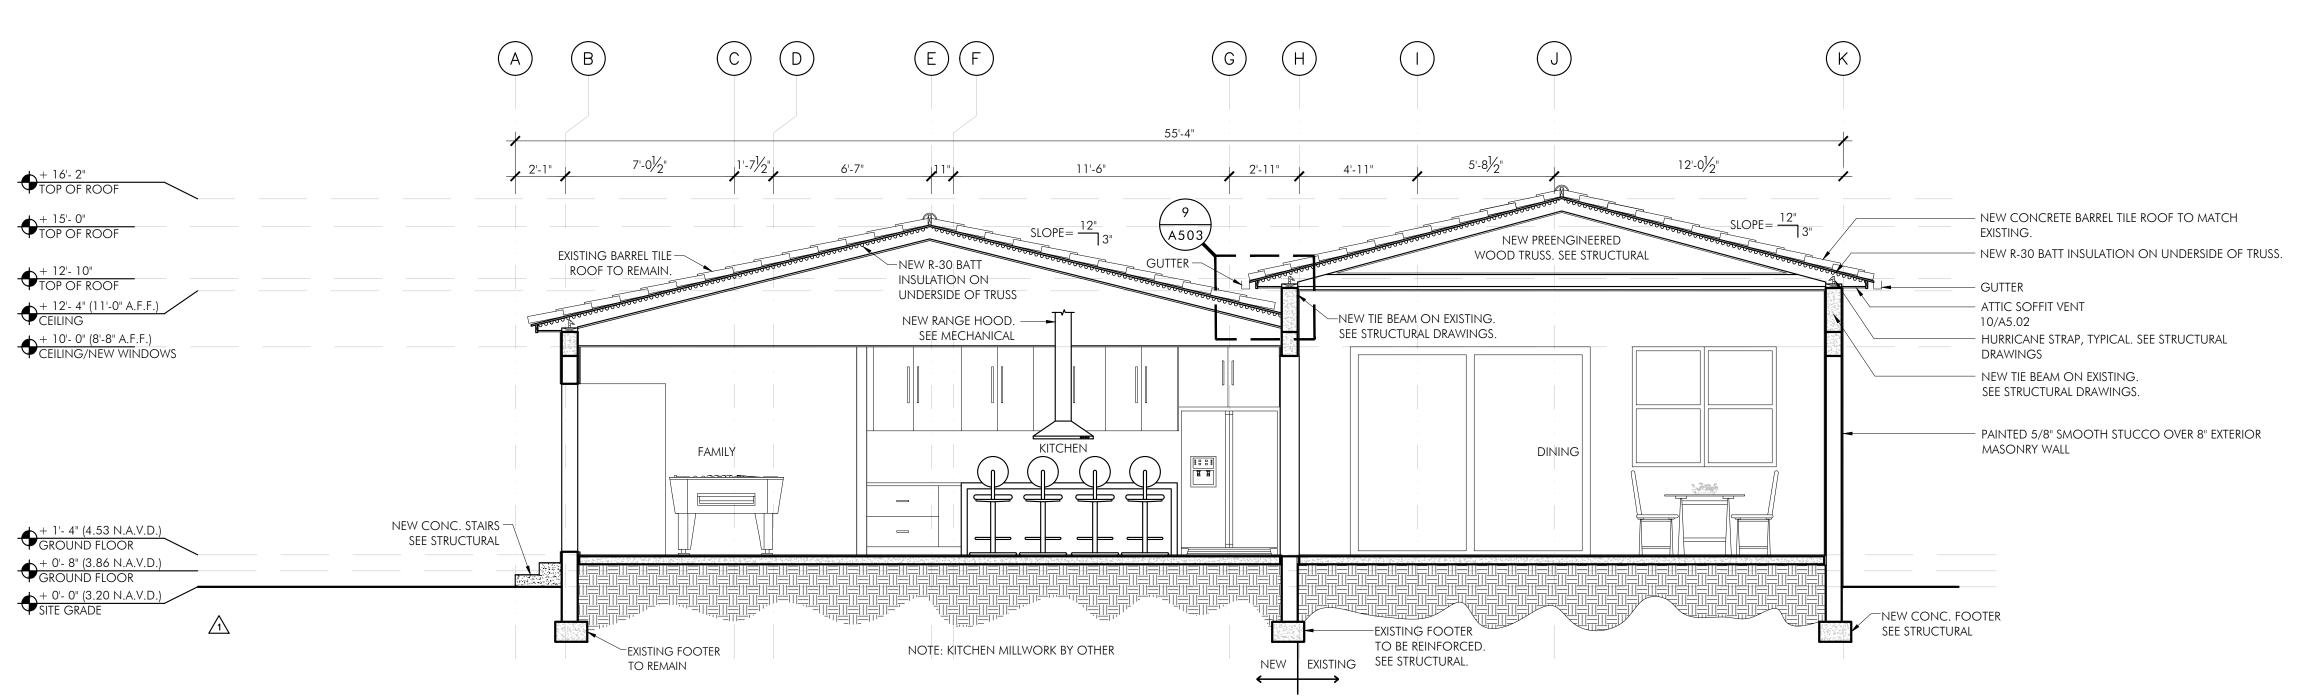


PROPOSED SECTION

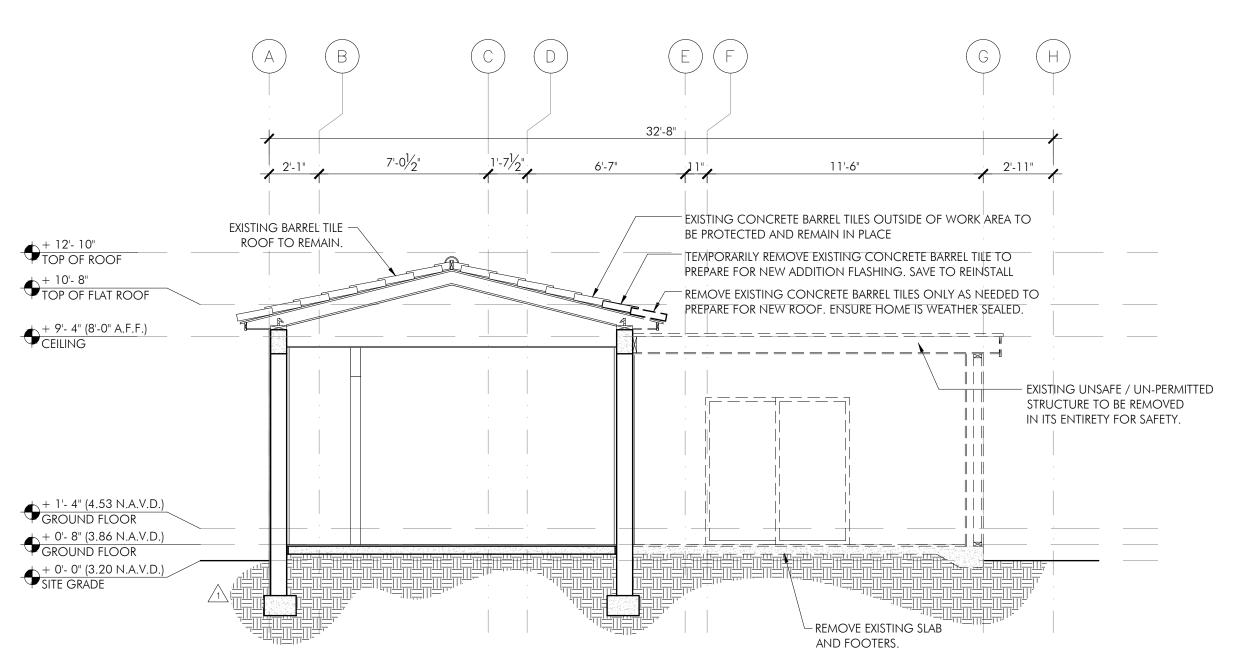




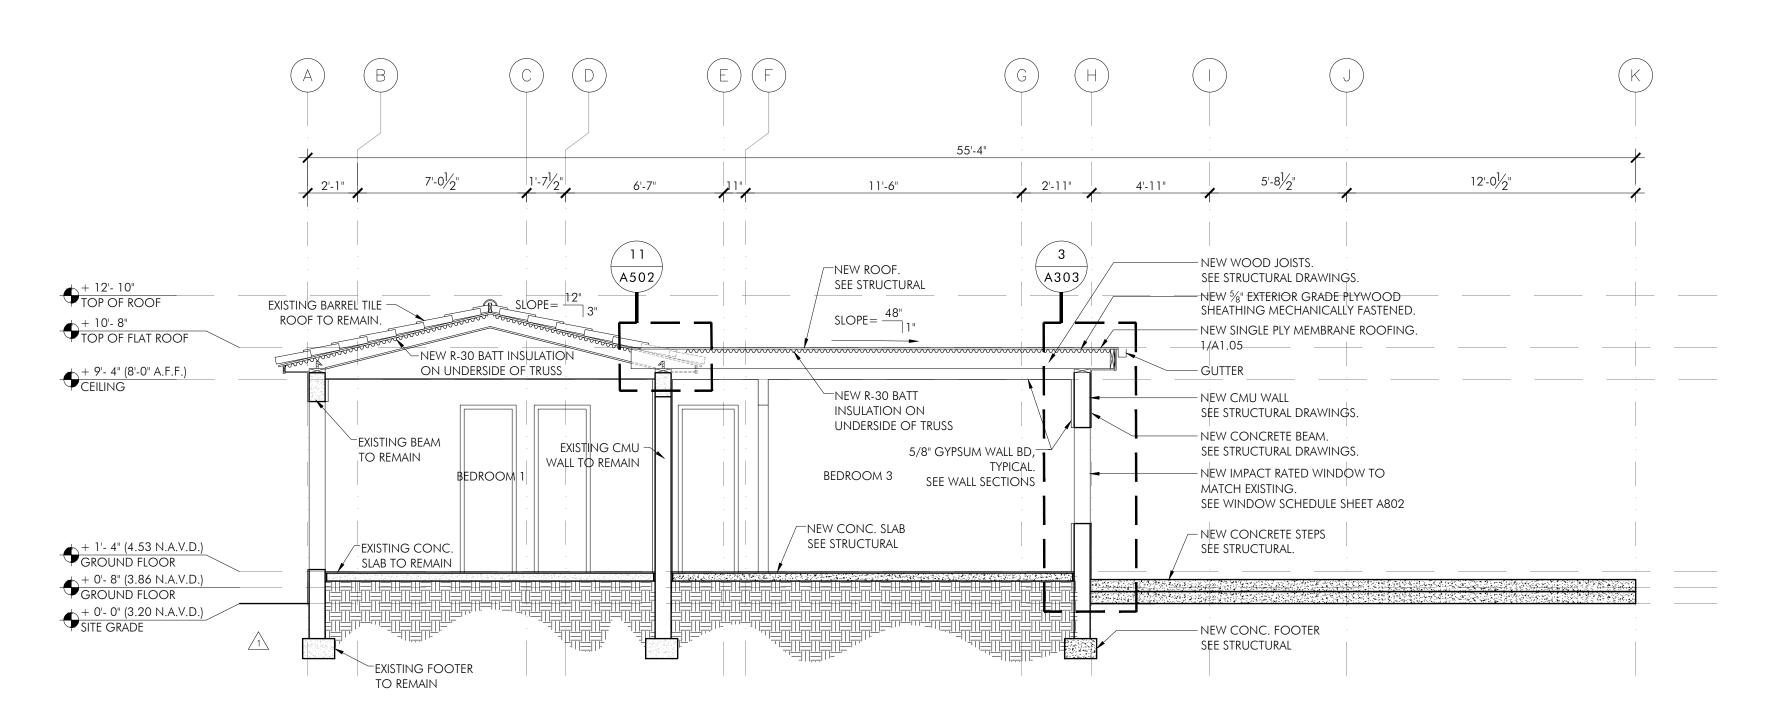



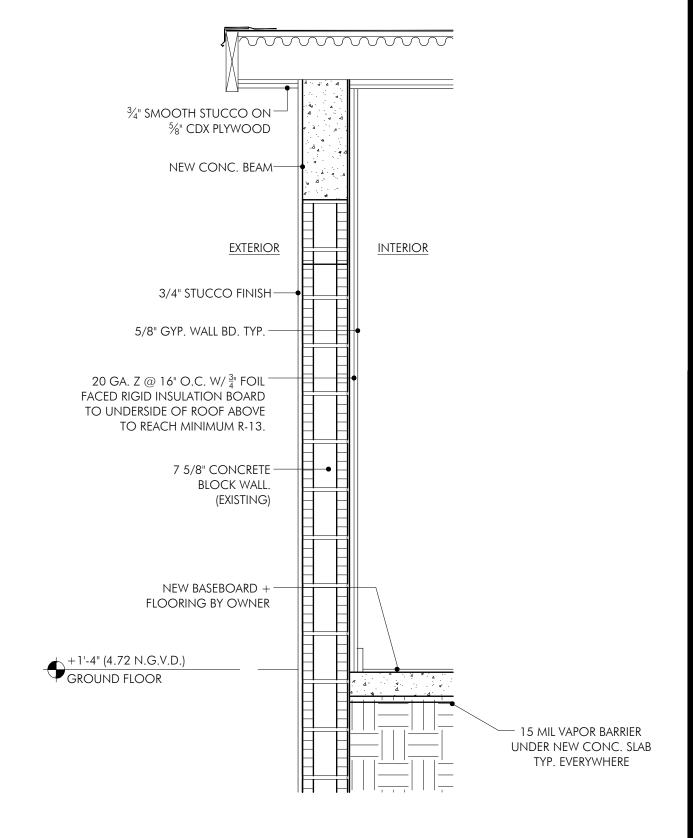



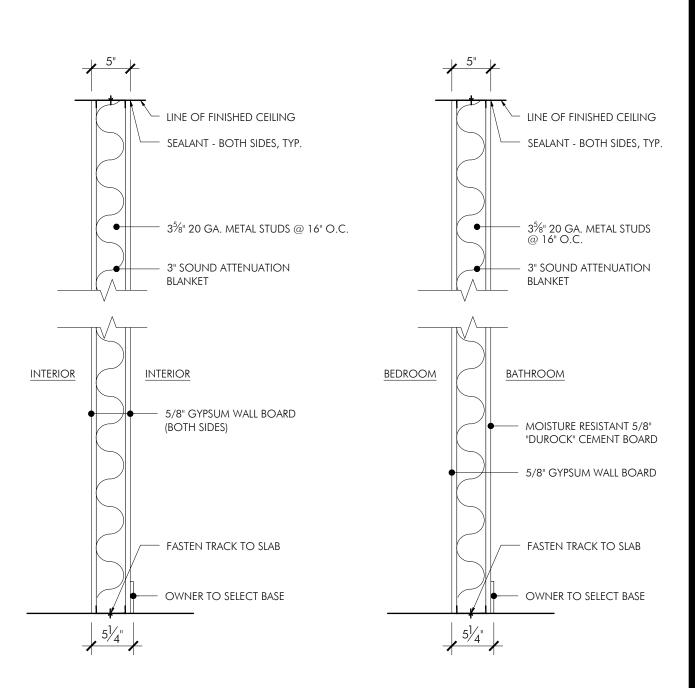



SCHISM ARCHITECTURE + DESIGN

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FL: AR101781

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> CHISCHITECTUR + DESIGN

ENOVATION & ADDITION
1415 MADISON ST

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DRAWN BY: SZM
DATE: 5/3/2024

REVISIONS:

1 2/15/24 BLDG DEPT NOTES


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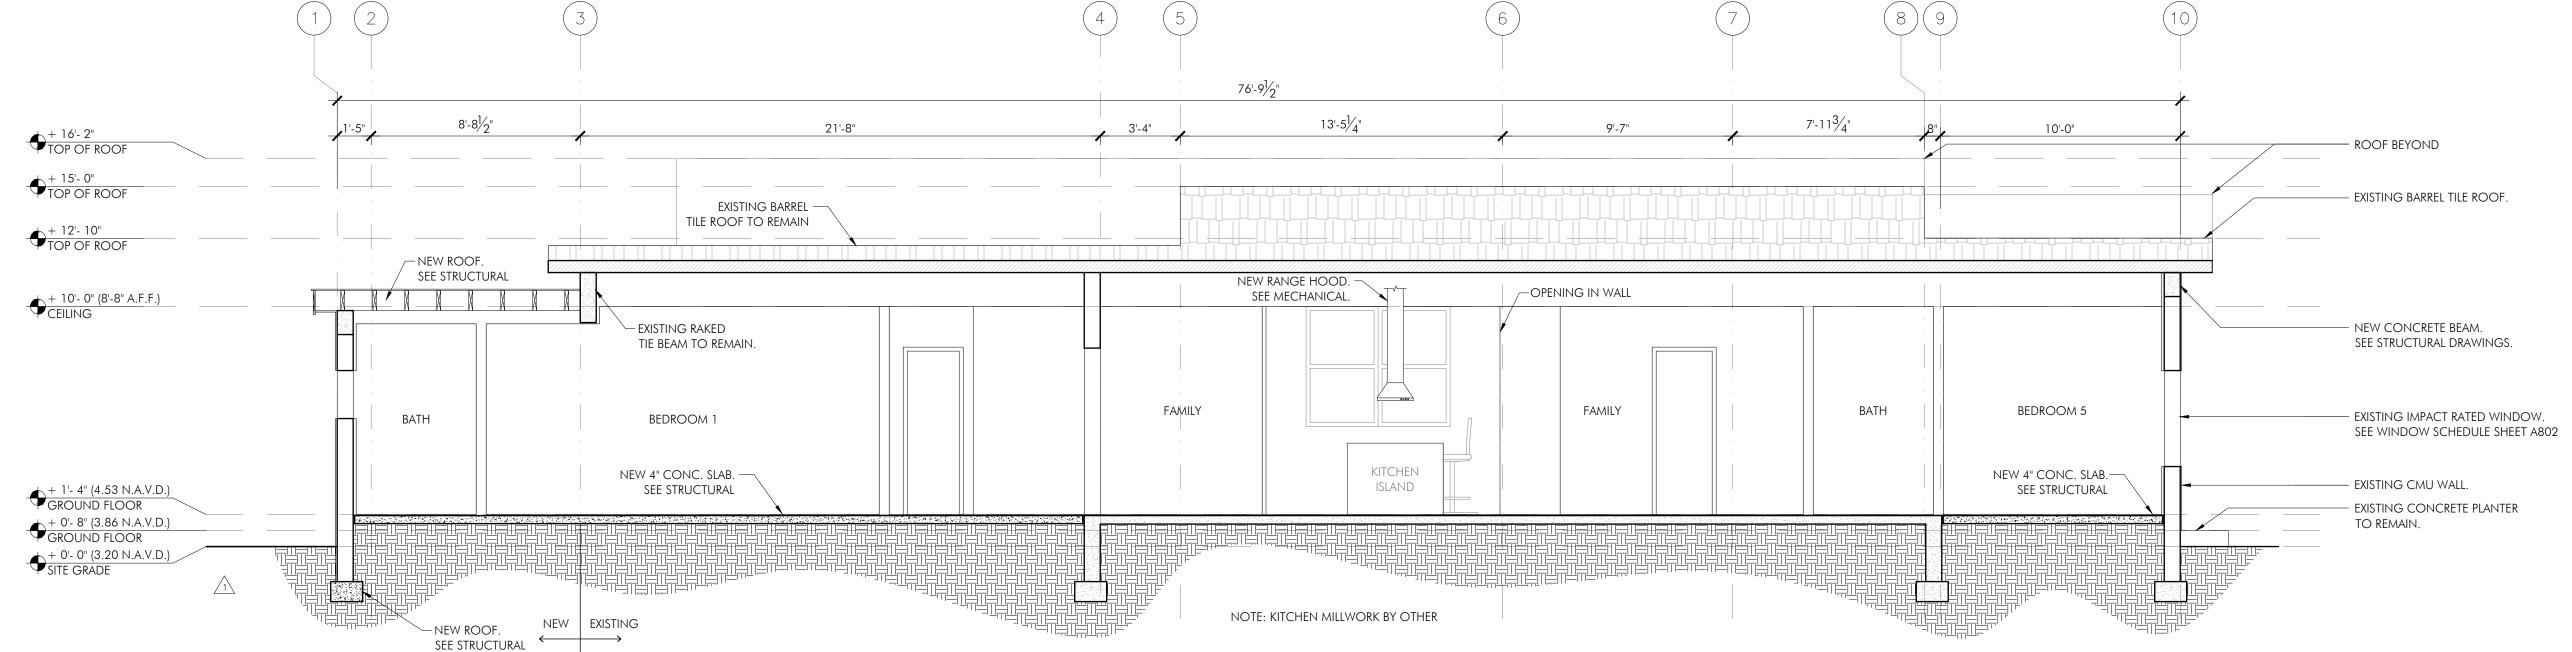
SECTIONS

PROJECT # 2307

DRAWING NO.

A 3.03



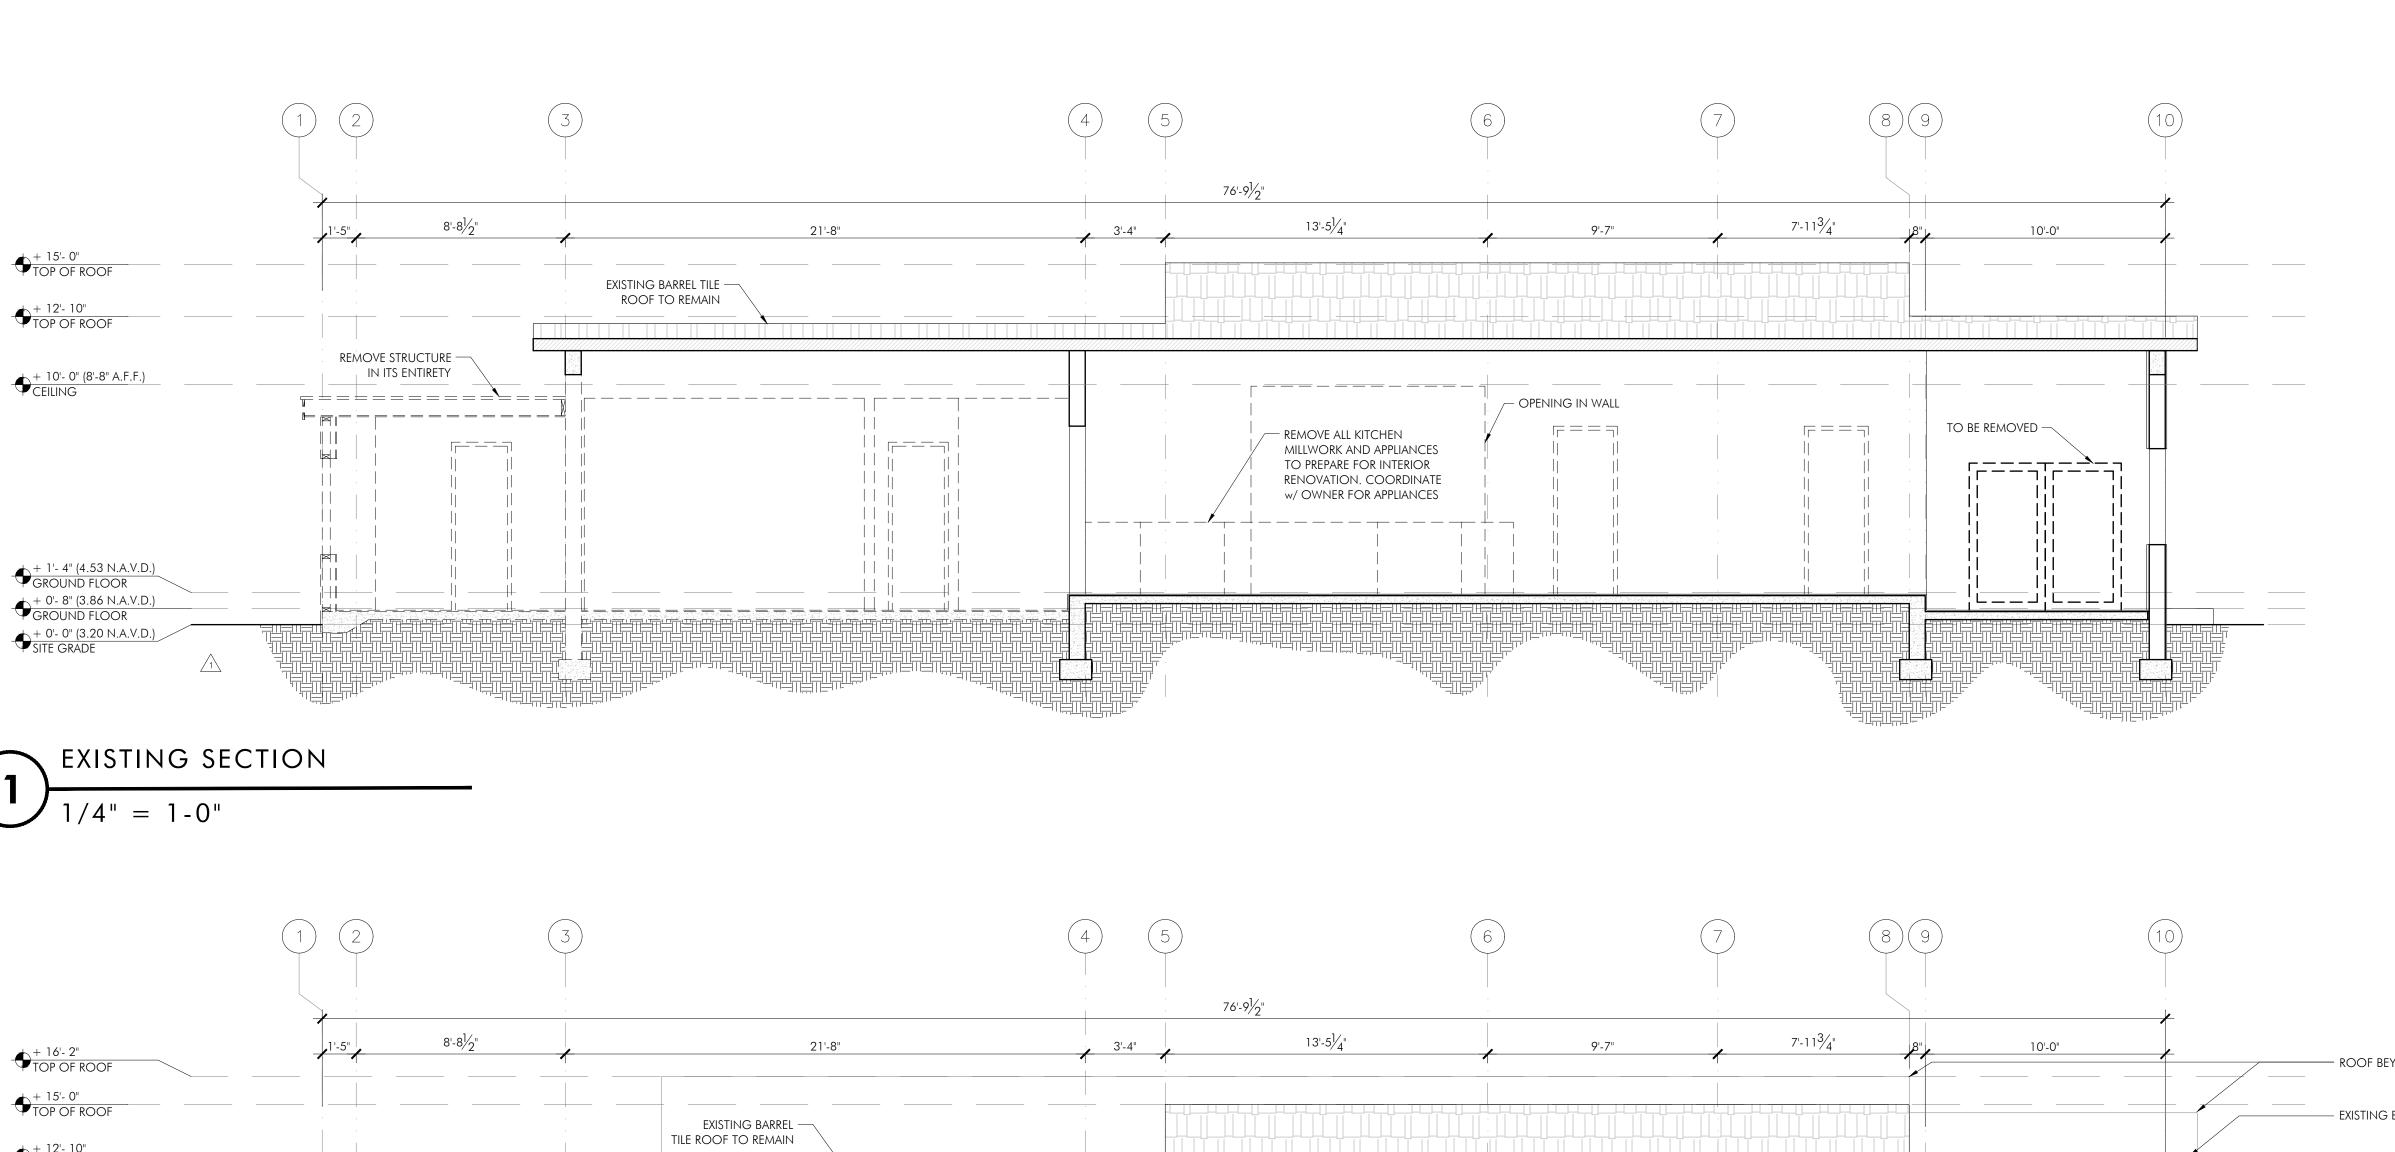

PROPOSED SECTION

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 $\otimes$ JOVATION DDITION X

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DRAWN BY: SZM DATE: 5/3/2024

**REVISIONS:** 2/15/24 BLDG DEPT NOTES


DRAWING TITLE:

SECTIONS

PROJECT # 2307

DRAWING NO.

A 3.04

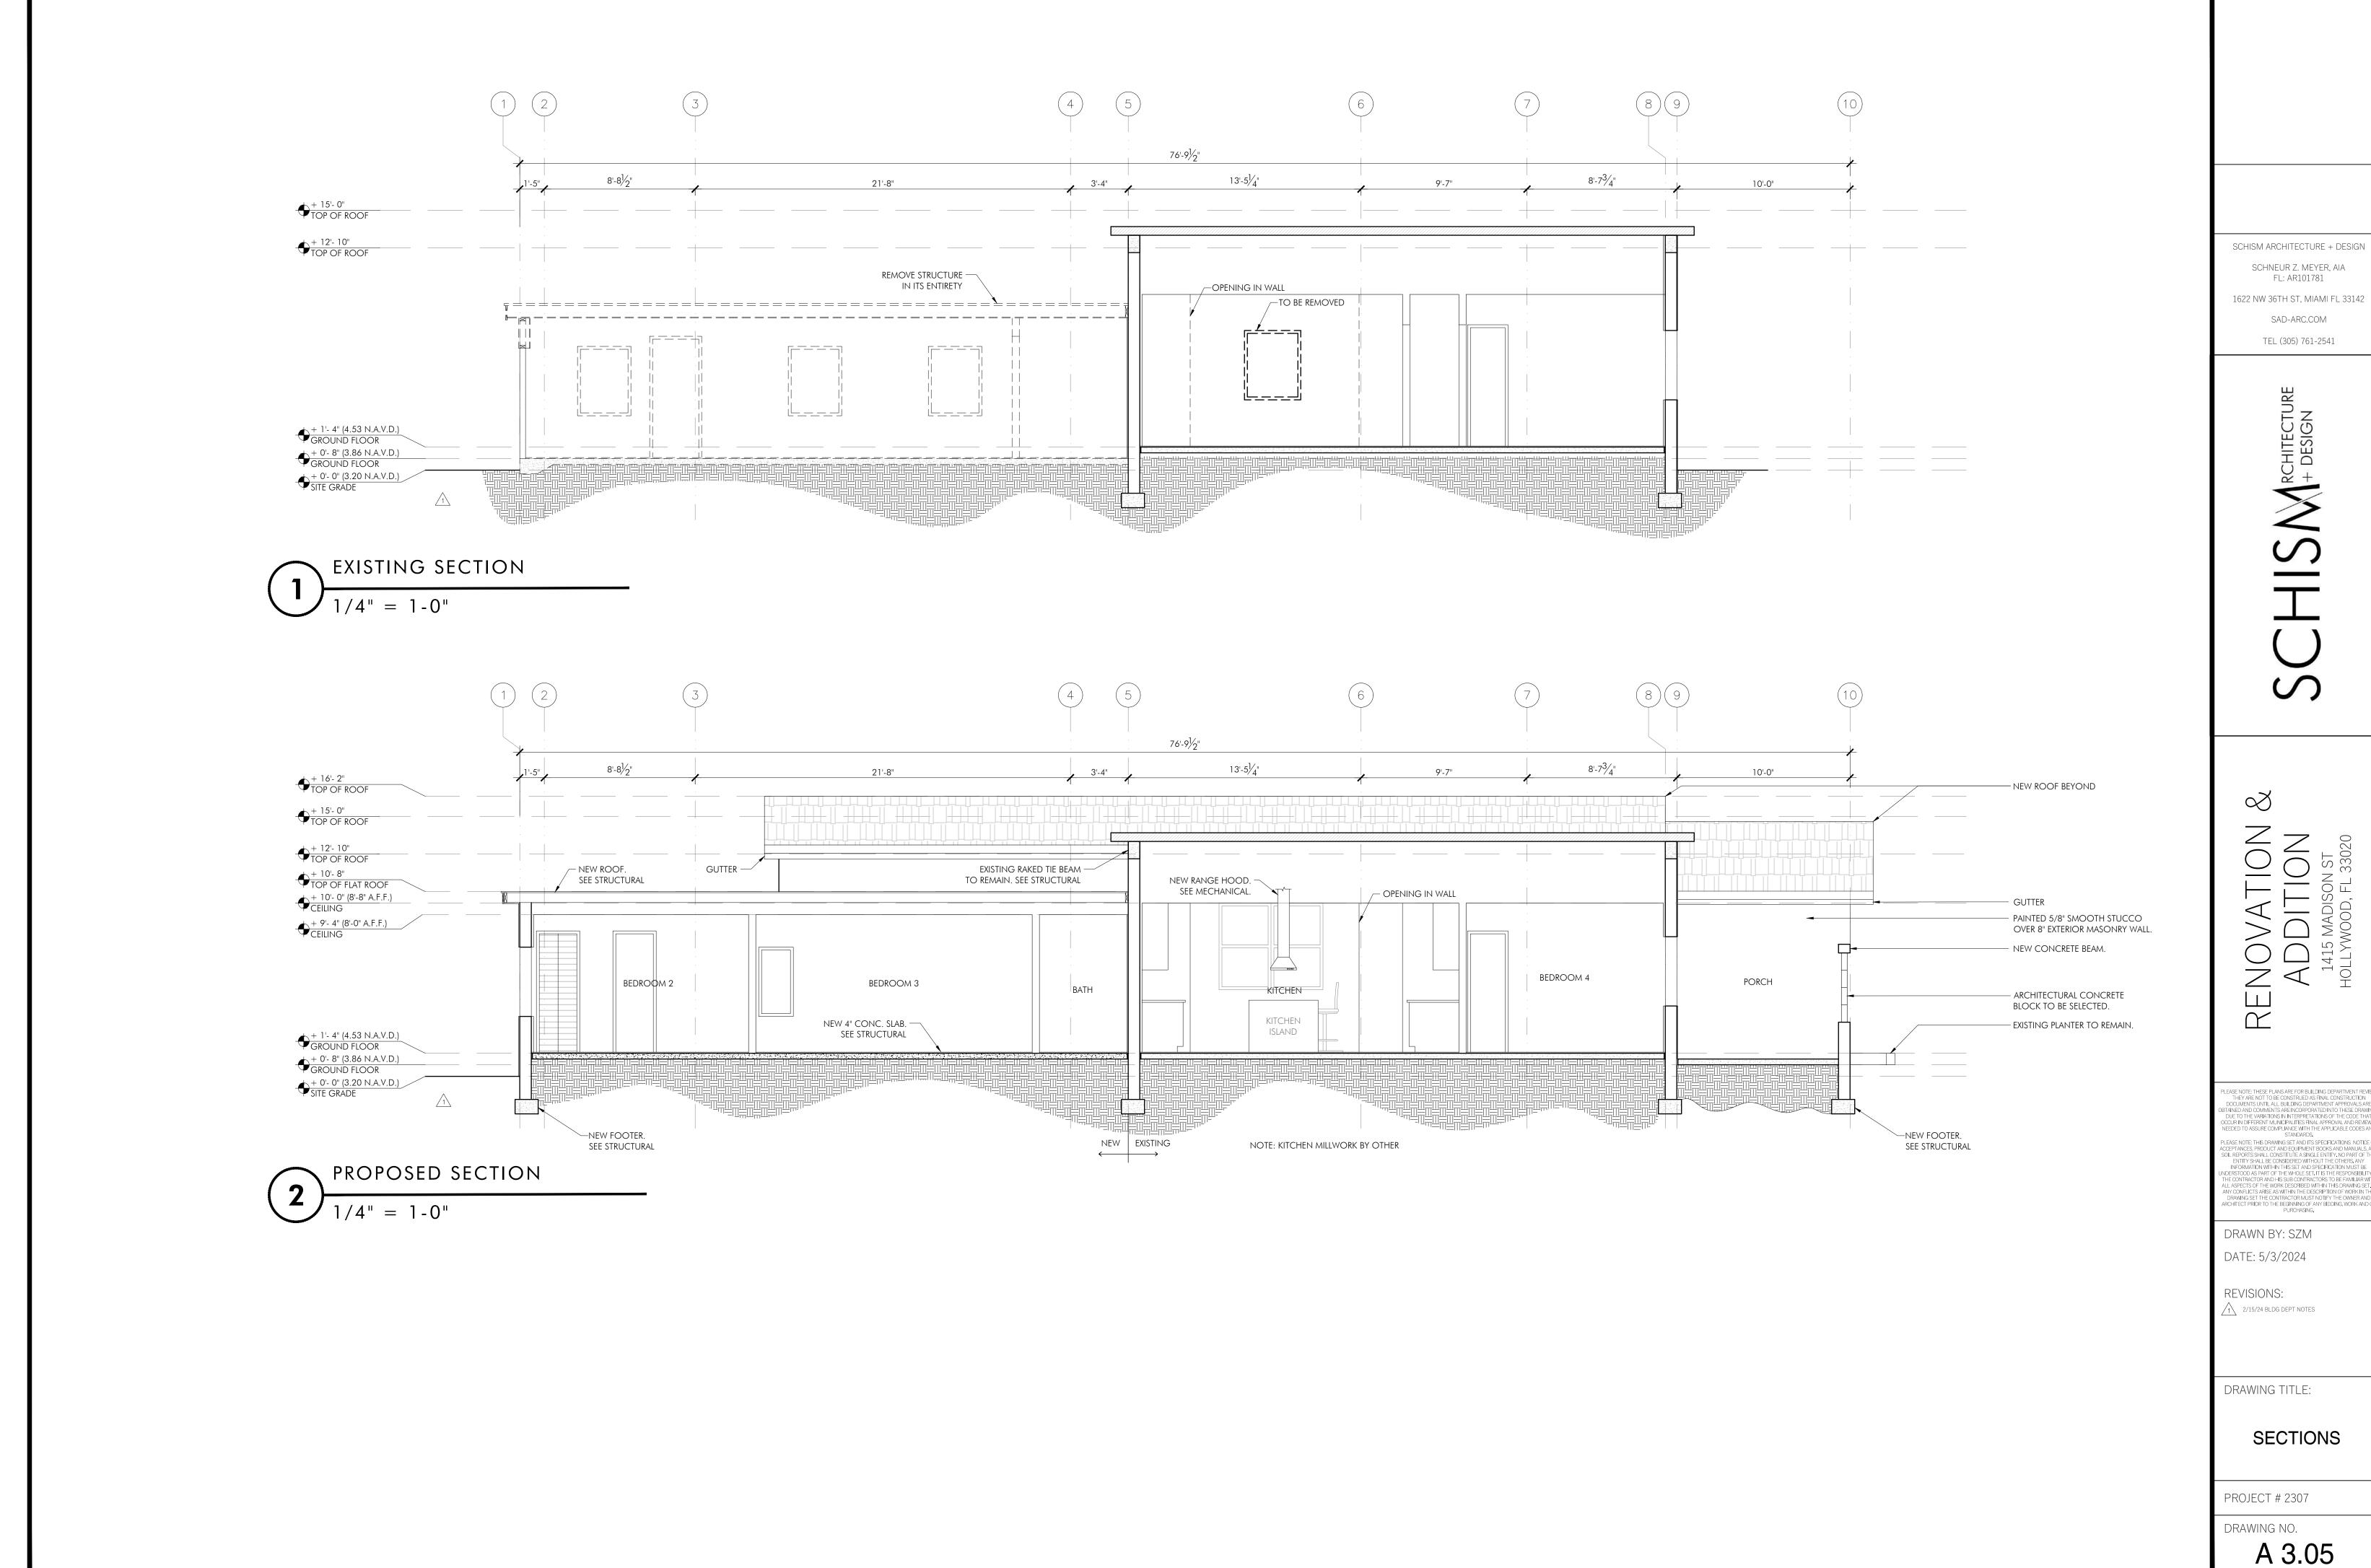

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STANDARDS.
PLEASE NOTE: THIS DRAMING SET AND UTS SPECIFICATIONS, NOTICE



LOCATION MAP NOT TO SCALE

# POST OPTIONS: WOOD 2 1/2" MIN. Ø POST WOOD 2" X 4" OAK 1 1/2" X 1 1/2" STEEL 1.33 LBS/FT. MIN.— 6' MAX. FILTER FABRIC (IN CONFORMANCE WITH SEC. 985 FDOT SPEC.) GRADE

TIME OF CONSTRUCTION AND BE CONSTRUCTED PRIOR TO ANY GRADING OR DISTURBANCE OF EXISTING SURFACE MATERIAL ON BALANCE OF SITE. PERIMETER SEDIMENT BARRIERS SHALL BE

PROVIDED TO ENSURE INTENDED PURPOSE IS ACCOMPLISHED. THE DEVELOPER, OWNER AND/OR CONTRACTOR SHALL BE CONTINUALLY RESPONSIBLE FOR ALL SEDIMENT CONTROLS. SEDIMENT

. SEDIMENT WILL BE PREVENTED FROM ENTERING ANY STORM WATER SYSTEM, DITCH OR CHANNEL. ALL STORMWATER INLETS THAT ARE MADE OPERABLE DURING CONSTRUCTION SHALL BE PROTECTED SO THAT SEDIMENT—LADEN WATER CANNOT ENTER THE CONVEYANCE SYSTEM WITHOUT FIRST BEING

. WHERE CONSTRUCTION VEHICLE ACCESS ROUTES INTERSECT PAVED PUBLIC ROADS, PROVISIONS SHALL BE MADE TO MINIMIZE THE TRANSPORT OF SEDIMENT BY TRACKING ONTO THE PAVED SURFACE. WHERE SEDIMENT IS TRANSPORTED ONTO A PUBLIC ROAD SURFACE WITH CURBS AND GUTTERS, THE ROAD SHALL BE CLEANED THOROUGHLY AT THE END OF EACH DAY. SEDIMENT SHALL BE REMOVED FROM THE ROADS BY SHOVELING OR SWEEPING AND TRANSPORTED TO A SEDIMENT CONTROL DISPOSAL AREA. STREET WASHING SHALL BE ALLOWED ONLY AFTER SEDIMENT IS REMOVED IN THIS MANNER. THIS PROVISION SHALL APPLY TO INDIVIDUAL SUBDIVISION LOTS AS WELL AS TO LARGER LAND DISTURBING ACTIVITIES.

SEVEN (7) DAYS AFTER FINAL GRADE IS REACHED ON ANY PORTION OF THE SITE. TEMPORARY SOIL AT FINAL GRADE BUT WILL REMAIN UNDISTURBED FOR LONGER THAN THIRTY (30) DAYS. PERMANENT STABILIZATION SHALL BE APPLIED TO AREAS THAT ARE TO BE LEFT UNDISTURBED FOR MORE THAN

TEMPORARY PROTECTION AND PERMANENT STABILIZATION OF ALL SOIL STOCKPILES ON SITE AS WELL AS SOIL INTENTIONALLY TRANSPORTED FROM THE PROJECT SITE.

DAYS AFTER FINAL SITE STABILIZATION OR AFTER THE TEMPORARY MEASURES ARE NO LONGER

8. PROPERTIES AND WATER WAYS DOWNSTREAM FROM CONSTRUCTION SITE SHALL BE PROTECTED FROM SEDIMENT DEPOSITION AND EROSION AT ALL TIMES DURING CONSTRUCTION.


9. CONTRACTOR IS RESPONSIBLE FOR ALL SURFACE WATER DISCHARGES, RAINFALL RUN OFF OR DEWATERING ACTIVITIES.

10. CONTRACTOR MUST INCORPORATE ALL BMP'S NECESSARY TO MEET OR EXCEED STATE WATER

11. THE POLLUTION PREVENTION PLAN IS A MINIMUM GUIDELINE ONLY. ADDITIONAL BMP'S MAY BE NECESSARY AT CONTRACTOR'S EXPENSE.

THIS ITEM HAS BEEN DIGITALLY SIGNED AND SEALED BY WILFORD ZEPHYR ON THE DATE ADJACENT TO THE SEAL.

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# **EROSION & SEDIMENT CONTROL PLAN**

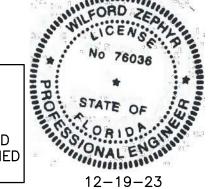SCALE: 1"=10'

P.E.#:76036

INEERING R. P.E.

ZEPHY

DDITI

ON ST. FLORID,

TON MAD

DATE: 12/6/23 SCALE: 1"=10'

SHEET NO.:

1 OF 2

PROJECT NO.: 23-64

LEGEND

5.50

PROPOSED CONCRETE PROPOSED GRADE EXISTING ELEVATION PROPOSED WATER METER PROPOSED BFP DEVICE

ALL ELEVATIONS ARE REFERENCED TO NAVD88 VERTICAL DATUM

**BMP NOTES:** . ALL SEDIMENT CONTROL MEASURES ARE TO BE ADJUSTED TO MEET FIELD CONDITIONS AT THE CONSTRUCTED TO PREVENT SEDIMENT OR TRASH FROM FLOWING OR FLOATING ON TO ADJACENT 2. PERIODIC INSPECTION AND MAINTENANCE OF ALL SEDIMENT CONTROL STRUCTURES MUST BE

CONTROL MEASURES SHALL BE IN WORKING CONDITION AT THE END OF EACH WORKING DAY.


FILTERED OR OTHERWISE TREATED TO REMOVE SEDIMENT.

5. PERMANENT OR TEMPORARY SOIL STABILIZATION SHALL BE APPLIED TO DENUDED AREAS WITHIN STABILIZATION SHALL BE APPLIED WITHIN SEVEN (7) DAYS TO DENUDED AREAS THAT MAY NOT BE ONE YEAR.

6. DURING CONSTRUCTION OF THE PROJECT, SOIL STOCKPILES SHALL BE STABILIZED, COVERED OR CONTAINED WITH SEDIMENT TRAPPING MEASURES. THE CONTRACTOR IS RESPONSIBLE FOR THE

7. ALL TEMPORARY EROSION AND SEDIMENT CONTROL MEASURES SHALL BE REMOVED WITHIN 30

QUALITY AND SWPPP REQUIREMENTS.

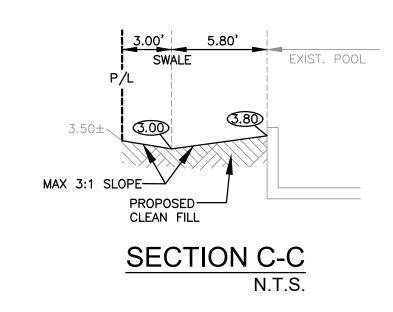

- 1) CONTRACTOR MUST NOTIFY ZEPHYR ENGINEERING OF THE START OF CONSTRUCTION DATE PRIOR TO CONTRACTOR MUST COORDINATE PROPOSED IMPROVEMENTS SHOWN ON CIVIL PLANS WITH EXISTING SITE CONDITIONS & PROPOSED PLANS BY THE OTHER DESIGN PROFESSIONALS PRIOR TO CONSTRUCTION. CONTRACTOR MUST ALSO VERIFY THAT THERE ARE NO DISCREPANCIES BETWEEN THE WATER, SEWER & DRAINAGE PLANS THAT MAY CAUSE CONFLICTS PRIOR TO CONSTRUCTION. CONTACT ZEPHYR ENGINEERING
- PRIOR TO CONSTRUCTION, CONTRACTOR RESPONSIBLE TO DOCUMENT EXISTING CONDITIONS ON AND AROUND THE PROJECT AREA, INCLUDING THE R.O.W. AND ADJACENT PROPERTIES. IT'S RECOMMENDED THAT CONTRACTOR TAKE PHOTOGRAPHS & VIDEOS TO CLEARLY DOCUMENT CONDITIONS PRIOR TO CONSTRUCTION. CONTRACTOR RESPONSIBLE TO REPAIR ALL DAMAGES CAUSED BY OR AS A RESULT OF THE PROPOSED CONSTRUCTION.
- ALL ROOF DRAINS MUST BE CONNECTED TO THE ONSITE DRAINAGE SYSTEM.
- CONTRACTOR TO REFER TO ARCHITECTURAL PLANS FOR SITE PLAN LAYOUT AND DIMENSIONS. EXISTING UTILITIES SHOWN ARE BASED ON BEST AVAILABLE INFORMATION. CONTRACTOR'S RESPONSIBLE TO FIELD VERIFY LOCATION OF ALL EXISTING UTILITIES PRIOR TO CONSTRUCTION. CONTRACTOR TO BE AWARE THAT THERE MAY BE SOME EXISTING UTILITIES ON OR ADJACENT TO THE PROJECT SITE THAT MAY NOT BE SHOWN ON THE CIVIL PLANS, AND CONTRACTOR IS RESPONSIBLE TO FIELD VERIFY THOSE UTILITIES AS WELL. CONTRACTOR RESPONSIBLE FOR RELOCATION OF EXISTING UTILITIES THAT CONFLICTS WITH PROPOSED CONSTRUCTION.

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12-19-23

PAVING, GRADING & DRAINAGE PLAN SCALE: 1"=10"

INEERING

ZEPHY


DDITION ADDIT ON ST. FLORIDA

P.E.#:76036

DATE: 12/6/23 SCALE: 1"=10'

SHEET NO.: 2 OF 2

PROJECT NO.: 23-64

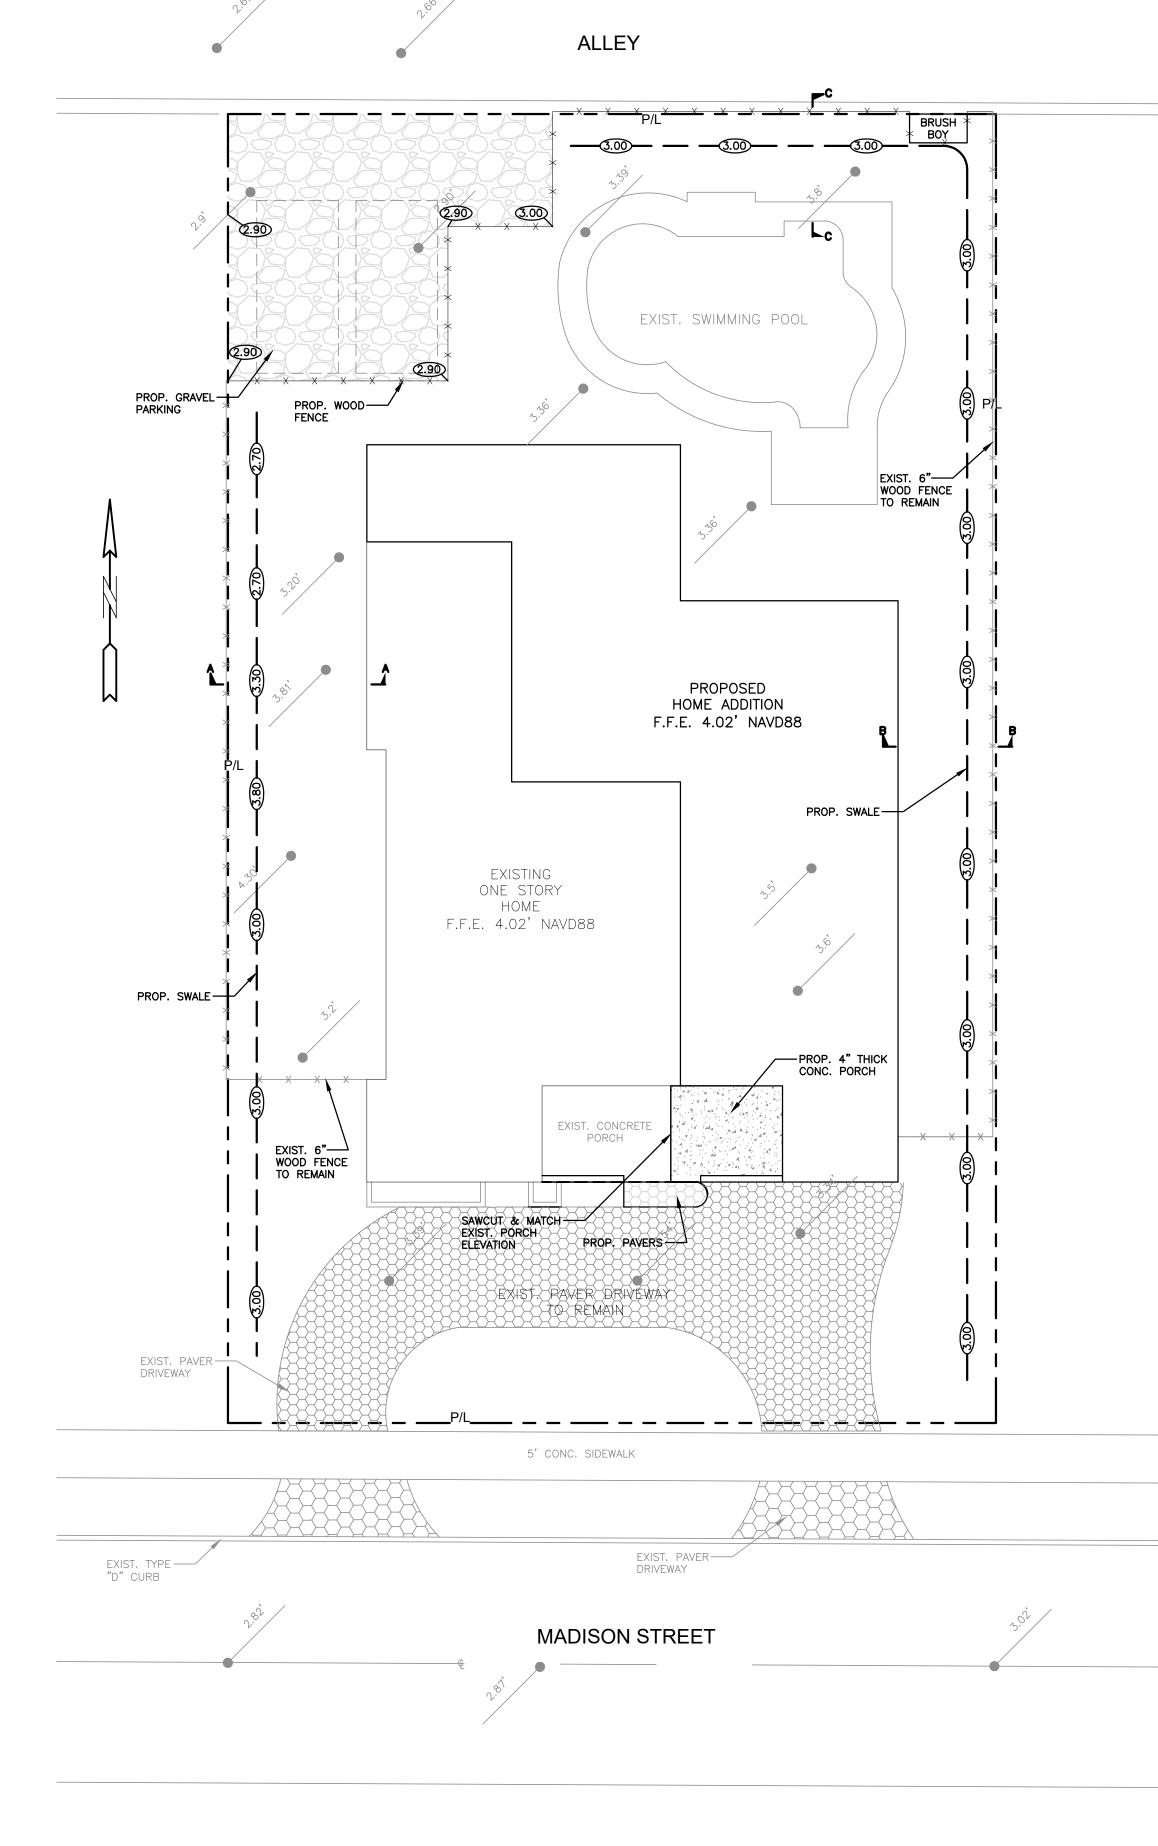

LOT 19 BLOCK 88

LOT 20 BLOCK 88 LOT 18 BLOCK 88

LOT 17 BLOCK 88



5.50

PROPOSED CONCRETE PROPOSED GRADE EXISTING ELEVATION PROPOSED WATER METER PROPOSED BFP DEVICE

The plan takes precedence over the plant list.

2 Full business days before digging, call toll free 1-800-432-4770 Sunshine State One Call of Florida, Inc. Notification Center. Contractors are responsible for coordinating with the owners and appropriate public agencies to assist in locating and verifying all underground utilities prior to excavation. All existing utilities shown on the plans are to be considered approximate and should be verified by the contractor prior to the start of work operations.

General site and berm grading to +/- 1 inch (1") shall be provided by the general contractor. All finished site grading and final decorative berm shaping shall be provided by the landscape contractor.

All sizes shown for plant material on the plans are to be considered Minimum. All plant material must meet or exceed these minimum requirements for both height and spread. Any other requirements for specific shape or effect as noted on the plan(s) will also be required for final acceptance.

All plant material furnished by the landscape contractor shall be Florida #1 or better as established by Grades and Standards for Florida Nursery Trees and Plants.

All trees designated as single trunk shall have a single, relatively straight, dominant leader, proper structural branching and even branch distribution. Trees with bark inclusion, tipped branches, and co-dominant trunks will not be accepted. Trees with girdling, circling and/or plunging roots will be rejected.

All planting beds shall be free of all rocks  $\frac{1}{2}$ " or larger, sticks, and objectionable material including weeds, weed seeds. All limerock shall be removed/cleaned down to the native soils. Planting soil 50/50 sand/topsoil mix shall be delivered to the site in a clean loose and friable condition and is required around the root ball of all trees and palms, the top 6" of all shrubs and ground cover beds. This soil can be tilled into the existing soil after the existing soil has been cleaned of all rocks, limestone and sticks. Recycled compost is encouraged as a soil amendment alternative. Sod 1.5-2" topsoil comes furnished.

All burlap, string, cords, wire baskets, plastic or metal containers shall be removed from the rootballs before planting. Remove all bamboo and metal nursery stakes.

All trees/palms shall be planted so the top of the root ball, root flair are slightly above final grade. Shrub material shall be planted such that the top of the plant ball is flush with the surrounding grade. It is the sole responsibility of the landscape contractor to insure that all new plantings receive adequate water during the installation and during all plant warranty periods. Deep watering of all new trees and palms and any supplemental watering that may be required to augment natural rainfall and site irrigation is mandatory to insure proper plant development and shall be provided as a part of this contract.

All trees/palms shall be staked using biodegradable material. No wire, black strapping, or other synthetic material shall be used. Nailing into trees and palms for any reason is prohibited and the material will be rejected. Please refer to the planting

All landscape areas shall be irrigated by a fully automatic sprinkler system with a minimum 100% coverage with all heads adjusted to 50% overlap. Each system shall be installed with an operational rain sensor and rust inhibitor.


## No fertilizers are required.

All landscape areas shall be covered with Pine Straw, Pine Bark, Eucalyptus or sterilized seed free Melaleuca mulch to a minimum depth of two inches (2") of cover when settled. Spread mulch to 1" thickness 3" away from the trunks/stems of all plant material. All trees in sodded areas shall have a clean cut 4' diameter mulch ring. The 5-6" height water ring shall be made from mulch, not soil. Certain areas may receive a thicker mulch cover where noted on plans. Cypress, red, gold and green mulch is prohibited.

Please refer to the planting details for a graphic representation of the above notes. All plant material as included herein shall be warranted by the landscape contractor for a minimum period of 12 months after final inspection approval.

No landscape substitutions shall be made without the City of Hollywood approval.

No tree removal or planting allowed until sub permits are fully approved by city.

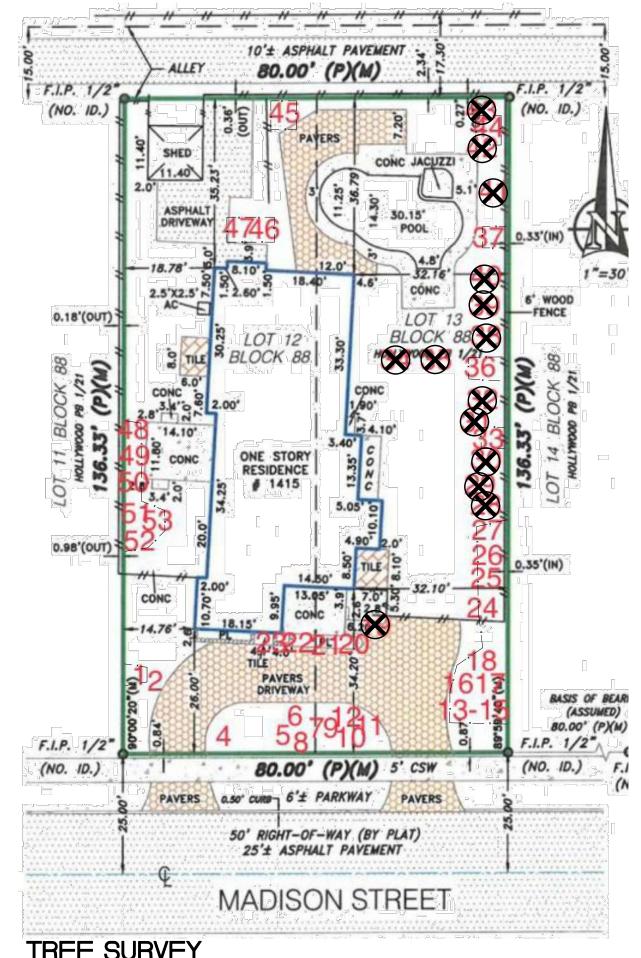

# TREE SURVEY


SCALE: 1'=20'

C: 18" for all 1 gal., 30" for all 3 gal. or greater,  $\longrightarrow$  (+)(+)(+)─**├** B: 18" between all 1 gal. vines not included m and 1 gal., 24" between  $\rightarrow$  all 1 gal. and 3 gal., 36" between all 3 gal. and 3 A: 14" for all 1 + + + + + + + Curb or edge gal., 24" for all 3 ◀ of pavement gal. or greater.


TYPICAL SHRUB SPACING DETAIL

Code		Drought	QTY.	Botanical Name / Common Name Specifications	
EXISTII	NG TR	EES / PAL	MS		
			1	Adonidia merrillii / Christmas Palm 25' Ht.	
			2	Caryota mitis / Fishtail Palm 20' Ht.	
			1	Clerodendrum quadriloculare / Starburst 20' Ht. x 10' Spr., 5" DBH	
			6	Dypsis lutescens / Areca Palm 20-25' Ht.	
			3	Myrcianthes fragrans / Simpson Stopper 20' Ht. x 7-10' Spr., 3-5" DBH	
			27	Ptychosperma elegans / Solitaire Palm 20-30' Ht.	
			14	Roystonea elata / Cuban-Florida Royal Palm 30-60' Ht.	
			4	Sabal palmetto / Cabbage Palm 20-30' Ht.	
			1	Syagrus romanzoffiana / Queen palm 30' Ht.	
			1	Tabebuia heterophylla / Pink Trumpet Tree 25' Ht. x 15' Spr., 7" DBH	
			1	Washingtonia robusta / Washington Palm 60' Ht.	
			1	Yucca aloifolia / Spanish Bayonet 15' Ht.	
			41	Palms Counted 3:1 - Christmas, Solitaire, Sabals, Queen, Washingtonia	
	SED	TREES / P.	ALMS		
LI		V	1	Lagerstroemia indica / Crape Myrtle 12'x5-6', 2" DBH, Sng. Trunk	
KF	(N)	V	1	Krugiodendron ferreum / Black Ironwood 12'x5-6', 2" DBH, Sng. Trunk	
			2	Total Site Trees	
			1	Native Trees	
			50%	Native Trees	
EXISTI	NG TR	EES / PAL	MS TO BE F	REMOVED	
#19			1	Ptychosperma elegans / Solitaire Palm 20' Ht.	
#34			1	Myrcianthes fragrans / Simpson Stopper 20' Ht. x 7-10' Spr., 3" DBH	
#35			1	Myrcianthes fragrans / Simpson Stopper 20' Ht. x 7-10' Spr., 5" DBH	
	TION	TREE LIST			
Code		Drought	QTY.	Botanical Name / Common Name Specifications	Total
NA		NA	0	No Mitigation Trees NA	
				Total DBH Added	0
				Total DBH Removed	8
				DBH Deficiency	
MITICA	TION	DALMILIC	_	Payment Into the Tree Trust Fund @ \$350 per every 2" =	\$1,400
Code	HON	PALM LIS		Botanical Name / Common Name Specifications	Total
AM		Drought	QII.		Total
AIVI		V	- '	Adonidia merrillii / Christmas Palm 8' CT  Total Palms Added	- 1
				Total Palms Removed	1
				Palms Deficiency	0
HEDGE		HRUBS			
CRS	(N)	V	18	Clusia rosea / Small Leaf Clusia 48"x 24", 36" OC	
PMP		V	7	Podocarpus maki / Podocarpus 5'6' OA Ht., 2' CT, Sng. Trunk	
			25	Total Shrubs	
			18	Native Shrubs	
			72%	Native Shrubs	


By GC S.F. Stenotaphrum secundatum / St. Augustine 'Palmetto' Solid install, no gaps between seams

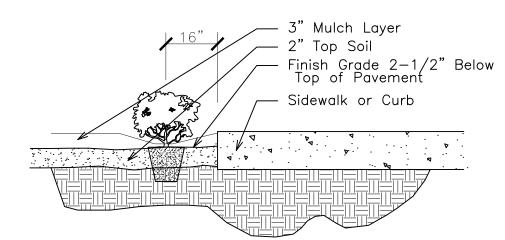

# SHRUB INSTALLATION DETAIL

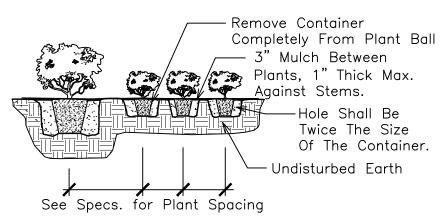


# SHRUB PLANTING DETAIL

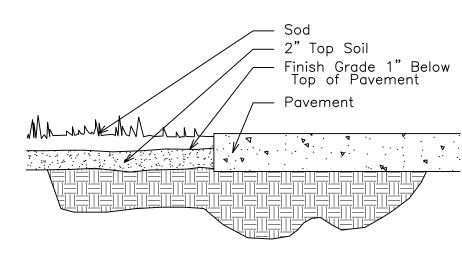

# SOD INSTALLATION DETAIL

# EXISTING TREE / PALM LIST


SCIENTIFIC NAME	COMMON NAME	DBH	SPREAD	HEIGHT	TPZ RADIUS	CONDITION	DISPOSITION
1.Adonidia merrillii	Christmas palm tree	4"	6'	25'	2'	FAIR 80%	REMAIN
2.Clerodendrum quadriloculare	Starburst tree	5"	10'	20'	3'	FAIR 80%	REMAIN
3.Sabal palmetto	Cabbage palm tree	9"	10'	22'	3'	FAIR 80%	REMAIN
4.Roystonea regia	Royal palm tree	14"	22'	58'	3'	FAIR 80%	REMAIN
5,6.Ptychosperma elegans (8)	Solitaire palm tree	2"ea.	5'ea.	18'-33'ea.	2'ea.	FAIR 80%	REMAIN
7.Roystonea regia	Royal palm tree	13"	20'	43'	3'	FAIR 80%	REMOVE #19
8.Syagrus romanzoffiana	Queen palm tree	8"	16'	32'	3'	FAIR 80%	REMAIN
9.Roystonea regia	Royal palm tree	15"	22'	44'	3'	FAIR 80%	REMAIN
10.Sabal palmetto	Cabbage palm tree	16"	10'	21'	3'	FAIR 80%	REMAIN
11.Roystonea regia (2)	Royal palm tree	8"-9"ea.	22'ea,	30'ea.	3'ea.	FAIR 80%	REMOVE
12. Washingtonia robusta	Mexican Fan palm tree	7"	8'	58'	3'	FAIR 80%	REMAIN
13-18.Roystonea regia (6)	Royal palm tree	10"-14"ea.	22'ea.	36'-56'ea.	3'ea.	FAIR 80%	REMOVE
19-22.Ptychosperma elegans (8)	Solitaire palm tree	2"ea.	6'ea.	18'-30'ea.	2'ea.	FAIR 80%	REMAIN
23.Myrcianthes fragrans	Simpson Stopper tree	3"	7'	19'	3'	FAIR 80%	REMOVE
24-26.Dypsis lutescens (3)	Areca palm tree	14"-20"ea.	15'-22'ea.	20'-27'ea.	3'ea.	FAIR 80%	REMOVE
27.Tabebuia rosea	Pink Trumpet tree	7"	16'	26'	4'	FAIR 80%	REMAIN
28-32.Schefflera actinophylla (5)	Umbrella tree	4"-16"ea.	20"25'ea.	20'-30'ea.	8'ea.	POOR/INVASIVE 50%	REMAIN
33.Roystonea regia	Royal palm tree	14"	22'	46'	3'	FAIR 80%	REMAIN
34,35.Myrcianthes fragrans (2)	Simpson Stopper tree	3"-5"ea.	7-14'ea.	20'-24'ea.	3'ea.	MODERATE 60%	REMOVE
36,37.Dypsis lutescens (2)	Areca palm tree	10"-20"ea.	14'-20'ea.	22'-27'ea.	3'ea.	MODERATE 60%	REMAIN
38-41.Schefflera actinophylla (4)	Umbrella tree	8"-36"ea.	15'-20'ea.	20'-25'ea.	8'ea.	POOR/INVASIVE 50%	REMAIN
42,43.Cupaniopsis anacardioides (2)	Carrotwood tree	15"-17"ea.	25'ea.	24'-28'ea.	9'ea.	FAIR/INVASIVE 80%	REMAIN
44.Sabal palmetto	Cabbage palm tree	9"	12'	32'	3'	FAIR 80%	REMAIN
45.Caryota mitis	Fishtail palm tree	13"	16'	22'	3'	POOR 50%	REMAIN
46,47.Ptychosperma elegans (7)	Solitaire palm tree	2"ea.	5'ea.	16'-26'ea.	2'ea.	FAIR 80%	REMAIN
48.Dypsis lutescens	Areca palm tree	20"	20'	26'	3'	MODERATE 60%	REMAIN
49. Yucca aloifolia	Spanish Bayonet tree	5"	7'	14'	3'	MODERATE 70%	REMAIN
50.Ptychosperma elegans (4)	Solitaire palm tree	2"ea.	6'ea.	23'-28'ea.	2'ea.	FAIR 80%	REMAIN
51,52.Roystonea regia (2)	Royal palm tree	11"-13"ea.	22'ea.	40'-47'ea.	3'ea.	FAIR 80%	REMAIN
53.Sabal palmetto	Cabbage palm tree	10"	8'	30'	3'	FAIR 80%	REMAIN

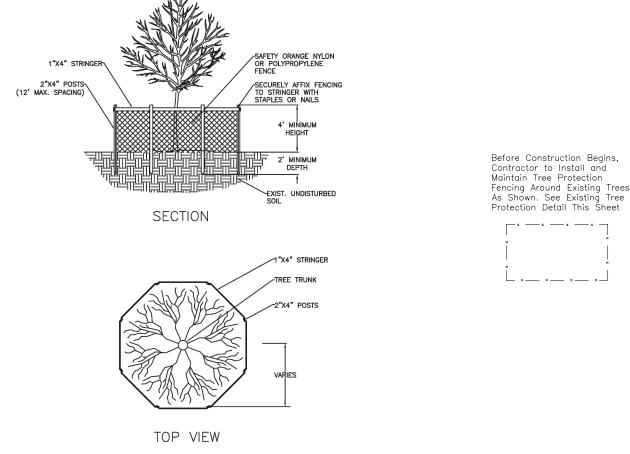


NOTES:


1. BARRICADE CIRCLE TO BE CENTERED ON TREE TRUNK(S). FOR GROUPS OF TREES, PLACE BARRICADES BETWEEN TREES AND CONSTRUCTION ACTIVITY.

2. TREE PROTECTION BARRICADES SHALL BE LOCATED TO PROTECT EXISTING, RELOCATED AND NEW TREES IN CONSTRUCTION AREAS. THE PROTECTIVE BARRIER SHALL BE PLACED AROUND THE TREE AT A DISTANCE 6 FEET FROM THE TREE TRUNK OR AT THE CANOPY DRIP LINE, WHICHEVER IS GREATER OR AS SHOWN ON

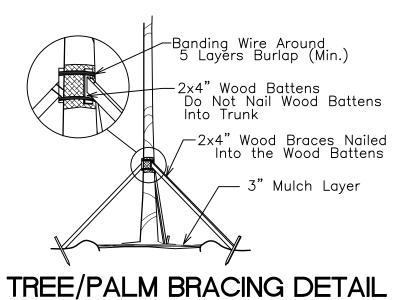

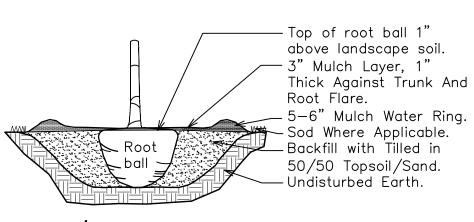

TREE/PALM PLANTING DETAIL

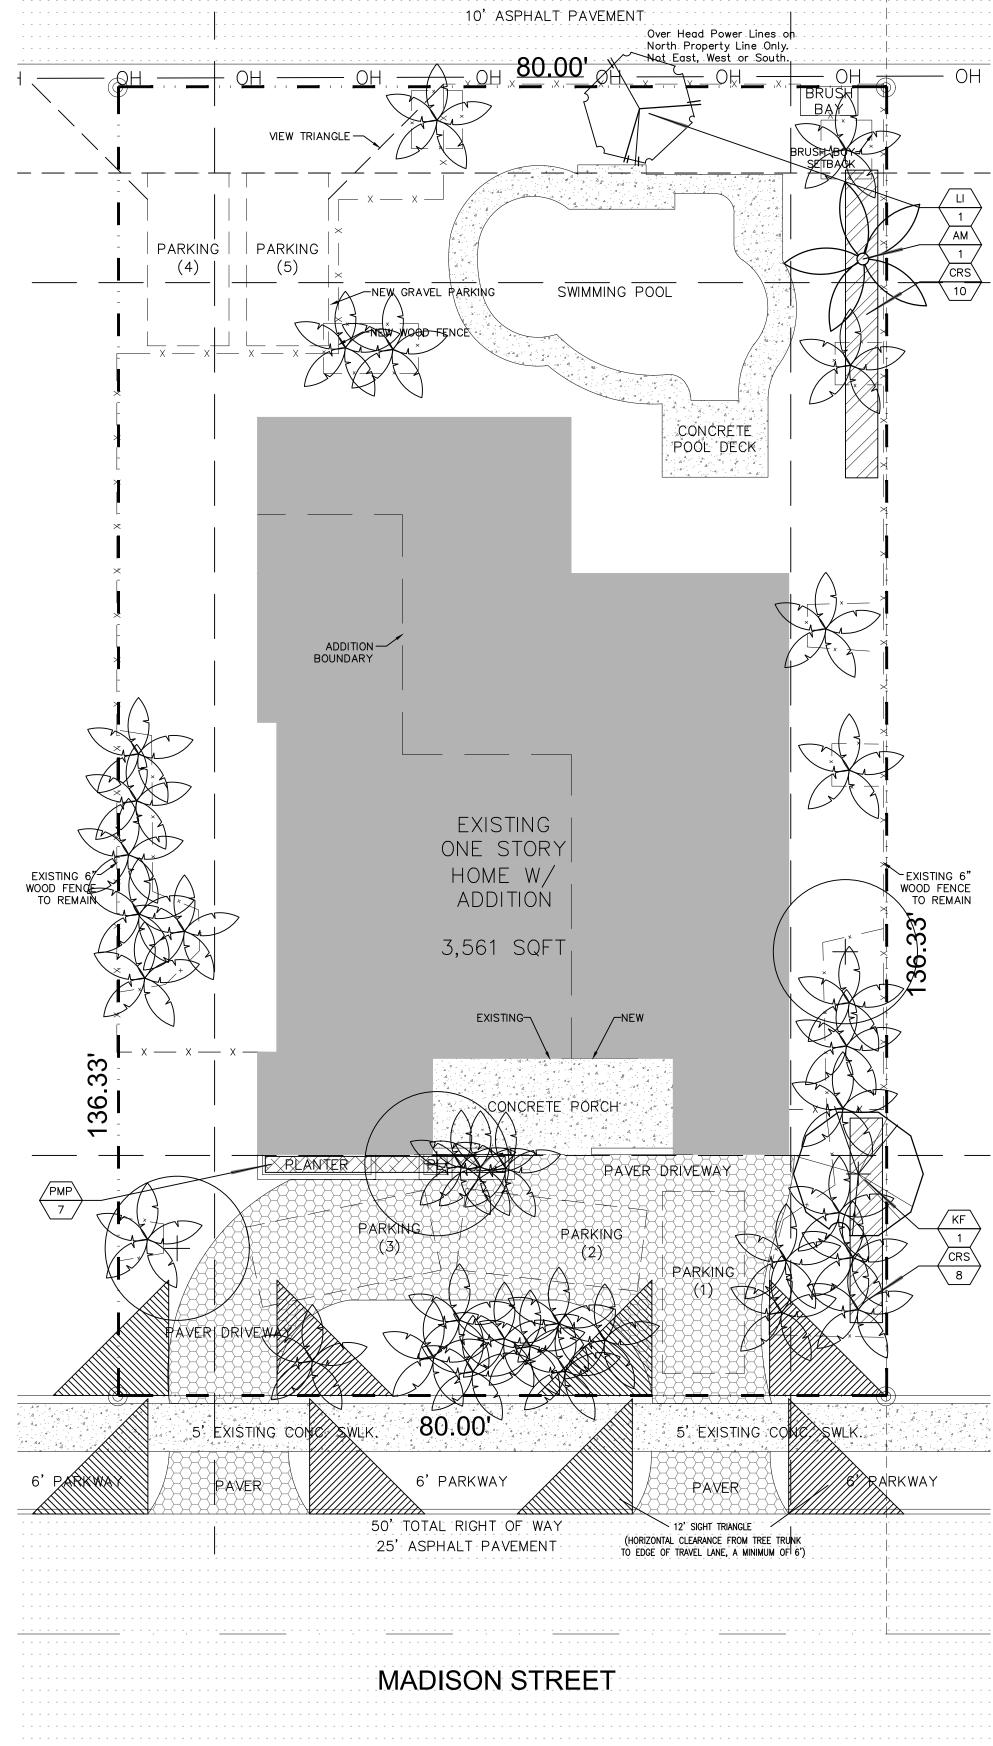

# LANDSCAPE PLAN


	F:	1"-10"	_
JUAL	-⊏·	1 -10	

CITY OF	- HOLL	YWOOD PLANTING CALCULATIONS	Required	Provided	
Sec. 2.1:1	Perime	eter Street Tree Requirement: One 12' Tree at 50' OC			
		Feet of Madison Street	2	2	2 Exist: #4 & #11 Royal
Sec. 2.1	SFR: T	ree and Shrub Requirement - Single Family Residence			
	3	Trees Front Half of Plot	3	3	1 Exist: #23 Stopper
					1 Exist: #27 Pink Tab
	15	Shrubs Front Half of Plot	15	15	
	1	Tree Rear Half of Plot	1	1	
	10	Shrubs Rear Half of Plot	10	10	
		Total Trees:	6	6	
		Total Shrubs:	25	25	

Sunshine 81 Call 811 or www.sunshine811.com two full

business days before digging to have utilities located and marked. Check positive response codes before you dig!



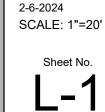

REVISIONS

Single

CHECKED: DATE:

## IRRIGATION LEGEND:

1" MAIN LINE

LATERAL ZONE LINES.

1" VACUUM BREAKER: Wilkins WK720A-100.

CONTROLLER — Intermatic Electric 4 station controller.

Mini Clik automatic rain sensor shutoff switch mounted outside on eave of structure.


ZONE VALVES — Fimco 3 Station Indexing.


SLEEVES -Sch. 40, 2 Sizes Larger. NOTE - Pipe Size Shown is the Lateral Size, NOT the Sleeve Size

> 6" POP-UP SPRAY -Hunter MP Rotator Series: Nozzles as Required.

NOTE — All of the below may not be used

MP2000 MP1000 MP800 13-21' 8-15' 6-12' Radius Radius Radius 90 Q 120 T 180 H 240 TT 270 TQ

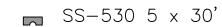

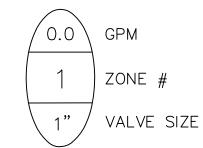

# IRRIGATION NOTES:

Main Lines: PVC SCH 40 Solvent Weld. Zone Lines: PVC SCH 40 Solvent Weld. 1/2 in. and 3/4 in. are not used. All lateral pipe is 1 inch. Sleeves and suction Line: PVC SCH 40.

Fittings: SCH 40 PVC

Fabrication: To manufacturers specifications. Use blue or grey PVC cement, square cut, clean and prime all joints.

Allow all main lines to cure for 24 hours before pressuring.

selection to provide for proper 100% min. coverage.

All pipe, fittings, and solvents to conform to latest ASTM specs.

Depth of Lines: Main Line and wiring = 18 in. depth, min. Sleeving under pavement = 24 in. depth, min. Suction Line = 24 in. depth, nominal. Zone Lines 1-1/2 in. and smaller = 15 in. depth, min.

AWG 14 for all hot wires and AWG 12 for common. Solid copper type UF UL listed for direct burial. Run wires under main. Run spares, two min.

Splice wires only in a valve box. All splices shall be moisture proof using Snap tite or DBY UL connectors.

Common shall be white, hot shall be red or color coded Spare shall be black. Run all wires in Grey Electrical SCH 40 conduit..


Backfill all trenches free of debris, compact to original density, flush all lines, use screens in all heads, adjust heads


for proper coverage avoiding excess water on walls, walks, etc. All details are graphically shown only. All quantities shall be verified by the contractor prior to installation. It shall be the contractors responsibility to assure complete overlapping coverage. Any discrepancies shall be reported to the owner and landscape architect before proceeding. Codes and local regulations shall take precedence over these plans, it is the contractors responsibility

to comply. The landscape architect reserves the right to make minor field changes, the contractor may field adjust spray nozzle


Provide owner with an accurate as installed plan(s) at completion showing main lines, wiring, valves, crossings, etc. using dimensions from fixed datums.

Contractor shall verify all underground utilities prior to commencement of work.

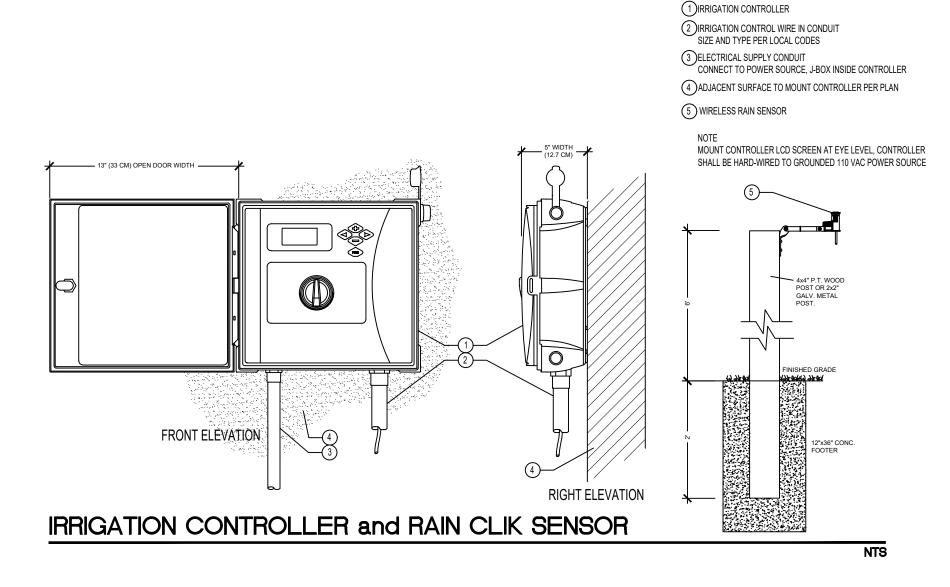

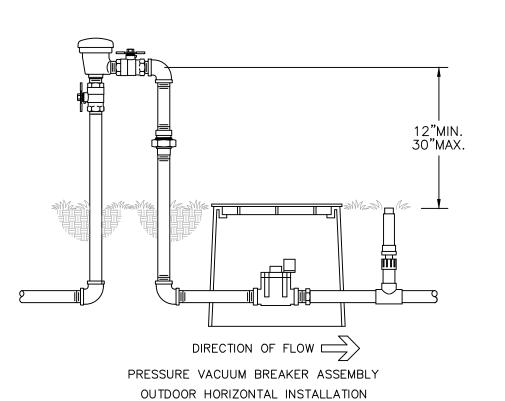


**WILKINS MODEL 720A** 

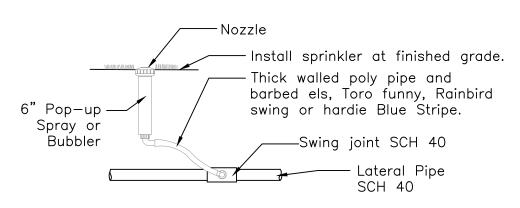

6" Pop-up Spray / Bubbler Detail

NTS

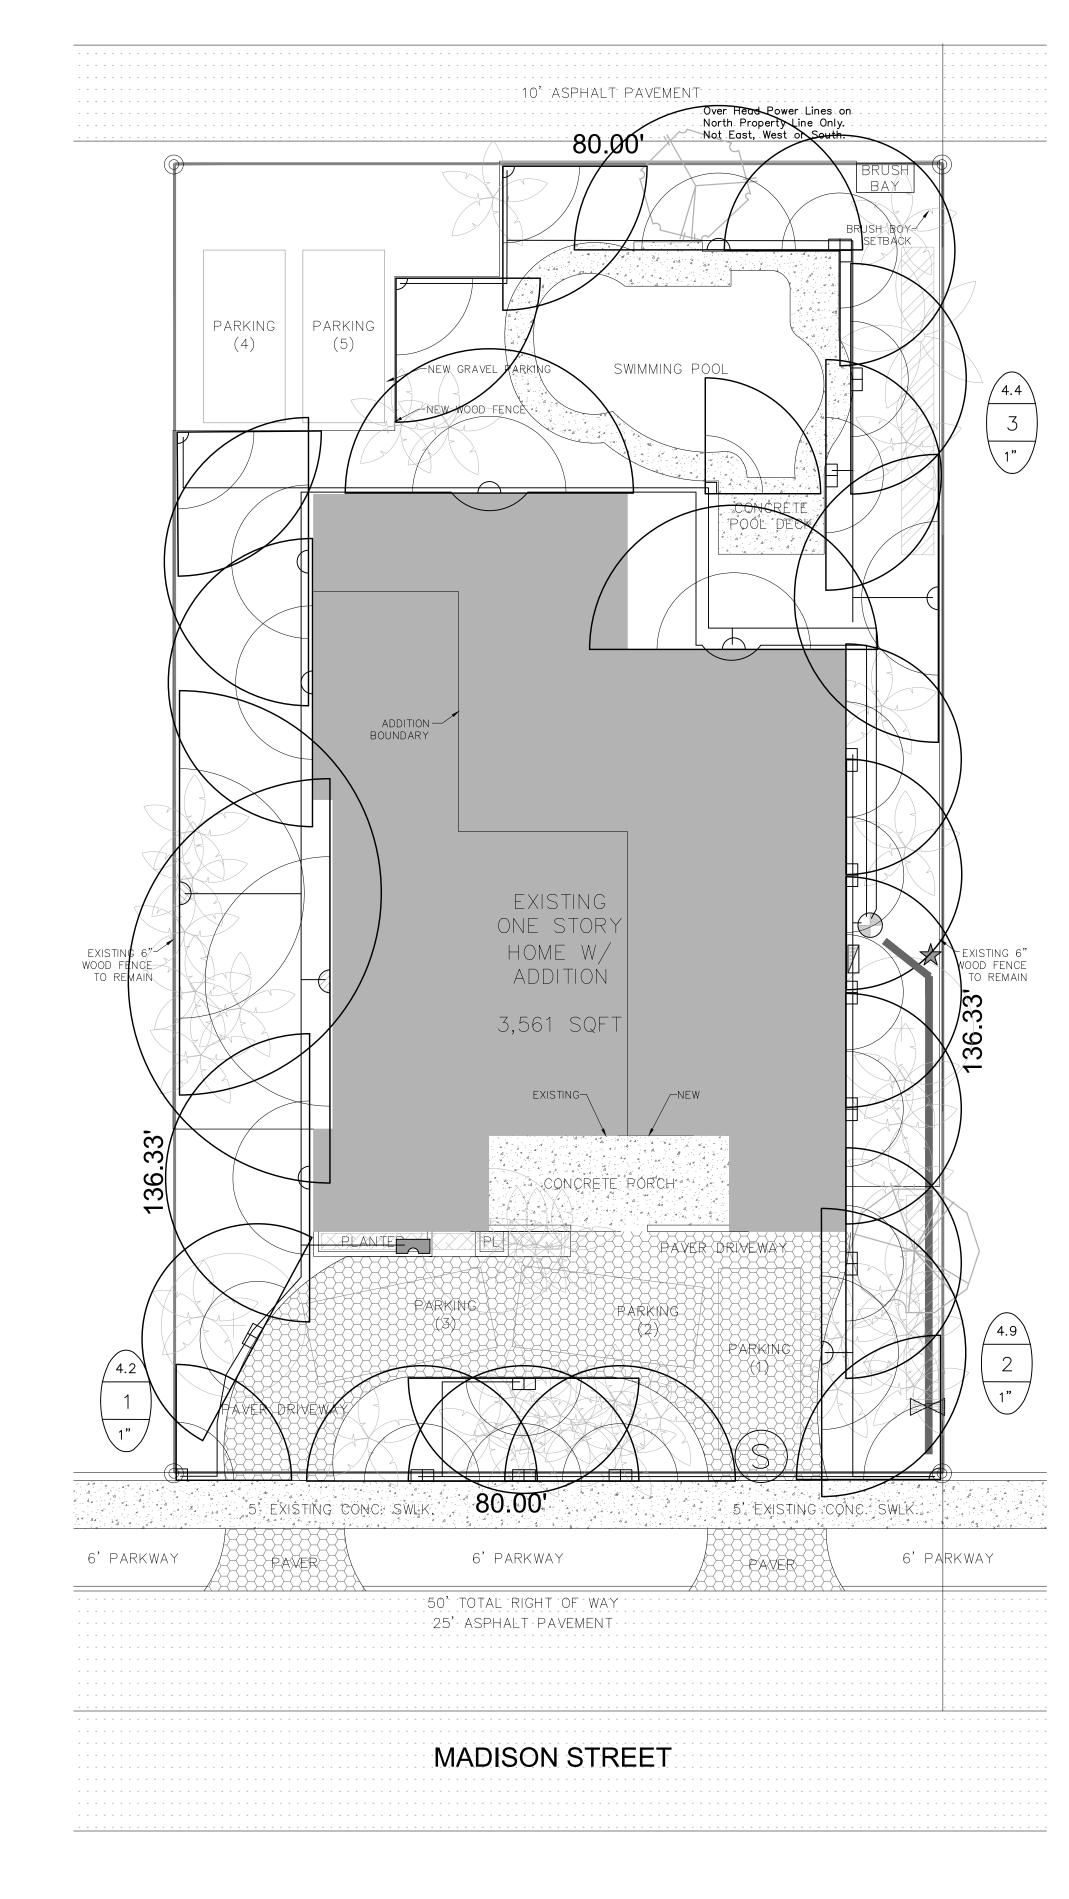



business days before digging to have utilities located and marked. Check positive response codes before you dia!





CHECKED:


SCALE: 1"=10'


DATE: 2-6-2024


Single

**REVISIONS** 

Call 811 or www.sunshine811.com two full

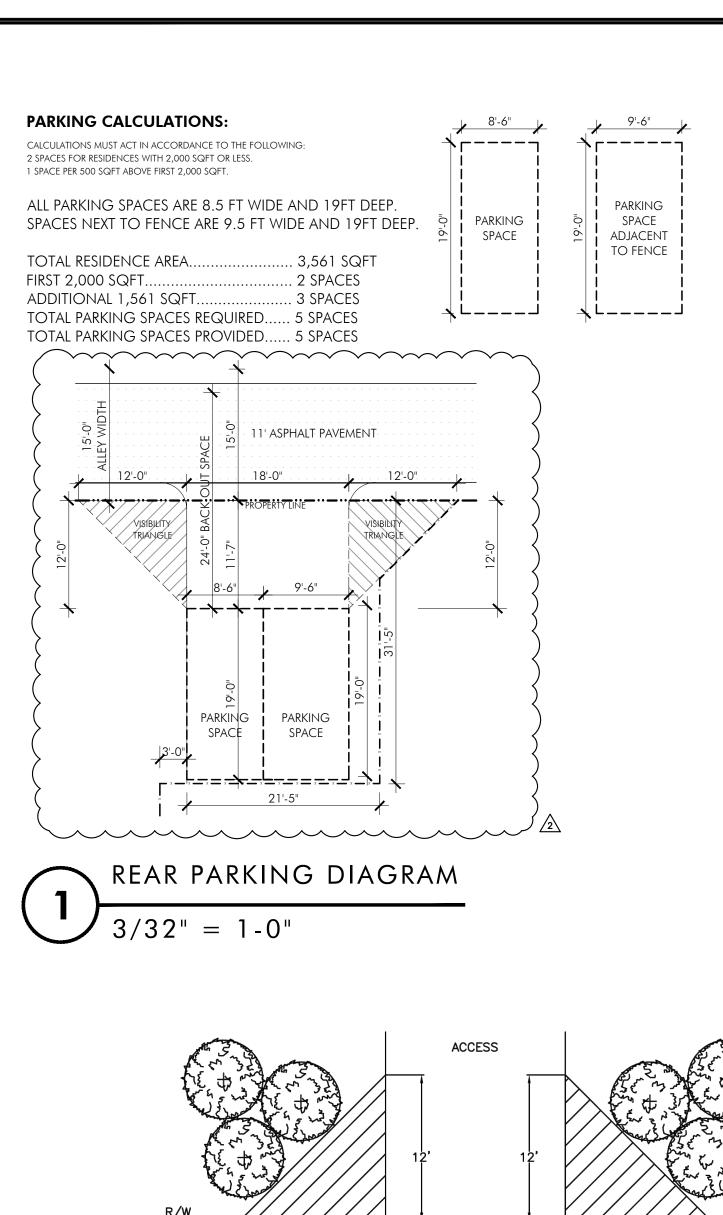

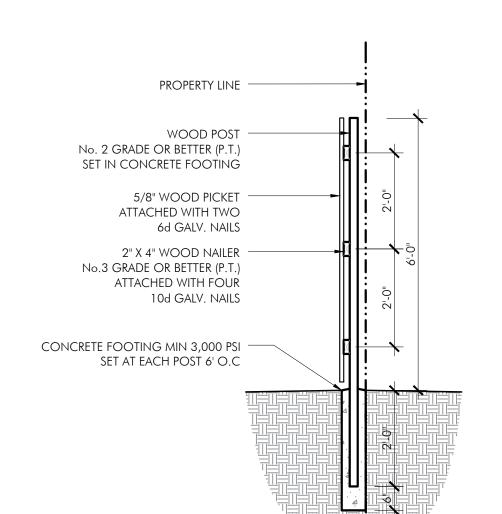

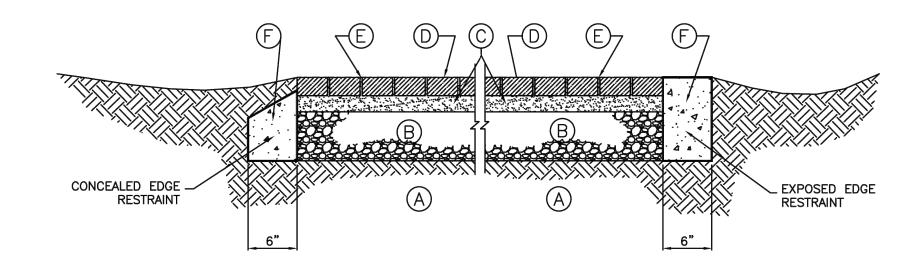

## LEGEND:

- (A) SUITABLE SUBGRADE (SEE NOTE No. 1)
- B LIMEROCK BASE COMPACTED TO A MIN. OF 98%
  OF MAX. DENSITY AS DETERMINED BY AASHTO T-180
  MINIMUM THICKNESS REQUIRED:
  6" IN THE PUBLIC RIGHT OF WAY
  4" ON PRIVATE PROPERTY
- © SAND BEDDING COURSE, 2" TYPICAL.

  (D) CONCRETE SEGMENTAL PAVING UNITS
- JOINT-FILLING SAND
   3,000PSI CONCRETE CONTINUOUS EXPOSED EDGE RESTRAINT REQUIRED IN THE PUBLIC RIGHT-OF-WAY.

## LIMITATIONS:


1. LIGHT TRAFFIC AND DOMESTIC USE ONLY. HEAVIER TRAFFIC OR UNSUITABLE SOIL CONDITIONS REQUIRE SPECIAL PAVEMENT STRUCTURE AND THICKNESS DESIGN.

2. SURFACE DRAINAGE: RECOMMENDED MINIMUM

2. SURFACE DRAINAGE: RECOMMENDED MINIMUM GRADE OF 2% TO SWALE PERVIOUS AREA.
3. THIS IS A NON-STANDARD TYPE OF DRIVEWAY CONSTRUCTION AND AN AFFIDAVIT IS REQUIRED FROM THE OWNER FOR WORK IN PUBLIC RIGHT-OF-WAY OR EASEMENT.




3 CONCRETE PAVERS DETAIL

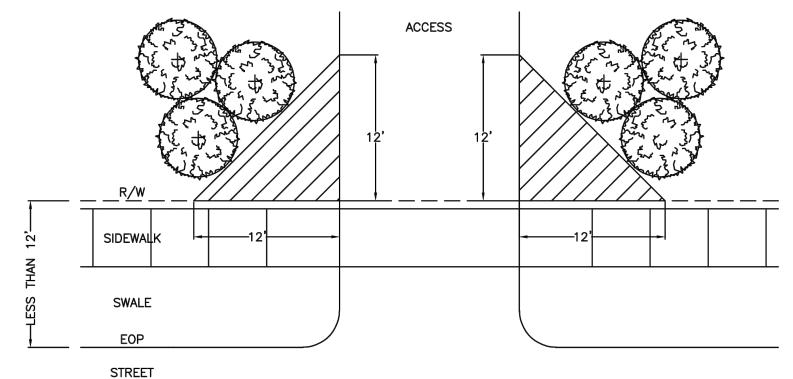

1. ALL FENCES, WALLS, BUSHES, HEDGES, AND ANY OTHER LANDSCAPING OR PLANT MATERIAL, WITHIN THE VIEW TRIANGLE SHALL PROVIDE UNOBSTRUCTED CROSS VISIBILITY AT A LEVEL BETWEEN 30 INCHES AND 72 INCHES ABOVE GROUND LEVEL.

2. TREES HAVING OVER 72 INCHES OF CLEAR TRUNK WITH LIMBS AND FOLIAGE TRIMMED IN SUCH A MANNER AS NOT TO EXTEND INTO THE VIEW TRIANGLE SHALL BE PERMITTED WITHIN SAID AREAS, PROVIDED THEY IN NO WAY IMPEDE VISIBILITY. NO LANDSCAPING ELEMENTS, EXCEPT FOR REQUIRED GRASS OR GROUND COVER, SHALL BE LOCATED CLOSER THAN 36 INCHES FROM THE EDGE OF ANY VEHICULAR TRAVEL LANE.



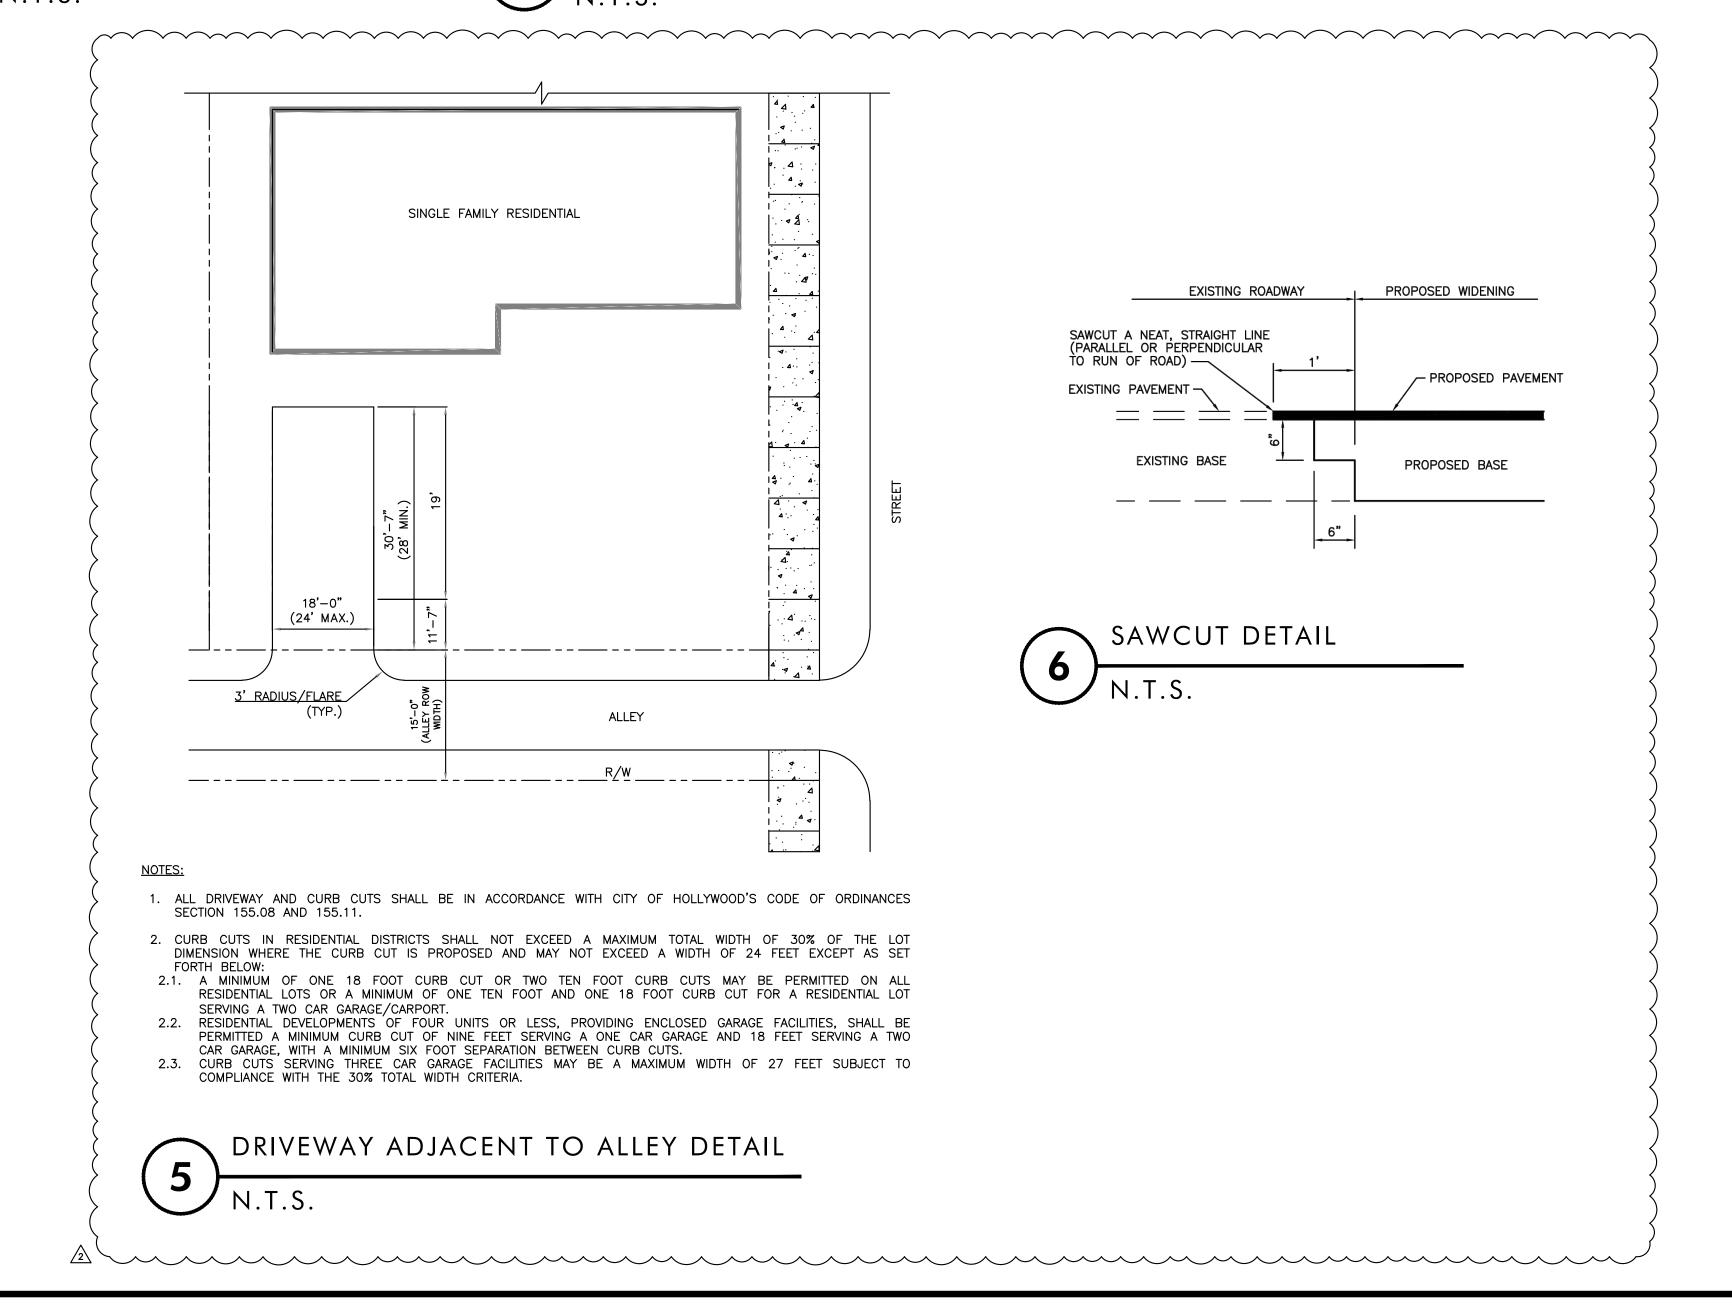

SCHISM ARCHITECTURE + DESIGN

SCHNEUR Z. MEYER, AIA
FL: AR101781

1622 NW 36TH ST, MIAMI FL 33142

1622 NW 36TH ST, MIAMI FL 33142

SAD-ARC.COM

TEL (305) 761-2541

CHITECTURE + DESIGN

ENOVATION & ADDITION

PLEASE NOTE: THESE PLANS ARE FOR BUILDING DEPARTMENT REVIEW
THEY ARE NOT TO BE CONSTRUED AS FINAL CONSTRUCTION
DOCUMENTS UNTIL ALL BUILDING DEPARTMENT APPROVALS ARE
BRANED AND COMMENTS ARE INCORPORATED INTO THESE DRAWIN
DUE TO THE VARIATIONS IN INTERPRETATIONS OF THE CODE THAT
DOCUR IN DIFFERENT MUNICIPALITIES FINAL APPROVAL AND REVIEW
NEEDED TO ASSURE COMPLIANCE WITH THE APPLICABLE CODES AND
STANDARDS.
PLEASE NOTE: THIS DRAWING SET AND ITS SPECIFICATIONS NOTICE C
CCEPTANCES, PRODUCT AND EQUIPMENT BOOKS AND MANUALS, AS
SOIL REPORTS SHALL CONSTITUTE A SINGLE ENTITY. NO PART OF THI
ENTITY SHALL BE CONSIDERED WITHOUT THE OTHERS, ANY
INFORMATION WITHIN THIS SET AND SPECIFICATION MUST BE
NDERSTOOD AS PART OF THE WHOLE SET. IT IS THE RESPONSIBILITY.

THE CONTRACTOR AND HIS SUB CONTRACTORS TO BE FAMILIAR WALL ASPECTS OF THE WORK DESCRIBED WITHIN THIS DRAWING SE ANY CONFLICTS ARISE AS WITHIN THE DESCRIPTION OF WORK IN T DRAWING SET THE CONTRACTOR MUST NOTIFY THE OWNER AND ARCHITECT PRIOR TO THE BEGINNING OF ANY BIDDING, WORK AND PURCHASING.

DRAWN BY: SZM
DATE: 5/3/2024

REVISIONS:

2/15/24 BLDG DEPT COMMENTS

5/3/24 BLDG DEPT COMMENTS

DRAWING TITLE:

SITE PLAN NOTES + DETAILS

PROJECT # 2307

DRAWING NO.

A 1.00 B

ARCH 0'-0" = 3.20' N.A.V.D.