

PROJECT TEAM

<u>OWNER</u> CHABAD OCEAN SYNAGOGUE, INC. RABBI MENASHE KUDAN A: 5-1 SEACREST PKWY HOLLYWOOD, FL 33019	<u>CIVIL ENGINEER:</u> GGG ENGINEERING, INC MR. GARY BLOOM, P.E. 2699 STIRLING RD, SUITE C-202 FORT LAUDERDALE, FL, 33312 PH: 954-986-3893
<u>ARCHITECT</u> KALLER ARCHITECTURE MR. JOSEPH B. KALLER, F.A. FIRL: JOSEPH B. KALLER 2411 HOLLYWOOD BLVD. HOLLYWOOD, FL 33020 P: (954) 920-5146 E: (954) 926-2841 E: joseph@kallerarchitects.com	<u>LANDSCAPE ARCHITECT:</u> THE MIRROR OF PARADISE MS. GABRIELA RUIZ, AIA, LA 3324 N OCEAN DRIVE FORT LAUDERDALE, FL 33308 PH: 954-478-3064
<u>SURVEYOR</u> JOHN IBARRA & ASSOCIATES, INC. MR. JOHN IBARRA A: 711 NUI TAND AVE. MIAMI, FL 33106 P: (305) 262-0400 E: (305) 262-0401 E: jibarra@ibarralandsurveyors.com	<u>SITE LIGHTING:</u> GENESIS LIGHTING MR. RYAN MCCARTHY 1401 NW 8 STREET SUNRISE, FL 33375 PH: 954.306.3931 FX: 954.306.3404

PROJECT DATA

LEGAL DESCRIPTION:
 LOT 15 AND 14, OF 9EACREST, ACCORDING TO THE FLAT THEREOF AS
 RECORDED IN PLAT BOOK 23, PAGE 16, OF THE PUBLIC RECORDS OF BROWARD
 COUNTY, FLORIDA. (REFER TO ALTA SURVEY FOR FULL DESCRIPTION)

ADDRESS:
 5- 7 9EACREST PKWY
 HOLLYWOOD, FL 33009

FOLIO NUMBER:
 514226100100 - 514226100110

PROPERTY OWNER:
 CHABAD OCEAN DRIVE SYNAGOGUE, INC,

JURISDICTION:
 CITY OF HOLLYWOOD
 BROWARD COUNTY
 STATE OF FLORIDA

1. SITE DATA:

- ZONING
- EXISTING LAND USE:
- PROPOSED USE:

RY-2B
 MHRS-3 - MEDIUM HIGH RESIDENTIAL
 ' PLACE OF WORSHIP

C. OCCUPANT LOADS:

NOTE: GROSS AREAS ARE MEASURED TO THE OUTSIDE FACE OF EXTERIOR
 WALLS AND GRILES IN CASE OF OPENING WALLS. NET AREAS ARE
 MEASURED TO THE INSIDE FACE OF FINISHED WALLS.

1. GROUND FLOOR

GALLERY	ASSEMBLY	30 NET	505 SF.	17 PERSONS
---------	----------	--------	---------	------------

2. SECOND FLOOR

LIBRARY	READING ROOM	50 NET	1016 SF.	20 PERSONS
OFFICES	BUSINESS	100 GROSS	498 SF.	5 PERSONS
PLAYROOM	DAYCARE	35 NET	418 SF.	12 PERSONS
SANCTUARY	ASSEMBLY (C)	1 NET	1511 SF.	224 PERSONS
JANITOR	ACCESSORY	300 GROSS	219 SF.	1 PERSONS
SUBTOTAL				262 PERSONS

3. THIRD FLOOR

KIDDUSH ROOM	ASSEMBLY (W)	15 NET	2025 SF.	135 PERSONS
KITCHEN		200 GROSS	728 SF.	4 PERSONS
STORAGE	ACCESSORY	300 GROSS	219 SF.	1 PERSONS
SUBTOTAL				140 PERSONS

4. FOURTH FLOOR

BRIDE ROOM	RESIDENTIAL	200 GROSS	195 SF.	1 PERSONS
CLASSROOM	EDUCATIONAL	20 NET	1055 SF.	53 PERSONS
JANITOR	ACCESSORY	200 GROSS	91 SF.	1 PERSONS
TERRACE	ASSEMBLY (W)	1 NET	1931 SF.	284 PERSONS

1. ELECTRIC VEHICLE (EV) CHARGING STATION/ PARKING.
2. RECYCLE BIN PROVIDED WITHIN TRASH ROOM.
3. CENTRAL AIR CONDITIONER OF 18 SEER OR HIGHER SHALL BE PROVIDED.
4. WINDOWS SHALL BE LOW-E.
5. DOORS SHALL BE ENERGY EFFICIENT.
6. ROOFING MATERIALS ARE ENERGY STAR RATED.
7. ALL THERMOSTATS PROVIDED SHALL BE PROGRAMMABLE.
8. 100% OF THE LANDSCAPING MEETS THE SOUTH FLORIDA WATER MANAGEMENT DISTRICT RECOMMENDATIONS.
9. OUTDOOR LIGHTING SHALL BE ENERGY-EFFICIENT.
10. ALL HOT WATER PIPES HAVE A MINIMUM OF 1/2" INSULATION.

	<u>SITE</u>
T-1	COVER SHEET
SU-1	BOUNDARY SURVEY
DE-1	EXISTING/ DEMOLITION PLAN
SP-1	NEW SITE PLAN
SP-2	SITE DETAILS
SP-3	SITE DETAILS AND BUILDING SIGNAGE DETAILS
SL-1	SITE PHOTOMETRICS PLAN
SL-2	SITE PHOTOMETRICS SPECIFICATIONS

C-1	CIVIL ENGINEERING PLAN
C-2	PAVEMENT MARKINGS AND SIGNAGE PLAN
C-3	CONSTRUCTION DETAILS
C-4	CONSTRUCTION DETAILS
C-5	CONSTRUCTION DETAILS
C-6	CONSTRUCTION DETAILS
C-7	STORMWATER POLLUTION PREVENTION PLAN
C-8	STORMWATER POLLUTION PREVENTION PLAN
C-9	STORMWATER POLLUTION PREVENTION PLAN

DT-1	TREE RELOCATION PLAN
LP-1	LANDSCAPE PLAN (GROUND LEVEL), CODE, NOTES
LP-2	LANDSCAPE PLAN ROOF GARDEN AND DETAILS
IR-1	IRRIGATION PLAN - GROUND LEVEL
IR-2	IRRIGATION PLAN - ROOF GARDEN, NOTES AND DETAILS
<u>ARCHITECTURE</u>	

A-1	GROUND FLOOR PLAN
A-2	SECOND FLOOR PLAN
A-3	THIRD FLOOR PLAN
A-4	FOURTH FLOOR PLAN
A-5	ROOF PLAN
A-6	FRONT ELEVATION (NORTH)
A-7	REAR ELEVATION (SOUTH)
A-8	SIDE ELEVATION (EAST)
A-9	SIDE ELEVATION (WEST)
A-10	EXTERIOR RENDERINGS

C. OCCUPANT LOADS:

NOTE: GROSS AREAS ARE MEASURED TO THE OUTSIDE FACE OF EXTERIOR WALLS AND CENTER LINE OF DIVISIONS. NET AREAS ARE MEASURED TO THE INSIDE FACE OF FINISHED WALLS.

1. GROUND FLOOR			
GALLERY -----	ASSEMBLY	@ 30 NET	505 SF. 17 PERSONS
2. SECOND FLOOR			
LIBRARY -----	READING ROOM	@ 50 NET	1016 SF. 20 PERSONS
OFFICES -----	BUSINESS	@ 100 GROSS	436 SF. 5 PERSONS
PLAYROOM -----	DAYCARE	@ 35 NET	418 SF. 12 PERSONS
SANCTUARY -----	ASSEMBLY (C)	@ 7 NET	151 SF. 224 PERSONS
JANITOR -----	ACCESSORY	@ 300 GROSS	219 SF. 1 PERSONS
SUBTOTAL -----			262 PERSONS
3. THIRD FLOOR			
DPUSH ROOM -----	ASSEMBLY (W)	@ 15 NET	2025 SF. 135 PERSONS
KITCHEN -----	KITCHEN	@ 200 GROSS	718 SF. 4 PERSONS
STORAGE -----	ACCESSORY	@ 300 GROSS	219 SF. 1 PERSONS
SUBTOTAL -----			140 PERSONS
4. FOURTH FLOOR			
BRIDE ROOM ---	RESIDENTIAL	@ 200 GROSS	195 SF. 1 PERSONS
CLASSROOMS ---	EDUCATIONAL	@ 20 NET	1055 SF. 53 PERSONS
JANITOR -----	ACCESSORY	@ 300 GROSS	91 SF. 1 PERSONS
TERRACE -----	ASSEMBLY (W)	@ 7 NET	1391 SF. 284 PERSONS
SUBTOTAL -----			339 PERSONS
TOTAL -----			750 PERSONS

* NOTE: ASSEMBLY ROOMS SHALL BE USED INDEPENDENTLY AND NEVER AT THE SAME TIME.

2017 FLORIDA BUILDING CODE
2018 FLORIDA FIRE PREVENTION CODE

1. OCCUPANCY TYPE _____ GROUP 'A' - ASSEMBLY
(SECTION 303.1)

2. CONSTRUCTION TYPE _____ TYPE IIIA
(SECTION 602)

3. ULTIMATE DESIGN WIND SPEED _____ 190 MPH
(FIGURE 1603.3)

4. RISK CATEGORY _____ CAT III
(SECTION 1604.5)

5. FIRE SPRINKLER _____ YES - FULLY AUTOMATIC
(SECTION 903.2.1)

6. FIRE ALARM _____ YES
(SECTION 907.2.1)

An architectural rendering of a modern building complex. The central focus is a multi-story building with a light-colored, textured facade and a large, glass-enclosed section. To its left is a parking lot with several cars. In the background, several tall, modern high-rise buildings are visible under a cloudy sky. The foreground shows a paved area with some landscaping and a small structure.

SHEET TITLE

COVER SHEET
PROJECT LOCATION
INDEX

REVISIONS
No. DATE DESCRIPTION

1		
2		
3		
100		

This drawing, as an instrument of service, is and shall remain the property of the Architect and shall not be reproduced, published or used in any way without the permission of the Architect.

PROJECT No.: 18067
DATE: 12/21/2018
DRAWN BY: JP
CHECKED BY: JBK

SHEET

T-1

CHABAD OCEAN JEWISH CENTER

[illegible]

KallerArchitecture

AA# 26001212
2417 Hollywood Blvd.
Hollywood Florida 33020
954.920.5746
joseph@kallerarchitects.com

www.kallerarchitects.com

SEAL

JOSEPH B. KALLER
FLORIDA R.A. # 0009239

**CHABAD OCEAN
JEWISH CENTER**
7 SEACREST PKWY
HOLLYWOOD, FL 33019

PROJECT TITLE

COVER SHEET
PROJECT LOCATION
INDEX

SHEET TITLE

REVISION	DATE	DESCRIPTION
1	10/10/2018	Initial design
2	11/10/2018	Revised design
3	12/10/2018	Final design


No.	DATE	DESCRIPTION
-----	------	-------------

PROJECT No.: 18067
DATE: 12/21/2018
DRAWN BY: JP
CHECKED BY: JBK

SHEET


T-1

KALLER ARCHITECTURE, ALL RIGHTS RESERVED © 2018

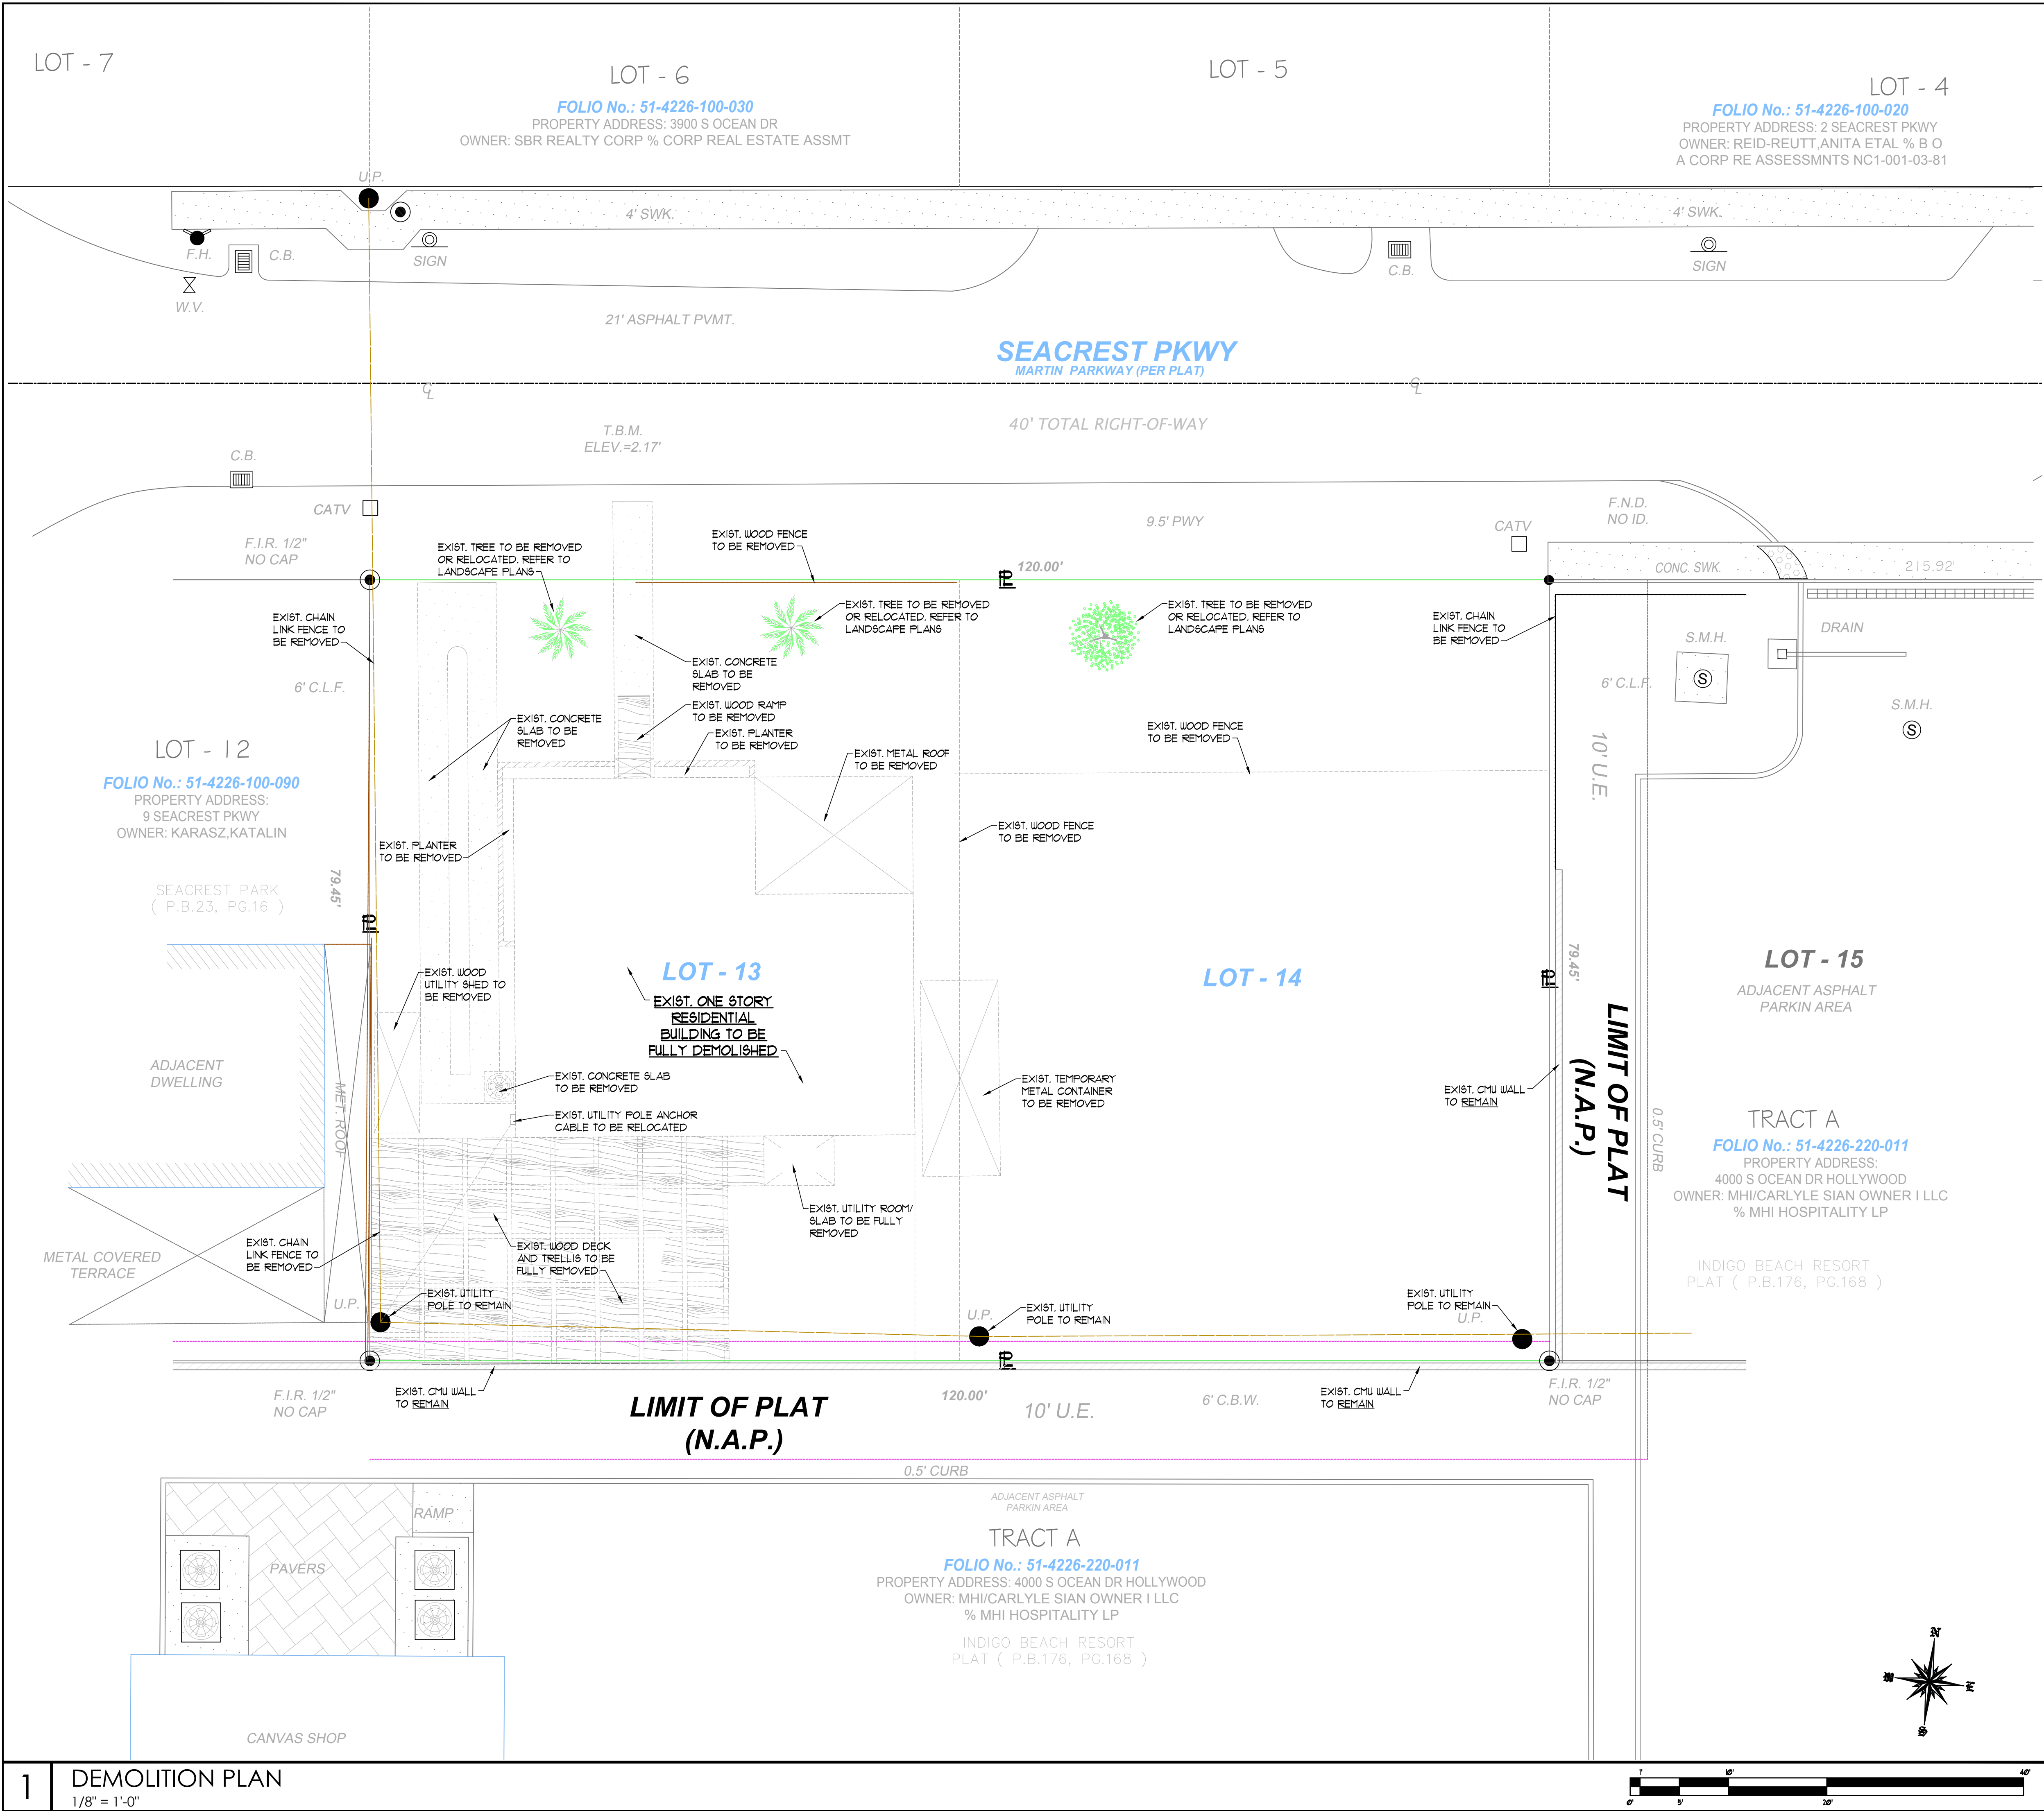

- A. DEMOLITION CONTRACTOR SHALL VISIT THE SITE TO FAMILIARIZE WITH THE COMPLETE SCOPE OF SERVICES AND WORKING CONDITIONS AND REQUEST IN WRITING (RFI) ANY QUESTIONS OR COMMENTS PRIOR TO COMMENCING THE WORK.
- B. ALL APPLICABLE PERMITS FROM GOVERNING AUTHORITIES SHALL BE ISSUED FOR PROJECT PRIOR TO ANY DEMOLITION WORK.
- C. ALL UTILITIES SHALL BE TURNED OFF, DISCONNECTED, CAPPED OR REMOVED AS REQUIRED PRIOR TO ANY DEMOLITION WORK.
- D. CONTRACTOR MUST THOROUGHLY REVIEW ASBESTOS ABETMENT REPORT AND FOLLOW IN STRICT ACCORDANCE ALL LAWS AND REGULATIONS FOR ENCAPSULATION, REMOVAL, BAGGING AND DISPOSAL METHOD.
- E. PROVIDE SIGNAGE, BARRICADES, SUPPORT, POST SHORES, TEMPORARY PARTITIONS AS REQUIRED TO PROTECT SAFETY OF PERSONS AND ADJACENT STRUCTURES.
- F. CONTRACTORS MUST REMOVE ALL DEBRIS ON A DAILY BASIS AND KEEP SITE CLEAN, ALL SUEPT AND PROTECTED AT ALL TIMES FROM INCLEMENT WEATHER.
- G. ALL EXISTING PLUMBING FIXTURES AND FLOOR DRAINS SHALL BE DISCONNECTED, REMOVED, AND LINES CAPPED.

2 GENERAL DEMOLITION NOTES

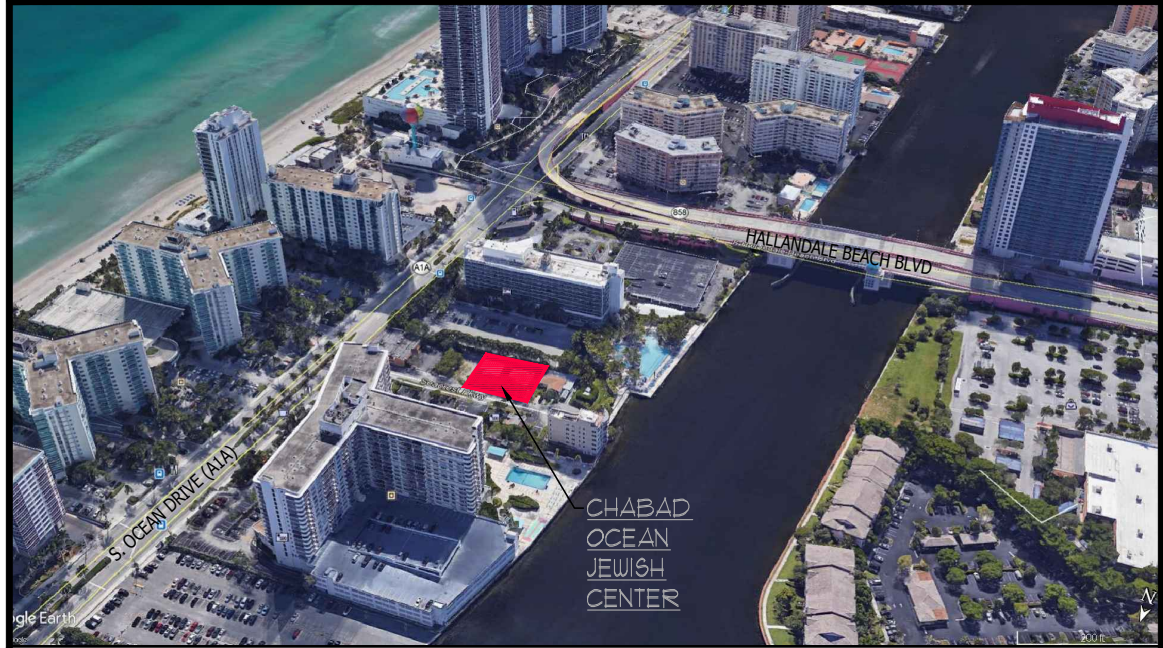

3 LOCATION MAP

N.T.S.

KallerArchitecture
AA# 26001212
2417 Hollywood Blvd.
Hollywood Florida 33020
954.920.5746
joseph@kallerarchitects.com
www.kallerarchitects.com

SEAL

JOSEPH B. KALLER
FLORIDA R.A. # 0009239

CHABAD OCEAN JEWISH CENTER
7 SEACREST PKWY
HOLLYWOOD, FL 33019

DEMOLITION PLAN
GENERAL DEMOLITION NOTES

REVISIONS		
No.	DATE	DESCRIPTION

PROJECT No.: 18067
DATE: 12/21/2018
DRAWN BY: JP
CHECKED BY: JBK

SHEET

DE-1

This drawing, as an instrument of service, is and shall remain the property of the Architect and shall not be reproduced, published or used in any way without the permission of the Architect.

12/21/2018 4:22:33 PM, 1:1

FOLIO No.: 51-4226-100-020
PROPERTY ADDRESS: 2 SEACREST PKWY
OWNER: REID-REUTT, ANITA ETAL % B O
A CORP RE ASSESSMNTS NC1-001-03-8







* NOTE: ASSEMBLY ROOMS SHALL BE USED INDEPENDENTLY AND NEVER AT THE SAME TIME

SP-1



1. ALL PAVERS SHALL BE AS MANUF. BY PAVER MODULE HIGH TRAFFIC CONC. PSI STRENGTH OR APPROVED EQUAL.
2. ALL PERIMETER EDGES SOLDIER COURSE SHALL BE DOUBLE 4" X 8" PAVES 18" WIDE.
3. PAYER STYLE, COLOR AND PATTERN SHALL BE 4" X 8" GREY MIX COLOR "BROWN COLOR MIX" AND SHALL BE SET IN RUNNING BAND PATTERN. SUBMIT SAMPLES FOR APPROVAL PRIOR TO MANUFACTURING OR INSTALLING.
4. NO JOINT SHALL EXCEED 18".
5. ALL PAVERS SHALL BE SET OVER LEVELING SCREED SAND 2" THICK MAX.
6. ALL PAVERS SHALL BE SET OVER A MINIMUM OF 8" THICK CRUSHED AND MACHINE COMPACTED D.O.T. APPROVED LIME ROCK BASE.
7. ALL AREAS TO RECEIVE PAVES SHALL BE CUT DOWN MINIMUM 1" AND CLEARED OF PEDESTRIAN MATERIALS.

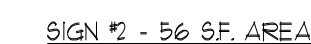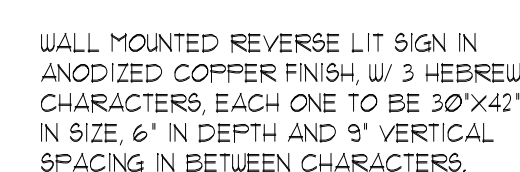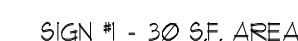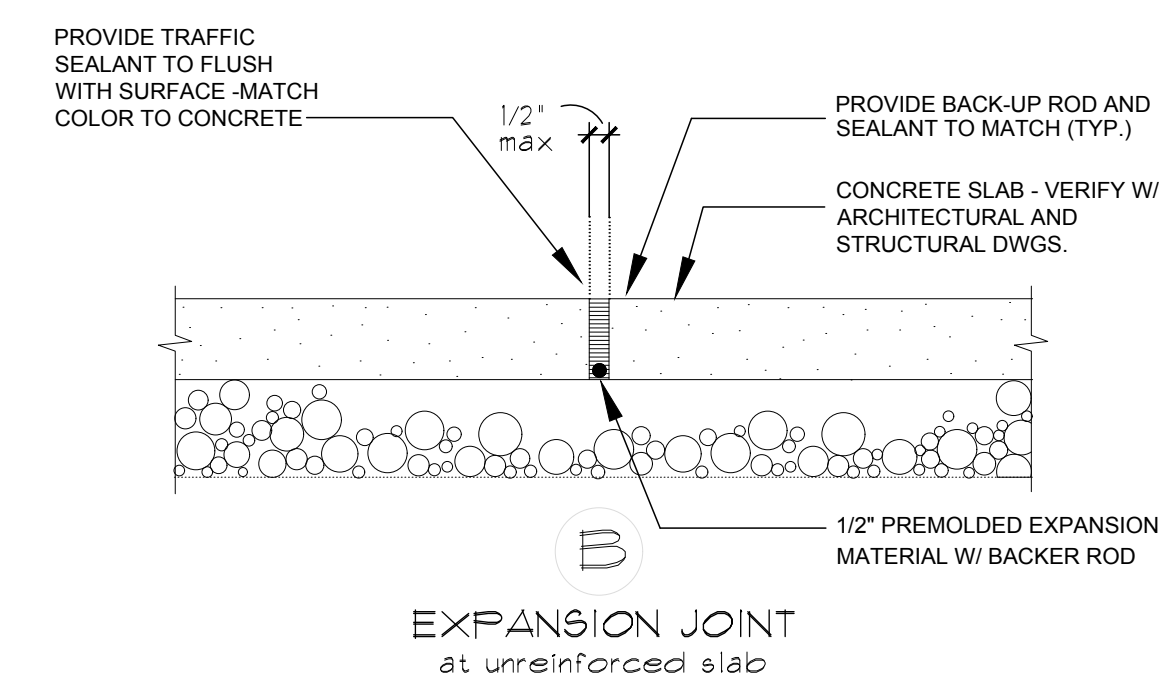

WALL MOUNTED REVERSE LIT SIGN TO READ "CHABAD OCEAN", EACH LETTER TO BE 18" IN HEIGHT, 4" IN DEPTH, ALL CAPITAL LETTERS IN COOPERPLATE GOTHIC LIGHT FONT, ANODIZED COPPER FINISH. VERTICALLY OFFSET 6" SHALL BE 10'-0" WIDE, WALL MOUNTED SIGN TO READ "JEWISH CENTER", EACH LETTER TO BE 9" IN HEIGHT, 2" IN DEPTH, ALL CAPITAL LETTERS IN COOPERPLATE GOTHIC LIGHT FONT IN ANODIZED ALUMINUM MILL FINISH.



WALL MOUNTED BUILDING
ADDRESS NUMBER '7'
CHARACTER, 24" HIGH, 4" DEPTH,
BANKGOTHIC MD BT FONT IN
ANODIZED ALUMINUM MILL FINISH



'12'-0" MAX. CLEARANCE HEIGHT' -
WHITE PLEXY-GLASS SIGN W/ 6"
HIGH BLACK HELVETICA FONT
ABOVE DRIVE-THRU.



ALL SIGNAGE TO BE LED BACK LIT PIN MOUNTED
CHANNEL LETTERS

ALL SIGNAGE TO COMPLY WITH THE REQUIREMENTS OF THE CITY OF HOLLYWOOD ZONING AND LAND DEVELOPMENT CODE.

NOTE:
A SEPARATE SIGN PERMIT IS REQUIRED FOR EACH SIGN.
A SEPARATE ELECTRICAL PERMIT IS REQUIRED FOR SIGNS REQUIRING ILLUMINATION.

REVISIONS		
No.	DATE	DESCRIPTION

[illegible]

This drawing, as an instrument of service, is and shall remain the property of the Architect and shall not be reproduced, published or used in any way without the permission of the Architect.

PROJECT No.: 18067

DATE: 12/21/2018

DRAWN BY: JP

SHEET

SP-3

**CHABAD OCEAN
JEWISH CENTER**
7 SEACREST PKWY
HOLLYWOOD, FL 33019

PROJECT TITLE

BUILDING SIGNAGE DETAILS

SHEET TITLE



www.kallerarchitects.com

REAL

JOSEPH B. KALLER
FLORIDA R.A. # 00092

CHABAD OCEAN
JEWISH CENTER
7 SEACREST PKWY
HOLLYWOOD, FL 33019

SITE PHOTOMETRICS PLAN

REVISIONS		
No.	DATE	DESCRIPTION


1	2	3
4	5	6
7	8	9
430	431	432
433	434	43




drawing, as an instrument of service, is and shall remain the property of the Architect and shall not be reproduced, published or used in any way without the permission of the Architect.

PROJECT No.: 18067
DATE: 12/21/2018
DRAWN BY: JP
CHECKED BY: JBK



SHEET

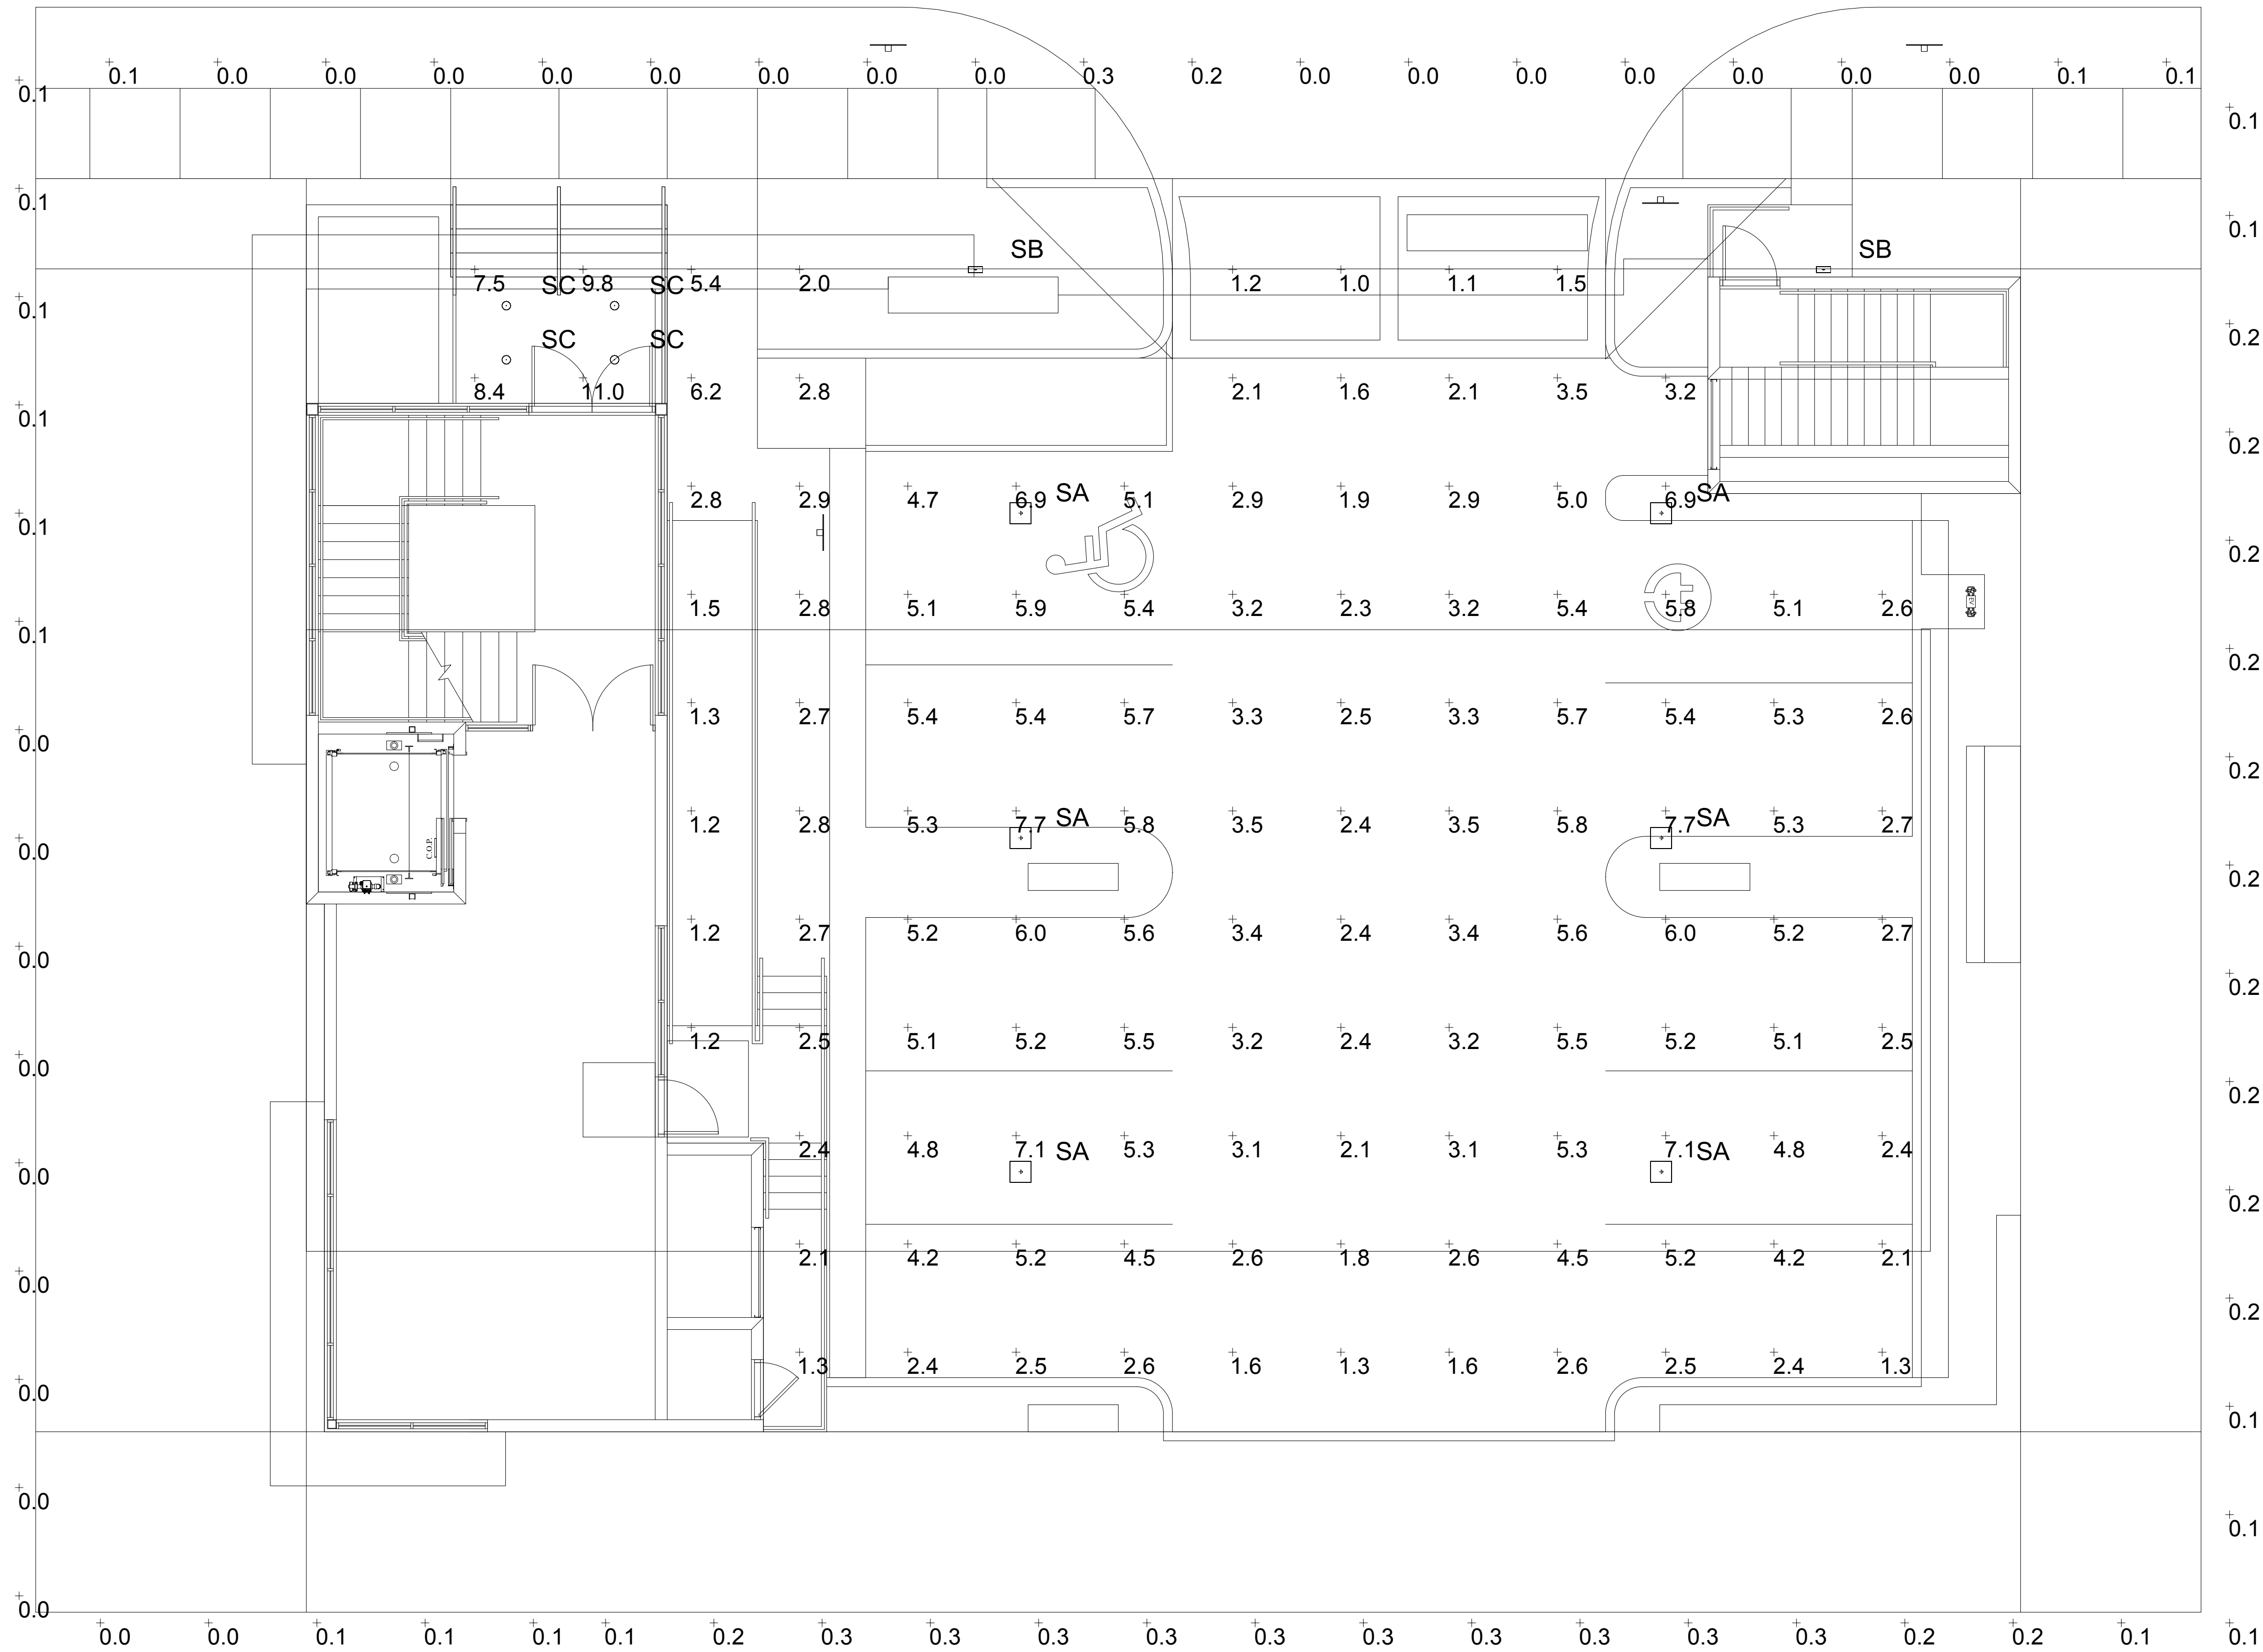SL-1



Luminaire Schedule					
Symbol	Qty	Label	Description	LLF	Lum. Lumens
	6	SA	CREE LTG#: IG-NM-5S-A-40K-UL-WH / MTD AT 9' AFG	0.900	3910
	2	SB	LIGHTWAY #: BUXW-9-LED-10W-4K / WALL MTD AT 7' AFF	0.900	1180
	4	SC	ATLANTIC LTG#: LED6-SYL11-4K-6LED-FR-CL-DBGS / MTD AT 9' AFF	0.900	814

Calculation Summary							
Label	CalcType	Units	Avg	Max	Min	Avg/Min	Max/Min
PARKING AREAS	Illuminance	Fc	3.95	7.7	1.0	3.95	7.70
PROPERTY LINES	Illuminance	Fc	0.11	0.3	0.0	N.A.	N.A.
WALKWAY AREAS	Illuminance	Fc	3.67	11.0	1.2	3.06	9.17

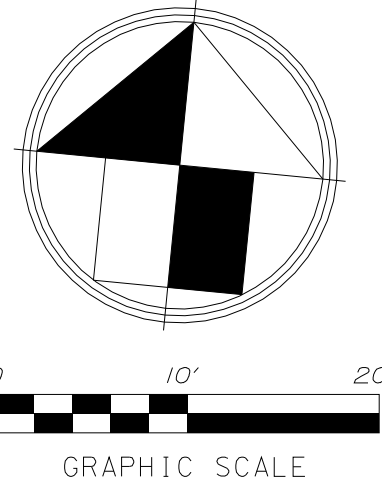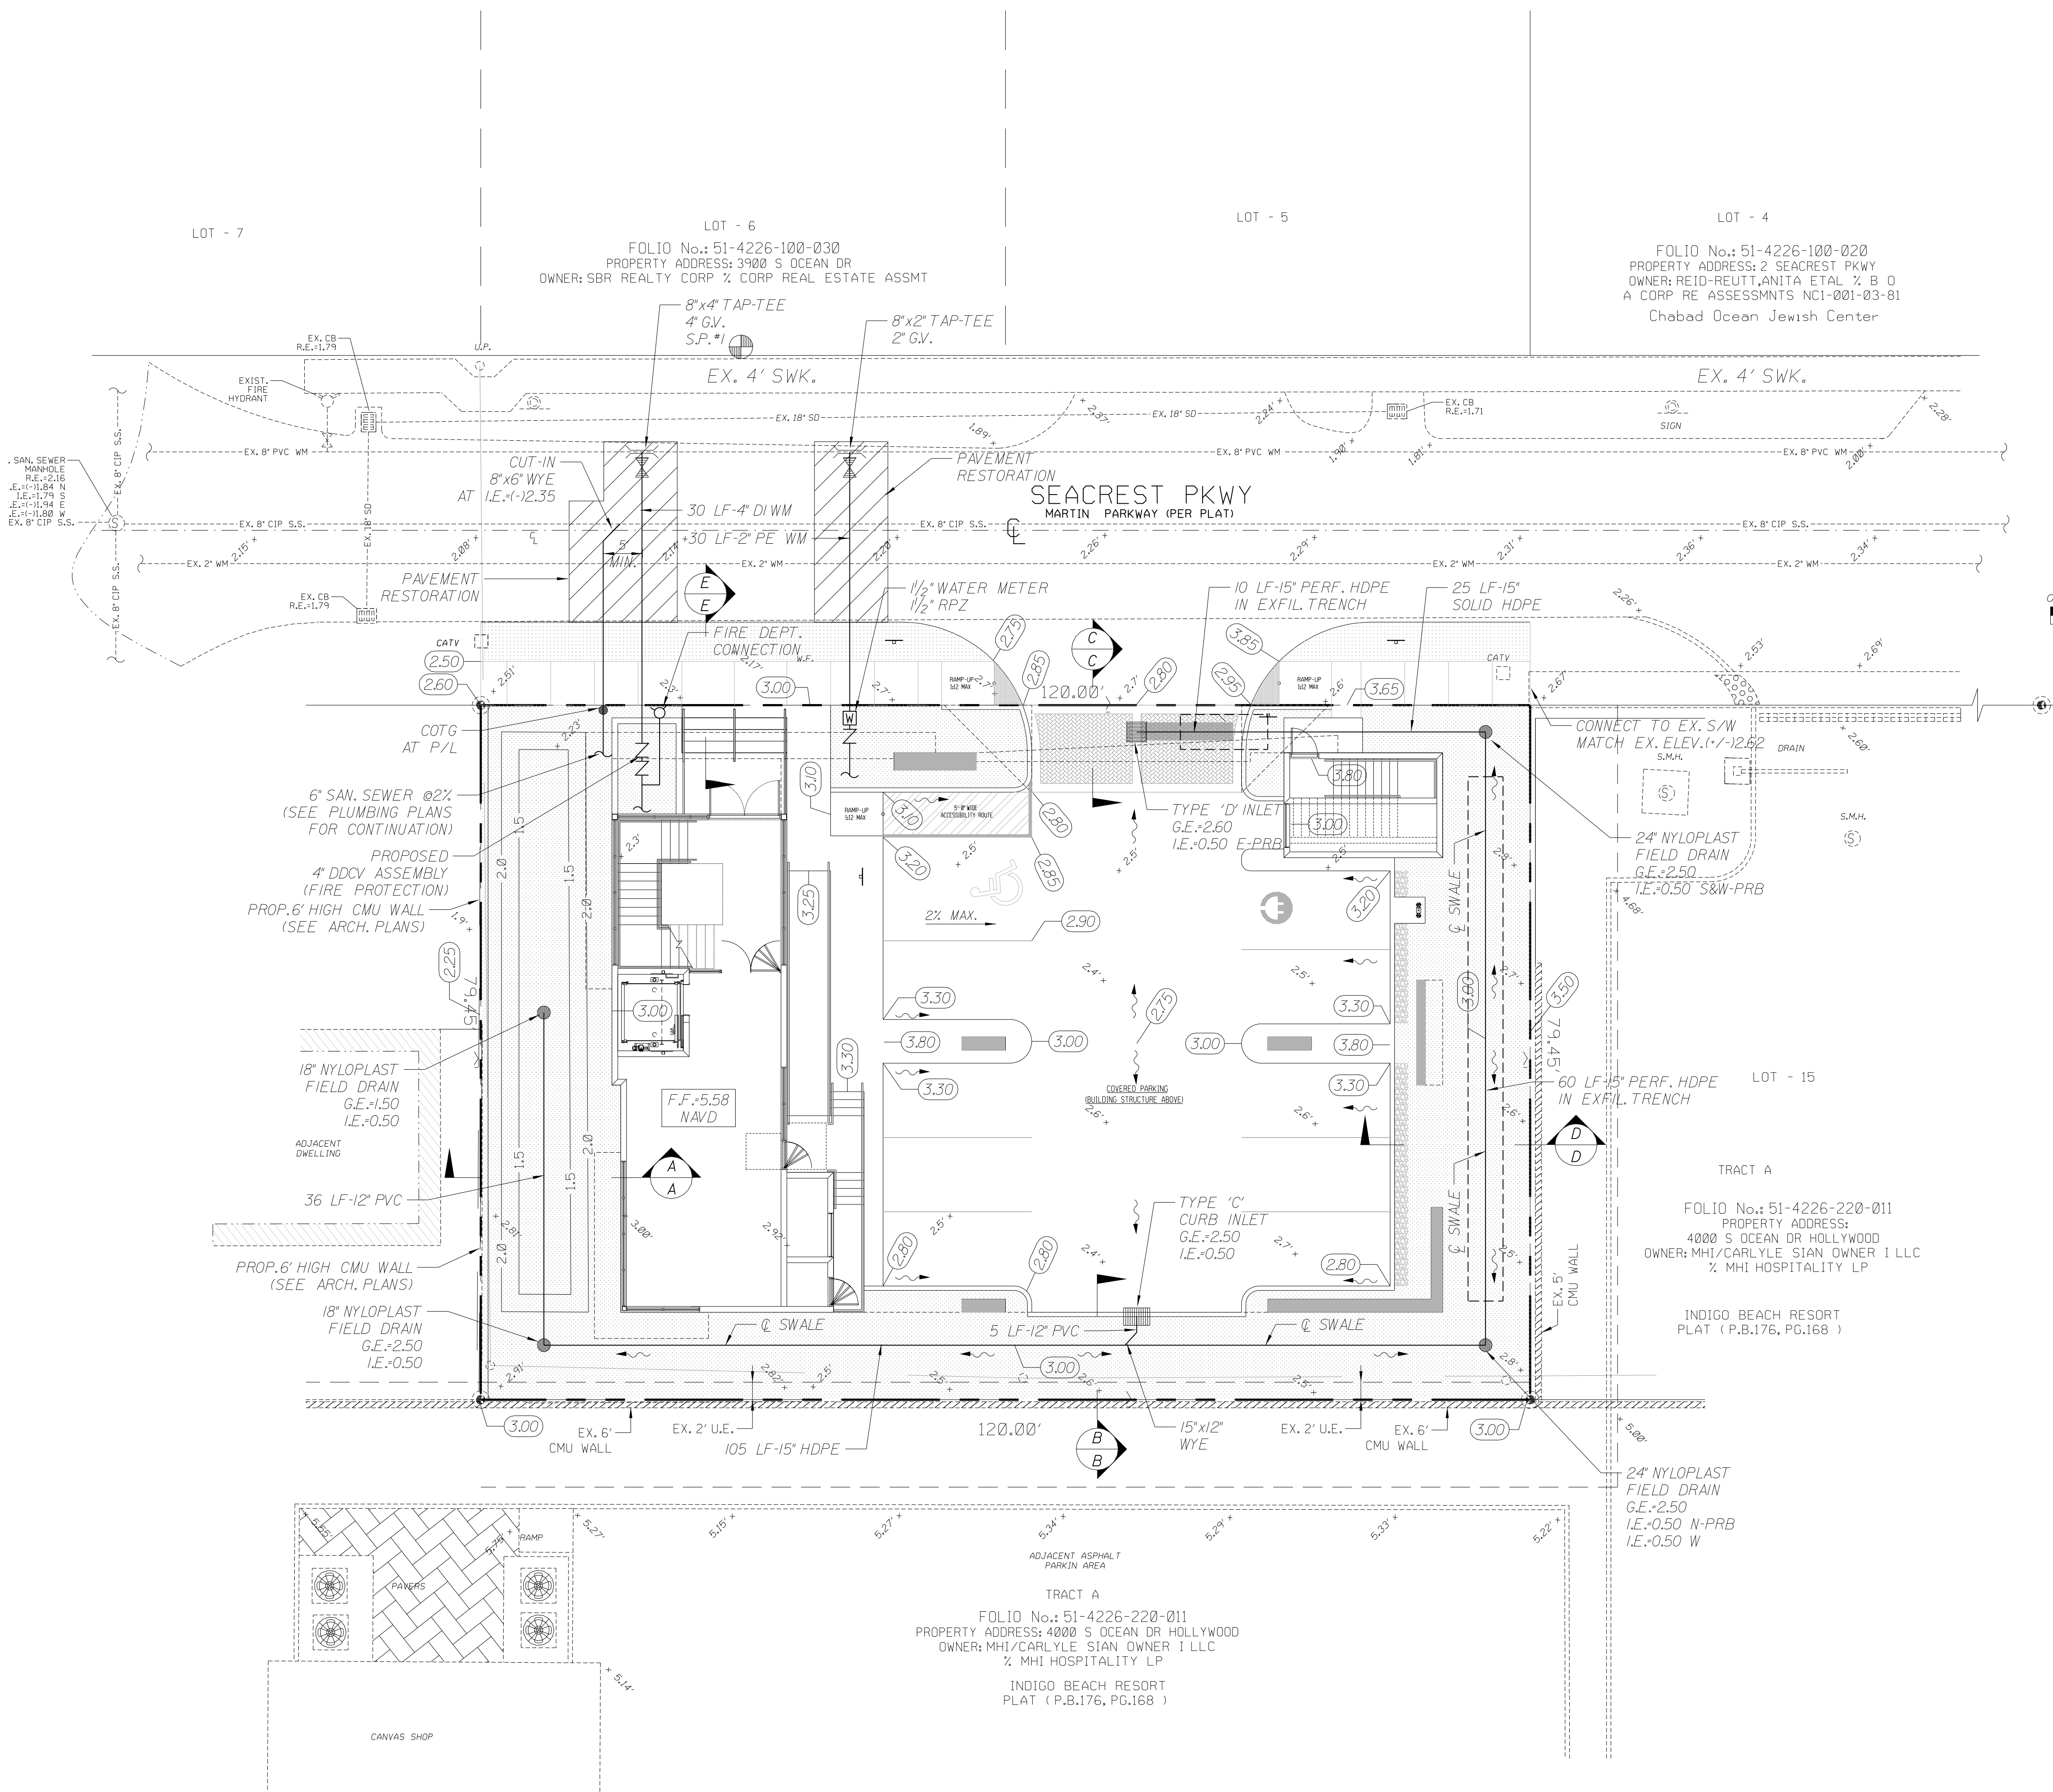


NOTE:
UNDERGROUND FIRE MAIN WORK
WILL BE COMPLETED BY A CONTRACTOR
HOLDING CLASS I, II OR V LICENSE
PER FS 633.102



LEGEND	
	DOUBLE WATER METER SERVICE
	SINGLE WATER METER SERVICE
	LENGTH, SIZE & TYPE OF WATER MAIN
	FIRE HYDRANT, GATE VALVE & TEE ASSEMBLY
	PROPOSED GATE VALVE
	BACTERIOLOGICAL SAMPLING POINT
	CLEANOUT TO GRADE
	R.E. RIM ELEVATION
	G.E. GRATE ELEVATION
	I.E. INVERT ELEVATION
	F.F. FINISHED FLOOR ELEVATION
	DIRECTION OF OVERLAND FLOW
	POLLUTION RETARDANT BASIN
	EXISTING OR FUTURE UTILITIES
	EXISTING GRADE
	PROPOSED GRADE

NOTE:
ALL EXISTING AND PROPOSED GRADE ELEVATIONS
REFER TO 1988 NAVD DATUM.


REVISIONS: <table><tr><td>1.</td><td></td></tr><tr><td>2.</td><td></td></tr><tr><td>3.</td><td></td></tr><tr><td>4.</td><td></td></tr><tr><td>5.</td><td></td></tr><tr><td>6.</td><td></td></tr><tr><td>7.</td><td></td></tr><tr><td>8.</td><td></td></tr></table>	1.		2.		3.		4.		5.		6.		7.		8.		CLIENT: Kaller Architects 2417 Hollywood Boulevard Hollywood, Florida 33020-6605 (954) 920-5746	
1.																		
2.																		
3.																		
4.																		
5.																		
6.																		
7.																		
8.																		
PROJECT: Chabad Ocean Jewish Center HOLLYWOOD FLORIDA	TASK: CIVIL ENGINEERING PLAN																	
GGB Engineering, Inc. CIVIL AND FORENSIC ENGINEERS • LAND PLANNERS • CONSTRUCTION MANAGERS FLORIDA REGISTRATION NO. 8118 2699 Stirling Road, Suite C-202 Fort Lauderdale, Florida 33312 Phone: (954) 986-9899 Fax: (954) 986-8655																		
DATE: Nov. 2018 DESIGNED BY: G.C.B.	SCALE: 1"=10' DRAWN BY: F.M.																	
PROJECT NO. 18-1107 SHEET C-1																		
<small>GARY G. BLOOM, P.E. FLA. LIC. NO. 19832 NOT VALID UNLESS SIGNED AND SEALED BY ENGINEER</small>																		

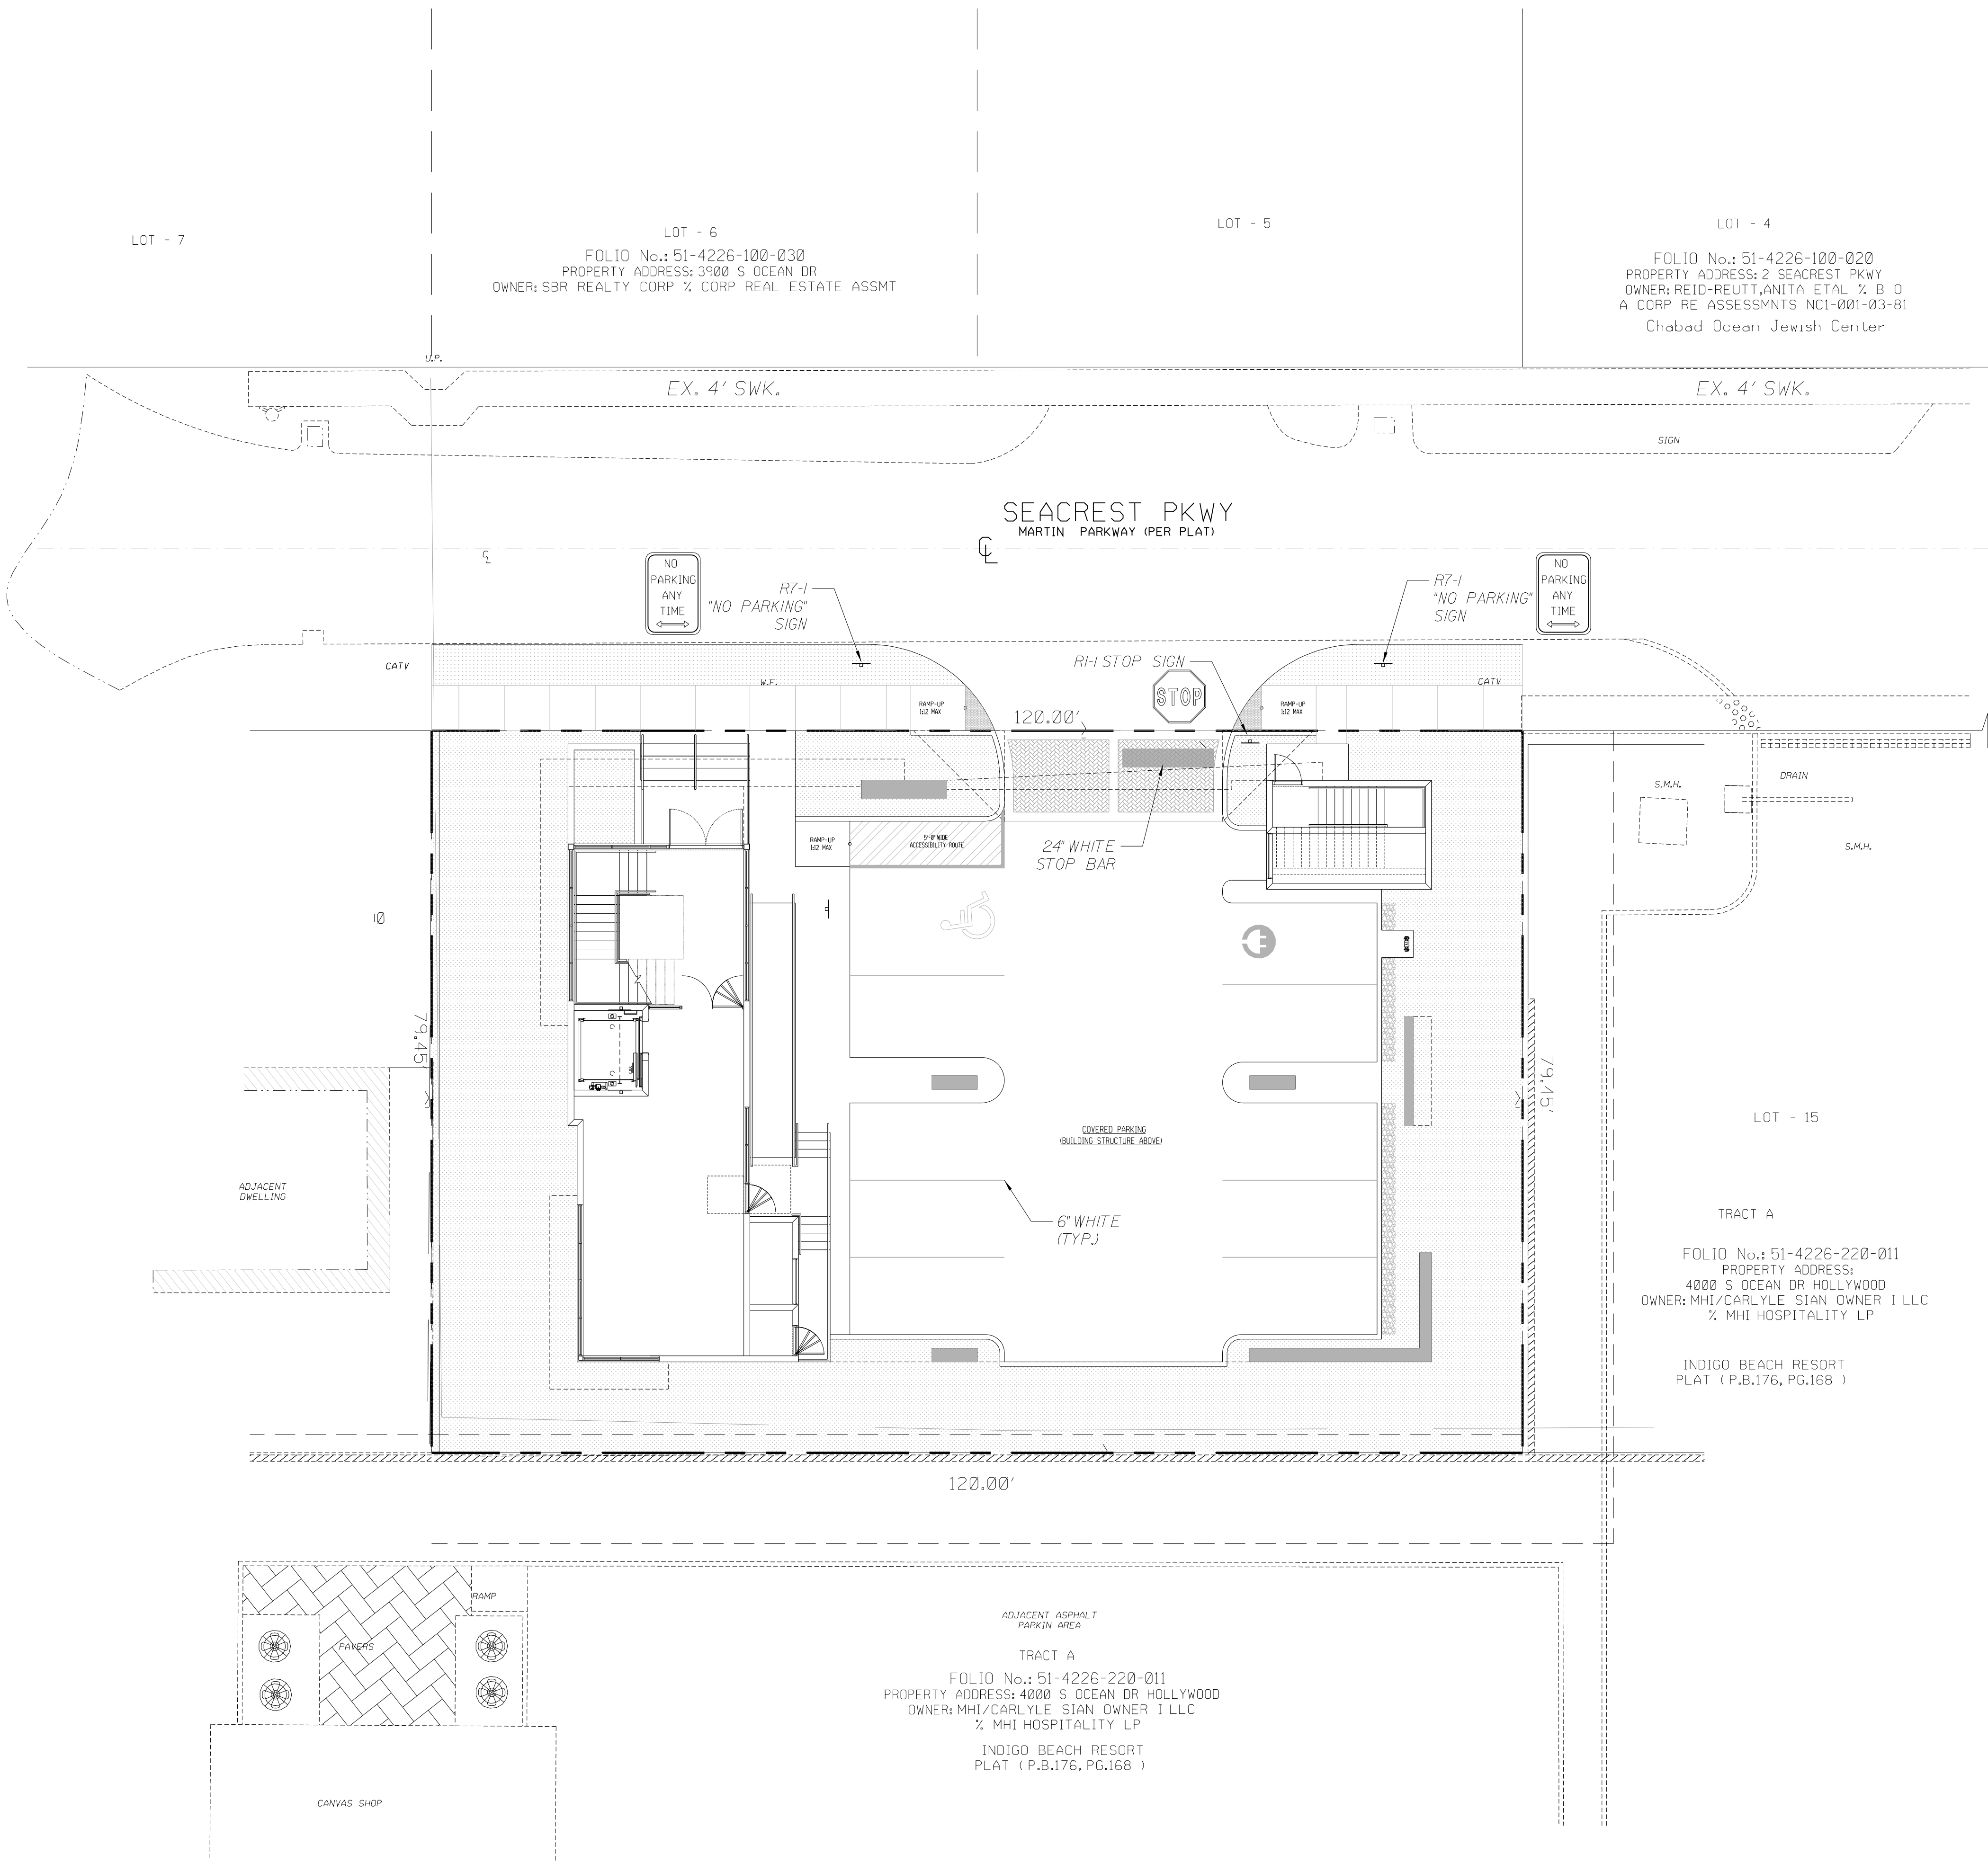

LOCATION MAP
N.T.S.

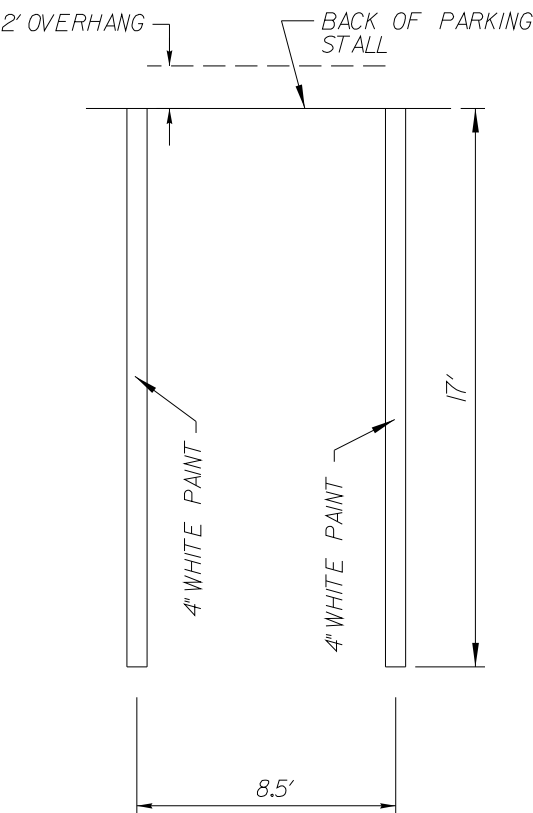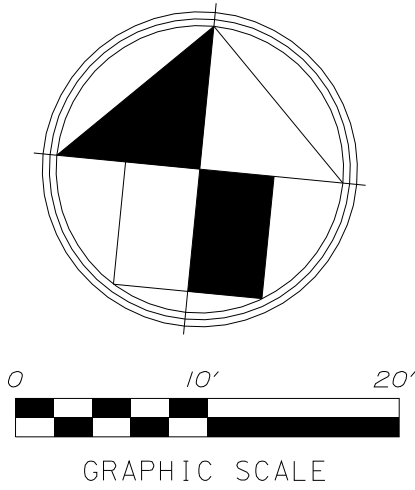

TYPICAL PARKING STALL DETAIL
N.T.S.

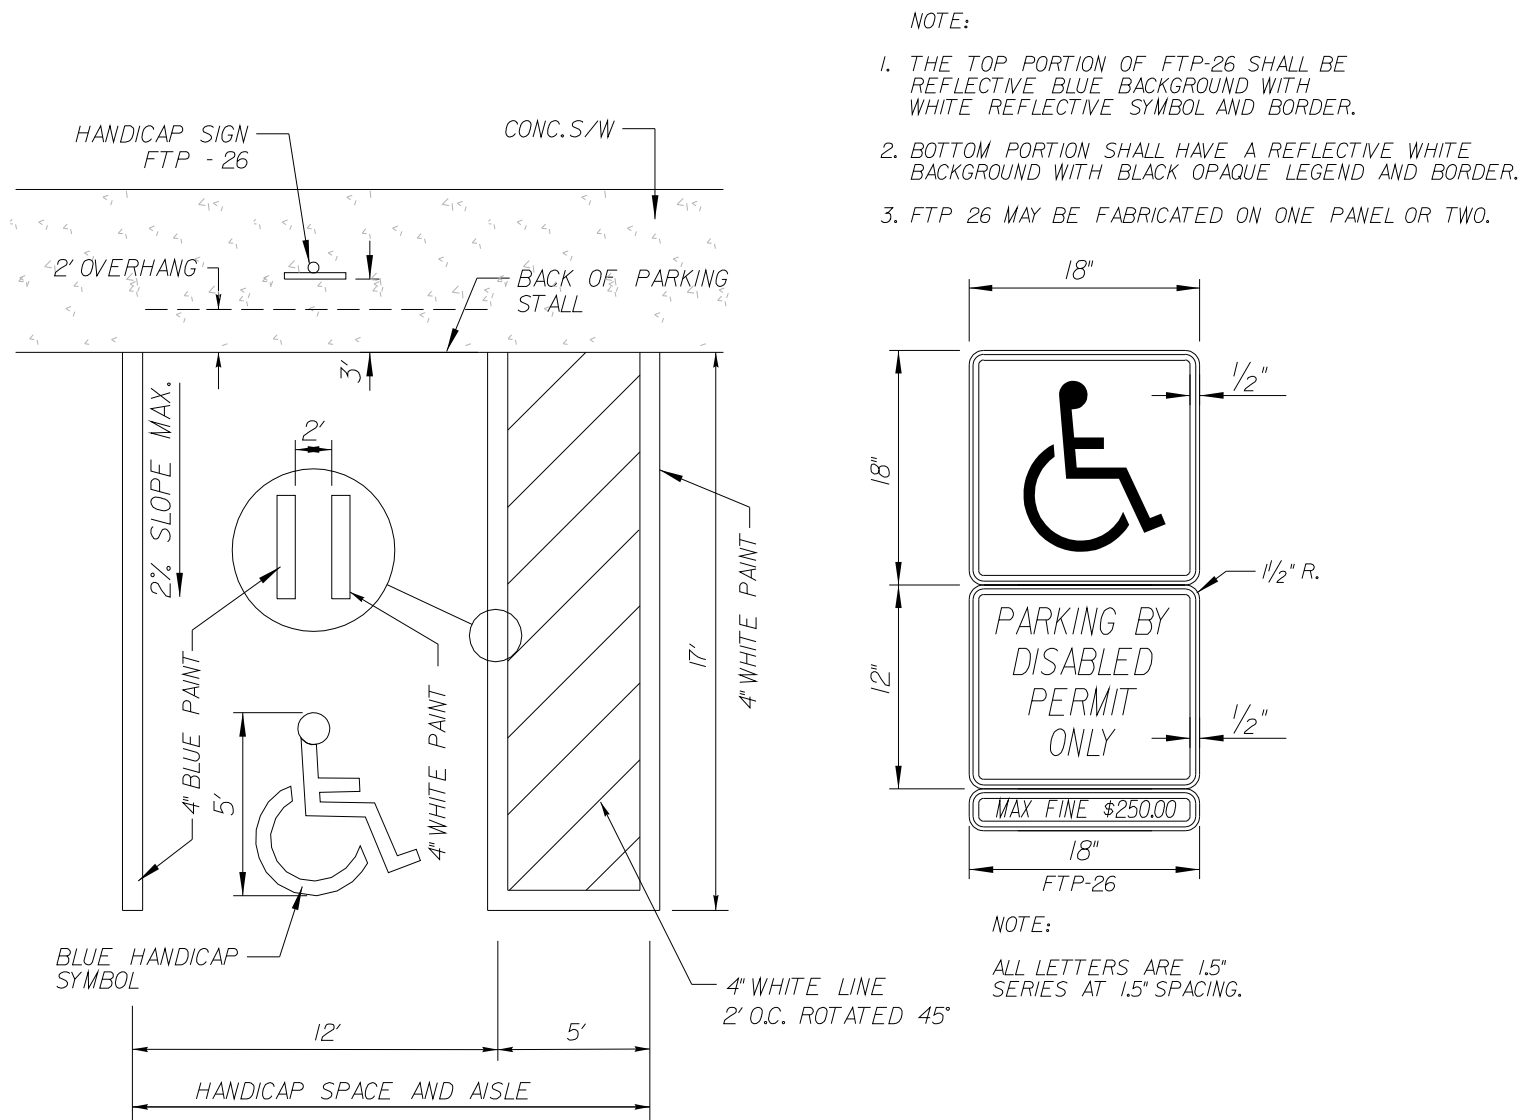

HANDICAP STALL AND SIGN DETAIL
N.T.S.

NOTE:
ALL PAVEMENT MARKINGS TO CONFORM
TO BROWARD COUNTY STANDARDS
LATEST EDITION.

REVISIONS:	
1.	
2.	
3.	
4.	
5.	
6.	
7.	
8.	
CLIENT:	
Kaller Architects 2417 Hollywood Boulevard Hollywood, Florida 33020-6605 (954) 920-5746	
PROJECT:	TASK:
Chabad Ocean Jewish Center HOLLYWOOD FLORIDA	PAVEMENT MARKINGS AND SIGNAGE PLAN
GGB Engineering, Inc. CIVIL AND FORENSIC ENGINEERS • LAND PLANNERS • CONSTRUCTION MANAGERS FLORIDA REGISTRATION NO. 8118 2699 Stirling Road, Suite C-202 Fort Lauderdale, Florida 33312 Phone: (954) 986-9899 Fax: (954) 986-8655	
DATE: Nov. 2018	SCALE: 1"=10'
DESIGNED BY: C.G.B.	DRAWN BY: F.M.
PROJECT NO. 18-1107	
SHEET C-1A	
GARY G. BLOOM, P.E. FLA. LIC. NO. 19832 NOT VALID UNLESS SIGNED AND SEALED BY ENGINEER	

PAVING, GRADING AND DRAINAGE NOTES

1. ALL UNSUITABLE MATERIALS, SUCH AS MUCK, HORGANIC, ORGANIC MATERIAL AND OTHER DELETERIOUS MATERIAL, AS CLASSIFIED BY AASHTO M-45, FOUND WITHIN THE ROAD AND SHOULDER ARE TO BE REMOVED TO THE SURFACE OF THE ROAD AND REPLACED WITH THE SPECIFIED FILL MATERIAL IN MAXIMUM 1' LIFTS COMPACTED TO NOT LESS THAN 100% MODULUS TO THE REQUIRED DENSITY. THE FILL MATERIAL, WHEN PLACED IN 1' THICKNESS OF LAYERS MAY BE INCREASED PROVIDED THE EQUIPMENT AND METHODS USED ARE PROVEN BY FIELD DENSITY TESTING TO BE CAPABLE OF COMPACTING THICK LAYERS REMOVED TO THE SURFACE.
3. ALL AREAS SHALL BE CLEARED AND GRUBBED PRIOR TO CONSTRUCTION. THIS SHALL INCLUDE COMPLETE REMOVAL AND DISPOSAL OF ALL TREES, BRUSH, STUMPS, ROOTS, GRASS, WEEDS, RUBBISH AND ALL OTHER OBSTRUCTION RESTING ON OR PROTRUDING THROUGH THE PROPOSED ROAD. MATERIALS TO REMAIN OR TO BE ADJUSTED SHALL BE SO DESIGNATED IN THE DRAWINGS.
4. FILL MATERIAL SHALL BE CLASSIFIED AS A-1, A-3, OR A-2-4 IN ACCORDANCE WITH AASHTO M-45 AND SHALL BE FREE FROM VEGETATION AND ORGANIC MATERIAL. NOT MORE THAN 1% BY WEIGHT SHALL BE OVERSIZED MATERIAL.
5. THE CONTRACTOR SHALL BE RESPONSIBLE FOR PROVIDING CERTIFIED MATERIAL TEST RESULTS TO THE ENGINEER OF RECORD PRIOR TO THE RELEASE OF FINAL CERTIFICATION BY THE ENGINEER. TEST RESULTS SHALL INCLUDE, BUT MAY NOT BE LIMITED TO, COMPRESSION, TENSILE, AND SHOCK, UTILITIES, EXCAVATION, ASPHALT GRADATION REPORTS, CONCRETE CYLINDERS, ETC.

3. PRIOR TO CONSTRUCTION, THE CONTRACTOR SHALL NOTIFY THE FOLLOWING UTILITY COMPANIES:

4. ALL ELEVATIONS ARE BASED UPON THE NATIONAL GEODETIC VERTICAL DATUM (NGVD) OF 1929

10. THE CONTRACTOR SHALL OBTAIN ANY NECESSARY TREE REMOVAL PERMITS FROM THE CITY OF HOLLYWOOD PRIOR TO COMMENCING WORK.

12. COMPLIANCE WITH THE "TRENCH SAFETY ACT" IS REQUIRED FOR ALL EXCAVATIONS IN EXCESS OF 5 FOOT DEPTHS.

5. ALL REFLECTIVE PAVEMENT MARKERS SHALL BE APPROVED BY CITY OF HOLLYWOOD BEFORE INSTALLATION.



DRAINAGE STRUCTURES SECTION DETAILS



- 1.- CONTRACTOR TO VERIFY THAT
BAFFLE WILL FIT STRUCTURE
ID.
- 2.- DEBRIS BAFFLE REQUIRED
AT CATCH BASINS
CONNECTED DIRECTLY TO
PROPOSED DRAIN FIELD.
- 3.- PROVIDE NEOPRENE GASKET
SIDES AND TOP

4.- SECTION OF A.C.M.P. CUT IN HALF OR EQUIVALENT PREFABRICATED FIBERGLASS. BAFFLE DIAMETER TO BE AS PER TABLE I

5.- 1/2" GALVANIZED LAG BOLT IN LEAD SHIELD

6.- WELD OR 2-1/4" THRU BOLTS.

ASIN
L

1. ALL CONCRETE SHALL BE 3000 PSI, 4" THICK 6" THICK (MIN.) AT DRIVEWAYS ONLY.
2. TYPE "A" JOINT TO BE USED AT P.C. AND P.T. OF CURVES AND JUNCTION OF EXISTING AND NEW SIDEWALK
3. TYPE "B" JOINT TO BE USED AT 5'-0" CENTER TO CENTER ON SIDEWALKS.
4. TYPE "C" JOINT TO BE USED WHERE SIDEWALK ABUTS CONCRETE CURBS, DRIVEWAYS, AND SIMILAR STRUCTURES.
5. SIDEWALK SLOPES SHALL CONFORM TO THE REQUIREMENTS OF THE AMERICAN DISABILITIES ACT (A.D.A.).
6. SIDEWALK SHALL BE CONSTRUCTED TO MEET THE ELEVATION OF THE ULTIMATE SECTION.
7. ALL MUCK AND / OR UNSUITABLE MATERIAL MUST BE REMOVED IN ITS ENTIRETY TO 3 FEET BEYOND LIMITS OF SIDEWALK AND REPLACE WITH CLEAN FILL.

NOTE: PLACES WHERE TYPE 'D' CURB
ARE UTILIZED IN LIEU OF WHEELSTOPS
THE STANDARD VERTICAL HEIGHT OF 6"
SHALL BE MODIFIED TO 5"



BEVELED EDGES: ALL EXPOSED CORNERS AND EDGES TO BE CHAMFERED 3/4"

FOUNDATION MATERIAL: WHERE MATERIAL UNSATISFACTORY FOR FOUNDATION IS ENCOUNTERED, ALL SUCH MATERIAL MUST BE REMOVED DOWN TO SATISFACTORY MATERIAL AND BACKFILLED TO SUBGRADE WITH CLEAN SAND.

BEVELED EDGES: ALL EXPOSED CORNERS AND EDGES TO BE CHAMFERED 3/4"

FOUNDATION MATERIAL: WHERE MATERIAL UNSATISFACTORY FOR FOUNDATION IS ENCOUNTERED, ALL SUCH MATERIAL MUST BE REMOVED DOWN TO SATISFACTORY MATERIAL AND BACKFILLED TO SUBGRADE WITH CLEAN SAND.


INLET TYPES: INLETS ARE TO BE CONSTRUCTED TO THE DIMENSIONS SHOWN HEREON. TYPE "E MOD." IS A TYPE "E" TURNED 90° TO RECEIVE R.C.P. UP TO 48" DIAMETER. INLETS RECEIVING PIPE LARGER THAN 48" DIAMETER SHALL BE IN ACCORDANCE WITH F.D.O.T. STANDARDS. SEE F.D.O.T. STANDARD INDEXES 200, 201 & 232.

MATERIAL: INLET WALLS AND BASES MAY BE EITHER CAST-IN-PLACE CLASS I, 2500 P.S.I. CONCRETE OR PRECAST CLASS II, 4000 P.S.I. CONCRETE.

POLLUTION CONTROL DEVICES: "SPECIAL" INLETS SHALL HAVE POLLUTION CONTROL DEVICE INSTALLED, CONSISTING OF HALF-ROUND GALVANIZED STEEL PLATE, OPEN AT THE BOTTOM, WELDED CLOSED AT TOP (OPTIONAL).

LOCKDOWN: PROVIDE EYEBOLT PER F.D.O.T. STANDARD INDEX 201.

COMPACT TRENCH BACKFILL AND SOIL WITHIN MIN. 5' OF TRENCH TO MIN. 95% OF MAX. DRY DENSITY PER ASTM D-1557.

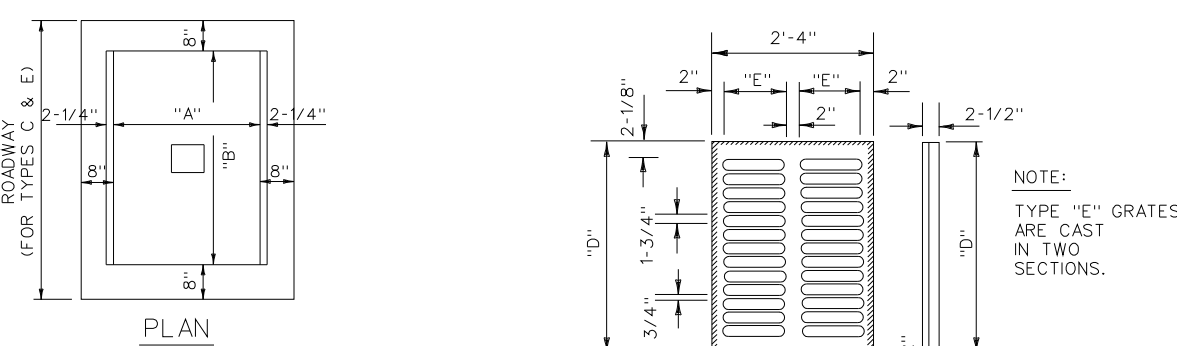

EXFILTRATION TRENCH

REVISIONS:

1. _____
2. _____
3. _____
4. _____
5. _____
6. _____
7. _____
8. _____

Kaller Architects
2417 Hollywood Boulevard
Hollywood, Florida 33020-6605
(954) 920-5746

PROJECT: **Chabad Ocean Jewish Center**

HOLLYWOOD FLORIDA

CONSTRUCTION DETAILS

GGB Engineering, Inc.

FORENSIC ENGINEERS • LAND PLANNERS
• CONSTRUCTION MANAGERS
FLORIDA REGISTRATION No. 8118


2699 Stirling Road, Suite C-202
Fort Lauderdale, Florida 33312
Phone: (954) 986-9899
Fax: (954) 986-6655

DATE: Nov. 2018	SCALE: N.T.S.
DESIGNED BY: G.G.B.	DRAWN BY: F.M.


PROJECT NUMBER
18-1107

SHEET
C-2


GARY G. BLOOM, P.E.
FLA LIC. No. 19832
NOT VALID UNLESS SIGNED
AND SEALED BY ENGINEER

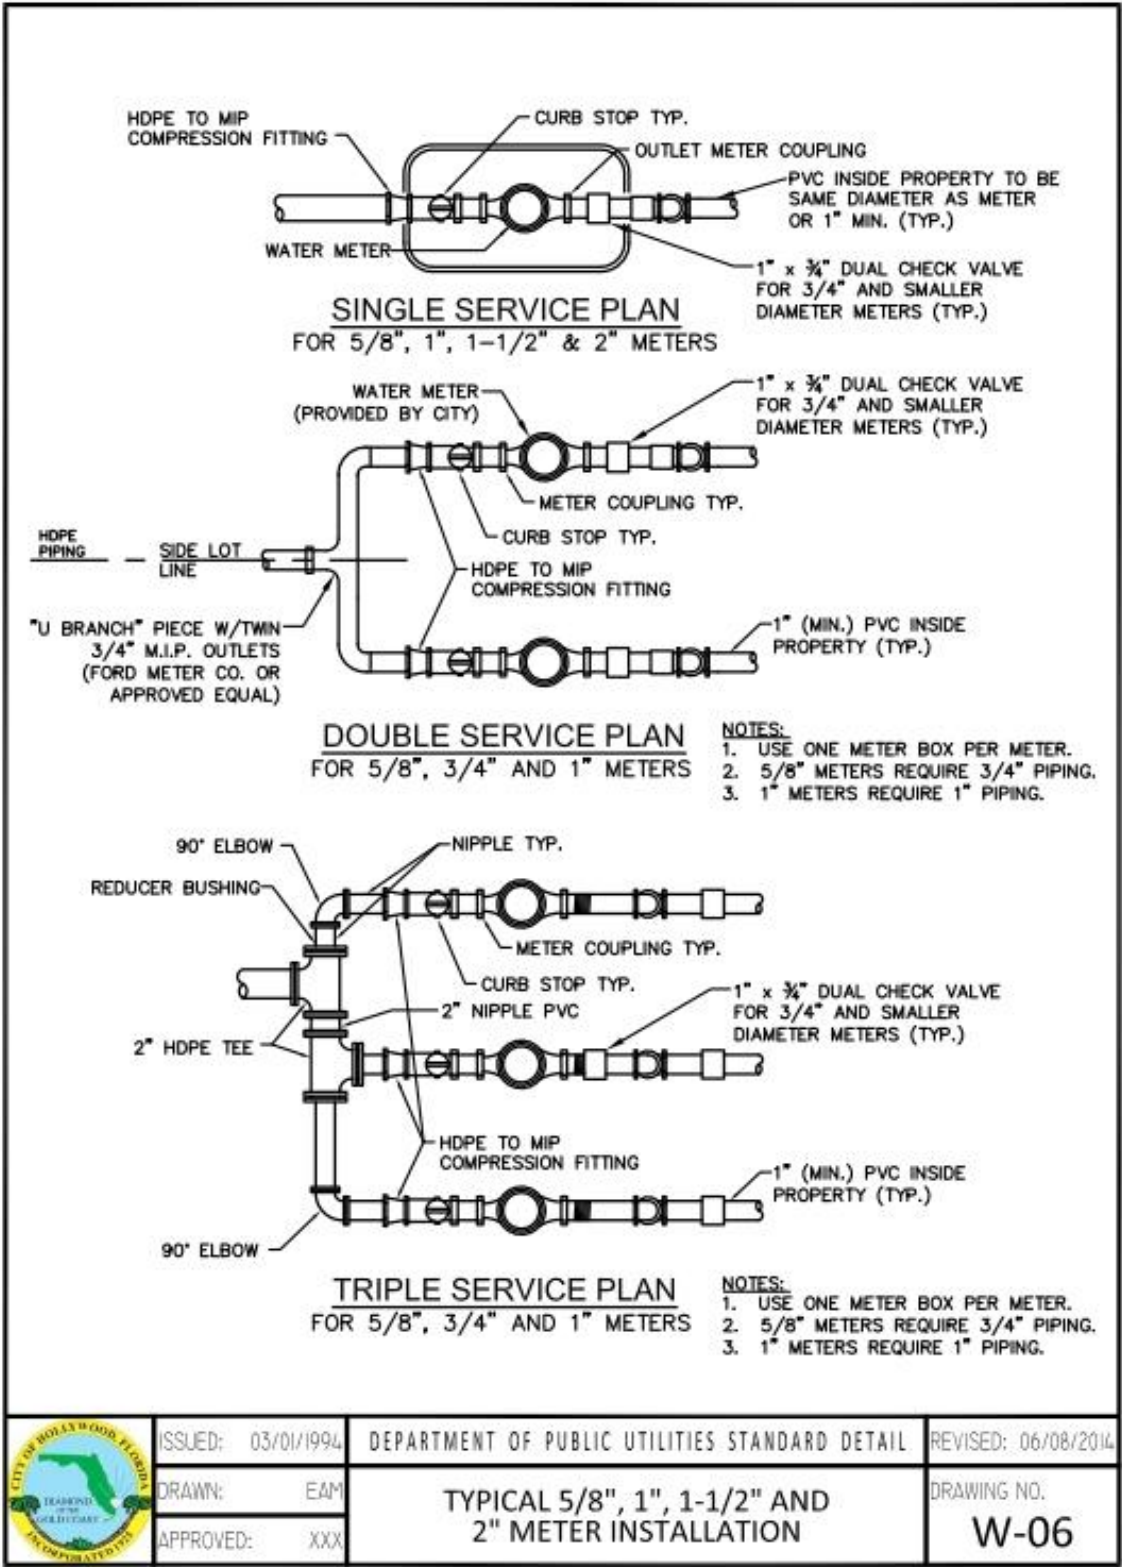


ISSUED: 03/01/99A	DEPARTMENT OF PUBLIC UTILITIES STANDARD DETAIL	REVISED: 06/08/2014
DRAWN: EAP	TYPICAL 5/8", 1", 1-1/2" AND 2" METER INSTALLATION	DRAWING NO. W-06
APPROVED: XXX		

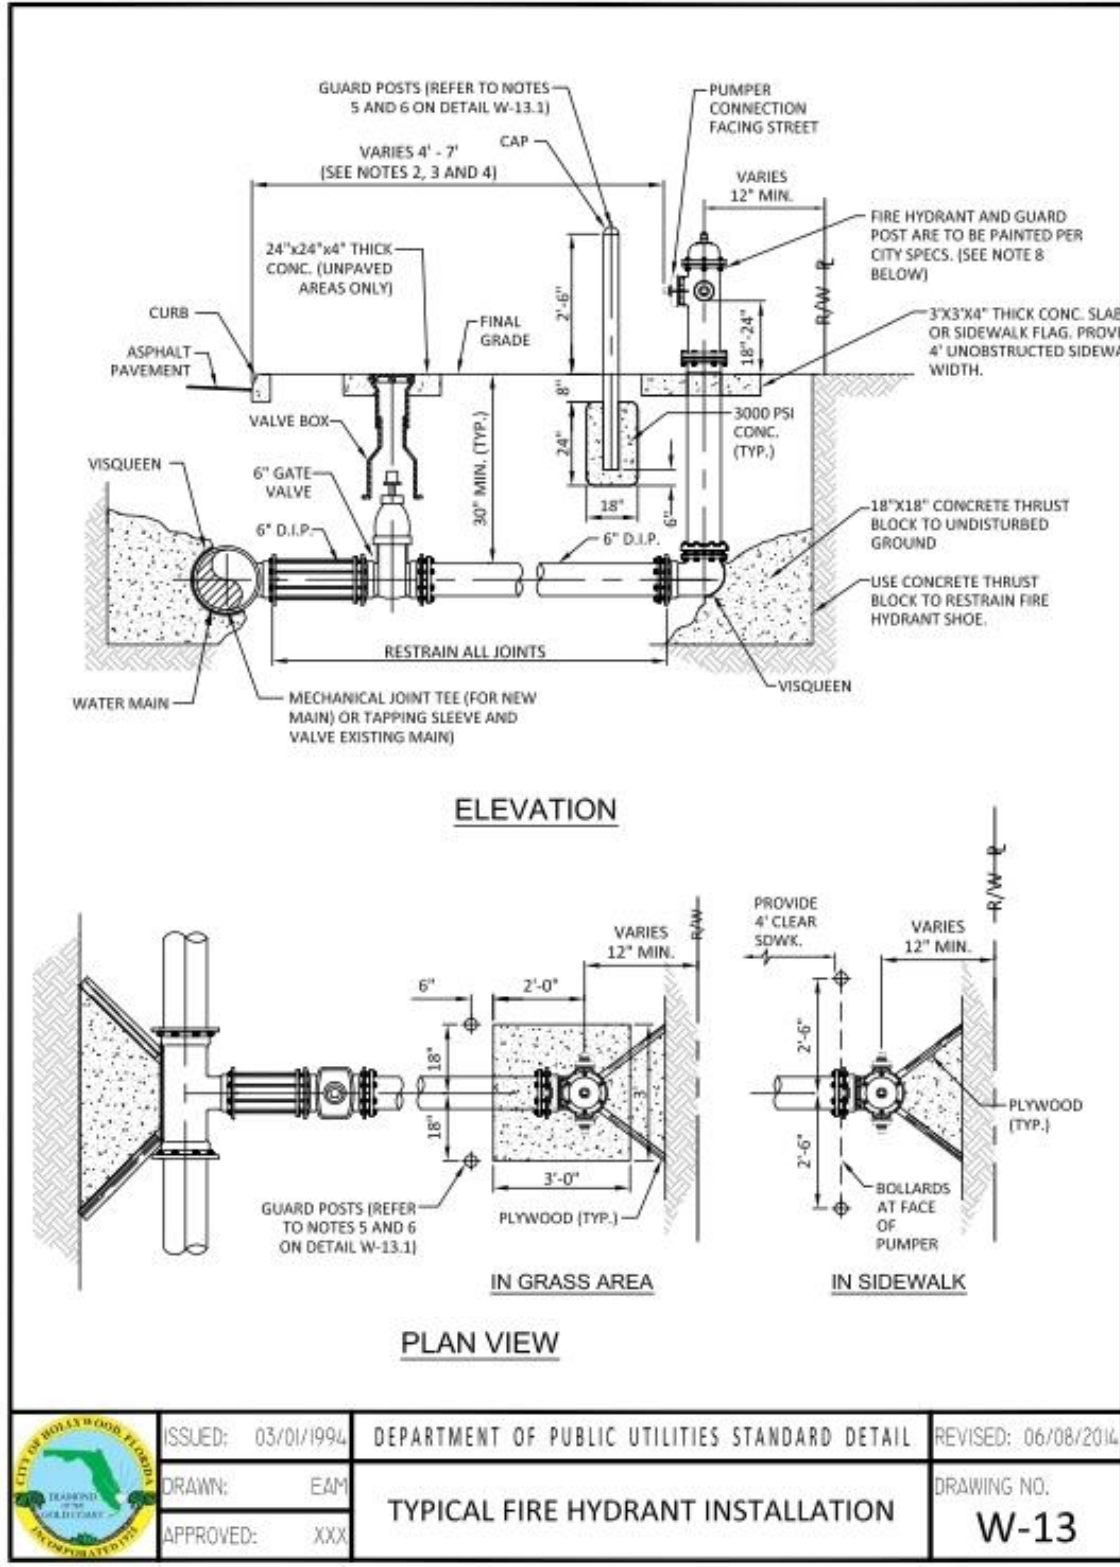


ISSUED: 03/01/99A	DEPARTMENT OF PUBLIC UTILITIES STANDARD DETAIL	REVISED: 06/08/2014
DRAWN: EAP	TYPICAL FIRE HYDRANT INSTALLATION	DRAWING NO. W-13
APPROVED: XXX		

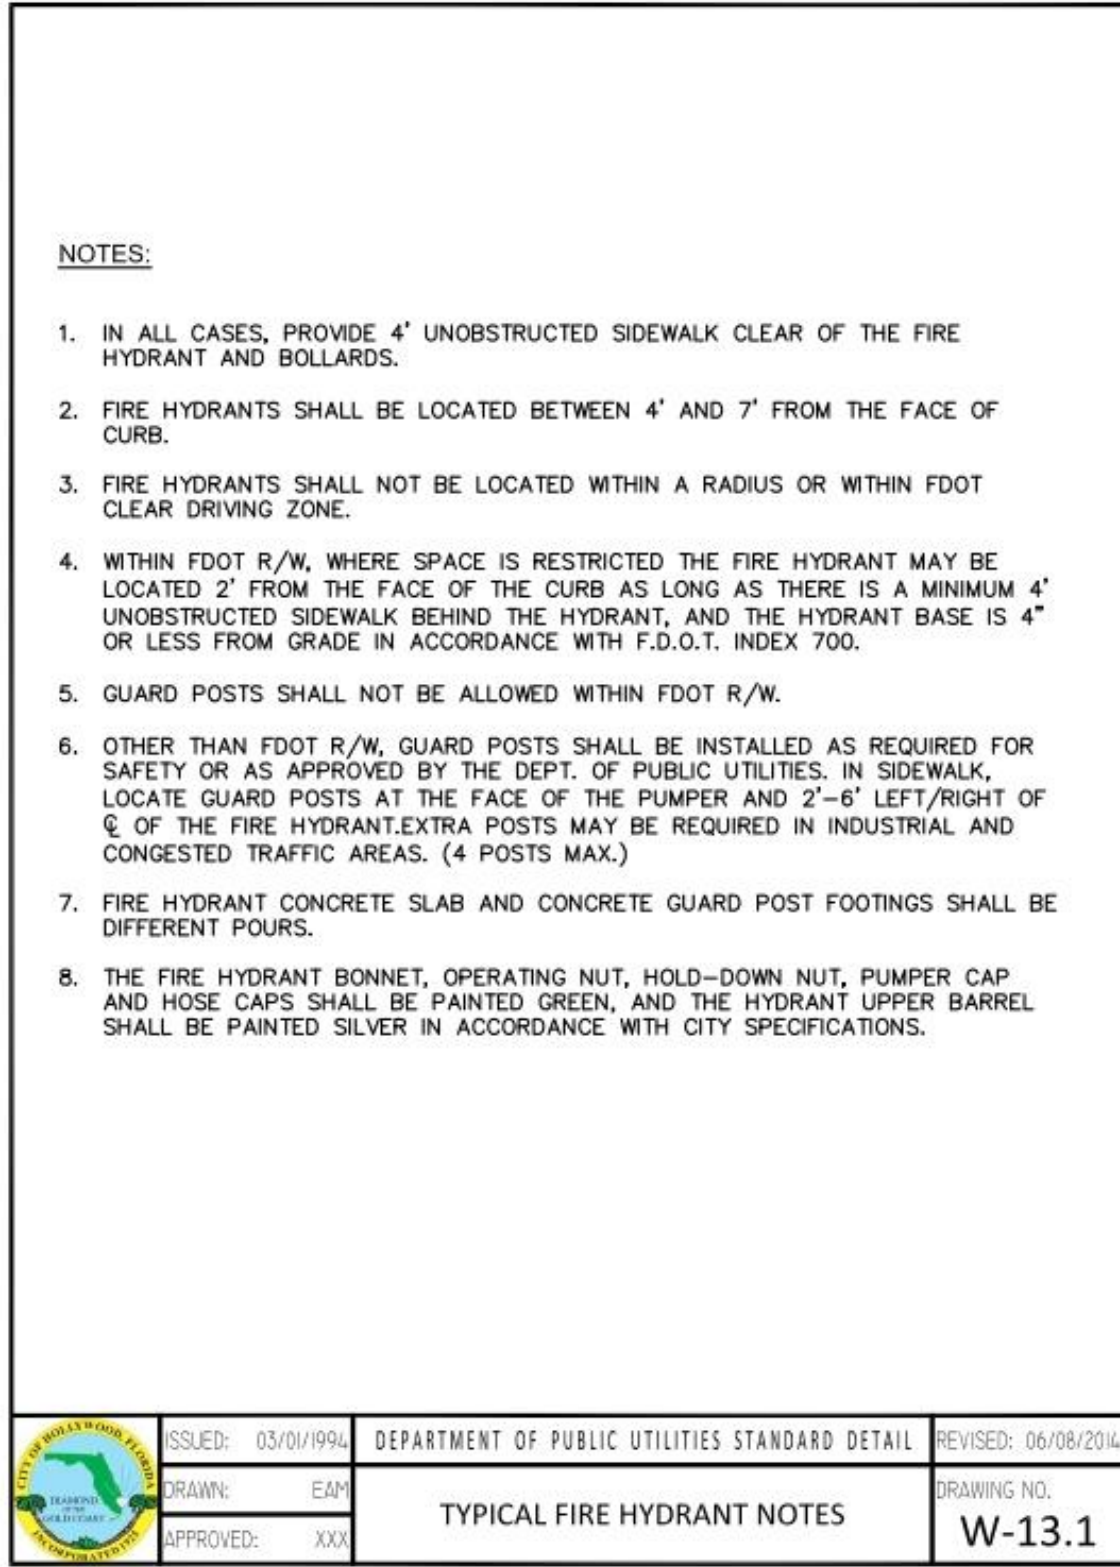


ISSUED: 03/01/99A	DEPARTMENT OF PUBLIC UTILITIES STANDARD DETAIL	REVISED: 06/08/2014
DRAWN: EAP	TYPICAL FIRE HYDRANT NOTES	DRAWING NO. W-13.1
APPROVED: XXX		

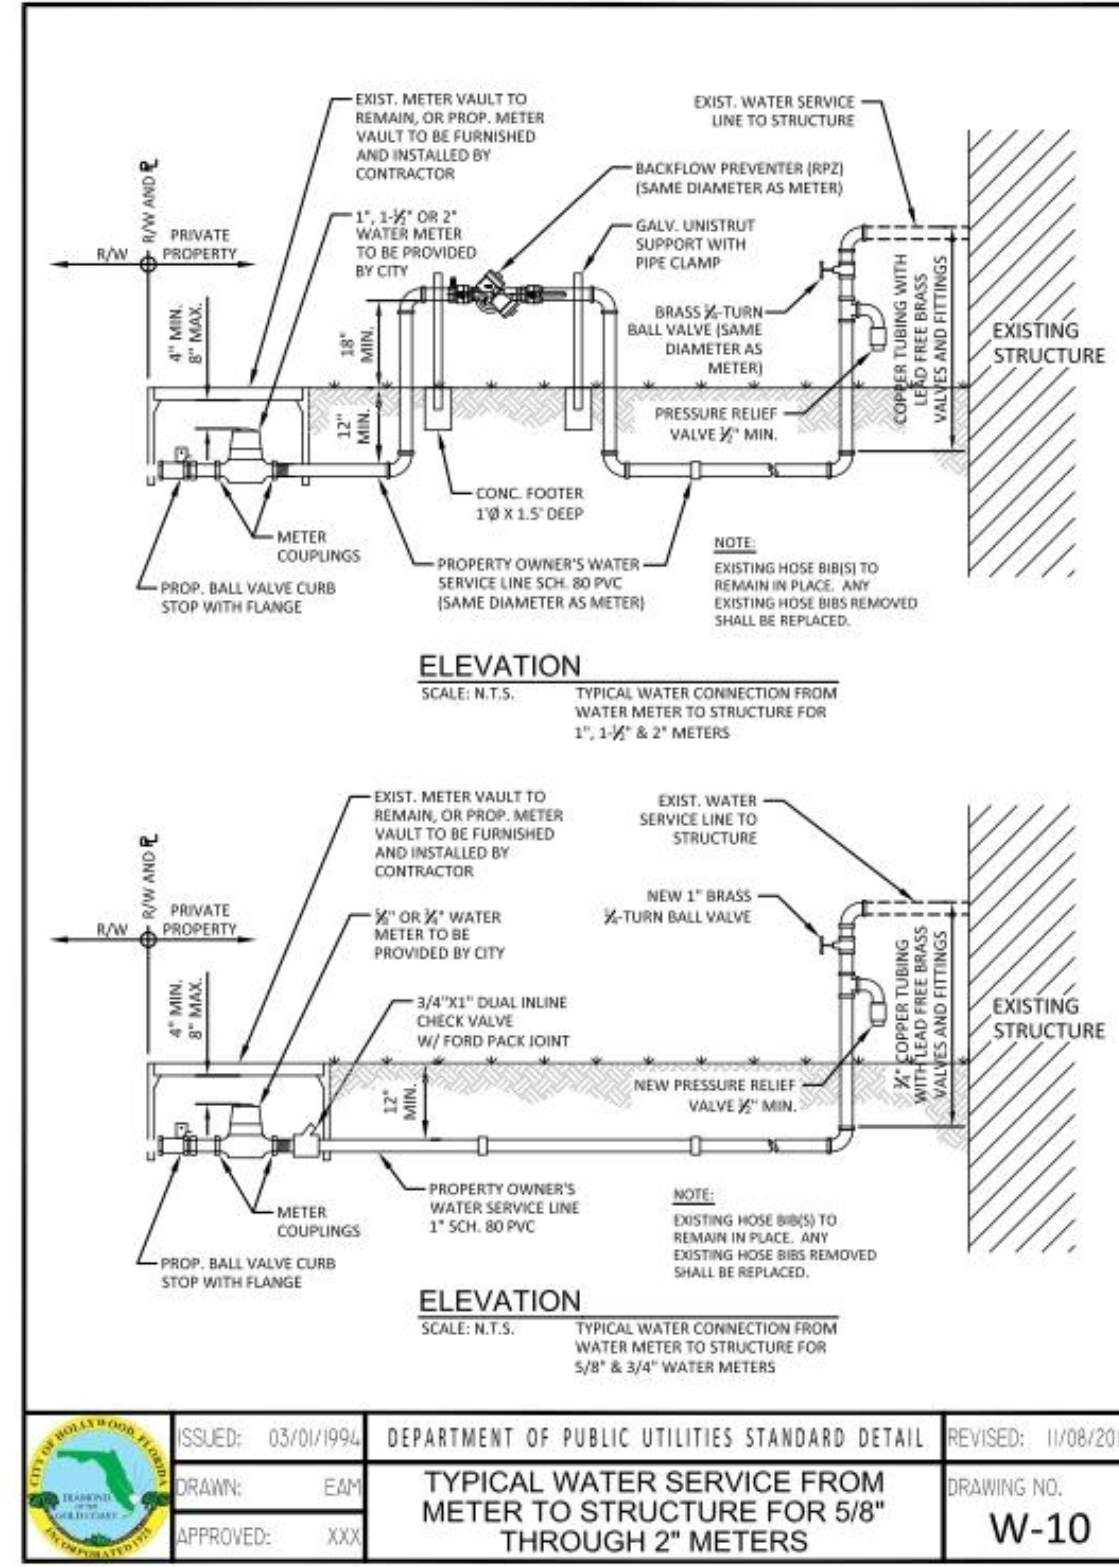


ISSUED: 03/01/99A	DEPARTMENT OF PUBLIC UTILITIES STANDARD DETAIL	REVISED: 11/08/2014
DRAWN: EAP	TYPICAL WATER SERVICE FROM METER TO STRUCTURE FOR 5/8" THROUGH 2" METERS	DRAWING NO. W-10
APPROVED: XXX		

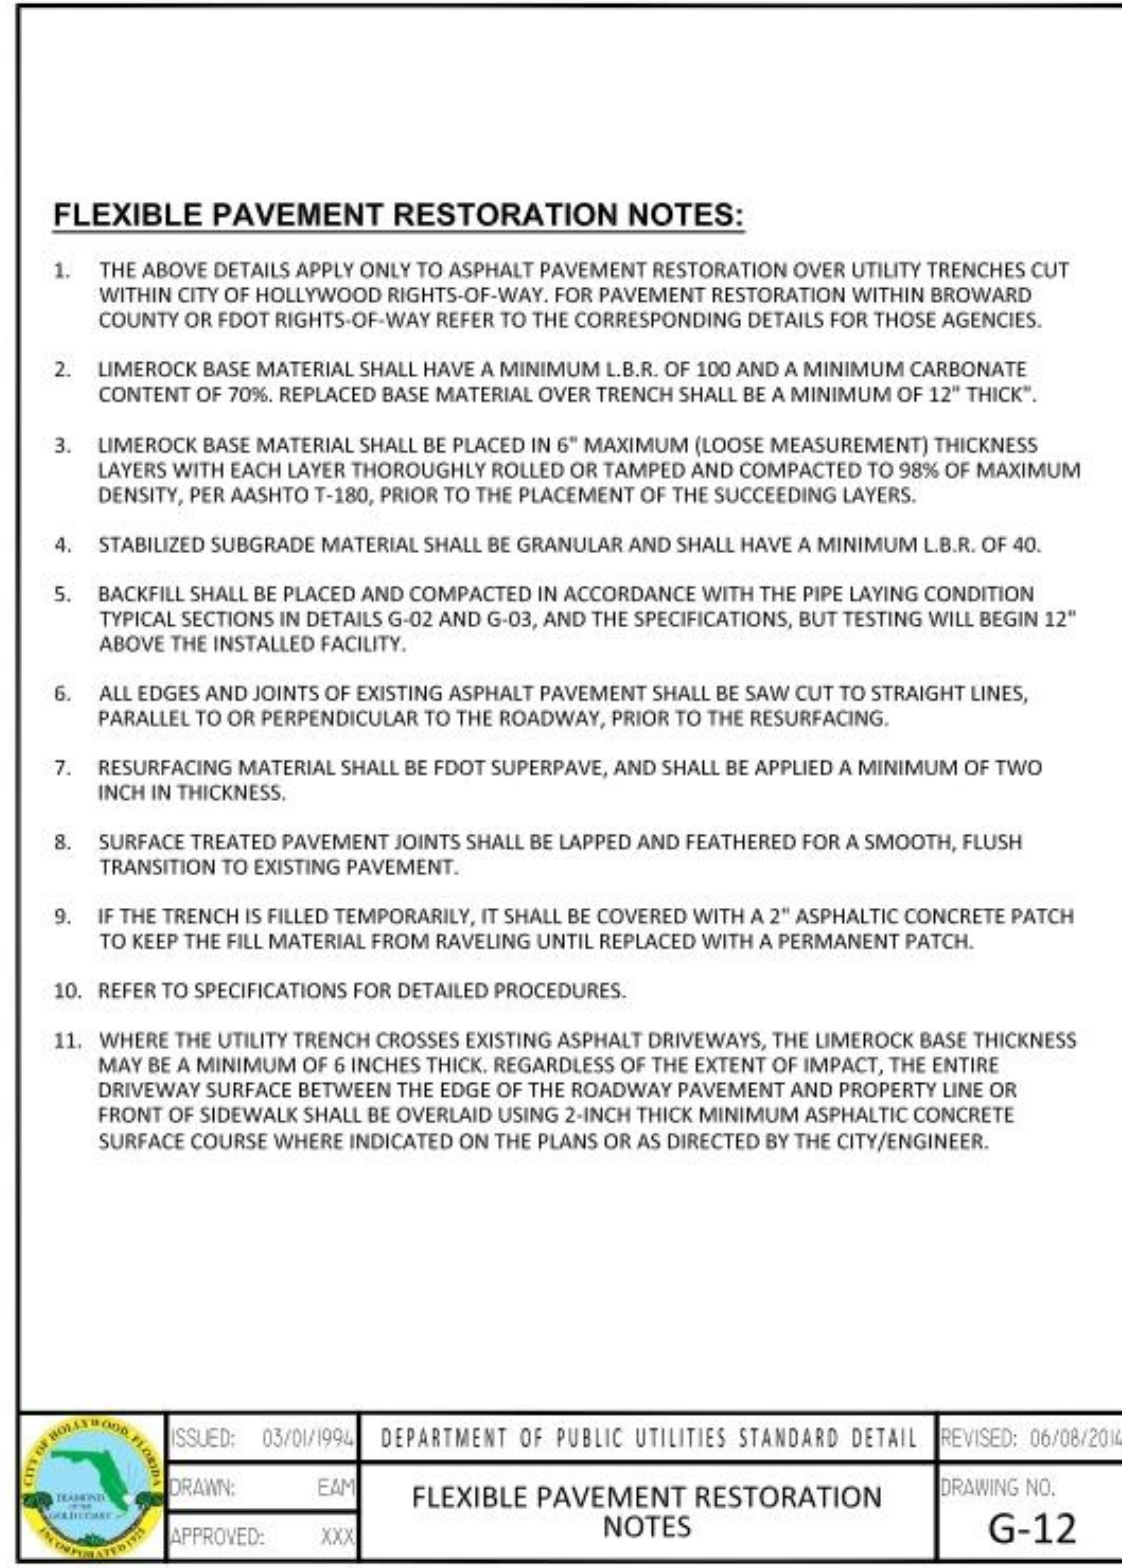

ISSUED: 03/01/99A	DEPARTMENT OF PUBLIC UTILITIES STANDARD DETAIL	REVISED: 06/08/2014
DRAWN: EAP	FLEXIBLE PAVEMENT RESTORATION NOTES	DRAWING NO. G-12
APPROVED: XXX		

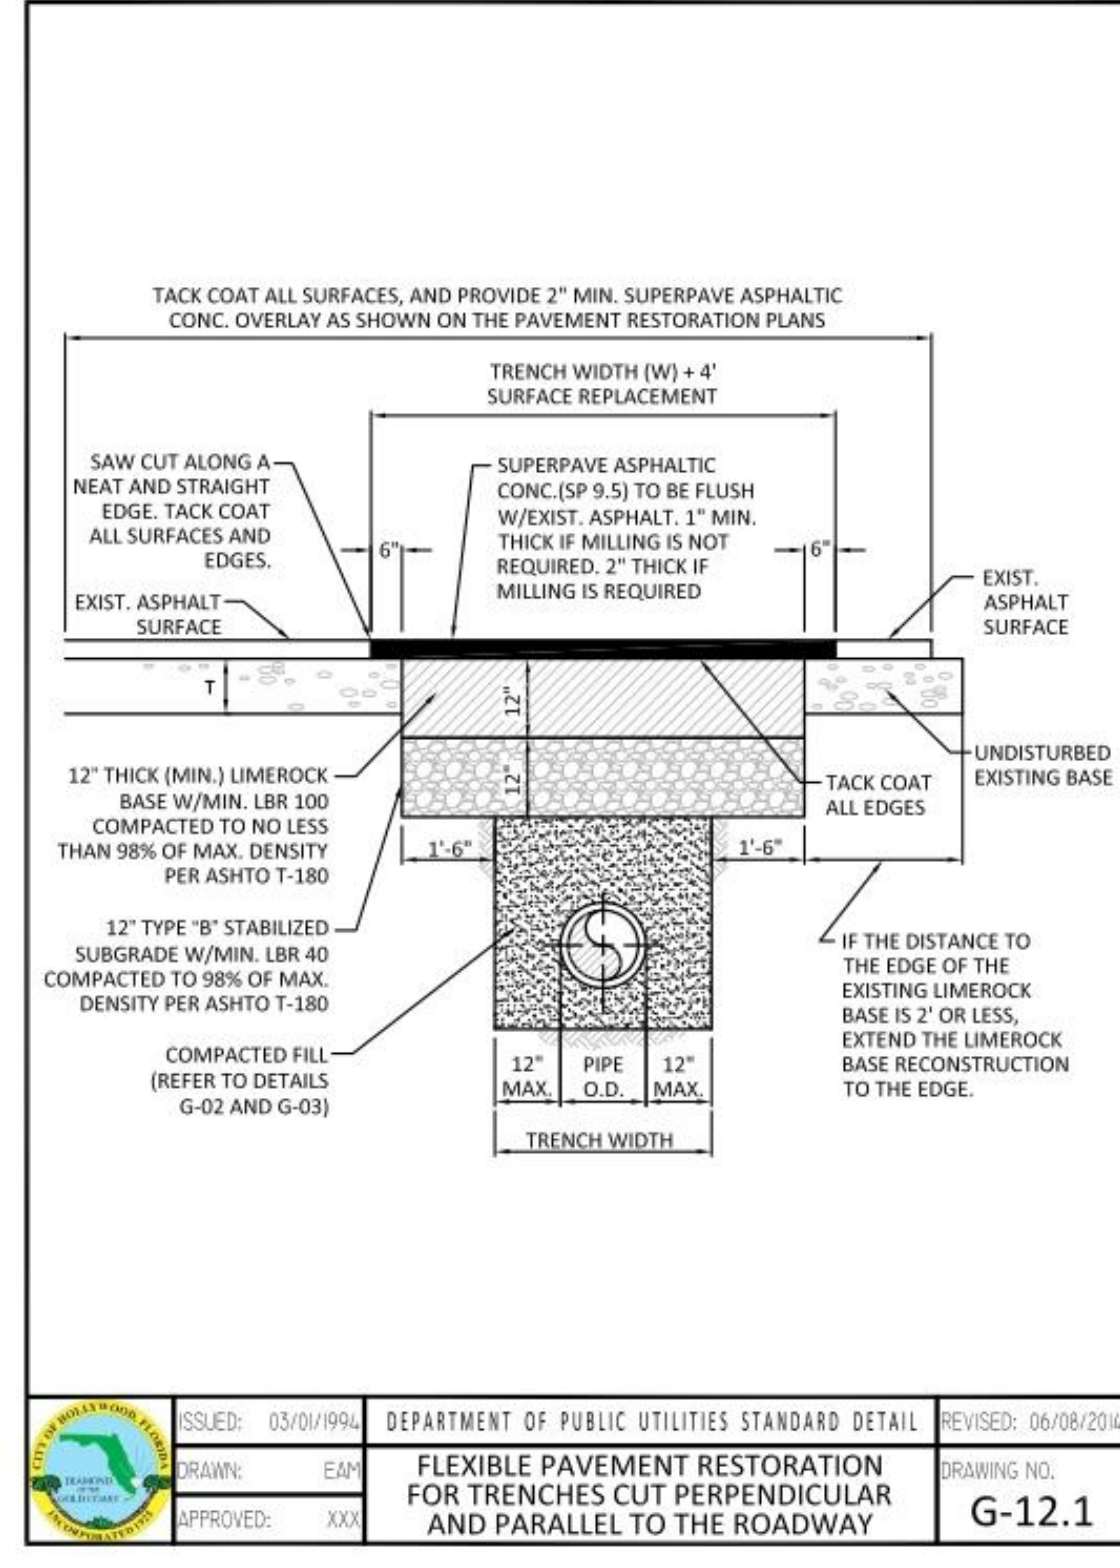

ISSUED: 03/01/99A	DEPARTMENT OF PUBLIC UTILITIES STANDARD DETAIL	REVISED: 06/08/2014
DRAWN: EAP	FLEXIBLE PAVEMENT RESTORATION FOR TRENCHES CUT PERPENDICULAR AND PARALLEL TO THE ROADWAY	DRAWING NO. G-12.1
APPROVED: XXX		

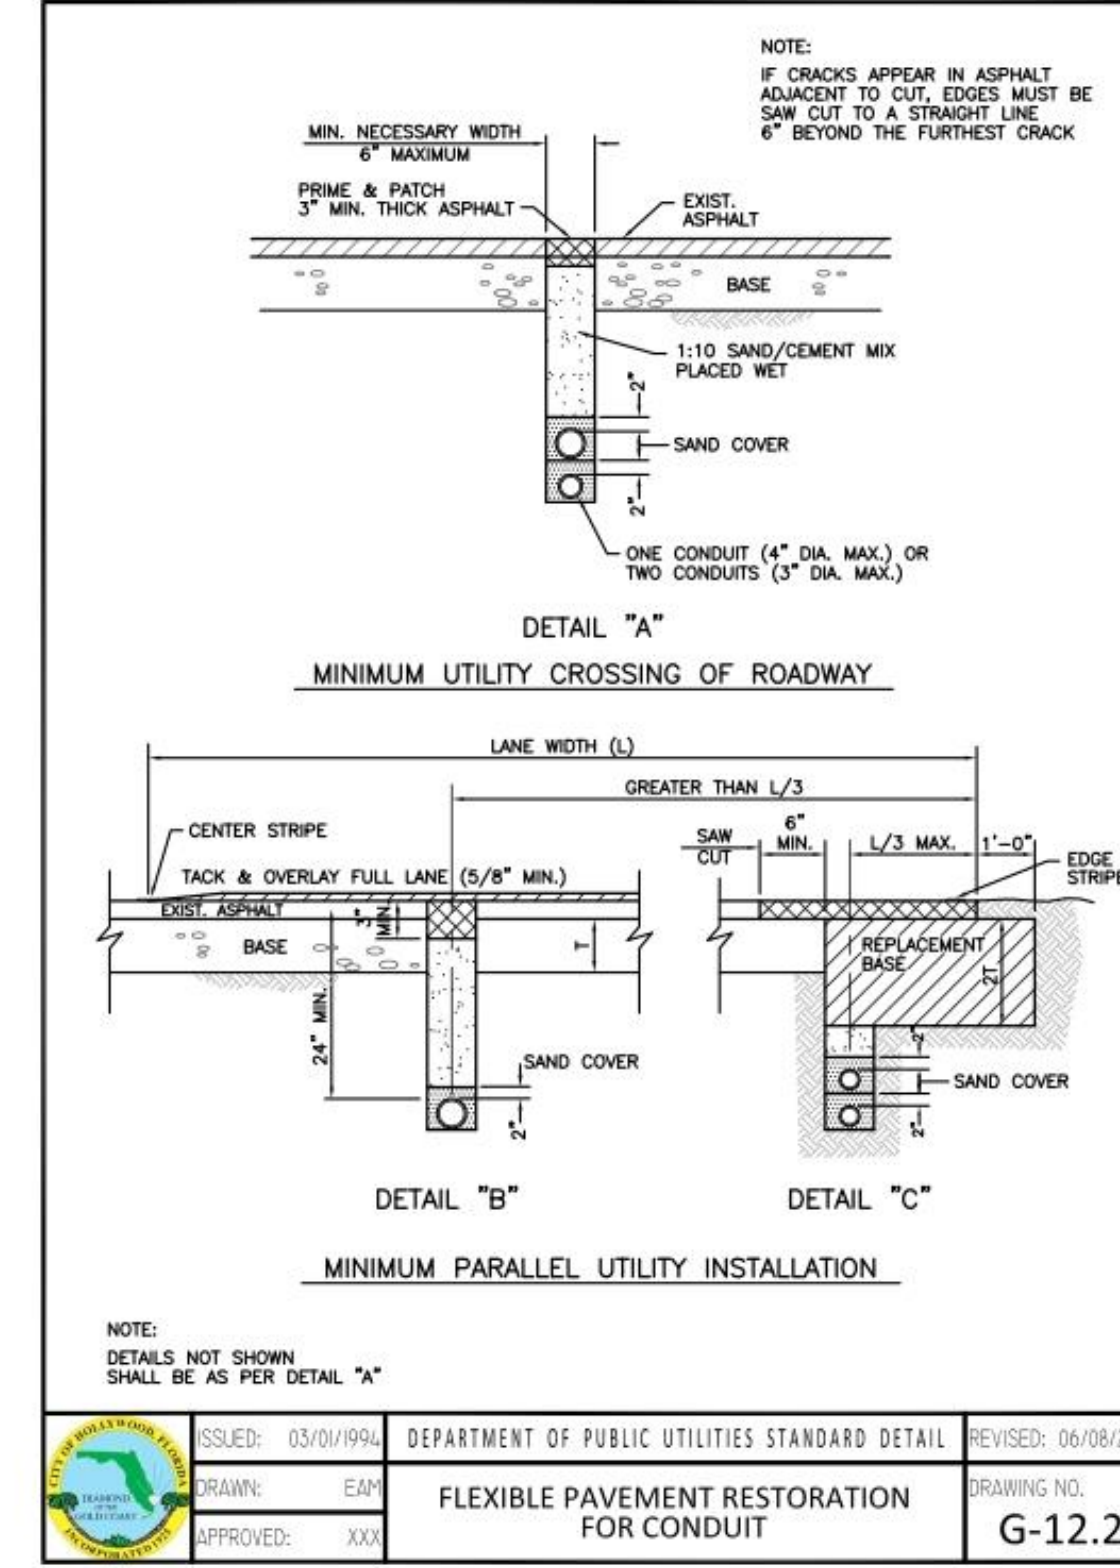

ISSUED: 03/01/99A	DEPARTMENT OF PUBLIC UTILITIES STANDARD DETAIL	REVISED: 06/08/2014
DRAWN: EAP	FLEXIBLE PAVEMENT RESTORATION FOR CONDUIT	DRAWING NO. G-12.2
APPROVED: XXX		

PROJECT: Chabad Ocean Jewish Center HOLLYWOOD FLORIDA TASK: CONSTRUCTION DETAILS		CLIENT: Kaller Architects 2417 Hollywood Boulevard Hollywood, Florida 33020-6605 (954) 920-5746
PROJECT: GGB Engineering, Inc. CIVIL AND FORENSIC ENGINEERS • LAND PLANNERS • CONSTRUCTION MANAGERS 2699 Stirling Road, Suite C-202 Fort Lauderdale, Florida 33312 Phone: (954) 986-9899 Fax: (954) 986-8655		DATE: Nov. 2018 DESIGNED BY: G.C.B. PROJECT NO. 18-1107 SHEET C-3
DATE: Nov. 2018 DESIGNED BY: G.C.B. PROJECT NO. 18-1107 SHEET C-3		DATE: Nov. 2018 DRAWN BY: F.M. PROJECT NO. 18-1107 SHEET C-3

WATER SYSTEM:

ALL WORKMANSHIP AND MATERIAL SHALL CONFORM TO STANDARDS OF THE LOCAL MUNICIPALITY AND APPLICABLE DEPARTMENT OF HEALTH AND REHABILITATION SERVICES STANDARDS. NO PHYSICAL CONNECTION OF NEW WATER MAINS TO EXISTING WATER MAINS SHALL BE MADE UNTIL SUCH TIME THAT THE NEW MAINS ARE CONFIRMED TO BE BACTERIOLOGICALLY SAFE AND THE HEALTH DEPARTMENT RELEASE HAS BEEN OBTAINED. TEMPORARY CONNECTIONS OF NEW MAINS TO ACTIVE MAINS FOR THE PURPOSE OF FILLING AND FLUSHING SHALL BE MADE BY A METHOD DEEMED ACCEPTABLE TO THE UTILITY PROVIDING SERVICE.

ALL WATER MAINS SHALL BE DESIGNED FOR A MINIMUM WORKING PRESSURE OF 150 PSI AND HAVE COMPRESSION TYPE BELL AND SPIGOT JOINTS.

THE WATER SYSTEM SHALL BE HYDROSTATICALLY PRESSURE TESTED AND DISINFECTED PER AWWA / ANSI C601/05 AND TESTED FOR A PERIOD OF 2 HOURS AT NOT LESS THAN 150 PSI IN ACCORDANCE WITH ANSI / AWWA STANDARD C600-05 WITH AN ALLOWABLE LEAKAGE AS DETERMINED BY THE FOLLOWING FORMULA:

$$L = S D^{0.5} \sqrt{148,000}$$

WHERE:
L = ALLOWABLE LEAKAGE IN GALLONS / HOUR
S = PIPE LENGTH IN FEET
D = NOMINAL DIAMETER OF PIPE IN INCHES
P = AVERAGE TEST PRESSURE IN PSI

TEST PRESSURE SHALL NOT VARY MORE THAN 5 PSI THROUGHOUT THE TEST. THE MAXIMUM ALLOWABLE LEAKAGE SHALL BE BASED ON A MAXIMUM 2000 FEET WHEN THE LENGTH OF PIPE TESTED EXCEEDS 2000 FEET. THRUST BLOCKS AS SHOWN ON THE DETAIL SHEETS SHALL BE PROVIDED AT ALL BENDS UNLESS OTHERWISE NOTED IN PLANS. IF RESTRAINT JOINT PIPE IS SPECIFIED ON THE PLANS, IT SHALL BE INSTALLED TO MEET THE REQUIREMENTS OF THE PIPE MANUFACTURER AND THE UTILITY DEPARTMENT. NO CONCRETE THRUST BLOCKS WILL BE ALLOWED EXCEPT FOR FIRE HYDRANTS.

BACTERIOLOGICAL TESTING SHALL BE IN ACCORDANCE WITH AWWA / ANSI C601-05 LATEST REVISION.

PVC WATER MAIN PIPE (BLUE) SHALL MEET THE REQUIREMENTS OF AWWA C-300.97 POLY(VINYL CHLORIDE) PRESSURE PIPE, CLASS 150 PIPE SHALL CONFORM TO REQUIREMENT OF SR 18.

ALL PVC PIPE SHALL BE SUITABLE FOR USE AS A PRESSURE CONDUIT. PROVISIONS MUST BE MADE FOR EXPANSION AND CONTRACTION AT EACH JOINT WITH AN ELASTOMERIC RING. THE BELL SHALL CONSIST OF AN INTEGRAL WALL SECTION WITH AN ELASTOMERIC RING WHICH MEETS THE REQUIREMENTS OF ASTM F-477 STANDARD SPECIFICATIONS. FOR ELASTOMERIC SEALS (GASKETS FOR JOINTING PLASTIC PIPE), THE WALL THICKNESS IN THE BELL SECTION SHALL CONFORM TO THE REQUIREMENTS OF ASTM D-3139.

PVC PIPE SHALL BE DELIVERED TO THE JOB SITE FROM THE FACTORY AND STORED AT THE JOB SITE IN PALLETIZED UNITS OR BUNDLES TO PREVENT UNNECESSARY DEFLECTION PRIOR TO INSTALLATION. EACH PALLETIZED UNIT SHALL BE SIZED TO LIMIT THE STACKING OF PIPE NOT MORE THAN SIXTY (60) INCHES HIGH OR AS APPROVED BY THE ENGINEER.

CARE SHALL BE TAKEN DURING THE TRANSPORTING OF THE PIPE TO INSURE THAT THE BINDING AND TIE DOWN METHODS DO NOT DAMAGE OR DEFLECT THE PIPE IN ANY MANNER. PIPE BENT, DEFLECTED, OR OTHERWISE DAMAGED DURING SHIPPING WILL BE REJECTED.

PVC MAINS SHALL BE LAID WITH A MINIMUM OF 36" CLEAR COVER.

FITTINGS SHALL BE MECHANICAL JOINT DUCTILE IRON PRESSURE CLASS 350 THROUGH 12". ALL FITTINGS SHALL BE CEMENT MORTAR LINED AND SEALED THE SAME AS PIPE IN ACCORDANCE WITH AWWA/ANSI C110/A21.10-03.

PVC AND D.I.P. PIPE SHALL BE DEFLECTED NO MORE THAN ONE HALF (1/2) THE MANUFACTURERS RECOMMENDATION.

JOINTS FOR BELL AND SPIGOT PVC/DIP PIPE AND FITTINGS SHALL BE MECHANICAL OR RUBBER GASKET (EITHER ON SPIGOT OR IN BELL) COMPRESSION TYPE AS SPECIFIED IN ACCORDANCE WITH AWWA/ANSI STANDARD C111/A21.11-00. SPECIAL FITTINGS AND JOINTS SHALL BE CONSIDERED FOR SPECIFIC INSTALLATION.

ALL WATER MAINS SHALL HAVE CONTINUOUS DETECTOR TAPE 18 INCHES BELOW GRADE ALONG ALL WATER MAINS. DETECTOR TAPE SHALL HAVE BLUE SIDE-UP. 14 GAUGE MULTI STRAND WIRE SHALL BE ATTACHED TO ALL NON-CONDUCTIVE WATER MAIN VE FACILITY. FUTURE INSTALLATION OF AN EXTRA 4" OF WIRE SHALL BE PROVIDED AT BLOWOFFS, FIRE HYDRANTS, ETC.

POLYETHYLENE ENCASUREMENT/WRAP SHALL BE INSTALLED ON ALL IRON PIPES INCLUDING VALVES, FITTINGS, SLEEVES, HYDRANTS, ETC. POLYWRAP SHALL BE INSTALLED IN ACCORDANCE WITH THE MINIMUM ANSI/AWWA C105/A21.5-05 STANDARDS.

DUCTILE IRON WATER MAIN SEALCOAT SHALL BE COAL TAR EPOXY OR ASPHALT.

DUCTILE IRON PIPE JOINTS SHALL BE PUSH-ON TYPE AND RESTRAINED A MINIMUM DISTANCE AS SPECIFIED IN RESTRAINED DETAIL ON APPLICABLE DETAIL SHEET. USING MECA-100 OR APPROVED EQUAL USING TR-FLEX U.S. PIPE OR FLEX RING BY AMERICAN PIPE.

WATER MAIN STUBS FOR FUTURE EXTENSION INCLUDING ALL FITTINGS BACK TO TEE (1/2" TUB LENGTH) OR TWO TIE PIPE LENGTHS LONG WILL BE RESTRAINT JOINT PIPE FOR THE LAST TWO LENGTHS. (AS REQUIRED BY ENGINEER OR UTILITY DEPT.)

DUCTILE IRON PIPE SHALL BE CLASS 350 AND SHALL BE CEMENT LINED AND SEALCOATED IN ACCORDANCE WITH AWWA / ANSI STANDARD C151/A21.51-02. WATER MAINS SHALL BE LAID WITH A MINIMUM 30" CLEAR COVER. DUCTILE IRON FITTINGS SHALL BE CLASS 350 THROUGH 12" AND CLASS 250 IN SIZES 16" AND LARGER. ALL FITTINGS SHALL BE CEMENT LINED AND SEALCOATED THE SAME AS PIPE IN ACCORDANCE WITH AWWA / ANSI STANDARDS C104/A21.4-03 AND C153/A21.53-00. NEOPRENE GASKETS SHALL BE USED.

ALL WATER MAINS SHALL BE BEDDED AND BACKFILLED PER STANDARD TRENCH DETAILS.

CONTRACTOR IS RESPONSIBLE FOR THE EXISTING ON-SITE WATER SYSTEM UNTIL FINAL INSPECTION, CERTIFICATION AND APPROVAL BY THE UTILITY.

CONTRACTOR IS RESPONSIBLE WHETHER, OR NOT NOTED ON PLANS, FOR RAISING OR LOWERING OF EXISTING GATE VALVE BOXES, METER BOXES, ETC. THAT MAY NEED ADJUSTMENT TO MEET PROPOSED FINISH GRADES.

ALL EXISTING WATER MAINS AND COMPONENTS DESIGNATED FOR REMOVAL ARE THE PROPERTY OF THE UTILITY. MATERIALS SHALL BE REMOVED FROM THE GROUND AS CAREFULLY AS POSSIBLE AND SALVAGED FOR UTILITY. SHOULD UTILITY REFUSE SAID WATER COMPONENTS, THEN THE CONTRACTOR WILL BE RESPONSIBLE FOR OFF-SITE DISPOSAL.

CONTRACTOR TO REFER TO ARCHITECTURAL (PLUMBING) PLANS TO CONFIRM LOCATIONS AND ELEVATIONS OF ALL WATER FIRE AND SEWER BUILDING CONNECTIONS.

DEVELOPER IS RESPONSIBLE TO DEDICATE UTILITY EASEMENTS TO THE UTILITY FOR ALL PUBLIC WATER MAINS THAT ARE TO BE ULTIMATELY OWNED AND MAINTAINED BY THE UTILITY. EASEMENTS TO BE GRANTED UPON THE CONCLUSION OF THE WORK FROM AS-BUILT PIPE LOCATIONS, UNLESS OTHERWISE REQUIRED BY THE UTILITY.

CONTRACTOR IS RESPONSIBLE TO DELIVER AS-BUILT WATER PLANS, MYLAR, ANTI-CORRUPT, DISK AND COMPUTER GENERATED PRIOR TO FINAL CERTIFICATION TO THE UTILITY. AS-BUILTS SHALL BE SIGNED AND SEALED BY A REGISTERED FLORIDA SURVYOR.

MAINTAIN A 10-FOOT HORIZONTAL CLEARANCE BETWEEN ALL UTILITIES AND BUILDING STRUCTURES, UNLESS OTHERWISE SHOWN ON THE PLANS.

LANDSCAPING SHALL NOT BE INSTALLED WITHIN 6' OF ALL WATER MAINS AND SERVICES OR WITHIN A 5' RADIUS OF ALL FIRE HYDRANTS, UNLESS APPROVED BY THE ENGINEER.

WATER MAINS SHALL BE DEFLECTED OVER DRAINAGE AT ALL CONFLICTS.

ALL WATER SERVICES SHALL TERMINATE A MINIMUM OF 5' FROM BUILDING.

UNDERGROUND WATER MAINS AND FIRE HYDRANTS SHALL BE INSTALLED AND OPERATIONAL PRIOR TO BUILDING CONSTRUCTION AS REQUIRED BY THE LOCAL FIRE DEPARTMENT AND THE SOUTH FLORIDA BUILDING CODE, LATEST REVISION.

ALL WATER MAIN INSTALLATION SHALL COMPLY WITH THE COLOR CODING REQUIREMENTS OF CHAPTER 62-555.320 FAC.

WATER SERVICE LINES:

WATER SERVICES SHALL BE POLYETHYLENE TUBING (PE 3408) COMPLYING WITH APPLICABLE REQUIREMENTS FOR PE. AWWA C902-02 HIGH MOLECULAR WEIGHT PLASTIC MATERIAL ASTM D-2666, 250 PSI RATING (CTS-DD) SDR 9. SERVICE PIPE SHALL BE INSTALLED AS A SINGLE RUN WITHOUT UNIONS.

JOINTS FOR TUBING SHALL BE OF THE COMPRESSION TYPE UTILIZING A TOTALLY CONNECTED GRIP SEAL AND COUPLING NUT. STAINLESS STEEL TUBE STIFFENER INSERTS SHALL ALSO BE USED FOR TUBING SERVICES.

SERVICE LINES SHALL BE MARKED WITH 2" X 4" POST PAINTED BLUE.

ALL WATER SERVICES SHALL BE BEDDED AND BACKFILLED PER STANDARD TRENCH DETAIL.

PIPE DEFLECTION SHALL BE NO MORE THAN ONE HALF OF THE MANUFACTURER'S RECOMMENDATION.

MINIMUM COVER SHALL BE 24".

ALL WATER SERVICE LINES UNDER PAVED AREAS SHALL BE SLEEVED IN SCHEDULE 40 PVC AND SHALL BE OF ONE SINGLE LENGTH WITHOUT UNIONS.

FORD STAINLESS INSERTS ARE REQUIRED FOR PLASTIC PIPE.

GATE VALVES:

GATE VALVES 4" AND LARGER SHALL BE MECHANICAL JOINT TYPE AND COMPLY WITH AWWA / ANSI STANDARD C509-01.

MECHANICAL JOINTS SHALL CONFORM TO AWWA / ANSI C111/A21.11-00.

ALL GATE VALVES ARE TO BE IRON BODY, BRONZE MOUNTED, DOUBLE DISK, NON-RISING STEM, RESILIENT SEAT TYPE, OPENING LEFT (COUNTER CLOCKWISE) THE INTERIOR LINING SHALL BE FUSION BONDED EPOXY ACCORDING TO AWWA 550-50 AND AN EXTERIOR EPOXY COAT (BOTH 40 MILS DFT.)

GATE VALVES 4" TO 12" SHALL HAVE A MAXIMUM WORKING PRESSURE OF 200 PSI AND BE TESTED AT 400 PSI. GATE VALVES SHALL BE RESILIENT SEATED MUELLER, CLOW RESILIENT WEDGE, M & H, OR APPROVED EQUAL, WITH RESTRAINT JOINTS.

GATE VALVES UNDER 4" IN SIZE SHALL BE BRONZE GATE VALVES CONFORMING TO MSS STANDARD PRACTICE SP-37. THEY SHALL BE DOUBLE DISK, NON-RISING STEM, OPEN, LEFT (COUNTER CLOCKWISE) WITH OPERATING WHEEL, PEWTER AND POT METAL OPERATING WHEELS SHALL NOT BE PERMITTED. GATE VALVES SHALL MEET AWWA C500-02 STANDARDS.

VALVE BOXES SHALL BE CAST IRON EXTENSION TYPE WITH NOT LESS THAN 5-1/4" DIAMETER SHAFT AND WITH COVERS MARKED "WATER". PAINTED BLUE. USF 7500 OR APPROVED EQUAL.

GATE VALVES 18" AND LARGER WILL BE SUBSTITUTED WITH BUTTERFLY VALVES AS MANUFACTURED BY PRATT, DEZURIK, CLOW, OR APPROVED EQUAL.

BUTTERFLY VALVES ARE TO BE CAST OR DUCTILE IRON BODY; ALLOY CAST IRON OR DUCTILE IRON DISK; BODY MOUNTED ADJUSTABLE SEAT; ONE-PIECE STAINLESS STEEL SHAFT; SHORT OR LONG BODY TYPE WITH THE VALVE CLASS, SHAFT SIZE AND OTHER SPECIAL REQUIREMENTS SELECTED IN ACCORDANCE WITH THE SPECIFIC DESIGN; AND ARE TO COMPLY WITH THE PROVISIONS OF AWWA C504-00, "RUBBER SEATED BUTTERFLY VALVES."

VALVE OPERATION IS TO BE APPROVED GEAR ACTUATORS, WITH SEALED ENCLOSURES (FOR BURIED OR SUBMERGED SERVICE), POSITION INDICATORS WILL BE FURNISHED AS REQUIRED. UNITS ARE TO BE EQUIPPED WITH 2" ACTUATING RODS, CAST IRON HANDWHEELS, OR CHAIN OPERATORS, WITH GALVANIZED STEEL CHAINS, AS APPROPRIATE FOR THE INSTALLATION. APPURTENANCES ARE TO BE FURNISHED BY THE VALVE MANUFACTURER.

WATER SERVICE FITTINGS:

METER VALVES (ASTM B-62 LATEST) SHALL BE FORD ANGLE STOPS, MODEL #K4V3-342W FOR SINGLE SERVICES AND FORD MODEL #UV63-42W FOR DOUBLE SERVICES OR APPROVED EQUAL.

CURB STOPS SHALL BE OF THE INVERTED KEY TYPE WITH TEE-HEAD SHUT OFF. CURB STOPS SHALL BE MADE OF BRASS ALLOY IN ACCORDANCE WITH ASTM SPECIFICATION B62-82A.

METER VALVES AND CORPORATION STOPS (FORD BALL CORP. NO. FC 202) SHALL BE OF BRONZE CONSTRUCTION IN ACCORDANCE WITH ASTM SPECIFICATION B62-82A WITH EPOXY COATED DUCTILE IRON BODY STAINLESS STEEL SERVICE SADDLES BY FORD.

INLET THREAD FOR METER VALVES AND CURB STOPS SHALL BE AWWA TAPER THREAD IN ALL SIZES IN ACCORDANCE WITH ANSI / AWWA STANDARD C800-05. UNION CONNECTIONS SHALL HAVE A COMPRESSION TYPE FITTING SAME AS VALVES.

CONTRACTOR TO REVIEW WATER DETAILS TO DETERMINE EXTENT OF JURISDICTION OF WATER SERVICE AND METER MATERIALS (METERS, ETC.) SUPPLIED AND INSTALLED BY UTILITY.

FIRE HYDRANTS:

ALL FIRE HYDRANTS SHALL COMPLY WITH AWWA / ANSI STANDARD C502-05 AND THE FOLLOWING DESIGN STANDARDS.

THE FIRE HYDRANTS SHALL BE OF THE COMPRESSION TYPE, OPENING AGAINST THE PRESSURE AND CLOSING WITH A 12" (12" MINIMUM) 5/4" VALVE OPENING. THE HYDRANT SHALL BE EQUIPPED WITH (2)-2 1/2" HOSE NOZZLES AND (1)-5/4" PUMPER NOZZLE.

FIRE HYDRANTS SHALL BE FURNISHED WITH A SEALED OIL OR GREASE RESERVOIR LOCATED IN THE BONNET SO THAT ALL THREADED AND BEARING SURFACES ARE AUTOMATICALLY LUBRICATED WHEN THE HYDRANT IS OPERATED. THE DISASSEMBLY WILL BE DESIGNED FOR DISASSEMBLY BY USE OF A SHORT DISASSEMBLY WRENCH OR THE HYDRANT SHOE SHALL HAVE INTEGRAL CAST TIE BACK LUGS ON THE MAIN VALVE TO PERMIT THE MAIN VALVE ASSEMBLY AND VALVE SEAT TO BE REMOVED WITHOUT DIGGING EARTH OR DISASSEMBLING THE HYDRANT BARREL.

FIRE HYDRANTS SHALL BE FURNISHED WITH A BREAKABLE FEATURE THAT WILL BREAK CLEANLY UPON IMPACT. THIS SHALL CONSIST OF A TWO PART BREAKABLE SAFETY FLANGE WITH A BREAKABLE STEM COUPLING. THE UPPER AND LOWER BARRELS SHALL BE FLUTED AND RIBBED ABOVE AND BELOW THE SAFETY FLANGE OR HAVE AN EXTRA STRENGTH LOWER BARREL.

THE FIRE HYDRANT INTERNAL VALVE SHALL BE 5/4" MINIMUM. THE PENTAGONAL OPERATING NUTS AND THE CAP NUTS SHALL BE 1/2" POINT TO FLAT. DRAIN VALVE OUTLETS FOR THE HYDRANTS SHALL BE PLUGGED OR OMITTED. THE HYDRANTS SHALL OPEN COUNTER CLOCKWISE AND THE DIRECTION OF OPENING SHALL BE CAST ON THE TOP. THE BURY LENGTH, MEASURED FROM THE BOTTOM OF THE CONNECTION TO THE TIE BACK LINE, AT THE HYDRANT SHALL BE THREE FEET SIX INCHES (42") MINIMUM OR AS REQUIRED BY PLAN.

THE HYDRANT SHALL BE EQUIPPED WITH A 6" MINIMUM MECHANICAL JOINT BASE INLET UNLESS OTHERWISE SPECIFIED BY THE ENGINEER.

FIRE HYDRANTS SHALL BE MUELLER PAINTED TRAFFIC RED, OR AS OTHERWISE SPECIFIED ON PLANS, OR AS REQUIRED BY THE LOCAL UTILITY COMPANY.

REFER TO WATER DETAILS FOR OTHER REQUIREMENTS / INFORMATION RELATED TO FIRE HYDRANTS.


SANITARY SEWER:

ALL WORKMANSHIP AND MATERIAL SHALL CONFORM TO STANDARDS OF THE BROWARD COUNTY BUILDING DEPARTMENT, LOCAL MUNICIPALITY AND THE WATER RESOURCE DIVISION, BROWARD COUNTY DEPARTMENT OF NATURAL RESOURCE PROTECTION.

UNLESS OTHERWISE NOTED OR APPROVED, ALL GRAVITY MAINS AND SERVICES UP TO 3' OUTSIDE OF BUILDING SHALL BE UNPLASTICIZED POLYVINYL CHLORIDE (PVC) NONPRESSURE PIPE CONFORMING TO ASTM D3034 AND SDR 35 WITH INTEGRAL WALL. JOINTS SHALL BE PLUGGED FOR PUSH-ON RUBBER GASKET TYPE JOINT SEALS CONFORMING TO ASTM D1869, UNLESS OTHERWISE SPECIFIED ON THE PLANS.

PVC FITTINGS SHALL BE OF MONOLITHIC CONSTRUCTION OF THE TYPE SPECIFIED BY THE MANUFACTURER OF THE PIPE. MINIMUM THICKNESS OF WELDS OR THREADED JOINTS WILL BE PERMITTED. ALL JOINTS SHALL BE COMPRESSION GASKET TYPE.

THE JOINING OF PIPE ON THE JOB SHALL BE DONE IN STRICT ACCORDANCE WITH THE PIPE MANUFACTURER'S INSTALLATION INSTRUCTIONS. JOINTS ENTIRELY IN THE TRENCH UNLESS OTHERWISE DIRECTED BY THE ENGINEER, SPECIFIED ON THE PLANS.

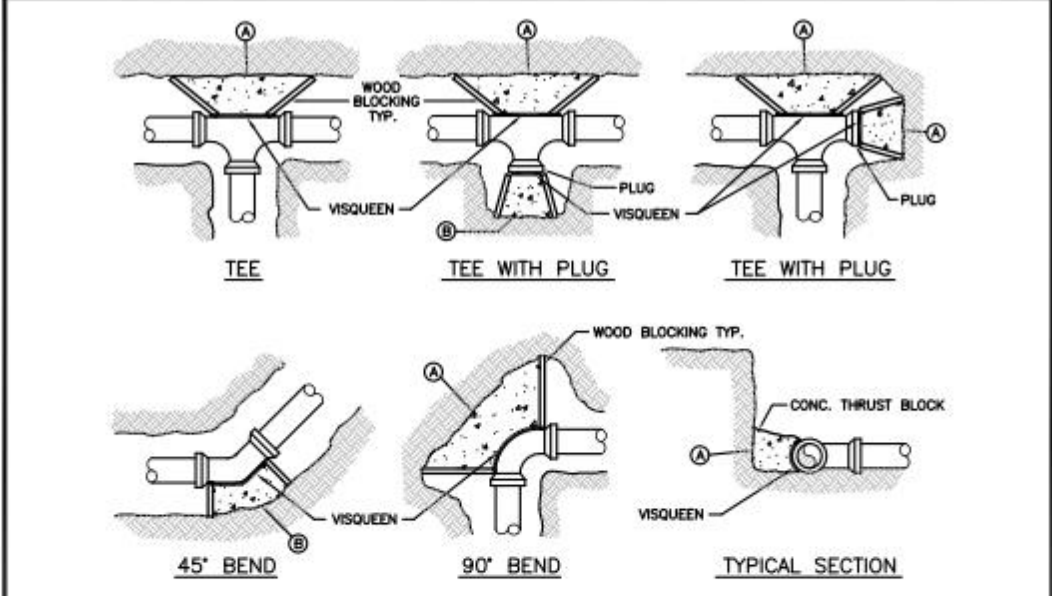

MINIMUM CONCRETE THRUST BLOCKING BEARING ON UNDISTURBED MATERIAL (SQ. FT.)				
MARK	PIPE SIZE			
	4" OR 6"	8"	10"	12"
A				
B				

- NOTES:
- THRUST BLOCKS ARE TO BE USED IN COMBINATION WITH, AND NOT IN LIEU OF, MECHANICAL JOINT RESTRAINTS AS REQUIRED BY THE CITY. REFER TO THRUST RESTRAINT DESIGN TABLE IN STANDARD DETAIL G-10.
 - THE AREAS IN THE TABLE ARE BASED ON POUNDS PER SQUARE FOOT SOIL BEARING AGAINST THE UNDISTURBED TRENCH WALL AND ARE TO REPRESENT THE MINIMUM VERTICAL BEARING AREA AT THE THRUST BLOCK IN A PLANE PERPENDICULAR TO THE LINE BISECTING THE INCLUDING ANGLE OF THE FITTING.
 - POUR THRUST BLOCKS AGAINST UNDISTURBED MATERIAL. WHERE TRENCH WALL HAS BEEN DISTURBED, EVACUATE LOOSE MATERIAL AND EXTEND THRUST BLOCK TO UNDISTURBED MATERIAL.
 - ON BENDS AND TEES, EXTEND THRUST BLOCKS FULL LENGTH OF FITTING.
 - DO NOT COVER COUPLING OR JOINTS WITH CONCRETE.
 - CONCRETE TO BE 2500 P.S.I. MINIMUM 28 DAY STRENGTH.
 - TABLE TO BE COMPLETED BY DESIGN ENGINEER.

ISSUED: 03/01/09/04	DEPARTMENT OF PUBLIC UTILITIES STANDARD DETAIL	REVISED: 06/08/2014
DRAWN: EAM	THRUST BLOCK DESIGN	DRAWING NO. G-10
APPROVED: JAA		

WATER NOTES CONTINUED:

- VALVE BOXES AND COVERS FOR ALL SIZE VALVES SHALL BE OF CAST IRON CONSTRUCTION AND ADJUSTABLE SCREW-ON TYPE. THE LID SHALL HAVE CAST IN THE METAL THE WORD "WATER" FOR THE WATER LINES. ALL VALVE BOXES SHALL BE SIX INCH (6") NOMINAL DIAMETER AND SHALL BE SUITABLE FOR DEPTHS OF THE PARTICULAR VALVE. THE STEM OF THE BURIED VALVE SHALL BE WITHIN TWENTY FOUR INCHES (24") OF THE FINISHED GRADE UNLESS OTHERWISE APPROVED BY THE CITY. VALVE BOXES SHALL BE TYLER BRAND, NO SUBSTITUTES.
- FIRE HYDRANTS: PRESENT CITY OF HOLLYWOOD UTILITIES SPECIFICATIONS ALLOW ONLY MANUFACTURERS: MUELLER MODEL SUPER CENTURION 200-552; SIZE REFERENCE CATALOG NO. A-423 AND AMERICAN DURLING MODEL B-8-4 552" SIZE. ANY DEVIATION FROM REQUIRED SPECIFICATIONS WILL REQUIRE CITY OF HOLLYWOOD UTILITIES APPROVAL.
- ALL WATER MAIN INSTALLATIONS SHALL COMPLY WITH THE COLOR CODING REQUIREMENTS OF CHAPTER 62-555.320 FAC.
- ALL PVC PIPE SHALL CONFORM TO THE REQUIREMENTS OF ANSI/AWWA C300 LATEST REVISION AND CLASS 350. ALL DIP WATER MAINS SHALL BE DUCTILE IRON PRESSURE CLASS 350, WITH WALL THICKNESS COMPLYING WITH CLASS 52. ALL DUCTILE IRON PIPE SHALL CONFORM TO THE REQUIREMENTS OF ANSI/AWWA C151/A21.51-02 AND BE CEMENT LINED AND SEAL COATED PER ANSI/AWWA C104/A21.4-03.
- FITTINGS SHALL BE DUCTILE IRON, MEETING ANSI/AWWA C153/A21.53-00 SPECIFICATIONS, WITH 350 PSI MINIMUM WORKING PRESSURE. FITTINGS MUST BE CEMENT LINED AND SEAL COATED PER ANSI/AWWA C104/A21.4-03. ALL DUCTILE IRON PIPE AND FITTINGS MUST BE MANUFACTURED IN THE UNITED STATES OF AMERICA.
- ALL DUCTILE IRON PIPE TO BE MECHANICAL JOINTS, WRAPPED IN POLY ADEQUATE PROTECTIVE MEASURES AGAINST CORROSION SHALL BE USED AS DETERMINED BY DESIGN.
- GATE VALVES 4" AND LARGER SHALL BE RESILIENT SEAT AND SHALL MEET ANSI/AWWA C-509-01 SPECIFICATIONS, LATEST REVISION. VALVES MUST BE MUELLER (O.A.E.). VALVE BOXES SHALL BE TYLER UNION, CONTROL/GATE VALVES 3" AND SMALLER SHALL BE NIBCO T-133 U.F. NO SUBSTITUTIONS.
- PAVEMENT RESTORATION SHALL BE CARRIED OUT IN ACCORDANCE WITH THE REQUIREMENTS OF THE CITY.
- ALL TRENCHING, PIPE LAYING, BACKFILL, PRESSURE TESTING, AND DISINFECTING MUST COMPLY WITH THE CITY OF HOLLYWOOD SPECIFICATIONS.
- THE MINIMUM DEPTH OF COVER OVER WATER MAINS IS 30" (DIPI) OR 36" (PVC).
- MINIMUM CLEARANCE BETWEEN STORM STRUCTURES AND WATER MAINS SHALL BE 2', AND MAXIMUM DEFLECTION PER EACH JOINT SHALL BE 50% OF MANUFACTURERS RECOMMENDATION (MAXIMUM) WHERE DEFLECTION IS REQUIRED.
- TAPPING SLEEVES SHALL BE MUELLER H-R-315 (O.A.E.). TAPPING VALVES 4" AND LARGER SHALL BE RESILIENT WEDGE TYPE MEETING ANSI/AWWA C509-01. ALL TAPPING VALVES SHALL HAVE A CAST-IN ALIGNMENT RIDGE AND BE CAPABLE OF ACCEPTING A FULL SIZE CUTTER.
- CONTRACTOR SHALL BE RESPONSIBLE FOR IDENTIFYING CONFLICTS WITH WATER MAINS PLACED AT MINIMUM COVER. IN CASE OF CONFLICT, WATER MAIN SHALL BE LOWERED TO PASS UNDER CONFLICTS WITH 18" MINIMUM SEPARATION. NO ADDITIONAL PAYMENT SHALL BE DUE TO CONTRACTOR FOR LOWERING THE MAIN OR THE ADDITIONAL FITTINGS USED THEREON.

ISSUED: 03/01/09/04	DEPARTMENT OF PUBLIC UTILITIES STANDARD DETAIL	REVISED: 06/08/2014
DRAWN: EAM	WATER NOTES	DRAWING NO. W-01.1
APPROVED: JAA		

CONNECTION OF PVC PIPE TO MANHOLES SHALL BE MADE WITH "KOR-N-SEAL" MANHOLE COUPLINGS CORRESPONDING TO THE SIZE AND TYPE OF SEWER PIPE OR OTHER ADAPTERS AS MAY BE APPROVED BY THE UTILITY.

INFLUENT AND EFFLUENT SEWERS SHALL BE GROUTED IN PLACE USING A TYPE A WATERPROOF EXPANDING GROUT ACCEPTABLE TO THE ENGINEER. ALL OPENINGS AND JOINTS SHALL BE SEALED WATERTIGHT. REFER TO GENERAL NOTES FOR NON-SHRINK GROUT.

LIFT HOLES THROUGH PRECAST STRUCTURES ARE NOT PERMITTED.

A. FLOW CHANNEL SHALL BE CONSTRUCTED TO DIRECT INFLUENT INTO FLOW STREAM. REFER TO DETAILS.

OUTSIDE DRAINAGE CONNECTIONS WILL BE REQUIRED WHEN THE VERTICAL DISTANCE BETWEEN PIPES EXCEEDS TWENTY FEET (20'). MINIMUM THICKNESS OF CONNECTIONS, WHERE REQUIRED, SHALL BE CAST MONOLITHICALLY WITH THE MANHOLE ELEMENTS AS SHOWN ON DETAILS.


THE D AND FRAME SHALL BE CAST OF CLASS-GROUND GRAY IRON CONFORMING TO ASTM A-48, CLASS 50 AND SHALL BE OF UNIFORM QUALITY, FREE OF BLOW HOLES, POROSITY, CRACKS, AND OTHER OBVIOUS VISUAL DEFECTS. THE COMBINED WEIGHT OF THE FRAME AND LID SHALL NOT BE LESS THAN 420 POUNDS, AND THE LID SHALL WEIGH A MINIMUM OF 160 POUNDS. THE SEATING SURFACES BETWEEN FRAMES AND COVERS SHALL BE MACHINED TO FIT TRUE. NO PLUGGING OR FILLING WILL BE ALLOWED. CASTING PATTERNS SHALL CONFORM TO THOSE DESIGNATED BY THE GOVERNING UTILITY.

THE LID SHALL HAVE THE WORDS "(PREFERABLY AS REQUIRED BY THE UTILITY)" CAST IN ALL MANHOLE COVERS. CASTINGS SHALL BE CLEANED AND COATED WITH A COAL TAR PITCH VARNISH WHICH IS TOUGH WHEN COLD BUT NOT TACKY OR BRITTLE. PICK TYPE LIFTING HOLES WILL BE CAST INTO LIDS, BUT SHALL NOT GO CLEAR THROUGH THE LID.

MINIMUM COVER ON PUBLIC SANITARY SEWER PIPE SHALL BE 36" ABOVE PVC PIPE, AND 30" ABOVE D.I.P.

ALL MANHOLE LIDS SHALL BE PROVIDED WITH WATERTIGHT POLYETHYLENE MANHOLE INSERTS AS APPROVED BY THE UTILITY DEPARTMENT.

INSIDE SURFACES OF MANHOLES TO BE TREATED WITH TWO COATS COPPERS BITUMASTIC 300-M OR EQUAL. MINIMUM DRY THICKNESS 16 MILS. MANHOLES SHALL BE CURED TWENTY-ONE (21) DAYS BEFORE COATING. MANHOLES SHALL BE PAINTED AT FACTORY PRIOR TO DELIVERY OR ON-SITE WITH ONE COAT (BLACK) OUTSIDE OR AS REQUIRED BY THE UTILITY. FIRST COAT TO BE RED, SECOND COAT TO BE BLACK, UNLESS OTHERWISE SPECIFIED ON THE PLANS.

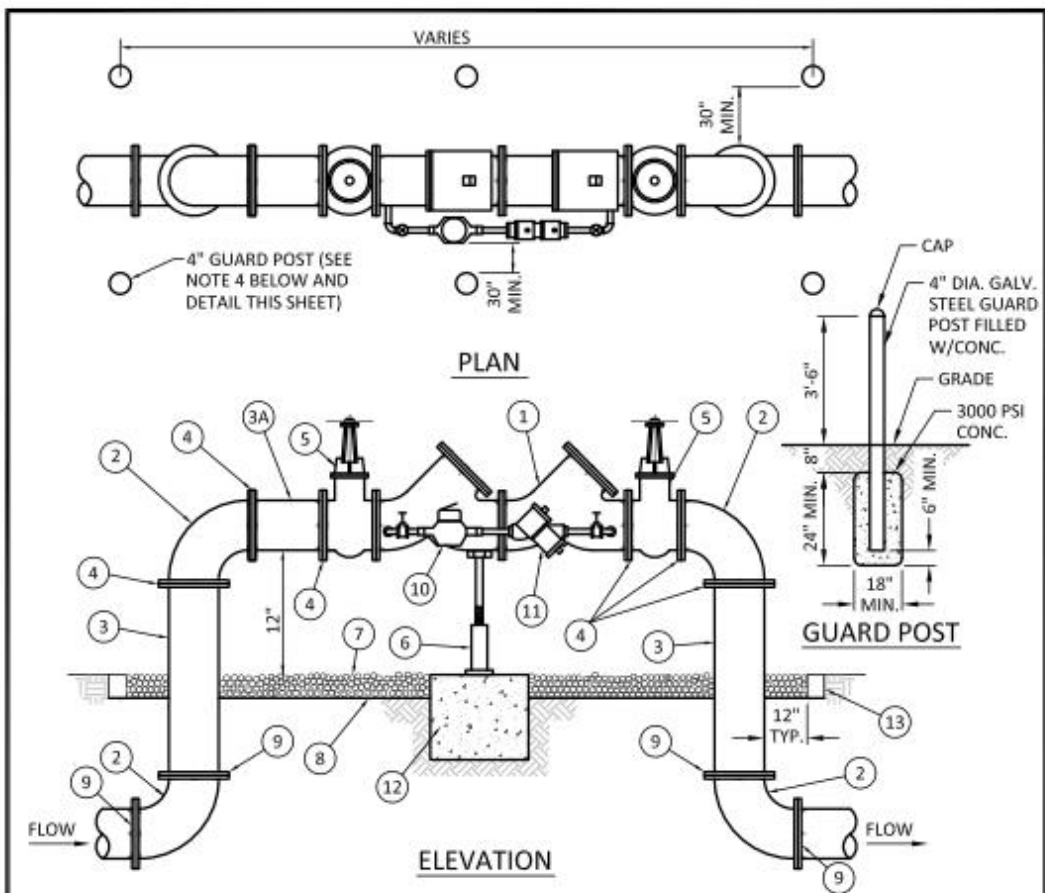

MATERIALS					
ITEM	QTY.	DESCRIPTION	ITEM	QTY.	DESCRIPTION
1	1	4" 6" 8" VALVE DOUBLE CHECK	7	N/A	PEA GRAVEL (4" DEEP)
2	4	4" 6" 8" BEND 90°	8	N/A	PLASTIC LINER/WEED STOP (5 MILS)
3	2	4" 6" 8" D.I.P. SPOOL PIECE	9	4	RESTRAINED JOINTS
3A	1	4" 6" 8" D.I.P. SPOOL PIECE (24" LONG)	10	1	LOW FLOW METER
4	7	4" 6" 8" FLANGE, D.I.P.	11	1	VALVE BYPASS DOUBLE CHECK
5	2	4" 6" 8" GATE VALVE (SEE NOTE 6)	12	1	18"x18"x18" CONC. SUPPORT
6	1	SCREW JACK/ANCHORED	13	1	P.T. 2X4 LUMBER ALL AROUND

- NOTES:
- TIED ADJUST AND CUT ITEM 3 TO THE PROPER LENGTH.
 - ALL PIPING SHALL BE D.I.P. CL 50/52 AS APPLICABLE TO MINIMUM STANDARDS.
 - ALL LOW FLOW METER PIPING SHALL BE BRASS OR COPPER.
 - PROTECTIVE 4" GALV. GUARD POSTS SHALL BE SPACED EVERYWHERE AS SHOWN ABOVE OR IN ACCORDANCE WITH INSPECTOR'S DIRECTIONS.
 - MAY USE 45° BENDS (SEE DETAIL W-07.2) WHEN WORKING AREA IS NOT LIMITED, AS DIRECTED BY CITY.
 - GATE VALVES SHALL BE CHAINED AND LOCKED TOGETHER TO PREVENT TAMPERING.

ISSUED: 03/01/09/04	DEPARTMENT OF PUBLIC UTILITIES STANDARD DETAIL	REVISED: 06/08/2014
DRAWN: EAM	TYPICAL 4", 6" AND 8" DOUBLE CHECK DETECTOR ASSEMBLY FOR FIRE SPRINKLER SERVICE (90° BENDS)	DRAWING NO. W-03
APPROVED: JAA		

WATER NOTES CONTINUED:

- PIPE JOINT RESTRAINT SHALL BE PROVIDED BY THE USE OF DUCTILE IRON FOLLOWER GLANDS MANUFACTURED TO ASTM A-536-80. TWIST-OFF NUTS SHALL BE USED TO ENSURE PROPER ACTUATING OF THE RESTRAINING DEVICES. THE MECHANICAL JOINT RESTRAINING DEVICES SHALL HAVE A WORKING PRESSURE OF 250 PSI MINIMUM, WITH A MINIMUM SAFETY FACTOR OF 2.1, AND SHALL BE EBA IRON, INC. MEGALUG OR APPROVED EQUAL. JOINT RESTRAINTS SHALL BE PROVIDED AT A MINIMUM OF THREE JOINTS (60 FEET) FROM ANY FITTING.
- WHENEVER IT IS NECESSARY, IN THE INTEREST OF SAFETY, TO BRACE THE SIDES OF A TRENCH, THE CONTRACTOR SHALL FURNISH PUT IN PLACE AND MAINTAIN SUCH SHEETING OR BRACING AS MAY BE NECESSARY TO SUPPORT THE SIDES OF THE EXCAVATION TO ENSURE PERSONNEL SAFETY, AND TO PREVENT MOVEMENT WHICH CAN IN ANY WAY DAMAGE THE WORK OR ENDANGER ADJACENT STRUCTURES. THE CONTRACTOR SHALL BE SOLELY RESPONSIBLE FOR THE SEQUENCE, METHODS AND MEANS OF CONSTRUCTION, AND FOR THE IMPLEMENTATION OF ALL OSHA AND OTHER SAFETY REQUIREMENTS.

ISSUED: 03/01/09/04	DEPARTMENT OF PUBLIC UTILITIES STANDARD DETAIL	REVISED: 06/08/2014
DRAWN: EAM	WATER NOTES	DRAWING NO. W-02
APPROVED: JAA		

THE ENGINEER AND UTILITY SHALL INSPECT INSIDE OF MANHOLE AFTER EACH APPLICATION OF COAT OF PAINT.

UPON COMPLETION OF THE WORK A LAMPING INSPECTION SHALL BE MADE OF THE COMPLETED SYSTEM ALONG WITH AN INFILTRATION AND / OR EXFILTRATION TEST. AFTER ALL TESTING INCLUDED IN THIS CONTRACT HAS BEEN COMPLETED, THE CONTRACTOR WILL PROVIDE A TELEVIEWED INSPECTION OF THE SEWER LINES PRIOR TO BEING ACCEPTED FOR USE AND A SECOND TELEVIEWED INSPECTION AND LAMPING PRIOR TO RELEASE OF ONE-YEAR MAINTENANCE BOND.

MANHOLE JOINTS WILL BE SEALED WITH RAMNEK OR APPROVED EQUAL AND ANTI-HYDRAULIC CEMENT INSIDE AND OUT.

ALL SANITARY SEWER GRAVITY MAINS AND SERVICES SHALL BE BEDDED AND BACKFILLED PER STANDARD TRENCH DETAIL.

ALL WORKMANSHIP AND MATERIAL SHALL CONFORM TO THE REQUIREMENTS OF THE GOVERNING AUTHORITY.

A MINIMUM OF 10-FOOT HORIZONTAL CLEARANCE IS REQUIRED BETWEEN ALL UTILITY PIPE AND BUILDING STRUCTURES, UNLESS OTHERWISE SHOWN ON THE PLANS.

LANDSCAPING SHALL NOT BE INSTALLED WITHIN A MINIMUM OF 6' OF ALL SANITARY SEWER MAINS AND LATERALS.

ALL SEWER LATERALS SHALL TERMINATE AT THE PROPERTY LINE AND / OR A MINIMUM OF 5' FROM BUILDING, UNLESS OTHERWISE SPECIFIED ON THE PLANS. APPROVED BY THE UTILITY. PICK TYPE LIFTING HOLES IN OR OUT OF PAVEMENT SHALL BE INSTALLED BY THE CONTRACTOR.

SERVICE LATERALS SHALL HAVE CLEANOUTS INSTALLED AT A MAXIMUM OF 75' SPACING. CLEANOUTS IN PAVEMENT SHALL HAVE TRAFFIC BEARING LIDS.

CONTRACTOR SHALL BE RESPONSIBLE TO COMPLETELY INSPECT THE EXISTING SANITARY SEWER SYSTEM AND / OR LIFT STATION, IF APPLICABLE, IN ADVANCE OF ANY WORK AND NOTIFY THE ENGINEER IN ADVANCE OF ANY DEFICIENCIES. SHOULD THE CONTRACTOR COMMENCE WORK WITHOUT FIRST INSPECTING THE EXISTING SANITARY SEWER SYSTEM AND / OR LIFT STATION, THEN THE CONTRACTOR IS RESPONSIBLE FOR ALL REPAIRS.

CONTRACTOR SHALL BE RESPONSIBLE FOR THE EXISTING ON-SITE SANITARY SEWER SYSTEM PAVING, FINISH GRADE, AND WATER MAINS. THE CONTRACTOR AND APPROVAL BY THE GOVERNING AUTHORITY, CONTRACTOR TO INCLUDE THE COST OF CLEANING, REPAIRING, AND TESTING EXISTING SEWER MAINS AND LATERALS AS REQUIRED FOR NEW CONSTRUCTION.

WATER NOTES:	
1.	NEW OR RELOCATED UNDERGROUND WATER MAINS INCLUDED IN THIS PROJECT THAT WILL CROSS ANY EXISTING OR PROPOSED GRAVITY OR VACUUM-TYPE SANITARY SEWER OR STORM SEWER WILL BE LAID SO THE OUTSIDE OF THE WATER MAIN IS AT LEAST SIX INCHES ABOVE THE OTHER PIPELINE OR AT LEAST 12 INCHES BELOW THE OTHER PIPELINE.
2.	NEW OR RELOCATED UNDERGROUND WATER MAINS INCLUDED IN THIS PROJECT THAT WILL CROSS ANY EXISTING OR PROPOSED PRESSURE-TYPE SANITARY SEWER, WASTEWATER OR STORM WATER FORCE MAIN, OR PIPELINE CONVEYING RECLAIMED WATER WILL BE LAID SO THE OUTSIDE OF THE WATER MAIN IS AT LEAST 12 INCHES ABOVE OR BELOW THE OTHER PIPELINE. (FAC 62-555.314(2), EXCEPTIONS ALLOWED UNDER FAC 62-555.314(5)).
3.	AT ALL UTILITY CROSSINGS DESCRIBED ABOVE, ONE FULL LENGTH OF WATER MAIN PIPE WILL BE CENTERED ABOVE OR BELOW THE OTHER PIPELINE SO THE WATER MAIN JOINTS WILL BE AS FAR AS POSSIBLE FROM THE OTHER PIPELINE, OR THE PIPES WILL BE AT LEAST 30 FEET FROM ALL JOINTS IN VACUUM-TYPE SANITARY SEWERS, STORM SEWERS, STORM WATER FORCE MAINS, OR PIPELINES CONVEYING RECLAIMED WATER REGULATED UNDER PART II OF CHAPTER 62-610, F.A.C. AND AT LEAST SIX FEET FROM ALL JOINTS IN GRAVITY OR PRESSURE-TYPE SANITARY SEWERS. WASTEWATER FORCE MAINS OR PIPELINES CONVEYING RECLAIMED WATER NOT REGULATED UNDER PART II OF CHAPTER 62-610, F.A.C. (FAC 62-555.314(2), EXCEPTIONS ALLOWED UNDER FAC 62-555.314(5

WATER MAIN SEPARATION IN ACCORDANCE WITH F.A.C. RULE 62-555.314

OTHER PIPE	HORIZONTAL SEPARATION	CROSSING (1), (4)	JOINT SPACING @ CROSSING (FULL JOINT CENTERED) (8)
STORM SEWER, STORM WATER FORCE MAIN, RECLAIMED WATER (2)	 3 ft minimum	 3 ft minimum	 3 ft minimum
GRAVITY SANITARY SEWER (3)	 10 ft preferred 6 ft minimum	 10 ft preferred 6 ft minimum	 10 ft preferred 6 ft minimum
ON-SITE SEWAGE TREATMENT & DISPOSAL SYSTEM	30 ft minimum		

1. WATER MAIN SHOULD CROSS ABOVE OTHER PIPE, WHEN WATER MAIN MUST BE BELOW OTHER PIPE, THE MINIMUM SEPARATION IS 12 INCHES.

2. RECLAIMED WATER REGULATED UNDER PART III OF CHAPTER 62-502, F.A.C.

3. TOP OF THE GRAVITY SANITARY SEWER.

4. 18" VERTICAL MINIMUM SEPARATION REQUIRED BY CITY OF HOLLYWOOD, UNLESS OTHERWISE APPROVED.

5. A MINIMUM 6 FOOT HORIZONTAL SEPARATION SHALL BE MAINTAINED BETWEEN ANY TYPE OF SEWER AND WATER MAIN IN CASES WHERE IT IS NOT POSSIBLE TO MAINTAIN A 10 FOOT HORIZONTAL SEPARATION, THE WATER MAIN MUST BE LAID IN A SEPARATE TRENCH OR ON AN UNDISTURBED EARTH SHELF LOCATED ON ONE SIDE OF THE SEWER OR FORCE MAIN AT SUCH AN ELEVATION THAT THE BOTTOM OF THE WATER MAIN IS AT LEAST 18 INCHES ABOVE THE TOP OF THE SEWER.

6. IN A SEPARATE TRENCH OR ON AN UNDISTURBED EARTH SHELF LOCATED ON ONE SIDE OF THE SEWER OR FORCE MAIN, THE WATER MAIN SHALL BE CONSTRUCTED OF DIP AND THE SANITARY SEWER OR FORCE MAIN SHALL BE CONSTRUCTED OF DIP WITH A MINIMUM VERTICAL SEPARATION OF 6 INCHES. THE WATER MAIN SHOULD ALWAYS BE ABOVE THE SEWER JOINTS ON THE WATER MAIN SHALL BE LOCATED AS FAR APART AS POSSIBLE FROM JOINTS ON THE SEWER OR FORCE MAIN (STAGGERED JOINTS).

8. ALL JOINTS ON THE WATER MAIN WITHIN 20 FEET OF THE CROSSING MUST BE MECHANICALLY RESTRAINED.

ISSUED: 03/01/1994
DRAWN: EAM
APPROVED: XXX

DEPARTMENT OF PUBLIC UTILITIES STANDARD DETAIL
SEPARATION REQUIREMENTS
OF
F.D.E.P. / F.D.N.R.P.

REVISED: 06/08/2014
DRAWING NO.
G-01.1

METER BY CITY
VALVE
UNION
BACKFLOW PREVENTER (RPZA OR DCDA)
VALVE
FLOW
FILLING ASSEMBLY FITTINGS AND EQUIPMENT SHALL BE 2" MAX.
DETAIL "A"

CORPORATION STOP
EXIST. WATER MAIN
GATE VALVE
CONNECTION TO BE COMPLETED AFTER SATISFACTORY TEST RESULTS HAVE BEEN OBTAINED
NEW WATER MAIN INSTALLED WITH PLUG & THRUST BLOCK
METHOD "A"

C.I. SCREW TYPE VALVE BOX
THRUST BLOCK
EXIST. OR NEW TEE
EXIST. OR NEW GATE VALVE
NEW GATE VALVE
NEW WATER MAIN
LIMITS OF TEST
METHOD "B"

NOTE:
REMOVE TEMPORARY CONNECTION AT CORPORATION STOP ON NEW MAIN AFTER FILLING & FLUSHING HAS BEEN COMPLETED.

ISSUED: 03/01/1994
DRAWN: EAM
APPROVED: XXX

DEPARTMENT OF PUBLIC UTILITIES STANDARD DETAIL
FILLING AND FLUSHING DETAILS

REVISED: 06/08/2014
DRAWING NO.
W-15

TESTING AND DISINFECTION NOTES:

1. NO CONNECTIONS TO THE EXISTING LINES SHALL BE MADE UNTIL THE PRESSURE AND BACTERIOLOGICAL TESTS HAVE BEEN PERFORMED ON THE PROPOSED WATER MAINS AND THE SYSTEM HAS BEEN APPROVED BY THE CITY OF HOLLYWOOD AND THE BROWARD COUNTY HEALTH DEPARTMENT.

2. THE PRESSURE TEST SHALL BE PERFORMED FOR 2 HOURS AT A CONSTANT PRESSURE OF 150 PSI AND IN ACCORDANCE WITH RULE 62-555.330 (FAC) C600 AWWA LATEST REVISION, EXCEPT AS OTHERWISE SPECIFIED HEREIN AND IN SPECIFICATION SECTION 15995, "PIPELINE TESTING AND DISINFECTION". PRESSURE TEST SHALL BE WITNESSED BY THE CITY OF HOLLYWOOD. THE ALLOWABLE LEAKAGE SHALL BE LESS THAN THE NUMBER OF GALLONS PER HOUR AS DETERMINED BY THE FORMULA:

$$L = \frac{S \times D \times \sqrt{P}}{148,000}$$

L = THE ALLOWABLE LEAKAGE IN GALLONS PER HOUR.
S = THE LENGTH OF PIPE BEING TESTED.
D = THE NOMINAL DIAMETER OF THE PIPE BEING TESTED.
P = THE AVERAGE TEST PRESSURE IN POUNDS PER SQUARE INCH.

3. THE COMPLETE LENGTH OF THE PROPOSED WATER MAIN SHALL BE TESTED, IN LENGTHS NOT TO EXCEED 2,000 FEET PER TEST.

4. PROPOSED WATER MAINS SHALL BE DISINFECTED IN ACCORDANCE WITH THE LATEST EDITION OF ANSI/AWWA STANDARD C651 AND BACTERIOLOGICAL TESTED FOR TWO CONSECUTIVE DAYS IN ACCORDANCE WITH SPECIFICATION SECTION 15995, "PIPELINE TESTING AND DISINFECTION".

5. BACTERIOLOGICAL TESTS SHALL BE REQUESTED AND PAID FOR BY THE CONTRACTOR.

6. THE CONTRACTOR SHALL DIRECTLY HIRE A TESTING LABORATORY CERTIFIED BY THE FLORIDA DEPARTMENT OF HEALTH IN ORDER TO COLLECT AND TEST WATER SAMPLES FROM THE WATER DISTRIBUTION SYSTEM TO BE PLACED INTO SERVICE. SAMPLE COLLECTION AND BACTERIOLOGICAL ANALYSES SHALL BE PERFORMED IN ACCORDANCE WITH RULES 62-555.315(6), 62-555.340 AND 62-555.330 (FAC), AS WELL AS ALL REQUIREMENTS OF THE BROWARD COUNTY HEALTH DEPARTMENT PERMIT.

7. THE WATER DISTRIBUTION SYSTEM SHALL NOT BE CONSIDERED COMPLETE AND READY FOR FINAL INSPECTION UNTIL SUCCESSFUL TEST RESULTS ARE OBTAINED FOR ALL TESTS DESCRIBED ABOVE.

ISSUED: 03/01/1994
DRAWN: EAM
APPROVED: XXX

DEPARTMENT OF PUBLIC UTILITIES STANDARD DETAIL
TESTING AND DISINFECTION NOTES

REVISED: 06/08/2014
DRAWING NO.
W-14

HORIZONTAL BENDS			
PIPE DIA. (INCHES)	BEND (ANGLE)	RESTRAINED LENGTH (RL) (FT)	
		PVC	*DIP
16	11 1/2	-	-
	22 1/2	-	-
	45	-	-
	90	-	-
8	11 1/2	-	-
	22 1/2	-	-
	45	-	-
	90	-	-
6	11 1/2	-	-
	22 1/2	-	-
	45	-	-
	90	-	-
4	11 1/2	-	-
	22 1/2	-	-
	45	-	-
	90	-	-

RESTRAINT LENGTH (RL)
BEND ANGLE
TYPICAL MECHANICAL JOINT RESTRAINT (SEE NOTE 3 ON STANDARD DETAIL G-10)

MIN. RESTRAINED LENGTH ALONG RUN (MRL)
MIN. RESTRAINED LENGTH ALONG BRANCH (RL)
BRANCH DIA.
RUN DIA.
TYPICAL MECHANICAL JOINT RESTRAINT (SEE NOTE 3 ON STANDARD DETAIL G-10)

TEES AND TAPPING SLEEVES				
RUN DIA. (INCHES)	BRANCH DIA. (INCHES)	MIN. RESTRAINED LENGTH ALONG RUN (FT.)	MIN. LENGTH TO RESTRAIN ALONG BRANCH (FT.)	
			PVC	*DIP
16"	16"	-	-	-
8"	8"	-	-	-
8"	6"	-	-	-
8"	4"	-	-	-
6"	6"	-	-	-
4"	4"	-	-	-

ISSUED: 03/01/1994
DRAWN: EAM
APPROVED: XXX

DEPARTMENT OF PUBLIC UTILITIES STANDARD DETAIL
JOINT RESTRAINT DESIGN
FOR PVC AND DIP
HORIZONTAL BENDS AND TEES

REVISED: 06/08/2014
DRAWING NO.
G-11.1

1" COPPER TUBING
1" G.V.
180° BEND
12" MIN.
GRADE
30" MIN. FOR D.I.P.
36" MIN. FOR P.V.C.
CORP. STOP (TO BE CLOSED AND PLUGGED AFTER TEST APPROVAL)
PROPOSED WATER MAIN
DOUBLE STRAP SERVICE SADDLE

NOTES:
SAMPLING POINT SHALL NOT BE REMOVED UNTIL APPROVAL IS OBTAINED FROM BROWARD COUNTY HEALTH DEPARTMENT.

ISSUED: 03/01/1994
DRAWN: EAM
APPROVED: XXX

DEPARTMENT OF PUBLIC UTILITIES STANDARD DETAIL
SAMPLING POINT DETAIL

REVISED: 06/08/2014
DRAWING NO.
W-16

REVISIONS:

1.	
2.	
3.	
4.	
5.	
6.	
7.	
8.	

CLIENT:

Kaller Architects
2417 Hollywood Boulevard
Hollywood, Florida 33020-6605
(954) 920-5746

PROJECT:

Chabad Ocean Jewish Center
HOLLYWOOD
FLORIDA



TASK:
CONSTRUCTION DETAILS

GGB Engineering, Inc.
CIVIL AND FORENSIC ENGINEERS • LAND PLANNERS
• CONSTRUCTION MANAGERS
FLORIDA REGISTRATION NO. 8118
2699 Stirling Road, Suite C-202
Fort Lauderdale, Florida 33312
Phone: (954) 986-9899
Fax: (954) 986-8655

DATE:
Nov. 2018
DESIGNED BY:
G.C.B.
PROJECT NO.
18-1107
SHEET
C-5

SCALE:
N.T.S.
DRAWN BY:
F.M.

GARY G. BLOOM, P.E.
FLA. LIC. NO. 79832
NOT VALID UNLESS SIGNED
AND SEALED BY ENGINEER

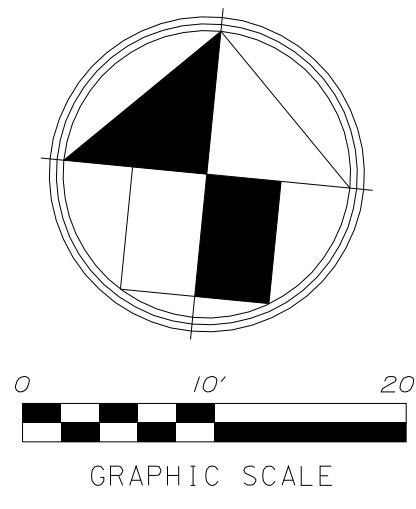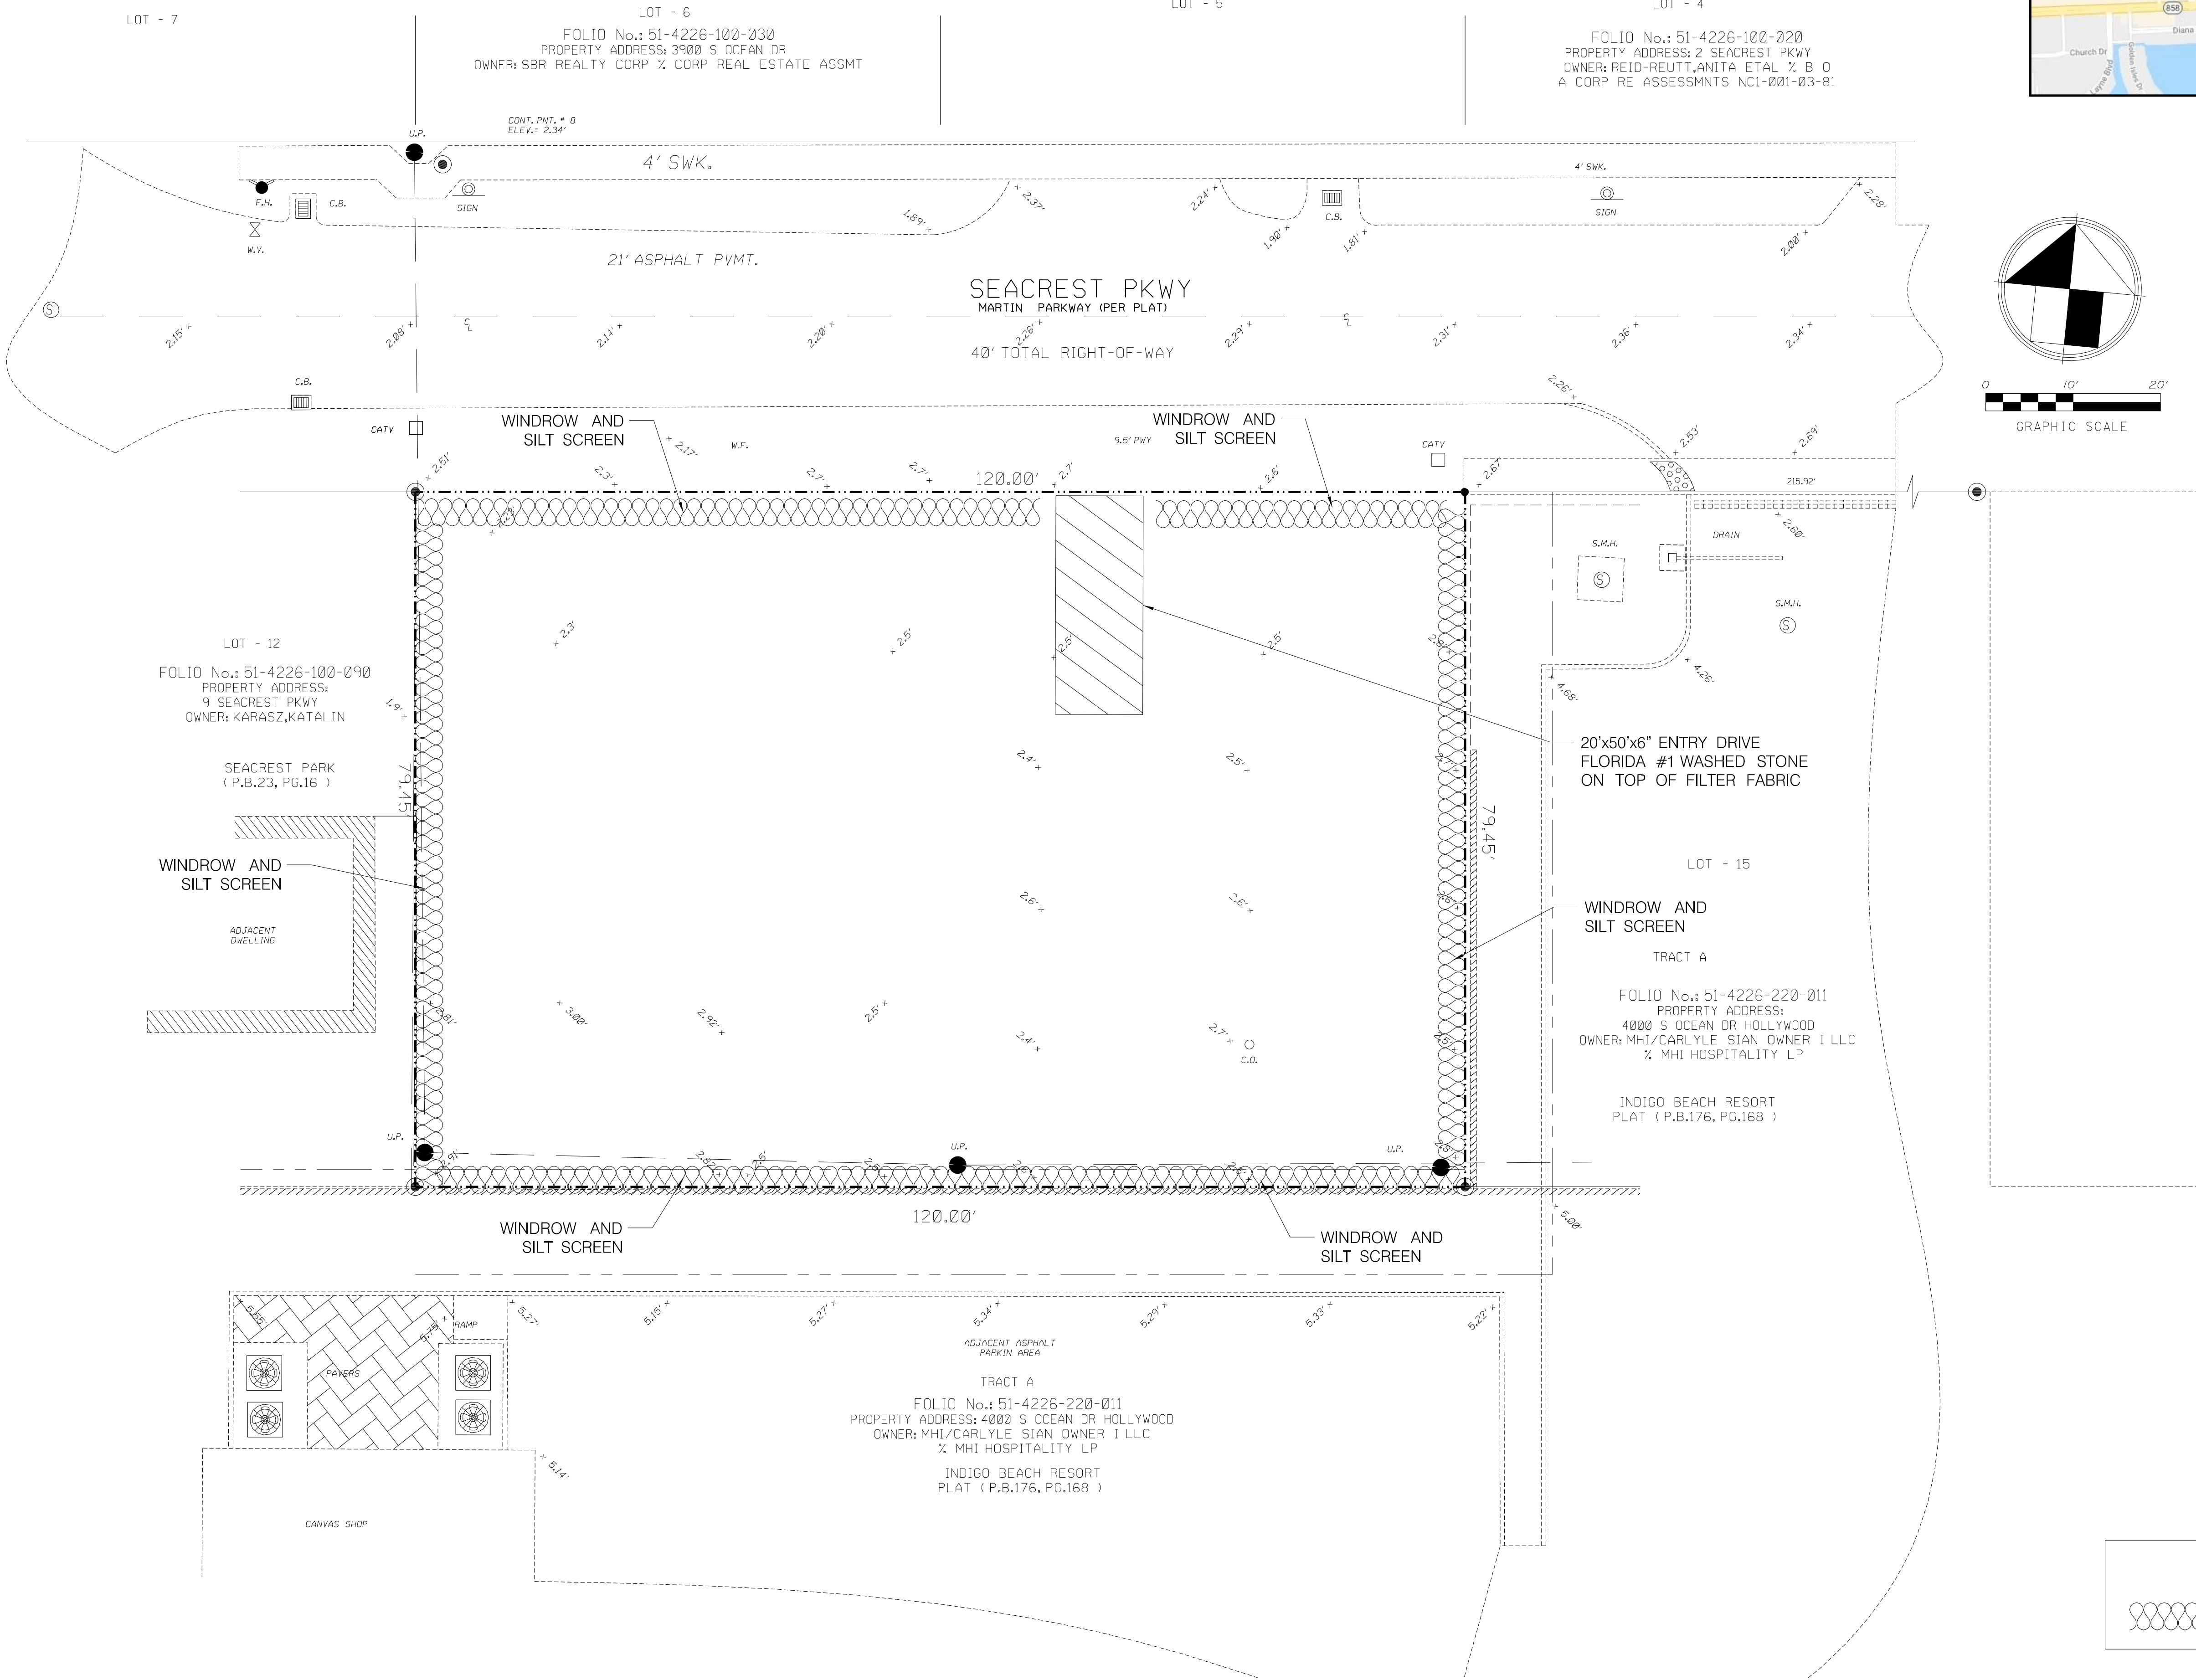

LEGEND

DENOTES WINDROW AND SILT SCREEN
ALONG PROPERTY LINE DURING
CONSTRUCTION OF GRADING AND DRAINAGE

REVISIONS:	
1.	
2.	
3.	
4.	
5.	
6.	
7.	
8.	

CLIENT:	Kaller Architects 2417 Hollywood Boulevard Hollywood, Florida 33020-6605 (954) 920-5746	

PROJECT:	Chabad Ocean Jewish Center	FLORIDA
	HOLLYWOOD	FLORIDA

TASK:	STORMWATER POLLUTION PREVENTION PLAN
-------	---

GGB Engineering, Inc.
CIVIL AND FORENSIC ENGINEERS • LAND PLANNERS
• CONSTRUCTION MANAGERS
FLORIDA REGISTRATION No. 8118
2699 Stirling Road, Suite C-202
Fort Lauderdale, Florida 33312
Phone: (954) 986-9899
Fax: (954) 986-8655

DATE:	Nov. 2018	SCALE:	1"=10'
DESIGNED BY:	G.C.B.	DRAWN BY:	F.M.
PROJECT NO. 18-1107			
SHEET C-6			


GARY G. BLOOM, P.E.
FLA. LIC. No. 19832
NOT VALID UNLESS SIGNED
AND SEALED BY ENGINEER



- | | |
|---|---|
| 1. Turbidity barriers are to be used in permanent bodies of water regardless of water depth. | <p>Note:
Turbidity barriers for flowing streams and tidal creeks may be either floating, or staked types or any combinations of types that will suit site conditions and meet erosion control and water quality requirements. The barrier type(s) will be at the Contractor's option unless otherwise specified in the plans; however, payment will be under the pay item(s) established in the plans for Floating Turbidity Barrier and/or</p> |
| 2. Number and spacing of anchors dependent on current velocities. | |
| 3. Deployment of barrier around pile locations may vary to accommodate construction operations. | |
| 4. Navigation may require segmenting barrier during construction operations. | |
| 5. For additional information see Section 104 of the Standard Specifications. | |

TURBIDITY BARRIER APPLICATIONS


TURBIDITY BARRIER DETAILS PER FDOT INDEX NO. 103

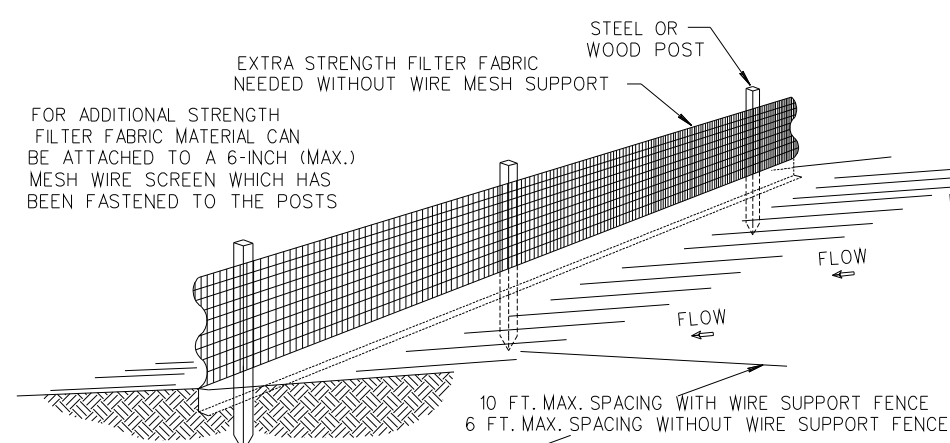


NOTES:

2. THE HEIGHT OF A SILT FENCE SHALL NOT EXCEED 36 INCHES (90 CM).
3. THE FILTER FABRIC SHALL BE PURCHASED IN A CONTINUOUS ROLL CUT TO THE LENGTH OF THE BARRIER TO AVOID USE OF JOINTS.
4. POSTS SHALL BE SPACED A MAXIMUM OF 10 FEET (3 M) APART AT THE BARRIER LOCATION. THE FILTER FABRIC SHALL BE FASTENED TO THE POSTS USING 1/2 INCHES (50 CM) WHEN EXTRA STRENGTH FABRIC IS USED WITHOUT THE WIRE SUPPORT FENCE, POST SPACING SHALL EXCEED 6 FEET (18 M).
5. A TRENCH SHALL BE LOCATED APPROXIMATELY 4 INCHES (10 CM) WIDE AND 4 INCHES (10 CM) DEEP ALONG THE LINE OF POSTS AND UPSLOPE FROM THE BARRIER.
6. WHEN STANDARD STRENGTH FILTER FABRIC IS USED, A WIRE MESH SUPPORT FENCE SHALL BE FASTENED SECURELY TO THE UPSLOPE SIDE OF THE POSTS USING HEAVY DUTY WIRE. THE WIRE SHALL BE FASTENED TO THE POSTS USING 1/2 INCHES (50 CM) WHEN EXTRA STRENGTH FABRIC IS USED WITHOUT THE WIRE SUPPORT FENCE, POST SPACING SHALL EXCEED 6 FEET (18 M) ABOVE THE ORIGINAL GROUND SURFACE.
7. THE STANDARD STRENGTH FABRIC SHALL BE EXTENDED INTO THE TRENCH TO THE TRENCH AND 8 INCHES (20 CM) OF THE FABRIC SHALL BE EXTENDED INTO THE TRENCH. THE FABRIC SHALL NOT EXTEND MORE THAN 36 INCHES (90 CM) ABOVE THE ORIGINAL GROUND SURFACE.
8. THE TRENCH SHALL BE BACKFILLED AND THE SOIL COMPACTED OVER THE FILTER FABRIC.
9. ALL PROJECTS REQUIRE SUBMITTAL OF POLLUTION PREVENTION PLAN (PPP).
10. ALL PROJECTS TAC OR MORE MUST SUBMIT NOTICE OF INTENT (NOI) TO DEEP.

SILT FENCE INSTALLATION DETAIL D 9.1a
Sheet 1 of 2

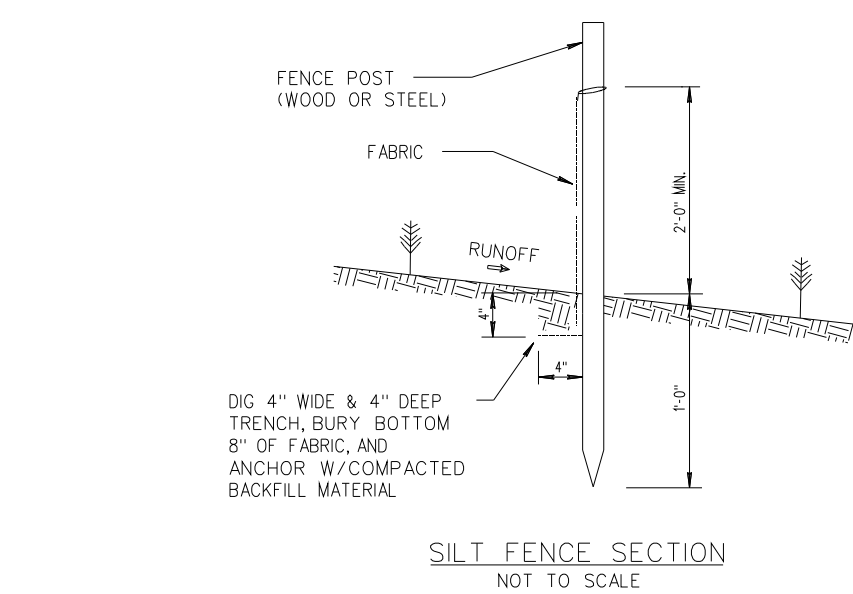


SILT FENCE SECTION
NOT TO SCALE

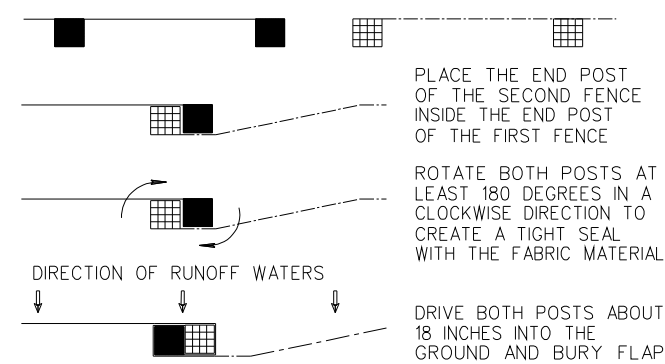


ATTACHING TWO SILT FENCES
NOT TO SCALE

SILT FENCE INSTALLATION DETAIL D 9.1b
Sheet 2 of 2

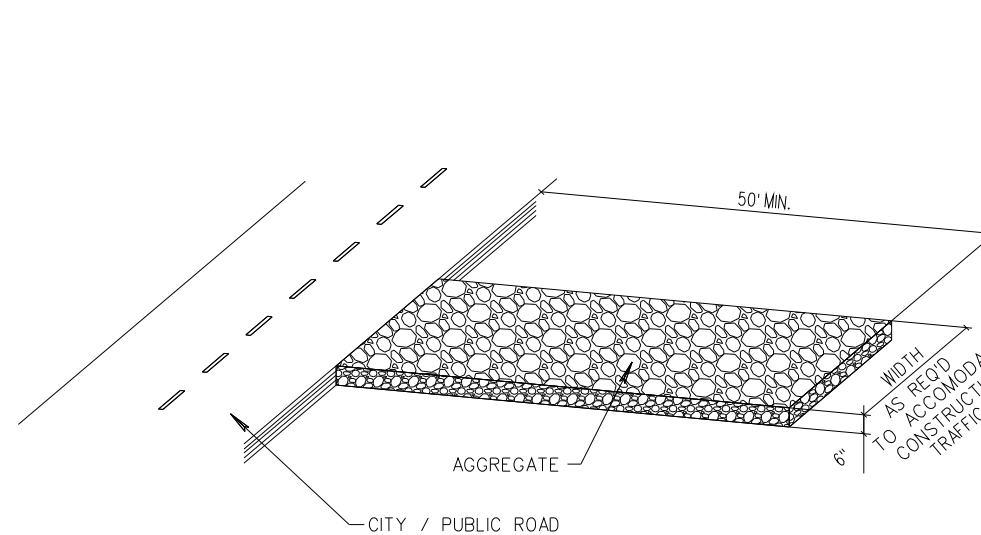

NOTE:
A CONSTRUCTION ENTRANCE SHALL BE
CONSTRUCTED AND CONTAIN AN AGGREGATE
LAYER (FDOT AGGREGATE NO.1), AT LEAST
6-INCHES THICK. IT MUST EXTEND TO THE
WIDTH OF THE VEHICULAR INGRESS AND
EGRESS AREA.

STABILIZED CONSTRUCTION ENTRANCE DETAIL D9.1C

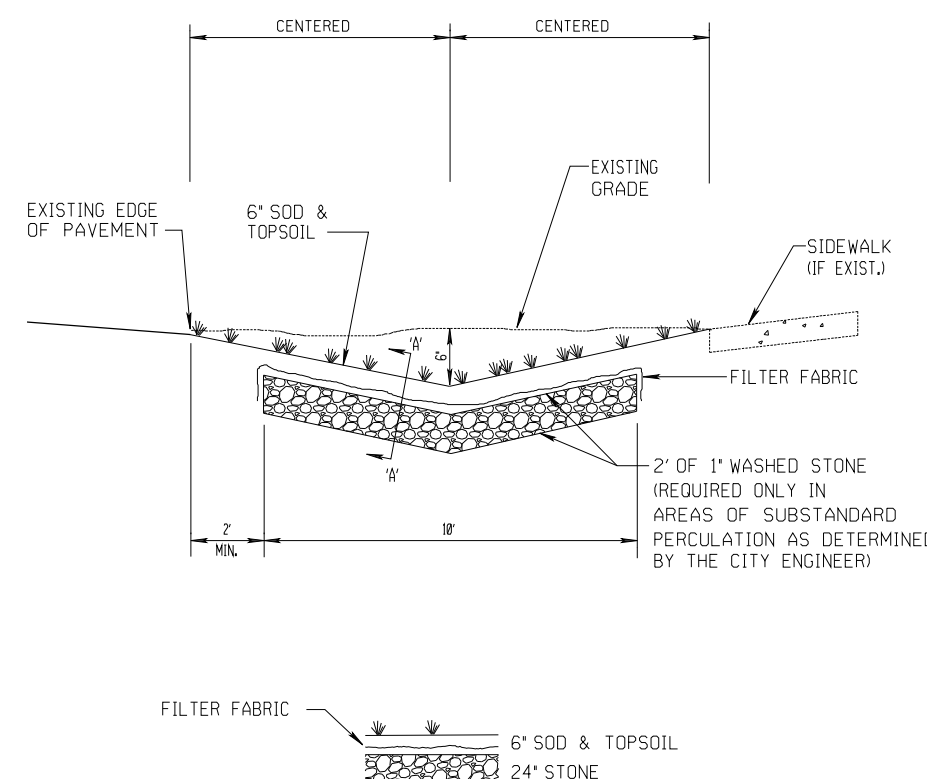

NOTE:

1. CONTRACTOR TO REPLACE ALL IRRIGATION, TREES & SHRUBBERY
IN SWALES DAMAGED DURING CONSTRUCTION.

SWALE REPLACEMENT DETAIL D10.1

[illegible][illegible]

NOTE TO CONTRACTOR:

THIS IS THE CONTRACTORS CERTIFICATION REQUIRED BY THE EPA'S NATIONAL POLLUTION DISCHARGE ELIMINATION SYSTEM (NPDES). STORM WATER POLLUTION PREVENTION PLAN FOR CONSTRUCTION SITES OVER 1 ACRES. THIS CERTIFICATION MUST BE COMPLETED WEEKLY AND AFTER EVERY RAINFALL EVENT OVER 0.25 INCHES. IT IS SUGGESTED THAT THIS SHEET BE REMOVED FROM THE PLAN SET AND DUPLICATED AS NEEDED BY THE CONTRACTOR.

PROJECT: _____

STORM WATER POLLUTION PREVENTION PLAN
REPEATED AND MAINTENANCE REPORT FORM

STRUCTURAL CONTROLS

DATE: _____

ONE OR BASIC	FIVE	10	IS ONE/SEVERAL STABILIZED?	IS THERE EVIDENCE OF REBOUND OR DETERIORATION

MAINTENANCE REQUIRED FOR EACH ONE/SEVERAL:

TO BE PERFORMED BY: _____, ON OR BEFORE: _____

EACH MAINTENANCE MUST/OBTAIN ALL FOREST CONTROLS:

FUNCTIONAL /OBTAIN	AND FORESTORY /OBTAIN /OBTAIN	AND FORESTORY /OBTAIN /OBTAIN	AND FORESTORY /OBTAIN /OBTAIN

MAINTENANCE REQUIRED FOR EACH MAINTENANCE MUST/OBTAIN ALL FOREST CONTROLS:

TO BE PERFORMED BY: _____, ON OR BEFORE: _____

PAGE 2 OF 4

PROJECT: _____

DOWN WATER POLLUTION PREVENTION PLAN
INSPECTOR AND MAINTENANCE REPORT FORM

CHARGES REQUIRED TO THE POLLUTION PREVENTION PLAN: _____

REASONS FOR CHARGES: _____

I CERTIFY UNDER PENALTY OF LAW THAT THIS DOCUMENT AND ALL
ATTACHMENTS AND PROVIDED HEREIN BY INSPECTOR OR SUPERVISOR IS
ACCORDING WITH A SYSTEM DESIGNED TO AVOID THE UNLAWFUL
DISCHARGE OF POLLUTANTS INTO ANY WATER OF THE STATE OF
MISSISSIPPI. I HAVE BEEN TRAINED IN THE PROPER USE OF THE SYSTEM AND
I HAVE BEEN ADVISED THAT VIOLATIONS OF THE SYSTEM ARE
PUNISHABLE BY THE SUPERVISOR. I AM HEREBY CERTIFYING THAT I AM
COMPLYING WITH THE BEST OF MY KNOWLEDGE AND BELIEF.
SIGNATURE OF INSPECTOR OR SUPERVISOR: _____
PRINTED NAME OF INSPECTOR OR SUPERVISOR: _____
PRINTED NAME OF SUBMITTING PARTY: _____
PRINTED NAME OF THE PROJECT OR THE PROJECTOR: _____

DATE: _____

DATE: _____

PAGE 4 OF 4

REVISIONS:

1. _____
2. _____
3. _____
4. _____
5. _____
6. _____
7. _____
8. _____

CLIENT:

PROJECT: **Chabad Ocean Jewish Center**

PROJECT:

GGB Engineering, Inc.

FORENSIC ENGINEERS • LAND PLANNERS
• CONSTRUCTION MANAGERS
FLORIDA REGISTRATION No. 8118

699 Stirling Road, Suite C-202
Fort Lauderdale, Florida 33312

DATE: Nov. 2018	SCALE: N.T.S.
DESIGNED BY: G.G.B.	DRAWN BY: F.M.

PROJECT NO.
18-1107

SHEET
C-7

GARY G. BLOOM, P.E.
FLA LIC. No. 19832
NOT VALID UNLESS SIGNED
AND SEALED BY ENGINEER