

**TOWN HOLLYWOOD**  
STIRLING ROAD EAST OF 95, HOLLYWOOD, FL

**PLANTING PLAN**

REVISIONS:


**OCTOBER 9, 2020**  
DATE



**MS., SOQ,**  
DRAWN BY:

**M.J.**  
APPROVED BY:


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**LP-7**

**S.P.A.**

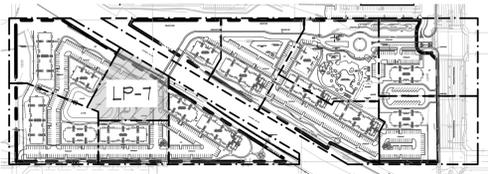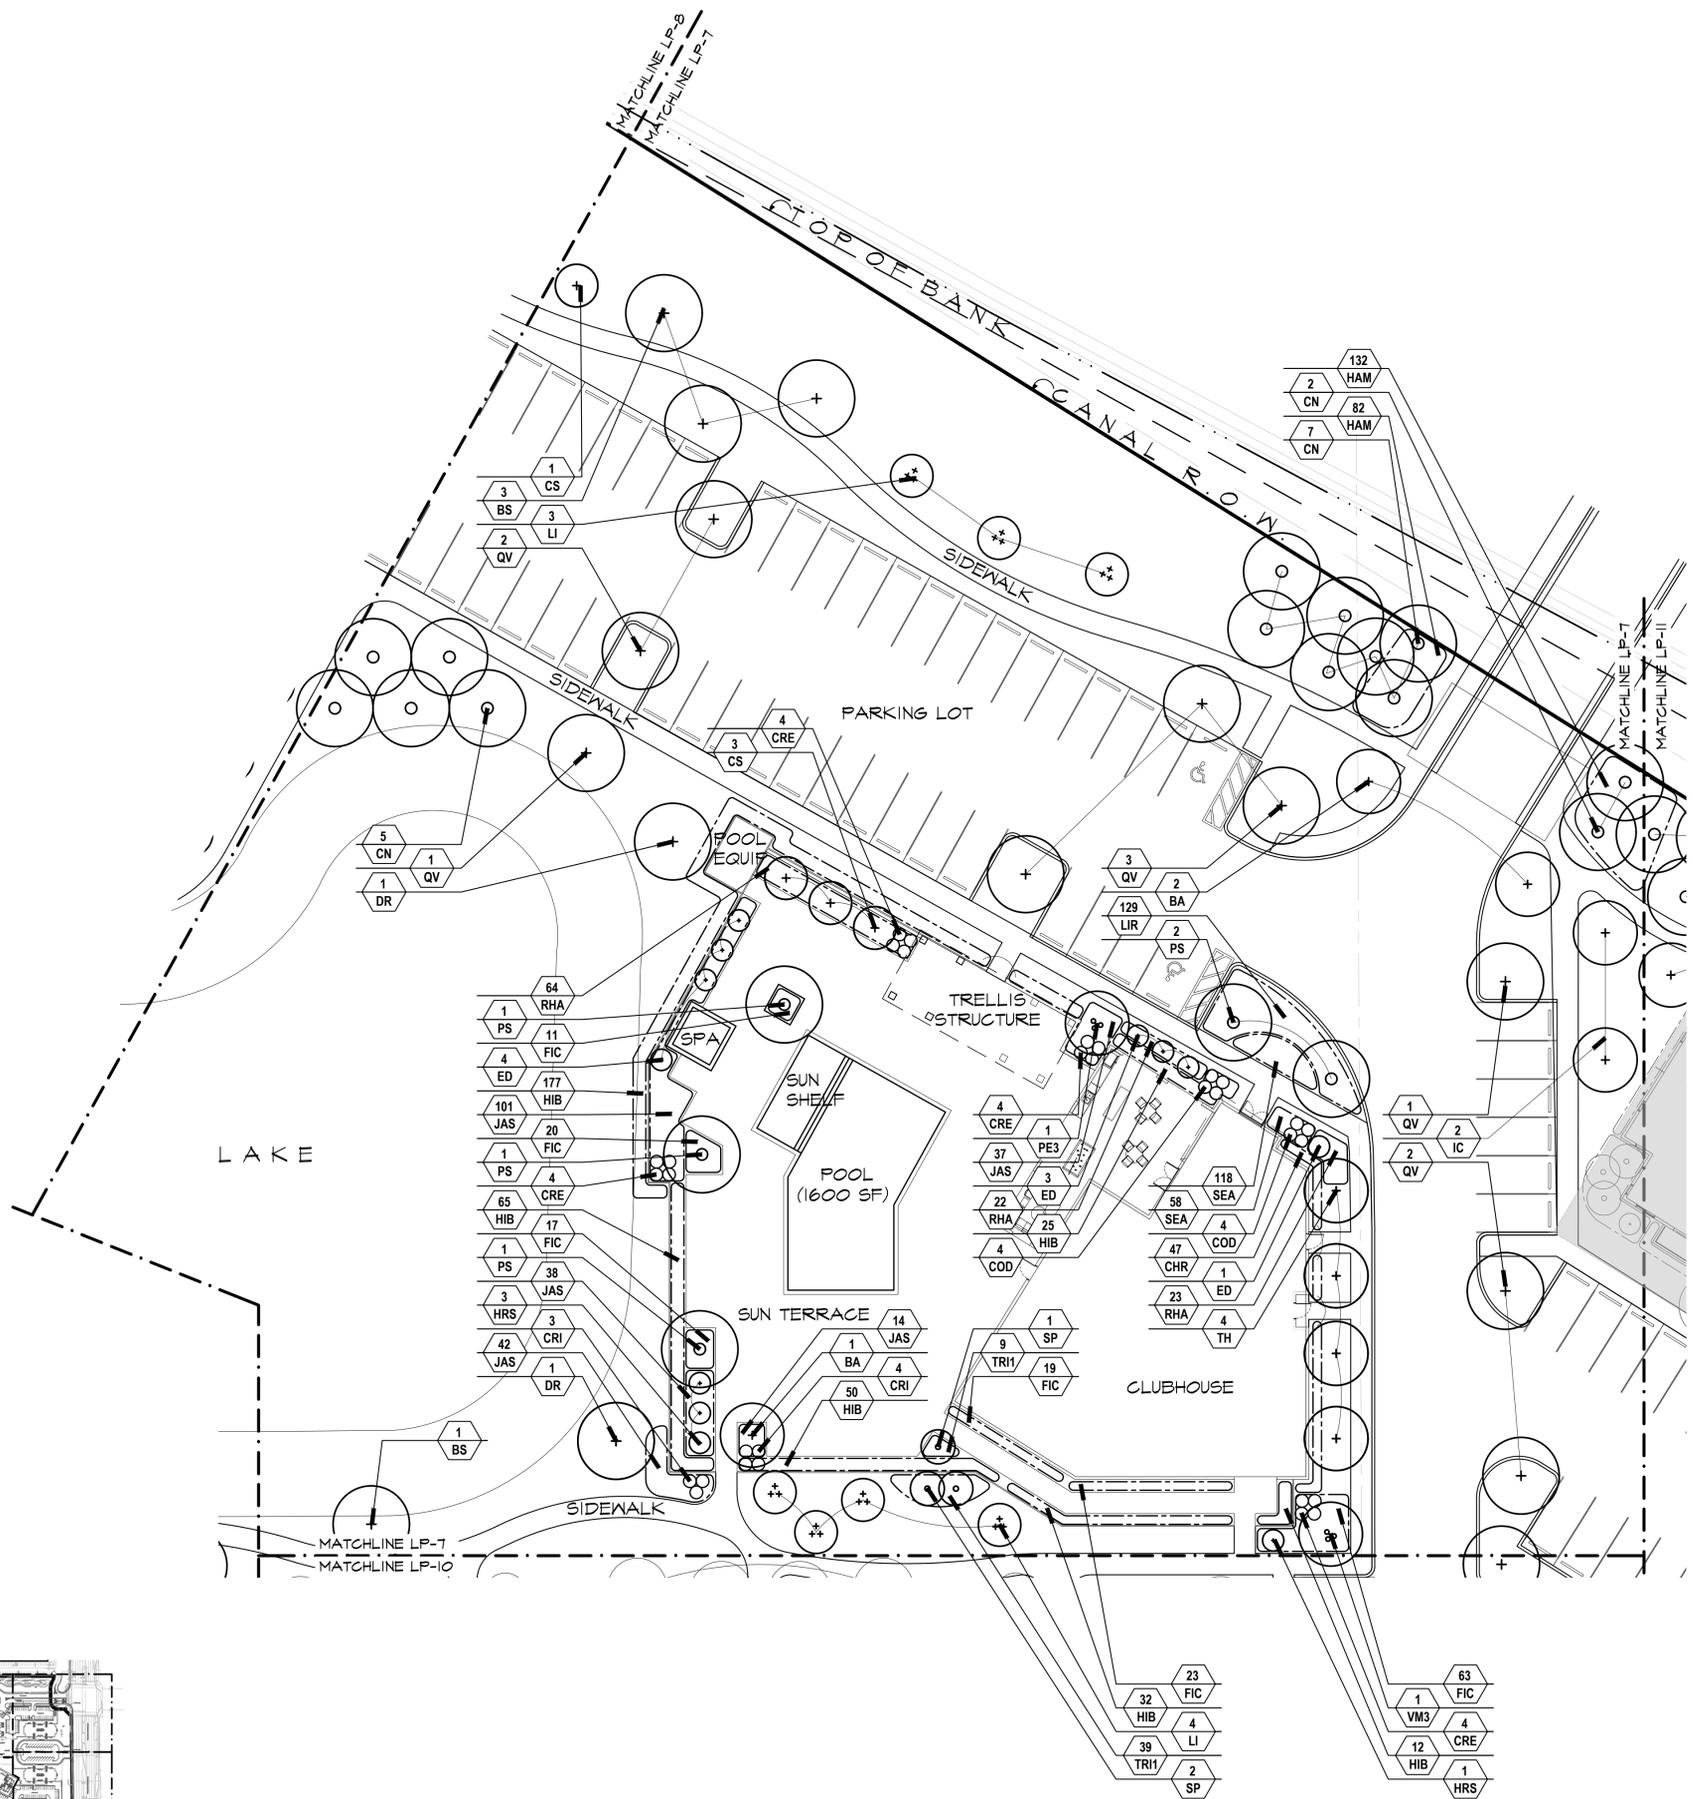

LOCATION MAP  
N.T.S.

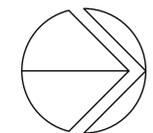

SCALE: 1"=20'





**DSBOCA**  
design studio boca

landscape architects  
and planners

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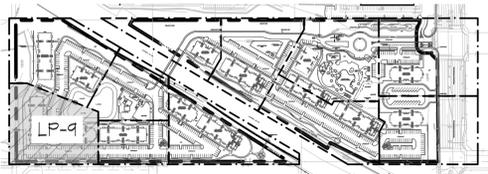
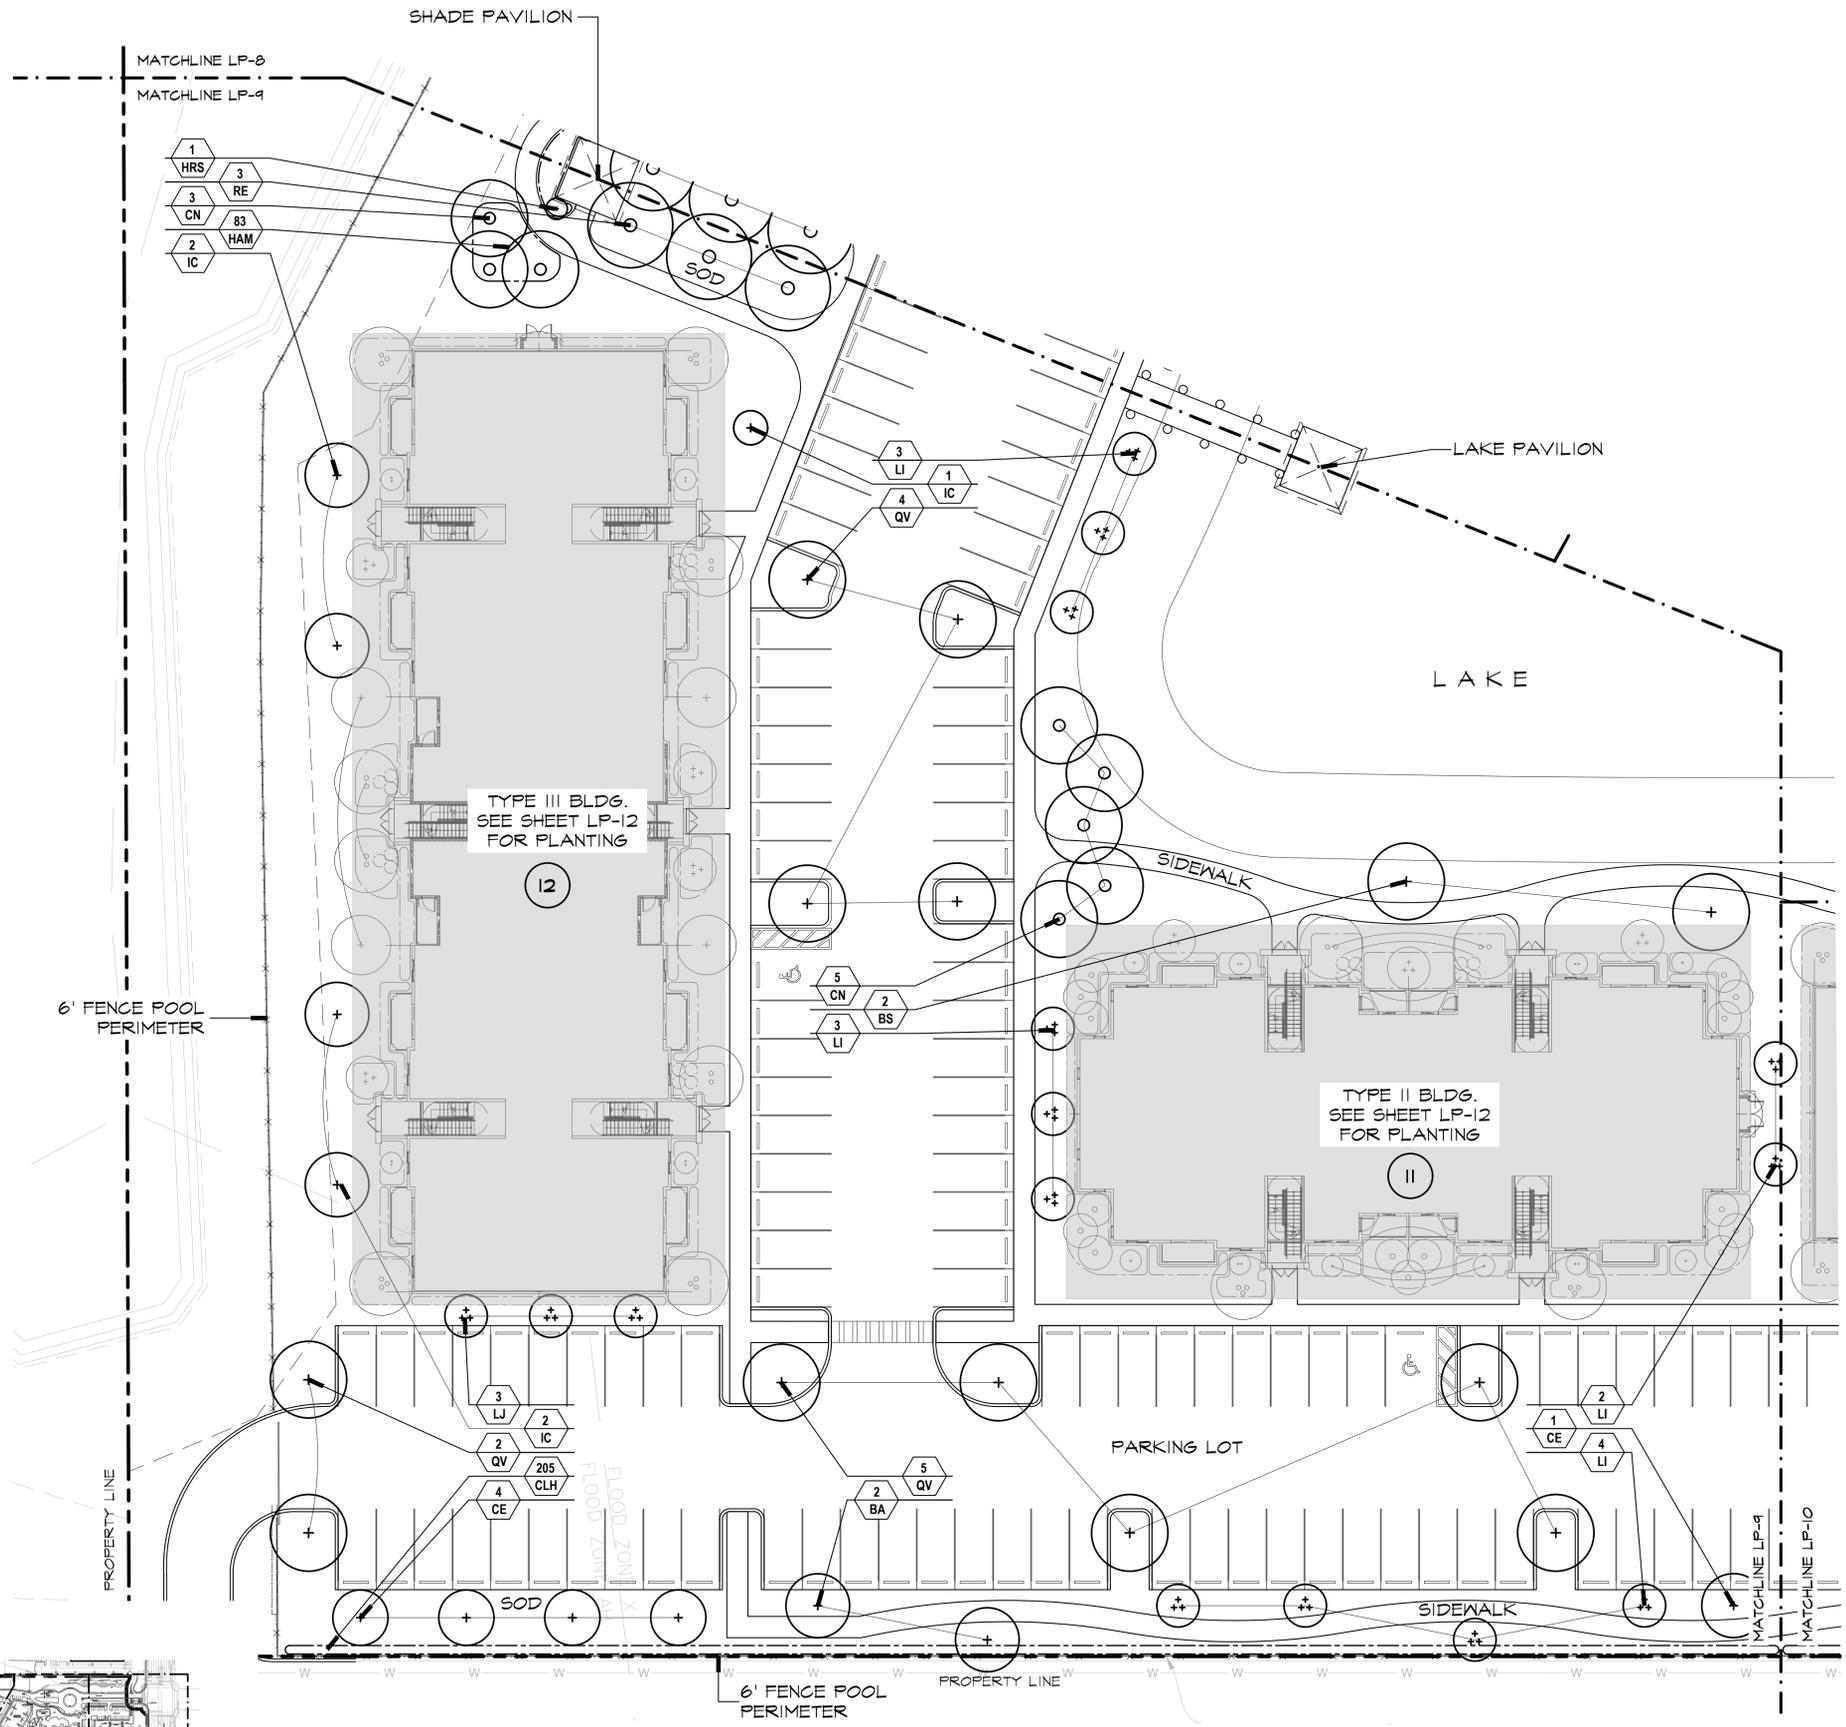
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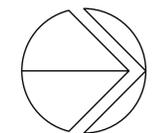
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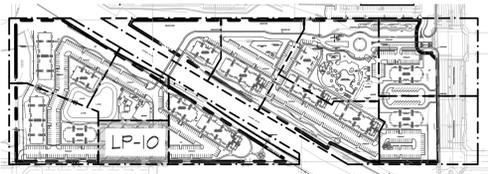
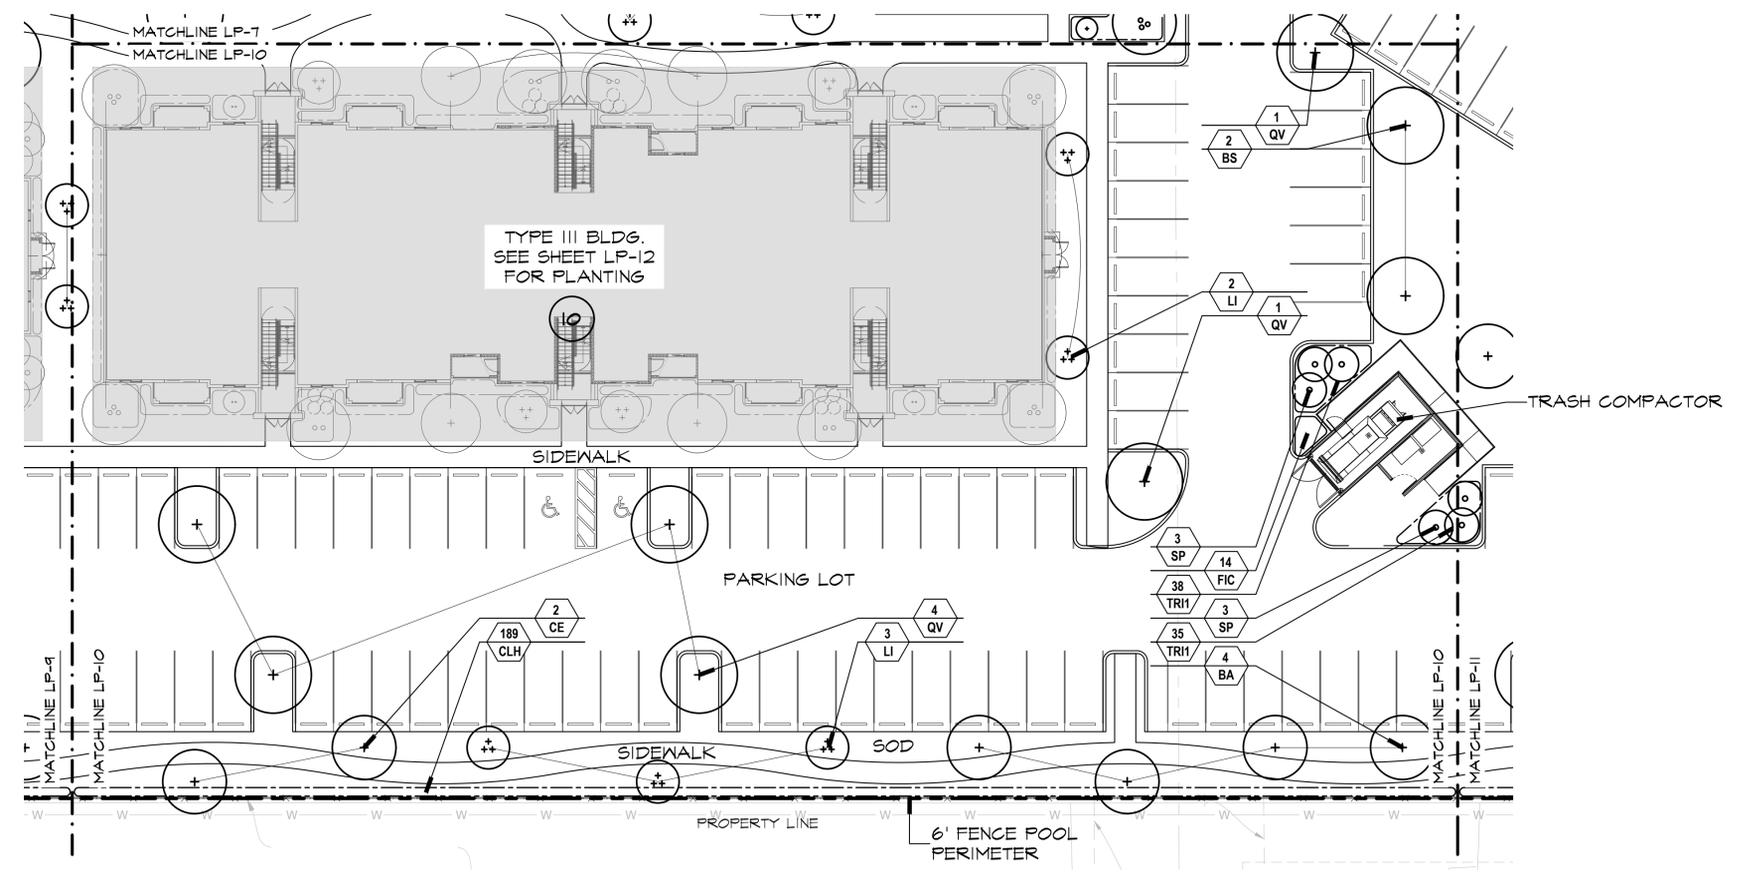
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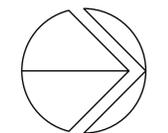


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SCALE: 1"=20'

**LP-10**



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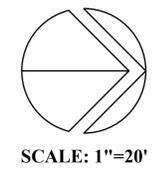
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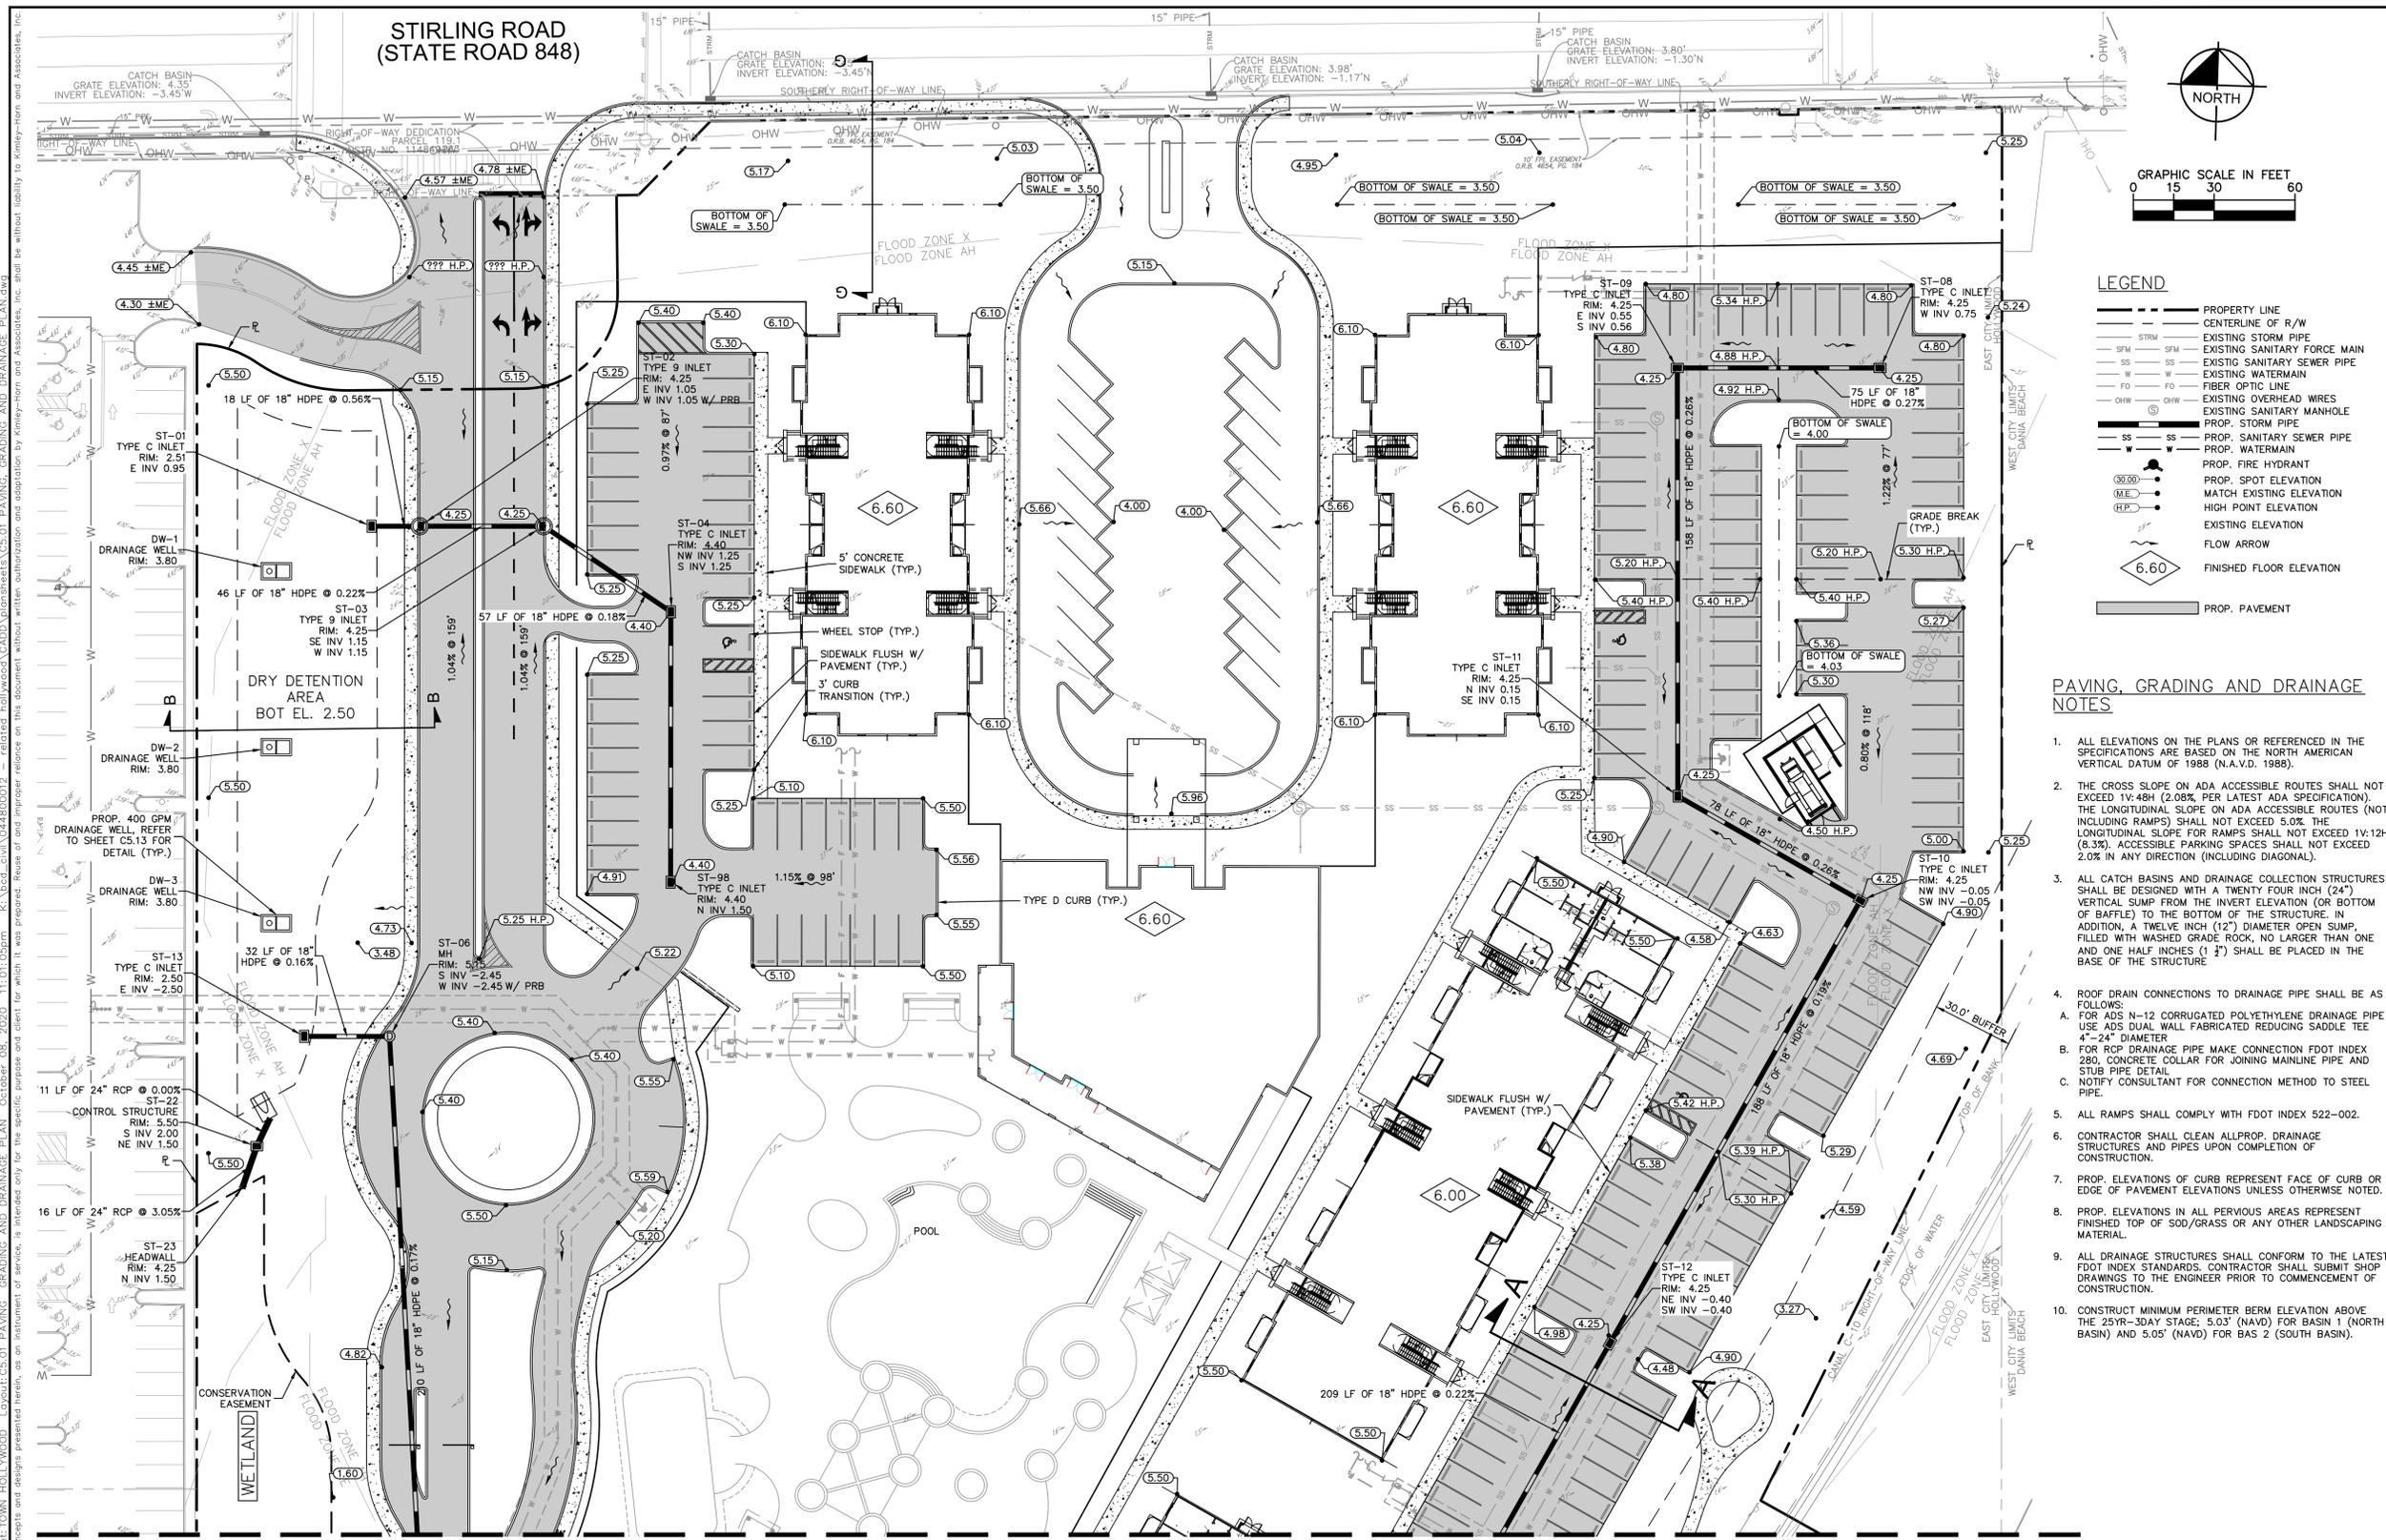

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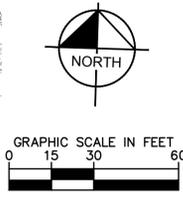


LOCATION MAP  
N.T.S.





PLOTTED BY: NHI - SHEET: ST-TOWN HOLLYWOOD - LAYOUT: C5.01 PAVING, GRADING AND DRAINAGE PLAN - OCTOBER 05, 2020 11:01:05pm - IK:\local\civ\044800012 - released hollywood\CADD\layouts\C5.01 PAVING, GRADING AND DRAINAGE PLAN.dwg  
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- LEGEND**
- PROPERTY LINE
  - CENTERLINE OF R/W
  - EXISTING STORM PIPE
  - EXISTING SANITARY FORCE MAIN
  - EXISTING SANITARY SEWER PIPE
  - EXISTING WATERMAIN
  - FIBER OPTIC LINE
  - EXISTING OVERHEAD WIRES
  - EXISTING SANITARY MANHOLE
  - PROP. STORM PIPE
  - PROP. SANITARY SEWER PIPE
  - PROP. WATERMAIN
  - PROP. FIRE HYDRANT
  - PROP. SPOT ELEVATION
  - MATCH EXISTING ELEVATION
  - HIGH POINT ELEVATION
  - EXISTING ELEVATION
  - FLOW ARROW
  - 6.60 FINISHED FLOOR ELEVATION
  - PROP. PAVEMENT

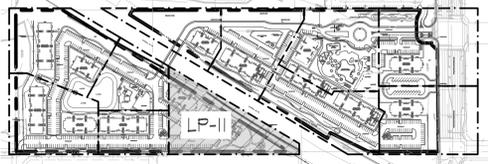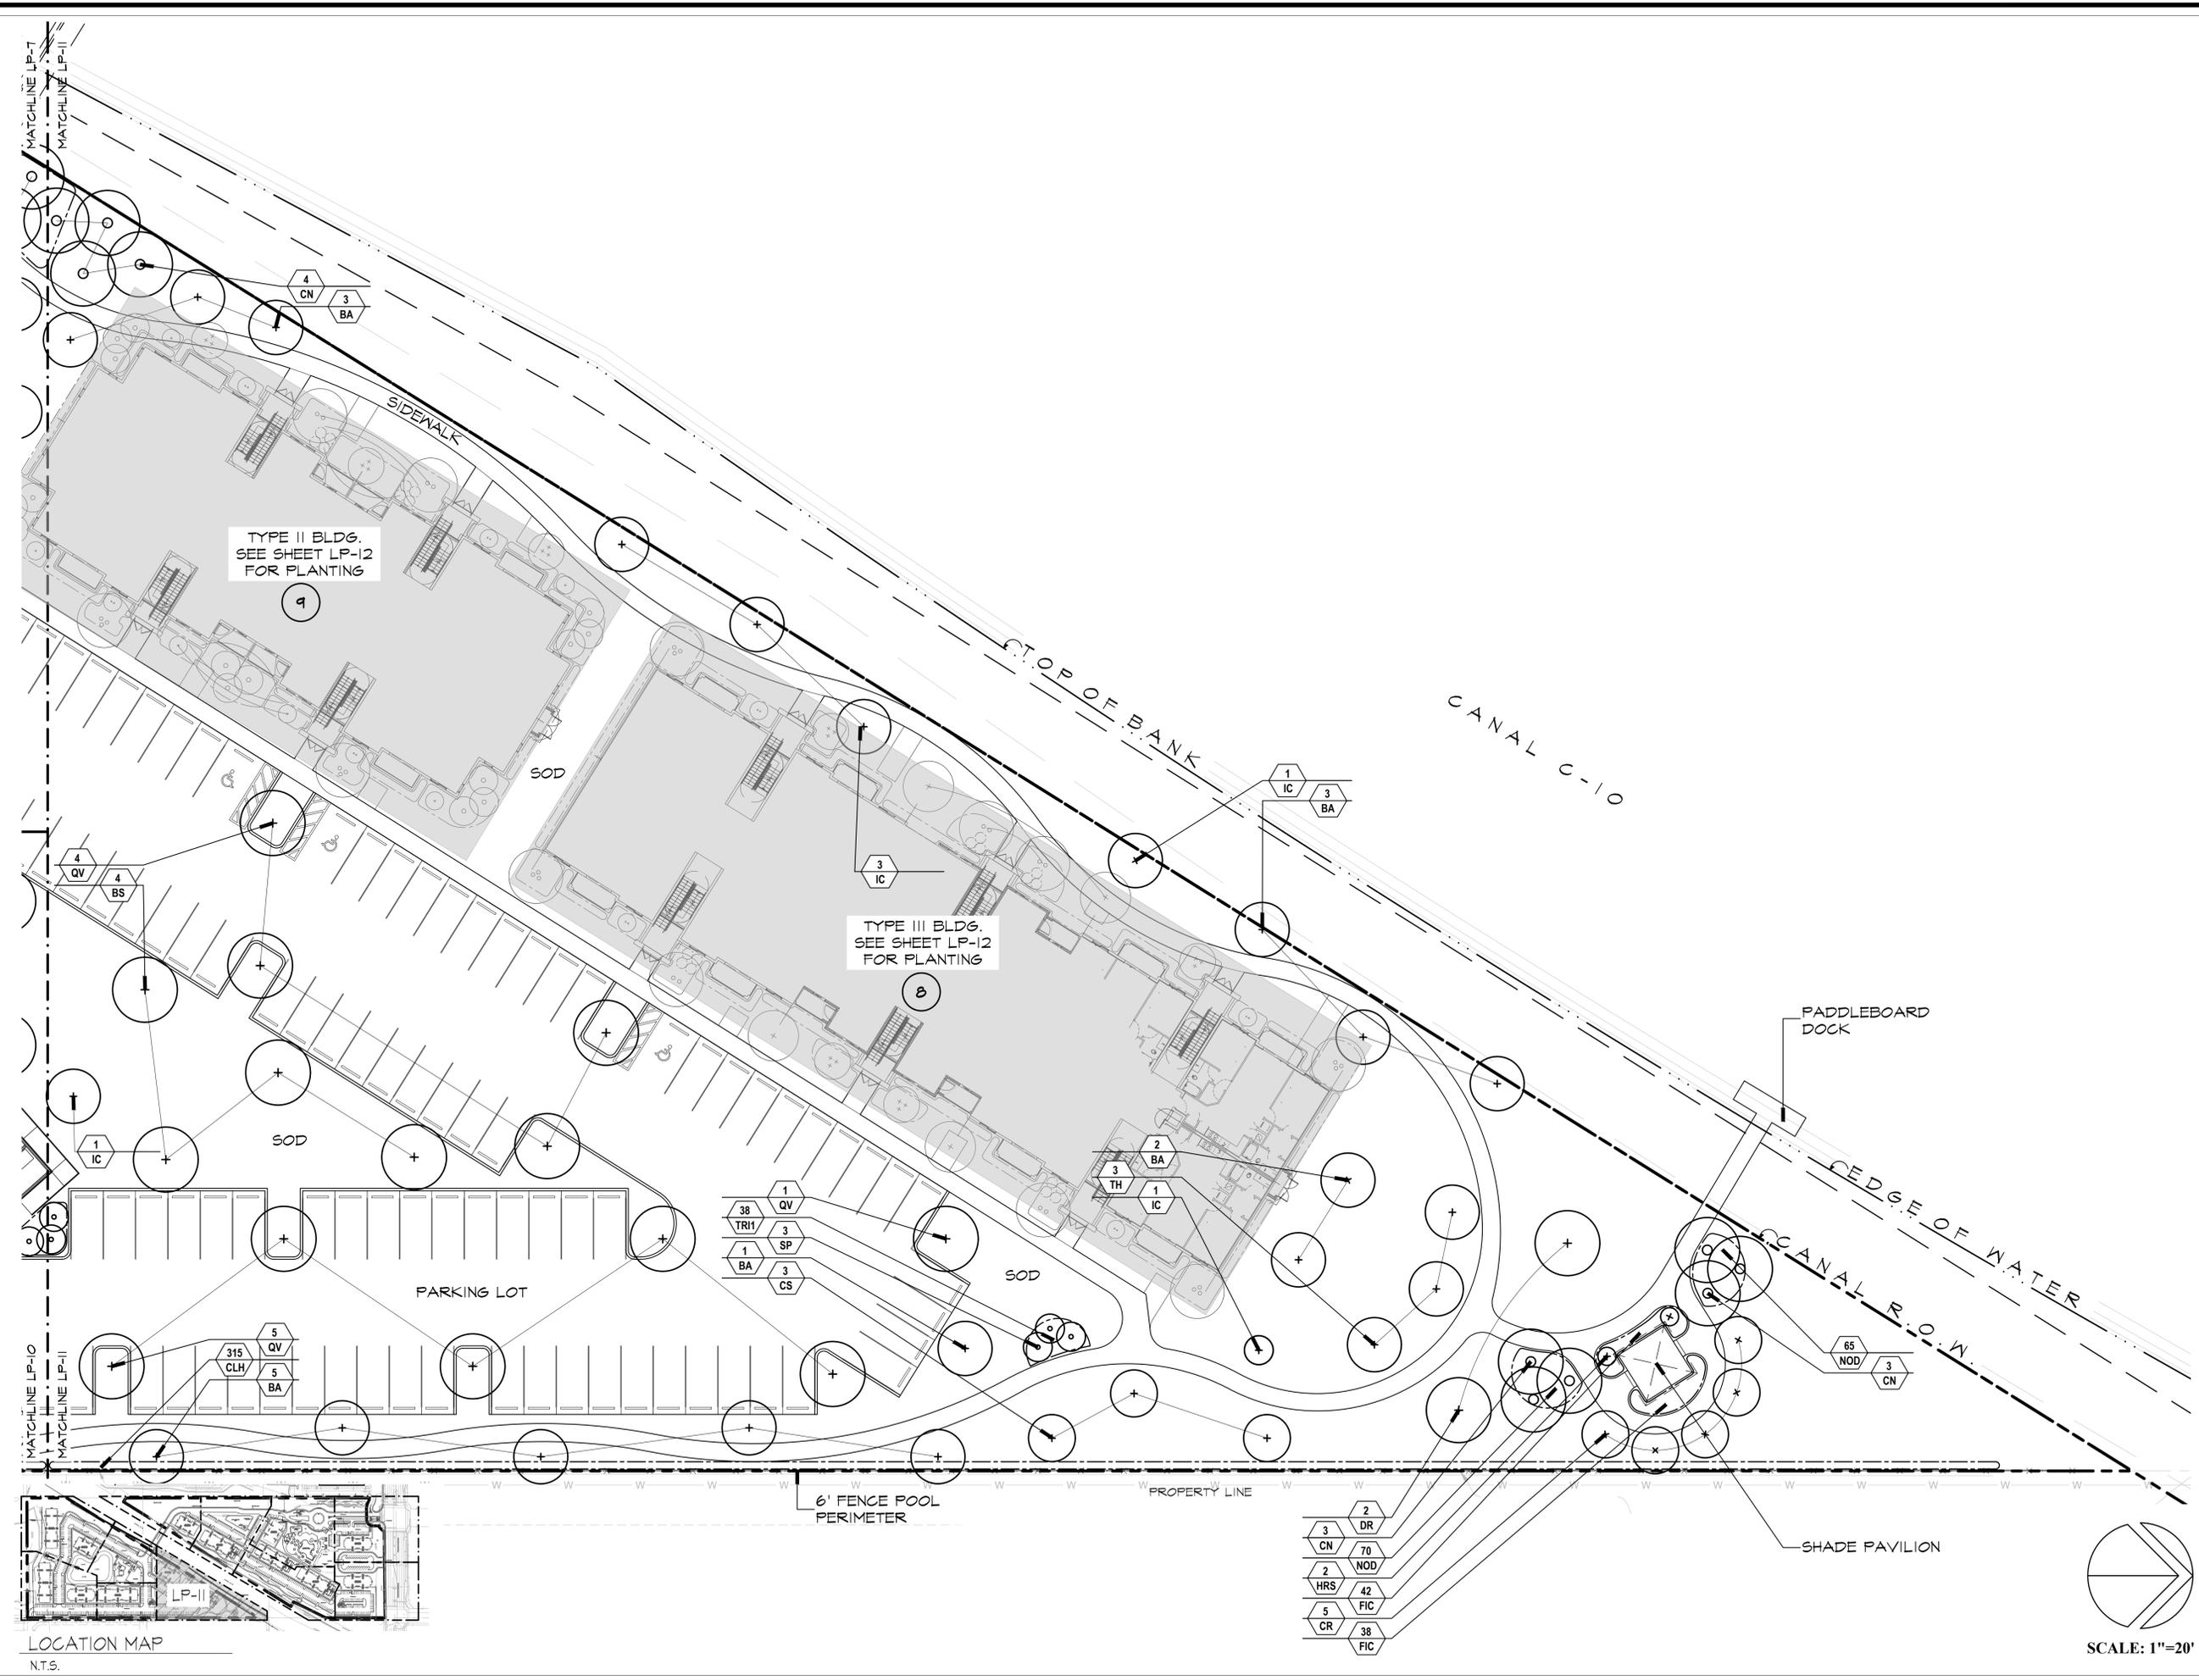**PAVING, GRADING AND DRAINAGE NOTES**

1. ALL ELEVATIONS ON THE PLANS OR REFERENCED IN THE SPECIFICATIONS ARE BASED ON THE NORTH AMERICAN VERTICAL DATUM OF 1988 (N.A.V.D. 1988).
2. THE CROSS SLOPE ON ADA ACCESSIBLE ROUTES SHALL NOT EXCEED 1:48 (2.08% PER LATEST ADA SPECIFICATION). THE LONGITUDINAL SLOPE ON ADA ACCESSIBLE ROUTES (NOT INCLUDING RAMPS) SHALL NOT EXCEED 5.0%. THE LONGITUDINAL SLOPE FOR RAMPS SHALL NOT EXCEED 1:12 (8.33%). ACCESSIBLE PARKING SPACES SHALL NOT EXCEED 2.0% IN ANY DIRECTION (INCLUDING DIAGONAL).
3. ALL CATCH BASINS AND DRAINAGE COLLECTION STRUCTURES SHALL BE DESIGNED WITH A TWENTY FOUR INCH (24") VERTICAL SUMP FROM THE INVERT ELEVATION (OR BOTTOM OF BAFFLE) TO THE BOTTOM OF THE STRUCTURE. IN ADDITION, A TWELVE INCH (12") DIAMETER OPEN SUMP, FILLED WITH WASHED GRADE ROCK, NO LARGER THAN ONE AND ONE HALF INCHES (1 1/2") SHALL BE PLACED IN THE BASE OF THE STRUCTURE.
4. ROOF DRAIN CONNECTIONS TO DRAINAGE PIPE SHALL BE AS FOLLOWS:
  - A. FOR ADS N-12 CORRUGATED POLYETHYLENE DRAINAGE PIPE USE ADS DUAL WALL FABRICATED REDUCING SADDLE TEE 4"-24" DIAMETER
  - B. FOR RCP DRAINAGE PIPE MAKE CONNECTION FDOT INDEX 280, CONCRETE COLLAR FOR JOINING MAINLINE PIPE AND STUB PIPE DETAIL
  - C. NOTIFY CONSULTANT FOR CONNECTION METHOD TO STEEL PIPE.
5. ALL RAMPS SHALL COMPLY WITH FDOT INDEX 522-002.
6. CONTRACTOR SHALL CLEAN ALL PROP. DRAINAGE STRUCTURES AND PIPES UPON COMPLETION OF CONSTRUCTION.
7. PROP. ELEVATIONS OF CURB REPRESENT FACE OF CURB OR EDGE OF PAVEMENT ELEVATIONS UNLESS OTHERWISE NOTED.
8. PROP. ELEVATIONS IN ALL PERVIOUS AREAS REPRESENT FINISHED TOP OF SOD/GRASS OR ANY OTHER LANDSCAPING MATERIAL.
9. ALL DRAINAGE STRUCTURES SHALL CONFORM TO THE LATEST FDOT INDEX STANDARDS. CONTRACTOR SHALL SUBMIT SHOP DRAWINGS TO THE ENGINEER PRIOR TO COMMENCEMENT OF CONSTRUCTION.
10. CONSTRUCT MINIMUM PERIMETER BERM ELEVATION ABOVE THE 25YR-30AY STAGE; 5.0' (NAVD) FOR BASIN 1 (NORTH BASIN) AND 5.05' (NAVD) FOR BAS 2 (SOUTH BASIN).

MATCH LINE - SEE SHEET C5.02

PLANS ARE IN NAVD 1988  
 DATUM CONVERSION EQUATION IS BELOW:  
 (NAVD 1988) + 1.608' = (NGVD 1929)

THE PRESENCE OF GROUNDWATER SHOULD BE ANTICIPATED ON THIS PROJECT. CONTRACTOR'S BID SHALL INCLUDE CONSIDERATION FOR ADDRESSING THIS ISSUE.

CALL 48 HOURS BEFORE YOU DIG

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 Call before you dig.

SUNSHINE STATE ONE CALL OF FLORIDA, INC.


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© 2015 KIMLEY-HORN AND ASSOCIATES, INC. 1615 S. CONGRESS AVE., SUITE 200, BOCA RATON, FL 33445 PHONE: 561-330-2345 FAX: 561-863-8175 WWW.KIMLEY-HORN.COM CA 00000696			
KHA PROJECT 044800012	LICENSED PROFESSIONAL MICHAEL D. SPRUCE, P.E.	DATE OCT. 2020	SCALE AS SHOWN
DESIGNED BY JVP	DRAWN BY AMC	FL LICENSE NUMBER 52776	CHECKED BY MDS
<b>PAVING, GRADING AND DRAINAGE PLAN</b>		TOWN HOLLYWOOD PREPARED FOR RD STIRLING, LLC	
SHEET NUMBER <b>C5.01</b>		CITY OF HOLLYWOOD FL	



MATCH LINE - SEE SHEET C5.02



MATCH LINE - SEE SHEET C5.04

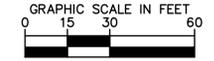

**LEGEND**

- PROPERTY LINE
- CENTERLINE OF R/W
- EXISTING STORM PIPE
- SFM --- EXISTING SANITARY FORCE MAIN
- SS --- EXISTING SANITARY SEWER PIPE
- W --- EXISTING WATERMAIN
- FO --- FIBER OPTIC LINE
- OHW --- EXISTING OVERHEAD WIRES
- S --- EXISTING SANITARY MANHOLE
- --- PROP. STORM PIPE
- SS --- PROP. SANITARY SEWER PIPE
- W --- PROP. WATERMAIN
- --- PROP. FIRE HYDRANT
- --- PROP. SPOT ELEVATION
- --- MATCH EXISTING ELEVATION
- --- HIGH POINT ELEVATION
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- 6.60 --- FINISHED FLOOR ELEVATION
- --- PROP. PAVEMENT

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10. CONSTRUCT MINIMUM PERIMETER BERM ELEVATION ABOVE THE 25YR-30AY STAGE; 5.0' (NAVD) FOR BASIN 1 (NORTH BASIN) AND 5.05' (NAVD) FOR BAS 2 (SOUTH BASIN).

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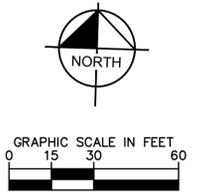
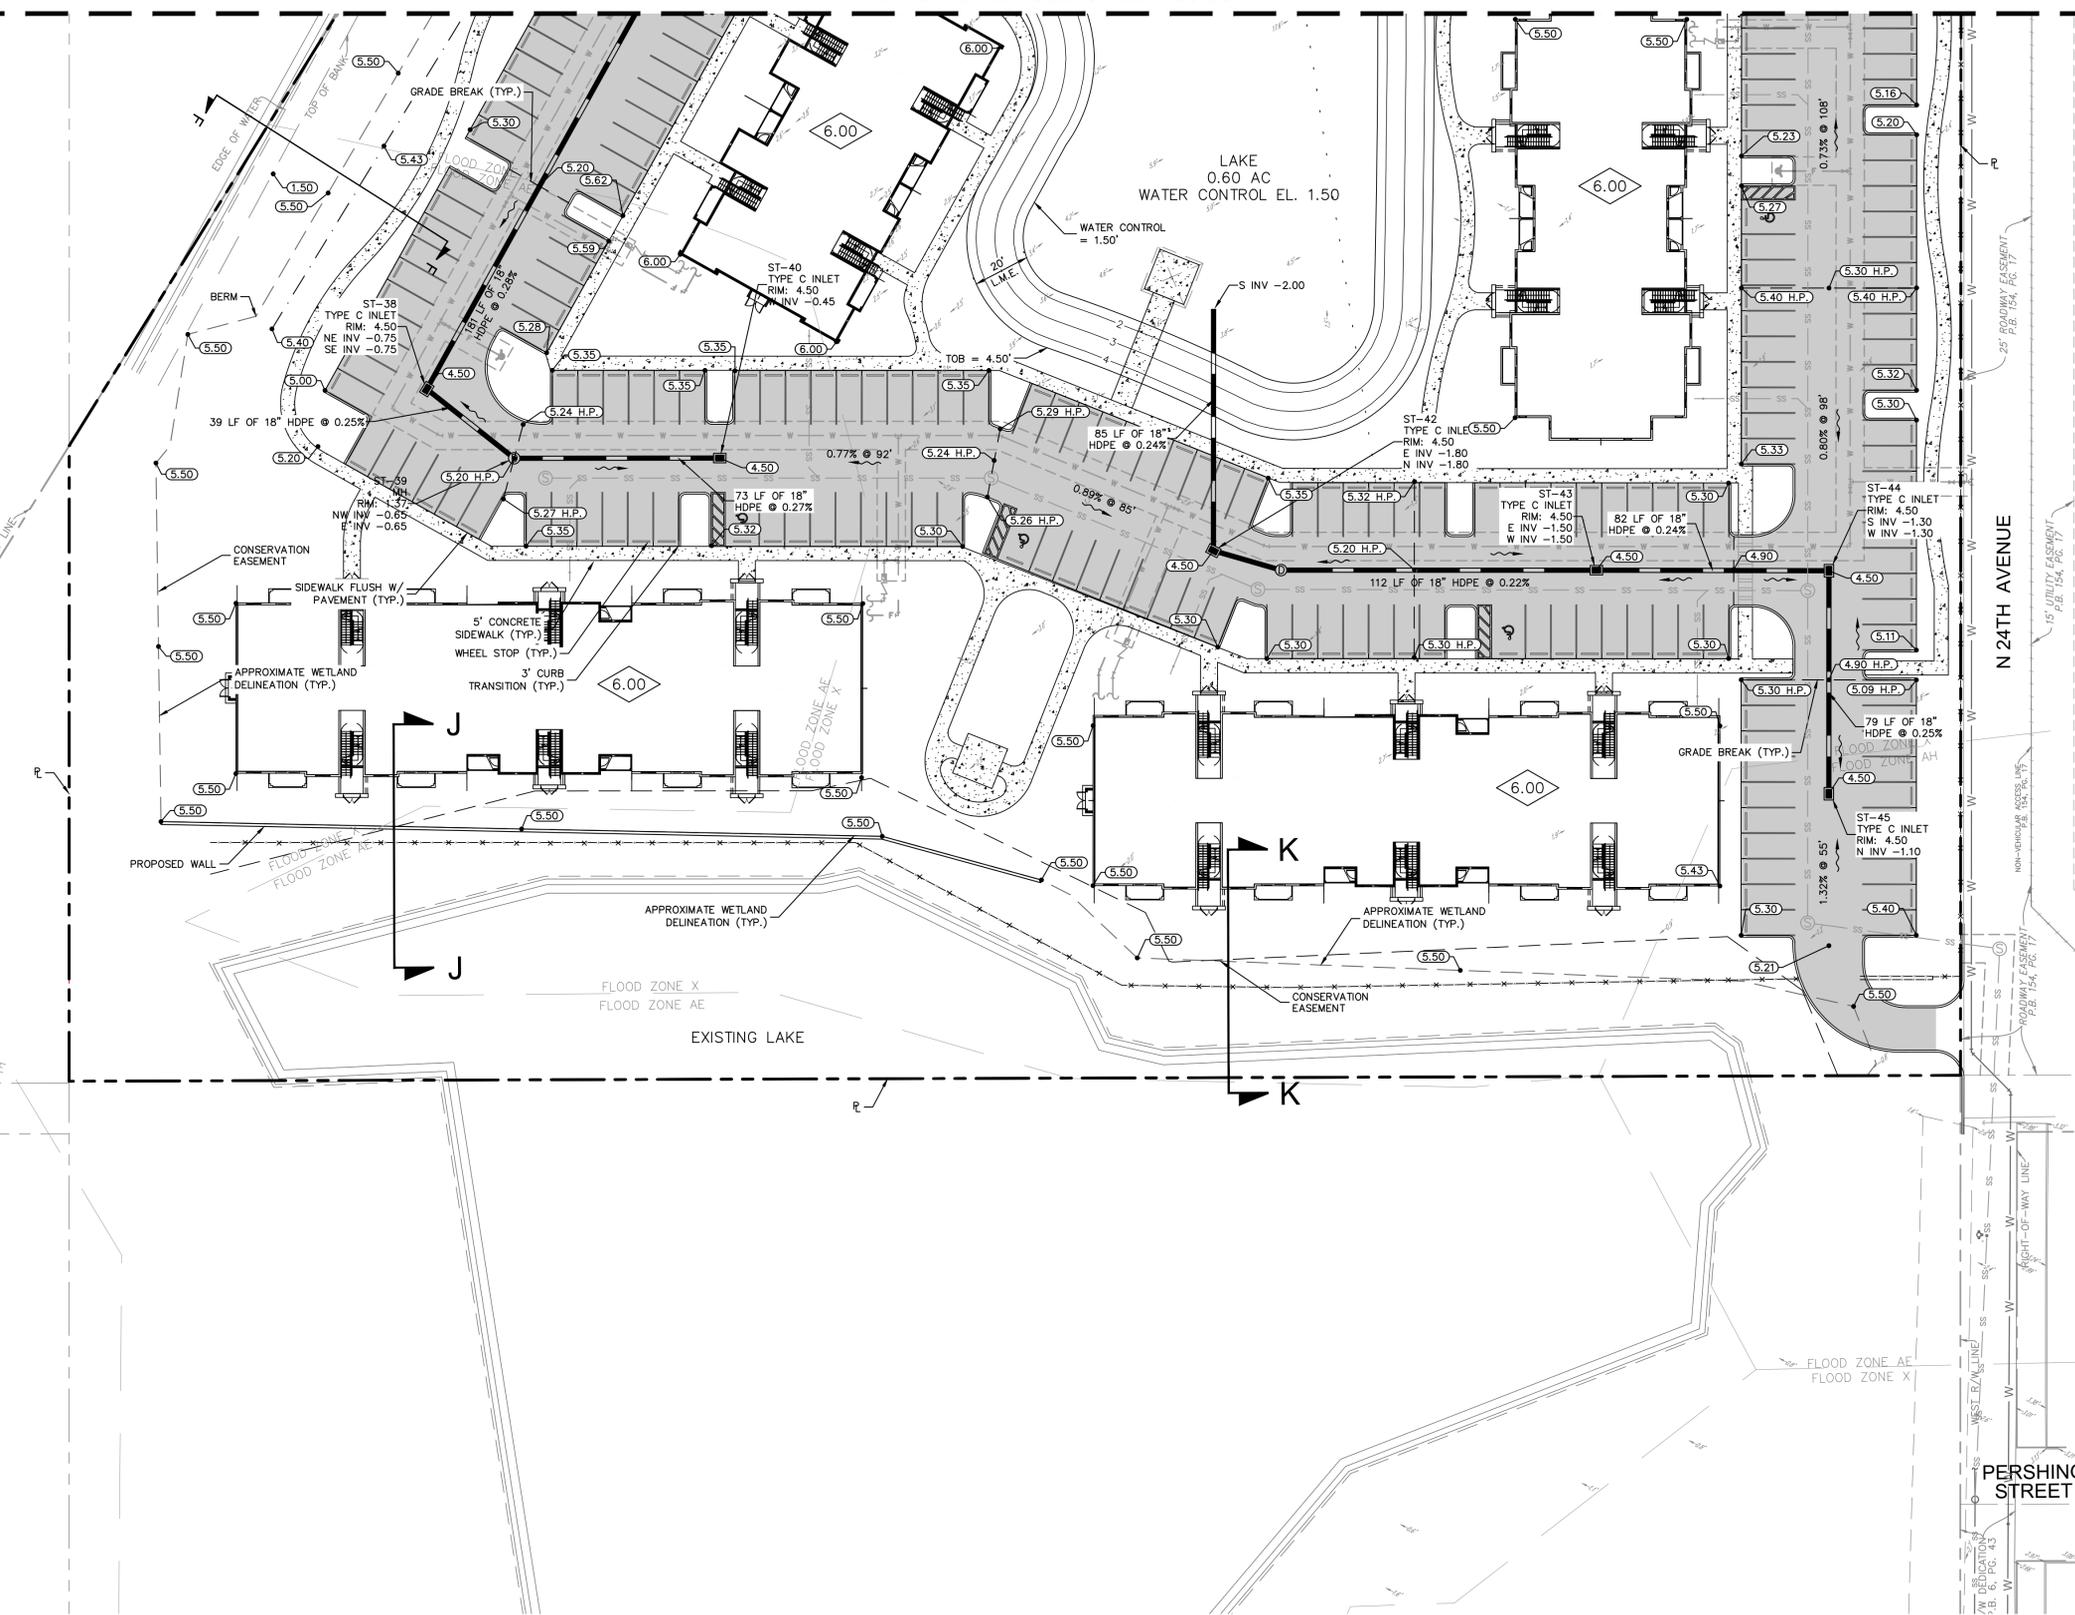
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NO.	REVISIONS	DATE	BY
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KHA PROJECT 044800012	LICENSED PROFESSIONAL MICHAEL D. SPRUCE, P.E.	DATE OCT. 2020	FL LICENSE NUMBER 52776
<b>PAVING, GRADING AND DRAINAGE PLAN</b>			
TOWN OF HOLLYWOOD PREPARED FOR RD STIRLING, LLC	CHECKED BY MDS	DATE	FL
SHEET NUMBER <b>C5.03</b>			CITY OF HOLLYWOOD

PLOTTED BY: NHI - SHEET: TOWN HOLLYWOOD - LAYOUT: C5.03 PAVING, GRADING AND DRAINAGE PLAN - OCTOBER 08, 2020 11:57:35pm - K:\boc\2019\044800012 - related hollywood\cadd\plansheets\C5.01 PAVING, GRADING AND DRAINAGE PLAN.dwg  
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MATCH LINE - SEE SHEET C5.03



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---	EXISTING STORM PIPE
---	EXISTING SANITARY FORCE MAIN
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---	EXISTING WATERMAIN
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---	EXISTING OVERHEAD WIRES
---	EXISTING SANITARY MANHOLE
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---	PROP. SANITARY SEWER PIPE
---	PROP. WATERMAIN
---	PROP. FIRE HYDRANT
---	PROP. SPOT ELEVATION
---	MATCH EXISTING ELEVATION
---	HIGH POINT ELEVATION
---	EXISTING ELEVATION
---	FLOW ARROW
---	FINISHED FLOOR ELEVATION
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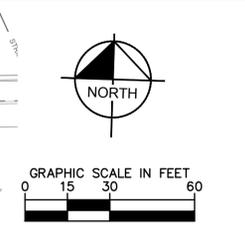
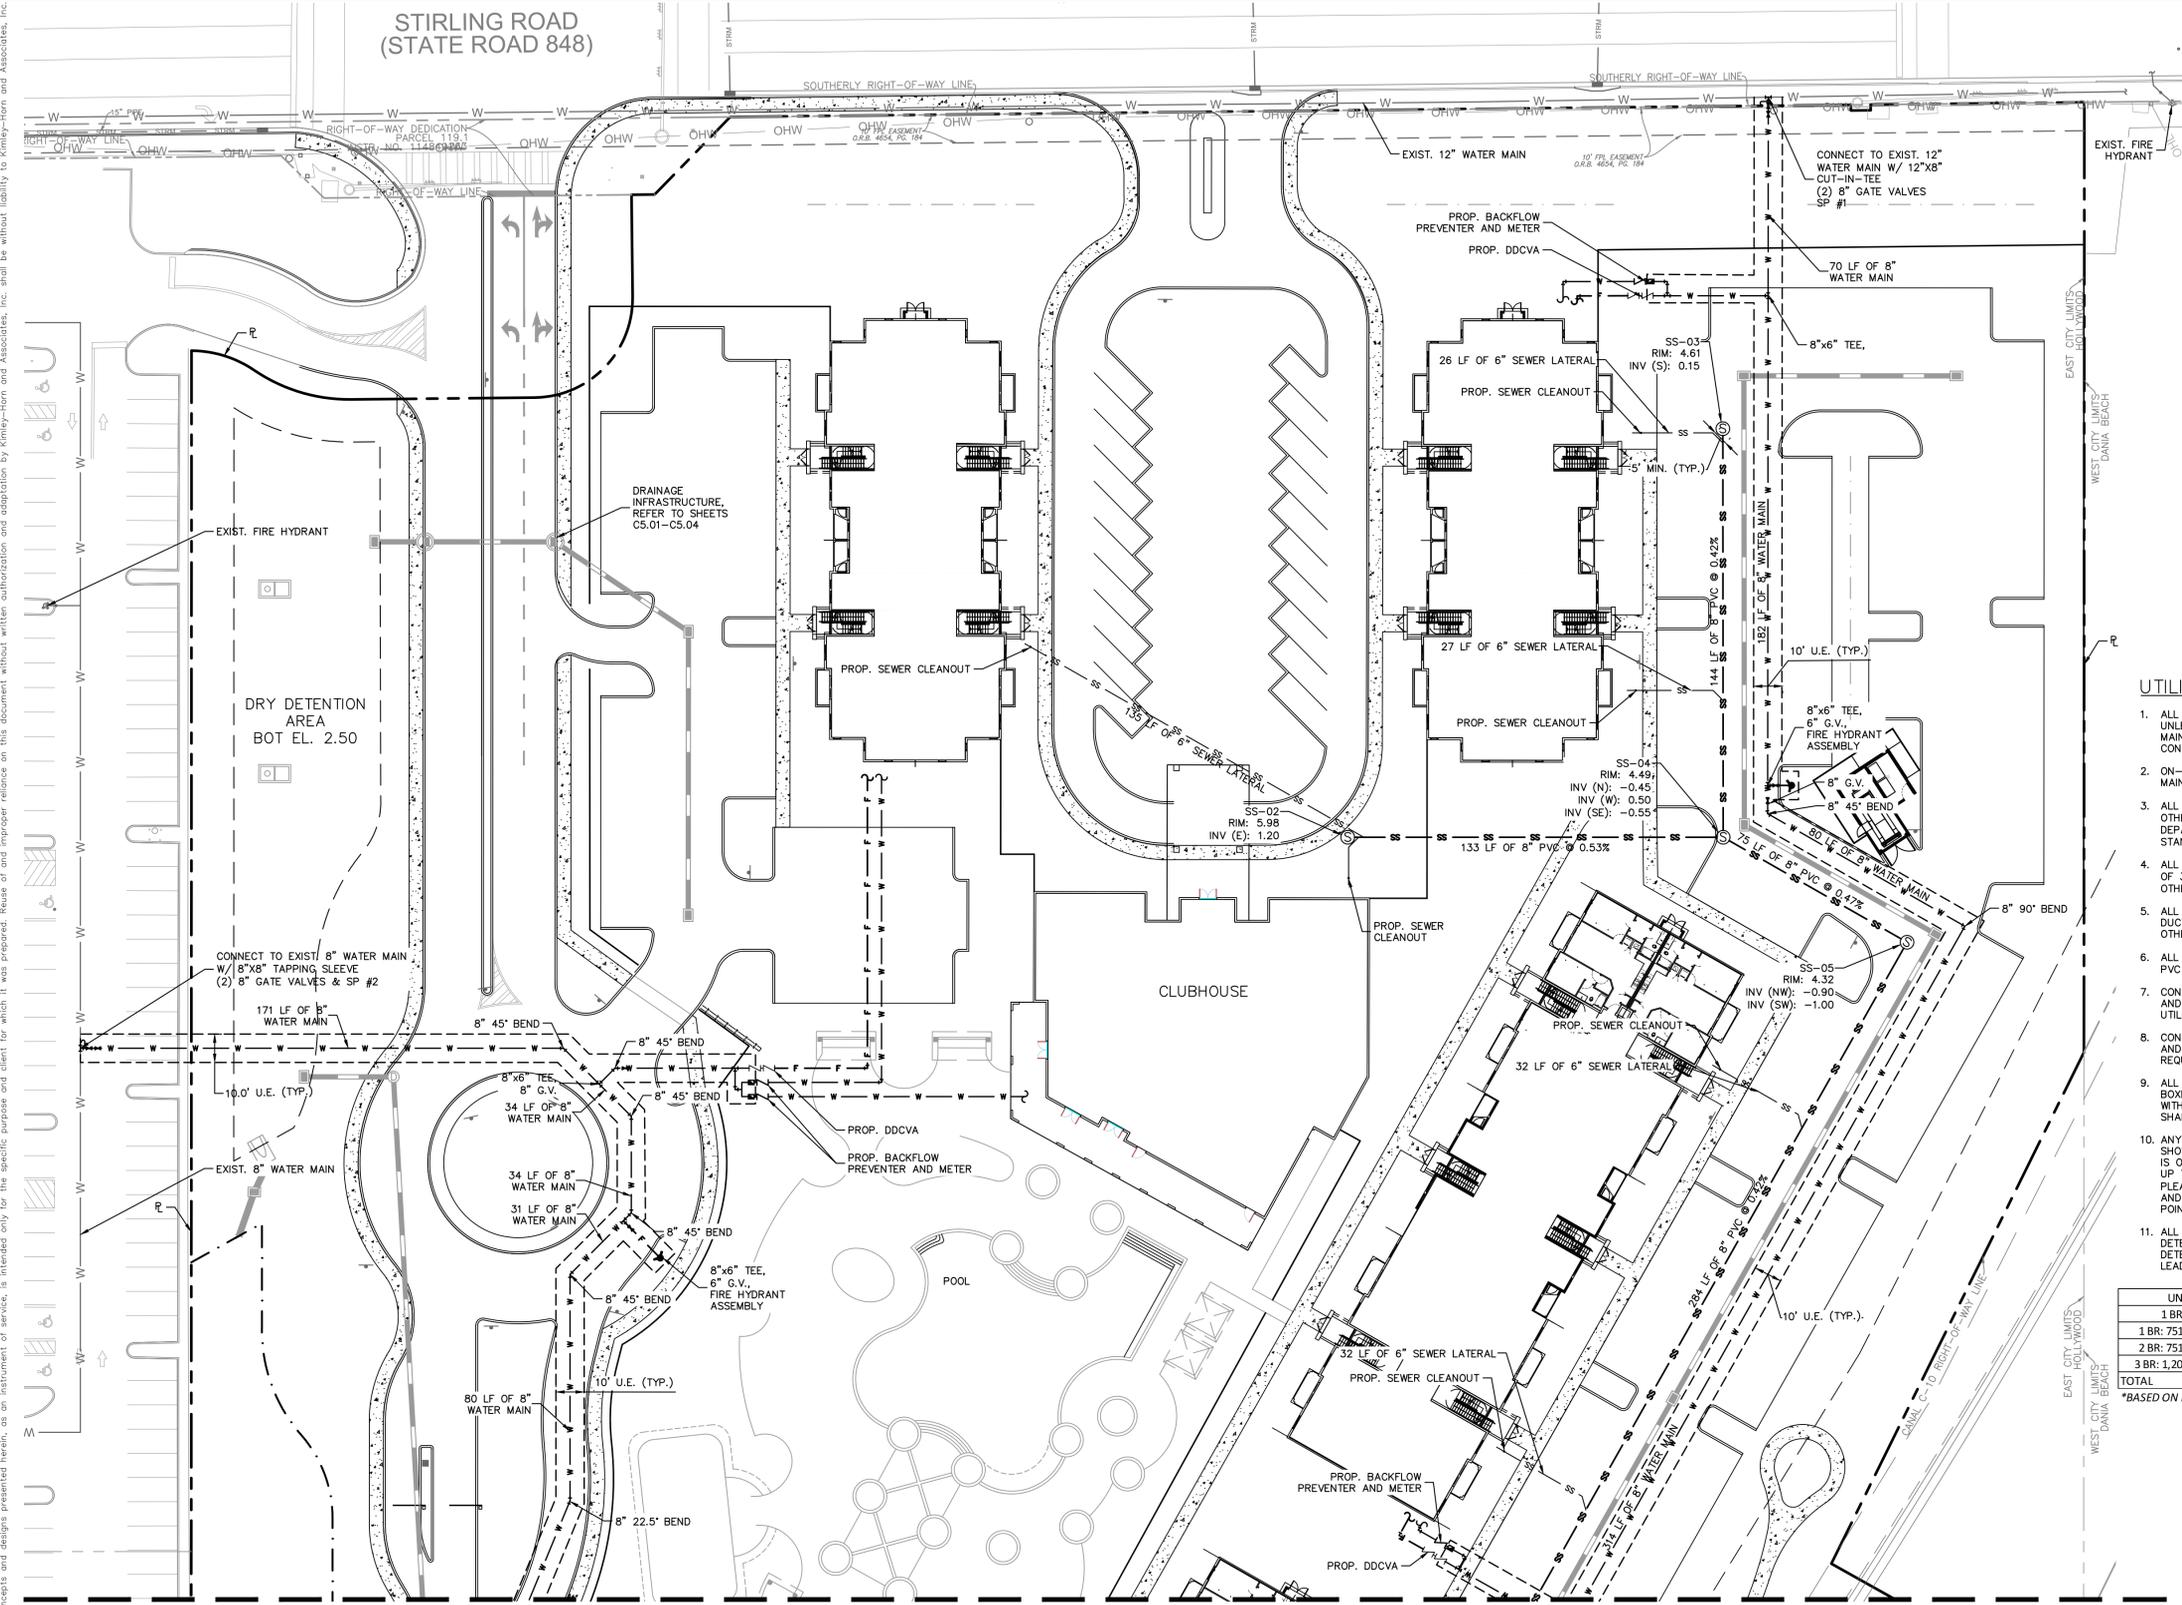
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KHA PROJECT 044800012	LICENSED PROFESSIONAL MICHAEL D. SPRUIELL, P.E. DATE OCT. 2020
SCALE AS SHOWN	FL LICENSE NUMBER 52776
DESIGNED BY JVP	CHECKED BY MDS
DRAWN BY AMC	DATE
TOWN HOLLYWOOD PREPARED FOR RD STIRLING, LLC	SHEET NUMBER C5.04
CITY OF HOLLYWOOD	REVISIONS No. DATE

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---	EXISTING SANITARY FORCE MAIN
---	EXISTING SANITARY SEWER PIPE
---	EXISTING WATERMAIN
---	FIBER OPTIC LINE
---	EXISTING OVERHEAD LINE
---	EXISTING SANITARY MANHOLE
---	PROPOSED STORM PIPE
---	PROPOSED SANITARY SEWER PIPE
---	PROPOSED WATERMAIN
---	PROPOSED FIRE HYDRANT
---	PROPOSED SANITARY MANHOLE
---	PROPOSED CONCRETE SIDEWALK
---	PROPOSED ASPHALT PAVEMENT

**UTILITY NOTES:**

- ALL WATER & FIRE MAIN SHALL BE PVC C-900 DR-14 UNLESS OTHERWISE NOTED. RESTRAIN ALL JOINTS. ALL FIRE MAIN SHALL BE INSTALLED BY A CERTIFIED FIRE SPRINKLER CONTRACTOR.
- ON-SITE SEWER LATERALS, MANHOLES, AND GRAVITY SEWER MAIN ARE PRIVATELY OWNED AND MAINTAINED.
- ALL DUCTILE IRON PIPE (DIP) SHALL BE CLASS 51 UNLESS OTHERWISE NOTED. ALL DIP SHALL BE MARKED PER FLORIDA DEPARTMENT OF ENVIRONMENTAL PROTECTION (FDEP) STANDARDS.
- ALL WATER MAIN AND FIRE MAIN SHALL HAVE A MINIMUM OF 36" COVER OVER THE TOP OF THE PIPE UNLESS OTHERWISE NOTED.
- ALL FITTINGS FOR WATER MAIN AND FIRE MAIN SHALL BE DUCTILE IRON MECHANICAL JOINT FITTINGS UNLESS OTHERWISE NOTED.
- ALL GRAVITY SEWER MAIN (SS) AND LATERALS SHALL BE PVC SDR-26 UNLESS OTHERWISE NOTED.
- CONTRACTOR SHALL SUPPORT AND PROTECT ALL EXIST. AND PROPOSED UTILITIES WHEN CONSTRUCTING NEW UTILITIES.
- CONTRACTOR SHALL FURNISH AND INSTALL NECESSARY PIPE AND FITTINGS TO TRANSITION PIPE MATERIALS WHEN REQUIRED AND TO CONNECT TO BUILDING PLUMBING.
- ALL MANHOLES, VALVES, CLEANOUTS AND OTHER SUCH BOXES IN PAVEMENT OR SIDEWALKS SHALL BE SET FLUSH WITH PAVEMENT TO MATCH THE PROPOSED SLOPE AND SHALL BE H-20 TRAFFIC RATED.
- ANY BUILDING FIRE LINE SHOWN ON THESE PLANS IS BEING SHOWN FOR COORDINATION PURPOSES ONLY. KIMLEY-HORN IS ONLY RESPONSIBLE FOR THE DESIGN OF THE WATER MAIN UP TO THE POINT OF SERVICE NOTED ON THE PLANS. PLEASE SEE PLANS BY (FIRE LINE DESIGNER) FOR PLAN AND DETAILS OF THE BUILDING FIRE LINE BEYOND THE POINT OF SERVICE.
- ALL PROPOSED BACKFLOW PREVENTERS, REDUCED PRESSURE DETECTOR BACKFLOW PREVENTERS AND DOUBLE DETECTOR CHECK VALVES SHALL BE USC CERTIFIED AND LEAD FREE.

UNIT TYPE	# UNITS	DEMAND	TOTAL DEMAND (GPD)
1 BR: <750 SF	150	100	15,000
1 BR: 751 SF - 1,200 SF	54	200	10,800
2 BR: 751 SF - 1,200 SF	168	200	33,600
3 BR: 1,201 SF - 2,250 SF	48	300	14,400
<b>TOTAL</b>	<b>420</b>	<b>-</b>	<b>73,800</b>

\*BASED ON FAC DEMAND PER # OF BEDROOMS

MATCH LINE - SEE SHEET C6.02

THE PRESENCE OF GROUNDWATER SHOULD BE ANTICIPATED ON THIS PROJECT. CONTRACTOR'S BID SHALL INCLUDE CONSIDERATION FOR ADDRESSING THIS ISSUE.

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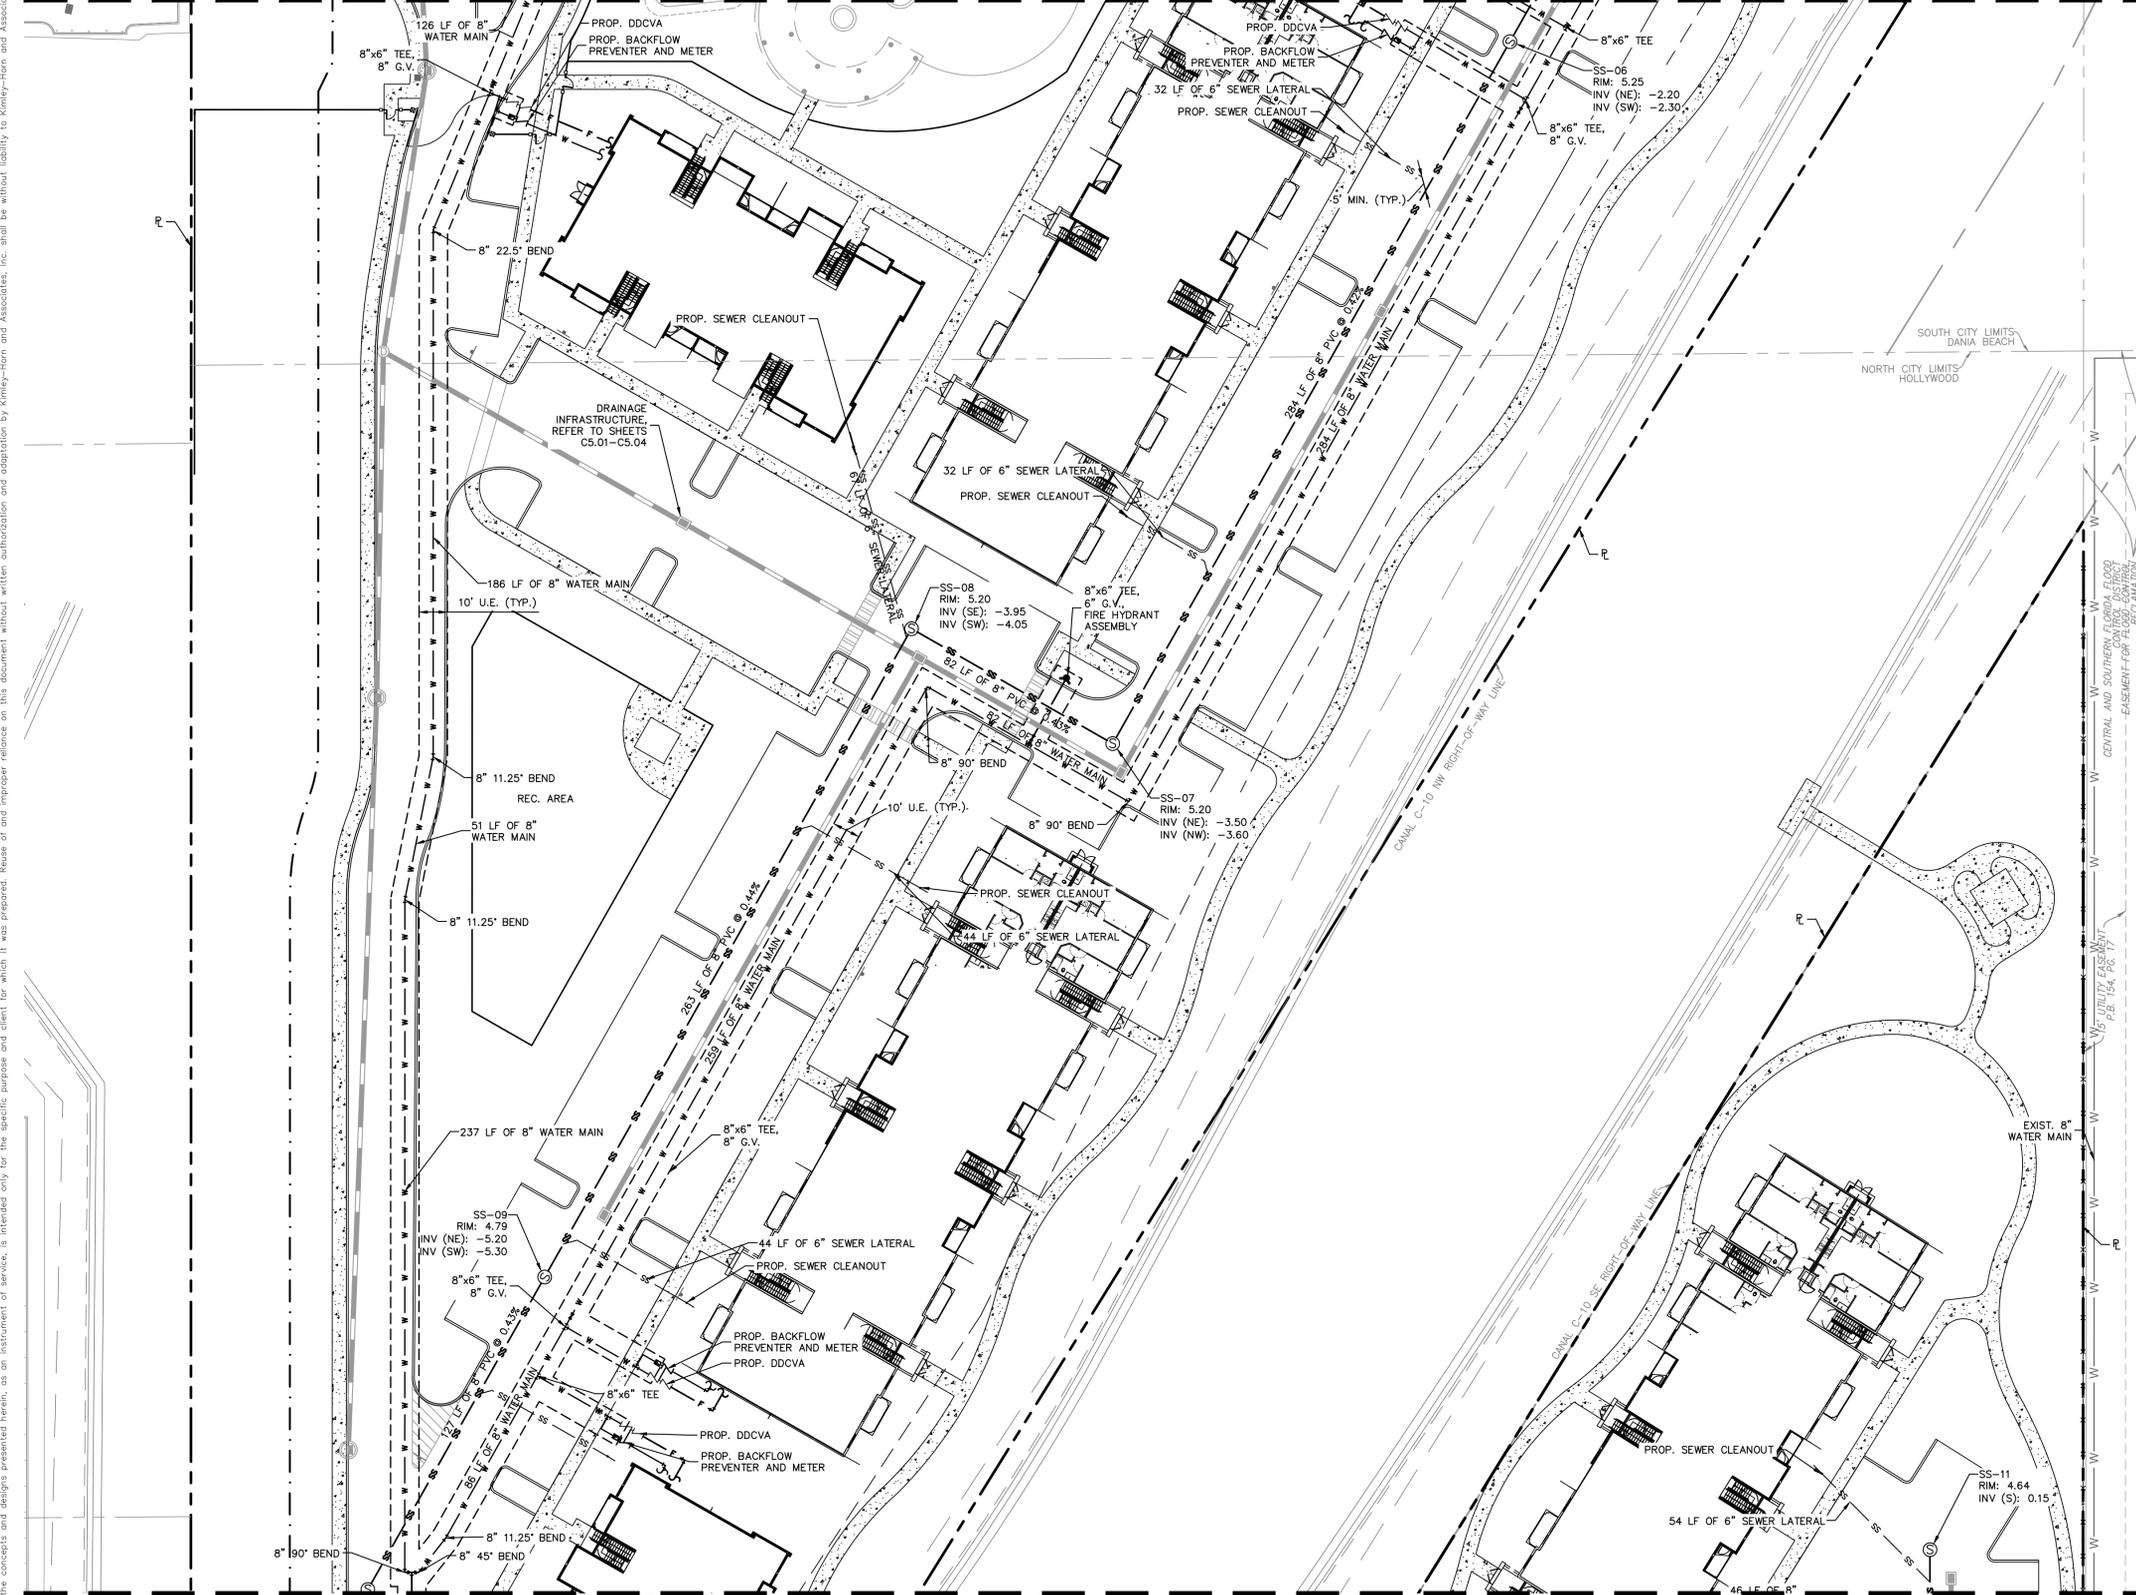
IT'S THE LAW! DIAL 811 Know what's below. Call before you dig.

SUNSHINE STATE ONE CALL OF FLORIDA, INC.


<p><b>Kimley»Horn</b></p> <p>© 2018 KIMLEY-HORN AND ASSOCIATES, INC.                  1615 S. CONGRESS AVE., SUITE 200, FT. LAUDERDALE, FL 33445                  PHONE: 561-330-2345 FAX: 561-863-8175                  WWW.KIMLEY-HORN.COM CA 00000696</p>	<p>NO. _____</p> <p>DATE _____</p>
	<p>REVISIONS</p>
<p>LICENSED PROFESSIONAL</p> <p>MICHAEL D. SPRUCE, P.E.</p>	<p>FL LICENSE NUMBER 52776</p>
<p><b>UTILITY PLAN</b></p>	<p>DATE _____</p>
<p>TOWN HOLLYWOOD                  PREPARED FOR                  RD STIRLING, LLC</p>	<p>CITY OF HOLLYWOOD</p>
<p>SHEET NUMBER  <b>C6.01</b></p>	<p>FL</p>

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MATCH LINE - SEE SHEET C6.01



MATCH LINE - SEE SHEET C6.03

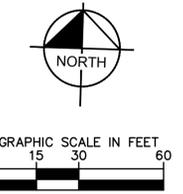

**LEGEND**

---	PROPERTY LINE
---	CENTERLINE OF R/W
---	EXISTING STORM PIPE
---	EXISTING SANITARY FORCE MAIN
---	EXISTING SANITARY SEWER PIPE
---	EXISTING WATERMAIN
---	FIBER OPTIC LINE
---	EXISTING OVERHEAD LINE
---	EXISTING SANITARY MANHOLE
---	PROPOSED STORM PIPE
---	PROPOSED SANITARY SEWER PIPE
---	PROPOSED WATERMAIN
---	PROPOSED FIRE HYDRANT
---	PROPOSED SANITARY MANHOLE
---	PROPOSED CONCRETE SIDEWALK
---	PROPOSED ASPHALT PAVEMENT

**UTILITY NOTES:**

1. ALL WATER & FIRE MAIN SHALL BE PVC C-900 DR-14 UNLESS OTHERWISE NOTED. RESTRAIN ALL JOINTS. ALL FIRE MAIN SHALL BE INSTALLED BY A CERTIFIED FIRE SPRINKLER CONTRACTOR.
2. ON-SITE SEWER LATERALS, MANHOLES, AND GRAVITY SEWER MAIN ARE PRIVATELY OWNED AND MAINTAINED.
3. ALL DUCTILE IRON PIPE (DIP) SHALL BE CLASS 51 UNLESS OTHERWISE NOTED. ALL DIP SHALL BE MARKED PER FLORIDA DEPARTMENT OF ENVIRONMENTAL PROTECTION (FDEP) STANDARDS.
4. ALL WATER MAIN AND FIRE MAIN SHALL HAVE A MINIMUM OF 36" COVER OVER THE TOP OF THE PIPE UNLESS OTHERWISE NOTED.
5. ALL FITTINGS FOR WATER MAIN AND FIRE MAIN SHALL BE DUCTILE IRON MECHANICAL JOINT FITTINGS UNLESS OTHERWISE NOTED.
6. ALL GRAVITY SEWER MAIN (SS) AND LATERALS SHALL BE PVC SDR-26 UNLESS OTHERWISE NOTED.
7. CONTRACTOR SHALL SUPPORT AND PROTECT ALL EXIST. AND PROPOSED UTILITIES WHEN CONSTRUCTING NEW UTILITIES.
8. CONTRACTOR SHALL FURNISH AND INSTALL NECESSARY PIPE AND FITTINGS TO TRANSITION PIPE MATERIALS WHEN REQUIRED AND TO CONNECT TO BUILDING PLUMBING.
9. ALL MANHOLES, VALVES, CLEANOUTS AND OTHER SUCH BOXES IN PAVEMENT OR SIDEWALKS SHALL BE SET FLUSH WITH PAVEMENT TO MATCH THE PROPOSED SLOPE AND SHALL BE H-20 TRAFFIC RATED.
10. ANY BUILDING FIRE LINE SHOWN ON THESE PLANS IS BEING SHOWN FOR COORDINATION PURPOSES ONLY. KIMLEY-HORN IS ONLY RESPONSIBLE FOR THE DESIGN OF THE WATER MAIN UP TO THE POINT OF SERVICE NOTED ON THE PLANS. PLEASE SEE PLANS BY (FIRE LINE DESIGNER) FOR PLAN AND DETAILS OF THE BUILDING FIRE LINE BEYOND THE POINT OF SERVICE.
11. ALL PROPOSED BACKFLOW PREVENTERS, REDUCED PRESSURE DETECTOR BACKFLOW PREVENTERS AND DOUBLE DETECTOR CHECK VALVES SHALL BE USC CERTIFIED AND LEAD FREE.

CENTRAL AND SOUTHERN FLORIDA FLOOD EASEMENT FOR FLOOD CONTROL, CONSERVATION, WATER STORAGE, AND O.R.B. 2004, PG. 798

THE PRESENCE OF GROUNDWATER SHOULD BE ANTICIPATED ON THIS PROJECT. CONTRACTOR'S BID SHALL INCLUDE CONSIDERATION FOR ADDRESSING THIS ISSUE.

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SUNSHINE STATE ONE CALL OF FLORIDA, INC.

No.	REVISIONS	DATE	BY

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 1815 S. CONGRESS AVE., SUITE 200, FT. LAUDERDALE, FL 33445  
 PHONE: 561-330-2345 FAX: 561-863-8175  
 WWW.KIMLEY-HORN.COM CA 00000696


KHA PROJECT	044800012
LICENSED PROFESSIONAL	MICHAEL D. SPRUDGE, P.E.
DATE	OCT. 2020
SCALE	AS SHOWN
DESIGNED BY	JVP
DRAWN BY	AMC
CHECKED BY	MDS
FL LICENSE NUMBER	527776

**UTILITY PLAN**

TOWN HOLLYWOOD  
 PREPARED FOR  
 RD STIRLING, LLC  
 CITY OF HOLLYWOOD  
 SHEET NUMBER  
**C6.02**

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MATCH LINE - SEE SHEET C6.02

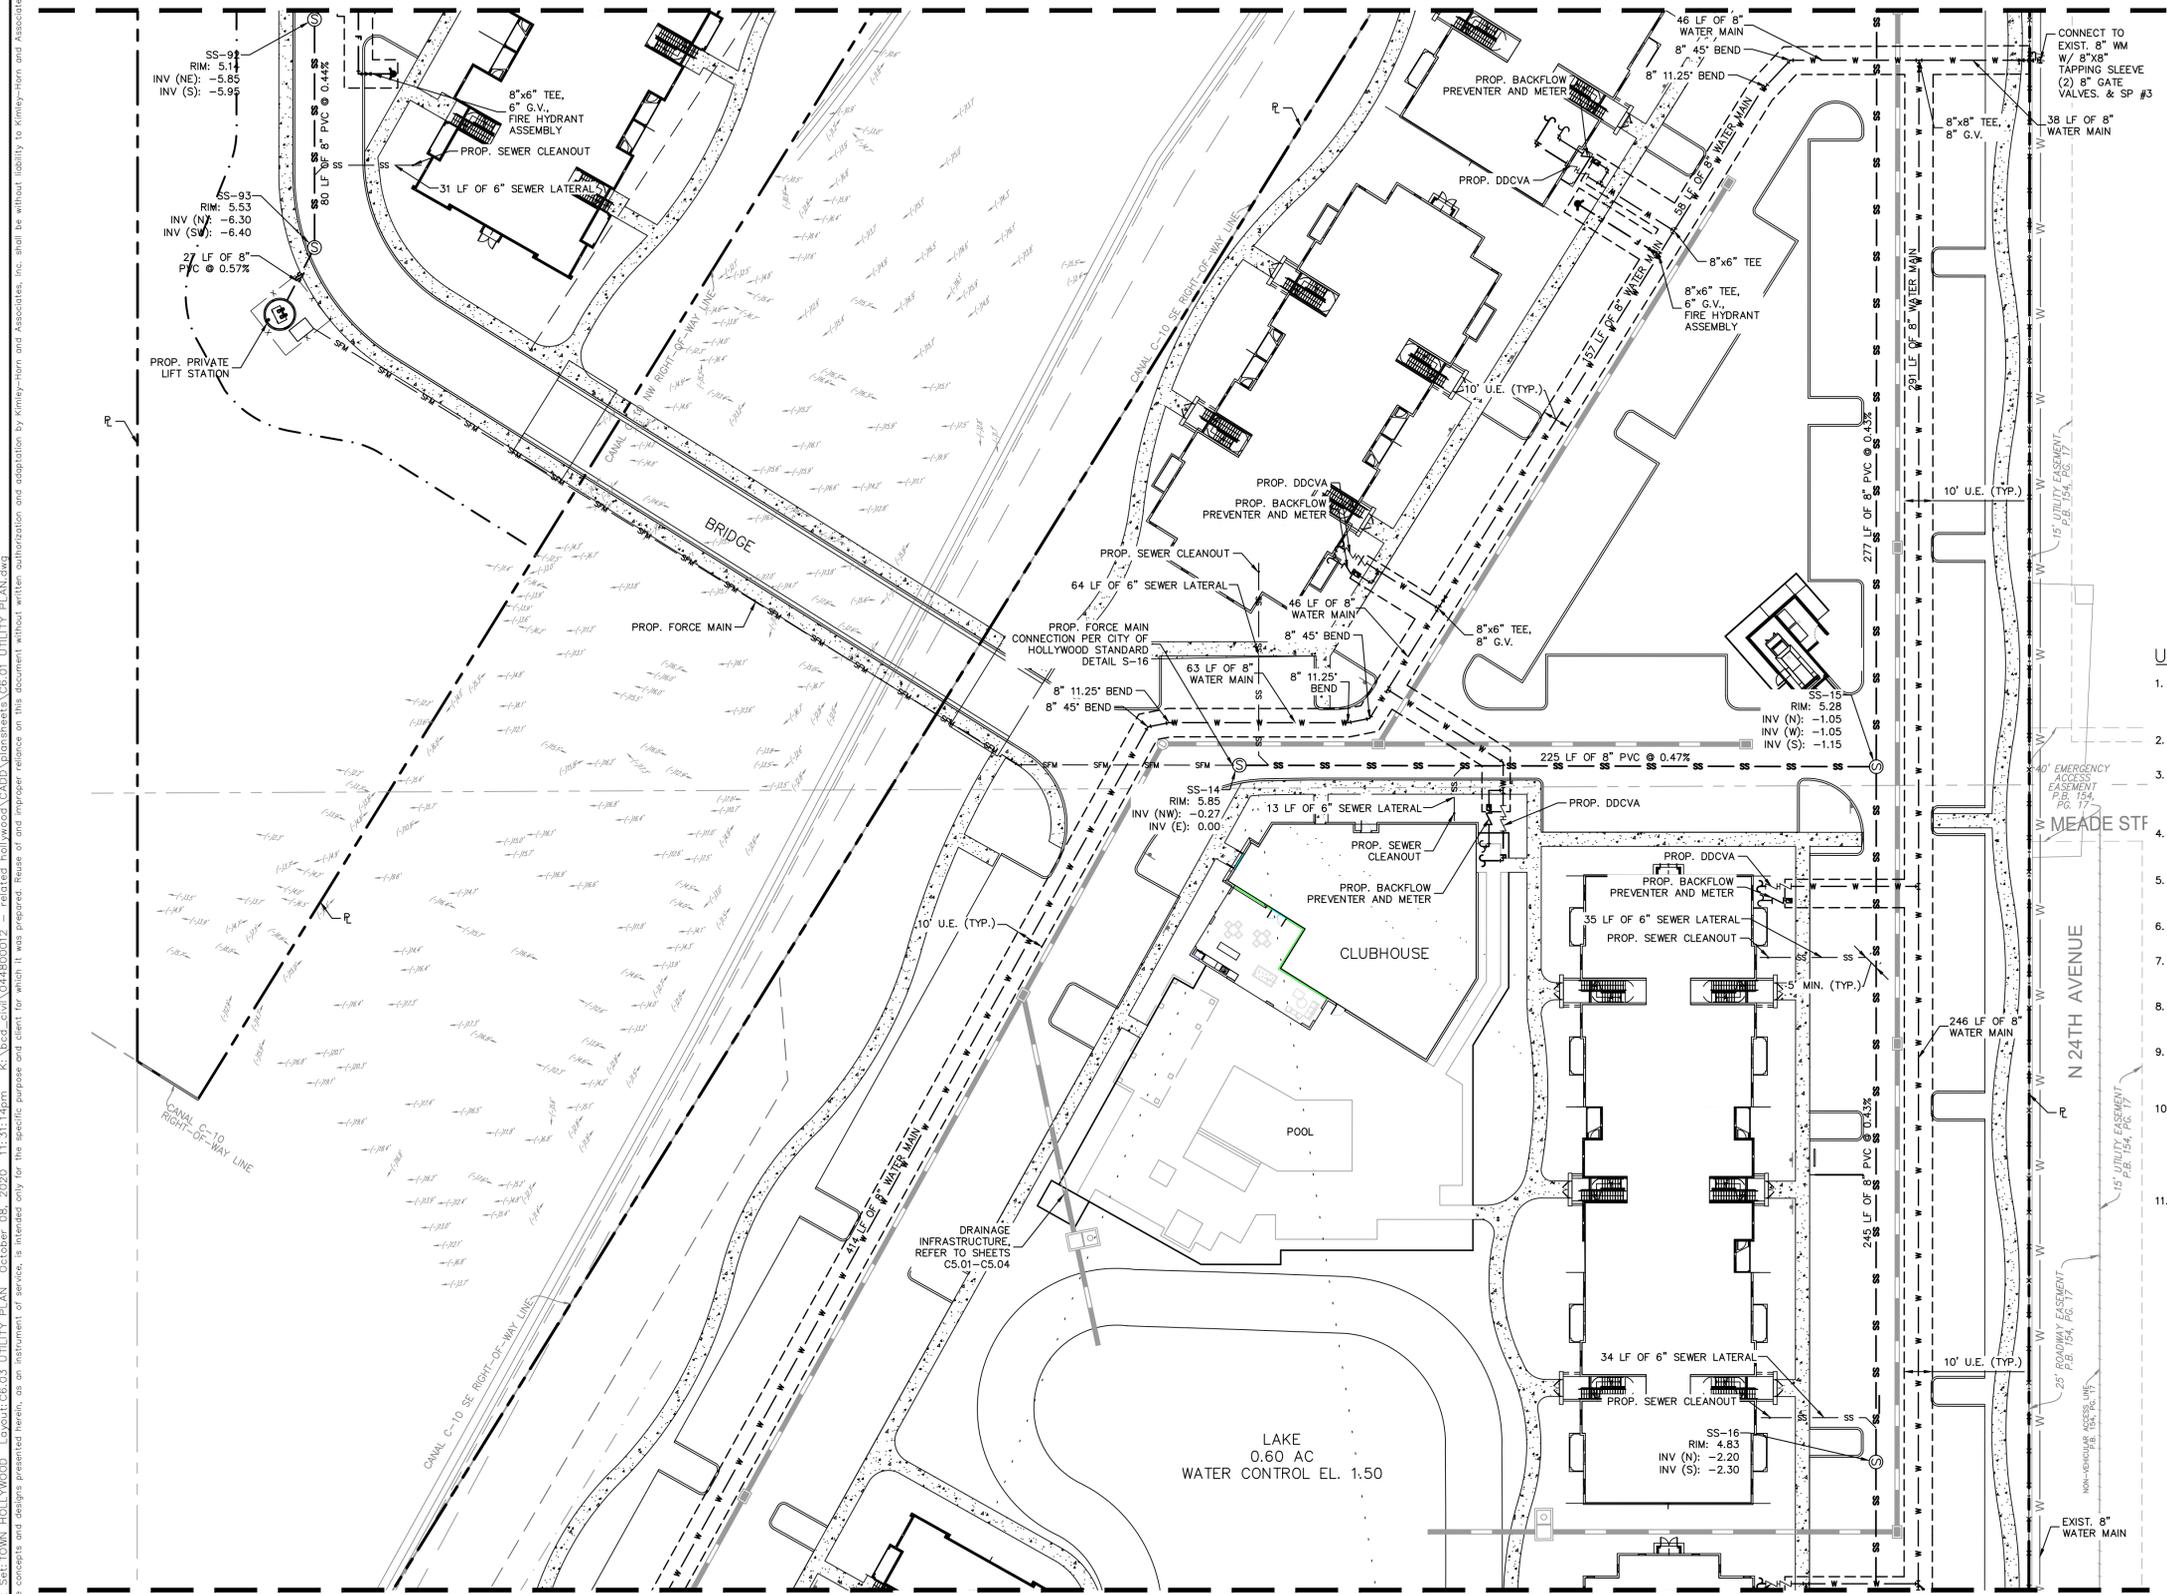

MATCH LINE - SEE SHEET C6.04



**LEGEND**

- PROPERTY LINE
- CENTERLINE OF R/W
- STRM --- EXISTING STORM PIPE
- SFM --- EXISTING SANITARY FORCE MAIN
- SS --- EXISTING SANITARY SEWER PIPE
- W --- EXISTING WATERMAIN
- FO --- FIBER OPTIC LINE
- OHL --- EXISTING OVERHEAD LINE
- SM --- EXISTING SANITARY MANHOLE
- SS --- PROPOSED STORM PIPE
- SS --- PROPOSED SANITARY SEWER PIPE
- W --- PROPOSED WATERMAIN
- FH --- PROPOSED FIRE HYDRANT
- SM --- PROPOSED SANITARY MANHOLE
- --- PROPOSED CONCRETE SIDEWALK
- --- PROPOSED ASPHALT PAVEMENT

**UTILITY NOTES:**

1. ALL WATER & FIRE MAIN SHALL BE PVC C-900 DR-14 UNLESS OTHERWISE NOTED. RESTRAIN ALL JOINTS. ALL FIRE MAIN SHALL BE INSTALLED BY A CERTIFIED FIRE SPRINKLER CONTRACTOR.
2. ON-SITE SEWER LATERALS, MANHOLES, AND GRAVITY SEWER MAIN ARE PRIVATELY OWNED AND MAINTAINED.
3. ALL DUCTILE IRON PIPE (DIP) SHALL BE CLASS 51 UNLESS OTHERWISE NOTED. ALL DIP SHALL BE MARKED PER FLORIDA DEPARTMENT OF ENVIRONMENTAL PROTECTION (FDEP) STANDARDS.
4. ALL WATER MAIN AND FIRE MAIN SHALL HAVE A MINIMUM OF 36" COVER OVER THE TOP OF THE PIPE UNLESS OTHERWISE NOTED.
5. ALL FITTINGS FOR WATER MAIN AND FIRE MAIN SHALL BE DUCTILE IRON MECHANICAL JOINT FITTINGS UNLESS OTHERWISE NOTED.
6. ALL GRAVITY SEWER MAIN (SS) AND LATERALS SHALL BE PVC SDR-26 UNLESS OTHERWISE NOTED.
7. CONTRACTOR SHALL SUPPORT AND PROTECT ALL EXIST. AND PROPOSED UTILITIES WHEN CONSTRUCTING NEW UTILITIES.
8. CONTRACTOR SHALL FURNISH AND INSTALL NECESSARY PIPE AND FITTINGS TO TRANSITION PIPE MATERIALS WHEN REQUIRED AND TO CONNECT TO BUILDING PLUMBING.
9. ALL MANHOLES, VALVES, CLEANOUTS AND OTHER SUCH BOXES IN PAVEMENT OR SIDEWALKS SHALL BE SET FLUSH WITH PAVEMENT TO MATCH THE PROPOSED SLOPE AND SHALL BE H-20 TRAFFIC RATED.
10. ANY BUILDING FIRE LINE SHOWN ON THESE PLANS IS BEING SHOWN FOR COORDINATION PURPOSES ONLY. KIMLEY-HORN IS ONLY RESPONSIBLE FOR THE DESIGN OF THE WATER MAIN UP TO THE POINT OF SERVICE NOTED ON THE PLANS. PLEASE SEE PLANS BY (FIRE LINE DESIGNER) FOR PLAN AND DETAILS OF THE BUILDING FIRE LINE BEYOND THE POINT OF SERVICE.
11. ALL PROPOSED BACKFLOW PREVENTERS, REDUCED PRESSURE DETECTOR BACKFLOW PREVENTERS AND DOUBLE DETECTOR CHECK VALVES SHALL BE USC CERTIFIED AND LEAD FREE.

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SUNSHINE STATE ONE CALL OF FLORIDA, INC.

No.	REVISIONS	DATE	BY

**Kimley»Horn**  
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 1815 S. COACHESS VALLEY STREET, SUITE 200, BOCA RATON, FL 33445  
 PHONE: 561-330-2345 FAX: 561-863-8175  
 WWW.KIMLEY-HORN.COM CA 00000696

KHA PROJECT 044800012	LICENSED PROFESSIONAL MICHAEL D. SPRUCE, P.E.
DATE OCT. 2020	FL LICENSE NUMBER 52776
SCALE AS SHOWN	DRAWN BY JVP
CHECKED BY MDS	DATE



**UTILITY PLAN**

TOWN HOLLYWOOD  
 PREPARED FOR  
 RD STIRLING, LLC  
 CITY OF HOLLYWOOD, FL

SHEET NUMBER  
**C6.03**

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MATCH LINE - SEE SHEET C6.03

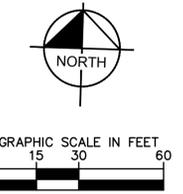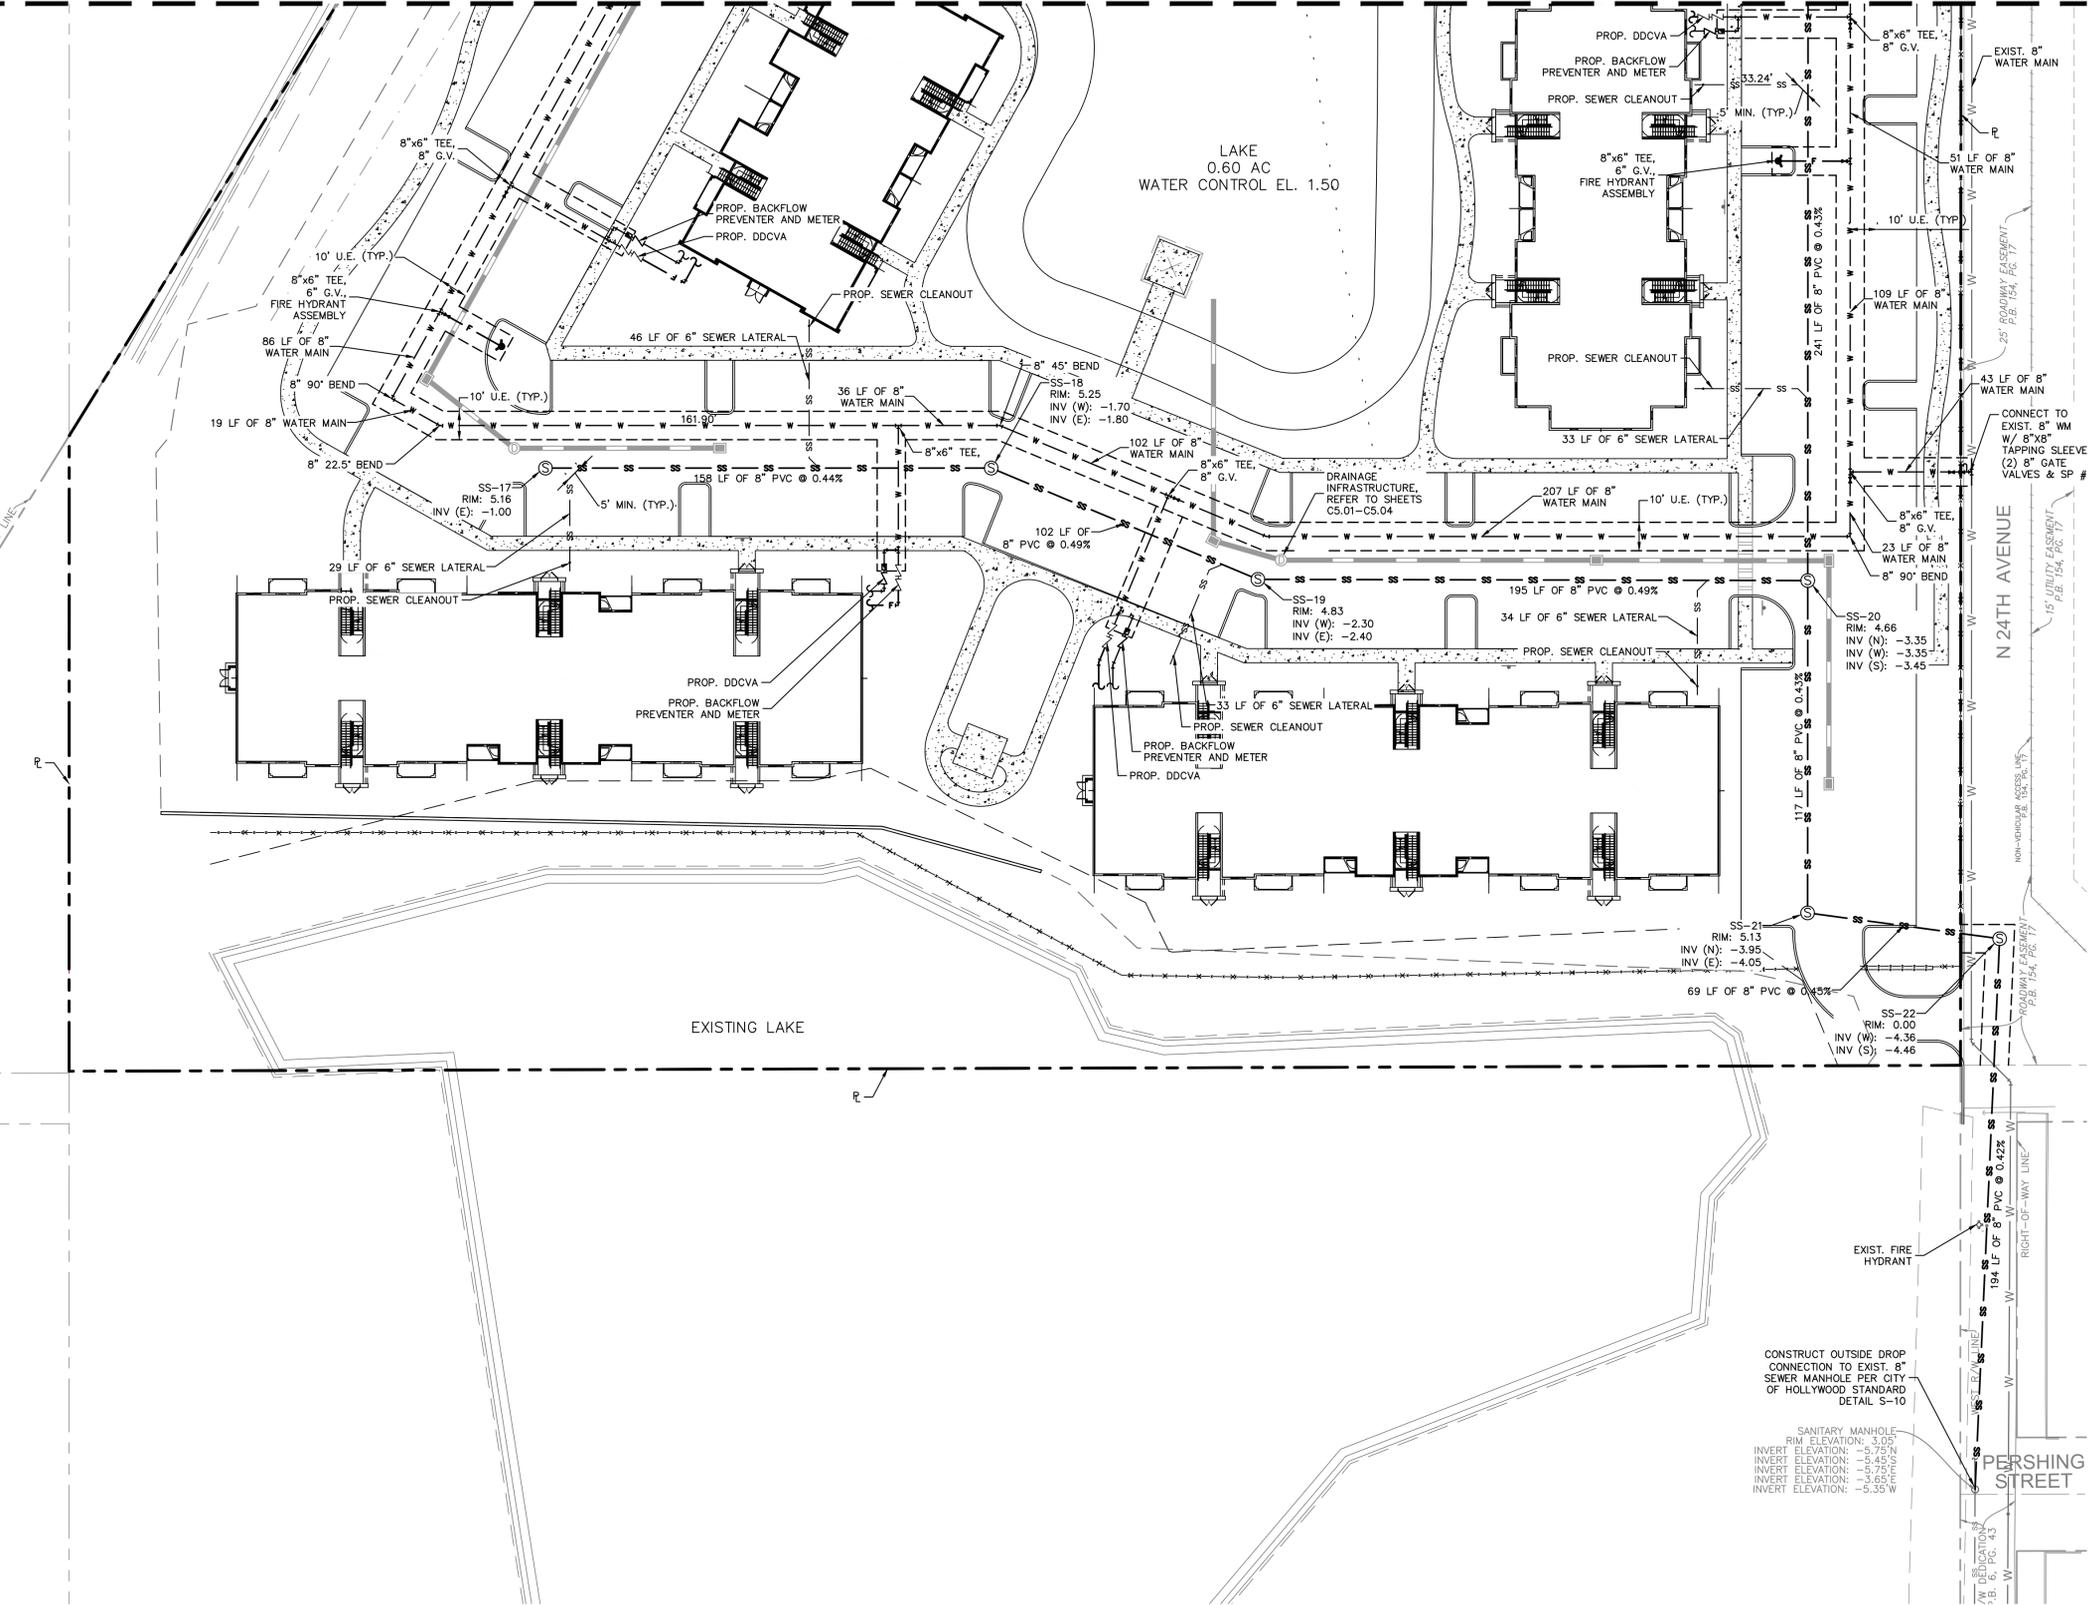

LEGEND

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CONSTRUCT OUTSIDE DROP CONNECTION TO EXIST. 8" SEWER MANHOLE PER CITY OF HOLLYWOOD STANDARD DETAIL S-10

SANITARY MANHOLE  
 RIM ELEVATION: 3.05  
 INVERT ELEVATION: -5.75 N  
 INVERT ELEVATION: -5.45 S  
 INVERT ELEVATION: -5.75 E  
 INVERT ELEVATION: -3.65 W  
 INVERT ELEVATION: -5.35 W

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TOWN HOLLYWOOD PREPARED FOR RD STIRLING, LLC	
CITY OF HOLLYWOOD	
SHEET NUMBER <b>C6.04</b>	
REVISIONS	DATE
No.	BY