SITE DEVELOPMENT PLANS

FOR

RETAIL SHOPS & BANK OF AMERICA AT HOLLYWOOD SHOPPING PLAZA

LOCATED AT

603 & 851 S STATE ROAD 7 CITY OF HOLLYWOOD, FLORIDA 33023 SECTION 13, TOWNSHIP 51S, RANGE 42E

RETAIL SHOPS - SHEET LIST TABLE

SHEET TITLE

OHEET HOMBER	311221 11122
C-000	COVER SHEET
1 OF 3	TOPOGRAPHIC SURVEY
2 OF 3	TOPOGRAPHIC SURVEY
3 OF 3	TOPOGRAPHIC SURVEY
C-001	GENERAL NOTES
C-100	DEMOLITION & EROSION CONTROL PLAN - RETAIL SHOPS
C-101	DEMOLITION AND EROSION CONTROL PLAN - ADDITIONAL PARKING
C-102	DEMOLITION AND EROSION CONTROL DETAILS
C-200	OVERALL SITE PLAN
C-201	SITE PLAN - RETAIL SHOPS
C-202	SITE PLAN - ADDITIONAL PARKING AT REAR OF SITE
C-203	SITE PLAN DETAILS
C-300	PAVING GRADING AND DRAINAGE PLAN - RETAIL SHOPS
C-301	PAVING GRADING & DRAINAGE - ADDITIONAL PARKING AT REAR OF SITE
C-400	UTILITY PLAN - RETAIL SHOPS
C-401	UTILITY PLAN - ADDITIONAL PARKING AT REAR OF SITE
C-402	CITY OF HOLLYWOOD STANDARD POTABLE WATER DETAILS
C-403	CITY OF HOLLYWOOD STANDARD POTABLE WATER DETAILS
C-404	CITY OF HOLLYWOOD STANDARD WASTE WATER DETAILS
C-405	CITY OF HOLLYWOOD STANDARD WASTE WATER DETAILS

L-300	LANDSCAPE NOTES	
ARCHITECT	(PREPARED BY GUTIERREZ & LOZANO ARCHITECTS)	
SHEET NUMBER	SHEET TITLE	
A-1.0	FLOOR PLAN	
A-2.0	BUILDING ELEVATIONS	
,	0 0	

BUILDING COLOR ELEVATIONS

LANDSCAPE PLAN

LANDSCAPE DETAILS

BANK OF AMERICA - SHEET LIST TABLE

CIVIL PLANS	(INFINITY)
SHEET NUMBER	SHEET TITLE
C02.01	SITE PLAN
C03.01	GRADING AND DRAINAGE PLAN
C04.01	UTILITY PLAN
C12.01	SITE DETAILS
C12.02	SITE DETAILS
C12.03	CITY OF HOLLYWOOD DETAILS
L01.01	LANDSCAPE PLAN
L02.01	LANDSCAPE PLAN DETAILS
1 OF 1	ALTA/NSPS LAND TITLE SURVEY
ARCHITECT	(PREPARED BY M. ARTHUR GENSLER JR. & ASSOCIATES)
C02.01	SITE PLAN
C03.01	GRADING AND DRAINAGE PLAN
C04.01	UTILITY PLAN
C12.01	SITE DETAILS
C12.02	SITE DETAILS
C12.03	CITY OF HOLLYWOOD DETAILS
C12.04	ALTA/NSPS LAND TITLE SURVEY THE PRESENCE OF GROUNDWATER SHOULD BE ANTICIPATED ON THIS PROJECT. CONTRACTOR'S BID SHALL INCLUDE CONSIDERATION FOR

MEETINGS <u>DATE</u> 09/06/16 PRELIMINARY TAC FINAL TAC PLANNING DEV. BOARD CITY COMMISSION _____

CIVIL PLANS

L-100

L-200

A-2.1

SHEET NUMBER

PROJECT TEAM

OWNER/DEVELOPER

SHOPPING CENTER - ARCHITECT

GUTIERREZ & LOZANO ARCHITECTS, PA 2830 WEST STATE ROAD 84, SUITE 117 FAX (954) 321-3864

(954) 572-1777

SHOPPING CENTER - CIVIL ENGINEER

KIMLEY-HORN AND ASSOCIATES, INC

SHOPPING CENTER - LANDSCAPE ARCHITECT

MILTON SCOTT MINGONET, PLA, AICF KIMLEY-HORN AND ASSOCIATES, INC.

BANK OF AMERICA - CIVIL ENGINEER

1208 E. KENNEDY BOULEVARD, SUITE 230

(813-434-4770

BANK OF AMERICA - LANDSCAPE ARCHITECT

PATRICK D. CUNNINGHAM, RLA PATRICK D. CUNNINGHAM, LLC 444 POINCIANA DRIVE SARASOTA, FLORIDA 34243 (941) 351-8915

PROJECT LOCATION

BANK OF AMERICA ARCHITECT DANA MULLER, A1A M. ARTHUR GENSLER JR. & ASSOCIATES, INC. 2 HARRISON STREET, SUITE 400 SAN FRANCISCO, CALIFORNIA 94105

LIST OF CONTACTS

STORMWATER BROWARD COUNTY EPD. 1 N. UNIVERSITY DRIVE PLANTATION, FL 33301 (954) 519-1243

WATER CITY OF HOLLYWOOD 2600 HOLLYWOOD BLVD. HOLLYWOOD, FL 33022 (954) 321-3302 CONTACT: JAMES RUSNAK

SANITARY SEWER

CITY OF HOLLYWOOD 2600 HOLLYWOOD BLVD. HOLLYWOOD, FL 33022 (954) 321-3302 CONTACT: JAMES RUSNAK

FIRE PREVENTION CITY OF HOLLYWOOD 2741 STIRLING ROAD HOLLYWOOD, FL 33312 (954) 967-4248 CONTACT: VIRGIL FERNANDEZ PLANNING AND ZONING

CITY OF HOLLYWOOD 2600 HOLLYWOOD BLVD. HOLLYWOOD, FL 33022 (954) 321-3471

ENGINEERING CITY OF HOLLYWOOD 2600 HOLLYWOOD BLVD HOLLYWOOD, FL 33022 (954) 921-3900

BUILDING DIVISION CITY OF HOLLYWOOD 2600 HOLLYWOOD BLVD. HOLLYWOOD, FL 33022 (954) 321-3335

TRAFFIC

FLORIDA DEPT. OF TRANSPORTATION 3400 WEST COMMERCIAL BLVD. FORT LAUDERDALE, FL 33309 (954) 777-4383

ELECTRIC PROVIDER FLORIDA POWER & LIGHT 4000 DAVIE ROAD EXTENSION HOLLYWOOD, FL 33024 (954) 442-6347 **CONTACT: JAMES TALLEY**

TELEPHONE PROVIDER

8601 W. SURPRISE BLVD., ROOM 2106 PLANTATION, FL 33322 (954) 476-6125 CONTACT: BILL SERPE

CABLE PROVIDER COMCAST CABLE

2601 SW 145TH AVENUE MIRAMAR, FL 33027 (954) 447-8405 CONTACT: LEONARD MAXWELL-NEWBOLD

NATURAL GAS PROVIDER TECO PEOPLE'S GAS 15779 W. DIXIE HIGHWAY NORTH MIAMI, FL 33162 (954) 931-9742

CONTACT: DOUG HOFFMAN

PREPARED BY:

BID SHALL INCLUDE CONSIDERATION FOR ADDRESSING THIS ISSUE. BEFORE YOU DIG

IT'S THE LAW! Know what's **below**. SUNSHINE STATE ONE CALL OF FLORIDA, INC.

SHEET NUMBER C-000

SHOPS AMERICA OOD PLA

PROJECT LOCATION **BROWARD COUNTY**

LEGAL DESCRIPTION:

PARCEL 1:

THAT PART OF THE SOUTHEAST 1/4 OF SECTION 13, TOWNSHIP 51 SOUTH, RANGE 41 EAST, BROWARD COUNTY, FLORIDA, MORE PARTICULARLY DESCRIBED AS FOLLOWS:

COMMENCING AT THE SOUTHWEST CORNER OF THE SOUTHEAST 1/4, RUN NORTH 02°30'21" WEST ALONG THE WEST LINE OF SAID SOUTHEAST 1/4, A DISTANCE OF 282.00 FEET TO THE POINT OF BEGINNING; THENCE CONTINUE NORTHERLY ON THE LAST DESCRIBED COURSE, A DISTANCE OF 394.05 FEET TO THE NORTHWEST CORNER OF THE SOUTHWEST 1/4 OF THE SOUTHWEST 1/4 OF THE SOUTHEAST 1/4; THENCE RUN NORTH 89°28'18" EAST ALONG THE NORTH LINE OF SAID SOUTHWEST 1/4 OF THE SOUTHEAST 1/4, A DISTANCE OF 667.75 FEET TO THE NORTHEAST CORNER OF SAID SOUTHWEST 1/4 OF THE SOUTHWEST 1/4 OF THE SOUTHEAST 1/4; THENCE RUN NORTH 89°28'18" EAST ON A PROJECTION OF THE NORTH LINE OF SAID SOUTHWEST 1/4 OF THE SOUTHWEST 1/4 OF THE SOUTHEAST 1/4, A DISTANCE OF 175.0 FEET; THENCE RUN SOUTH 02°33'01" PARALLEL WITH THE EAST LINE OF SAID SOUTHWEST 1/4 OF THE SOUTHWEST 1/4 OF THE SOUTHEAST 1/4, A DISTANCE OF 646.41 FEET TO A POINT, 35.0 FEET NORTH OF THE SOUTH LINE OF THE SOUTHEAST 1/4; THENCE RUN SOUTH 89°49'34" WEST PARALLEL WITH SAID SOUTH LINE OF THE SOUTHEAST 1/4, A DISTANCE OF 573.73 FEET TO A POINT; THENCE RUN NORTH 02°30'30" WEST, A DISTANCE OF 247.00 FEET; THENCE RUN SOUTH 89°49'34" WEST, A DISTANCE OF 270.04 FEET TO THE POINT OF BEGINNING.

LESS AND EXCEPT THAT PORTION CONVEYED TO THE STATE OF FLORIDA DEPARTMENT OF TRANSPORTATION BY VIRTUE OF WARRANTY DEED RECORDED IN OFFICIAL RECORDS BOOK 48831, PAGE 1152, OF THE PUBLIC RECORDS OF BROWARD COUNTY, FLORIDA.

SUBJECT TO AND TOGETHER WITH ALL OF THE NON-EXCLUSIVE EASEMENTS AND OTHER RIGHTS APPURTENANT THERETO THAT ARE GRANTED IN THAT CERTAIN RECIPROCAL EASEMENT AGREEMENT BY AND BETWEEN LEF/HOLLYWOOD, L.L.C., A FLORIDA LIMITED LIABILITY COMPANY, AND KMART CORPORATION, A MICHIGAN CORPORATION, RECORDED APRIL 29, 2004, IN OFFICIAL RECORDS BOOK 37341, PAGE 115, AS AFFECTED BY ORDER OF TAKING RECORDED IN OFFICIAL RECORDS BOOK 48998, PAGE 30, OF THE PUBLIC RECORDS OF BROWARD COUNTY, FLORIDA.

FOLIO NO. 514113-00-0161

PARCEL; 2:


THAT PART OF THE SOUTHWEST 1/4 OF THE SOUTHWEST 1/4 OF THE SOUTHEAST 1/4 OF SECTION 13, TOWNSHIP 51 SOUTH, RANGE 41 EAST, BEING FURTHER DESCRIBED AS FOLLOWS:


COMMENCE AT THE SOUTHWEST CORNER OF THE SOUTHWEST 1/4 OF THE SOUTHWEST 1/4 OF THE SOUTHEAST 1/4 OF SAID SECTION 13; THENCE NORTH 02°30'30" WEST ALONG THE WEST LINE OF THE SOUTHWEST 1/4 OF THE SOUTHWEST 1/4 OF THE SOUTHEAST 1/4 A DISTANCE OF 35.03 FEET; THENCE NORTH 89°49'34" EAST, 100.80 FEET TO THE POINT OF BEGINNING; THENCE NORTH 34°03'00" WEST, 51.07 FEET ALONG THE EAST RIGHT-OF-WAY OF STATE ROAD NO. 7 (U.S. HIGHWAY 441) AS DESCRIBED IN THAT CERTAIN STATE OF FLORIDA DEPARTMENT OF TRANSPORTATION ORDER OF TAKING RECORDED IN OFFICIAL RECORDS BOOK 48998, PAGE 30, OF THE PUBLIC RECORDS OF BROWARD COUNTY, FLORIDA; THENCE CONTINUING ALONG SAID EAST RIGHT—OF—WAY LINE, NORTH 02°30'30" WEST, 198.72 FEET; THENCE CONTINUING ALONG SAID EAST RIGHT-OF-WAY LINE, NORTH 21°39'33" WEST, 6.28 FEET; THENCE NORTH 89°49'34" EAST, 198.04 FEET; THENCE SOUTH 02°30'30" EAST, 247.00 FEET TO THE NORTH RIGHT-OF-WAY LINE OF WASHINGTON STREET (70 FOOT RIGHT-OF-WAY): THENCE SOUTH 89°49'34" WEST, ALONG SAID NORTH RIGHT-OF-WAY LINE, 169.24 FEET TO THE POINT OF BEGINNING.

SAID LANDS LYING IN THE CITY OF HOLLYWOOD, BROWARD COUNTY, FLORIDA.

FOLIO NO. 5141-13-00-0162

LEGEND

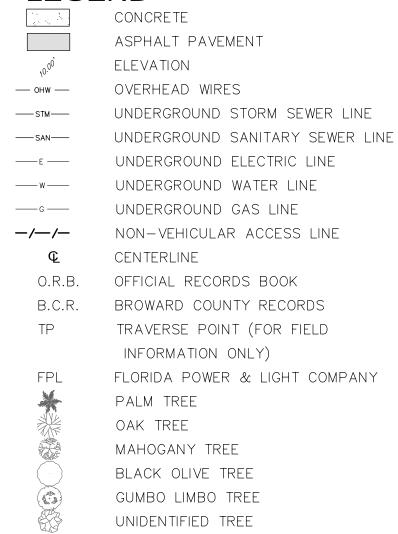

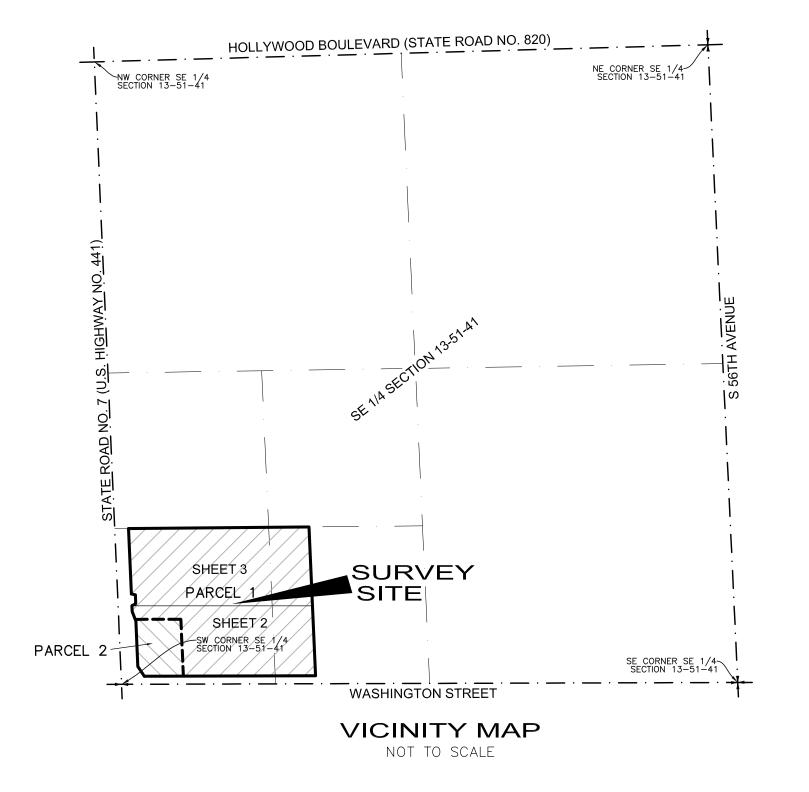

NOTES

- 1) THIS SITE CONTAINS A TOTAL AREA OF 498,953 SQUARE FEET (11.4544 ACRES), MORE OR LESS.
- 2) ELEVATIONS ARE BASED ON NORTH AMERICAN VERTICAL DATUM OF 1988. NATIONAL
- GEODETIC SURVEY BENCHMARK NO. S 312; ELEVATION: 8.60'.

 3) FLOOD ZONE: AH; BASE FLOOD ELEVATION: 10 FEET; PANEL #125113 0564H;
- MAP DATE: 8/18/14.
 4) THIS SITE LIES IN SECTION 13, TOWNSHIP 51 SOUTH, RANGE 41 EAST, BROWARD COUNTY,
- 5) BEARINGS ARE BASED ON THE NORTH RIGHT—OF—WAY LINE OF WASHINGTON STREET BEING S89°49'33"W.
- 6) REASONABLE EFFORTS WERE MADE REGARDING THE EXISTENCE AND THE LOCATION OF UNDERGROUND UTILITIES. THIS FIRM, HOWEVER, DOES NOT ACCEPT RESPONSIBILITY FOR THIS INFORMATION. BEFORE EXCAVATION OR CONSTRUCTION CONTACT THE APPROPRIATE UTILITY COMPANIES FOR FIELD VERIFICATION.
- 7) THE HORIZONTAL POSITIONAL ACCURACY OF WELL DEFINED IMPROVEMENTS ON THIS SURVEY IS ±0.07'. THE VERTICAL ACCURACY OF ELEVATIONS OF WELL DEFINED
- IMPROVEMENTS ON THIS SURVEY IS ± 0.07 '.
- 8) THIS SITE CONTAINS 562 TOTAL PARKING SPACES (549 REGULAR & 13 DISABLED).
 9) THIS SURVEY WAS PREPARED WITH BENEFIT OF CERTIFICATE OF SEARCH OWNERSHIP & ENCUMBRANCE REPORT FILE NUMBER: 5914770, PREPARED BY COMMONWEALTH LAND TITLE INSURANCE COMPANY, DATED THROUGH JULY 25, 2016 AT 6:00 A.M. THE FOLLOWING ITEMS ARE EASEMENTS, RIGHTS OF WAY AND OTHER MATTERS LISTED IN SAID REPORT:
- CANNOT BE PLOTTED.
 ITEM 2-NOTICE OF COMMENCEMENT IN INSTRUMENT NO. 113401650, AFFECTS THIS SITE BUT
- CANNOT BE PLOTTED.

 ITEM 3-NOTICE OF COMMENCEMENT IN INSTRUMENT NO. 113715765, AFFECTS THIS SITE BUT CANNOT BE PLOTTED.

ITEM 1-NOTICE OF COMMENCEMENT IN INSTRUMENT NO. 113164894, AFFECTS THIS SITE BUT

- ITEM 4-EASEMENT IN O.R.B. 952, PAGE 33, AFFECTS THIS SITE AS DEPICTED HEREON.
 ITEM 5-MEMORANDUM OF LEASE IN O.R.B. 3637, PAGE 630, AFFECTS THIS SITE BUT
- CANNOT BE PLOTTED.

 ITEM 6-AMENDMENT TO LEASE IN O.R.B. 3746, PAGE 544, IS NOT AVAILABLE FOR REVIEW.

 ITEM 7-AMENDED AND RESTATED MEMORANDUM OF LEASE IN O.R.B. 29402, PAGE 152,
- AFFECTS THIS SITE BUT CANNOT BE PLOTTED.

 ITEM 8-ORDINANCE NO. 2002-16 IN O.R.B. 34145, PAGE 1891, AFFECTS THIS SITE BUT
- CANNOT BE PLOTTED.

 ITEM 9—FIRST ADDENDUM TO AMENDED AND RESTATED LEASE IN O.R.B. 37341, PAGE 107,
- AFFECTS THIS SITE BUT CANNOT BE PLOTTED.

 ITEM 10—RECIPROCAL EASEMENT AGREEMENT IN O.R.B. 37341, PAGE 115, DEPICTED HEREON,

 AFFECTS THIS SITE BY PROVIDING ACCESS TO STATE ROAD 7
- AFFECTS THIS SITE BY PROVIDING ACCESS TO STATE ROAD 7.

 ITEM 11—ORDINANCE NO. 2009—13 IN O.R.B. 46117, PAGE 1638, AFFECTS THIS SITE BUT CANNOT BE PLOTTED.
- ITEM 12—RESOLUTION NO. 11—V—12 IN O.R.B. 47881, PAGE 1636, AFFECTS THIS SITE BUT CANNOT BE PLOTTED.
- ITEM 13-RESOLUTION NO. 11-V-12 IN O.R.B. 47939, PAGE 1096, AFFECTS THIS SITE BUT CANNOT BE PLOTTED.
- ITEM 14—SUBORDINATION OF UTILITY INTERESTS IN O.R.B. 48108, PAGE 1089, AFFECTS THIS SITE AS DEPICTED HEREON.
 ITEM 15—NOTICE OF LIS PENDENS IN O.R.B. 48678, PAGE 184, DOES NOT AFFECT THIS
- SITE.
 ITEM 16-RESOLUTION NO. 12-DV-02 IN O.R.B. 48723, PAGE 405, AFFECTS THIS SITE BUT
- CANNOT BE PLOTTED.

 ITEM 17-RESOLUTION NO. 12-DV-02 IN O.R.B. 48803, PAGE 844, AFFECTS THIS SITE BUT CANNOT BE PLOTTED.
- ITEM 18-TEMPORARY EASEMENT IN O.R.B. 48831, PAGE 1194, AFFECTS THIS SITE AS DEPICTED HEREON.
- ITEM 19-ORDER TO ALLOW WITHDRAWAL OF FUNDS IN O.R.B. 48926, PAGE 448, DOES NOT AFFECT THIS SITE.

 ITEM 20-ORDER OF TAKING IN O.R.B. 48998, PAGE 30, DEPICTED HEREON, DOES NOT
- AFFECT THIS SITE.

 ITEM 21-ASSIGNMENT OF RECIPROCAL EASEMENT AGREEMENT IN O.R.B. 50163, PAGE 1990,

 AFFECTS THIS SITE BY PROVIDING ACCESS TO STATE ROAD 7 BUT CANNOT BE PLOTTED.

 ITEM 22-CORRECTIVE ASSIGNMENT OF RECIPROCAL EASEMENT AGREEMENT IN O.R.B. 50216,
- PAGE 866, AFFECTS THIS SITE BY PROVIDING ACCESS TO STATE ROAD 7 BUT CANNOT BE PLOTTED.

 ITEM 23-EASEMENT IN O.R.B. 50806, PAGE 928, AFFECTS THIS SITE AS DEPICTED HEREON.

 ITEM 24-STIPULATED FINAL JUDGMENT IN O.R.B. 51260, PAGE 607, DEPICTED HEREON,
- DOES NOT AFFECT THIS SITE.
 ITEM 25-ASSIGNMENT OF EASEMENT AGREEMENT RIGHTS IN INSTRUMENT NO. 112752723
- AFFECTS THIS SITE BUT CAN NOT BE PLOTTED.
 ITEM 26-STIPULATED ORDER AS TO PARCEL 162 IN INSTRUMENT NO. 112915196, DEPICTED HEREON, DOES NOT AFFECT THIS SITE.
- HEREON, DOES NOT AFFECT THIS SITE.

 ITEM 27-MEMORANDUM OF LEASE IN INSTRUMENT NO. 112975159, AFFECTS THIS SITE BUT CANNOT BE PLOTTED.
- ITEM 28-STIPULATED ORDER IN INSTRUMENT NO. 113080364, DOES NOT AFFECT THIS SITE.


 10) THE LEGAL DESCRIPTION SHOWN HEREON HAS BEEN REVISED TO CORRECT ERRORS SHOWN IN THE ABOVE MENTIONED OPINION OF TITLE.

CERTIFICATION

TO: DACAR MANAGEMENT, LLC; COMMONWEALTH LAND TITLE INSURANCE COMPANY; DUNAY MISKEL BACKMAN LLP:
THIS IS TO CERTIFY THAT THIS MAP OR PLAT AND THE SURVEY ON WHICH IT IS BASED WERE MADE IN ACCORDANCE WITH THE 2016 MINIMUM STANDARD DETAIL REQUIREMENTS FOR ALTA/NSPS LAND TITLE SURVEYS, JOINTLY ESTABLISHED AND ADOPTED BY ALTA AND NSPS, AND INCLUDES ITEMS 1, 2, 3, 4, 7(a), 8, 9, & 11 OF TABLE A THEREOF.


NOT VALID WITHOUT THE SIGNATURE AND THE ORIGINAL RAISED SEAL OF A FLORIDA LICENSED SURVEYOR AND MAPPER.


□ JOHN F. PULICE, PROFESSIONAL SURVEYOR AND MAPPER LS2691
□ BETH BURNS, PROFESSIONAL SURVEYOR AND MAPPER LS6136
□ VICTOR R. GILBERT, PROFESSIONAL SURVEYOR AND MAPPER LS6274
STATE OF FLORIDA

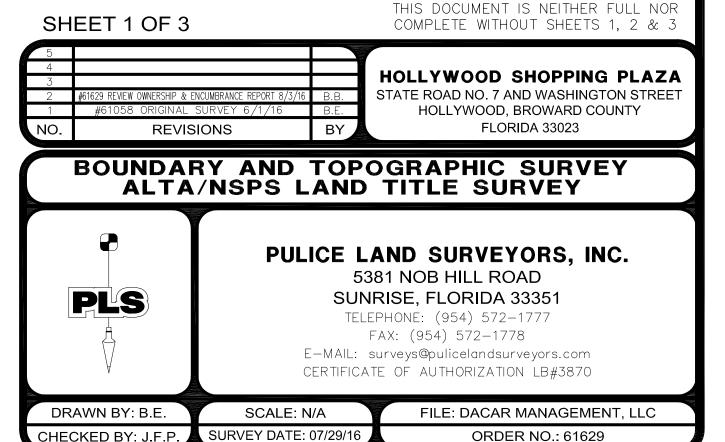

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TITLE EXCEPTION



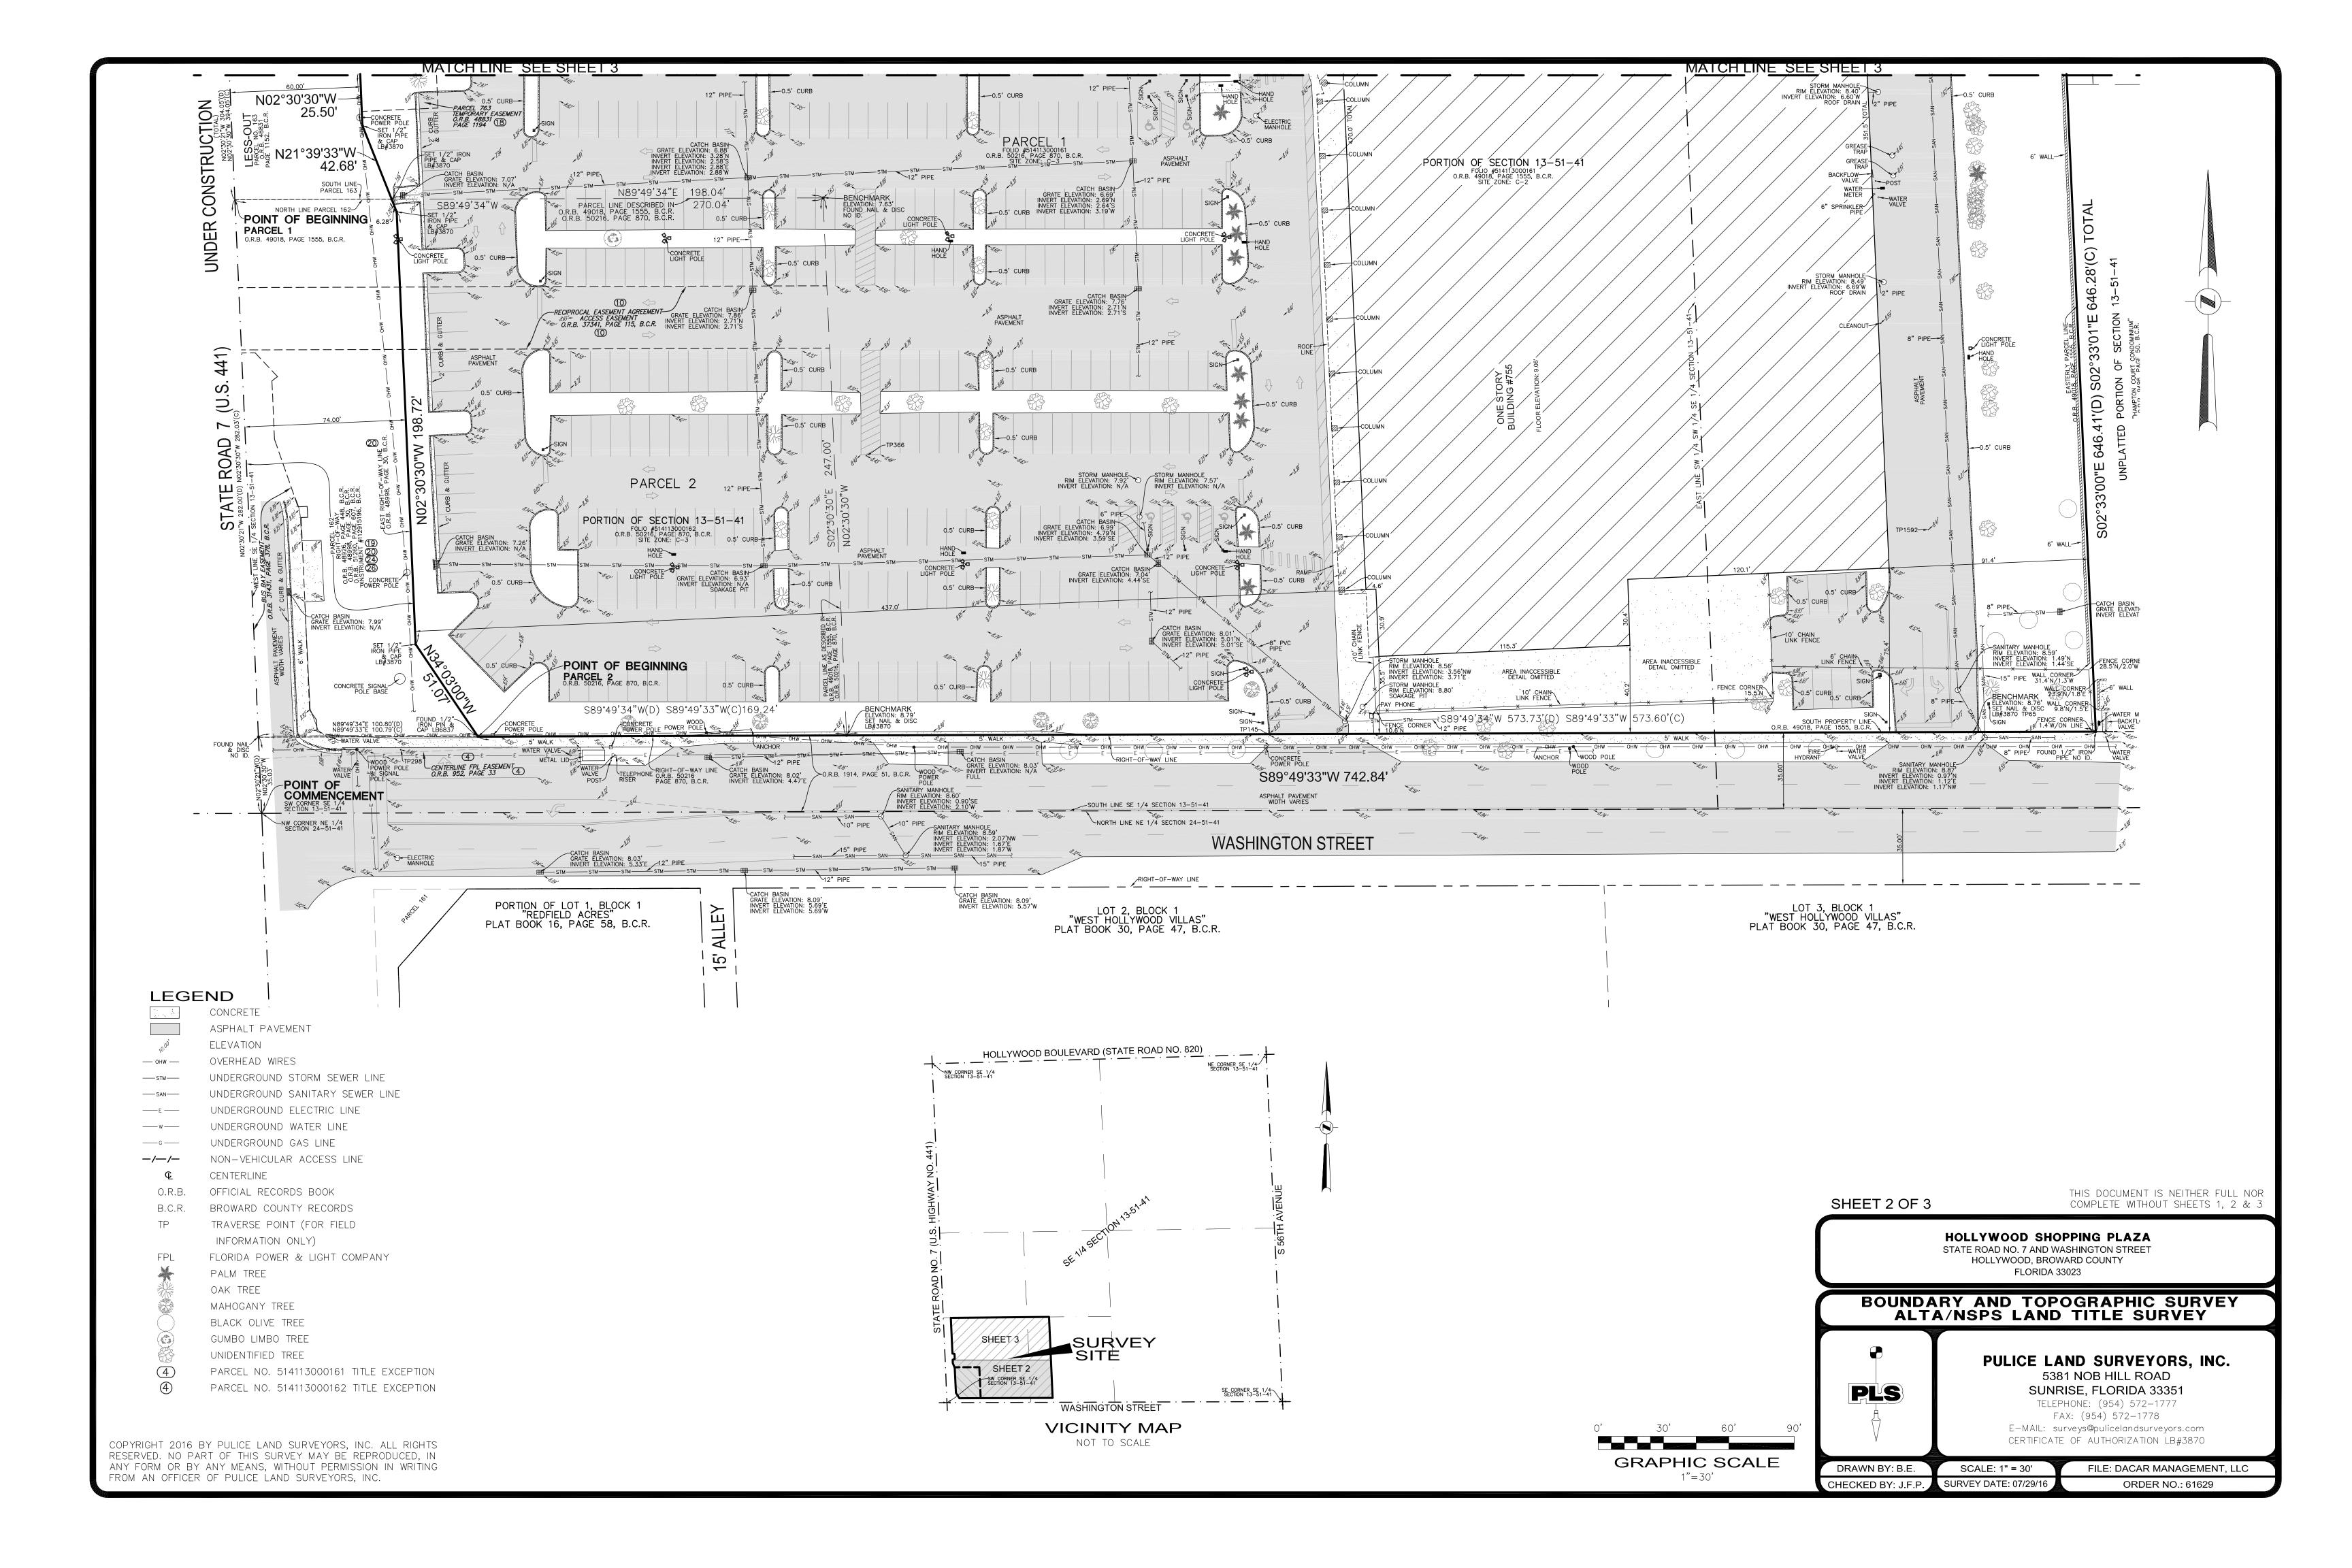

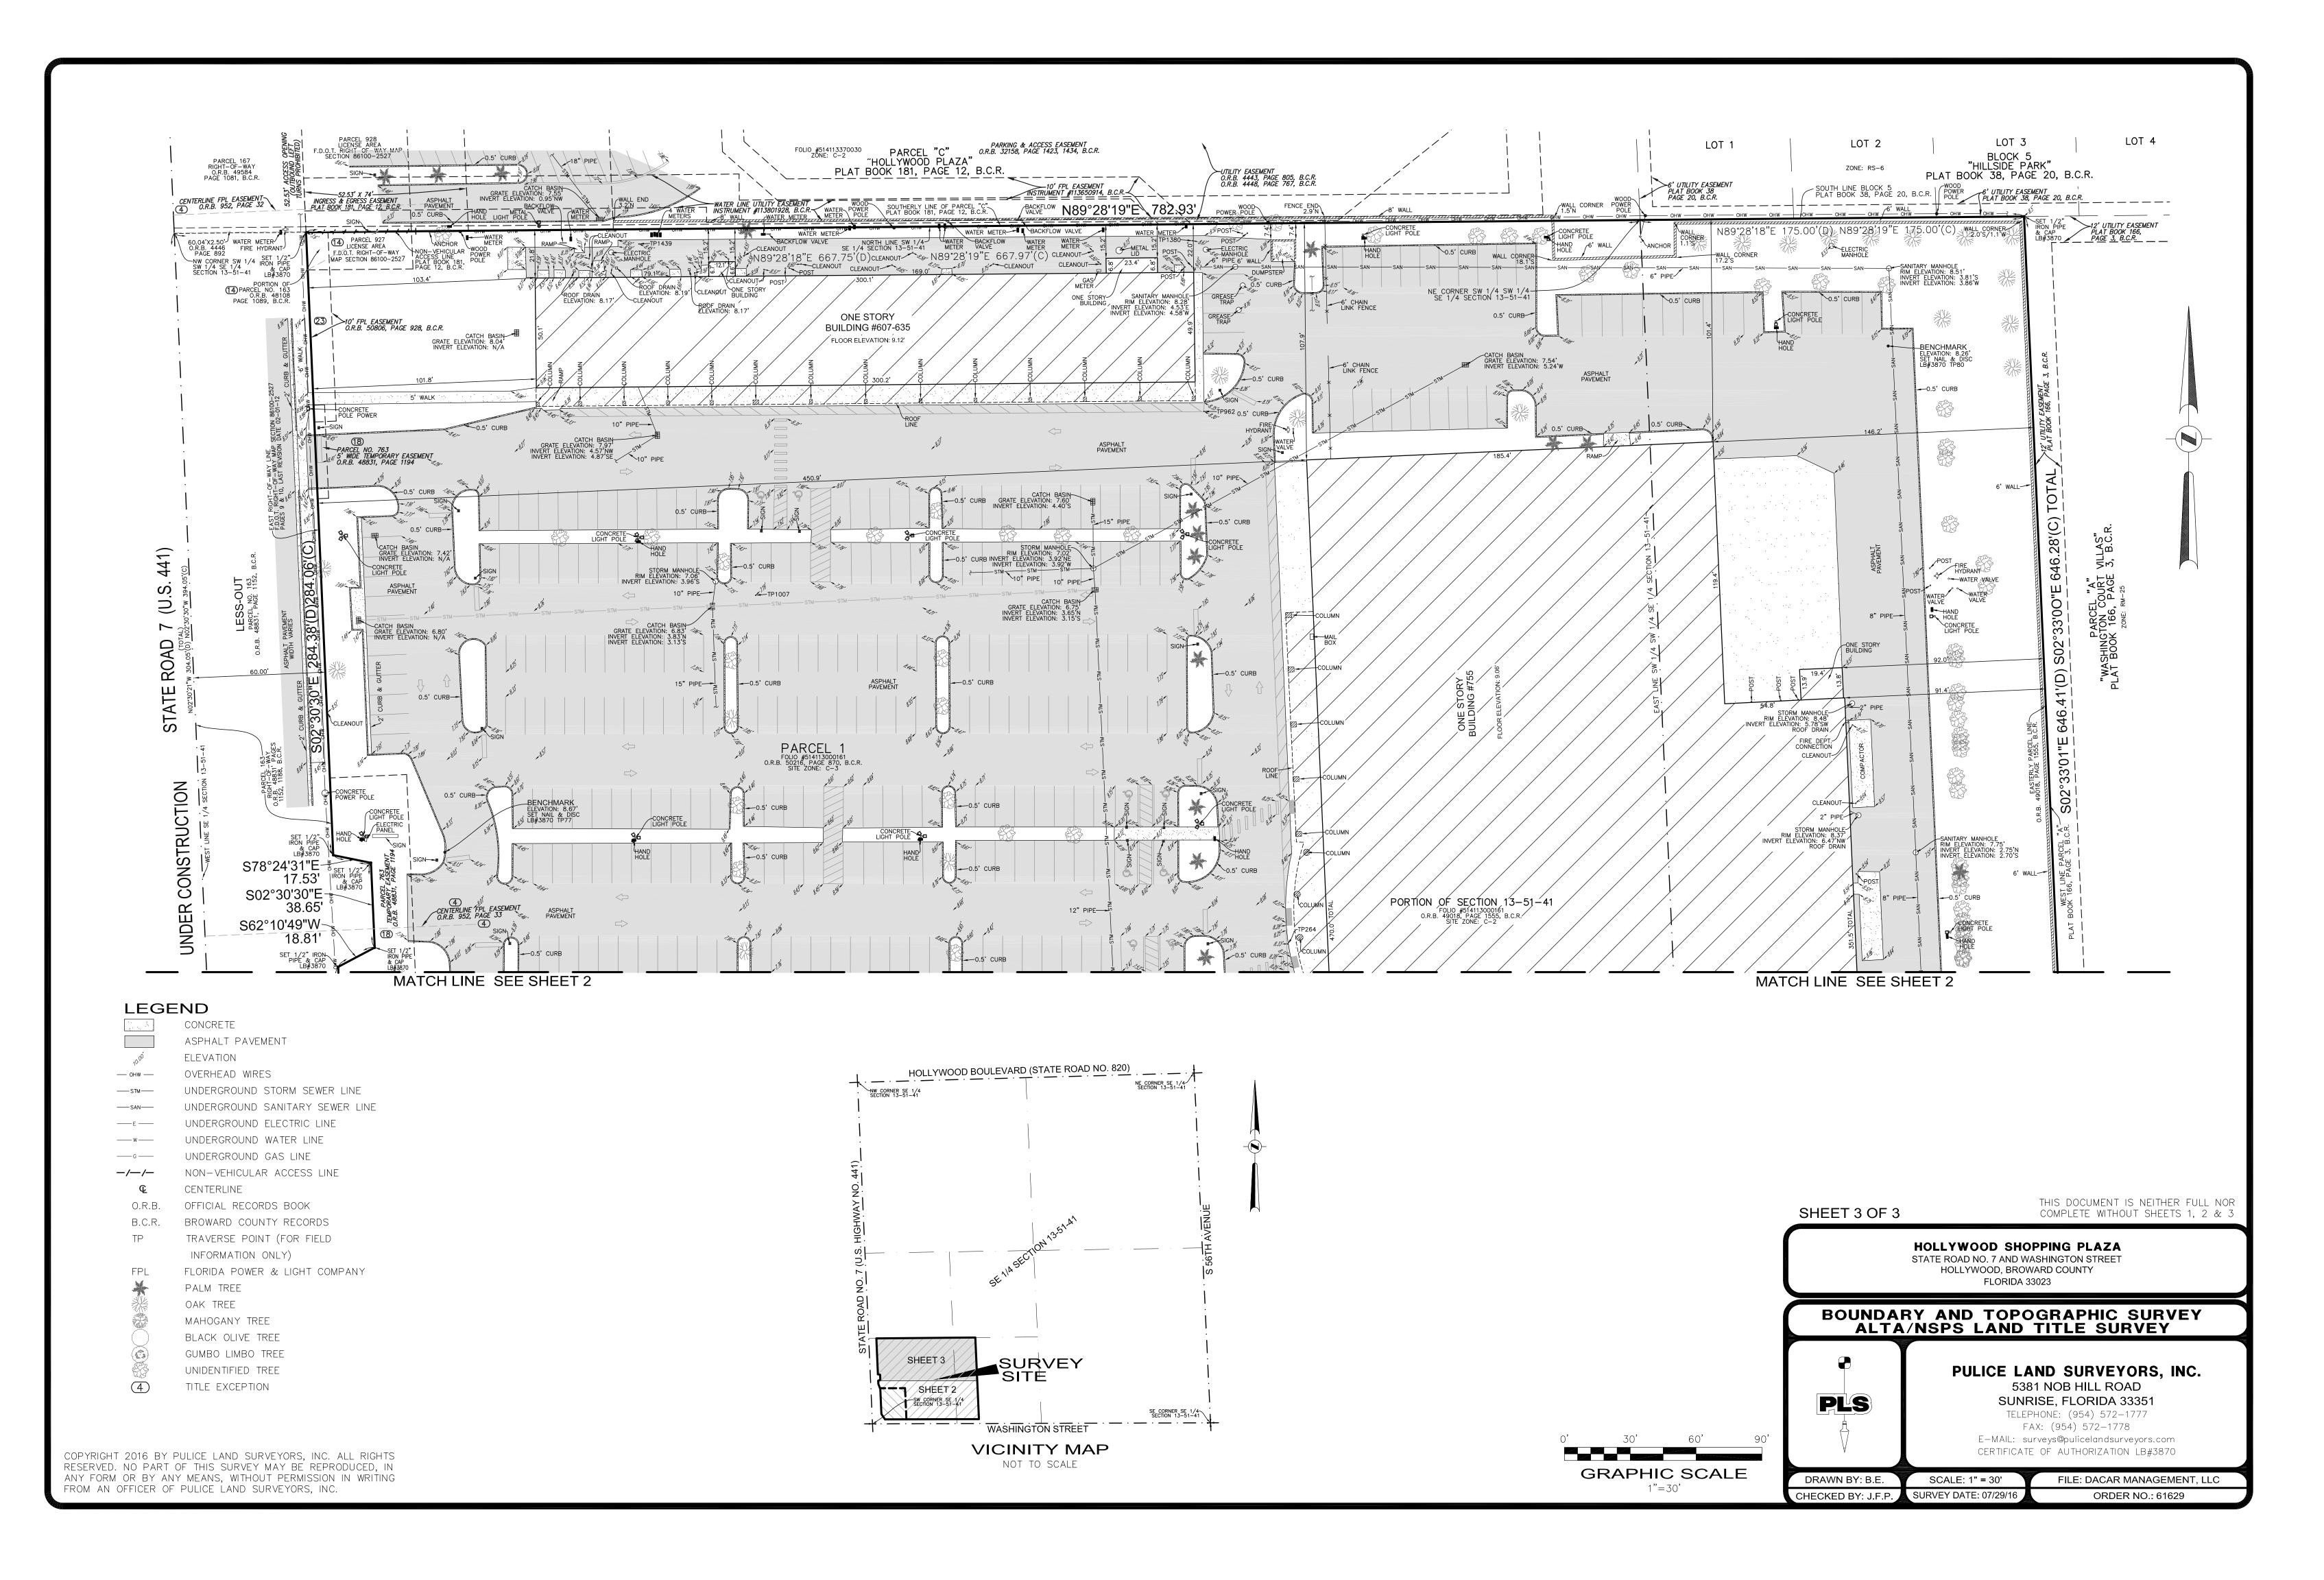- 1. THE CONTRACTOR AND SUBCONTRACTORS SHALL OBTAIN A COPY OF THE FLORIDA DEPARTMENT OF TRANSPORTATION "STANDARD SPECIFICATIONS FOR ROAD AND BRIDGE CONSTRUCTION" (LATEST EDITION) AND BECOME FAMILIAR WITH THE CONTENTS PRIOR TO COMMENCING WORK, AND, UNLESS OTHERWISE NOTED, ALL WORK SHALL CONFORM AS APPLICABLE TO THESE STANDARDS AND SPECIFICATIONS.
- 2. THE CONTRACTOR SHALL BE RESPONSIBLE FOR FURNISHING ALL MATERIAL AND LABOR TO CONSTRUCT THE FACILITY AS SHOWN AND DESCRIBED IN THE CONSTRUCTION DOCUMENTS IN ACCORDANCE WITH THE APPROPRIATE APPROVING AUTHORITIES, SPECIFICATIONS AND REQUIREMENTS. CONTRACTOR SHALL CLEAR AND GRUB ALL AREAS UNLESS OTHERWISE INDICATED, REMOVING TREES, STUMPS, ROOTS, MUCK, EXISTING PAVEMENT AND ALL OTHER DELETERIOUS MATERIAL.
- 3. EXISTING UTILITIES SHOWN ARE LOCATED ACCORDING TO THE INFORMATION AVAILABLE TO THE ENGINEER AT THE TIME OF THE TOPOGRAPHIC SURVEY AND HAVE NOT BEEN INDEPENDENTLY VERIFIED BY THE OWNER OR THE ENGINEER. GUARANTEE IS NOT MADE THAT ALL EXISTING UNDERGROUND UTILITIES ARE SHOWN OR THAT THE LOCATION OF THOSE SHOWN ARE ENTIRELY ACCURATE. FINDING THE ACTUAL LOCATION OF ANY EXISTING UTILITIES IS THE CONTRACTOR'S RESPONSIBILITY AND SHALL BE DONE BEFORE HE COMMENCES ANY WORK IN THE VICINITY. FURTHERMORE, THE CONTRACTOR SHALL BE FULLY RESPONSIBLE FOR ANY AND ALL DAMAGES DUE TO THE CONTRACTOR'S FAILURE TO EXACTLY LOCATE AND PRESERVE ANY AND ALL UNDERGROUND UTILITIES. THE OWNER OR ENGINEER WILL ASSUME NO LIABILITY FOR ANY DAMAGES SUSTAINED OR COST INCURRED BECAUSE OF THE OPERATIONS IN THE VICINITY OF EXISTING UTILITIES OR STRUCTURES. NOR FOR TEMPORARY BRACING AND SHORING OF SAME. IF IT IS NECESSARY TO SHORE, BRACE, SWING OR RELOCATE A UTILITY, THE UTILITY COMPANY OR DEPARTMENT AFFECTED SHALL BE CONTACTED AND THEIR PERMISSION OBTAINED REGARDING THE METHOD TO USE FOR SUCH WORK.
- 4. IT IS THE CONTRACTOR'S RESPONSIBILITY TO CONTACT THE VARIOUS UTILITY COMPANIES WHICH MAY HAVE BURIED OR AERIAL UTILITIES WITHIN OR NEAR THE CONSTRUCTION AREA BEFORE COMMENCING WORK. THE CONTRACTOR SHALL PROVIDE 48 HOURS MINIMUM NOTICE TO ALL UTILITY COMPANIES PRIOR TO BEGINNING CONSTRUCTION. A LIST OF THE UTILITY COMPANIES WHICH THE CONTRACTOR MUST CALL BEFORE COMMENCING WORK IS PROVIDED ON THE COVER SHEET OF THESE CONSTRUCTION PLANS. THIS LIST SERVES AS A GUIDE ONLY AND IS NOT INTENDED TO LIMIT THE UTILITY COMPANIES WHICH THE CONTRACTOR MAY WISH TO NOTIFY.
- 5. THE CONTRACTOR SHALL BE RESPONSIBLE FOR OBTAINING ALL REQUIRED CONSTRUCTION PERMITS AND BONDS IF REQUIRED PRIOR TO CONSTRUCTION.
- 6. THE CONTRACTOR SHALL HAVE AVAILABLE AT THE JOB SITE AT ALL TIMES ONE COPY OF THE CONSTRUCTION DOCUMENTS INCLUDING PLANS, SPECIFICATIONS, AND SPECIAL CONDITIONS AND COPIES OF ANY REQUIRED CONSTRUCTION PERMITS.
- 7. ANY DISCREPANCIES ON THE DRAWINGS SHALL BE IMMEDIATELY BROUGHT TO THE ATTENTION OF THE OWNER AND ENGINEER BEFORE COMMENCING WORK. NO FIELD CHANGES OR DEVIATIONS FROM DESIGN ARE TO BE MADE WITHOUT PRIOR APPROVAL OF THE OWNER AND NOTIFICATION TO THE ENGINEER.
- 8. ALL COPIES OF COMPACTION, CONCRETE AND OTHER REQUIRED TEST RESULTS ARE TO BE SENT TO THE OWNER AND DESIGN ENGINEER OF RECORD DIRECTLY FROM THE **TESTING AGENCY.**
- 9. THE CONTRACTOR SHALL BE RESPONSIBLE FOR SUBMITTING TO THE ENGINEER A CERTIFIED RECORD SURVEY SIGNED AND SEALED BY A PROFESSIONAL LAND SURVEYOR REGISTERED IN THE STATE OF FLORIDA DEPICTING THE ACTUAL FIELD LOCATION OF ALL CONSTRUCTED IMPROVEMENTS THAT ARE REQUIRED BY THE JURISDICTIONAL AGENCIES FOR THE CERTIFICATION PROCESS. ALL SURVEY COSTS WILL BE THE CONTRACTORS RESPONSIBILITY.
- 10. THE CONTRACTOR SHALL BE RESPONSIBLE FOR DOCUMENTING AND MAINTAINING AS-BUILT INFORMATION WHICH SHALL BE RECORDED AS CONSTRUCTION PROGRESSES OR AT THE COMPLETION OF APPROPRIATE CONSTRUCTION INTERVALS AND SHALL BE RESPONSIBLE FOR PROVIDING AS-BUILT DRAWINGS TO THE OWNER FOR THE PURPOSE OF CERTIFICATION TO JURISDICTIONAL AGENCIES AS REQUIRED. ALL AS-BUILT DATA SHALL BE COLLECTED BY A STATE OF FLORIDA PROFESSIONAL LAND SURVEYOR WHOSE SERVICES ARE ENGAGED BY THE CONTRACTOR.
- 11. ANY WELLS DISCOVERED ON SITE THAT WILL HAVE NO USE MUST BE PLUGGED BY A LICENSED WELL DRILLING CONTRACTOR IN A MANNER APPROVED BY ALL JURISDICTIONAL AGENCIES. CONTRACTOR SHALL BE RESPONSIBLE FOR OBTAINING ANY WELL ABANDONMENT PERMITS REQUIRED.
- 12. ANY WELL DISCOVERED DURING EARTH MOVING OR EXCAVATION SHALL BE REPORTED TO THE APPROPRIATE JURISDICTIONAL AGENCIES WITHIN 24 HOURS AFTER DISCOVERY IS MADE.
- 13. THE CONTRACTOR SHALL BE RESPONSIBLE FOR VERIFYING THAT THE PROPOSED IMPROVEMENTS SHOWN ON THE PLANS DO NOT CONFLICT WITH ANY KNOWN EXISTING OR OTHER PROPOSED IMPROVEMENTS. IF ANY CONFLICTS ARE DISCOVERED, THE CONTRACTOR SHALL NOTIFY THE OWNER PRIOR TO INSTALLATION OF ANY PORTION OF THE SITE WORK THAT WOULD BE AFFECTED. FAILURE TO NOTIFY OWNER OF AN IDENTIFIABLE CONFLICT PRIOR TO PROCEEDING WITH INSTALLATION RELIEVES OWNER OF ANY OBLIGATION TO PAY FOR A RELATED CHANGE ORDER.

DEMOLITION NOTES

- 1. ALL MATERIAL REMOVED FROM THIS SITE BY THE CONTRACTOR SHALL BE DISPOSED OF BY THE CONTRACTOR IN A LEGAL MANNER.
- 2. REFER TO THE TOPOGRAPHIC SURVEY FOR ADDITIONAL DETAILS OF EXISTING STRUCTURES, ETC., LOCATED WITHIN THE PROJECT SITE. UNLESS OTHERWISE NOTED, ALL EXISTING BUILDINGS, STRUCTURES, SLABS, CONCRETE, ASPHALT, DEBRIS PILES, SIGNS, AND ALL APPURTENANCES ARE TO BE REMOVED FROM THE SITE BY THE CONTRACTOR AND PROPERLY DISPOSED OF IN A LEGAL MANNER AS PART OF THIS CONTRACT. SOME ITEMS TO BE REMOVED MAY NOT BE DEPICTED ON THE TOPOGRAPHIC SURVEY. IT IS THE CONTRACTOR'S RESPONSIBILITY TO VISIT THE SITE AND DETERMINE THE FULL EXTENT OF ITEMS TO BE REMOVED. IF ANY ITEMS ARE IN QUESTION, THE CONTRACTOR SHALL CONTACT THE OWNER PRIOR TO REMOVAL OF SAID ITEMS.
- 3. THE CONTRACTOR SHALL REFER TO THE DEMOLITION PLAN FOR DEMOLITION/PRESERVATION OF EXISTING TREES. ALL TREES NOT SPECIFICALLY SHOWN TO BE PRESERVED OR RELOCATED SHALL BE REMOVED AS A PART OF THIS CONTRACT. TREE PROTECTION FENCING SHALL BE INSTALLED PRIOR TO ANY DEMOLITION.

PAVING, GRADING AND DRAINAGE NOTES

- 1. ALL PAVING, CONSTRUCTION, MATERIALS, AND WORKMANSHIP WITHIN COUNTY'S RIGHT-OF-WAY SHALL BE IN ACCORDANCE WITH LOCAL OR COUNTY SPECIFICATIONS AND STANDARDS (LATEST EDITION) OR FDOT SPECIFICATIONS AND STANDARDS (LATEST EDITION) IF NOT COVERED BY LOCAL OR COUNTY REGULATIONS.
- 2. ALL UNPAVED AREAS IN EXISTING RIGHTS-OF-WAY DISTURBED BY CONSTRUCTION SHALL BE REGRADED AND SODDED.
- 3. TRAFFIC CONTROL ON ALL FDOT, LOCAL AND COUNTY RIGHTS-OF-WAY SHALL MEET THE REQUIREMENTS OF THE MANUAL OF UNIFORM TRAFFIC CONTROL DEVICES (U.S. DOT/FHA) AND THE REQUIREMENTS OF THE STATE AND ANY LOCAL AGENCY HAVING JURISDICTION. IN THE EVENT THAT THE CONTRACT DOCUMENTS AND THE JURISDICTIONAL AGENCY REQUIREMENTS ARE NOT IN AGREEMENT, THE MOST STRINGENT SHALL GOVERN.
- 4. THE CONTRACTOR SHALL GRADE THE SITE TO THE ELEVATIONS INDICATED AND SHALL REGRADE WASHOUTS WHERE THEY OCCUR AFTER EVERY RAINFALL UNTIL A GRASS STAND IS WELL ESTABLISHED OR ADEQUATE STABILIZATION OCCURS.
- 5. ALL OPEN AREAS WITHIN THE PROJECT SITE SHALL BE SODDED UNLESS INDICATED OTHERWISE ON THE LANDSCAPE PLAN.
- 6. ALL AREAS INDICATED AS PAVEMENT SHALL BE CONSTRUCTED IN ACCORDANCE WITH THE TYPICAL PAVEMENT SECTIONS AS INDICATED ON THE DRAWINGS.
- 7. WHERE EXISTING PAVEMENT IS INDICATED TO BE REMOVED AND REPLACED, THE CONTRACTOR SHALL SAW CUT A MINIMUM 2" DEEP FOR A SMOOTH AND STRAIGHT JOINT AND REPLACE THE PAVEMENT WITH THE SAME TYPE AND DEPTH OF MATERIAL AS EXISTING OR AS INDICATED.
- WHERE NEW PAVEMENT MEETS THE EXISTING PAVEMENT, THE CONTRACTOR SHALL SAW CUT THE EXISTING PAVEMENT A MINIMUM 2" DEEP FOR A SMOOTH AND STRAIGHT JOINT AND MATCH THE EXISTING PAVEMENT ELEVATION WITH THE PROPOSED PAVEMENT UNLESS OTHERWISE INDICATED.
- 9. THE CONTRACTOR SHALL INSTALL FILTER FABRIC OVER ALL DRAINAGE STRUCTURES FOR THE DURATION OF CONSTRUCTION AND UNTIL ACCEPTANCE OF THE PROJECT BY THE OWNER. ALL DRAINAGE STRUCTURES SHALL BE CLEANED OF DEBRIS AS REQUIRED DURING AND AT THE END OF CONSTRUCTION TO PROVIDE POSITIVE DRAINAGE FLOWS.
- 10. IF DEWATERING IS REQUIRED, THE CONTRACTOR SHALL OBTAIN ANY APPLICABLE REQUIRED PERMITS. THE CONTRACTOR IS TO COORDINATE WITH THE OWNER AND THE DESIGN ENGINEER PRIOR TO ANY EXCAVATION.
- 11. STRIP TOPSOIL AND ORGANIC MATTER FROM ALL AREAS OF THE SITE AS REQUIRED. IN SOME CASES TOPSOIL MAY BE STOCKPILED ON SITE FOR PLACEMENT WITHIN LANDSCAPED AREAS BUT ONLY AS DIRECTED BY THE OWNER.
- 12. FIELD DENSITY TESTS SHALL BE TAKEN AT INTERVALS IN ACCORDANCE WITH THE LOCAL JURISDICTIONAL AGENCY OR TO FDOT STANDARDS. IN THE EVENT THAT THE CONTRACT DOCUMENTS AND THE JURISDICTIONAL AGENCY REQUIREMENTS ARE NOT IN AGREEMENT, THE MOST STRINGENT SHALL GOVERN.
- 13. ALL SLOPES AND AREAS DISTURBED BY CONSTRUCTION SHALL BE GRADED AS PER PLANS. THE AREAS SHALL THEN BE SODDED OR SEEDED AS SPECIFIED IN THE PLANS, FERTILIZED. MULCHED. WATERED AND MAINTAINED UNTIL HARDY GRASS GROWTH IS ESTABLISHED IN ALL AREAS. ANY AREAS DISTURBED FOR ANY REASON PRIOR TO FINAL ACCEPTANCE OF THE JOB SHALL BE CORRECTED BY THE CONTRACTOR AT NO ADDITIONAL COST TO THE OWNER. ALL EARTHEN AREAS WILL BE SODDED OR SEEDED AND MULCHED AS SHOWN ON THE LANDSCAPING PLAN.
- 14. ALL CUT OR FILL SLOPES SHALL BE 4 (HORIZONTAL) :1 (VERTICAL) OR FLATTER UNLESS OTHERWISE SHOWN.
- 15. THE CONTRACTOR SHALL BE RESPONSIBLE FOR THE CONTROL OF DUST AND DIRT RISING AND SCATTERING IN THE AIR DURING CONSTRUCTION AND SHALL PROVIDE WATER SPRINKLING OR OTHER SUITABLE METHODS OF CONTROL. THE CONTRACTOR SHALL COMPLY WITH ALL GOVERNING REGULATIONS PERTAINING TO ENVIRONMENTAL PROTECTION.
- 16. THE CONTRACTOR SHALL TAKE ALL REQUIRED MEASURES TO CONTROL TURBIDITY INCLUDING BUT NOT LIMITED TO THE INSTALLATION OF TURBIDITY BARRIERS AT ALL LOCATIONS WHERE THE POSSIBILITY OF TRANSFERRING SUSPENDED SOLIDS INTO THE RECEIVING WATER BODY EXISTS DUE TO THE PROPOSED WORK. TURBIDITY BARRIERS MUST BE MAINTAINED IN EFFECTIVE CONDITION AT ALL LOCATIONS UNTIL CONSTRUCTION IS COMPLETED AND DISTURBED SOIL AREAS ARE STABILIZED. THEREAFTER, THE CONTRACTOR MUST REMOVE THE BARRIERS. AT NO TIME SHALL THERE BE ANY OFF-SITE DISCHARGE WHICH VIOLATES THE WATER QUALITY STANDARDS IN CHAPTER 17-302, FLORIDA ADMINISTRATIVE CODE.
- 17. SOD, WHERE CALLED FOR, MUST BE INSTALLED AND MAINTAINED ON EXPOSED SLOPES WITHIN 48 HOURS OF COMPLETING FINAL GRADING, AND AT ANY OTHER TIME AS NECESSARY, TO PREVENT EROSION, SEDIMENTATION OR TURBID DISCHARGES.
- 18. THE CONTRACTOR MUST REVIEW AND MAINTAIN A COPY OF THE ENVIRONMENTAL RESOURCE PERMIT COMPLETE WITH ALL CONDITIONS, ATTACHMENTS, EXHIBITS, AND PERMIT MODIFICATIONS IN GOOD CONDITION AT THE CONSTRUCTION SITE. THE COMPLETE PERMIT MUST BE AVAILABLE FOR REVIEW UPON REQUEST BY WATER MANAGEMENT DISTRICT REPRESENTATIVES.
- 19. THE CONTRACTOR SHALL ENSURE THAT ISLAND PLANTING AREAS AND OTHER PLANTING AREAS ARE NOT COMPACTED AND DO NOT CONTAIN ROAD BASE MATERIALS. THE CONTRACTOR SHALL ALSO EXCAVATE AND REMOVE ALL UNDESIRABLE MATERIAL FROM ALL AREAS ON THE SITE TO BE PLANTED AND PROPERLY DISPOSED OF IN A LEGAL
- 20. THE CONTRACTOR SHALL INSTALL ALL UNDERGROUND STORM WATER PIPING PER MANUFACTURER'S RECOMMENDATIONS.

RECORD DRAWINGS

1. CONTRACTOR SHALL PROVIDE TO THE ENGINEER AND OWNER A MINIMUM OF 10 HARD COPIES OF A PAVING, GRADING AND DRAINAGE RECORD DRAWING AND A SEPARATE UTILITY RECORD DRAWING, AS WELL AS BOTH IN AUTOCAD 2012 OR LATER, BOTH PREPARED BY A FLORIDA REGISTERED SURVEYOR. THE RECORD DRAWINGS SHALL VERIFY ALL DESIGN INFORMATION INCLUDED ON THE DESIGN PLANS OF THE SAME

WATER AND SEWER UTILITY NOTES

- 1. THE CONTRACTOR SHALL CONSTRUCT GRAVITY SEWER LATERALS, MANHOLES GRAVITY SEWER LINES AND DOMESTIC WATER AND FIRE PROTECTION SYSTEM AS SHOWN ON THESE PLANS. THE CONTRACTOR SHALL FURNISH ALL NECESSARY MATERIALS, EQUIPMENT, MACHINERY, TOOLS, MEANS OF TRANSPORTATION AND LABOR NECESSARY TO COMPLETE THE WORK IN FULL AND COMPLETE ACCORDANCE WITH THE SHOWN, DESCRIBED AND REASONABLY INTENDED REQUIREMENTS OF THE CONTRACT DOCUMENTS AND JURISDICTIONAL AGENCY REQUIREMENTS. IN THE EVENT THAT THE CONTRACT DOCUMENTS AND THE JURISDICTIONAL AGENCY REQUIREMENTS ARE NOT IN AGREEMENT, THE MOST STRINGENT SHALL GOVERN.
- 2. ALL EXISTING UNDERGROUND UTILITY LOCATIONS SHOWN ARE APPROXIMATE. THE CONTRACTOR SHALL COMPLY WITH ALL REQUIREMENTS FOR UTILITY LOCATION AND COORDINATION IN ACCORDANCE WITH THE NOTES CONTAINED IN THE GENERAL CONSTRUCTION SECTION OF THIS SHEET.
- 3. THE CONTRACTOR SHALL RESTORE ALL DISTURBED VEGETATION IN KIND, UNLESS SHOWN OTHERWISE.
- 4. DEFLECTION OF PIPE JOINTS AND CURVATURE OF PIPE SHALL NOT EXCEED THE MANUFACTURER'S SPECIFICATIONS. SECURELY CLOSE ALL OPEN ENDS OF PIPE AND FITTINGS WITH A WATERTIGHT PLUG WHEN WORK IS NOT IN PROGRESS. THE INTERIOR OF ALL PIPES SHALL BE CLEAN AND JOINT SURFACES WIPED CLEAN AND DRY AFTER THE PIPE HAS BEEN LOWERED INTO THE TRENCH. VALVES SHALL BE PLUMB AND LOCATED ACCORDING TO THE PLANS.
- 5. ALL PHASES OF INSTALLATION, INCLUDING UNLOADING, TRENCHING, LAYING AND BACK FILLING, SHALL BE DONE IN A FIRST CLASS WORKMANLIKE MANNER. ALL PIPE AND FITTINGS SHALL BE CAREFULLY STORED FOLLOWING MANUFACTURER'S RECOMMENDATIONS. CARE SHALL BE TAKEN TO AVOID DAMAGE TO THE COATING OR LINING IN ANY D.I. PIPE FITTINGS. ANY PIPE OR FITTING WHICH IS DAMAGED OR WHICH HAS FLAWS OR IMPERFECTIONS WHICH, IN THE OPINION OF THE ENGINEER OR OWNER, RENDERS IT UNFIT FOR USE, SHALL NOT BE USED. ANY PIPE NOT SATISFACTORY FOR USE SHALL BE CLEARLY MARKED AND IMMEDIATELY REMOVED FROM THE JOB SITE, AND SHALL BE REPLACED AT THE CONTRACTOR'S EXPENSE.
- 6. WATER FOR FIRE FIGHTING SHALL BE AVAILABLE FOR USE PRIOR TO COMBUSTIBLES BEING BROUGHT ON SITE.
- 7. ALL UTILITY AND STORM DRAIN TRENCHES LOCATED UNDER AREAS TO RECEIVE PAVING SHALL BE COMPLETELY BACK FILLED IN ACCORDANCE WITH THE GOVERNING JURISDICTIONAL AGENCY'S SPECIFICATIONS. IN THE EVENT THAT THE CONTRACT DOCUMENTS AND THE JURISDICTIONAL AGENCY REQUIREMENTS ARE NOT IN AGREEMENT, THE MOST STRINGENT SHALL GOVERN.
- 8. UNDERGROUND LINES SHALL BE SURVEYED BY A STATE OF FLORIDA PROFESSIONAL LAND SURVEYOR PRIOR TO BACK FILLING.
- 9. CONTRACTOR SHALL PERFORM, AT HIS OWN EXPENSE, ANY AND ALL TESTS REQUIRED BY THE SPECIFICATIONS AND/OR ANY AGENCY HAVING JURISDICTION. THESE TESTS MAY INCLUDE, BUT MAY NOT BE LIMITED TO, INFILTRATION AND EXFILTRATION, TELEVISION INSPECTION AND A MANDREL TEST ON GRAVITY SEWER. A COPY OF THE TEST RESULTS SHALL BE PROVIDED TO THE UTILITY PROVIDER, OWNER AND JURISDICTIONAL AGENCY AS REQUIRED.

EROSION CONTROL NOTES

- 1. THE STORM WATER POLLUTION PREVENTION PLAN ("SWPPP") IS COMPRISED OF THE EROSION CONTROL PLAN, THE STANDARD DETAILS.
- 2. ALL CONTRACTORS AND SUBCONTRACTORS INVOLVED WITH STORM WATER POLLUTION PREVENTION SHALL OBTAIN A COPY OF THE STORM WATER POLLUTION PREVENTION PLAN AND THE STATE OF FLORIDA NATIONAL POLLUTANT DISCHARGE ELIMINATION SYSTEM GENERAL PERMIT (NPDES PERMIT) AND BECOME FAMILIAR WITH THEIR CONTENTS.
- 3. THE CONTRACTOR SHALL IMPLEMENT BEST MANAGEMENT PRACTICES AS REQUIRED BY THE SWPPP. ADDITIONAL BEST MANAGEMENT PRACTICES SHALL BE IMPLEMENTED AS DICTATED BY CONDITIONS AT NO ADDITIONAL COST TO THE OWNER THROUGHOUT ALL PHASES OF CONSTRUCTION.
- 4. BEST MANAGEMENT PRACTICES (BMP'S) AND CONTROLS SHALL CONFORM TO FEDERAL, STATE, OR LOCAL REQUIREMENTS OR MANUAL OF PRACTICE, AS APPLICABLE. THE CONTRACTOR SHALL IMPLEMENT ADDITIONAL CONTROLS AS DIRECTED BY THE PERMITTING AGENCY OR OWNER.
- 5. EROSION CONTROL PLAN MUST CLEARLY DELINEATE ALL STATE WATERS. PERMITS FOR ANY CONSTRUCTION ACTIVITY IMPACTING STATE WATERS OR REGULATED WETLANDS MUST BE MAINTAINED ON SITE AT ALL TIMES.
- 6. THE CONTRACTOR SHALL MINIMIZE CLEARING TO THE MAXIMUM EXTENT PRACTICAL OR AS REQUIRED BY THE GENERAL PERMIT.
- 7. CONTRACTOR SHALL DENOTE ON PLAN THE TEMPORARY PARKING AND STORAGE AREA WHICH SHALL ALSO BE USED AS THE EQUIPMENT MAINTENANCE AND CLEANING AREA, EMPLOYEE PARKING AREA, AND AREA FOR LOCATING PORTABLE FACILITIES, OFFICE TRAILERS, AND TOILET FACILITIES.
- 8. ALL WASH WATER (CONCRETE TRUCKS, VEHICLE CLEANING, EQUIPMENT CLEANING, ETC.) SHALL BE DETAINED AND PROPERLY TREATED OR DISPOSED.
- 9. SUFFICIENT OIL AND GREASE ABSORBING MATERIALS AND FLOTATION BOOMS SHALL BE MAINTAINED ON SITE OR READILY AVAILABLE TO CONTAIN AND CLEAN-UP FUEL OR CHEMICAL SPILLS AND LEAKS.
- 10. THE CONTRACTOR SHALL BE RESPONSIBLE FOR DUST CONTROL ON SITE. THE USE OF MOTOR OILS AND OTHER PETROLEUM BASED OR TOXIC LIQUIDS FOR DUST SUPPRESSION OPERATIONS IS PROHIBITED.
- 11. RUBBISH, TRASH, GARBAGE, LITTER, OR OTHER SUCH MATERIALS SHALL BE DEPOSITED INTO SEALED CONTAINERS. MATERIALS SHALL BE PREVENTED FROM LEAVING THE PREMISES THROUGH THE ACTION OF WIND OR STORM WATER DISCHARGE INTO DRAINAGE DITCHES OR WATERS OF THE STATE.
- 12. ALL STORM WATER POLLUTION PREVENTION MEASURES PRESENTED ON THE PLAN, SHALL BE INITIATED AS SOON AS PRACTICABLE.

EROSION CONTROL NOTES (CONT.)

- 13. STABILIZATION PRACTICES SHOULD BE INITIATED AS SOON AS PRACTICAL, BUT IN NO CASE MORE THAN 7 DAYS WHERE CONSTRUCTION HAS TEMPORARILY CEASED.
- 14. DISTURBED PORTIONS OF THE SITE WHERE CONSTRUCTION ACTIVITY HAS PERMANENTLY STOPPED SHALL BE PERMANENTLY SEEDED. THESE AREAS SHALL BE SEEDED NO LATER THAN 7 DAYS AFTER THE LAST CONSTRUCTION ACTIVITY OCCURRED IN THESE AREAS. REFER TO SECTION 981 OF THE STANDARD SPECIFICATIONS FOR SEEDING AND MAINTENANCE REQUIREMENTS.
- 15. IF THE ACTION OF VEHICLES TRAVELING OVER THE GRAVEL CONSTRUCTION ENTRANCES IS NOT SUFFICIENT TO REMOVE THE MAJORITY OF DIRT OR MUD, THEN THE TIRES MUST BE WASHED BEFORE THE VEHICLES ENTER A PUBLIC ROAD. IF WASHING IS USED, PROVISIONS MUST BE MADE TO INTERCEPT THE WASH WATER AND TRAP THE SEDIMENT BEFORE IT IS CARRIED OFF THE SITE.
- 16. ALL MATERIALS SPILLED, DROPPED, WASHED, OR TRACKED FROM VEHICLES ONTO ROADWAYS OR INTO STORM DRAINS MUST BE REMOVED AS SOON AS POSSIBLE.
- 17. THE CONTRACTOR SHALL BE RESPONSIBLE FOR REMOVING SEDIMENT IN THE DETENTION POND AND ANY SEDIMENT THAT MAY HAVE COLLECTED IN THE STORM SEWER DRAINAGE SYSTEMS IN CONJUNCTION WITH THE STABILIZATION OF THE SITE.
- 18. ON-SITE & OFF SITE SOIL STOCKPILE AND BORROW AREAS SHALL BE PROTECTED FROM EROSION AND SEDIMENTATION THROUGH IMPLEMENTATION OF BEST MANAGEMENT PRACTICES. STOCKPILE AND BORROW AREA LOCATIONS SHALL BE NOTED ON THE EROSION CONTROL PLAN AND PERMITTED IN ACCORDANCE WITH GENERAL PERMIT REQUIREMENTS.
- 19. SLOPES SHALL BE LEFT IN A ROUGHENED CONDITION DURING THE GRADING PHASE TO REDUCE RUNOFF VELOCITIES AND EROSION.
- 20. DUE TO GRADE CHANGES DURING THE DEVELOPMENT OF THE PROJECT, THE CONTRACTOR SHALL BE RESPONSIBLE FOR ADJUSTING THE EROSION CONTROL MEASURES (SILT FENCES, ETC.) TO PREVENT EROSION.
- 21. ALL CONSTRUCTION SHALL BE STABILIZED AT THE END OF EACH WORKING DAY, THIS INCLUDES BACK FILLING OF TRENCHES FOR UTILITY CONSTRUCTION AND PLACEMENT OF GRAVEL OR BITUMINOUS PAVING FOR ROAD CONSTRUCTION.

MAINTENANCE

ALL MEASURES STATED ON THE EROSION AND SEDIMENT CONTROL PLAN, AND IN THE STORM WATER POLLUTION PREVENTION PLAN, SHALL BE MAINTAINED IN FULLY FUNCTIONAL CONDITION UNTIL NO LONGER REQUIRED FOR A COMPLETED PHASE OF WORK OR FINAL STABILIZATION OF THE SITE. ALL EROSION AND SEDIMENTATION CONTROL MEASURES SHALL BE CHECKED BY A QUALIFIED PERSON AT LEAST ONCE EVERY SEVEN CALENDAR DAYS AND WITHIN 24 HOURS OF THE END OF A 0.5" RAINFALL EVENT, AND CLEANED AND REPAIRED IN ACCORDANCE WITH THE FOLLOWING:

- 1. INLET PROTECTION DEVICES AND BARRIERS SHALL BE REPAIRED OR REPLACED IF THEY SHOW SIGNS OF UNDERMINING, OR DETERIORATION.
- 2. ALL SEEDED AREAS SHALL BE CHECKED REGULARLY TO SEE THAT A GOOD STAND IS MAINTAINED. AREAS SHOULD BE FERTILIZED, WATERED AND RESEEDED AS NEEDED. FOR MAINTENANCE REQUIREMENTS REFER TO SECTION 981 OF THE OF THE FLORIDA DEPARTMENT OF TRANSPORTATION "STANDARD SPECIFICATIONS FOR ROAD AND BRIDGE CONSTRUCTION" (LATEST EDITION).
- SILT FENCES SHALL BE REPAIRED TO THEIR ORIGINAL CONDITIONS IF DAMAGED. SEDIMENT SHALL BE REMOVED FROM THE SILT FENCES WHEN IT REACHES ONE-HALF THE HEIGHT OF THE SILT FENCE.
- 4. THE CONSTRUCTION ENTRANCES SHALL BE MAINTAINED IN A CONDITION WHICH WILL PREVENT TRACKING OR FLOW OF MUD ONTO PUBLIC RIGHTS-OF-WAY. THIS MAY REQUIRE PERIODIC TOP DRESSING OF THE CONSTRUCTION ENTRANCES AS CONDITIONS DEMAND.
- 5. THE TEMPORARY PARKING AND STORAGE AREA SHALL BE KEPT IN GOOD CONDITION (SUITABLE FOR PARKING AND STORAGE). THIS MAY REQUIRE PERIODIC TOP DRESSING OF THE TEMPORARY PARKING AS CONDITIONS DEMAND.
- 6. OUTLET STRUCTURES IN THE SEDIMENTATION BASINS SHALL BE MAINTAINED IN OPERATIONAL CONDITIONS AT ALL TIMES. SEDIMENT SHALL BE REMOVED FROM SEDIMENT BASINS OR TRAPS WHEN THE DESIGN CAPACITY HAS BEEN REDUCED BY 55 CUBIC YARDS / ACRE.
- 7. ALL MAINTENANCE OPERATIONS SHALL BE DONE IN A TIMELY MANNER BUT IN NO CASE LATER THAN 2 CALENDAR DAYS FOLLOWING THE INSPECTION.

TYPICAL ENGINEER OBSERVATIONS

CONTRACTOR SHALL NOTIFY ENGINEER 48 HOURS IN ADVANCE OF THE FOLLOWING

- PRE-CONSTRUCTION MEETING
- SUBGRADE PREPARATION - BASE INSTALLATION
- ASPHALT INSTALLATION
- UNDERGROUND PIPING AND UTILTIES INSTALLATION - INSTALLATION OF STRUCTURES, DDCV, HYDRANTS, METERS, ETC.
- SIDEWALK INSTALLATION - CONNECTIONS TO WATER AND SEWER MAINS
- TESTS OF UTILITIES

3RD PARTY TEST REPORTS REQ'D

TEST REPORTS REQUIRED FOR CLOSE OUT INCLUDE, BUT ARE NOT LIMITED TO:

- DENSITY TEST REPORTS
- BACTERIOLOGICAL TESTS OF WATER SYSTEM - PRESSURE TEST OF WATER/SEWER
- LEAK TESTS ON SEWER SYSTEM AND GREASE TRAPS - ANY OTHER TESTING REQUIRED BY THE AGENCY


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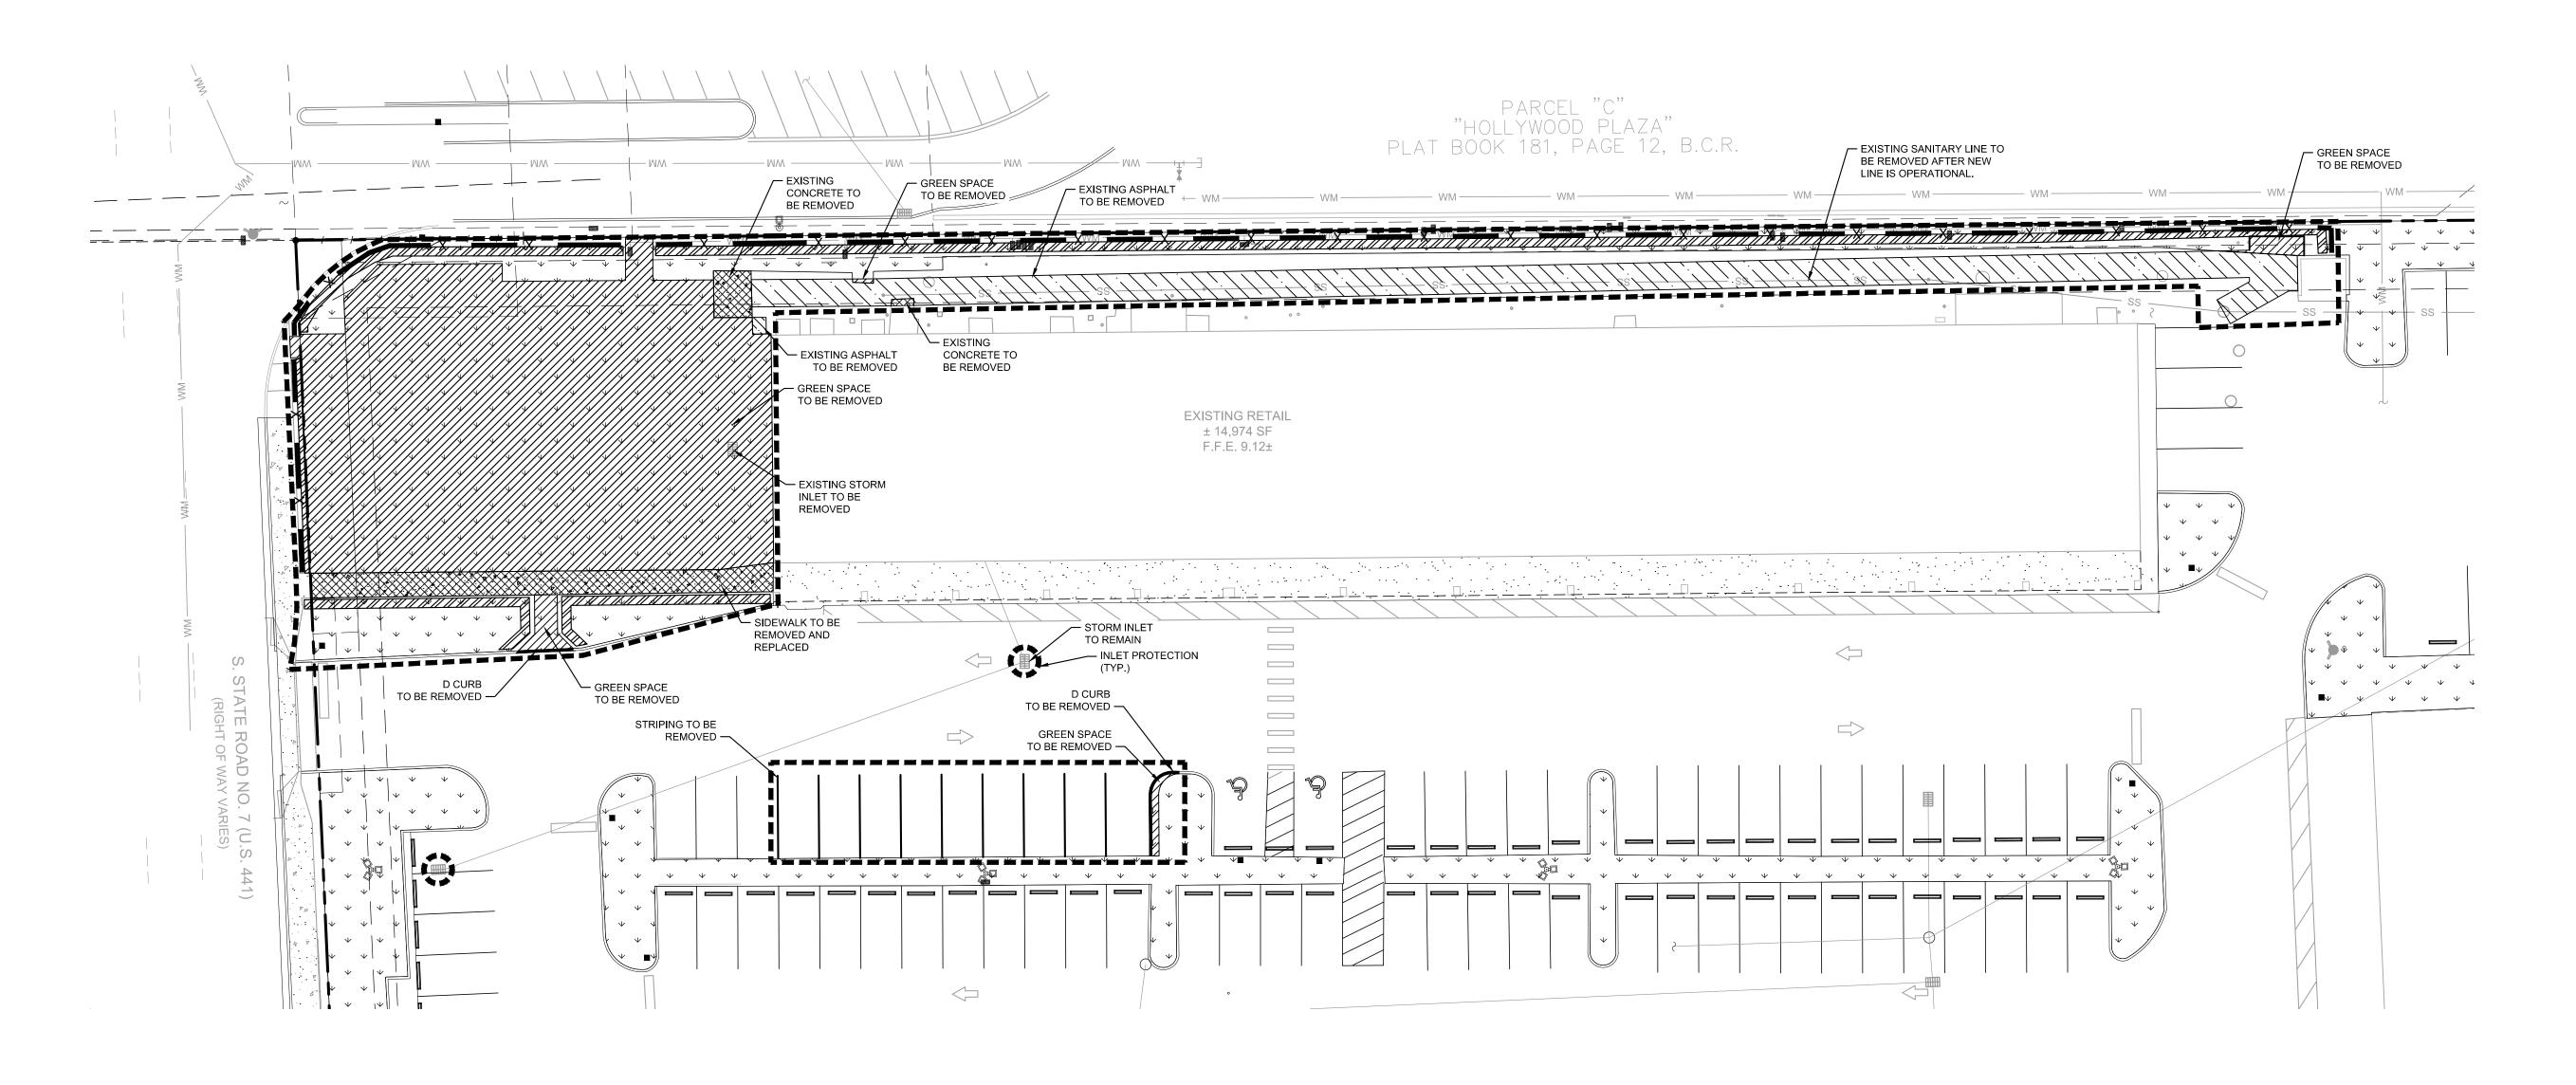
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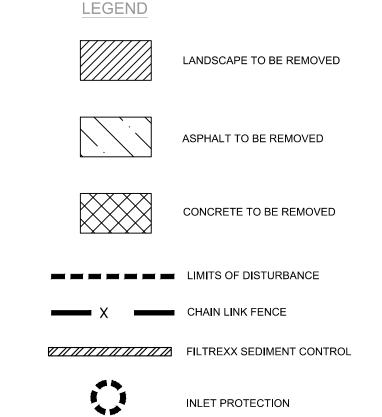
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DEMOLITION NOTES:

- 1. THE INTENT OF THE DEMOLITION PLAN IS TO DEPICT EXISTING FEATURES THAT ENCUMBER THE PROPOSED CONSTRUCTION AREA AND ARE SCHEDULED FOR REMOVAL. SOME INCIDENTAL ITEMS MAY HAVE BEEN INADVERTENTLY OMITTED FROM THE PLAN. THE CONTRACTOR IS ENCOURAGED TO THOROUGHLY INSPECT THE SITE AS WELL AS REVIEW THE PLANS AND SPECIFICATIONS PRIOR TO SUBMITTING PRICING. CONTRACTOR WILL NOT RECEIVE ADDITIONAL COMPENSATION FOR INCIDENTAL ITEMS NOT SHOWN ON THIS DEMOLITION PLAN.
- 2. THIS DEMOLITION PLAN IS BASED ON AVAILABLE UTILITY INFORMATION AND MAY OR MAY NOT BE ALL INCLUSIVE FOR THIS SITE. ANY UTILITIES ENCOUNTERED DURING DEMOLITION THAT ARE NOT DEPICTED/ADDRESSED ON THIS DRAWING SHOULD BE BROUGHT TO THE ATTENTION OF THE PROJECT ENGINEER IMMEDIATELY.
- 3. CONTRACTOR IS REQUIRED TO OBTAIN ALL DEMOLITION PERMITS.
- 4. ALL FEATURES IDENTIFIED ON THIS PLAN WHICH ARE LISTED TO BE DEMOLISHED ARE TO BE REMOVED FROM THE SITE. AFTER DEMOLITION IS COMPLETE THE SITE SHALL BE DELIVERED IN A CONDITION SUITABLE FOR DEVELOPMENT.
- 5. CONTRACTOR SHALL LIMIT ALL DEMOLITION ACTIVITIES TO THOSE AREAS DELINEATED ON THE CONSTRUCTION DRAWINGS UNLESS OTHERWISE DIRECTED BY THE DEVELOPER OR AS REQUIRED FOR CONSTRUCTION OF IMPROVEMENTS.
- 6. CONTRACTOR IS RESPONSIBLE FOR CONTROLLING AIRBORNE DUST AND POLLUTANTS BY USING WATER SPRINKLING OR OTHER SUITABLE MEANS OF CONTROL.
- 7. CONTRACTOR TO USE CARE IN HANDLING DEBRIS FROM SITE TO ENSURE THE SAFETY OF THE PUBLIC. HAUL ROUTE TO BE CLOSELY MONITORED FOR DEBRIS OR MATERIALS TRACKED ONTO ADJOINING ROADWAYS, SIDEWALKS, ETC. ROADWAYS AND WALKWAYS TO BE CLEARED DAILY OR AS NECESSARY TO MAINTAIN PUBLIC SAFETY.
- 8. DEWATERING BY CONTRACTOR. IF REQUIRED, A PERMIT NEEDS TO BE OBTAINED. 9. ALL ASPHALT TO BE REMOVED SHALL BE SAW CUT ADJACENT TO REMAINING
- IMPROVEMENTS.
- 10. WHERE REMAINING, INLETS, MANHOLE COVERS, AND VALVE COVERS TO BE PROTECTED IN PAVEMENT REMOVAL AREAS. CONTRACTOR SHALL REPLACE DAMAGED STRUCTURES AT THEIR EXPENSE.
- 11. CONTRACTOR TO PROVIDE TREE PROTECTION FOR ALL TREES TO REMAIN.

SURVEY NOTES:

1. INFORMATION ON THE PLAN BASED UPON THE SURVEY PREPARED BY PULICE LAND SURVEYORS, INC., DATED JULY 29TH, 2016 AND LAST REVISED AUGUST 3RD, 2016

> THE PRESENCE OF GROUNDWATER SHOULD BE ANTICIPATED ON THIS PROJECT. CONTRACTOR'S BID SHALL INCLUDE CONSIDERATION FOR ADDRESSING THIS ISSUE.
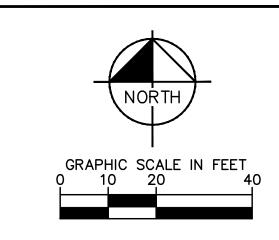
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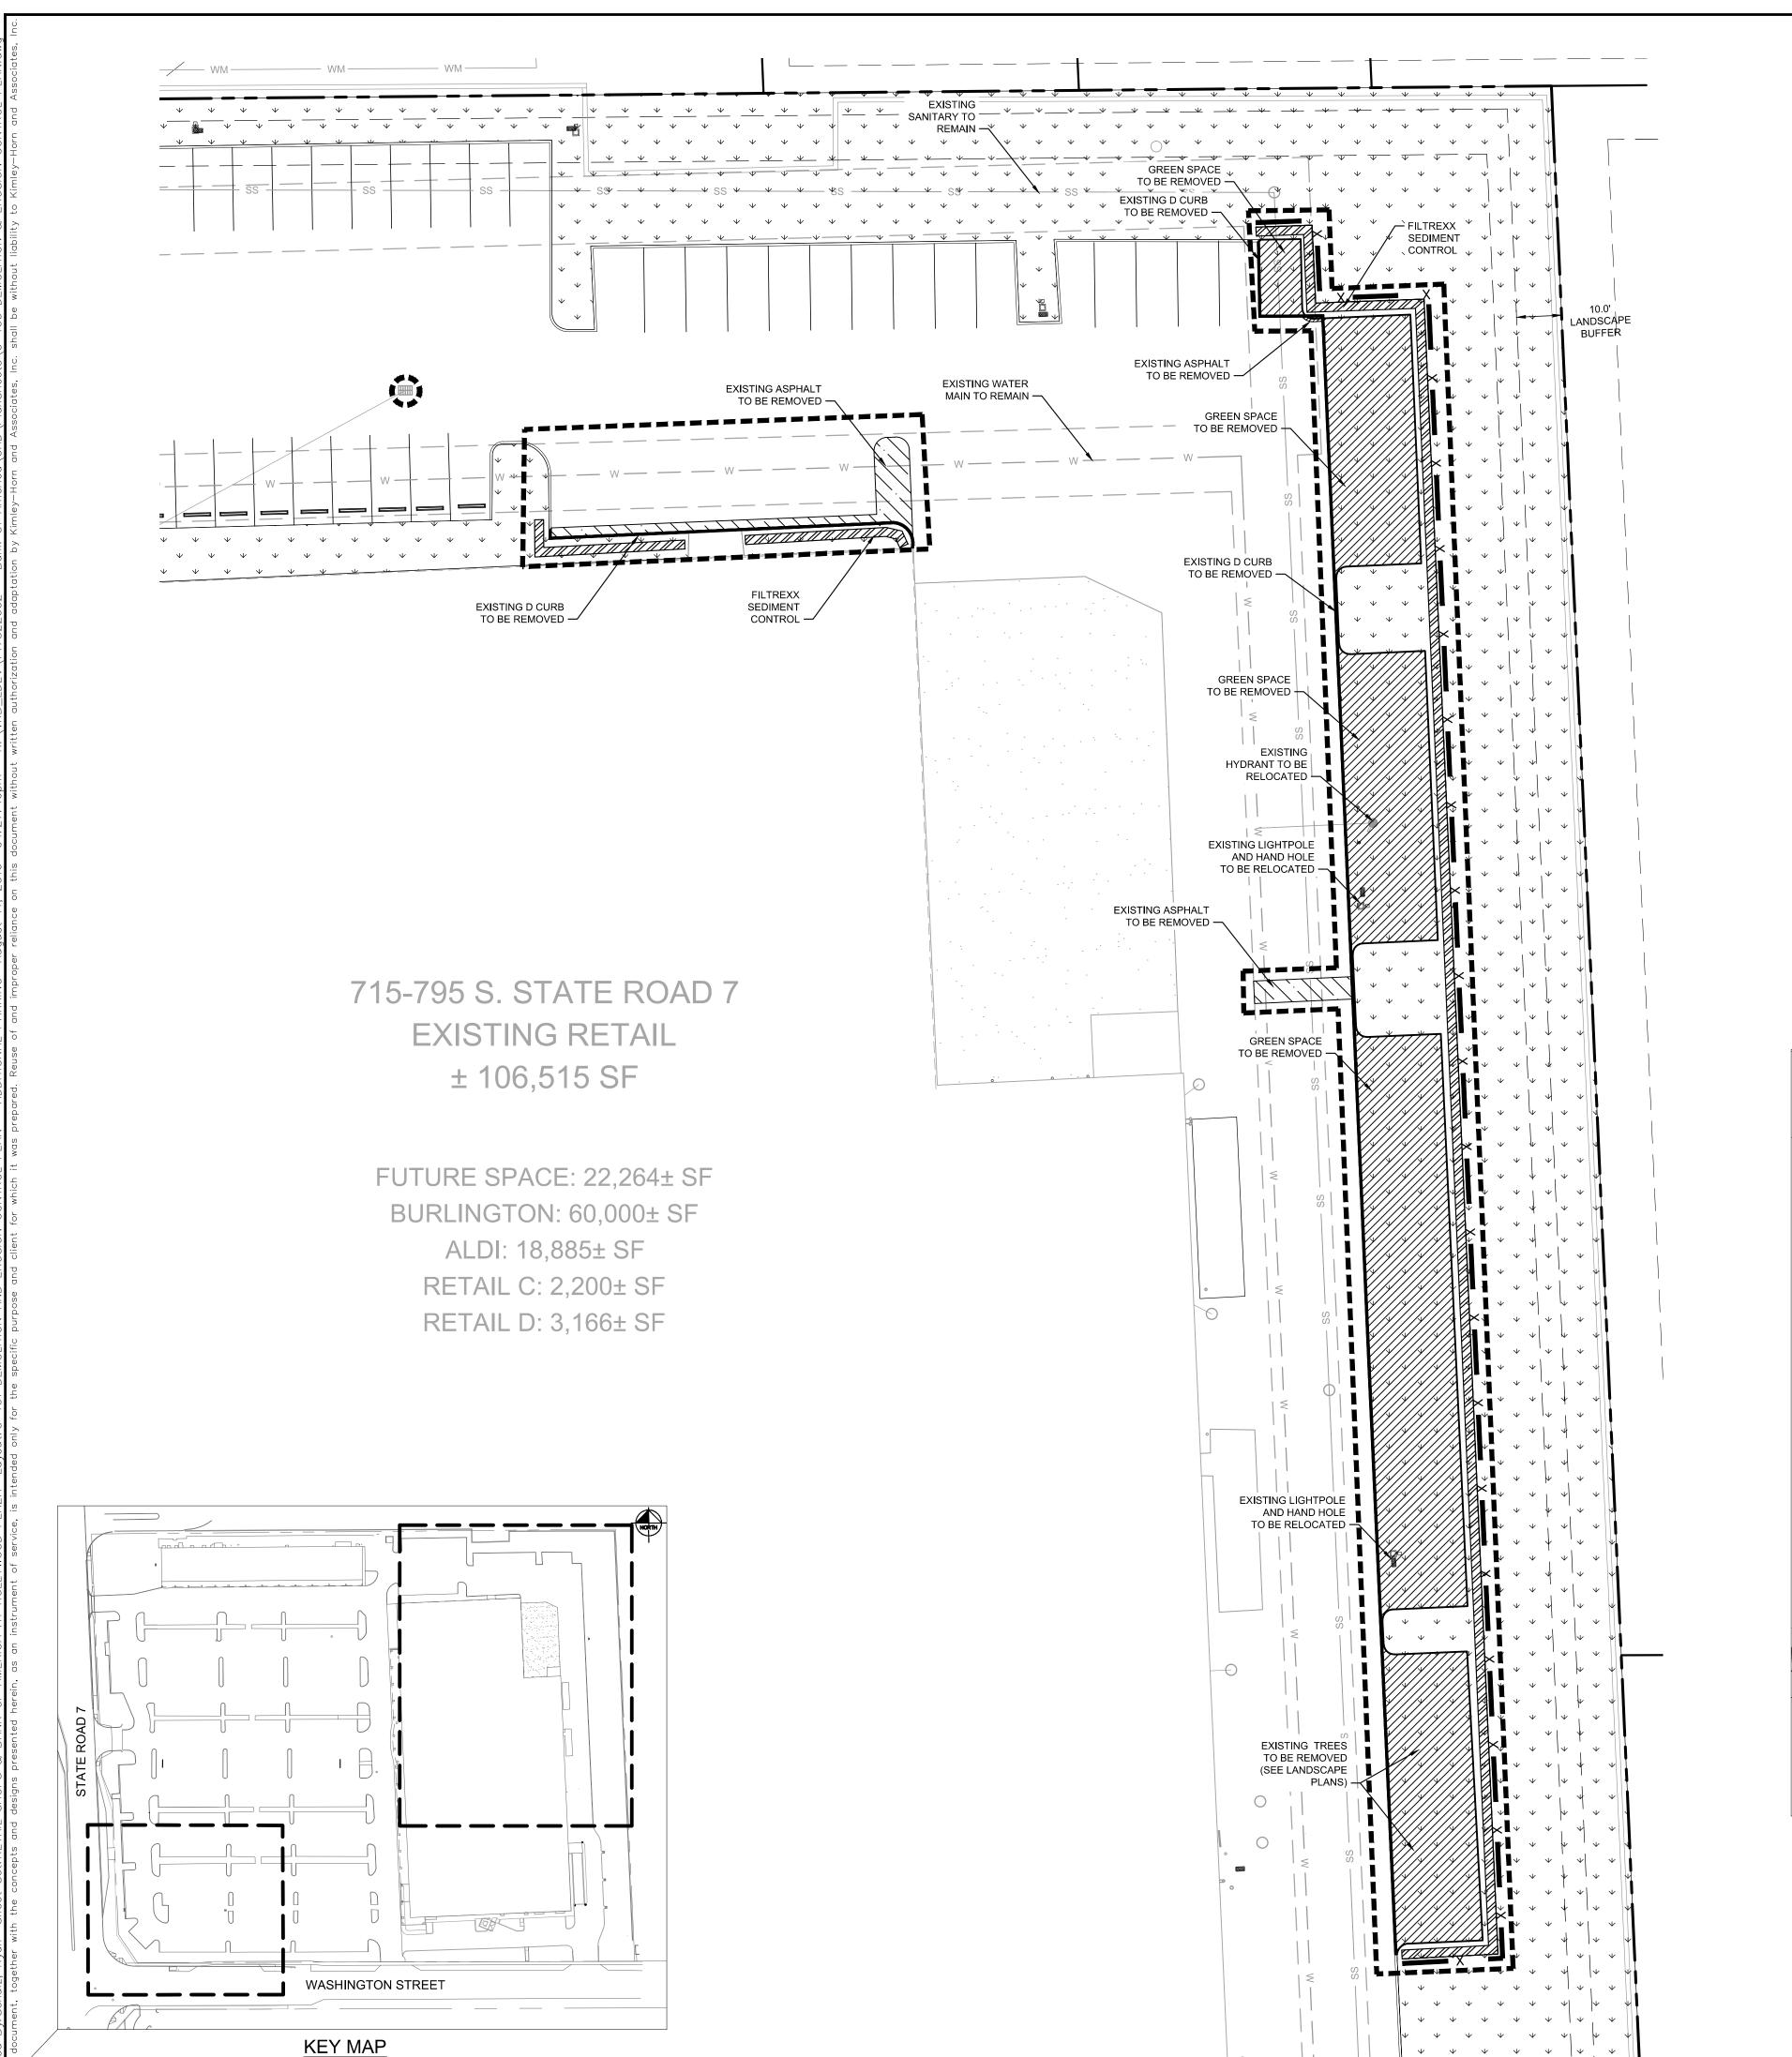
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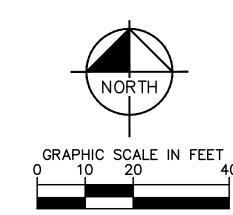
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WASHINGTON STREET **KEY MAP** <u>N.T.S.</u>


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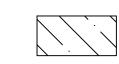
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<u>LEGEND</u>



LANDSCAPE TO BE REMOVED



ASPHALT TO BE REMOVED

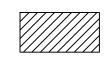LIMITS OF DISTURBANCE



INLET PROTECTION

EXISTING LIGHT POLE

DEMOLITION NOTES:


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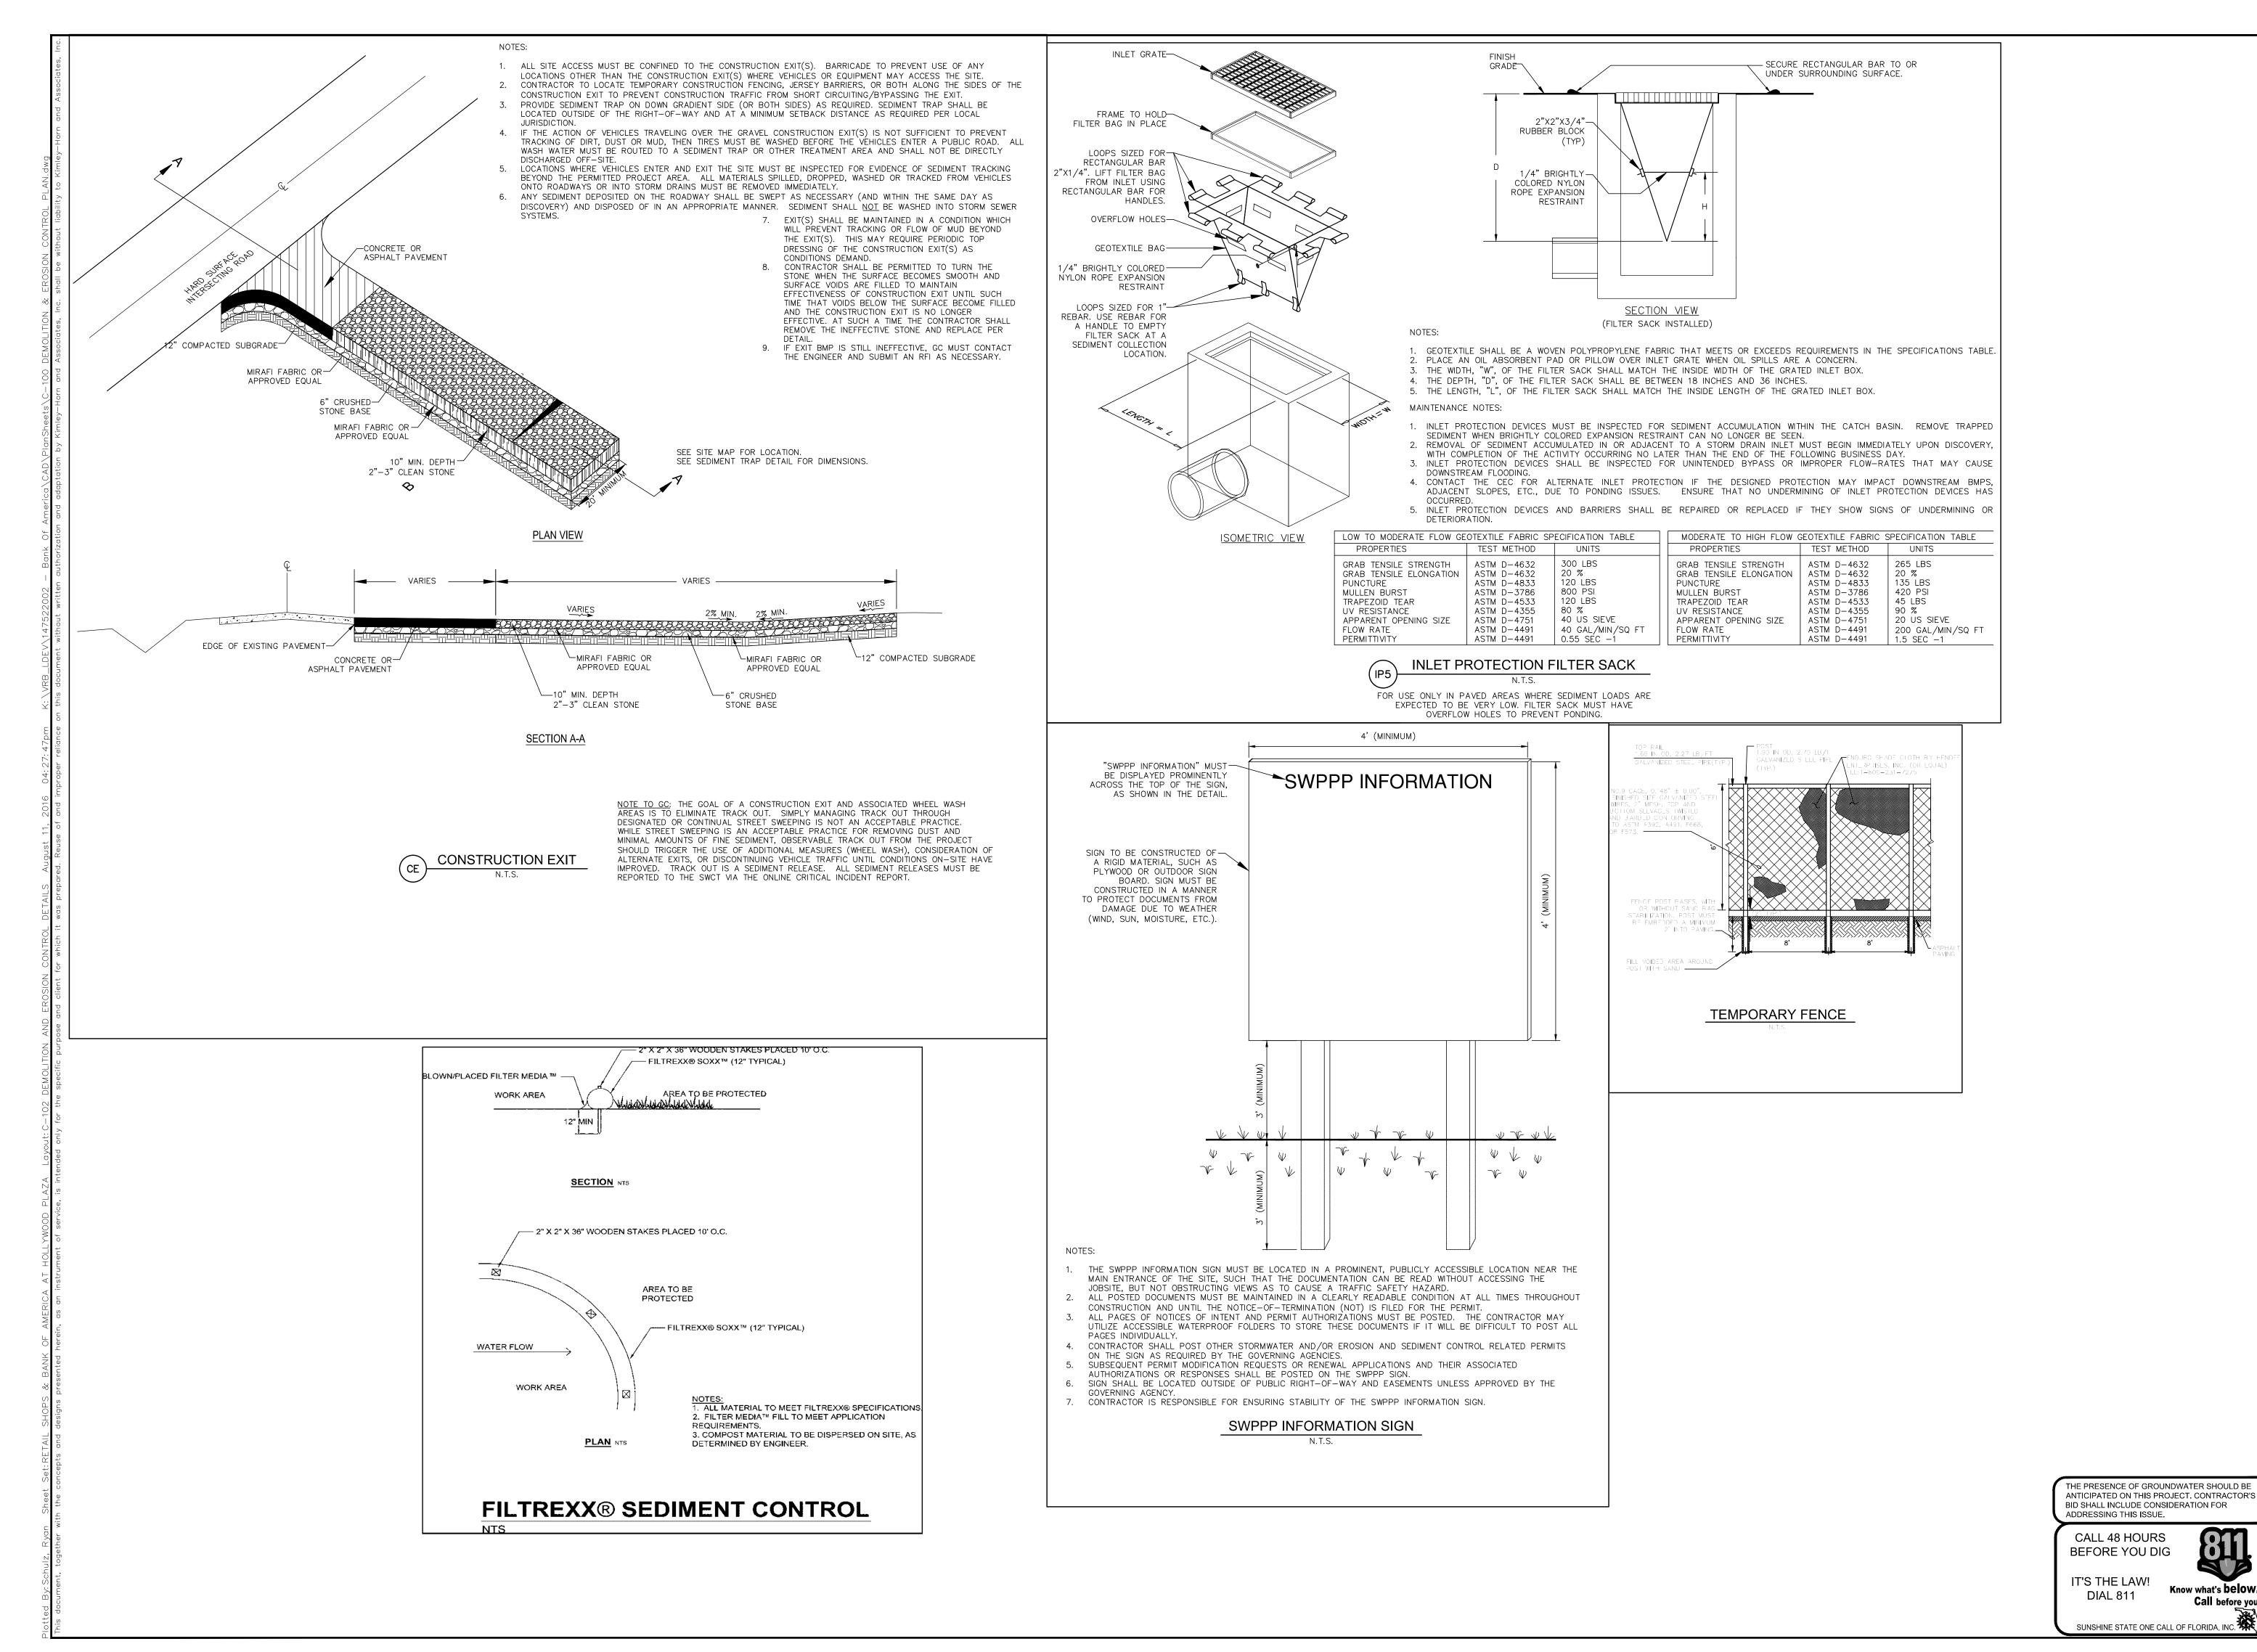
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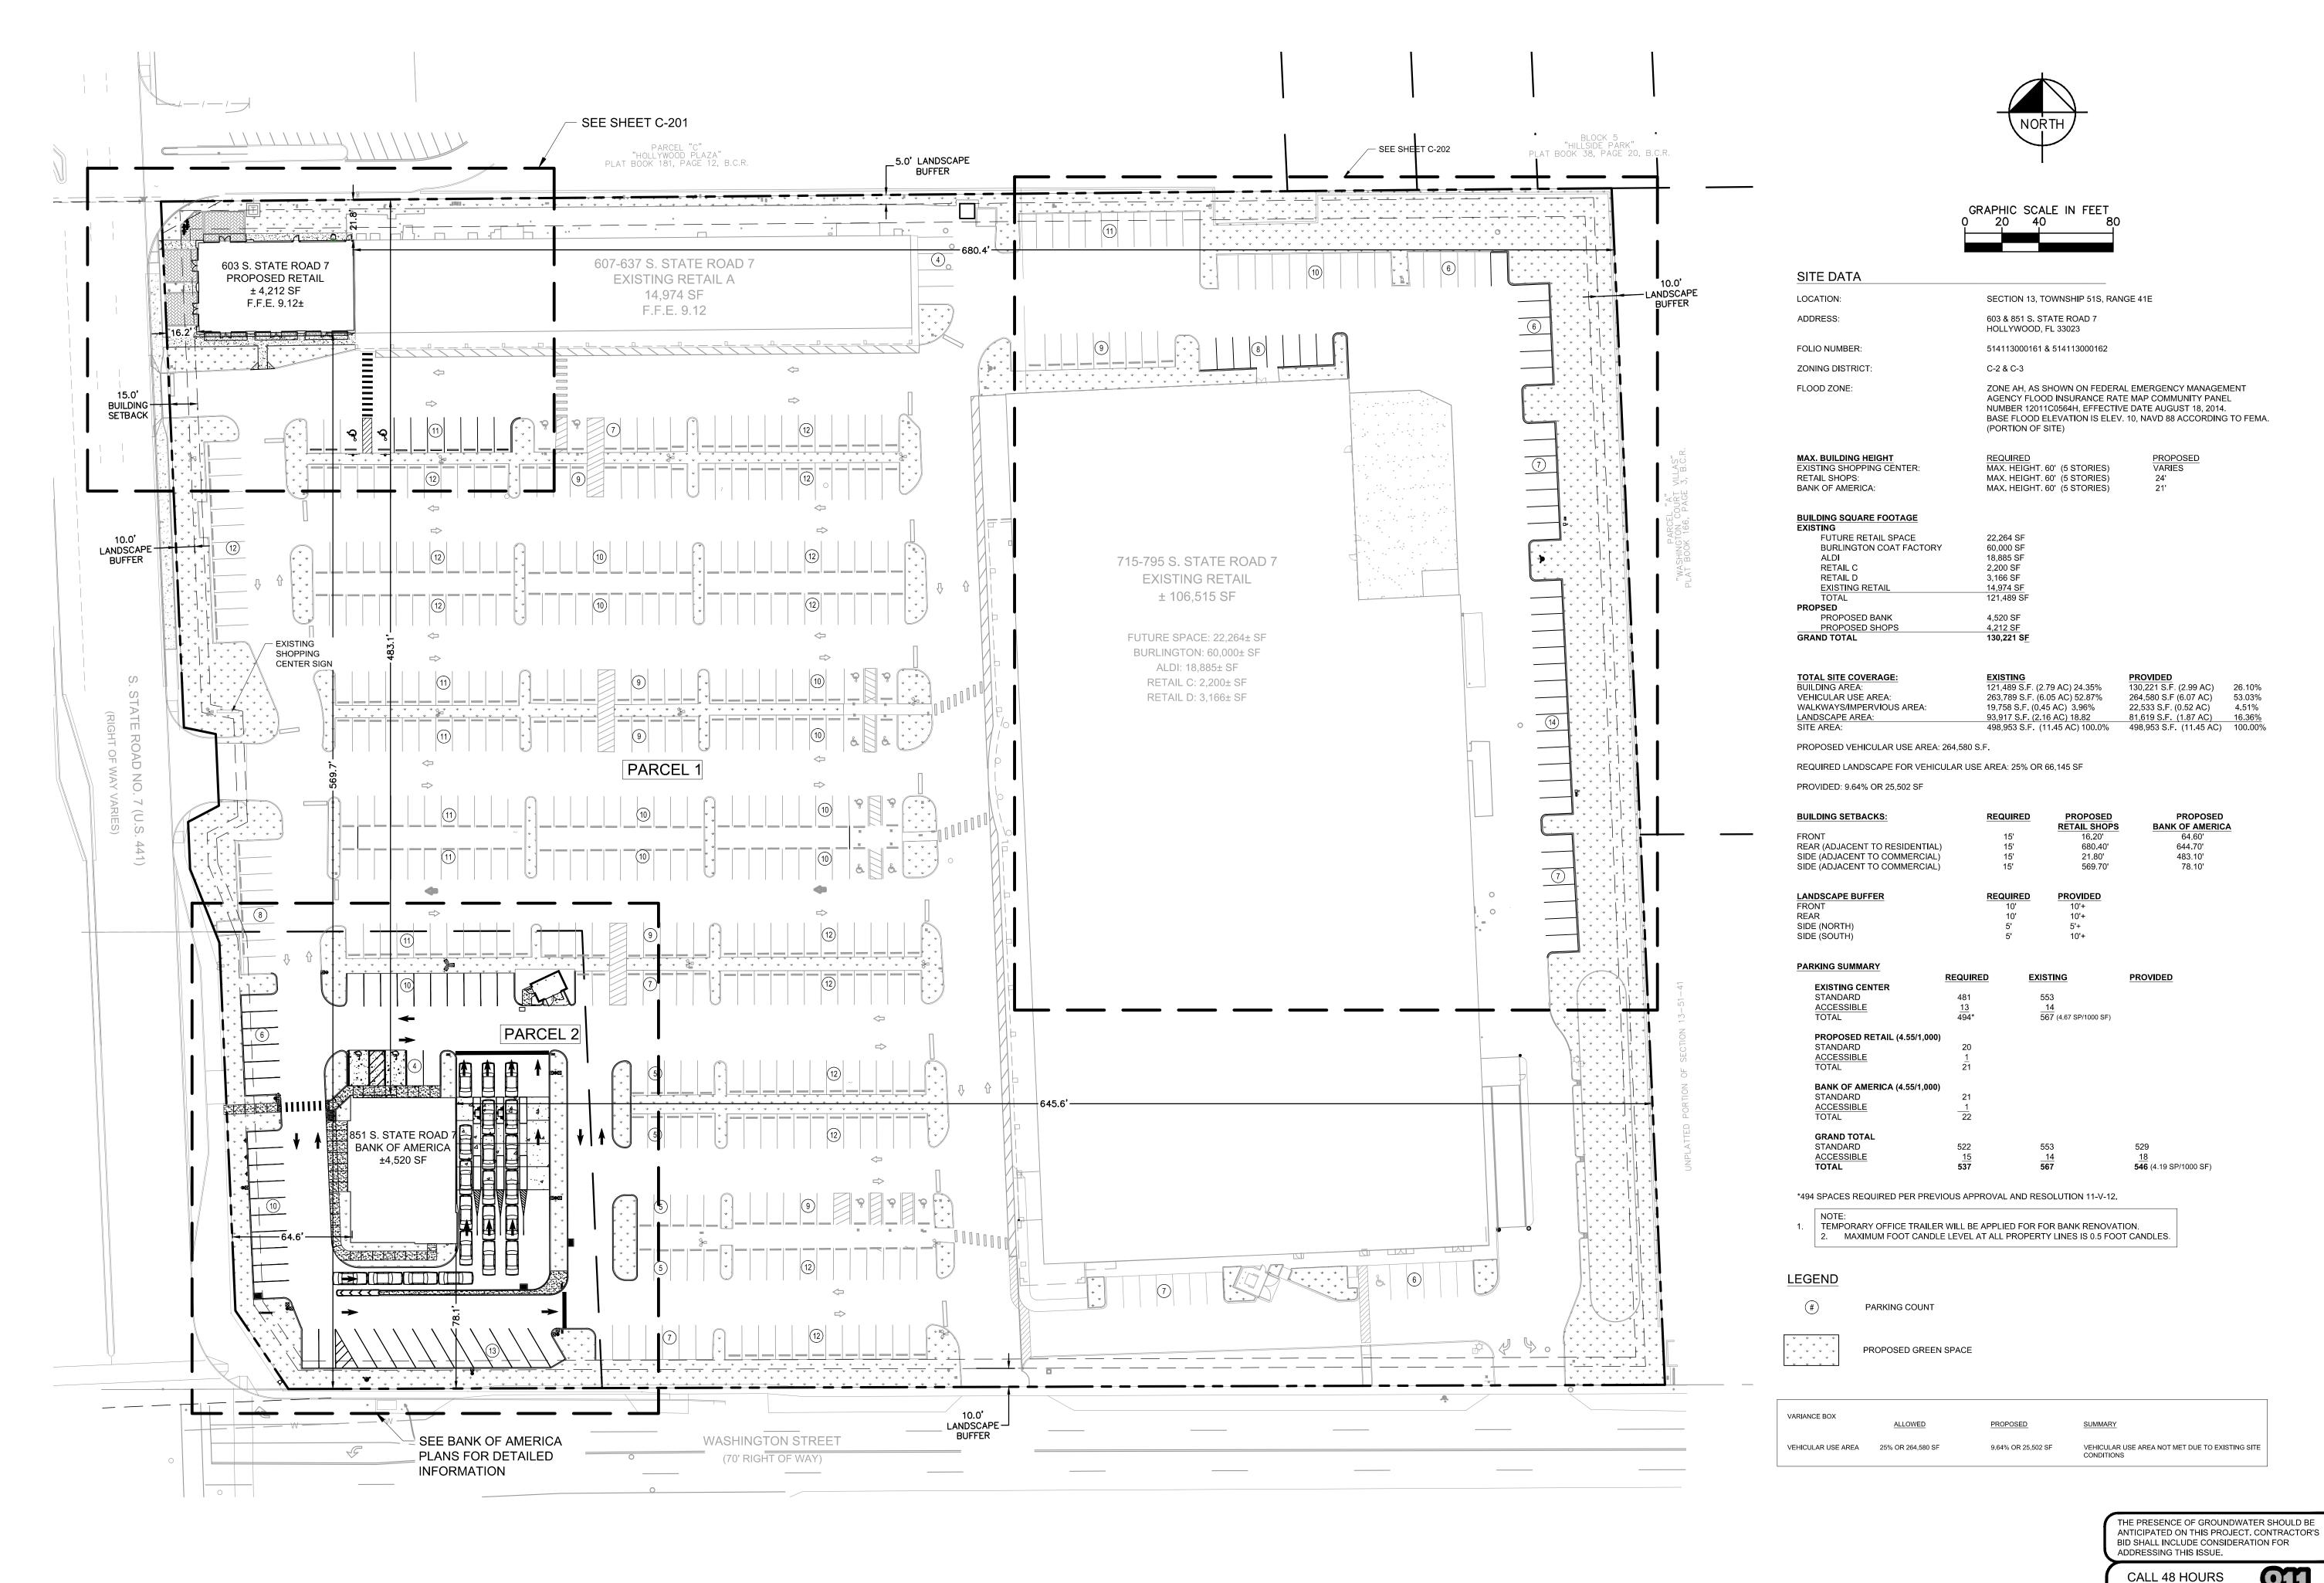
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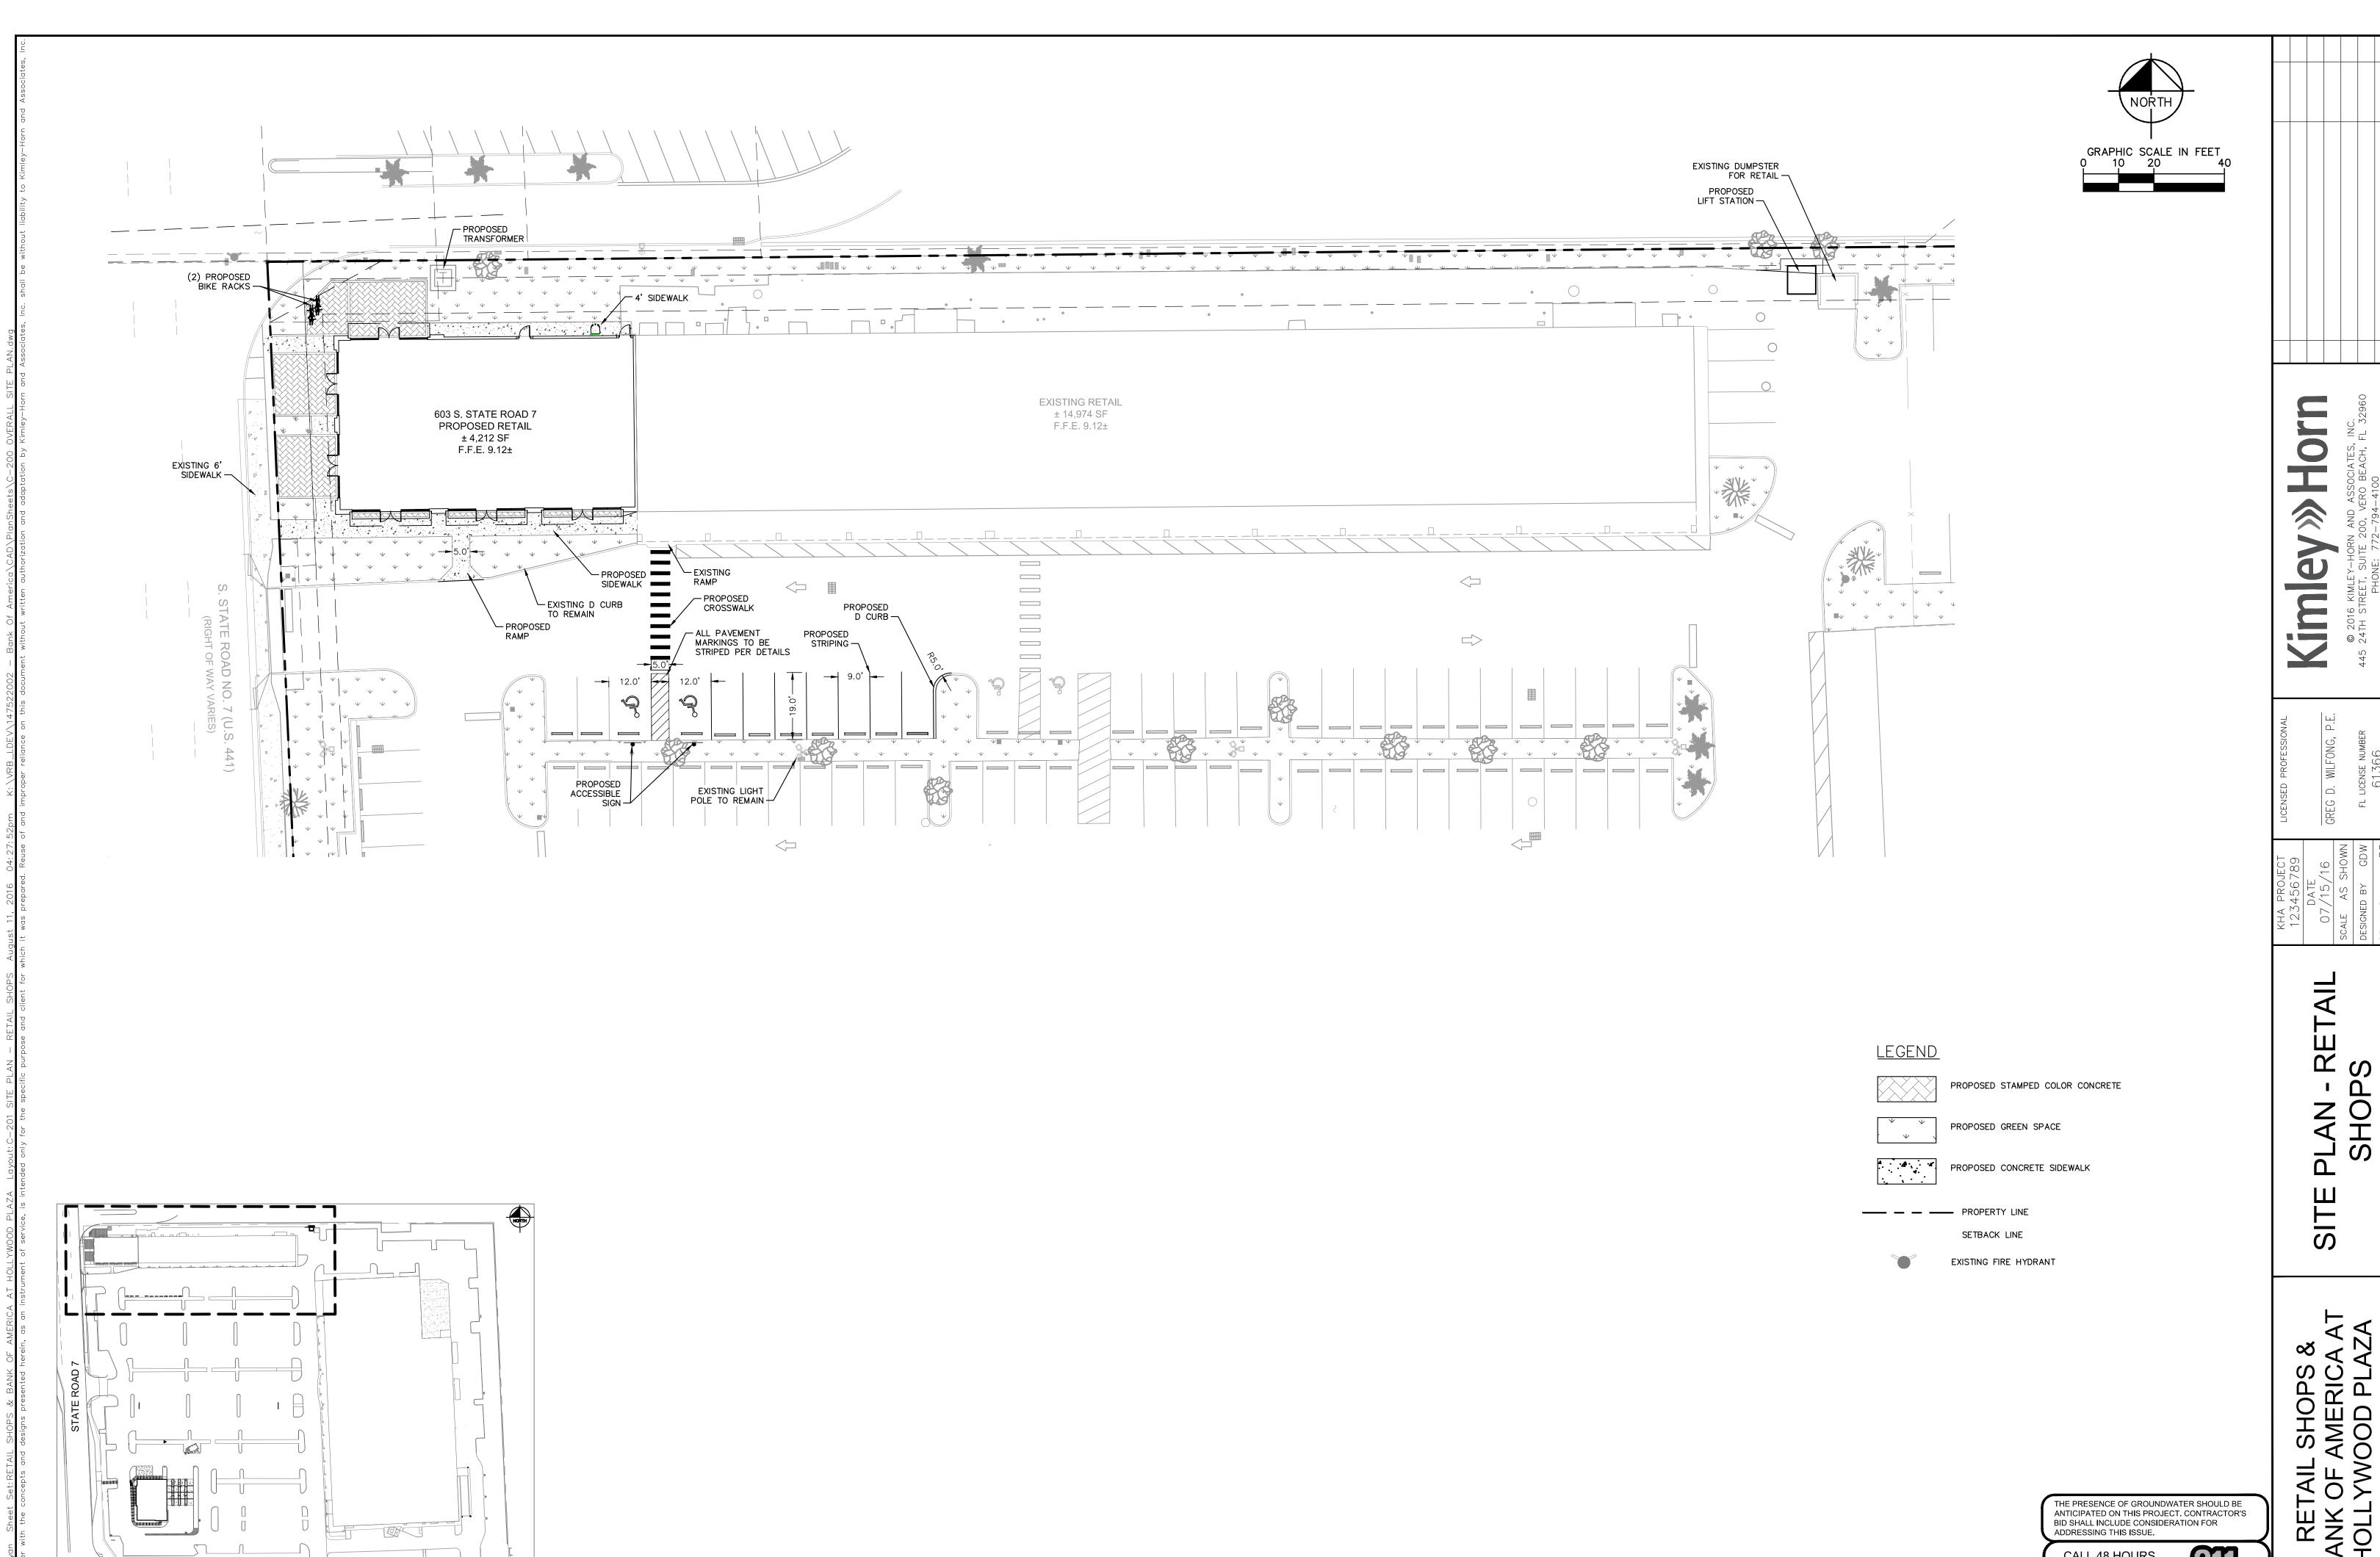
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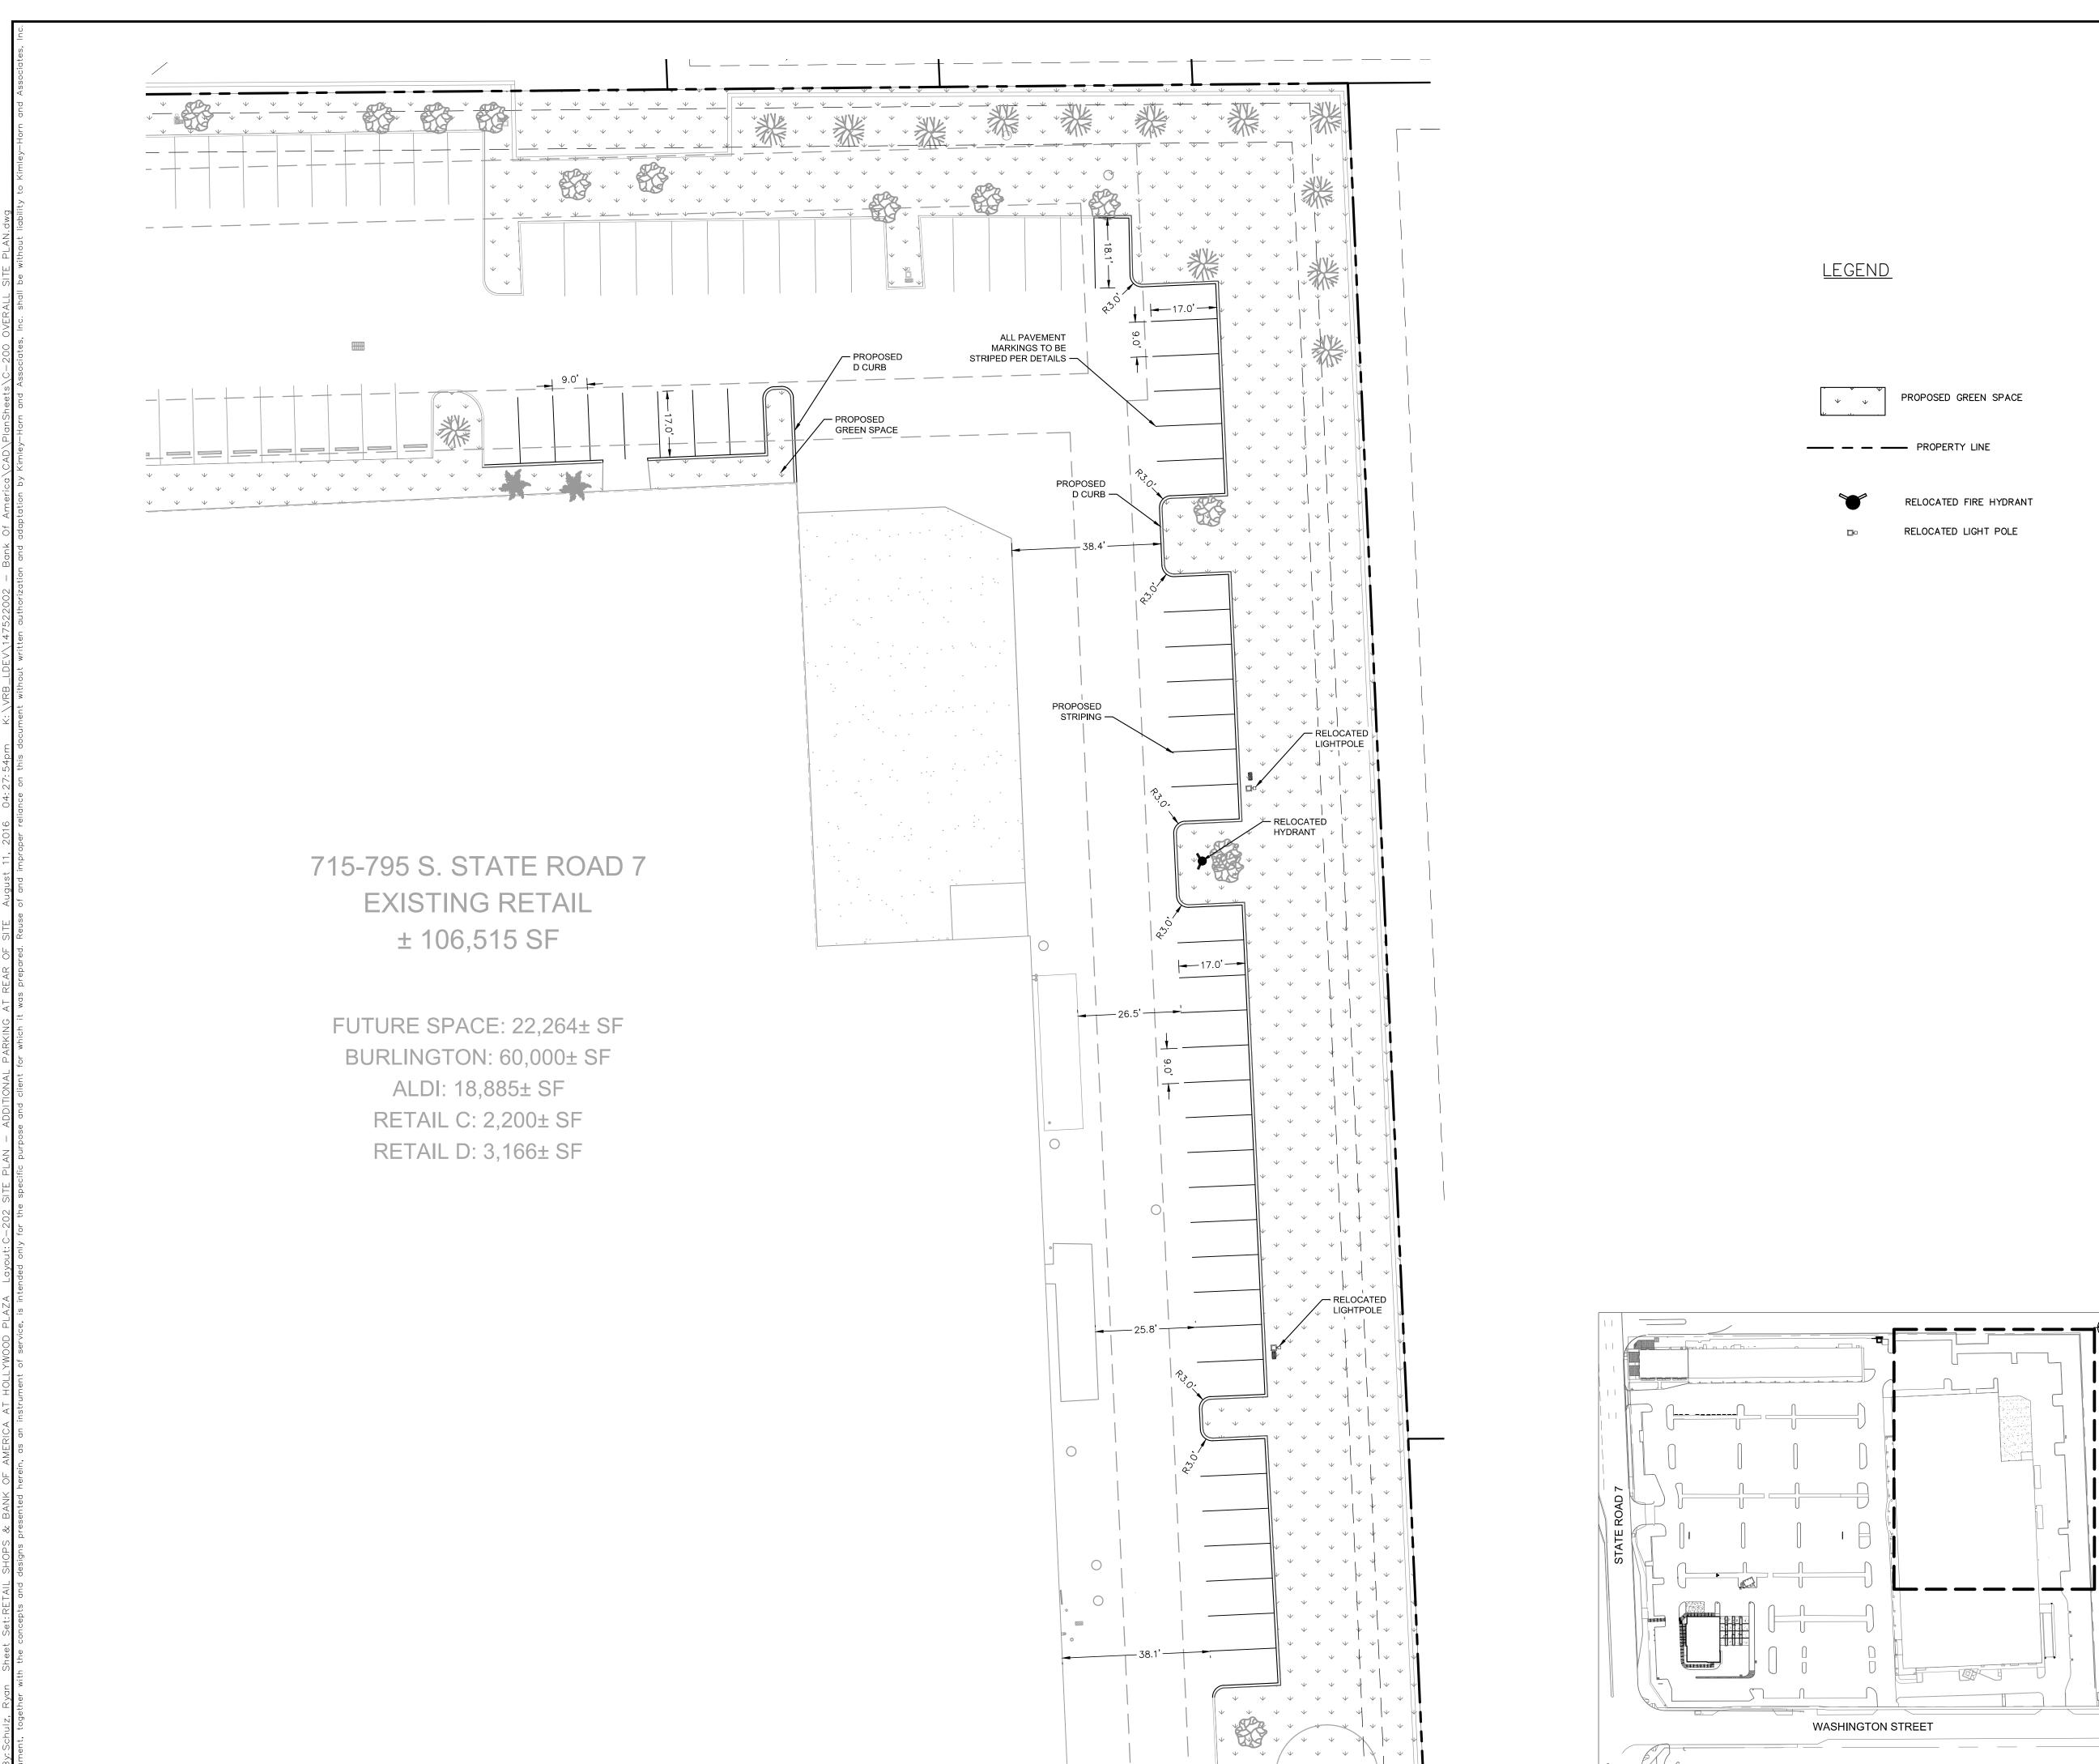
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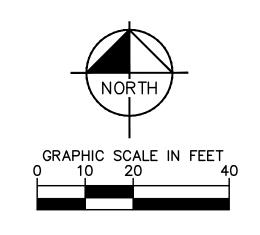
BEFORE YOU DIG IT'S THE LAW! Know what's **below.** Call before you dig.

DIAL 811

SUNSHINE STATE ONE CALL OF FLORIDA, INC.

SHEET NUMBER C-201



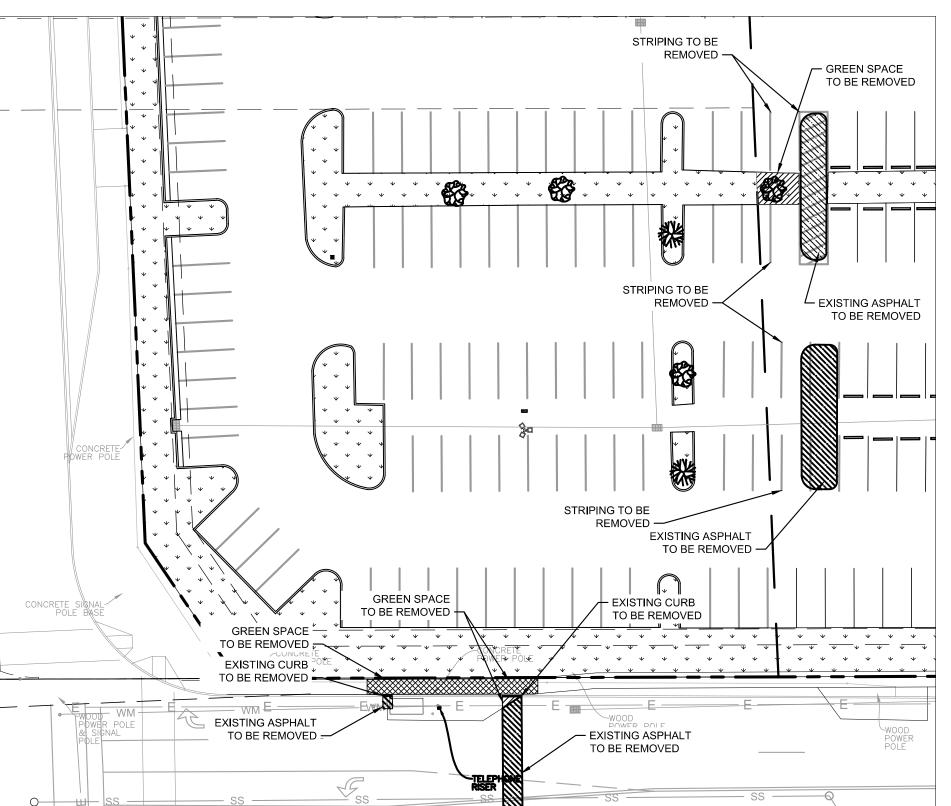

KEY MAP N.T.S.


THE PRESENCE OF GROUNDWATER SHOULD BE ANTICIPATED ON THIS PROJECT. CONTRACTOR'S BID SHALL INCLUDE CONSIDERATION FOR ADDRESSING THIS ISSUE.

CALL 48 HOURS BEFORE YOU DIG IT'S THE LAW! DIAL 811


Know what's **below.** Call before you dig. SUNSHINE STATE ONE CALL OF FLORIDA, INC.

SHEET NUMBER C-202


STAMPED COLORED ASPHALT DETAIL PROVIDED BY KIMLEY-HORN AND ASSOC.

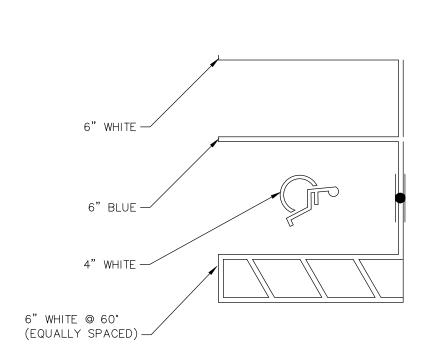



ADA PARKING STALL STRIPING

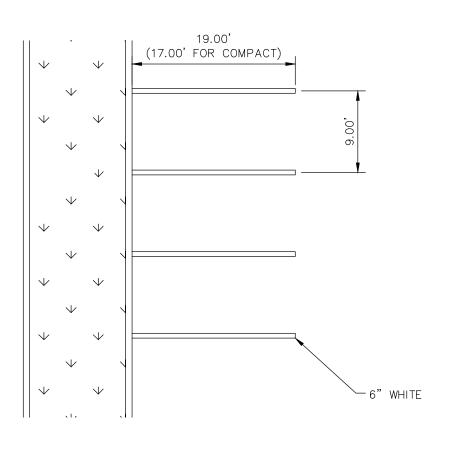


PARKING STALL STRIPING

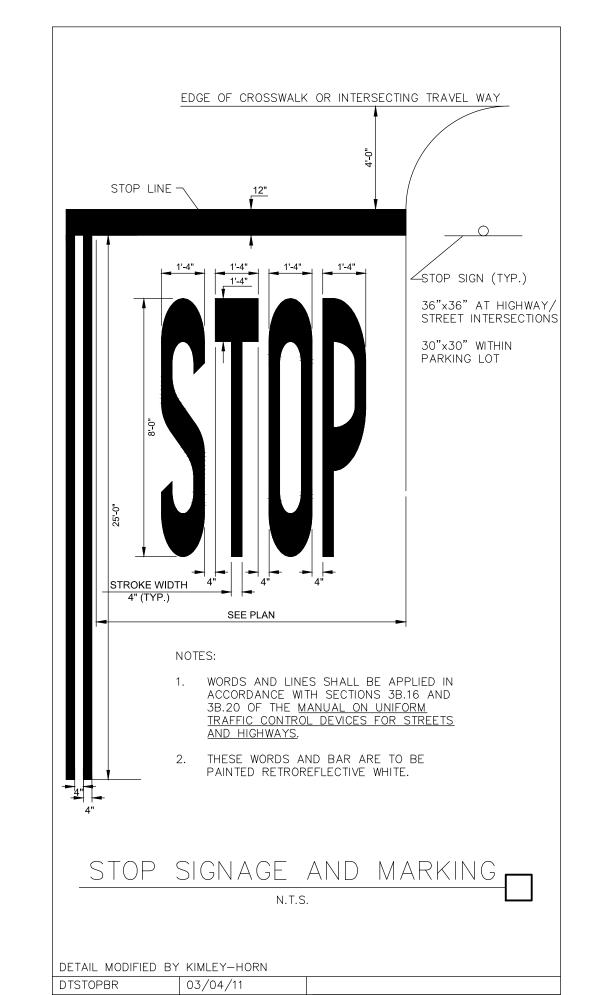


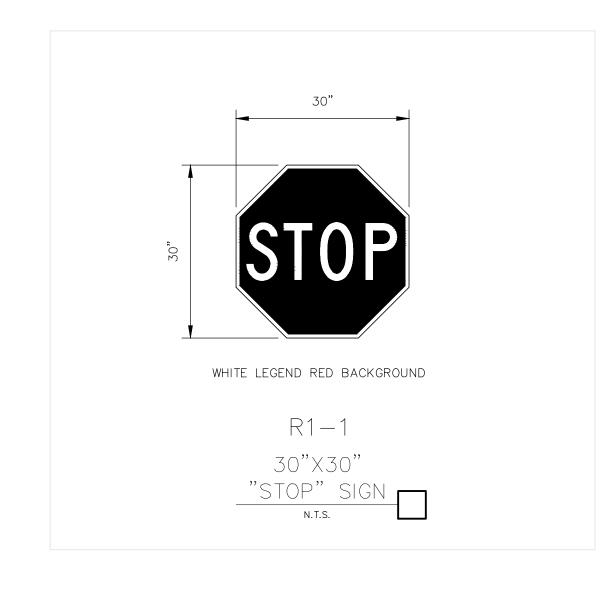

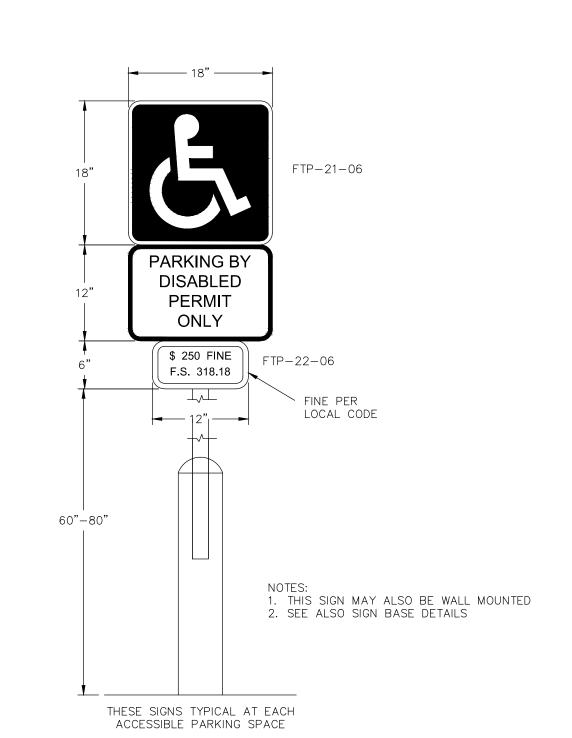

ACCESSIBLE PARKING SIGN

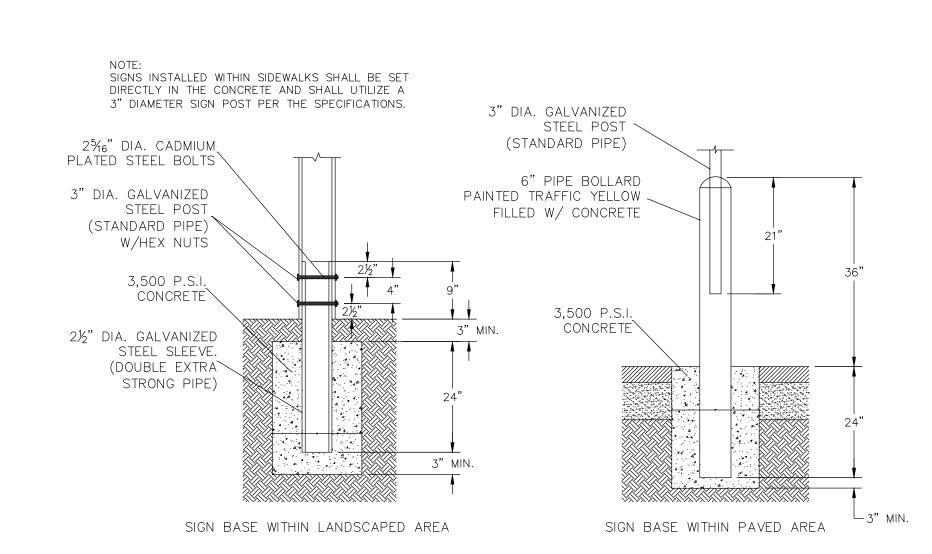

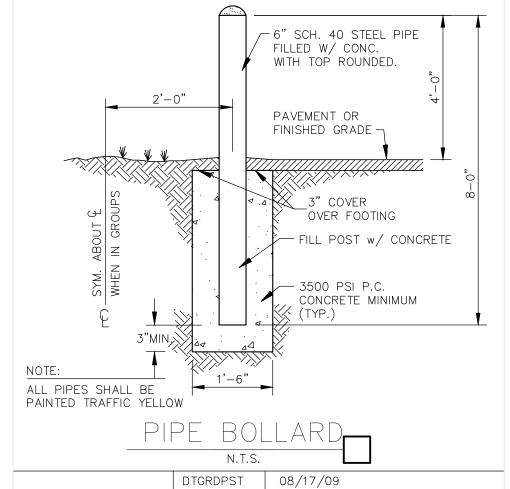

THE PRESENCE OF ROCK SHOULD BE ANTICIPATED ON THIS PROJECT. CONTRACTOR'S BID SHALL INCLUDE CONSIDERATION FOR ADDRESSING THIS Always call 811 two full business days before you dig

ALERT TO CONTRACTOR:

THE PRESENCE OF GROUNDWATER SHOULD BE ANTICIPATED ON THIS PROJECT. CONTRACTOR'S BID SHALL INCLUDE CONSIDERATION FOR THIS ISSUE. WHEN PERFORMING GRADING OPERATIONS DURING PERIODS OF WET WEATHER, PROVIDE ADEQUATE DEWATERING, DRAINAGE AND GROUND WATER MANAGEMENT TO CONTROL MOISTURE OF SOILS. REFER TO MASTER SITE SPECIFICATIONS.


ALL WM GENERAL CONTRACTOR WORK TO BE COMPLETED (EARTHWORK, FINAL UTILITIES, AND FINAL GRADING) BY THE MILESTONE DATE IN PROJECT DOCUMENTS. OUTLOT AREA TO BE KEPT FREE OF JOB TRAILERS AND STORAGE AFTER THE CONTRACT MILESTONE DATE FOR THE OUTLOT. WM GENERAL CONTRACTOR TO PROVIDE CLEAR ACCESS FOR OUTLOT CONTRACTOR TO THE SPECIFIC PARCEL AT ALL TIMES AFTER MILESTONE DATE. PURCHASER OF OUTLOT TO PROVIDE PERMIT


SHEET NUMBER C-203

DOCUMENTS AND SWPPP REQUIRED BY STATE/LOCAL REQUIREMENTS FOR SPECIFIC OUTLOT.

Kimley

SITE

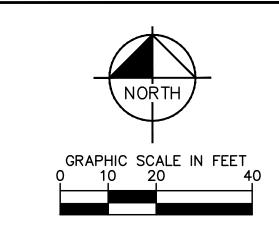

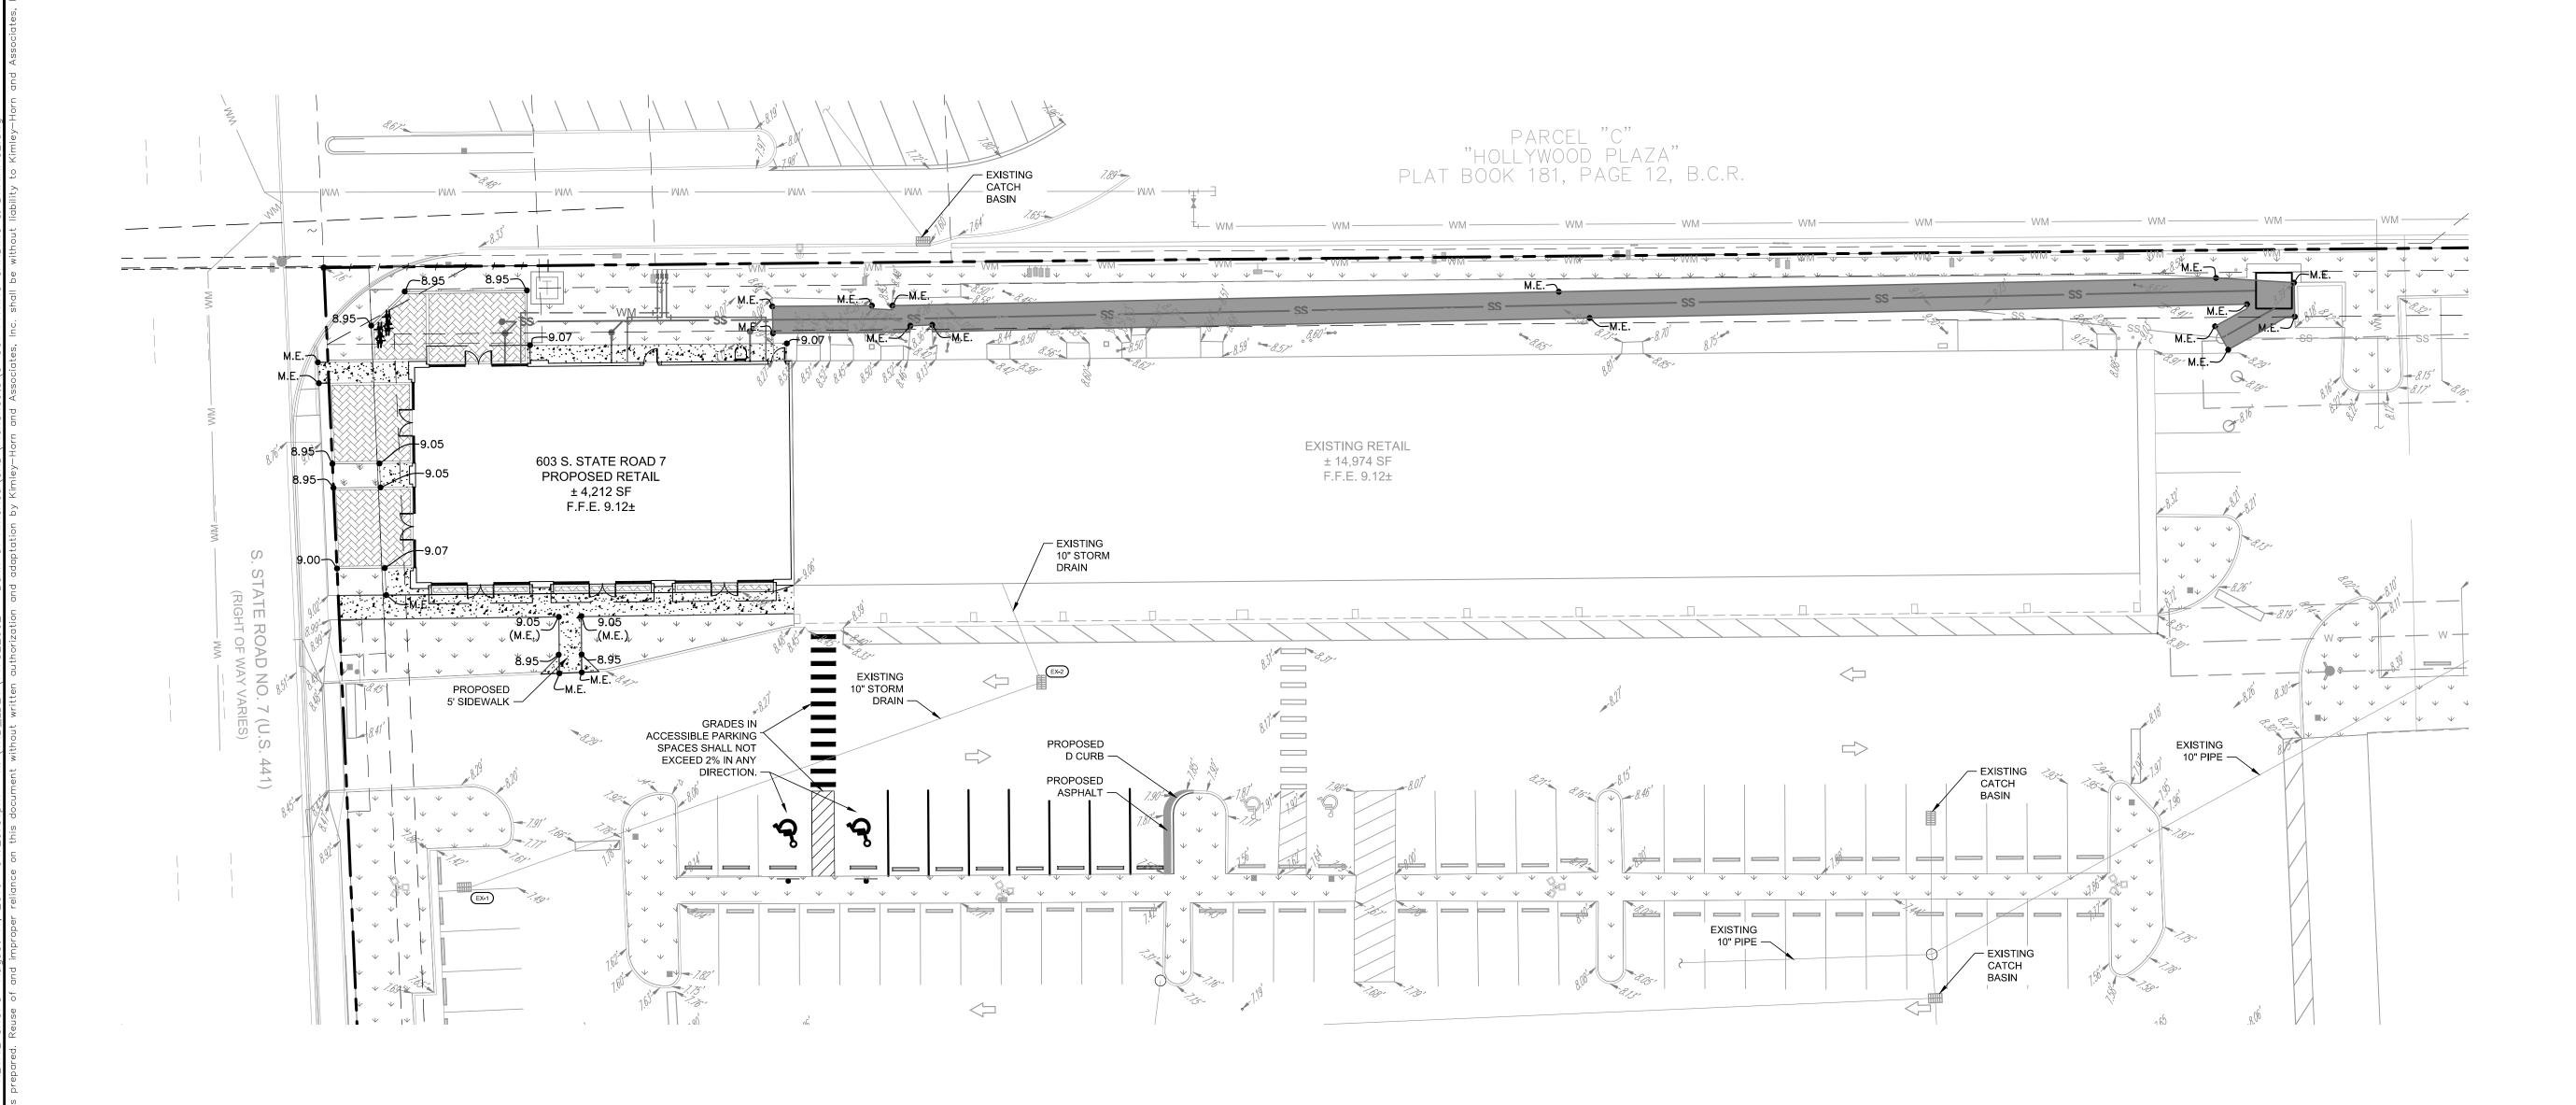

<u>LEGEND</u>

----- SETBACK LINE

EXISTING FIRE HYDRANT

EXISTING STORM MANHOLE

PROPOSED STORM CATCH BASIN


LIGHT POLE (SEE ARCH PLANS)

PROPOSED TYPE "D" CURB

PROPOSED PARKING SPACES

1. ADJUST RIM OF EXISTING INLETS TO MATCH PROPOSED GRADES.

- 2. ALL EXISTING PAVEMENT AND CONCRETE TO BE JOINED SHALL BE SAWCUT.
- SIDEWALKS AND CROSSWALKS SHALL NOT EXCEED 2% CROSS SLOPE NOR 5% LONGITUDINALLY. GRADES IN ACCESSIBLE PARKING SPACES SHALL NOT EXCEED 2% IN ANY DIRECTION. IN CASES OF SIDEWALK AT BUILDING ENTRANCES, GRADES SHALL NOT EXCEED 2% IN ANY DIRECTION. ACCESSIBLE CURB RAMPS SHALL NOT EXCEED 6' IN LENGTH, 6" RISE AND 1:12 SLOPE. LANDINGS AT CHANGES IN DIRECTION SHALL BE MINIMUM 60"X60" AND SHALL NOT EXCEED 2% SLOPE IN ANY
- 4. EXISTING GRADES AND DRAINAGE HAVE BEEN TAKEN FROM A SURVEY PREPARED BY PULICE LAND SURVEYORS, INC., DATED JULY 29TH, 2016 AND LAST REVISED AUGUST 3RD, 2016
- 5. CONTRACTOR SHALL COORDINATE PAVING IMPROVEMENTS TO AVOID TIRE MARKS FROM CONSTRUCTION ACTIVITY. FINAL PAVING SHALL BE AS SMOOTH AS POSSIBLE AND FREE FROM ANY MARKS, SCRAPES, GOUGES, TIRE MARKS, ETC. CAUSED DURING CONSTRUCTION ACTIVITY.
- 6. CONTRACTOR TO ENSURE POSITIVE RUNOFF FROM THE BUILDINGS. PAVING SHALL BE FREE OF PONDING AND MAINTAIN POSITIVE OUTFALL TO THE DRAINAGE SYSTEM. CONTRACTOR SHALL FIELD VERIFY EXISTING DRAINAGE PATTERNS AND TIE-IN GRADES AND ALERT OWNER AND ENGINEER SHOULD ANY CONFLICTS
- 7. DURING CONSTRUCTION AND AFTER FINAL GRADING, NO SURFACE WATER RUNOFF MAY BE DIRECTED TO ADJACENT PROPERTIES, AND ALL SURFACE WATER RUNOFF MUST BE ROUTED TO APPROVED DRAINAGE FACILITIES OR BE RETAINED ON SITE. ALL RUNOFF FROM THE SITE, BOTH DURING AND AFTER CONSTRUCTION, MUST BE FREE OF POLLUTANTS, INCLUDING SEDIMENT, PRIOR TO DISCHARGE.

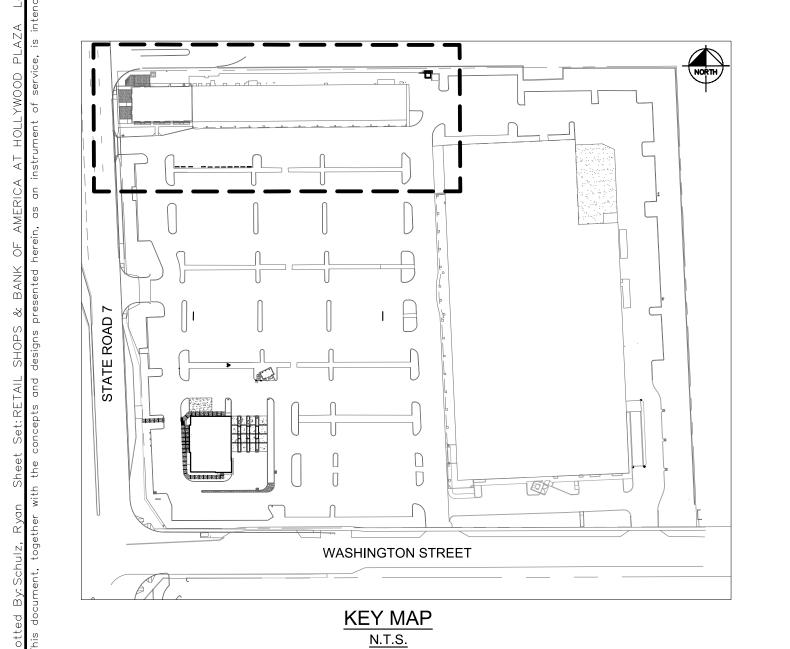


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BEFORE YOU DIG

Know what's **below.**

IT'S THE LAW! **DIAL 811** Call before you dig. SUNSHINE STATE ONE CALL OF FLORIDA, INC.

SHEET NUMBER

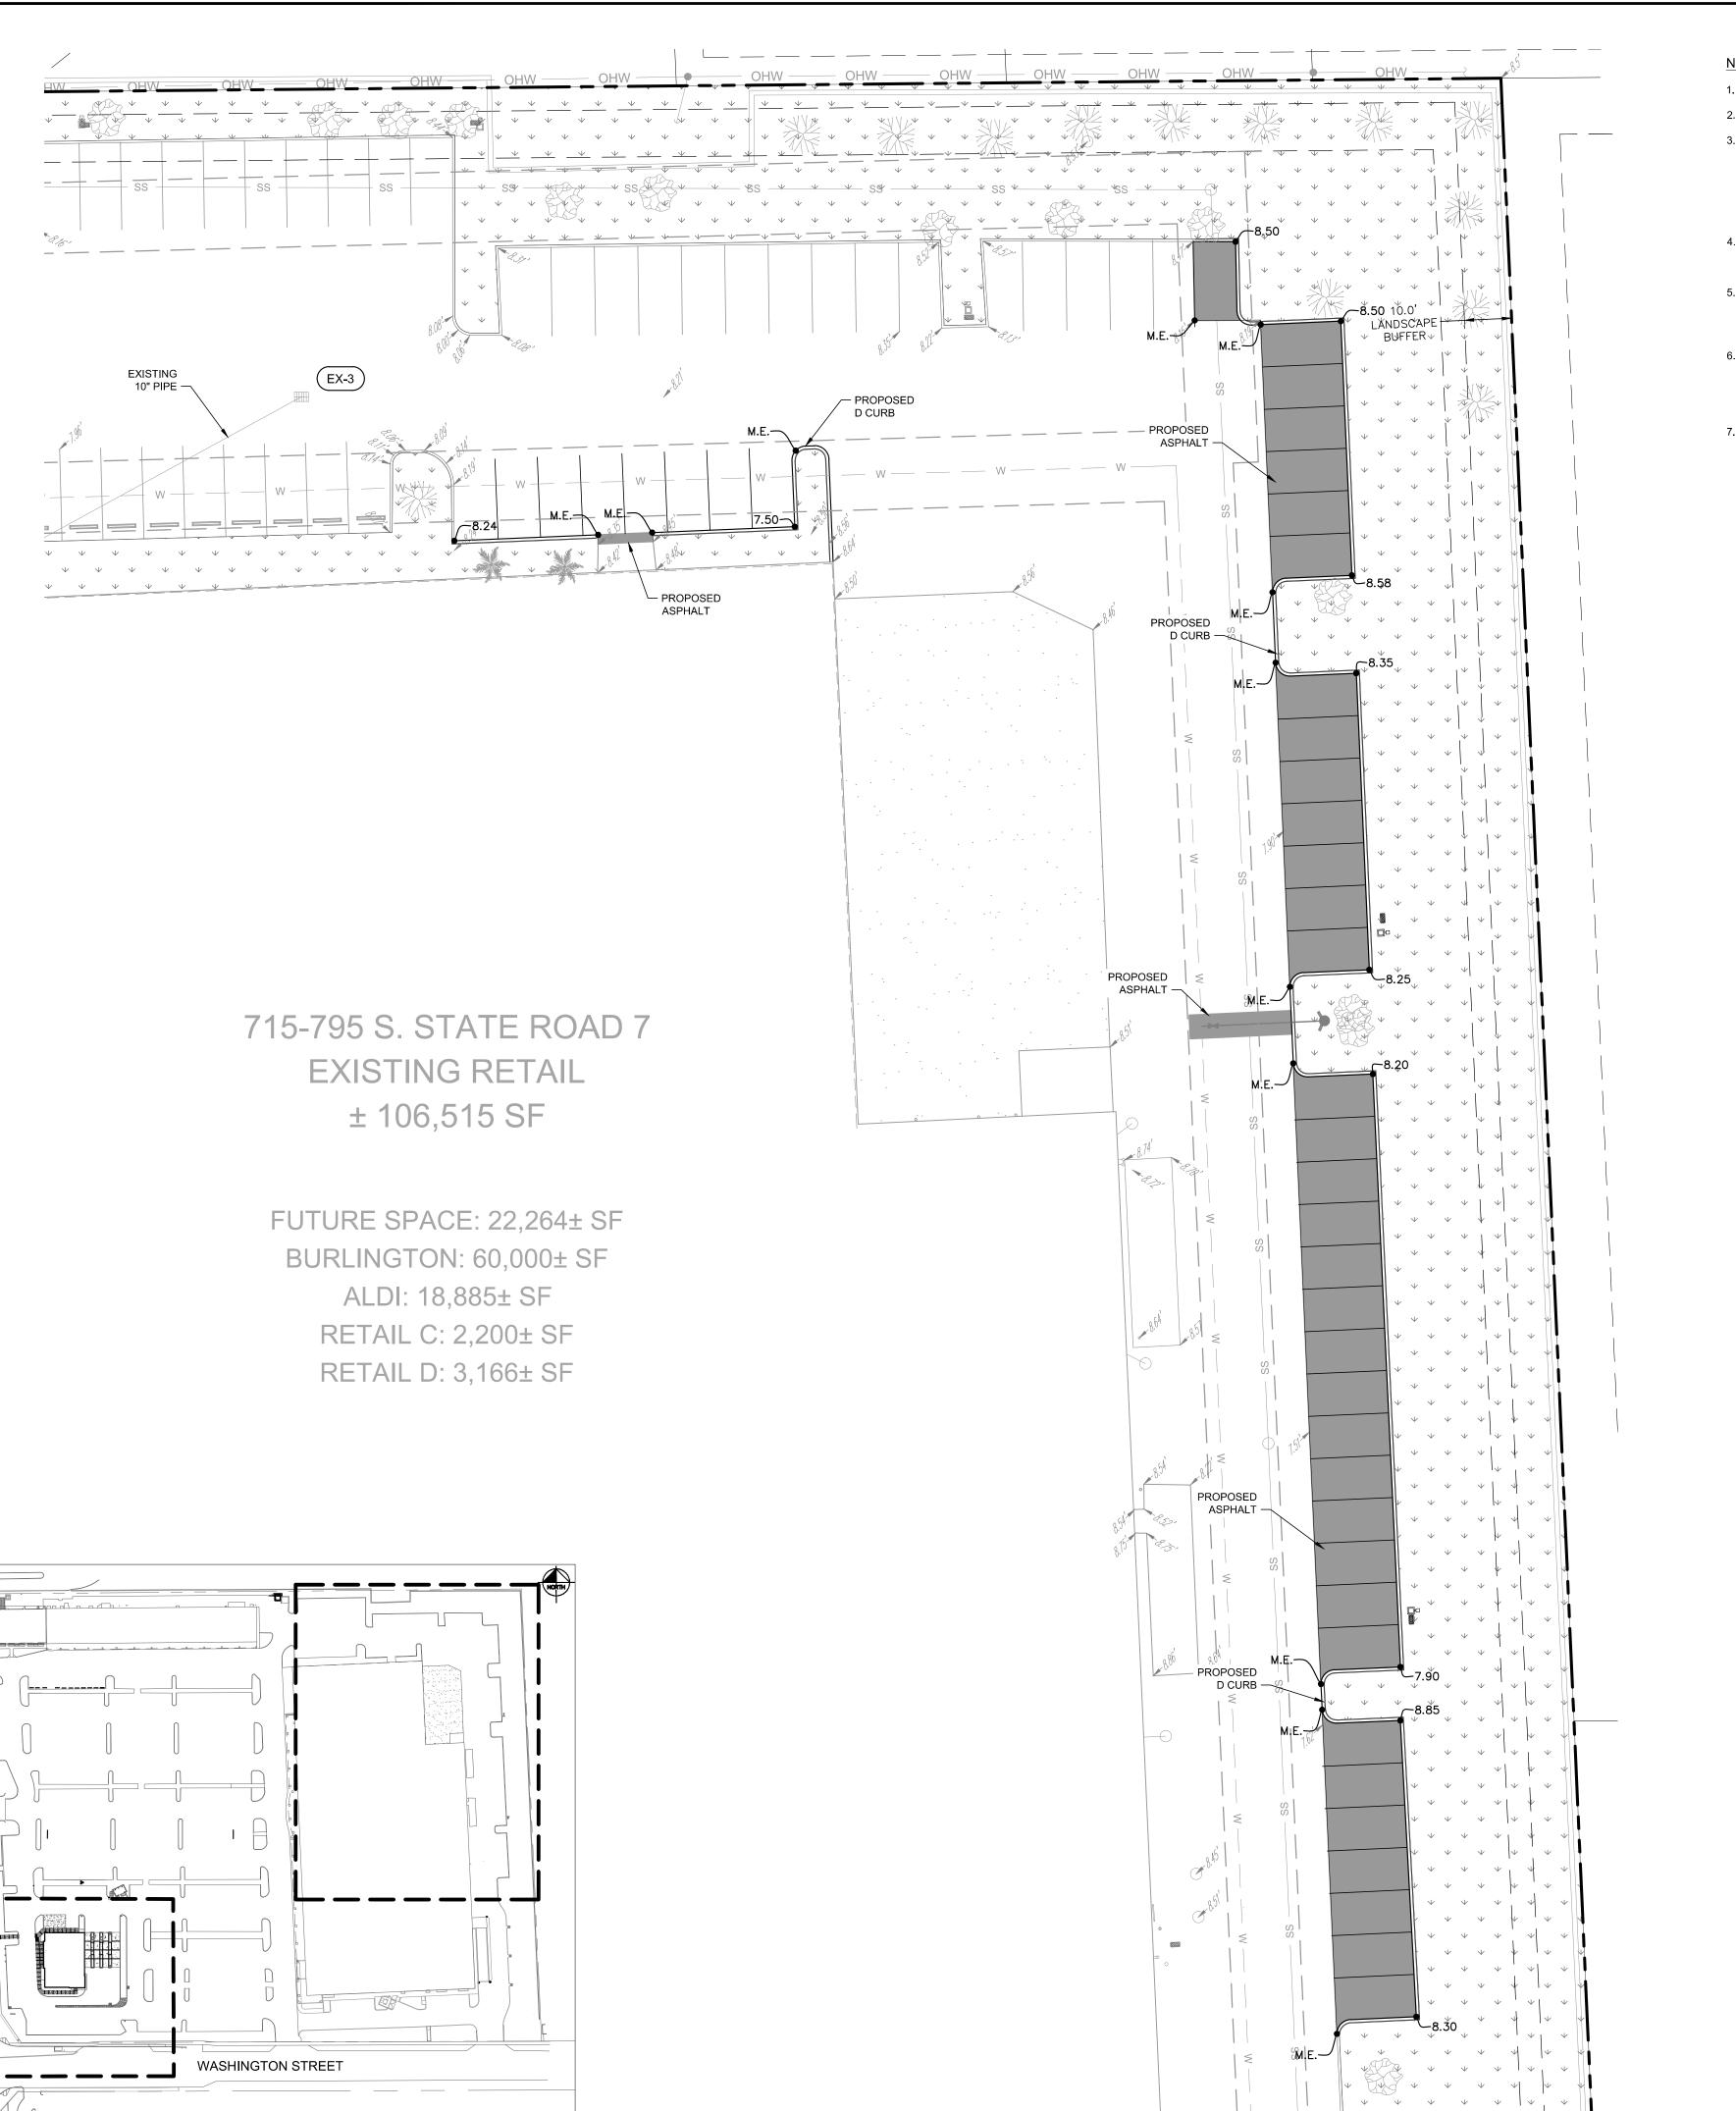

KEY MAP

<u>N.T.S.</u>

NOTES:

- 1. ADJUST RIM OF EXISTING INLETS TO MATCH PROPOSED GRADES.
- 2. ALL EXISTING PAVEMENT AND CONCRETE TO BE JOINED SHALL BE SAWCUT.
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<u>LEGEND</u>


PROPOSED GREEN SPACE




GRAPHIC SCALE IN FEET 0 10 20 40



PROPOSED ASPHALT PAVEMENT

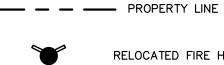


RELOCATED FIRE HYDRANT

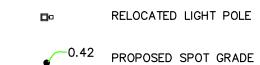

STRUCTURE TABLE



EX-3 EX. CATCH BASIN RIM EL=7.54± $INV.(W)=5.24\pm$

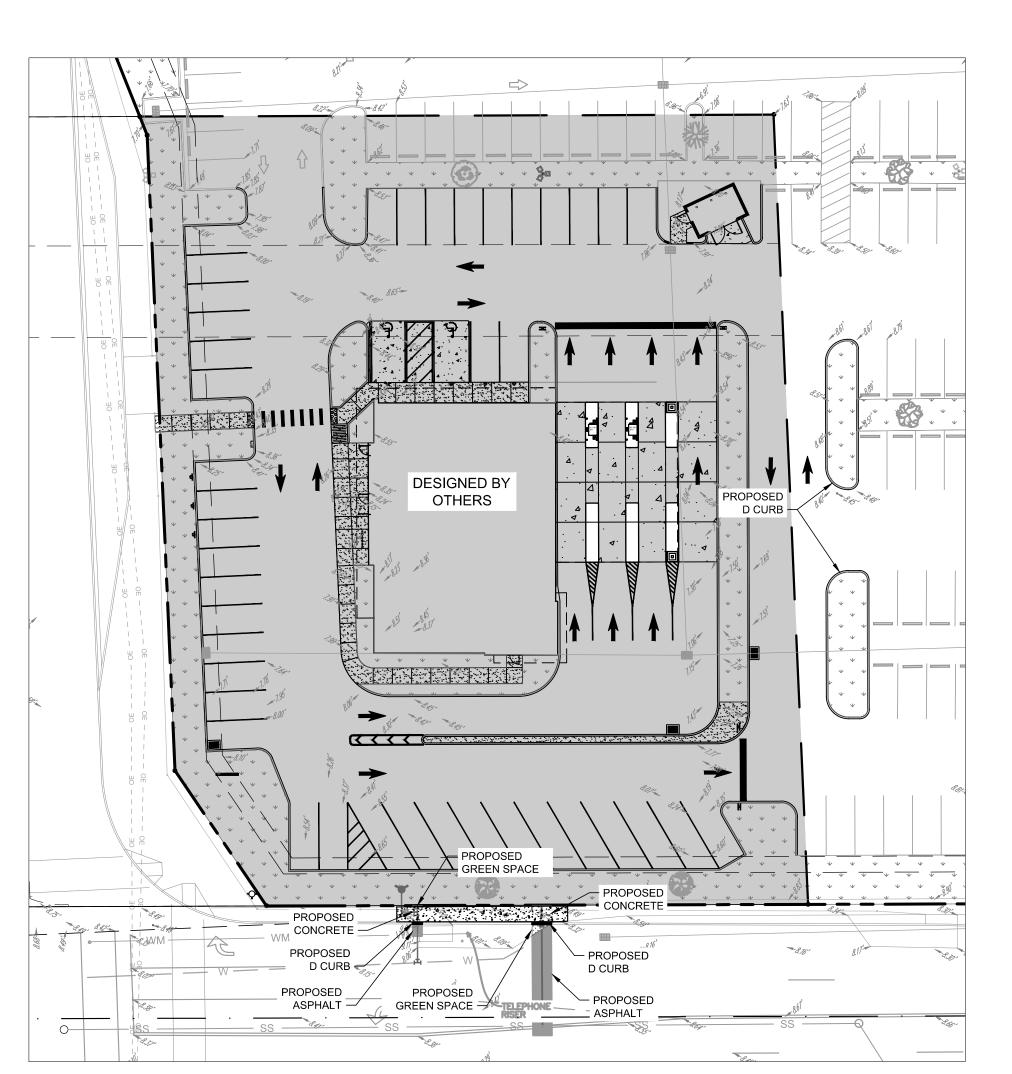


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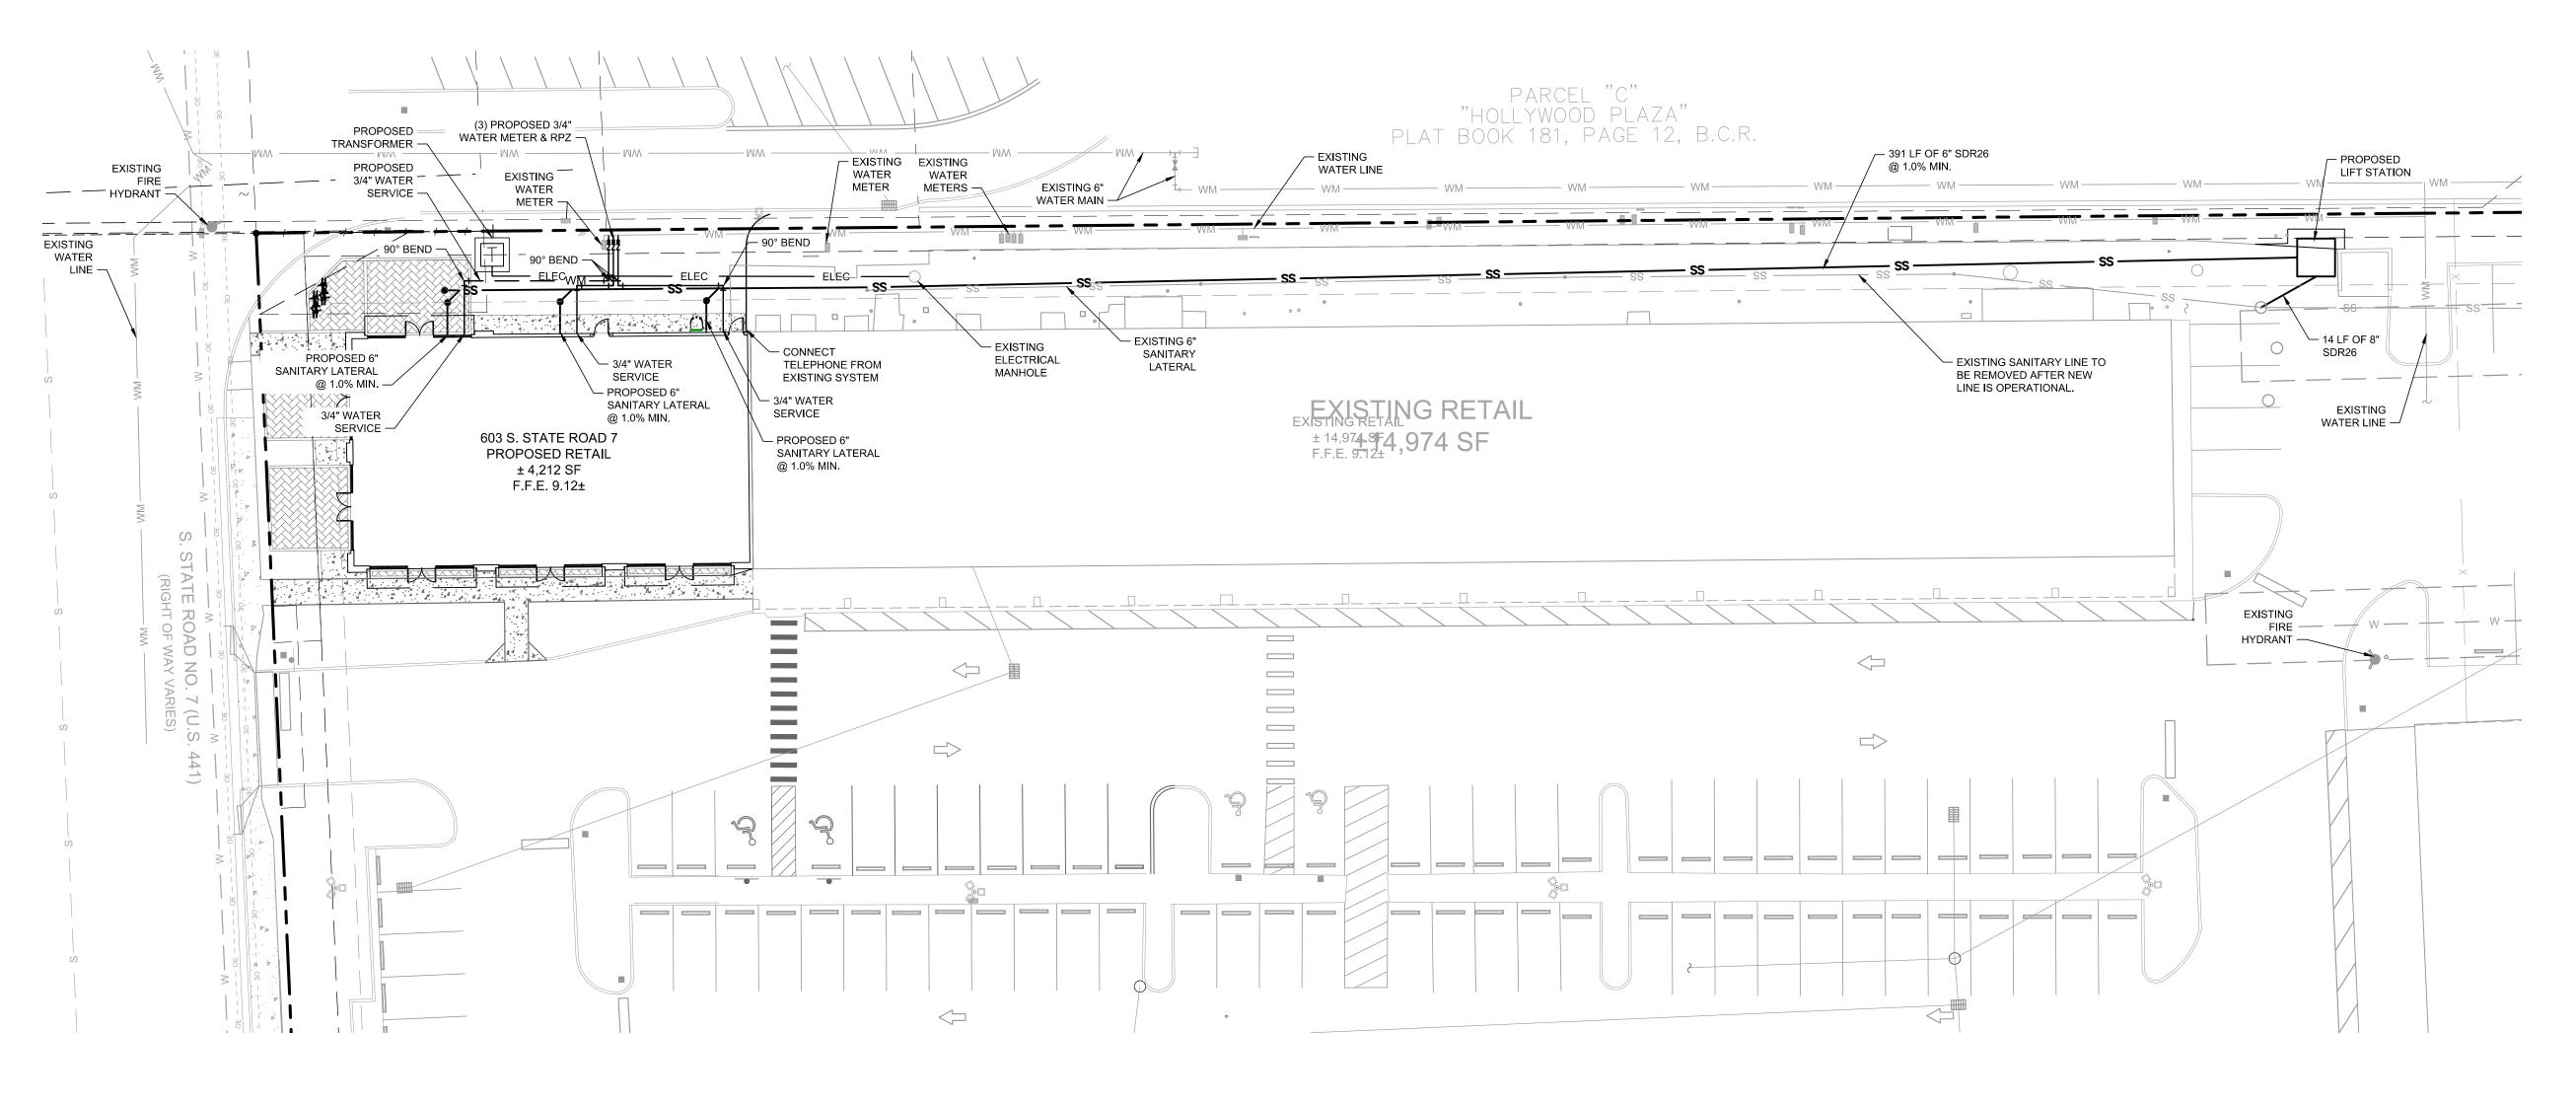
BEFORE YOU DIG

IT'S THE LAW! DIAL 811

Call before you dig. SUNSHINE STATE ONE CALL OF FLORIDA, INC.

SHEET NUMBER C-301



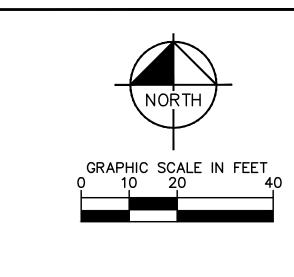

<u>LEGEND</u>

—— — LEASE LINE

——— SETBACK LINE

EXISTING FIRE HYDRANT

EXISTING STORM MANHOLE

LIGHT POLE (SEE ARCH PLANS)

PROPOSED PARKING SPACES

PROPOSED TYPE "D" CURB

PROPOSED STORM CATCH BASIN

UTILITY NOTES

- 1. ALL FILL MATERIAL IS TO BE IN PLACE AND COMPACTED BEFORE INSTALLATION OF PROPOSED UTILITIES. 2. CONTRACTOR SHALL NOTIFY THE UTILITY AUTHORITIES INSPECTORS 72 HOURS BEFORE CONNECTING TO ANY EXISTING LINE.
- 3. SANITARY SEWER PIPE SHALL BE AS FOLLOWS: 8" PVC SDR35 PER ASTM D 3034. FOR PIPES LESS THAT 12' DEEP
 - 8" PVC SDR26 PER ASTM D 3034, FOR PIPES MORE THAN 12' DEEP 6" PVC SCHEDULE 40
- DUCTILE IRON PIPE C-52 4. WATER LINES SHALL BE AS FOLLOWS:
- 6" AND LARGER, PVC C-900 PER ASTM D 2241 CLASS 200 UNDER COUNTY ROADS, OTHERWISE CLASS 150 6" AND LARGER DUCTILE IRON PIPE PER AWWA C150
- SMALLER THAN 6" EITHER COPPER TUBE TYPE "L" (SOFT) PER ANSI 816.22 OR PVC, 200 P.S.I., PER ASTM D1784 AND D2241. 5. MINIMUM TRENCH WIDTH SHALL BE 2 FEET.
- 6. ALL WATER JOINTS ARE TO BE MECHANICAL JOINTS WITH THRUST BLOCKING AS CALLED OUT IN SPECIFICATIONS. 7. ALL UTILITIES SHOULD BE KEPT TEN (10') APART (PARALLEL) OR WHEN CROSSING 18" VERTICAL CLEARANCE (OUTSIDE EDGE OF PIPE TO OUTSIDE EDGE OF PIPE).
- 8. CONTRACTOR SHALL MAINTAIN A MINIMUM OF 4'-0" COVER ON ALL WATERLINES. 9. IN THE EVENT OF A VERTICAL CONFLICT BETWEEN WATER LINES, SANITARY LINES, STORM LINES AND GAS LINES (EXISTING AND PROPOSED), THE SANITARY LINE
- SHALL BE DUCTILE IRON PIPE WITH MECHANICAL JOINTS AT LEAST 10 FEET ON BOTH SIDES OF CROSSING, THE WATER LINE SHALL HAVE MECHANICAL JOINTS WITH APPROPRIATE THRUST BLOCKING AS REQUIRED TO PROVIDE A MINIMUM OF 18" CLEARANCE. MEETING REQUIREMENTS OF ANSI A21.10 OR ANSI 21.11 10. UNDERGROUND LINES SHALL BE INSTALLED, INSPECTED AND APPROVED BEFORE BACKFILLING.
- 11. TOPS OF EXISTING MANHOLES SHALL BE RAISED AS NECESSARY TO BE FLUSH WITH PROPOSED PAVEMENT ELEVATIONS WITHIN PAVED AREAS, AND TO BE ONE FOOT ABOVE FINISHED GROUND ELEVATIONS WITH WATER TIGHT LIDS WITHIN LANDSCAPED AREAS.
- 12. ALL CONCRETE FOR ENCASEMENTS SHALL HAVE A MINIMUM 28 DAY COMPRESSION STRENGTH AT 3000 P.S.I. 13. EXISTING UTILITIES SHALL BE VERIFIED IN FIELD PRIOR TO INSTALLATION OF ANY NEW LINES.
- 14. REFER TO INTERIOR PLUMBING DRAWINGS FOR TIE-IN OF ALL UTILITIES. 15. CONTRACTOR IS RESPONSIBLE FOR COMPLYING TO THE SPECIFICATIONS OF THE LOCAL AUTHORITIES (HOLLYWOOD) WITH REGARDS TO MATERIALS AND
- INSTALLATION OF THE WATER AND SEWER LINES. 16. THE CONTRACTOR IS SPECIFICALLY CAUTIONED THAT THE LOCATION AND/OR ELEVATION OF EXISTING UTILITIES AS SHOWN ON THESE PLANS IS BASED ON
- RECORDS OF THE VARIOUS UTILITY COMPANIES, AND WHERE POSSIBLE, MEASUREMENTS TAKEN IN THE FIELD. THE INFORMATION IS NOT TO BE RELIED ON AS BEING EXACT OR COMPLETE. THE CONTRACTOR MUST CALL THE APPROPRIATE UTILITY COMPANIES AT LEAST 72 HOURS BEFORE ANY EXCAVATION TO REQUEST EXACT FIELD LOCATION OF UTILITIES. IT SHALL BE THE RESPONSIBILITY OF THE CONTRACTOR TO RELOCATE ALL EXISTING UTILITIES WHICH CONFLICT WITH THE PROPOSED IMPROVEMENTS SHOWN ON THE PLANS.
- 17. CONTRACTOR IS RESPONSIBLE FOR ALL NECESSARY INSPECTIONS AND/OR CERTIFICATIONS REQUIRED BY CODES AND/OR UTILITY SERVICE COMPANIES. THIS AND THE FINAL CONNECTIONS OF THE SERVICE SHALL BE COMPLETED 30 DAYS PRIOR TO STORE POSSESSION.
- 18. CONTRACTOR SHALL COORDINATE WITH ALL UTILITY COMPANIES FOR INSTALLATION REQUIREMENTS AND SPECIFICATIONS.
- 19. REFER TO BUILDING PLANS FOR SITE LIGHTING ELECTRICAL PLAN. 20. UNDERGROUND UTILITY LINES SHALL BE INSTALLED, INSPECTED AND APPROVED BEFORE BACKFILLING.
- 21. REFER TO INTERIOR PLUMBING DRAWINGS FOR TIE-IN OF ALL UTILITIES. 22. THE CONTRACTOR SHALL BE RESPONSIBLE FOR LOCATING EXISTING WATER MAINS, FORCE MAINS, SANITARY SEWER AND STORM MAINS AND MAINTAIN
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- LICENSE IN ACCORDANCE WITH CH. 489 OF THE FLORIDA STATUTES. 25. ALL UTILITY MAIN LENGTHS SHOWN ARE APPROXIMATE.
- 26. THE HORIZONTAL MINIMUM SEPARATION OF WATER AND SEWER MUST BE MET IN ACCORDANCE TO RULE 62-555-314.
- 27. ALL WATERMAINS TO HAVE MINIMUM 36" OF COVER AND MUST PROVIDE MINIMUM 12" OF SEPARATION.

IN CROSSINGS CONTAINING WATER LINES; WATER LINE MUST BE PLACED ABOVE STORM AND SANITARY SEWER, WITH A MINIMUM OF 6" VERTICAL SEPARATION, UNLESS OTHERWISE STATED.

28. PIPE COLOR CODING REQUIRED, REFER TO 62-555.320(21)(B)(3), F.A.C.

THE PRESENCE OF GROUNDWATER SHOULD BE ANTICIPATED ON THIS PROJECT. CONTRACTOR'S BID SHALL INCLUDE CONSIDERATION FOR ADDRESSING THIS ISSUE.

DIAL 811 Call before you dig

BEFORE YOU DIG IT'S THE LAW! Know what's **below.**

WASHINGTON STREET

KEY MAP

SUNSHINE STATE ONE CALL OF FLORIDA, INC.


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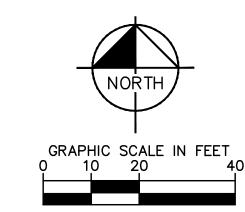
PLAN SHOP



- 1. ALL FILL MATERIAL IS TO BE IN PLACE AND COMPACTED BEFORE INSTALLATION OF PROPOSED UTILITIES. 2. CONTRACTOR SHALL NOTIFY THE UTILITY AUTHORITIES INSPECTORS 72 HOURS BEFORE CONNECTING TO ANY
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 - 6" AND LARGER DUCTILE IRON PIPE PER AWWA C150 SMALLER THAN 6" EITHER COPPER TUBE TYPE "L" (SOFT) PER ANSI 816.22 OR PVC, 200 P.S.I., PER ASTM D1784 AND D2241.
- 5. MINIMUM TRENCH WIDTH SHALL BE 2 FEET. 6. ALL WATER JOINTS ARE TO BE MECHANICAL JOINTS WITH THRUST BLOCKING AS CALLED OUT IN SPECIFICATIONS.
- ALL UTILITIES SHOULD BE KEPT TEN (10') APART (PARALLEL) OR WHEN CROSSING 18" VERTICAL CLEARANCE (OUTSIDE EDGE OF PIPE TO OUTSIDE EDGE OF PIPE).
- (EXISTING AND PROPOSED), THE SANITARY LINE SHALL BE DUCTILE IRON PIPE WITH MECHANICAL JOINTS AT LEAST 10 FEET ON BOTH SIDES OF CROSSING, THE WATER LINE SHALL HAVE MECHANICAL JOINTS WITH APPROPRIATE THRUST BLOCKING AS REQUIRED TO PROVIDE A MINIMUM OF 18" CLEARANCE. MEETING REQUIREMENTS OF ANSI A21.10 OR ANSI 21.11 (AWWA C-151) (CLASS 50).
- 10. UNDERGROUND LINES SHALL BE INSTALLED, INSPECTED AND APPROVED BEFORE BACKFILLING. 11. TOPS OF EXISTING MANHOLES SHALL BE RAISED AS NECESSARY TO BE FLUSH WITH PROPOSED PAVEMENT
- ELEVATIONS WITHIN PAVED AREAS, AND TO BE ONE FOOT ABOVE FINISHED GROUND ELEVATIONS WITH WATER
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- 18. CONTRACTOR SHALL COORDINATE WITH ALL UTILITY COMPANIES FOR INSTALLATION REQUIREMENTS AND
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- 20. UNDERGROUND UTILITY LINES SHALL BE INSTALLED, INSPECTED AND APPROVED BEFORE BACKFILLING. 21. REFER TO INTERIOR PLUMBING DRAWINGS FOR TIE-IN OF ALL UTILITIES.
- 22. THE CONTRACTOR SHALL BE RESPONSIBLE FOR LOCATING EXISTING WATER MAINS, FORCE MAINS, SANITARY SEWER AND STORM MAINS AND MAINTAIN MINIMUM CLEARANCES BETWEEN WATER MAINS AND OTHER UTILITIES AT ALL POINTS ALONG THEIR LENGTH AS REQUIRED IN THE PLANS, DETAILS AND SPECIFICATIONS.
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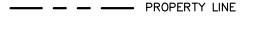
ABOVE STORM AND SANITARY SEWER, WITH A MINIMUM OF 6" VERTICAL SEPARATION, UNLESS OTHERWISE STATED.

IN CROSSINGS CONTAINING WATER LINES; WATER LINE MUST BE PLACED



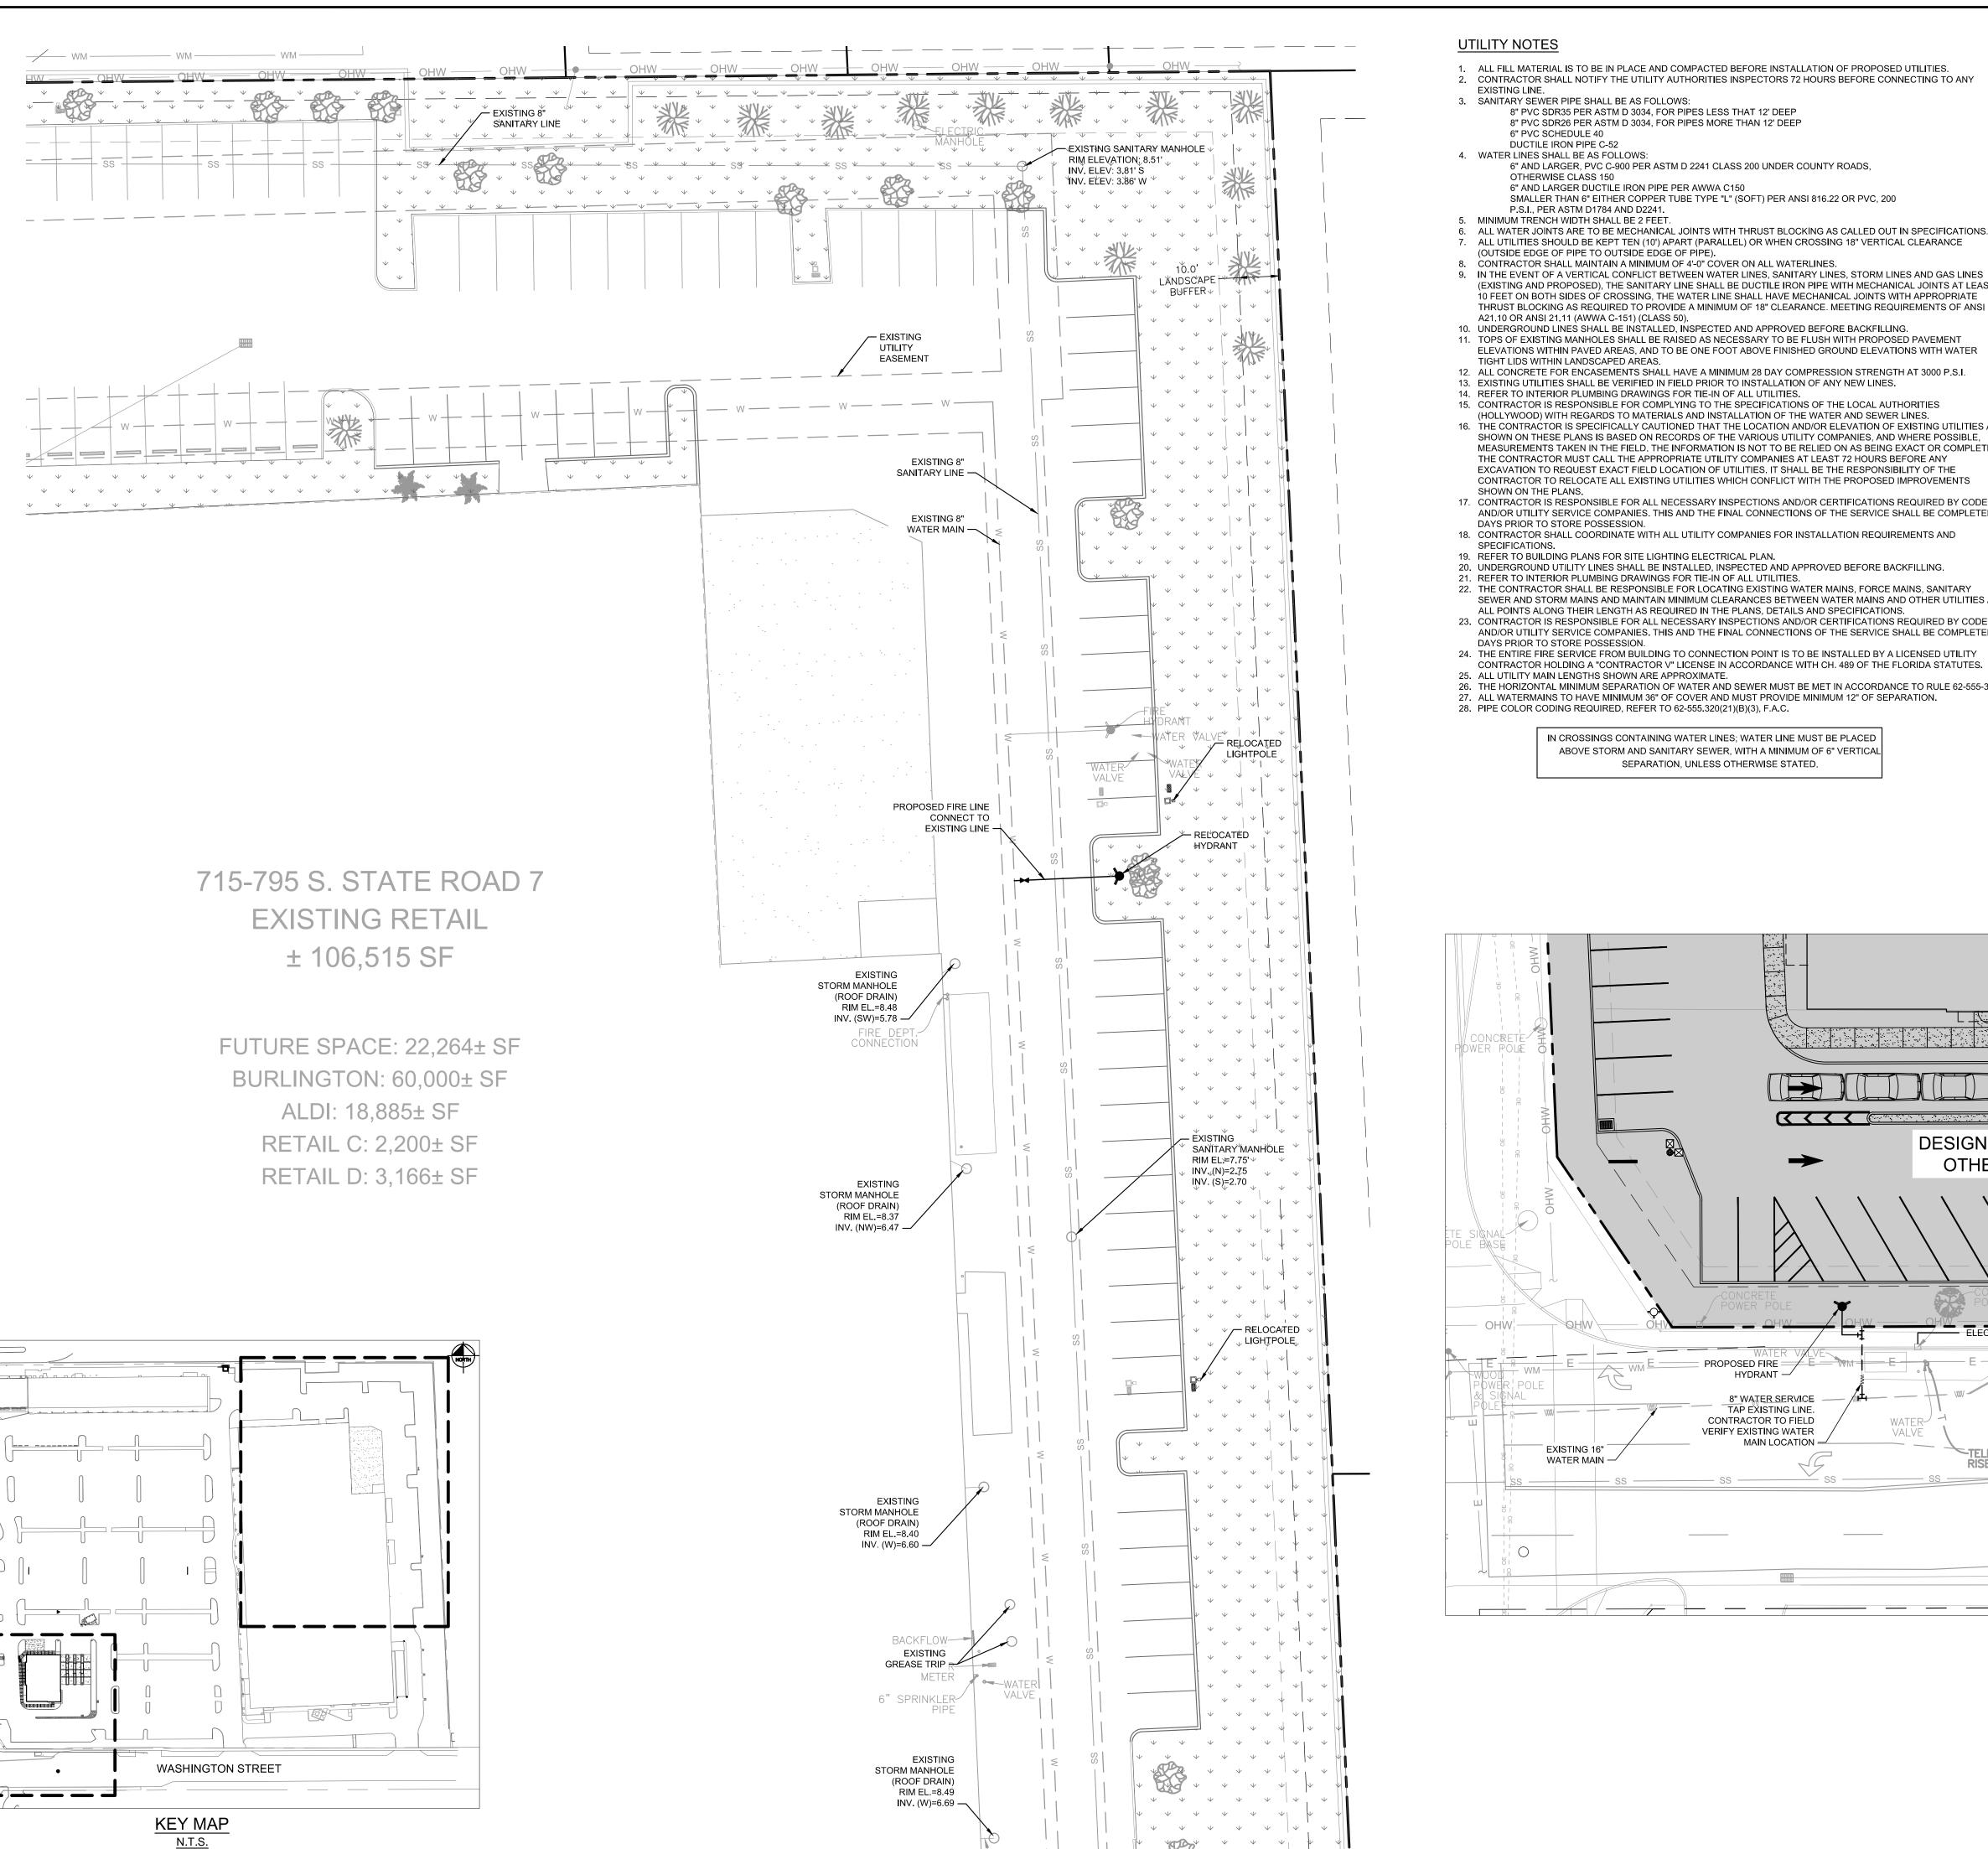


PROPOSED GREEN SPACE





STRUCTURE TABLE

SANITARY SEWER MANHOLE RIM EL=X.XX± $INV.(N)=X.XX\pm$

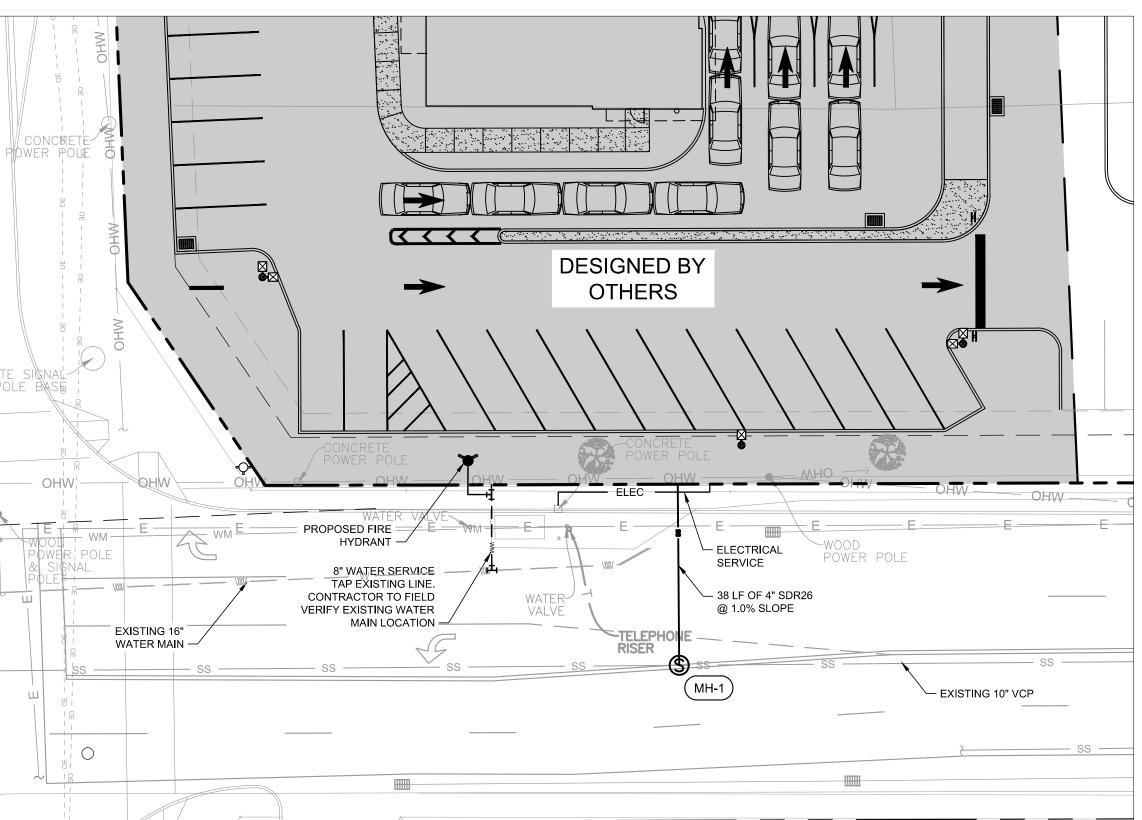

THE PRESENCE OF GROUNDWATER SHOULD BE ANTICIPATED ON THIS PROJECT. CONTRACTOR'S BID SHALL INCLUDE CONSIDERATION FOR ADDRESSING THIS ISSUE.

CALL 48 HOURS BEFORE YOU DIG

IT'S THE LAW! **DIAL 811**


SUNSHINE STATE ONE CALL OF FLORIDA, INC.

Call before you dig.

C-401

0 24

SHEET NUMBER

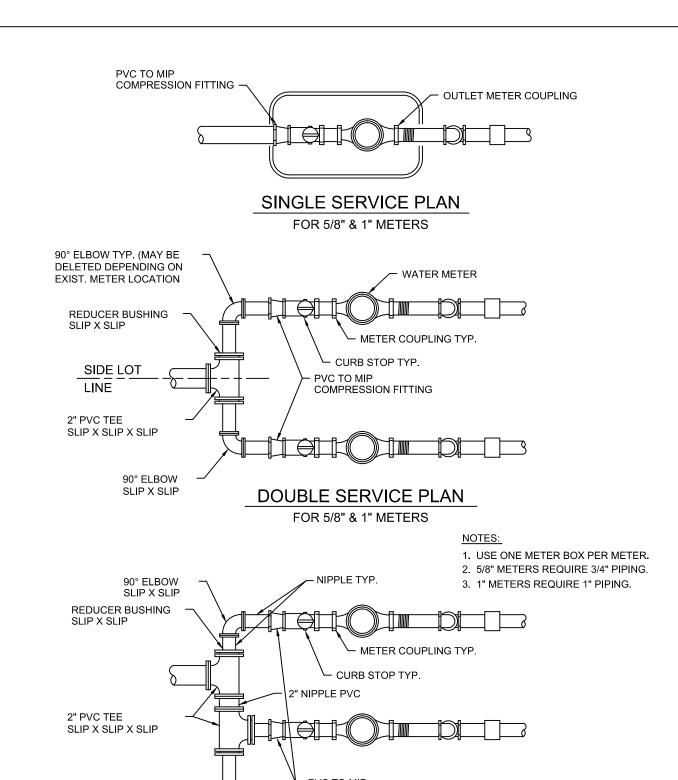

COMPRESSION FITTING

TRIPLE SERVICE PLAN

FOR 5/8" & 1" METERS


- FINAL GRADE

PUMPER CONNECTION FACING STREET

30"x30" CONC.

OMIT IN PAVED

AREAS

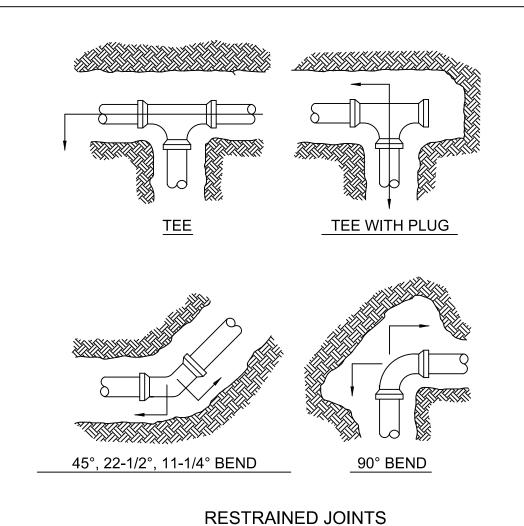

PIPE SIZE

4" | 6" | 8" | 10" | 12"

76 | 97 | 117 | 136 | 162

SAND STRAINER-

TEST COCK _

CONC. SLAB -

BALL VALVE -

**NOTE: RPZ DETAIL IS NOT A CITY

OF HOLLYWOOD STANDARD DETAIL.

TEST COCK -

- BALL VALVE -

PLAN VIEW

N.T.S.

REDUCE PRESSURE ZONE (RPZ)

1. LENGTH SHOWN IN THE TABLE TO BE RESTRAINED IN THE DIRECTION OF THE ARROWS,


2. RESTRAINED LENGTHS TABULATED ARE BASED ON THE FOLLOWING CONDITIONS:

F. 18' SPAN BETWEEN THE FIRST TWO UNRESTRAINED JOINTS ON EITHER SIDE OF THE TEE. (9' EACH WAY).

3. USE RESTRAINED JOINTS FOR FITTINGS AND MECHANICAL JOINT PIPE.

FINISHED GRADE

SECTION "A-A" 30° MINIMUM **---**

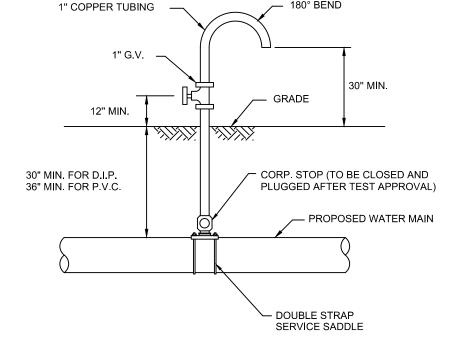

SAMPLING POINT

SAMPLING POINT SHALL NOT BE REMOVED UNTIL APPROVAL IS OBTAINED FROM BROWARD COUNTY PUBLIC HEALTH UNIT (B.C.P.H.U.)

- CONC. POURED TO UNDISTURBED SOIL

ALL AROUND

C.I. VALVE BOX

- 90° ELBOW

∽ 2" GALVANIZED OR PVC

RISER PIPE

PLAN VIEW FLUSHING RISER

1. PIPE JOINT COMPOUND SHALL BE APPLIED TO MALE THREADS ONLY. 2. COAT ALL EXPOSED THREADS WITH BITUMASTIC BEFORE BACKFILLING. 3. 2" TAP IN BOTTOM OF CAP ON MAIN.

- REDUCED PRESSURE BACKFLOW

- REDUCED PRESSURE BACKFLOW

REDUCE PRESSURE ZONE (RPZA) 3/4" - 2"

REDUCE PRESSURE ZONE (RPZA) 2 1/2" - 10"

MODELS: HERSEY - DDC-II-OSYRW WATTS - 774 DCDA / 774 XDCDA

FEDCO - 806YD-OSYRW

MODELS: HERSEY - FRP-II WATTS - 009 QT OR 909 QT

FEDCO - 825-Y-B

PREVENTION ASSEMBLY

PREVENTION ASSEMBLY

FINISHED GRADE

BRONZE ANGLE

VALVE

2" CORPORATION STOP


M.J. CAP AND

RETAINER GLAND \

4. PLYWOOD AND CONCRETE TO HAVE A HEIGHT EQUAL TO THE DIAMETER OF THE PIPE.

TESTING AND DISINFECTION

- 1. NO CONNECTIONS TO THE EXISTING LINES SHALL BE MADE UNTIL THE PRESSURE AND BACTERIOLOGICAL TESTS HAVE BEEN PERFORMED ON THE PROPOSED WATER MAINS AND THE SYSTEM IS ACCEPTABLE TO THE CITY OF HOLLYWOOD AND BROWARD COUNTY PUBLIC HEALTH UNIT (BCPHU).
- 2. THE PRESSURE TEST SHALL BE FOR 2 HOURS AT 150 PSI AND IN ACCORDANCE WITH ANSI/AWWA STANDARD C600-05 OR LATEST REVISION. PRESSURE TEST SHALL BE WITNESSED BY THE CITY OF HOLLYWOOD. THE ALLOWABLE LEAKAGE SHALL BE LESS THAN THE NUMBER OF GALLONS PER HOUR AS DETERMINED BY THE FORMULA:

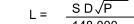

- L = THE ALLOWABLE LEAKAGE IN GALLONS PER HOUR. S = THE LENGTH OF PIPE BEING TESTED. D = THE NOMINAL DIAMETER OF THE PIPE BEING TESTED. P = THE AVERAGE TEST PRESSURE IN POUNDS PER SQUARE INCH.
- 3. THE COMPLETE LENGTH OF THE PROPOSED WATER MAIN SHALL BE TESTED, IN LENGTHS NOT TO EXCEED 2,000 FEET PER TEST.
- 4. PROPOSED WATER MAINS SHALL BE DISINFECTED IN ACCORDANCE WITH ANSI/AWWA STANDARD C651-05 OR LATEST REVISION AND BACTERIOLOGICALLY TESTED FOR TWO CONSECUTIVE DAYS. THE CITY OF HOLLYWOOD WATER TREATMENT PLANT LABORATORY WILL BE THE SOLE SAMPLER AND WILL PROVIDE BACTERIOLOGICAL TESTING.

SEPARATION REQUIREMENTS OF F.D.E.P. / F.D.N.R.P.

Sanitary sewers and force mains should cross under water mains whenever possible. Sanitary sewers and force mains crossing water mains shall be laid to provide a minimum vertical distance of 18 inches between the invert of the upper pipe and the crown of the lower pipe whenever possible.

Where sanitary sewers and force mains must cross a water main with less than 18 inches vertical distance, both the sewer and the water main shall be constructed of ductile iron pipe (DIP) at the crossing. Sufficient lengths of DIP must be used to provide a minimum seperation of 10 feet between any two joints. All joints on the water main within 20 feet of the crossing must be mechanically restrained. A minimum vertical clearance of 6 inches must be maintained at all crossings.

All crossings shall be arranged so that the sewer pipe joints and the water main pipe joints are equidistant from the point of crossing (pipes centered on the crossing).


Where a new pipe conflicts with an existing pipe with less than 18 inches vertical clearance, the new pipe shall be arranged to meet the crossing requirements above.

A minimum 10 foot horizontal separation shall be maintained between any type of sewer and water main in parallel installations whenever possible.

In cases where it is not possible to maintain a 10 foot horizontal separation, the water main must be laid in a separate trench or on an undisturbed earth shelf located on one side of the sewer or force main at such an elevation that the bottom of the water main is at least 18 inches above the top of the sewer.


Where it is not possible to maintain a vertical distance of 18 inches in a parallel instalations, the water main shall be constructed of DIP and the sanitary sewer or force main shall be constructed of DIP with a minimum vertical distance of 6 inches. The water main should always be above the sewer. Joints on the water main shall be located as far apart as possible from joints on the sewer or force main (staggered joints).

All DIP shall be class 50 or higher. Adequate protective measures against corrosion shall be used as determined by the design.

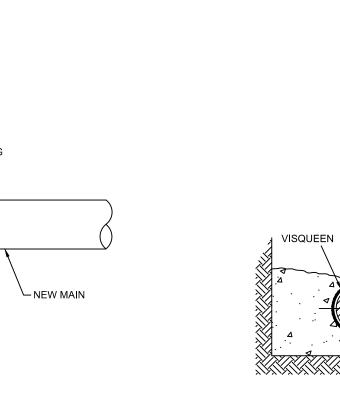

90° ELBOW

SLIP X SLIP

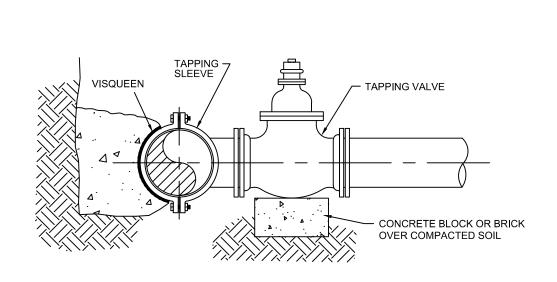

PLAN

ELEVATION


TYPICAL TAPPING SLEEVE AND VALVE

CHK'D APPR'D

1. NOTIFY THE CITY OF HOLLYWOOD 48 HOURS IN ADVANCE OF PROPOSED TAP. 2. TAPPING MUST BE DONE IN THE PRESENCE OF AN AUTHORIZED CITY REPRESENTATIVE.

DESCRIPTION

REVISIONS

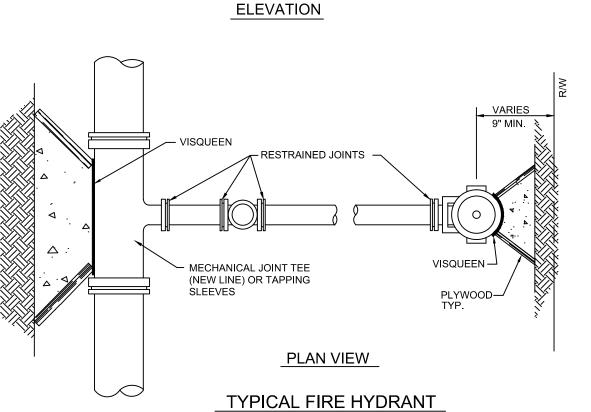


INSTALLATION DETAILS

PROJECT No

CAD NAME_

DATE _

1. GUARD POSTS TO BE INSTALLED AS REQUIRED FOR SAFETY OR AS APPROVED BY THE UTILITIES DEPT. (4 POSTS MAX.) 2. GUARD POSTS TO BE 4" DIA. GALV. STEEL PIPE FILLED WITH CONCRETE

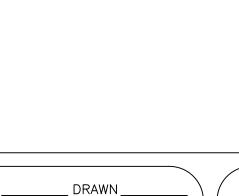

_ SCALE <u>AS NOTE</u>D

NOTES:

-3000 PSI CONCRETE

FROM CENTER OF FITTINGS.

A. LAYING CONDITION: TYPE 3
B. SOIL DESIGNATION: SAND/SIL

DEPTH OF COVER: 3 FEET.

SAFETY FACTOR: 1.5

FLORIDA P.E. No.

DESIGNED_ CHECKED_

ENGINEERING SUPPORT SERVICES PUBLIC UTILITIES DEPARTMENT CITY OF HOLLYWOOD FLORIDA

THE PRESENCE OF GROUNDWATER SHOULD BE ANTICIPATED ON THIS PROJECT. CONTRACTOR'S BID SHALL INCLUDE CONSIDERATION FOR ADDRESSING THIS ISSUE.

CALL 48 HOURS BEFORE YOU DIG

IT'S THE LAW! Know what's **below. DIAL 811**

Call before you dig. SUNSHINE STATE ONE CALL OF FLORIDA, INC.

SHEET NUMBER C-402

00

ОШ Q Q S

CIT

- BACKFILL CONSOLIDATED

TO CENTERLINE OF PIPE

➤ FLAT OR RESTORED TRENCH BOTTOM

CAREFULLY PLACED SELECT

BACKFILL IN TWO 6" LAYERS

MAXIMUM DENSITY UNDER

ELSEWHERE.

FLAT OR RESTORED

TRENCH BOTTOM

SIDEWALK-

PVC TO MIP

(SEE NOTE 4)

REDUCER BUSHING

COMPRESSION FITTING

SLIP X SLIP

2" SCHEDULE 80 PVC

LENGTH VARIES

CHK'D APPR'D

(SEE NOTE 4)

- WATER METER BOX

WATER METER

PROPERTY OWNER'S

CITY OF HOLLYWOOD FLORIDA

(SEE NOTE 6)

WITH PACK


RESPONSIBILITY | RESPONSIBILITY

JOINT

EACH COMPACTED TO 100% OF

STRUCTURES OR PAVED AREAS


AND 95% OF MAXIMUM DENSITY

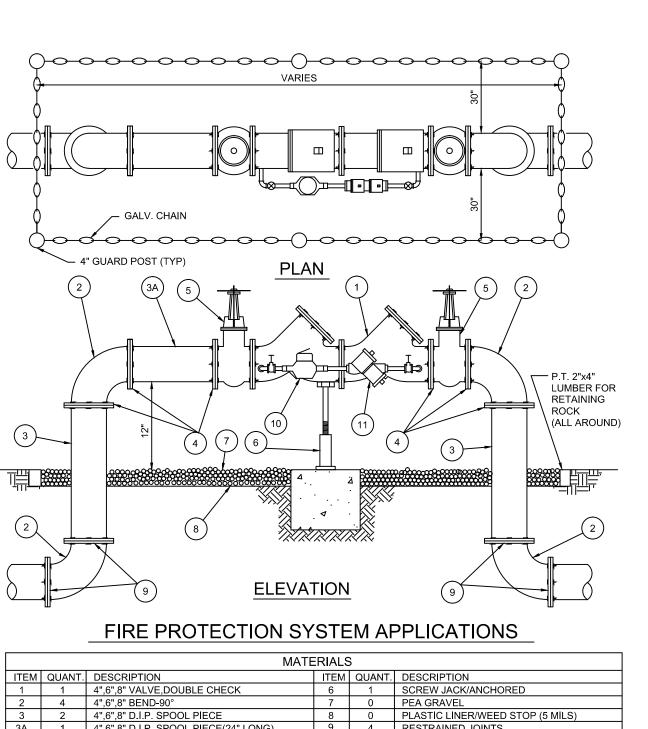


EM	QUANT.	DESCRIPTION	ITEM	QUANT	DESCRIPTION
1	1	4",6",8" VALVE,DOUBLE CHECK	6	1	SCREW JACK/ANCHORED
2	4	4",6",8" BEND-90°	7	0	PEA GRAVEL
3	2	4",6",8" D.I.P. SPOOL PIECE	8	0	PLASTIC LINER/WEED STOP (5 MILS)
3A	1	4",6",8" D.I.P. SPOOL PIECE(24" LONG)	9	4	RESTRAINED JOINTS
4	5	4",6",8" FLANGE, D.I.P.	10	1	LOW FLOW METER
5	2	4",6",8" VALVE, GATE	11	1	VALVE, BYPASS DOUBLE CHECK

1. FIELD ADJUST AND CUT ITEM 3 TO THE PROPER LENGTH. 2. ALL PIPING SHALL BE D.I.P. CL 50/52 AS APPLICABLE TO MINIMUM STANDARDS. 3. ALL LOW FLOW METER PIPING SHALL BE BRASS OR COPPER. 4. PROTECTIVE 4" GALV. GUARD POSTS SHALL BE SPACED EVENLY APART AS SHOWN ABOVE OR IN ACCORDANCE WITH INSPECTOR'S DIRECTIONS. CHAIN SHALL BE LOOPED THROUGH EYELETS CAST IN CONCRETE TOP. 5. USE 45° BENDS WHEN WORKING AREA IS NOT LIMITED.


DOUBLE DETECTOR CHECK VALVE AND BACKFLOW PREVENTER

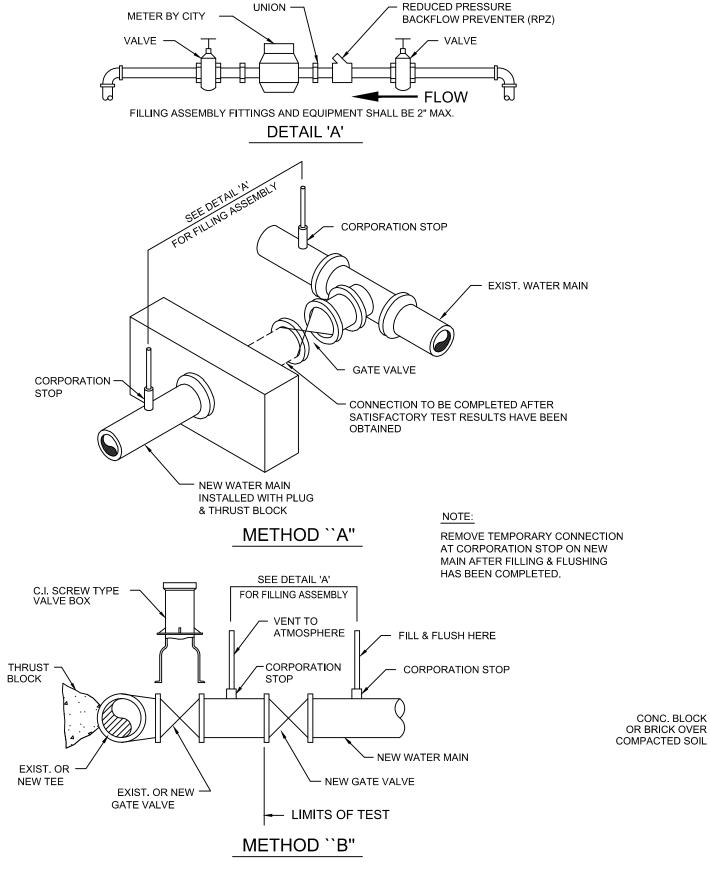



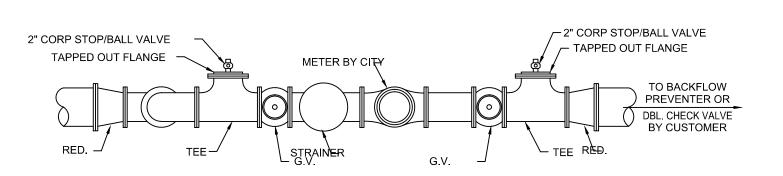


PLAN

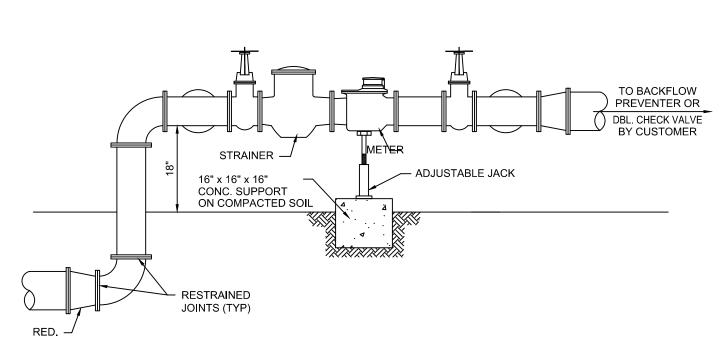


ELEVATION

- 1. THE WATER METER AND STRAINER BY THE CITY OF HOLLYWOOD.
- 2. THE CITY'S RESPONSIBILITY ENDS AT THE REDUCER PRECEDING THE BACKFLOW PREVENTER. 3. TAPPED OUT FLANGE SHOULD MATCH SIZE OF TEE AND STANDARD 2" CORP STOPP OR BALL VALVE.


3" OR LARGER METER INSTALLATION (FIRE LINES AND COMMERCIAL APPLICATIONS)

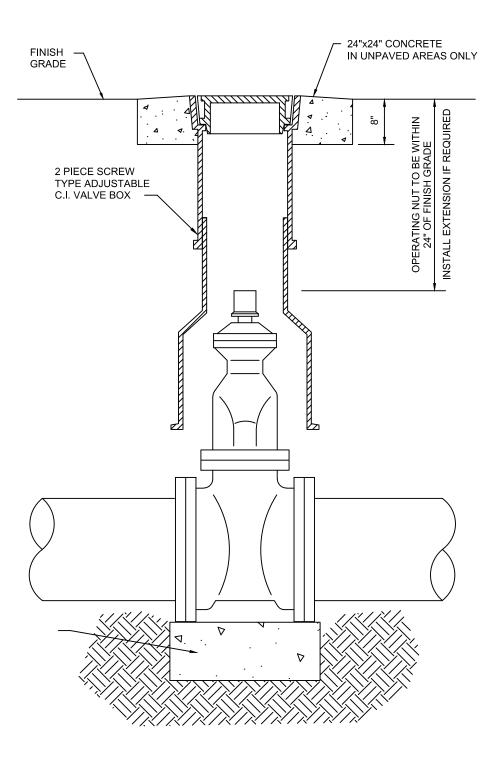

TYPICAL GATE VALVE AND VALVE BOX

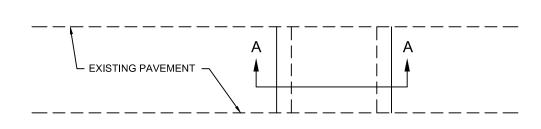

PLAN VIEW

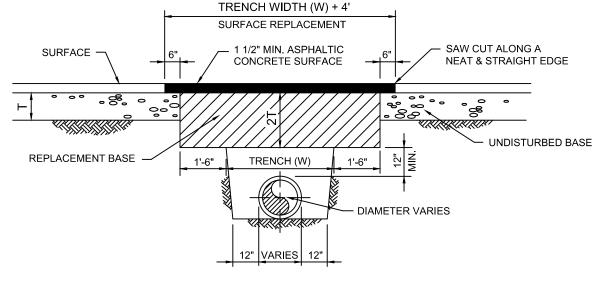



SECTION "A-A"


FLEXIBLE PAVEMENT RESTORATION PERPENDICULAR UTILITY INSTALLATION

(CITY STREETS ONLY)

- 1. REPLACED BASE MATERIAL OVER TRENCH SHALL BE TWICE THE THICKNESS OF THE ORIGINAL BASE, MINIMUM 12", MAXIMUM 18".
- 2. BASE MATERIAL SHALL BE PLACED IN 6" MAXIMUM (LOOSE MEASUREMENT) LAYERS AND EACH LAYER THOROUGHLY ROLLED OR TAMPED TO 98% OF MAXIMUM DENSITY, PER AASHTO T-180.
- 3. ASPHALT CONCRETE PAVEMENT JOINTS SHALL BE MECHANICALLY SAWED. 4. SURFACE TREATED PAVEMENT JOINTS SHALL BE LAPPED AND FEATHERED.
- 5. SURFACE MATERIAL SHALL BE CONSISTENT WITH THE EXISTING SURFACE. 6. BASE MATERIAL SHALL HAVE A MINIMUM LBR OF 100 AND A MINIMUM CARBONATE CONTENT OF 70%.
- 7. IF THE TRENCH IS FILLED TEMPORARILY, IT SHALL BE COVERED WITH A 2" ASPHALTIC CONCRETE PATCH TO KEEP THE FILL MATERIAL FROM RAVELING UNTIL REPLACED WITH A PERMANENT PATCH.
- 8. BACKFILL SHALL BE IN ACCORDANCE WITH DETAIL OF PIPE LAYING CONDITION TYPICAL SECTION, EXCEPT AS SHOWN ABOVE.

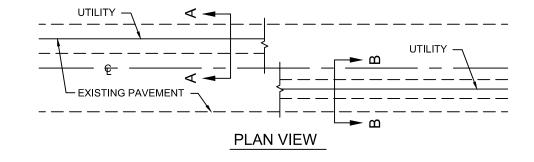

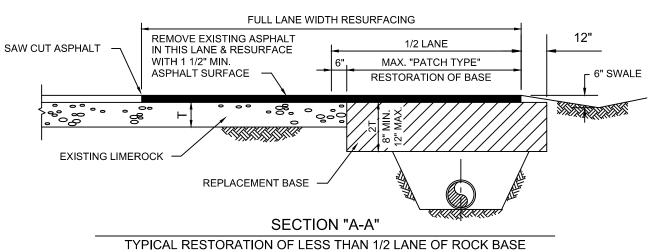

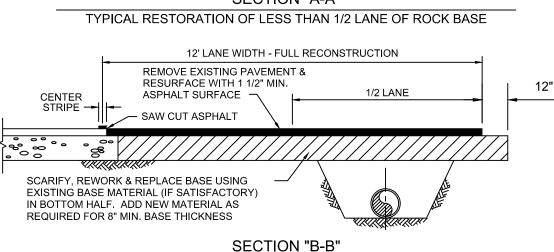


TYPICAL RESTORATION OF 1/2 LANE OR MORE OF ROCK BASE

FLEXIBLE PAVEMENT RESTORATION PARALLEL UTILITY INSTALLATION

(CITY STREETS ONLY)

- 1. BASE MATERIAL SHALL HAVE A MINIMUM L.B.R. OF 100 AND A MINIMUM CARBONATE CONTENT OF 70%. 2. BASE MATERIAL SHALL BE PLACED IN 6" MAXIMUM THICKNESS LAYERS WITH EACH LAYER COMPACTED
- AS REQUIRED AND TESTED PRIOR TO THE PLACEMENT OF THE SUCCEEDING LAYERS. 3. SUBGRADE MATERIAL SHALL BE GRANULAR AND SHALL HAVE A MINIMUM L.B.R. OF 40.
- 4. BACKFILL SHALL BE PLACED AND COMPACTED IN 8" LAYERS, BUT TESTING WILL BEGIN 12" ABOVE THE
- 5. ALL EDGES OF EXISTING ASPHALT PAVEMENT WHERE RESURFACING WILL ABUT SHALL BE SAW CUT TO STRAIGHT LINES, PARALLEL TO OR PERPENDICULAR TO THE ROADWAY, PRIOR TO THE RESURFACING.
- 6. RESURFACING MATERIAL SHALL BE OF THE SAME MIX AS THE EXISTING SURFACE, AND SHALL BE APPLIED
- A MINIMUM OF ONE AND ONE-HALF INCHES AND A MAXIUMUM OF TWO INCHES IN THICKNESS.
- 7. REFER TO SPECIFICATIONS FOR DETAILED PROCEDURES.

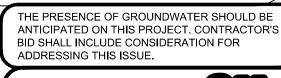

SHEET NUMBER

© 7

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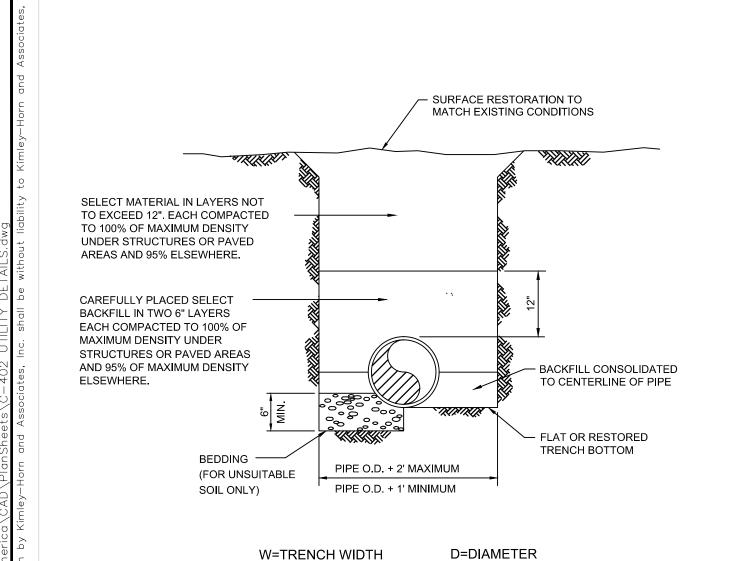
BEFORE YOU DIG IT'S THE LAW! Know what's **below**. **DIAL 811** Call before you dig

ENGINEERING SUPPORT SERVICES PUBLIC UTILITIES DEPARTMENT

DESIGNED_ DRAWN __ SCALE _AS NOTED CHECKED_ PROJECT No. CAD NAME DATE __

CALL 48 HOURS

SUNSHINE STATE ONE CALL OF FLORIDA, INC.




1. BEDDING MATERIAL WHEN NECESSARY, SHALL BE CLEAN SANDY SOIL WHENEVER AVAILABLE WITHIN THE LIMITS OF CONSTRUCTION. IMPORTED BEDDING SHALL BE WELL GRADED 3/4" MAX. SIZED CRUSHED LIMEROCK. ALL BEDDING MATERIAL

SHALL BE COMPACTED TO 95% OF MAXIMUM DENSITY BEFORE ANY PIPE IS LAID.


W=TRENCH WIDTH

2. DENSITY TESTING SHALL BE IN ACCORDANCE WITH AASHTO T-180 AND ASTM D-3017.

ō			
o O	DATE: 3/01/94	CITY OF HOLLYWOOD — UTILITIES DEPARTMENT STANDARD DETAIL	REVISED:
lian	DRAWN: EAM	PIPE LAYING CONDITION	DRAWING NO.
oer re	APPROVED:	TYPICAL SECTION (D.I.P.)	S-2

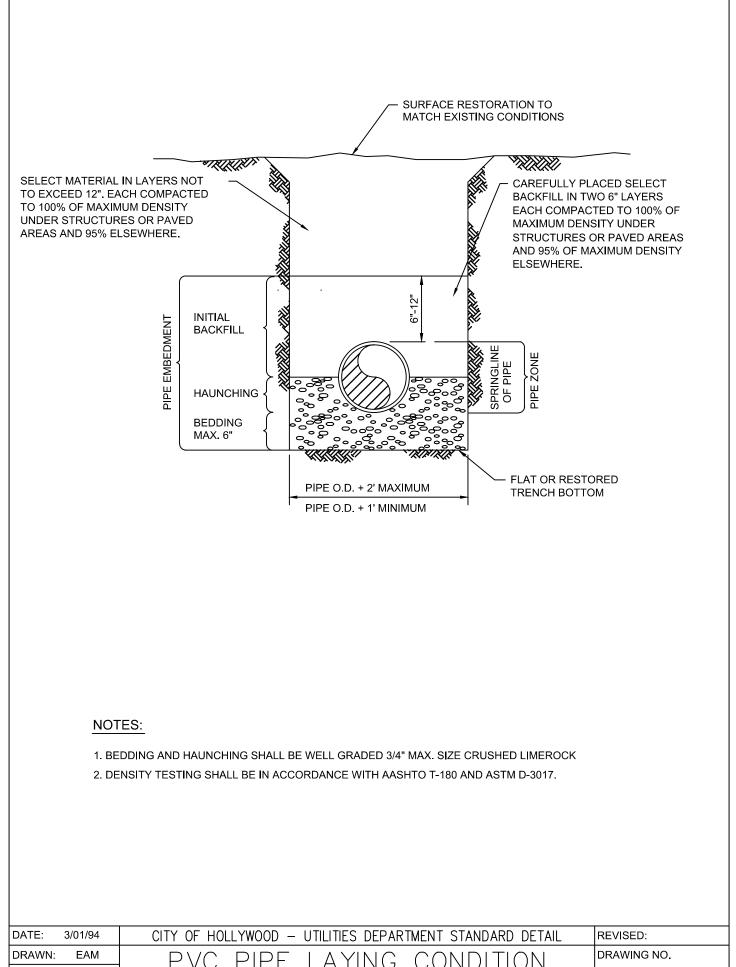



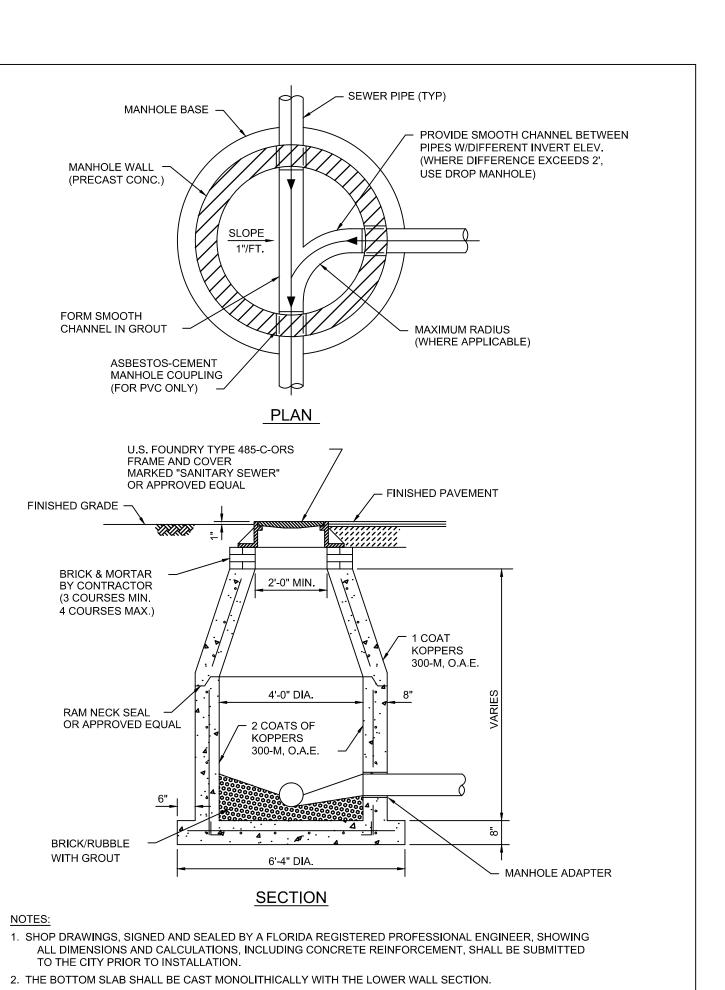


CITY OF HOLLYWOOD — UTILITIES DEPARTMENT STANDARD DETAIL


STANDARD PRECAST MANHOLE


RAWING NO.


DRAWN: EAM


APPROVED:

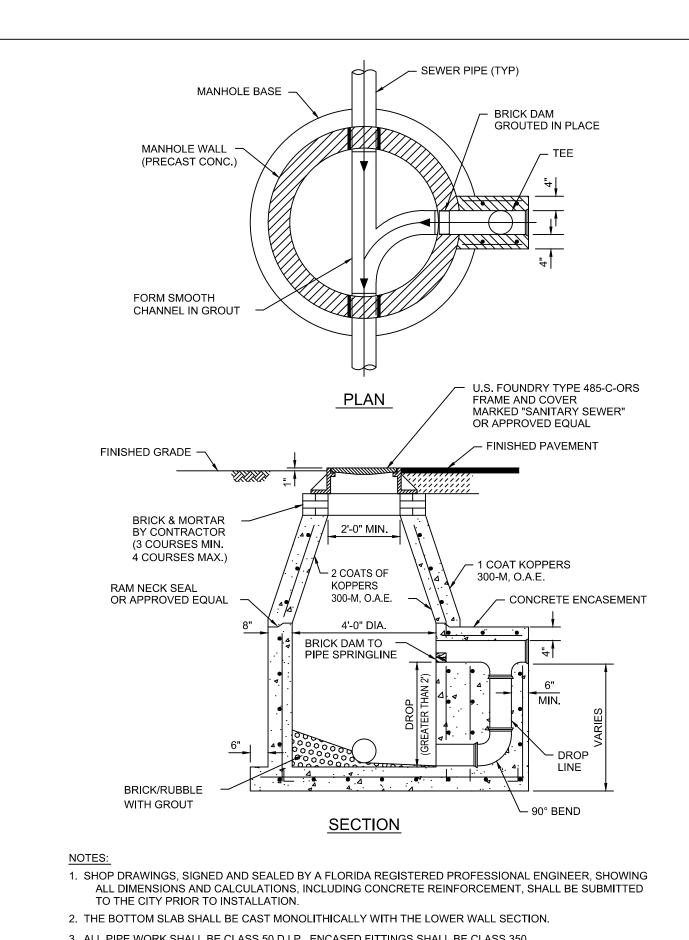

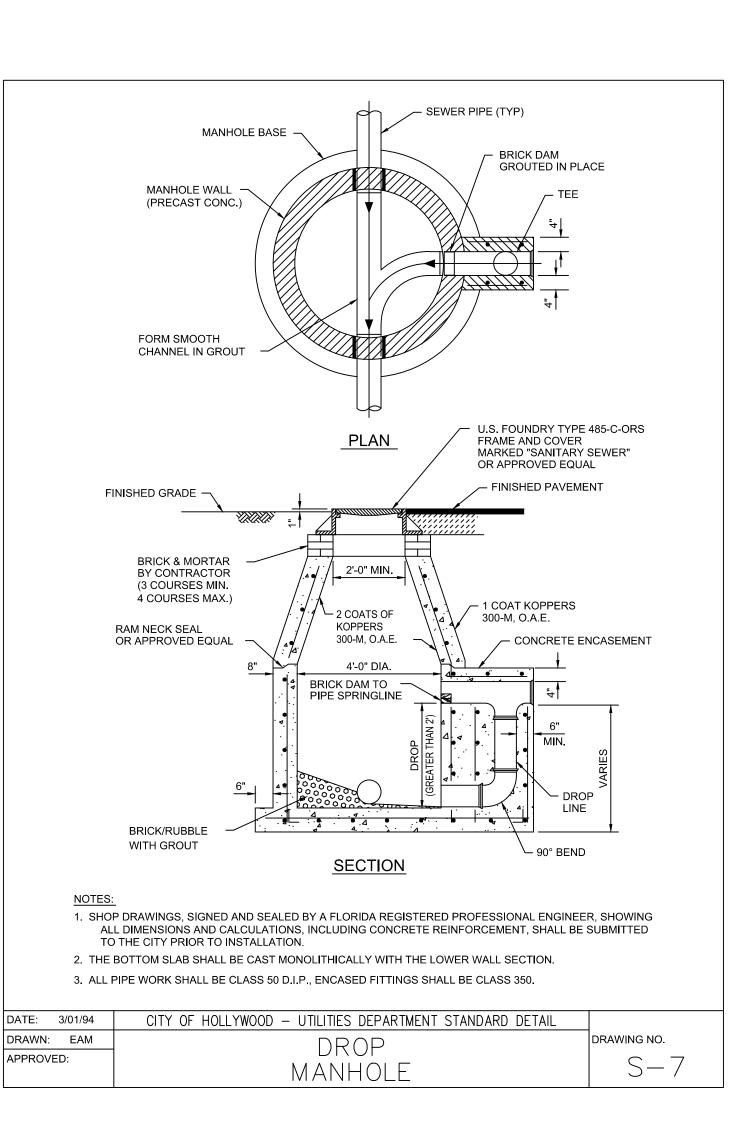

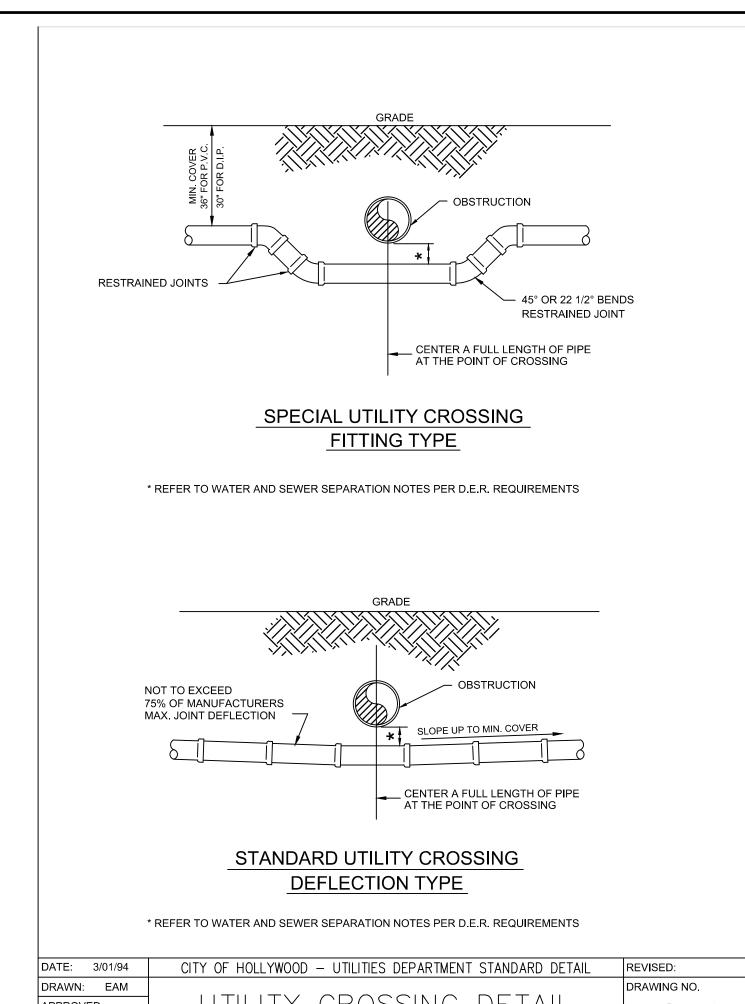

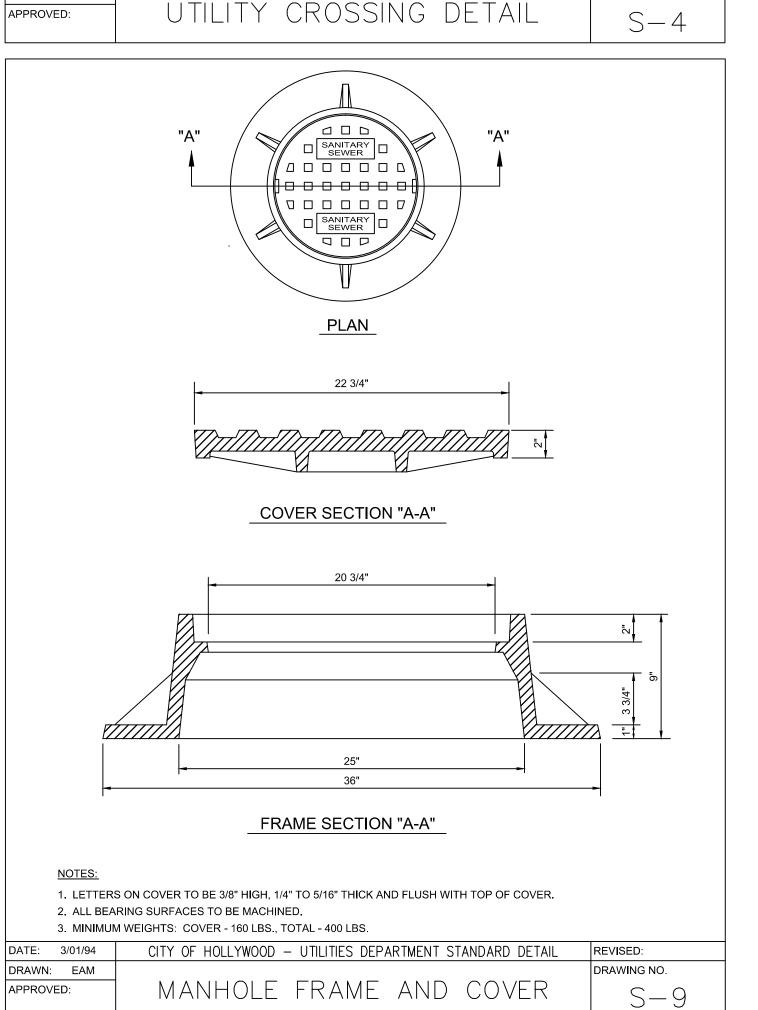

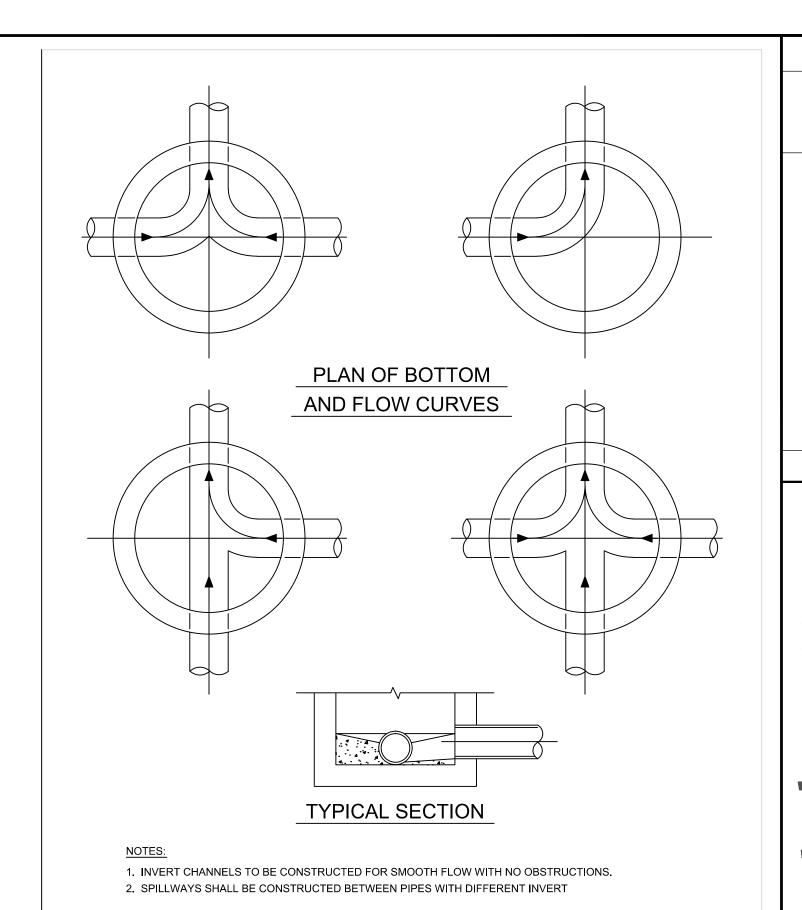

ELEVATIONS PROVIDING SMOOTH FLOWS.

DRAWN: EAM

APPROVED:


WITH SAND & COVERED WITH 1" OF MORTAR.

3. CHANNELS FOR FUTURE CONNECTIONS (STUBS) SHALL BE CONSTRUCTED FILLED

CITY OF HOLLYWOOD — UTILITIES DEPARTMENT STANDARD DETAIL

MANHOLE FLOW PATTERNS

4. WHEN FLOW LINE DEFLECTS MORE THAN 45°, A DROP OF 0.10' IS REQUIRED.

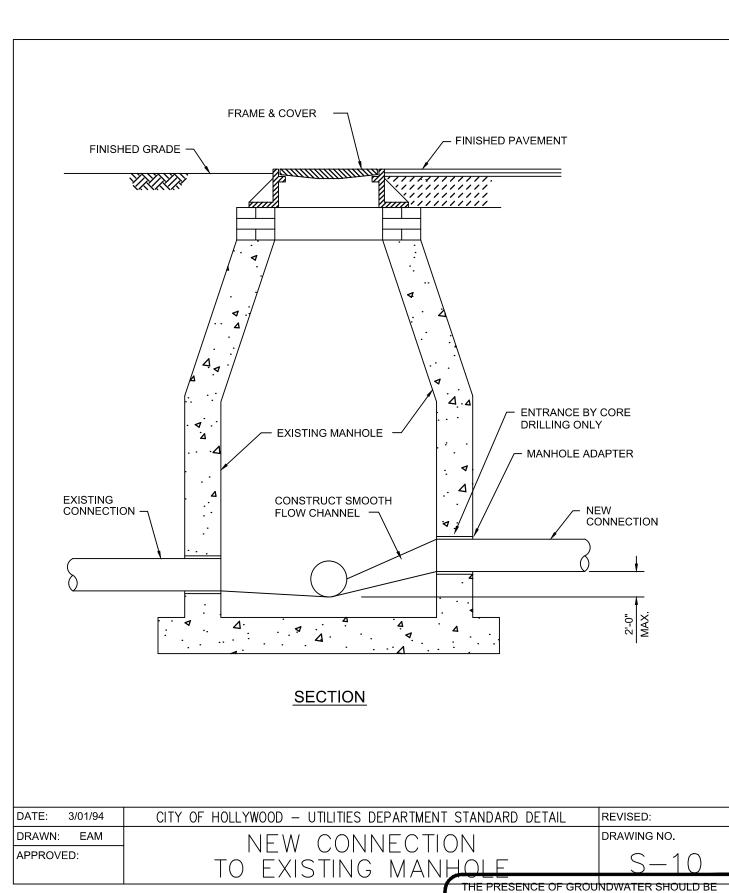



REVISED:

ANTICIPATED ON THIS PROJECT. CONTRACTOR'S

SUNSHINE STATE ONE CALL OF FLORIDA, INC.

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BID SHALL INCLUDE CONSIDERATION FOR

ADDRESSING THIS ISSUE.

CALL 48 HOURS

BEFORE YOU DIG


IT'S THE LAW!


DIAL 811


DRAWING NO.


S-5


© 20 24TH

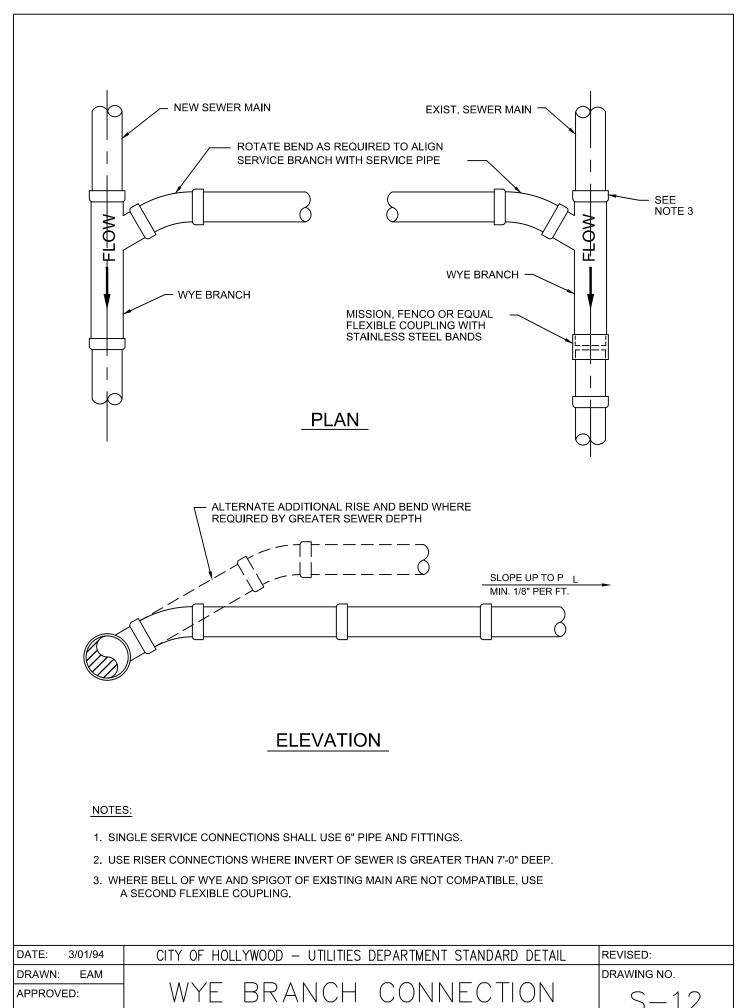


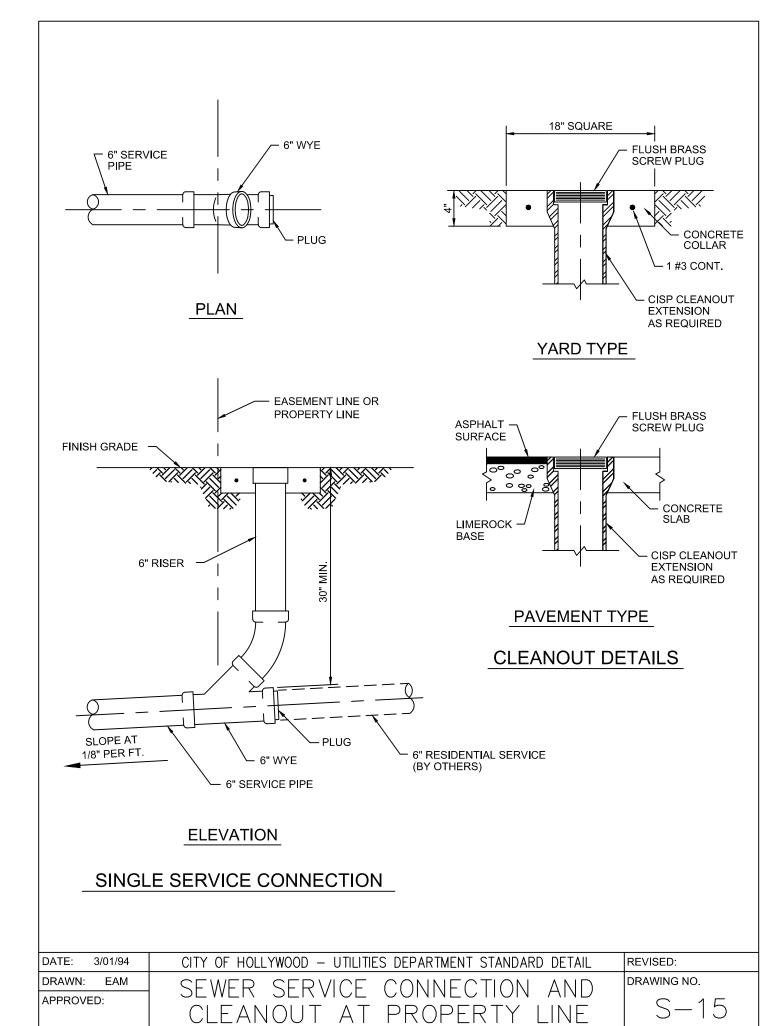

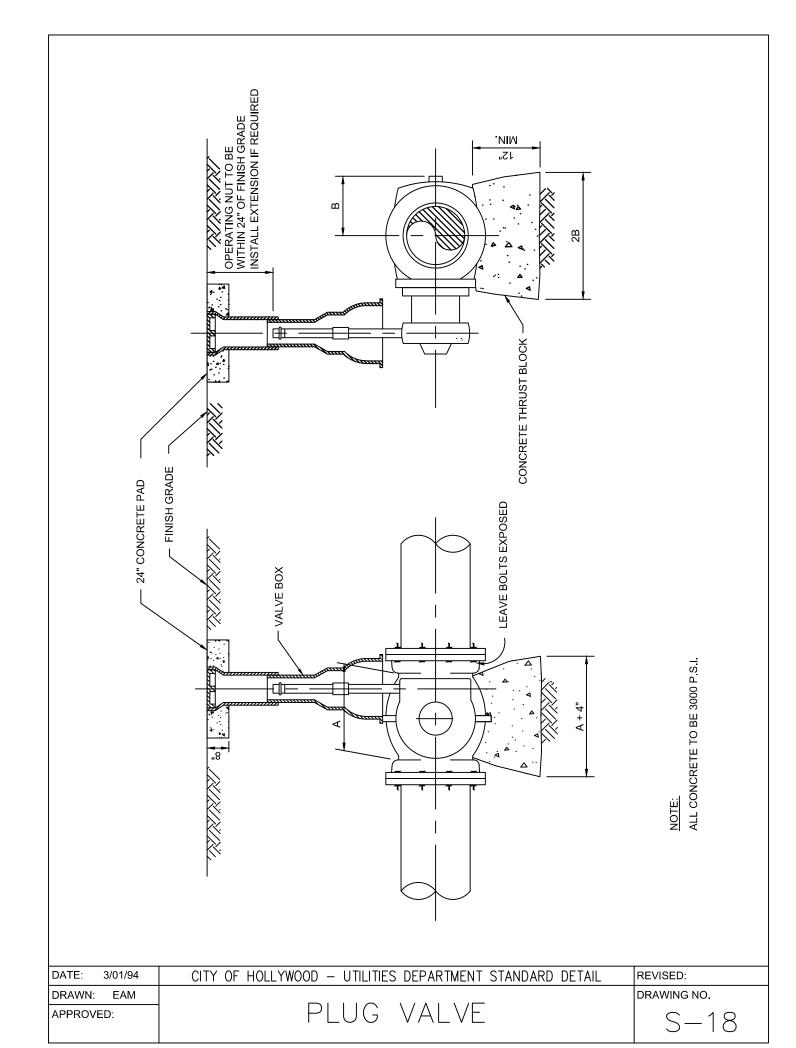

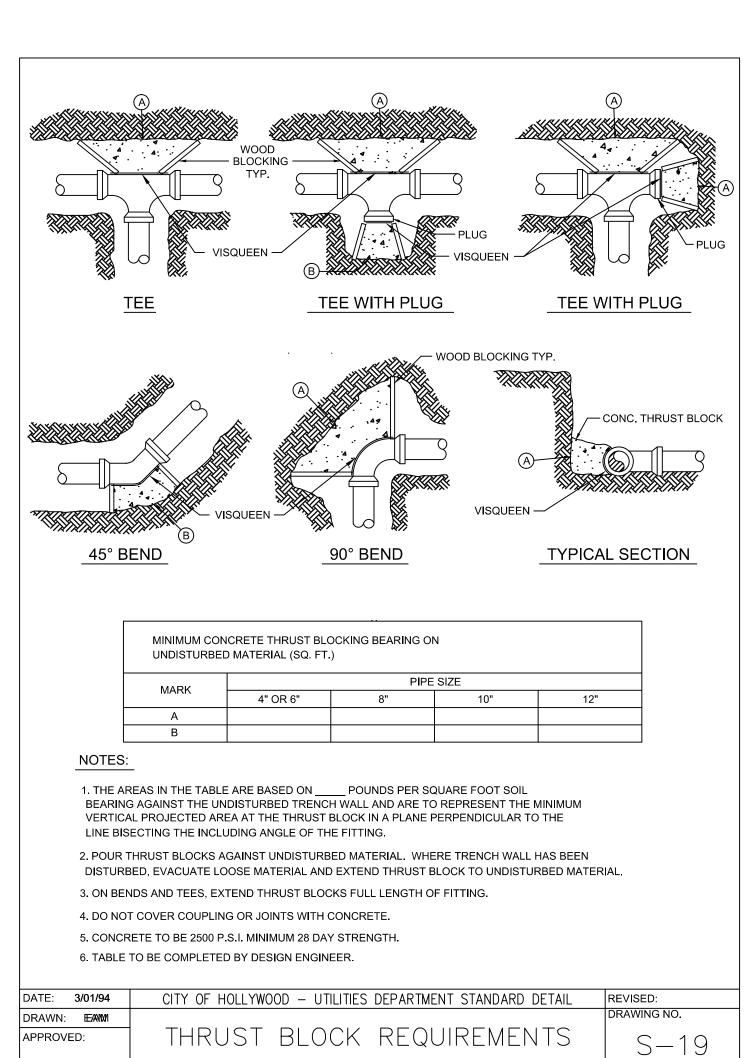

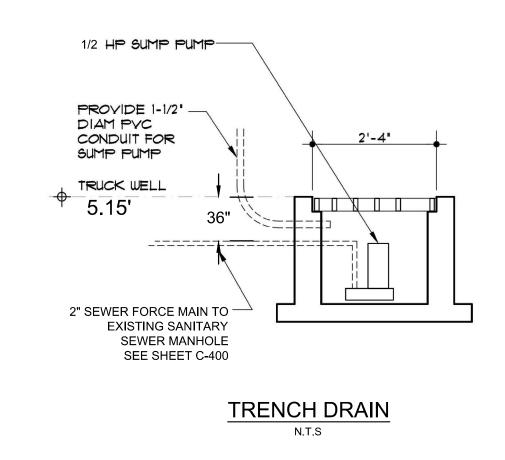

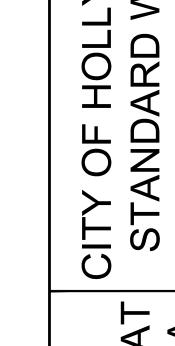

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THE PRESENCE OF GROUNDWATER SHOULD BE

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ANTICIPATED ON THIS PROJECT. CONTRACTOR'S BID SHALL INCLUDE CONSIDERATION FOR ADDRESSING THIS ISSUE. BEFORE YOU DIG

IT'S THE LAW! **DIAL 811**



BAC/GU WASHINGTON PARK

GENSLER PROJECT NUMBER: 69.6191.100

BAC SERIAL NUM.: FLW-C66

DESIGNATION: SIGNATURE

TAC SUBMISSION

08.15.2016

851 S STATE RD 7 HOLLYWOOD, FL 33023

Jones Lang LaSalle

Project Manager 1000 S Federal Hwy, Ste 200 Deerfield Beach, FL 33441 (954) 425-8707

Attn: Andrew De Los Santos

M. Arthur Gensler Jr. & Associates, Inc.

Gensler
Architect
LIC. NO. AA0002837

Main Office
2 Harrison Street, Ste 400

San Francisco, CA 94105
T: 415.433.3700

Satellite Office

100 North Tampa St, Ste. 2300 *Tampa*, FL 33602 T: 813.204.9000 Attn: Alyx Mays

Infinity Engineering Group, LLC.

Engineer of Record 1208 E. Kennedy Blvd., Suite 230 Tampa, FL 33602 T: 813.434.4770 Attn: Brett Nevaril

(BASED ON PAREX STUCCO) STUCCO/ PLASTER [BAC PRESCRIPTIVE] / "BASIS OF DESIGN"

ST-1 10409 "TUNDRA," SAND FINE FIN. ST-2 10432 "WARM SAND," SAND FINE FIN. ST-3

(BASED ON ALPOLIC) **ALUMINUM COMPOSITE METAL PANEL** [BAC PRESCRIPTIVE] / "BASIS OF DESIGN"

ACM-1 "BRITE RED" #4MMBTR REFER TO SECTION 07 42 43 ACM-2 "RVW WHITE" #3MM4RVW REFER TO SECTION 07 42 43 ACM-3 "MATCH STOREFRONT" REFER TO SECTION 08 41 13

10447 "MOSS," SMOOTH FIN.

ALUMINUM GLAZING FRAMES

[BAC PRESCRIPTIVE] / "BASIS OF DESIGN"

AF-1 CURTAINWALL SYSTEM AS SPECIFIED AF-2 STOREFRONT SYSTEM AS SPECIFIED

(ALL PAINTED EXPT-3) STUCCO ACCESSORIES [BAC PRESCRIPTIVE] / "BASIS OF DESIGN" (BASED ON FRY REGLET)

SA-1 WIDE CHANNEL SCREED AS SPECIFIED SA-2 NARROW CHANNEL SCREED AS SPECIFIED SA-3 MODIFIED CHANNEL SCREED AS SPECIFIED

METAL COPING

(BAC PERFORMANCE)

PREFINISHED METAL COPING CUSTOM COLOR: TO MATCH ST-3

EXTERIOR PAINT (BASED ON BENJAMIN MOORE) [BAC PRESCRIPTIVE] / "BASIS OF DESIGN" (BASED ON FRY REGLET)

EXPT-1 [N185] COLOR: HC-102 "CLARKSVILLE GRAY," MATCHES ST-3: MOSS EXPT-2 [N185] COLOR: HC-80 "BLEEKER BEIGE," MATCHES ST-2: WARM SAND EXPT-3 [N185] COLOR: CLASSIC #1039 "STONE HOUSE," MATCHES ST-1: TUNDRA

EXTERIOR SEALANT COLOR

[BAC PERFORMANCE]

BLACK GLAZING AT EXTERIOR STOREFRONT MATCH METAL CLIP COLOR (ACM, RED AND WHITE) METAL PANEL TO METAL PANEL MATCH METAL FRAME WINDOW FRAME/ STOREFRONT TO STUCCO (ACM, RED AND WHITE) METAL PANEL TO STUCCO MATCH ADJACENT STUCCO FINISH MATCH STOREFRONT FRAME (ACM, RED AND WHITE) METAL PANEL TO STOREFRONT

GLAZING SCHEDULE

GLAZING	(BAC PERFORMANCE)
GL-1	1" HEAT STRENGTHENED CLEAR LOW-E INSULATING GLAZING AS SPECIFIED
GL-2	1" TEMPERED CLEAR LOW-E INSULATING GLAZING AS SPECIFIED
GL-3	1/2" TEMPERED MONOLITHIC GLASS

ABBREVIATIONS

Α		J	
ACCES	ACCESSORY	JAN	JANITOR
ACOUS	ACOUSTIC(AL)	K	
AFF	ABOVE FINISHED FLOOR	KIT	KITCHEN
AL	ALUMINUM	L	
ALT	ALTERNATE	LAV	LAVATORY
ANNUNC	ANNUNCIATOR	LB	POUND
ANOD	ANODIZED	LOUVER	LOUVER
APPL	APPLIANCE	LT	LIGHT
AUTO	AUTOMATIC	LVLG	LEVELING
AVG	AVERAGE	M	
В		M.E.	MATCH EXISTING
BD	BOARD	MAX	MAXIMUM
BLDG	BUILDING	MECH	MECHANICAL
BLKG	BLOCKING	MEMB	MEMBRANE
BOLLD	BOLLARD	MET	METAL
BRDLM	BROADLOOM	MEZZ	MEZZANINE
BU	BUILT UP	MFD	MANUFACTURED
С		MFR	MANUFACTURER
CAB	CABINET	MIN	MINIMUM
CEM	CEMENT(ITIOUS)	MISC	MISCELLANEOUS
CER	CERAMIC	MLWK	MILLWORK
CLG	CEILING	MOIST	MOISTURE
CMU	CONCRETE MASONRY	MOT	MOTOR(IZED)
	UNIT	MTD	MOUNTED
COATG	COATING	N	
COILG	COILING	NIC	NOT IN CONTRACT
CONC	CONCRETE	NO	NUMBER
CONSTR	CONSTRUCTION	NTS	NOT TO SCALE
CONT	CONTINUOUS(ATION)	0	
CONTR	CONTRACT(OR)	ОН	OPPOSITE HAND
COV	COVER	OPNG	OPENING(S)
CPT	CARPET	OPP	OPPOSITE
D		OPR	OPERABLE
DBL	DOUBLE	ORNA	ORNAMENTAL

DEPT DEPARTMENT os OCCUPANCY SENSOR DES DESIGN(ED) OVFL OVERFLOW DET DETAIL OVHD OVERHEAD DF DRINKING FOUNTAIN DIA DIAMETER PBD PARTICLE BOARD DIFF DIFFUSER PEDTR PEDESTRIAN DIM DIMENSION PLASTIC LAMINATE PLAM DISP DISPENSER PLAS PLASTER DIV DIVISION PLSTC PLASTIC DN DOWN PLYWD PLYWOOD DR DOOR PANEL DSCON DISCONNECT POLYST POLYSTYRENE DWR DRAWER PORTABLE PREFAB PREFABRICATED PREFIN PREFINISHED ELECTRICAL PRTECN PROTECTION **EMBED** EMBEDD(ED)(ING) PTN PARTITION ENGINEER(ED) **ENTRANCE** RDR READER RECESS(ED)

RECEPTACLE

REFER(ENCE)

REFRIGERATOR

RESIST(ANT)(IVE)

ROUGH OPENING

REFLECTED

REQUIRED

ROOFING

ROOM

SCRIBE

SINGLE

SHORING

SIMILAR

STANDARD

STOREFRONT

SUSPENDED

TONGUE AND GROOVE

TEMPERED GLASS

SURFACE

SYSTEM(S)

THICK

TOILET

TRAFFIC

TREATED

TYPICAL

UNDRLAY UNDERLAYMENT

NOTED

UTILITY

VEHICLE

WITH

WOOD

WINDOW

WEIGHT

WTRPRF WATERPROOFING

VERTICLE

WITHOUT

VERIFY IN FIELD

WATER CLOSET

TRANSPARENT

UNLESS OTHERWISE

STEEL

STRUCT STRUCTURAL

STD

STL

SURF

SUSP

T&G

TLT

TRANS

TRTD

TYP

UON

UTIL

VEH

VERT

VIF

WC

WD

WDW

STRFR

SECURITY

SQUARE FEET

STAINLESS STEEL

ENGR ENTR EQ **EQUAL** RECES **EQUIP EQUIPMENT** EX **EXISTING** REF EXPANSION JOINT REFL **EXPS** EXPOSE(D) REFR EXT **EXTERIOR** REQD RESIS **FABRICATION** RFG FD FLOOR DRAIN RM FIRE EXTINGUISHER FIRE EXTINGUISHER AND FE&C CABINET SCR FIRE HOSE CABINET SECUR FIN FINISH FLDG FOLDING SGL FLOOR(ING) SHORG **FPLC** FIREPLACE SIM

FR FIRE RAT(ING)(ED) FRMG FRAMING FURN **FURNITURE** FABRIC WALL COVERING FWC FXD FIXED **FXTR** FIXTURE GA GAUGE GFCI GROUND FAULT CIRCUIT INTERRUPTER GLASS FIBER REINFORCED CONCRETE GLASS FIBER REINFORCED GYPSUM GLASS FIBER REINFORCED PLASTER GL GLASS

GR GRAD(E)(ING) GYP GYPSUM HEAD HDWD HARDWOOD **HDWE** HARDWARE **HOLLOW METAL** HORIZ HORIZONTAL HEATING, VENTILATING, AND AIR CONDITIONING

INFILTR INFORMATION INSTRUM INSTRUMENT(ATION) INSULATION INTERIOR INTLK INTERLOCK(ING)

DRAWING INDEX

SHEET			F	REVISIONS
NUMBER	SHEET NAME	LATEST	DATE	DESCRIPTION
A000	COVER		08.15.2016	ISSUE FOR TAC SUBMISSION
A001	DRAWING INDEX		08.15.2016	ISSUE FOR TAC SUBMISSION


CIVIL

SHEET		REVISIONS			
NUMBER	SHEET NAME	LATEST	DATE	DESCRIPTION	
C02.01	SITE PLAN		08.15.2016	ISSUE FOR TAC SUBMISSION	
C03.01	GRADING AND DRAINAGE PLAN		08.15.2016	ISSUE FOR TAC SUBMISSION	
C04.01	UTILITY PLAN		08.15.2016	ISSUE FOR TAC SUBMISSION	
C12.01	SITE DETAILS		08.15.2016	ISSUE FOR TAC SUBMISSION	
C12.02	SITE DETAILS		08.15.2016	ISSUE FOR TAC SUBMISSION	
C12.03	CITY OF HOLLYWOOD DETAILS		08.15.2016	ISSUE FOR TAC SUBMISSION	
L01.01	LANDSCAPE PLAN		08.15.2016	ISSUE FOR TAC SUBMISSION	
L02.01	LANDSCAPE PLANTING DETAILS		08.15.2016	ISSUE FOR TAC SUBMISSION	
1 OF 1	ALTA/NSPS LAND TITLE SURVEY		08.15.2016	ISSUE FOR TAC SUBMISSION	


ARCHITECTURAL

SHEET			REVISIONS			
NUMBER	SHEET NAME	LATEST	DATE	DESCRIPTION		
A101	CONSTRUCTION PLAN		08.15.2016	ISSUE FOR TAC SUBMISSION		
A102	ELEVATIONS		08.15.2016	ISSUE FOR TAC SUBMISSION		
A103	ELEVATIONS		08.15.2016	ISSUE FOR TAC SUBMISSION		
A104	DUMPSTER ENCLOSURE		08.15.2016	ISSUE FOR TAC SUBMISSION		
A105	COLOR ELEVATIONS		08.15.2016	ISSUE FOR TAC SUBMISSION		
A106	COLOR ELEVATIONS		08.15.2016	ISSUE FOR TAC SUBMISSION		

VICINITY MAP

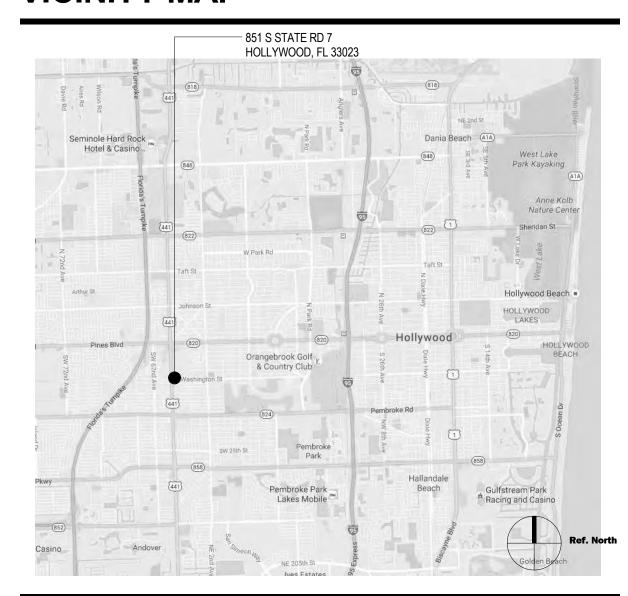

LOCATION MAP

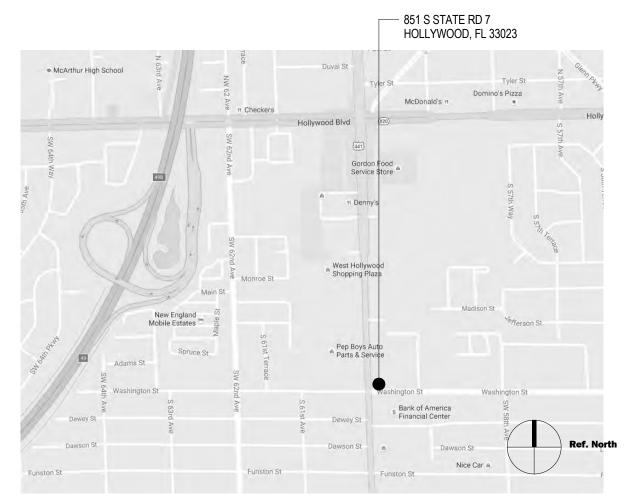

Bank of America 🤎

851 S STATE RD 7 HOLLYWOOD, FL 33023

SERIAL NUM.: FLW-C66 SIGNATURE DESIGNATION: NRSP VERSION: 2.0 2-2016 **BULLETIN**:

M. Arthur Gensler Jr. & Associates Inc.

Gensler

LIC. NO. AA0002837

Main Office 2 Harrison Street Suite 400 San Francisco CA 94105

Tel 415.433.3700 Fax 415.836.4599



Infinity Engineering Group, LLC. Attn: Brett Nevaril 1208 E. Kennedy Blvd. Suite 230 Tampa, FL 33602 Tel 813.434.4770 Fax 813.445.4211

_____ Date Description 08.15.16 ISSUE FOR TAC SUBMISSION

Seal / Signature

DANA MULLER, AIA REG. FL. NO. AR92911


08.15.2016

Project Name BAC/GU WASHINGTON PARK

Project Number 69.6191.100

Scale 12" = 1'-0"

Description DRAWING INDEX

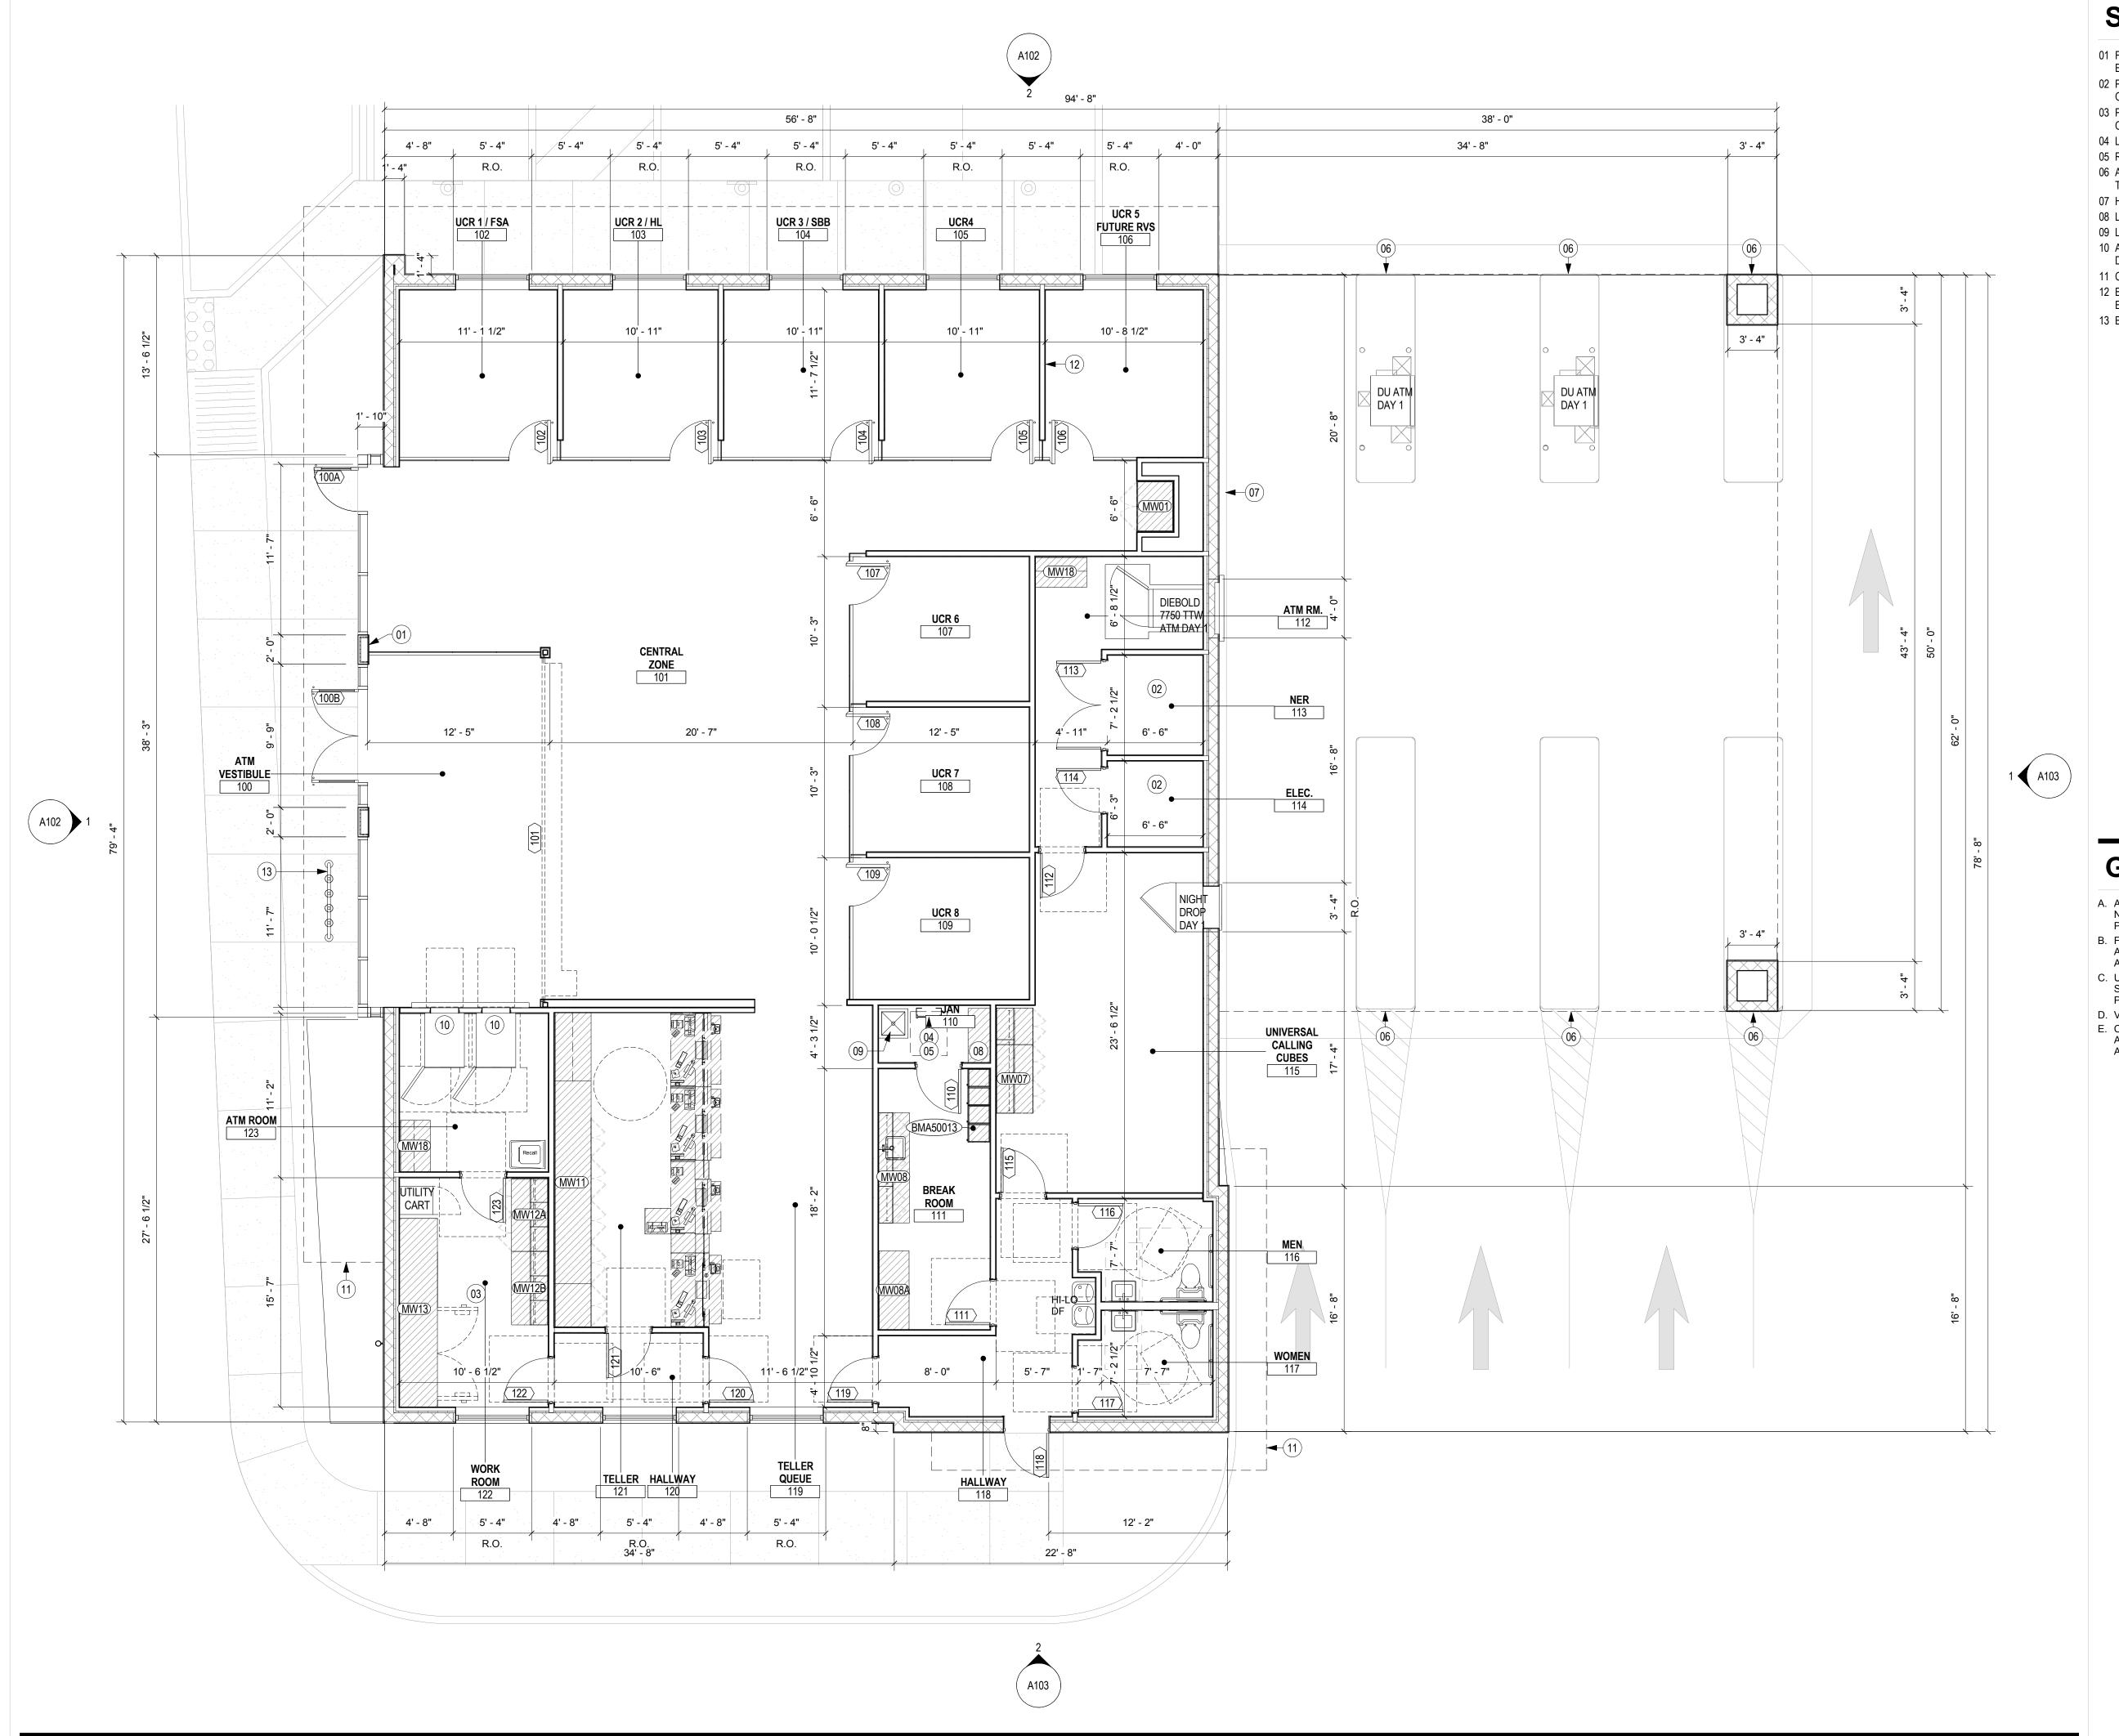

SHEET NOTES

- 01 FIRE PROTECTION EQUIPMENT. REFER TO ELECTRICAL DRAWINGS
- 02 PROVIDE FIRE RATED 3/4" PLYWOOD BACKBOARD ON ALL WALLS, H=8'-0"
- 03 PROVIDE HEAVY DUTY FLOOR PER SPEC -COORDINATE LOCATION WITH CASH VAULT DOOR
- 04 LADDER TO ROOF HATCH SEE DETAIL 12/A09.32
- 05 ROOF HATCH ABOVE SEE DETAIL 8/A09.32 06 ALIGN EDGE OF D.T. ISLAND WITH LINE OF DRIVE
- THRU SOFFIT ABOVE
- 07 HEADER CURB 08 LOCATION OF TRASH CONTAINER
- 09 LOCATION OF MOP SINK
- 10 ACCESSIBLE ATM SHALL COMPLY WITH AMERICAN DISABILITY ACT 2010
- 11 CANOPY ABOVE
- 12 BLOCKING TO BE PROVIDED FOR FUTURE RVS EQUIPMENT.
- 13 BIKE RACK

M. Arthur Gensler Jr. & Associates Inc.

BULLETIN:

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851 S STATE RD 7

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- **GENERAL NOTES**
- A. ALL PARTITIONS TO BE TYPE "A3B," UNLESS NOTED OTHERWISE. REFER TO WALL PARTITION TYPES. B. FOR ADDITIONAL GENERAL NOTES, LEGENDS AND SCHEDULES, REFER TO SHEETS A00.00
- AND A00.10. C. UNLESS OTHERWISE NOTED, LOCATE HINGE SIDE OF ALL DOORS 6" FROM ADJACENT
- PERPENDICULAR PARTITION. D. VERIFY ALL EQUIPMENT WITH VENDOR.

Date Description

08.15.16 ISSUE FOR TAC SUBMISSION

E. CONTRACTOR SHALL PROVIDE BLOCKING FOR ALL WALL-MOUNTED EQUIPMENT AND ACCESSORIES.

Seal / Signature

DANA MULLER, AIA REG. FL. NO. AR92911

08.15.2016

Project Name

BAC/GU WASHINGTON PARK


Project Number 69.6191.100

Scale 3/16" = 1'-0"


Description

CONSTRUCTION PLAN

CONSTRUCTION PLAN Copy 1

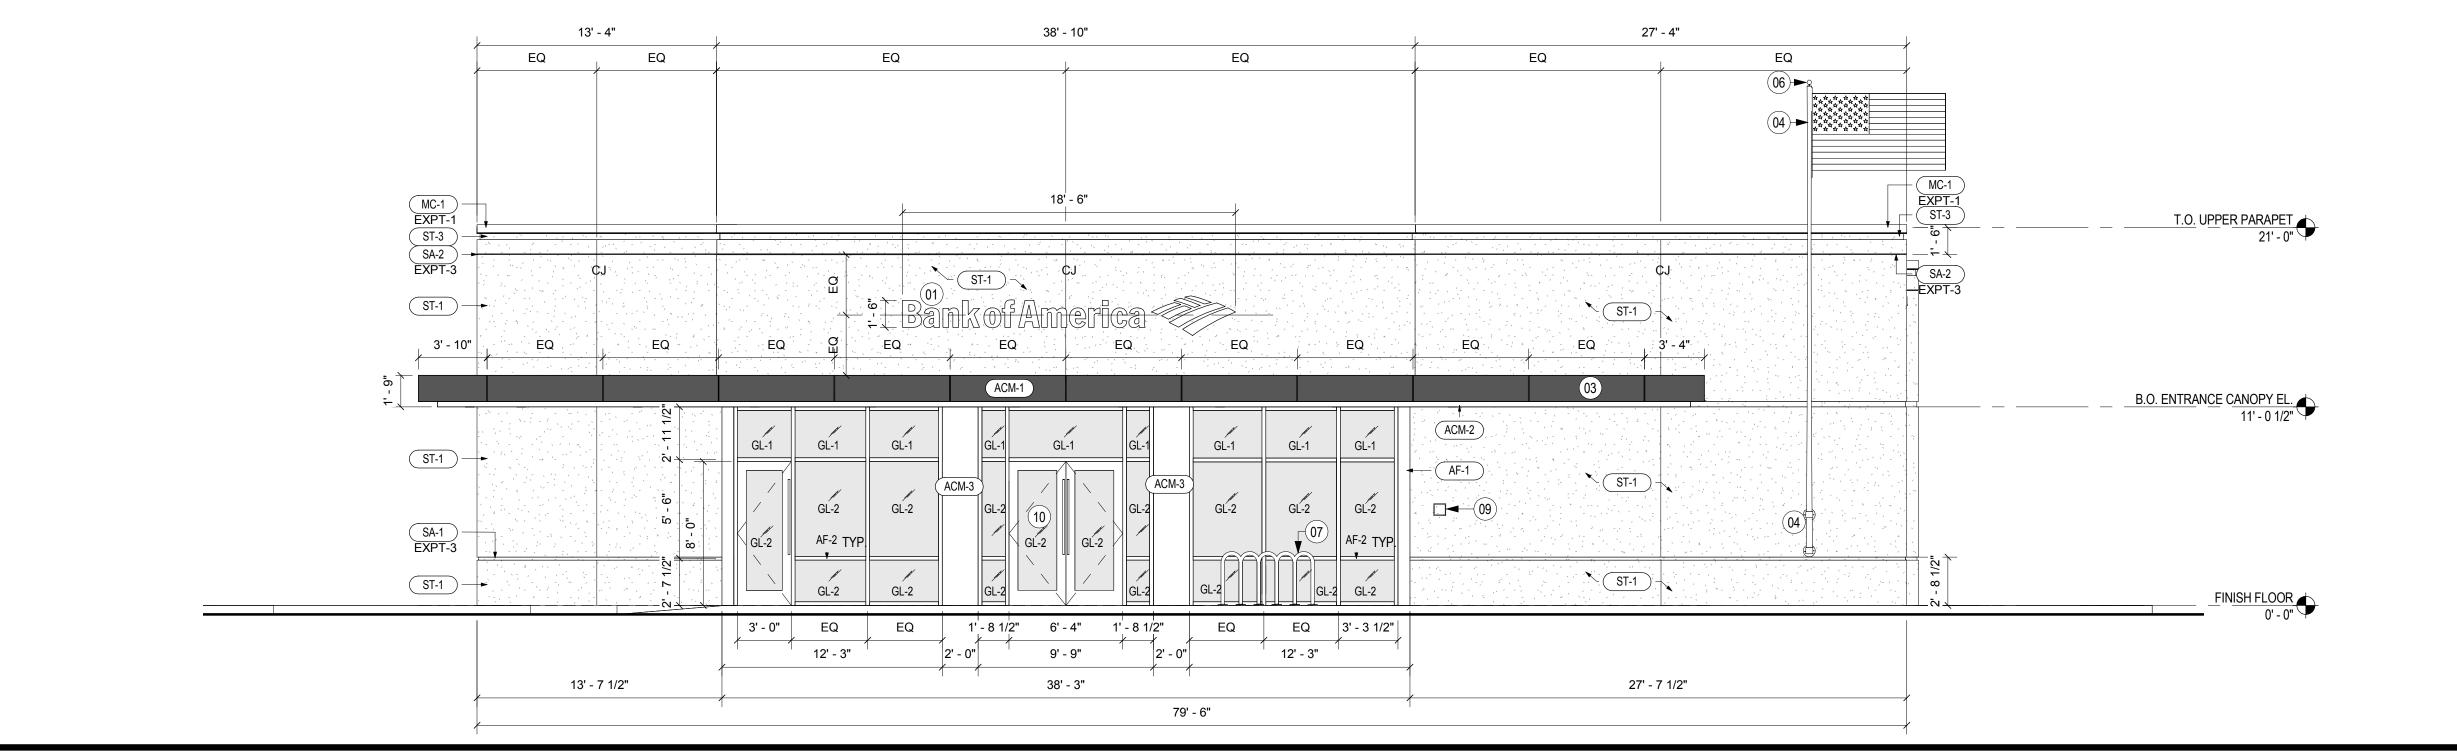

WEST ELEVATION Copy 1 SCALE: 3/16" = 1'-0"

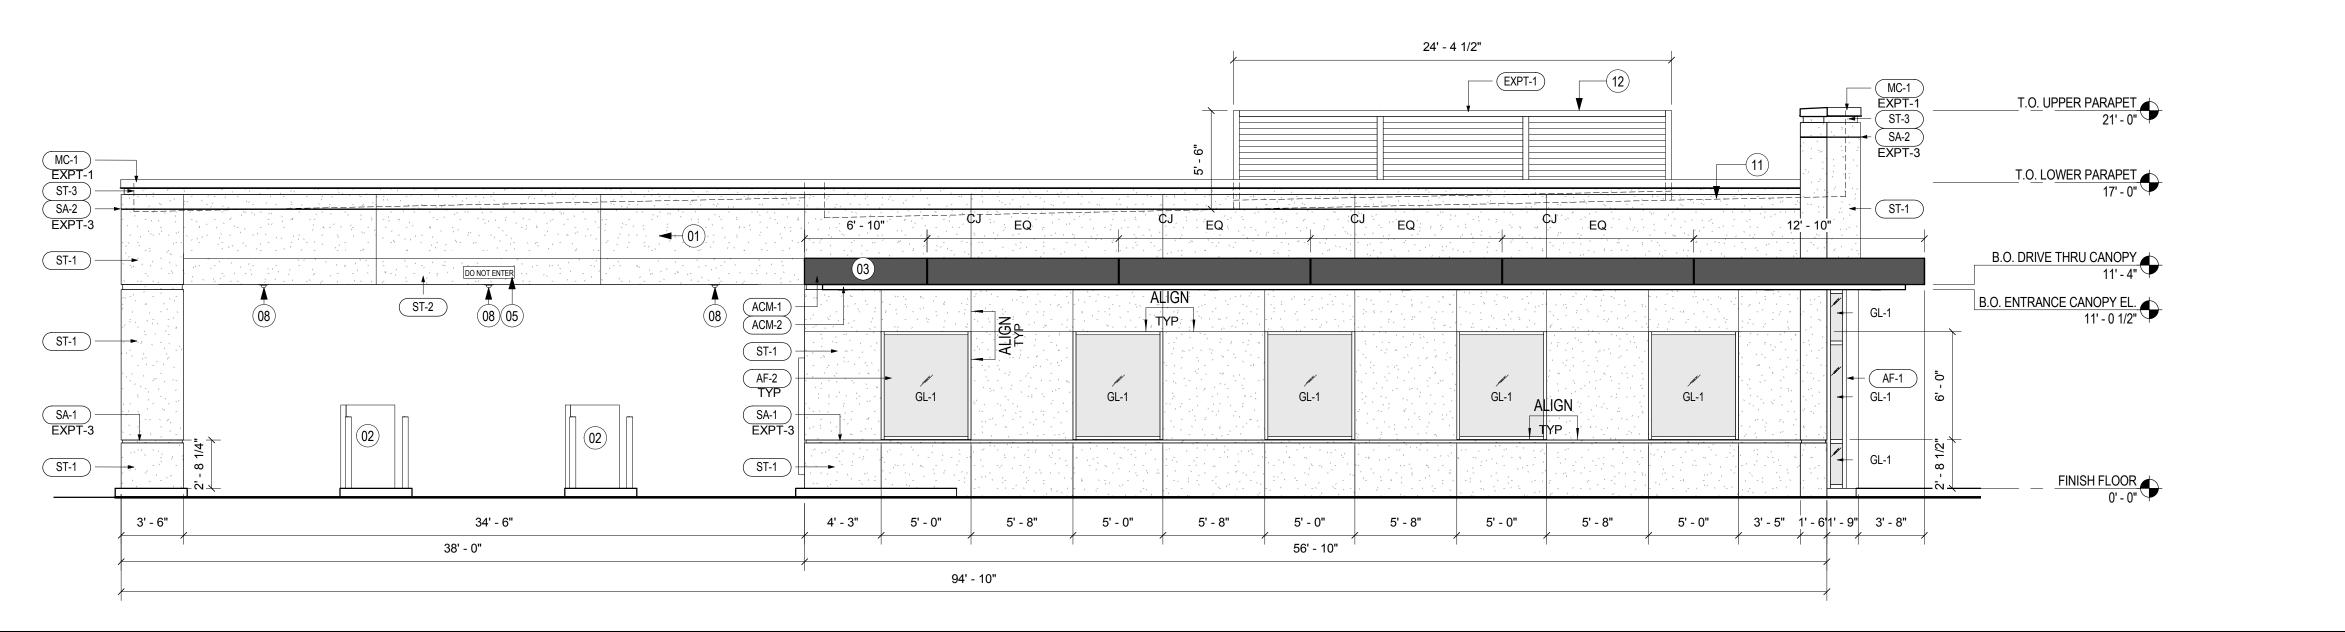

NORTH ELEVATION Copy 1

(BASED ON PAREX STUCCO) STUCCO/ PLASTER [BAC PRESCRIPTIVE] / "BASIS OF DESIGN"

10409 "TUNDRA," SAND FINE FIN. ST-2 10432 "WARM SAND," SAND FINE FIN. ST-3 10447 "MOSS," SMOOTH FIN.

ALUMINUM COMPOSITE METAL PANEL (BASED ON ALPOLIC) STUCCO ACCESSORIES [BAC PRESCRIPTIVE] / "BASIS OF DESIGN"

"BRITE RED" #4MMBTR REFER TO SECTION 07 42 43 ACM-2 "RVW WHITE" #3MM4RVW REFER TO SECTION 07 42 43 ACM-3 "MATCH STOREFRONT" REFER TO SECTION 08 41 13

ALUMINUM GLAZING FRAMES [BAC PRESCRIPTIVE] / "BASIS OF DESIGN"

CURTAINWALL SYSTEM AS SPECIFIED AF-2 STOREFRONT SYSTEM AS SPECIFIED

(ALL PAINTED EXPT-3) [BAC PRESCRIPTIVE] / "BASIS OF DESIGN" (BASED ON FRY REGLET)

SA-1 WIDE CHANNEL SCREED AS SPECIFIED SA-2 NARROW CHANNEL SCREED AS SPECIFIED SA-3 MODIFIED CHANNEL SCREED AS SPECIFIED

METAL COPING (BAC PERFORMANCE)

PREFINISHED METAL COPING CUSTOM COLOR: TO MATCH ST-3

(BASED ON BENJAMIN MOORE) **EXTERIOR PAINT** [BAC PRESCRIPTIVE] / "BASIS OF DESIGN" (BASED ON FRY REGLET)

EXPT-1 [N185] COLOR: HC-102 "CLARKSVILLE GRAY," MATCHES ST-3: MOSS EXPT-2 [N185] COLOR: HC-80 "BLEEKER BEIGE," MATCHES ST-2: WARM SAND EXPT-3

[N185] COLOR: CLASSIC #1039 "STONE HOUSE," MATCHES ST-1: TUNDRA

[BAC PERFORMANCE] **EXTERIOR SEALANT COLOR**

GLAZING AT EXTERIOR STOREFRONT BLACK MATCH METAL CLIP COLOR (ACM, RED AND WHITE) METAL PANEL TO METAL PANEL MATCH METAL FRAME WINDOW FRAME/ STOREFRONT TO STUCCO MATCH ADJACENT STUCCO FINISH (ACM, RED AND WHITE) METAL PANEL TO STUCCO (ACM, RED AND WHITE) METAL PANEL TO STOREFRONT MATCH STOREFRONT FRAME

SHEET NOTES

01 BANK OF AMERICA SIGN BY OWNER

02 DRIVE THRU ATM BY OWNER 03 METAL PANEL SYSTEM

04 31 - FT FLAG POLE AND MOUNTING BRACKETS -PROVIDED BY CONTRACTOR (FLAG FURNISHED BY OWNER, INSTALLED BY CONTRACTOR)

05 S - TYPE REGULATORY DIRECTIONAL/ INFORMATIONAL MONIGLE SIGNAGE PROVIDED BY OWNER. CENTER OF SIGN = CENTER OF LANE

06 LIGHT FIXTURE MOUNTED ON TOP OF FLAG POLE. SEE ELECT. DWG. FOR FIXTURE TYPE

07 BIKE RACK 08 EXTERIOR SECURITY CAMERA

09 KNOX BOX. COORDINATE WITH FIRE OFFICIAL THE MOUNTING HEIGHT AND LOCATION PRIOR INSTALLATION

10 SIGNAGE ON DOOR THAT READS "NO SMOKING WITHIN 25 FEET OF THE ENTRANCE" PROVIDED BY

11 LINE OF ROOF BEYOND 12 MECHANICAL EQUIPMENT SCREENING. M. Arthur Gensler Jr. &

Associates Inc.

SERIAL NUM.:

BULLETIN:

DESIGNATION:

NRSP VERSION:

851 S STATE RD 7

HOLLYWOOD, FL 33023

Bank of America 🧼

FLW-C66

2.0

2-2016

SIGNATURE

Tel 415.433.3700

Fax 415.836.4599

LIC. NO. AA0002837

Main Office

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│ Date Description

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Seal / Signature

DANA MULLER, AIA REG. FL. NO. AR92911

08.15.2016

Project Name

BAC/GU WASHINGTON PARK

Project Number

69.6191.100

Scale

As indicated

Description


ELEVATIONS

A102

EXTERIOR FINISH SCHEDULE

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EAST ELEVATION Copy 1

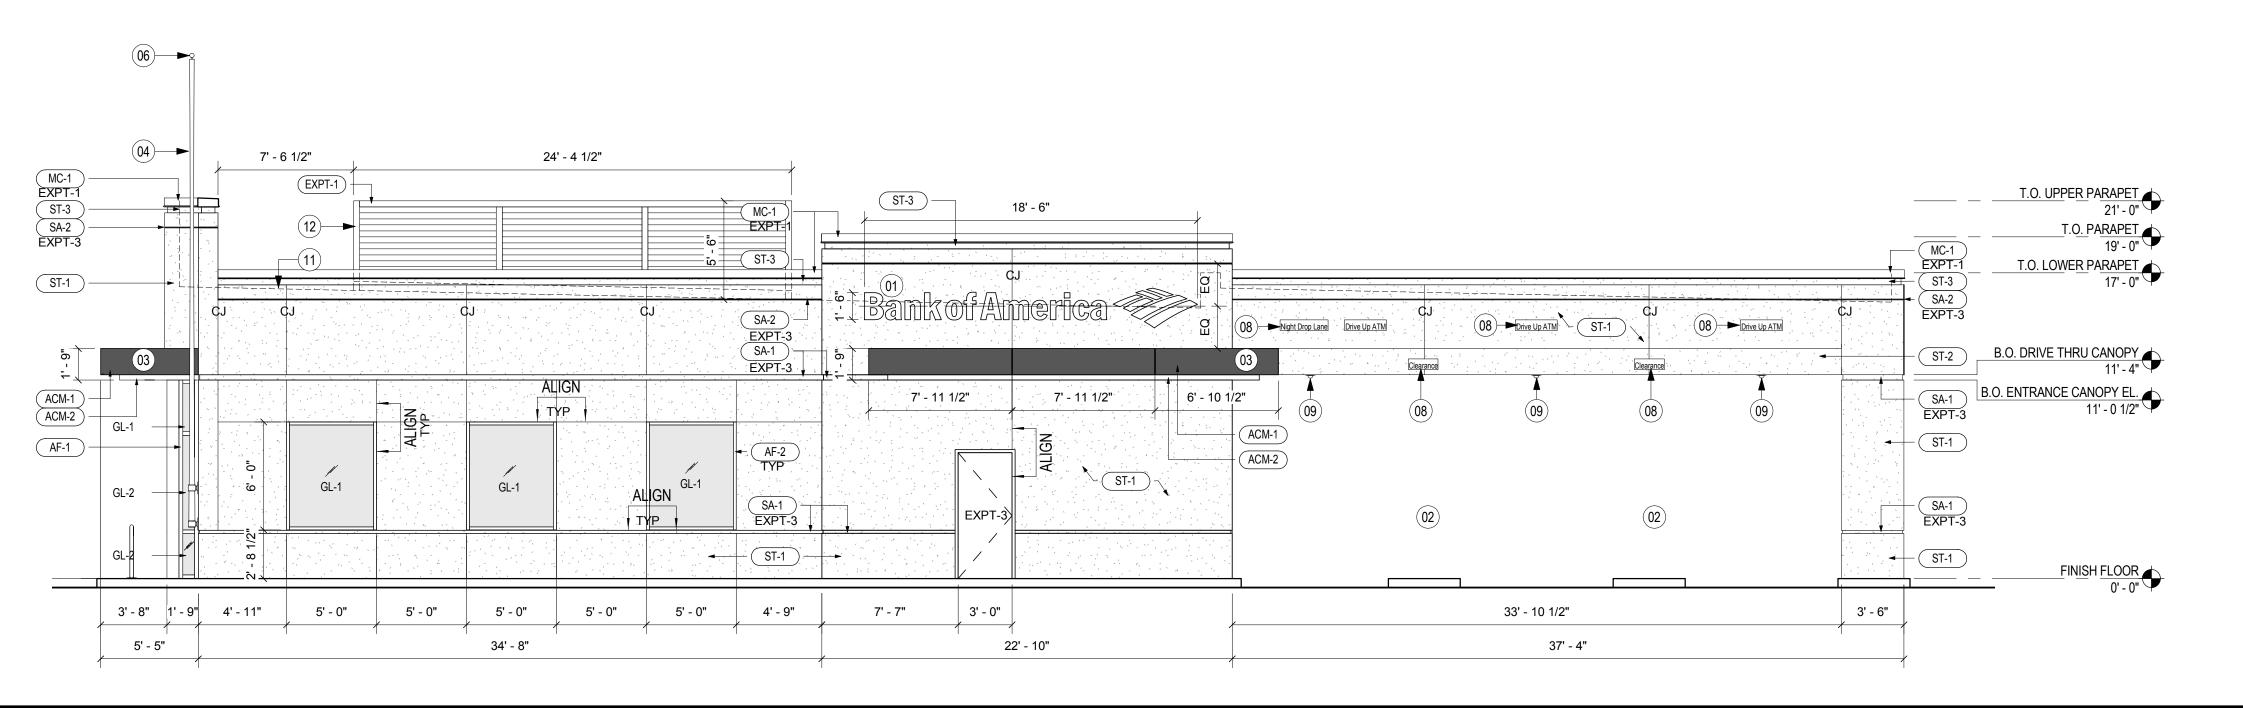

SOUTH ELEVATION Copy 1

(BASED ON PAREX STUCCO) STUCCO/ PLASTER [BAC PRESCRIPTIVE] / "BASIS OF DESIGN"

ST-1 10409 "TUNDRA," SAND FINE FIN. ST-2 10432 "WARM SAND," SAND FINE FIN. ST-3 10447 "MOSS," SMOOTH FIN.

ALUMINUM COMPOSITE METAL PANEL (BASED ON ALPOLIC) STUCCO ACCESSORIES [BAC PRESCRIPTIVE] / "BASIS OF DESIGN"

"BRITE RED" #4MMBTR REFER TO SECTION 07 42 43 ACM-2 "RVW WHITE" #3MM4RVW REFER TO SECTION 07 42 43 ACM-3 "MATCH STOREFRONT" REFER TO SECTION 08 41 13

ALUMINUM GLAZING FRAMES [BAC PRESCRIPTIVE] / "BASIS OF DESIGN" CURTAINWALL SYSTEM AS SPECIFIED

AF-2 STOREFRONT SYSTEM AS SPECIFIED (ALL PAINTED EXPT-3)

[BAC PRESCRIPTIVE] / "BASIS OF DESIGN" (BASED ON FRY REGLET) SA-1 WIDE CHANNEL SCREED AS SPECIFIED SA-2 NARROW CHANNEL SCREED AS SPECIFIED SA-3 MODIFIED CHANNEL SCREED AS SPECIFIED

(BAC PERFORMANCE) **METAL COPING** PREFINISHED METAL COPING CUSTOM COLOR: TO MATCH ST-3 MC-1

(BASED ON BENJAMIN MOORE) **EXTERIOR PAINT** [BAC PRESCRIPTIVE] / "BASIS OF DESIGN" (BASED ON FRY REGLET)

EXPT-1 [N185] COLOR: HC-102 "CLARKSVILLE GRAY," MATCHES ST-3: MOSS EXPT-2 [N185] COLOR: HC-80 "BLEEKER BEIGE," MATCHES ST-2: WARM SAND EXPT-3 [N185] COLOR: CLASSIC #1039 "STONE HOUSE," MATCHES ST-1: TUNDRA

[BAC PERFORMANCE] **EXTERIOR SEALANT COLOR**

BLACK GLAZING AT EXTERIOR STOREFRONT (ACM, RED AND WHITE) METAL PANEL TO METAL PANEL MATCH METAL CLIP COLOR WINDOW FRAME/ STOREFRONT TO STUCCO MATCH METAL FRAME MATCH ADJACENT STUCCO FINISH (ACM, RED AND WHITE) METAL PANEL TO STUCCO (ACM, RED AND WHITE) METAL PANEL TO STOREFRONT MATCH STOREFRONT FRAME

SHEET NOTES

01 BANK OF AMERICA SIGN BY OWNER 02 DRIVE THRU ATM BY OWNER 03 METAL PANEL SYSTEM 04 31 - FT FLAG POLE AND MOUNTING BRACKETS -PROVIDED BY CONTRACTOR (FLAG FURNISHED BY OWNER, INSTALLED BY CONTRACTOR)

05 NIGHT DEPOSITORY 06 LIGHT FIXTURE MOUNTED ON TOP OF FLAG POLE. SEE ELECT. DWG. FOR FIXTURE TYPE 08 S-TYPE REGULATORY DIRECTIONAL/INFORMATIONAL MONIGLE SIGNAGE

PROVIDED BY OWNER. CENTERLINE OF SIGN= CENTERLINE OF LANE. 09 EXTERIOR SECURITY CAMERA 10 DRIVE UP TTW ATM BY OWNER 11 LINE OF ROOF BEYOND 12 MECHANICAL EQUIPMENT SCREENING.

Bank of America 🧼

851 S STATE RD 7 HOLLYWOOD, FL 33023

SERIAL NUM.: FLW-C66 SIGNATURE DESIGNATION: NRSP VERSION: 2.0 **BULLETIN**: 2-2016

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Gensler

LIC. NO. AA0002837

Main Office 2 Harrison Street Suite 400

Tel 415.433.3700 Fax 415.836.4599 San Francisco CA 94105



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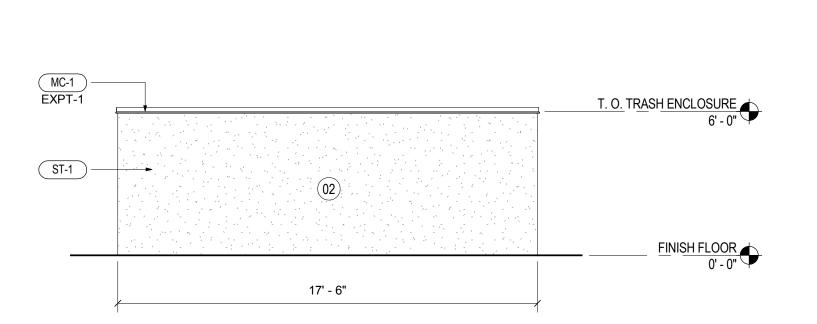
Description

ELEVATIONS

A103

EXTERIOR FINISH SCHEDULE

DUMPSTER ENCLOSURE RIGHT ELEVATION SCALE: 1/4" = 1'-0"



DUMPSTER ENCLOSURE REAR ELEVATION SCALE: 1/4" = 1'-0"


DUMPSTER ENCLOSURE PLAN

EXPT-3

MC-1 EXPT-3

ST-1

A104

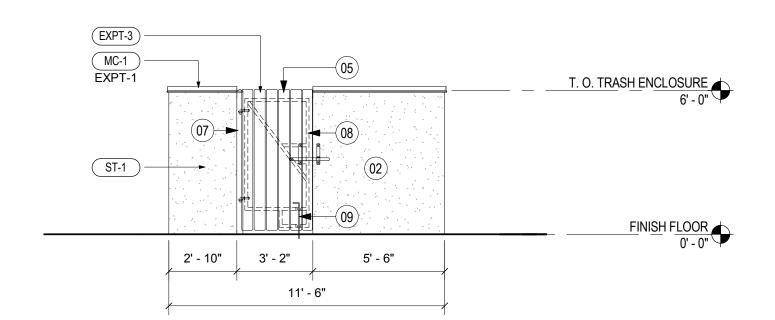

DUMPSTER ENCLOSURE LEFT ELEVATION

DUMPSTER ENCLOSURE FRONT ELEVATION
SCALE: 1/4" = 1'-0"

8' - 0"

17' - 6"

EXTERIOR PAINT

EXTERIOR SEALANT COLOR

WINDOW FRAME/ STOREFRONT TO STUCCO

(ACM, RED AND WHITE) METAL PANEL TO STUCCO

(ACM, RED AND WHITE) METAL PANEL TO METAL PANEL

(ACM, RED AND WHITE) METAL PANEL TO STOREFRONT

GLAZING AT EXTERIOR STOREFRONT

EXPT-1

EXPT-2

4' - 9"

[BAC PRESCRIPTIVE] / "BASIS OF DESIGN"

[N185] COLOR: HC-102 "CLARKSVILLE GRAY," MATCHES ST-3: MOSS

[N185] COLOR: HC-80 "BLEEKER BEIGE," MATCHES ST-2: WARM SAND

[N185] COLOR: CLASSIC #1039 "STONE HOUSE," MATCHES ST-1: TUNDRA

[BAC PERFORMANCE]

MATCH METAL CLIP COLOR

MATCH ADJACENT STUCCO FINISH

MATCH STOREFRONT FRAME

MATCH METAL FRAME

BLACK

STUCCO/ PLASTER (BASED ON PAREX STUCCO) [BAC PRESCRIPTIVE] / "BASIS OF DESIGN"

10409 "TUNDRA," SAND FINE FIN. ST-2 10432 "WARM SAND," SAND FINE FIN. ST-3 10447 "MOSS," SMOOTH FIN.

ALUMINUM COMPOSITE METAL PANEL (BASED ON ALPOLIC) [BAC PRESCRIPTIVE] / "BASIS OF DESIGN"

"BRITE RED" #4MMBTR REFER TO SECTION 07 42 43 ACM-2 "RVW WHITE" #3MM4RVW REFER TO SECTION 07 42 43 ACM-3 "MATCH STOREFRONT" REFER TO SECTION 08 41 13

ALUMINUM GLAZING FRAMES [BAC PRESCRIPTIVE] / "BASIS OF DESIGN" CURTAINWALL SYSTEM AS SPECIFIED

AF-2 STOREFRONT SYSTEM AS SPECIFIED (ALL PAINTED EXPT-3) STUCCO ACCESSORIES

(BASED ON FRY REGLET [BAC PRESCRIPTIVE] / "BASIS OF DESIGN" SA-1 WIDE CHANNEL SCREED AS SPECIFIED SA-2 NARROW CHANNEL SCREED AS SPECIFIED SA-3 MODIFIED CHANNEL SCREED AS SPECIFIED

METAL COPING (BAC PERFORMANCE)

PREFINISHED METAL COPING CUSTOM COLOR: TO MATCH ST-3

SHEET NOTES

01 CONC. SLAB. REFER TO STRUCTURAL DRAWINGS 02 MASONRY BLOCK WALL W/ DIRECT BOND STUCCO

FINISH, TYP 03 48" HIGH, 4" DIA, PAINTED STEEL PIPE BOLLARD

FILLED WITH CONCRETE 04 CONCRETE CURB. REFER TO CIVIL DRAWINGS

05 NOM. 1" X 6" RECYCLED PLASTIC 'LUMBER', WITH 5/8" GAP BETWEEN BOARDS.

06 CONCRETE SIDEWALK. REFER TO CIVIL DRAWINGS

A104

4 (04)

T. O. TRASH ENCLOSURE 6' - 0"

FINISH FLOOR
0' - 0"

(BASED ON BENJAMIN MOORE)

(BASED ON FRY REGLET)

07 3" X 3" SQUARE STEEL TUBE W/ DRIVE ON CAPS. PAINT TO MATCH ADJACENT WALL. 08 1 1/2" X 1 1/2' SQUARE STEEL TUVE. SHOP WELD

ALL JOINTS. 09 21" L. (MIN.) 3/8" DIA RODS W/ MIN 3" HOOK. DRILL HOLES IN CONCRETE TO LOCK GATES OPEN AND

CLOSED POSITIONS. 10 LANDSCAPING. REFER TO CIVIL DRAWINGS

HOLLYWOOD, FL 33023

851 S STATE RD 7

Bank of America 🤎

SERIAL NUM.: FLW-C66 SIGNATURE DESIGNATION: NRSP VERSION: 2.0

2-2016

M. Arthur Gensler Jr. & Associates Inc.

BULLETIN:

Gensler

LIC. NO. AA0002837

Main Office

2 Harrison Street Suite 400 San Francisco CA 94105 Tel 415.433.3700 Fax 415.836.4599



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08.15.16 ISSUE FOR TAC SUBMISSION

Seal / Signature

DANA MULLER, AIA REG. FL. NO. AR92911

08.15.2016

Project Name BAC/GU WASHINGTON PARK

Project Number 69.6191.100

Scale As indicated

Description

DUMPSTER ENCLOSURE

EXTERIOR FINISH SCHEDULE

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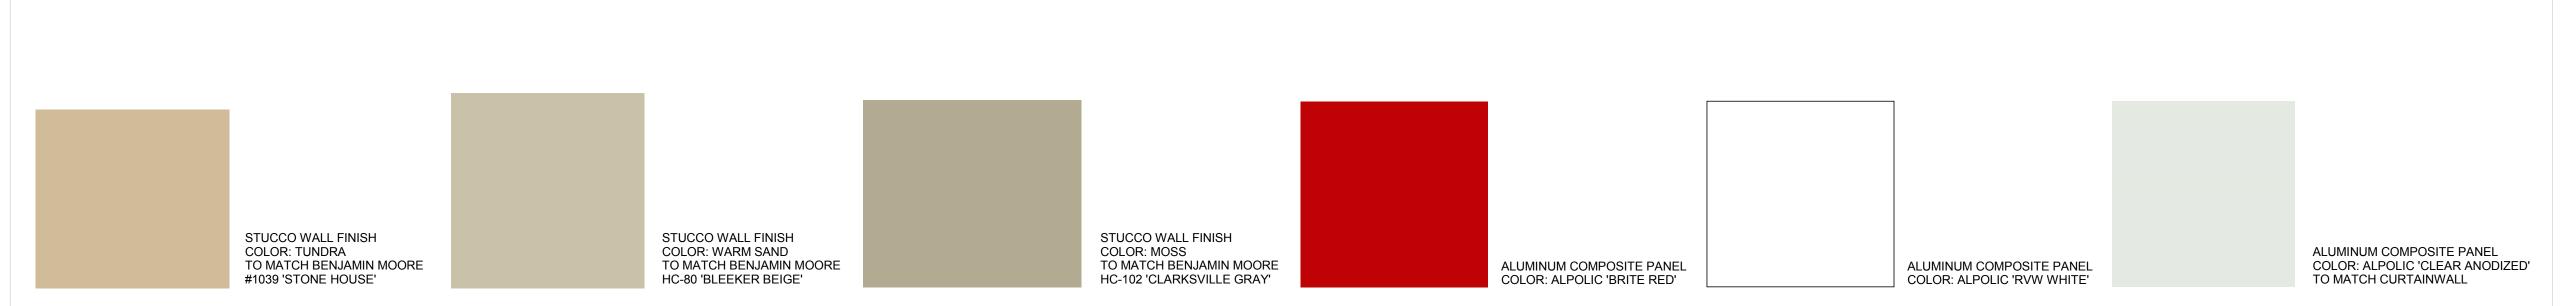
SCALE: 3/16" = 1'-0" ALUMINUM MECHANICAL EQUIPMENT SCREEN WALL PAINT TO MATCH BENJAMIN MOORE HC-102 "CLARKSVILLE GRAY" PREFINISHED METAL COPING TO MATCH BENJAMIN MOORE HC-102 "CLARKSVILLE GRAY" STUCCO ON CONCRETE MASONRY WALL TO

MATCH BENJAMIN MOORE HC-102 - STUCCO ON CONCRETE MASONRY WALL TO MATCH BENJAMIN MOORE CLASSIC #1039 "STONE HOUSE" B.O. DRIVE THRU CANOPY B.O. ENTRANCE CANOPY EL. 11' - 0 1/2" (08)(05) - ALUMINUM COMPOSITE METAL PANEL "BRITE RED" #4MMBTR BY ALPOLIC STUCCO ON CONCRETE MASONRY WALL TO MATCH BENJAMIN MOORE HC-80 "BLEEKER BEIGE" ALUMINUM COMPOSITE METAL PANEL "RVW WHITE" #3MM4RVW BY ALPOLIC CLEAR ANODIZED ALUMINUM

CLEAR ANODIZED ALUMINUM STOREFRONT SYSTEM

CURTAINWALL SYSTEM

NORTH ELEVATION - COLOR



EXTERIOR FINISH LEGEND

SHEET NOTES

- 01 BANK OF AMERICA SIGN BY OWNER 02 DRIVE THRU ATM BY OWNER
- 03 METAL PANEL SYSTEM 04 31 - FT FLAG POLE AND MOUNTING BRACKETS -PROVIDED BY CONTRACTOR (FLAG FURNISHED BY OWNER, INSTALLED BY CONTRACTOR)
- 05 S TYPE REGULATORY DIRECTIONAL/ INFORMATIONAL MONIGLE SIGNAGE PROVIDED BY
- OWNER. CENTER OF SIGN = CENTER OF LANE 06 LIGHT FIXTURE MOUNTED ON TOP OF FLAG POLE. SEE ELECT. DWG. FOR FIXTURE TYPE
- 07 BIKE RACK

INSTALLATION

- 08 EXTERIOR SECURITY CAMERA 09 KNOX BOX. COORDINATE WITH FIRE OFFICIAL THE MOUNTING HEIGHT AND LOCATION PRIOR
- 10 SIGNAGE ON DOOR THAT READS "NO SMOKING WITHIN 25 FEET OF THE ENTRANCE" PROVIDED BY
- 11 LINE OF ROOF BEYOND
- 12 MECHANICAL EQUIPMENT SCREENING.

Bank of America 🧼

851 S STATE RD 7

HOLLYWOOD, FL 33023

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Project Name

BAC/GU WASHINGTON PARK

Project Number 69.6191.100

Scale

As indicated

Description COLOR ELEVATIONS



06 PREFINISHED METAL COPING TO MATCH BENJAMIN MOORE HC-102 "CLARKSVILLE GRAY" ALUMINUM MECHANICAL EQUIPMENT SCREEN WALL TO 04)— MATCH BENJAMIN MOORE HC-102 "CLARKSVILLE GRAY" STUCCO ON CONCRETE MASONRY WALL TO MATCH BENJAMIN MOORE HC-102 "CLARKSVILLE GRAY" ILLUMINATED SIGN BY OWNER, REFER TO SIGN PACKAGE FOR DETAILS T.O. LOWER PARAPET STUCCO ON CONCRETE MASONRY WALL TO MATCH BENJAMIN MOORE CLASSIC #1039 "STONE HOUSE" B.O. DRIVE THRU CANOPY B.O. ENTRANCE CANOPY EL. 11' - 0 1/2" ALUMINUM COMPOSITE METAL PANEL "BRITE RED" #4MMBTR BY ALPOLIC -WIDE CHANNEL STUCCO SCREED. STUCCO ON CONCRETE MASONRY PAINT BENJAMIN MOORE CLASSIC #1039 ALUMINUM COMPOSITE METAL PANEL WALL TO MATCH BENJAMIN MOORE HC-80 "BLEEKER BEIGE" "STONE HOUSE" "RVW WHITE" #3MM4RVW BY ALPOLIC FINISH FLOOR 0' - 0" CLEAR ANODIZED ALUMINUM WIDE CHANNEL STUCCO SCREED. BENJAMIN MOORE CLASSIC #1039 ALUMINUM COMPOSITE METAL PANEL PAINT BENJAMIN MOORE CLASSIC #1039 "STONE HOUSE" "STONE HOUSE" PAINT FINISH -"BRITE RED" #4MMBTR BY ALPOLIC STOREFRONT SYSTEM - ALUMINUM COMPOSITE METAL PANEL "RVW WHITE" #3MM4RVW BY ALPOLIC

SOUTH ELEVATION - COLOR SCALE: 3/16" = 1'-0"



EXTERIOR FINISH SCHEDULE

EAST ELEVATION - COLOR

SCALE: 3/16" = 1'-0"

SHEET NOTES

01 BANK OF AMERICA SIGN BY OWNER 02 DRIVE THRU ATM BY OWNER

- 03 METAL PANEL SYSTEM
- 04 31 FT FLAG POLE AND MOUNTING BRACKETS -PROVIDED BY CONTRACTOR (FLAG FURNISHED BY OWNER, INSTALLED BY CONTRACTOR)
- 05 NIGHT DEPOSITORY 06 LIGHT FIXTURE MOUNTED ON TOP OF FLAG POLE.
- SEE ELECT. DWG. FOR FIXTURE TYPE 08 S-TYPE REGULATORY DIRECTIONAL/INFORMATIONAL MONIGLE SIGNAGE PROVIDED BY OWNER. CENTERLINE OF SIGN=
- 09 EXTERIOR SECURITY CAMERA

CENTERLINE OF LANE.

- 10 DRIVE UP TTW ATM BY OWNER
- 11 LINE OF ROOF BEYOND 12 MECHANICAL EQUIPMENT SCREENING.
- Bank of America 🧼

HOLLYWOOD, FL 33023

851 S STATE RD 7

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08.15.2016

Project Name

BAC/GU WASHINGTON PARK

Project Number 69.6191.100

Scale

As indicated

Description

COLOR ELEVATIONS

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