PLANNING DIVISION



File No. (internal use only):_

GENERAL APPLICATION

2600 Hollywood Boulevard Room 315 Hollywood, FL 33022

	APPLICATION TYPE (CHECK ONE):
CITY OF	Technical Advisory Committee
	City Commission Planning and Development Board
FLORIDA	Date of Application: February 27, 2023
Tel: (954) 921-3471	Location Address: 1914-1920 Pierce Street
Fax: (954) 921-3347	Lot(s): LOT 19,20 E1/2 Block(s): BLK 20 Subdivision: HOLLYWOOD 1-21 B
	Folio Number(s):5142 15 01 3490
	Zoning Classification: ND2 Land Use Classification: Residential
This application must be	Existing Property Use: multi family Sq Ft/Number of Units:
completed in full and submitted with all documents	Is the request the result of a violation notice? () Yes (X) No If yes, attach a copy of violation.
to be placed on a Board or Committee's agenda.	Has this property been presented to the City before? If yes, check al that apply and provide File Number(s) and Resolution(s): PACO 23-DP-20
	Economic Roundtable Technical Advisory Committee Historic Preservation Board
The applicant is responsible for obtaining the appropriate	☐ City Commission ☐ Planning and Development
checklist for each type of application.	Explanation of Request: request for site plan approval
Applicant(s) or their authorized legal agent must be	Number of units/rooms: <u>32</u> Sq Ft: <u>31,238</u>
present at all Board or Committee meetings.	Value of Improvement: Estimated Date of Completion: 2024
	Will Project be Phased? () Yes (XNo If Phased, Estimated Completion of Each Phase
At least one set of the	
submitted plans for each application must be signed	Name of Current Property Owner: AIR ABODES LLC
and sealed (i.e. Architect or	Address of Property Owner: 8201 PETERS RD #1000 FORT LAUDERDALE FL 33324
Engineer).	Telephone: 786-252-9459 Fax: Email Address: sindig@barmiholdings.com
Documents and forms can be	Name of Consultant/Representative/Tenant (circle one): Alexis Bogomolni (under contract)
accessed on the City's website	Address: 2980 NE 207 Street SUITE 603 Telephone: (786) 252-9459
at	Fax: Email Address: alexisbogo@abhre.com
http://www.hollywoodfl.org/Do cumentCenter/Home/View/21	Date of Purchase: 01/06/2022 Is there an option to purchase the Property? Yes (X) No ()
ouncil contention of viewiz r	If Yes, Attach Copy of the Contract. Pierce St, LLC currently under contract to purchase form Air Abodes, LLC
	List Anyone Else Who Should Receive Notice of the Hearing: Alexis Bogomolni
A.L.D.	alexisbogo@abhre.com (786) 252-9459 Address: 2980 NE 207 Street SUITE 603 Pamela Butler (954) 471-6177 Email Address: Choicepermitting@hotmail.com
	Pamela Butler (954) 471-6177 Email Address: <u>Choicepermitting@hotmail.com</u>



CERTIFICATION OF COMPLIANCE WITH APPLICABLE REGULATIONS

The applicant/owner(s) signature certifies that he/she has been made aware of the criteria, regulations and guidelines applicable to the request. This information can be obtained in Room 315 of City Hall or on our website at <u>www.hollywoodfl.org</u>. The owner(s) further certifies that when required by applicable law, including but not limited to the City's Zoning and Land Development Regulations, they will post the site with a sign provided by the Office of Planning and Development Services. The owner(s) will photograph the sign the day of posting and submit photographs to the Office of Planning and Development Services as required by applicable law. Failure to post the sign will result in violation of State and Municipal Notification Requirements and Laws.

(I)(We) certify that (I) (we) understand and will comply with the provisions and regulations of the City's Zoning and Land Development Regulations, Design Guidelines, Design Guidelines for Historic Properties and City's Comprehensive Plan as they apply to this project. (I)(We) further certify that the above statements and drawings made on any paper or plans submitted herewith are true to the best of (my)(our) knowledge. (I)(We) understand that the application and attachments become part of the official public records of the City and are not returnable.

Signature of Current Owner: <u>Jan Sunt</u>	Date: 2/28/23
PRINT NAME: Sam Schwardz, Mangger	Date: 2/28/23
Signature of Consultant/Representative:	Date:
PRINT NAME: Pamela Butler	O3/01/2023
Signature of Tenant:	Date:
PRINT NAME:	Date:

Current Owner Power of Attorney

I am the current owner of the described real property and that I am aware of the nature and effect the request for site plan and design approval to my property, which is hereby <u>Pamela Butler & Alberto Lorente</u> to be my legal representative before the <u>Committee</u>) relative to all matters concerning this application.

Sworn to and subscribed before me

Notary Public

State of Florida

this 28th day of February 2023



Signature of Current Owner

Sam Schuar Print Name

My Commission Expires: 10 26 (Check One) Personally known to me; OR ____ Produced Identification ____



TECHNICAL ADVISORY COMMITTEE REPORT

March 20, 2023

Air Abodes LLC/Alexis Bogomolni 2980 NE 207 Street, Suite 603 Aventura, FL 33180

FILE NUMBER: 23-DP-20

SUBJECT: Preliminary Site Plan and Design review for 32 Residential Units.

SITE DATA

Owner/Applicant:	Air Abodes LLC
Address/Location:	1914-1920 Pierce Street, Hollywood, FL 33020
Net Size of Property:	16,360 sq. ft. (0.375 acres)
Land Use:	Regional Activity Center (RAC)
Zoning:	ND-2
Present Use of Land:	Multifamily
Year Built:	1924/1944 (Broward County Property Appraiser)
ADJACENT LAND USE	
North:	Regional Activity Center (RAC)
South:	Regional Activity Center (RAC)
East:	Regional Activity Center (RAC)
West:	Regional Activity Center (RAC)
ADJACENT ZONING	
North:	North Downtown Medium Intensity Multi-Family District (ND-2)
South:	North Downtown Medium Intensity Multi-Family District (ND-2)
East:	North Downtown Medium Intensity Multi-Family District (ND-2)
West:	North Downtown Medium Intensity Multi-Family District (ND-2)

APPLICANTS MUST ADDRESS ALL COMMENTS AND FINDINGS AS IDENTIFIED BY MEMBERS OF THE TECHNICAL ADVISORY COMMITTEE BOTH IN WRITING (IDENTIFY PAGE NUMBER OF THE CORRECTION) AND ON THE SITE PLAN (ALL CHANGES MUST BE IDENTIFIED, I.E. BUBBLED).

A. <u>APPLICATION SUBMITTAL</u>

Tasheema Lewis, Associate Planner (<u>tlewis@hollywoodfl.org</u>) 954-921-3471

- Provide plat determination letter from the County. Should platting be necessary, prior to Final TAC submittal County Plat comments are required. Plat shall be submitted for recordation prior to submitting for Planning and Development Board. Include several copies of plat documents in future submittals.
 Please see included in this submission Plat Determination issued from Broward County Planning Council.
- 2. Ownership & Encumbrance Report (O&E):
 - a. Substantially compliant.
- 3. Alta Survey:
 - a. Shall be based on and dated after O&E. Ensure that O&E report is specifically referenced. Please see updated survey based on O&E and stated such on sheet 1 of 2 on April 14, 2023.
 - b. Work with the Engineering Division to ensure the survey includes the appropriate elements such as all easements and dedications are indicated.
 Please see updated survey reflecting any existing encumbrance.
- 4. Site Plan:
 - a. Provide cover sheet with location map.
 Response: Cover Sheet and Location Map provided in Cover Sheet A000
 - b. Side setback should be measured at the exterior most portion of the building. Response: Refer to Revised Drawings for setbacks location.
 - c. Clearly show dimensions for both curb cuts that is labeled 24'. It appears the dimensions exceed the width indicated and 30% curb cut requirement.
 Response: Refer to Revised Site Plan A100
 - d. Show dimensions for parallel spaces. Response: Refer to Revised Site Plan A100
 - e. Provide bicycle racks or storage shall. 1 per 20 spaces required. Response: Refer to Revised Site Plan A100
 - f. No column shall be within 3 ft. of the entrance to a parking space. Show length dimension of driveways. Indicate on site plan.
 - Response: Refer to Revised Site Plan A100
 - g. Consider inverting the orientation of the trash room and stair 2 for more efficient trash removal from the alley.
 - Response: Considered but does not work.
 - h. Provide dimensions for handicap parking space. Response: Refer to Revised Site Plan A100
 - i. Identify the space east of the lobby. Response: Refer to Revised Site Plan A100
 - j. Provide color material legend on elevation sheet. Response: See Revised Elevations for material color.
 - Identify the door leading to the lobby. Is this a fence gate?
 Response: Door was a fence and is removed. Refer to Revised Site Plan A100
 - I. Indicate propose fencing on the site plan. Response: Refer to Revised Site Plan A100
 - m. Work with engineering to ensure property has the correct amount of required handicap spaces. Response: Refer to Revised Site Plan A100. 2 ADA spaces required and provided.
 - n. Provide dimensions of the aluminum gazebo and pool.

Response: Refer to Revised Site Plan A104

- Provide table indicating unit type/size.
 Response: Refer to Revised A101 for requested table.
- Parking garage shall be screened with both architectural and landscape treatment.
 Response: Refer to Revised Site Plan A100, A201, A202 and Landscaping Plans. Architectural screen provided on north and south side and landscaping provided on the east and west sides as per landscaping drawings.
- q. Elevator bulkhead exceeds the maximum 25% encroachment.
 Response: Elevator bulkhead was revised to 71'-0" as per revised A201 and A202.
- Show property lines and setbacks on elevation sheets.
 Response: Refer to Revised Elevations A201 and A202
- s. Dimension any balcony encroachment. Response: Refer to Revised Drawings for balcony encroachment dimensions.
- Provide note on site plan that "any changes to design, including material changes, may require Planning and Development Board approval prior to construction.
 Response: Note added to Revised Site Plan A100
- 5. Site Data:
 - a. Substantially compliant.
- 6. Complete and submit to Broward County School Board an impact fee application prior to submitting for Board consideration. Ensure that the application has not expired at the time of Board Consideration Website:

https://www.browardschools.com/cms/lib/FL01803656/Centricity/Domain/13479/PublicSchoolImpactApplication1.pdf

Submitted to Tammy Sartin at Broward County School Board and pending review. Will provide update prior to Board Hearing.

 Indicate past, current and future meeting dates as they happen (not submittal dates) on Cover Sheet. Indicate specific Board/Committee (i.e. TAC, PDB, etc.) For future Board/Committee dates not known, leave blank until staff has advised of next meeting date.

Response: Refer to New Cover Sheet A000

8. A public participation outreach meeting shall be required for Land Use, Rezoning, Special Exception, and Site Plan requests. Applicants shall conduct at least one public participation outreach meeting and provide mailed written notice to all property owners and certified/registered civic and neighborhood association(s) within 500 feet of the proposed project. Fifteen days prior to the meeting, the applicant shall mail such notice and post a sign on the property, including the date, time, and place of the public participation outreach meeting. Such meeting shall occur prior to the applicable Committee, Board or City Commission submittal and the Applicant shall include in its application packet a letter certifying the date(s), time(s), location(s), a copy of the sig-in sheet, presentation material and general summary of the discussion, including comments expressed during the meeting(s).

The following Civic Association are located within 500 feet project site.

a. Downtown Parkside Royal Poinciana

Visit <u>http://www.hollywoodfl.org/204/Neighborhood-Association-Contact-List</u> for Contact Information. Noted and scheduled for July 2023...awaiting date confirmation from Civil Association. Will provide update at TAC meeting.

- 9. Additional comments may be forthcoming. Response: Understood
- 10. Provide written responses to all comments with next submittal. Response: Written Response Provided

B. ZONING

Tasheema Lewis, Associate Planner (<u>tlewis@hollywoodfl.org</u>) 954-921-3471

- 1. Indicate car lift specifications in notes on site plan. Response: Refer to Revised A104 FOR Car Lift Notes and details.
- Indicate curbing type in the parking area.
 Response: Refer to Revised Site Plan A100 for curbing identification.

C. ARCHITECTURE AND URBAN DESIGN

Tasheema Lewis, Associate Planner (<u>tlewis@hollywoodfl.org</u>) 954-921-3471

1. No comments at this time. Need to provide renderings and material legend with Final TAC submission. Renderings to be provided prior to Final TAC sign off

D. <u>SIGNAGE</u>

Tasheema Lewis, Associate Planner (<u>tlewis@hollywoodfl.org</u>) 954-921-3471

For review, full signage package shall be provided.
 No signage being proposed. Should any sign be installed at a later date it will meet the LDR requirements.

E. <u>LIGHTING</u> Tasheema Lewis, Associate Planner (<u>tlewis@hollywoodfl.org</u>) 954-921-3471

1. Indicate 0.5 foot candle lighting. Response: Note added to Revised Site Plan A100

F. GREEN BUILDING & ENVIRONMENTAL SUSTAINABILITY

Tasheema Lewis, Associate Planner (<u>tlewis@hollywoodfl.org</u>) 954-921-3471

- Indicate on the site plan where the infrastructure necessary for future installation of electric vehiclecharging equipment will be located. (See 151.154, Ordinance O-2016-02).
 Response: Refer to Revised Site Plan A100 for future installation of electric vehicle charging equipment.
- Work with Building Department to ensure compliance with Green Building Ordinance. Need at least 10. Review and adjust drawings as necessary. Indicate on drawings Green Building certification to be achieved.
 Response: Refer to Revised Site Plan A100 for Green Building Certification to be achieved.

G. ENGINEERING

Azita Behmardi, City Engineer (<u>abehmardi@hollywoodfl.org</u>) 954-921-3251 Clarissa Ip, Assistant City Engineer (<u>cip@hollywoodfl.org</u>) 954-921-3915 Rick Mitinger, Transportation Engineer (<u>rmitinger@hollywoodfl.org</u>) 954-921-3990

Revision Procedure:

-Any revisions applied to the plans shall be numbered and bubbled/clouded. -In an 8.5"x11" revision summary, identify each revision by providing the plan sheet number, revision cloud / bubble number and a narrative describing each change or how a comment is being addressed.

1. Unity of Title or similar will be required.

Noted and will be provided prior to the issuance of a building permit.

2. Please sign and seal survey.

See submitted signed and sealed survey.

- Provide plat determination letter from the Broward County Planning Council.
 Please see included in this submission Plat Determination issued from Broward County Planning Council.
- 4. On overall site plan and all applicable plans, please provide items such as:
 - a. Existing right-of-way width dimension and show limits of the rights-of-way on of all street / alleys adjacent to the site.
 - Response: Refer to Revised Site Plan A100
 - Include and show all surrounding elements of the site on plans, as applicable, i.e. adjacent alley, road, properties, limits of rights-of-way on both sides of adjacent streets or alleys including any curb cuts, edge of pavement, swale, sidewalks etc.
 Response: Refer to Revised Site Plan A100
 - Provide sight triangle as per Chapter 155.12 of the City code, be sure to provide dimension for distance between edge of pavement and the property line.
 Response: Refer to Revised Site Plan A100
 - d. Setback dimensions for all features (slabs and walkways) adjacent to the site's property lines. Response: Refer o Revised Site Plan A100
 - e. Label property line around all sides of site.
 - Response: Refer to Revised Site Plan A100
 - Provide dimensions of all parking stalls, width and length. Stalls adjacent to obstruction on one side shall be minimum 9.5' wide and 10.5' wide for stalls with obstruction on both sides.
 Response: Refer to Revised Site Plan A100
 - g. Provide dimension of drive aisle width adjacent to parallel Stalls 11-13 and indicate direction of vehicular traffic.
 - Response: Refer to Revised Site Plan A100
 - h. Building column setback from the entrance of the parking stalls, minimum 3' is required. **Response: Refer to Revised Site Plan A100**
 - i. Provide dimension for curb cuts at the property line and for all walkways connecting to the public sidewalk or alley. Curb cuts shall meet Chapter 155.08 of the City code.

Response: Refer to Revised Site Plan A100

- 5. Provide width dimension for the parallel parking, minimum is 8.5'.
- Response: Refer to Revised Site Plan A100
- 6. On Sheet A100, please clearly show where the building walls end adjacent to Stall 1 and Stall 16 and how the building accesses connect to the driveways. Also, please indicate material of the driveways and driveway aprons.

Response: Refer to Revised Site Plan A100

- 7. On Sheet A100, in the General Zoning Requirements Table, include the ADA stall in the parking calculations.
 - Response: Refer to Revised Site Plan A100
- 8. On Sheet A100, show the direction of vehicular traffic circulation on plan.

Response: Refer to Revised Site Plan A100

9. Proposed gates are shown at the driveway openings on plans at the property line. Please label on plans. Vehicular queueing spaces and any additional space required for gate operation will be required, please show on plans. Minimum of one vehicular queueing space at the Entrance to the parking within private property is required. There shall be no parking adjacent to the vehicular queueing space. Please indicate the area on plan, minimum queueing space dimension is 8.5'x19'. Also, include information such as type of gate and access control (i.e. remote, sensor, etc.).

Response: Refer to Revised Site Plan A100

10. Label wall or fence at the front and back of the property along the property, identify its material and height. Detail with section will be required to show its footing to not encroach into adjacent right-of-way or property.

Response: Refer to Revised Site Plan A100

11. Label what appears to be an elevator on plans.

Response: Refer to Revised Site Plan A100

- 12. Indicate location for mailboxes / mail services on plans. Response: Refer to Revised Site Plan A100
- Sheet A100, label all material types (i.e. parking area, gray hatch) and indicate location where there is a change in elevation and where it is flush.
 Response: Refer to Revised Site Plan A100
- 14. Indication location and type of curbing used on plans. Response: Refer to Revised Site Plan A100
- 15. Sheet A100, what is the double line running through parking Stall 1-10? Response: Refer to Revised Site Plan A100
- 16. Indicate on plans for existing sidewalk along Pierce Street to be replaced. Provide ADA detectable warning at driveway openings, include details.

Response: Refer to Revised Site Plan A100

17. On Sheet A101, Elevations, please identify the vehicular Entrance and Exit to the parking area and provide Response: the vertical clearance.

Response: Refer to Revised Site Plan A100, A201 and A202

- 18. Provide dimension for the ADA accessible route, minimum width is 5' and identify any change in elevation or slopes. If there is no change in elevation, indicate on plans the transition is flush. Please add a note on the site plan stating any lip from 1/4" but not greater than ½" will be beveled to meet ADA requirements. Response: Refer to Revised Site Plan A100Provide trash chute.
- 19. Indicate on plans for existing curb cuts and swales in the rights-of-way to be properly closed off and restored.

Response: Refer to Revised Site Plan A100 and Civil Drawings

- 20. Provide civil plans for the proposed project. Indicate items such as but not limited to drainage improvements, curbing, drive aisle widths, vehicular circulation, sight visibility triangle, vehicular turning radii, pavement marking and signage plans and details. Show location of existing water and sewer mains on plans and show the project is planning to connect to the city system. For water and sanitary sewer connection, show any pavement restoration and details required for connections within City rights-of-way. Full road width asphalt pavement mill and resurface is required for all adjacent road / alley to the parcel. Provide City of Hollywood pavement, sidewalks and swale grading details in plan set. **Noted...please see included civil plan sheets with this submission.**
- 21. Please note that the City, in conjunction with the Downtown Community Redevelopment Agency, is working on developing a manual setting forth requirements for rights-of-way design and improvements guidelines in the RAC area. Rights-of-way improvements are to be determined and will be required. Continued coordination will be necessary.

Noted...please provide specific code requirements so plans can be updated and modified prior to submitting for building permits.

- 22. MOT plans required at the time of City Building Permit review. Noted
- 23. All outside agency permits must be obtained prior to issuance of City building permit. **Noted**
- Impact fees (inclusive of park impact fee) under the new City Ordinance PO-2022-17, effective September 21, 2022, to be paid prior to building permit issuance.
 Noted

More comments may follow upon review of the requested information.

Response: Understood

H. LANDSCAPING

Favio Perez, Landscape Reviewer (<u>fperez@hollywoodfl.org</u>) 954-921-3997 Clarissa Ip, Assistant City Engineer (<u>cip@hollywoodfl.org</u>) 954-921-3915

1. Tree disposition sheet is not taking into account the removal of tree #16. Revise mitigation chart/requirements and compensation.

RESPONSE: TREE DISPOSITION UPDATED PER COMMENT.

Revise legend with requirements to show the RAC zoning requirements: 1 street tree per 30 lf, 1 tree per 20 lf for landscape buffer within required setbacks, 1 tree per 20 lf when abutting an alley, 1 tree per parking island, 1 tree per 1,000 sf of pervious area of property.

Response: LANDSCAPE LEGEND UPDATED PER COMMENT.

2. No gravel allowed in open space areas. All landscape areas shall be covered by living plant material as required by code.

Response: ALL GRAVEL REMOVED PER COMMENT.

3. Trees #14 & #15 are proposed to remain. Building construction will impact ¾ of the critical root zone. Provide redesign or mitigation.

Response: TREES #14 AND #15 ARE NOW PROPOSED TO BE REMOVED PER COMMENT.

- 4. Existing sabal palms are noted in good condition. Recommend relocation on site. Response: SABAL PALMS TO BE RELOCATED PER COMMENT.
- Furnish a RESPONSE SHEET with written responses to all plan review comments on 8-1/2" x 11" design professional office letter head; include date, project name, permit application number, contact information (phone and email). Include reference to clouded updates on plans (if applicable). Provide clouded and numbered revisions to any revised sheet.

Response: UNDERSTOOD.

I. <u>UTILITIES</u>

Alicia Verea-Feria, Engineer (<u>averea-feria@hollywoodfl.org</u>) 954-921-3302

1. Submit civil engineering plans indicating existing and proposed drainage, water and sewer service for initial review.

Response: See Civil Plans.

- 2. Show Water and Sewer demand calculations on proposed utilities plans. Response: See Civil Plans.
- Clarify how the fire line will be serviced for this property, as applicable.
 Response: 4" Fire line comes into the property.
- Include the City's latest applicable standard water and sewer details. The details are available on the City's website via the following link: <u>http://www.hollywoodfl.org/1169/Standard-Details-and-Public-Notices</u>.
 Response: Hollywood Details included in Civil Plans.
- This site resides currently within FEMA Flood Zone X. The proposed Finished Floor Elevations (FFE) requirements shall comply with the greatest of the following three (3) conditions, as applicable.
 Response: Acknowledged.
 - a. Section 154.50 of the City's Code of Ordinances requires the minimum FFE for residential shall be, at a minimum, 18-inches above the elevation of the crown of the adjacent road or 6-inches, at a minimum, for non-residential use.
 - b. Broward County Preliminary 2019 FEMA Flood Maps (as recommended), available online via the following link:

https://bcgis.maps.arcgis.com/apps/View/index.html?appid=ea44837317bd47eaa5373ce3e2f0 1b6e; OR

- c. Broward County Future Conditions 100-year Flood Map 2060 (in effect as of July 2021), available online via the following link: <u>https://bcgis.maps.arcgis.com/apps/webappviewer/index.html?id=ec160b81e7f84bdeacd a62575e817380</u>
- 6. Indicate FFE for all enclosed areas on the ground floor. **Response: FFE of 9.00 indicated.**
- 7. Provide perimeter cross sections across all property limits including transition areas meeting adjacent property grades.
 - **Response: Cross-section on Civil Sheets**
- 8. Ensure all stormwater is retained onsite. Response: All stormwater is retained onsite.
- 9. Indicate how roof drainage will be collected and connected to the on-site drainage system. Response: Roof drains to be tied into stormwater piping.
- 10. Provide preliminary drainage calculations. **Response: See attached.**
- 11. Submit Erosion Control Plan and details. Response: Erosion Plans Included in Civil Set.
- 12. Permit approval from outside agencies will be required. **Response: Acknowledged.**
- 13. Landscape plans to be submitted should coordinate with civil plans to accommodate for drainage features. **Response: Acknowledged.**
- 14. Additional comments may follow upon further review of requested items. **Response: Understood**

BUILDING

RussellLong,AssistantBuildingOfficial(rlong@hollywoodfl.org)954-921-3490Daniel Quintana, Electrical Plans Examiner/Inspector (dquintana@hollywoodfl.org)954-921-3335

1. Substantially Compliant.

J. <u>FIRE</u>

Chris Clinton, Deputy Fire Marshal / Assistant Division Chief (<u>cclinton@hollywoodfl.org</u>) 954-967-4404

Fire review for TAC is limited to fire department access and minimum fire flow requirements for water supply for firefighting purposes. A complete architectural review will be completed during formal application of architectural plans to the building department. **Response: Understood**

- At time of submittal, water supply must meet NFPA 1 (2018 Ed.) Section 18.4.5.3. --- In order to determine the minimum fire flow for firefighting purposes, a hydrant flow test will need to be scheduled through our underground utilities dept., underground@hollywoodfl.org. --- After the results are completed, the civil engineer shall show on civil drawings the calculations using table 18.4.5.2.1 showing that the project meets the minimum fire flow requirements for the building.
 - Response: Calculations on Civil Sheet.
- Water supply and any new hydrants shall be in place prior to accumulation of combustible materials per NFPA 1 (2018 Ed.) Section 16.4.3.1.1.

Response: Acknowledged.

3. As per NFPA 1 (2018 Ed.) Section 12.3.2 --- In new buildings three stories or greater in height, a quality assurance program for the installation of devices and systems installed to protect penetration and joints shall be prepared and monitored by the RDP responsible for design. Inspections of firestop systems and fire-resistive joint systems shall be in accordance with 12.3.2.1 and 12.3.2.2. --- Inspections of fire stop systems and fire-resistive joint systems shall be in accordance with 12.3.2.1 and 12.3.2.1. --- Architectural plans will be required to show this information moving forward for buildings three stories or greater in Page 8 of 10.

height. Provide a note on the plan regarding NFPA 1 (2018 Ed.) Section 12.3.2. **Response: Note added to Revised A100**

- 4. Be advised that NFPA 1 (2018 edition) Section 11.10.1 requires that minimum radio signal strength for fire department communications shall be maintained at a level determined by the AHJ for all new and existing buildings. --- If at any time (including the construction phase), Fire Department personnel determine that the minimum radio signal strength is not being met, a Two-Way Radio Communication Enhancement system may be required to be installed as determined by the AHJ. Response: Understood
- 5. Plan pages A100 and A101 show two numbers per parking space (see 19-42). Do these double numbers represent proposed car stackers? If so, be advised that the currently adopted NFPA 13 edition calls for this hazard classification to be protected as Extra Hazard Group II.

Response: Numbers indicate car stackers. Hazard Classification Understood

- NFPA 13 (2016 Ed.) Section 5.4.2 (Extra Hazard (Group 2) --- Extra hazard (Group 2) occupancies shall be defined as occupancies or portions of other occupancies with moderate to substantial amounts of flammable or combustible liquids or occupancies where shielding of combustibles is extensive.
 Response: Understood
- NFPA 13 (2016 Ed.) Section A.5.4.2 (9) --- Car stackers and car lift systems with 2 cars stacked vertically. Response: Understood

K. PUBLIC WORKS

Daniel Millien, Environmental Services Manager (<u>dmillien@hollywoodfl.org</u>) 954-967-4526 No comments received.

L. PARKS, RECREATION AND CULTURAL ARTS

David Vazquez, Assistant Director (<u>dvazquez@hollywoodfl.org</u>) 954-921-3404

1. Park Impact Fee application required.

Please see included Park Impact Fee Application

M. COMMUNITY DEVELOPMENT

Liliana Beltran, Housing inspector (<u>lbeltran@hollywoodfl.org</u>) 954-921-2923

1. No comments received.

N. ECONOMIC DEVELOPMENT

Raelin Storey, Director (<u>rstorey@hollywoodfl.org</u>) 954-924-2922 Herbert Conde-Parlato, Economic Development Manager (<u>hconde-parlato@hollywoodfl.org</u>) 954-924-2922

What is the estimated value of the project? It was left blank on the application.
 6 million

O. POLICE DEPARTMENT

Christine Adamcik, Police (<u>cadamcik@hollywoodfl.org</u>) 954-967-4371 Steven Bolger, Police (<u>sbolger@hollywoodfl.org</u>) 954-967-4500 Doreen Avitabile, Police (<u>davitabile@hollywoodfl.org</u>) 954-967-4371

1. Substantially compliant.

P. DOWNTOWN AND BEACH CRA

Jorge Camejo, Executive Director (jcamejo@hollywoodfl.org) 954-924-2980 Susan Goldberg, Deputy Director (sgoldberg@hollywoodfl.org) 954-924-2980 Francisco Diaz-Mendez, Project Manager (<u>fdiaz-mendez@hollywoodfl.org</u>) 954-924-2980

- 1. Elevations lack details and information on proposed finishes and materials. Noted...please see updated elevations reflecting material and finish legend
- The lobby area appears to be very small. Please work on improving the architectural details and delineation of the lobby area to make it more inviting to pedestrians.
 Response: Understood
- 3. CRA would like to suggest reducing the width of the proposed single lane driveways to 11'. Response: Refer to Revised A100. Driveway reduced to 12'-0".

Q. <u>PARKING</u>

Jovan Douglas, Parking Operations Manager (jdouglas@hollywoodfl.org) 954-921-3548

1. No comments received.

R. ADDITIONAL COMMENTS

Tasheema Lewis, Associate Planner (<u>tlewis@hollywoodfl.org</u>) 954-921-3471

1. Additional comments may be forthcoming. **Response: Understood**

The Technical Advisory Committee does not find this application substantially compliant with all applicable regulations, therefore the Applicant must resubmit for TAC review.

Please be advised, in the future any additional review by the TAC may result in the payment of additional review fees.

If these comments have not been addressed within 120 days of this dated report the application will expire. As a result, a new application and fee will be required for additional review by the TAC.

Note that any use proposed for the site shall be consistent with Zoning and Land Development Regulations.

Should you have any questions, please do not hesitate to contact your Project Planner at 954-921-3471.

Sincerely,

Tasheema Lewis Associate Planner

C: 1914-1920 Pierce Street via email <u>sindig@barmiholdings.com</u> Alexis Bogomolni via email <u>choicepermitting@hotmail.com</u>

ALTA/NSPS LAND TITLE SURVEY

- 1. NOT VALID WITHOUT THE SIGNATURE AND THE ORIGINAL RAISED SEAL OF A FLORIDA LICENSED SURVEYOR AND MAPPER.
- THIS SURVEY WAS DONE SOLELY FOR BOUNDARY PURPOSES AND DOES NOT 2. DEPICT THE JURISDICTION OF ANY MUNICIPAL, STATE, FEDERAL OR OTHER
- ENTITIES. THE LAND DESCRIPTION SHOWN HEREON WAS PROVIDED BY THE CLIENT.
- 3. UNDERGROUND IMPROVEMENTS NOT SHOWN.
- ELEVATIONS SHOWN HEREON ARE BASED ON THE NORTH AMERICAN VERTICAL 5. DATUM OF 1988.
- 6. BENCHMARK REFERENCE : CITY OF HOLLYWOOD BENCHMARK: SQUARE CUT AT NW CORNER OF 24TH AVENUE AND POLK STREET. ELEVATION=10.50' (NAVD88)
- 7. THIS SURVEY WAS MADE IN ACCORDANCE WITH LAWS AND/OR MINIMUM STANDARDS OF THE STATE OF FLORIDA.
- 8. THE PROPERTY DESCRIBED HEREON (THE "PROPERTY") IS THE SAME AS THE PROPERTY DESCRIBED IN OWNERSHIP AND ENCUMBRANCE REPORT SEARCH NO .: 22-991-1-UPDATE 1, CERTIFIED FROM DATE OF PLAT (MAY 14, 1925) THROUGH THE 1ST DAY OF JANUARY 2023. AT 11:00 O'CLOCK P.M. AND THAT ALL EASEMENTS, COVENANTS AND RESTRICTIONS REFERENCED IN SAID TITLE COMMITMENT OR APPARENT FROM A PHYSICAL INSPECTION OF THE PROPERTY OR OTHERWISE KNOWN TO ME HAVE BEEN PLOTTED HEREON OR OTHERWISE NOTED AS TO THEIR EFFECT ON THE PROPERTY.

ENCUMBRANCES:


NOTES:

ITEM 1. EASEMENTS, RESTRICTIONS, RESERVATIONS, COVENANTS AND CONDITIONS SET FORTH ON PLAT OF HOLLYWOOD, PLAT BOOK 1, PAGE 21, PUBLIC RECORDS BROWARD COUNTY, FLORIDA. (AFFECTS/PLOTTED)

ITEM 2. CLAIM OF LIENS: CITY OF HOLLYWOOD, A FLORIDA MUNICIPAL CORPORATION TO AIR ABODES LLC, DATED DECEMBER 13, 2022, FILED DECEMBER 14, 2022, UNDER INSTRUMENT NO. 118571343. (AFFECTS/NOT PLOTTABLE)

ITEM 3. CLAIM OF LIENS: CITY OF HOLLYWOOD, A FLORIDA MUNICIPAL CORPORATION TO AIR ABODES LLC, DATED DECEMBER 13, 2022, FILED DECEMBER 14, 2022, UNDER INSTRUMENT NO. 118571359. (AFFECTS/NOT PLOTTABLE)

- 9. ALL UTILITIES SERVING THE PROPERTY ENTER THROUGH ADJOINING PUBLIC STREETS AND/OR EASEMENTS OF RECORD.
- 10. THERE ARE NO ENCROACHMENTS ONTO ADJOINING PREMISES, STREETS OR ALLEYS BY ANY BUILDINGS, STRUCTURES OR OTHER IMPROVEMENTS LOCATED ON THE PROPERTY, AND NO ENCROACHMENTS ONTO THE PROPERTY BY BUILDINGS. STRUCTURES OR OTHER IMPROVEMENTS SITUATED ON ADJOINING PREMISES.
- 11. THE PROPERTY HAS DIRECT ACCESS TO PIERCE STREET, DEDICATED PUBLIC STREETS AS SHOWN ON PLAT BOOK 1, PAGE 21, SAME BEING PAVED AND DEDICATED PUBLIC ROADWAYS MAINTAINED BY THE CITY OF HOLLYWOOD, BROWARD COUNTY, FLORIDA.
- 12. THERE ARE NO STRIPED PARKING SPACES ON THE PROPERTY.
- 13. THERE IS NO OBSERVED EVIDENCE OF CURRENT EARTH MOVING WORK, BUILDING CONSTRUCTION OR BUILDING ADDITIONS AT THE PROPERTY.
- 14. THERE IS NO PROPOSED CHANGES IN STREET RIGHT OF WAY LINES AFFECTING THE PROPERTY, ACCORDING TO BROWARD COUNTY, FLORIDA.
- 15. THERE IS NO OBSERVED EVIDENCE OF RECENT STREET OR SIDEWALK CONSTRUCTION OR REPAIRS AFFECTING THE PROPERTY.
- 16. THERE IS NO OBSERVED EVIDENCE OF USE OF THE PROPERTY AS A SOLID WASTE DUMP, SUMP OR SANITARY LANDFILL.
- 17. NO FIELD DELINEATION OF WETLANDS MARKERS WERE OBSERVED.

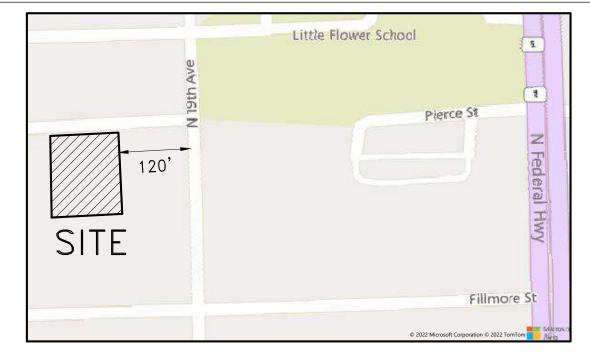

LOCATION MAP (NTS)

LEGEND:


CKD CONC DWN	CHECKED BY CONCRETE DRAWN BY	OR PLAT THER PUBLIC RECOR
FB/PG	FIELD BOOK AND PAGE	
SIR	SET 5/8"IRON ROD & CAP #6448	
SNC		CERTIFIED TO:
FIR	FOUND IRON ROD	
FIP		1920 PIERCE LL
FNC		ALEX D. SIRULN
FND	FOUND NAIL & DISK	FIDELITY NATION
PRM		
P.B.		SURVEYOR'S CER
	BROWARD COUNTY RECORDS FLORIDA POWER & LIGHT	SURVETURS CER
	CHAIN LINK FENCE	
	OVERHEAD UTILITY LINES	
	WATER METER	THIS IS TO CERT
WV		WERE MADE IN
SSMH	SANITARY SEWER MANHOLE	FOR ALTA/NSPS
SDMH	STORM DRAIN MANHOLE	NSPS, AND INCL
BFP	BACK FLOW PREVENTER	14, 16 17 AND
EB	ELECTRIC BOX	
WPP	WOOD POWER POLE	THE FIELDWORK
MLP	METAL LIGHT POLE	
CPP	CONCRETE POWER POLE	
0.00	ELEVATIONS	
UNK		
ALTA	AMERICAN LAND TITLE ASSOCIATION	
NSPS	NATIONAL SOCIETY OF PROFESSIONAL SURVEYORS	

\int				PROJECT NUMBER: 9818-22	REVISIONS	DATE	FB/PG	DWN	СКД	FLOOD ZONE INFORMA	ATION	PROPERTY ADDRESS :
	CODZINZ	SURVEYORS & ASSOCIA	(IES, INC.)		ALTA/NSPS LAND TITLE SURVEY	06/28/22	SKETCH	АМ	REC	COMMUNITY NUMBER 1	25113	1914 & 1920 PIERCE STREET
		3921 SW 47TH AVENUE, SUITE 1011		CLIENT :	UPDATE SURVEY	02/04/23	SKETCH	JD	REC	PANEL NUMBER	0569H	
		DAVIE, FLORIDA 33314 CERTIFICATE OF AUTHORIZATION : LB			REVISED PER O&E	04/19/23	SKETCH	АМ	REC	ZONE	Х	SCALE: N/A
		PHONE (954)689-7766 FAX (954)68		MG3 GROUP						BASE FLOOD ELEV	N/A	
L		THONE (954)089-7700 TAX (954)08	9-7799							EFFECTIVE DATE 08/	18/14	SHEET 1 OF 2

ERTIFICATION

RTIFY THAT THIS MAP OR PLAT AND THE SURVEY ON WHICH IT IS BASED ACCORDANCE WITH THE 2021 MINIMUM STANDARD DETAIL REQUIREMENTS LAND TITLE SURVEYS, JOINTLY ESTABLISHED AND ADOPTED BY ALTA AND LUDES ITEMS 1, 2, 3, 4, 5, 6(A), 6(B), 7 (A), (B) AND (C), 8, 9, 13, ND 19 OF TABLE A THEREOF.

WAS COMPLETED ON FEBRUARY 04, 2023.

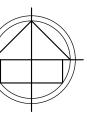



LAND DESCRIPTION:

LOTS 19, 20 AND 21, BLOCK 20 OF "HOLLYWOOD", ACCORDING TO THE MAP OR PLAT THEREOF, AS RECORDED IN PLAT BOOK 1, PAGE 21, OF THE RDS OF BROWARD COUNTY, FLORIDA.

> LC. A FLORIDA LIMITED LIABILITY COMPANY NIK. P.A. NAL TITLE INSURANCE COMPANY

> > RICHARD E. COUSINS PROFESSIONAL SURVEYOR AND MAPPER FLORIDA REGISTRATION NO. 4188

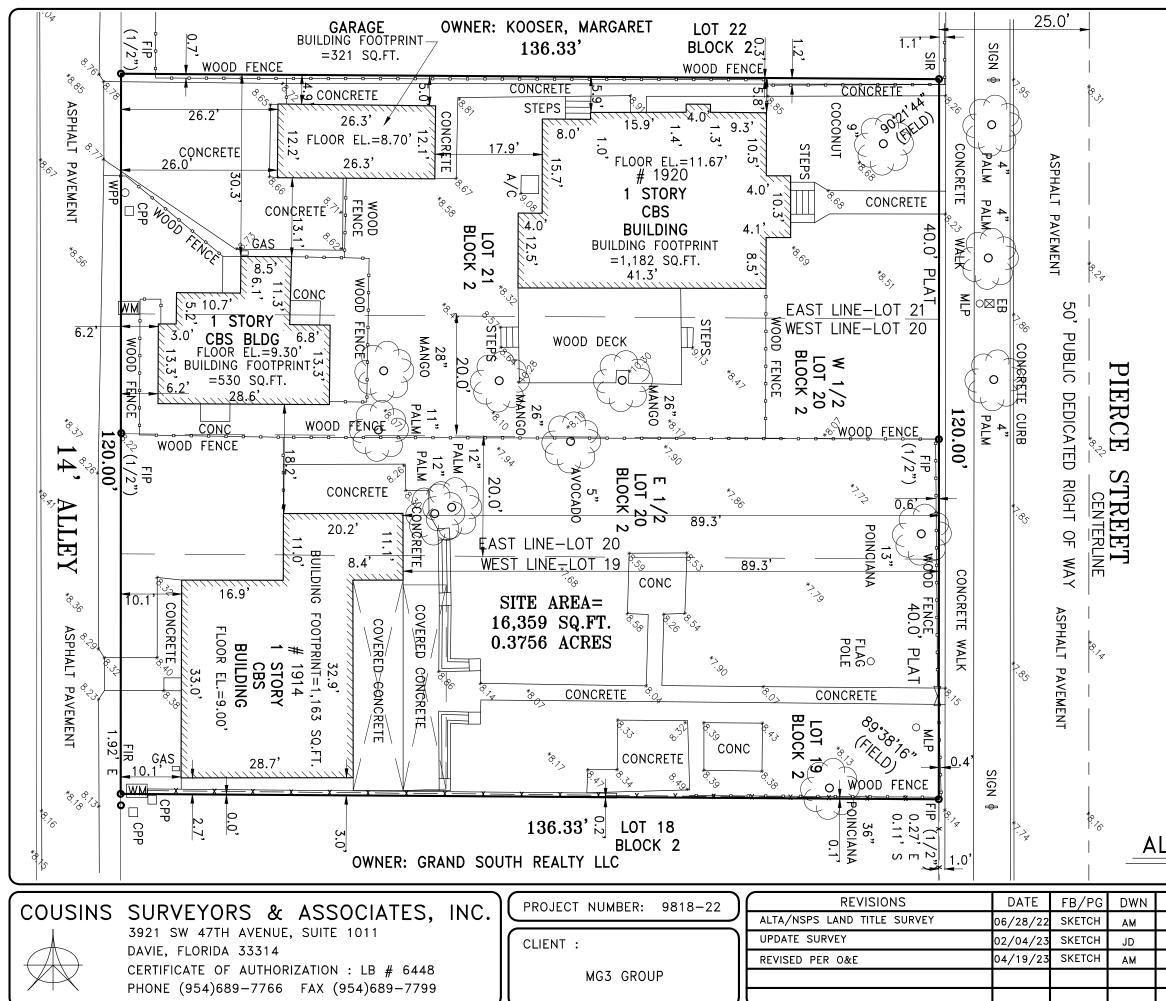

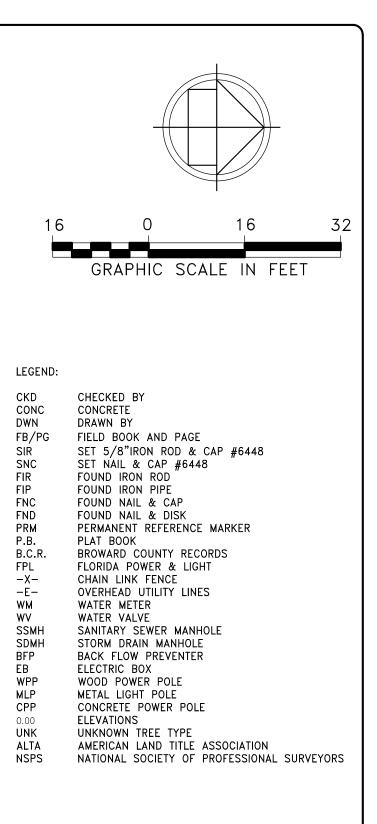

ALTA/NSPS LAND TITLE SURVEY


СКД	FLOOD ZONE INFORMATION	PROPERTY ADDRESS :
REC	COMMUNITY NUMBER 125113	1914 & 1920 PIERCE STREET
REC	PANEL NUMBER 0569H	
REC	ZONE X	SCALE: 1"= 16'
	BASE FLOOD ELEV N/A	
	EFFECTIVE DATE 08/18/14	SHEET 2 OF 2

INDEX OF DRAWINGS

	<u>ARCHIT</u>	ECTURAL:
REV. DATE	<u>SHEET</u>	TITLE
1 03.28.23 1 03.28.23 1 03.28.23 1 03.28.23 1 03.28.23 1 03.28.23 1 03.28.23 1 03.28.23 1 03.28.23 1 03.28.23 1 03.28.23 1 03.28.23 1 03.28.23 1 03.28.23 1 03.28.23	A000 A100 A101 A102 A103 A104 A201 A202	COVER SHEET PROPOSED GROUND FLOOR / SITE PLAN AND NOTES FAR AND OPEN AREAS SQUARE FEET PLANS PROPOSED SECOND AND THIRD FLOOR PLANS PROPOSED FOURTH AND FIFTH FLOOR PLANS PROPOSED ROOF PLAN AND PARKLIFT DETAILS PROPOSED NORTH AND WEST EXTERIOR ELEVATIONS PROPOSED SOUTH AND EAST EXTERIOR ELEVATIONS
	<u>CIVIL:</u>	
<u>REV.</u> DATE	<u>SHEET</u>	TITLE
1 06.15.23 1 06.15.23 1 06.15.23 1 06.15.23 1 06.15.23 1 06.15.23 1 06.15.23 1 06.15.23 1 06.15.23 1 06.15.23 1 06.15.23 1 06.15.23 1 06.15.23 1 06.15.23 1 06.15.23	C-1 C-2 C-3 C-4 C-5 C-6 C-7 C-8	SITE PAVING, GRADING, AND DRAINAGE PLAN SITE PAVING, GRADING, AND DRAINAGE DETAILS WATER AND SEWER PLAN WATER AND SEWER DETAILS WATER AND SEWER DETAILS PAVEMENT MARKINGS AND SIGNAGE PLAN GENERAL NOTES STORMWATER POLLUTION PREVENTION PLANS
	LANDSC	CAPE:
REV. DATE	SHEET	TITLE
1 03.28.23 1 03.28.23 1 03.28.23 1 03.28.23 1 03.28.23 1 03.28.23 1 03.28.23 1 03.28.23 1 03.28.23 1 03.28.23 1 03.28.23 1 03.28.23 1 03.28.23	TD-1 TD-2 L-1 L-2 L-3 L-4 IRR-1 IRR-2	TREE DISPOSITION PLAN TREE DISPOSITION DETAILS, SPECIFICATIONS SITE LANDSCAPE PLAN LANDSCAPE DETAILS, SPECIFICATIONS, ETC. SECOND LEVEL COURTYARD LANDSCAPE PLAN ROOF-POOL LEVEL LANDSCAPE PLAN SITE IRRIGATION PLAN IRRIGATION DETAILS, SPECIFICATIONS, ETC.
1 03.28.23 1 03.28.23 03.28.23	IRR-3 IRR-4	SECOND LEVEL COURTYARD IRRIGATION PLAN ROOF-POOL LEVEL IRRIGATION PLAN


NEW 32 UNITS DEVELOPMENT AT **DOWNTOWN HOLLYWOOD** 1914 - 1920 PIERCE STREET HOLLYWOOD, FLORIDA 33020 (RESPONSE TO TAC COMMENTS DATED MARCH 20, 2023)

1920 Summer of the local division of the local di

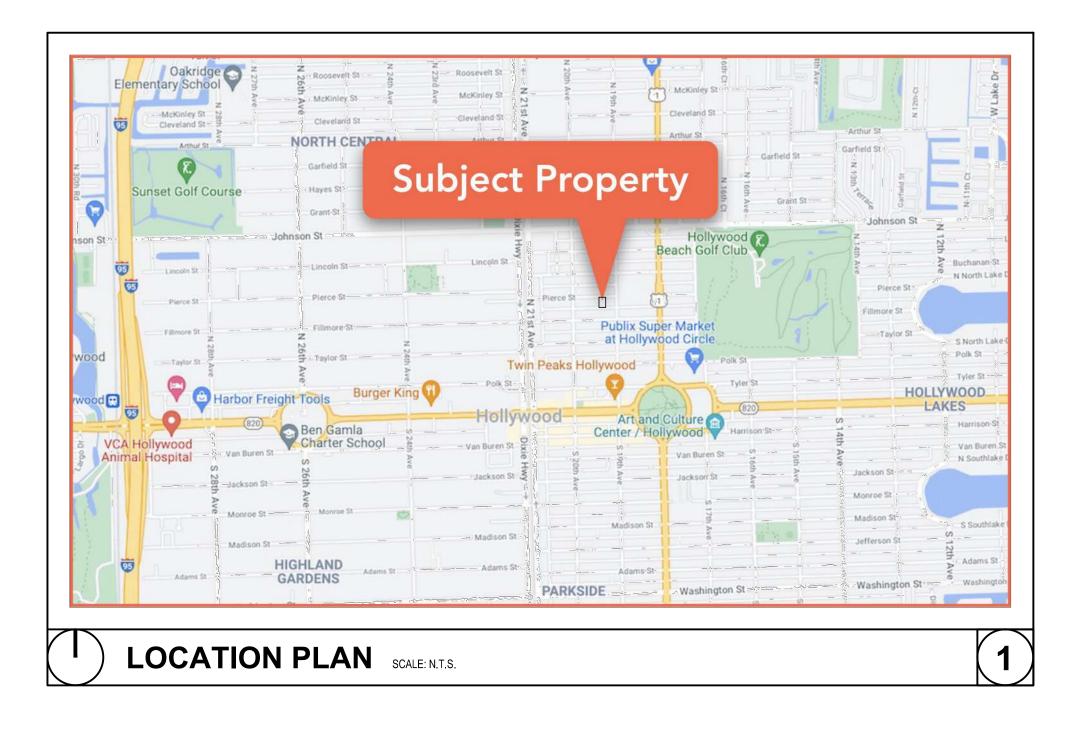



IN ASSOCIATION WITH:

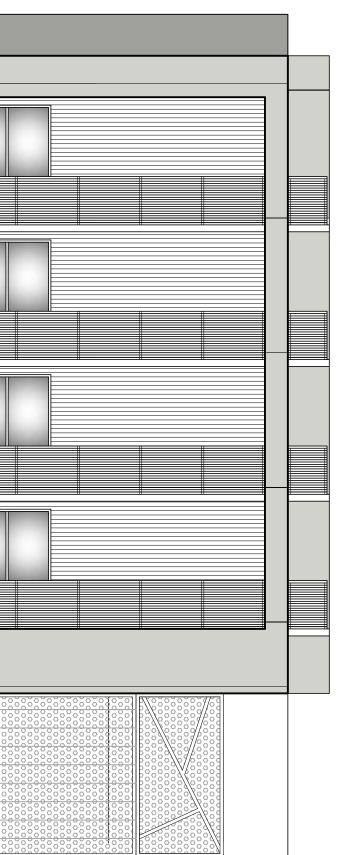




PROFESSIONAL SEAL:

PROJECT:


NEW 32 UNITS DEVELOPMENT AT: DOWNTOWN HOLLYWOOD


1914 - 1920 PIERCE STREET HOLLYWOOD, FL. 33020 DATE ISSUE DESCRIPTION

/1	03.28.23	TAC COMMENTS

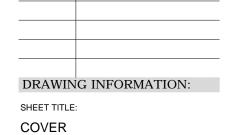

DELIVERY DATE:	03.28.2023
DRAWN BY:	J.B.
CHECKED BY:	A.LL.
REF NUMBER:	

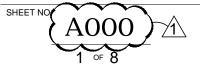

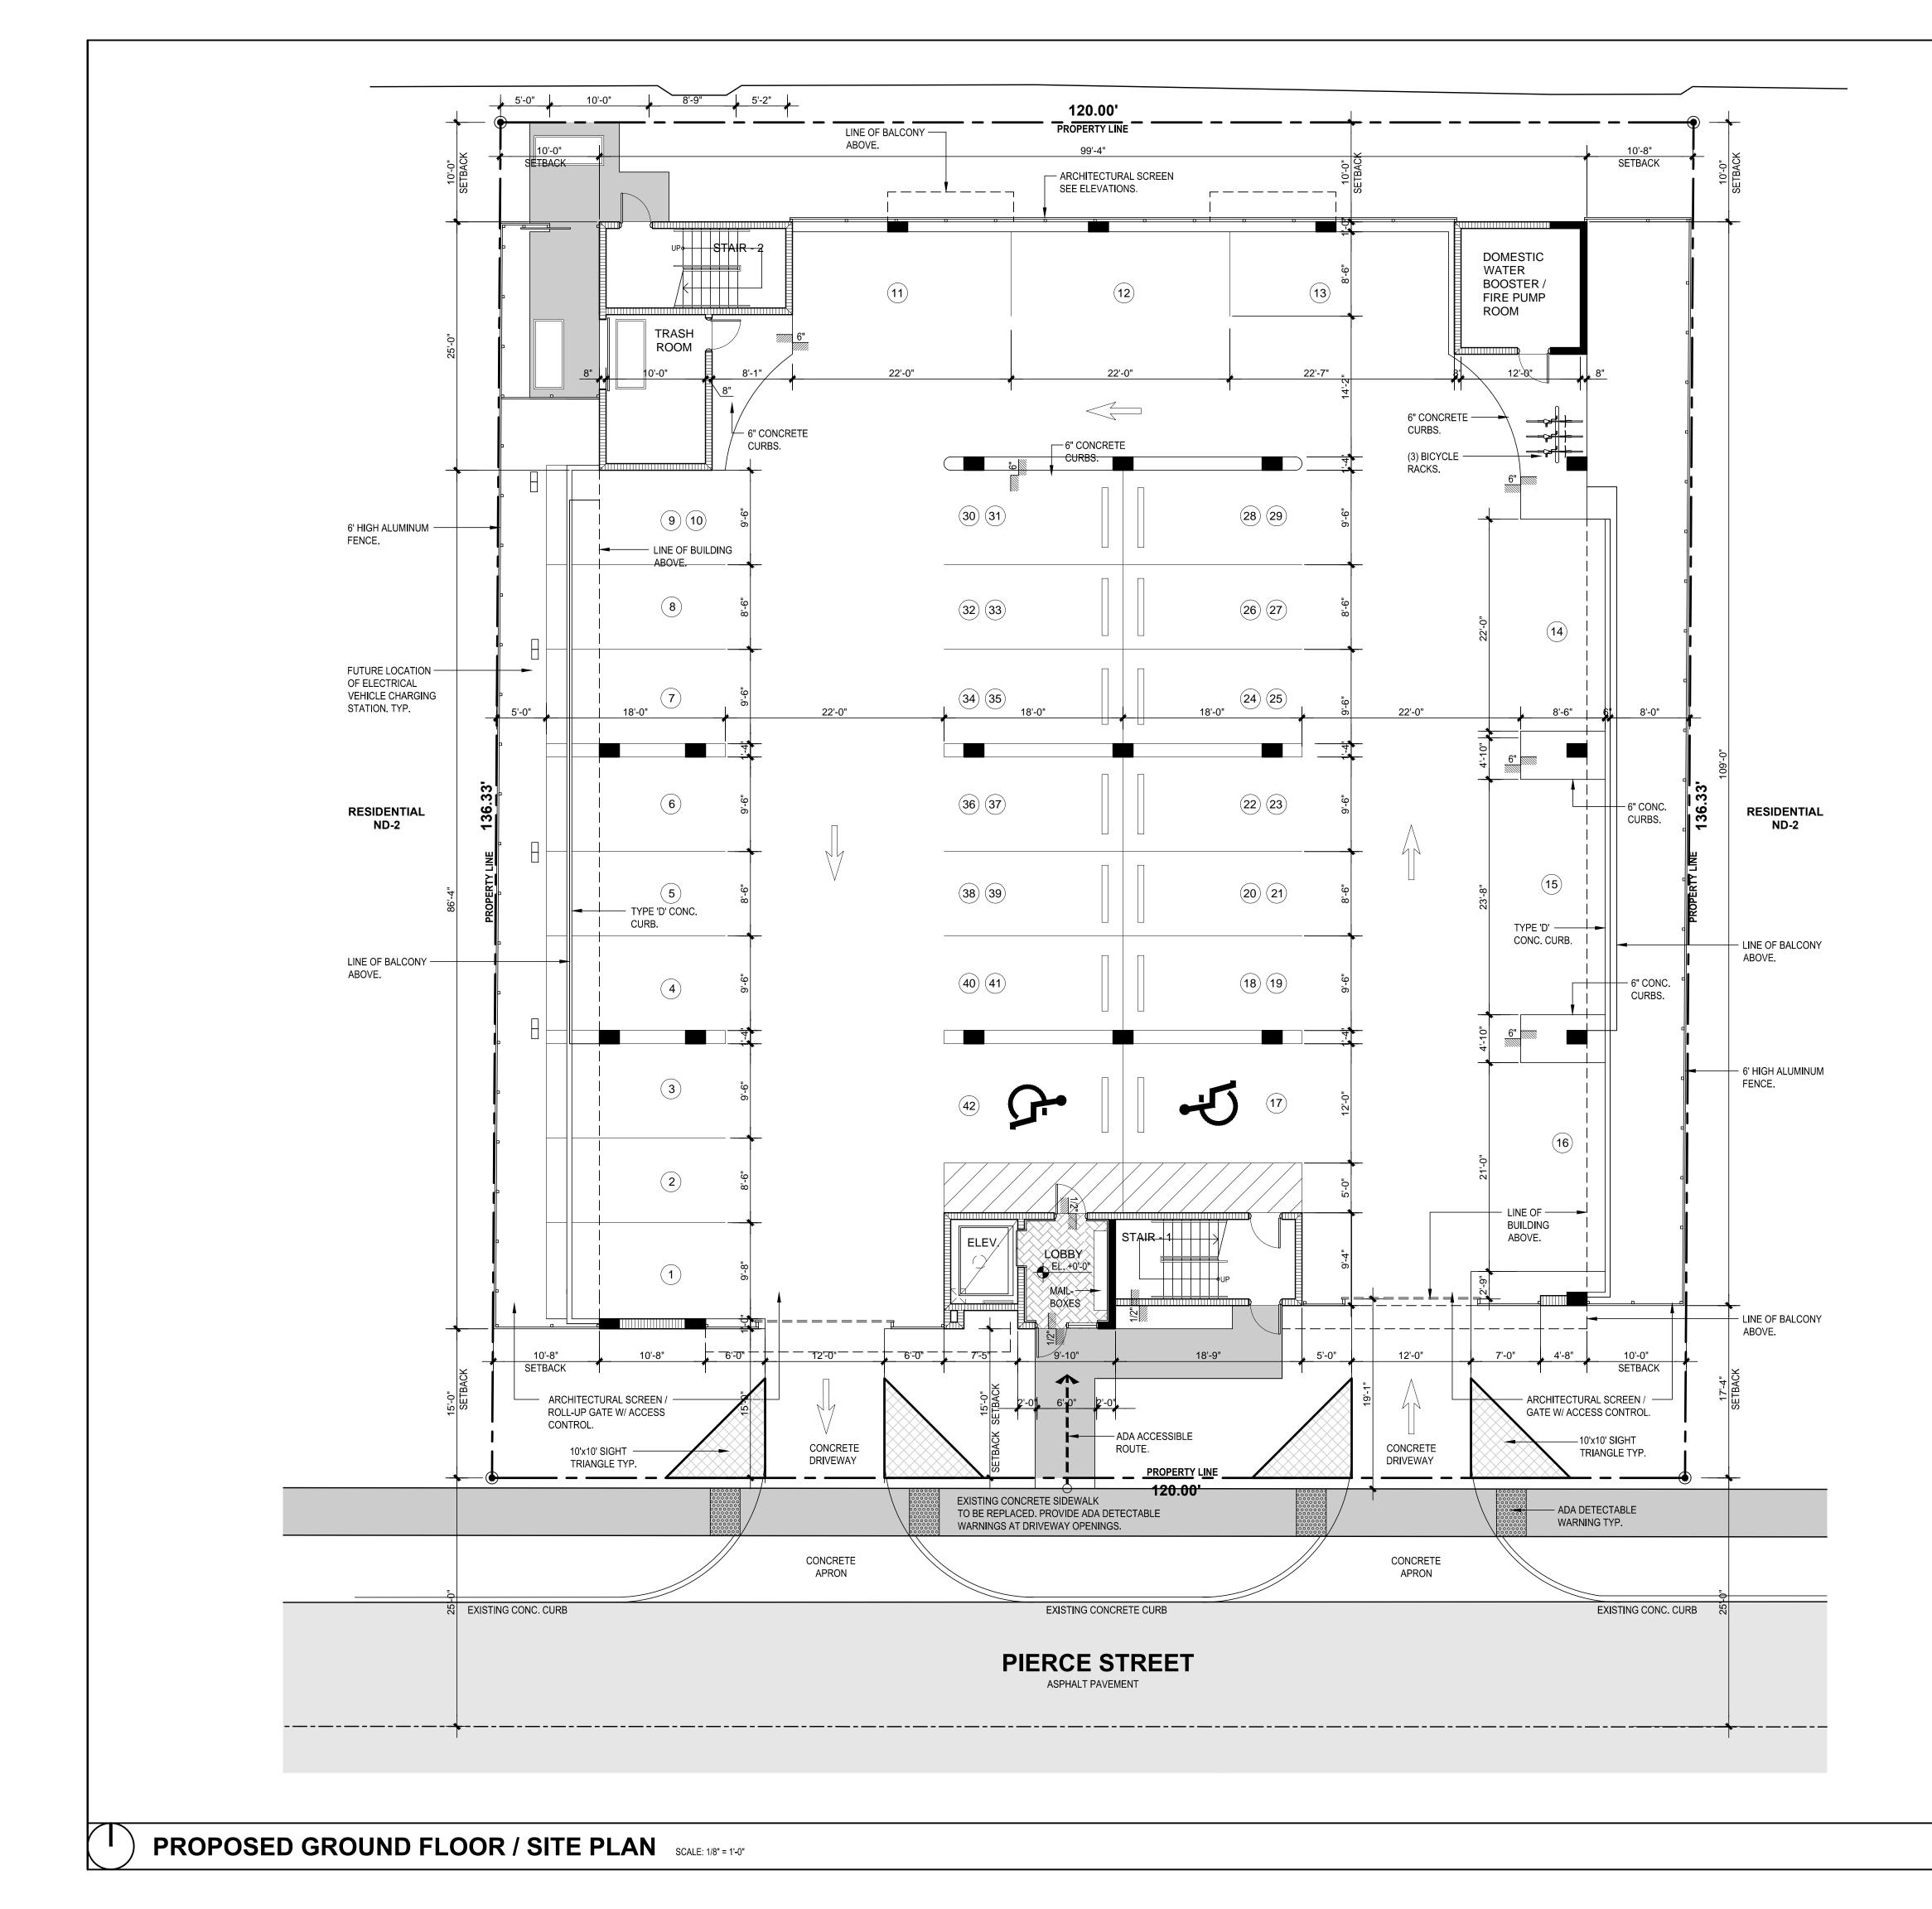



MIAMI, FL. 33175 . (305) 525-2370 AA-26002273

IN ASSOCIATION WITH:

GENERAL ZONING REQUIREMENTS

BUILDING ADDRESS: ADDRESS:	1914-1920 PIERCE STREET HOLLYWOOD, FLORIDA				
BUILDING ZONING: EXISTING ZONING DESIGNATION: ND-2					
LAND AREAS: LAND AREA NET SF. LAND AREA NET ACRES	16,360 SF. 0.3755				
BUILDING FAR: ALLOWED: 2 PROVIDED: 1.99	16,360 X 2 = 32,720 SF. 32,525SF.				
LOT COVERAGE: PROPOSED LOT COVERAGE	: 11,533 SF. / 70.49%				
PAVED AREA: PROPOSED PAVED AREA	688 SF. / 4.20%				
LANDSCAPE AREAS: PROPOSED LANDSCAPED AREA 4,136 SF. / 25.31%					
SETBACKS: FRONT REQUIRED: 15'-0 REAR REQUIRED: 10'-0 SIDES REQUIRED: 10'-0	" PROVIDED: 10'-0"				
BUILDING HEIGHT LIMITATIONS: ALLOWED 5 STORIES 55'-0" PROVIDED 5 STORIES 55'-0" ROOF TOP AMENITIES PERMITTED TO EXCEED 15'-0" = 70'-0" POOL DECK PROVIDED 65'-0" TOP OF STAIR / ELEVATOR PROVIDED 69'-6"					
PARKING REQUIREMENTS FOR 32 APARTMENTSREQUIRED 1 PER 1 BEDROOM(20) 1 BEDROOM = 20 SPACESREQUIRED 1.5 PER 2 BEDROOMS(12) 2 BEDROOMS = 18 SPACESREQUIRED FOR GUEST 1 PER 10 = 4(4) SPACES REQUIRED					

TOTAL PARKING SPACES REQUIRED 42 SPACES TOTAL PARKING SPACES PROVIDED 42 SPACES

ADA PARKING REQUIRED (2 SPACES) ADA PARKING **PROVIDED** (2 SPACES)

NOTE

1. ANY CHANGES TO DESIGN, INCLUDING MATERIAL CHANGES, MAY REQUIRE PLANNING AND DEVELOPMENT BOARD APPROVAL PRIOR TO CONSTRUCTION.

2. PROVIDE 0.5 FOOT CANDLE LIGHTING.

3. BUILDING SHALL COMPLY WITH THE REQUIREMENT OF NFPA1 (2018 ED.) SECTION 12.3.2

GREEN BUILDING CERTIFICATION TO BE ACHIEVED.

- ELECTRIC VEHICLE PROVISIONS (INFRASTURE ONLY). 1.
- HVAC 18 SEER OR HIGHER.
- PROGRAMMABLE THERMOSTATS OCCUPANCY / VACANCY SENSORS (NOT SURE IF THIS ONE CAN 4.
- BE USED ONLY IN COMMON AREAS). MERV AIR FILTERS AT LEAST 8
- ALL ENERGY-EFFICIENT OUTDOOR LIGHTING.
- DUAL FLUSH TOILETS (1/1.6 FLUSH) ENERGY STAR APPROVED ROOFING MATERIALS.
- 8. ENERGY EFFICIENT (LOW-E) WINDOWS. 9.
- 10. ENERGY EFFICIENT DOORS.



PROFESSIONAL SEAL:



Alberto Llorente AR-0012031

PROJECT:

NEW 32 UNITS DEVELOPMENT AT: DOWNTOWN HOLLYWOOD

1914 - 1920 PIERCE STREET HOLLYWOOD, FL. 33020


DATE ISSUE DESCRIPTION 03.28.23 TAC COMMENTS

DRAWIN	G INFORMATION:	
SHEET TITLE:		

PROPOSED GROUND FLOOR / SITE PLAN.

DELIVERY DATE:	03.28.2023
DRAWN BY:	J.B.
CHECKED BY:	A.LL.
REF NUMBER:	




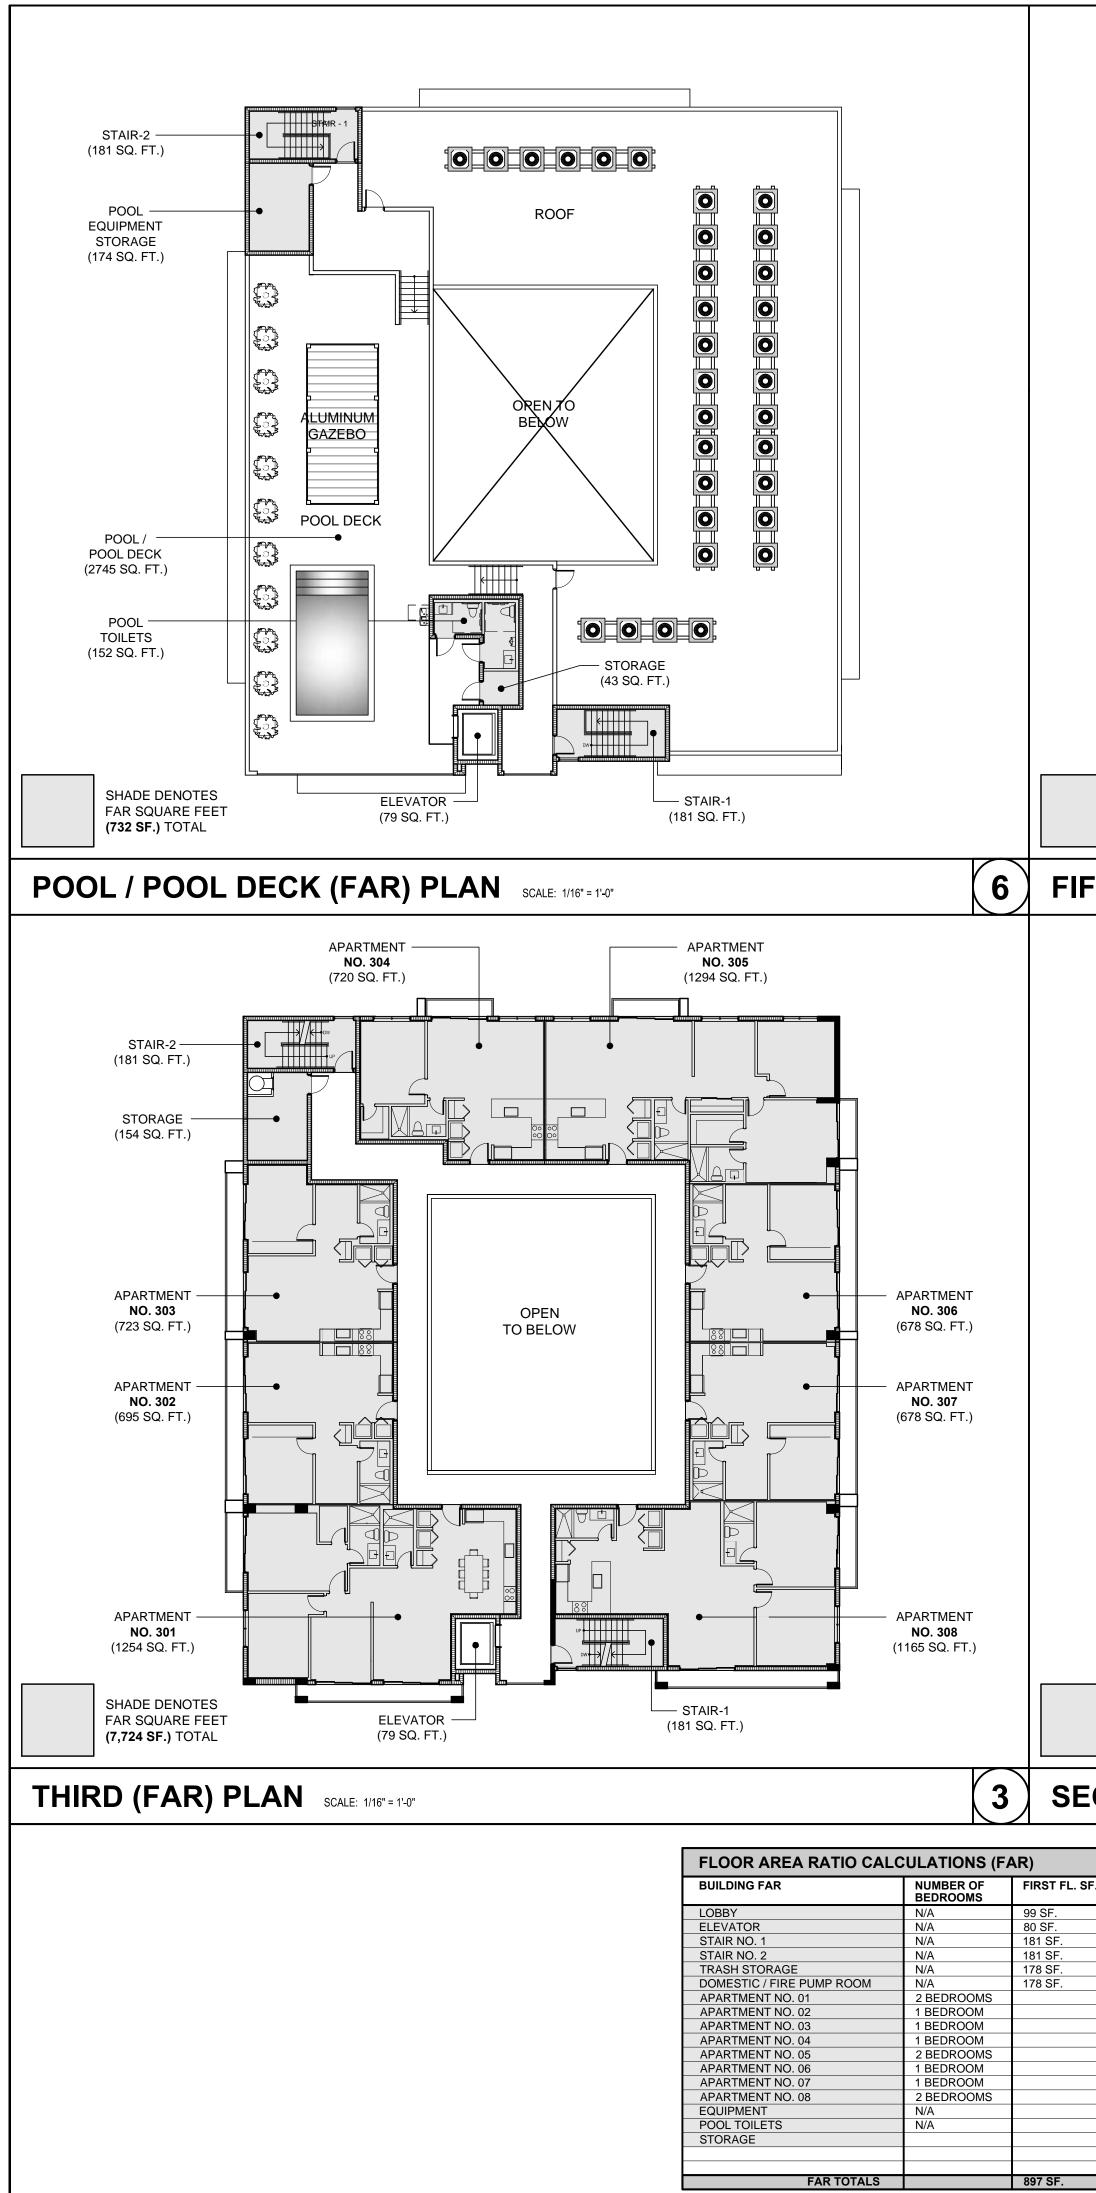


	APARTMENT NO. 504 (720 SQ. FT.)		APART NO. (1294 St	505			
STAIR-2						STA (181 S	IR-2
STORAGE (154 SQ. FT.)						STOF (154 S	RAGE
APARTMENT					 APARTMENT NO. 506 (678 SQ. FT.) APARTMENT NO. 507 (678 SQ. FT.) 	(723 S APAR	403 Q. FT.)
APARTMENT					—— APARTMENT NO. 508 (1165 SQ. FT.)	APAR NO . (1254 S	401
SHADE DENOTES FAR SQUARE FEET (7,724 SF.) TOTAL		/ATOR Q. FT.)	STAIR-1 (181 SQ. F			FAR SC	DENOTES UARE FEET SF.) TOTAL
FTH (FAR) P	PLAN SCALE: 1/16" = 1'-0	n			5	FOURTH	I (FAR)
STAIR-2 (181 SQ. FT.) STORAGE (154 SQ. FT.) APARTMENT NO. 203 (723 SQ. FT.) APARTMENT NO. 202	NO. 204 (720 SQ. FT.)			SQ. FT.)	APARTMENT NO. 206 (678 SQ. FT.) APARTMENT NO. 207	STAIR-2 (181 SQ. F TRASH STORAG (178 SQ. F	T.)
(695 SQ. FT.) APARTMENT NO. 201 (1254 SQ. FT.) SHADE DENOTES FAR SQUARE FEET (7,7724 SF.) TOTAL		/16" = 1'-0"	STAIR-1 (181 SQ. F		(678 SQ. FT.) —— APARTMENT NO. 208 (1165 SQ. FT.)	FAR SC (897 SF	DENOTES UARE FEET .) TOTAL
		, i v – I – v			OPEN AREAS		· · · · / · ►
80 SF. 80 181 SF. 18 181 SF. 18	HIRD FL. SF. FOURTH FL. S 0 SF. 80 SF. 31 SF. 181 SF. 31 SF. 181 SF. 34 SF. 184 SF. 54 SF. 154 SF.	F. FIFTH FL. SF. ROC 80 SF. 80 S 181 SF. 181 S 181 SF. 181 S 154 SF. 181 S	SF. 1,086 SI	F	BUILDING FAR SECOND FLOOR OPEN TERRA OPEN WALKWAY APARTMENT NO. 01 BALCONY APARTMENT NO. 02 BALCONY APARTMENT NO. 03 BALCONY		FIRST FL. SF.


7,803 SF.	7,803 SF.	7,803 SF.	7,803 SF.	811 SF.	32,920 SF.
				43 SF.	
				152 SF.	
				174 SF.	
1,165 SF.	1,165 SF.	1,165 SF.	1,165 SF.		4,660 SF.
678 SF.	678 SF.	678 SF.	678 SF.		2,712 SF.
678 SF.	678 SF.	678 SF.	678 SF.		2,712 SF.
1,294 SF.	1,294 SF.	1,294 SF.	1,294 SF.		5,176 SF.
720 SF.	720 SF.	720 SF.	720 SF.		2,880 SF.
723 SF.	723 SF.	723 SF.	723 SF.		2,892 SF.
695 SF.	695 SF.	695 SF.	695 SF.		2,780 SF.
1,254 SF.	1,254 SF.	1,254 SF.	1,254 SF.		5,016 SF.
					178 SF.
154 SF.	154 SF.	154 SF.	154 SF.		794 SF.
181 SF.	181 SF.	181 SF.	181 SF.	181 SF.	1,086 SF.
181 SF.	181 SF.	181 SF.	181 SF.	181 SF.	1,086 SF.
80 SF.	80 SF.	80 SF.	80 SF.	80 SF.	480 SF.
					99 SF.

OPEN AREAS	
BUILDING FAR	FIRST FL. SF.
SECOND FLOOR OPEN TERRACE AND WALKWAYS	
OPEN WALKWAY	
APARTMENT NO. 01 BALCONY	
APARTMENT NO. 02 BALCONY	
APARTMENT NO. 03 BALCONY	
APARTMENT NO. 04 BALCONY	
APARTMENT NO. 05 BALCONY	
APARTMENT NO. 06 BALCONY	
APARTMENT NO. 07 BALCONY	
APARTMENT NO. 08 BALCONY	
POOL AND POOL DECK	
OPEN AREAS TOTALS	
BUILDING FAR AND OPEN AREAS	
FAR TOTALS	897 SF.
OPEN AREAS TOTALS	
TOTAL	897 SF.

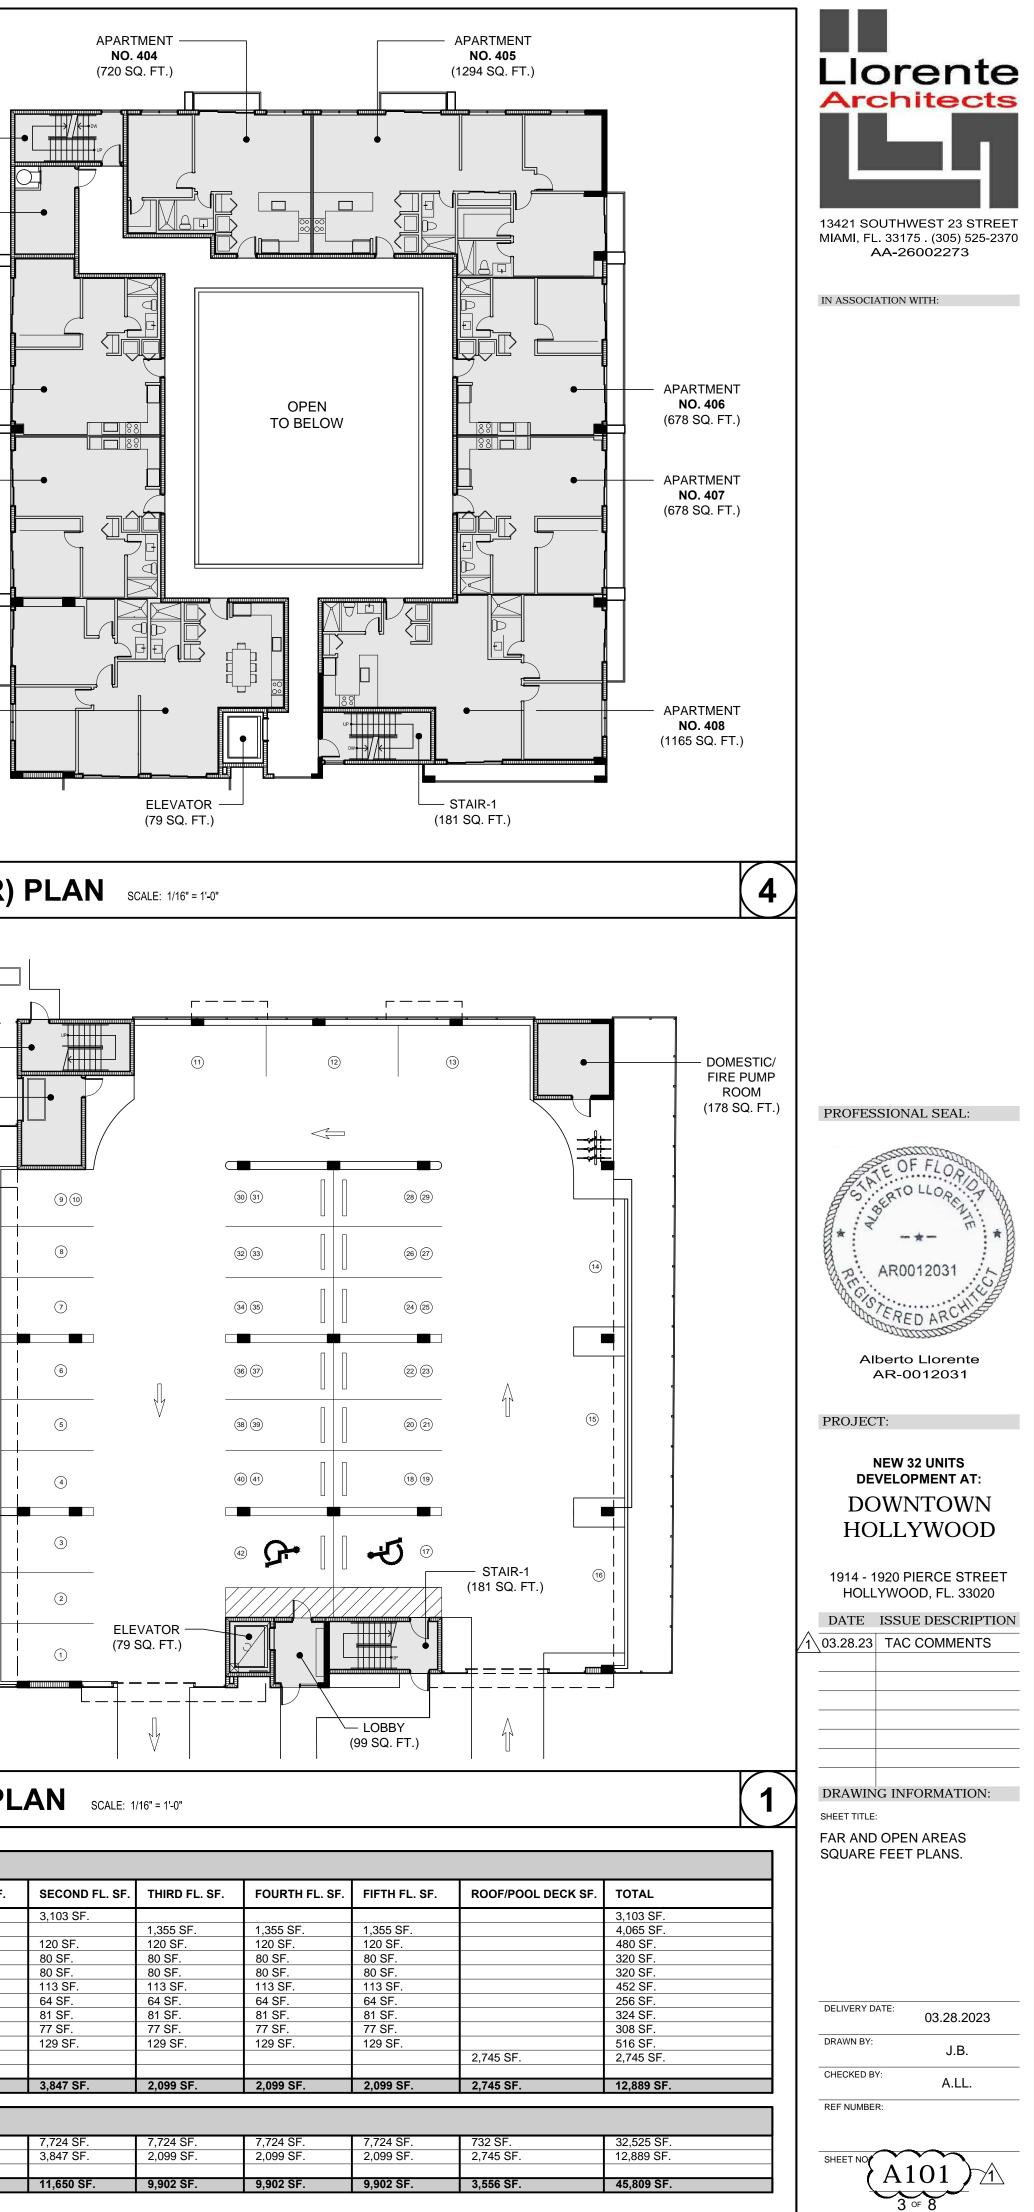

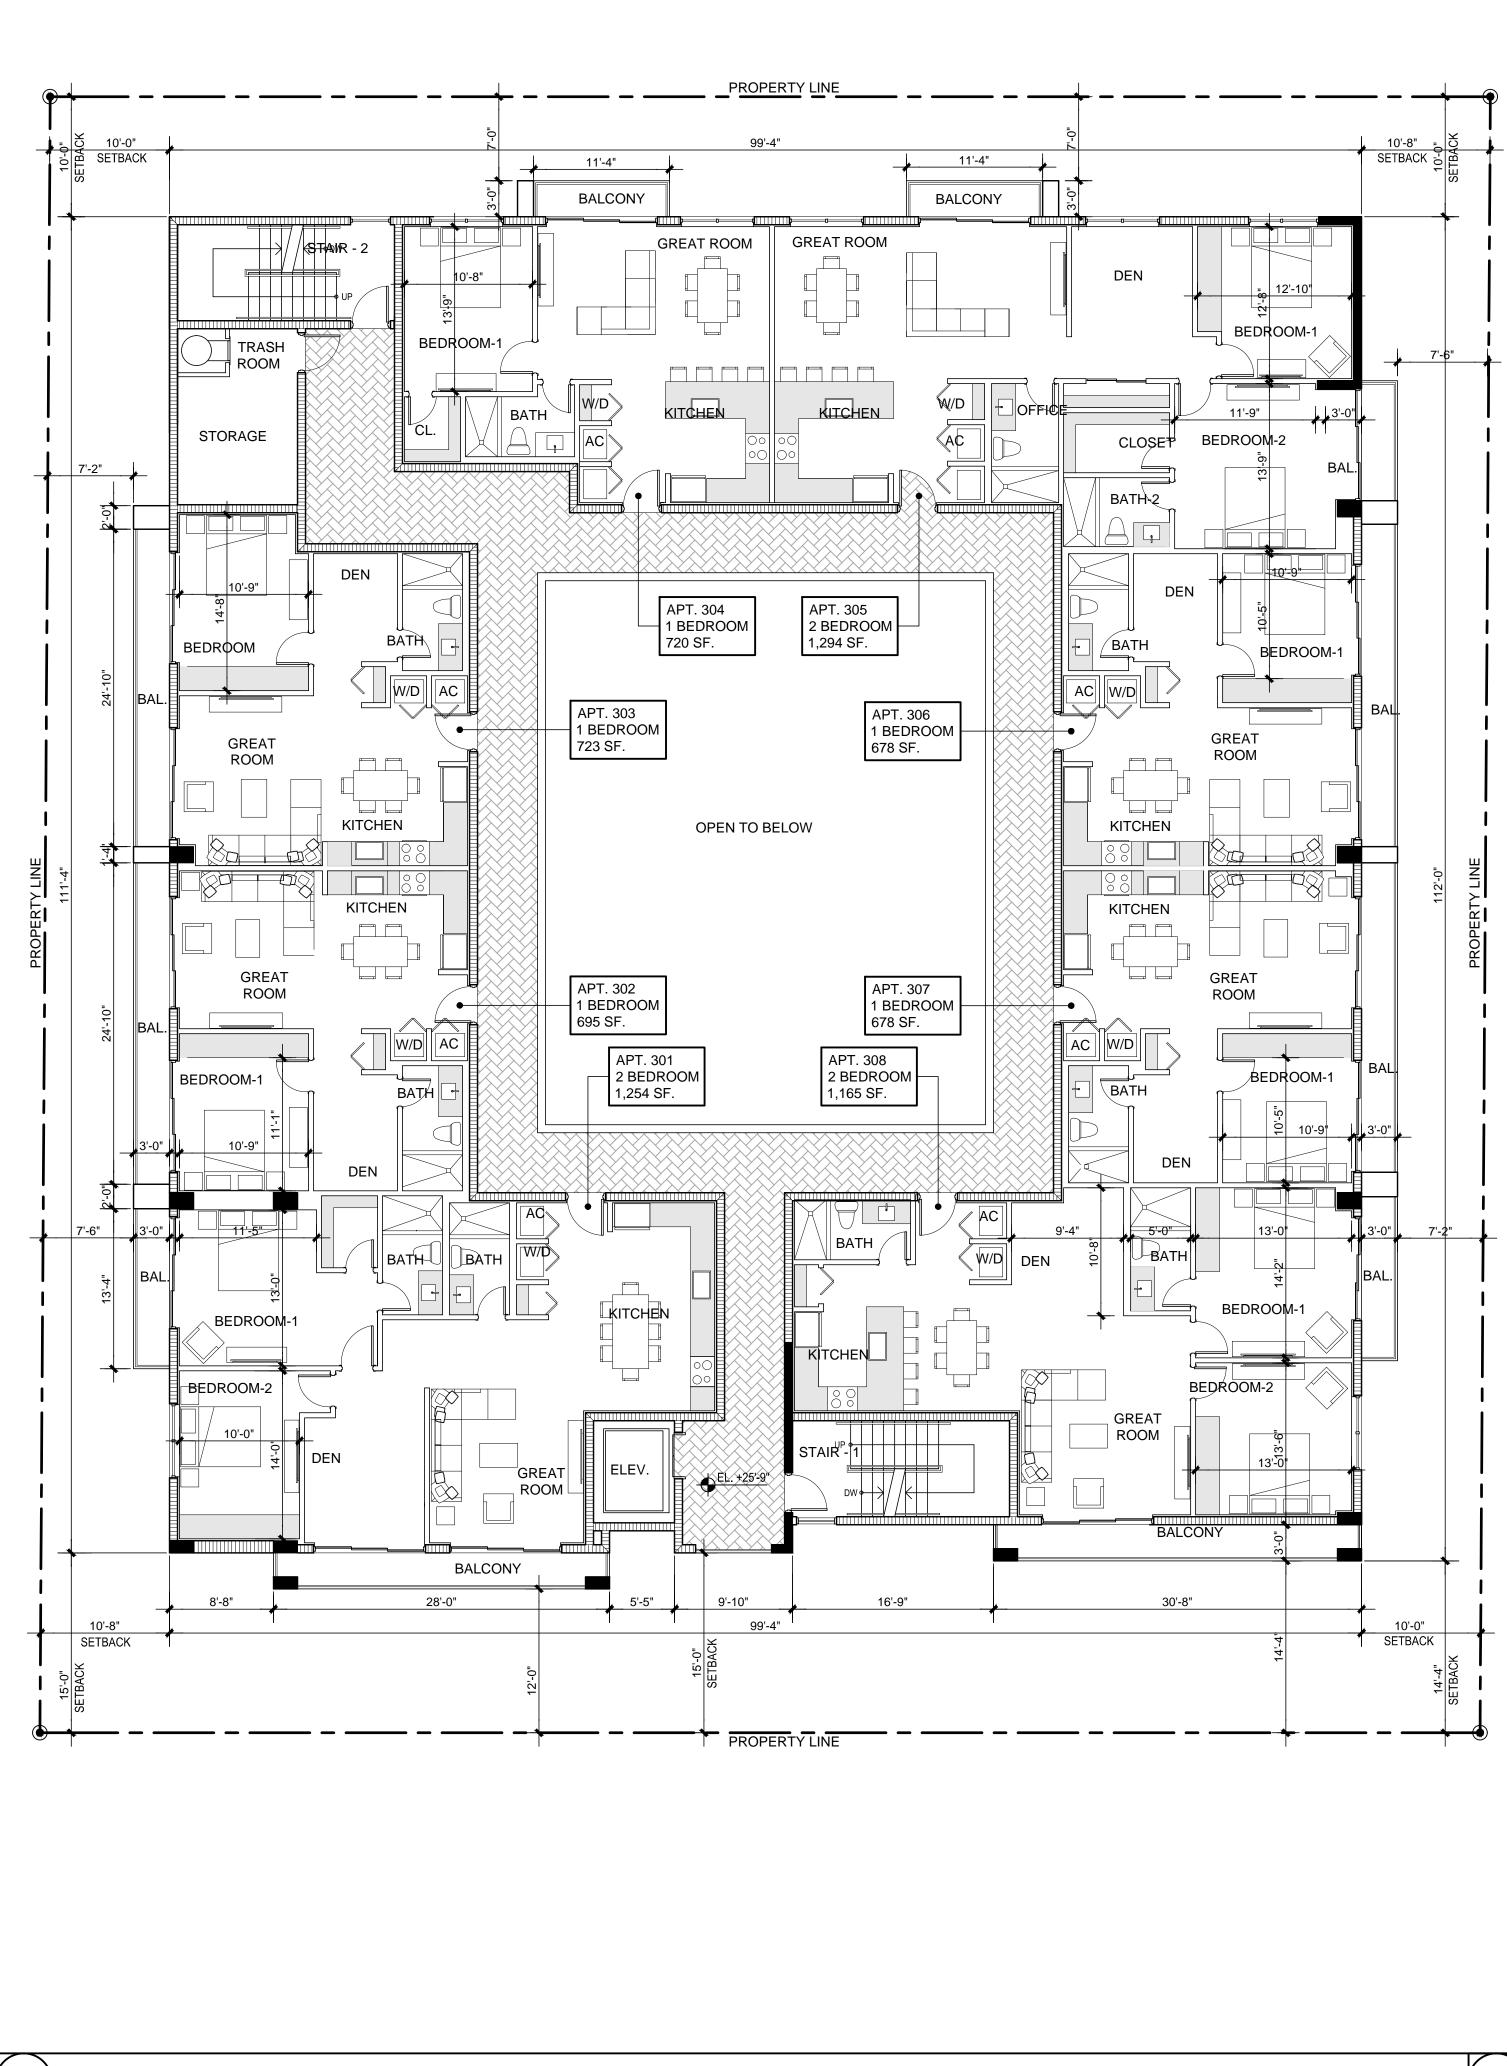


) PROPOSED THIRD FLOOR PLAN SCALE: 1/8" = 1'-0"

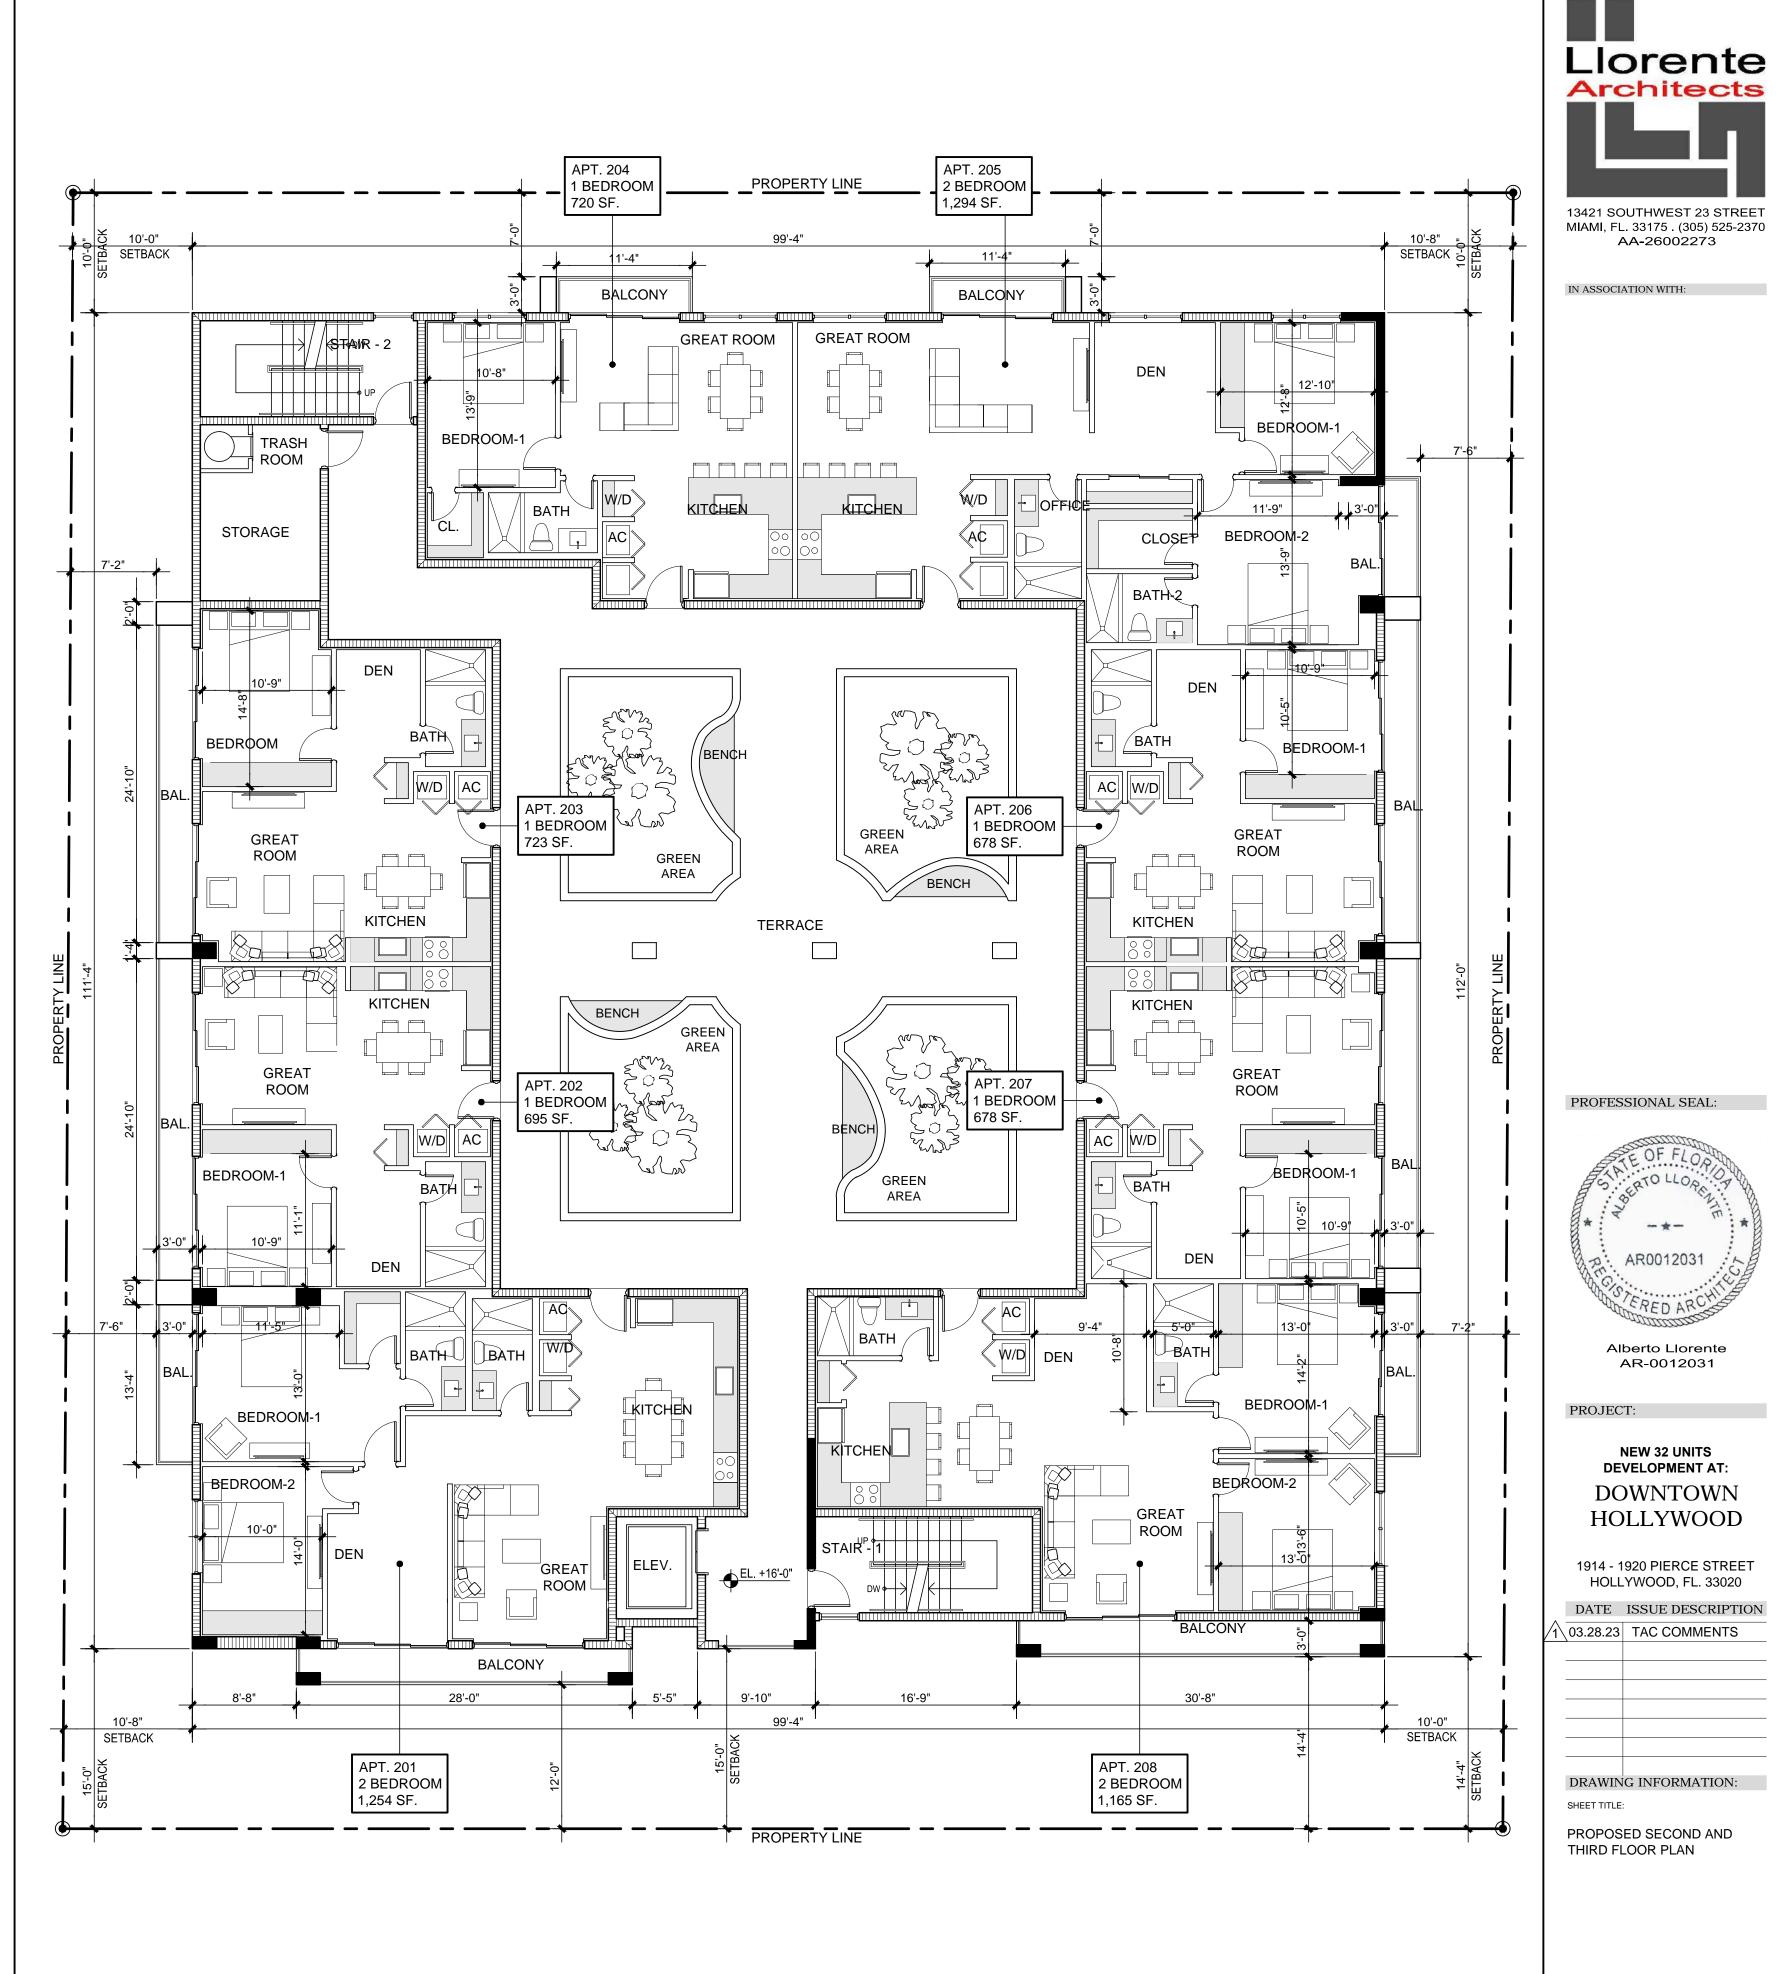


DELIVERY DATE:	03.28.2023
DRAWN BY:	J.B.
CHECKED BY:	A.LL.
REF NUMBER:	

1 SHEET NO

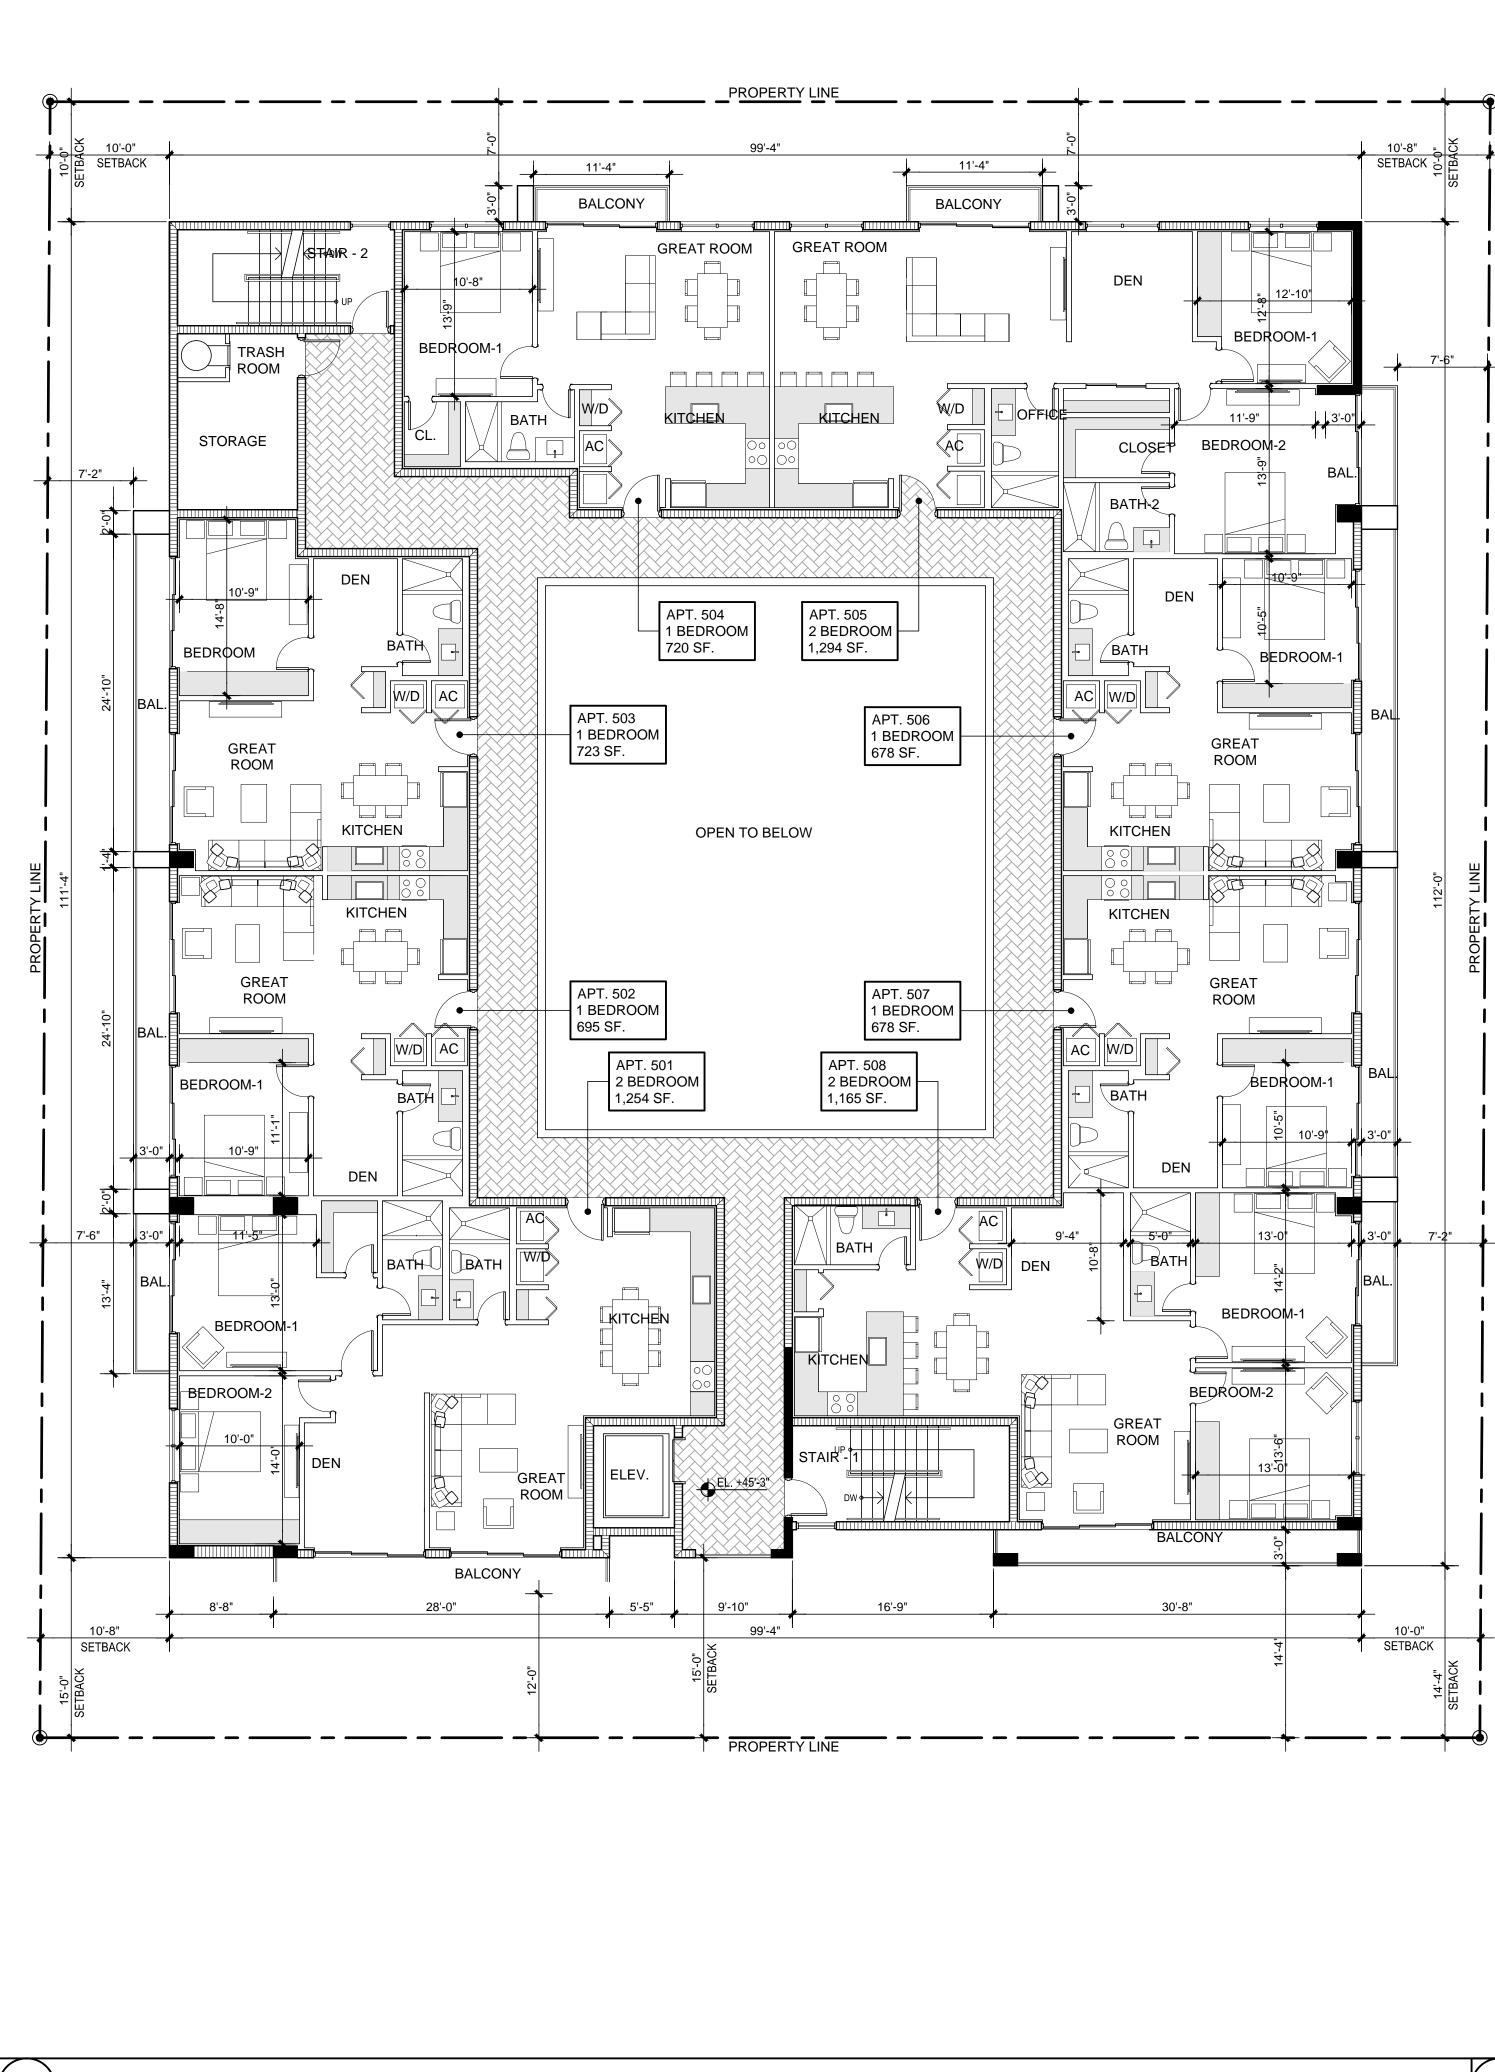

PROPOSED FIFTH FLOOR PLAN SCALE: 1/8" = 1'-0"

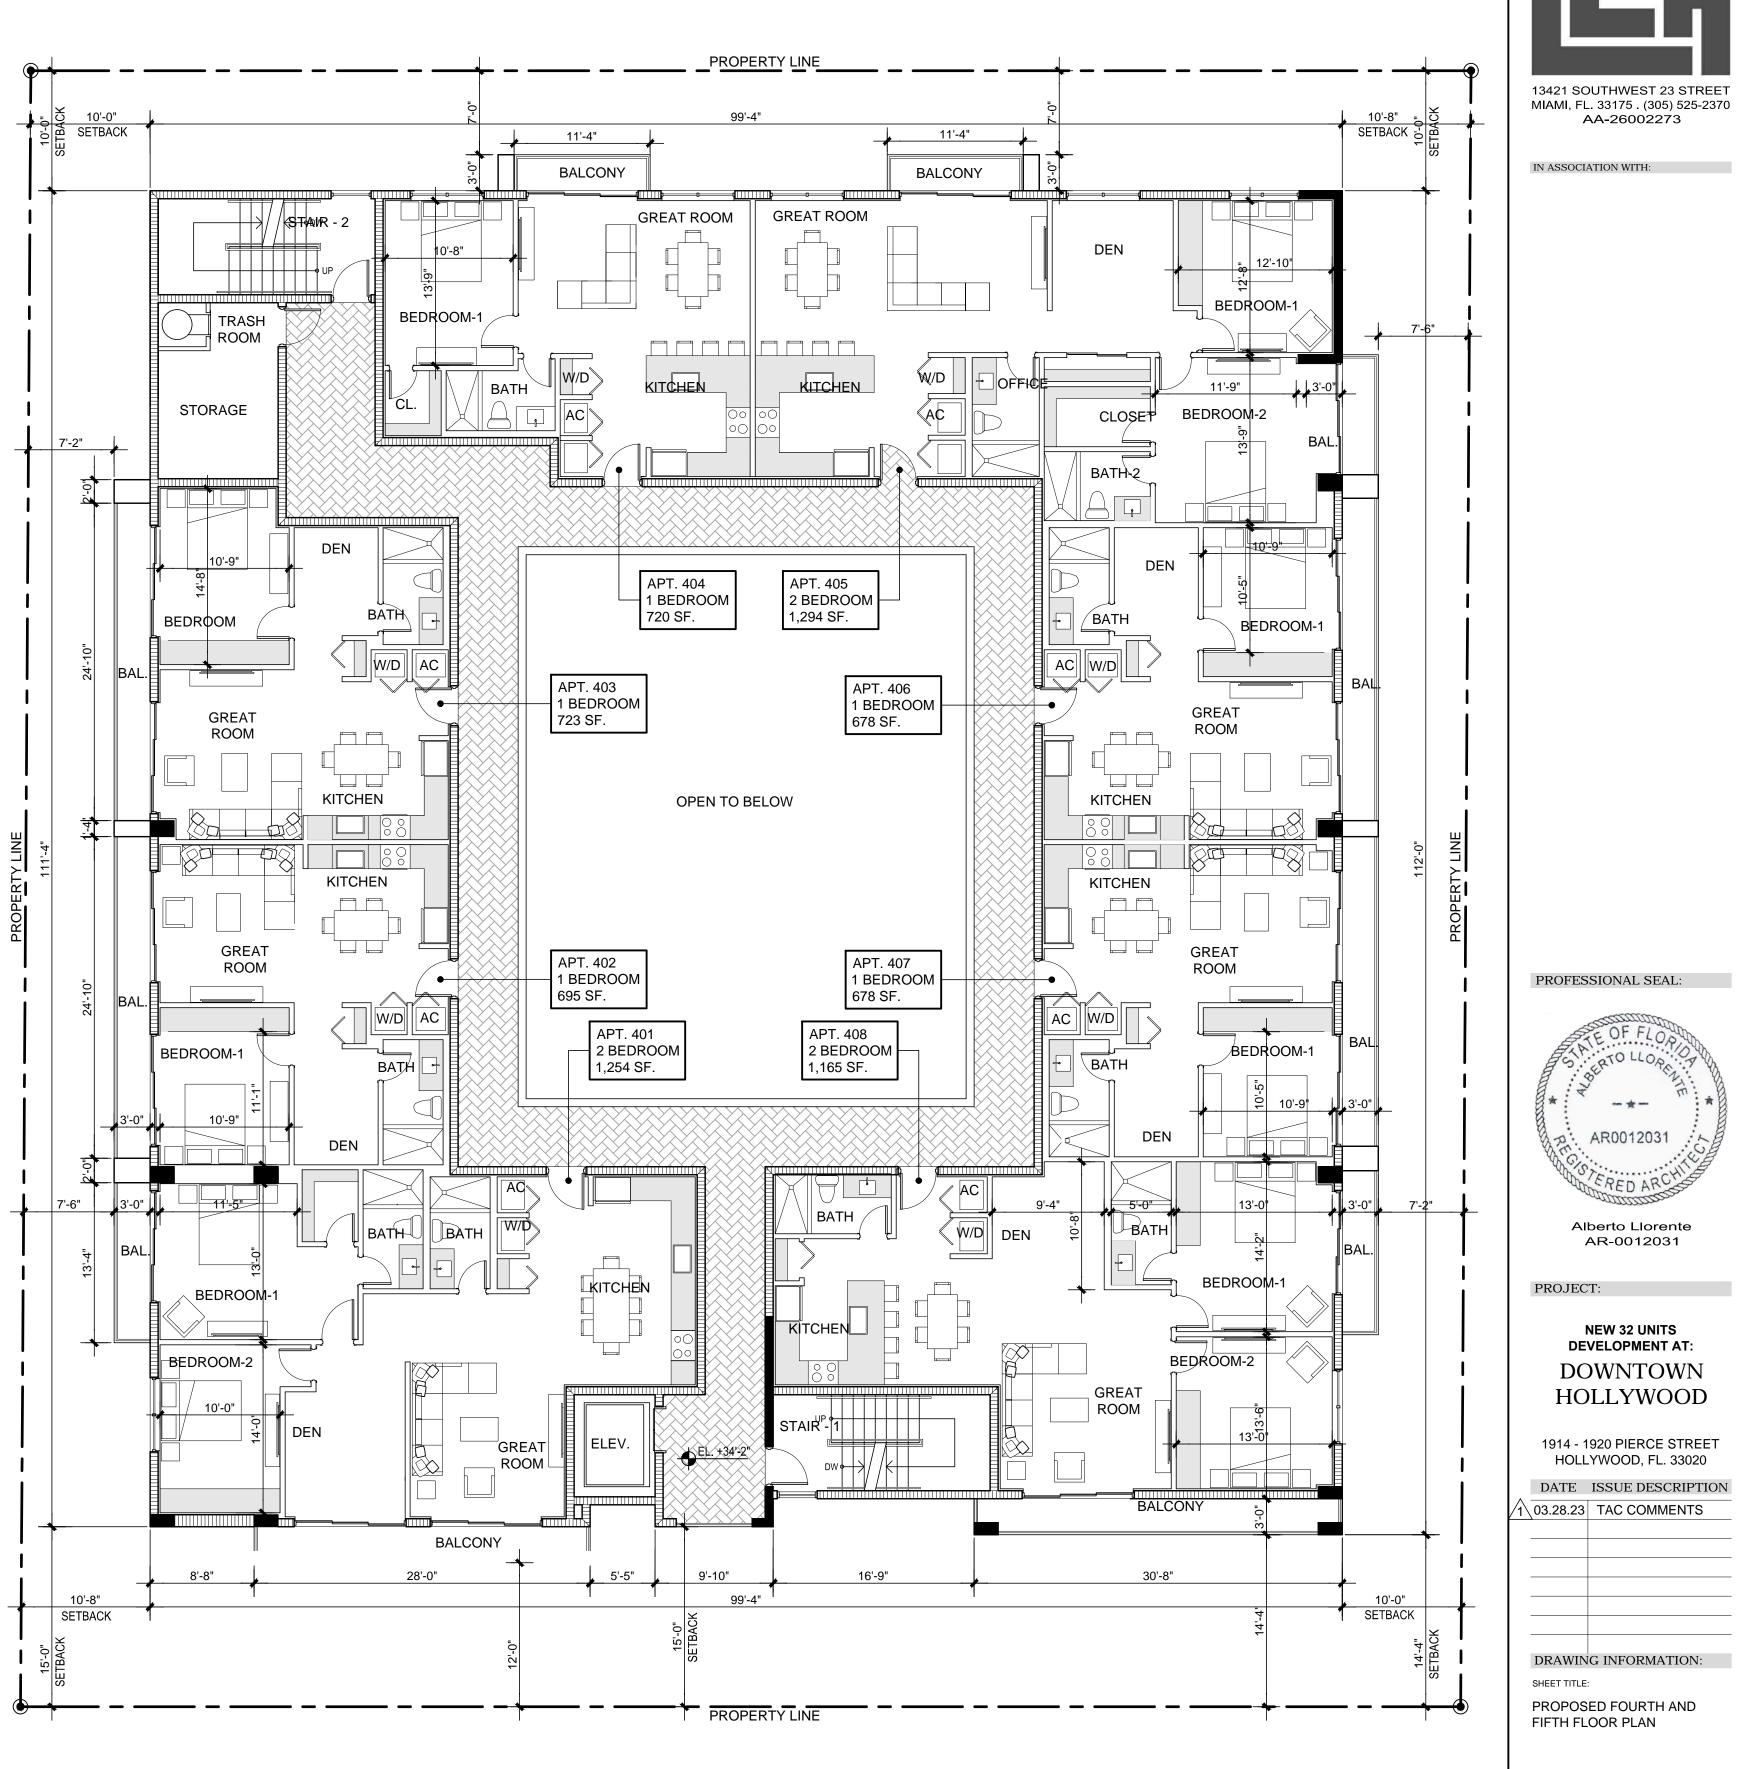

PROPOSED FOURTH FLOOR PLAN SCALE: 1/8" = 1-0"

(2 ∬


Llorente

Architects


DELIVERY DATE:	03.28.2023
DRAWN BY:	J.B.
CHECKED BY:	A.LL.
REF NUMBER:	

°(A103) 1


SHEET NO **1**

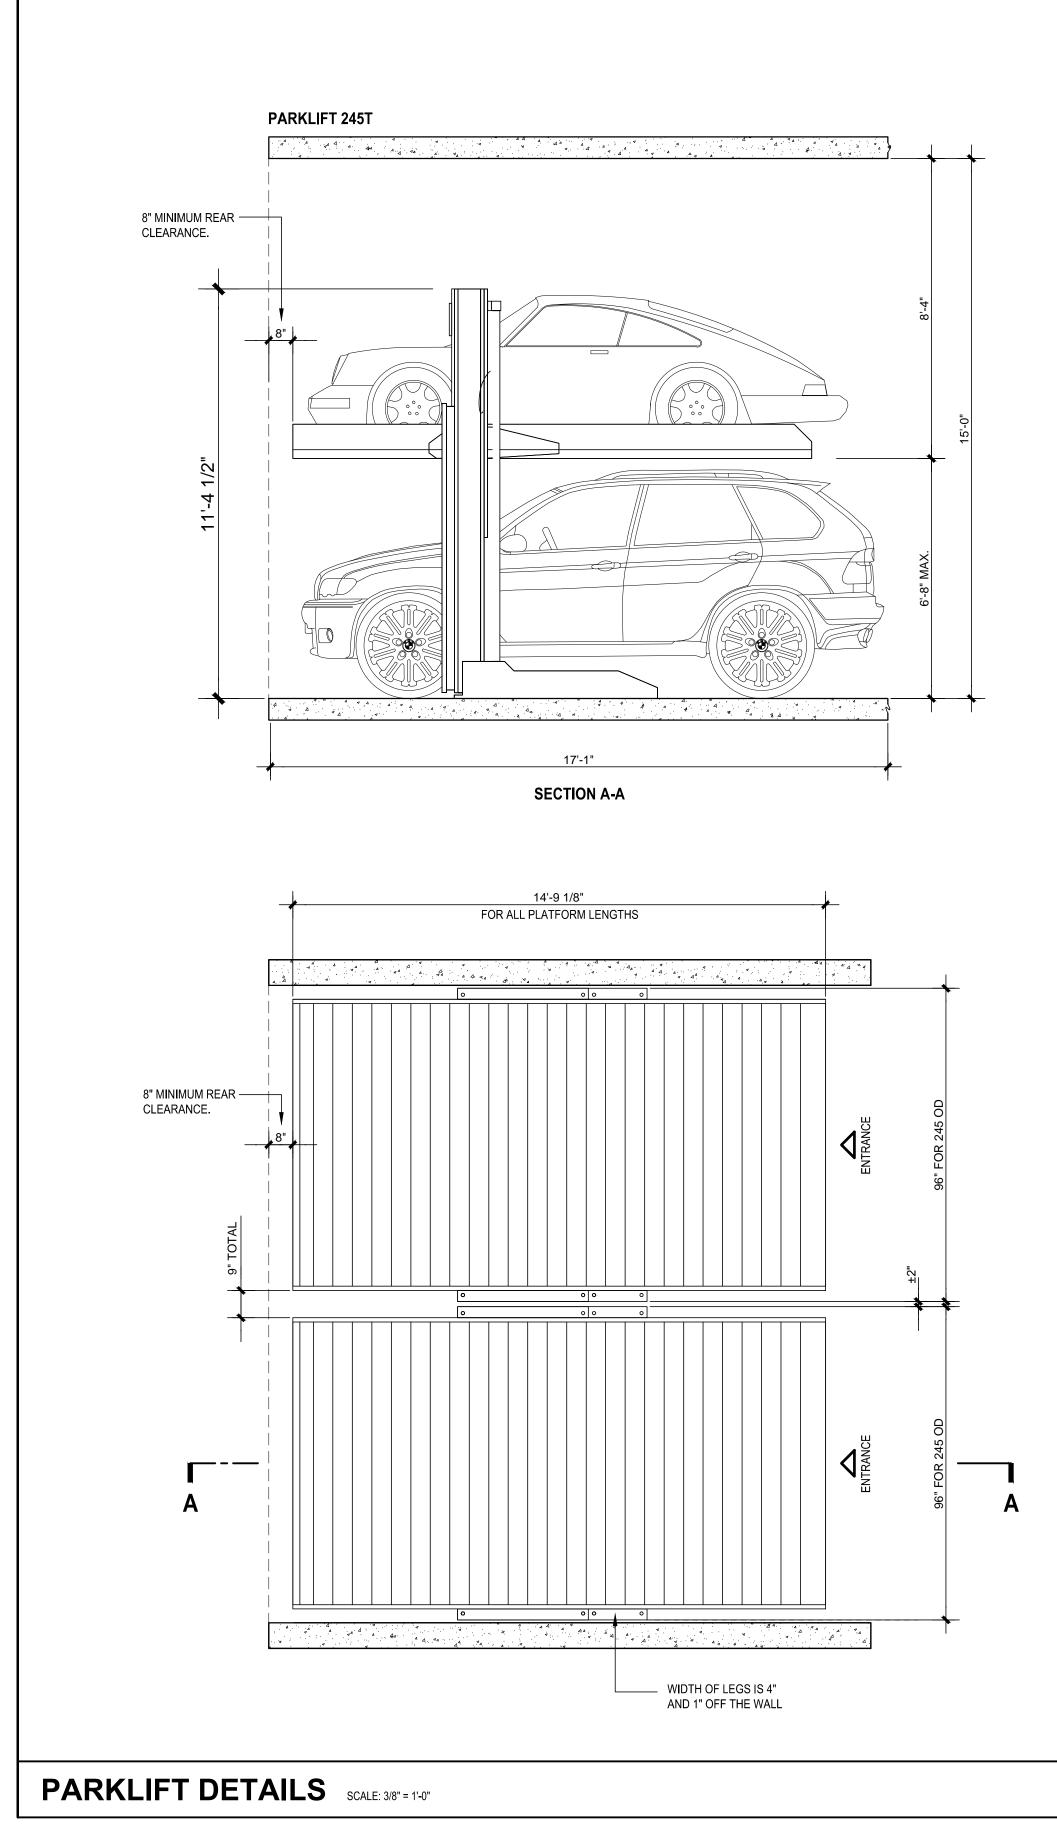

ARKLIFT 245T SPECIFICATIONS					
APABILITIES					
VORKING CAPACITY TATIC CAPACITY YNAMIC CAPACITY	6,000 LBS 12,000 LBS 9,000 LBS				
IMENSIONS					
OVERALL WIDTH LATFORM WIDTH OVERALL PLATFORM LENGTH MAXIMUM VEHICLE WHEELBASE MAXIMUM CLEARANCE (LOWER CAR) OVERALL HEIGHT	96 7/16" 82 1/16" 88" 177 1/8" 146" 80" 11'-5"				
PEED					
IFTING SPEED (SECONDS) OWERING SPEED (SECONDS)	17 SECONDS 15 SECONDS				
OWER					
OWER REQUIREMENTS 20V SINGLE PHASE 40 AMP	220V 3 PHASE 40 AMP				
EATURES					
PPLICATION URFACE IATERIAL AFETY	OUTDOOR / INDOOR ASPHALT / CONCRETE 100% GALVANIZED STEEL STEEL-ON-STEEL LOCKS				

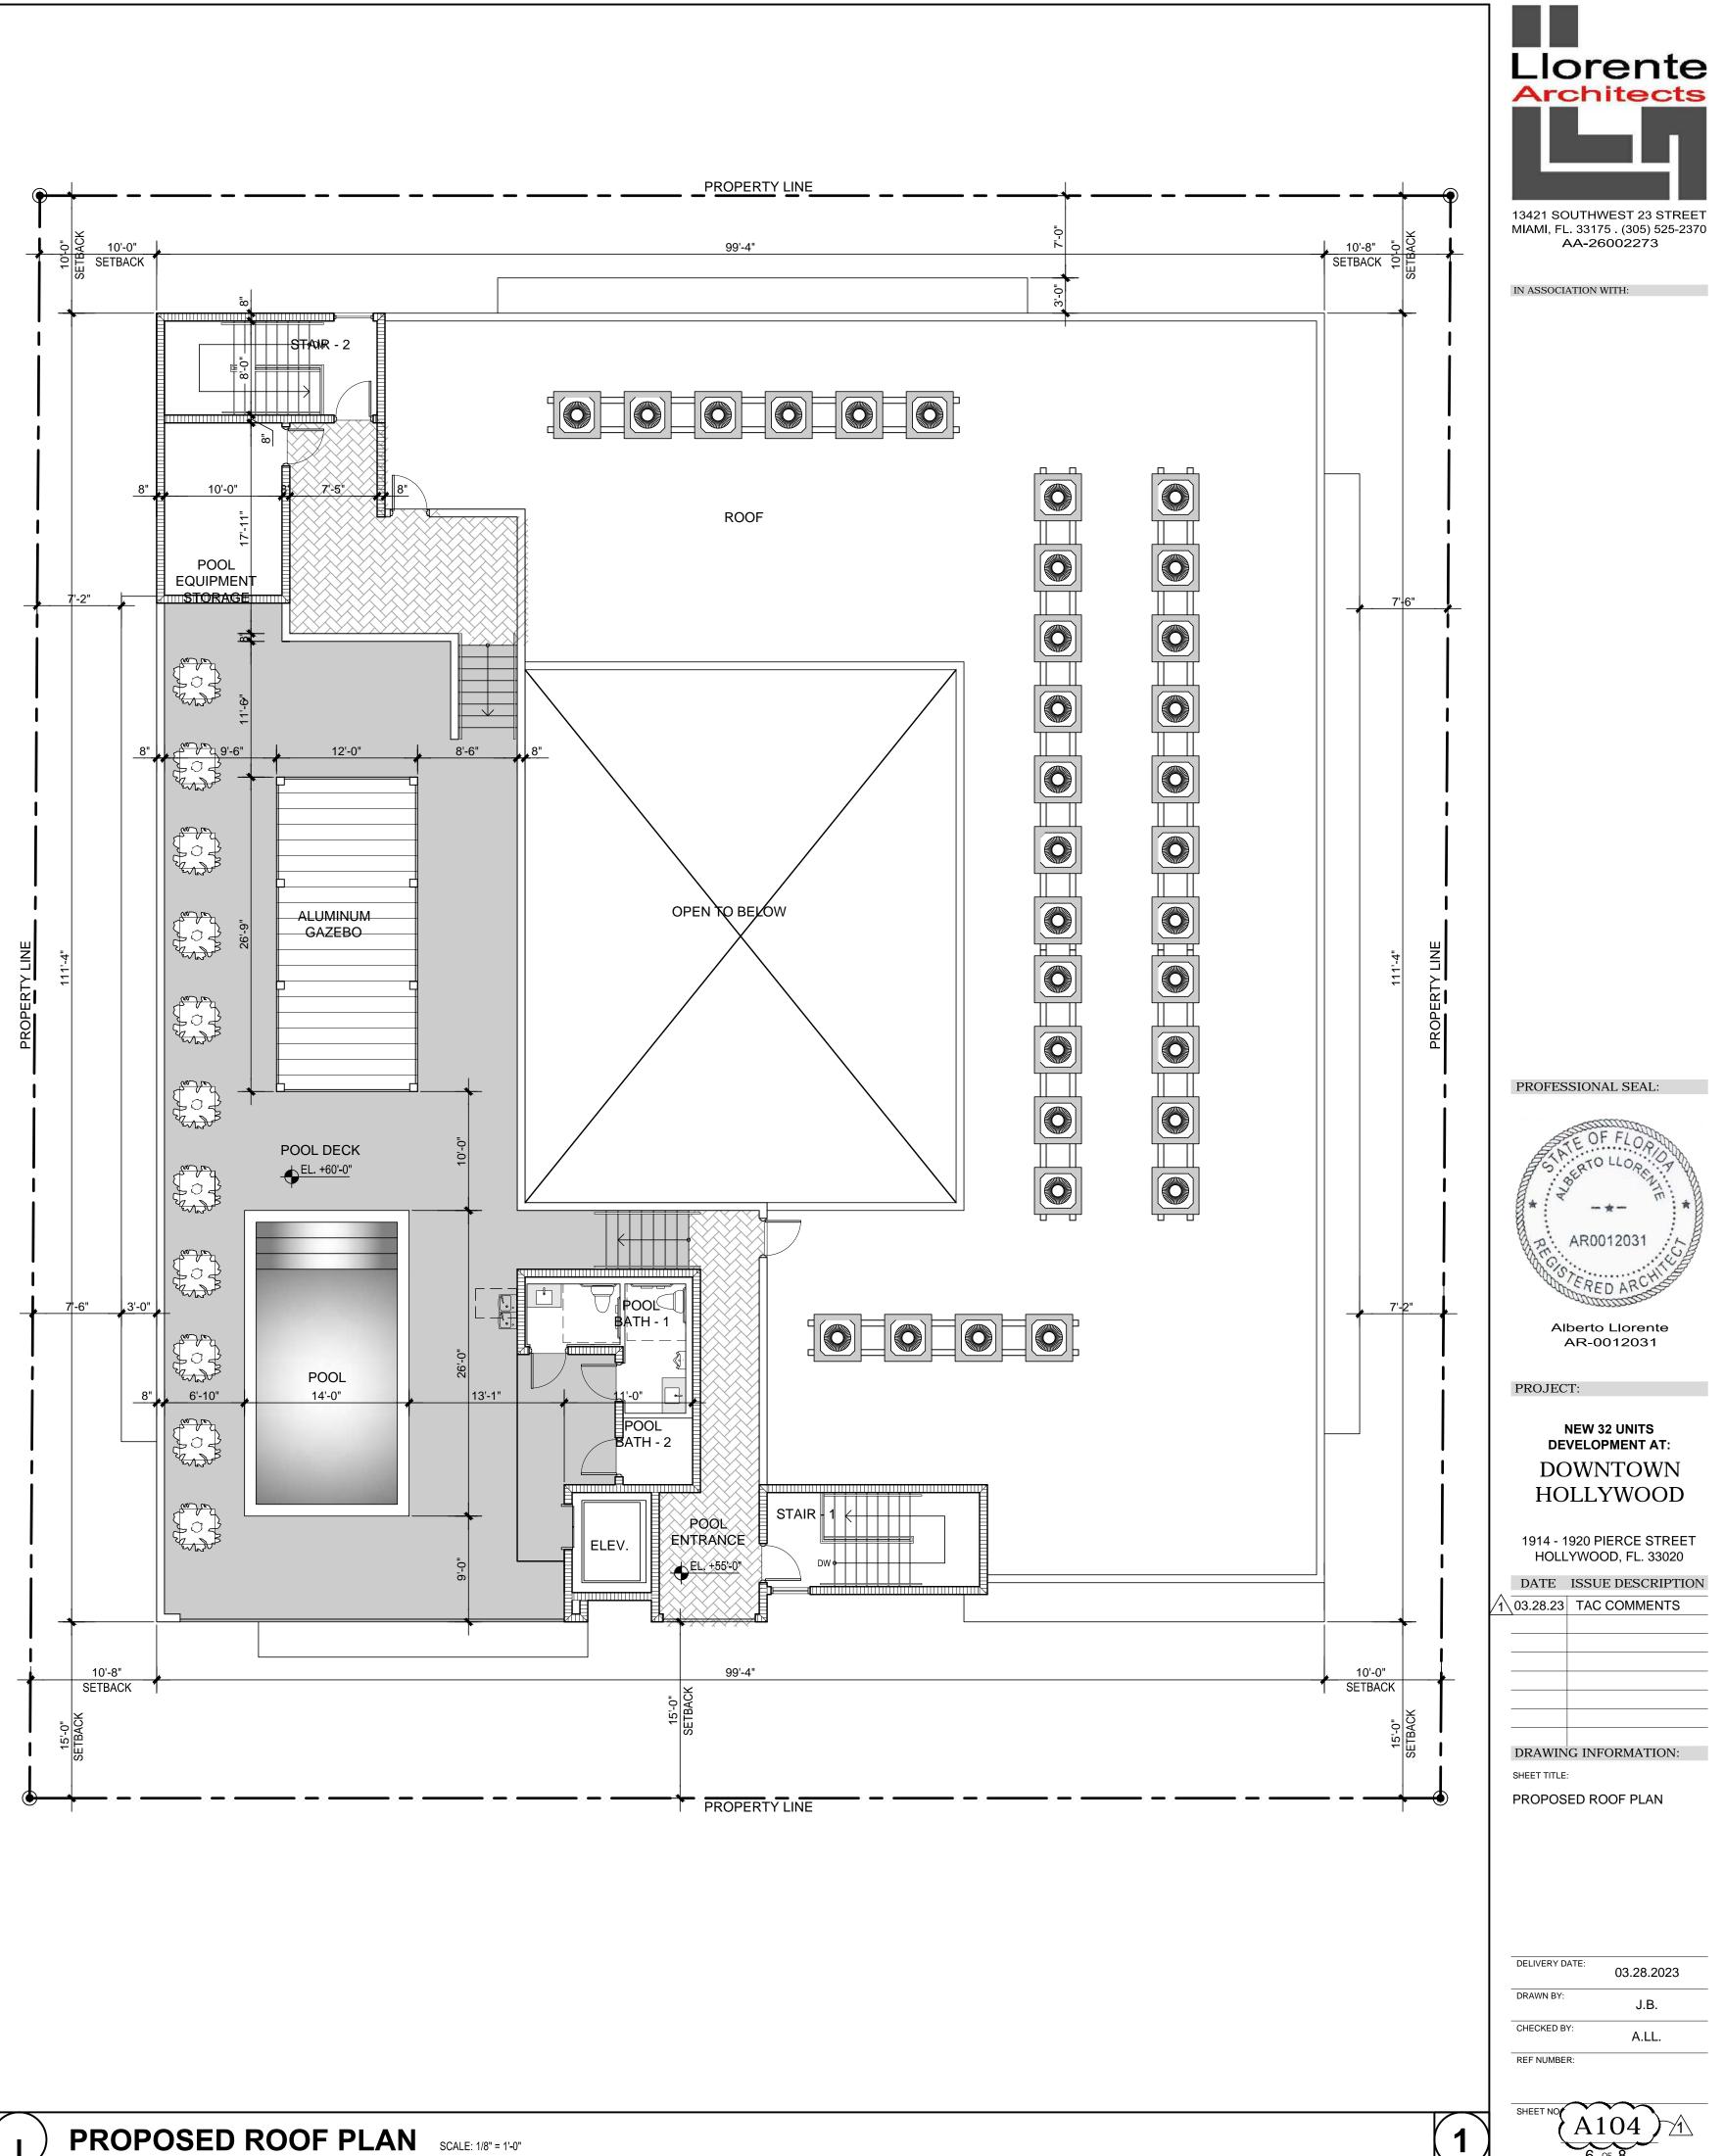

PROPOSED ROOF PLAN SCALE: 1/8" = 1'-0"

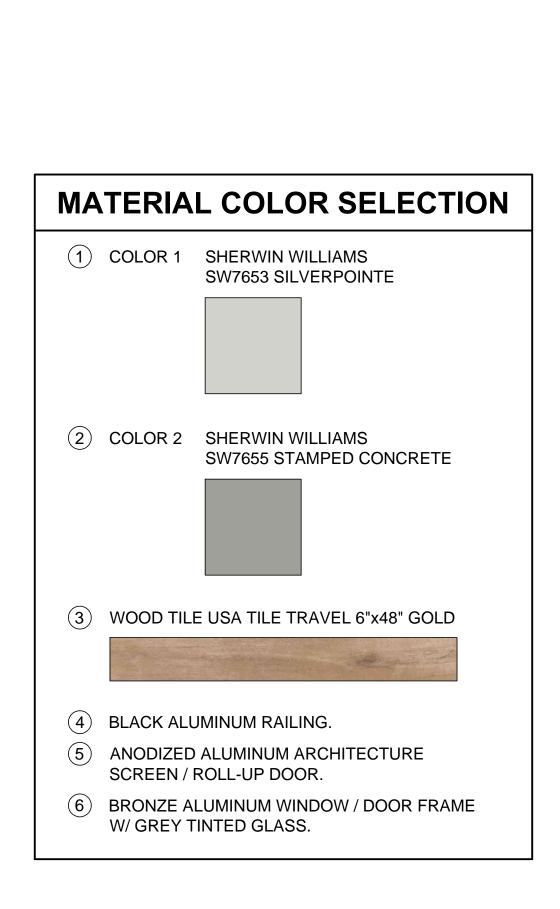

15'-0"

12'-0"

LINE OF BALCONY.----

LINE OF BALCONY.-


1)—


15'-0"

17'-4"

LINE OF BALCONY.


PROPOSED EXTERIOR ELEVATION SCALE: 1/8" = 1'-0"

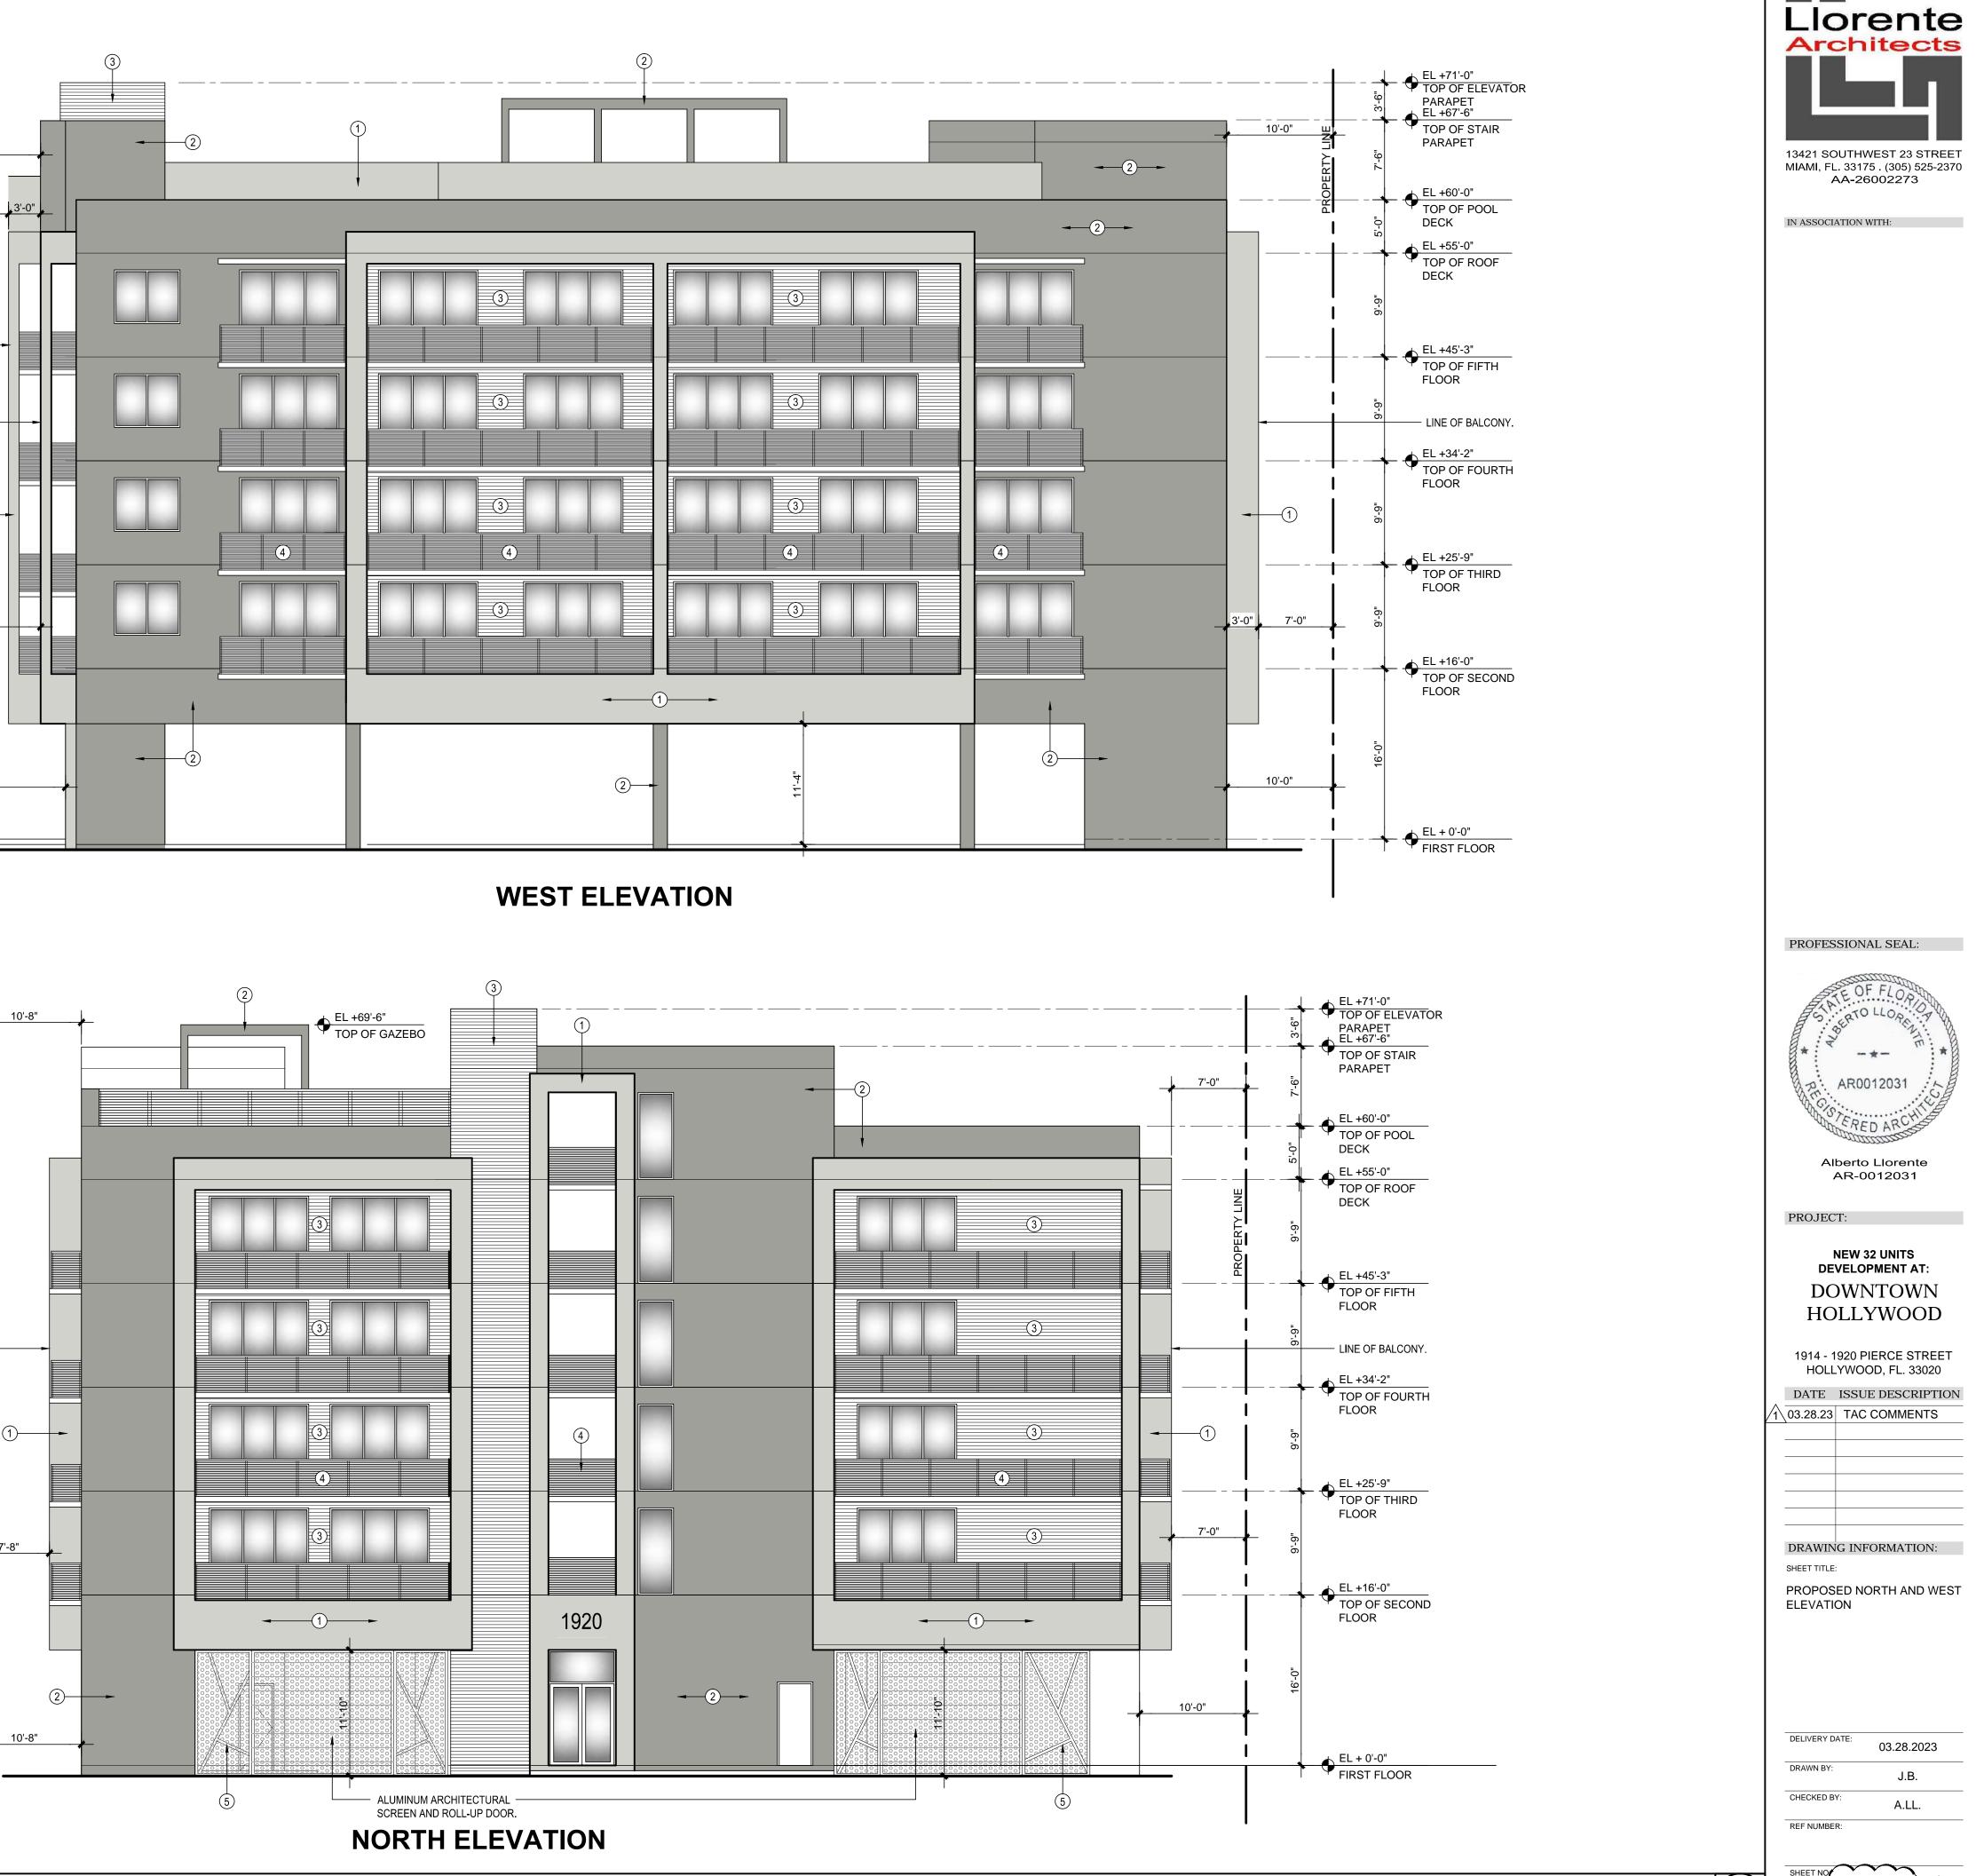

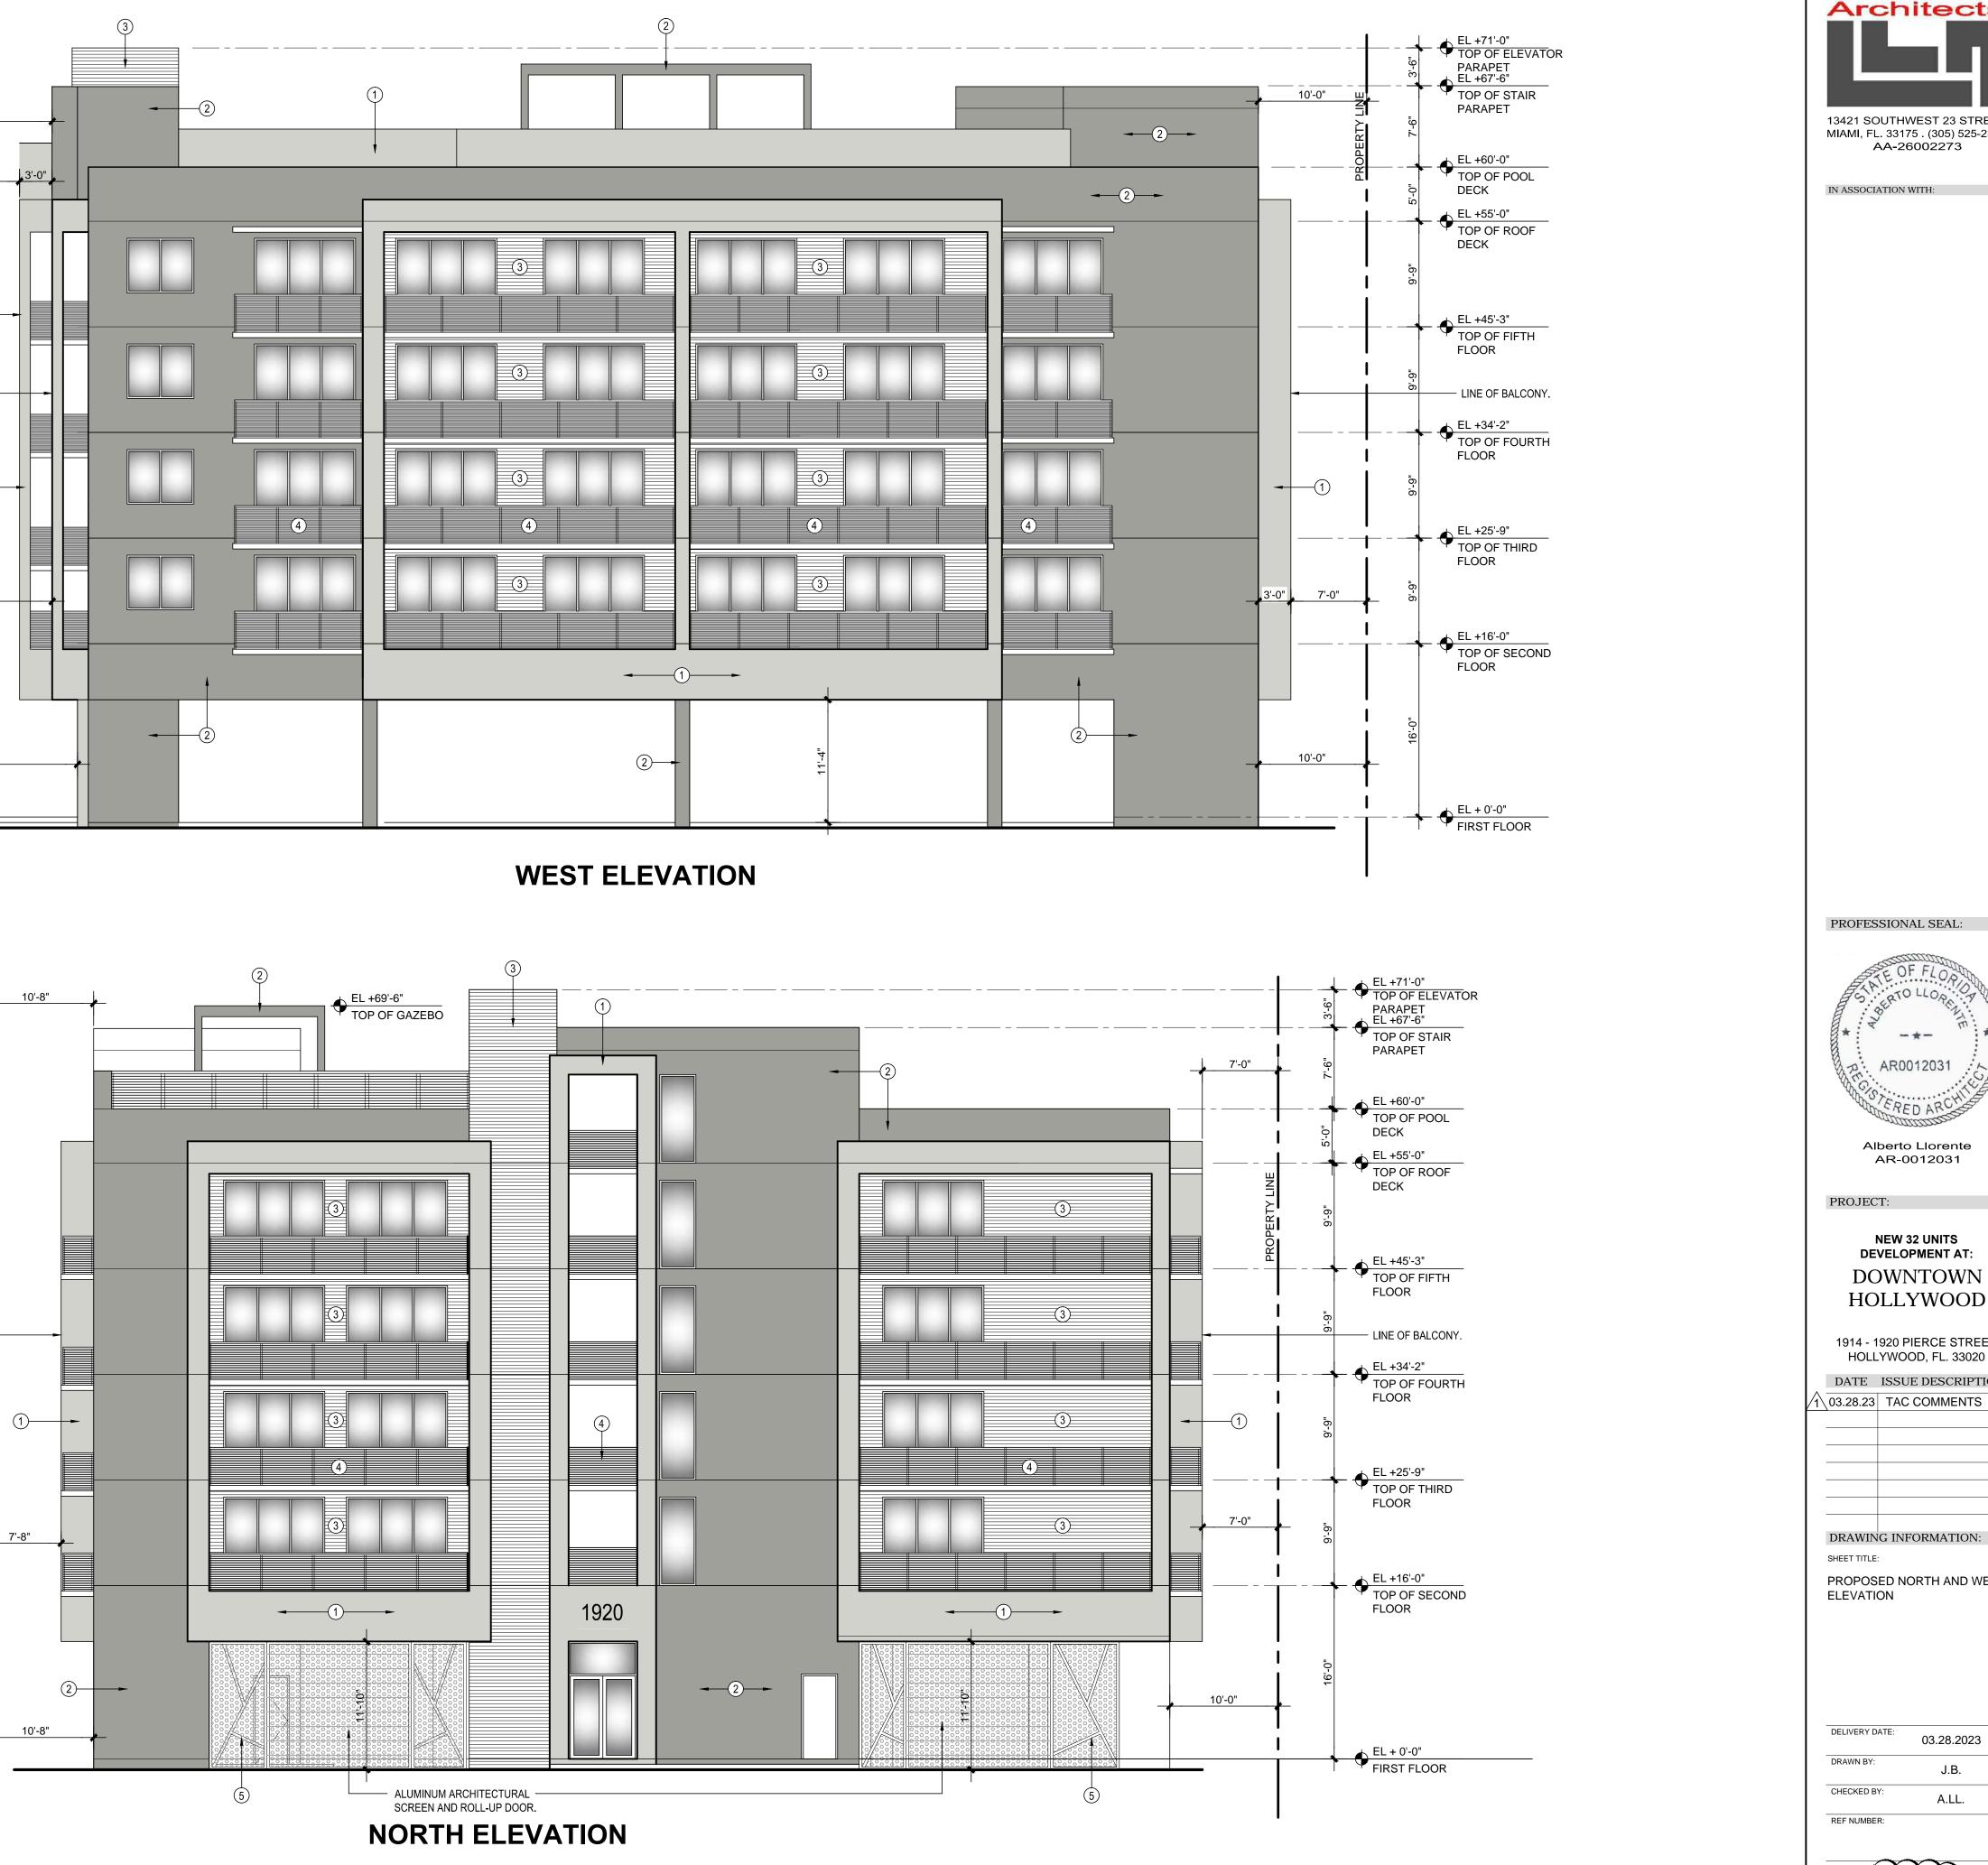

1

A201

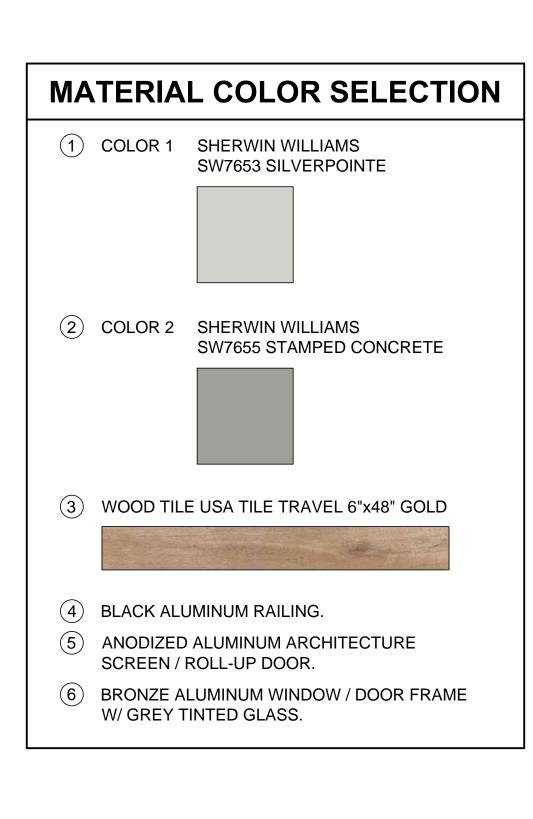

10'-0"


7'-0" 3


10'-0"


LINE OF BALCONY.

LINE OF BALCONY.

PROPOSED EXTERIOR ELEVATION SCALE: 1/8" = 1'-0"

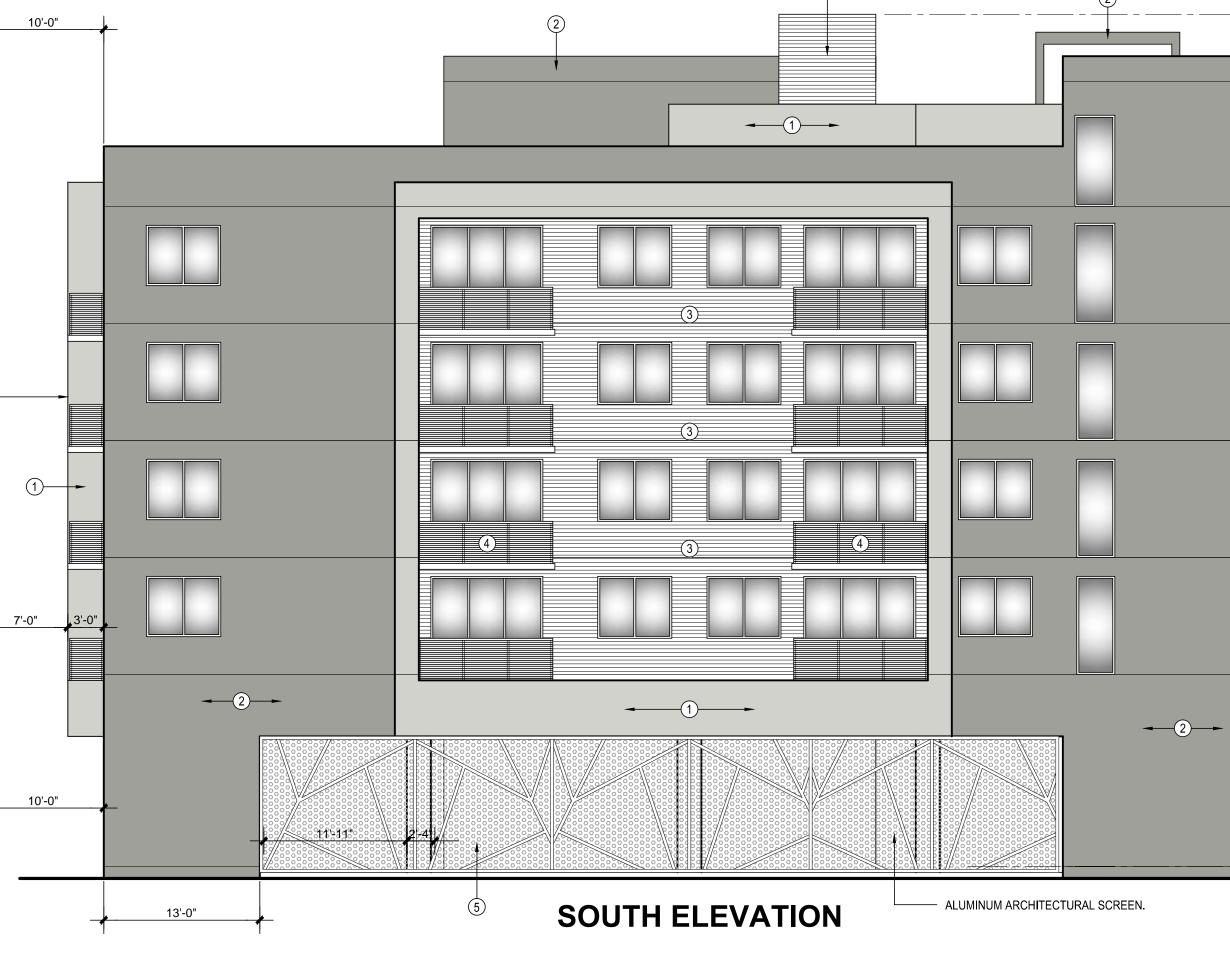

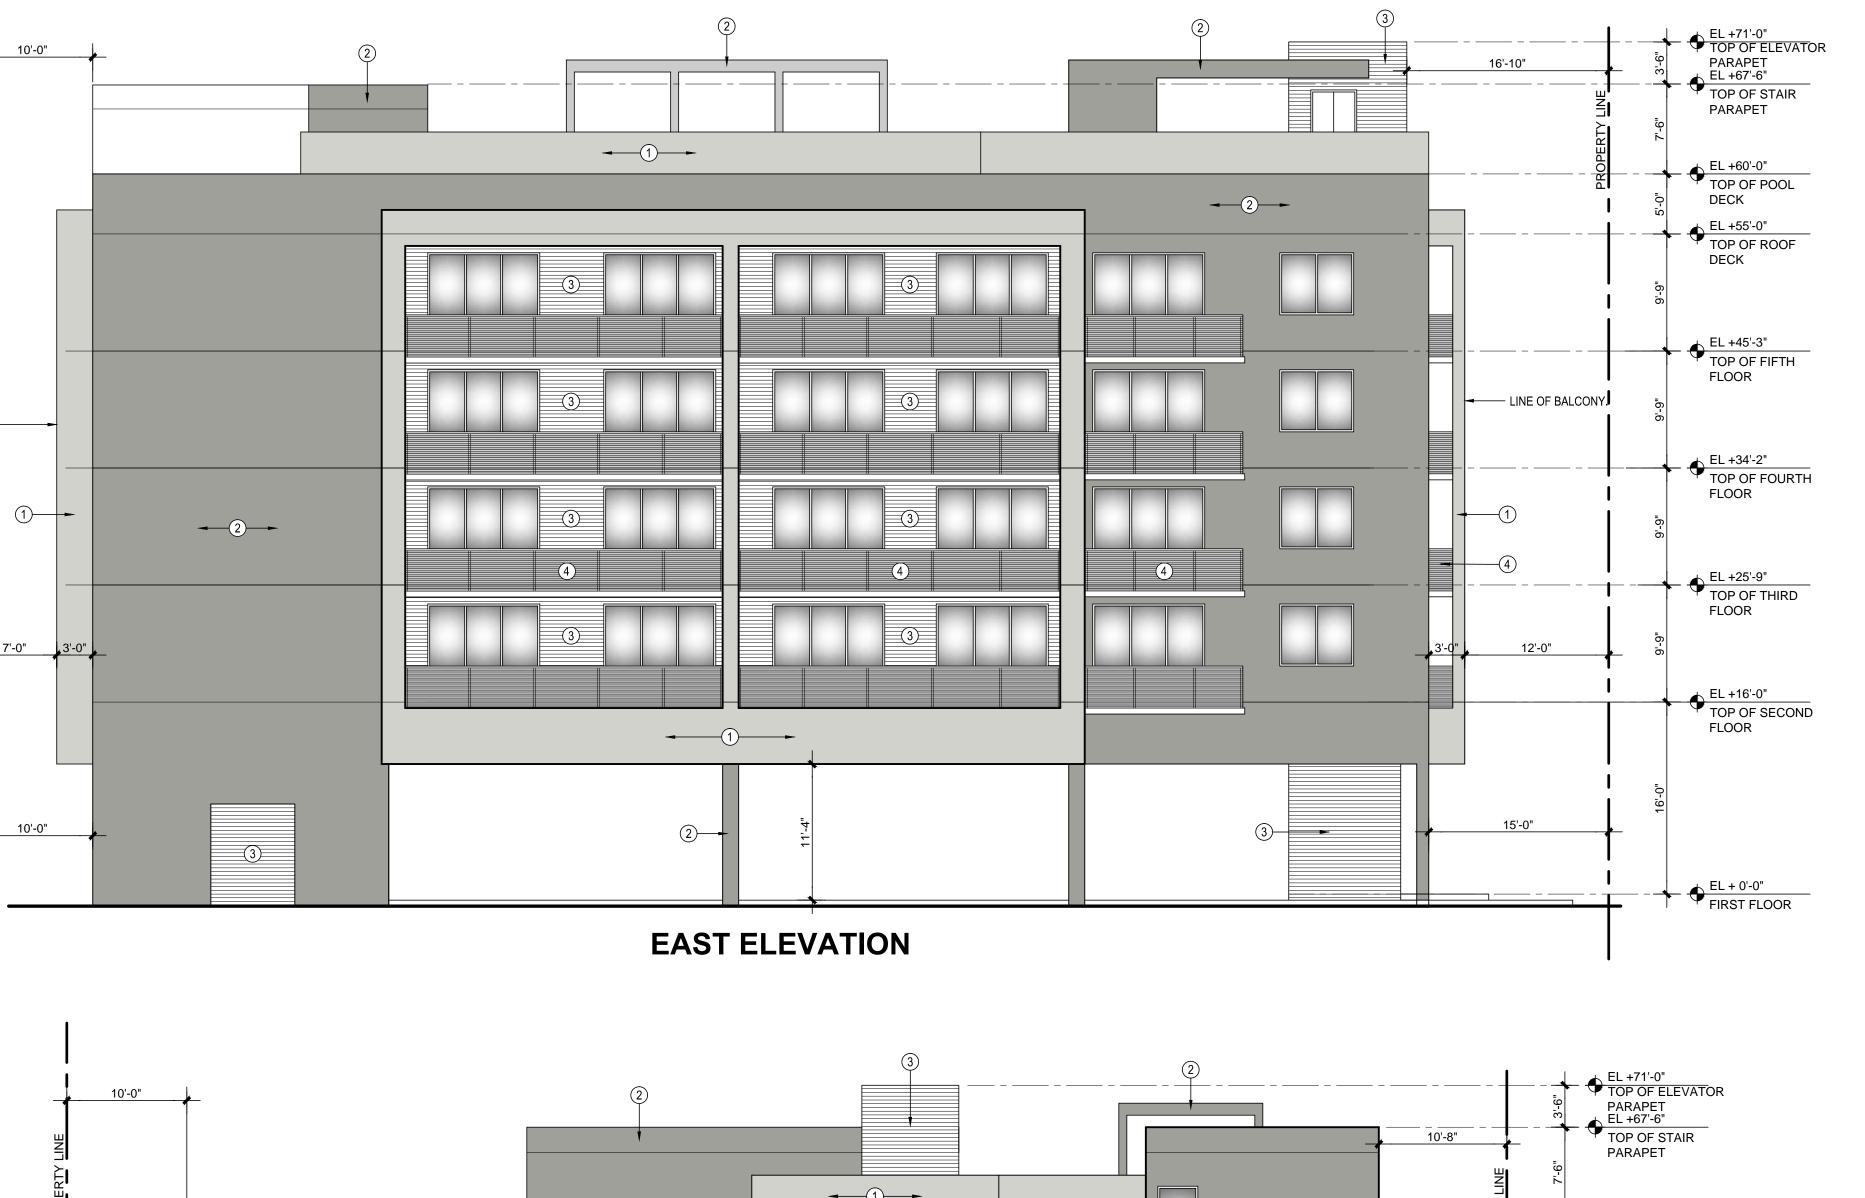

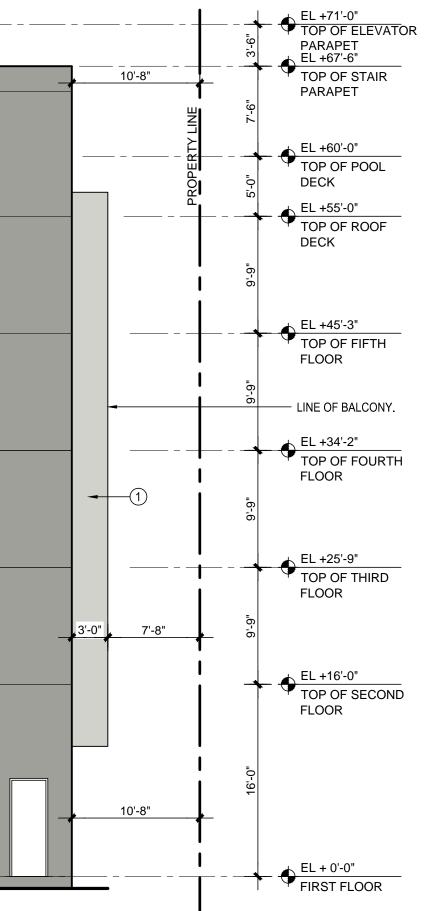



PROFESSIONAL SEAL:



AR-0012031

PROJECT:

NEW 32 UNITS DEVELOPMENT AT: DOWNTOWN HOLLYWOOD

1914 - 1920 PIERCE STREET HOLLYWOOD, FL. 33020

DATE ISSUE DESCRIPTION 03.28.23 TAC COMMENTS

DRAWING INFORMATION:

SHEET TITLE:

PROPOSED SOUTH AND EAST ELEVATION


DELIVERY DATE: 03.28.2023 DRAWN BY: J.B. CHECKED BY: A.LL. REF NUMBER:

A202

1

SHEET N



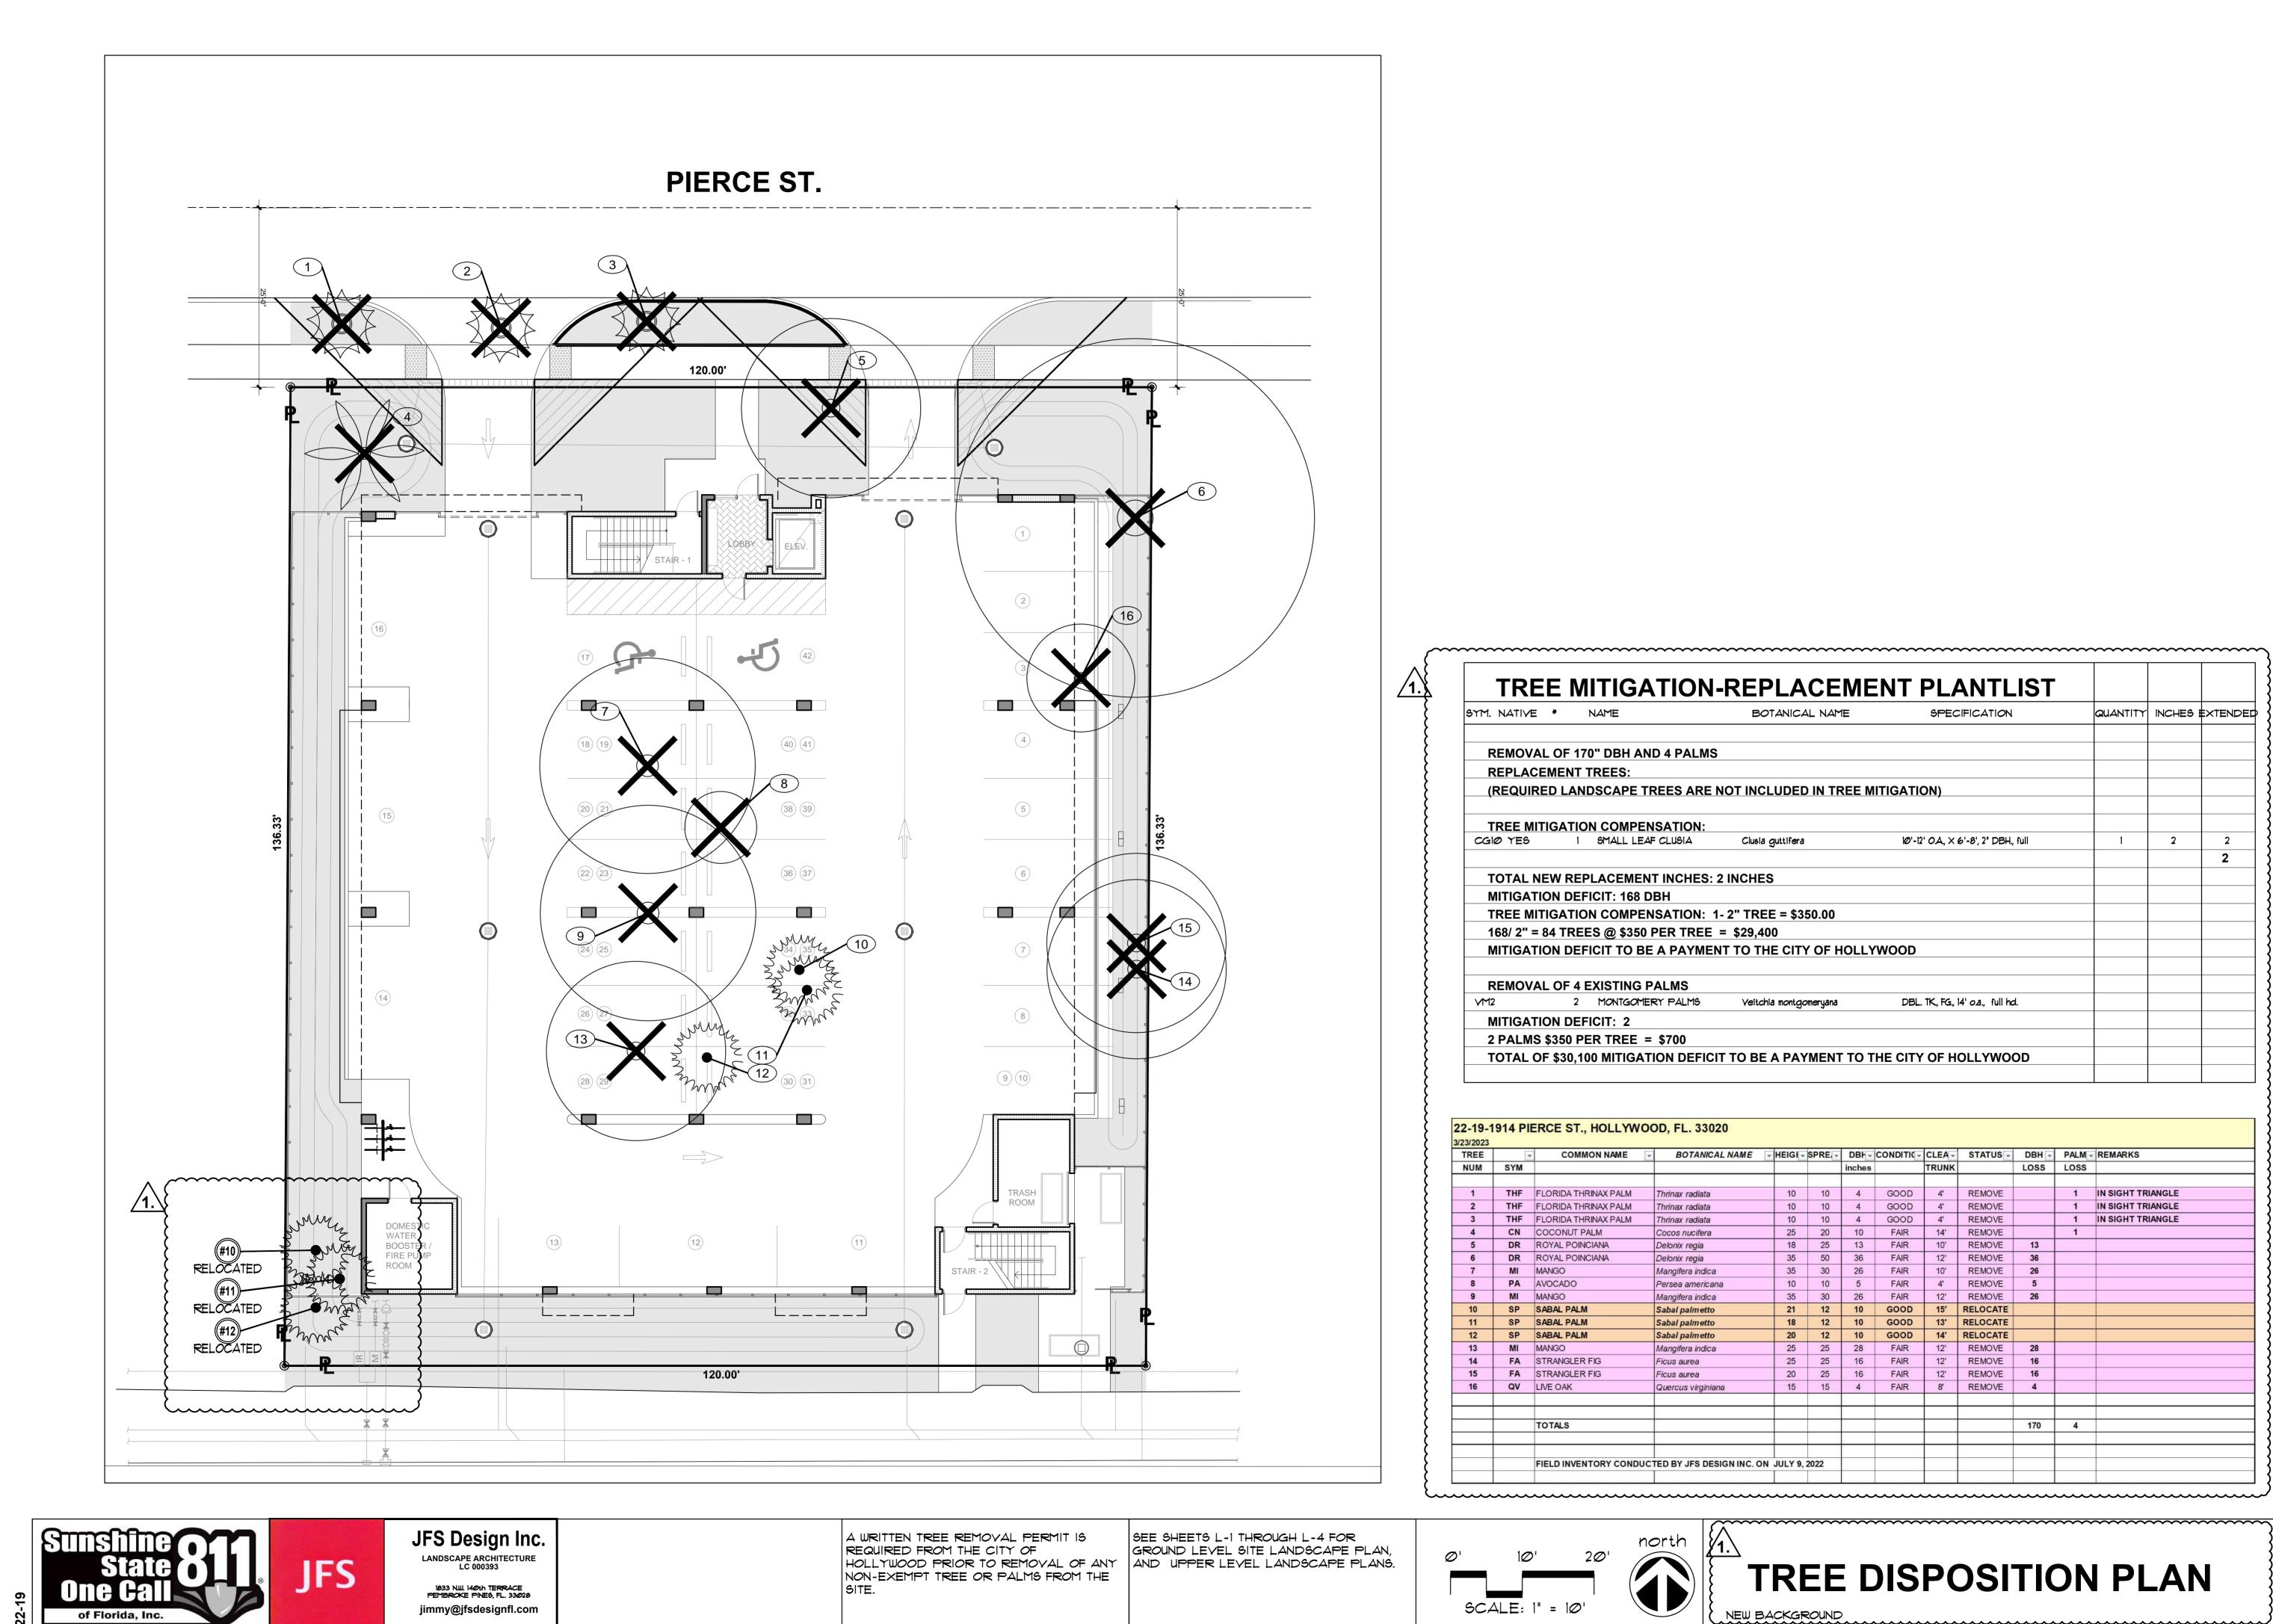



IN ASSOCIATION WITH:

	BOTANICAL NAME	SPECIFICATION	QUANTITY	INCHES	EXTENDE
ALMS					
	OT INCLUDED IN TREE M	ITIGATION)			
ION: MA	Clusia guttifera	10'-12' O.A., X 6'-8', 2" DBH., full	1	2	2
	Ciusia guttireia		'	2	2
HES: 2	INCHES				
ION: 1-	2" TREE = \$350.00				
	\$29,400				
AYMENT	TO THE CITY OF HOLLY	WOOD			
S					
LMS	Veitchia montgomeryana	DBL. TK., FG., 14' o.a., full hd.			
0					
-	TO BE A PAYMENT TO T	HE CITY OF HOLLYWOOD			

BOTANICAL NAME	- HEIGI -	SPRE	DBH -	CONDITIC -	CLEA -	STATUS -	DBH -	PALM -	REMARKS
			inches		TRUNK		LOSS	LOSS	
								104	
x radiata	10	10	4	GOOD	4'	REMOVE		1	IN SIGHT TRIANGLE
x radiata	10	10	4	GOOD	4'	REMOVE		1	IN SIGHT TRIANGLE
ix radiata	10	10	4	GOOD	4'	REMOVE		1	IN SIGHT TRIANGLE
s nucifera	25	20	10	FAIR	14'	REMOVE		1	
ix regia	18	25	13	FAIR	10'	REMOVE	13		
ix regia	35	50	36	FAIR	12'	REMOVE	36		
ifera indica	35	30	26	FAIR	10'	REMOVE	26		
a americana	10	10	5	FAIR	4'	REMOVE	5		
ifera indica	35	30	26	FAIR	12'	REMOVE	26		
palmetto	21	12	10	GOOD	15'	RELOCATE			
palmetto	18	12	10	GOOD	13'	RELOCATE	1		
palmetto	20	12	10	GOOD	14'	RELOCATE			
ifera indica	25	25	28	FAIR	12'	REMOVE	28		
aurea	25	25	16	FAIR	12'	REMOVE	16		
aurea	20	25	16	FAIR	12'	REMOVE	16		
us virginiana	15	15	4	FAIR	8'	REMOVE	4		
	r.								
							170	4	
Y JFS DESIGN INC. OI	N JULY 9.	2022							

TREE DISPOSITION PLAN NEW BACKGROUND

	1ES F. SOCASH LA * 0001132
PROJECT	
DEV	EW 32 UNITS ELOPMENT AT: WNTOWN
	LLYWOOD
	20 PIERCE STREET WOOD, FL. 33020
DATE I	SSUE DESCRIPTION
03.28.23	TAC COMMENTS
DRAWING	INFORMATION:
	INFORMATION.

PROFESSIONAL SEAL:

DELIVERY DATE:	02.13.2023
DRAWN BY:	J.B.
CHECKED BY:	A.LL.
REF NUMBER:	








JFS Design Inc. LANDSCAPE ARCHITECTURE LC 000393

> 1833 NW. 140th TERRACE PEMBROKE PINES, FL. 33028 jimmy@jfsdesignfl.com

2-1

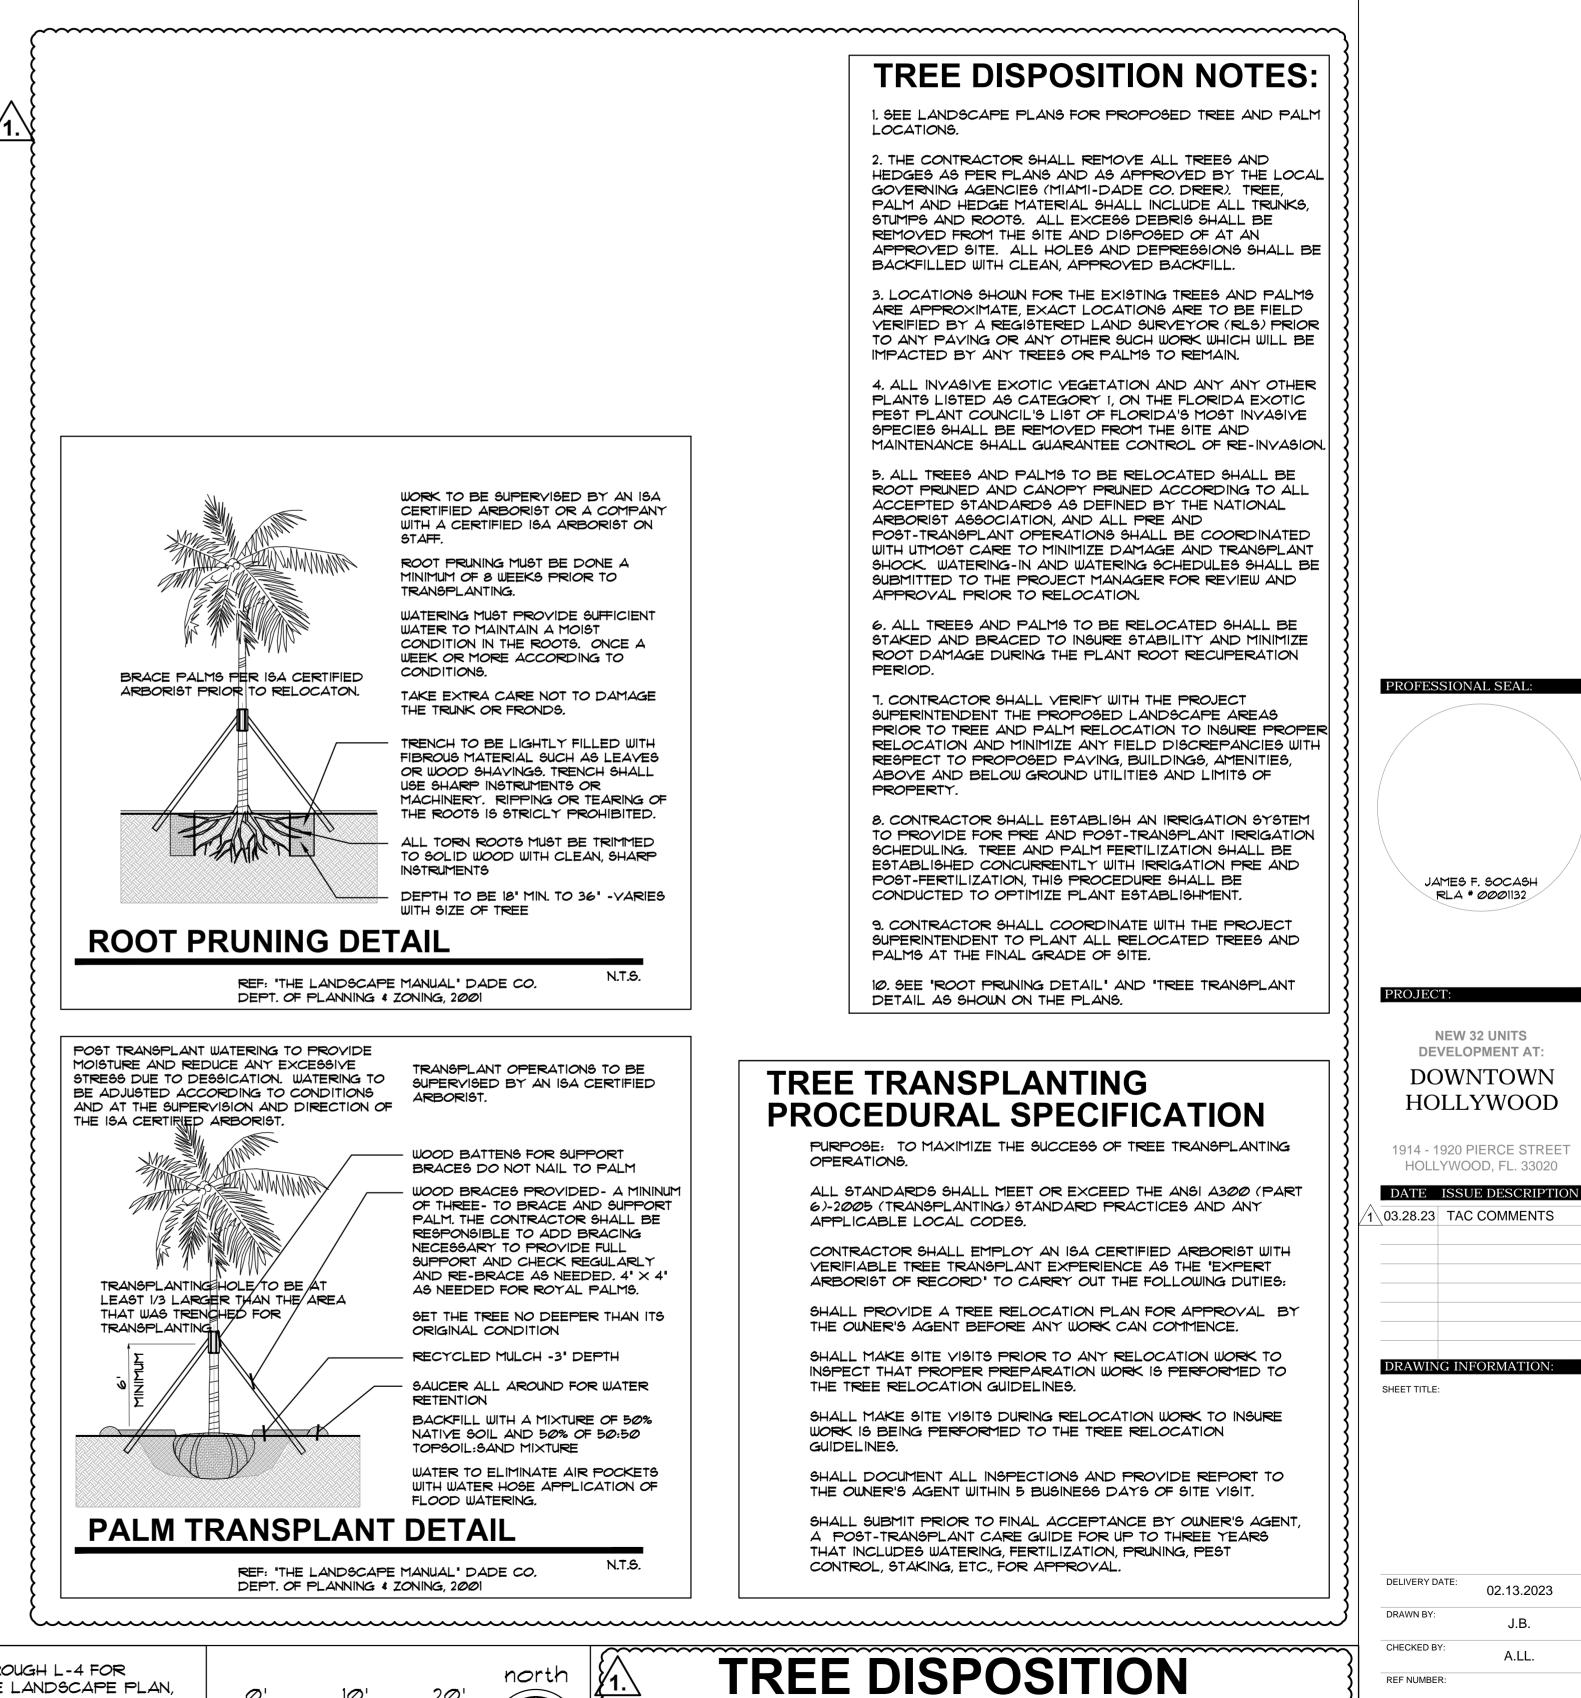


NEW SHEET

DETAILS, SPECIFICATIONS

A WRITTEN TREE REMOVAL PERMIT IS REQUIRED FROM THE CITY OF HOLLYWOOD PRIOR TO REMOVAL OF ANY NON-EXEMPT TREE OR PALMS FROM THE SITE.


SEE SHEETS L-1 THROUGH L-4 FOR GROUND LEVEL SITE LANDSCAPE PLAN, AND UPPER LEVEL LANDSCAPE PLANS.

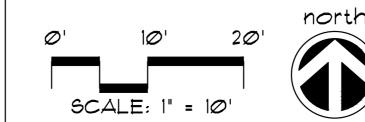



IN ASSOCIATION WITH:

SHEET NO. TD-2

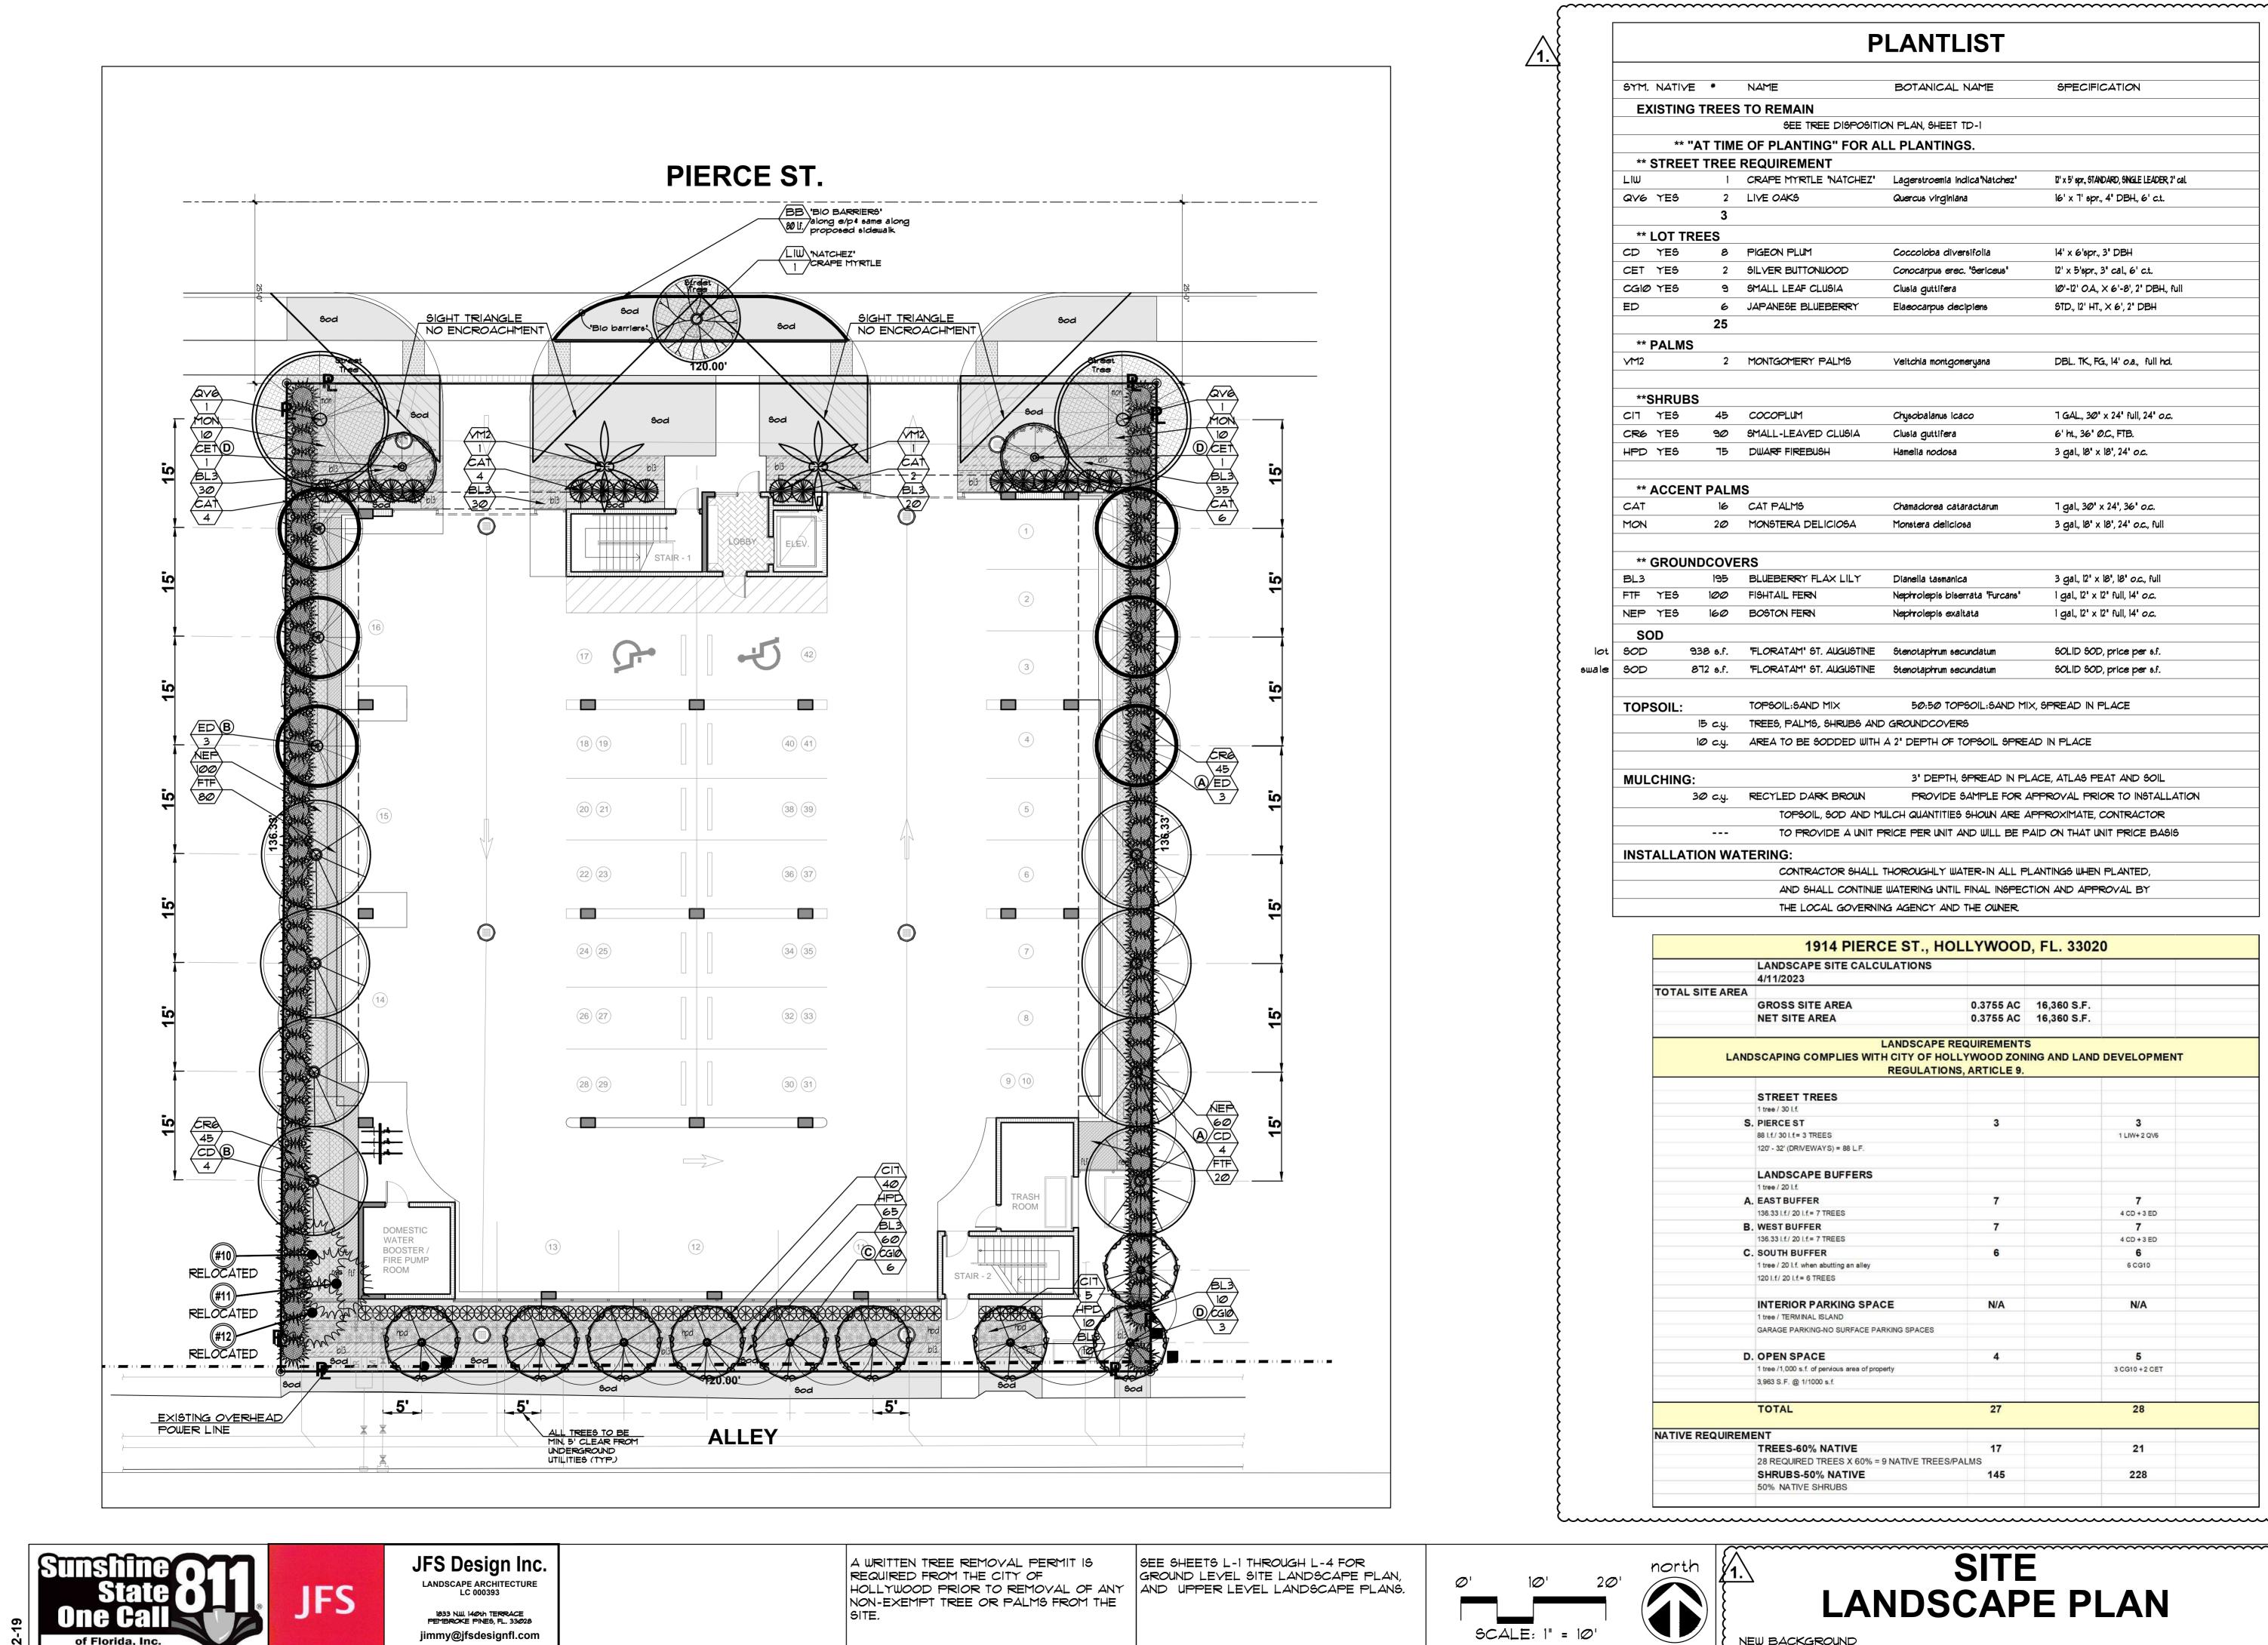

PLANTLIST

BOTANICAL NAME

Coccoloba diversifolia

Elaeocarpus decipiens

Veitchia montgomeryana

Chysobalanus icaco

Chamadorea cataractarum

Nephrolepis biserrata 'Furcans'

TOPSOIL, SOD AND MULCH QUANTITIES SHOWN ARE APPROXIMATE, CONTRACTOR

CONTRACTOR SHALL THOROUGHLY WATER-IN ALL PLANTINGS WHEN PLANTED, AND SHALL CONTINUE WATERING UNTIL FINAL INSPECTION AND APPROVAL BY

1914 PIERCE ST., HOLLYWOOD, FL. 33020

LANDSCAPE REQUIREMENTS

3

7

7

6

N/A

4

27

17

145

SITE

LANDSCAPE PLAN

NEW BACKGROUND

.....

LANDSCAPING COMPLIES WITH CITY OF HOLLYWOOD ZONING AND LAND DEVELOPMENT **REGULATIONS, ARTICLE 9.**

THE LOCAL GOVERNING AGENCY AND THE OWNER.

LANDSCAPE SITE CALCULATIONS

4/11/2023

GROSS SITE AREA

NET SITE AREA

STREET TREES

88 I.f./ 30 I.f.= 3 TREES

136.33 I.f./ 20 I.f.= 7 TREES

136.33 I.f./ 20 I.f.= 7 TREES

120 I.f./ 20 I.f.= 6 TREES

1 tree / TERMINAL ISLAND

1 tree / 20 l.f. when abutting an alley

INTERIOR PARKING SPACE

1 tree /1,000 s.f. of pervious area of property

GARAGE PARKING-NO SURFACE PARKING SPACES

28 REQUIRED TREES X 60% = 9 NATIVE TREES/PALMS

120' - 32' (DRIVEWAYS) = 88 L.F.

LANDSCAPE BUFFERS

1 tree / 30 l.f.

S. PIERCE ST

1 tree / 20 l.f.

A. EAST BUFFER

B. WEST BUFFER

C. SOUTH BUFFER

D. OPEN SPACE

TOTAL

3,963 S.F. @ 1/1000 s.f.

TREES-60% NATIVE

SHRUBS-50% NATIVE

50% NATIVE SHRUBS

TO PROVIDE A UNIT PRICE PER UNIT AND WILL BE PAID ON THAT UNIT PRICE BASIS

50:50 TOPSOIL:SAND MIX, SPREAD IN PLACE

3" DEPTH, SPREAD IN PLACE, ATLAS PEAT AND SOIL

0.3755 AC 16,360 S.F.

0.3755 AC 16,360 S.F.

PROVIDE SAMPLE FOR APPROVAL PRIOR TO INSTALLATION

Monstera deliciosa

Dianella tasmanica

Nephrolepis exaltata

Clusia guttifera

Hamelia nodosa

Clusia guttifera

Conocarpus erec. "Seríceus"

SPECIFICATION

12' x 5' spr., STANDARD, SINGLE LEADER, 2' cal.

16' x 7' spr., 4" DBH., 6' c.t.

14' x 6'spr., 3**'** DBH

12' x 5'spr., 3" cal., 6' c.t.

STD., 12' HT., X 6', 2" DBH

DBL. TK., FG., 14' o.a., full hd.

7 GAL., 30" x 24" full, 24" *o.c.*

6' ht., 36**"** Ø.C., FTB.

3 gal., 18" x 18", 24" o.c.

7 gal., 30' x 24', 36' o.c.

3 gal., 18' x 18', 24' o.c., full

3 gal., 12' x 18', 18' o.c., full

1 gal., 12" x 12" full, 14" o.c.

l gal., 12" x 12" full, 14" o.c.

SOLID SOD, price per s.f.

SOLID SOD, price per s.f.

3

1 LIW+ 2 QV6

7

7

4 CD + 3 ED

4 CD + 3 ED

6

6 CG10

N/A

5 3 CG10 +2 CET

28

21

228

10'-12' O.A., X 6'-8', 2" DBH., full

Llorente

Architects

13421 SOUTHWEST 23 STREET MIAMI, FL. 33175 . (305) 525-2370

AA-26002273

IN ASSOCIATION WITH:

PROFESSIONAL SEAL:

JAMES F. SOCASH

RLA * 0001132

NEW 32 UNITS DEVELOPMENT AT:

DOWNTOWN

HOLLYWOOD

1914 - 1920 PIERCE STREET

HOLLYWOOD, FL. 33020

DATE ISSUE DESCRIPTION

DRAWING INFORMATION:

02.13.2023

J.B.

A.LL.

SHEET TITLE:

DELIVERY DATE:

DRAWN BY

CHECKED BY:

REF NUMBER:

SHEET NO.

03.28.23 TAC COMMENTS

PROJECT:

EXISTING TREES TO REMAIN SEE TREE DISPOSITION PLAN, SHEET TD-1

** "AT TIME OF PLANTING" FOR ALL PLANTINGS.

** STREET TREE REQU

3

25

8 PIGEON PLUM

2 SILVER BUTTONWOOD

6 JAPANESE BLUEBERRY

2 MONTGOMERY PALMS

90 SMALL-LEAVED CLUSIA

20 MONSTERA DELICIOSA

195 BLUEBERRY FLAX LILY

TOPSOIL:SAND MIX

45 COCOPLUM

16 CAT PALMS


100 FIGHTAIL FERN

160 BOSTON FERN

75 DWARF FIREBUSH

9 SMALL LEAF CLUSIA

TIME OF PLANTING" FOR ALL PLANTINGS.							
1	CRAPE MYRTLE 'NATCHEZ'	Lagerstroemia indica'Natchez'					
2	LIVE OAKS	Quercus virginiana					

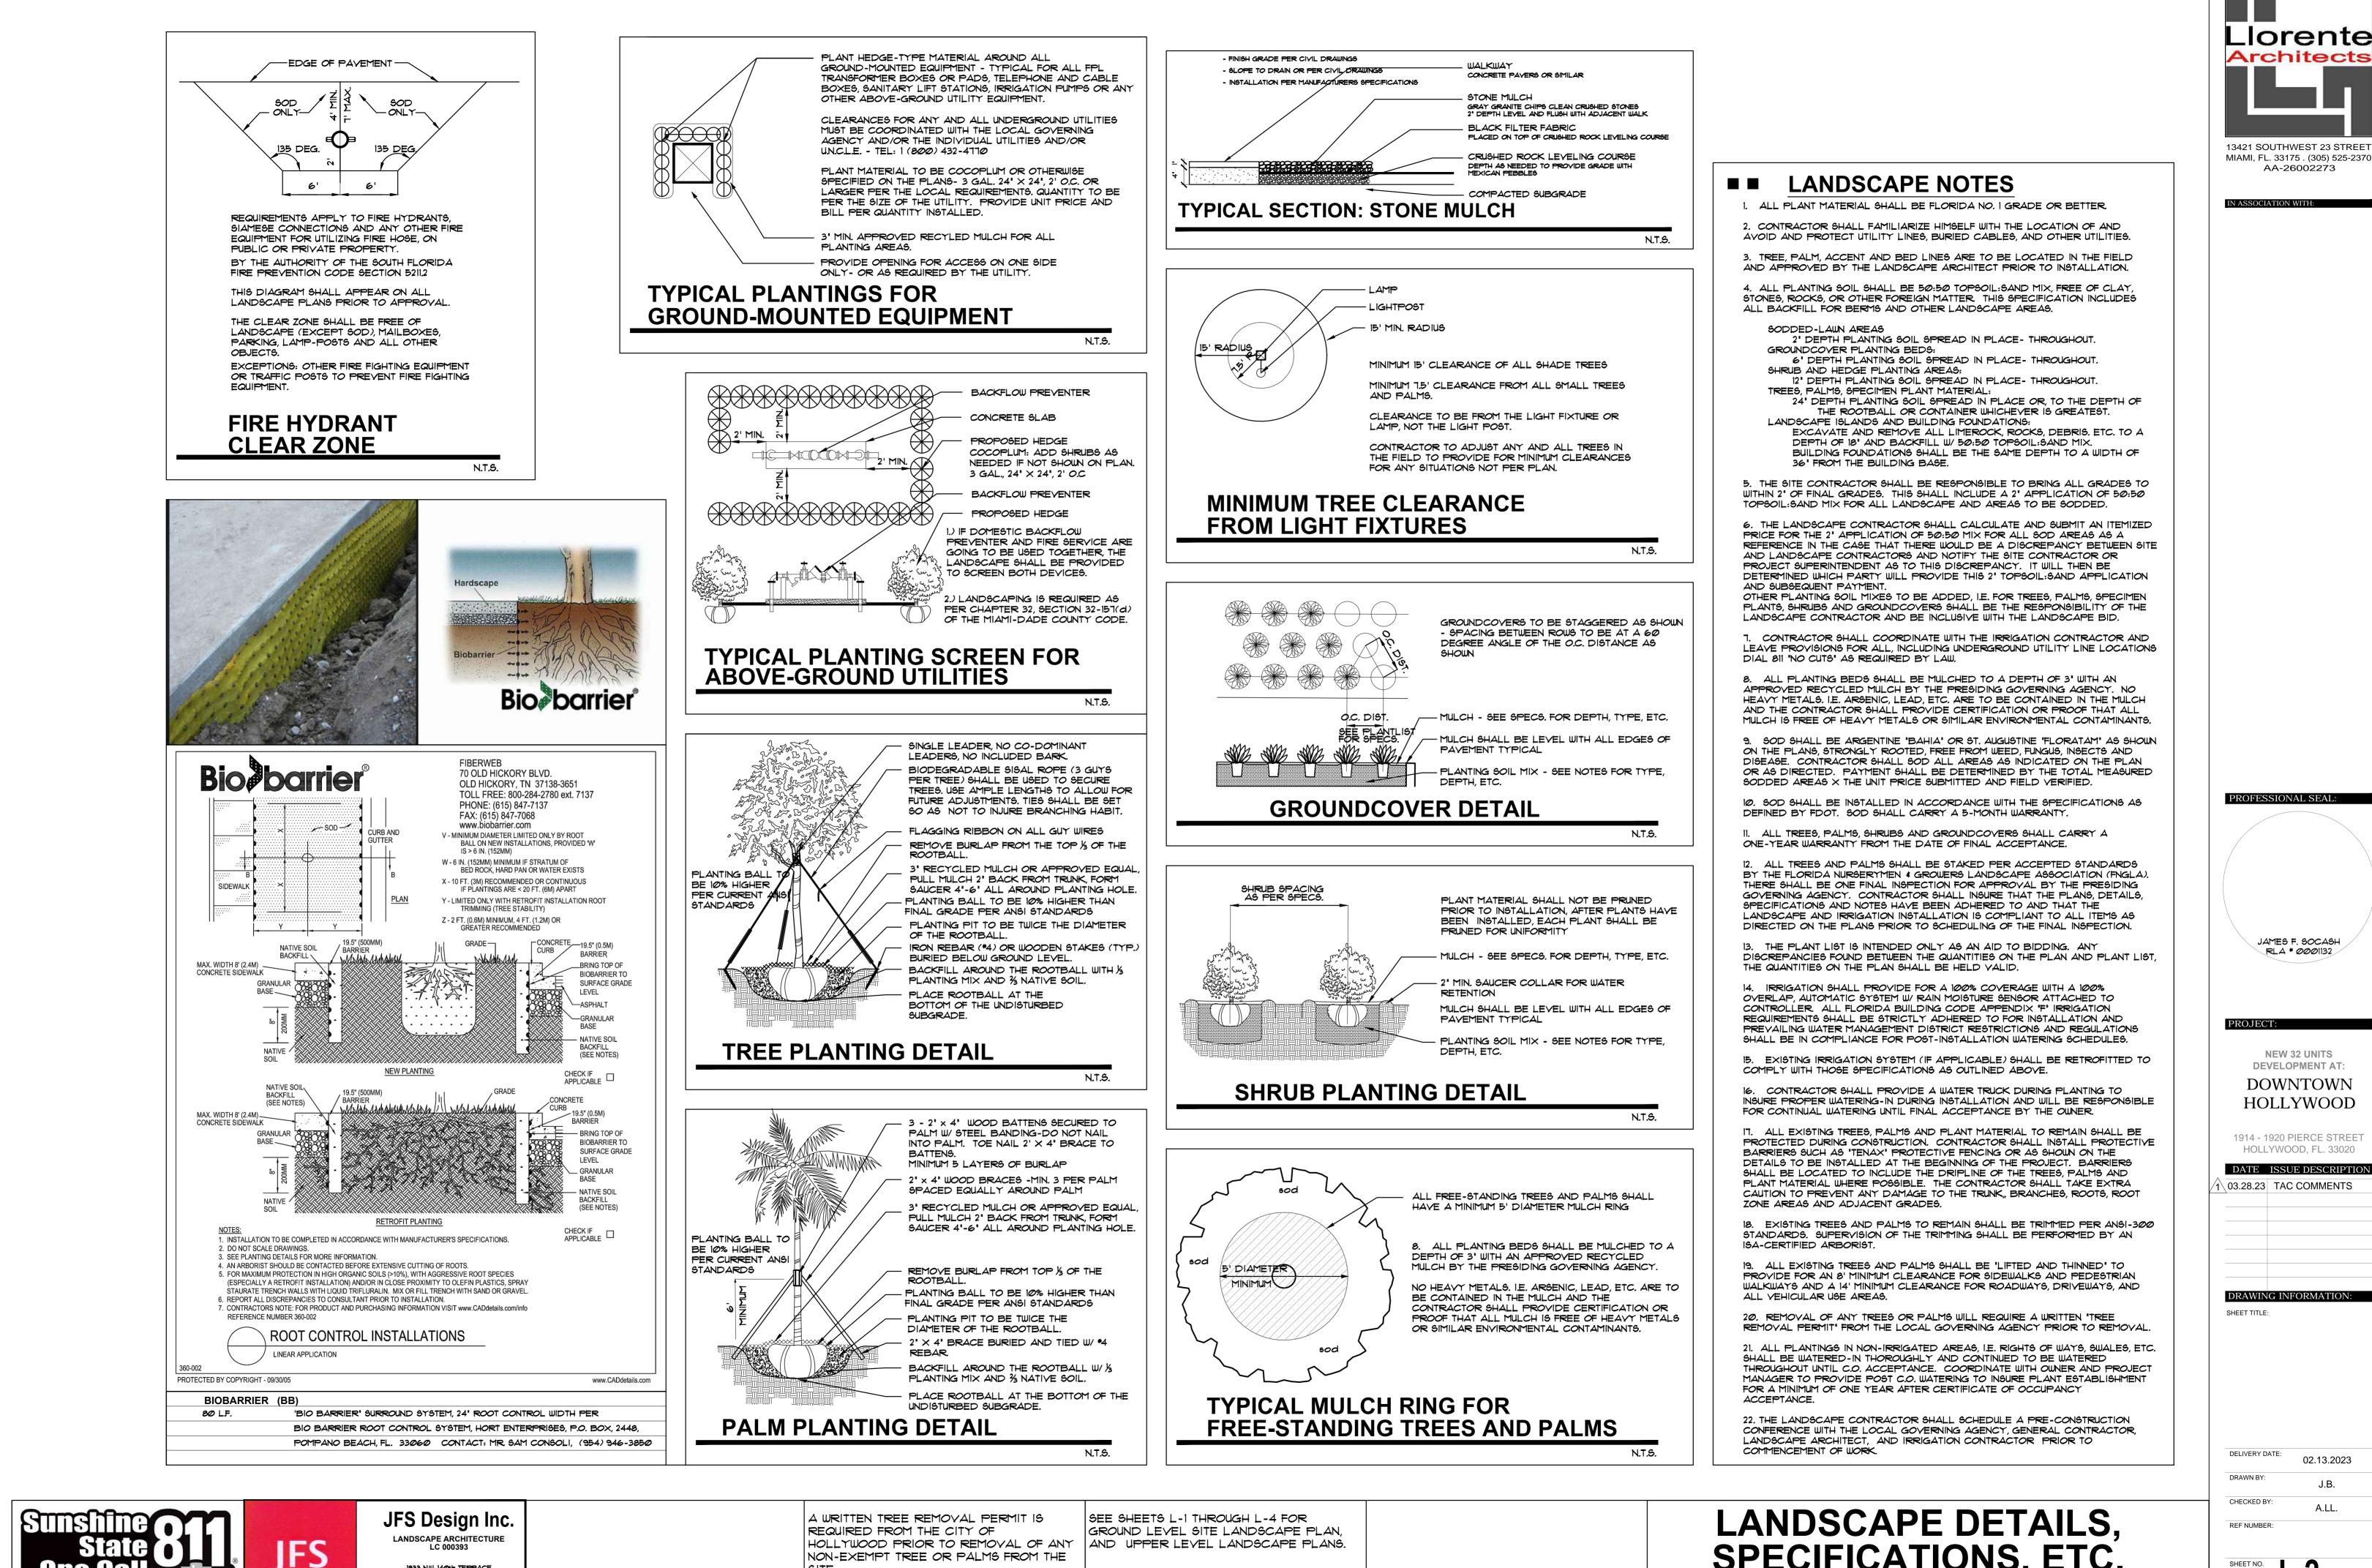

of Florida, Inc


1833 N.W. 140th TERRACE PEMBROKE PINES, FL. 33028

jimmy@jfsdesignfl.com

NON-EXEMPT TREE OR PALMS FROM THE SITE.

SPECIFICATIONS, ETC.


SHEET NO.

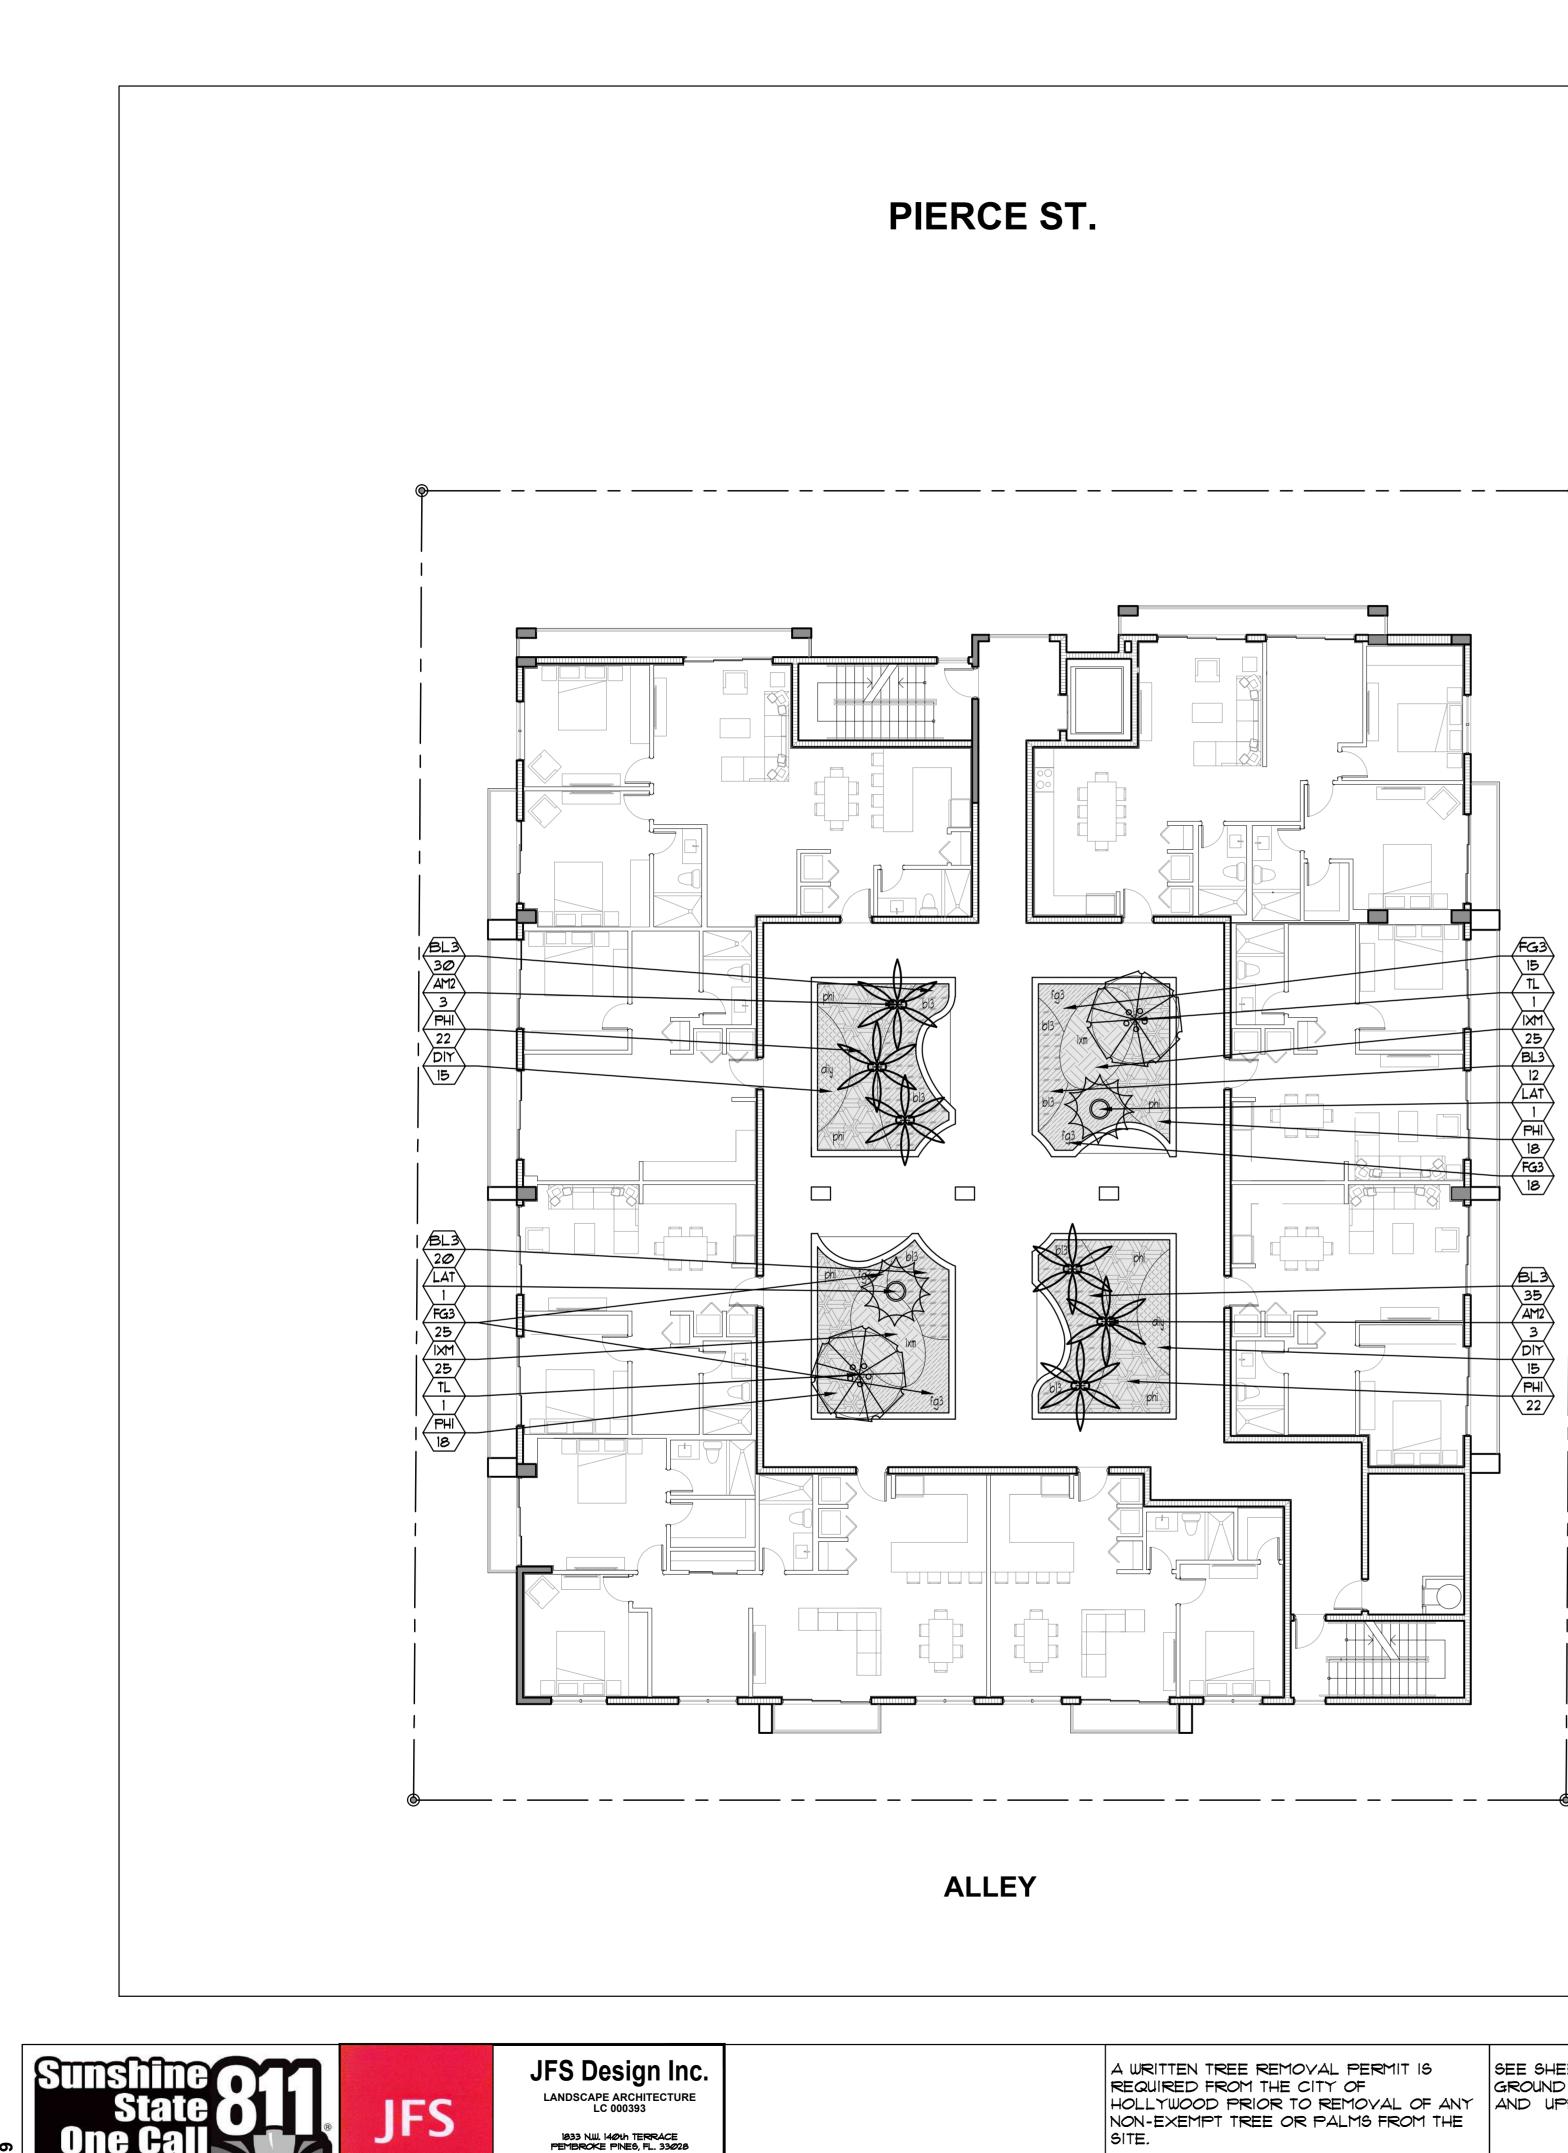

jimmy@jfsdesignfl.com

of Florida. Inc



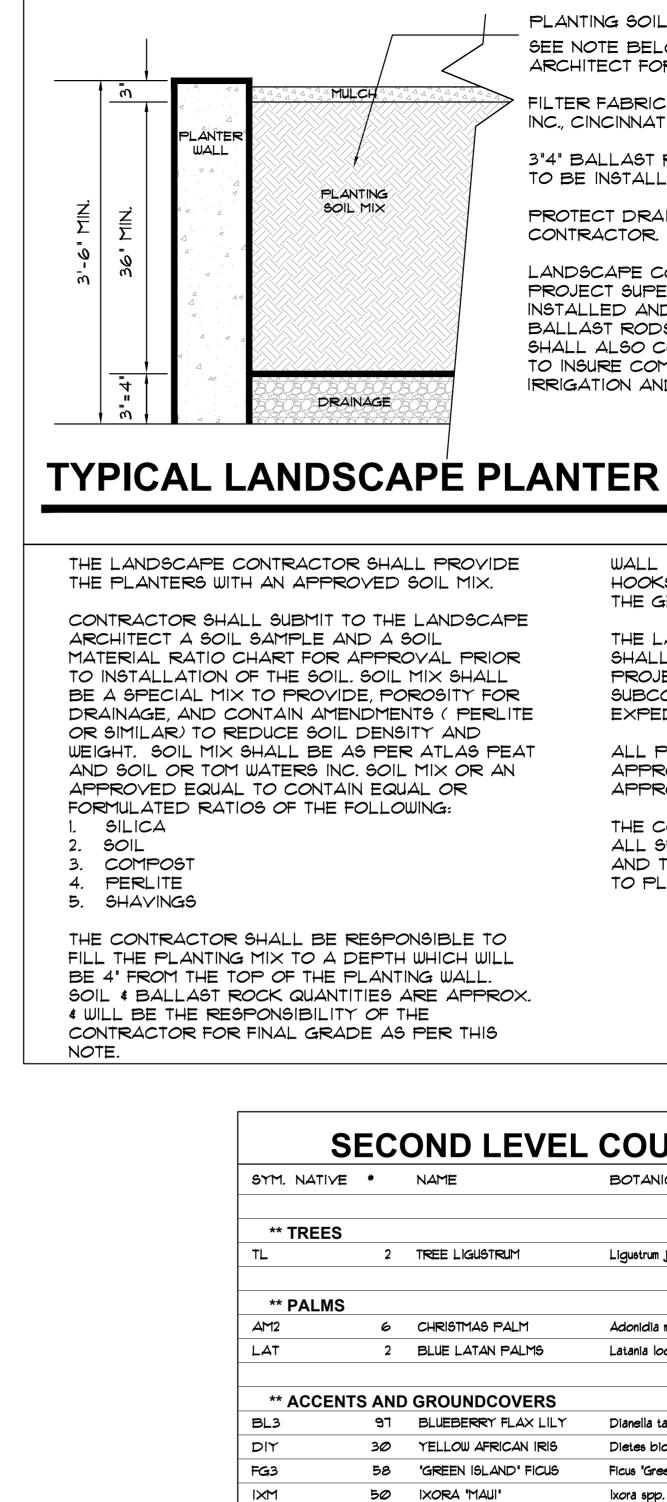

INSTALLAT


PHI

TOPSOIL:

MULCHING

SITE.

SEE SHEETS L-1 THROUGH L-4 FOR GROUND LEVEL SITE LANDSCAPE PLAN, AND UPPER LEVEL LANDSCAPE PLANS

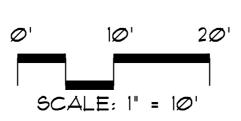



PLANTING SOIL:

SEE NOTE BELOW: PROVIDE SAMPLE TO LANDSCAPE ARCHITECT FOR APPROVAL PRIOR TO INSTALLATION.

FILTER FABRIC BY "POLY FILTER" BY CARTHAGE MILLES INC., CINCINNATI, OH., OR APPROVED EQUAL.

3"4" BALLAST ROCK OR APPROVED EQUAL 3"-4" DEPTH TO BE INSTALLED BY GENERAL CONTRACTOR.

PROTECT DRAINAGE PIPE AS INSTALLED BY CENERAL CONTRACTOR.

LANDSCAPE CONTRACTOR SHALL COORDINATE WITH THE PROJECT SUPERINTENDENT TO HAVE ALL DRAINAGE PIPE INSTALLED AND CONNECTED PRIOR TO BACKFILLING WITH BALLAST RODS, FILTER FABRIC, ETC. CONTRACTOR SHALL ALSO COORDINATE ALL IRRIGATION INSTALLATION TO INSURE COMPLETE OPERATION LOGISTICS REGARDING IRRIGATION AND DRAINAGE.

N.T.S.

WALL IMPERMEABILIZATION, DRAINS AND EYE HOOKS SHALL BE PREPARED & INSTALLED BY THE GENERAL CONTRACTOR.

THE LANDSCAPE AND IRRIGATION CONTRACTORS SHALL COORDINATE ALL WORK WITH THE PROJECT MANAGER AND ALL PERTINENT SUBCONTRACTORS TO INSURE A PROFESSIONAL EXPEDITIOUS PROCESS.


ALL PLANTING BEDS SHALL BE MULCHED WITH AN APPROVED RECYCLED MULCH, OR AN APPROVED EQUAL. SEE "LANDSCAPE NOTES".

THE CONTRACTOR SHALL SUBMIT PHOTOS FOR ALL SPECIMEN PLANT MATERIAL (ALL PALMS AND TREES) TO THE L.A. FOR APPROVAL PRIOR TO PLANTING.


*	NAME	BOTANICAL NAME	SPECIFICATION
2	TREE LIGUSTRUM	Ligustrum japonicum	8' x 8' full crown
		A share star as swetter	
6	CHRISTMAS PALM BLUE LATAN PALMS	Adonidia merrillii	FG., 10' o.a., DBL., full head
2	DLUE LATAN PALMS	Latania loddegesii	10' o.a., 6' C.T.
	O GROUNDCOVERS		
97	BLUEBERRY FLAX LILY	Dianella tasmanica	3 gai., 12' x 18', 18' o.c., full
30	YELLOW AFRICAN IRIS	Dietes bicolor	3 gai., 12' x 18', 18' o.c., full
58	'GREEN ISLAND' FICUS	Ficus 'Green Island'	3 gai., 18' x 18', 18' o.c., full
50	IXORA 'MAUI'	lxora spp. "Maui"	3 gal., 18' x 18', 18' o.c., full
80	PHILODENDRON	Philodendron bipinna. selloum	3 gal., 24" x 24", 24" <i>o.c.</i> , full
	TOPSOIL:SAND MIX		
@2 c.y.		PER ATLAS PEAT AND SOIL FOR	PLANTER BOXES
	BASED UPON 36" DEPTH, >	K 921 S.F. / 27 = 102 C.Y.	
: 10 c.y.	DRK BRUN RECYCLED MU		ACE, ATLAS PEAT AND SOIL
12° 0.g.			PPROVAL PRIOR TO INSTALLATION
	TOPSOIL, SOD AND I	MULCH QUANTITIES SHOWN ARE AF	PROXIMATE, CONTRACTOR
	TO PROVIDE A UNIT	PRICE PER UNIT AND WILL BE PA	AID ON THAT UNIT PRICE BASIS
	UPON FINAL INSPECT	ION AND APPROVAL.	
	ATERING:		
	CONTRACTOR SHALL	. THOROUGHLY WATER-IN ALL PL	ANTINGS WHEN PLANTED,
	AND SHALL CONTINU	IE WATERING UNTIL FINAL INSPECT	ION AND APPROVAL BY
	THE LOCAL GOVERN	ING AGENCY AND THE OWNER.	





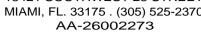

IN ASSOCIATION WITH:

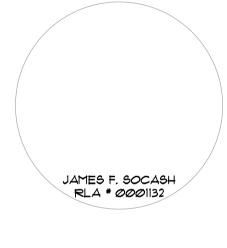

PROFESSIONAL SEAL:

PROJECT:


NEW 32 UNITS DEVELOPMENT AT: DOWNTOWN HOLLYWOOD


1914 - 1920 PIERCE STREET HOLLYWOOD, FL. 33020


DATE ISSUE DESCRIPTION 1 03.28.23 TAC COMMENTS

DRAWING INFORMATION: SHEET TITLE:

DELIVERY DATE:	02.13.2023
DRAWN BY:	J.B.
CHECKED BY:	A.LL.
REF NUMBER:	

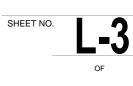


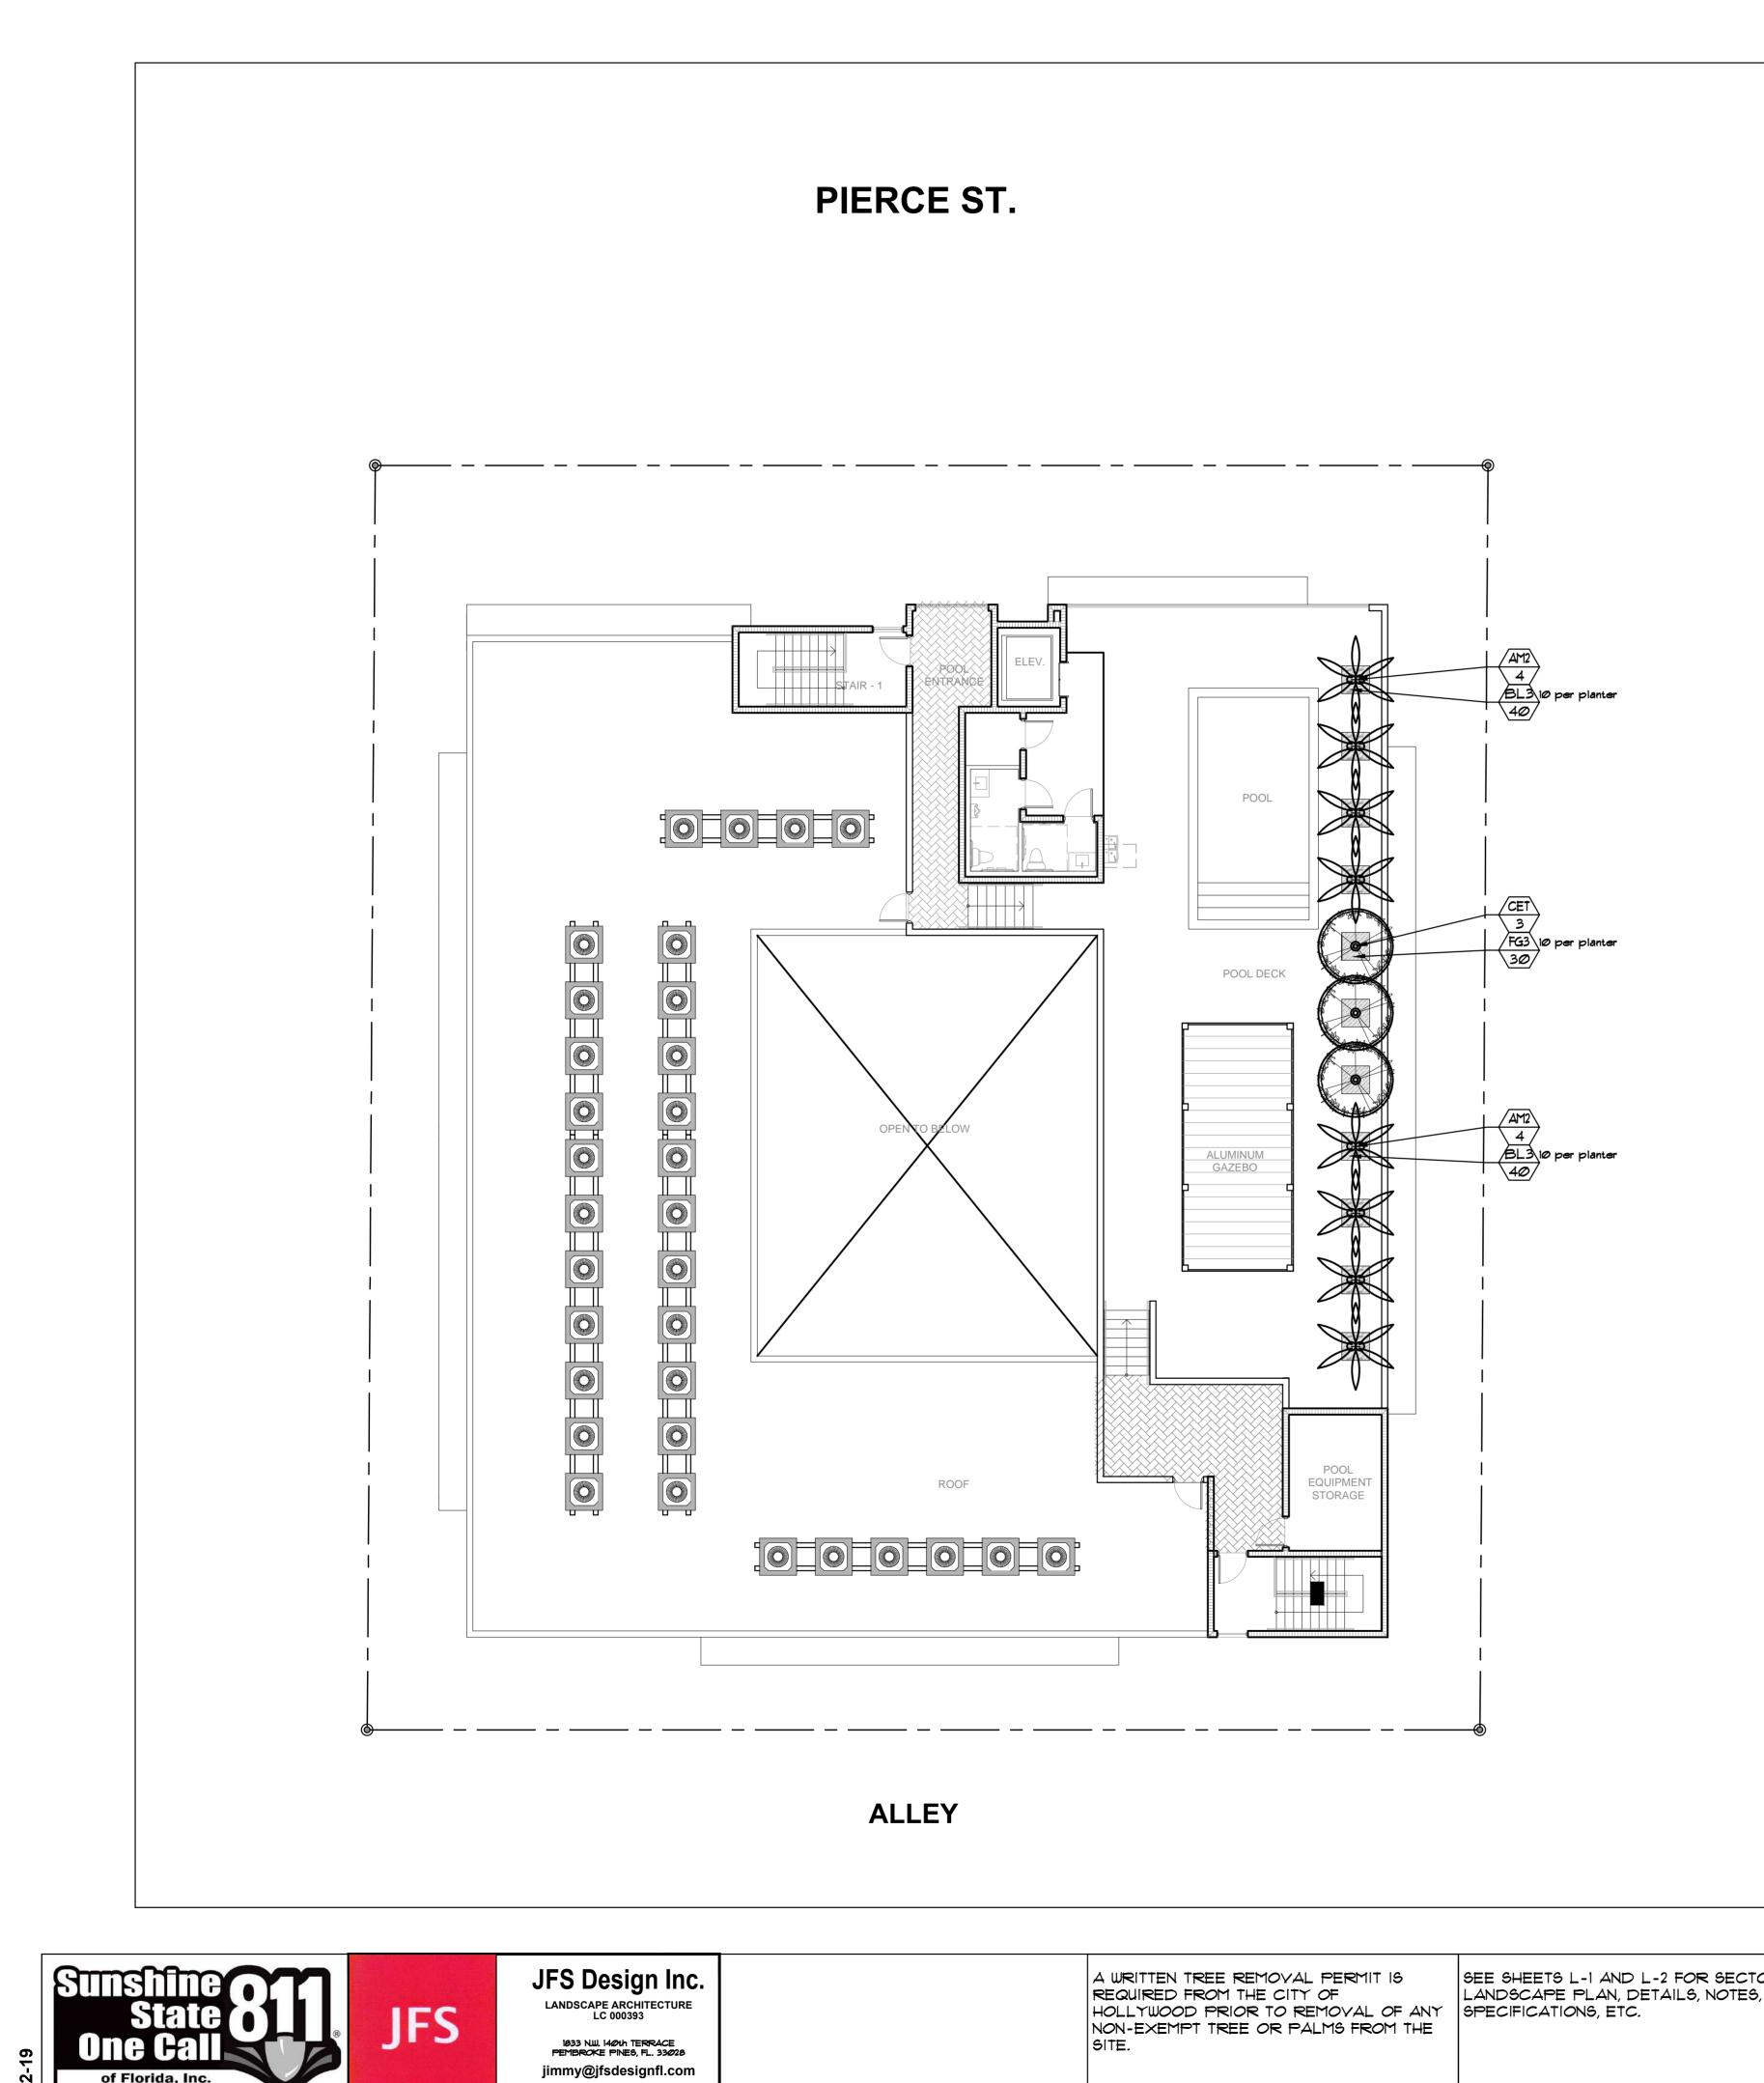

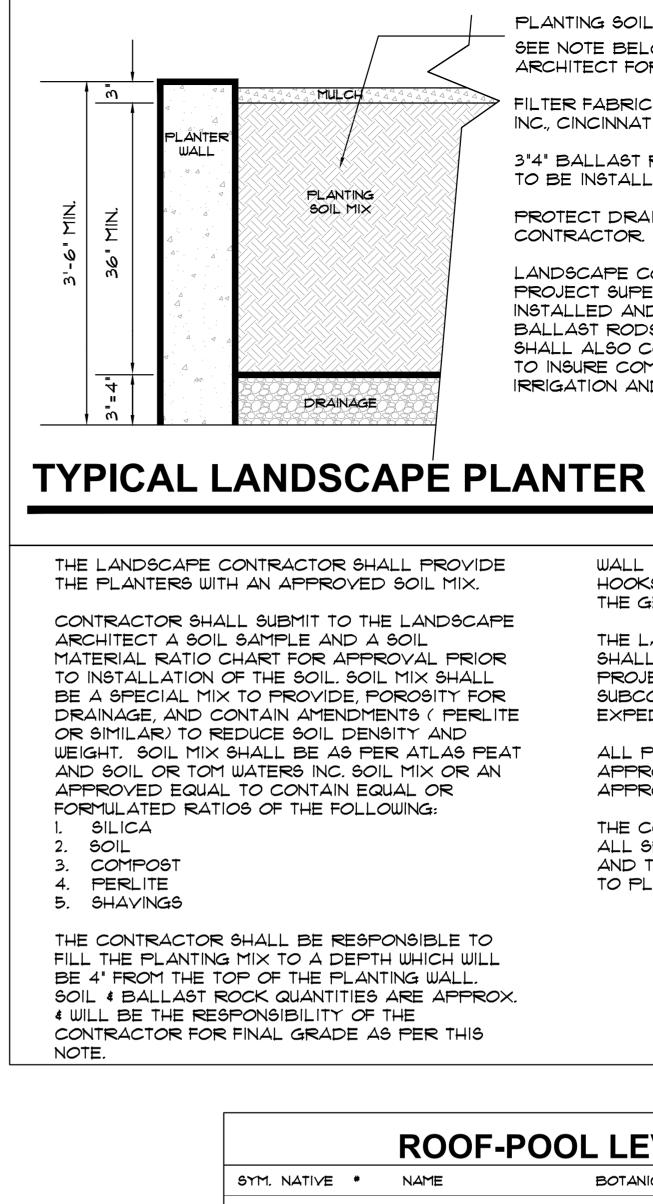

SYM. NATIVE
** TREES
CET YES
** PALMS
AM2
** ACCEN
BL3
FG3
TOPSOIL:
MULCHING:
INSTALLATI

SEE SHEETS L-1 AND L-2 FOR SECTOR

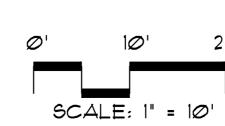



PLANTING SOIL:

SEE NOTE BELOW: PROVIDE SAMPLE TO LANDSCAPE ARCHITECT FOR APPROVAL PRIOR TO INSTALLATION.

FILTER FABRIC BY "POLY FILTER" BY CARTHAGE MILLES INC., CINCINNATI, OH., OR APPROVED EQUAL.

3"4" BALLAST ROCK OR APPROVED EQUAL 3"-4" DEPTH TO BE INSTALLED BY GENERAL CONTRACTOR.

PROTECT DRAINAGE PIPE AS INSTALLED BY CENERAL CONTRACTOR.

LANDSCAPE CONTRACTOR SHALL COORDINATE WITH THE PROJECT SUPERINTENDENT TO HAVE ALL DRAINAGE PIPE INSTALLED AND CONNECTED PRIOR TO BACKFILLING WITH BALLAST RODS, FILTER FABRIC, ETC. CONTRACTOR SHALL ALSO COORDINATE ALL IRRIGATION INSTALLATION TO INSURE COMPLETE OPERATION LOGISTICS REGARDING IRRIGATION AND DRAINAGE.

WALL IMPERMEABILIZATION, DRAINS AND EYE HOOKS SHALL BE PREPARED & INSTALLED BY THE GENERAL CONTRACTOR.

N.T.S.

THE LANDSCAPE AND IRRIGATION CONTRACTORS SHALL COORDINATE ALL WORK WITH THE PROJECT MANAGER AND ALL PERTINENT SUBCONTRACTORS TO INSURE A PROFESSIONAL EXPEDITIOUS PROCESS.

ALL PLANTING BEDS SHALL BE MULCHED WITH AN APPROVED RECYCLED MULCH, OR AN APPROVED EQUAL. SEE "LANDSCAPE NOTES".


THE CONTRACTOR SHALL SUBMIT PHOTOS FOR ALL SPECIMEN PLANT MATERIAL (ALL PALMS AND TREES) TO THE L.A. FOR APPROVAL PRIOR TO PLANTING.

		DL LEVEL PL	
= *	NAME	BOTANICAL NAME	SPECIFICATION
3	SILVER BUTTONWOOD	Conocarpus erec. 'Sericeus'	10' x 6', STANDARD
; 			
8	CHRISTMAS PALM	Adonidia merrillii	FG., 10' o.a., DBL., full head
115 ANI 80	D GROUNDCOVERS BLUEBERRY FLAX LILY	Dianella tasmanica	3 gal., 12' x 18', 18' o.c., full
30	'GREEN ISLAND' FICUS	Ficus 'Green Island'	3 gai., 18' x 18', 18' o.c., full
			3
	TOPSOIL:SAND MIX		
11 c.y.	'2100 MIX' FOR PLANTING-	PER ATLAS PEAT AND SOIL FOR	R PLANTER BOXES
	BASED UPON 36" DEPTH,	X 99 S.F. / 27 = 11 C.Y.	
:			
1 c.y.	DRK BRUN RECYCLED MU	LCH 3" DEPTH, SPREAD IN PL	ACE, ATLAS PEAT AND SOIL
		PROVIDE SAMPLE FOR A	APPROVAL PRIOR TO INSTALLATION
	TOPSOIL, SOD AND	MULCH QUANTITIES SHOWN ARE A	APPROXIMATE, CONTRACTOR
	TO PROVIDE A UNIT	PRICE PER UNIT AND WILL BE P	AID ON THAT UNIT PRICE BASIS
	UPON FINAL INSPEC	tion and Approval.	
	ATERING:		
	CONTRACTOR SHAL	L THOROUGHLY WATER-IN ALL PL	LANTINGS WHEN PLANTED,
	AND SHALL CONTINU	JE WATERING UNTIL FINAL INSPEC	TION AND APPROVAL BY

ROOF-POOL LEVEL LANDSCAPE PLAN



IN ASSOCIATION WITH:

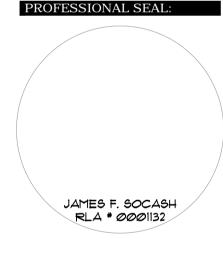

PROJECT:


NEW 32 UNITS DEVELOPMENT AT: DOWNTOWN HOLLYWOOD


1914 - 1920 PIERCE STREET HOLLYWOOD, FL. 33020

DATE ISSUE DESCRIPTION 1 03.28.23 TAC COMMENTS

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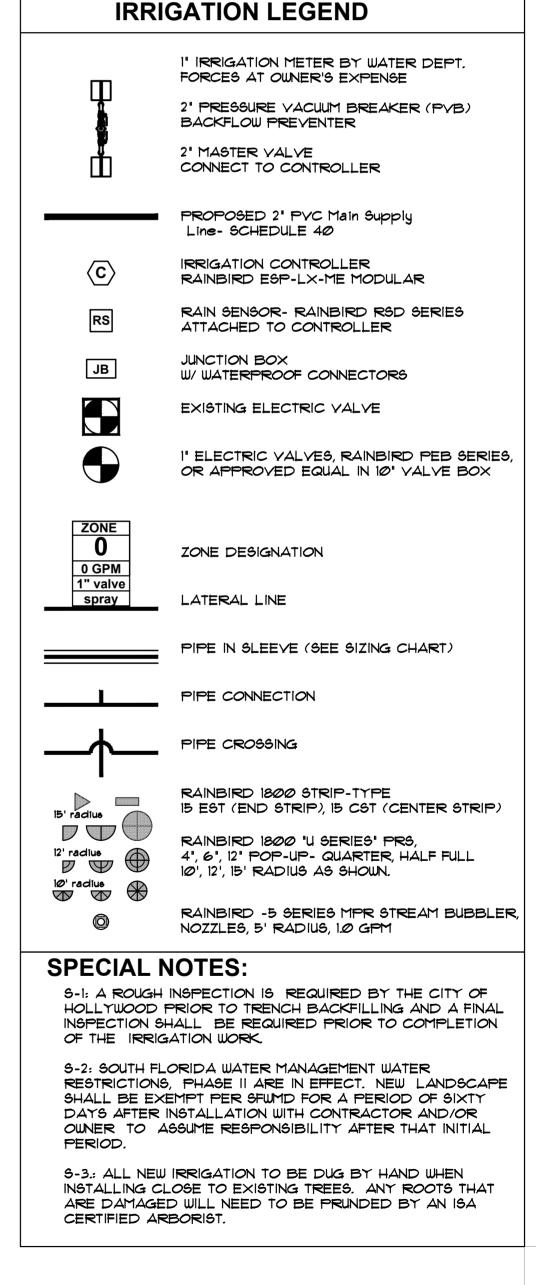
DELIVERY DATE: 02.13.2023 DRAWN BY J.B. CHECKED BY A.LL. REF NUMBER:



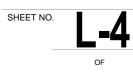

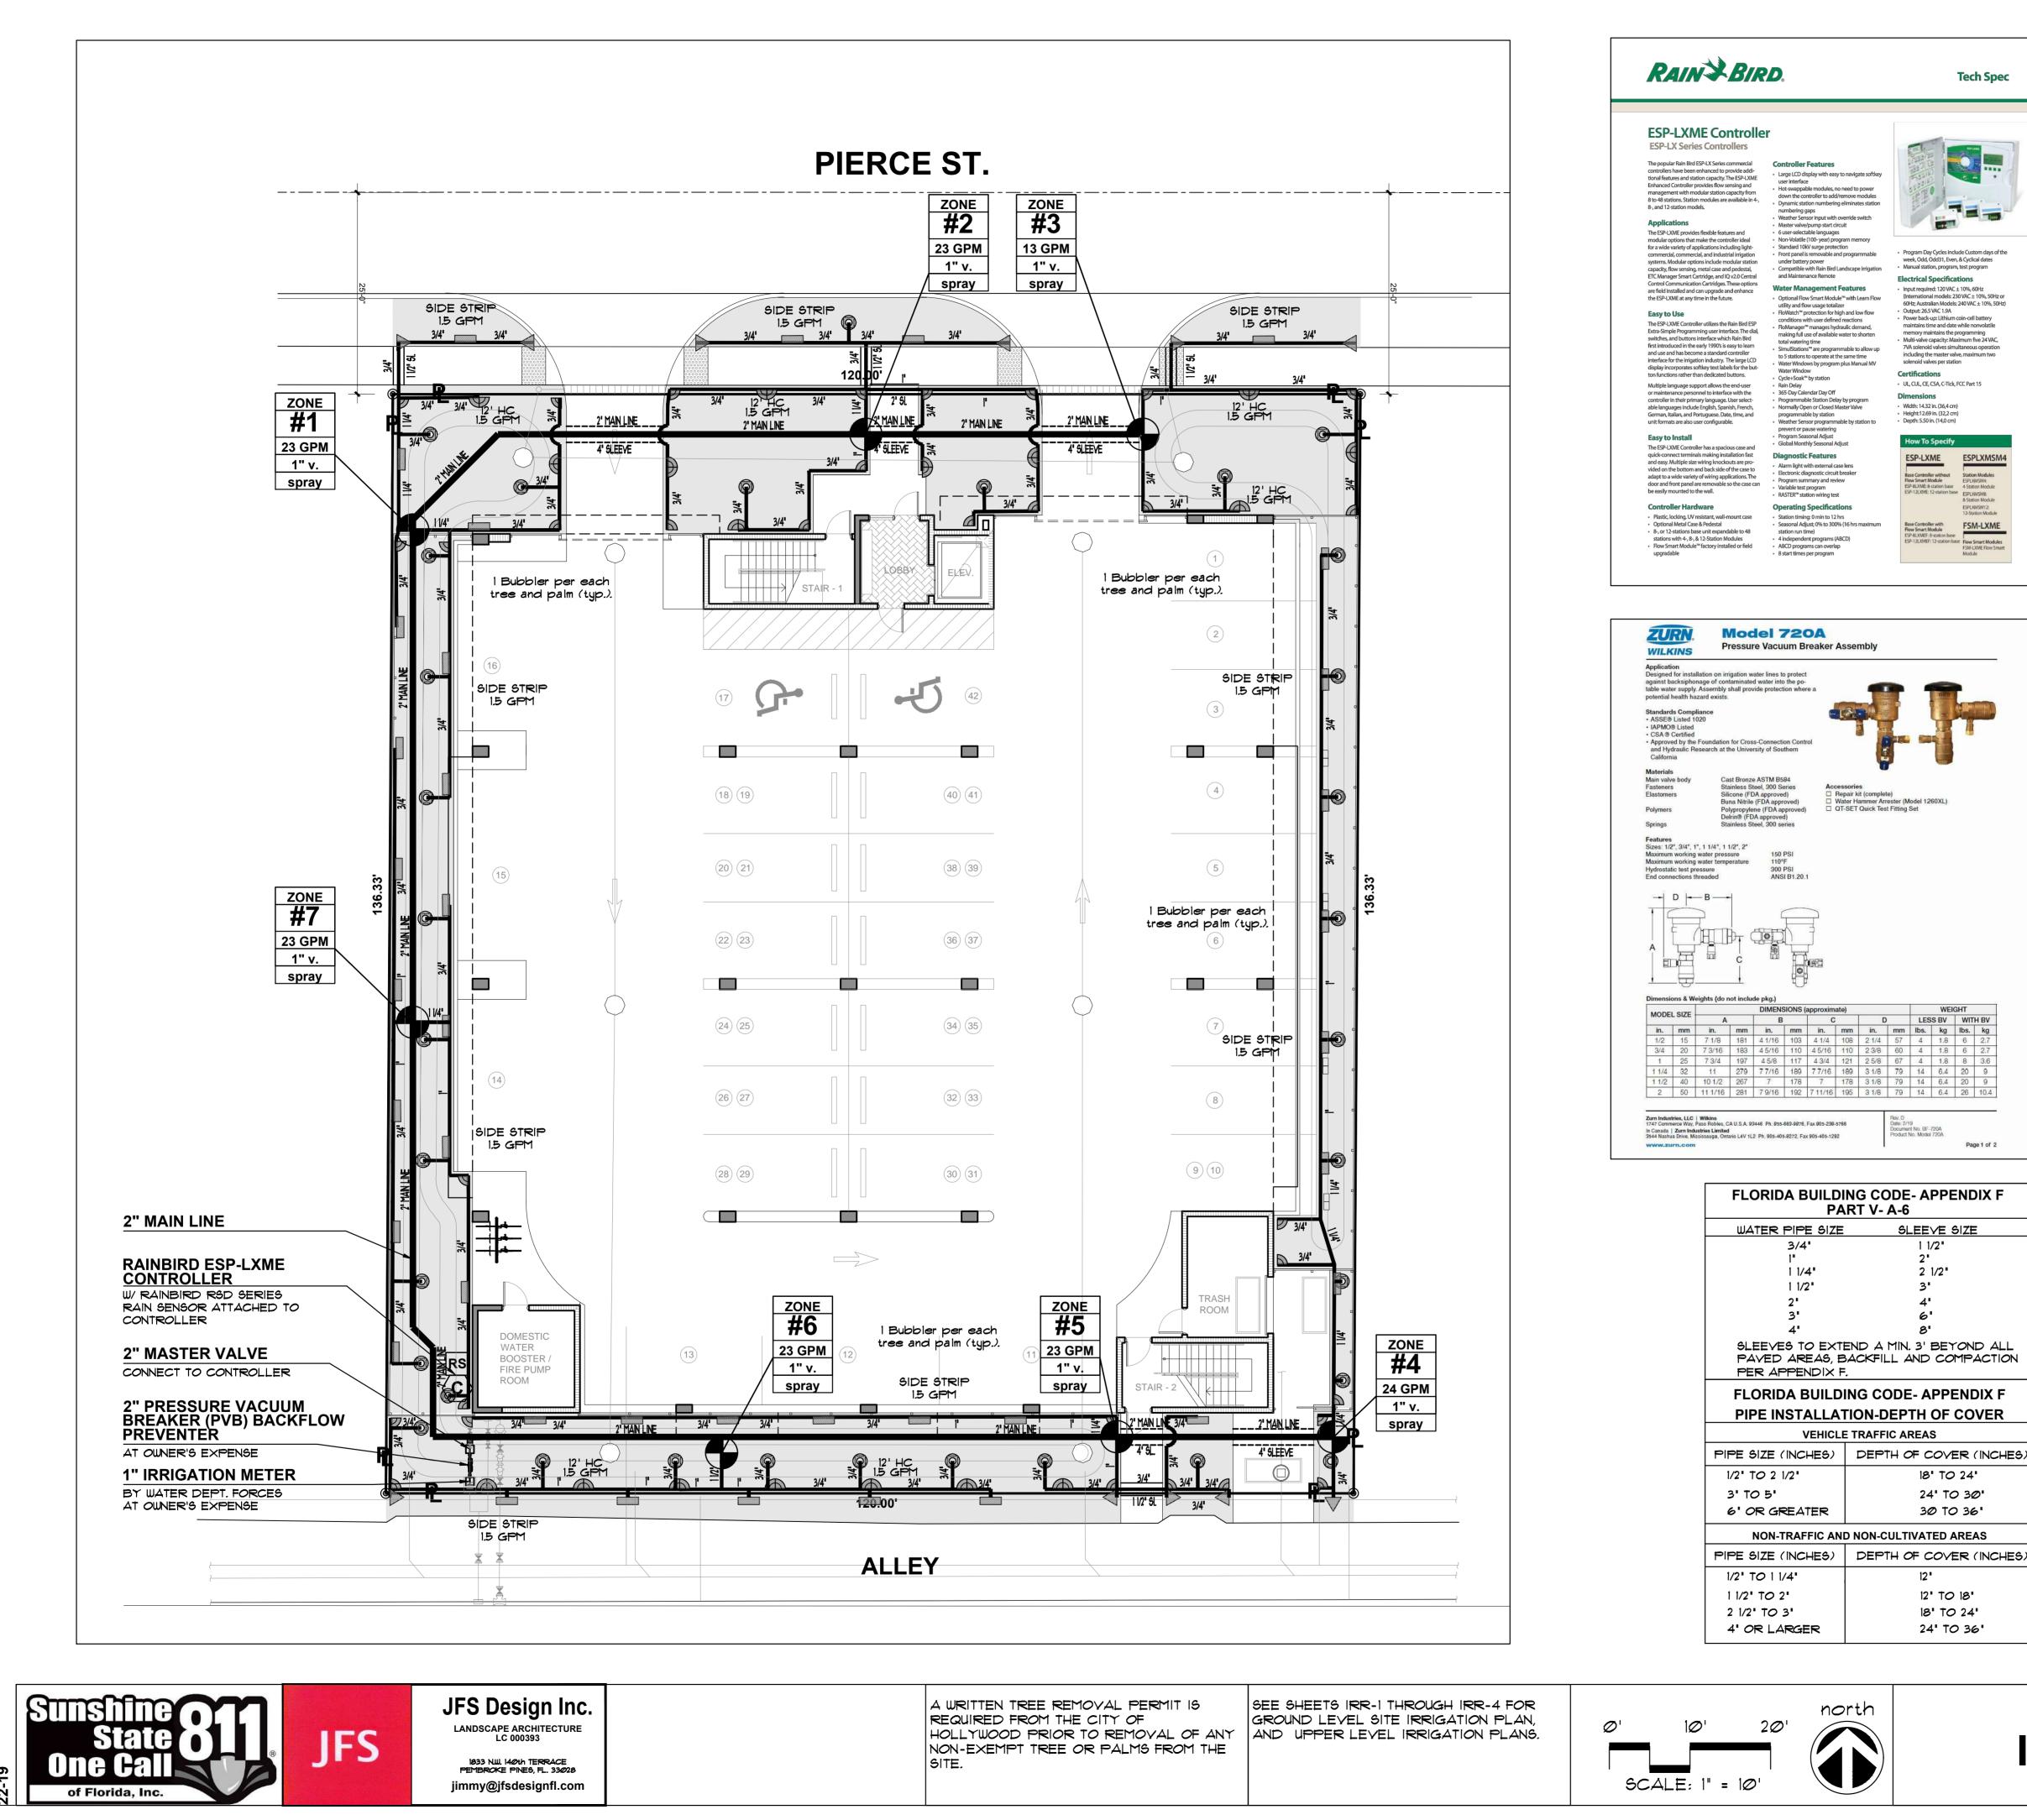

SITE **IRRIGATION PLAN**





RAIN BIRD.

Module features shall include a FloWatch Learn Flo

Module teatures shall include a HoWatch Leam How Utility which learns the normal flow rate of each sta-tion, Each time the station runs FloWatch compares the current real-time flow rate to the learned rate and takes user defined actions if high flow, low flow, or no flow is detected. FloWatch shall automatically determine the location of the flow urobitem and ico.

determine the location of the flow problem and late the problem by turning off the affected station master valve. FloWatch shall be compatible with bo

normally closed and open master valves. A Manual Master Valve Water Windows shall be provided to

coordinate day time manual watering with the flow

sensing. This Water Windows shall offer programma-ble days of the week and manual watering additional flow rate.

The controller shall have an alarm indicator light or

the front paral visible through the outer door with the front paral visible through the outer door with the door closed and locked. The alarm light shall prompt the user to select the alarm softkey to revie the alarm condition(\$).

The controller shall be compatible with the ETC-LX ET

Manager Cartridge which upgrades the controller to a Smart controller. A weather service signal received by the cartridge shall automatically adjust the individual controller program day cycles and station run times to

apply the minimum amount of water required based

The controller shall be compatible with the IQ v2.0

Central Control System utilizing IQ-NCC Network

Communication Cartridges. The IQ-NCC Cartridge shall provide communication with the IQ Central Computer and other controllers via a variety of

Computer and other controllers via a variety of communication options (Direct Connect Cable, Phone, GPRS/Cellular, Ethernet, Wiff, Radio, and QIWe Communication Cable). The IQ v2.0 Central Control System shall provide remote computer control of the controller providing automatic or manual program adjustments.

The controller shall offer an optional metal cabinet

The controller shall be as manufactured by Rain Bird

D40030EO

adjustments.

and pedestal.

Rain Bird International, Inc.

1000 West Sierra Madre Ave.

Azusa, CA 91702

www.rainbird.com

Phone: (626) 963-9311 Fax: (626) 852-7343

The Intelligent Use of Water

Corporation.

on the current plant water requirements.

day cycle. (Custom, Even, Odd, Odd31, & Cyclical). ycle. (Custom, Even, Odd, Odds), or Cyclicall, set to Permanent Day Off shall override the nal repeating schedule and not water on the cified day(s) of the week. The controller shall also

Ave a Calendar Day Off Beature allowing the user to select up to 5 dates up to 365-days in the future when the controller shall not start programs. The controller shall incorporate a Rain Delay feature allowing the user to set the number of days the controller should matched Refuse not exercise the auto

remain off before automatically returning to the auto

The controller shall have Cycle+Soak water manage-ment software which is capable of operating each sta-

tion for a maximum cycle time and a minimum soak

ime to reduce water run-off. The maximum cycle

feature providing real-time flow, power, and station management. FloManager shall manage the number of stations operating at any point in time based on water source capacity, station flow rate, number of the source capacity.

valves per station; user-defined simultaneous stations per program and for the controller. FloManager shall incorporate the ability to provide station priorities to

determine the order in which stations shall operate.

instead operate the highest priority stations first and the lower priority stations last when FloManager

is enabled. FloManager shall be an option that is disabled by default and the controller shall operate

zones in order of station number, started with the

The nights infinite 2016: The controller shall offer Water Windows for each program. This function sets the allowed start and stop time where watering is allowed. If the watering cannot be completed by the time the Water Window closes, the stations with remaining run time are paused and watering automatically resumes when the Water Window opens the next time.

The controller shall offer a Flow Smart Module option

which adds flow sensing functionality. The Flow

input from a flow sensor with no flow scaling device

Smart Module sensor input shall accept a direct

the highest number zone.

Rain Bird Corporation

Phone: (626) 812-3400

Azusa, CA 91702

Fax: (626) 812-3411

970 West Sierra Madre Avenue

Specification Hotline 800-458-3005 (U.S. and Canada)

time shall not extended by Seasonal Adjustment.

The controller shall incorporate a FloManager

mode.

Seasonal Adjustment of 0 to 300% by month. Station The controller shall ignore the station number and

required.

Tech Spec

- + + C

Program Day Cycles include Custom days of the

week. Odd. Odd31. Even. & Cyclical dates

(International models: 230 VAC ± 10%, 50Hz of 60Hz; Australian Models: 240 VAC ± 10%, 50Hz

Output: 26.5 VAC 1.9A
 Power back-up: Lithium coin-cell battery maintains time and date while nonvolatile

memory maintains the programming

Multi-valve capacity: Maximum five 24 VAC

7VA solenoid valves simultaneous operati

including the master valve, maximum two solenoid valves per station

UL CUL CE, CSA, C-Tick, FCC Part 15

How To Specify

ESP-LXME ESPLXMSM4

Base Controller without Flow Smart Module ESP-8LXME:8-station base ESP-12LXME:12-station base 8-Station Module ESP-22LXME:8-station base 8-Station Module 8-Station Module

ESPLXMSM12: 12-Station Module

FSM-LXME

base Flow Smart Modules FSM-LXME Flow Smart Module

Certifications

Dimensions

Width: 14.32 in. (36,4 cm)

Depth: 5.50 in. (14.0 cm)

Base Controller with Flow Smart Module ESP-8LXMEF: 8-station bar ESP-12LXMEF: 12-station

Document No. BF-720A Product No. Model 720A

SLEEVE SIZE 1 1/2"

2 1/2"

18" TO 24"

24" TO 3Ø'

30 TO 36'

12" TO 18"

18" TO 24"

24' TO 36'

12"

3"

Page 1 of 2

Height:12.69 in. (32,2 cm)

Manual station, program, test program

Input required: 120 VAC ± 10%, 60Hz

Electrical Specifications

Specifications

The ESP-LXME Controller shall be of a hybrid type that

combines electro-mechanical and microelectronic cir-cuitry capable of fully automatic or manual operation. The controller shall be housed in a wall-mountable, weather-resistant plastic cabinet with a key-locking cabinet door suitable for either indoor or outdoor installation. The controller shall have the ability to housement med and ensettal in zer use of for

be programmed and operated in any one of six languages: English, Spanish, French, German, Italian, & Portuguese. The display shall show programming

options and operating instructions in the chosen language without altering the programming or operation information.

The controller shall have a base station capacity of

The controller shall have a base station capacity of 8 or 12 stations as well as 3 expansion slots capable of receiving station modules of 4, 8, or 12 stations to create a controller capacity of up to 48 stations. All stations shall have the capability of independently obeying or ignoring the weather sensor as well as using or not using the master valve. Station timing shall be from 0 minutes to 12 hours. The controller shall have a Seasonal Adjustment by program which adjusts the station run time from 0 to 300% in 1% increments. The controller shall also have a Monthly Seasonal Advisormed for Lo 300% by mooth. Station

timing with Seasonal Adjustment shall be from 1 second to 16 hours.

The controller shall have 4 separate and independent

The controller shall have 4 separate and independent programs which can have different start times, start day cycles, and station run times. Each program shall have up to 8 start times per day for a total of 32 possible start times per day. The 4 programs shall be allowed to overlap operation based on user defined settings which control the number of simultaneous stations per program and total for the controller. The controller shall allow up to 5 valves to operate imultaneous up on program and total for the controller.

simultaneously per program and total for the contro

ler including the master valve/pump start circuit. The controller shall have an electronic, diagnostic circuit breaker that shall sense a station with an electrical

overload or short circuit and shall bypass that station

The controller shall have a 365-day calendar with

Permanent Day Off feature that allows a day(s) of the week to be turned off on any user selected program

and continue to operate all other stations.

Rain Bird Corporation 6991 E. Southpoint Road Tucson, AZ 85756

Phone: (520) 741-6100

Rain Bird Technical Services (800) RAINBIRD (1-800-724-6247)

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Fax: (520) 741-6522

(U.S. and Canada)


IN ASSOCIATION WITH:

PROFESSIONAL SEAL: JAMES F. SOCASH RLA * 0001132

PROJECT:

NEW 32 UNITS DEVELOPMENT AT: DOWNTOWN HOLLYWOOD


1914 - 1920 PIERCE STREET HOLLYWOOD, FL. 33020

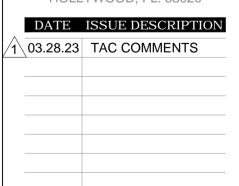

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DELIVERY DATE:	02.13.2023
DRAWN BY:	J.B.
CHECKED BY:	A.LL.
REF NUMBER:	



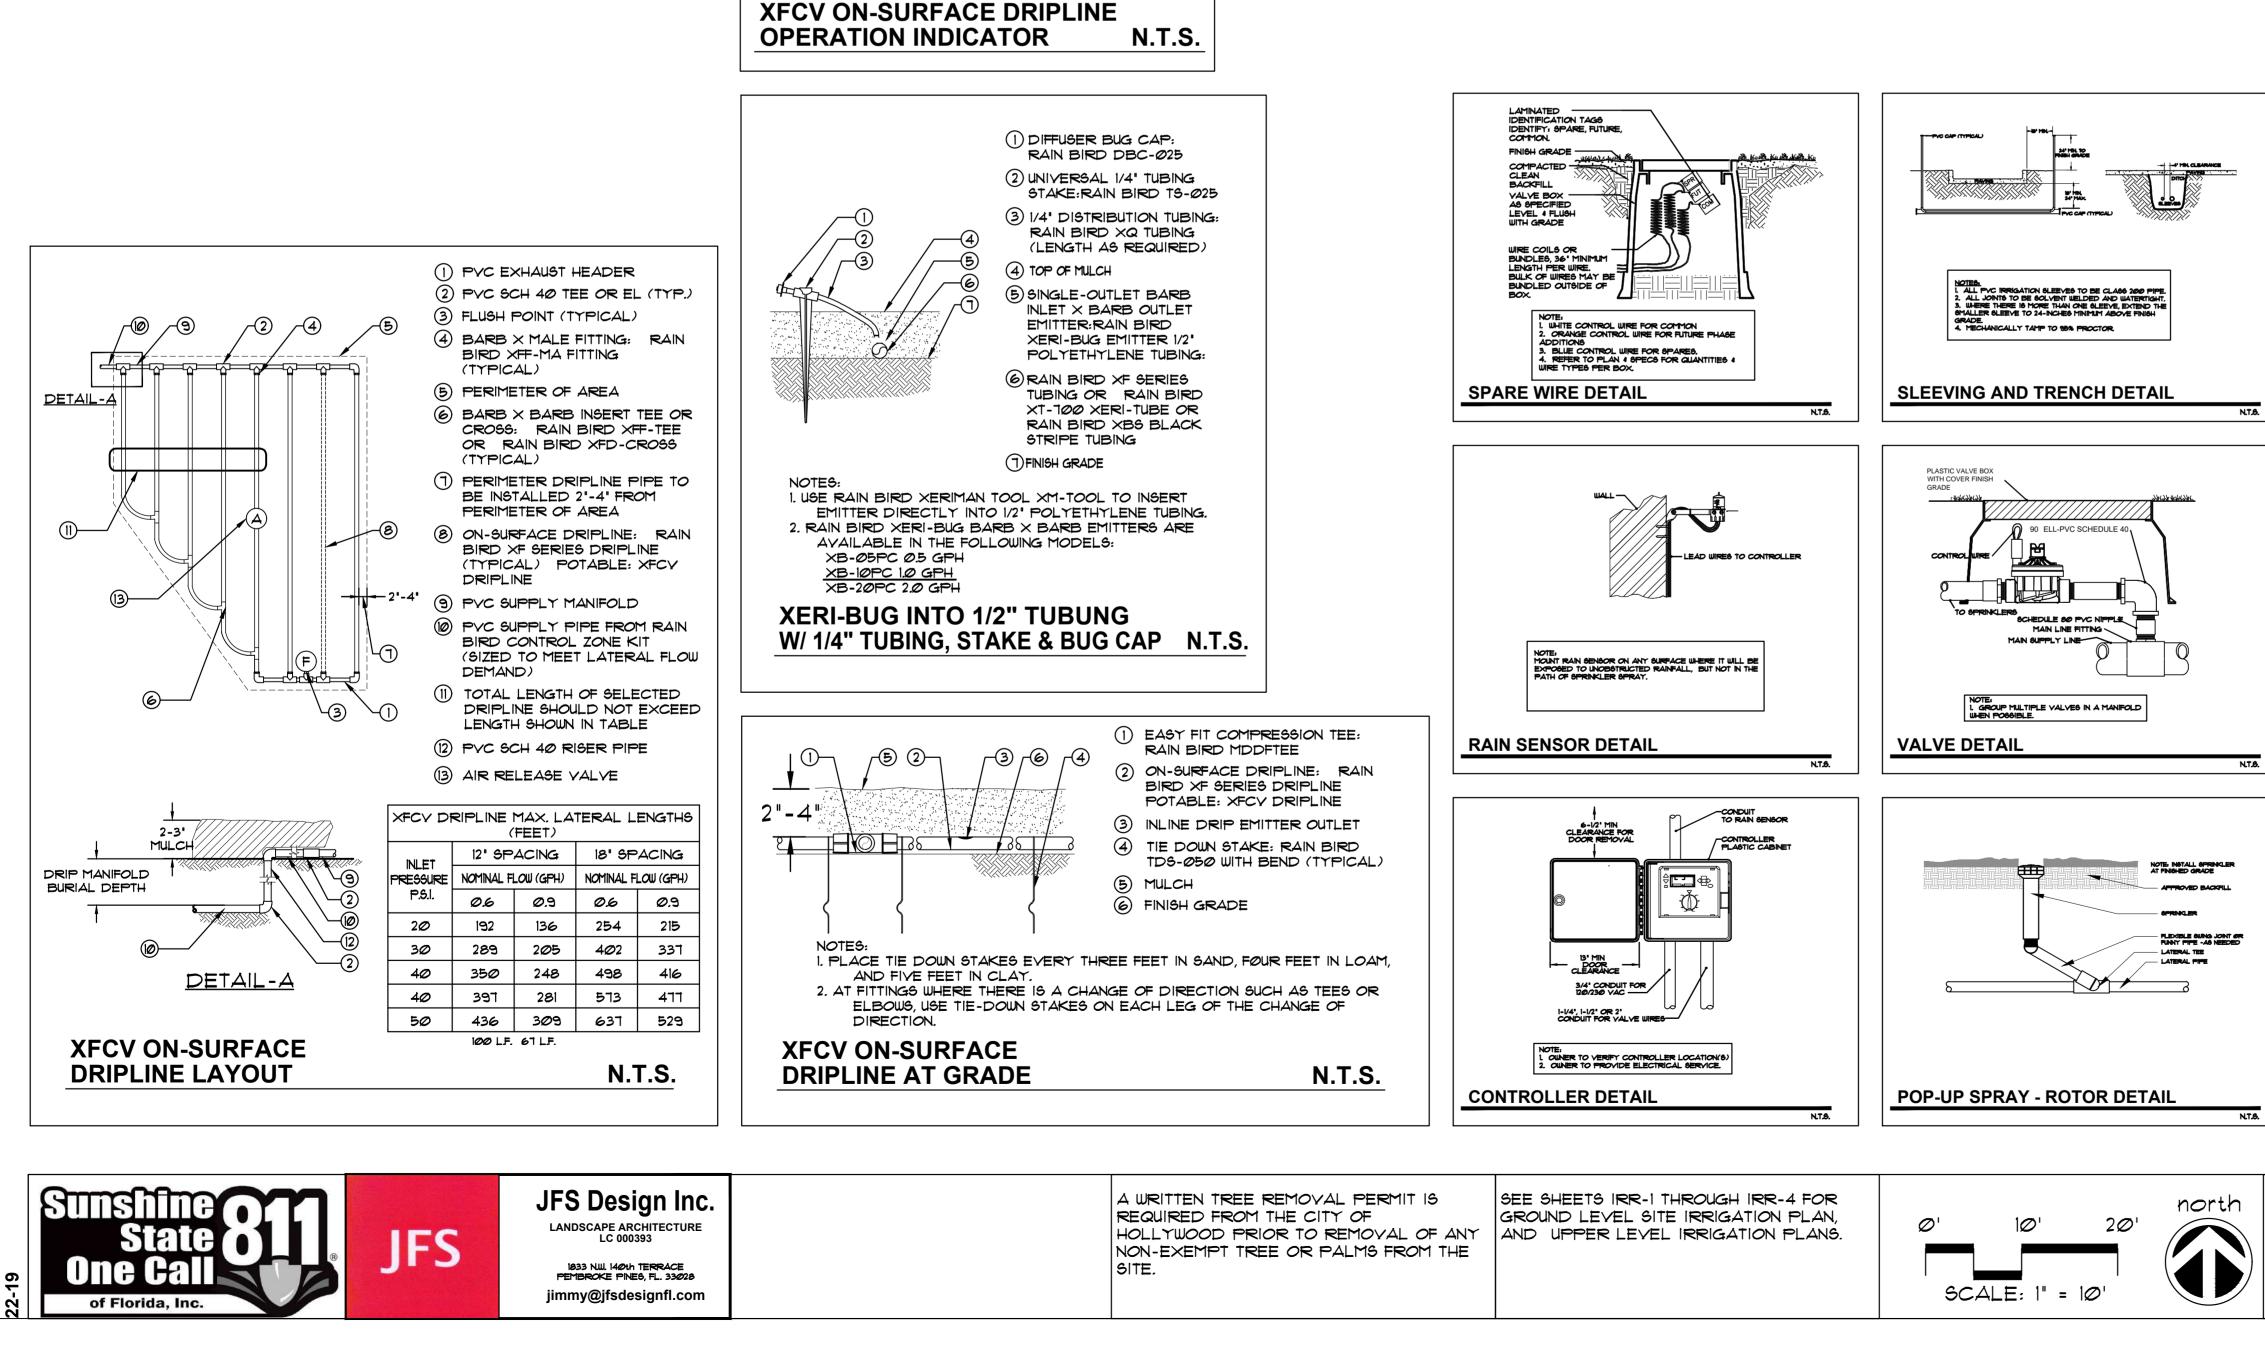

() MULCH (2)-2) FINISH GRADE (**3**)— 3 OPERATION INDICATOR RAIN BIRD MODEL: OPERIND (4) ON-SURFACE DRIPLINE: RAIN BIRD XF SERIES DRIPLINE POTABLE: XFCY SERIES NOTE: 1. USE XERIMAN TOOL XM-TOOL TO INSERT BARB TRANSFER FITTING DIRECTLY INTO DRIPLINE TUBING. 2. VAN NOZZLE MAY BE SET TO CLOSED, OR IF IT IS DESIRED TO SEE SPRAY FROM THE NOZZLE, SET THE ARC TO 1/4 PATTERN. THE FLOW FROM THE NOZZLE, Ø.3 GPM, SHOULD BE ACCOUNTED FOR IN THE SYSTEM DESIGN.

 \bigcirc

	GENERAL IRRIGATION NOTES
1.	IRRIGATION CONTRACTOR SHALL PROVIDE, FURNISH AND INSTALL A FULLY AUTOMATIC IRRIGATION SYSTEM WHICH WILL COMPLY WITH ALL LOCAL CODE, STATE CODE & FLORIDA WATER
_	MANAGEMENT DISTRICT (SFWMD) REQUIREMENTS.
2.	THE IRRIGATION CONTRACTOR SHALL SCHEDULE AN ON-SITE PRE-CONSTRUCTION CONFERENCE WITH THE OWNER & THE OWNER'S AUTHORIZED REPRESENTATIVE PRIOR TO COMMENCEMENT OF INSTALLATION OF THE IRRIGATION SYSTEM.
3.	CONTRACTOR SHALL INSTALL A POP-UP TYPE HEADS. SPRAY TYPE SHALL BE ROTOR, IMPACT, SPRAY OR BUBBLER AND SHALL BE SO INSTALLED TO NOT CAUSE ANY OVERSPRAY ONTO ANY PAVED SURFACES, I.E. ROADS, SIDEWALKS, ETC. ALL FIXTURES SHALL BE "TORO", "RAINBIRD" OR AN APPROVED EQUAL. ALL WORK SHALL BE DONE IN A PROFESSIONAL MANNER AND AS PER THE MANUFACTURER'S SPECIFICATIONS. SPRAY HEADS SHALL BE 4" POP-UPS FOR SODDED AREAS, 6" FOR GROUNDCOVER PLANTINGS AND 12" POP-UPS FOR ALL PLANTING AND SHRUB BEDS. SPRAY HEADS ON RISERS SHALL ONLY BE PERMITTED PER THE LAND. ARCH.
4.	ALL MAIN SUPPLY LINE SHALL BE PVC SCHEDULE 40 PIPE. ALL PVC FITTINGS SHALL BE SCHEDULE 40. THE MAIN LINE IS SHOWN SCHEMATICALLY. LOCATE MAIN LINES IN LANDSCAPE AREAS WHERE POSSIBLE AND SLEEVE UNDER PAVEMENT WHERE NECESSARY. MAIN LINES SHALL BE IN THE SAME TRENCH WITH LATERAL LINES WHERE POSSIBLE.
5.	CONTRACTOR SHALL CONSTRUCT CONCRETE THRUST BLOCKS, 12" X 12" X 12" AT ALL "T" INTERSECTIONS OR BENDS 45 DEGREES OR GREATER ON THE MAIN LINE.
6.	MINIMUM PIPE SIZE SHALL BE 3/4" PIPE.
7.	CONTRACTOR SHALL FAMILIARIZE HIMSELF WITH THE LOCATION OF AND AVOID & PROTECT ALL UTILITY LINES, DUCTS, BURIED CABLES AND OTHER UTILITIES IN THE AREA. CONTRACTOR WILL BE RESPONSIBLE FOR THE REPAIR, LIABILITY AND COSTS INCURRED IN THE DAMAGE OR DESTRUCTION OF SAID UTILITIES. CALL U.N.C.L.E. 1(800) 432-8770, 48 HOURS PRIOR TO COMMENCENT OF ANY WORK FOR PROPER UTILITY LOCATION AND CLEARANCES.
8.	THE CONTRACTOR SHALL SECURE ALL WORK WITH THE PROJECT MANAGER, LANDSCAPE CONTRACTOR AND ALL OTHER CONTRACTORS TO INSURE PROPER INSTALLATION, SCHEDULING AND PROCEDURE.
9.	THE CONTRACTOR SHALL COORDINATE WITH THE PROJECT MANAGER TO PROVIDE ELECTRICAL SUPPLY TO THE CONTROLLER, PUMP, ETC. AS NEEDED.
10.	THE CONTRACTOR SHALL BE RESPONSIBLE TO SECURE ALL PERMITS AS MAY BE DEEMED NECESSARY TO PERFORM THE WORK. ENTIRE SYSTEM SHALL BE INSTALLED IN COMPLIANCE WITH ALL LOCAL AND STATE CODES. THE OWNER IS RESPONSIBLE FOR ALL PERMIT FEES.
11.	ALL SLEEVES UNDER PAVEMENT SHALL BE BURIED PER FL. BLDG CODE, APPENDIX "F". ALL LATERAL SLEEVES UNDER SIDEWALKS SHALL BE BURIED BELOW WALKWAYS AND SHALL BE SCHEDULE 40 PVC. ALL SLEEVING SHALL BE SCHEDULE 40 PVC PIPE & SHALL BE 2 TIMES THE MAIN OR LATERAL PIPE SIZE.
12.	THE CONTRACTOR SHALL CONNECT THE MASTER VALVE (WHEN APPLICABLE) & ALL ELECTRIC VALVES TO THE CONTROLLER & PROVIDE PROPER SYNCHRONIZATION.
13.	ALL LOW-VOLTAGE ELECTRIC VALVES SHALL BE #14 DIRECT BURIAL. ALL WIRES UNDER ROADS TO BE PLACED IN A SEPARATE 1" SLEEVE. CONTRACTOR SHALL PROVIDE A MINIMUM OF 2 EXTRA WIRES FOR EMERGENCY POST-INSTALLATION WIRING.
14.	ALL LINE LOCATIONS ARE APPROXIMATE. CONTRACTOR SHALL ADJUST TRENCHING AND LOCATION OF SPRAY HEADS IN THE FIELD FOR EXISTING CONDITIONS, WALKS, UTILITIES, STRUCTURES & PLANTINGS TO PROVIDE AND INSURE 100% COVERAGE AND 100% OVERLAP.
15.	CONTRACTOR SHALL PROVIDE A ONE-YEAR GUARANTEE ON ALL PARTS AND A 90-DAY GUARANTEE ON LABOR FROM THE DATE OF FINAL ACCEPTANCE.
16.	THE IRRIGATION CONTRACTOR SHALL RECORD ALL CHANGES MADE TO THE IRRIGATION SYSTEM DURING INSTALLATION, & PROVIDE AN AS-BUILT DRAWING TO THE OWNER'S REPRESENTATIVE UPON COMPLETION AND ACCEPTANCE OF THE WORK.
17.	THE IRRIGATION CONTRACTOR SHALL INSTRUCT THE OWNER OR THE OWNER'S REPRESENTATIVE IN THE COMPLETE OPERATION & MAINTENANCE OF THE SYSTEM. THE CONTRACTOR SHALL FURNISH TWO (2) COPIES OF AN IRRIGATION SYSTEM MANAGEMENT MANUAL PREPARED BY THE MANUFACTURER & THE SYSTEM INSTALLER.
18.	THE IRRIGATION CONTRACTOR SHALL CHECK AND ADJUST THE SYSTEM AT THE END OF THE 90-DAY PERIOD, FROM THE DATE OF FINAL ACCEPTANCE.
19.	ANY IRRIGATION PIPING WITHIN THE CONFINES OF ANY BUILDING SHALL BE CLEARLY MARKED "NON POTABLE WATER".
20.	TREE AND PALM PLANTINGS IN RIGHTS OF WAYS SHALL HAVE ONE FLOOD BUBBLER PER TREE OR PALM. COORDINATE PIPING AND SEEVING AS NEEDED.



IN ASSOCIATION WITH:



PROFESSIONAL SEAL:



PROJECT:

NEW 32 UNITS DEVELOPMENT AT: DOWNTOWN HOLLYWOOD

1914 - 1920 PIERCE STREET


HOLLYWOOD, FL. 33020 DATE ISSUE DESCRIPTION 1 03.28.23 TAC COMMENTS

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IRRIGATION DETAILS, SPECIFICATIONS, ETC.





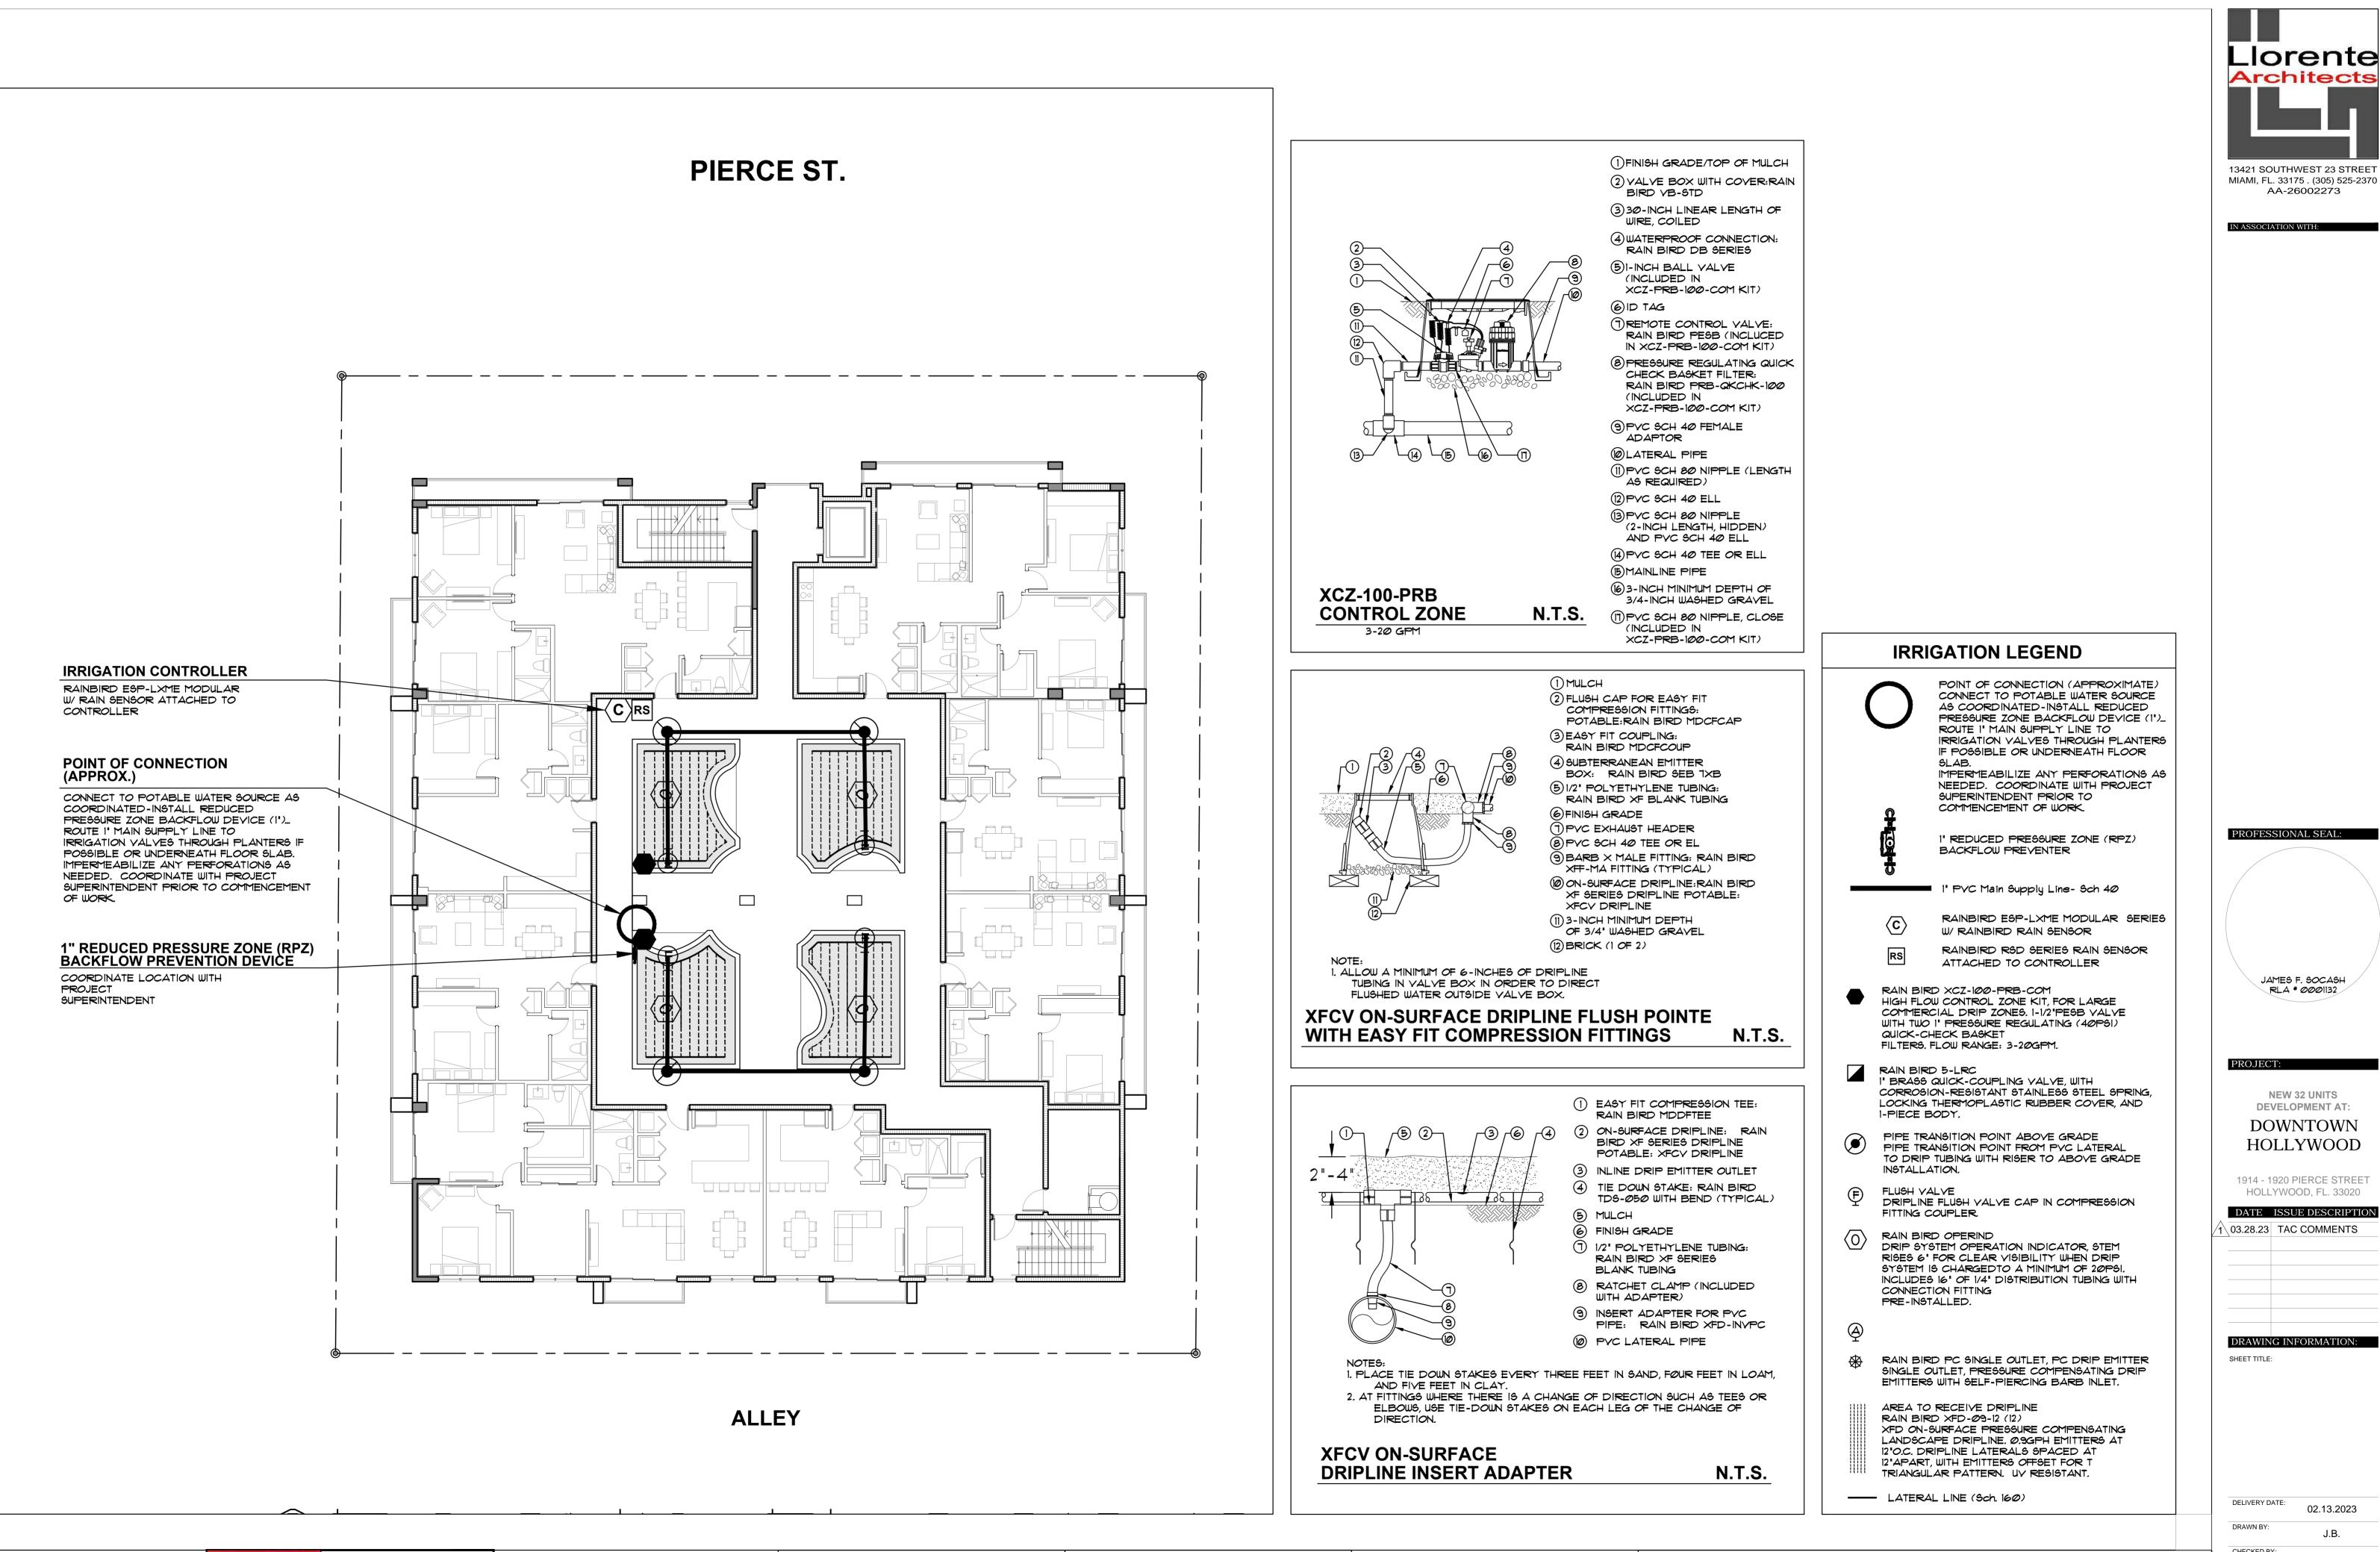


IFS

1833 N.W. 140th TERRACE PEMBROKE PINES, FL. 33028 jimmy@jfsdesignfl.com

A WRITTEN TREE REMOVAL PERMIT IS REQUIRED FROM THE CITY OF HOLLYWOOD PRIOR TO REMOVAL OF ANY NON-EXEMPT TREE OR PALMS FROM THE SITE.


SEE SHEETS IRR-1 THROUGH IRR-4 FOR GROUND LEVEL SITE IRRIGATION PLAN, AND UPPER LEVEL IRRIGATION PLANS.

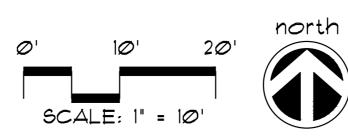


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CHECKED BY:	A.LL.
REF NUMBER:	



SECOND LEVEL COURTYARD **IRRIGATION PLAN**

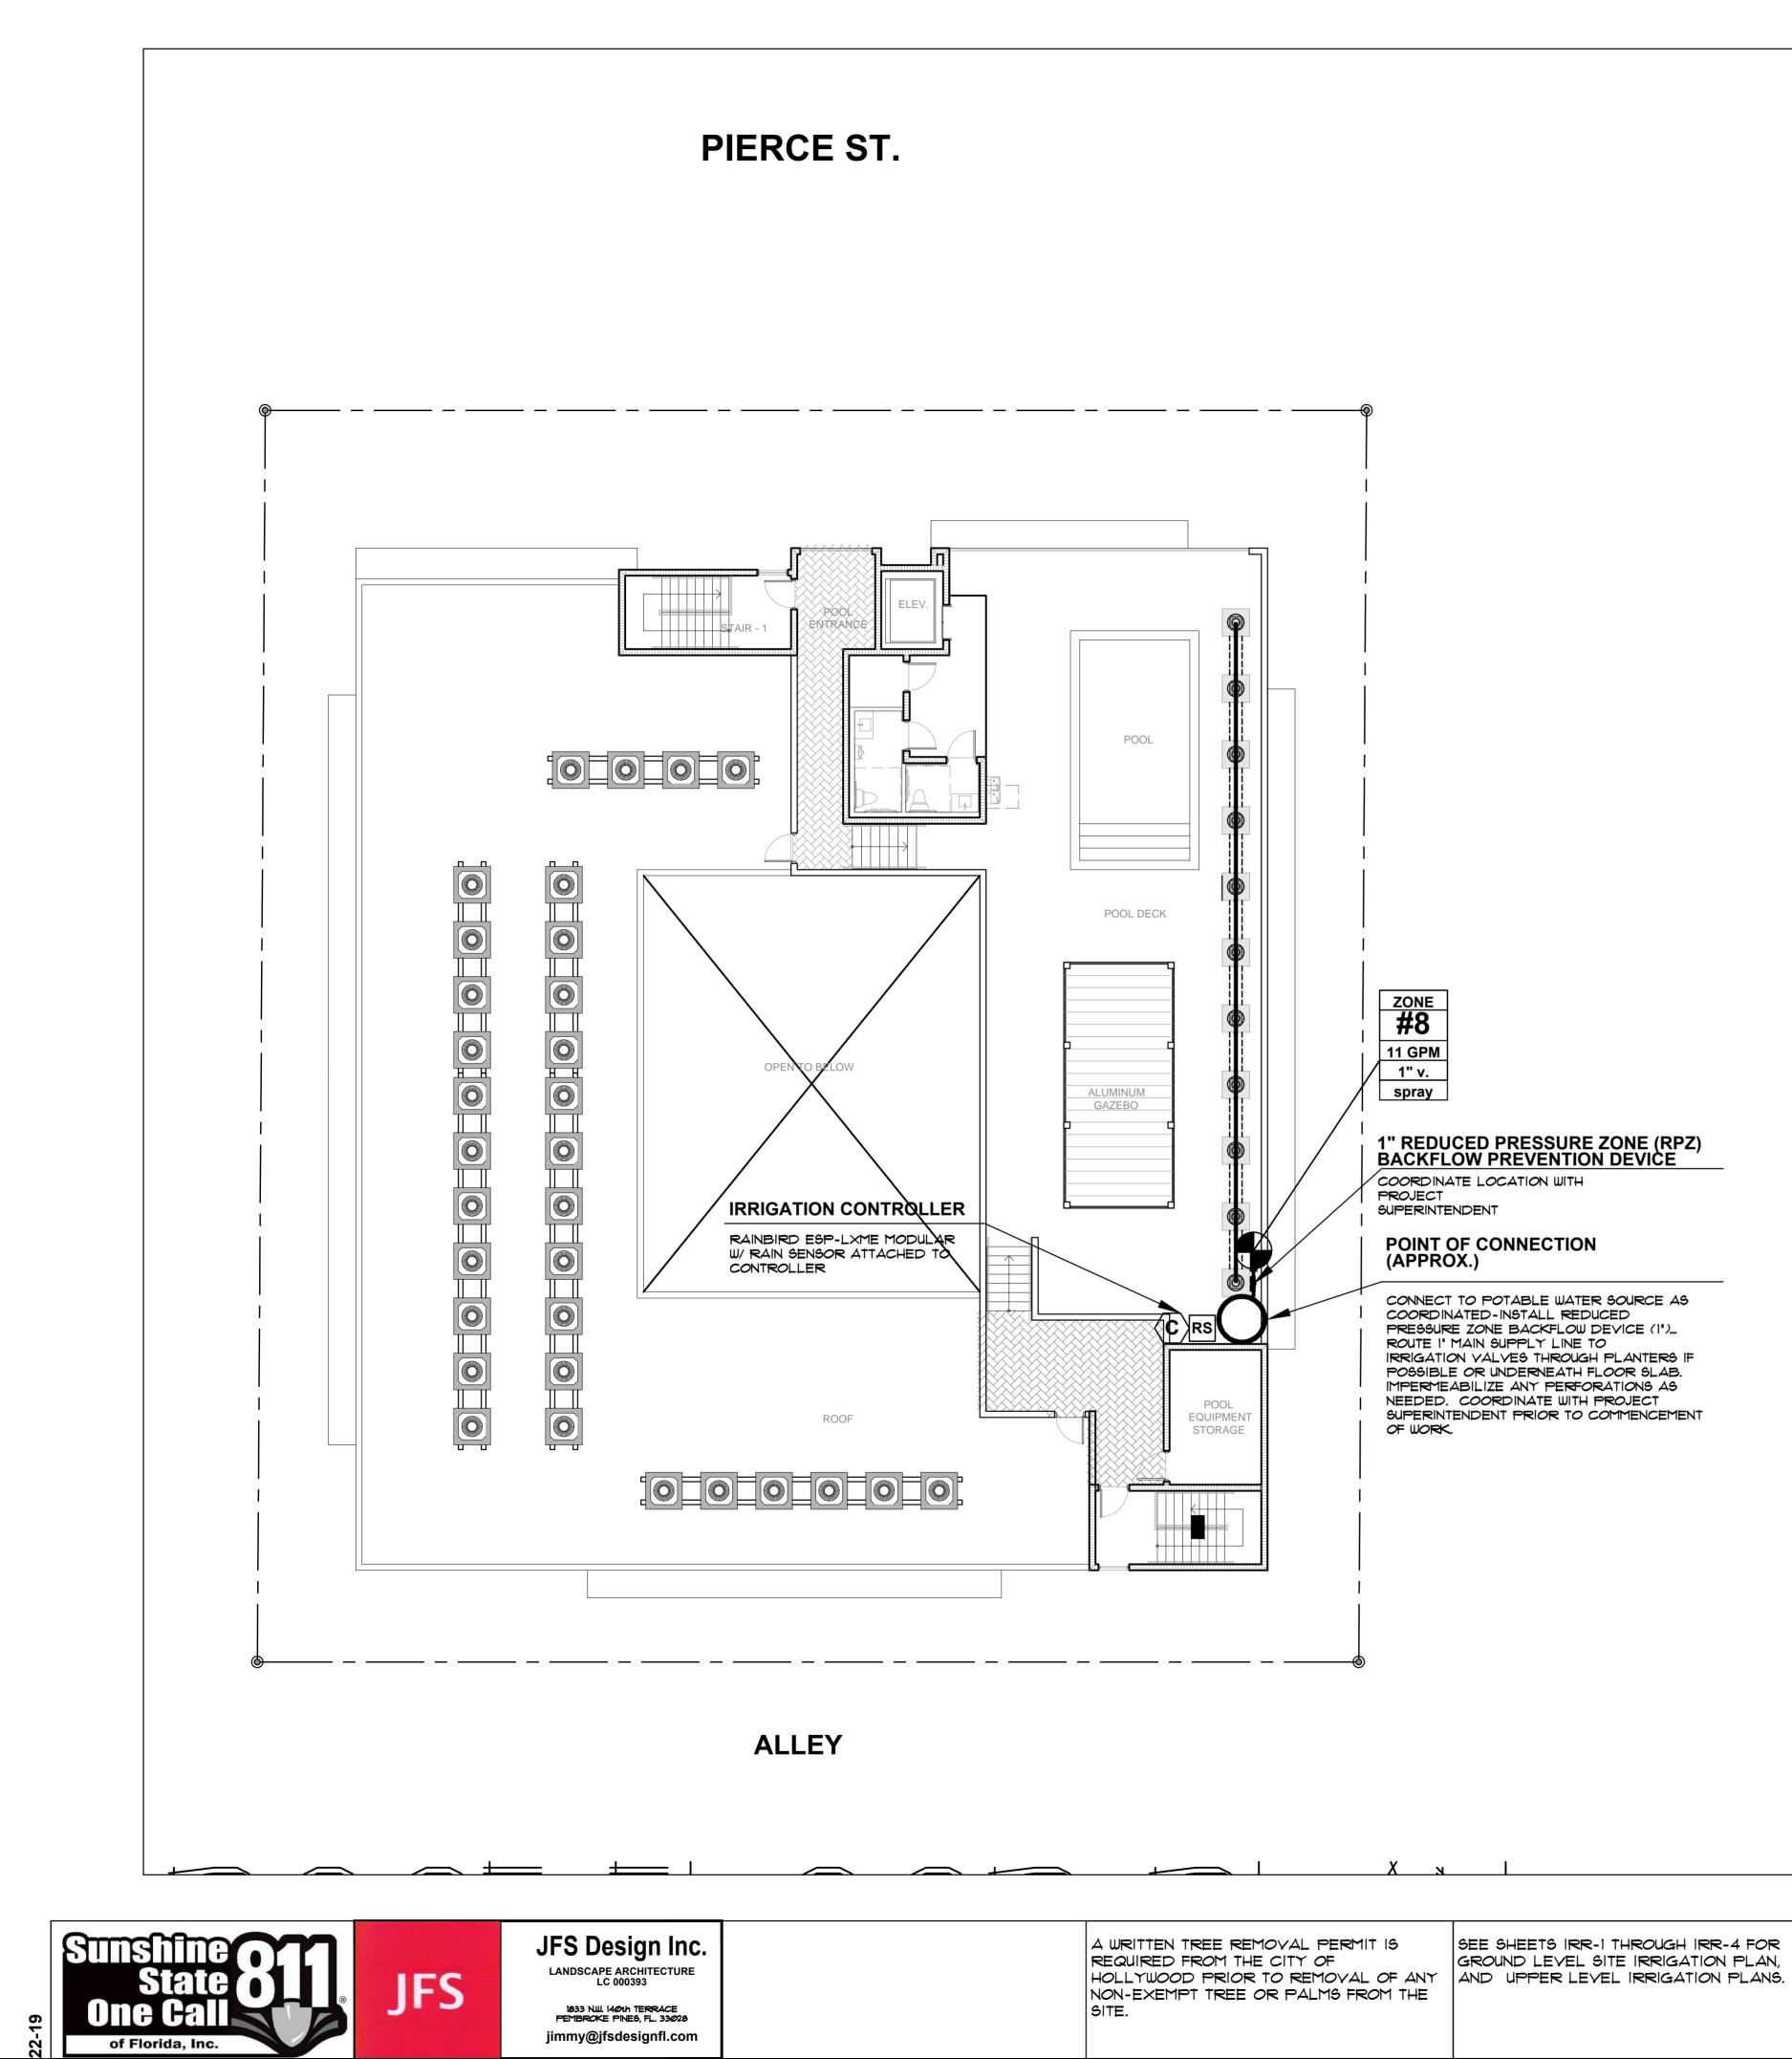

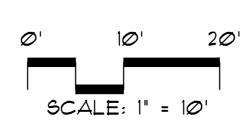



ROOF-POOL LEVEL IRRIGATION PLAN



DELIVERY DATE:	02.13.2023
DRAWN BY:	J.B.
CHECKED BY:	A.LL.
REF NUMBER:	

DRAWING INFORMATION: SHEET TITLE:

DATE	ISSUE DESCRIPTION
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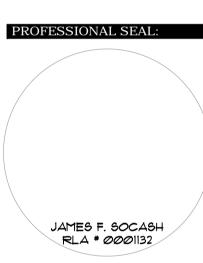
DOWNTOWN HOLLYWOOD

1914 - 1920 PIERCE STREET HOLLYWOOD, FL. 33020


NEW 32 UNITS DEVELOPMENT AT:

PROJECT:

JAMES F. SOCASH RLA # 0001132






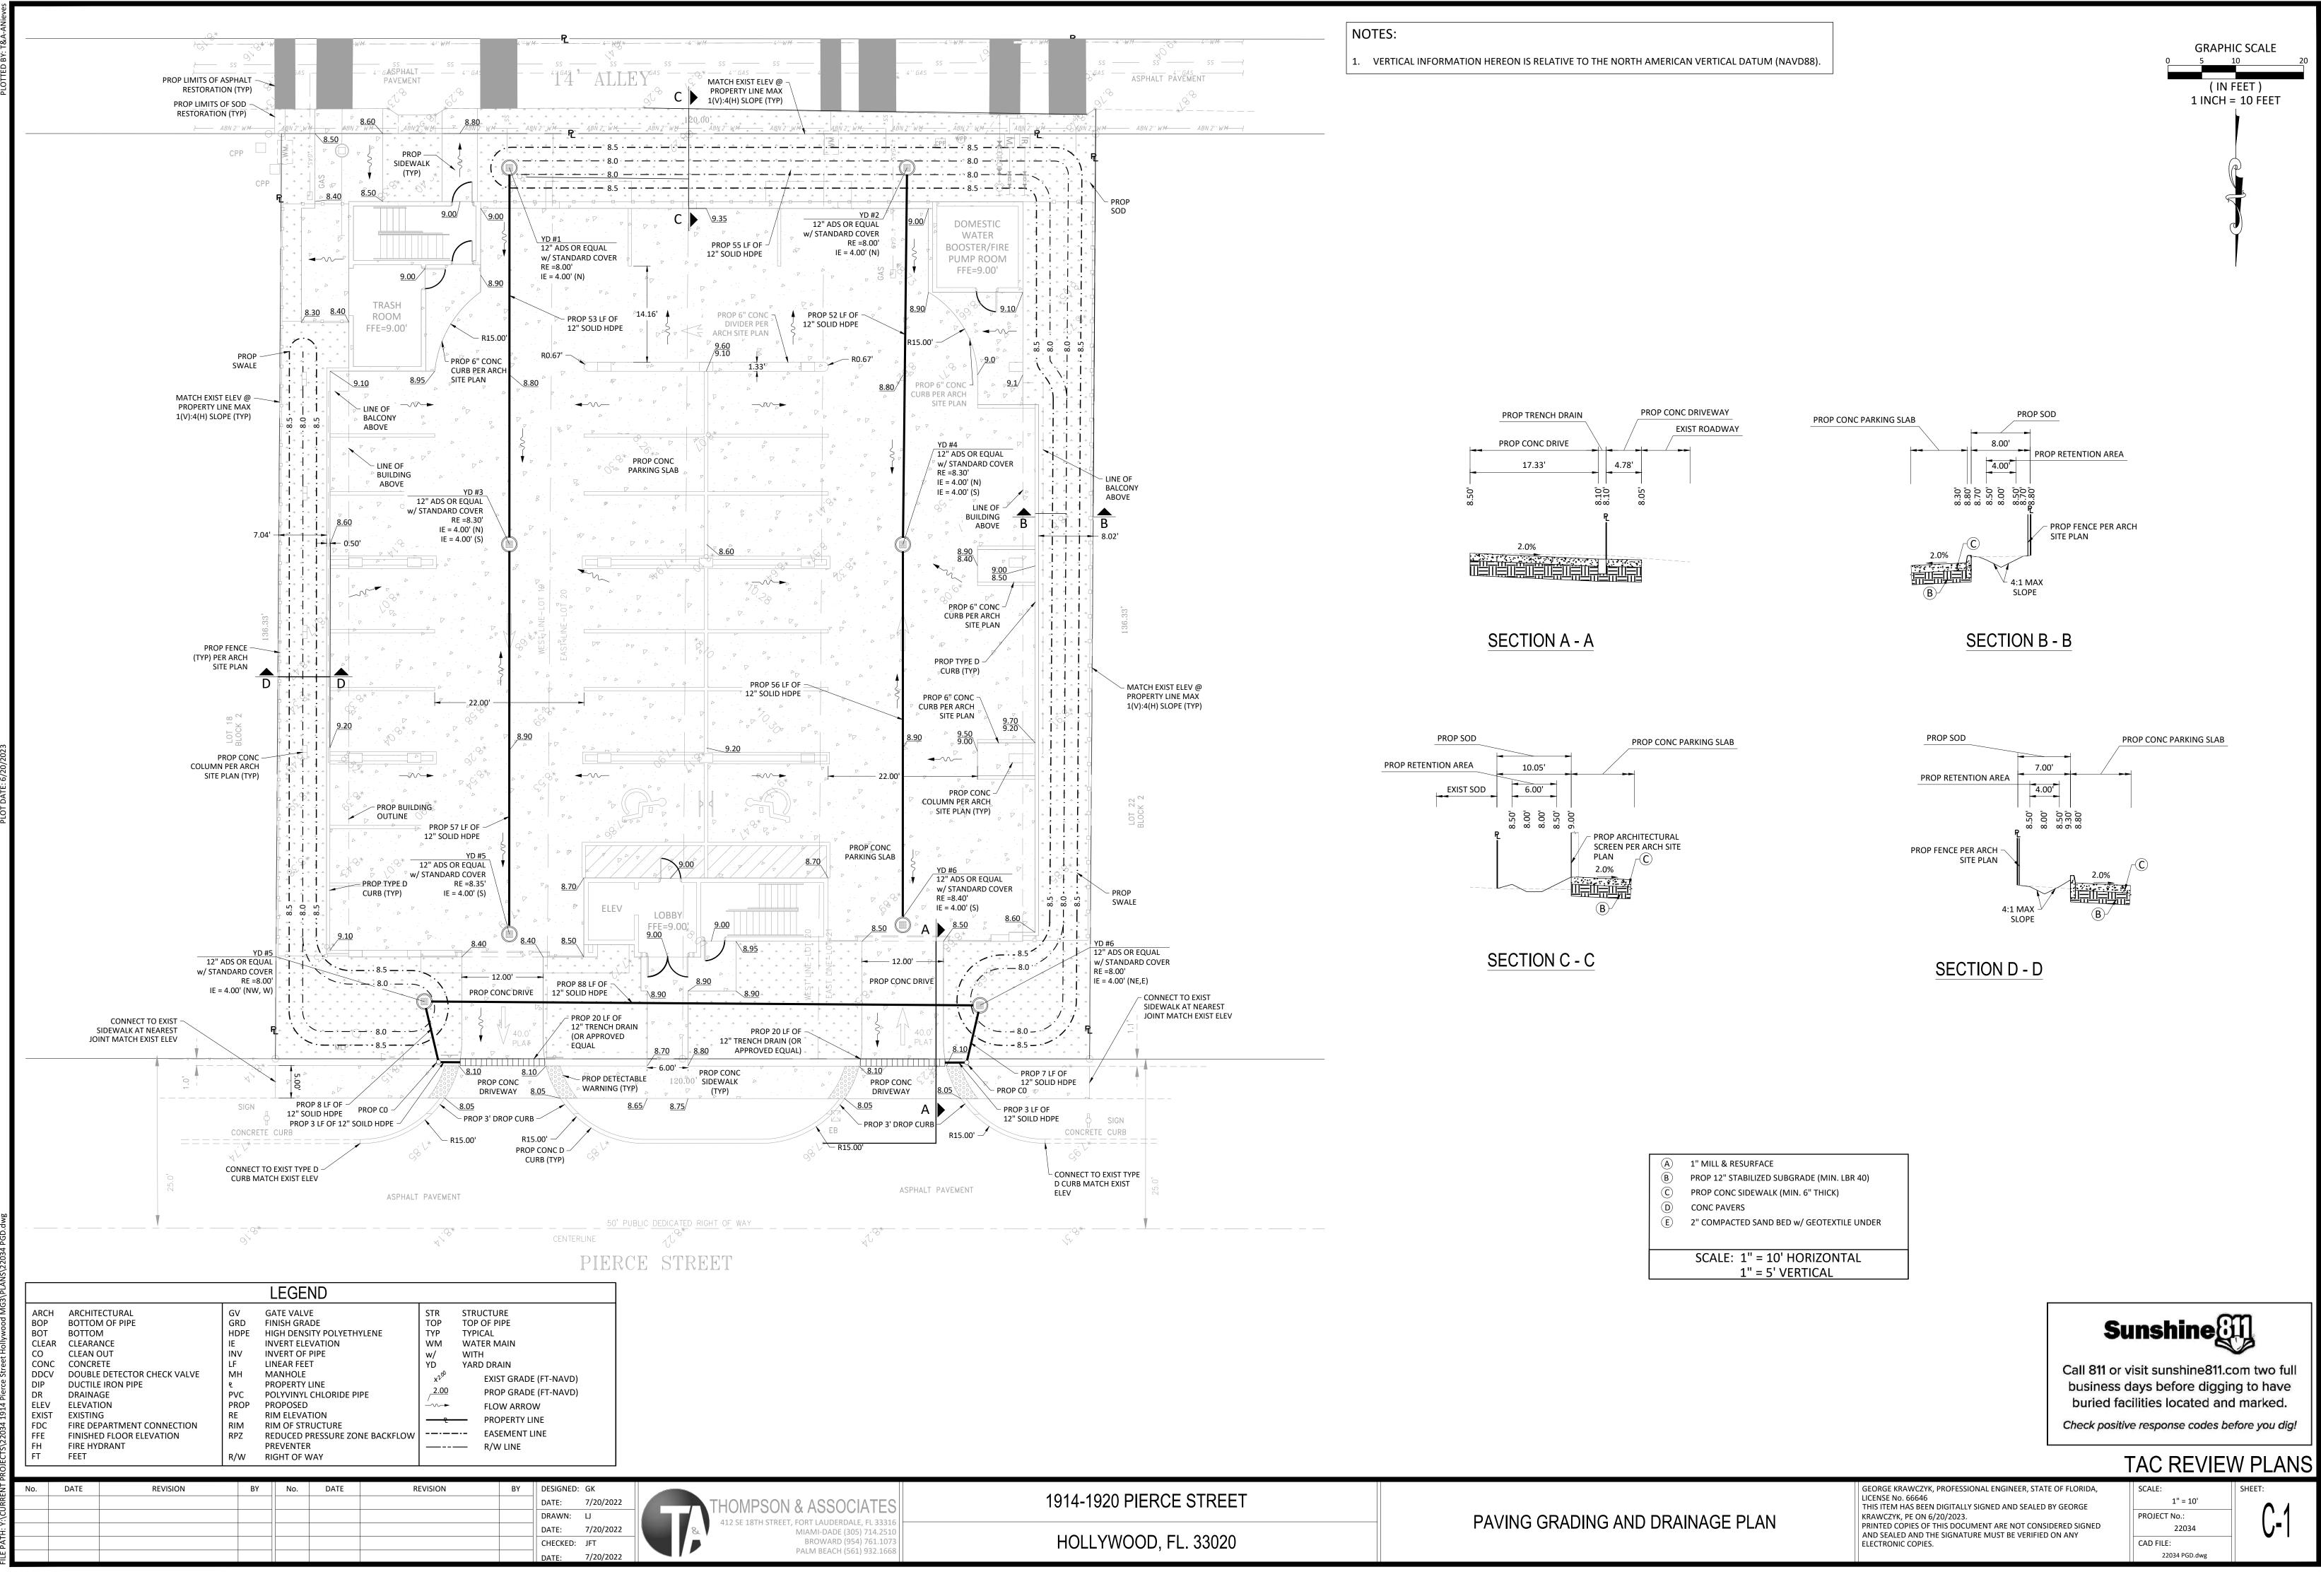

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	MI	AMI-D	ADE	(305)	714.	251(
	E	BROW	'ARD	(954)	761.	1073
	PAI	LM BE	ACH	(561)	932.	166



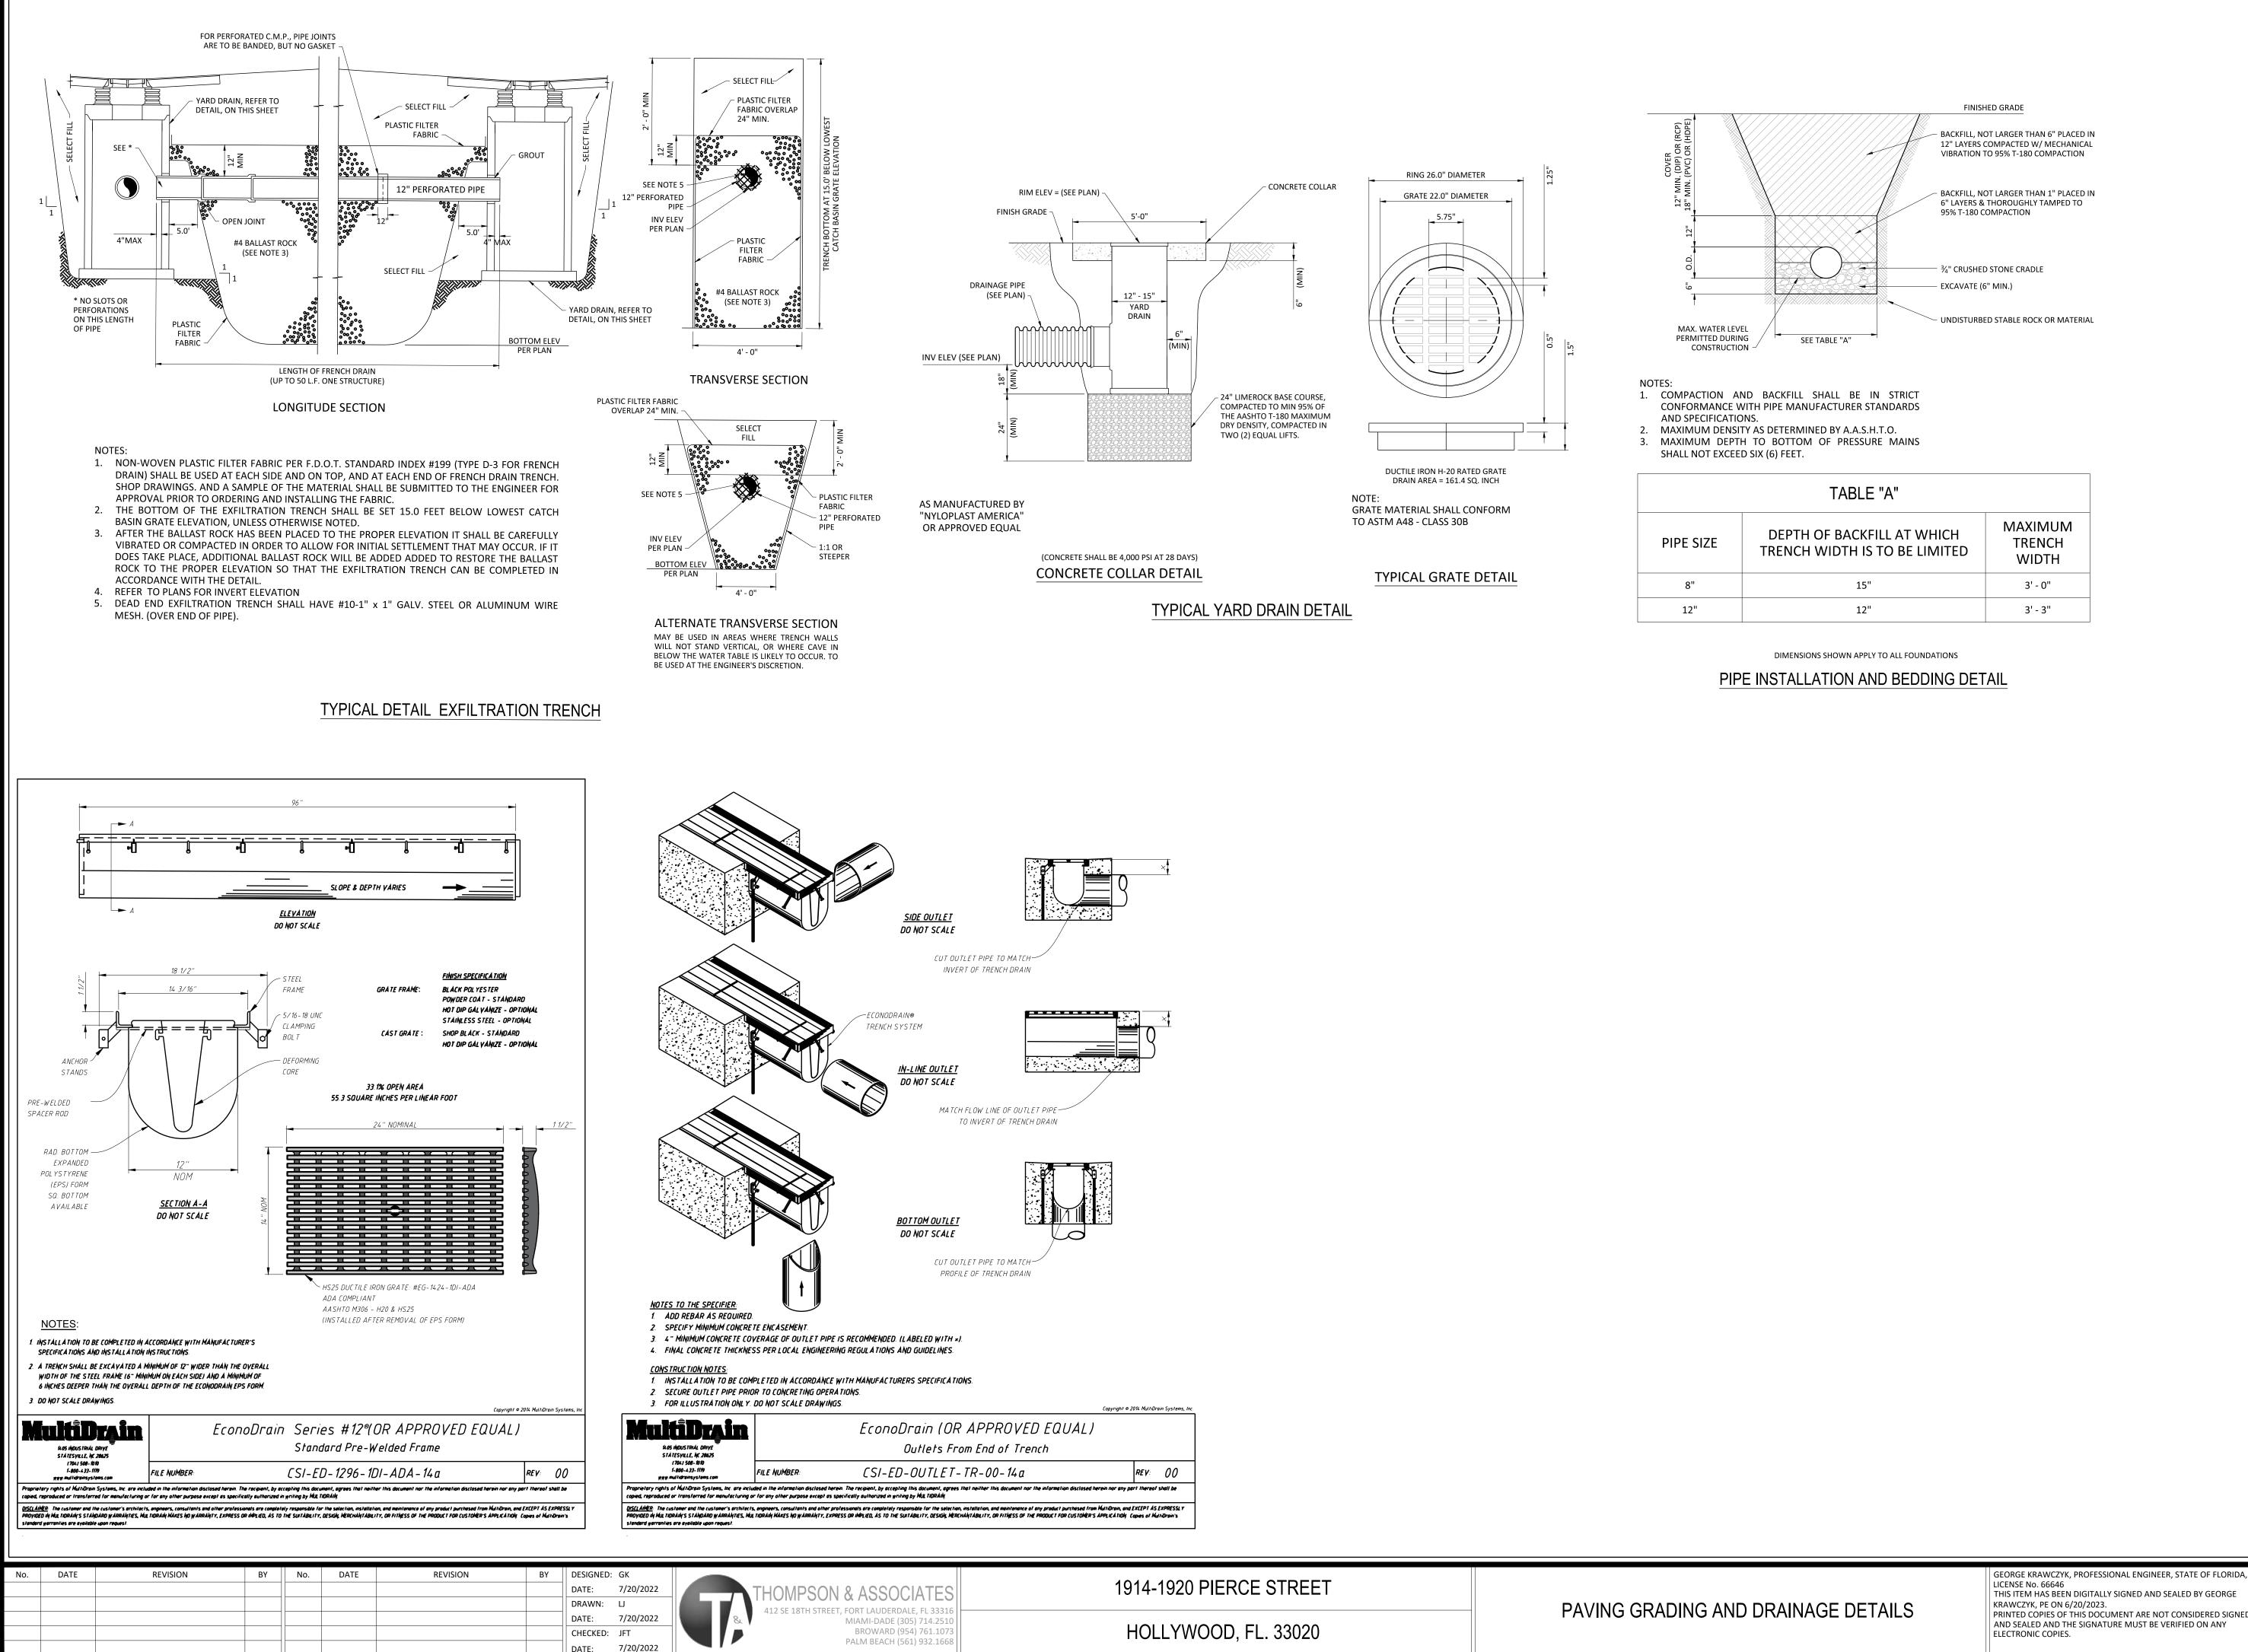

TAI	BLE	"A	

DEPTH OF BACKFILL AT WHICH TRENCH WIDTH IS TO BE LIMITED	MAXIMUM TRENCH WIDTH
15"	3' - 0''
12"	3' - 3"

TAC REVIEW PLANS

SHEE.


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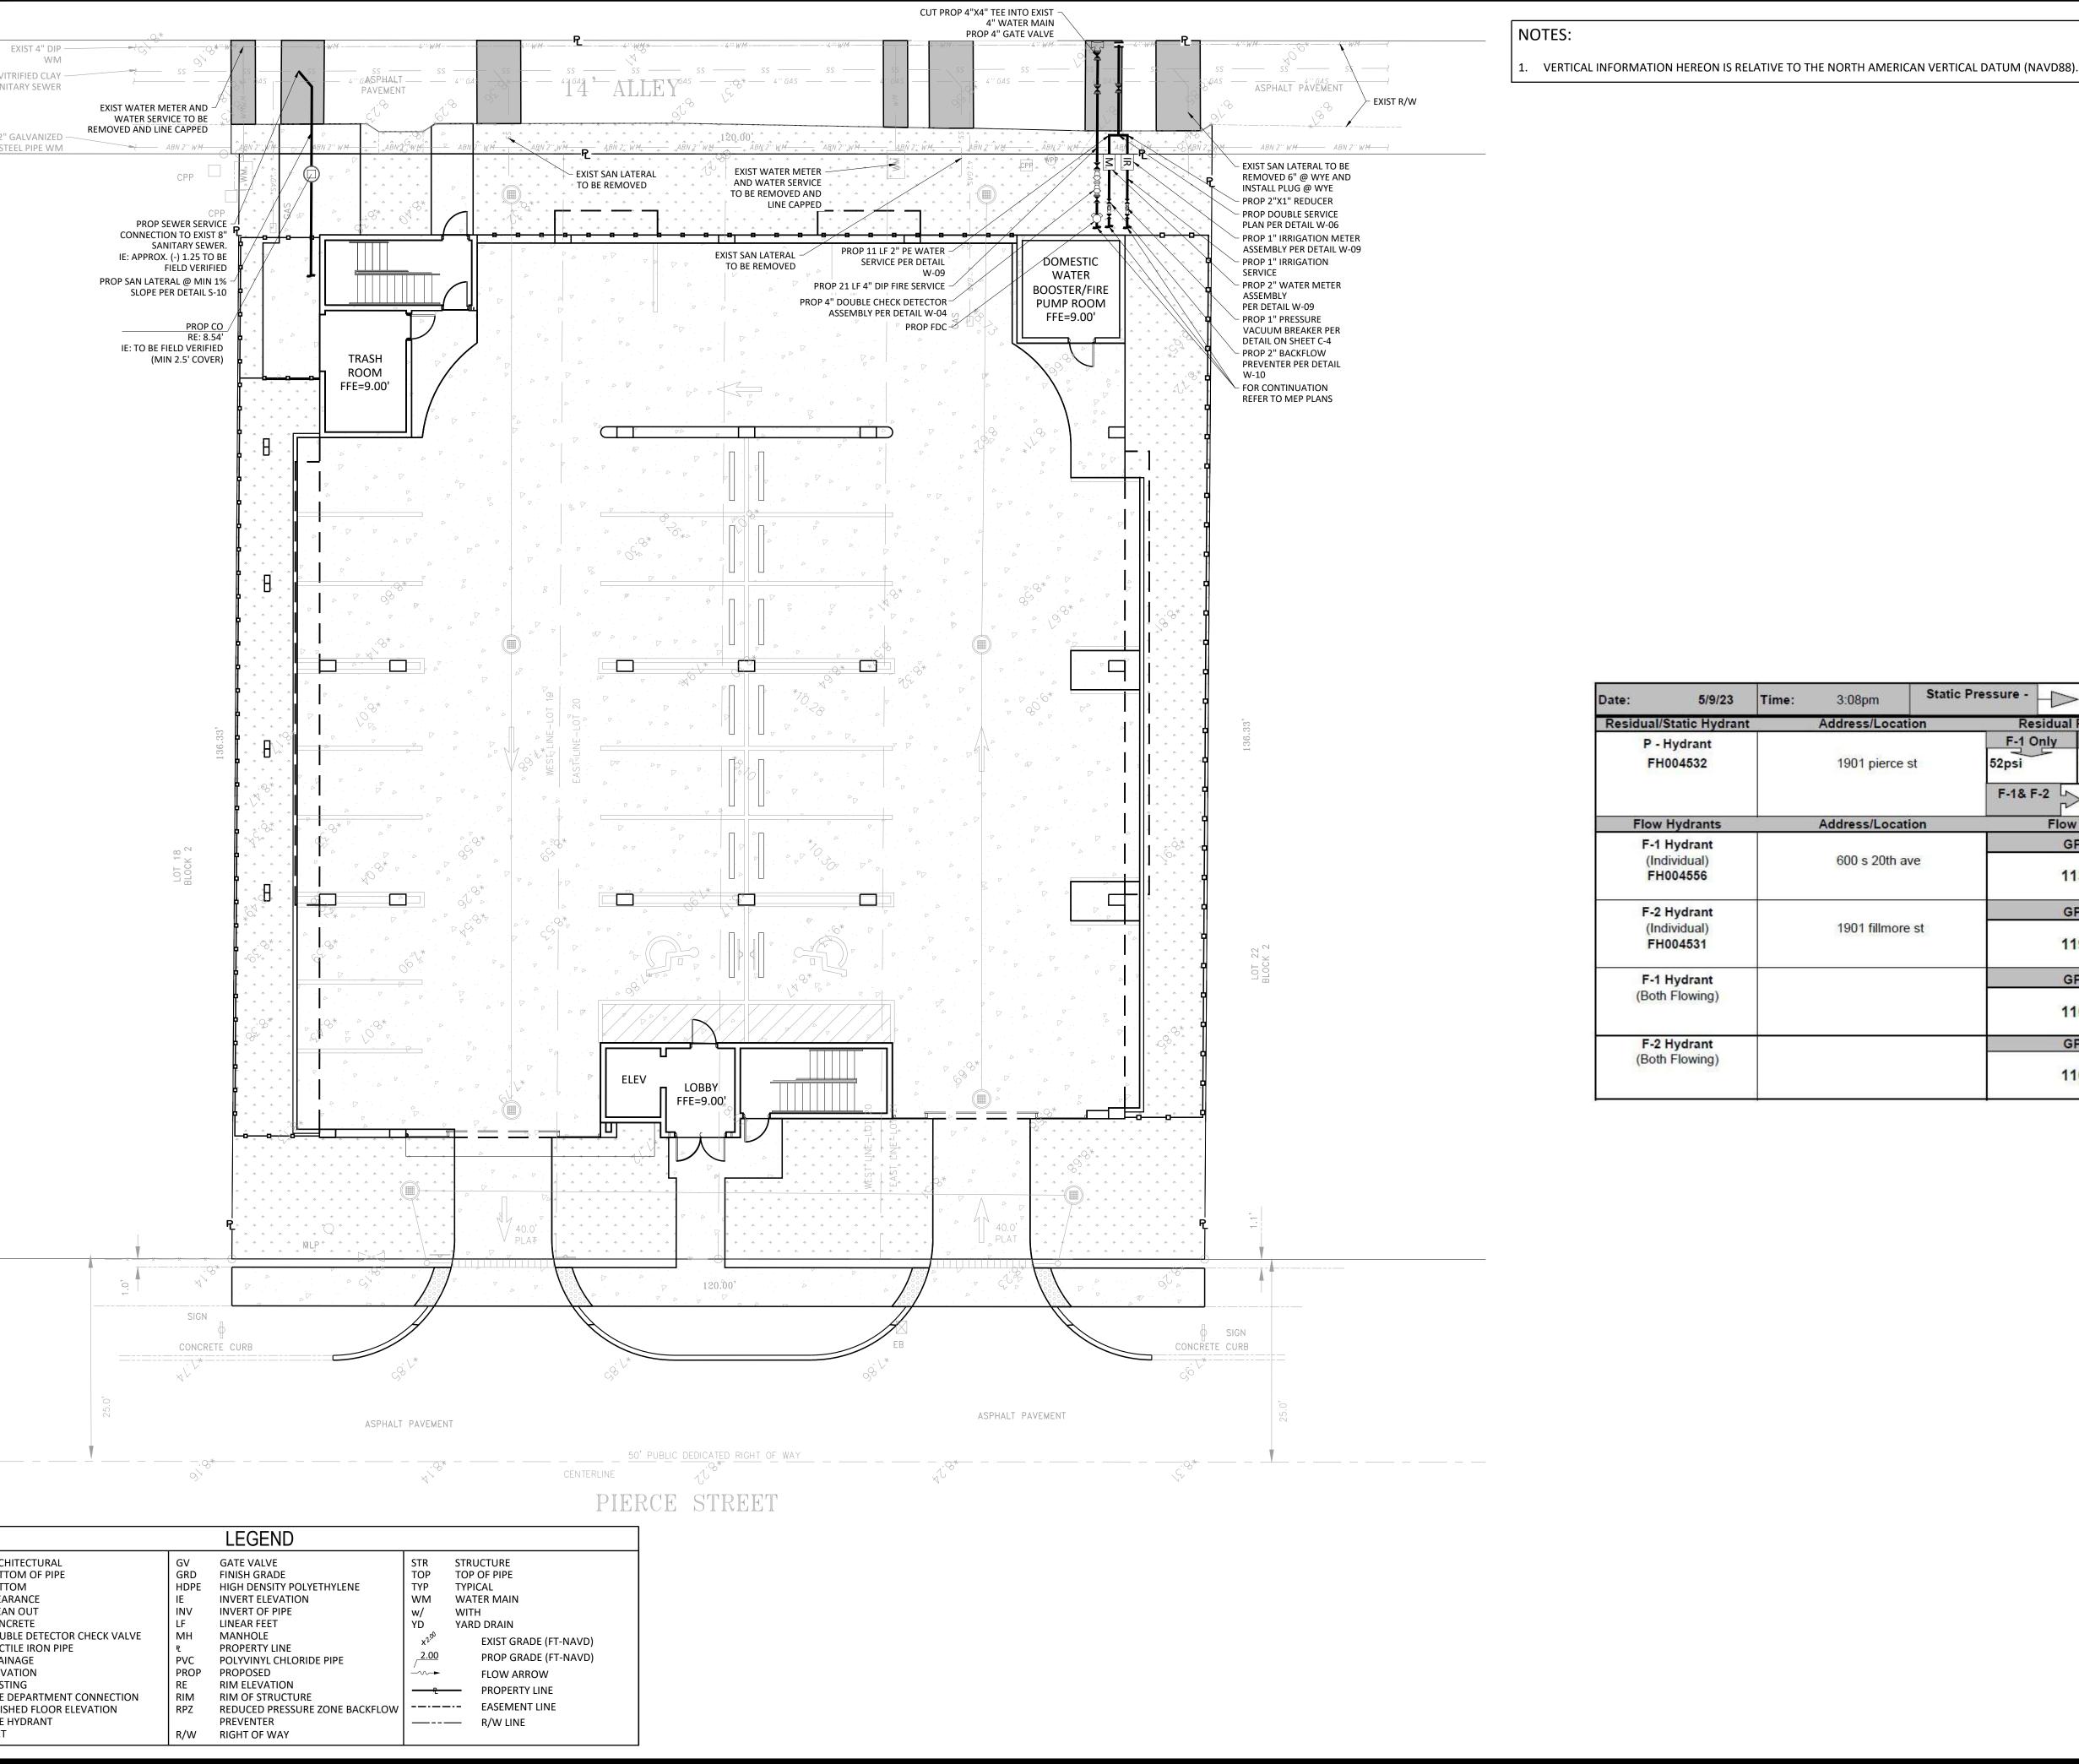
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1" = 10' PROJECT No.: 22034 CAD FILE: 22034 GN.dwg

SCALE:





HOMPSON	&	ASSC)CI/	AT	ES
12 SE 18TH STREET,	MI	RT LAUDEF AMI-DADE BROWARD LM BEACH	(305) (954)	714. 761.	2510 1073

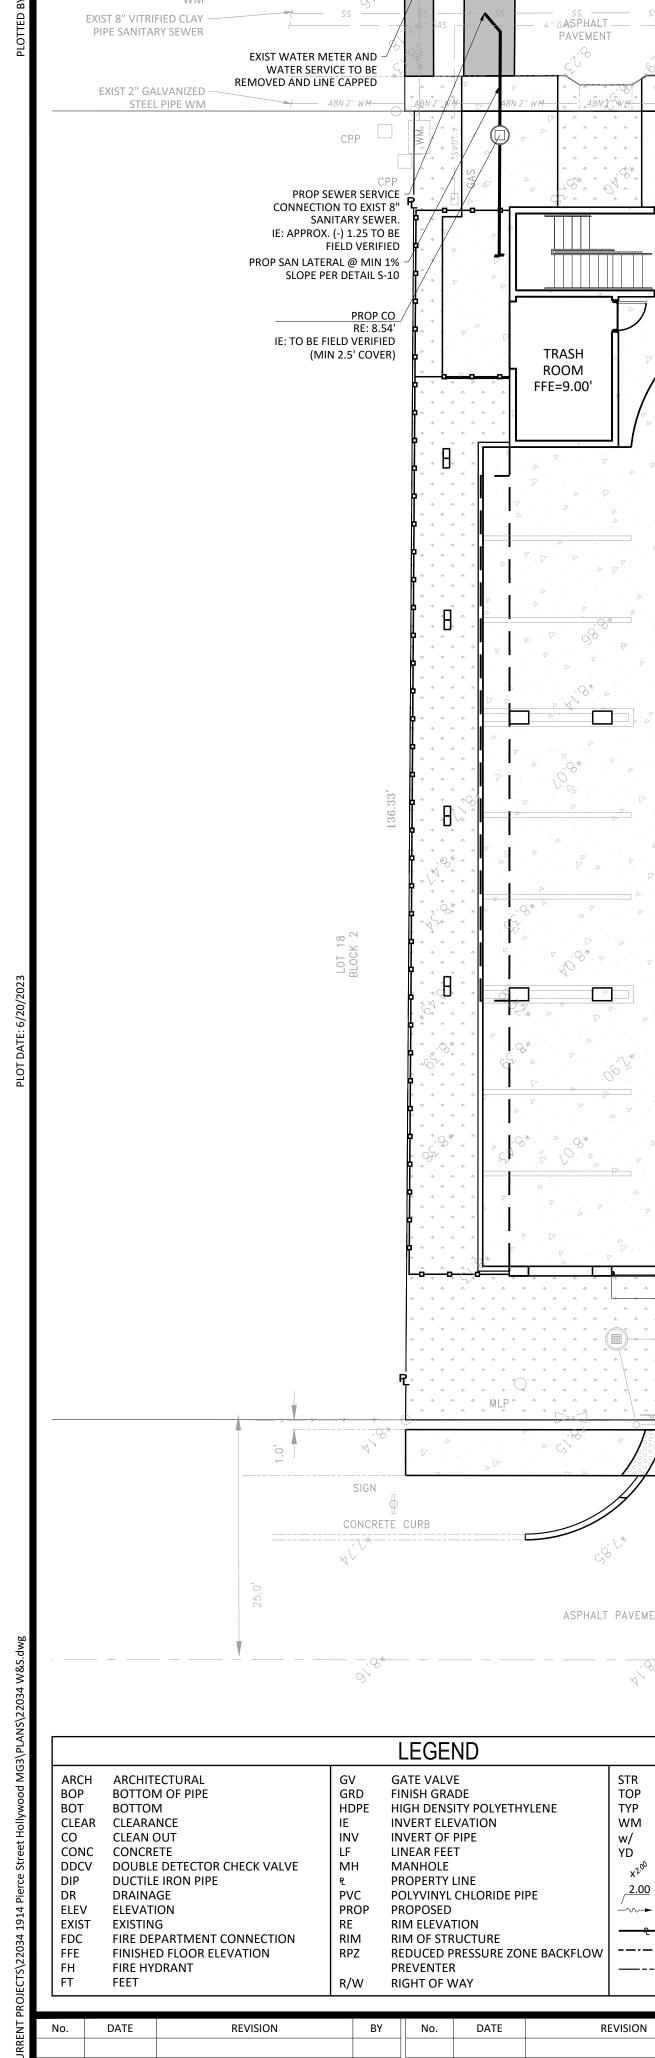BY DESIGNED: GK

DATE:

DATE:

DRAWN:

CHECKED: JFT


DATE: 7/20/2022

7/20/2022

7/20/2022

1914-1920 PIERCE STREET

HOLLYWOOD, FL. 33020

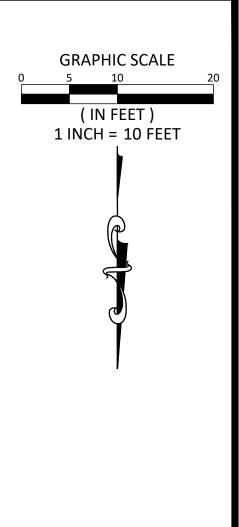

3:08pm Static Pre			55psi	
on	Residual Pressures			
	F-1 0	nly F	-2 Only	
st	52psi	52p	si	
	F-1& F-2			
on	Flow Rate			
	GPM			
'e	1130			
	GPM			
st	1190			
	GPM			
	1100			
		GPM		
	1160			
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Call 811 or visit sunshine811.com two full business days before digging to have buried facilities located and marked.

Check positive response codes before you dig!

1" = 10'

22034

22034 W&S.dwg

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PROJECT No.:

CAD FILE:

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SHEET:

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6-J

GEORGE KRAWCZYK, PROFESSIONAL ENGINEER, STATE OF FLORIDA, LICENSE No. 66646 THIS ITEM HAS BEEN DIGITALLY SIGNED AND SEALED BY GEORGE KRAWCZYK, PE ON 6/20/2023. PRINTED COPIES OF THIS DOCUMENT ARE NOT CONSIDERED SIGNED AND SEALED AND THE SIGNATURE MUST BE VERIFIED ON ANY ELECTRONIC COPIES.

W	ATER	SYSTEM NOT	ES:							
L.	NEW OR RELOCATED UNDERGROUND WATER MAINS INCLUDED IN THIS PROJECT THAT WILL CROSS ANY EXISTING OR PROPOSED GRAVITY OR VACUUM-TYPE SANITARY SEWER OR STORM SEWER WILL BE LAID SO THE OUTSIDE OF THE WATER MAIN IS AT LEAST SIX INCHES ABOVE THE OTHER PIPELINE OR AT LEAST 12 INCHES BELOW THE OTHER PIPELINE.									
2.	NEW OR RELOCATED UNDERGROUND WATER MAINS INCLUDED IN THIS PROJECT THAT WILL CROSS ANY EXISTING OR PROPOSED PRESSURE-TYPE SANITARY SEWER, WASTEWATER OR STORM WATER FORCE MAIN, OR PIPELINE CONVEYING RECLAIMED WATER WILL BE LAID SO THE OUTSIDE OF THE WATER MAIN IS AT LEAST 12 INCHES ABOVE OR BELOW THE OTHER PIPELINE. [FAC 62-555.314(2); EXCEPTIONS ALLOWED UNDER FAC 62-555.314(5)].									
3.	AT ALL UTILITY CROSSINGS DESCRIBED ABOVE, ONE FULL LENGTH OF WATER MAIN PIPE WILL BE CENTERED ABOVE OR BELOW THE OTHER PIPELINE SO THE WATER MAIN JOINTS WILL BE AS FAR AS POSSIBLE FROM THE OTHER PIPELINE, OR THE PIPES WILL BE ARRANGED SO THAT ALL WATER MAIN JOINTS ARE AT LEAST THREE FEET FROM ALL JOINTS IN VACUUM-TYPE SANITARY SEWERS, STORM SEWERS, STORM WATER FORCE MAINS, OR PIPELINES CONVEYING RECLAIMED WATER REGULATED UNDER PART III OF CHAPTER 62-610, F.A.C., AND AT LEAST SIX FEET FROM ALL JOINTS IN GRAVITY OR PRESSURE-TYPE SANITARY SEWERS, WASTEWATER FORCE MAINS, OR PIPELINES CONVEYING RECLAIMED WATER NOT REGULATED UNDER PART III OF CHAPTER 62-610, F.A.C. [FAC 62-555.314(2); EXCEPTIONS ALLOWED UNDER FAC 62-555.314(5)].									
l.		INDERGROUND WATE	R MAINS INCLUDED IN THIS PROJECT TO BE DUCTILE IRON PIPE (D SEWER MAINS.	.I.P.) WHEN						
	POLYETHYLENE ENCASEMENT MATERIAL SHALL BE USED TO ENCASE ALL BURIED DUCTILE IRON PIPE, FITTINGS, VALVES, RODS, AND APPURTENANCES IN ACCORDANCE WITH AWWA C105, METHOD A. THE POLYETHYLENE TUBING SHALL BE CUT TWO FEET LONGER THAN THE PIPE SECTION AND SHALL OVERLAP THE ENDS OF THE PIPE BY ONE FOOT. THE POLYETHYLENE TUBING SHALL BE GATHERED AND LAPPED TO PROVIDE A SNUG FIT AND SHALL BE SECURED AT QUARTER POINTS WITH POLYETHYLENE TAPE. EACH END OF THE POLYETHYLENE TUBING SHALL BE SECURED WITH A WRAP OF POLYETHYLENE TAPE.									
	THE POLYETHYLENE TUBING SHALL PREVENT CONTACT BETWEEN THE PIPE AND BEDDING MATERIAL, BUT IS NOT INTENDED TO BE A COMPLETELY AIRTIGHT AND WATERTIGHT ENCLOSURE. DAMAGED POLYETHYLENE TUBING SHALL BE REPAIRED IN A WORKMANLIKE MANNER USING POLYETHYLENE TAPE, OR THE DAMAGED SECTION SHALL BE REPLACED. POLY WRAP WILL NOT BE PAID FOR AS A SEPARATE BID ITEM. IT SHALL BE CONSIDERED TO BE A PART OF THE PRICE BID FOR WATER MAINS.									
			ALL BE ENCASED IN POLY WRAP UP TO THE GROUND SURFACE ANI RED BY THE POLY WRAP.	D THE WEEP						
8.	HUNDF STEM, MALLE	RED (200) PSI WORKIN BRASS BODY, AND SC ABLE IRON HANDWH	H PIPE LESS THAN THREE INCHES (3") IN DIAMETER SHALL BE RATE NG PRESSURE, NON-SHOCK, BLOCK PATTERN, SCREWED BONNET, I DLID WEDGE. THEY SHALL BE STANDARD THREADED FOR PVC PIPE EEL. GATE VALVES 3" THROUGH 16" IN DIAMETER SHALL BE RESILI VALVES FOR SPECIAL APPLICATIONS WILL REQUIRE CITY UTILITY	NON-RISING AND HAVE A ENT SEAT AND						
).	SCREW ALL VA PARTIC	V-ON TYPE. THE LID S ALVE BOXES SHALL BE CULAR VALVE. THE ST	FOR ALL SIZE VALVES SHALL BE OF CAST IRON CONSTRUCTION AN HALL HAVE CAST IN THE METAL THE WORD "WATER" FOR THE WA SIX INCH (6") NOMINAL DIAMETER AND SHALL BE SUITABLE FOR E EM OF THE BURIED VALVE SHALL BE WITHIN TWENTY-FOUR INCH S OTHERWISE APPROVED BY THE CITY.	TER LINES. DEPTHS OF THE						
0.		ATER MAIN INSTALLAT 5.320 F.A.C.	TIONS SHALL COMPLY WITH THE COLOR CODING REQUIREMENTS	OF CHAPTER						
LIV	OOD, FLOR	ISSUED: 03/01/1994	DEPARTMENT OF PUBLIC UTILITIES STANDARD DETAIL	REVISED: 06/08/2014						
AMON	D ST - ST	DRAWN: EAM	WATER SYSTEM NOTES	DRAWING NO.						
.Deca	00									

WATER METER SERVICE NOTES:

- SUCCESSIVE TAPS INTO THE WATER MAIN SHALL BE SPACED NOT LESS THAN 18" ON CENTER.
- P.E. TUBING SHALL BE IN ACCORDANCE WITH THE LATEST EDITION OF AWWA STANDARD C901. "POLYETHYLENE (PE) PRESSURE PIPE AND TUBING, 1/2 IN. (13mm) THROUGH 3 IN. (76 mm), FOR WATER SERVICE".
- MINIMUM SERVICE PIPE DIAMETER SHALL BE 1" FOR SINGLE OR DUAL 🚀 OR SINGLE 1" DIAMETER METERS.
- MINIMUM SERVICE PIPE DIAMETER SHALL BE 2" FOR SINGLE OR DUAL 1-¹/₂" OR SINGLE 2" DIAMETER METERS.
- FOR METER DIAMETERS LARGER THAN 2", THE MINIMUM SERVICE PIPE DIAMETER SHALL BE THE SAME AS THE METER DIAMETER.
- APPROVED COPPER TUBING MAY BE USED AT THE CITY'S DISCRETION.
- FOR NEW METER INSTALLATIONS, ALL SADDLES, VALVES, PIPING, FITTINGS, CURB STOPS, METER VALVES, METER COUPLINGS, METER VAULTS AND COVERS SHALL BE FURNISHED AND INSTALLED BY THE CONTRACTOR. THE WATER METERS WILL BE PROVIDED AND INSTALLED BY THE CITY OF HOLLYWOOD (NEW ACCOUNTS).
- FOR METER RELOCATIONS, ALL SADDLES, VALVES, PIPING, FITTINGS, CURB STOPS, METER VALVES, METER COUPLINGS, METER VAULTS AND COVERS SHALL BE FURNISHED AND INSTALLED BY THE CONTRACTOR. THE EXISTING WATER METER TO BE RELOCATED AND INSTALLED BY CONTRACTOR.
- FOR EXISTING METERS ABUTTING THE RIGHT-OF-WAY THAT ARE BEING DISCONNECTED FROM EXISTING MAINS AND RECONNECTED TO NEW MAINS, THE CONTRACTOR SHALL:
- a. CUT AND PLUG THE EXISTING SERVICE LINE AT THE MAIN AND AT THE METER, AND REMOVE THE EXISTING BALL VALVE CURB STOP.
- b. FURNISH AND INSTALL SERVICE SADDLE, CORPORATION STOP OR SERVICE VALVE AND VALVE BOX, PIPING AND FITTINGS UP TO AND INCLUDING THE BALL VALVE CURB STOP.
- THE ELEVATION AT THE TOP OF THE METER BOX SHALL MATCH THE ELEVATION OF THE BACK OF 12. SIDEWALK, WHENEVER PRACTICAL
- AS PART OF THE SERVICE INSTALLATION, THE CONTRACTOR SHALL RESTORE THE RIGHT-OF-WAY 13. TO MATCH EXISTING CONDITIONS, INCLUDING ROADWAY PAVEMENT, PAVEMENT MARKINGS AND RPMs, CONCRETE CURBS, SIDEWALKS, RAMPS (INCLUDING DETECTABLE WARNING SURFACE), SODDING, AND ALL OTHER IMPROVEMENTS REMOVED OR DAMAGED DURING THE SERVICE INSTALLATION.
- 14. FOR UNPAVED AREAS, THE MINIMUM GROUND COVER ACCEPTED BY THE CITY IS SODDING.

OF HOLLY WOOD AT	ISSUED:	03/01/1994	DEPARTMENT OF PUBLIC UTILITIES STANDARD DETAIL	REVISED:	/06/20
DIAMOND	DRAWN:	EAM	WATER METER SERVICE NOTES FOR	DRAWING N	NO.
GOLD COAST	APPROVED	D: XXX	5/8" THROUGH 2" METERS	W-	07

No.	DATE	REVISION	BY	No.	DATE	REVISION	BY	DESIGNED:	GK	
								DATE:	7/20/2022	
								DRAWN:	IJ	
								DATE:	7/20/2022	
								CHECKED:	JFT	
								DATE:	7/20/2022	

WATER SYSTEM NOTES (CONTINUED):


- 11. ALL WATER MAIN INSTALLATIONS SHALL COMPLY WITH THE COLOR CODING REQUIREMENTS OF CHAPTER 62-555.320 F.A.C.
- AMERICA.

- CITY OF HOLLYWOOD SPECIFICATIONS.

- JOINTS (60 FEET) FROM ANY FITTING.

OF HOLLYWOOD, ATO	ISSUED: 03/01/1	ç
Diamond	DRAWN:	E
GOLD COAST	APPROVED:	>

	EXISI. MELEK VAULI 10 REMAIN, OR PROP. METER VAULT TO BE FURNISHED AND INSTALLED BY	CONTRACTOR WATER METER TO BE	PROVIDED BY CITY = 3/4"X1" DUAL INLINE
			4" 8"
		<mark>Я</mark> ОИА	ROADWAY CURB I PAVEMENT I CURB I SWALE I CONC. SWK. I
			PROF. VALVE BOX W/LID, RISER AND 24"x24"x8" THICK CONC CONL OLI AD
HOLLYWOOD	ISSUED	: 03/0) /1994

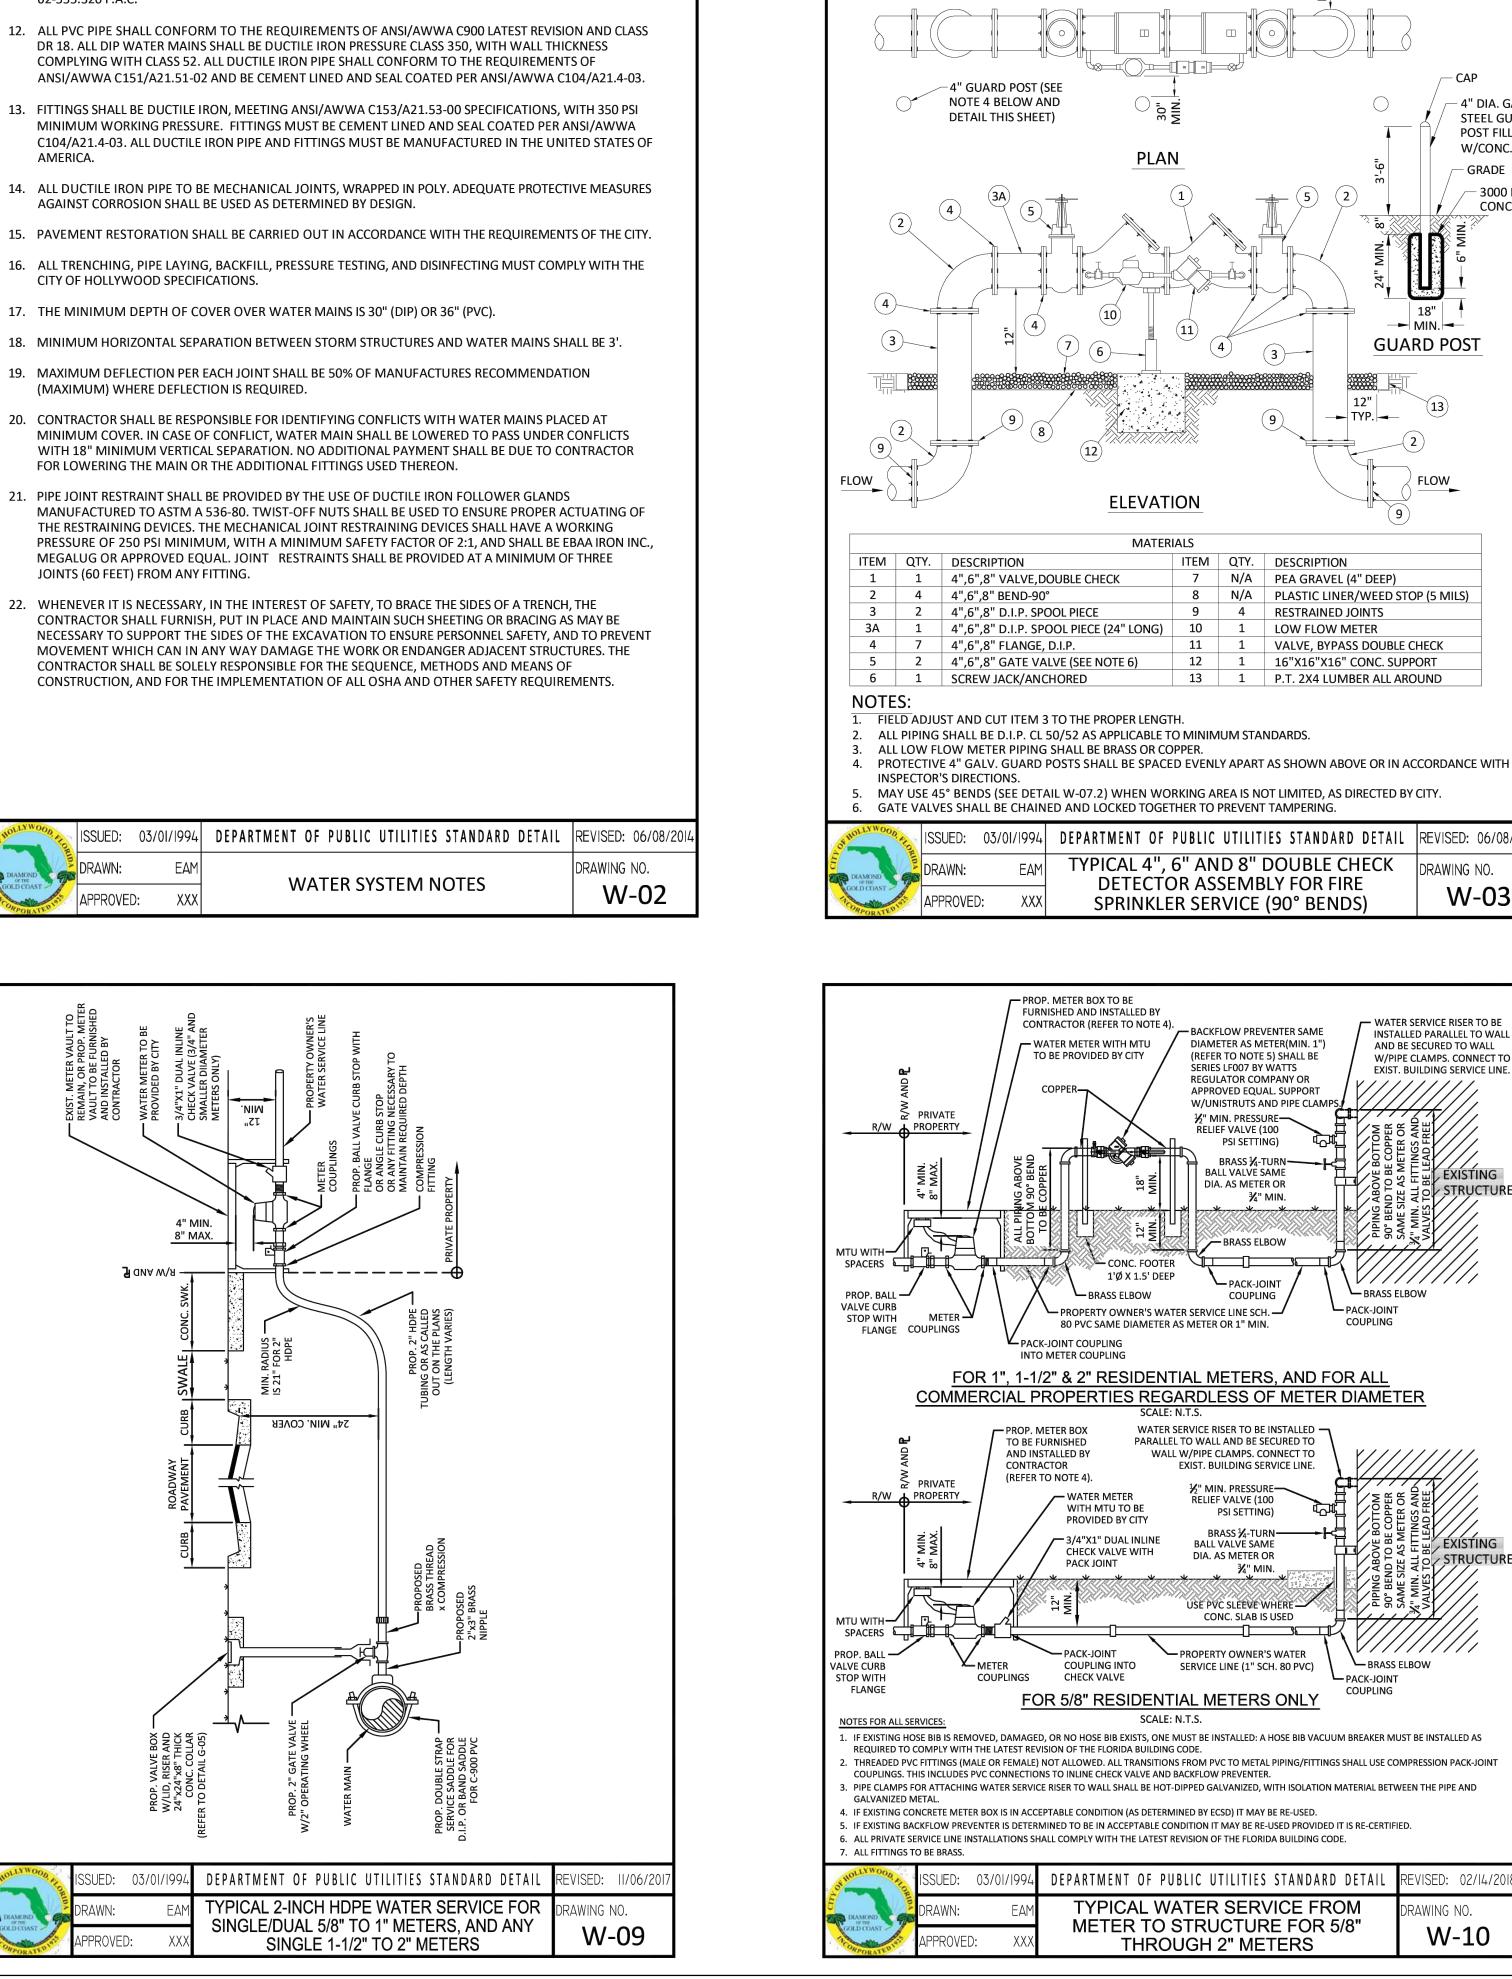

/IPSON & ASSOCIATES SE 18TH STREET, FORT LAUDERDALE, FL 333 MIAMI-DADE (305) 714.251 BROWARD (954) 761.1073 PALM BEACH (561) 932.1668

1914-1920 PIERCE STREET

HOLLYWOOD, FL. 33020

WATER AND SEWER DETAILS

VARIES

PLAN

MATERIALS

ITEM

11

12 1

- BACKFLOW PREVENTER SAME

(REFER TO NOTE 5) SHALL BE

DIAMETER AS METER(MIN. 1"

SERIES LF007 BY WATTS

2" MIN. PRESSURE

RELIEF VALVE (100

PSI SETTING)

BRASS 1/2-TURN

BRASS ELBOW

- PACK-JOINT

COUPLING

WATER SERVICE RISER TO BE INSTALLED -

WALL W/PIPE CLAMPS. CONNECT TO

'X" MIN, PRESSURE

RELIEF VALVE (100

EXIST. BUILDING SERVICE LINE.

PSI SETTING)

BRASS 1/4-TURN-

USE PVC SLEEVE WHERE -

PROPERTY OWNER'S WATER

THROUGH 2" METERS

SCALE: N.T.S.

SERVICE LINE (1" SCH. 80 PVC)

CONC. SLAB IS USED

3⁄/" MIN. TRIKINI

BALL VALVE SAME

DIA. AS METER OR

PARALLEL TO WALL AND BE SECURED TO

3∕4" MIN.


BALL VALVE SAME

DIA. AS METER OR

REGULATOR COMPANY OR APPROVED EQUAL. SUPPORT W/UNISTRUTS AND PIPE CLA


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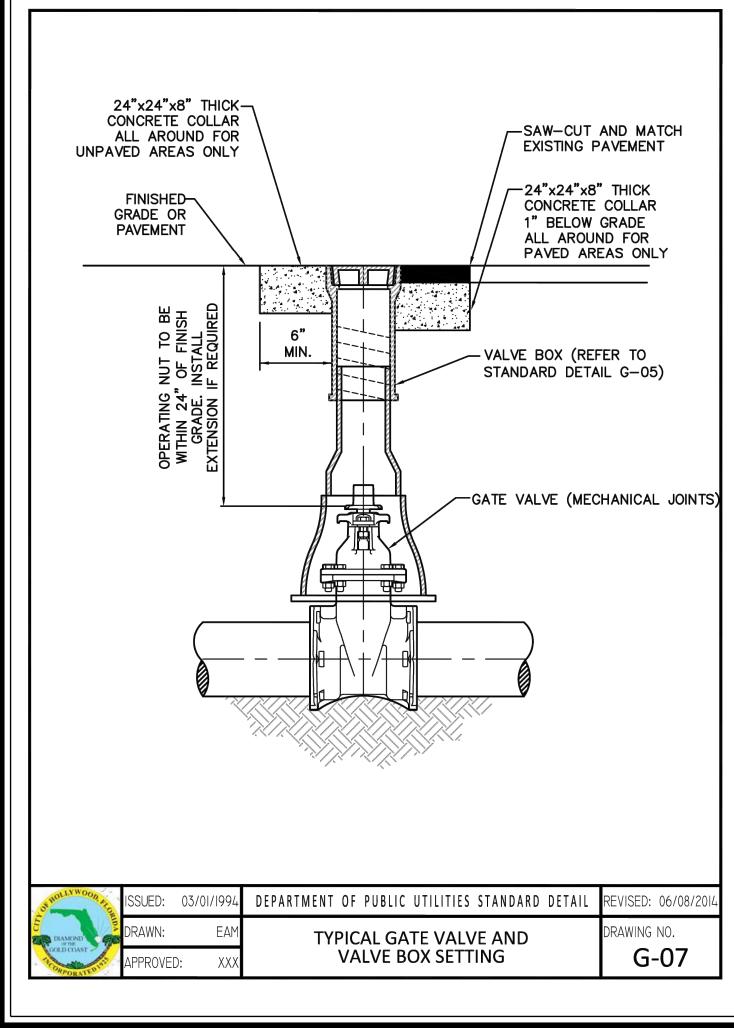
QTY. DESCRIPTION

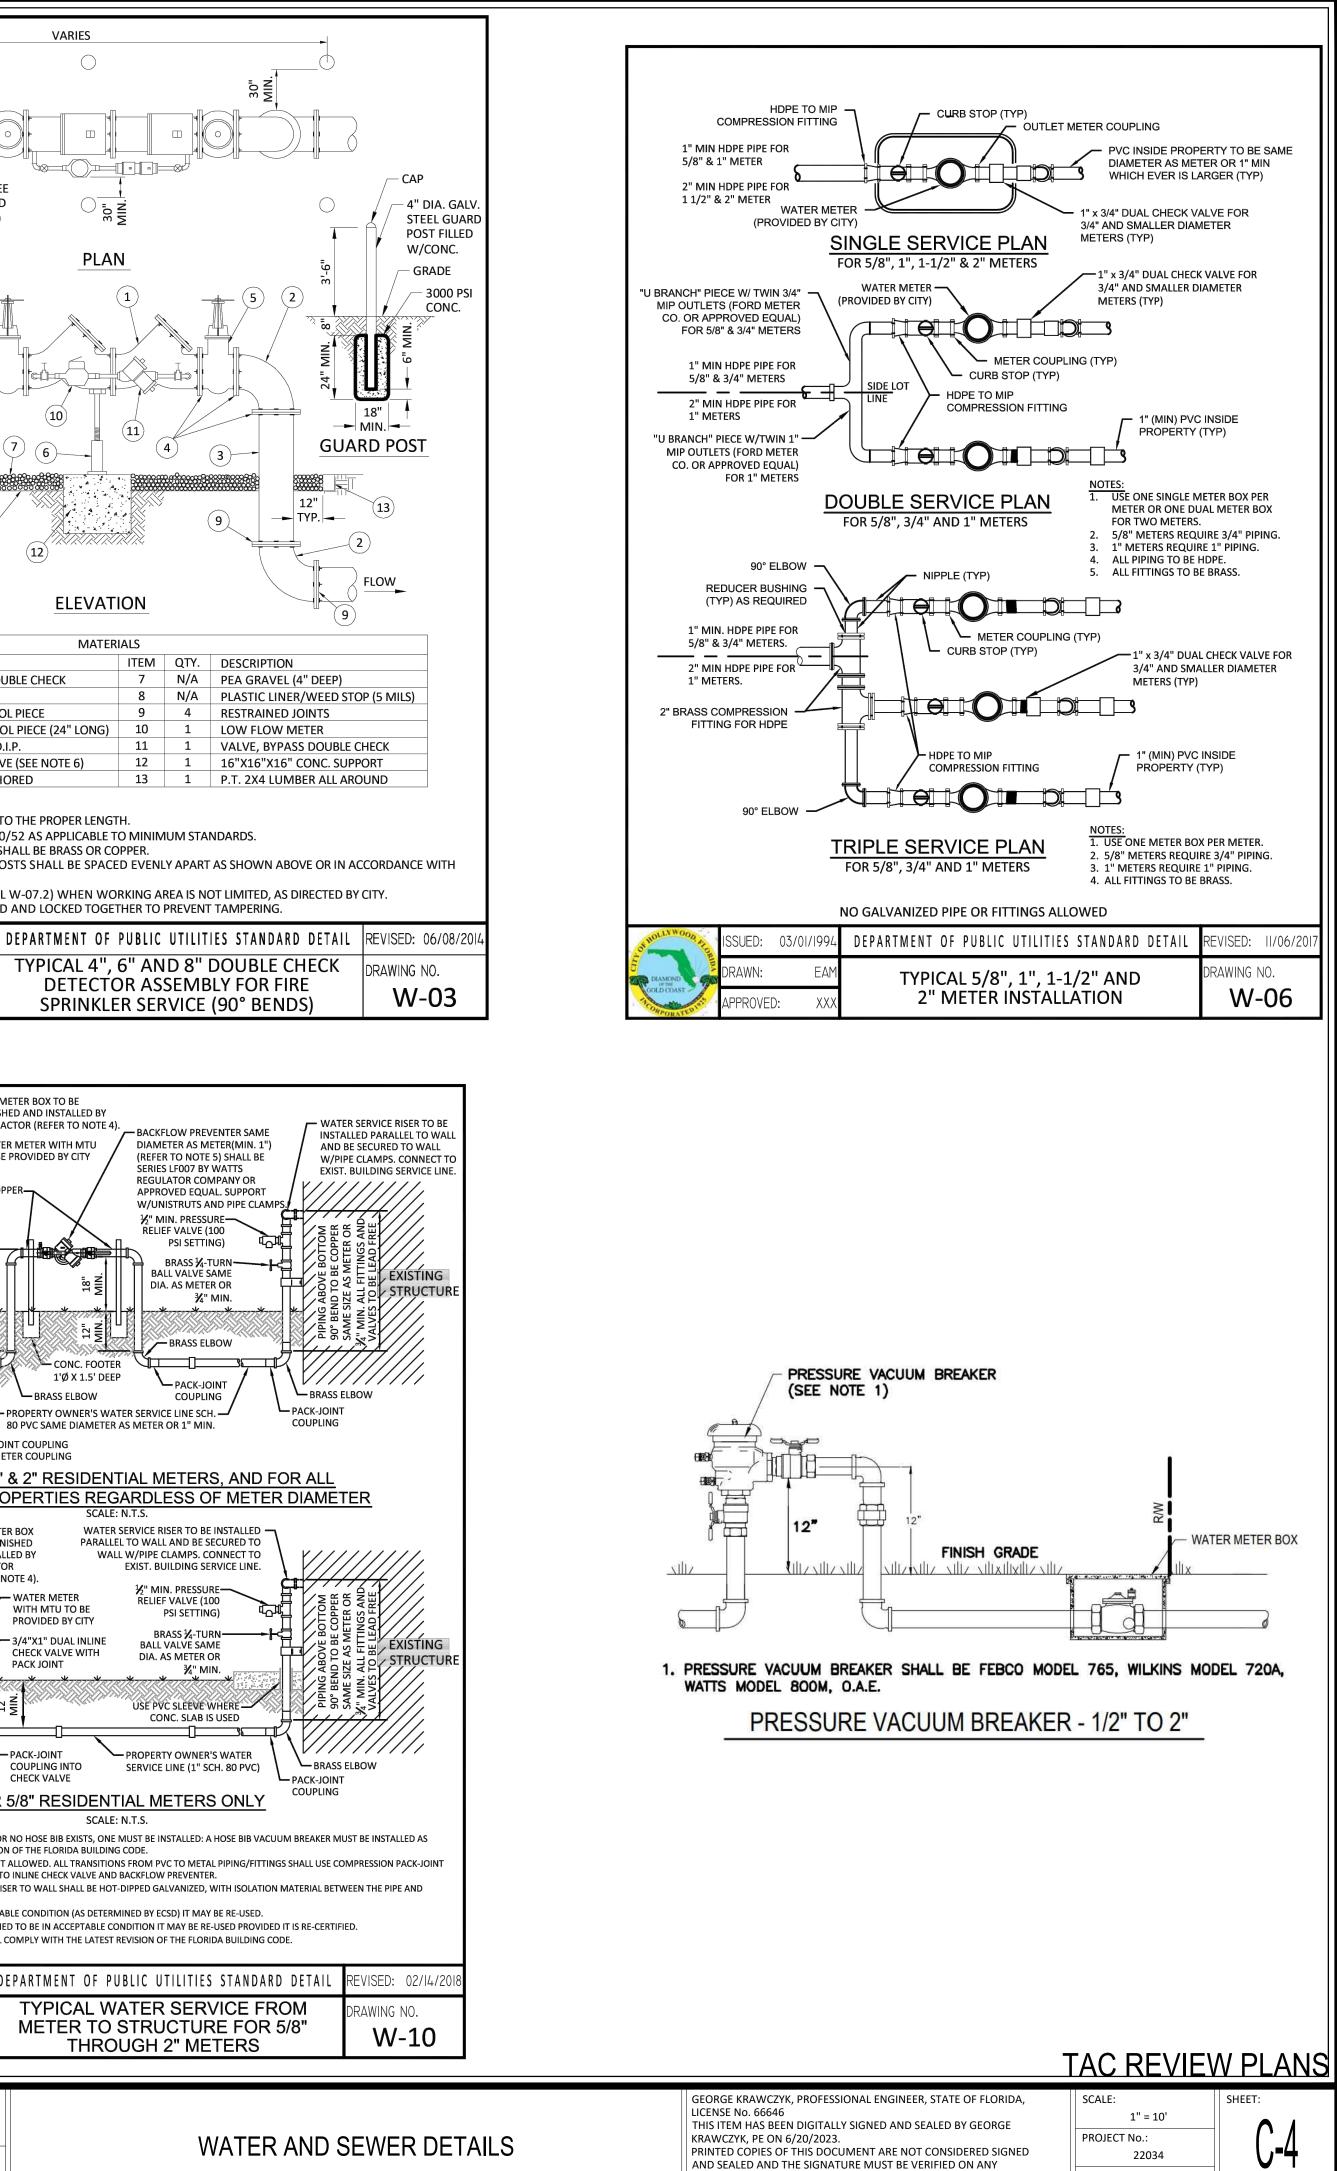

ELECTRONIC COPIES

CAD FILE: 22034 GN.dwg



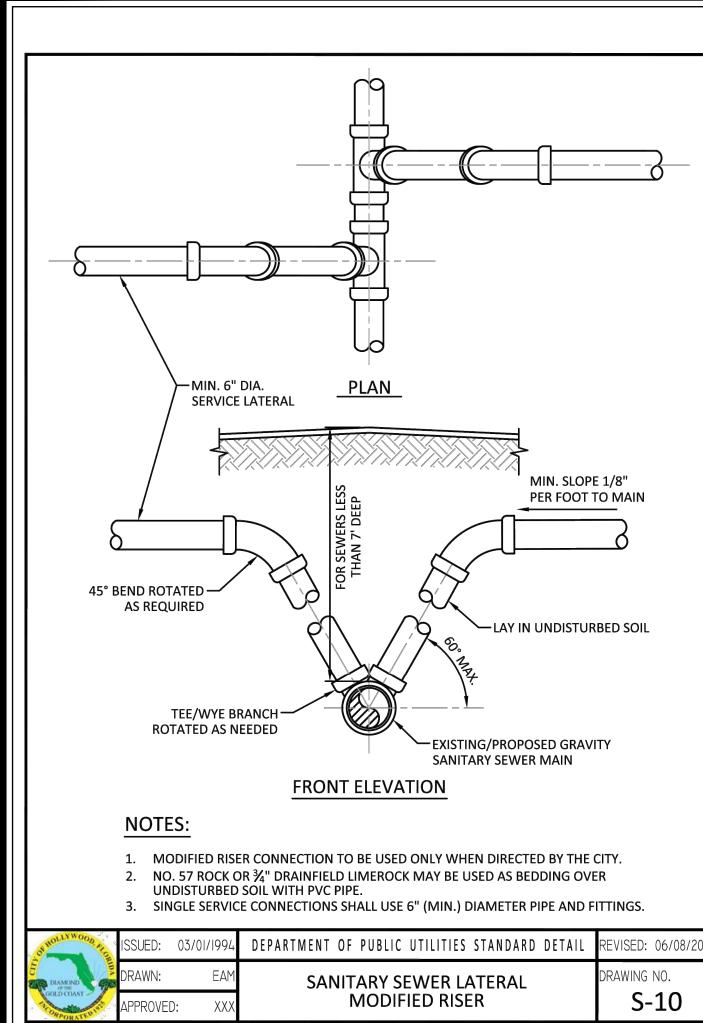

BY No.

DATE

REVISION

DESIGNED: GK

CHECKED: JFT

7/20/2022

7/20/2022

7/20/2022

DATE:

DATE:

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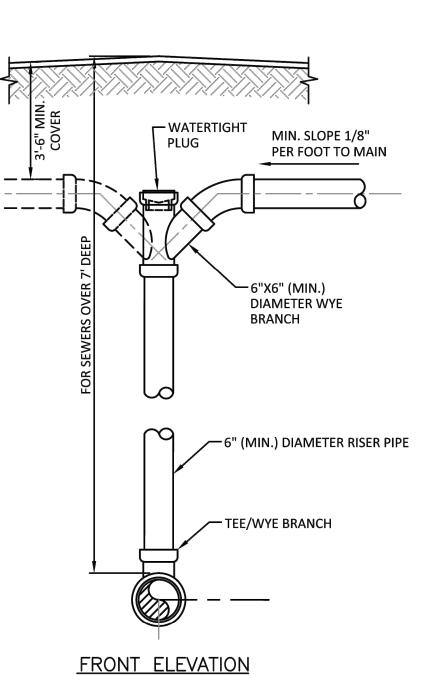
BY

E NOTES:	6" (MIN.) DIAMETER RISER PIPE TEE/WYE BRANCH
_	
 RISER CONNECTION TO E DEEP OR WHEN DIRECTE NO. 57 ROCK OR ¾" DRA UNDISTURBED SOIL WIT 	AINFIELD LIMEROCK MAY BE USED AS BEDDING OVER
	MENT OF PUBLIC UTILITIES STANDARD DETAIL REVISED: 06/08 SANITARY SEWER LATERAL VERTICAL RISER S-11
RESILIENT SEATED GATE VA 4" THROUGH 12" SIZE (WATER AND FORCE MAIN)	
REQUIREMENTS OF AWWA C509 (LA SPECIFICATIONS:	EATED, MANUFACTURED TO MEET OR EXCEED THE ATEST REVISION) AND IN ACCORDANCE WITH THE FOLLOWING
NOMINAL DIAMETER OF THE VA 1.2. THE VALVES ARE TO BE NON-RIS BRONZE SHOWN IN AWWA C509	STRUCTED WATERWAY EQUAL TO OR GREATER THAN THE FULL ALVE. ISING STEM WITH THE STEM MADE OF CAST, FORGED OR ROLLED 09, TWO STEM SEALS SHALL BE PROVIDED AND SHALL BE OF THE ONE BELOW THE THRUST COLLAR WITH LUBRICANT BETWEEN
O-RING.	F BRONZE, MAY BE INDEPENDENT OF THE GATE OR CAST
INTEGRALLY WITH THE GATE. IF STRAIGHT AND TRUE WITH THE	F THE STEM NUT IS CAST INTEGRALLY, THE THREADS SHALL BE E AXIS OF THE STEM TO AVOID BINDING DURING THE OPENING OF
INTEGRALLY WITH THE GATE. IF STRAIGHT AND TRUE WITH THE CLOSING CYCLE. 1.4. THE SEALING MECHANISM SHAL SYNTHETIC RUBBER COATING OF RESILIENT SEALING MECHANISM	
 INTEGRALLY WITH THE GATE. IF STRAIGHT AND TRUE WITH THE CLOSING CYCLE. 1.4. THE SEALING MECHANISM SHAL SYNTHETIC RUBBER COATING OF RESILIENT SEALING MECHANISM PRESSURE WHEN INSTALLED WITH 	E AXIS OF THE STEM TO AVOID BINDING DURING THE OPENING OF ALL CONSISTS OF A CAST IRON GATE HAVING A VULCANIZED OR A RUBBER SEAT MECHANICALLY RETAINED ON THE GATE, THE M SHALL PROVIDE ZERO LEAKAGE AT THE WATER WORKING


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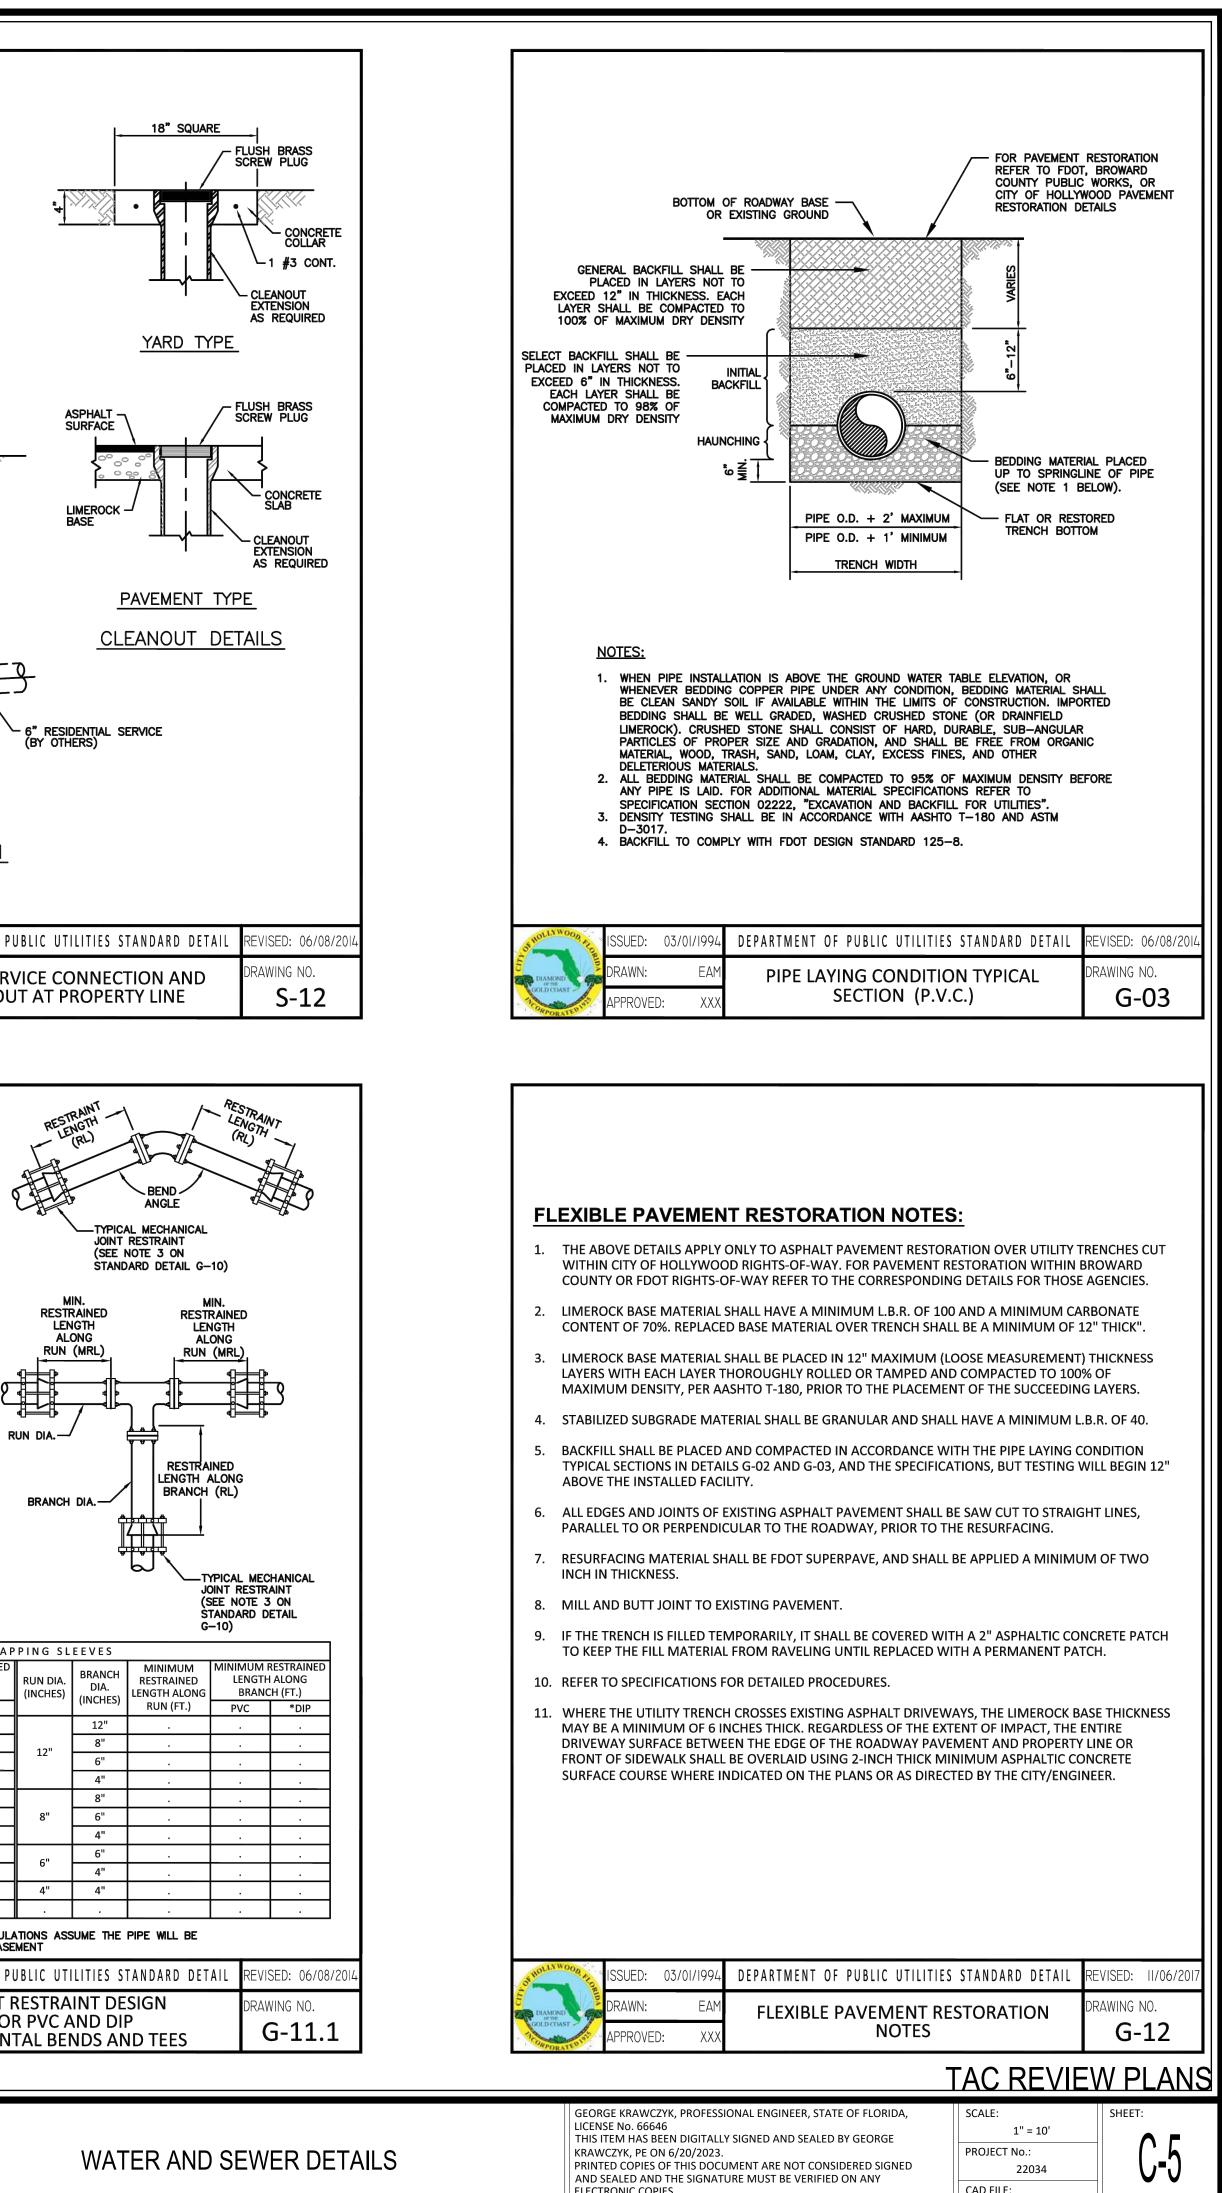
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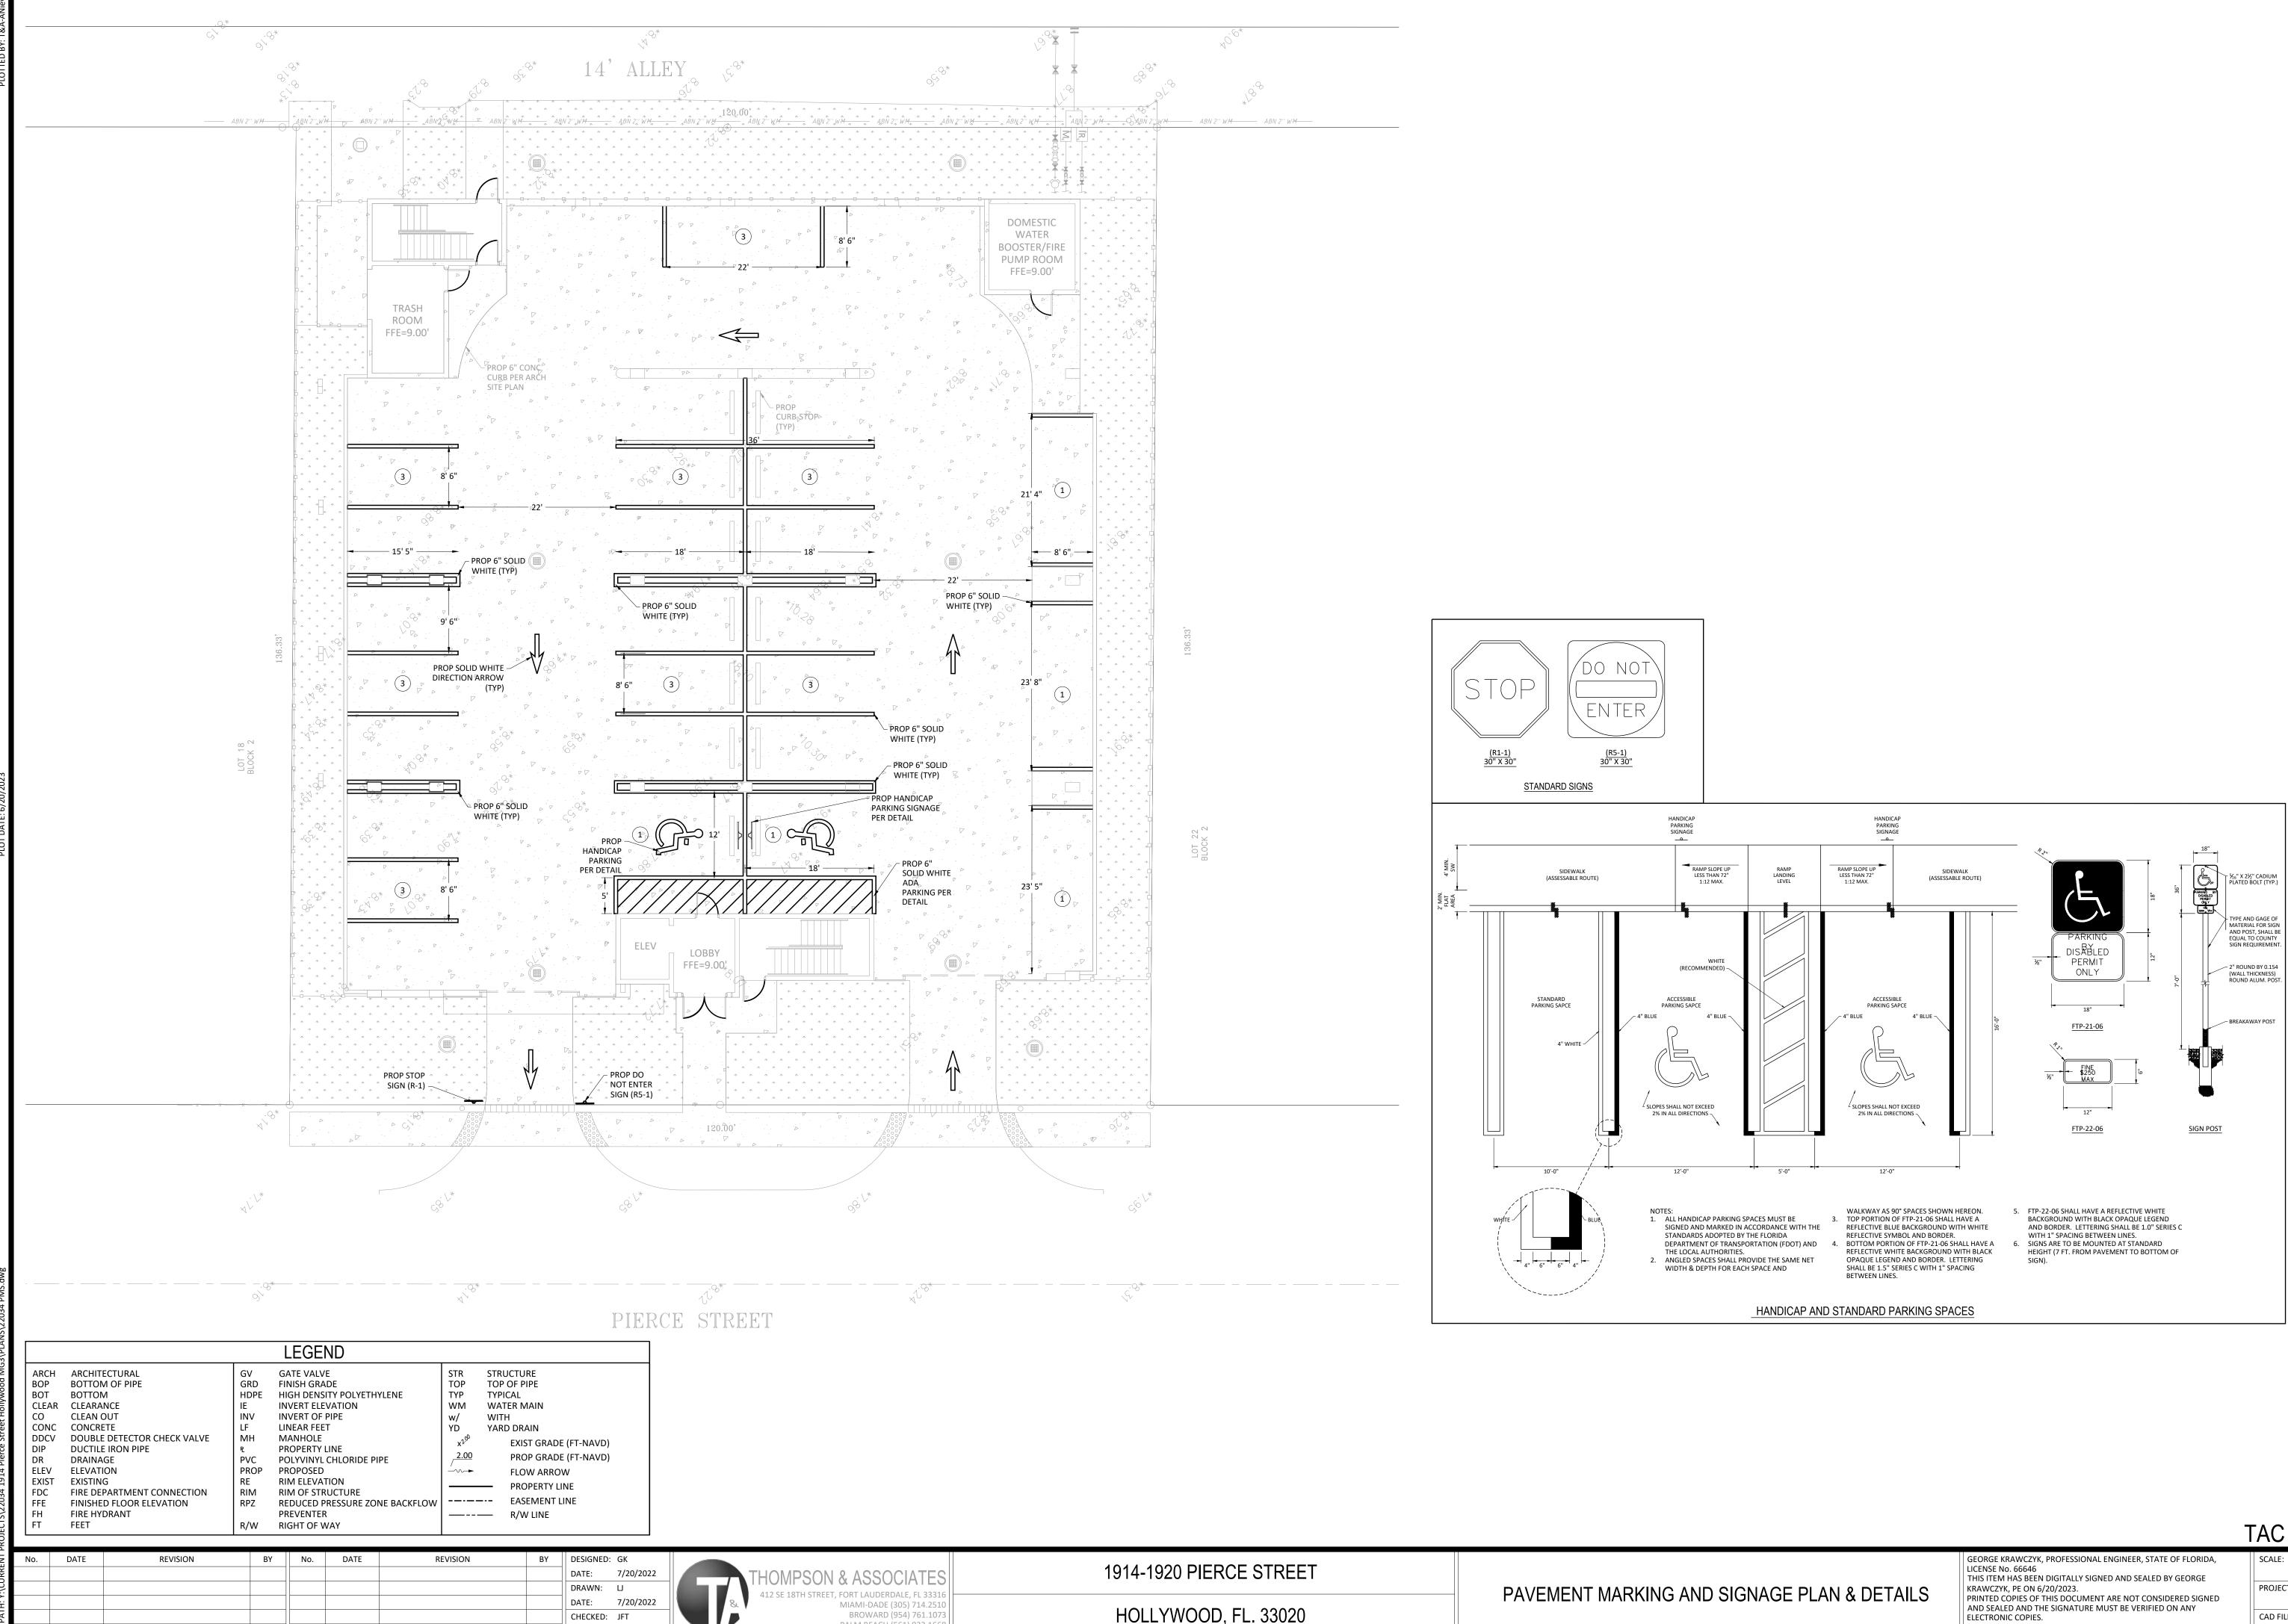
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/1994	DEPARTMENT OF PUBLIC UTILITIES STANDARD DETAIL	REVISED: 06/08/2014
EAM	RESILIENT SEATED GATE VALVE	DRAWING NO.
XXX	SPECIFICATIONS	G-07.1

SON	& ASSOCIATES
I STREET,	FORT LAUDERDALE, FL 33316 MIAMI-DADE (305) 714.2510
	BROWARD (954) 761.1073
	PALM BEACH (561) 932.1668

1914-1920 PIERCE STREET

HOLLYWOOD, FL. 33020

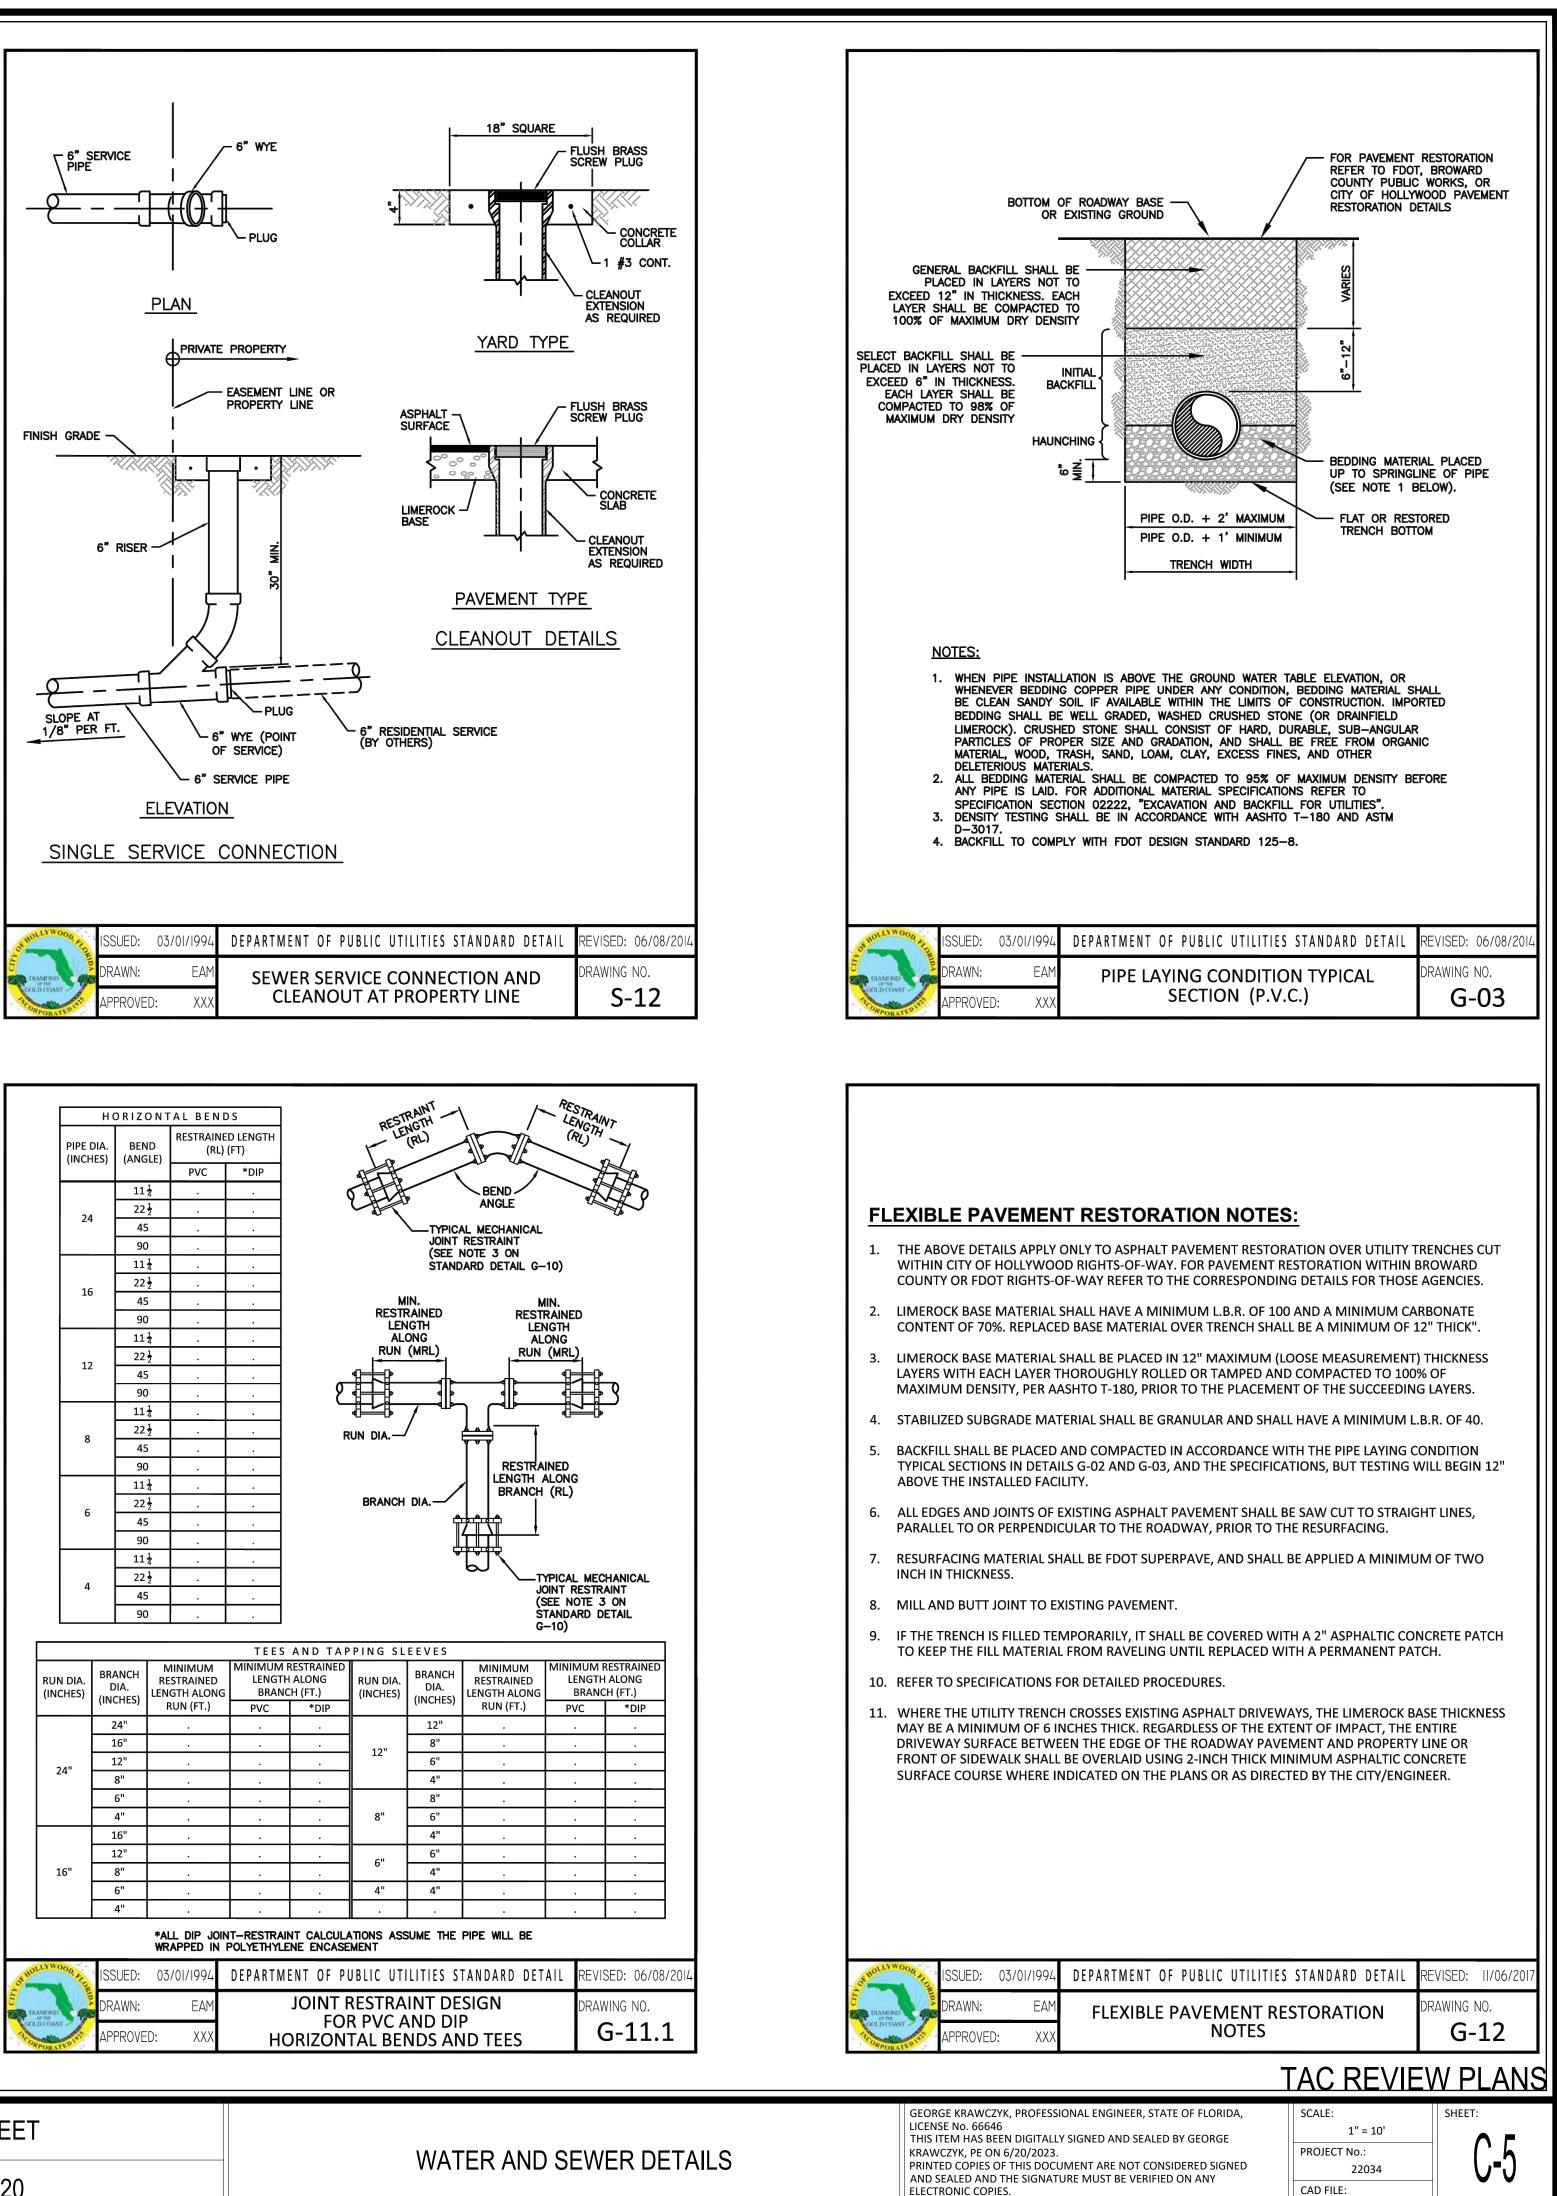

SON	& ASSOCIA ⁻	ΓES
	FORT LAUDERDALE, FL MIAMI-DADE (305) 71 BROWARD (954) 76	33316 4.2510
	PALM BEACH (561) 93	

DATE:

7/20/2022

HOLLYWOOD, FL. 33020

TAC REVIEW PLANS

1" = 10' PROJECT No.: 22034 CAD FILE: 22034 PMS.dwg

SHEET: $\land \land$ 6-0

GRAPHIC SCALE (IN FEET) 1 INCH = 10 FEET

SECTION 1: GENERAL NOTES

APPLICABLE CODES

- A. ALL CONSTRUCTION WITHIN THE LIMITS OF PUBLIC RIGHTS OF WAY THAT FALLS UNDER CITY OF HOLLYWOOD JURISDICTION SHALL CONFORM TO CITY OF HOLLYWOOD DESIGN GUIDELINES, LATEST EDITION. B. ALL CONSTRUCTION SHALL BE DONE IN A SAFE MANNER, SPECIFICALLY, THE RULES AND REGULATIONS OF THE OCCUPATIONAL SAFETY AND HEALTH ADMINISTRATION (OSHA) AND THE MANUAL OF UNIFORM TRAFFIC CONTROL
- DEVICES (M.U.T.C.D.) SHALL BE STRICTLY OBSERVED. C. ALL ELEVATIONS ON THE PLANS OR REFERENCED IN THE SPECIFICATIONS ARE BASED ON THE NORTH AMERICAN VERTICAL DATUM OF 1988 (NAVD 88).

2. PRE-CONSTRUCTION RESPONSIBILITY

- A. UPON THE RECEIPT OF THE "NOTICE TO PROCEED", PRIOR TO COMMENCING WORK, THE CONTRACTOR SHALL CONTACT THE ENGINEER OF RECORD AND ARRANGE A PRE-CONSTRUCTION CONFERENCE TO INCLUDE CITY OF HOLLYWOOD. UTILITY OWNERS. THE OWNER AND THE ENGINEER OF RECORD. B. THE CONTRACTOR SHALL OBTAIN A "SUNSHINE ONE CALL" CERTIFICATION NUMBER AT LEAST 2 WORKING DAYS PRIOR
- TO BEGINNING ANY EXCAVATION. C. ALL APPLICABLE PERMITS SHALL BE OBTAINED BY THE CONTRACTOR PRIOR TO START OF CONSTRUCTION.
- D. PRIOR TO BEGINNING CONSTRUCTION, THE CONTRACTOR SHALL VERIFY THE SIZE, LOCATION, ELEVATION, AND MATERIAL OF ALL EXISTING UTILITIES WITHIN THE AREA OF CONSTRUCTION. E. THE CONTRACTOR SHALL BE RESPONSIBLE FOR DAMAGE TO ANY EXISTING UTILITIES FOR WHICH THE CONTRACTOR FAILS TO REQUEST LOCATIONS FROM SUNSHINE ONE CALL. THE CONTRACTOR IS ALSO RESPONSIBLE FOR DAMAGE TO ANY
- EXISTING UTILITIES WHICH ARE PROPERLY LOCATED. IF UPON EXCAVATION, AN EXISTING UTILITY IS FOUND TO BE IN CONFLICT WITH THE PROPOSED CONSTRUCTION OR TO
- BE OF A SIZE OR MATERIAL DIFFERENT FROM THAT SHOWN ON THE PLANS, THE CONTRACTOR SHALL IMMEDIATELY NOTIFY THE ENGINEER OF RECORD, WHO WILL IN TURN NOTIFY THE APPROPRIATE UTILITY OWNER.
- G. THE CONTRACTOR WILL VERIFY THE RESTRAINT OF EXISTING UTILITY LINES, AND SHALL RESTRAIN AS NECESSARY TO PREVENT BLOWOUTS, PRIOR TO CONNECTING TO EXISTING UTILITIES.

INSPECTIONS

THE CONTRACTOR SHALL NOTIFY CITY OF HOLLYWOOD AND THE ENGINEER OF RECORD AND ANY OTHER GOVERNMENTAL AGENCIES HAVING JURISDICTION AT LEAST 24 HOURS PRIOR TO BEGINNING CONSTRUCTION AND PRIOR TO THE INSPECTION OF THE FOLLOWING ITEMS, WHERE APPLICABLE.

- A. STORM DRAINAGE B. SANITARY SEWER
- WATER SYSTEM
- D. SUBGRADE: SUBMIT AND HAVE APPROVED DENSITIES PRIOR TO PLACEMENT OF ROCK E. LIMEROCK BASE: SUBMIT AND HAVE APPROVED DENSITIES AND AS-BUILTS PRIOR TO THE PLACEMENT OF ANY ASPHALT
- F. ASPHALTIC CONCRETE
- G. CLEARING AND FILLING
- H. FINAL CLOSEOUT I. SHOP DRAWINGS
- a. PRIOR TO ISSUANCE OF A CONSTRUCTION PERMIT, CONTRACTOR REVIEWED AND APPROVED SHOP DRAWINGS SHALL BE SUBMITTED TO AND REVIEWED BY THE ENGINEER OF RECORD AND CITY OF HOLLYWOOD FOR SANITARY MANHOLES, HYDRANTS, VALVES, PIPING, LIFT STATIONS AND OTHER ACCESSORIES. CATALOG LITERATURE SHALL BE SUBMITTED FOR WATER AND SEWER PIPES, FITTINGS AND APPURTENANCES.
- b. INDIVIDUAL SHOP DRAWINGS FOR ALL PRECAST STRUCTURES ARE REQUIRED. CATALOG LITERATURE WILL NOT BE ACCEPTED FOR PRECAST STRUCTURES. c. IT IS THE RESPONSIBILITY OF THE CONTRACTOR TO OBTAIN ALL OTHER AGENCY APPROVAL, IF REQUIRED.

SECTION 2: EARTHWORK AND COMPACTION NOTES:

GENERAL:

- A. QUALITY, CONTROL TESTING FOR STABILIZATION, BASE, PAVEMENT, COMPACTION, AND MATERIALS SHALL BE IN ACCORDANCE WITH FLORIDA D.O.T. REQUIREMENTS, AND SHALL BE ARRANGED FOR AND PAID FOR BY THE CONTRACTOR, COPIES OF ALL TEST REPORTS SHALL BE PROVIDED TO THE ENGINEER OF RECORD AS THEY ARE RECEIVED. . EXISTING ON-SITE BASE MATERIAL SHALL NOT BE REUSED FOR BASE CONSTRUCTION, BUT MAY BE USED FOR BACKFILL AROUND UTILITY AND DRAINAGE LINES, AND FOR SUBGRADE CONSTRUCTION, AND FOR GENERAL FILL IF NECESSARY.
- C. ALL SUBGRADE UNDER PAVED AREAS SHALL HAVE A MINIMUM L.B.R. VALUE OF 40 AND SHALL BE COMPACTED TO 100% OF THE MAXIMUM DENSITY AS DETERMINED BY AASHTO T-99-C.
- D. ALL SUBGRADE UNDER SIDEWALK AREAS SHALL HAVE A MINIMUM OF 6" COMPACTED SUBGRADE TO 98% OF THE MAXIMUM DENSITY AS DETERMINED BY AASHTO T-180. E. ALL FILL MATERIAL IN AREAS NOT TO BE PAVED SHALL BE COMPACTED TO 95% OF THE MAXIMUM DENSITY AS
- DETERMINED BY AASHTO T-99-C. F. A 2" BLANKET OF TOP SOIL SHALL BE PLACED OVER ALL AREAS TO BE SODDED.
- G. SOD SHALL BE ST. AUGUSTINE, BITTER BLUE OR FLORATAM AND SHALL BE PLACED ON THE GRADED TOP SOIL AND WATERED TO ENSURE SATISFACTORY CONDITION UPON FINAL ACCEPTANCE OF THE PROJECT. H. WHEN WORKING IN AND AROUND EXISTING DRAINAGE CANALS OR LAKES, APPROPRIATE SILT BARRIERS SHALL BE INSTALLED
- I. NO MUCK BLANKET IS TO BE PLACED ON THE BOTTOM OF RETENTION AREAS OR SWALES.

ON-SITE

- A. ALL ORGANIC AND OTHER UNSUITABLE MATERIAL WITHIN THREE (3) FEET OF FINISHED GRADE AREAS TO BE PAVED SHALL BE REMOVED. B. SUITABLE BACKFILL SHALL BE MINIMUM L.B.R. 40 MATERIAL COMPACTED TO 95% OF THE MAXIMUM DENSITY AS DETERMINED BY AASHTO T-99-C FOR THREE (3) FEET BEYOND THE PERIMETER OF THE PAVING.
- C. EROSION CONTROL SHALL BE PROVIDED BY THE CONTRACTOR PER DETAILS ON THE PLANS.

SECTION 3: STORM DRAINAGE NOTES:

- 1. GENERAL:
- A. EXISTING STORM DRAINAGE GRATES, FRAMES, MANHOLE COVERS, AND RINGS THAT ARE TO BE REMOVED OR ADJUSTED, MAY BE REUSED ON THE SITE. B. THE EXISTING DRAINAGE SYSTEM SHALL BE CLEANED AND/OR GRADED TO ENSURE PROPER FLOW FUNCTION.
- C. THE CONTRACTOR SHALL INSTALL FILTER FABRIC AT ALL CATCH BASIN GRATES UNTIL FINAL ACCEPTANCE OF THE STORM DRAINAGE SYSTEM.
- CONTRACTOR MAY UTILIZE ONE OF THE FOLLOWING MATERIALS, UNLESS OTHERWISE NOTED ON THE PLANS.
- A. HIGH DENSITY POLYETHYLENE PIPE (H.D.P.E.) a. PIPE SHALL BE CORRUGATED SMOOTH BORE POLYETHYLENE PIPE (N-12 PRO LINK ULTRA) OR APPROVED EQUAL. MANUFACTURED IN CONFORMANCE WITH ASTM M294.
- b. PIPE SHALL HAVE BUILT-IN BELL JOINT WITH RUBBER GASKET IN CONFORMANCE WITH ASTM F477. c. PIPE COUPLING BANDS IF NEEDED SHALL BE SPLIT/SPLIT PREMIUM REQUIRING MAXIMUM PULL-APART RESISTANCE
- B. POLYVINYL CHLORIDE PIPE (P.V.C.) a. PLASTIC PIPE SHALL CONFORM WITH ASTM D 3034, TYPE PSM, POLYVINYL CHLORIDE (PVC) MATERIAL; BELL AND SPIGOT STYLE SOLVENT SEALED EN JOINTS.
- ALUMINUM PIPE (C.A.P.) a. ALUMINUM PIPE SHALL CONFORM TO AASHTO M196 FOR CIRCULAR CORRUGATED PIPE OF AASHTO M211 FOR HELICALLY CORRUGATED PIPE, AND SECTION 945, AS PER FDOT STANDARD SPECIFICATIONS.
- b. MAKE FIELD JOINTS IN (CAP) WITH BANDS FABRICATED OF THE SAME ALLOY AS THE CULVERT PIPE AND CONFORMING TO THE REQUIREMENTS OF AASHTO M196.
- c. GASKET THE BANDED JOINTS WITH A NEOPRENE GASKET OF THE DESIGN INDICATED TO SECURE A SOIL-TIGHT OR WATERTIGHT JOINT. D. REINFORCED CONCRETE PIPE (R.C.P.)
- a. CONCRETE PIPE FOR STORM SEWERS SHALL CONFORM TO ASTM C 76, CLASS III WITH WALL TYPE A; BAR REINFORCEMENT. b. ALL REINFORCEMENT CONCRETE PIPES SHALL HAVE BELL AND SPIGOT END JOINTS, AS MODIFIED BY SECTION 941,
- FDOT STANDARD SPECIFICATIONS. c. ALL REINFORCEMENT CONCRETE PIPES SHALL HAVE RUBBER COMPRESSION GASKET JOINTS, AS PER ASTM C443, UNLESS OTHERWISE SPECIFIED.
- MISCELLANEOUS
- A. BEDDING AND INITIAL BACKFILL OVER DRAINAGE PIPES (EXCEPT FRENCH DRAINS) SHALL BE SAND WITH NO ROCKS LARGER THAN 2" DIAMETER. B. BACKFILL MATERIAL UNDER PAVED AREAS SHALL BE COMPACTED TO 100% OF THE MAXIMUM DENSITY AS DETERMINED
- BY AASHTO T-99-C. C. BACKFILL MATERIAL UNDER AREAS NOT TO BE PAVED SHALL BE COMPACTED TO 95% OF THE MAXIMUM DENSITY AS DETERMINED BY AASHTO T-99-C.
- D. CATCH BASINS SHALL BE PRECAST MINIMUM 3000 PSI CONCRETE WITH REINFORCED STEEL PER ASTM A615.

4. INSTALLATION

- A. PIPE SHALL BE PLACED ON STABLE GRANULAR MATERIAL FREE OF ROCK FORMATION OTHER FOREIGN FORMATIONS,
- AND CONSTRUCTED TO UNIFORM GRADE AND LINE B. BACKFILL MATERIAL SHALL BE WELL GRADED GRANULAR MATERIAL WELL TAMPED AND PLACED IN 6 INCH (MAXIMUM)
- LAYERS. C. PROVIDE A MINIMUM COVER OF 24 INCHES OVER STORM DRAINAGE, CROSSING BY HEAVY CONSTRUCTION VEHICLES DURING CONSTRUCTION SHALL NOT BE ALLOWED WITH LESS THAN 24 INCHES OF COVER.
- DATE BY No. DATE REVISION REVISION BY DESIGNED: GK DATE: 7/20/2022 DRAWN: DATE: 7/20/2022 CHECKED: JFT DATE 7/20/2022

- OF THE CONSTRUCTION AND INSPECTION. DRAINAGE INSPECTION.

- APPROXIMATELY 120 PERFORATIONS PER FOOT.
 - SHALL BE NON-PERFORATED PIPE. E. PIPES SHALL TERMINATE TWO (2) FEET FROM THE END OF THE TRENCH OR CONNECT TO ADDITIONAL CATCH BASINS.

SECTION 5: SIGNING AND MARKING NOTES:

1. GENERAL

- B.C.T.E.D. SPECIFICATIONS.
 - THE PROPOSED ROADWAY CONSTRUCTION.
 - THE PLANS AND APPLICABLE TRAFFIC DESIGN STANDARDS.
 - END OF THE PROJECT.
- APPROVAL AGENCIES' INSPECTOR.

SECTION 7: SANITARY SEWER SYSTEM

- 1. MATERIALS
- A. GRAVITY SEWER PIPE AND FITTINGS

- 2. INSTALLATION
- A. SERVICES

- CUT BACK TO FINISHED GRADE.

- **BEGINNING WORK IN ANY AREA.**

- DEWATERING.

OF HOLLYWOOD ALO	ISSUED:	03/01/1994	DEPARTMENT OF PUBLIC UTILITIES STANDARD DETAIL	REVISED:	11/06/2017
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D. THE CONTRACTOR SHALL NOTIFY THE LOCAL WATER MANAGEMENT DISTRICT AT LEAST 24 HOURS PRIOR TO THE START E. ALL DRAINAGE SYSTEMS SHALL BE PUMPED COMPLETELY DRY AND LAMPED AS A REQUIREMENT OF THE FINAL

5. STORM DRAINAGE PRE-TREATMENT/EXFILTRATION SYSTEM

A. ANY CONFLICT WITH EXISTING OR PROPOSED UTILITIES SHALL IMMEDIATELY BE BROUGHT TO THE ATTENTION OF THE ENGINEER OF RECORD. ANY IMPERMEABLE MATERIAL ENCOUNTERED IN THE EXCAVATION FOR THE DRAIN FIELD SHALL BE REMOVED AS DIRECTED BY THE ENGINEER OF RECORD. B. THE TRENCH LINER SHALL BE TYPE D-3 PER F.D.O.T. INDEX 199, OR APPROVED EQUAL. IT SHALL BE USED ON THE SIDES AND TOP OF DRAIN FIELD TRENCH. THE TOP SECTION OF THE MATERIAL SHALL BE OVERLAPPED A MINIMUM OF 24 INCHES AND THE CONTRACTOR SHALL TAKE EXTREME CARE IN BACKFILLING TO AVOID BUNCHING OF THE FABRIC. C. PERFORATED PIPE WITHIN THE DRAIN FIELD SHALL HAVE 3/8 INCH PERFORATIONS 360° AROUND THE PIPE WITH

D. PERFORATED PIPE SHALL TERMINATE FIVE (5) FEET FROM THE DRAINAGE STRUCTURE. THE REMAINING FIVE (5) FEET

A. ALL PAVEMENT MARKINGS AND SIGNING SHALL BE IN ACCORDANCE WITH CITY OF HOLLYWOOD, AND THE STANDARD SPECIFICATIONS OF THE FLORIDA DEPARTMENT OF TRANSPORTATION. B. ALL OFF-SITE MARKINGS TO BE THERMOPLASTIC PER FLORIDA DEPARTMENT OF TRANSPORTATION SPECIFICATIONS, AND ALL ON-SITE MARKINGS SHALL BE TRAFFIC PAINT PER CITY OF HOLLYWOOD SPECIFICATIONS, UNLESS OTHERWISE NOTED. C. INSTALL REFLECTIVE PAVEMENT MARKERS PER F.D.O.T. STANDARDS, OR AS SHOWN ON THE PLANS.

D. ALL SIGNS SHALL BE HIGH-INTENSITY GRADE REFLECTIVE SHEETING, MOUNTED ON A BREAK AWAY POST ASSEMBLY PER E. CONTRACTOR SHALL BE RESPONSIBLE FOR THE REMOVAL OF ALL PAVEMENT MARKINGS AND SIGNS CONFLICTING WITH

F. CONTRACTOR SHALL BE RESPONSIBLE FOR THE INSTALLATION OF ALL PAVEMENT MARKINGS AND SIGNS AS SHOWN IN G. CONTRACTOR SHALL BE RESPONSIBLE FOR MATCHING EXISTING PAVEMENT MARKINGS AT THE BEGINNING AND AT THE

H. SIGN ASSEMBLY LOCATIONS SHOWN IN THE PLANS WHICH ARE IN CONFLICT WITH STREET LIGHTING UTILITIES, DRIVEWAYS, PEDESTRIAN RAMPS ETC. MAY BE ADJUSTED AS DIRECTED BY THE ENGINEER OF RECORD AND/OR

a. PVC SEWER PIPE AND FITTINGS SHALL BE NON-PRESSURE POLYVINYL CHLORIDE PIPE CONFORMING TO ASTM D-3034, SDR 35, WITH PUSH-ON RUBBER GASKET JOINTS UNLESS OTHERWISE NOTED. b. THE INTERIOR OF THE DUCTILE IRON PIPE (DIP) SHALL BE EPOXY LINED CONFORMING TO ANSI/AWWA C104/A21.4 LATEST REVISION, OR POLYETHYLENE LINED CONFORMING TO ANSI/AWWA C105/A21.5, OR APPROVED EQUAL AND SHALL HAVE A COAL TAR EPOXY EXTERIOR COATING, MANUFACTURED IN ACCORDANCE TO ANSI/AWWA

C151/A21.51 OR LATEST REVISION, MINIMUM WALL THICKNESS CLASS 350 (UNLESS OTHERWISE SPECIFIED). CLASS 52 SHALL BE USED IN PAVED AREAS. c. ALL FITTINGS AND ACCESSORIES SHALL BE AS MANUFACTURED OR SUPPLIED BY THE PIPE MANUFACTURER.

a. MINIMUM SLOPE OF ALL SERVICE LINES SHALL BE AS INDICATED IN THE "FLORIDA BUILDING CODE".

SERVICE LATERALS SHALL TERMINATE AT A DEPTH NOT TO EXCEED 30 INCHES BELOW FINISHED GRADE.

EACH SERVICE CONNECTION SHALL BE PLUGGED WATERTIGHT WITH AN APPROVED PLUG. d. THE END OF EACH SERVICE CONNECTION SHALL BE MARKED WITH 2 INCH X 4 INCH TREATED STAKE PAINTED RED,

EXTENDING 18 INCHES (MINIMUM) ABOVE GRADE. IF HOUSE CONNECTION IS NOT MADE WITHIN THIRTY DAYS, A CLEAN-OUT INSIDE A VALVE BOX WITH AN ELECTRONIC MARKER MUST BE INSTALLED. e. CONTRACTOR SHALL ROUGH IN RISER TO 1 FOOT ABOVE FINISHED GRADE AND PLUG. AT PROJECT COMPLETION,

CONNECTION OF SERVICES TO BUILDING'S PLUMBING SHALL BE COORDINATED WITH THE APPROPRIATE MUNICIPAL BUILDING DEPARTMENT, PLUMBING SECTION.

GENERAL NOTES (CONTINUED):

27. THE CONTRACTOR SHALL BE RESPONSIBLE FOR MAINTAINING THE INTEGRITY OF AND MAKING THE REPAIRS TO EXISTING PAVEMENT, SIDEWALKS, PIPES, CONDUITS, CURBS, CABLES, ETC., WHETHER OR NOT SHOWN ON THE PLANS DAMAGED AS A RESULT OF THE CONTRACTORS OPERATIONS AND/OR THOSE OF HIS SUBCONTRACTORS, AND SHALL RESTORE THEM PROMPTLY AT NO ADDITIONAL EXPENSE TO THE OWNER. CONTRACTOR SHALL REPORT ANY DAMAGE TO SIDEWALK, DRIVEWAY, ETC., PRIOR TO

28. WHERE NEW PAVEMENT MEETS EXISTING, CONNECTION SHALL BE MADE IN A NEAT STRAIGHT LINE AND FLUSH WITH EXISTING PAVEMENT TO MATCH EXISTING CONDITIONS.

29. UNDER NO CIRCUMSTANCES SHALL THE CONTRACTOR LEAVE EXCAVATED TRENCHES, OR PARTS OF, EXPOSED OR OPENED AT THE END OF THE WORKING DAY, WEEKENDS, HOLIDAYS OR OTHER TIMES, WHEN THE CONTRACTOR IS NOT WORKING, UNLESS OTHERWISE DIRECTED. ALL TRENCHES SHALL BE COVERED, FIRMLY SECURED AND MARKED ACCORDINGLY FOR PEDESTRIAN / VEHICULAR TRAFFIC.

30. ALL EXCAVATED MATERIAL REMOVED FROM THIS PROJECT SHALL BE DISPOSED OF OFF THE PROPERTY BY THE CONTRACTOR AT THE CONTRACTOR'S EXPENSE.

31. ALL DUCTILE IRON PRODUCTS SHALL BE DOMESTIC MADE HEAVY DUTY CLASSIFICATION SUITABLE FOR HIGHWAY TRAFFIC LOADS, OR 20,000 LB.

32. ALL GRASSED AREAS AFFECTED BY CONSTRUCTION SHALL BE RE-SODDED.

33. THE CONTRACTOR SHALL BE RESPONSIBLE FOR THE PROVISION, INSTALLATION AND MAINTENANCE OF ALL TRAFFIC CONTROL AND SAFETY DEVICES, IN ACCORDANCE WITH SPECIFICATIONS OF THE LATEST REVISION OF FDOT DESIGN STANDARDS. IN ADDITION, THE CONTRACTOR IS RESPONSIBLE FOR THE RESETTING OF ALL TRAFFIC CONTROL AND INFORMATION SIGNAGE REMOVED DURING THE CONSTRUCTION PERIOD.

34. EXCAVATED OR OTHER MATERIAL STORED ADJACENT TO OR PARTIALLY UPON A ROADWAY PAVEMENT SHALL BE ADEQUATELY MARKED FOR TRAFFIC SAFETY AT ALL TIMES.

35. TEMPORARY PATCH MATERIAL MUST BE ON THE JOB SITE WHENEVER PAVEMENT IS CUT, OR THE CITY'S INSPECTOR WILL SHUT THE JOB DOWN.


36. CONTRACTOR MUST PROVIDE FLASHER ARROW SIGNAL FOR ANY LANE THAT IS CLOSED OR DIVERTED.

37. CONTRACTOR SHALL NOTIFY LAW ENFORCEMENT AND FIRE PROTECTION SERVICES TWENTY-FOUR (24) HOURS IN ADVANCE OF TRAFFIC DETOUR IN ACCORDANCE WITH SECTION 336.07 OF FLORIDA STATUTES.

38. CONTRACTOR TO RESTORE PAVEMENT TO ORIGINAL CONDITION AS REQUIRED.

39. CONTRACTOR SHALL BE RESPONSIBLE FOR PROVIDING DEWATERING PER SPECIFICATION SECTION 02140


	DED IN THESE DRAWINGS IS SOLELY TO ASSIST THE CONTRACT		12. CITY		LL NOT PROVIDE STAGING / STO	DRAGE AREA. CONTRACTOR SHA	ALL SECURE
WORK. THE CONTRACTORS THEY DEEM NECESSARY TO	OF CONDITIONS WHICH WILL BE ENCOUNTERED DURING THE ARE DIRECTED, PRIOR TO BIDDING, TO CONDUCT WHATEVER ARRIVE AT THEIR OWN CONCLUSION REGARDING THE ACTUA ED, AND UPON WHICH BIDS WILL BE BASED.	INVESTIGATIONS	13. COM	NTRACTOR SHALL HAUL	AS NECESSARY FOR CONSTRUC AWAY EXCESSIVE STOCKPILE C FT ON THE CONSTRUCTION SITI	F SOIL FOR DISPOSAL EVERY DA	Y. NO STOCKPILE
OF THE CITY OF HOLLYWOO	ATERIALS SHALL CONFORM TO APPLICABLE STANDARDS AND DD DEPARTMENT OF PUBLIC UTILITIES, ENGINEERING AND COL AND ALL OTHER LOCAL, STATE AND NATIONAL CODES, WHER	NSTRUCTION				ONCE DAY OR AS REQUIRED BY	
3. LOCATIONS, ELEVATIONS, S	IZES, MATERIALS, ALIGNMENTS, AND DIMENSIONS OF EXISTINUES ARE SHOWN ACCORDING TO THE BEST INFORMATION A	IG FACILITIES,	REC	UIRED BY NPDES REGU	LATIONS.	PTER 100) WHICH PROHIBITS EX	
THERE MAY HAVE BEEN OT	N OF THESE PLANS; AND DO NOT PURPORT TO BE ABSOLUTELY HER IMPROVEMENTS, UTILITIES, ETC., WITHIN THE PROJECT A PREPARATION OF THESE PLANS AND/OR THE ORIGINAL SITE SI	REA WHICH WERE	COM			MONDAY THROUGH SATURDAY	
WORK PRIOR TO CONSTRUC	Y THE LOCATIONS, ELEVATIONS, AND OTHER FEATURES AFFEC CTION, AND NOTIFY THE ENGINEER IMMEDIATELY WHEN CON ONDITIONS ARE DISCOVERED. THE ENGINEER ASSUMES NO RE	FLICT BETWEEN		TABLE EXCAVATED MAT LUDE COST IN OTHER IT		REAS. NO SEPARATE PAY ITEM	FOR THIS WORK,
AVOID CONFLICT WITH EXIS EXISTING UTILITIES SHALL B	NOT SHOWN ON THE PLANS. THE CONTRACTOR SHALL WORK STING UTILITIES (NO ADDITIONAL COST SHALL BE PAID FOR TH BE MAINTAINED IN SERVICE DURING CONSTRUCTION UNLESS (IS WORK).		ROAD CROSSINGS ARE FED ON THE DRAWINGS	-	EMENTS OF THE ECSD UNLESS C)THERWISE
	OORDINATE WITH ALL UTILITIES TO ARRANGE FOR THE RELOC		SIDI TYP	EWALKS, ETC. TO SATIS E OF MATERIAL THAT V	FY THE INSTALLATION OF THE P	NG EARTH, DRIVEWAYS, PARKIN PROPOSED IMPROVEMENTS WIT RUCTION OR AS DIRECTED BY EC	TH THE SAME
5. IT SHALL BE THE CONTRACT UTILITIES ON THIS PROJECT,	JTILITY FEATURES, ETC. AS NECESSARY TO COMPLETE THE WO OR'S RESPONSIBILITY TO LOCATE AND PROTECT ANY AND ALL , AND TO ENSURE THAT EXISTING UTILITIES ARE MAINTAINED	EXISTING	20. THE EQU	JIPMENT. IN CASE WOR	RK ON PRIVATE PROPERTY IS NE	PROPERTY WITH PERSONNEL, M EDED, A CITY OF HOLLYWOOD "	'RIGHT OF ENTRY"
6. CONTRACTOR SHALL ADJUS HAND-HOLES, PULL-BOXES,	NLESS APPROVED OTHERWISE BY THE UTILITY OWNER. ST ALL EXISTING UTILITY CASTINGS INCLUDING VALVE BOXES, I STORMWATER INLETS, AND SIMILAR STRUCTURES IN CONSTR	· · · · ·	CON 21. THE	NTRACTOR IS RESPONSI	BLE TO MAINTAIN ACCESS AT A BE RESPONSIBLE FOR DAMAGE,	DIRECTOR OF PUBLIC UTILITIES. 1 LL TIMES TO PRIVATE HOMES/E REMOVAL OR MODIFICATION, (BUSINESSES. CAUSED TO ANY
BE OVERLAID WITH ASPHAL 7. THE CONTRACTOR IS REQUI PERMITS PRIOR TO THE STA	IRED TO OBTAIN ALL APPLICABLE CONSTRUCTION AND ENVIR	ONMENTAL	REP PER	LACE ANY DAMAGED, F	REMOVED OR MODIFIED IRRIGA	OR PURPOSELY. THE CONTRACT TION PIPES, SPRINKLER HEADS (FING CONDITIONS AT NO ADDIT	OR OTHER
	IOTIFY ECSD AT LEAST 48 HOURS PRIOR TO BEGINNING CONST			-		AGED DURING THE CONSTRUCT CH OR EXCEED EXISTING CONDI	
IMPROVEMENTS, SHOP DRA DOCUMENT'S REQUIREMEN	MENT OF CONSTRUCTION AND INSTALLATION OF THE PROPO AWINGS SHALL BE SUBMITTED TO ECSD IN ACCORDANCE WIT NTS, FOR APPROVAL. IN ADDITION, IT IS THE CONTRACTOR'S R CY SHOP DRAWING APPROVAL, IF REQUIRED.	H THE CONTRACT			IDE MAINTENANCE OF TRAFFIC	IN ACCORDANCE WITH FDOT S STANDARDS.	TANDARDS AND
CONSTRUCTION OF ANY IN CONTRACTOR SHALL BE CO	IOTIFY ECSD IMMEDIATELY FOR ANY CONFLICT ARISING DURIN IPROVEMENTS SHOWN ON THESE DRAWINGS. THIS WORK BY NSIDERED INCIDENTAL TO THE CONTRACT AND NO ADDITION	THE	ENG 25. THE	SINEER.	ONSIBLE FOR OBTAINING THE N	PRIOR APPROVAL FROM THE E	RELOCATION
COMPENSATION SHALL BE A 11. ELEVATIONS SHOWN ARE IN 1988 (NAVD 88).	ALLOWED. N FEET AND ARE REFERENCED TO THE NORTH AMERICAN VER	FICAL DATUM OF	RIG	HT OF WAY.		ARTMENT FOR TREES LOCATED I	
						ESE PLANS AND APPLICABLE RECONSIGNED AND APPLICABLE RECONSISTENTION OF	
ISSUED: 03/01/1994 DRAWN: EAM	DEPARTMENT OF PUBLIC UTILITIES STANDARD DETAIL	REVISED: 06/08/2014 DRAWING NO.	ST DIAMOND	ISSUED: 03/01/1994 DRAWN: EAM		ITILITIES STANDARD DETAIL	REVISED: II/06/2017 DRAWING NO.
APPROVED: XXX	GENERAL NOTES	G-00	GOLD COAST -	APPROVED: XXX		INUED)	G-00.1
 41. WHEN PVC PIPE IS USED, A ABOVE THE PIPE. THE MAR BURIED PIPE BELOW. THE C INC. OR APPROVED EQUAL 42. ALL CONNECTIONS TO EXIS CONNECTIONS SHALL BE N BORNE BY THE CONTRACT 43. A COMPLETE AS-BUILT SUI CONSTRUCTION. AS-BUILT REGISTERED SURVEYOR PR SIGNED AND SEALED AS-BUILT NCLUDE: a. PLAN VIEW SHOWIN FITTING, BEND AND TO A SURVEY BASED b. THE PLAN VIEW SHOWN 	STING MAINS SHALL BE THE RESPONSIBILITY OF THE CONT METERED, AND THE COST OF WATER AND TEMPORARY ME	T THERE IS ENTERPRISES RACTOR. WATER TER SHALL BE STEM DURING ED BY A FLORIDA THE COST OF URVEY SHALL ET, VALVE, D IN REFERENCE	P EXCEED LAYER 100% SELECT BACK PLACED IN L EXCEED 6" EACH LA COMPACTI	OR NERAL BACKFILL SHALL PLACED IN LAYERS NOT 12" IN THICKNESS. E SHALL BE COMPACTED OF MAXIMUM DRY DENS STILL SHALL BE AYERS NOT TO IN THICKNESS. BA AYER SHALL BE ED TO 98% OF M DRY DENSITY HAUN		BACKFILL CO TO CENTERLI (SEE NOTE - MAXIMUM MINIMUM	DT, BROWARD IC WORKS, OR Y OWNER'S STORATION DETAILS DNSOLIDATED INE OF PIPE 1 BELOW). STORED
ELEVATIONS AT EAC DEFLECTION. c. THE PLAN VIEW SH UTILITIES IMMEDIA d. PROFILE VIEW WITH MAIN) OR PIPE INV DIRECTLY ABOVE TH THE MAIN. THE PRO INLET, VALVE, FITTI e. THE PROFILE VIEW AND THE VERTICAL NEW MAIN.	URED ALONG MAIN. THE PLAN VIEW SHALL ALSO INCLUDE CH MANHOLE, INLET, VALVE, FITTING, BEND AND VERTICAL MALL ALSO SHOW THE HORIZONTAL SEPARATION FROM UN ATELY ADJACENT OR PARALLEL TO THE NEW MAIN. H SPOT ELEVATIONS OF THE TOP OF THE MAIN (WATER MA FERT (GRAVITY MAIN) AND OF THE FINISHED GRADE OR MA HE MAIN AT INTERVALS NOT TO EXCEED 100 FEET AS MEAS OFILE VIEW SHALL ALSO INCLUDE SPOT ELEVATIONS AT EAC ING, BEND AND VERTICAL PIPE DEFLECTION. SHALL SHOW ALL UNDERGROUND UTILITIES CROSSING TH SEPARATION PROVIDED BETWEEN THAT UNDERGROUND JST BE CREATED FOLLOWING THE CITY OF HOLLYWOOD "SI WING STANDARDS" DEPARTMENT OF PUBLIC UTILITIES STANDARD DETAIL GENERAL NOTES (CONTINUED)	. PIPE DERGROUND NIN AND FORCE NHOLE RIM SURED ALONG CH MANHOLE, E NEW MAIN UTILITY AND THE		 WHENEVER BEDDING BE CLEAN SANDY S BEDDING SHALL BE LIMEROCK). CRUSH PARTICLES OF PRO MATERIAL, WOOD, T MATERIALS. ALL BEDDING MATE ANY PIPE IS LAID. SECTION 02222, "E JENSITY TESTING S 	SOIL IF AVAILABLE WITHIN THE WELL GRADED, WASHED CRUS ED STONE SHALL CONSIST OF PER SIZE AND GRADATION, ANI RASH, SAND, LOAM, CLAY, EXC RIAL SHALL BE COMPACTED TO FOR ADDITIONAL MATERIAL SPE EXCAVATION AND BACKFILL FOR HALL BE IN ACCORDANCE WITH PLY WITH FDOT DESIGN STANDA DEPARTMENT OF PUBLIC U PIPE LAYING CON	ONDITION, BEDDING MATERIAL S LIMITS OF CONSTRUCTION. IMP SHED STONE (OR DRAINFIELD HARD, DURABLE, SUB-ANGULAI D SHALL BE FREE FROM ORGAI SESS FINES, AND OTHER DELET O 95% OF MAXIMUM DENSITY B ECIFICATIONS REFER TO SPECIFI UTILITIES".	orted R Nic Erious Efore Ication
ALL RUVED: AAA	· · · · ·		2 ORPORATION			TAC REVIE	
REET			LICEN	SE No. 66646	NAL ENGINEER, STATE OF FLORIDA,	SCALE: 1" = 10'	SHEET:
D20	GENERA	L NOTES	KRAW PRINT AND S	/CZYK, PE ON 6/20/2023. ED COPIES OF THIS DOCUM	SIGNED AND SEALED BY GEORGE MENT ARE NOT CONSIDERED SIGNEI RE MUST BE VERIFIED ON ANY	PROJECT No.:	C-7

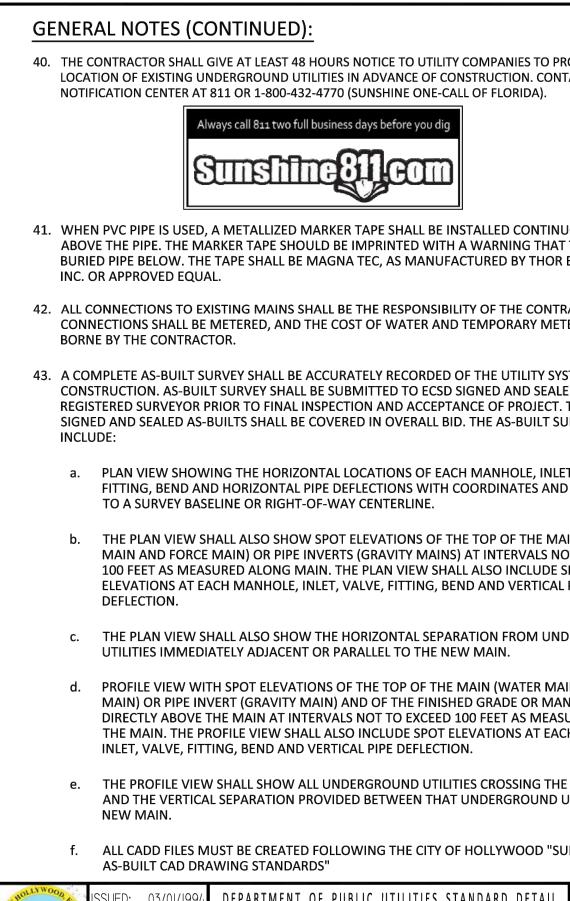

SON & ASSOCIATES		
STREET, FORT LAUDERDALE, FL 33316 MIAMI-DADE (305) 714.2510 BROWARD (954) 761.1073 PALM BEACH (561) 932.1668	┝	
MIAMI-DADE (305) 714.2510		
BROWARD (954) 761.1073		
PALM BEACH (561) 932.1668		

1914-1920 PIERCE STRE

HOLLYWOOD, FL. 33020

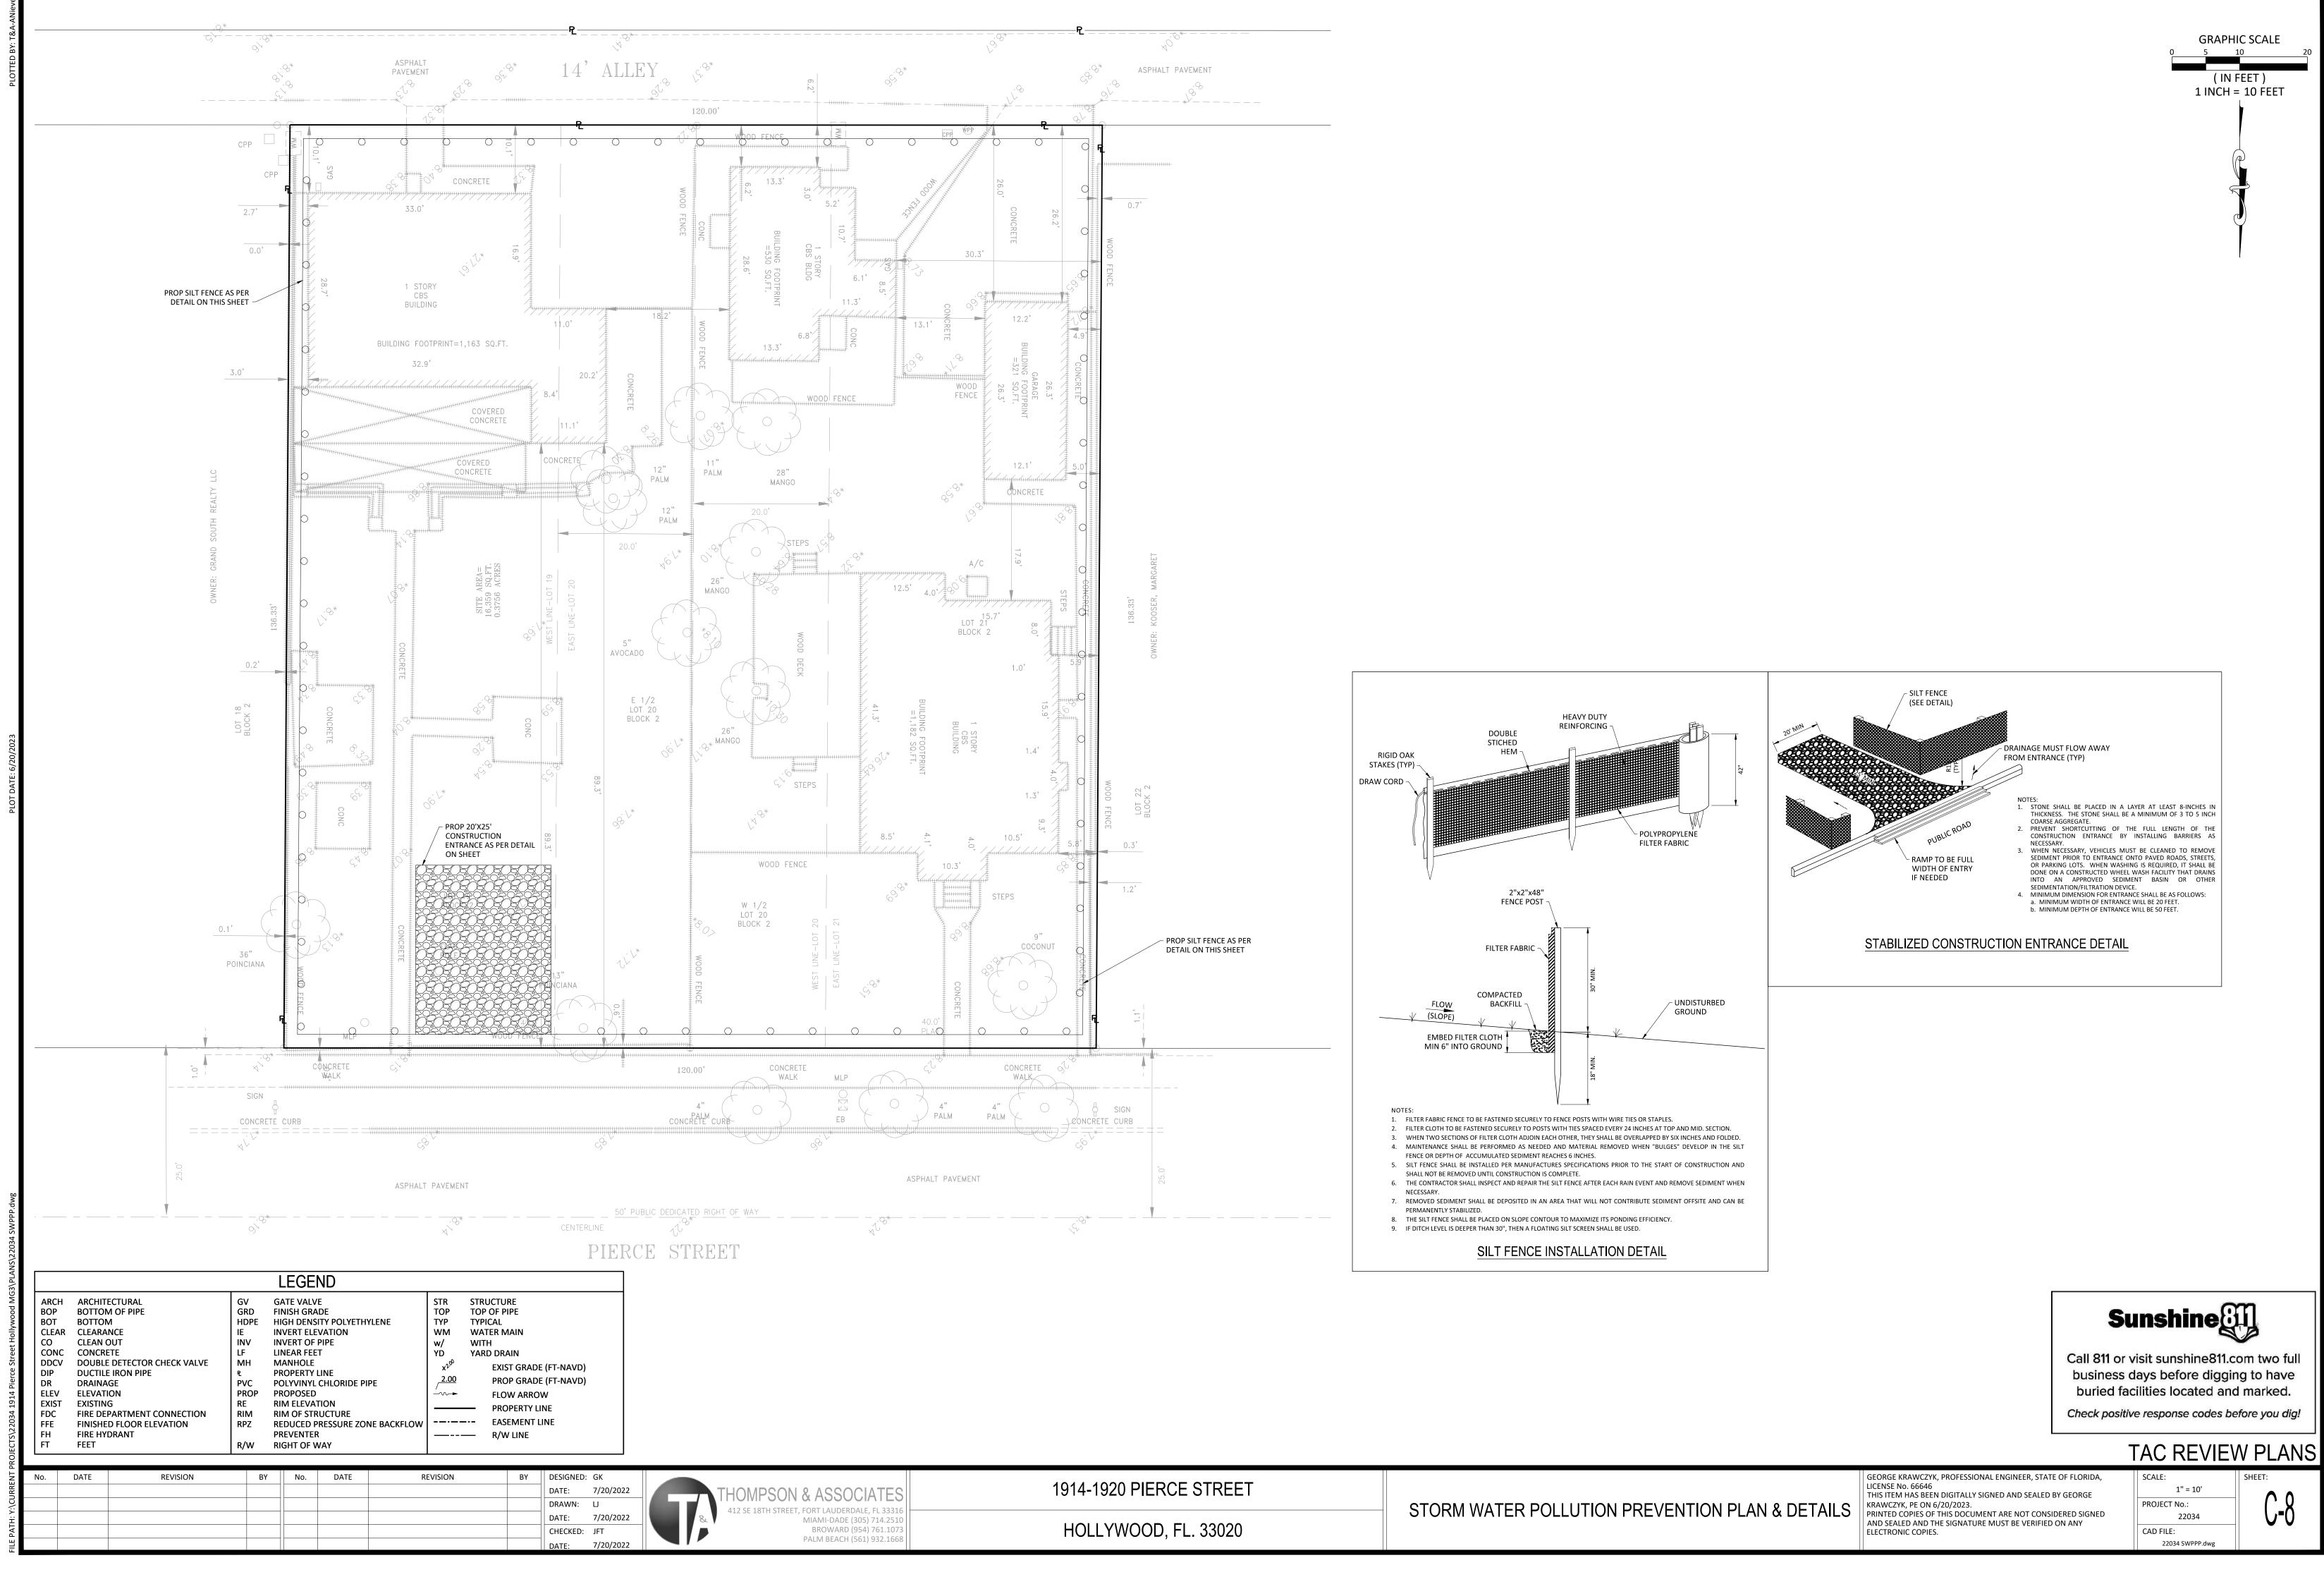

PRELIMINARY DRAINAGE REPORT

PREPARED FOR

DOWNTOWN HOLLYWOOD

1914 AND 1920 PIERCE STREET, HOLLYWOOD, FLORIDA 33020

T&A PROJECT NO. 22034 JUNE 20TH, 2023

> George Krawczyk P.E. Florida Registration No. 66646

> > June 20, 2023

PREPARED BY





1914-1920 PIERCE STREET, HOLLYWOOD FLORIDA, 33020

INTRODUCTION

The project location site is located at 1914 and 1920 Pierce Street, Hollywood, Fl 33020. The project includes development of a new multi-family structure, potable water connection, irrigation system connection, sanitary sewer connection, and paving, grading, and drainage. The on-site drainage system shall be designed and constructed to meet jurisdictional agencies' requirements. Parking areas are on the first level of the structure and living quarters start on the first floor. Swale areas surround the building and roof leaders will be connected to the drainage system. No offsite improvements related to the civil engineering scope are anticipated. The Drainage Basin that was analyzed and includes the limits of work associated with this project is 0.376 Acres or 16,359SF. The BCPA Folio Numbers that are included in the project area are 514215013490 and 514215013500. There no existing Surface Water Management Licenses that encompass sections of our basin.

DRAINAGE DESIGN

Rainwater is designed to be retained onsite as the grades around the building go into a swale or trench drain. Under the parking area there is 200 LF (linear feet) of 12" pipe of which 56 LF is needed for 4-foot-wide exfiltration trench with connections into the swale area. The pervious area is 25.35% of the site will be landscaped and conflicts have been coordinated.

The design/control elevation is at 1.5 ft-NAVD per the Broward County Future Groundwater Elevation Map. The elevation of 1.5 ft-NAVD was used for this analysis.

Water Quality for the basin is provided in the proposed retention area and swales at elevation 8.91 ft-NAVD 88.

The calculations in this report demonstrate that the post-construction water quality conditions are met for this site.

Project Project Date: A. A		AGE Total	1914 Pierce St H 22034 June 13th, 2023					Designed:	IJ
Date:	ACER/ 1.	Total						1	
	1.	Total	June 13th, 2023					Reviewed:	GK
A. 4	1.	Total						Checked:	GK
A. 4	1.	Total			SITE I	DATA			
A. <i>F</i>	1.	Total							
								0.376	AC
		Buildir	ng (roof)		FT-NAVD			0.070	
		a.	Building	9.00	то	9.00		0.262	AC
		b.	N/A	0.00	то	0.00		0.000	AC
		с.	N/A	0.00	TO	0.00		0.000	AC
			Impervious						
		d.	Sidewalk	0.00	то	0.00		0.000	AC
		e.	Concrete	8.35	TO	8.90		0.019	AC
		f.	Stairs	0.00	TO	0.00		0.000	AC
		g.	Deck	0.00	TO	0.00		0.000	AC
		h.	N/A	0.00	TO	0.00		0.000	AC
		i.	N/A	0.00	TO	0.00		0.000	AC
		j.	N/A	0.00 0.00	TO	0.00		0.000 0.000	AC
		k.	N/A		TO	0.00			AC
	С	Mot P	etention/Detention	Total Imperv	nous			0.280	AC
	3.			0.00	то	0.00		0.000	AC
		a.	N/A	Total Water				0.000	AC
	4.	Dry Pc	tention/Detention		wanageme	ent		0.000	
	4.	b.	Swale "H"	8.00	то	8.50		0.031	AC
		Б. С.	Swale "V"	8.00	то	8.00		0.012	AC
		d.	N/A	0.00	то	0.00		0.000	AC
		e.	N/A	0.00	то	0.00		0.000	AC
		f.	N/A	0.00	то	0.00		0.000	AC
			N/A	Total Dry Re				0.043	AC
5	5.	Pervio	us					0.045	
5		a.	Landscape	8.50	то	8.90		0.052	AC
		b.	N/A	0.00	TO	0.00		0.000	AC
		с.	N/A	0.00	TO	0.00		0.000	AC
		d.	N/A	0.00	TO	0.00		0.000	AC
		e.	N/A	0.00	TO	0.00		0.000	AC
		f.	N/A	0.00	TO	0.00		0.000	AC
		g.	N/A	0.00	то	0.00		0.000	AC
		h.	N/A	0.00	TO	0.00		0.000	AC
		i.	N/A	0.00	то	0.00		0.000	AC
				Total Perviou	us			0.052	AC
B. N	MINI	ИОМ Е	LEVATIONS				Designed	Code/Criteria	
	1.	Roads	and Parking				U		FT-NAVD
	2.		ed Floor						
C. A			DISCHARGE						
C. /					1	ŧN/A			
	1. 2.		D Canal able discharge for th	his project at	#N/A			#N/A	CFS
. .			-	ns project at	#IN/A			#11/A	ULD
D. V			L ELEVATION						
	1.		eason water table (Average October)				1.50	FT-NAVD
	2.		ol/Design elevation					1.50	FT-NAVD
	3.		ing body water leve	91				N/A	FT-NAVD
E. R	RAIN	ALL A	NOUNT						
	1.	3-Year	1-Day Storm (Parki	ing)				5.90	in
	2.		1-Day Storm (Parki					7.20	in
	3.		ar 1-Day Storm (Maj					8.20	in
	4.		ar 1-Day Storm (Adj		storm - De	sign Storm)		10.20	in
	5.		ear 1-Day Storm (Ac				evation)	12.40	in

			F	Post Floo	d Routing	g Analys	is					
Project Name:	1914 Pierce	St Hollywoo	od						Designed:		LJ	
Project No:	22034								Reviewed:		Gk	,
Date:	June 13th, 2	023							Checked:		Gk	
				BASIN A	REA BREA	KDOWN						
LAND USE	BASI	N 1	BASI	N 2	BASI	N 3	BASI	N 4	BASI	N 5	тот	AL
LAND USE	SF	AC	SF	AC	SF	AC	SF	AC	SF	AC	SF	AC
BUILDING/POOL												
a. Building	11,403.01	0.262		0.000		0.000		0.000		0.000	11,403.01	0.262
b. N/A	0.00	0.000		0.000		0.000		0.000		0.000	0.00	0.000
c. N/A	0.00	0.000		0.000		0.000		0.000		0.000	0.00	0.000
OTHER IMPERVIOUS												
d. Sidewalk	0.00	0.000		0.000		0.000		0.000		0.000	0.00	0.000
e. Concrete	810.51	0.019		0.000		0.000		0.000		0.000	810.51	0.019
f. Stairs	0.00	0.000		0.000		0.000		0.000		0.000	0.00	0.000
g. Deck	0.00	0.000		0.000		0.000		0.000		0.000	0.00	0.000
h. N/A	0.00	0.000		0.000		0.000		0.000		0.000	0.00	0.000
i. N/A	0.00	0.000		0.000		0.000		0.000		0.000	0.00	0.000
j. N/A	0.00	0.000		0.000		0.000		0.000		0.000	0.00	0.000
k. N/A	0.00	0.000		0.000		0.000		0.000		0.000	0.00	0.000
WATER MANAGEMENT												
a. N/A	0.00	0.000		0.000		0.000		0.000		0.000	0.00	0.000
RETENTION/DETENTION												
b. Swale "H"	1,355.00	0.031		0.000		0.000		0.000		0.000	1,355.00	0.031
c. Swale "V"	507.30	0.012		0.000		0.000		0.000		0.000	507.30	0.012
d. N/A	0.00	0.000		0.000		0.000		0.000		0.000	0.00	0.000
e. N/A	0.00	0.000		0.000		0.000		0.000		0.000	0.00	0.000
f. N/A	0.00	0.000		0.000		0.000		0.000		0.000	0.00	0.000
PERVIOUS												
a. Landscape	2,283.45	0.052		0.000		0.000		0.000		0.000	2,283.45	0.052
b. N/A	0.00	0.000		0.000		0.000		0.000		0.000	0.00	0.000
c. N/A	0.00	0.000		0.000		0.000		0.000		0.000	0.00	0.000
d. N/A	0.00	0.000		0.000		0.000		0.000		0.000	0.00	0.000
e. N/A	0.00	0.000		0.000		0.000		0.000		0.000	0.00	0.000
f. N/A	0.00	0.000		0.000		0.000		0.000		0.000	0.00	0.000
g. N/A	0.00	0.000		0.000		0.000		0.000		0.000	0.00	0.000
h. N/A	0.00	0.000		0.000		0.000		0.000		0.000	0.00	0.000
i. N/A	0.00	0.000		0.000		0.000		0.000		0.000	0.00	0.000
SUB-TOTAL	16,359.27	0.376	0.00	0.000	0.00	0.000	0.00	0.000	0.00	0.000	16,359.27	0.376
•	Building Area =			#DIV/0!		#DIV/0!		#DIV/0!		#DIV/0!		69.70%
•	pervious Area =			#DIV/0!		#DIV/0!		#DIV/0!		#DIV/0!		4.95%
	age Lake Area =			#DIV/0!		#DIV/0!		#DIV/0!		#DIV/0!		0.00%
Percentage	Pervious Area =			#DIV/0!		#DIV/0!		#DIV/0!		#DIV/0!		25.34%
	TOTAL =	100.00%		#DIV/0!		#DIV/0!		#DIV/0!		#DIV/0!		100.00%

Post Flood Routing Analysis							
Project Name:	1914 Pierce St Hollywood	Designed:	IJ				
Project No:	22034	Reviewed:	GK				
Date:	Date: June 13th, 2023 Checked: GK						

WATER QUALITY DESIGN CRITERIA

A. VOLUMETRIC REQUIREMENTS

- (a) Retention, detention, or both retention and detention in the overall system, including swales, lakes, canals, greenways, etc., shall be provided for one of the three following criteria or equivalent combinations thereof:
 - 1. Wet detention volume shall be provided for the first "X" of runoff from the developed project, or the total runoff of 2.5 times "X" inches times the percentage of imperviousness, whichever is greater.
 - 2. Dry detention volume shall be provided equal to 75 percent of the above amounts computed for wet detention.
 - 3. Retention volume shall be provided equal to 50 percent of the above amounts computed for wet detention. Retention volume included in flood protection calculations requires a guarantee of long term operation and maintenance of system bleed-down ability. include evidence of excellent soil percolation rates, such as coastal ridge sands, or an operations Examples of such guarantee entity which specifically reserves funds for operation, maintenance and replacement.
- (b) Systems with inlets in grassed areas will be credited with up to 0.2 inches of the required wet detention amount for the contributing areas. Full credit will be based on a ratio of 10:1 impervious area (paved or building area) to pervious area (i.e.

B. LAND USE AND COVERAGE CRITERIA

- (a) Commercial or industrial zoned projects shall provide at least one half inch of dry detention or retention pretreatment as part of the required retention / detention.
- (b) Projects having greater than 40% impervious area and which discharge directly to the certain receiving waters shall provide at least one half inch of dry detention or retention pretreatment as part of the required retention / detention.
- (c) Water surface and roofed areas can be deducted from site areas water quality pervious/impervious calculations. The water surface meeting dimensional criteria may also be subtracted from the total when making final water quality treatment volume calculations.
- (d) In cases of widening existing urban public highway projects, the District shall reduce the water quality requirements, if the applicant provides documentation which demonstrates that all reasonable design alternativeshave been considered, and which provides evidence that the alternatives are all cost-prohibitive.

C. EXFILTRATION SYSTEMS

- (a) Systems shall be designed for the retention volumes as specified above for retention systems, exfiltrated over one hour for retention purposes, prior to overflow, and based on test data for the site. (Note: such systems will not be acceptable on projects to be operated by entities other than single owners or entities with full time maintenance staff.)
- (b) A safety factor of two or more shall be applied to the design to allow for geological uncertainties.
- (c) A dry system is one with the pipe invert at or above the average wet season water table.

WATER QUALITY VALUE "X" AS REQUIRED FOR VOLUMETRIC REQUIREMENT =	1.00	in
PRETREATMENT REQUIREMENT (COMMERCIAL/INDUSTRIAL PROJECT) =	0.50	in

Post Flood Routing Analysis							
Project Name:	1914 Pierce St Hollywood	Designed:	LJ				
Project No: 22034 Reviewed: GK							
Date:	Date: June 13th, 2023 Checked: GK						
WATER QUALITY COMPUTATIONS							

A. QUALITY

a.

- 1. Compute the <u>"X"</u> inch of runoff from the developed project
 - = "X" in * total area * (1ft/12in)
 - = 0.03 ac-ft for the first inch of runoff
- 2. Compute (<u>"X"</u>*2.5) inches times the percentage of imperviousness
 - Site area for water quality pervious/impervious calculations only:
 - = Total project (water surface + roof)
 - = 0.11 ac of site area for water quality pervious/impervious
 - b. Impervious area for water quality pervious/impervious calculation only:
 - = (site area for water quality pervious/impervious) pervious
 - = 0.02 ac if impervious area for water quality pervious/impervious
 - c. Percentage of imperviousness for water quality:
 - = (Impervious area for water quality/site area for water quality) 100%
 - = 16.35 % impervious
 - d. For (<u>"X"</u>*2.5) inches times the percentage impervious:
 - = 2.5 X percent impervious
 - = 0.41 inches to be treated
 - e. Compute volume required for water quality detention:
 - = Inches to be treated X (total site Lake)
 - = 0.01 ac-ft for the 2.5 inches times the percentage imperviousness
- 3. Since the is greater than Then
 0.03
 ac-ft for the first inch of runoff

 ac-ft for the 2.5 inches times the percentage imperviousness ac-ft controls
- 4. Pretreatment Volume
 - = 0.5 in X (total area lakes)
 - = 0.00 ac-ft NO pretreatment is required for this project
- 5. Compute resulting required lake volume:
 - = Total required detention pretreatment
 - = 0.03 ac-ft required lake volume

The water quality for the basin is met at elevation 8.91 FT-NAVD

		Post Flood Routing	g An	alysis				
Project Name:	1914 Pierce St Hollyw	ood					Designed:	LJ
Project No:	22034	Review						GK
Date:	June 13th, 2023						Checked:	GK
		EXFILTRATION T	RENC	H				
	TRENCH S	ECTION DESIGN					HYDRAULIC CO	ONDUCTIVITY
8.00		Lowest Catch Basin Grate Elevation	=	8.00	FT-NAVD	K1 =	1.16E-04	CFS/ft ² -ft Head
	\uparrow	Asphalt Thickness	=	2.00	in	К2 =		CFS/ft ² -ft Head
		Base Thickness	=	12.00	in	КЗ =		CFS/ft ² -ft Head
.50		Limerock Thickness	=	8.00	in	K4 =		CFS/ft ² -ft Head
\wedge \wedge		Top of Trench Elevation	=	3.50	FT-NAVD	K5 =		CFS/ft ² -ft Head
.00		Control Elevation	=	1.50	FT-NAVD	К6 =		CFS/ft ² -ft Head
	H	Pipe Diameter	=	12.00	in	K7 =		CFS/ft ² -ft Head
.50		Top of Pipe Elevation	=	2.50	ft-NAVD	К8 =		CFS/ft ² -ft Head
D _u		Trench of Depth Above Pipe	=	1.00	FT	К9 =		CFS/ft ² -ft Head
		Depth to Water Table H ₂	=	6.50	FT	K10 =		CFS/ft ² -ft Head
	12.00	None Saturated Depth D _u	=	2.00	FT	K11 =		CFS/ft ² -ft Head
		Saturated Trench Depth D _s	=		FT	K12 =		CFS/ft ² -ft Head
50 🗸		Trench Width W	=	4.00	FT	K13 =		CFS/ft ² -ft Head
\wedge		Bottom of Trench Elevation	=	1.50	FT-NAVD	K14 =		CFS/ft ² -ft Head
Ds		Trench Depth	=	2.00	FT	K15 =		CFS/ft ² -ft Head
.50			_			K16 =		CFS/ft ² -ft Head
.						K17 =		CFS/ft ² -ft Head
	w >					K18 =		CFS/ft ² -ft Head
	1					Avrg K =	1.16E-04	CFS/ft ² -ft Head

Pretreatment Volume Required =

0.03 AC-FT

For Normal Conditions use:

 $L = V / [(K * ((H_2*W)+(2*H_2*D_u)-(D_u^2)+(2*H_2*D_s)))+(1.39x10^{-4}*W*D_u)] = 56$ FT of trench required

For the conditions listed below use:

The saturated depth of trench is greater than the non-saturated depth of trench, or

The trench width is greater than two times the total trench depth.

 $L = V / [K^{*}((2^{*}H_{2}^{*}D_{u})-(D_{u}^{2})+(2^{*}H_{2}^{*}D_{s}))+(1.39x10^{-4}*W^{*}D_{u})] = 102$ FT of trench required

			Post Flo	od Routing	Analysis			
roject Name:	1914 Pierce St I	Hollywood					Designed:	IJ
roject No:	22034						Reviewed:	GK
ate:	June 13th, 2023	}					Checked:	GK
			EXFILTRA	TION TRENCH	STORAGE			
INCREMENT U	JSED (FT)		PIPE STORAG			TRENCH STOP	RAGE	
		т	rench Length (FT)	= 56	Т	rench Length (FT) =	56	
0.25			ipe Diameter (FT)			Trench Depth (FT) =	2.00	TOTAL
0.25	,	F						
			Pipe Radius (FT)	= 0.50		Trench Width (FT) =	4.00	STORAGE
STAGE (FT-NGVD)	INCREMENTS (FT)	Included Angle (radians)	Pipe Area (sf)	Pipe Volume (ac-ft)	Trench Area (sf)	Trench Volume (cf)	Trench Volume (ac-ft)	(AC-FT)
1.50	0.00	0.00	0.00	0.0000	0.00	0.00	0.0000	0.0000
1.75	0.25	2.09	0.15	0.0027	0.50	27.88	0.0006	0.0033
2.00	0.50	3.14	0.39	0.0040	1.00	55.83	0.0013	0.0053
2.25	0.75	4.19	0.63	0.0054	1.49	83.79	0.0019	0.0073
2.50	1.00	6.28	0.79	0.0081	1.99	111.67	0.0026	0.0106
2.75	1.00	6.28	0.79	0.0081	1.99	111.67	0.0026	0.0106
3.00	1.00	6.28	0.79	0.0081	1.99	111.67	0.0026	0.0106
3.25	1.00	6.28	0.79	0.0081	1.99	111.67	0.0026	0.0106
3.50	1.00	6.28	0.79	0.0081	1.99	111.67	0.0026	0.0106
3.75	1.00	6.28	0.79	0.0081	1.99	111.67	0.0026	0.0106
4.00	1.00	6.28	0.79	0.0081	1.99	111.67	0.0026	0.0106
4.25	1.00	6.28	0.79	0.0081	1.99	111.67	0.0026	0.0106
4.50	1.00	6.28	0.79	0.0081	1.99	111.67	0.0026	0.0106
4.75	1.00	6.28	0.79	0.0081	1.99	111.67	0.0026	0.0106
5.00	1.00	6.28	0.79	0.0081	1.99	111.67	0.0026	0.0106
5.25	1.00	6.28	0.79	0.0081	1.99	111.67	0.0026	0.0106
5.50	1.00	6.28	0.79	0.0081	1.99	111.67	0.0026	0.0106
5.75	1.00	6.28	0.79	0.0081	1.99	111.67	0.0026	0.0106
6.00	1.00	6.28	0.79	0.0081	1.99	111.67	0.0026	0.0106
6.25	1.00	6.28	0.79	0.0081	1.99	111.67	0.0026	0.0106
6.50	1.00	6.28	0.79	0.0081	1.99	111.67	0.0026	0.0106
6.75	1.00	6.28	0.79	0.0081	1.99	111.67	0.0026	0.0106
7.00	1.00	6.28	0.79	0.0081	1.99	111.67	0.0026	0.0106
7.25	1.00	6.28	0.79	0.0081	1.99	111.67	0.0026	0.0106
7.50	1.00	6.28	0.79	0.0081	1.99	111.67	0.0026	0.0106
7.75	1.00	6.28	0.79	0.0081	1.99	111.67	0.0026	0.0106
8.00	1.00	6.28	0.79	0.0081	1.99	111.67	0.0026	0.0106

Post Flood Routing Analysis							
Project Name:	1914 Pierce St Hollywood	Designed:	IJ				
Project No:	22034	Reviewed:	GK				
Date: June 13th, 2023 Checked: GK							

SOIL STORAGE COMPUTATIONS

B. SCS CURVE NUMBER

1. The wet season water/control elevation and the control elevation

FT-NAVD

1.50

6.75

in

2. Average site finished grade

	AREA	START	END	AVERAGE	
LAND USE	Α	ELEV	ELEV	GRADE	A X G
	(AC)	(FT-NAVD)	(FT-NAVD)	G (FT)	(AC-FT)
Building	0.262	9.00	9.00	9.00	2.36
N/A	0.000	0.00	0.00	0.00	0.00
N/A	0.000	0.00	0.00	0.00	0.00
Sidewalk	0.000	0.00	0.00	0.00	0.00
Concrete	0.019	8.35	8.90	8.63	0.16
Stairs	0.000	0.00	0.00	0.00	0.00
Deck	0.000	0.00	0.00	0.00	0.00
N/A	0.000	0.00	0.00	0.00	0.00
N/A	0.000	0.00	0.00	0.00	0.00
N/A	0.000	0.00	0.00	0.00	0.00
N/A	0.000	0.00	0.00	0.00	0.00
N/A	0.000	0.00	0.00	0.00	0.00
Swale "H"	0.031	8.00	8.50	8.25	0.26
Swale "V"	0.012	8.00	8.00	8.00	0.09
N/A	0.000	0.00	0.00	0.00	0.00
N/A	0.000	0.00	0.00	0.00	0.00
N/A	0.000	0.00	0.00	0.00	0.00
Landscape	0.052	8.50	8.90	8.70	0.46
N/A	0.000	0.00	0.00	0.00	0.00
N/A	0.000	0.00	0.00	0.00	0.00
N/A	0.000	0.00	0.00	0.00	0.00
N/A	0.000	0.00	0.00	0.00	0.00
N/A	0.000	0.00	0.00	0.00	0.00
N/A	0.000	0.00	0.00	0.00	0.00
N/A	0.000	0.00	0.00	0.00	0.00
N/A	0.000	0.00	0.00	0.00	0.00
TOTAL	0.376				3.32
Weighted Average Site Grade	8.85	ft-NAVD			

3. Average depth to water table will be

=

= Average site grade - average water table/control elevation

4. Soil type Flatwoods

5. From the soil storage calculation sheet, inches of moisture stored under the pervious areas for this type of soil is:

6. Compute available soil storage

= Storage available X pervious area

- = 0.05 AC-FT available soil storage onsite
- 7. Convert available soil storage to site-wide moisture storage, S

= Available soil storage onsite/site area

- = <u>1.71</u> inches of site-wide storage, S
- 8. SCS Curve Number, CN

= 1000/(S+10)

= <u>85</u> SCS Curve Number

Post Flood Routing Analysis						
Project Name:	1914 Pierce St Hollywood	Designed:	IJ			
Project No: 22034 Reviewed: GK						
Date: June 13th, 2023 Checked: GK						
	SOIL STORAGE TABLE					

	COASTAL (1)		FLATWOODS (2)		DEPRESSIONAL (3)	
DEPTH TO WATER TABLE (FT)	CUMULATIVE WATER STORAGE (in)	COMPACTED WATER STORAGE (in)	CUMULATIVE WATER STORAGE (in)	COMPACTED WATER STORAGE (in)	CUMULATIVE WATER STORAGE (in)	COMPACTED WATER STORAGE (in)
1	0.60	0.45	0.60	0.45	0.60	0.45
2	2.50	1.88	2.50	1.88	2.10	1.58
3	6.60	4.95	5.40	4.05	4.40	3.30
4	10.90	8.18	9.00	6.75	6.80	5.10

NOTE:

- (1) Sandy Soil 0-40" thick with water tables dropping below 40" St. Lucie series is representative.
- (2) Water tables 15"-40" Immokalee series is representative
- (3) Water tables above ground 15" Riviera and Pompano series are representative
- (4) 4 feet is the maximum depth of percolation assumed possible in three days for any soil.
- A. From the calculation the average depth to the water table is
- B. The Soil Type is
- C. Assuming 25% compaction
- D. Inches of moisture stored under pervious area

DEPTH TO WATER TABLE (FT)	COMPACTED WATER STORAGE (in)
4.00	6.75
4.00	6.75
4.00	6.75


7.35

Flatwoods

ft

Post Flood Routing Analysis				
Project Name:	1914 Pierce St Hollywood	Designed:	IJ	
Project No:	22034	Reviewed:	GK	
Date:	June 13th, 2023	Checked:	GK	

GROUNDWATER TABLE

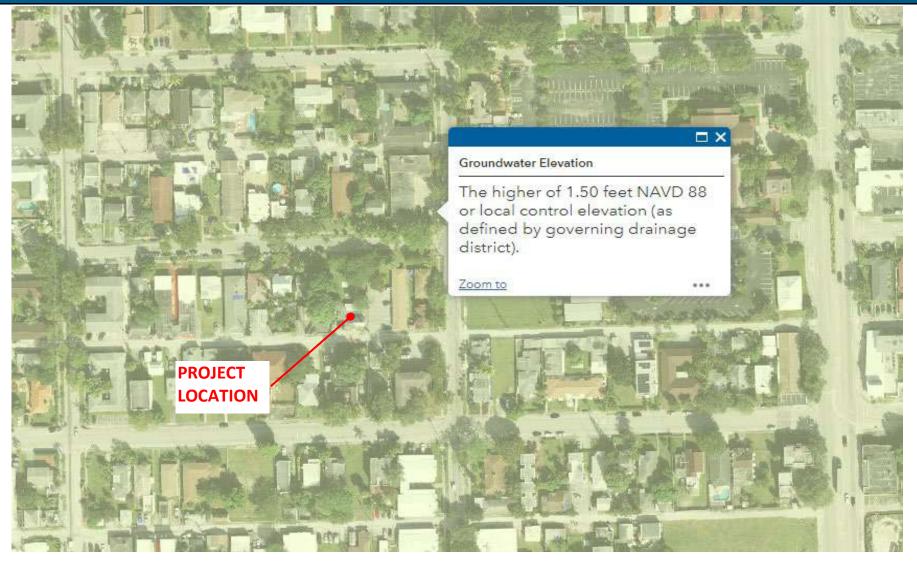



April 21, 2023

Pamela Butler, Senior Development Coordinator MG3 Group 2980 Northeast 207 Street, Suite 603 Aventura, Florida 33180 Via Email Only

Dear Ms. Butler:

Re: Platting requirements for a parcel legally described as Lots 19-21, Block 20, "Hollywood," according to the Plat thereof, as recorded in Plat Book 1, Page 21, of the Public Records of Broward County, Florida. This parcel is generally located on the south side of Pierce Street, between North 19 Avenue and North 20 Avenue, in the City of Hollywood.

This letter is in response to your correspondence regarding the Broward County Land Use Plan's platting requirements for a proposed multi-family residential development on the above referenced parcel.

Planning Council staff has determined that replatting <u>would not be required</u> by Policy 2.13.1 of the Broward County Land Use Plan (BCLUP) for the proposed development, subject to compliance with any applicable Broward County Trafficways Plan requirement.

As per the criteria of Policy 2.13.1, replatting is required for the issuance of building permits when constructing a non-residential or unified residential development, unless all of the following conditions are met:

- a. The lot or parcel is smaller than 10 acres and is unrelated to any adjacent development;
- b. The lot or parcel has been specifically delineated in a recorded plat;
- c. All land within the lot or parcel which is necessary to comply with the County Trafficways Plan has been conveyed to the public by deed or easement; and
- d. The proposed development is in compliance with the applicable land development regulations.

The subject parcel is less than 10 acres (approximately 0.38 acres) and meets the specifically delineated requirement. This platting interpretation is subject to the municipality finding that the proposed development is unrelated to any adjacent development, as noted in "a." above.

Pamela Butler April 21, 2023 Page Two

Some jurisdictions may be more restrictive and require platting in more situations than the BCLUP. The City of Hollywood's platting requirements should be investigated.

The contents of this letter are not a judgment as to whether this development proposal complies with State or local vehicular access provisions, the Broward County Trafficways Plan, permitted uses and densities, local zoning, the land development regulations of the municipality or the development review requirements of the BCLUP, including concurrency requirements.

If you have any additional questions concerning the BCLUP's platting requirements, please contact Dawn Teetsel at your convenience.

Respectfully,

Barbara Blake Boy Executive Director

BBB:DBT

cc/email: George Keller, City Manager City of Hollywood

> Shiv Newaldass, Director, Development Services City of Hollywood



CITY OF HOLLYWOOD PARKS, RECREATION AND CULTURAL ARTS DEPARTMENT PARK IMPACT FEE APPLICATION

Pursuant to Chapter 161.07 (G)(1) of the City's Zoning and Land Development Regulations, all persons platting or subdividing land for residential purposes or for hotel/motel purposes or who are required to obtain site plan approval for a residential, hotel or motel development shall be required to pay a park impact fee. This fee is to be used for parks (passive or active open space or recreational facilities) to meet the needs created by the development.

Is this a residential or hotel/motel development? Yes 🗵 No 🗌

If YES was selected please provide the following information. In NO was selected please do not complete application.

(PRINT LEGIBLY OR TYPE)

1. Owners Name:	1920 Pierce, LLC	
2. Project Name:	1920 Pierce	
3. Project Address:	1914-1920 Pierce Street	
4. Contact person:	Pamela Butler	
5. Contact number:	(954) 471-6177	
6. Type of unit(s): S	ingle Family 🗌 Multi-Family 🗵 Hotel/Motel 🗌	
7. Total number of re	esidential and/or hotel/motel units: 20 units under 1,000 sq ft PLUS 12 units	over 1,000 sq ft (32 total)
8. Unit Fee per resid	lential dwelling based on sq. ft.: 20 @ \$1,132 PLUS 12 @ \$1,401	
9. Unit Fee per hote	I/motel room: \$1,355.00	
10. Total Park Impac	ct Fee: <u>\$39,452.</u> Date: <u>June 15, 2023</u>	

The Park Impact Fee shall be paid in full prior to issuance of a building permit unless the project is to be completed in phases. This application provides an approximate Park Impact Fee however the final Park Impact Fee will be calculated and paid at time of building permit request.

This application (if applicable) should be submitted to the Technical Advisory Committee to obtain Parks, Recreation and Cultural Arts Department approval.

Please contact David Vazquez, Department of Parks, Recreation and Cultural Arts at 954.921.3404 or <u>dvazquez@hollywoodfl.org</u> with any inquiries.

City of Hollywood Park Impact Schedule of Fees

Land Use	Fee
Residential: single family (detached)	
Less than 1,500 sf	\$2,063
1,500 sf to 2,499 sf	\$2,317
2,500 sf and greater	\$2,594
Residential: multi-family (apartment/condominium/townhouse)	
Less than 1,000 sf	\$1,132
1,000 sf and greater	\$1,401
Residential: mobile home	
Mobile Home Park	\$2,055
Residential: Senior Housing	
Detached	\$1,778
Attached	\$931
Transient, Assisted, Group	
Hotel / Motel	\$1,355

*Square feet refers to enclosed, gross floor area excluding parking garage, screened enclosures and unfinished attics.

Fee calculation is from Chapter 38.97 of the Code of Ordinances entitled "Finance".