

GENERAL APPLICATION

APPLICATION DATE:			
2600 Hollywood Blvd Room 315 Hollywood, FL 33022	APPLICATION TYPE (CHECK ALI Technical Advisory Committee Planning and Development Board City Commission	Art in Public Places Committee Va	ariance pecial Exception
Tel: (954) 921-3471 Email: Development@ Hollywoodfl.org SUBMISSION REQUIREMENTS: One set of signed & sealed plans (i.e. Architect or Engineer) One electronic combined PDF submission (max. 25mb)	PROPERTY INFORMATION Location Address: 25 43 Polk Lot(s): 14 Blo Folio Number(s): 5142 16 01 Zoning Classification: Mc-1 (RA Existing Property Use: Pesident Is the request the result of a violation to the string property been presented to Number(s) and Resolution(s):	Land Use Classification Sq Ft/Number of lation notice? Yes No If yes	on: Residential Units: 2 s, attach a copy of violation
 Completed Application Checklist Application fee 	DEVELOPMENT PROPOSAL Explanation of Request: 33 year grown floor covered Phased Project: Yes No No Num	Parking	ils building with
	Project	Proposal	
NOTE:	Units/rooms (# of units)	# UNITS: 33	#Rooms
This application must be completed in full and submitted with all documents to be placed on a Board or	Units/rooms (# of units) Proposed Non-Residential Uses Open Space (% and SQ.FT.) Parking (# of spaces) Height (# of stories)	# UNITS: 33	S.F.)
This application must be completed in full and submitted with all documents to be placed	Units/rooms (# of units) Proposed Non-Residential Uses Open Space (% and SQ.FT.) Parking (# of spaces) Height (# of stories) Gross Floor Area (SQ. FT) Name of Current Property Owner Address of Property Owner:	#UNITS: 33 Required %: 40 (Area: PARK. SPACES (# STORIES) 4 Lot(s) Gross Area: 2543 Polk (treet	S.F.) B,205.6 S.F.) : (# 43) (45 FT.) ea (32,339 FT.) LL C ew C:Ty NY, 10956
This application must be completed in full and submitted with all documents to be placed on a Board or Committee's agenda. The applicant is responsible for obtaining the appropriate checklist for each type	Units/rooms (# of units) Proposed Non-Residential Uses Open Space (% and SQ.FT.) Parking (# of spaces) Height (# of stories) Gross Floor Area (SQ. FT) Name of Current Property Owner	#UNITS: 33 Required %: 40 (Area: PARK. SPACES (# STORIES) 4 Lot(s) Gross Area: 2543 Polk (Treet congars RD STE 204 N ail Address: menachema capita A,leed 80+ (Consultant Representation of the consultant Representation of the	S.F.) 8,205.6 S.F.) (# 43) (45 FT.) Pa (32,339 FT.) LL C Pa CITS NY, 10956 Allgroup. Com Pesentative Tenant 2: 454 920 5746

E-mail Address: CUTTO Planning @ Jahoo. com



GENERAL APPLICATION

CERTIFICATION OF COMPLIANCE WITH APPLICABLE REGULATIONS

The applicant/owner(s) signature certifies that he/she has been made aware of the criteria, regulations and guidelines applicable to the request. This information can be obtained in Room 315 of City Hall or on our website at www.hollywoodfl.org. The owner(s) further certifies that when required by applicable law, including but not limited to the City's Zoning and Land Development Regulations, they will post the site with a sign provided by the Office of Planning and Development Services. The owner(s) will photograph the sign the day of posting and submit photographs to the Office of Planning and Development Services as required by applicable law. Failure to post the sign will result in violation of State and Municipal Notification Requirements and Laws.

(I)(We) certify that (I) (we) understand and will comply with the provisions and regulations of the City's Zoning and Land Development Regulations, Design Guidelines, Design Guidelines for Historic Properties and City's Comprehensive Plan as they apply to this project. (I)(We) further certify that the above statements and drawings made on any paper or plans submitted herewith are true to the best of (my)(our) knowledge. (I)(We) understand that the application and attachments become part of the official public records of the City and are not returnable.

Signature of Current Owner:	_ Date: <u>03/20/24</u>
PRINT NAME: Menaches Triefel & ROM.	Date: 03/20/24
Signature of Consultant/Representative: TOSEH BORALLER	Date: 03 (20/14
PRINT NAME: Joseph B. Koller	Date:
Signature of Tenant:	Date:
PRINT NAME:	Date:
I am the current owner of the described real property and that I am aware of the nature to my property, which is hereby made by my legal representative before the Committee) relative to all matters concerning this application. Sworn to and subscribed before me this day of the Notary Public - State of Florida Signature	are and effect the request for the or I am hereby authorizing (Board and/or and/or of Current Owner
	chen Triezel
My Commission Expires:(Check One) Personally known to me; OR Produced Id	entification





2543 POLK STREET APARTMENTS

LEGAL DESCRIPTION

Lot 7, in Block 17, of Hollywood little ranches, being a subdivision of all of Section 16, Township 51 South, Range 42 East, and Block 96 of the original plat of Hollywood, according to the amended plat of Hollywood little ranches, as recorded in Plat Book 1, page 26 of the public records of Broward County, Florida.

PROJECT DESCRIPTION

Proposed four story building which has 33 residential units. The development counts with 42 parking spaces (including 7 tandem and 2 handicap parking spaces.), common area spaces, such as a habitable rooftop and meets all the accessibility requirements.

The main purpose of this development is to positively impact the community.



March 18, 2024

City of Hollywood 2600 Hollywood Boulevard Hollywood, FL 33022

Reference: 2543 Polk Street Apartments 2543 Polk Street Hollywood, Florida File #23-DP-61

To Whom It May Concern,

The following is our analysis of Criteria and findings for Review for the above referenced Residential Building as per the City of Hollywood Zoning and Land Development Regulations.

DESIGN REVIEW

GENRAL CRITERIA: All plans/architectural drawings shall be reviewed based upon the evaluation of compatibility with the City's Design Guidelines, including the following elements:

CRITERION 1: Architectural and Design components. Architecture refers to the architectural elements of exterior building surfaces. Architectural details should be commensurate with the building mass. The use of traditional materials for new architectural details is recommended. Design of the building(s) shall consider aesthetics and functionality, including the relationship of the pedestrian with the built environment.

ANALYSIS: The proposed new construction apartment building exterior design presents a contemporary concept characterized by a "T" shaped symmetrical axis, complemented by strategically positioned vertical elements, this design intent creates dynamic, movement, and an organic aesthetic.

The objective of this design is to achieve a timeless modern aesthetic that seamlessly integrates with the surroundings, remains ahead of the passage of time, and positively impacts the community.

CRITERION 2: Compatibility. The relationship between existing architectural styles and proposed construction, including how each building along the street relates to the whole and the pattern created with adjacent structures and the surrounding neighborhood. Buildings should contain architectural details that are characteristic of the surrounding neighborhood.

ANALYSIS: The proposed building follows the intent of the District per the Downtown Master Plan. The building design also provides a building base, a common design feature in the neighborhood, which encourages pedestrian movement around the building along the streets. The colors palate selected, and use of stucco work are also elements common to the existing and proposed buildings in the surrounding neighborhood.

CRITERION 3: Scale/Massing. Buildings shall be proportionate in scale, with a height which is consistent with the surrounding structures. Building mass shall reflect a simple composition of basic architectural details in relation to its length, width, height lot coverage, and setting of the structure in context with adjacent buildings. Architectural details include, but are not limited to, banding, molding, and fenestration.

ANALYSIS: The proposed building scale is consistent with the permitted and approved height restrictions allowed by the City Code of Ordinances. The overall scale of the building is broken up at the base of the building with the proposed "T" shape facade and the use of expansive windows and sliding doors at the apartment levels. The clean stucco color selection at the apartment levels creates a contrast with the vertical elements as well. The massing of the building is further broken up by pulling back the apartments at the upper levels to soften the verticality further.

CRITERION 4: Landscaping. Landscaped areas should contain a variety of native and other compatible plant types and forms and be carefully integrated with existing buildings and paved areas. Existing mature trees and other significant plants on the site should be preserved.

ANALYSIS: The proposed design incorporates the use of native plants selected specifically for use in this area with careful consideration of insects and diseases common to the area. The proposed planting also creates variations of color and texture and are integrated in the front yards of the apartment units and simultaneously along the public sidewalks.

Should you have any questions, please feel free to contact this office.

Sincerely,

Kaller Architecture

Joseph B. Kaller AIA, LEED AP BD+C

President

2543 POLK STREET APARTMENTS

HOLLYWOOD, FL 33020



ARCHITECT

JOSEPH B. KALLER AND ASSOCIATES, P.A.
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HOLLYWOOD, FL 33019
PHONE: (954)-920-5746

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FAX: (954)-926-2841

EMAIL: joseph@kallerarchitects.com

<u>OWNER</u>

2543 POLK STREET LLC 215 CONGERS RD STE NEW CITY, NEW YORK 10956

LANDSCAPE

THOMAS WHITE
ADDRESS: 2600 NE 27th AVE.
FORT LAUDERDALE, FL 33306
PHONE: (954)-253-2265
EMAIL: tcawhite@bellsouth.net

CIV

ZEPHYR ENGINEERING
CONTACT: WILFORD ZEPHYR
ADDRESS: 5451 PIERCE ST.
HOLLYWOOD, FL 33021
PHONE: (786)-302-7693
EMAIL: wzephyreng@gmail.com

SURVEYOR

STONER & ASSOCIATES, INC.

ADDRESS: 4341 SW 62nd AVE.

TOWN OF DAVIE, FL 33314

PHONE: (954)-585-0997

WEB: www.stonersurveyors.com

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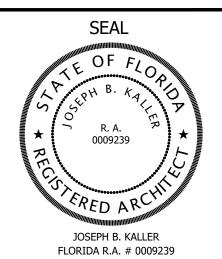
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EROSION & SEDIMENT CONTROL PLAN

Kaller Architecture

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www.kallerarchitects.com



SIKEEI FL. 33020

EET TITLE

MEETING DATES

BOARD/
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06-19-23
07-17-23
09-18-23
TBD

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CHECKED BY: JBK

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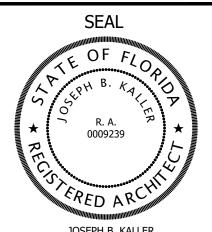




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JOSEPH B. KALLER FLORIDA R.A. # 0009239

SHEET TITLE

RENDERING 1

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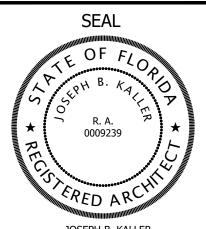


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JOSEPH B. KALLER FLORIDA R.A. # 0009239

POLK STREE --WOOD, FL. 33020

7543

PROJECT TITLE

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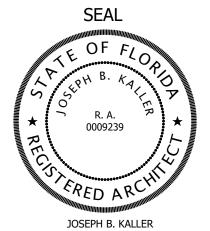
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JOSEPH B. KALLER FLORIDA R.A. # 0009239

MEETING DATES

PACO 06-19-23
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FINAL TAC 09-18-23
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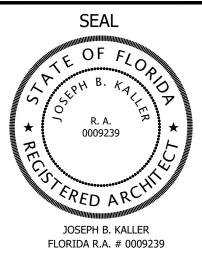
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POLK

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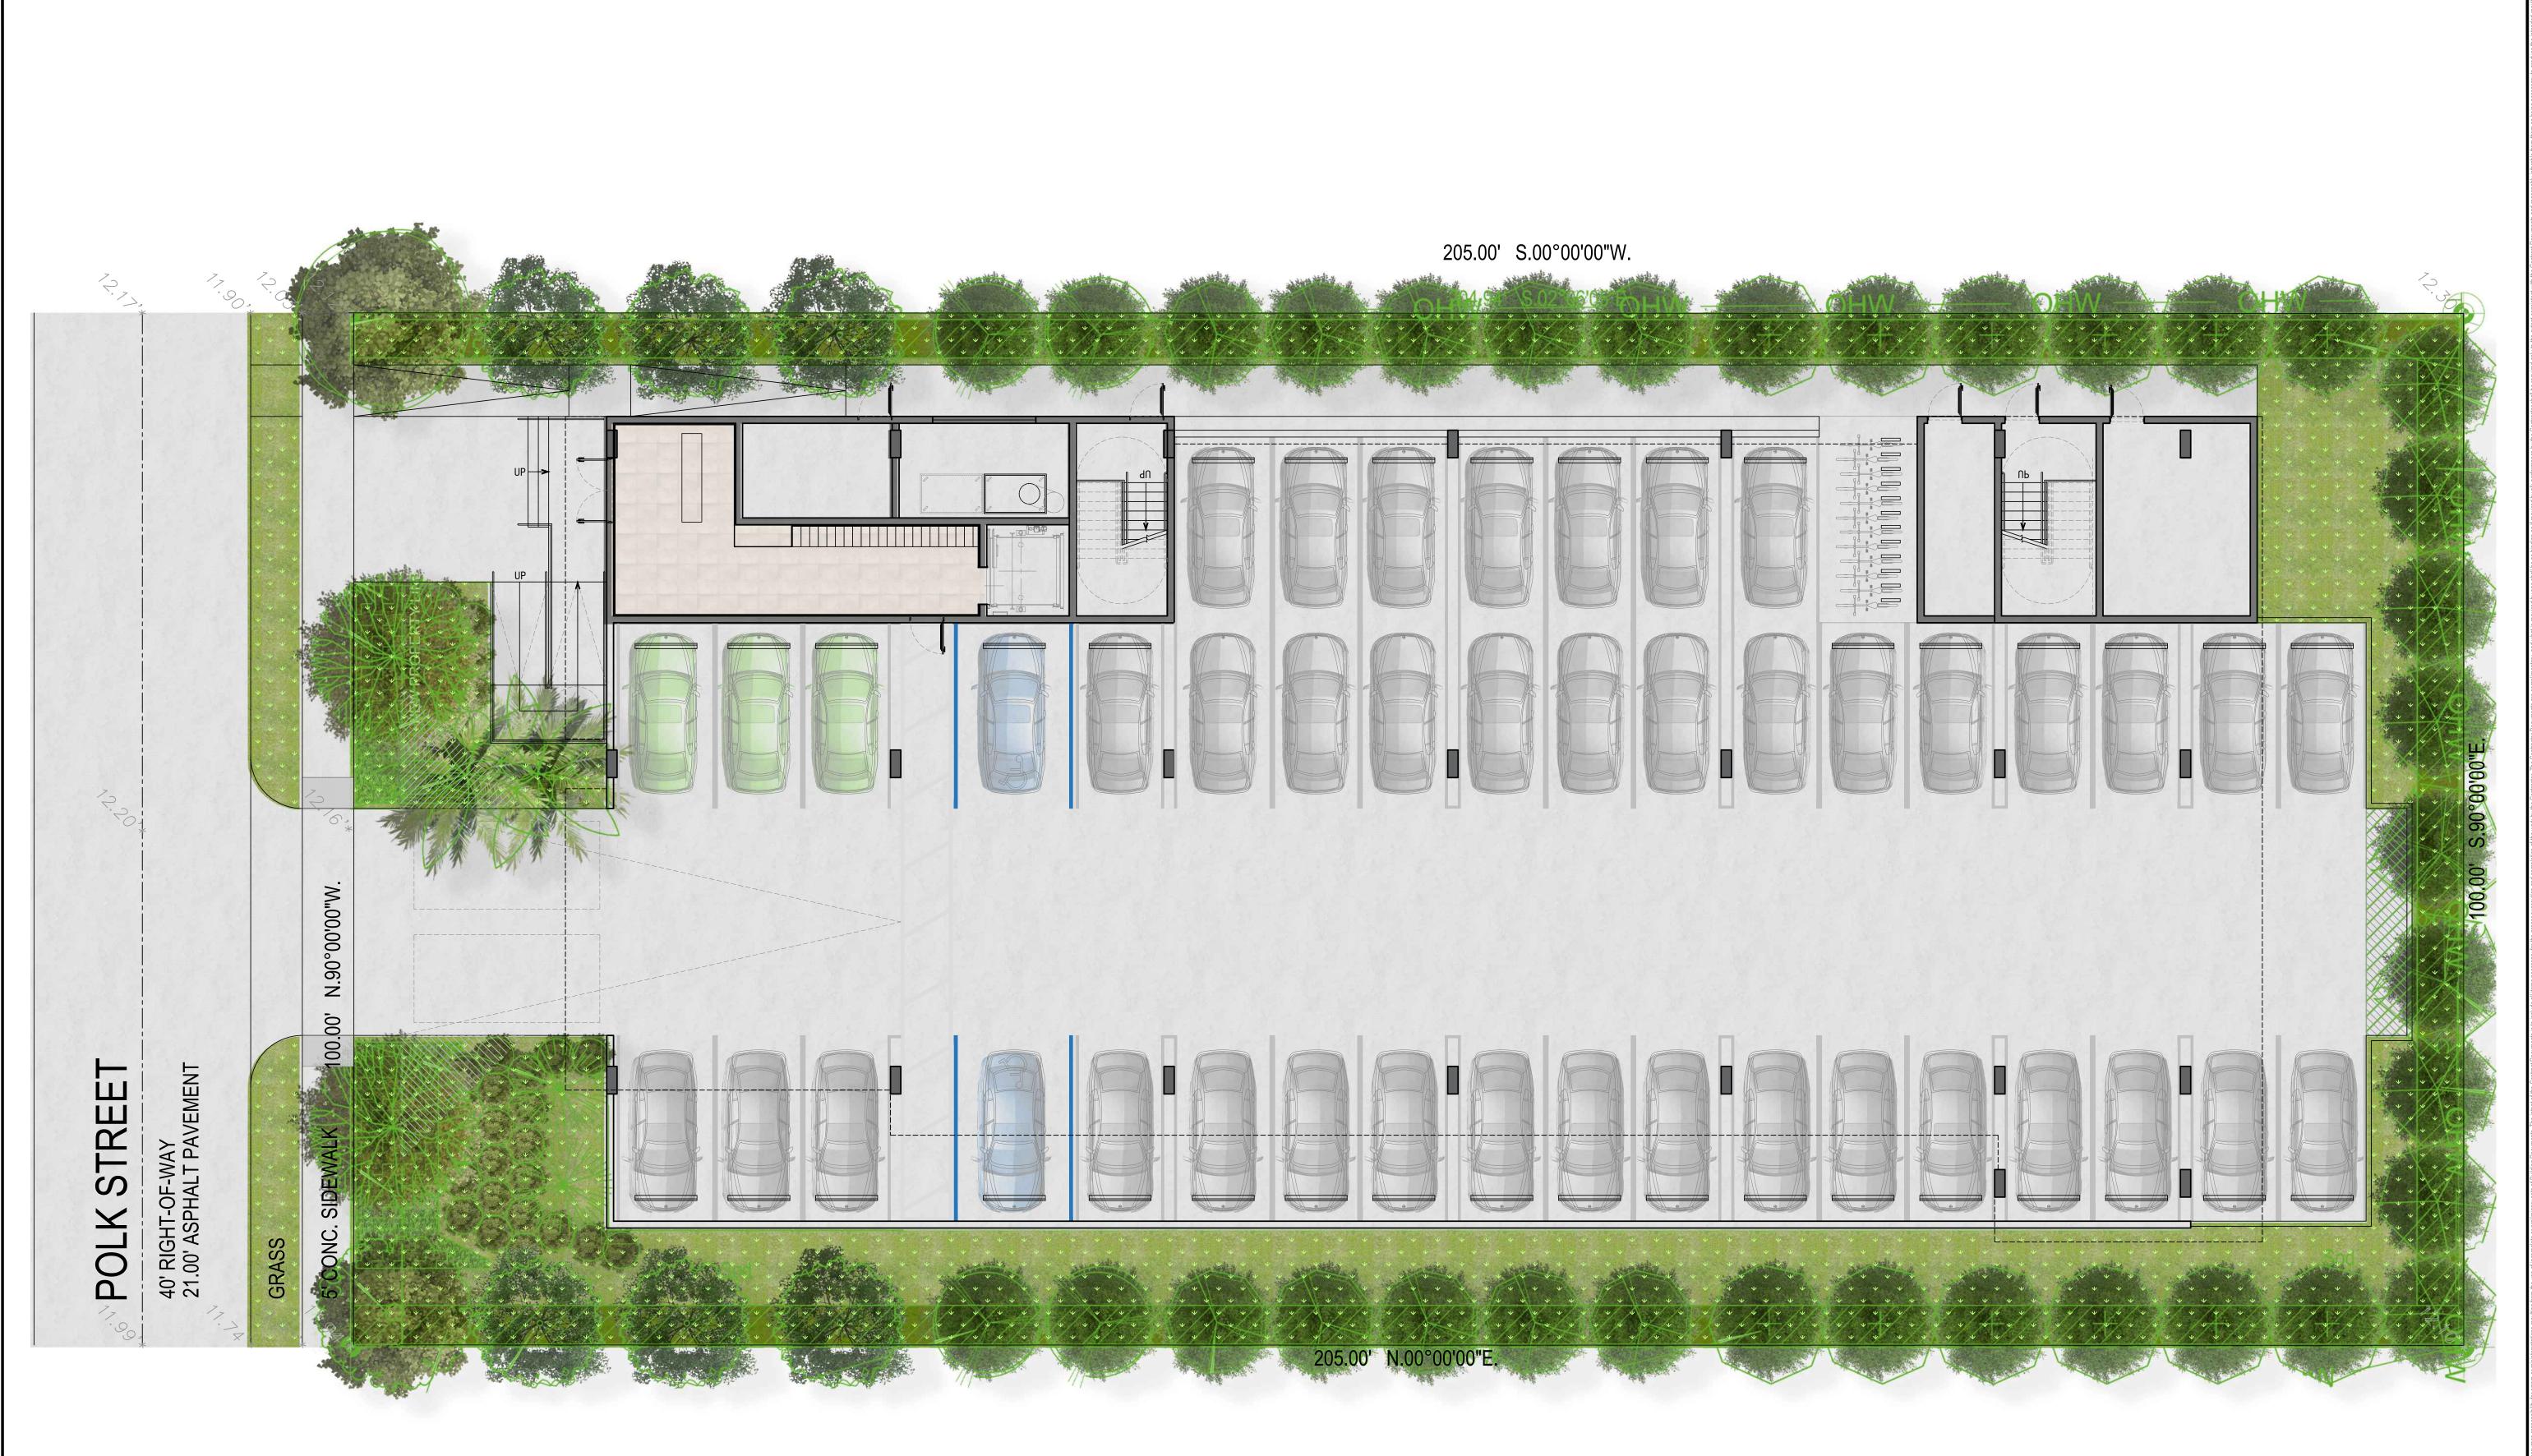
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STREET

POLK

SHEET TITLE

RENDERED SITE PLAN

MEETING DATES

BOARD/
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SHEET

LEGAL DESCRIPTION

HOLLYWOOD LITTLE RANCHES 1-26 B LOT 14 BLK 17

Parcel ID: 514216016570

20,514.00 SF (0.47 acres) **Total Lot Net Area:** 100.00' X 205.00' Lot dimensions:

ZONING INFO

BASIC ZONING

Municipal Future Land Use: Regional Activity Center (RAC)

Zone:

Residential Income (General/Multi-Family) **Existing Building Use:**

Residential **Existing Land Use:**

Regional Activity Center County Future Land Use:

Residential(2), Civic(2), Educational(1) Allowed Use(s):

BUILDING INTENSITY

Maximum Lot Coverage: N/A Maximum Building Height: 45 ft Maximum Height - Stories: Floor Area Ratio (FAR): 1.50 30,771 ft² Maximum Built Area Allowed: **Maximum Building Footprint:** 11,910 ft² Minimum Open Space: 40.00% **Maximum Residential Area Allowed:** 30,771 ft² **Estimated Residential Units Allowed: Unlimited**

SETBACKS AT GROUND LEVEL

Minimum Primary Frontage Setback: 20.00 ft Minimum Side Setback: 10.00 ft Minimum Rear Setback: 20.00 ft

AT-GRADE PARKING LOT AND VEHICULAR USE AREAS SETBACK REQUIREMENTS

10 feet Front: 5 feet Alley:

Amount of Required Off-Street Parking

Units of one bedroom or less; and Qualifiable Affordable Housing Developments: 1 space per unit; Units exceeding one bedroom (including dens): 1.5 space per unit; plus 1 space per 10 units for guest parking

Off-Street loading spaces; general provisions Multiple Family or Apt./Hotel Bldg: 50-100 Units - 1 space + 1 space for each

additional 100 units or major fraction.

FEMA

Insurance Mandated?

New Flood Zone: X - Below 500 Year Flood Plain

New NAVD 88 Elevation: N/A Old Flood Zone:

100 YEAR MAP

Future Conditions 100-Year Flood Elevation (Feet NAVD88)

Elevation: 13.5

NOTE: ALL SIGNAGE SHALL BE IN COMPLIANCE

WITH THE ZONING AND LAND DEVELOPMENT

REGULATIONS.

PROJECT INFO

PROPOSED CONSTRUCTION TYPE: 3B

Maximum Building Height:

45 ft Allowed: Proposed:

Floor Area Ratio (FAR) 1.50:

Allowed:

30,771.00 ft² (1.50) Proposed: 30,737.00 ft² (1.49)

31,518 ft²

40% (8,205.6 ft²)

Gross Building Area:

Proposed:

Leasable / Sellable Area:

26,708 ft² Proposed:

Open Space (pervious):

Minimum: Proposed:

5,131 ft² **Ground:** 3,087 ft² **Roof Terrace:** TOTAL: 40% (8,218 ft²)

Front Setback:

20'-0" Minimum: 20'-0" Proposed:

Rear Setback:

20'-0" Minimum: 20'-0" Proposed:

Side Setback:

Minimum: 10'-0" Proposed:

Parking Requirement

One Bed Unit (30un x 1): 30 spaces One Bed + Den (3un x 1): 05 spaces

Visitors (30un / 10): 03 spaces

Total Parking Required: 38 spaces Total Parking Proposed: 43 spaces (Inc. 7 tandem & 2 ADA P.S.)

Tandem spaces can only be assigned to one unit.

Accesible Parking spaces:

Required: 02 spaces Provided: 02 spaces

Off-Street loading spaces:

Required: 0 spaces Proposed: 0 spaces


Bicycle Parking:

Required: 3 racks (20 parking spaces = 1 bike rack) Proposed: 12 racks

UNIT MIX


TYPE	TAG	A/C AREA	TERRACE	SELLABLE AREA	Ħ	%	REQ. PARKING
ONE BED + DEN	D1	895	139	1034	1	3.0303	1.5
	D2	895	65	960	2	6.06061	3
ONE BED	A1	775	105	880	3	9.09091	3
	A2	712	134	846	1	3.0303	1
	A3	708	134	842	1	3.0303	1
	A4	550	118	668	3	9.09091	3
	A5	884	99	983	1	3.0303	1
	A6	672	93	765	2	6.06061	2
	A7	698	97	795	1	3.0303	1
	A8	679	93	772	1	3.0303	1
	A9	773	103	876	3	9.09091	3
	A10	712	60	772	2	6.06061	2
	A11	708	59	767	2	6.06061	2
	A12	884	45	929	2	6.06061	2
	A13	672	42	714	4	12.1212	4
	A14	698	42	740	2	6.06061	2
	A15	679	42	721	2	6.06061	2
TOTAL		24,054	2,654	26,708	33	100	35

CUMULATE AVE. UNIT SIZE REQ. 500 SF CUMULATE AVE. UNIT SIZE PROP. 729

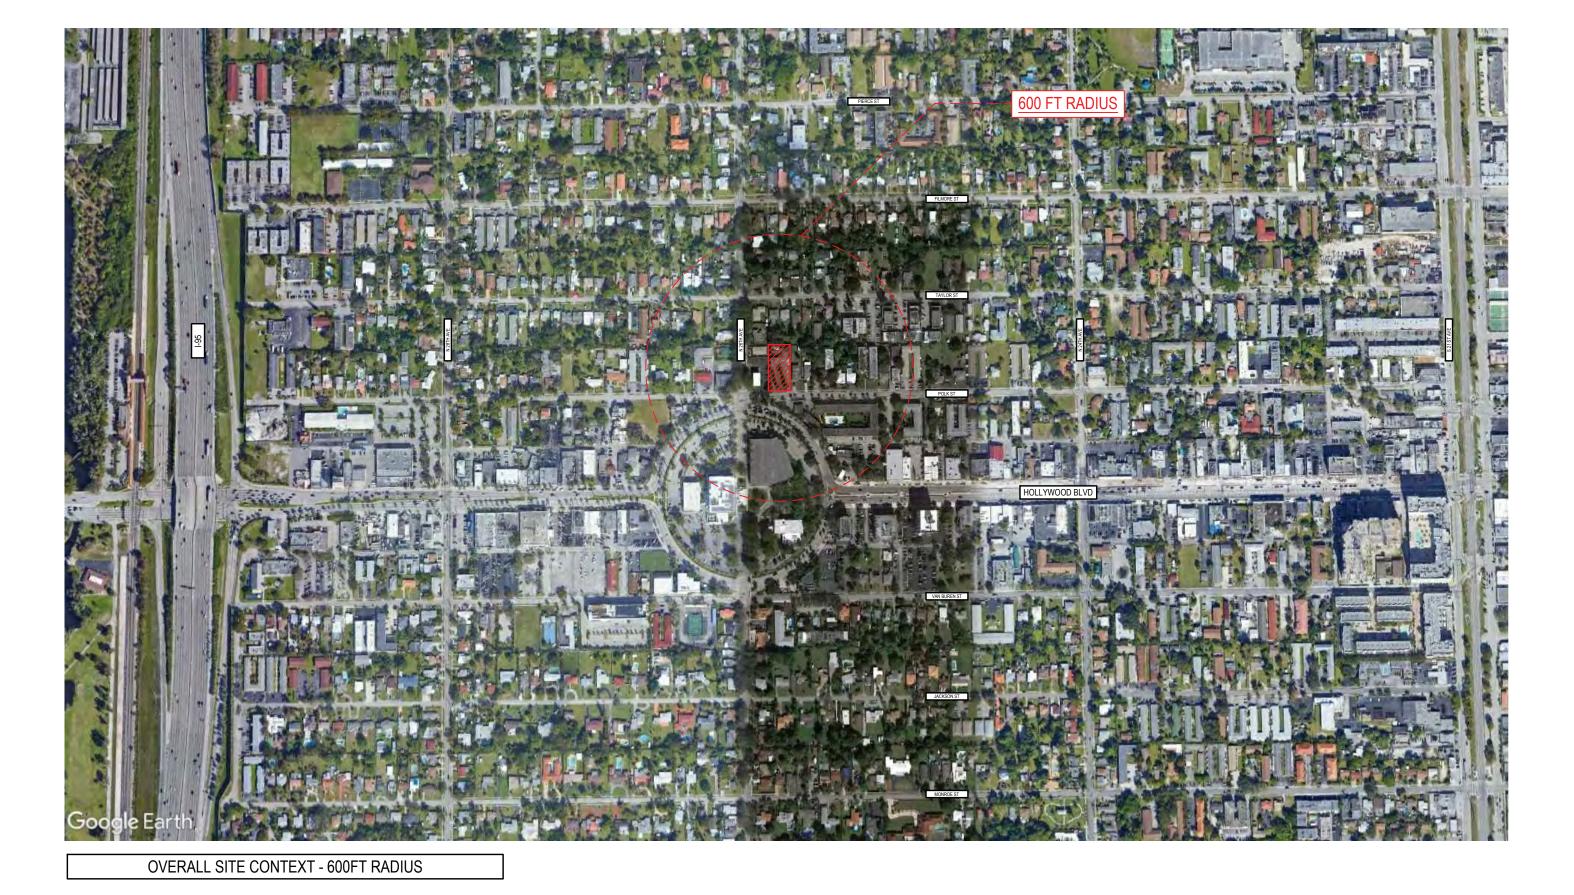



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STREET

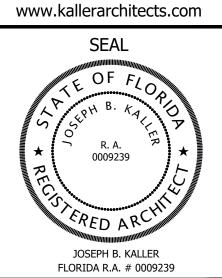POLK 43 7

SITE

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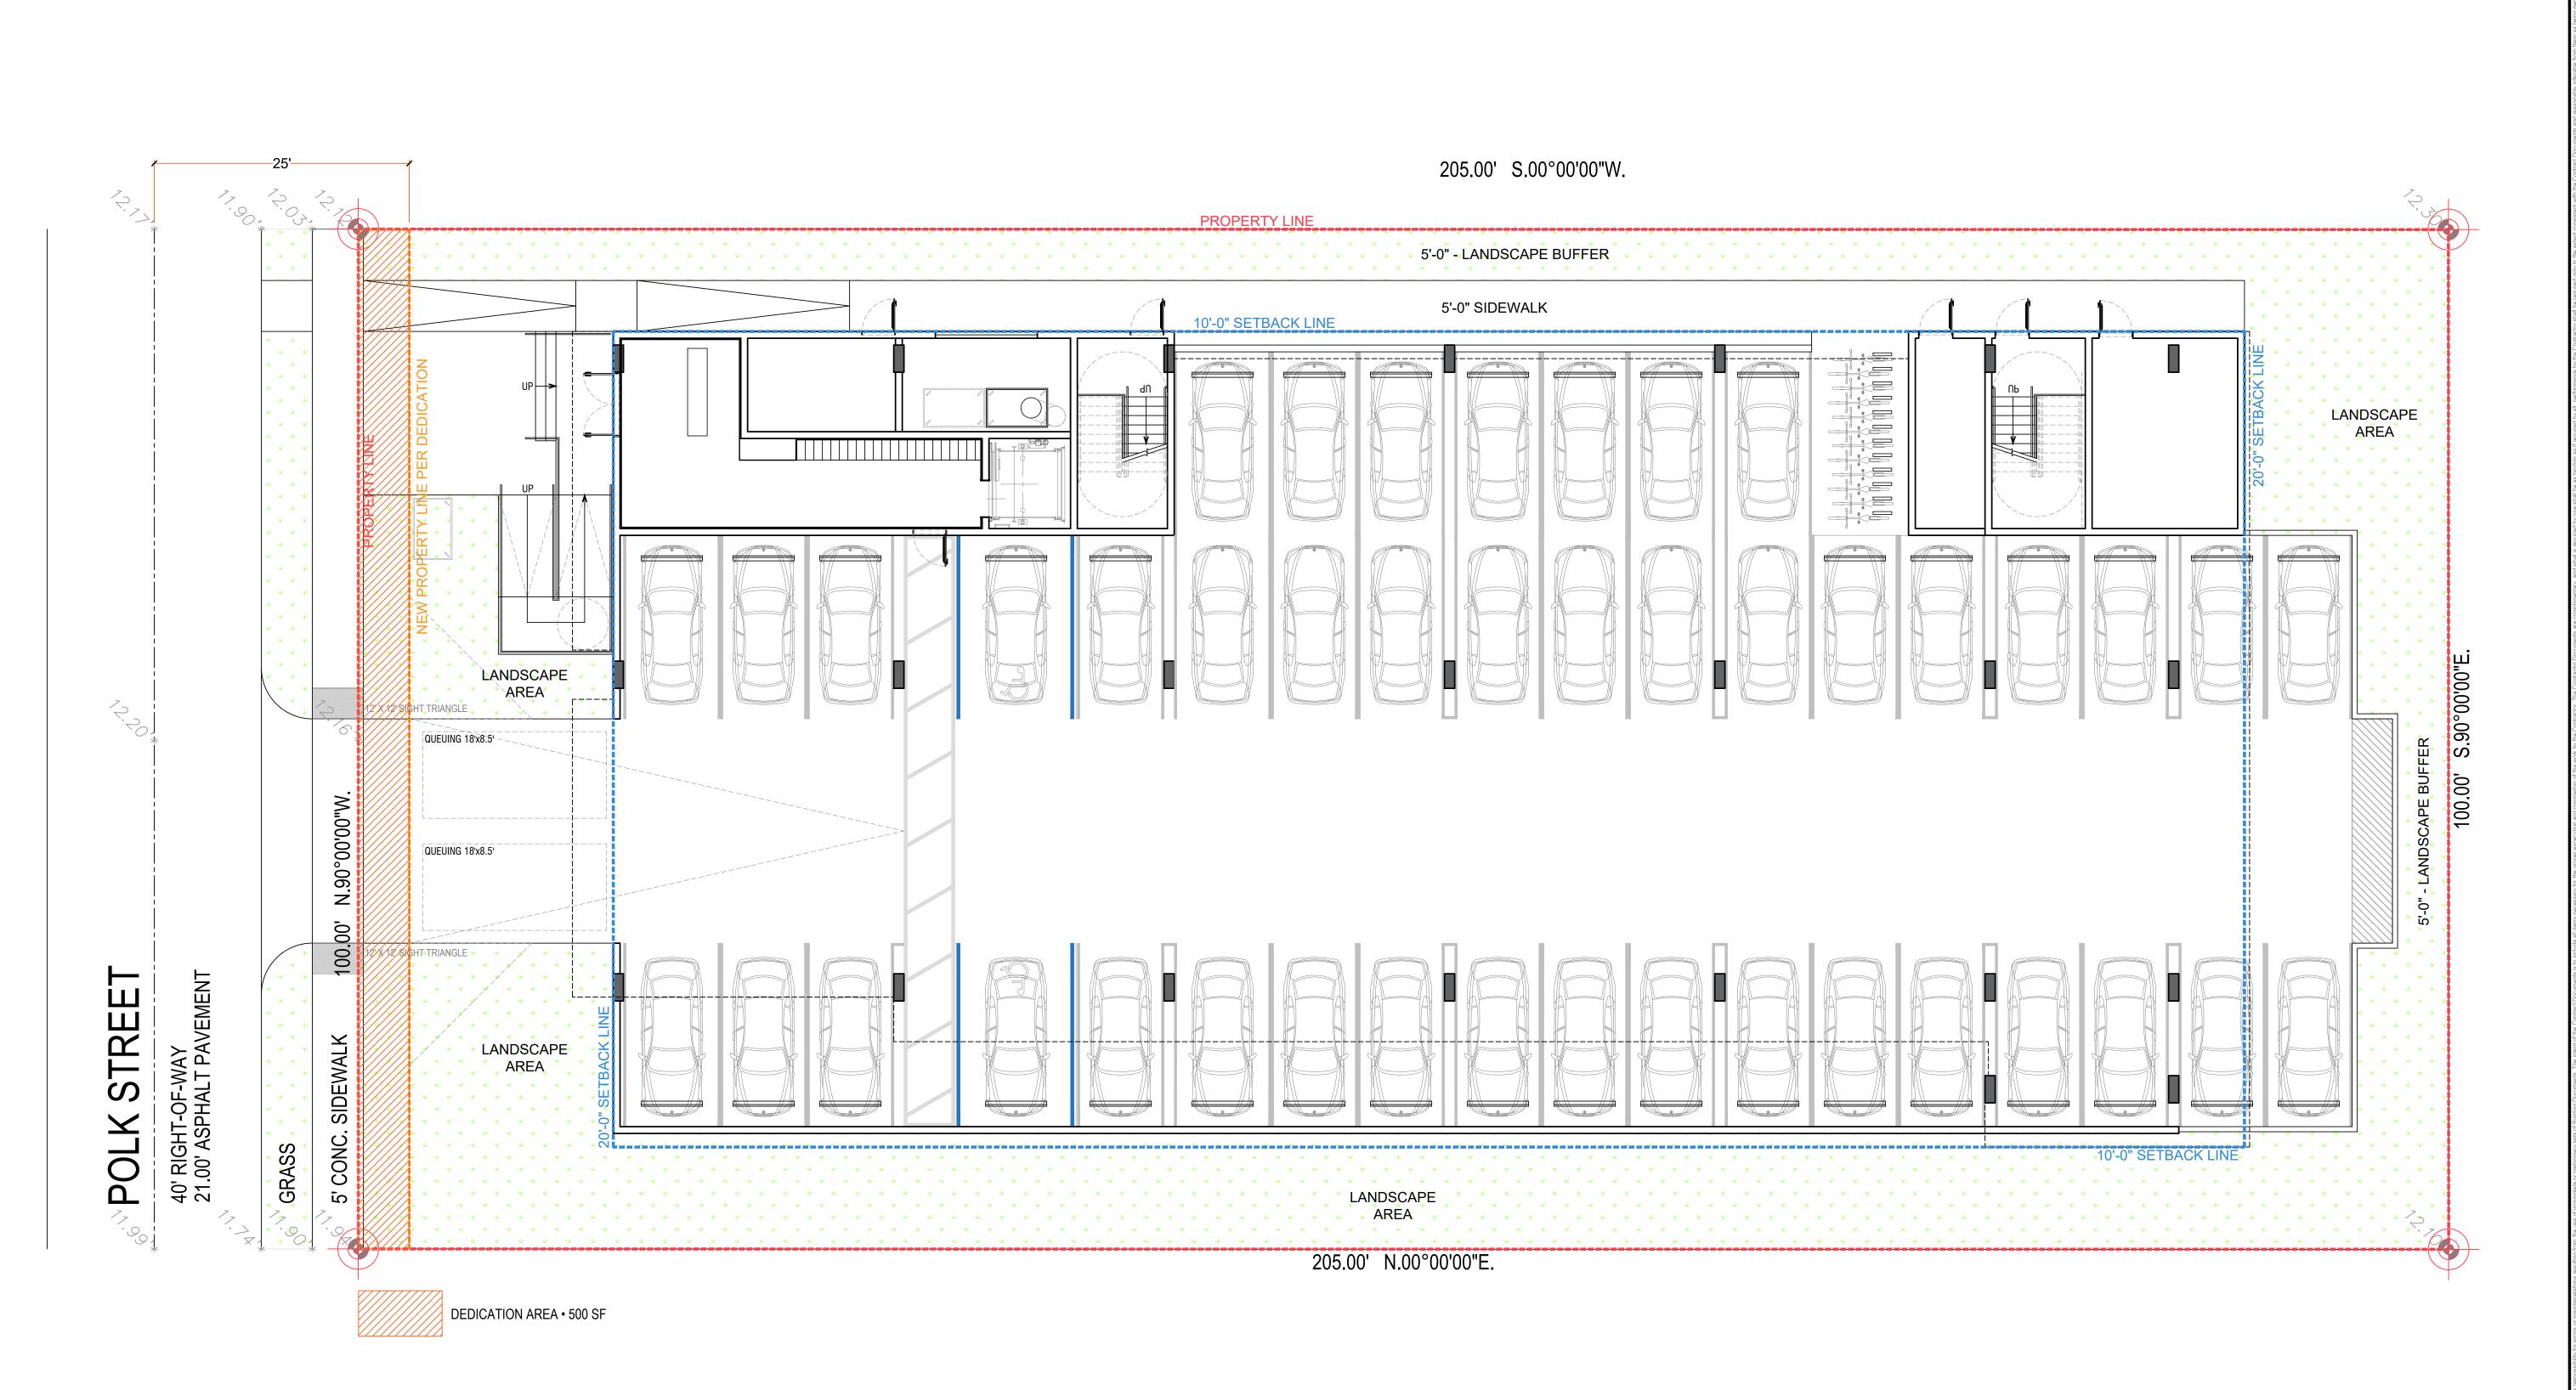
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CHECKED BY: JBK SHEET

CHARTS

CONTEXT





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JOSEPH B. KALLER

FLORIDA R.A. # 0009239

STREET POLK

SHEET TITLE
PROPOSED DEDICATION A
PLAN

MEETING DATES


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STREET POLK

V.U.A. -

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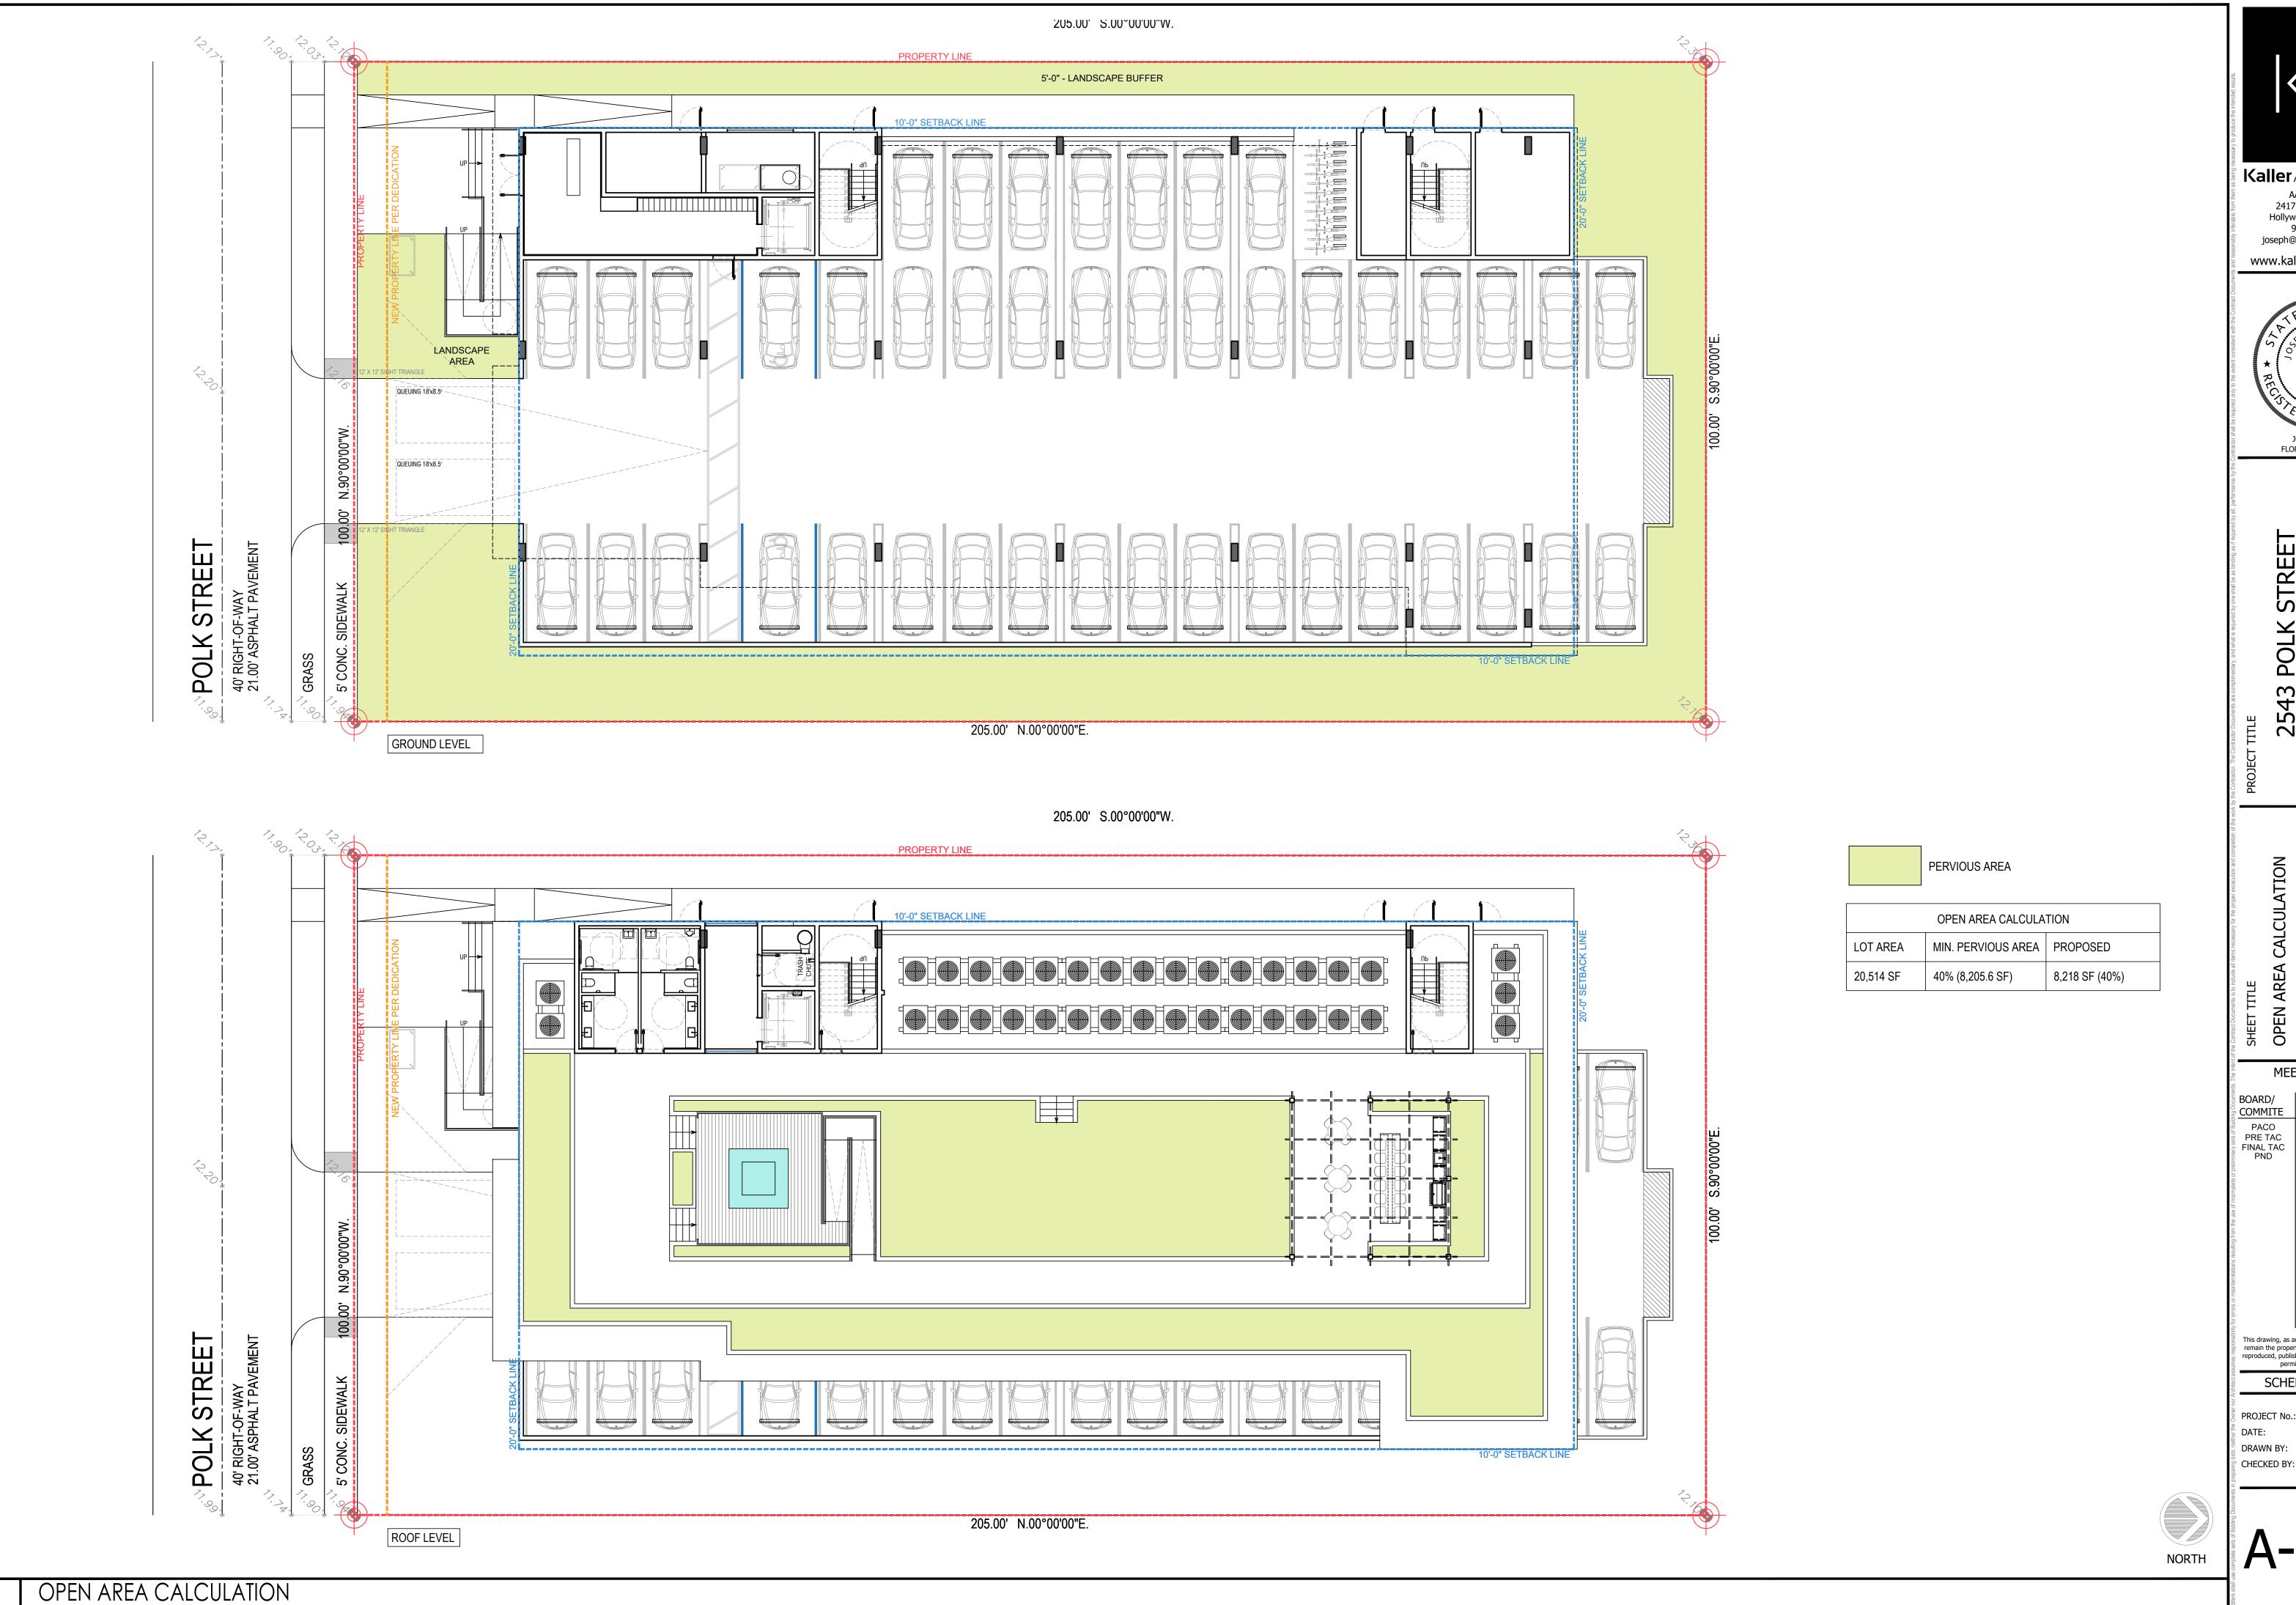
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REQUIRED LANDSCAPE 672 SF X 0.25 = 168 SF

PROPOSED LANDSCAPE

2,115 SF

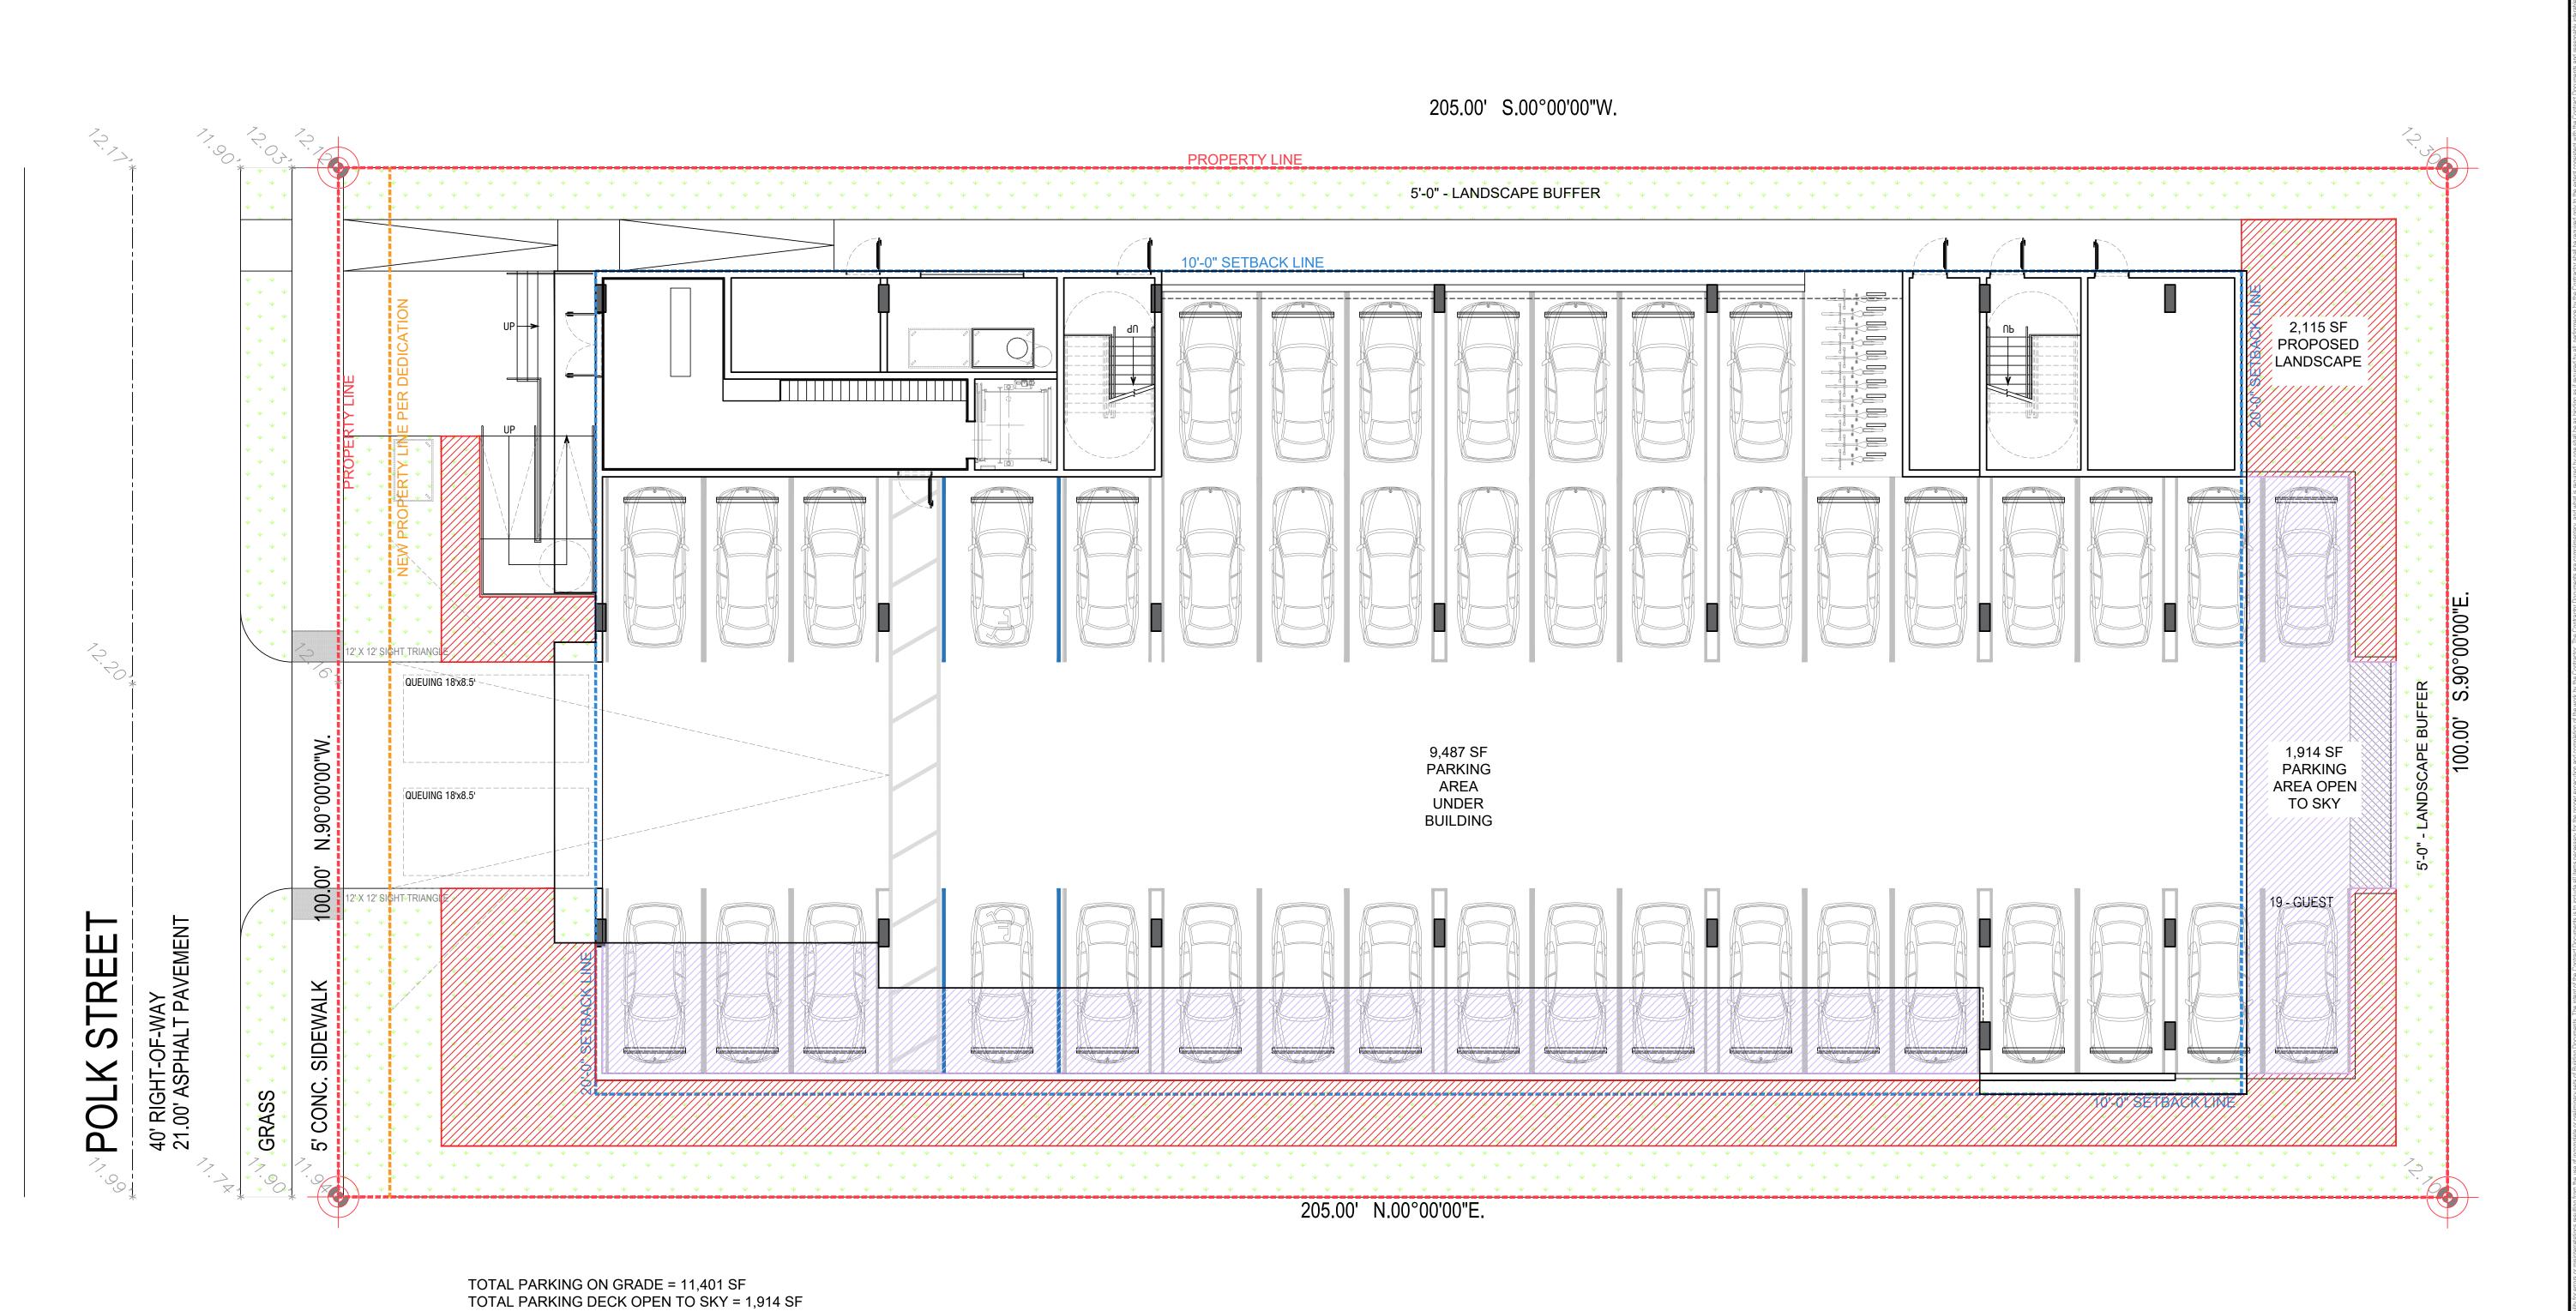


3/32" = 1'-0"



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STREET

POLK 2543

SHEET TITLE

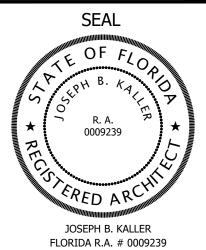OPEN AREA CALCULATION

DIAGRAM

MEETING DATES

DATE DESCRIPTION

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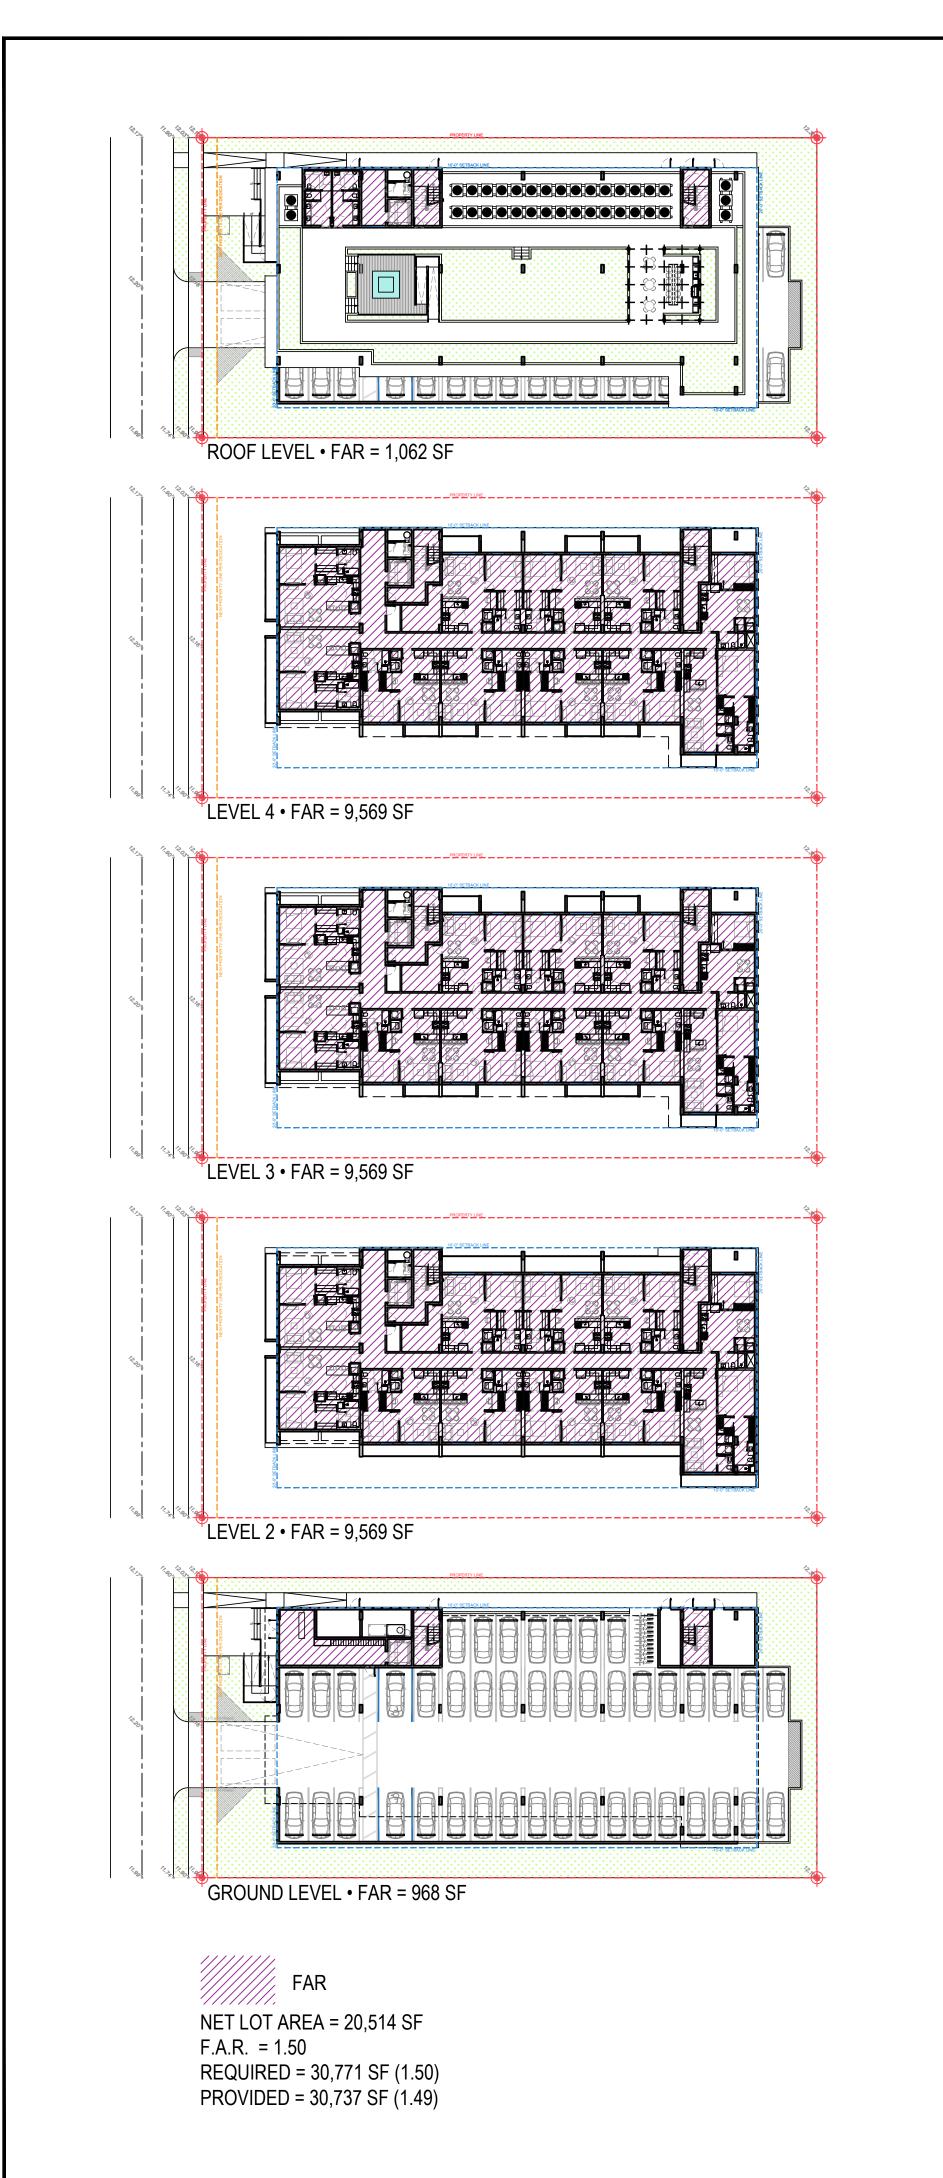
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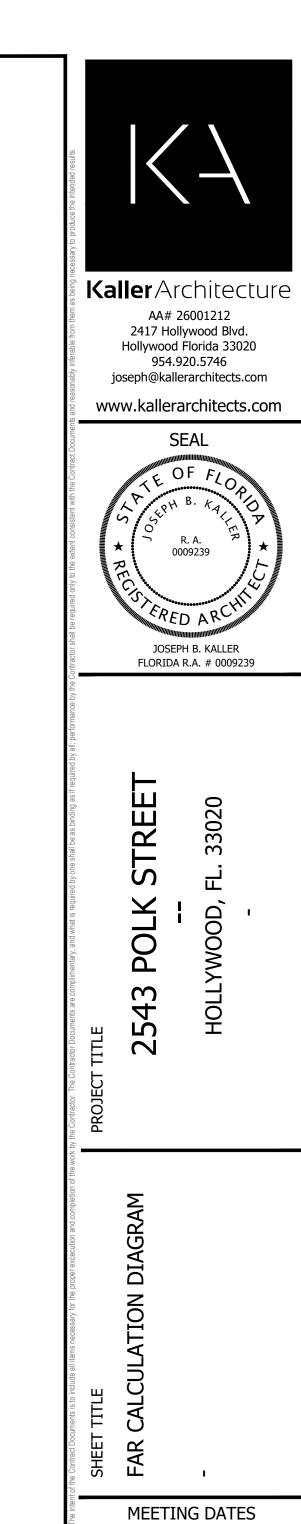
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SHEET





BOARD/
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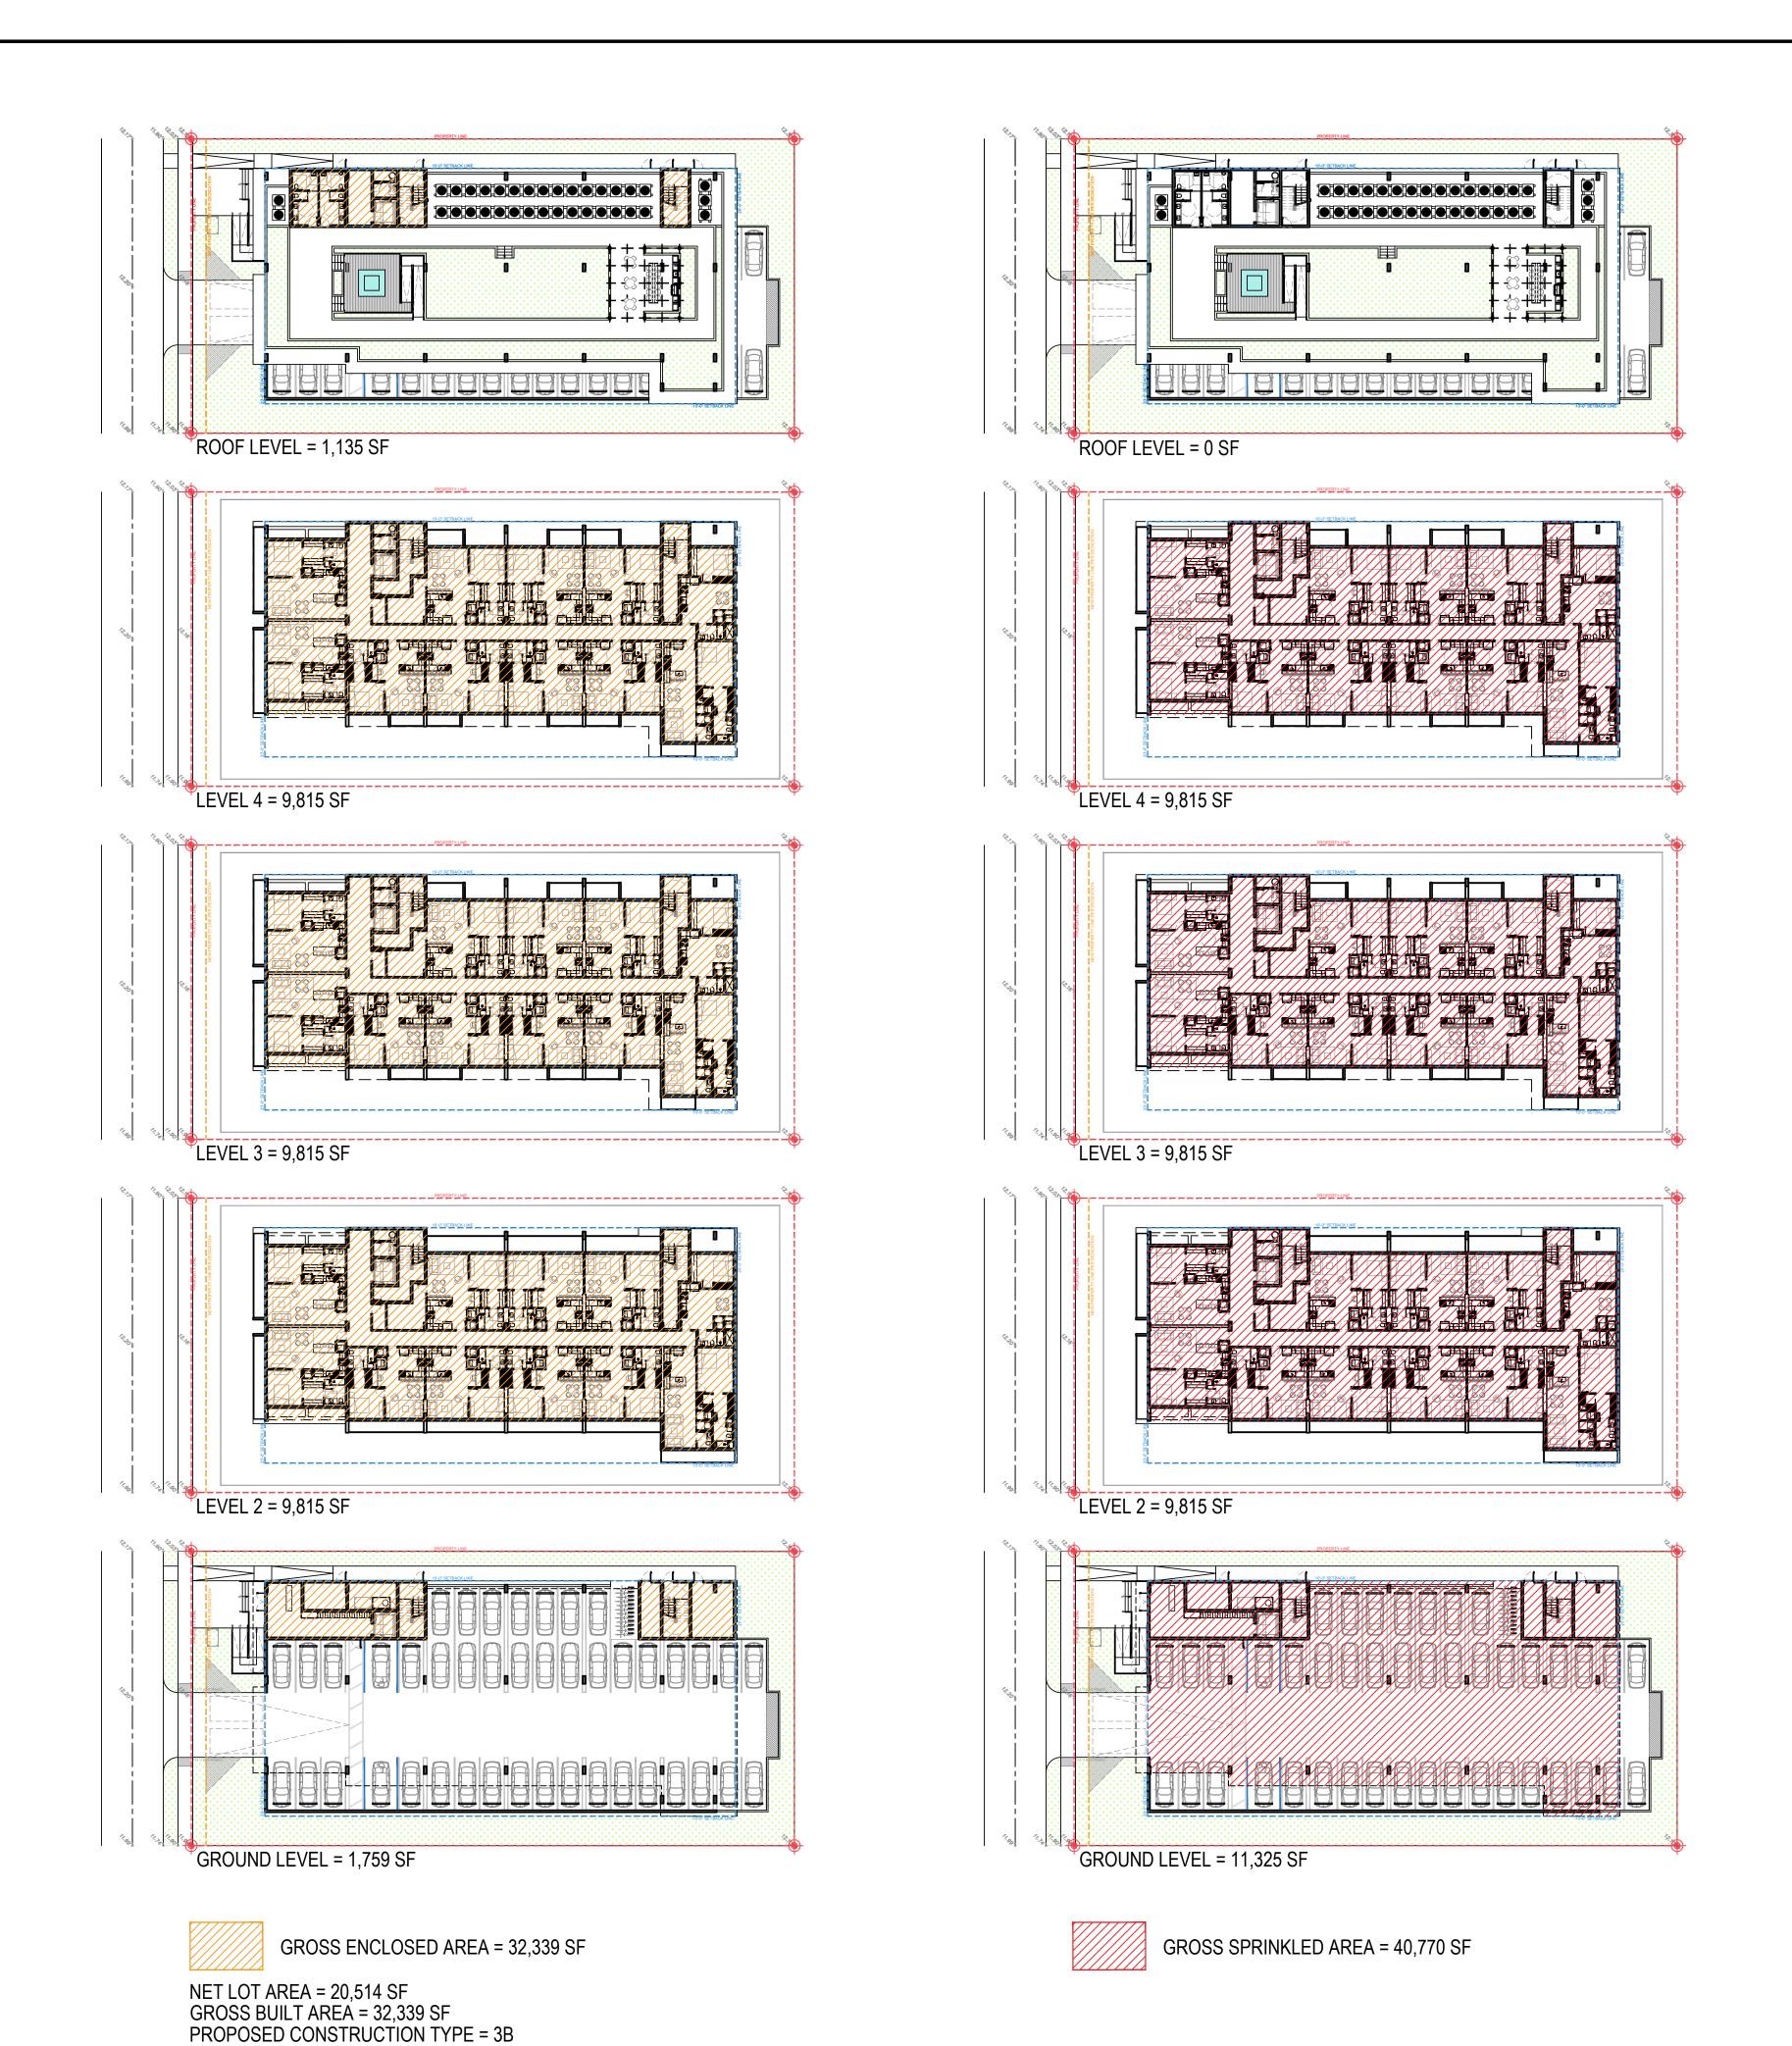
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954.920.5746

joseph@kallerarchitects.com

www.kallerarchitects.com

SEAL

OF FLOAD

R.A.

0009239

**

RECSSERED ARCHITIME

JOSEPH B. KALLER

FLOADINA B.A. # 00002330

JOSEPH B. KALLER FLORIDA R.A. # 0009239

STREET

2543 POLK --

PROJECT TITLE

I IIILE SS SPRINKLERED AREA CULATION

MEETING DATES

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PROJECT No.: 23017

DATE: 02/08/2

DRAWN BY: SCHIFF

CHECKED BY: JBK

NORTH

DRAWN BY: SCHIFFINO & J.D.

CHECKED BY: JBK


SHEET

4 -



AA# 26001212 2417 Hollywood Blvd. Hollywood Florida 33020 954.920.5746

joseph@kallerarchitects.com

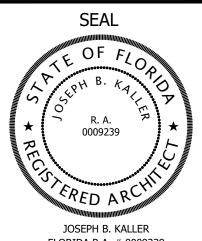

JOSEPH B. KALLER FLORIDA R.A. # 0009239

MEETING DATES

BOARD/
COMMITE

PACO
PRE TAC
PINAL TAC
PND

BOARD/
DATE

DESCRIPTION

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SCHEMATIC DESIGN

PROJECT No.: 23017 02/08/24


SCHIFFINO & J.D. CHECKED BY: JBK

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PROJECT No.: 23017

SCHIFFINO & J.D. CHECKED BY: JBK

SHEET



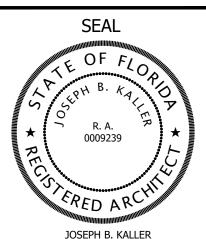













A 2607 POLK STREET

N.T.S.

B 2555 POLK STREET

N.T.S.

C 2535 POLK STREET

N.T.S.

D 2531 POLK STREET

N.T.S.

E 2525 POLK STREET

N.T.S.

F 2600 HOLLYWOOD BLVD

N.T.S.

G 3635 HOLLYWOOD BLVD

N.T.S.

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JOSEPH B. KALLER FLORIDA R.A. # 0009239

MEETING DATES

BOARD/ COMMITE DATE DESCRIPTION

PACO 06-19-23
PRE TAC 07-17-23
FINAL TAC PND TBD

DATE DESCRIPTION

DATE DESCRIPTION

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SHEET

A-1.8






VIEW

B VIEW



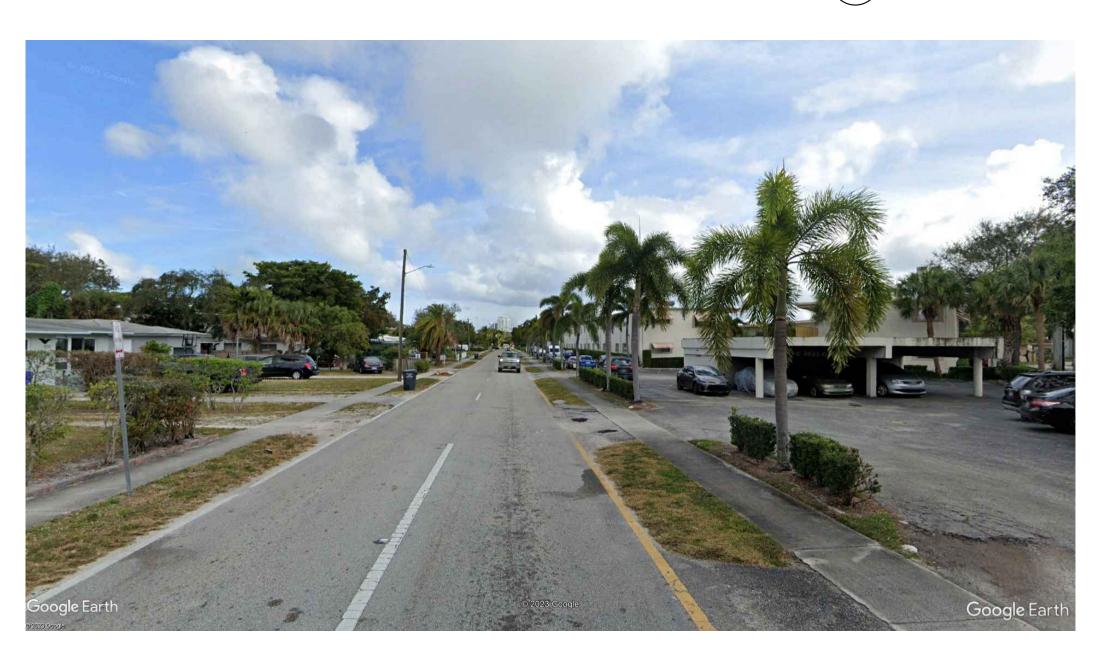


D VIEW



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joseph@kallerarchitects.com www.kallerarchitects.com

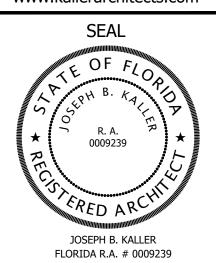

STREET VIEWS

MEETING DATES

BOARD/
COMMITE

PACO
PRE TAC
PND

PND

DATE

DESCRIPTION

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SCHEMATIC DESIGN

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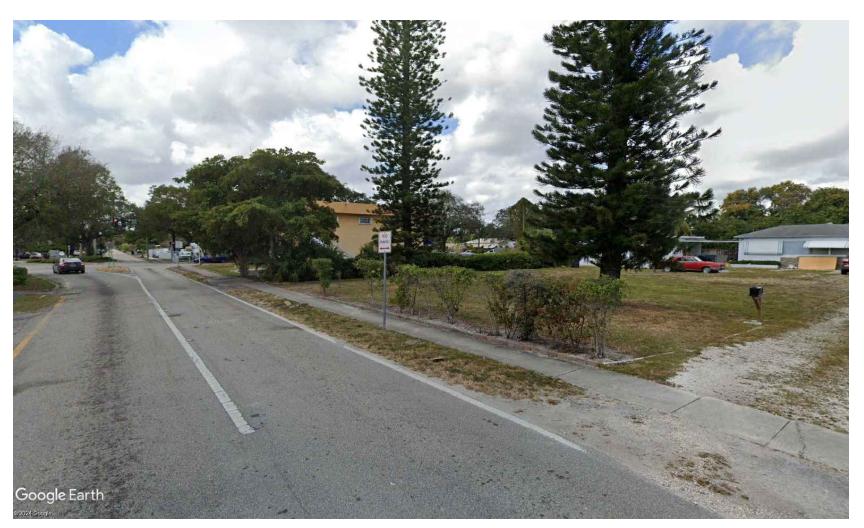
02/08/24 SCHIFFINO & J.D. CHECKED BY: JBK

SHEET












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MEETING DATES

BOARD/ COMMITE DATE DESCRIPTION

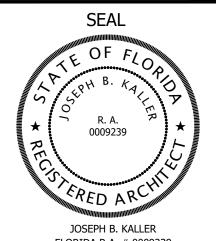PACO 06-19-23
PRE TAC 07-17-23
FINAL TAC PND TBD

PACO 09-18-23
TBD


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A-2.0



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FLORIDA R.A. # 0009239


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DATE DESCRIPTION

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SCHEMATIC DESIGN

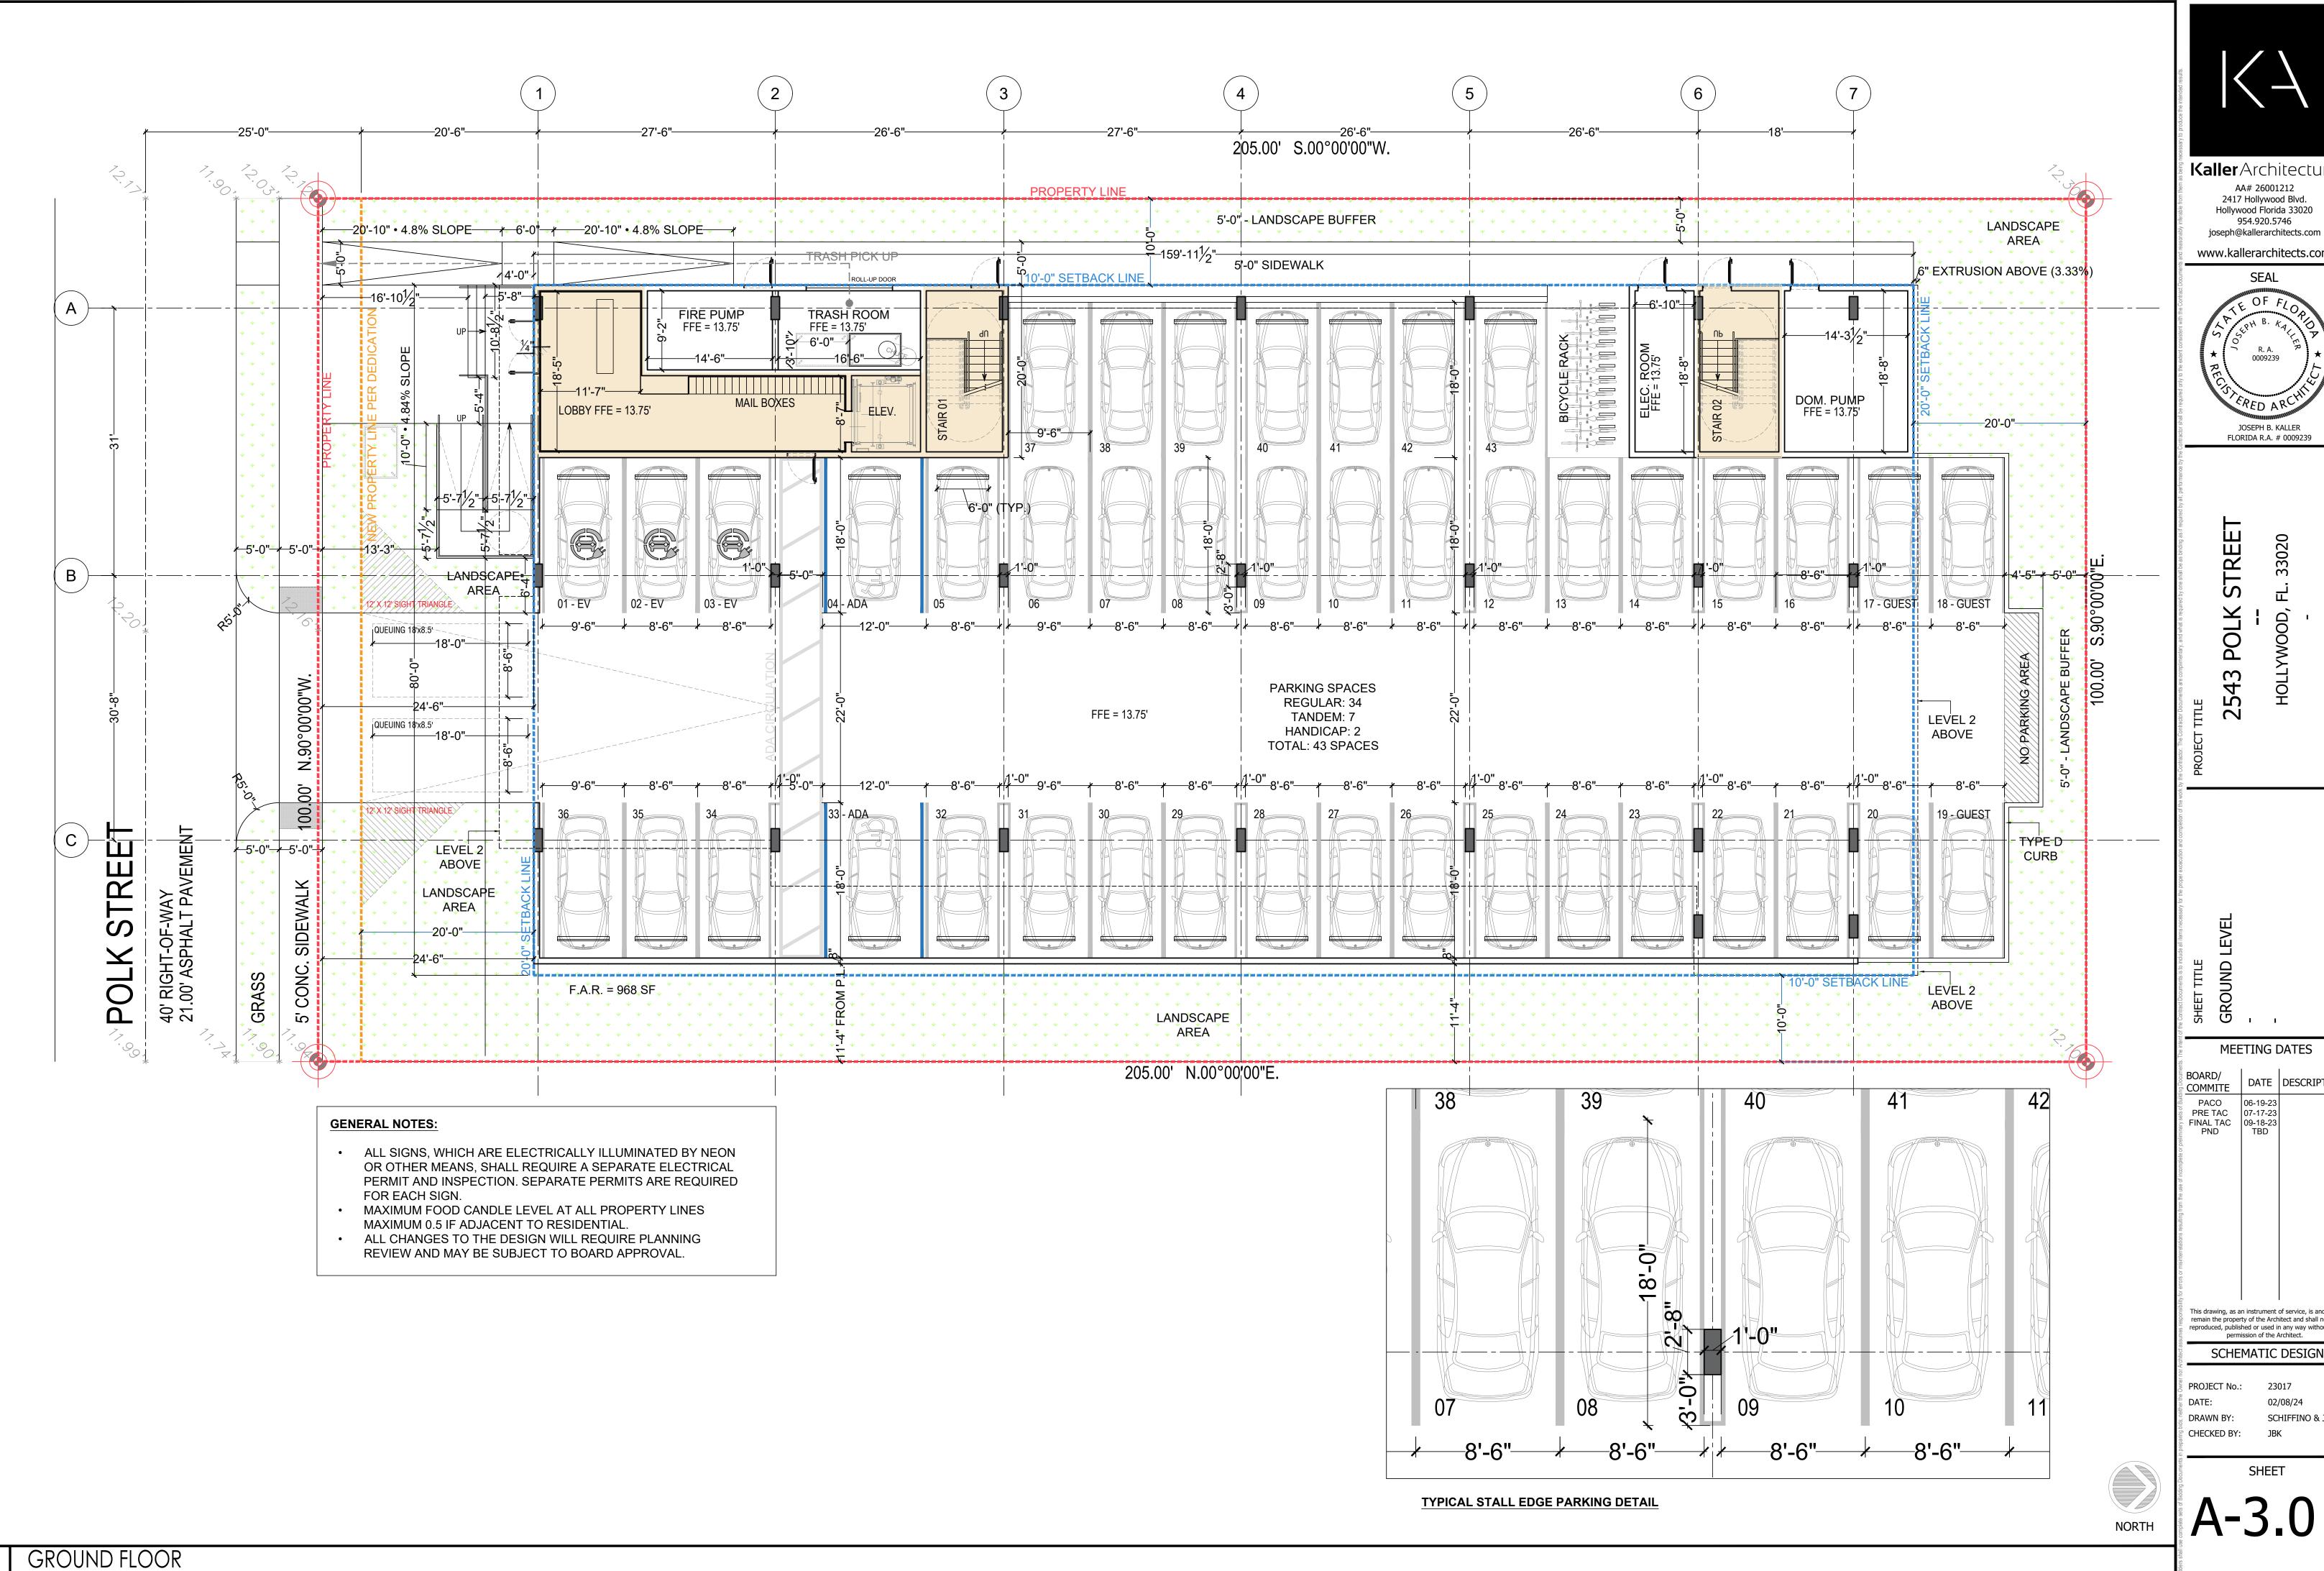
SCHIFFINO & J.D.



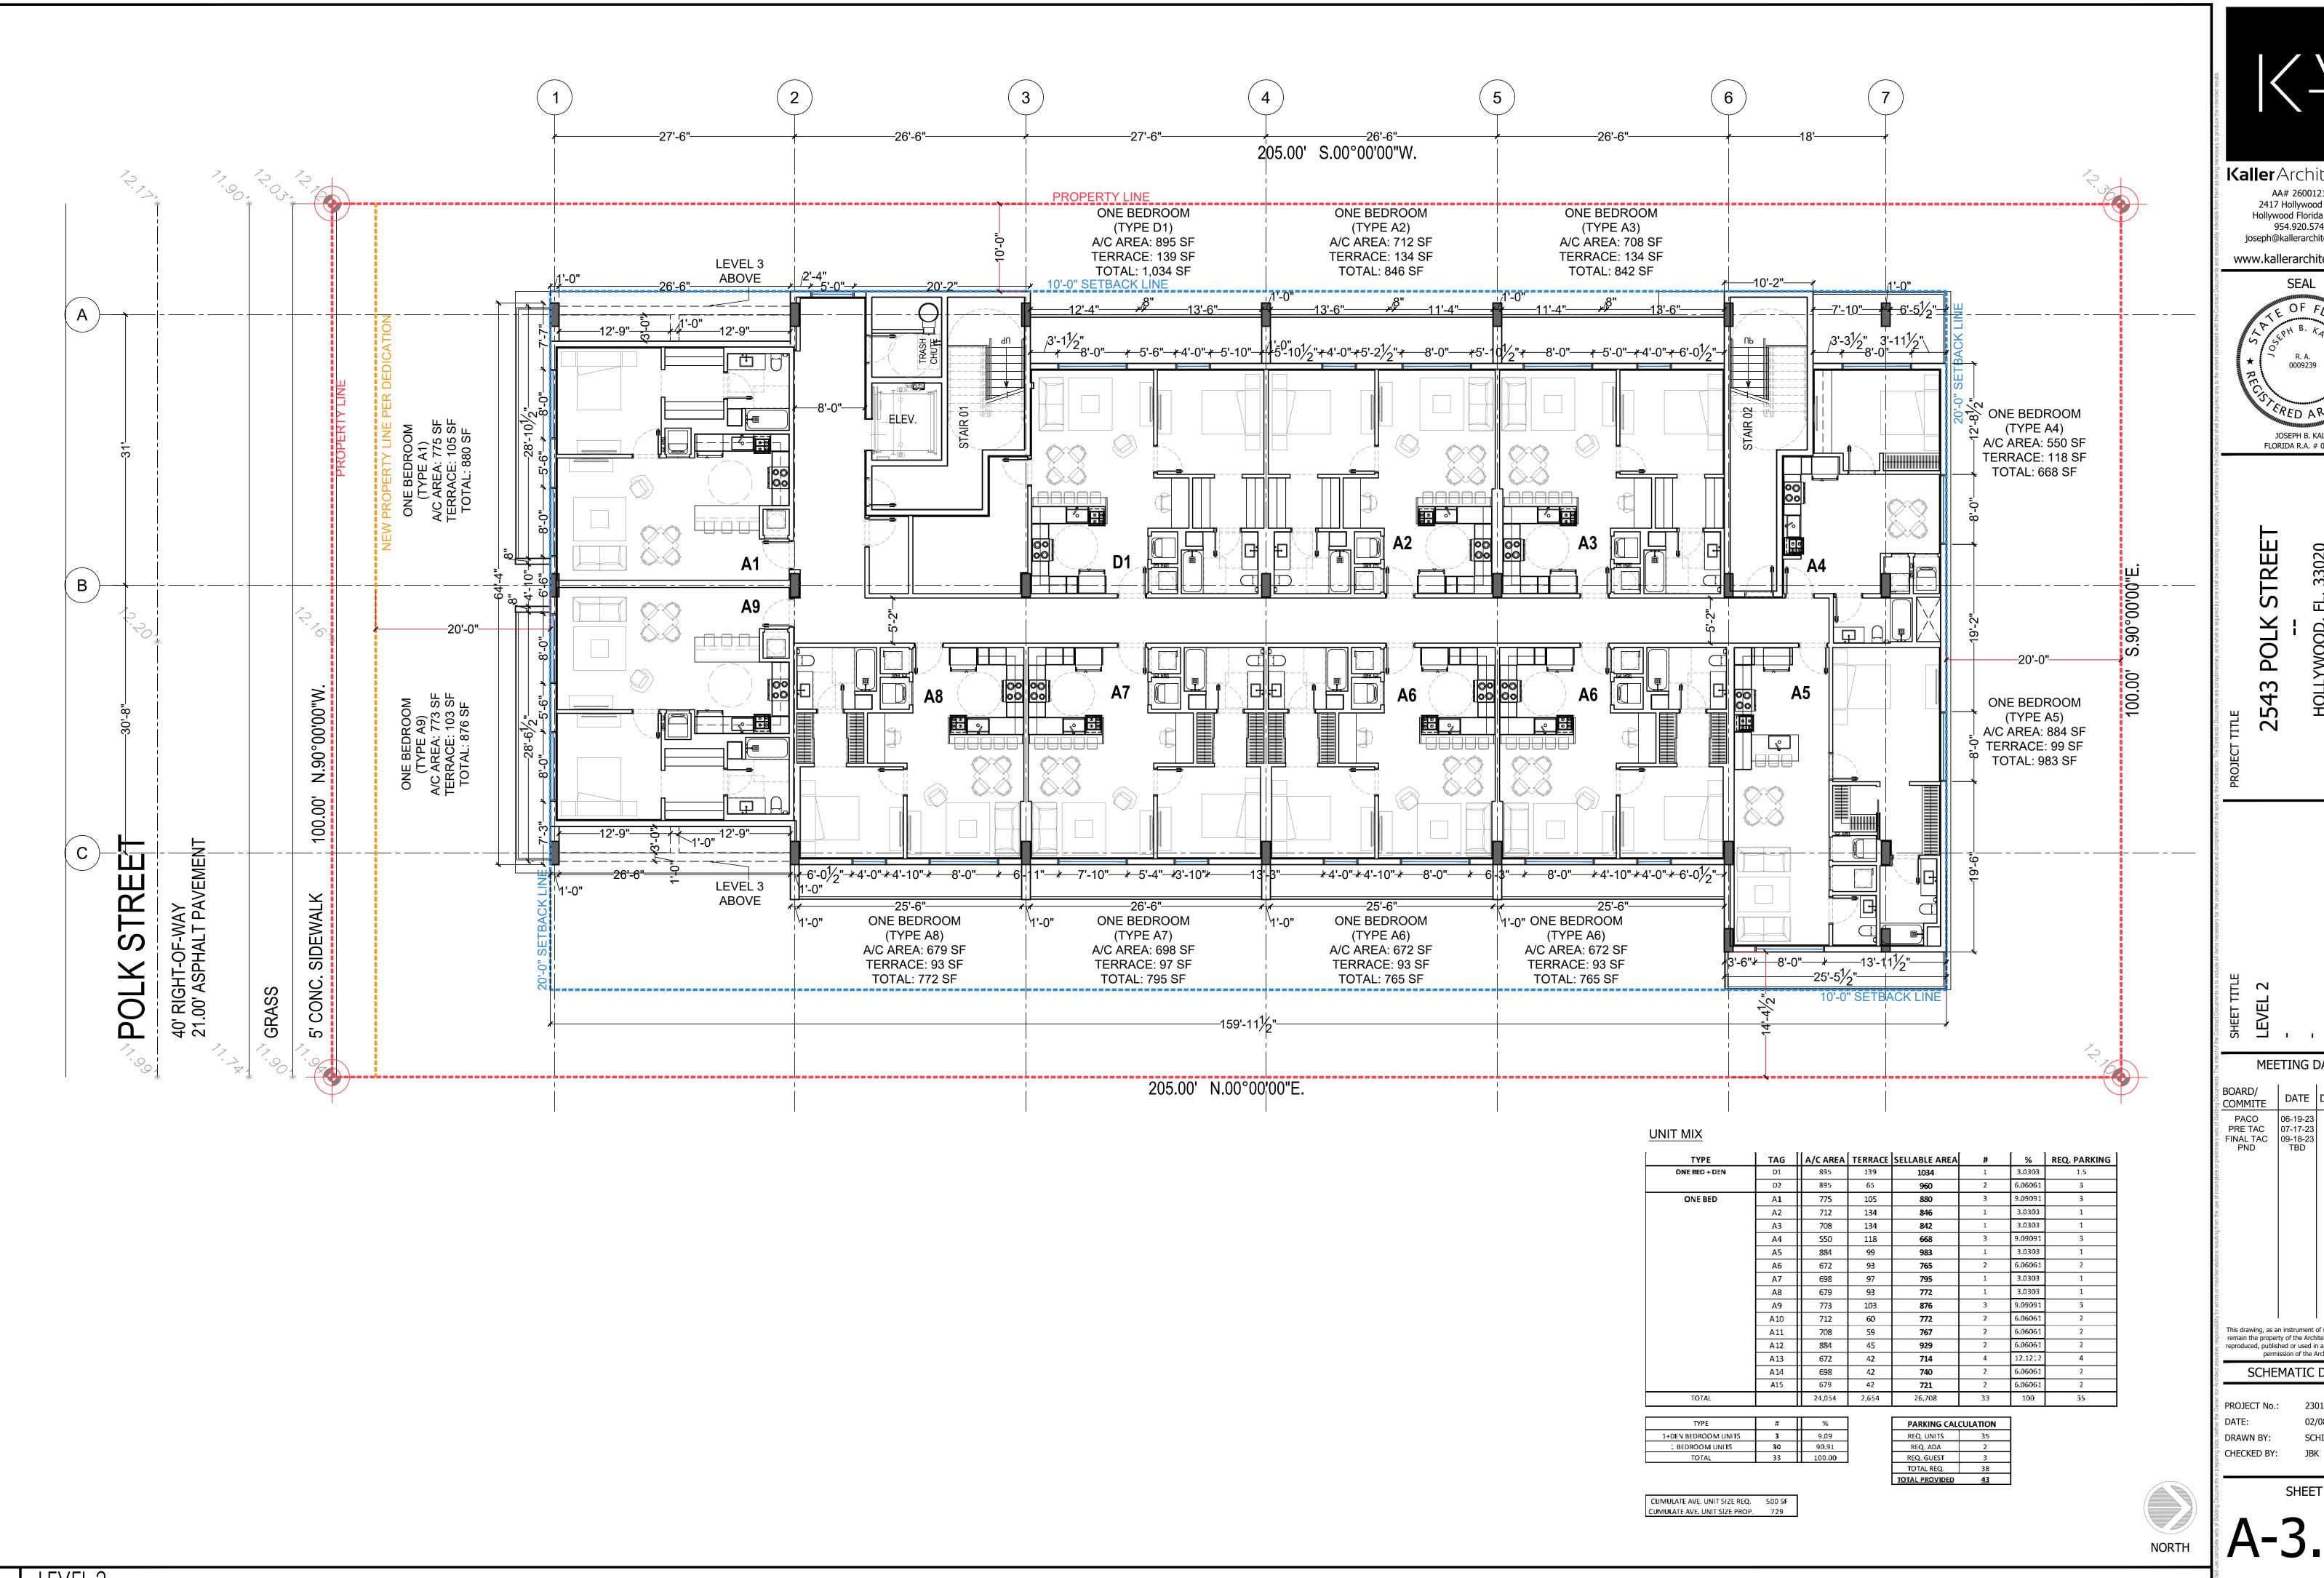

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FLORIDA R.A. # 0009239

STREET **POLK**

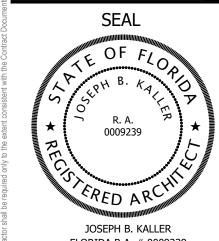7

MEETING DATES DATE DESCRIPTION


PRE TAC 07-17-23 09-18-23 PND TBD

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permission of the Architect. SCHEMATIC DESIGN


PROJECT No.: 23017

SCHIFFINO & J.D.

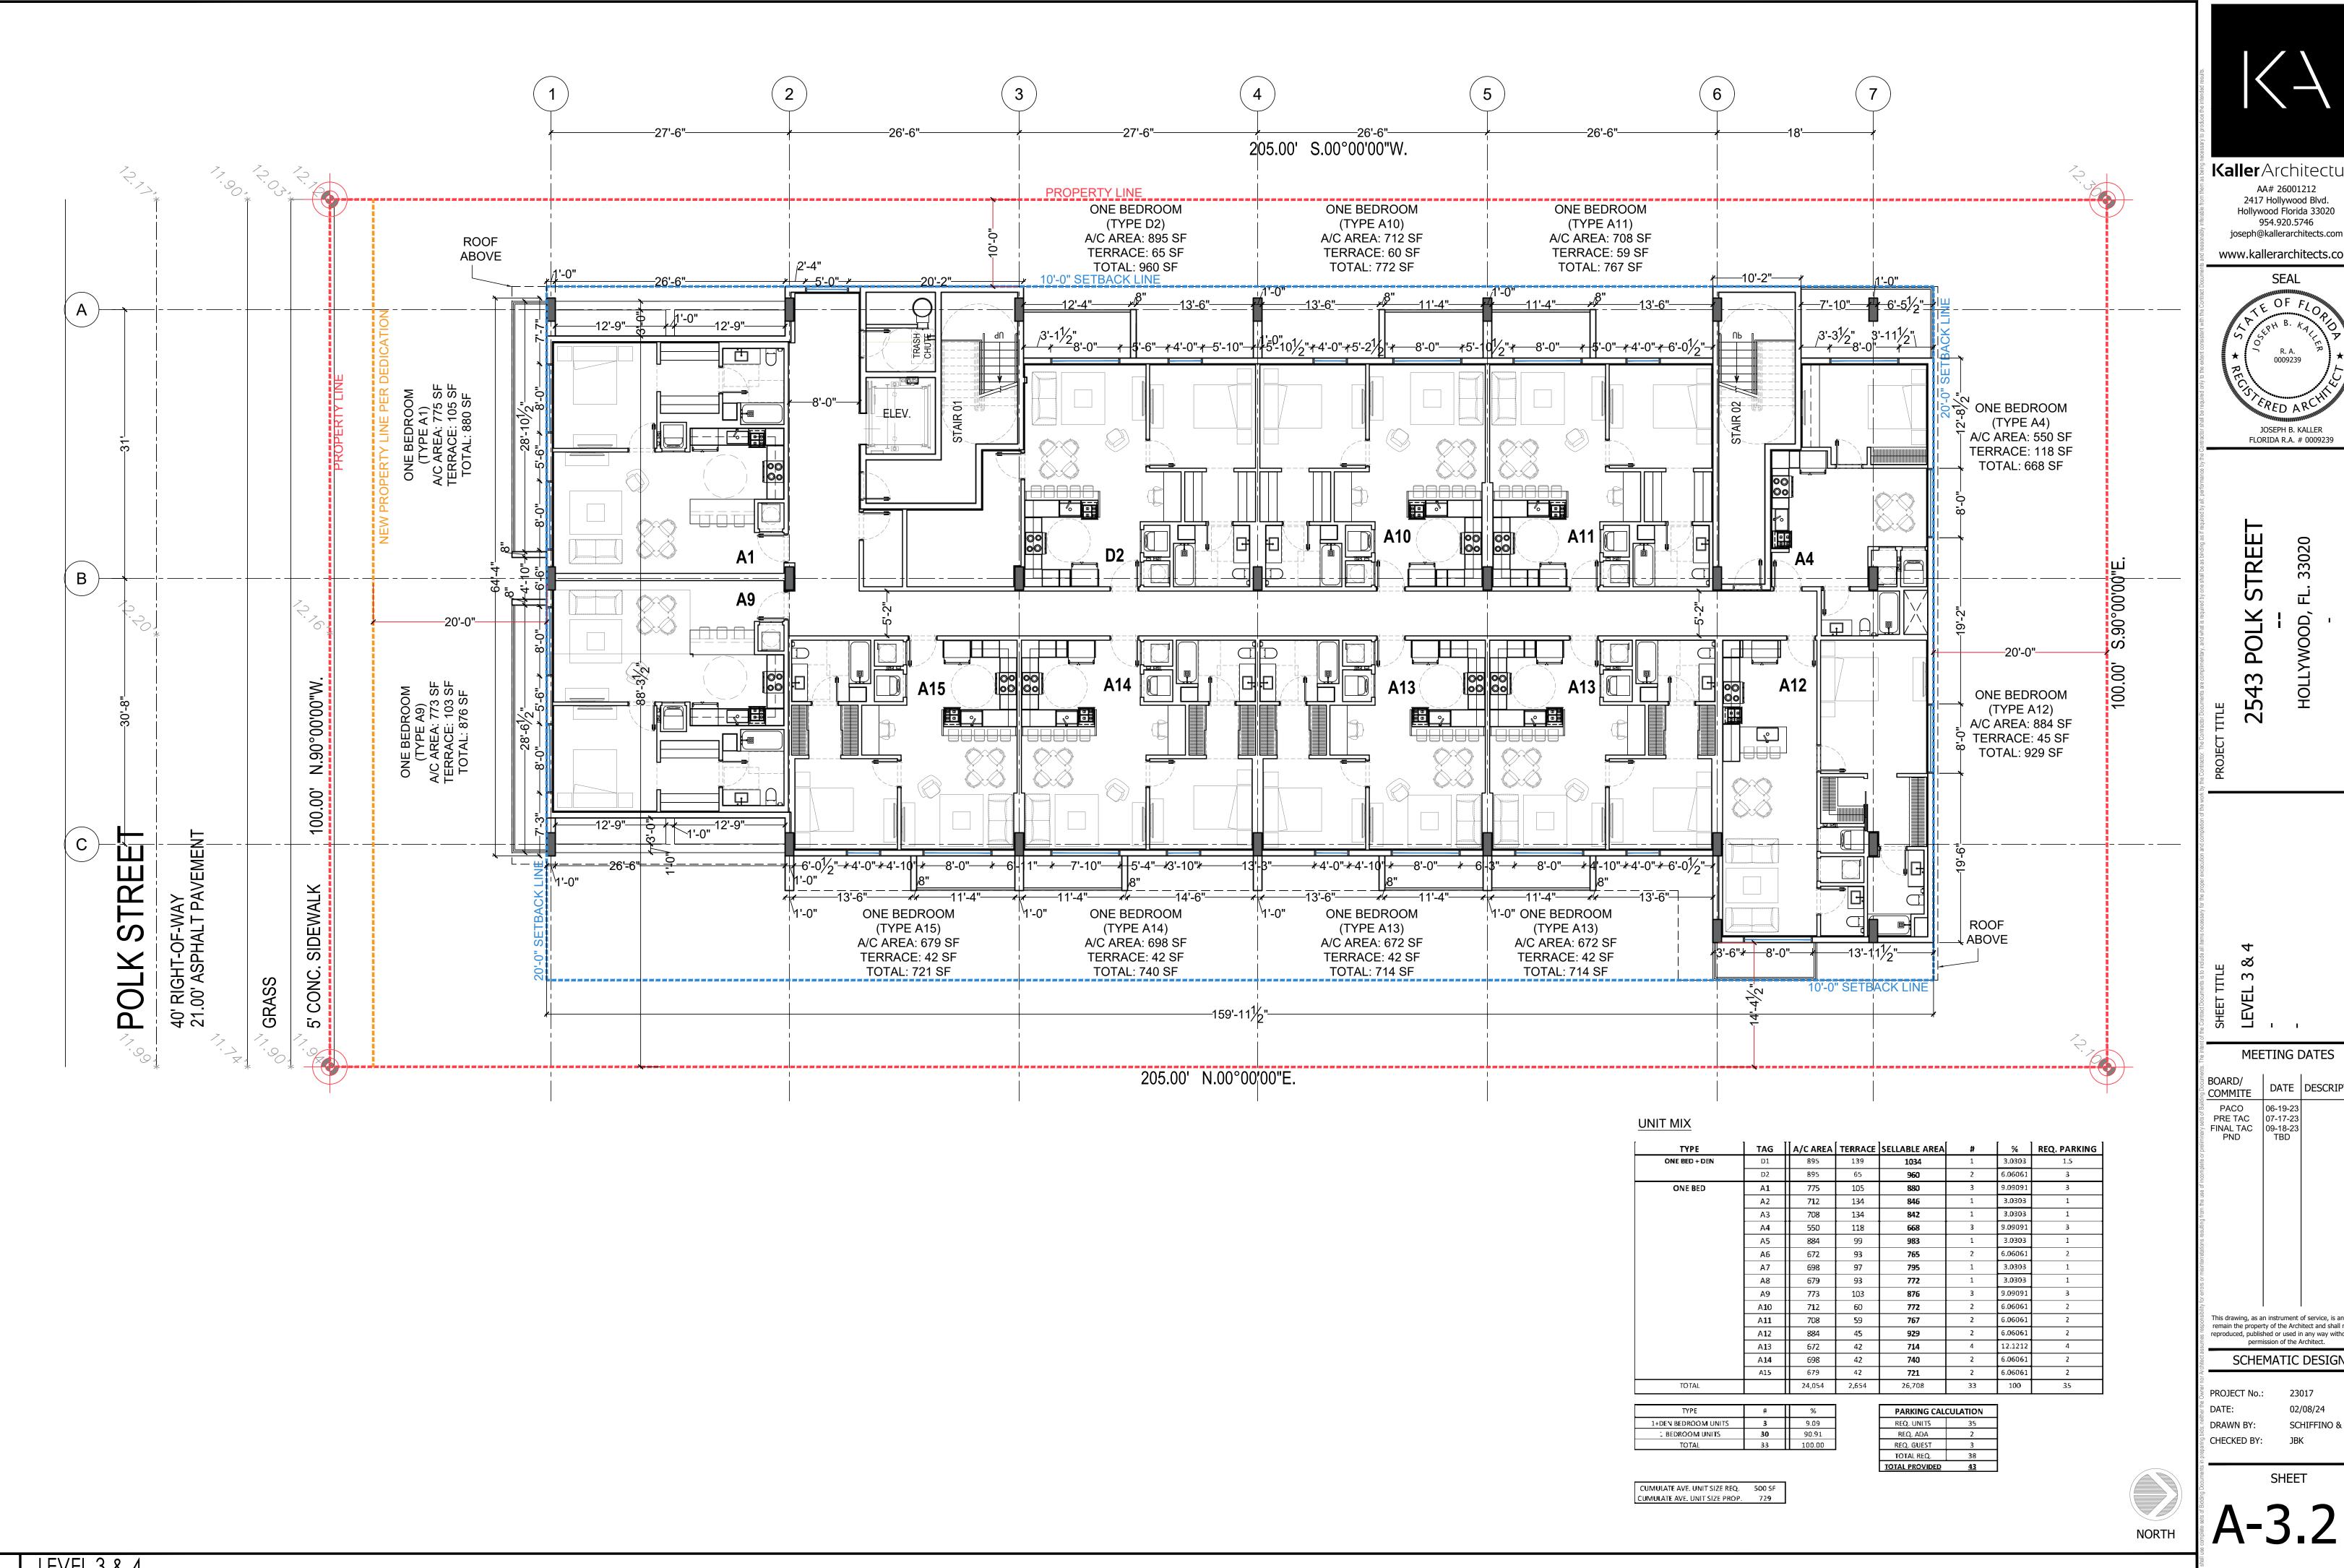

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JOSEPH B. KALLER FLORIDA R.A. # 0009239

STREET **POLK**

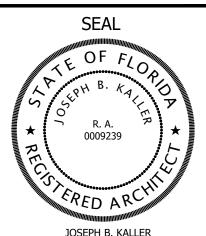7

MEETING DATES

DATE DESCRIPTION


PACO 06-19-23 07-17-23 09-18-23 PND TBD PACO

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SCHEMATIC DESIGN


PROJECT No.: 23017

SCHIFFINO & J.D. CHECKED BY: JBK

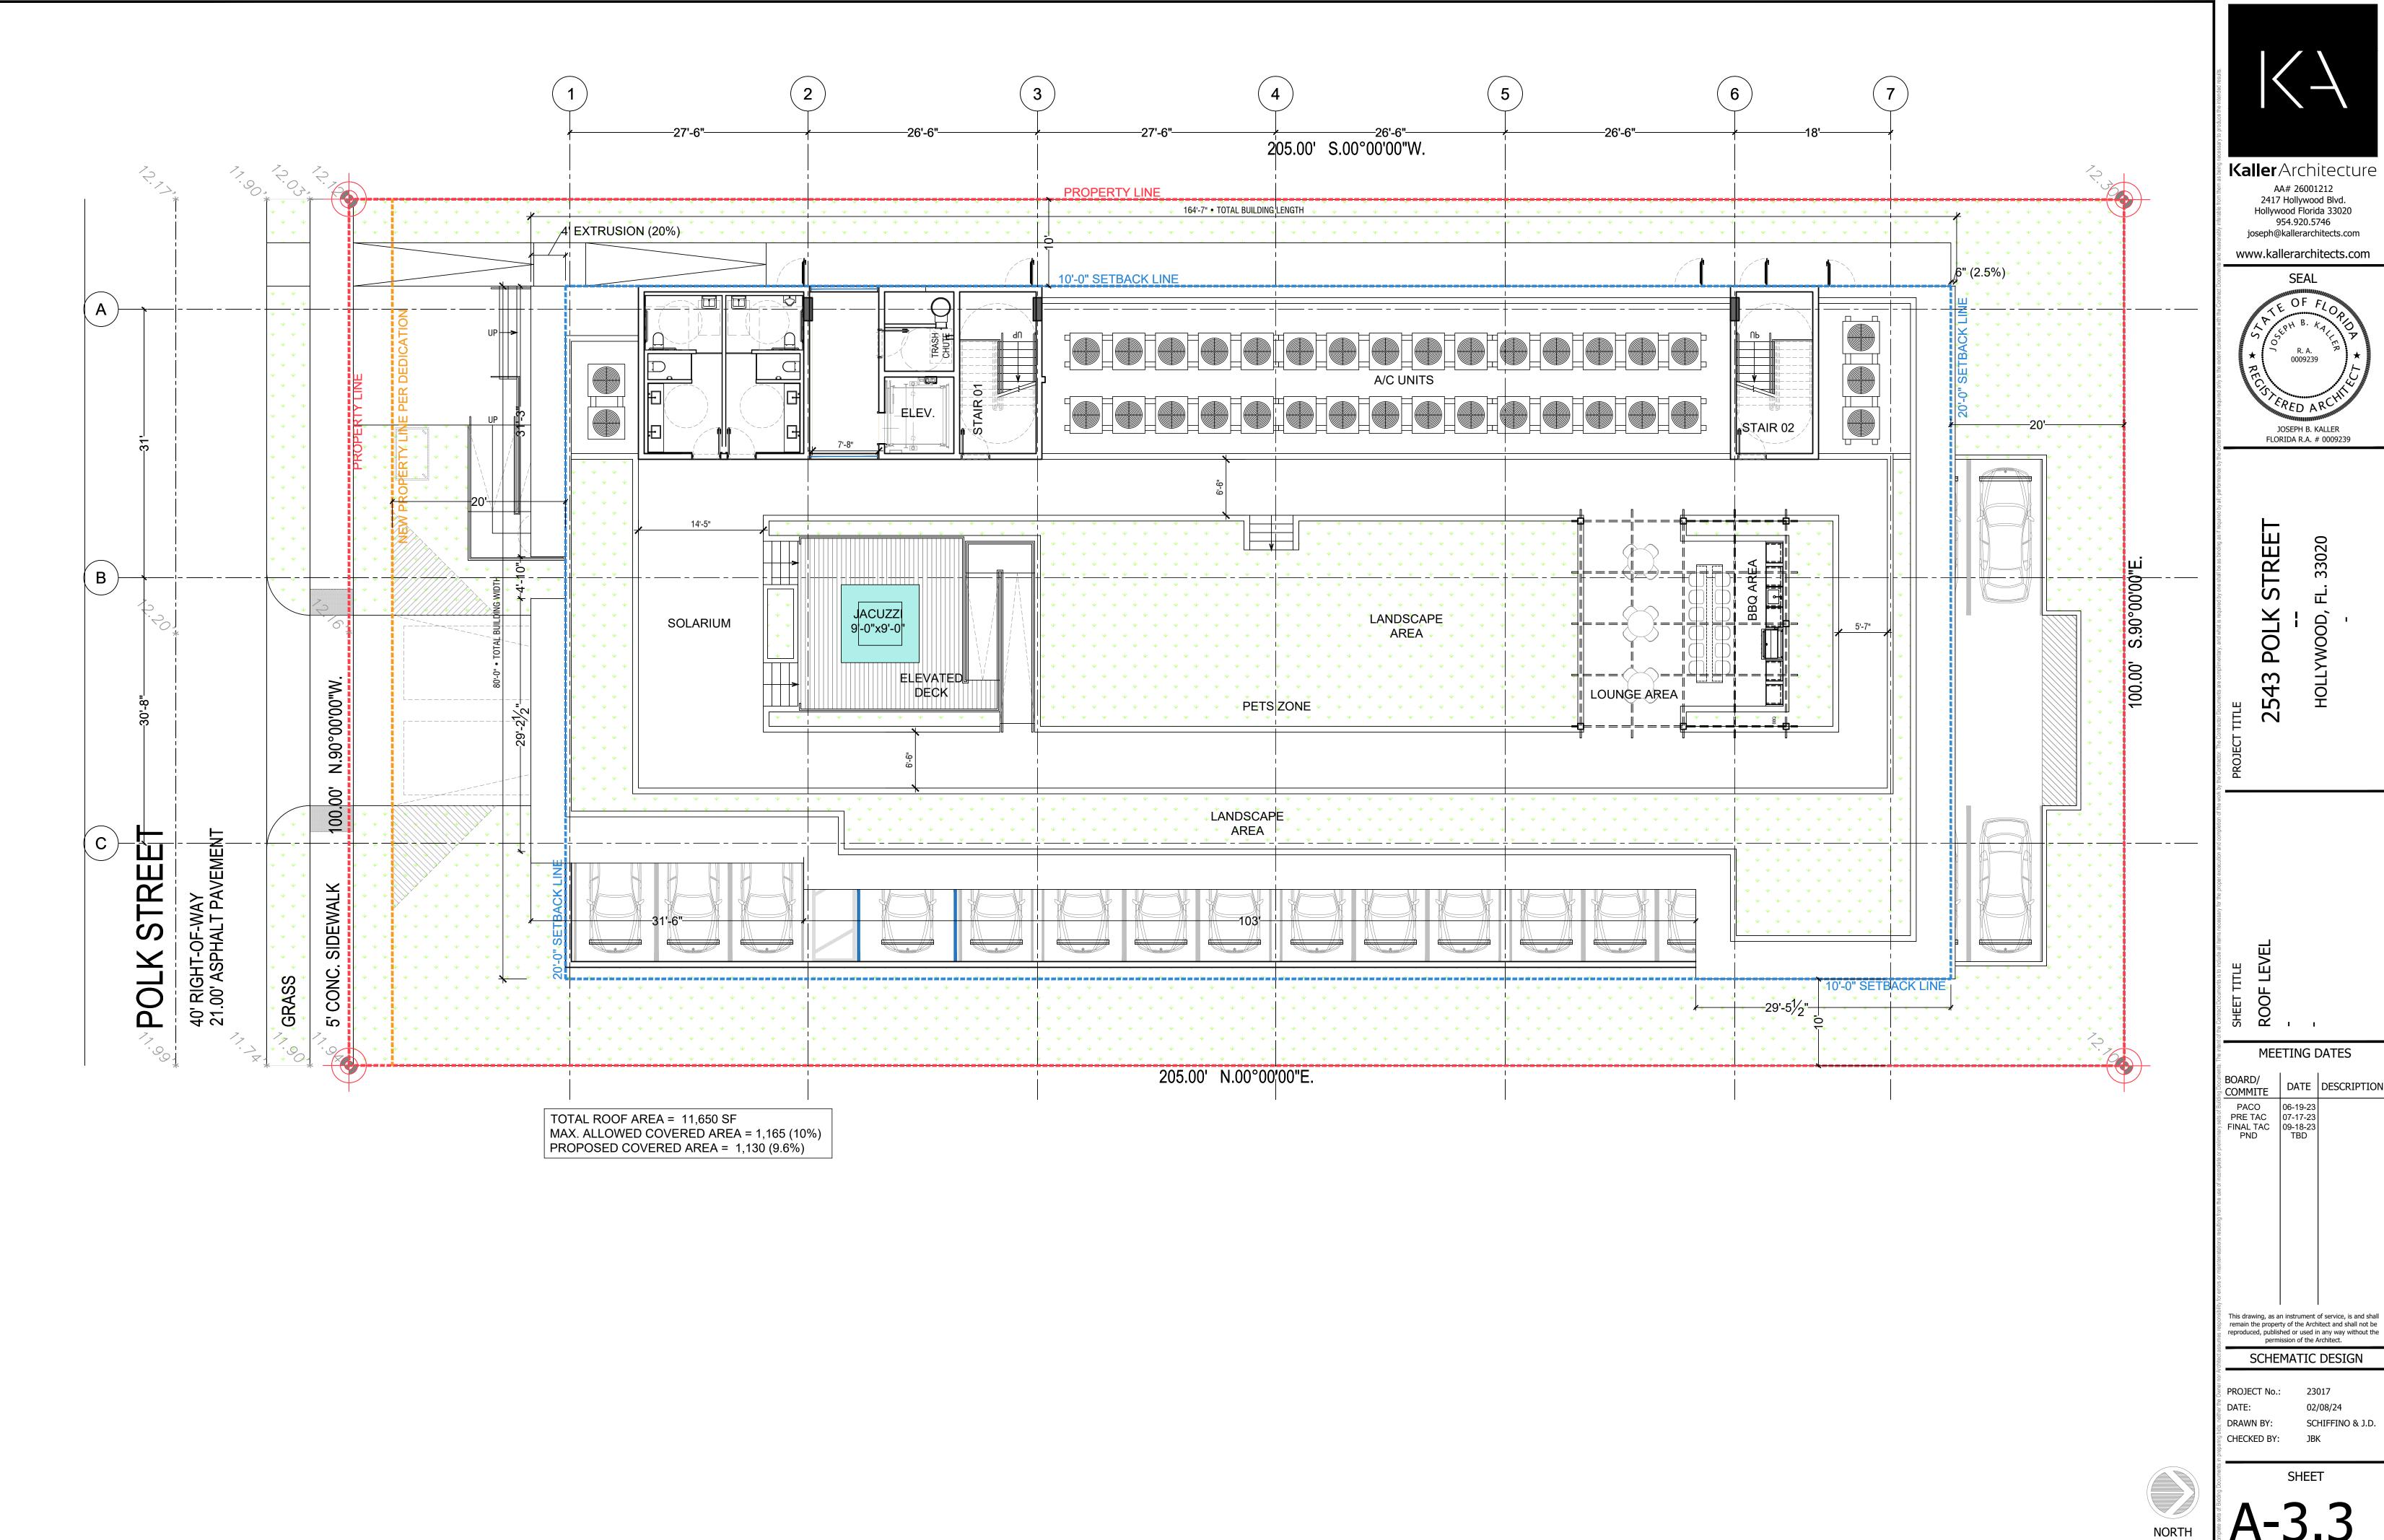

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02/08/24 SCHIFFINO & J.D.

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MEETING DATES
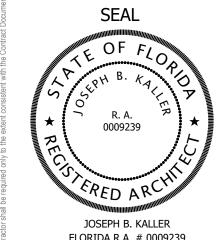
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COMMITE

PACO
PRE TAC
PINAL TAC
PND

BOARD/
DATE


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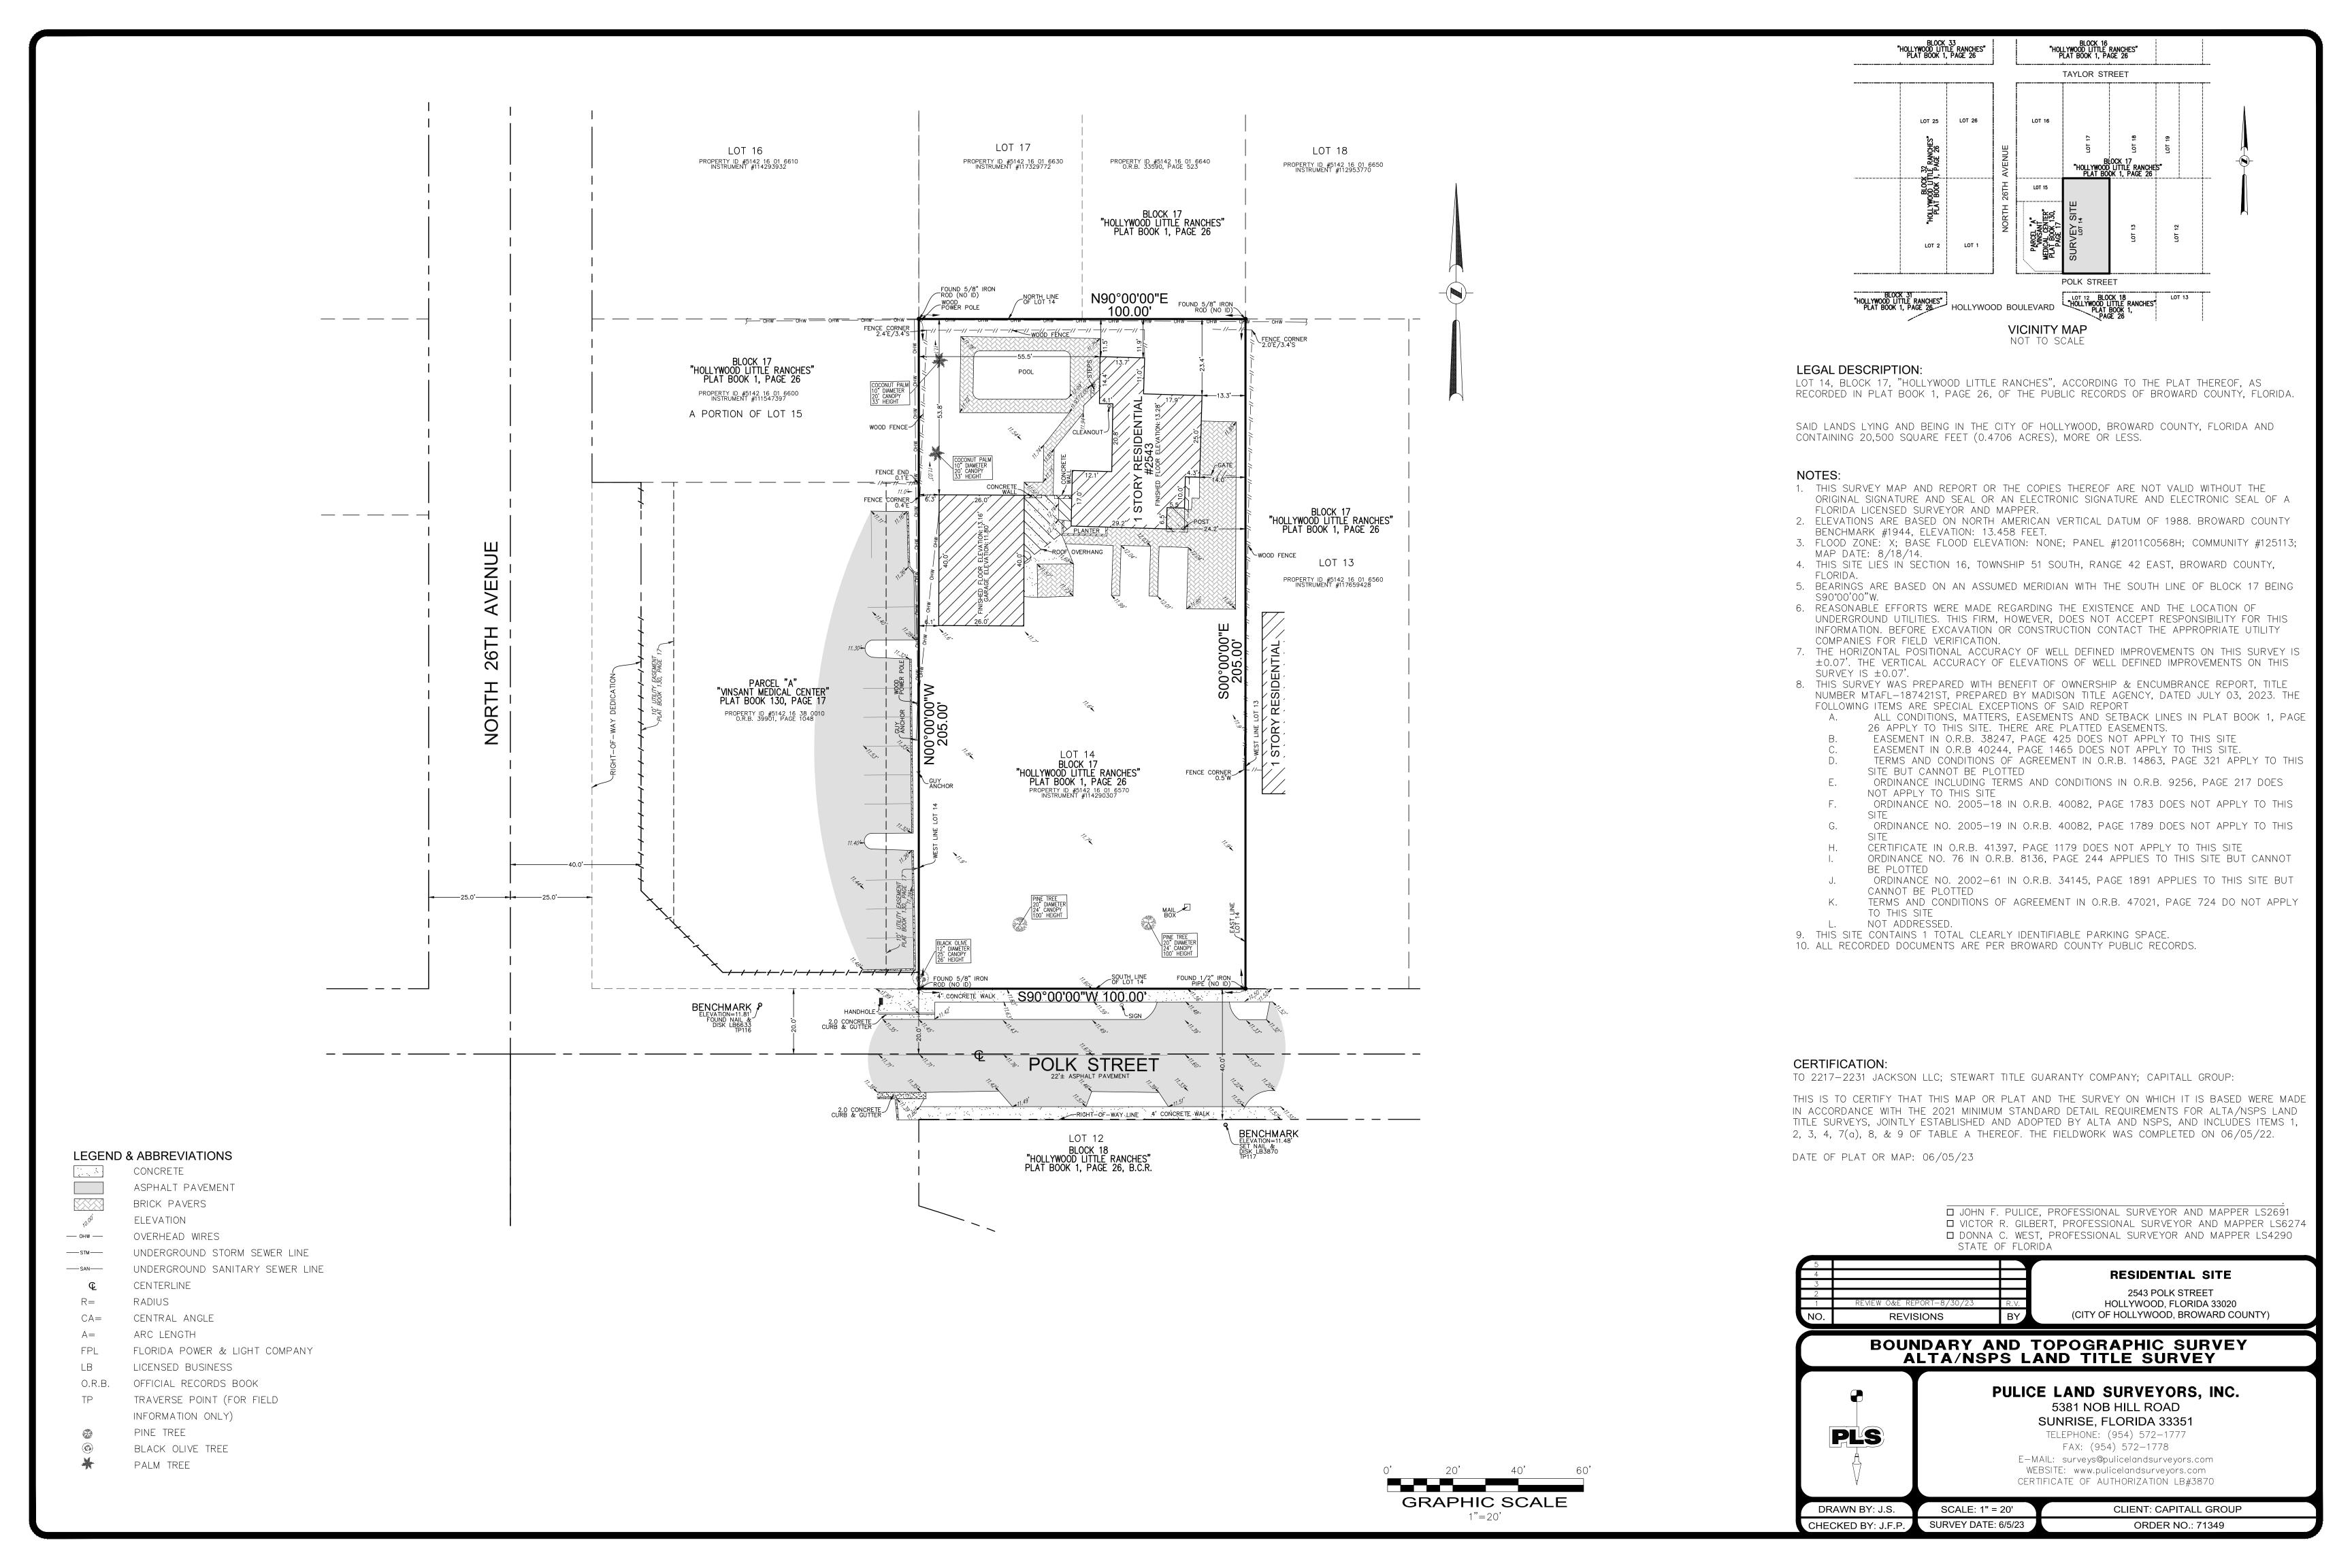
06-19-23
07-17-23
09-18-23
TBD


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SCHEMATIC DESIGN

PROJECT No.: 23017 02/08/24 SCHIFFINO & J.D.






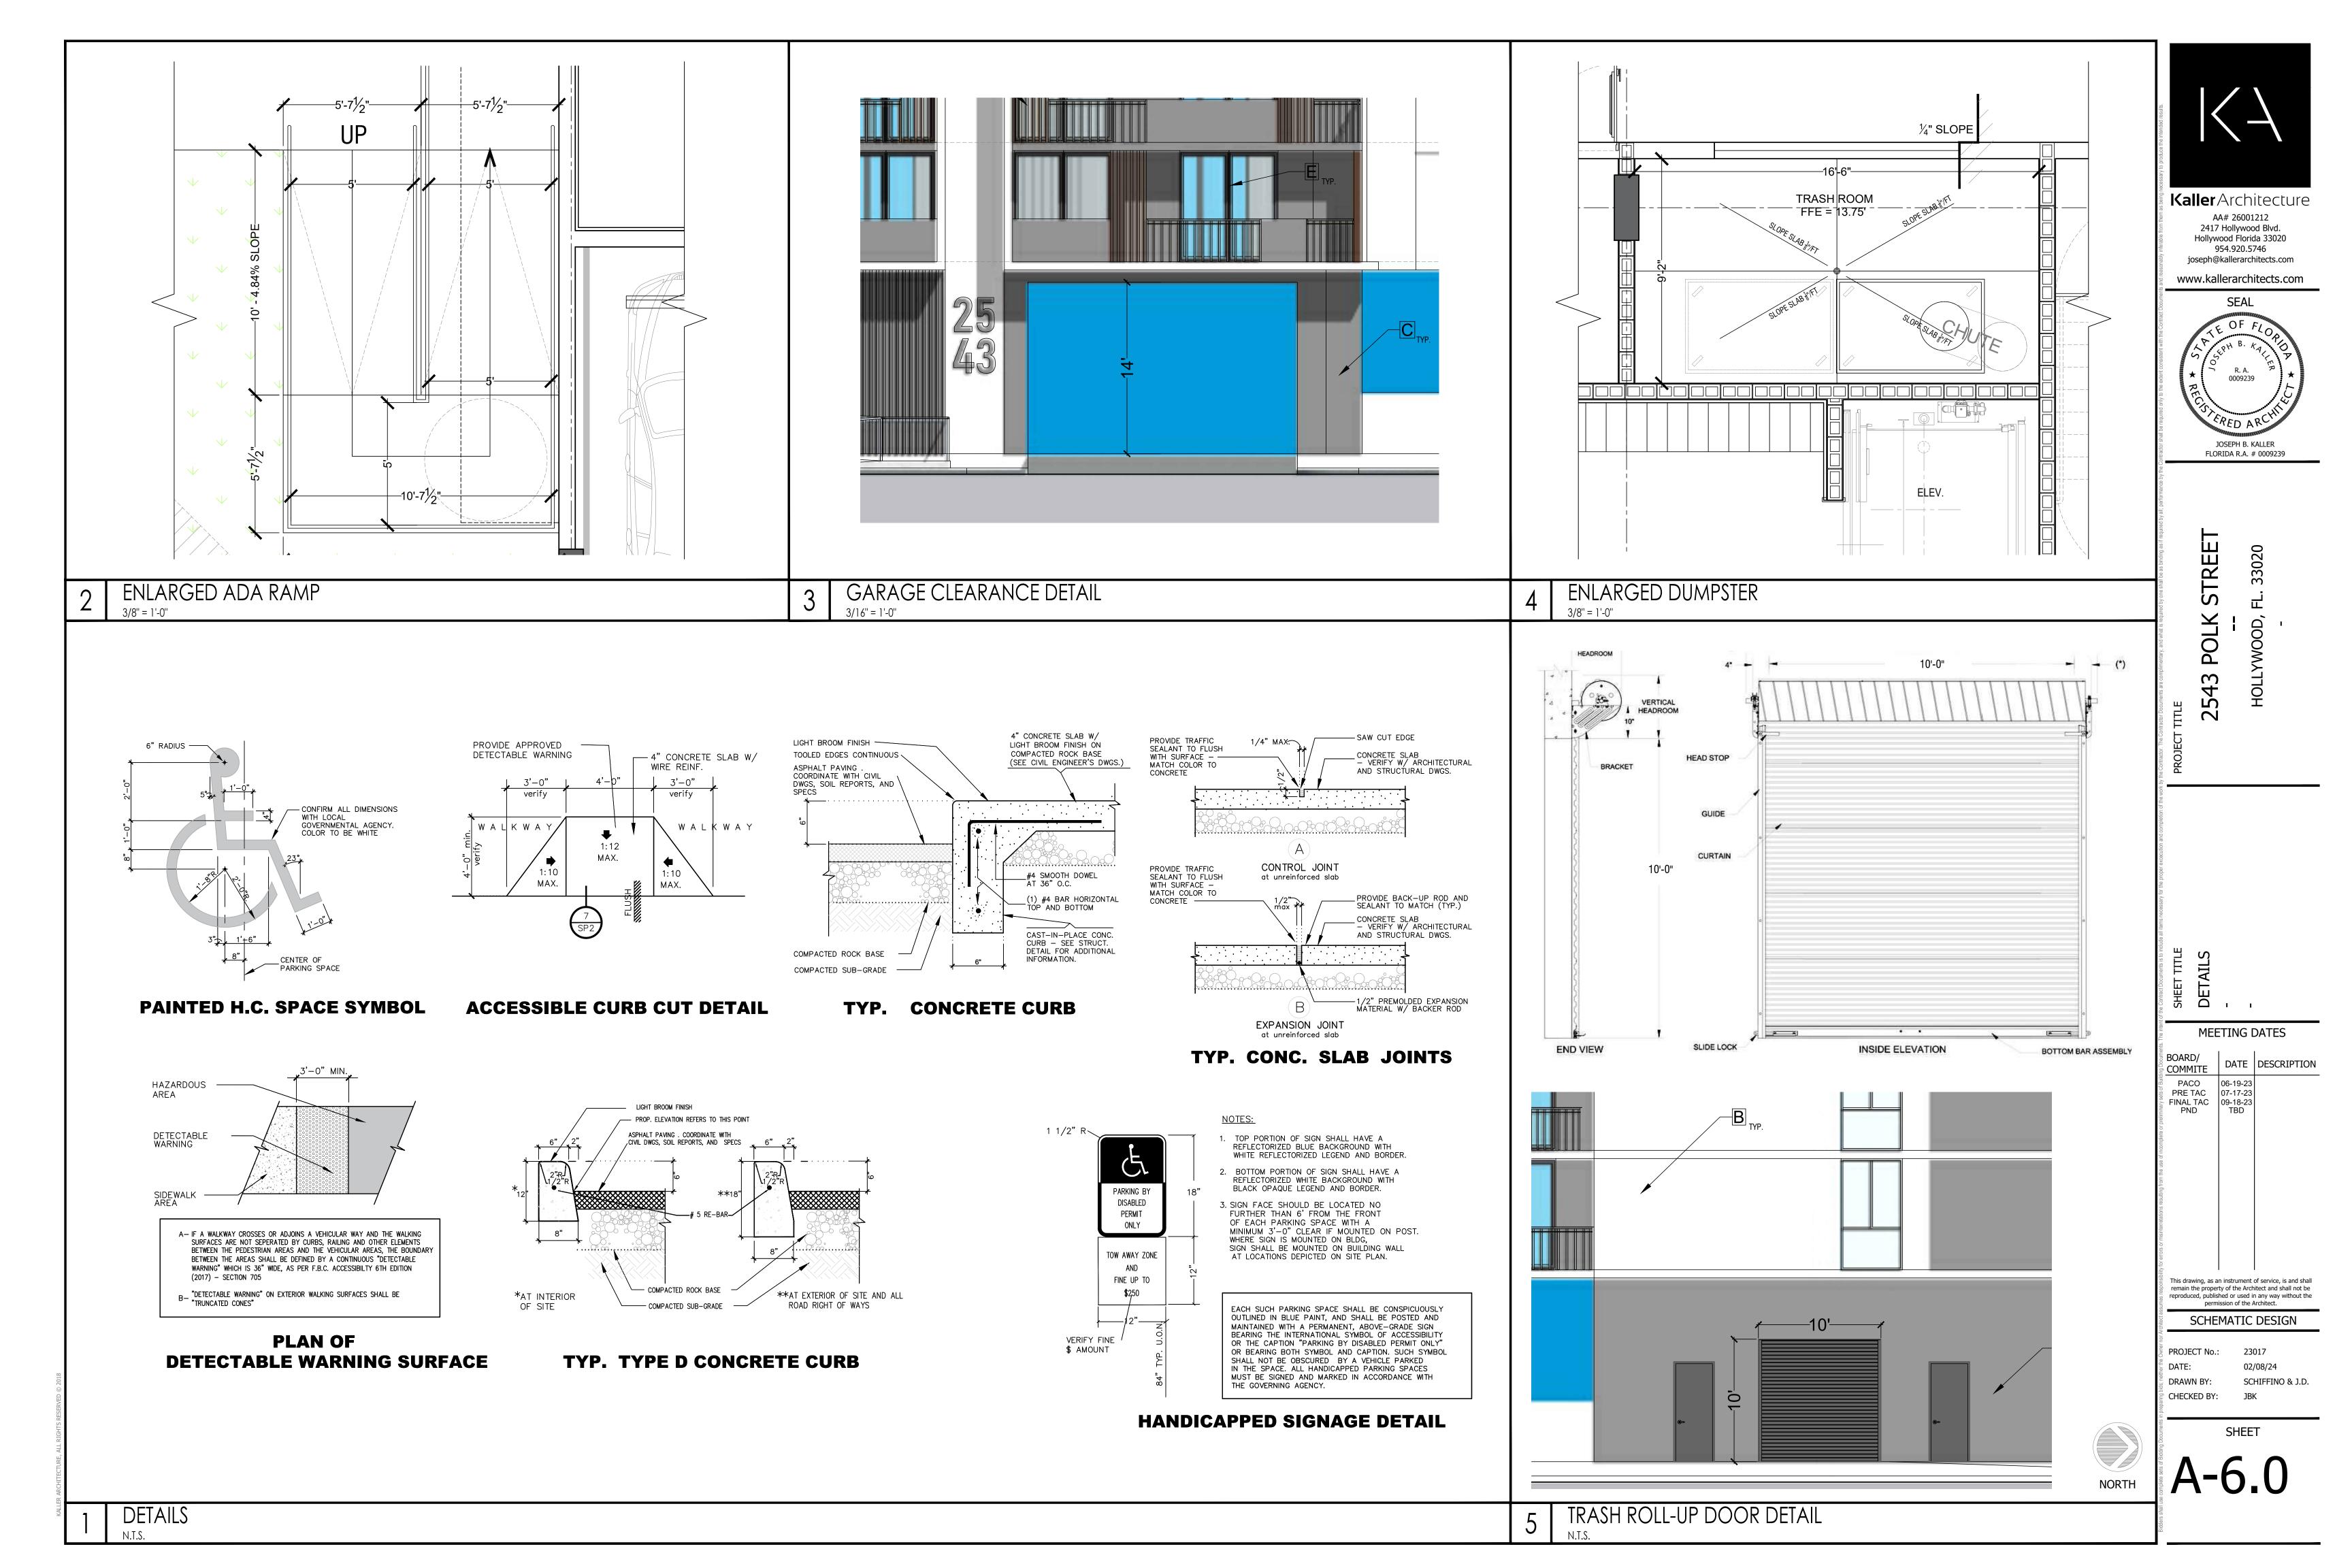

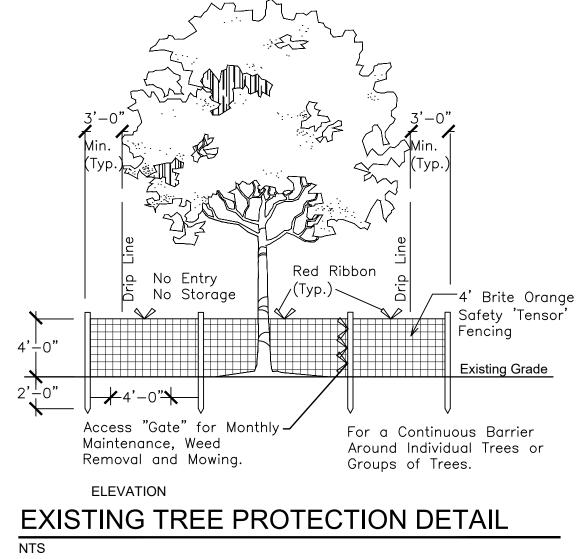Before Construction Begins, Contractor to Install and Maintain Tree Protection Fencing Around Existing Trees As Shown. See Existing Tree Protection Detail This Sheet

Case/Location:	2543 Polk Street, Hollywood, FL						
	8/19/2023						
Appraiser	Thomas White, ASLA-ISA. Arborist FL-5248A						
	Landscape Architect #FL1100						
	ISA Cert. Arborist #FL-5248A						
Existing Tr	ee List						
Section 4.5	City of Hollywood Landscape Manuel; No peri	mit requir	ed to rem	oved the N	lorfolk Island P	ines.	
Tree	Species	Ht.	Spr.	DBH	Condition	DBH	Disposition
#	Botanical Name / Common Name	(Feet)	(Feet)	(Inches)		Removed	
						(Inches)	
1	Bucida buceras / Black Olive	25	25	12	Fair-Poor	0	Remain
2	Araucaria heterophylla / Norfolk Island Pine	75	15	20	Poor	20	Remove
3	Araucaria heterophylla / Norfolk Island Pine	75	15	20	Poor	20	Remove
				DB	H Removed	40	
Existing Pa	alm List						
Palm	Species	Ht.	CT	DBH Condition		Replacement	Disposition
#	Botanical Name / Common Name	(Feet)	(Feet)	(Inches)		Palms	
4	Cocos nucifera / Coconut Palm	35	20	10	Good	1	Remove
5	Cocos nucifera / Coconut Palm	35	20	10	Good	1	Remove
		R	eplacem	ent Palm	s Required	2	1 2 20 19 2

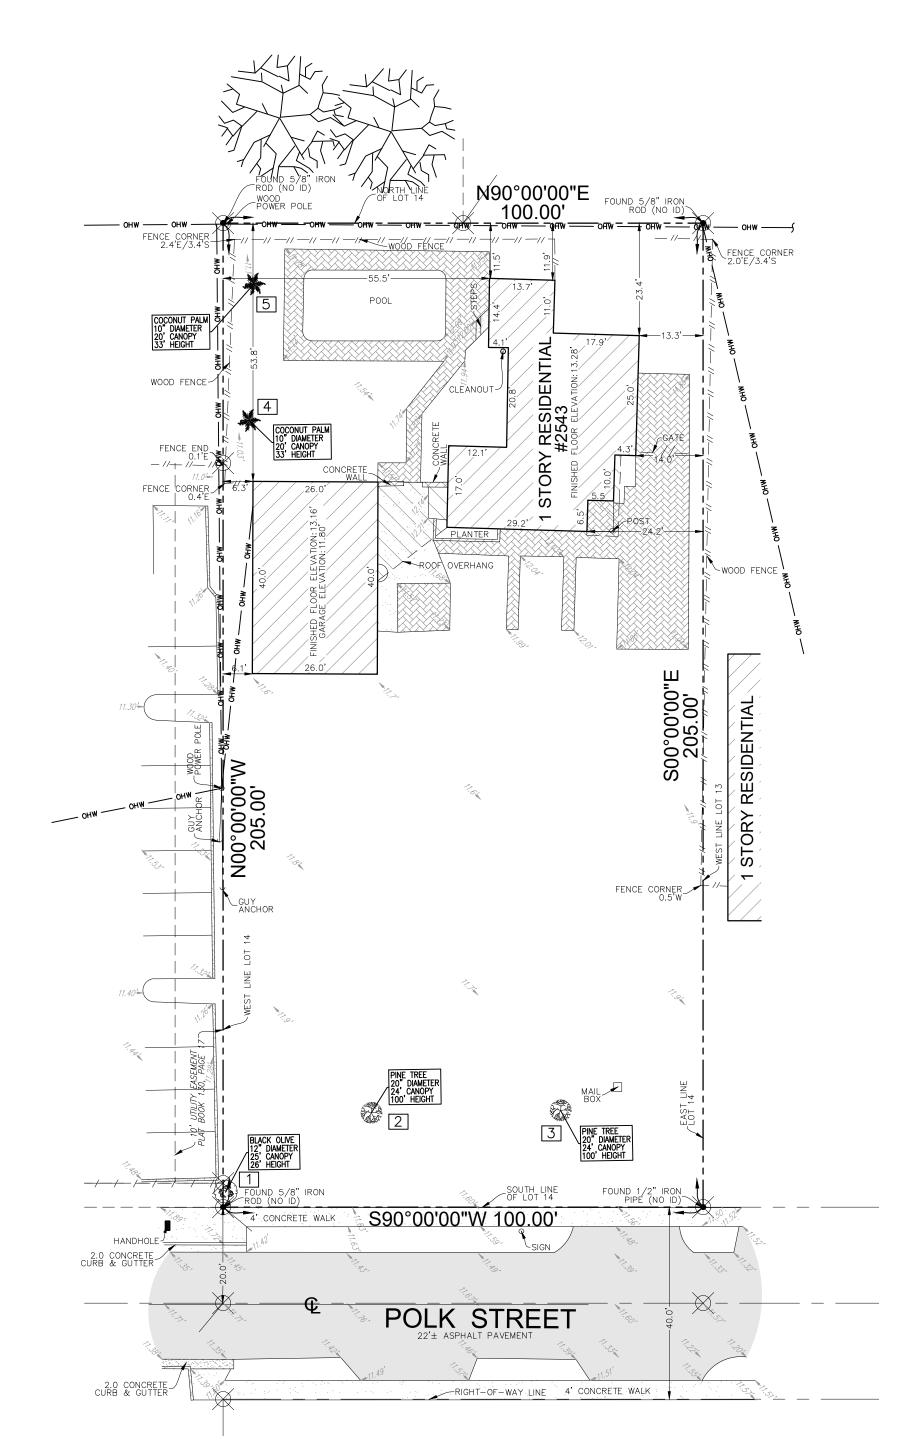



Call 811 or www.sunshine811.com two full business days before digging to have utilities located and marked.

Check positive response codes before you dig!





DRAWN: TW CHECKED: TW DATE: 8-25-2023

SCALE: 1"=20'

Pok

The plan takes precedence over the plant list.

2 Full business days before digging, call toll free 1-800-432-4770 Sunshine State One Call of Florida, Inc. Notification Center. Contractors are responsible for coordinating with the owners and appropriate public agencies to assist in locating and verifying all underground utilities prior to excavation. All existing utilities shown on the plans are to be considered approximate and should be verified by the contractor prior to the start of work operations..

General site and berm grading to +/- 1 inch (1") shall be provided by the general contractor. All finished site grading and final decorative berm shaping shall be provided by the landscape

All sizes shown for plant material on the plans are to be considered Minimum. All plant material must meet or exceed these minimum requirements for both height and spread. Any other requirements for specific shape or effect as noted on the plan(s) will also be required for final

All plant material furnished by the landscape contractor shall be Florida #1 or better as established by Grades and Standards for Florida Nursery Trees and Plants.

All trees designated as single trunk shall have a single, relatively straight, dominant leader, proper structural branching and even branch distribution. Trees with bark inclusion, tipped branches, and co—dominant trunks will not be accepted. Trees with girdling, circling and/or plunging roots will be

All planting beds shall be free of all rocks $\frac{1}{2}$ " or larger, sticks, and objectionable material including weeds, weed seeds. All limerock shall be removed/cleaned down to the native soils. Planting soil 50/50 sand/topsoil mix shall be delivered to the site in a clean loose and friable condition and is required around the root ball of all trees and palms, the top 6" of all shrubs and ground cover beds. This soil can be tilled into the existing soil after the existing soil has been cleaned of all rocks, limestone and sticks. Recycled compost is encouraged as a soil amendment alternative. Sod 1.5-2" topsoil comes furnished.

All burlap, string, cords, wire baskets, plastic or metal containers shall be removed from the rootballs before planting. Remove all bamboo and metal nursery stakes. Remove all tagging tape.

All trees/palms shall be planted so the top of the root ball, root flair are slightly above final grade. Shrub material shall be planted such that the top of the plant ball is flush with the surrounding grade. It is the sole responsibility of the landscape contractor to insure that all new plantings receive adequate water during the installation and during all plant warranty periods. Deep watering of all new trees and palms and any supplemental watering that may be required to augment natural rainfall and site irrigation is mandatory to insure proper plant development and shall be provided as

All trees/palms shall be staked using biodegradable material. No wire, black strapping, or other synthetic material shall be used. Nailing into trees and palms for any reason is prohibited and the material will be rejected. Please refer to the planting details

All landscape areas shall be irrigated by a fully automatic sprinkler system with a minimum 100% coverage with all heads adjusted to 50% overlap. Each system shall be installed with an operational rain sensor and rust inhibitor.


No fertilizers are required.

All landscape areas shall be covered with Pine Straw, Pine Bark, Eucalyptus or sterilized seed free Melaleuca mulch to a minimum depth of two inches (2") of cover when settled. Spread mulch to 1" thickness 3" away from the trunks/stems of all plant material. All trees in sodded areas shall have a clean cut 4' diameter mulch ring. The 5-6" height water ring shall be made from mulch, not soil. Certain areas may receive a thicker mulch cover where noted on plans. Cypress, red, gold and green mulch is prohibited.


Please refer to the planting details for a graphic representation of the above notes.

All plant material as included herein shall be warranted by the landscape contractor for a minimum period of 12 months after final inspection approval.


Trees and Palms shall not be removed without first obtaining an approved Tree Removal Permit from the City of Hollywood.

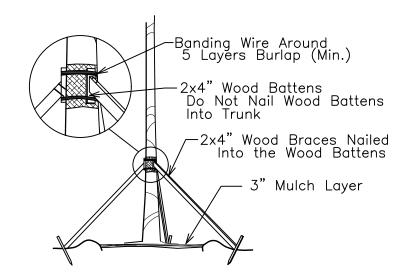


TREE/PALM BRACING DETAIL

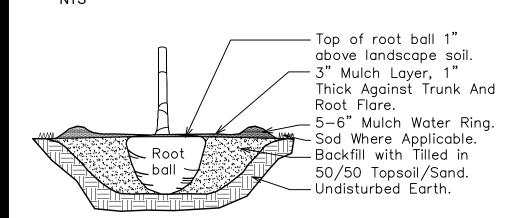

TREE/PALM PLANTING DETAIL

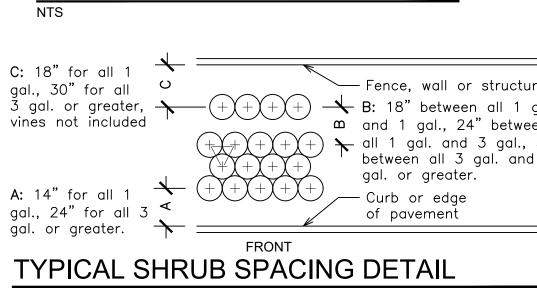


4.6 RAC							
4.d.(3)1	Street Trees:	One f	Per 30 LF of Street Frontage	Required		Provided	
	100	LF	Feet of Polk Street	4		4	
4.d.(3)2	5' Landscape	Buff	er Required and Provided. One Tree per 20 LF				
	510	LF	Perimeter of North, East, West Boundaries	26		26	
4.d.(3)5	5' Landscape	Buffe	er Required and Provided. 42" Landscape Element				
	510	LF	Perimeter of North, East, West Boundaries	42" Hedge		42" Hedge	CRS 42'
4.d.(3)9	One Tree per	ever	y 1,000 square feet of Pervious Area				
	7,219		Square Feet of Pervious (Net Lot) Area.	8		8	
4.d.(3)12	20% Landsca	pe O	pen Space	4,103	20%	7,219	26%
			Total Trees:	38		38	

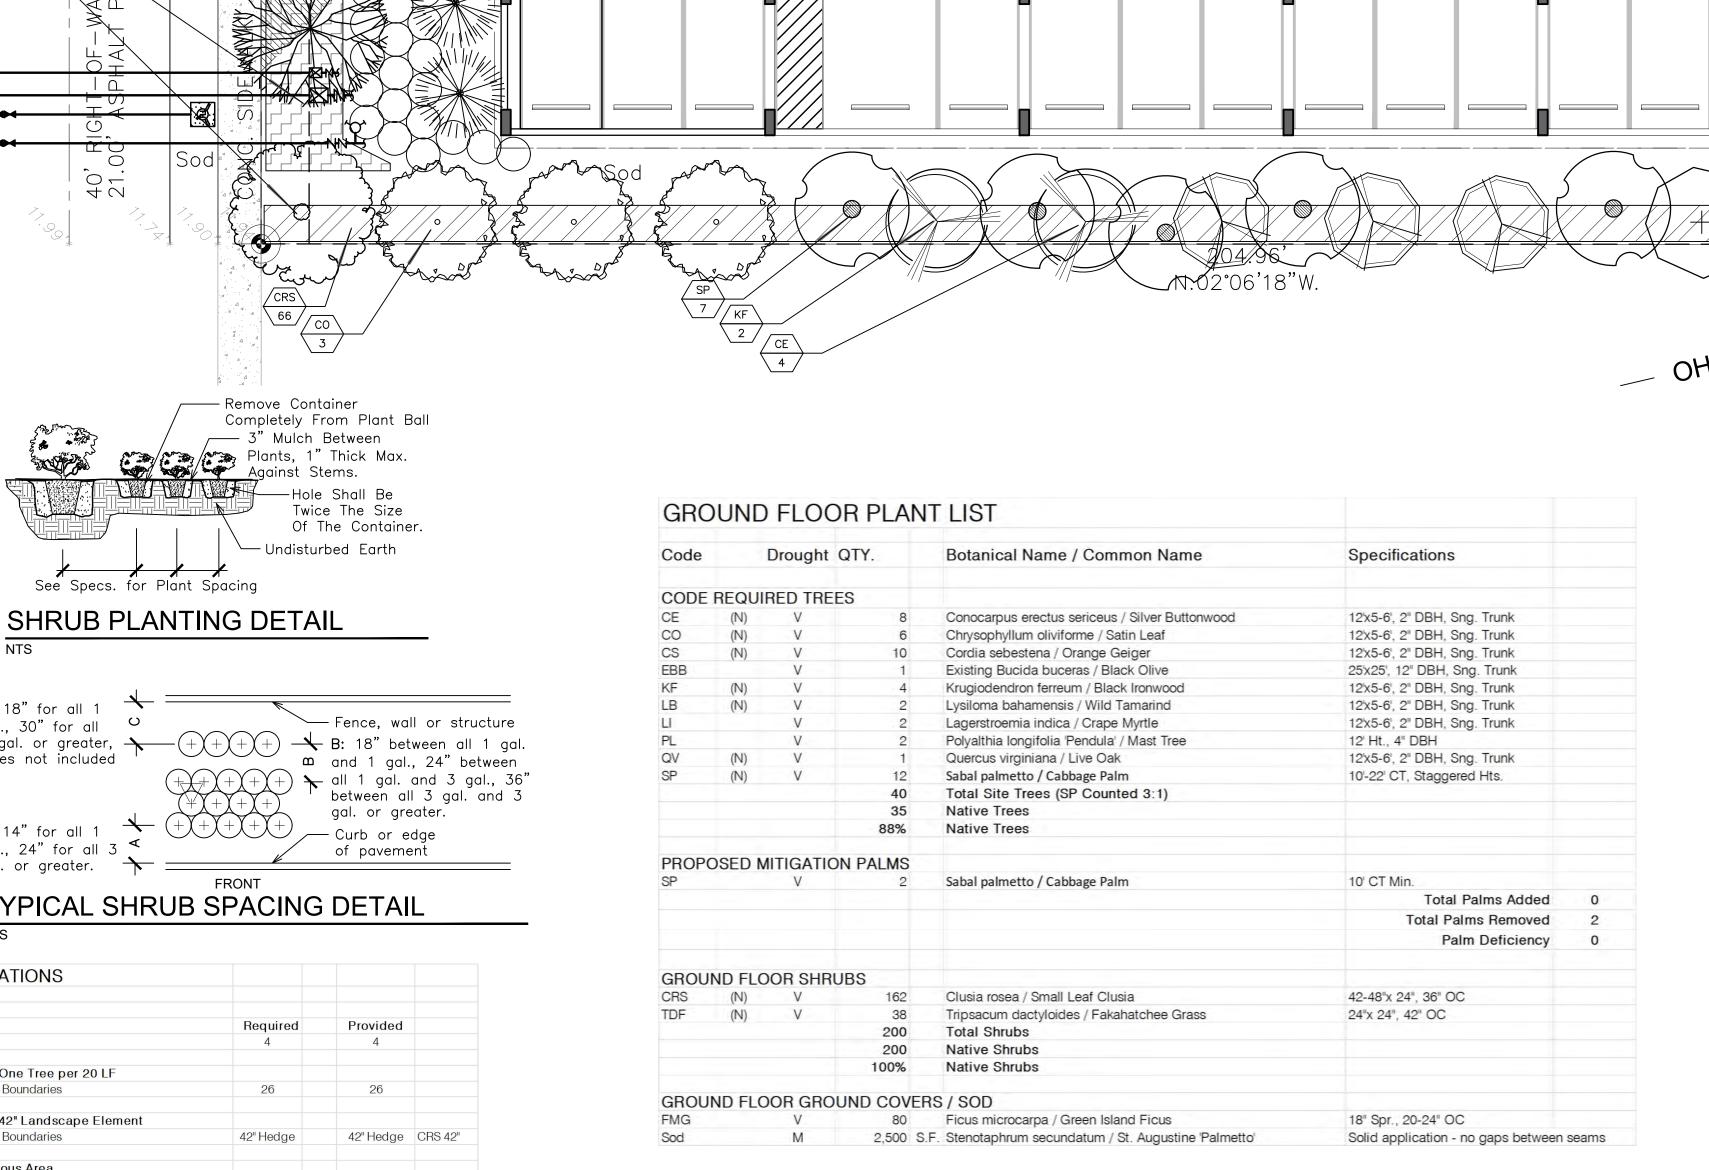

10'-0" SETBACK LINE

FIRE COM.

ROOM

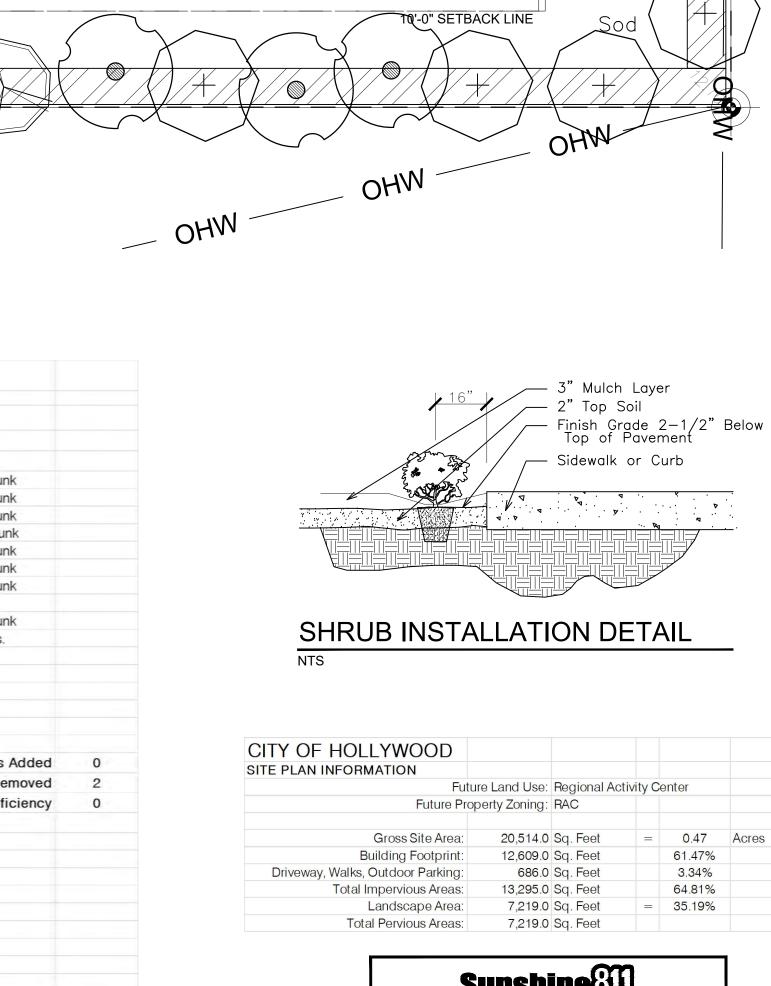



Check positive response codes before you dig!

CHECKED: DATE:

8-25-2023

SCALE: 1"=10'

REVISIONS



The plan takes precedence over the plant list.

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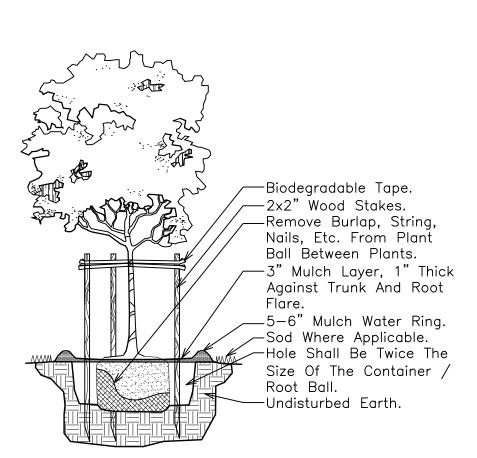
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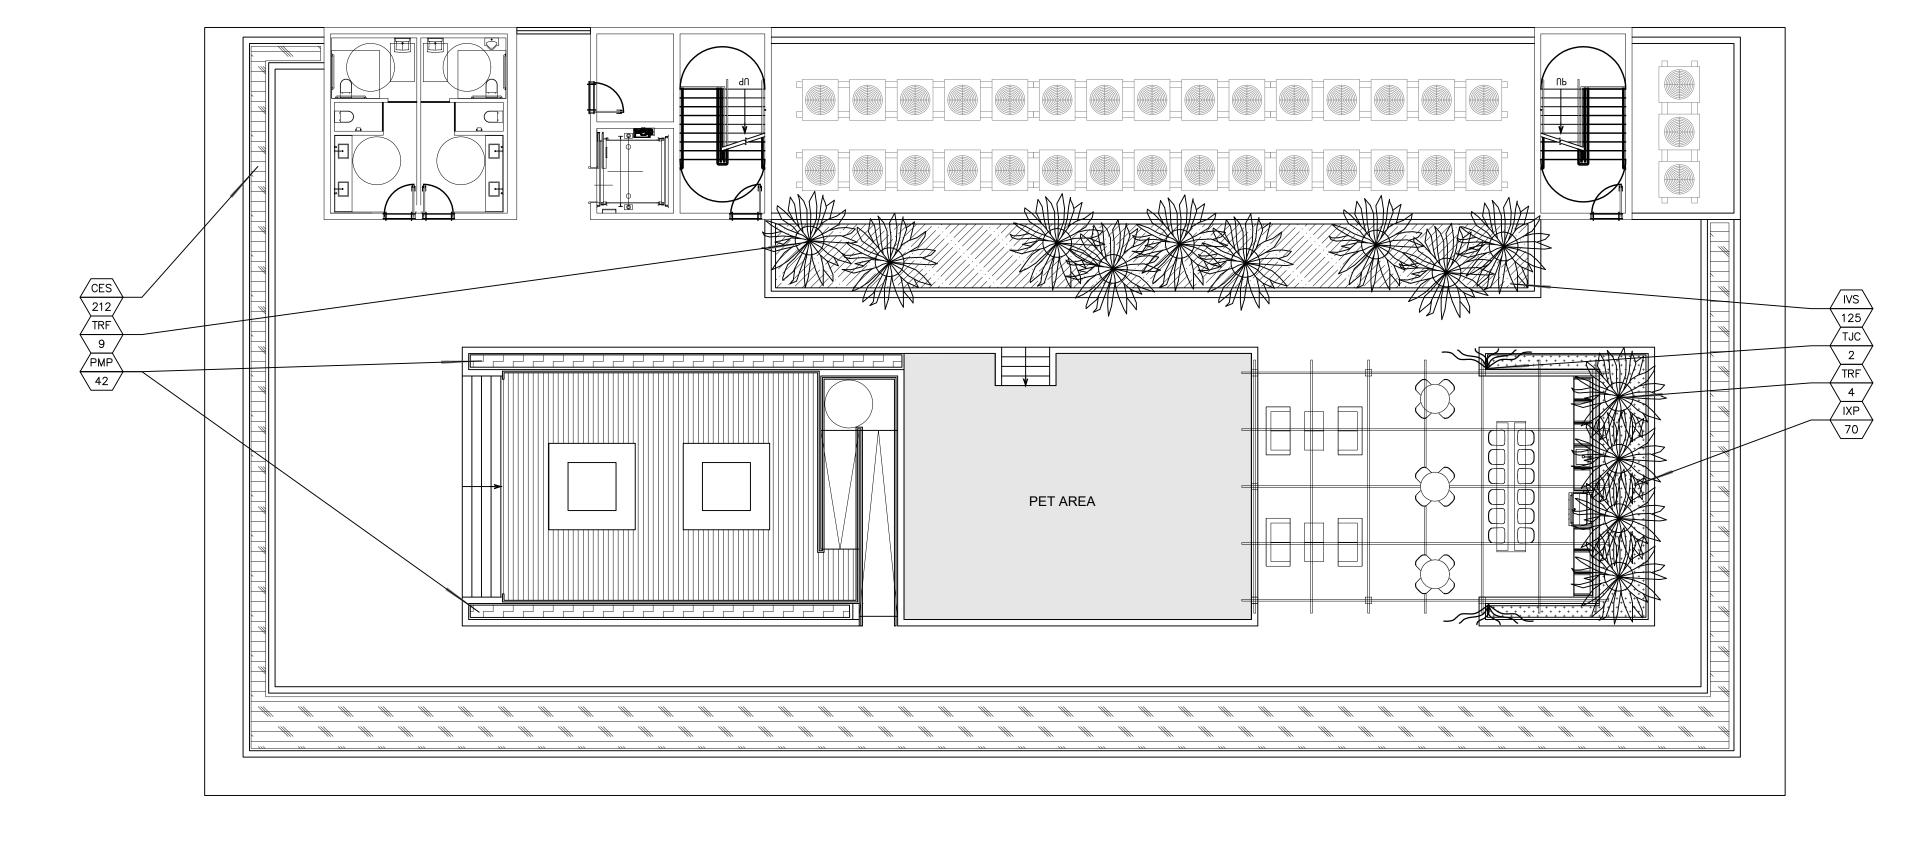
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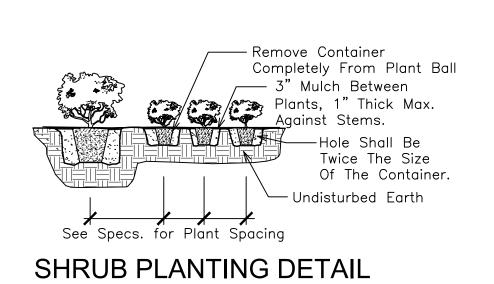
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SMALL TREE PLANTING DETAIL

NTS






C: 18" for all 1 gal., 30" for all 3 gal. or greater, vines not included	Fence, wall or structure B: 18" between all 1 gal. m and 1 gal., 24" between
A: 14" for all 1 gal., 24" for all 3 gal. or greater.	all 1 gal. and 3 gal., 36" between all 3 gal. and 3 gal. or greater. Curb or edge of pavement FRONT


TYPICAL SHRUB SPACING DETAIL



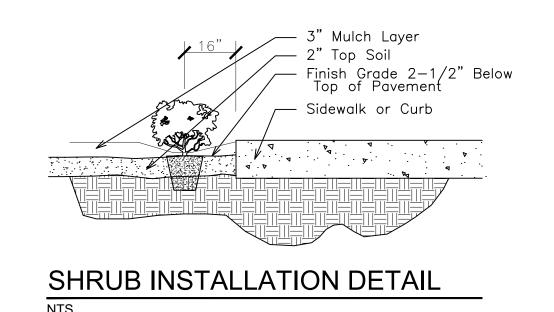





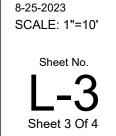

CHECKED:


DATE:



Violotto

Street Apartments

L3 Polk Street
2543 Polk St

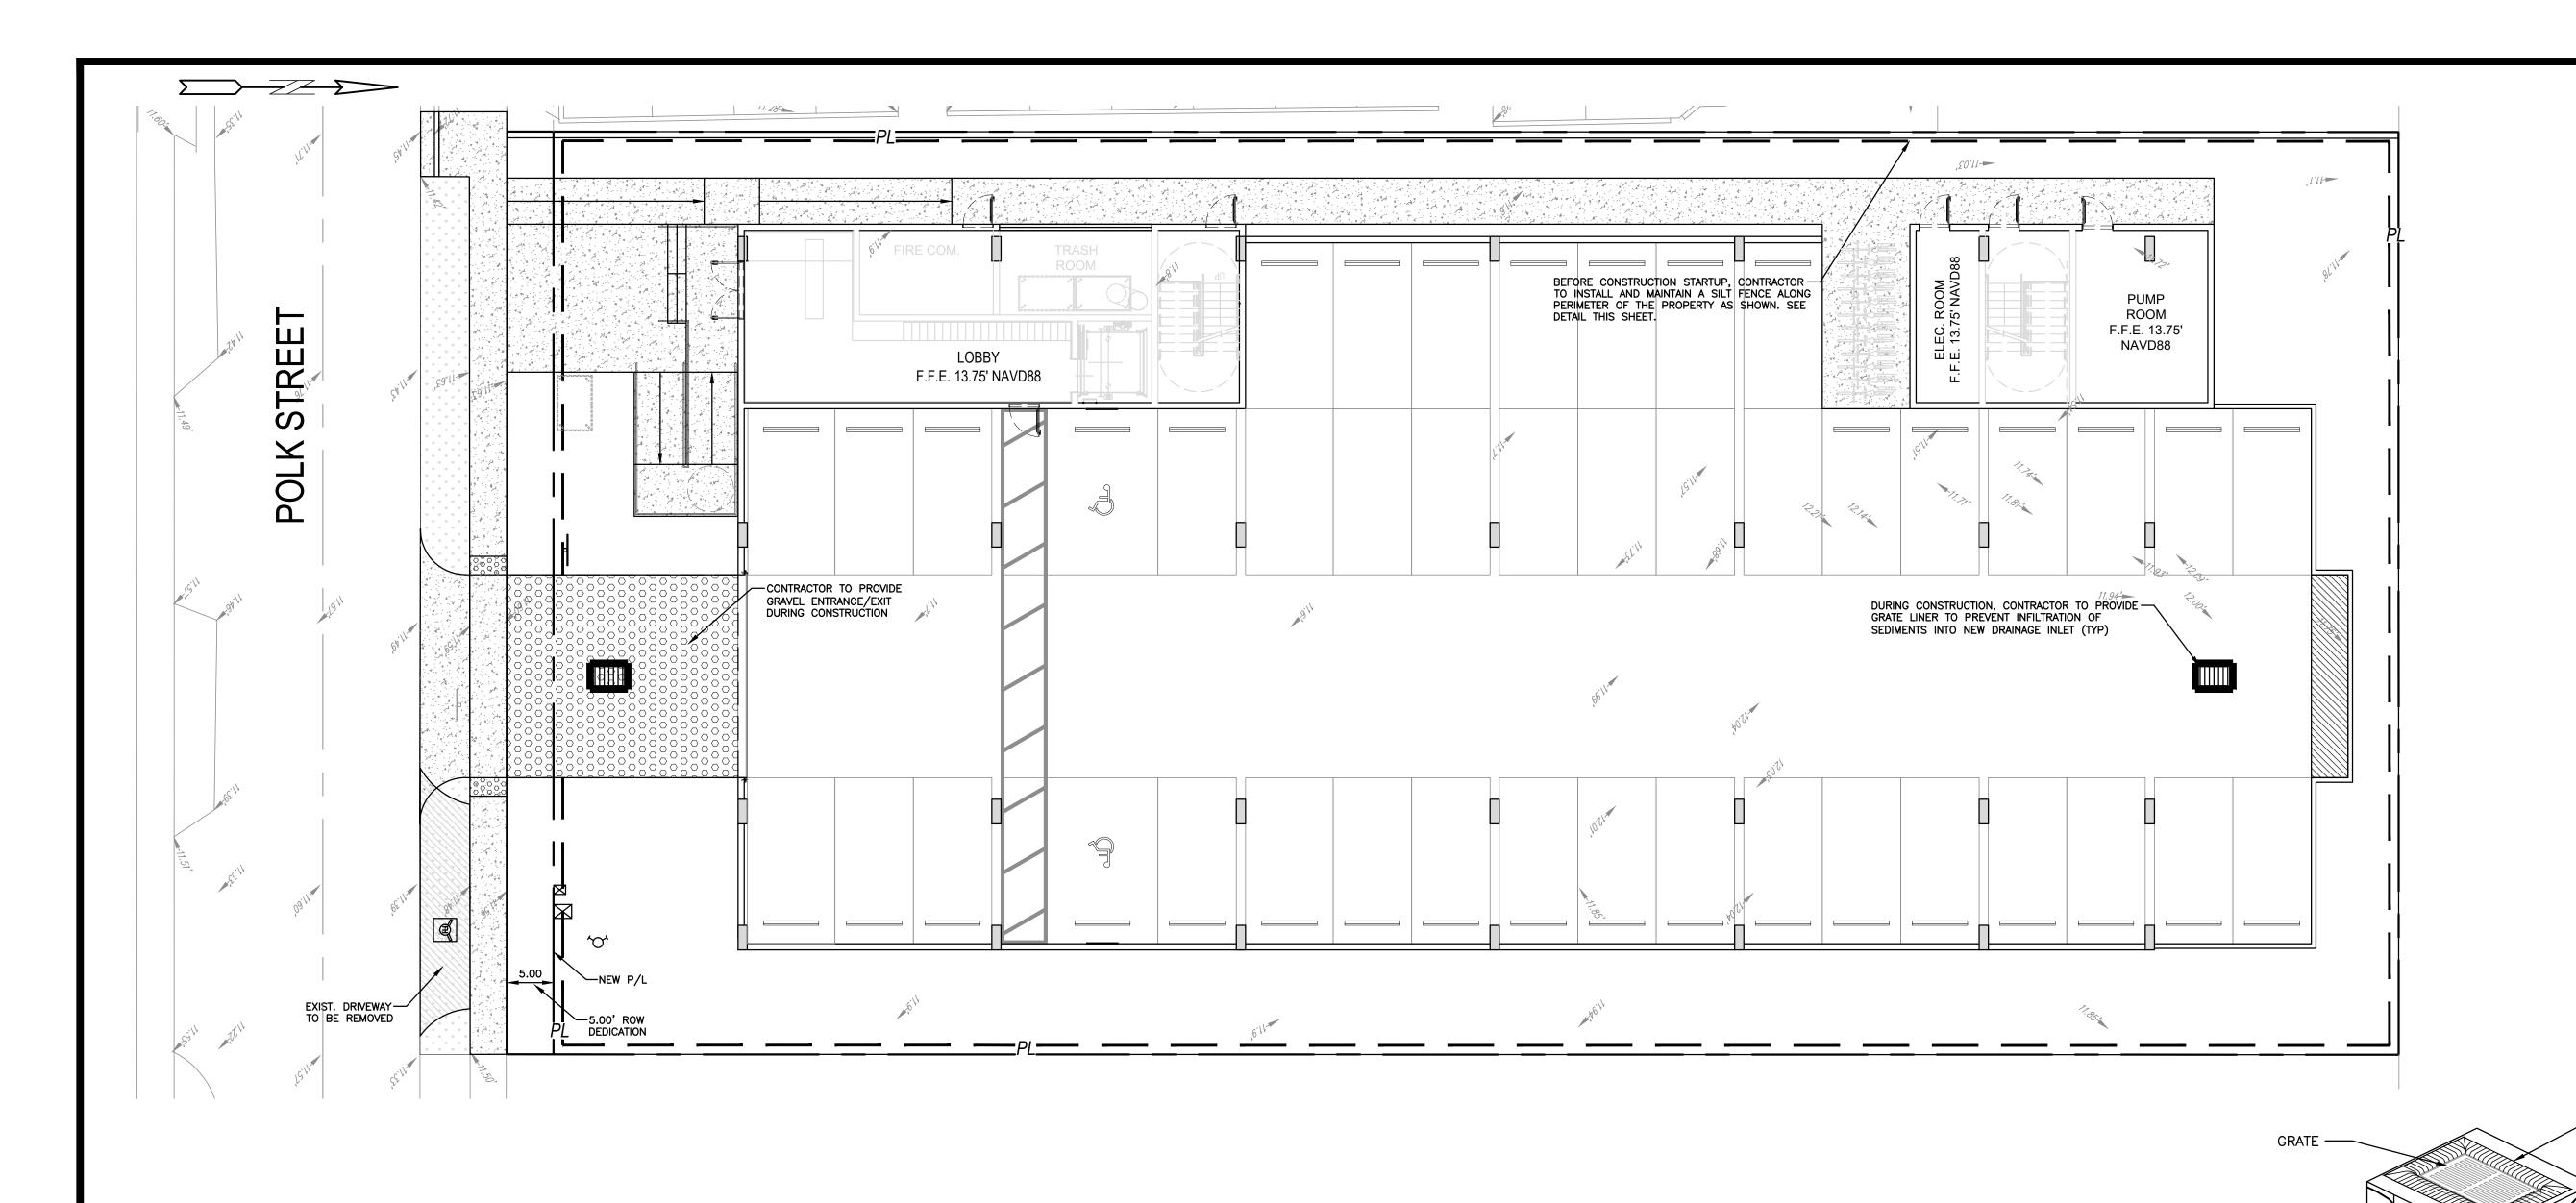

ALL ELEVATIONS ARE REFERENCE! TO NAVD88 VERTICAL DATUM

LEGEND

PROPOSED CONCRETE PROPOSED ASPHALT PROPOSED GRADE EXISTING ELEVATION

PROPOSED CATCH BASIN EXISTING CATCH BASIN PROPOSED WATER METER

EXISTING WATER METER

EXISTING WATER VALVE

- CONTRACTOR TO LIFT GRATE OFF AREA DRAINS AND INSTALL FILTER FABRIC ACROSS INLET OPENING. REPLACE GRATE TO HOLD FABRIC SECURELY IN PLACE

1. FILTER FABRIC TO MEET

FDOT INDEX NO. 199,

2. CONTRACTOR TO REMOVE FILTER FABRIC FROM CATCH BASIN JUST

AND/OR SEALCOATING.

POST

FILTER FABRIC (IN

GRADE

PRIOR TO PAVING

280 SPECIFICATIONS AND FDOT SECTION 985.

PROPOSED BFP DEVICE EXISTING SAN. SEWER MH

EXISTING FIRE HYDRANT

Щΰ

CONFORMANCE WITH SEC. 985 FDOT SPEC.

P.E.#:76036

DATE: 8/29/23 SCALE: 1"=10'

1 OF 11 PROJECT NO.: 23-40

. ALL SEDIMENT CONTROL MEASURES ARE TO BE ADJUSTED TO MEET FIELD CONDITIONS AT THE TIME OF CONSTRUCTION AND BE CONSTRUCTED PRIOR TO ANY GRADING OR DISTURBANCE OF EXISTING SURFACE MATERIAL ON BALANCE OF SITE. PERIMETER SEDIMENT BARRIERS SHALL BE CONSTRUCTED TO PREVENT SEDIMENT OR TRASH FROM FLOWING OR FLOATING ON TO ADJACENT PROPERTIES.

2. PERIODIC INSPECTION AND MAINTENANCE OF ALL SEDIMENT CONTROL STRUCTURES MUST BE PROVIDED TO ENSURE INTENDED PURPOSE IS ACCOMPLISHED. THE DEVELOPER, OWNER AND/OR CONTRACTOR SHALL BE CONTINUALLY RESPONSIBLE FOR ALL SEDIMENT CONTROLS. SEDIMENT CONTROL MEASURES SHALL BE IN WORKING CONDITION AT THE END OF EACH WORKING DAY.

3. SEDIMENT WILL BE PREVENTED FROM ENTERING ANY STORM WATER SYSTEM, DITCH OR CHANNEL. ALL STORMWATER INLETS THAT ARE MADE OPERABLE DURING CONSTRUCTION SHALL BE PROTECTED SO THAT SEDIMENT-LADEN WATER CANNOT ENTER THE CONVEYANCE SYSTEM WITHOUT FIRST BEING FILTERED OR OTHERWISE TREATED TO REMOVE SEDIMENT.

4. WHERE CONSTRUCTION VEHICLE ACCESS ROUTES INTERSECT PAVED PUBLIC ROADS, PROVISIONS SHALL BE MADE TO MINIMIZE THE TRANSPORT OF SEDIMENT BY TRACKING ONTO THE PAVED SURFACE. WHERE SEDIMENT IS TRANSPORTED ONTO A PUBLIC ROAD SURFACE WITH CURBS AND GUTTERS, THE ROAD SHALL BE CLEANED THOROUGHLY AT THE END OF EACH DAY. SEDIMENT SHALL BE REMOVED FROM THE ROADS BY SHOVELING OR SWEEPING AND TRANSPORTED TO A SEDIMENT CONTROL DISPOSAL AREA. STREET WASHING SHALL BE ALLOWED ONLY AFTER SEDIMENT IS REMOVED IN THIS MANNER. THIS PROVISION SHALL APPLY TO INDIVIDUAL SUBDIVISION LOTS AS WELL AS TO LARGER LAND DISTURBING ACTIVITIES.

5. PERMANENT OR TEMPORARY SOIL STABILIZATION SHALL BE APPLIED TO DENUDED AREAS WITHIN SEVEN (7) DAYS AFTER FINAL GRADE IS REACHED ON ANY PORTION OF THE SITE. TEMPORARY SOIL STABILIZATION SHALL BE APPLIED WITHIN SEVEN (7) DAYS TO DENUDED AREAS THAT MAY NOT BE AT FINAL GRADE BUT WILL REMAIN UNDISTURBED FOR LONGER THAN THIRTY (30) DAYS. PERMANENT STABILIZATION SHALL BE APPLIED TO AREAS THAT ARE TO BE LEFT UNDISTURBED FOR MORE THAN ONE YEAR.

6. DURING CONSTRUCTION OF THE PROJECT, SOIL STOCKPILES SHALL BE STABILIZED, COVERED OR CONTAINED WITH SEDIMENT TRAPPING MEASURES. THE CONTRACTOR IS RESPONSIBLE FOR THE TEMPORARY PROTECTION AND PERMANENT STABILIZATION OF ALL SOIL STOCKPILES ON SITE AS WELL AS SOIL INTENTIONALLY TRANSPORTED FROM THE PROJECT SITE.


7. ALL TEMPORARY EROSION AND SEDIMENT CONTROL MEASURES SHALL BE REMOVED WITHIN 30 DAYS AFTER FINAL SITE STABILIZATION OR AFTER THE TEMPORARY MEASURES ARE NO LONGER NEEDED.

8. PROPERTIES AND WATER WAYS DOWNSTREAM FROM CONSTRUCTION SITE SHALL BE PROTECTED FROM SEDIMENT DEPOSITION AND EROSION AT ALL TIMES DURING CONSTRUCTION.

9. CONTRACTOR IS RESPONSIBLE FOR ALL SURFACE WATER DISCHARGES, RAINFALL RUN OFF OR DEWATERING ACTIVITIES.

10. CONTRACTOR MUST INCORPORATE ALL BMP'S NECESSARY TO MEET OR EXCEED STATE WATER QUALITY AND SWPPP REQUIREMENTS.

11. THE POLLUTION PREVENTION PLAN IS A MINIMUM GUIDELINE ONLY. ADDITIONAL BMP'S MAY BE NECESSARY AT CONTRACTOR'S EXPENSE.

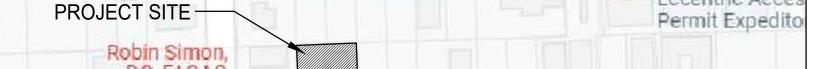

Eccentric Acces

Van Buren St

BMP NOTES:

Alex Unlimited DO, FAOAO Electricity Corp

Polk St Polk St Polk St Hollywood Branch Library Rosenberg & Rosenberg, PA

Hollywood: Utility Billing - Drive Thru Broward Relations Office lanagement Hywoo Hollywood City Hall Silhouette Archer Body Contouring Inc. - B ussifay Argentinean Studio I Originally \$150 entina SS S 29th Terrace

Ben Gamla

Charter School

LOCATION MAP NOT TO SCALE

Van Buren St

EROSION & SEDIMENT CONTROL PLAN

TYPE III SILT FENCE

POLLUTION PREVENTION FOR CATCH BASIN

6' MAX.

No 76036 STATE OF

3-4-24

CATCH BASIN -STRUCTURE


POST OPTIONS: WOOD 2 1/2" MIN. Ø

WOOD 2" X 4" OAK 1 1/2" X 1 1/2" STEEL


1.33 LBS/FT. MIN.—

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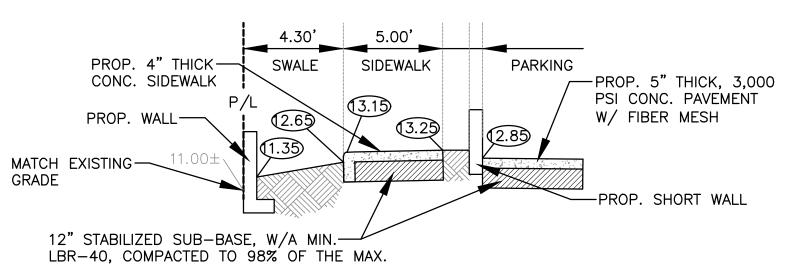
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- & PROPOSED PLANS BY THE OTHER DESIGN PROFESSIONALS PRIOR TO CONSTRUCTION. CONTRACTOR MUST ALSO VERIFY THAT THERE ARE NO DISCREPANCIES BETWEEN THE WATER, SEWER & DRAINAGE PLANS THAT MAY CAUSE CONFLICTS PRIOR TO CONSTRUCTION. CONTACT ZEPHYR ENGINEERING IF DISCREPANCIES EXIST.
- 4) PRIOR TO CONSTRUCTION, CONTRACTOR RESPONSIBLE TO DOCUMENT EXISTING CONDITIONS ON AND AROUND THE PROJECT AREA, INCLUDING THE R.O.W. AND ADJACENT PROPERTIES. IT'S RECOMMENDED THAT CONTRACTOR TAKE PHOTOGRAPHS & VIDEOS TO CLEARLY DOCUMENT CONDITIONS PRIOR TO CONSTRUCTION. CONTRACTOR RESPONSIBLE TO REPAIR ALL DAMAGES CAUSED BY OR AS A RESULT OF THE PROPOSED CONSTRUCTION.
- 5) ALL ROOF DRAINS MUST BE CONNECTED TO THE ONSITE DRAINAGE SYSTEM.
- CONTRACTOR TO REFER TO ARCHITECTURAL PLANS FOR SITE PLAN LAYOUT AND DIMENSIONS.
- 7) EXISTING UTILITIES SHOWN ARE BASED ON BEST AVAILABLE INFORMATION. CONTRACTOR'S RESPONSIBLE TO FIELD VERIFY LOCATION OF ALL EXISTING UTILITIES PRIOR TO CONSTRUCTION. CONTRACTOR TO BE AWARE THAT THERE MAY BE SOME EXISTING UTILITIES ON OR ADJACENT TO THE PROJECT SITE THAT MAY NOT BE SHOWN ON THE CIVIL PLANS, AND CONTRACTOR IS RESPONSIBLE TO FIELD VERIFY THOSE UTILITIES AS WELL. CONTRACTOR RESPONSIBLE FOR RELOCATION OF EXISTING UTILITIES THAT CONFLICTS WITH PROPOSED CONSTRUCTION.

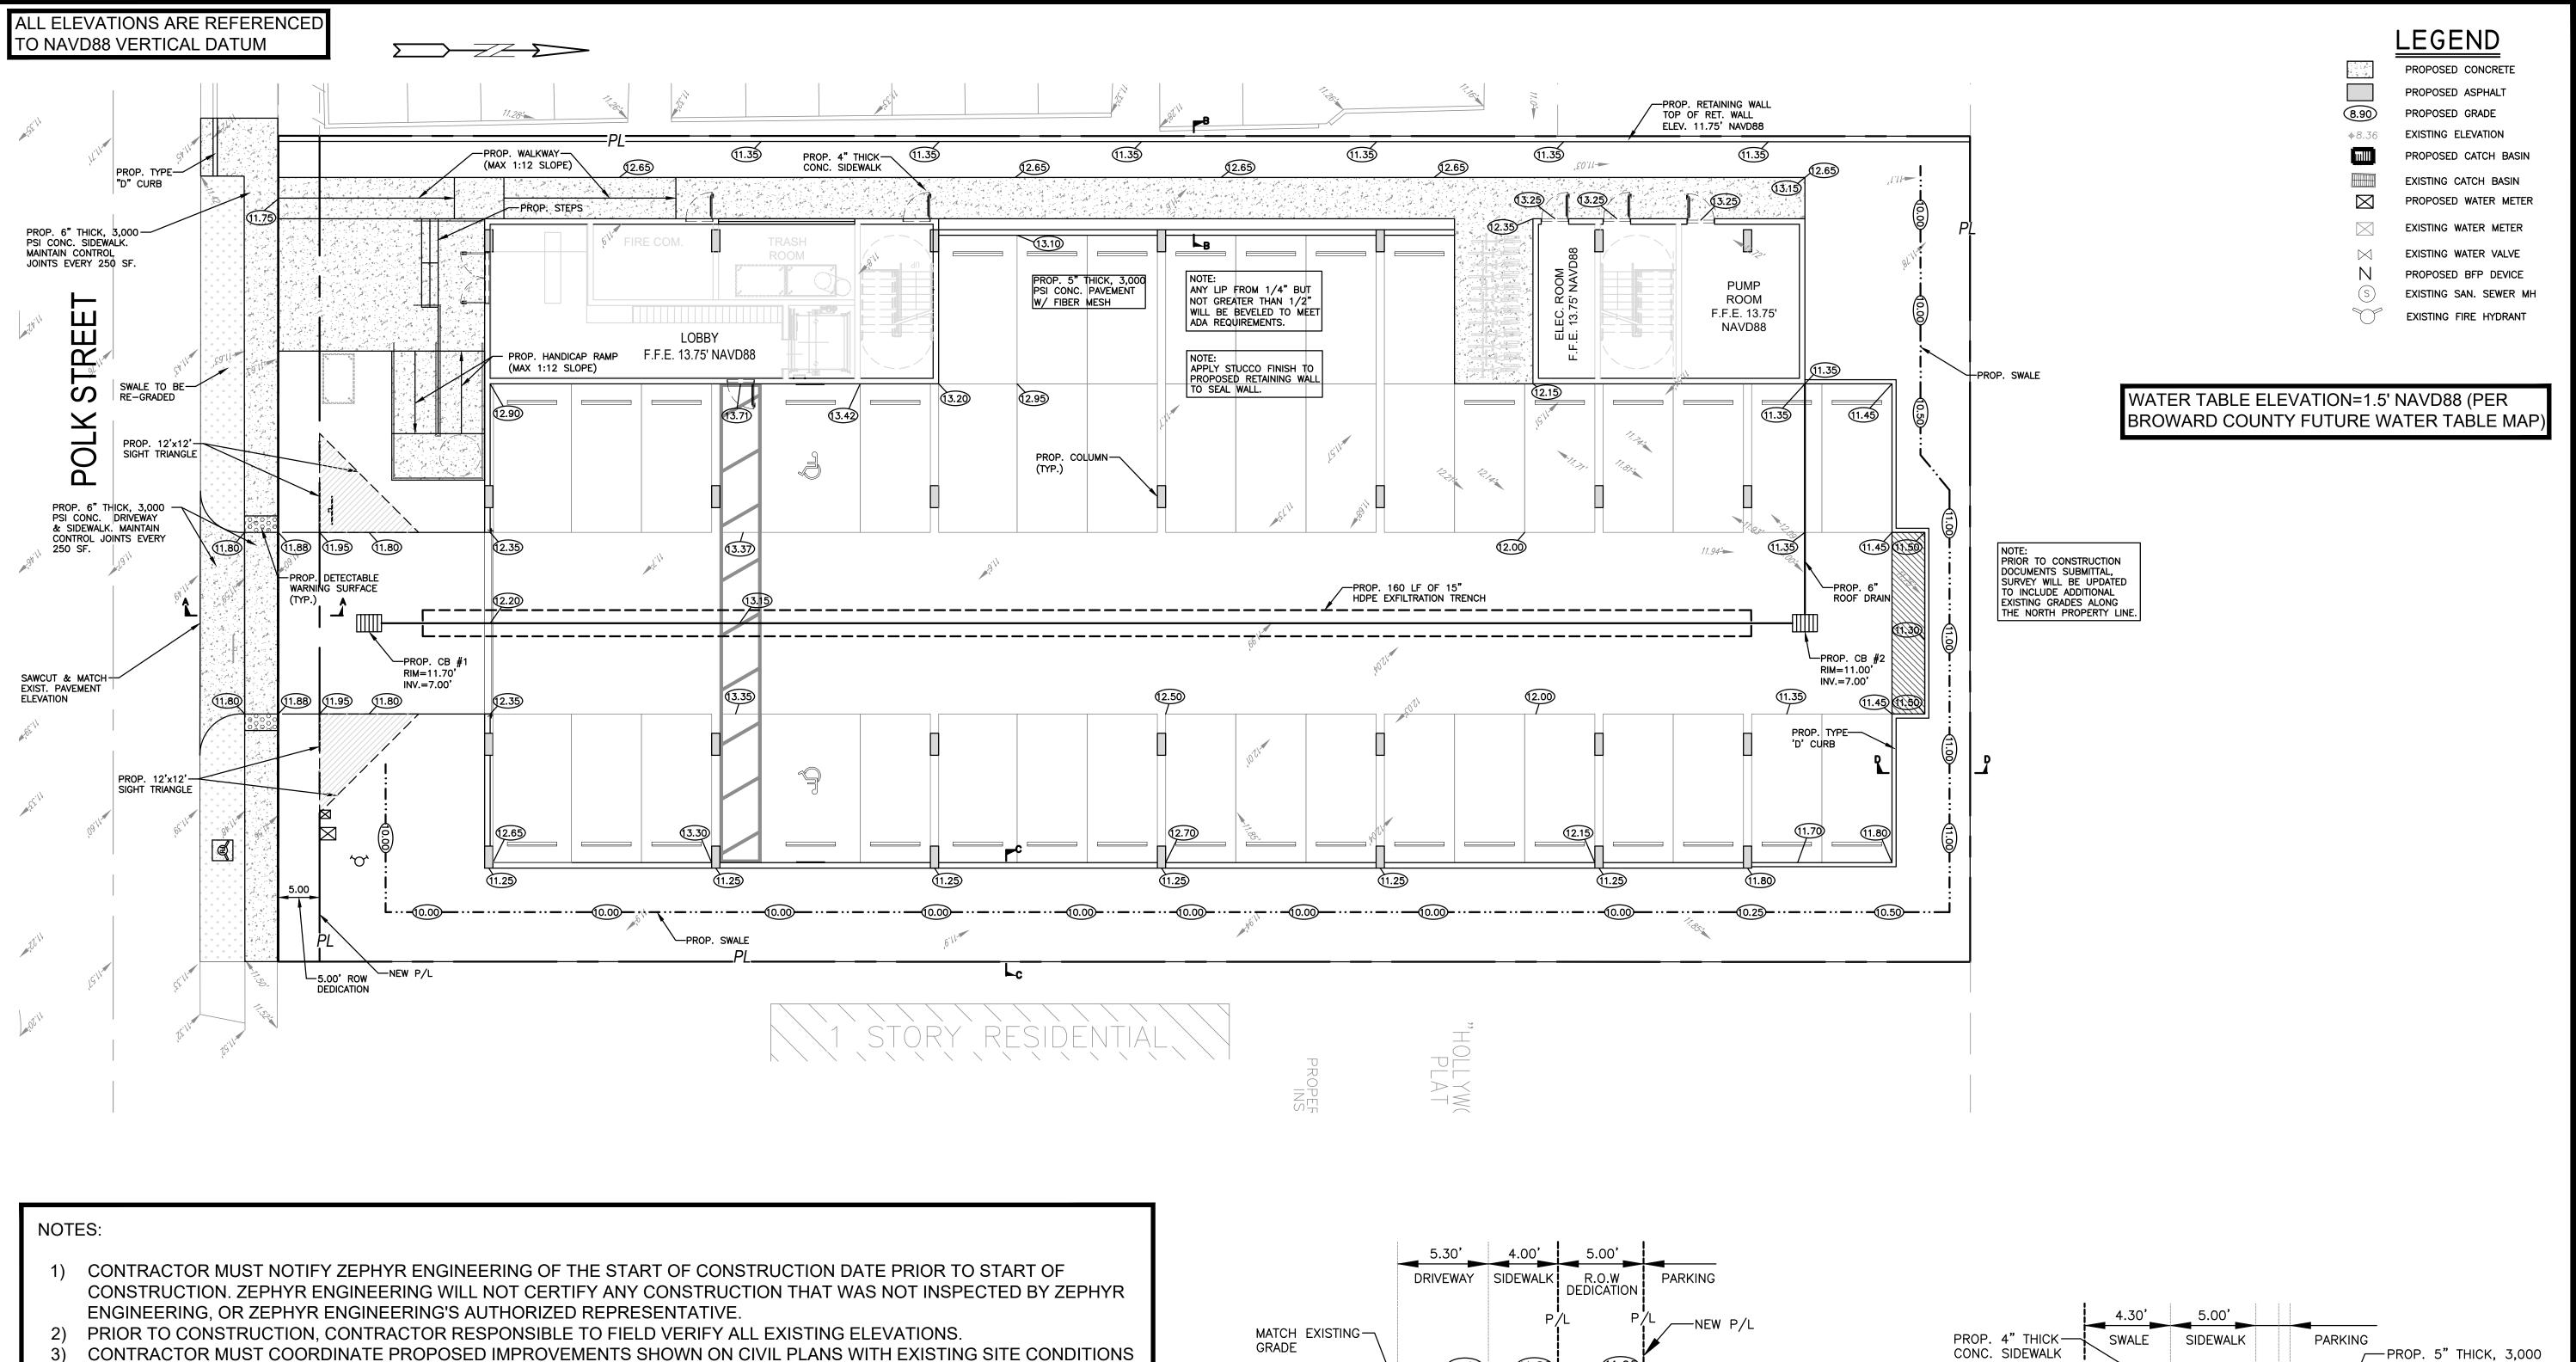

SECTION A-A N.T.S.

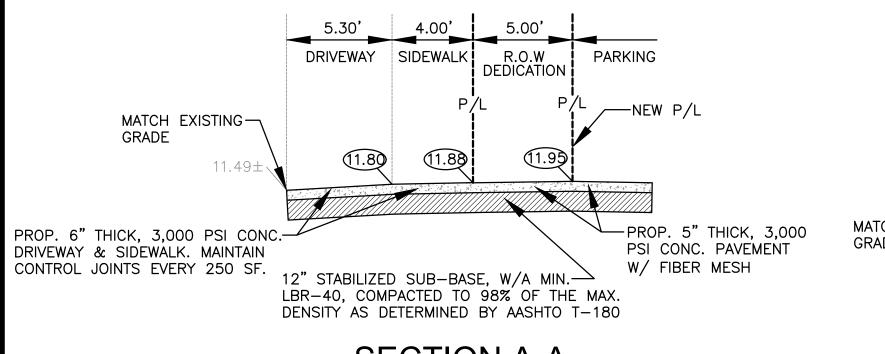

SECTION B-B



DENSITY AS DETERMINED BY AASHTO T-180

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PAVING, GRADING & DRAINAGE PLAN SCALE: 1"=10'

PROJECT NO.: 23-40

P.E.#:76036

Ш

RTME

DATE: 8/29/23 SCALE: 1"=10'

2 OF 11

I. THE LOCATION OF EXISTING UTILITIES AND TOPOGRAPHY HAS BEEN PREPARED FROM THE MOST RELIABLE INFORMATION AVAILABLE TO THE ENGINEER. THIS INFORMATION IS NOT GUARANTEED AND IT IS THE RESPONSIBILITY OF THE CONTRACTOR TO DETER-MINE THE EXACT LOCATION OF ALL EXISTING UTILITIES

AND TOPOGRAPHY PRIOR TO CONSTRUCTION. 2. PRIOR TO CONSTRUCTION THE CONTRACTOR IS TO NOTIFY THE FOLLOWING

COMPANIES & AGENCIES AND ANY OTHERS SERVING THE AREA: FLORIDA POWER & LIGHT CO., CONSTRUCTION

COMCAST

LOCAL CITY / COUNTY ENGINEERING & UTILITY DEPARTMENTS FLORIDA DEPARTMENT OF TRANSPORTATION (FDOT), AS APPLICABLE UNDERGROUND UTILITIES NOIFICATION CENTER OF FLORIDA (S.U.N.S.H.I.N.E.)

PAVING, GRADING & DRAINAGE NOTES:

ALL UNSUITABLE MATERIALS, SUCH AS MUCK, HARDPAN, ORGANIC MATERIAL & OTHER DELETERIOUS MATERIAL AS CLASSIFIED BY AASHTO M-145, FOUND WITHIN THE ROAD & PARKING LOT AREAS SHALL BE REMOVED DOWN TO ROCK OR SUITABLE MATERIAL, & REPLACED W/ THE SPECIFIED FILL MATERIAL IN MAXIMUM 12" LIFTS COMPACTED TO NOT LESS THAN 100% MAXIMUM DRY DENSITY AT OPTIMUM MOISTURE IN ACCORDANCE W/ AASHTO T-99. THICKNESS OF LAYERS MAY BE INCREASED PROVIDED THE EQUIPMENT & METHODS USED ARE PROVEN BY FIELD DENSITY TESTING TO BE CAPABLE OF COMPACTING THICK LAYERS TO SPECIFIED DENSITIES.

- 2. ALL AREAS SHALL BE CLEARED & GRUBBED PRIOR TO CONSTRUCTION. THIS SHALL CONSIST OF THE COMPLETE REMOVAL & DISPOSAL OF ALL TREES, BRUSH, STUMPS, ROOTS, GRASS, WEEDS, RUBBISH & ALL OTHER OBSTRUCTION RESTING ON OR PROTRUDING THROUGH THE SURFACE OF THE EXIST. GROUND TO A DEPTH OF 12". ITEMS DESIGNATED TO REMAIN OR TO BE RELOCATED OR ADJUSTED SHALL BE SO DESIGNATED ON THE DWGS.
- 3. FILL MATERIAL SHALL BE CLASSIFIED AS A-1, A-3 OR A-2.4 IN ACCORDANCE W/ AASHTO M-145 & SHALL BE FREE FROM VEGETATION & ORGANIC MATERIAL. NOT MORE
- THAN 12% BY WEIGHT OF FILL MATERIAL SHALL PASS THE NO. 200 SIEVE. 4. THE CONTRACTOR SHALL BE RESPONSIBLE FOR PROVIDING CERTIFIED MATERIAL TEST RESULTS TO THE ENGINEER OF RECORD PRIOR TO THE RELEASE OF FINAL CERTIFICATION BY THE ENG. TEST RESULTS MUST INCLUDE BUT MAY NOT BE LIMITED TO, DENSITIES FOR SUBGRADE & LIME ROCK, UTILITIES, EXCAVATION, ASPHALT GRADIATION REPORTS, CONC.
- 5. ALL INLETS & PIPE SHALL BE PROTECTED DURING CONSTRUCTION TO PREVENT SILTATION IN THE DRAINAGE SYSTEMS BY WAY OF TEMPORARY PLUGS & PLYWOOD OR PLASTIC COVERS OVER THE INLETS. THE ENTIRE DRAINAGE SYSTEM TO BE CLEAN OF DEBRIS PRIOR TO FINAL
- 6. WHERE NEW ASPHALT MEETS OR ABUTS EXIST. ASPHALT, THE EXIST. ASPHALT SHALL BE SAWCUT TO PROVIDE A STRAIGHT EVEN LINE. PRIOR TO REMOVING CURB OR GUTTER, THE ADJACENT ASPHALT SHALL ALSO BE SAWCUT TO PROVIDE A STRAIGHT EVEN LINE.
- ALL PROPOSED GRADES (ELEVATIONS) REFER TO ASPHALT GRADES UNLESS INDICATED
- 8. SITE GRADING SHALL BE W/IN 0.1' OF THE REQUIRED ELEVATION & ALL AREAS SHALL BE
- 9. ALL SUBGRADE SHALL HAVE AN LBR OF 40 UNLESS OTHERWISE NOTED & SHALL BE
- COMPACTED TO 98% MAXIMUM DRY DENSITY PER AASHTO T-99. 10. ALL LIMEROCK SHALL BE COMPACTED TO 98% PER AASHTO T-180 & HAVE NOT LESS THAN 60% OF CARBONATES OF CALCIUM & MAGNESIUM UNLESS OTHERWISE DESIGNATED. ALL
- LIMEROCK SHALL BE PRIMED. 11 CONCRETE & ASPHALT THICKNESS SHALL BE OF TYPE DESIGNATED ON DWGS. (SEE SECTIONS)
- 12. PLASTIC FILTER FABRIC SHALL BE MIRAFI, TYPAR OR EQUAL CONFORMING TO SECTION 985 OF THE FDOT STANDARD SPECIFICATIONS.
- 13. CONC. SIDEWALKS SHALL BE 4" THICK ON COMPACTED SUBGRADE, W/ 1/2" EXPANSION JOINTS PLACED AT A MAXIMUM OF 75'. CRACK CONTROL JOINTS SHALL BE 5' ON CENTER. THE BACK OF SIDEWALK ELEVATION SHALL EQUAL THE CROWN OF ROADWAY, UNLESS SPECIFIED OTHERWISE BY LOCAL CODES OR INDICATED ON DWGS. ALL CONC. SIDEWALKS THAT CROSS DRIVEWAYS SHALL BE 6" THICK.
- 14. PIPE SPECIFICATIONS: THE MATERIAL TYPE IS SHOWN ON THE DRAWINGS BY ONE OF THE FOLLOWING DESIGNATIONS -
 - RCP = REINFORCED CONC. PIPE, ASTM DESIGNATION C-76, TABLE III
 - CMP = CORRUGATED METAL (ALUM.) PIPE, TM DESIGNATION M-196CMP = (SMOOTH LINED) CORRUGATED METAL (ALUM.) PIPE, ASTM DESIGNATION M-196
 - SCP = SLOTTED CONC. PIPE, FDOT SECTIONS 941 & 942 PVC = POLYVINYLCHLORIDE PIPE
 - PCMP = PERFORATED CMP, FDOT SECTION 945 DIP = DUCTILE IRON PIPE HDPE = HIGH DENSITY POLYETHYLENE PIPE.

15. ASPHALT -


BITUMINOUS MATERIAL SHALL BE ASPHALT CEMENT, VISCOSITY GRADE AC-20, CONFORMING TO THE REQUIREMENTS OF FDOT STANDARD SPECIFICATIONS, 1986 EDITION, SECTION 916-1 PRIME COAT SHALL BE CUT BACK ASPHALT, GRADE RC-70 OR RC-250 CONFORMING TO THE REQUIREMENTS SPECIFIED IN AASHTO DESIGNATION M-81-75 (1982). RATE - 0.10 GALS./S.Y. TACK COAT SHALL BE EMULSIFIED ASPHALT, GRADE RS-2 CONFORMING TO THE REQUIREMENTS SPECIFIED IN AASHTO DESIGNATION M-140-82. RATE - 0.02 TO 0.08


DESIGN MIX SHALL CONFORM TO FDOT SECTION 331 UNLESS OTHERWISE SPECIFIED.


PAVEMENT MARKING & SIGNING STANDARD NOTES :


- 1. STOP SIGNS SHALL BE 30"x30" (R1-1), HIGH INTENSITY.
- 2. ALL SIGNS SHALL BE PLACED AT A HEIGHT NOT LESS THAN 5' & NOT GREATER THAN 7', THE HEIGHT IS MEASURED FROM THE BOTTOM OF THE SIGN TO THE EDGE OF NEAREST PAVEMENT. THE SIGN POST SHALL BE PLACED A MINIMUM OF 6' TO A MAXIMUM OF 12' FROM THE ADJACENT PAVEMENT, & A MINIMUM OF 6' FROM THE CROSS TRAFFIC
- 3. STOP BARS SHALL BE 24" WHITE.
- 4. ALL SITE PAVEMENT MARKINGS SHALL BE PAINT. (UNLESS INDICATED OTHERWISE)
- 5. ALL PAVEMENT MARKINGS AND SIGNAGE IN THE ROAD RIGHT-OF-WAY SHALL BE THERMOPLASTIC & SHALL CONFORM TO MUTCD AND PBC TYPICAL T-P-06-001.


ALL ELEVATIONS ARE REFERENCED TO NAVD88 VERTICAL DATUM

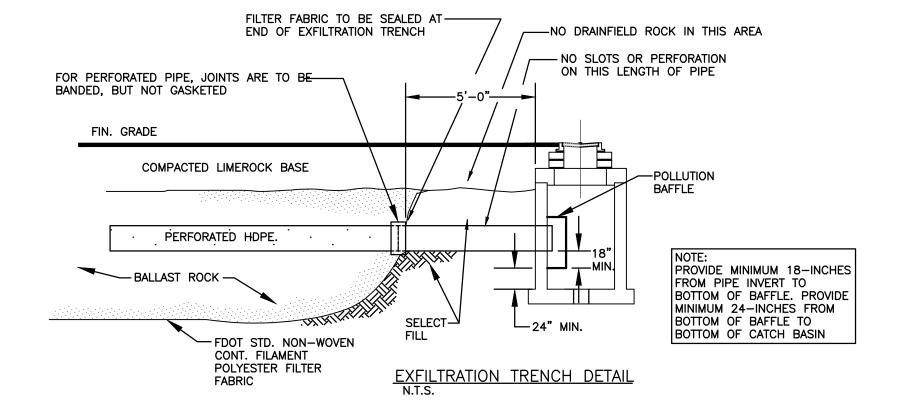

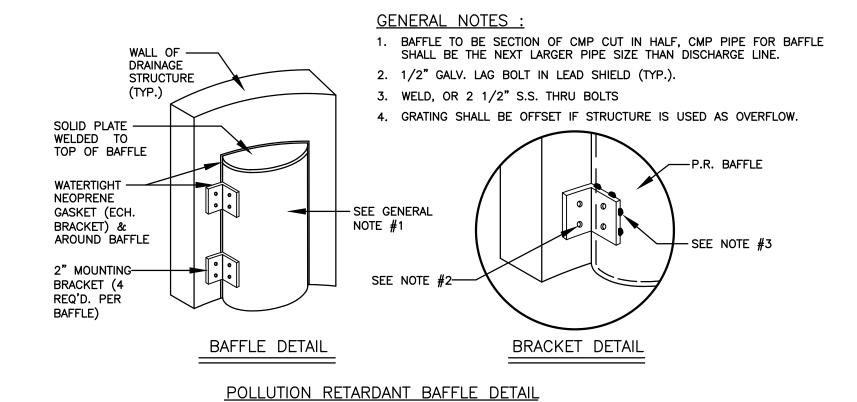


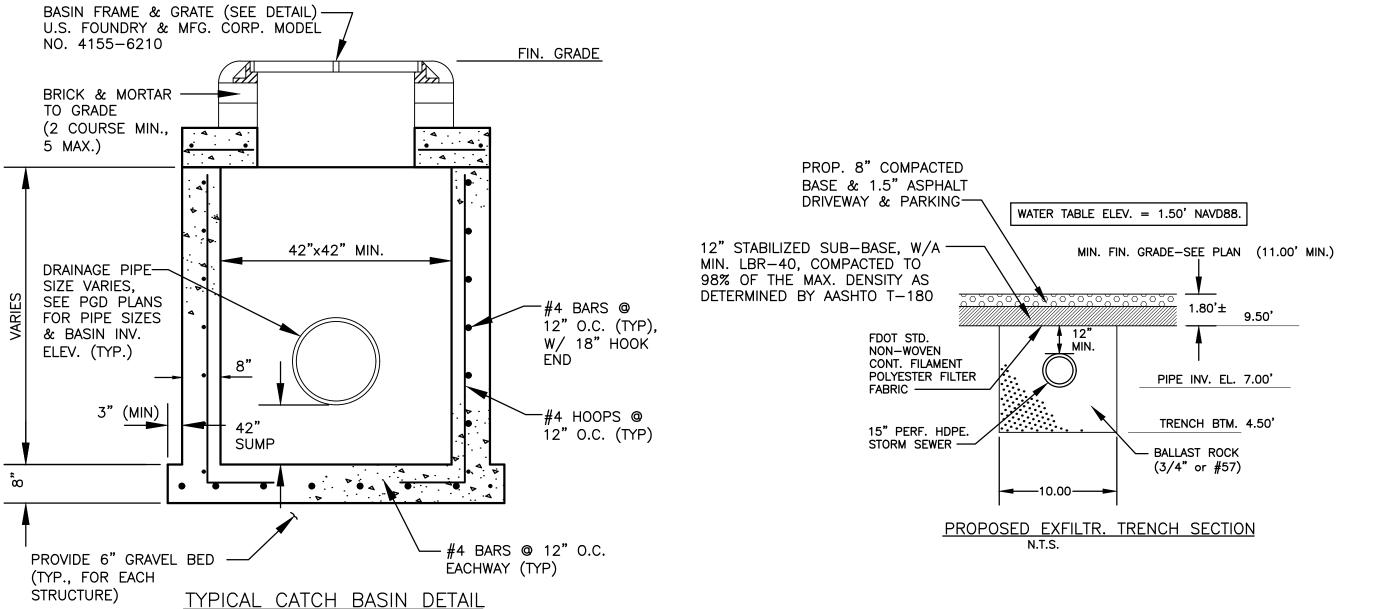

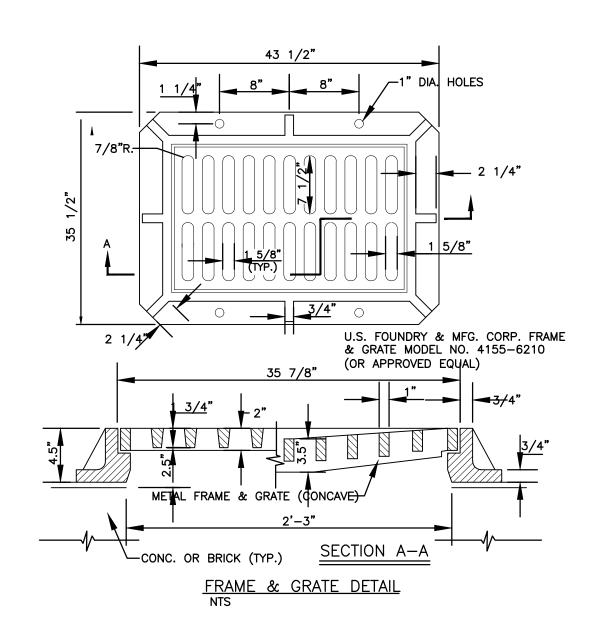

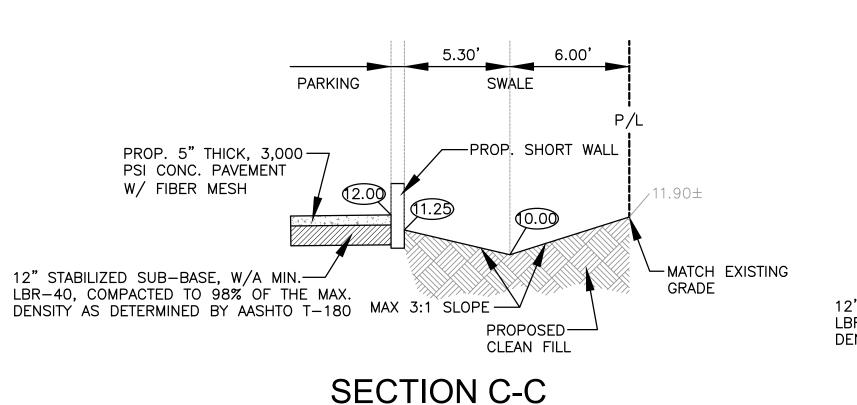

N.T.S.

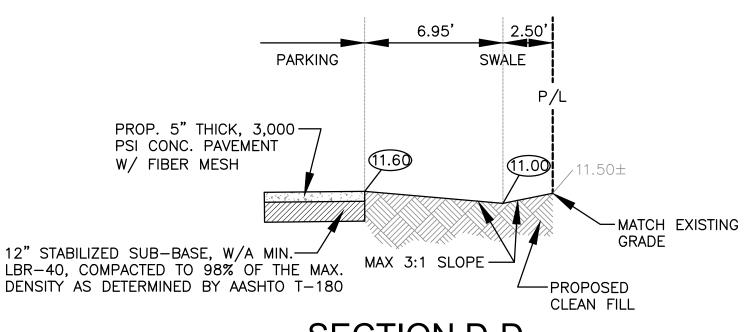

SECTION D-D N.T.S.

CIVIL DETAILS I SCALE: N.T.S.



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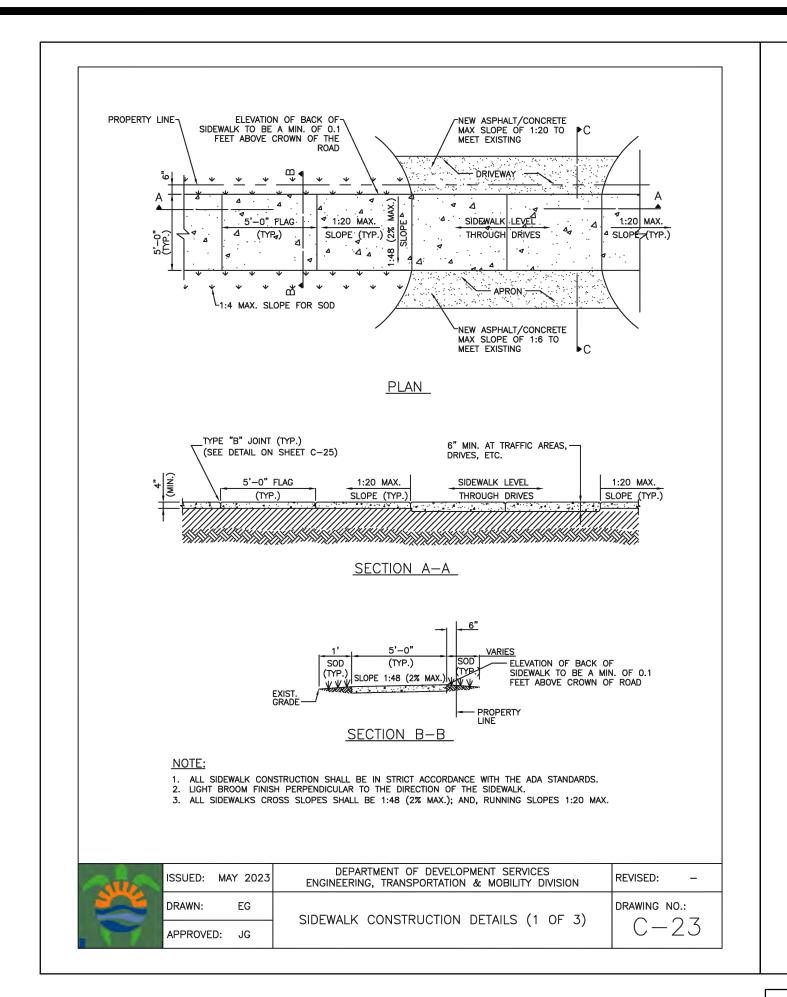
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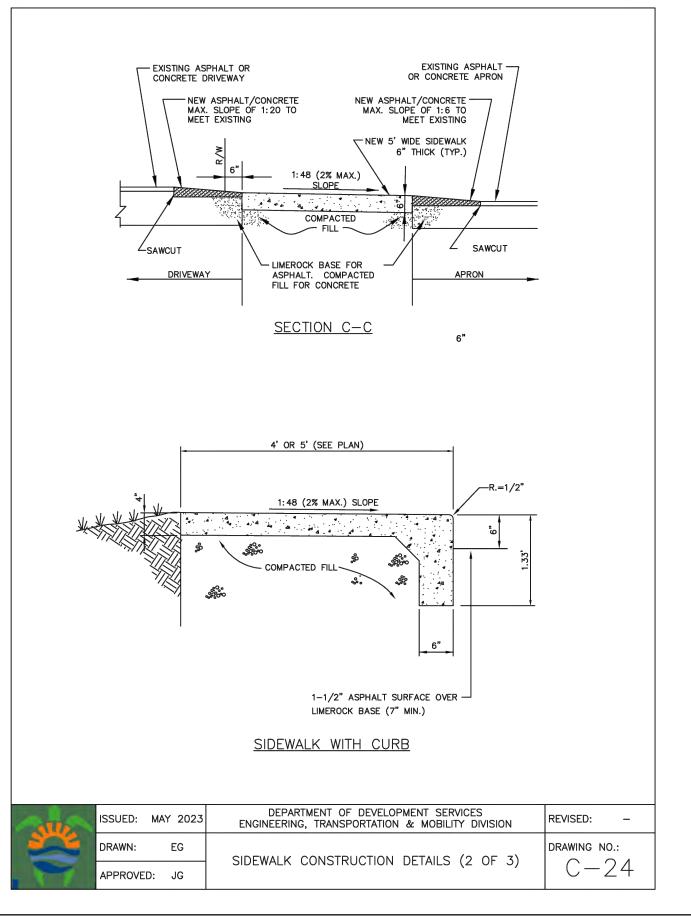
ME \square \bowtie


P.E.#:76036 DATE: 8/29/23 SCALE: N.T.S.


SHEET NO.: 3 OF 11


PROJECT NO.: 23-40






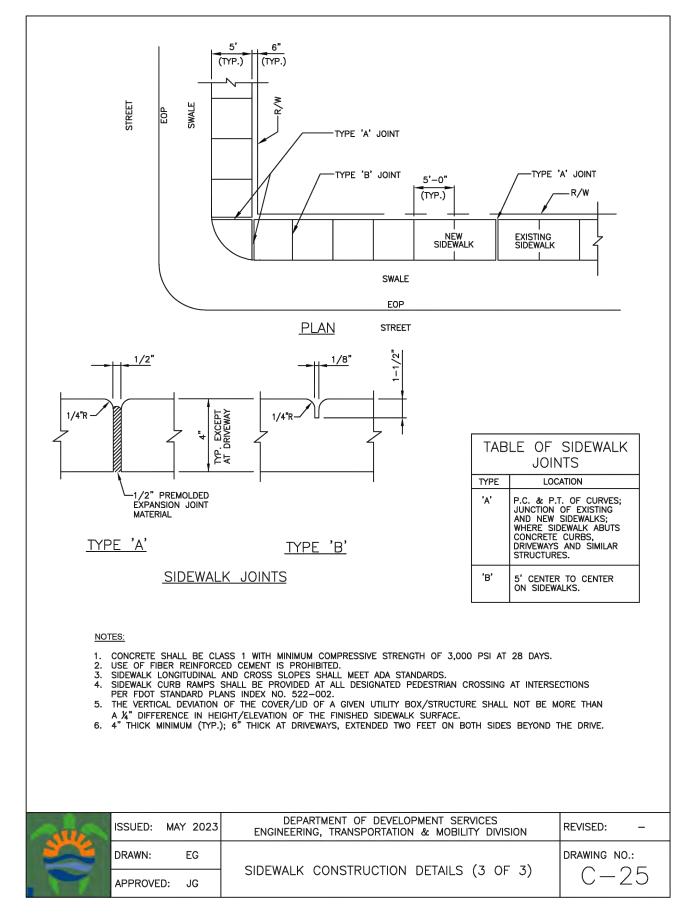

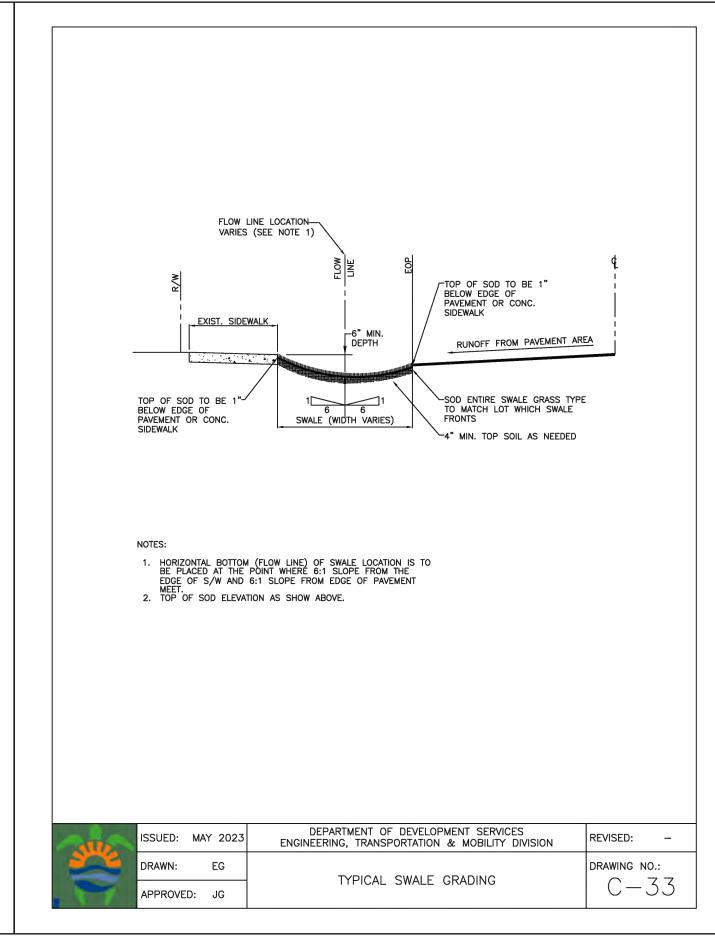

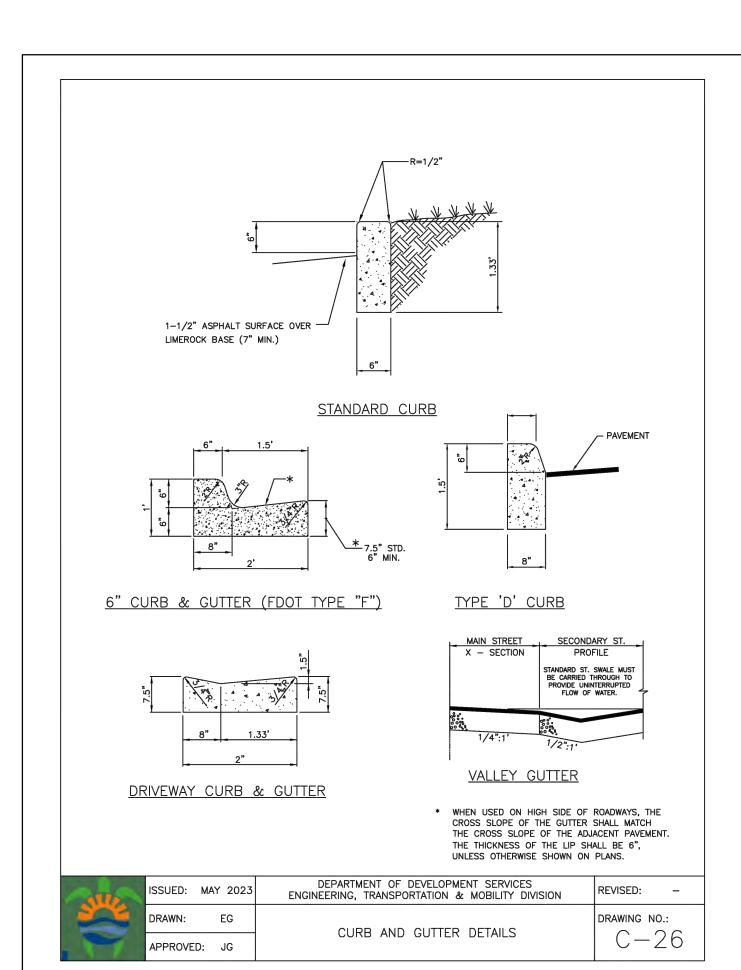

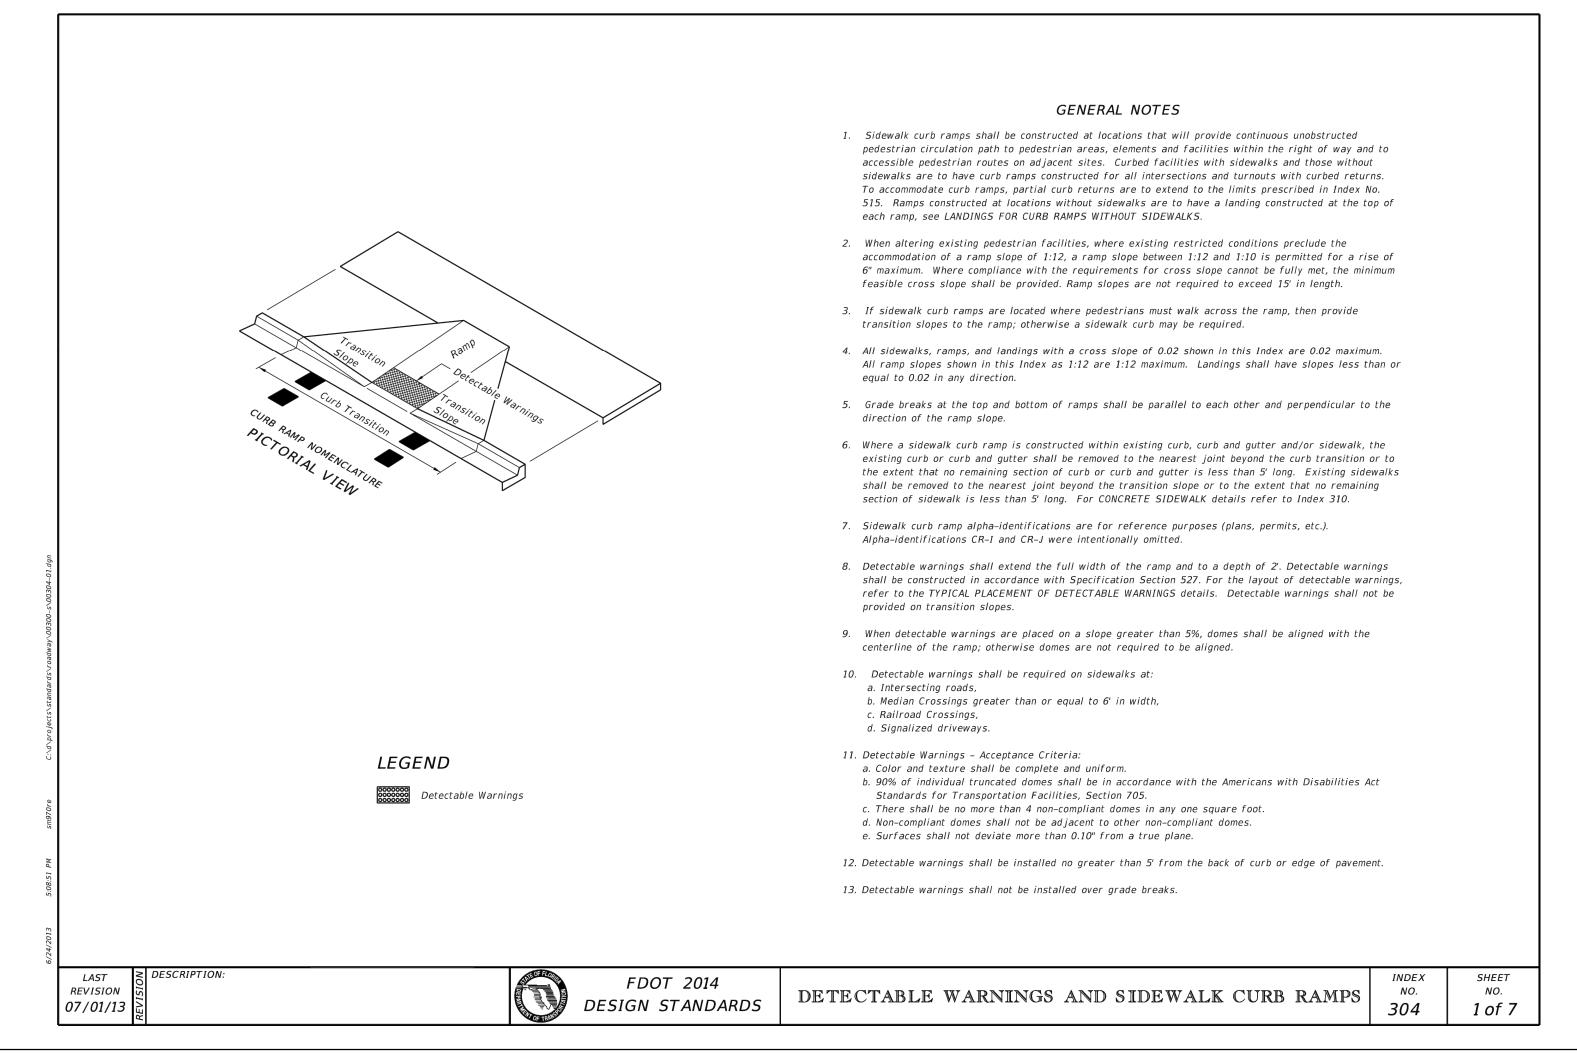



3-4-24

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CIVIL DETAILS II

SCALE: N.T.S.

P.E.#:76036 DATE: 8/29/23


SCALE: N.T.S.


SHEET NO.:


C4
4 OF 11

EERIN

PROJECT NO.: 23–40

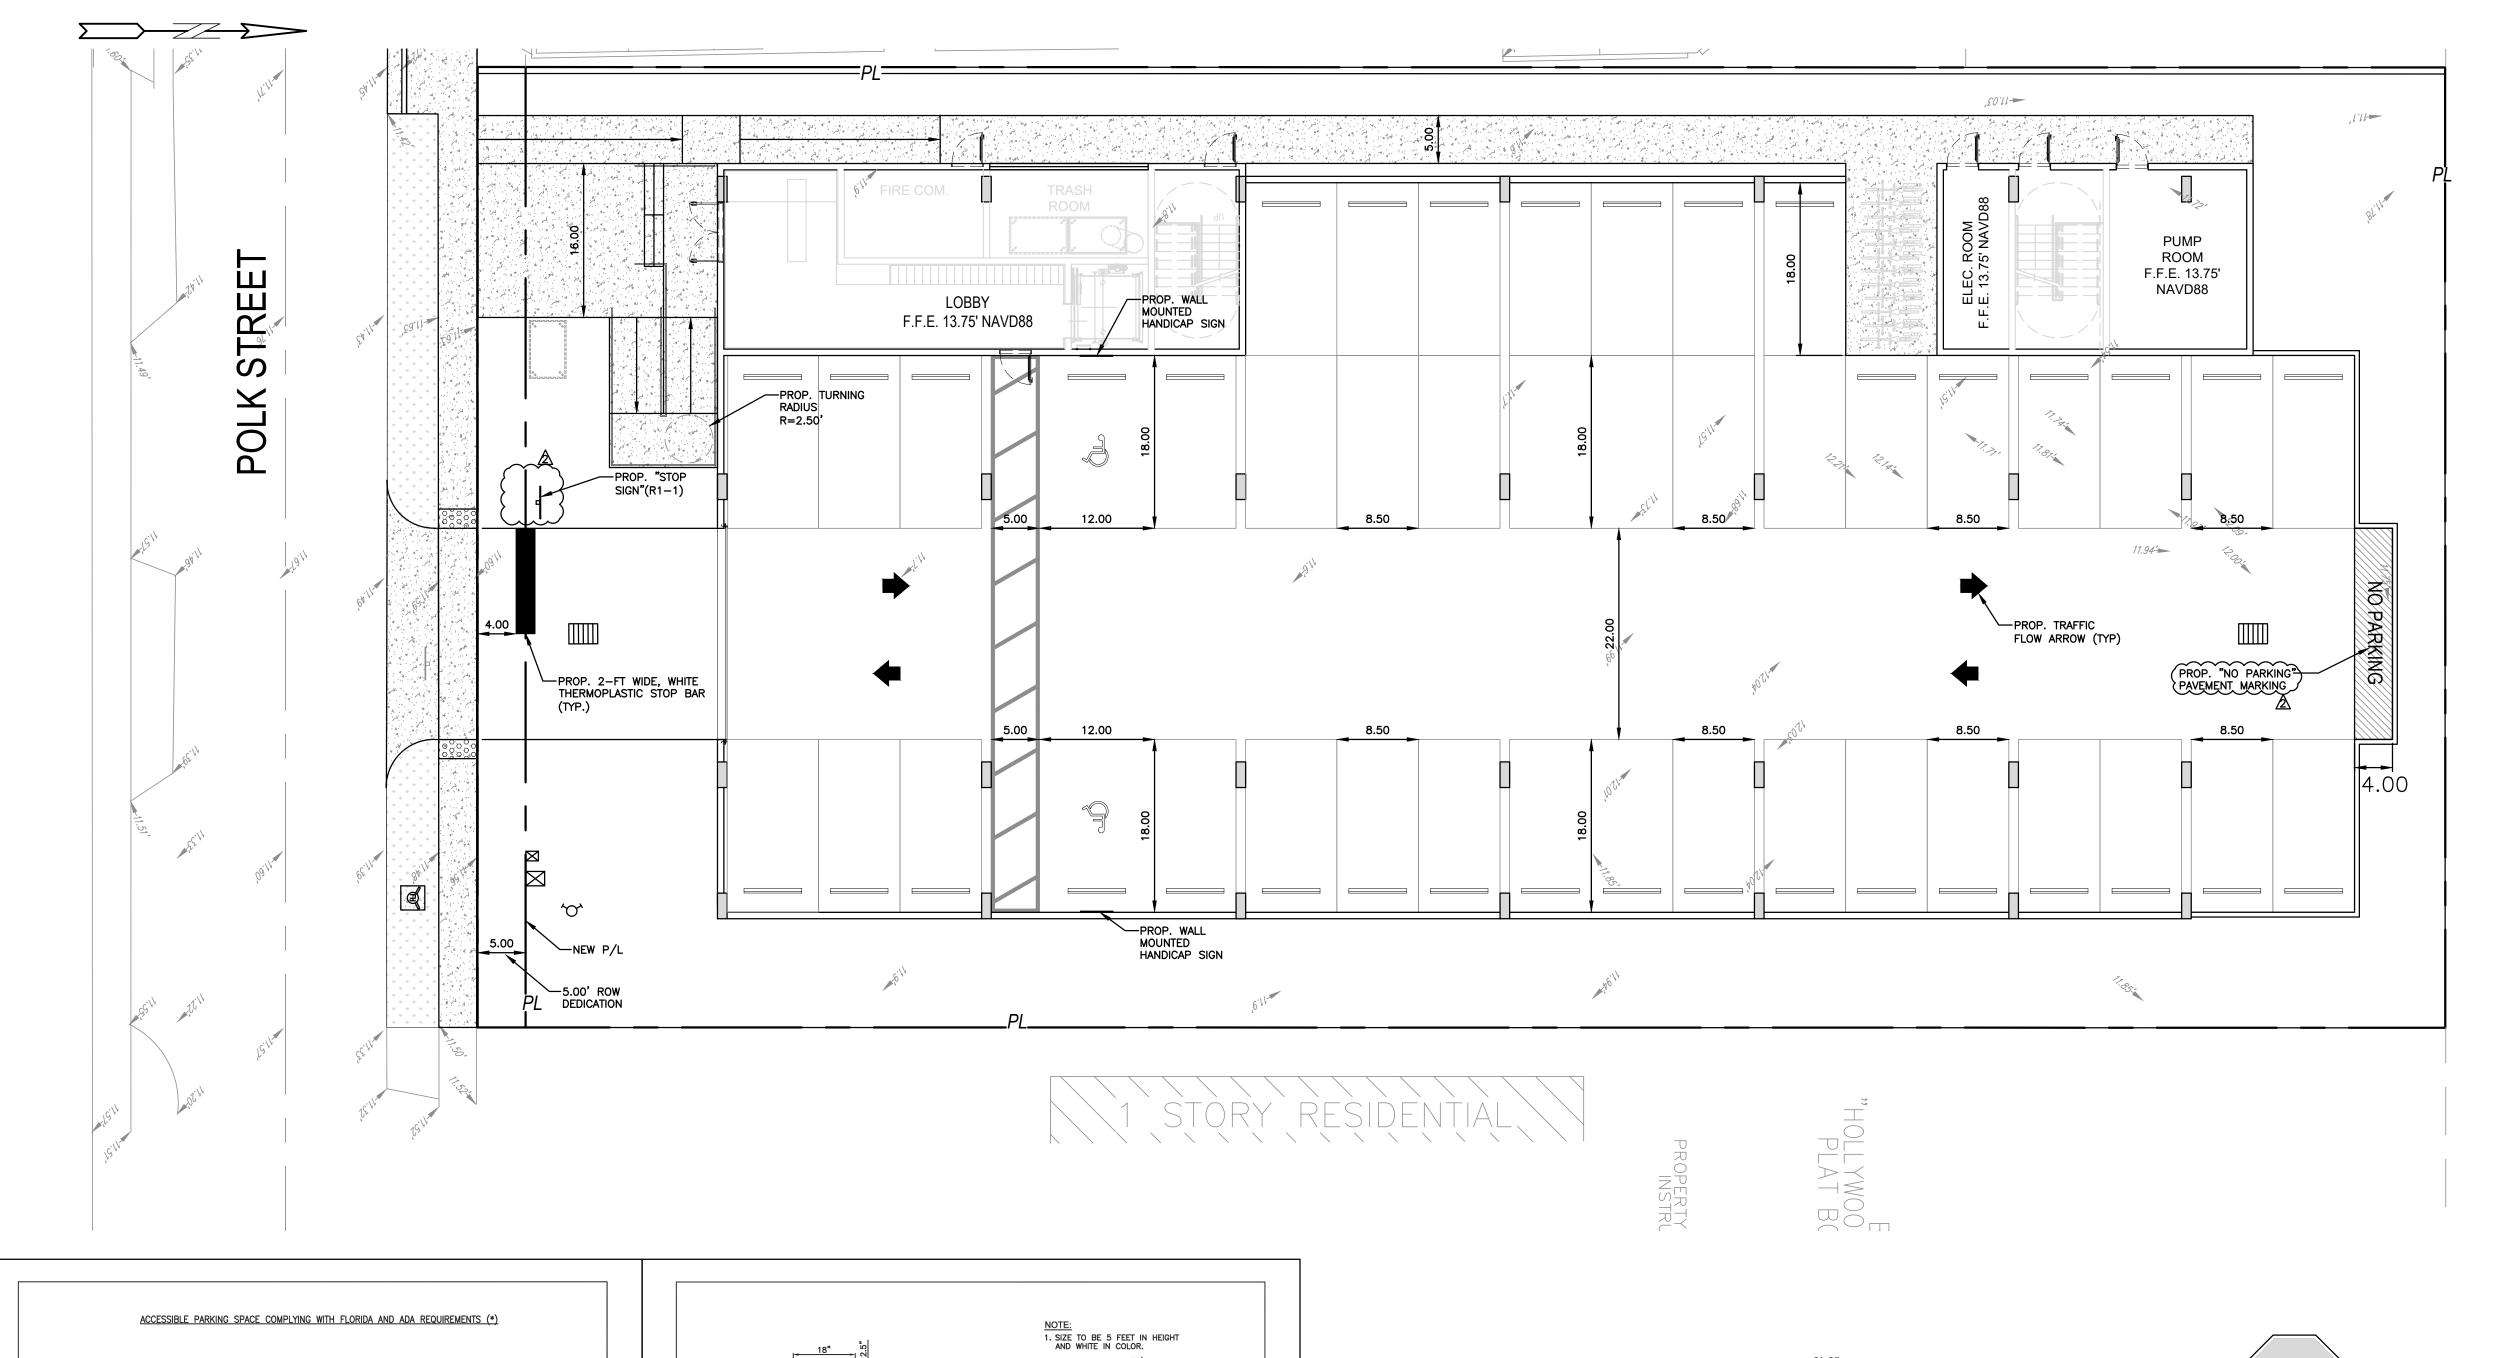

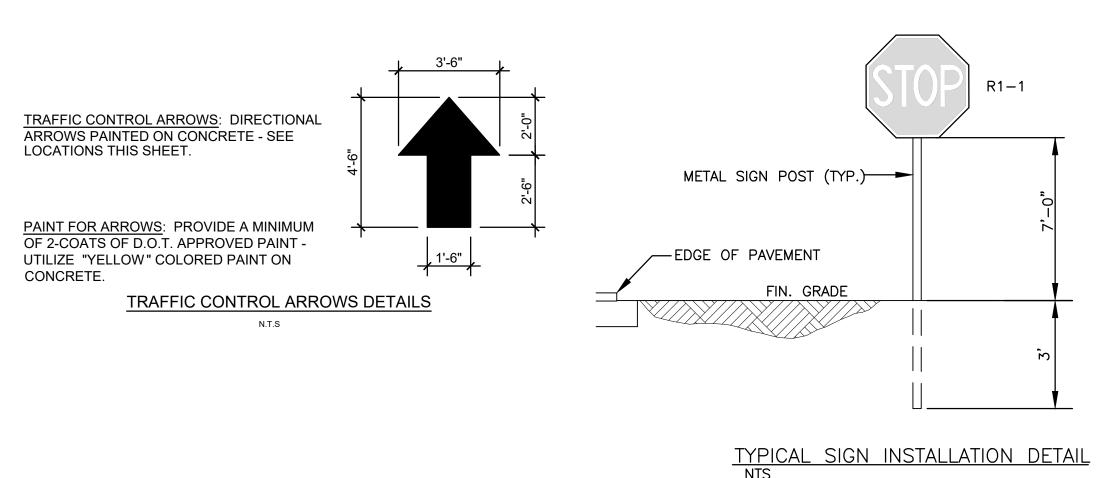

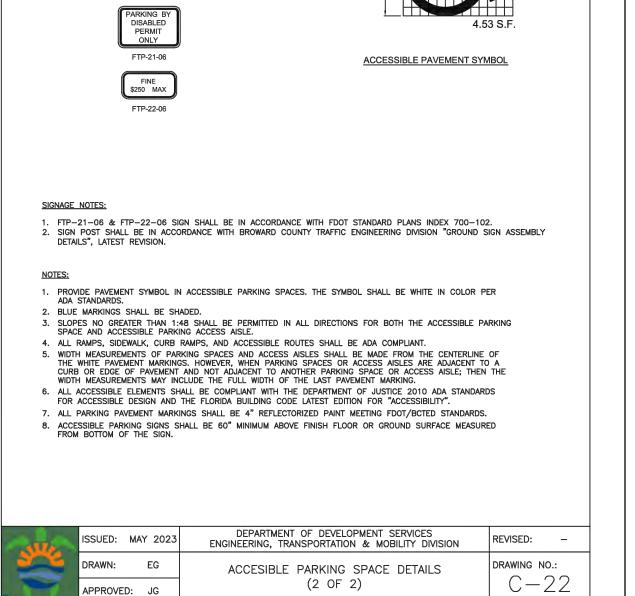

ALL LETTERS ARE 1" SERIES AT 1" SPACING

3.25" 11.5" 3.25"

ACCESSIBLE PARKING SIGN-RECOMMENDED LOCATION (TYP.)

PRECAST— ONCRETE WHEEL STOP (TYP. 6"x6"x6")

5' (TYP.)

(*) IN CASE OF CONFLICT PLANS TO COMPLY WITH ADA 406 & 502, AND FDOT 711-001 (SHEET 11)

DEPARTMENT OF DEVELOPMENT SERVICES ENGINEERING, TRANSPORTATION & MOBILITY DIVISION

ACCESIBLE PARKING SPACE DETAILS

(1 OF 2)

SIDEWALK

(3) 4" WHITE DIAGONALS EQUALLY SPACED PER AISLE

REVISED: -

DRAWING NO.:

12' (TYP.) 5' (TYP.) 12' (TYP.)



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PAVEMENT MARKINGS & SIGNAGE PLAN

SCALE: 1"=10'

5 OF 11 PROJECT NO.: 23-40

PAF TREI FL 3 $\omega \succ$

P.E.#:76036

DATE: 8/29/23 SCALE: 1"=10'

SHEET NO .:

EXISTING WATER VALVE PROPOSED BFP DEVICE EXISTING SAN. SEWER MH EXISTING FIRE HYDRANT GINEERIN PHYR, P.E.

ALL ELEVATIONS ARE REFERENCED

LEGEND

PROPOSED CONCRETE

PROPOSED ASPHALT

PROPOSED GRADE EXISTING ELEVATION

PROPOSED CATCH BASIN

PROPOSED WATER METER


EXISTING WATER METER

EXISTING CATCH BASIN

TO NAVD88 VERTICAL DATUM

8.90

ZEPHY

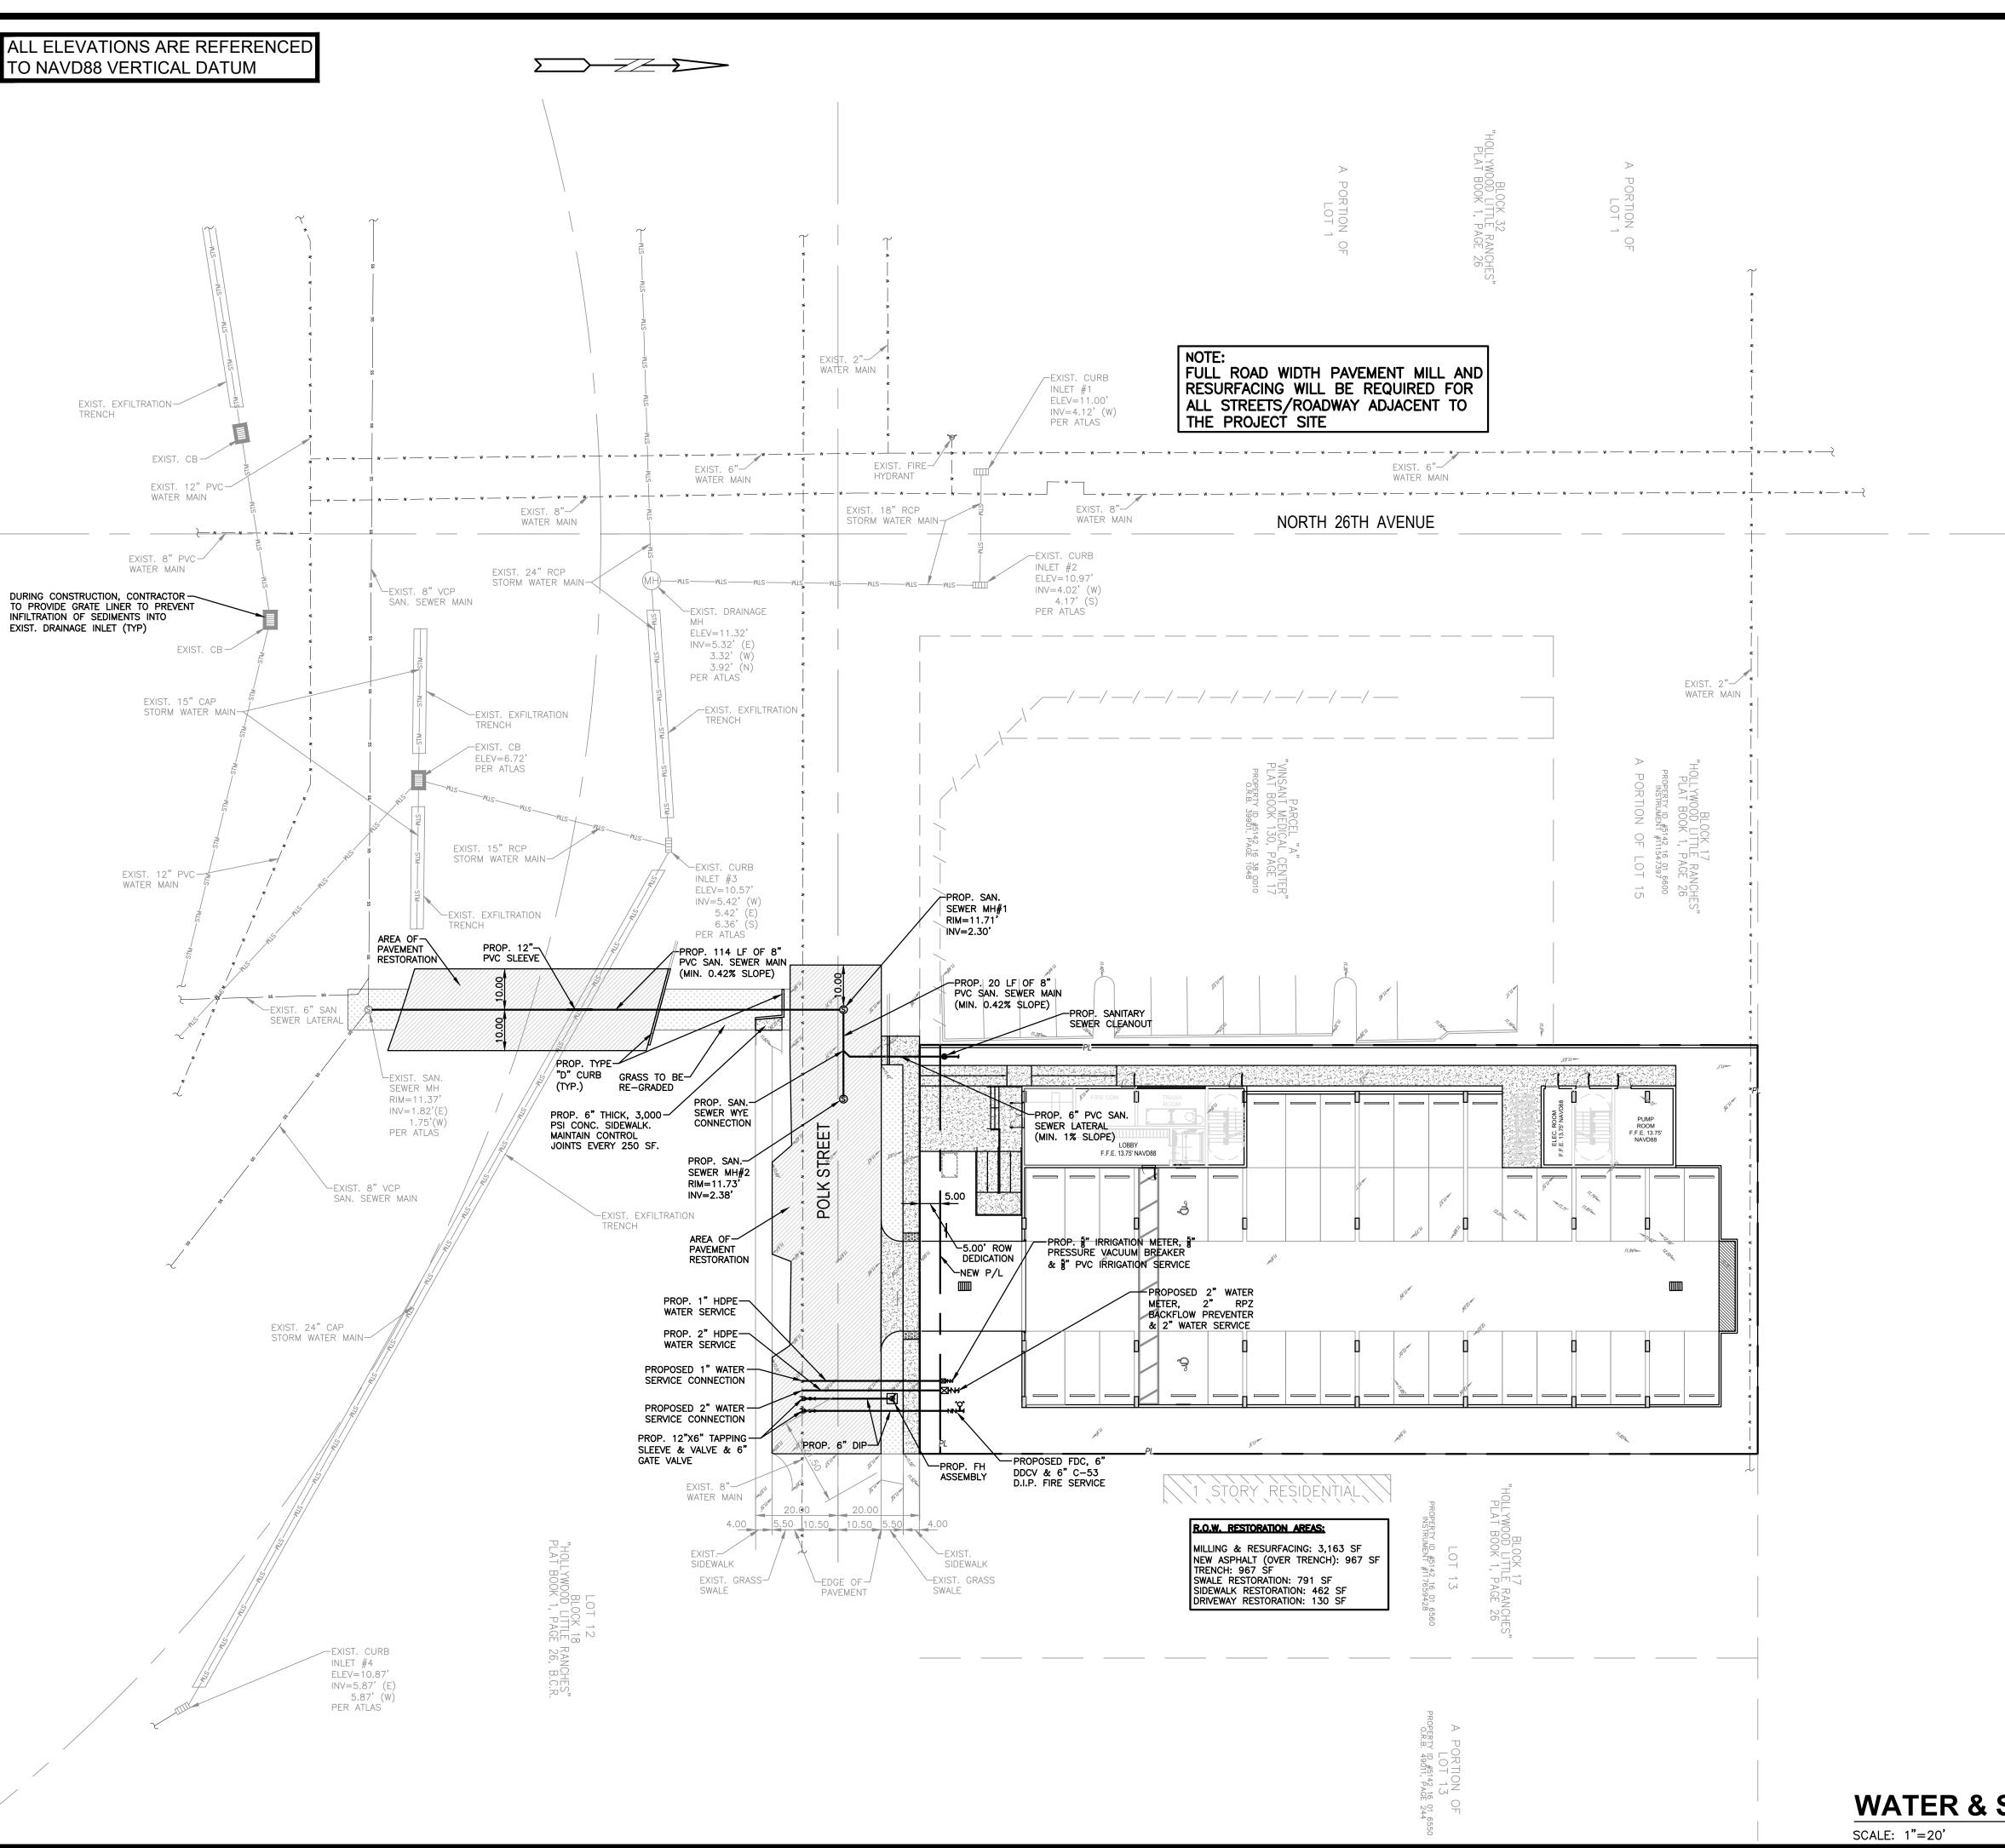

LEGEND

PROPOSED CONCRETE PROPOSED ASPHALT PROPOSED GRADE EXISTING ELEVATION



PROPOSED CATCH BASIN EXISTING CATCH BASIN PROPOSED WATER METER

EXISTING WATER METER

EXISTING WATER VALVE PROPOSED BFP DEVICE EXISTING SAN. SEWER MH EXISTING FIRE HYDRANT

TME

P.E.#:76036

DATE: 8/29/23 SCALE: 1"=20'

SHEET NO .: 6 OF 11 PROJECT NO.: 23-40

WATER & SEWER PLAN & DETAILS

FIRE DEPT. NOTES:

633.102.

PROJECT INFO:

WATER DEMAND

WASTEWATER DEMAND

• 33 RESIDENTIAL UNITS

I. UNDERGROUND FIRE MAIN WORK WILL BE

WATER & SEWER DEMAND CALCULATIONS:

RESIDENTIAL UNIT FACTORS PUBLICATIONS)

ON ANY ELECTRONIC COPIES.

OR V LICENSE AS DEFINED BY FLORIDA STATUTE

(33 RESIDENTIAL UNITS)X(141 GPD/UNIT)=4,653 GPD

(33 RESIDENTIAL UNITS)X(100 GPD/UNIT)=3,300 GPD

(PER BROWARD COUNTY WATER & WASTEWATER ENGINEERING

DIVISION'S GUIDELINE FOR DETERMINING ABILITY TO PROVIDE POTABLE WATER & WASTEWATER SERVICE AND EQUIVALENT

No 76036

3-4-24

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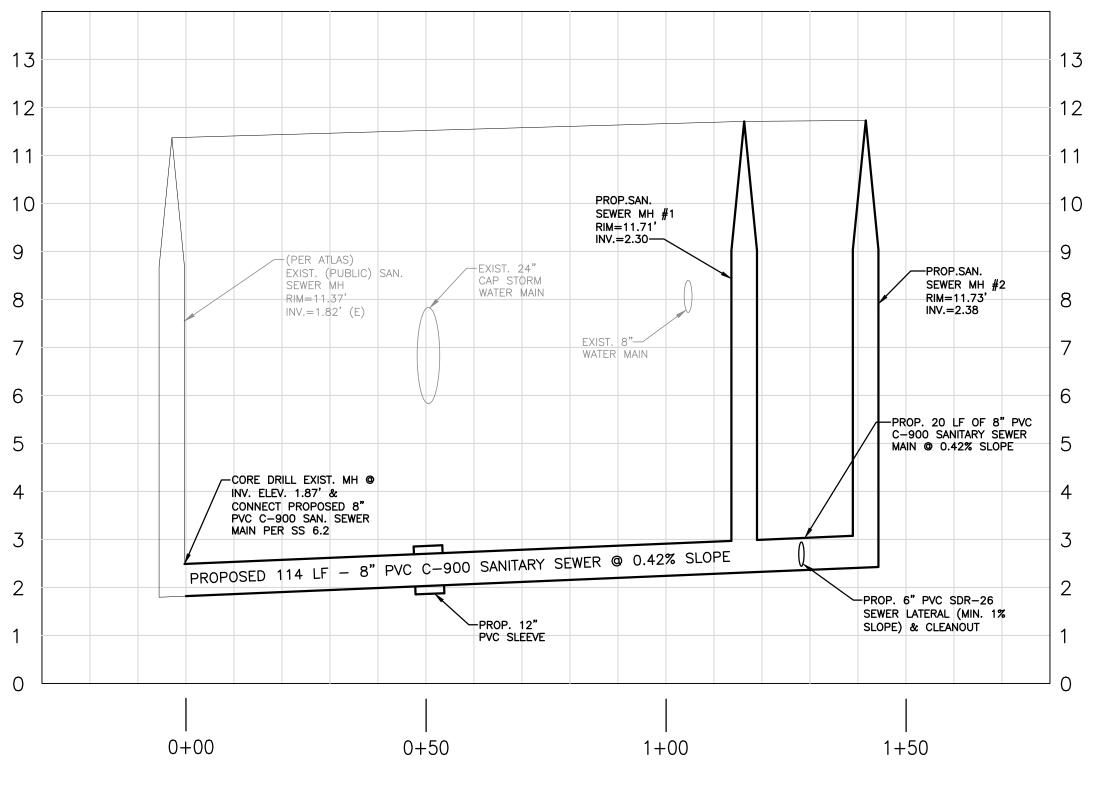
SIGNED AND SEALED AND THE SIGNATURE MUST BE VERIFIED

COMPLETED BY A CONTRACTOR HOLDING A CLASS I,II,

2. WATER SUPPLY AND ANY NEW HYDRANTS SHALL BE

IN PLACE PRIOR TO ACCUMULATION OF COMBUSTIBLE

MATERIALS PER NFPA 1 (2018 Ed.) SECTION 16.4.3.1.



PROPOSED SANITARY SEWER MAIN PROFILE

SCALE: 1"=20'-0" HORZ. 1"=2'-0" VERT.

LEGEND

PROPOSED CONCRETE PROPOSED ASPHALT

8.90 PROPOSED GRADE EXISTING ELEVATION

> PROPOSED CATCH BASIN EXISTING CATCH BASIN

PROPOSED WATER METER EXISTING WATER METER

EXISTING WATER VALVE

PROPOSED BFP DEVICE EXISTING SAN. SEWER MH EXISTING FIRE HYDRANT



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SANITARY SEWER MAIN PROFILE

SCALE: 1"=20'

P.E.#:76036

DATE: 8/29/23 SCALE: 1"=20'


7 OF 11

ENGINEERING FORD ZEPHYR, P.E. HOLLYWOOD, FL (786)302-7693

ZEPHY

APARTMENTS STREET D, FL 33020

PROJECT NO.: 23-40

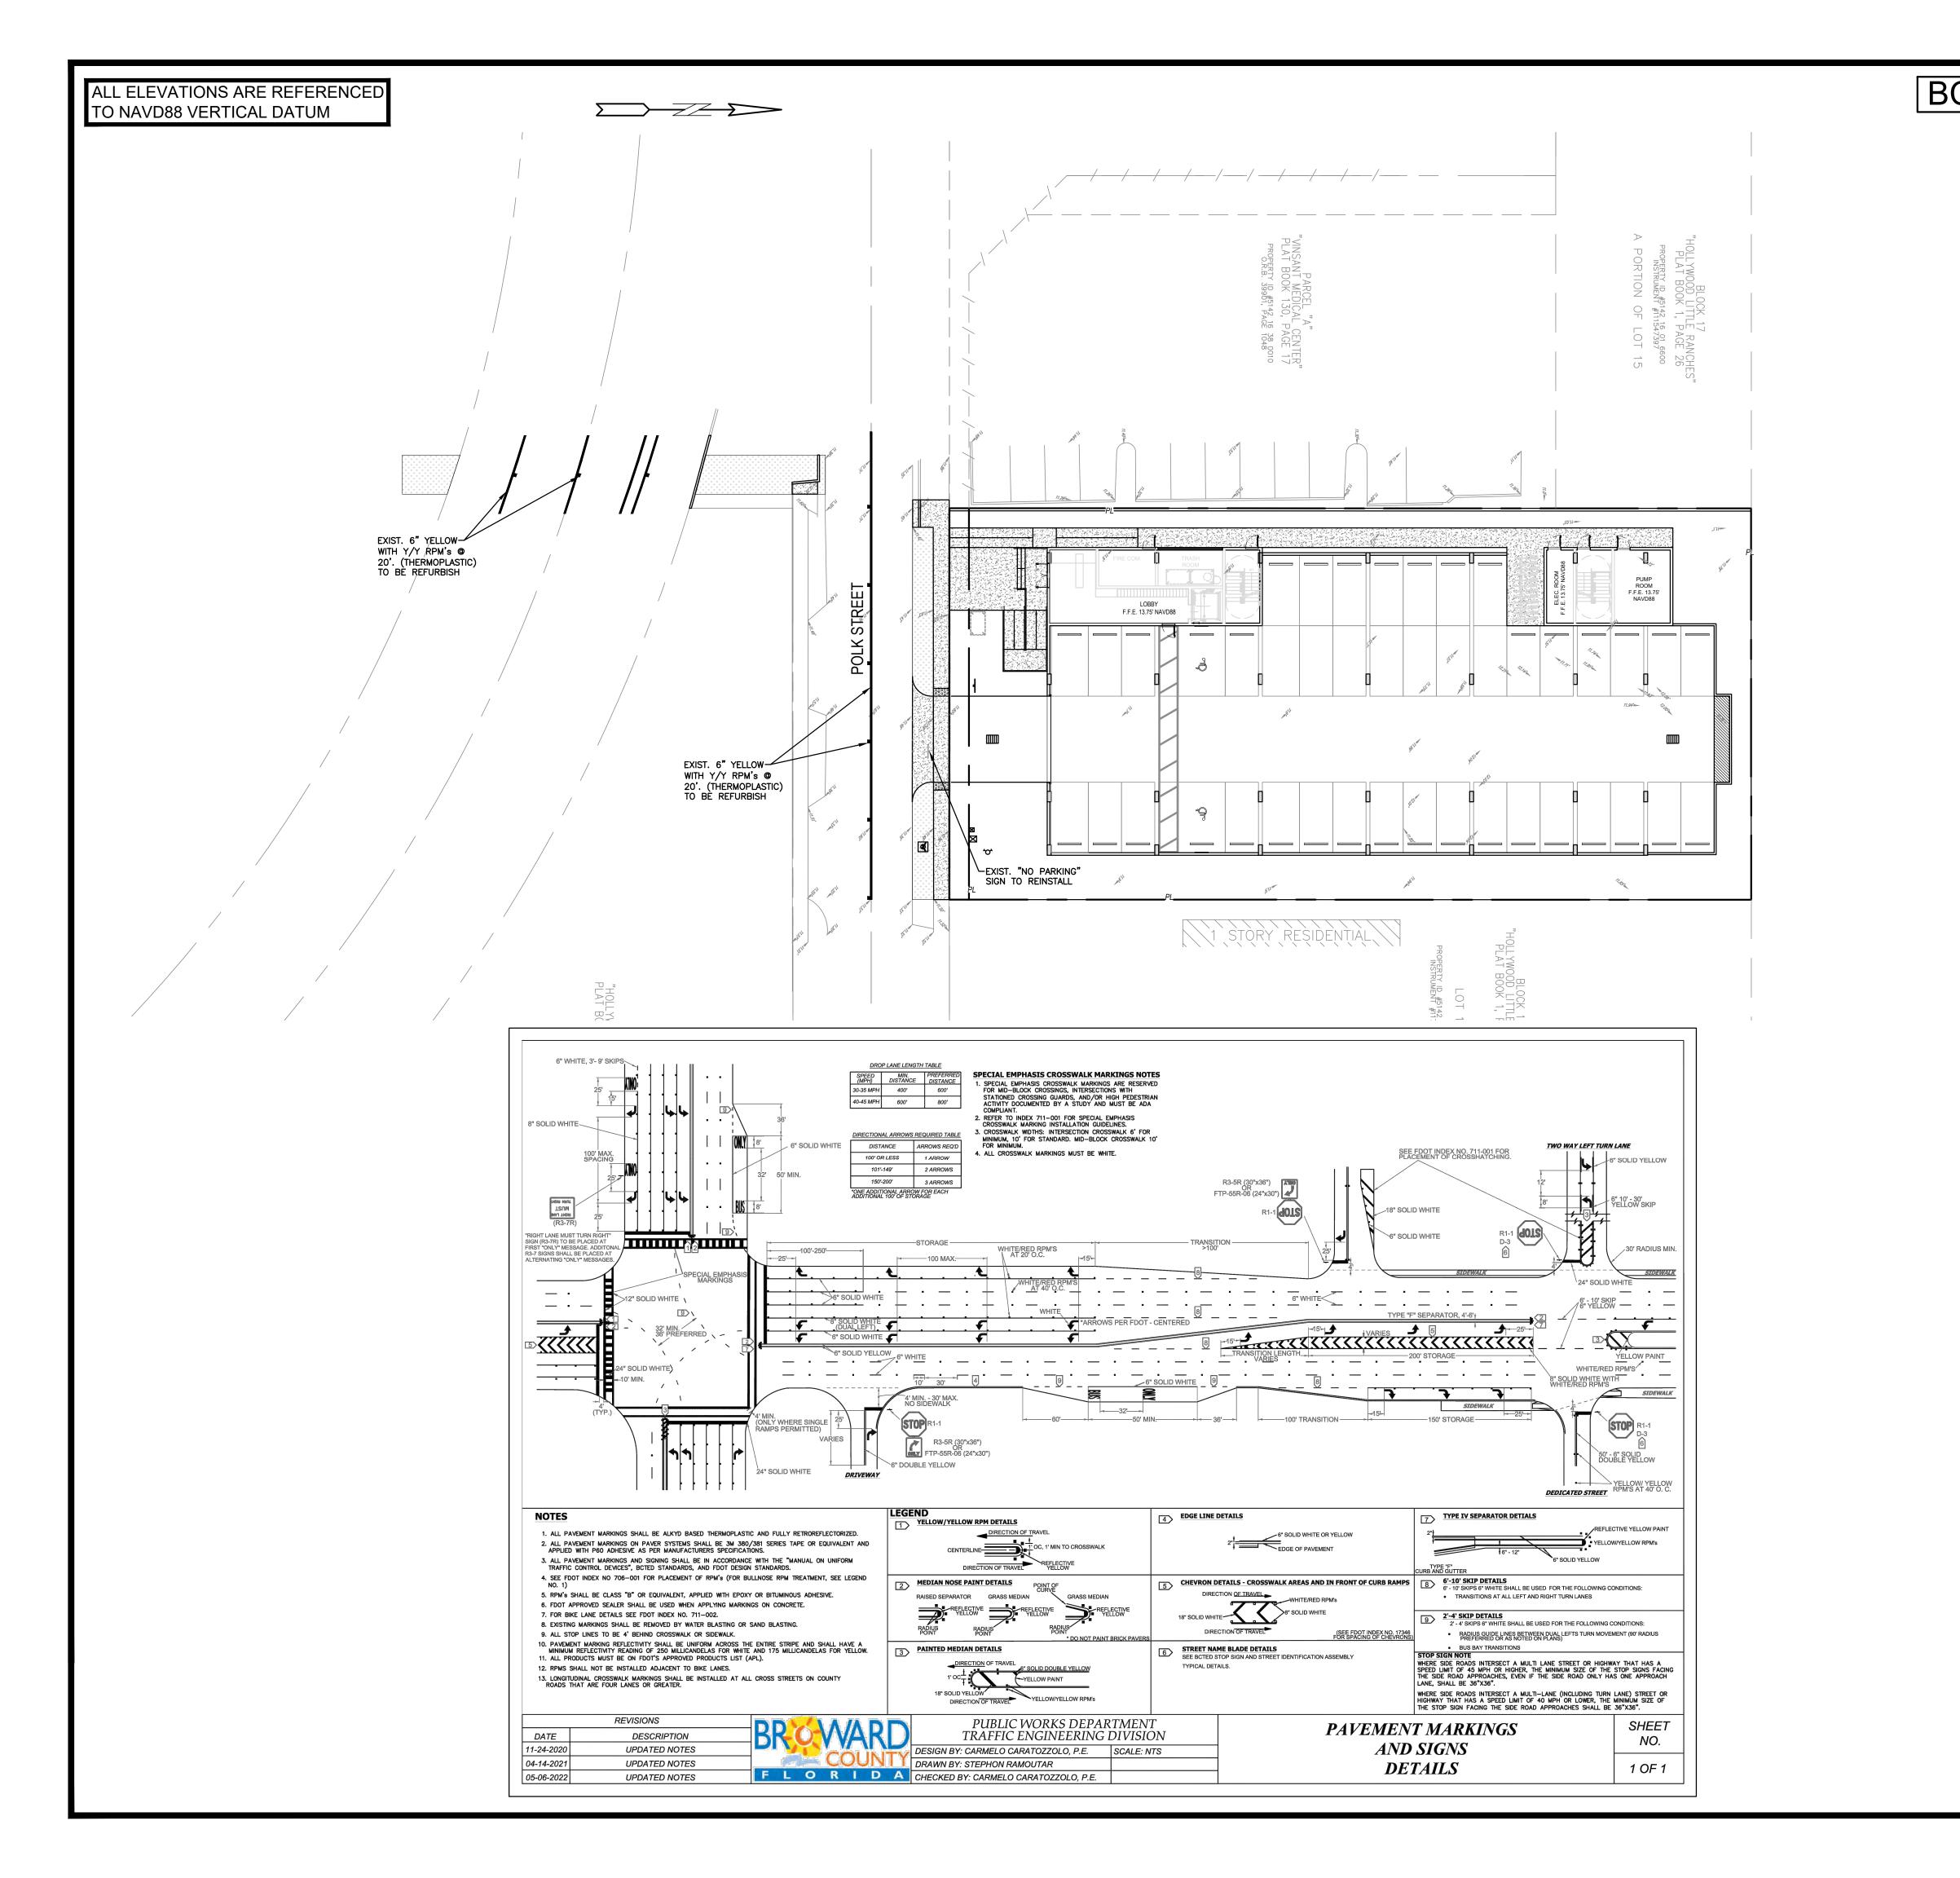

BCTED NO. XXXXXXX

LEGEND PROPOSED CONCRETE PROPOSED ASPHALT PROPOSED GRADE EXISTING ELEVATION PROPOSED CATCH BASIN EXISTING CATCH BASIN PROPOSED WATER METER EXISTING WATER METER EXISTING WATER VALVE PROPOSED BFP DEVICE

EXISTING SAN. SEWER MH EXISTING FIRE HYDRANT

ENGINEERING DRD ZEPHYR, P.E.

ZEPHY

RTMEN

P.E.#:76036

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3-4-24


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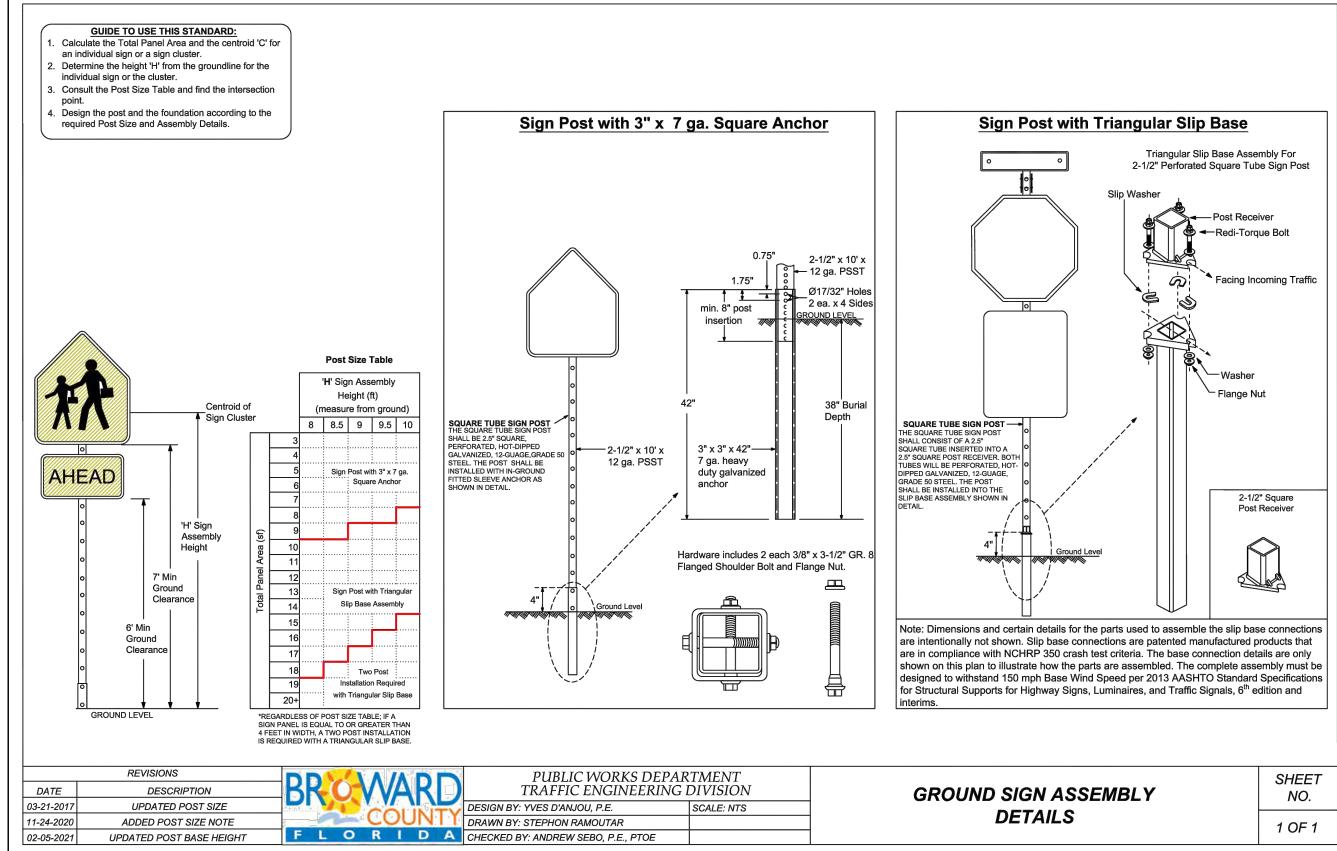
R.O.W. PMS PLAN & DETAILS


SCALE: 1"=20'


DATE: 8/29/23

8 OF 11 PROJECT NO.: 23-40



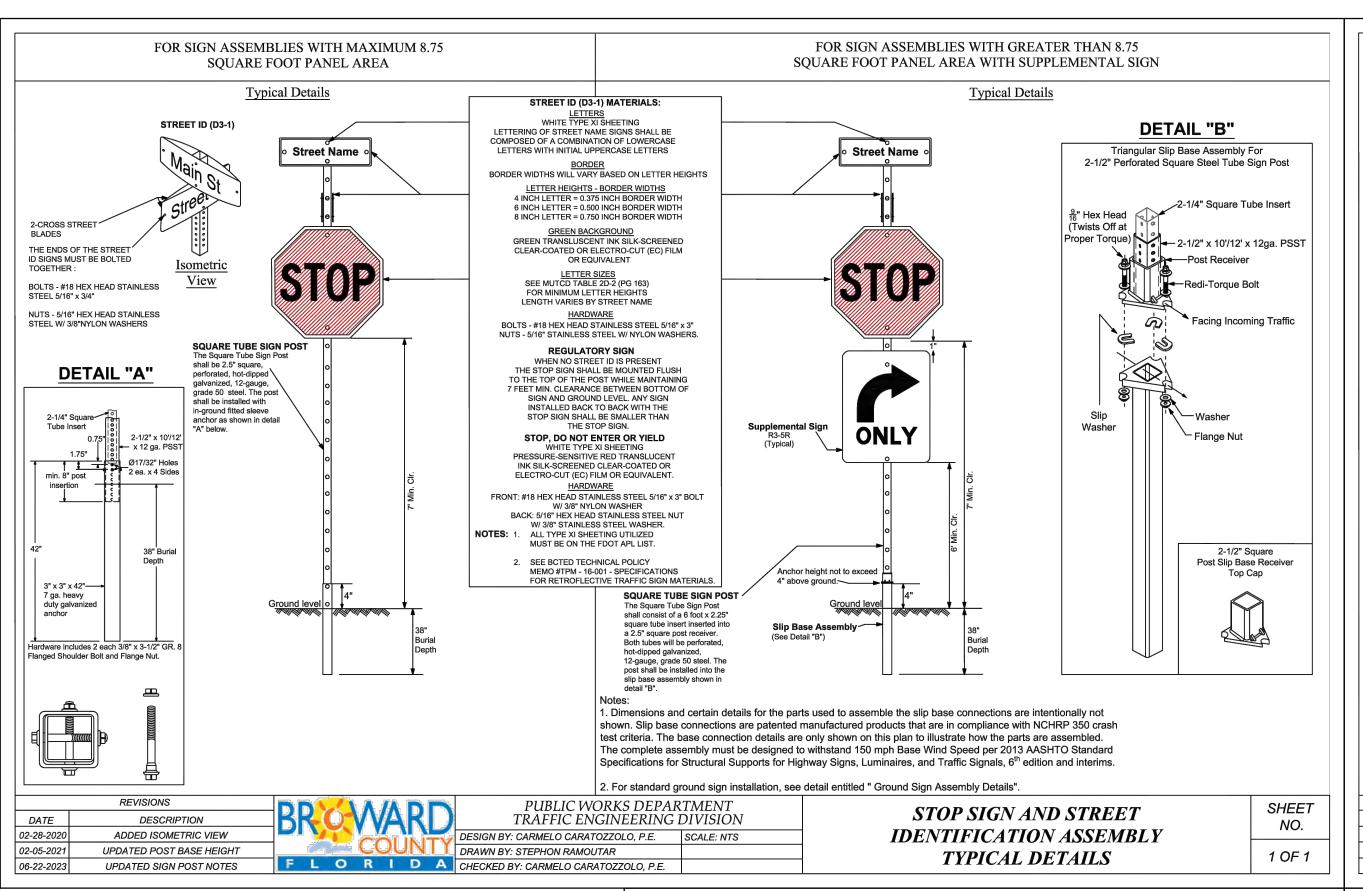

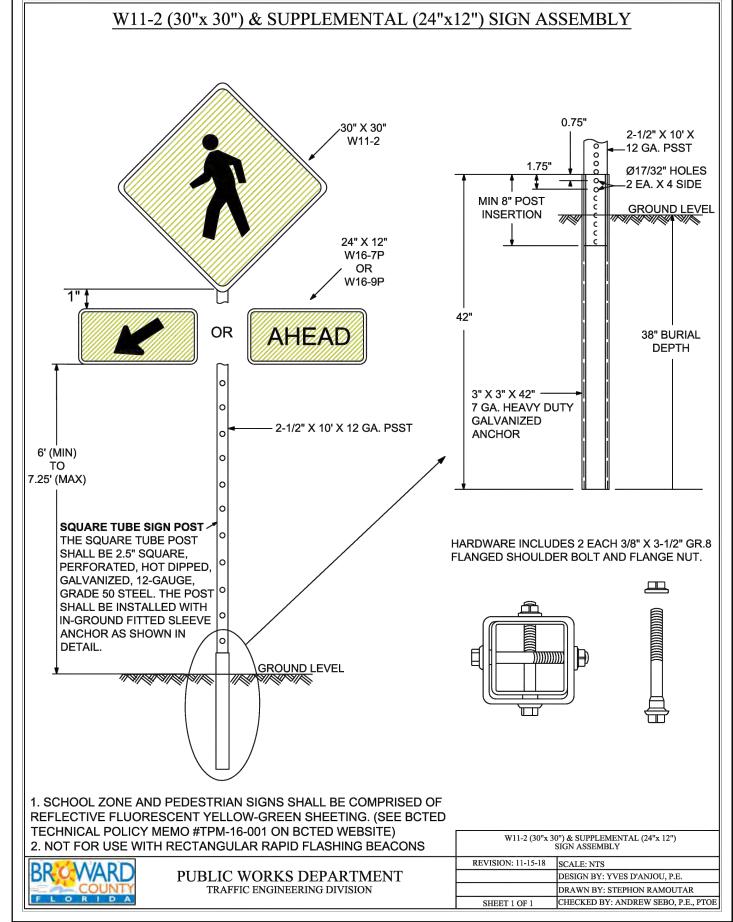

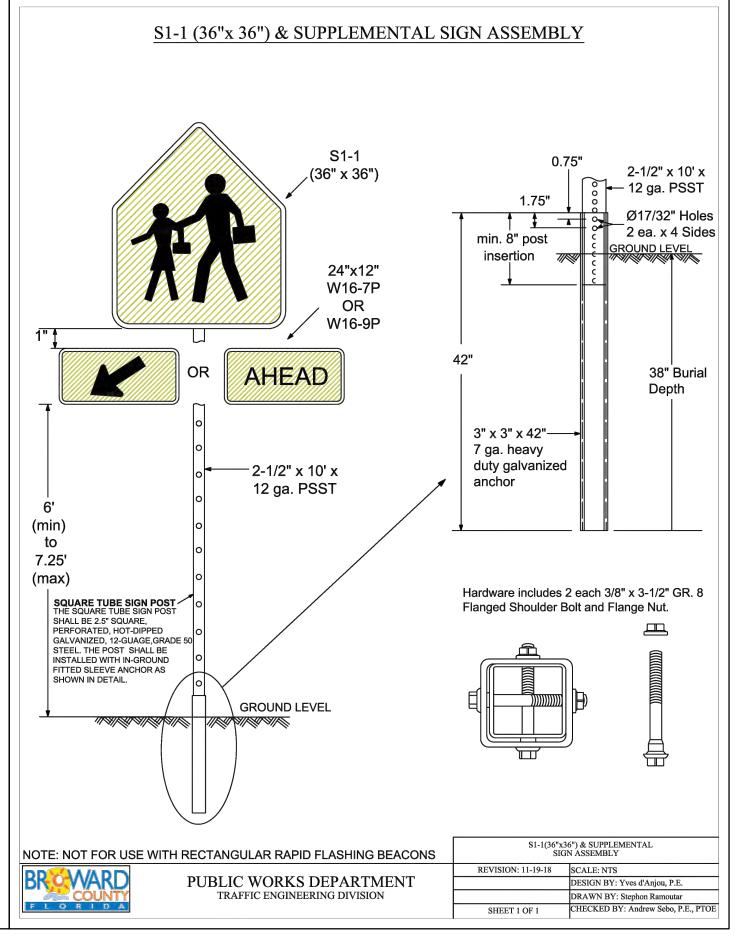



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R.O.W. PMS DETAILS

SCALE: N.T.S.

NO. DATE DESCRIPTION

MLFORD ZEPHYR, P.E.
HOLLYWOOD, FL
(786)302—7693

Ш

OLK STREET APARTMEN 2543 POLK STREET

P.E.#:76036

DATE: 8/29/23


SCALE: N.T.S.

SHEET NO.: 9 OF 11 PROJECT NO.: 23-40

DATE: 8/29/23 SCALE: N.T.S.

10 OF 11

PROJECT NO.: 23-40

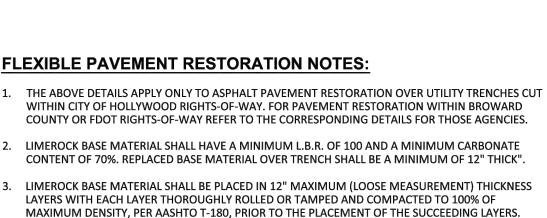

4. STABILIZED SUBGRADE MATERIAL SHALL BE GRANULAR AND SHALL HAVE A MINIMUM L.B.R. OF 40. 5. BACKFILL SHALL BE PLACED AND COMPACTED IN ACCORDANCE WITH THE PIPE LAYING CONDITION

6. ALL EDGES AND JOINTS OF EXISTING ASPHALT PAVEMENT SHALL BE SAW CUT TO STRAIGHT LINES,

TYPICAL SECTIONS IN DETAILS G-02 AND G-03, AND THE SPECIFICATIONS, BUT TESTING WILL BEGIN 12"

PARALLEL TO OR PERPENDICULAR TO THE ROADWAY, PRIOR TO THE RESURFACING.

7. RESURFACING MATERIAL SHALL BE FDOT SUPERPAVE, AND SHALL BE APPLIED A MINIMUM OF TWO INCH IN THICKNESS.


8. MILL AND BUTT JOINT TO EXISTING PAVEMENT.


9. IF THE TRENCH IS FILLED TEMPORARILY, IT SHALL BE COVERED WITH A 2" ASPHALTIC CONCRETE PATCH TO KEEP THE FILL MATERIAL FROM RAVELING UNTIL REPLACED WITH A PERMANENT PATCH.

10. REFER TO SPECIFICATIONS FOR DETAILED PROCEDURES.

11. WHERE THE UTILITY TRENCH CROSSES EXISTING ASPHALT DRIVEWAYS. THE LIMEROCK BASE THICKNESS MAY BE A MINIMUM OF 6 INCHES THICK. REGARDLESS OF THE EXTENT OF IMPACT, THE ENTIRE DRIVEWAY SURFACE BETWEEN THE EDGE OF THE ROADWAY PAVEMENT AND PROPERTY LINE OR FRONT OF SIDEWALK SHALL BE OVERLAID USING 2-INCH THICK MINIMUM ASPHALTIC CONCRETE SURFACE COURSE WHERE INDICATED ON THE PLANS OR AS DIRECTED BY THE CITY/ENGINEER.

ISSUED: 03/01/1994 DEPARTMENT OF PUBLIC UTILITIES STANDARD DETAIL REVISED: 11/06/2017 DRAWN: EAM APPROVED: XXX REVISED: 11/06/2017 ORAWING NO. G-12					
FLEXIBLE PAVEIVIENT RESTORATION	OF HOLLI WOOD FILE	ISSUED:	03/01/1994	DEPARTMENT OF PUBLIC UTILITIES STANDARD DETAIL	REVISED: 11/06/201
APPROVED: XXX NOTES G-12	DIAMOND 90	DRAWN:	EAM	FLEXIBLE PAVEMENT RESTORATION	DRAWING NO.
	GOLD COAST	APPROVE	D: XXX	NOTES	G-12

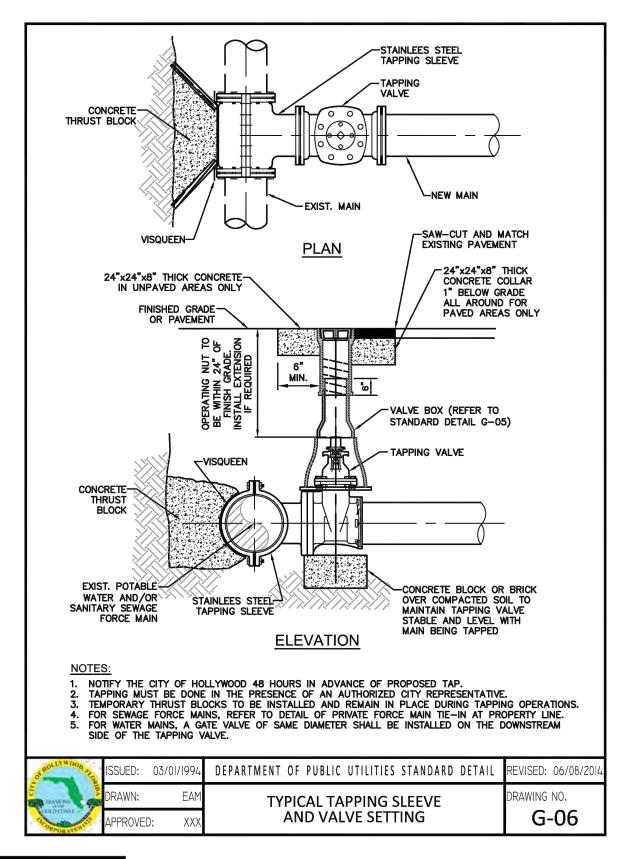

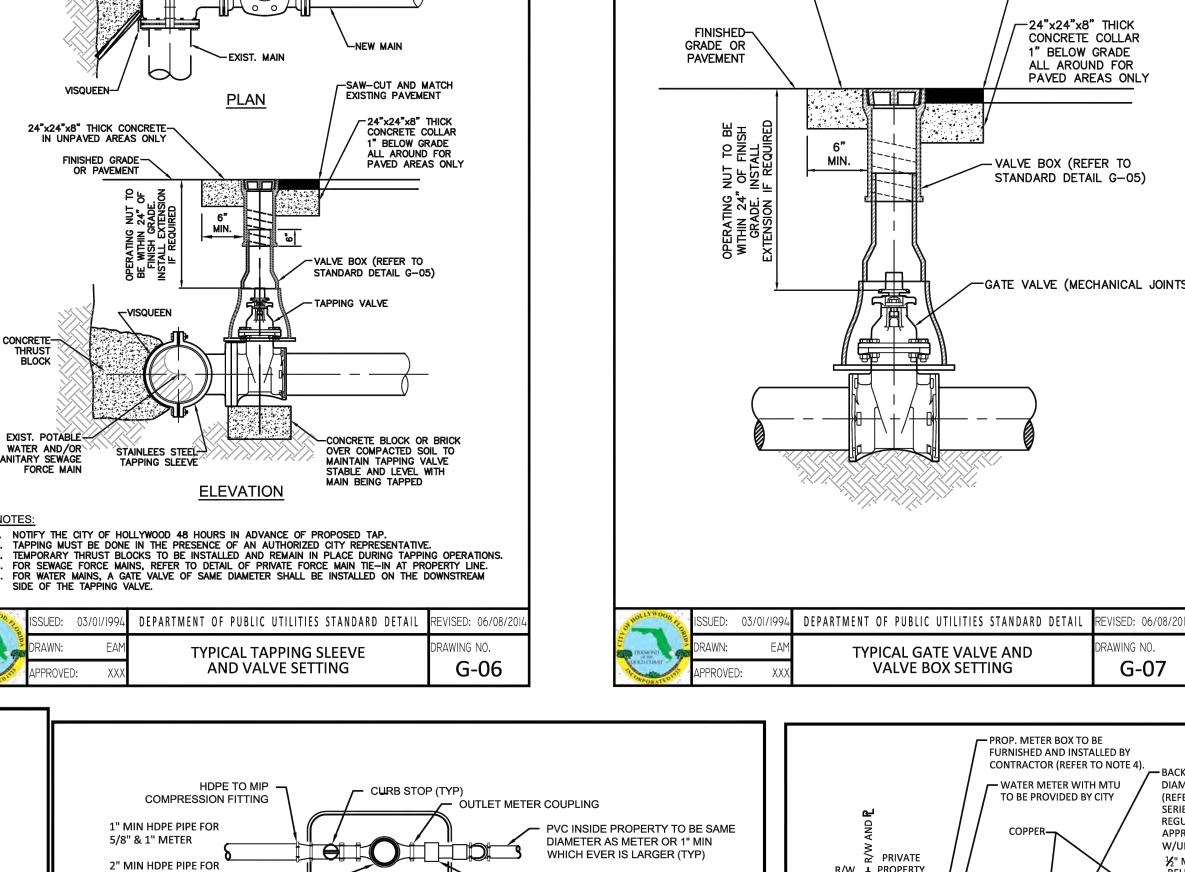


24"x24"x8" THICK-

CONCRETE COLLAR

UNPAVED AREAS ONLY

ALL AROUND FOR

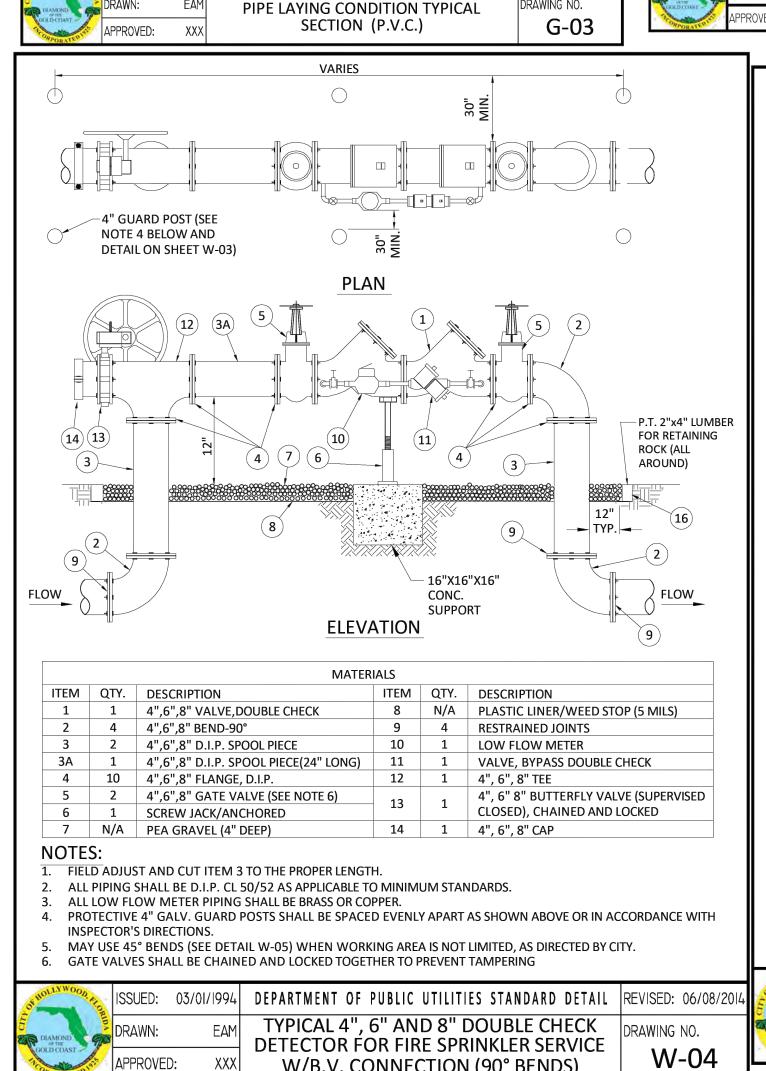

W/B.V. CONNECTION (90° BENDS)

FOR PAVEMENT RESTORATION

CITY OF HOLLYWOOD PAVEMENT

REFER TO FDOT, BROWARD COUNTY PUBLIC WORKS, OF

BEDDING MATERIAL PLACED UP TO SPRINGLINF OF PIPE

AWING NO.

(SEE NOTE 1 BELOW).

- FLAT OR RESTORED

TRENCH BOTTOM

RESTORATION DETAILS

BOTTOM OF ROADWAY BASE

BACKFILL

HAUNCHING

DELETERIOUS MATERIALS.

PIPE O.D. + 2' MAXIMUM

PIPE O.D. + 1' MINIMUM

TRENCH WIDTH

1. WHEN PIPE INSTALLATION IS ABOVE THE GROUND WATER TABLE ELEVATION, OR

MATERIAL, WOOD, TRASH, SAND, LOAM, CLAY, EXCESS FINES, AND OTHER

ANY PIPE IS LAID. FOR ADDITIONAL MATERIAL SPECIFICATIONS REFER TO SPECIFICATION SECTION 02222, "EXCAVATION AND BACKFILL FOR UTILITIES". 3. DENSITY TESTING SHALL BE IN ACCORDANCE WITH AASHTO T-180 AND ASTM

4. BACKFILL TO COMPLY WITH FDOT DESIGN STANDARD 125-8.

BEDDING SHALL BE WELL GRADED, WASHED CRUSHED STONE (OR DRAINFIELD LIMEROCK). CRUSHED STONE SHALL CONSIST OF HARD, DURABLE, SUB-ANGULAR

WHENEVER BEDDING COPPER PIPE UNDER ANY CONDITION, BEDDING MATERIAL SHALL BE CLEAN SANDY SOIL IF AVAILABLE WITHIN THE LIMITS OF CONSTRUCTION. IMPORTED

PARTICLES OF PROPER SIZE AND GRADATION, AND SHALL BE FREE FROM ORGANIC

|ISSUED: 03/01/1994| DEPARTMENT OF PUBLIC UTILITIES STANDARD DETAIL |REVISED: 06/08/20

PLACED IN LAYERS NOT

EXCEED 12" IN THICKNESS. EACH

LAYER SHALL BE COMPACTED T

100% OF MAXIMUM DRY DENSIT


ACED IN LAYERS NOT T

EXCEED 6" IN THICKNESS.


EACH LAYER SHALL B

MAXIMUM DRY DENSITY

OR EXISTING GROUND

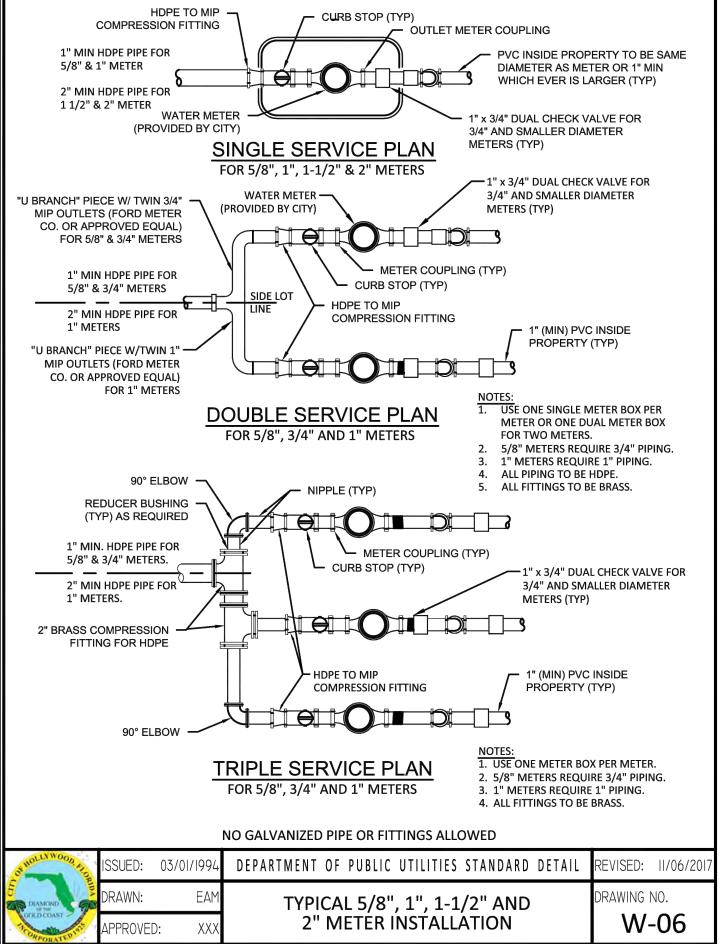

	90° ELE		RIPLE SERVICE PLAN FOR 5/8", 3/4" AND 1" METERS NOTES: 1. USE ONE ME 2. 5/8" METERS 3. 1" METERS R 4. ALL FITTINGS	S REQUII REQUIRE	RE 3/4" PIPIN 1" PIPING.	
	_		NO GALVANIZED PIPE OR FITTINGS ALLOWED			
OLLY WOOD, KIC	ISSUED:	03/01/1994	DEPARTMENT OF PUBLIC UTILITIES STANDARD DE	TAIL	REVISED:	11/06/2017
DIAMOND STEE	DRAWN:	EAM	TYPICAL 5/8", 1", 1-1/2" AND		DRAWING 1	٧٥.
ORPORATEO INT.	APPROVED	: XXX	2" METER INSTALLATION		W-	-06

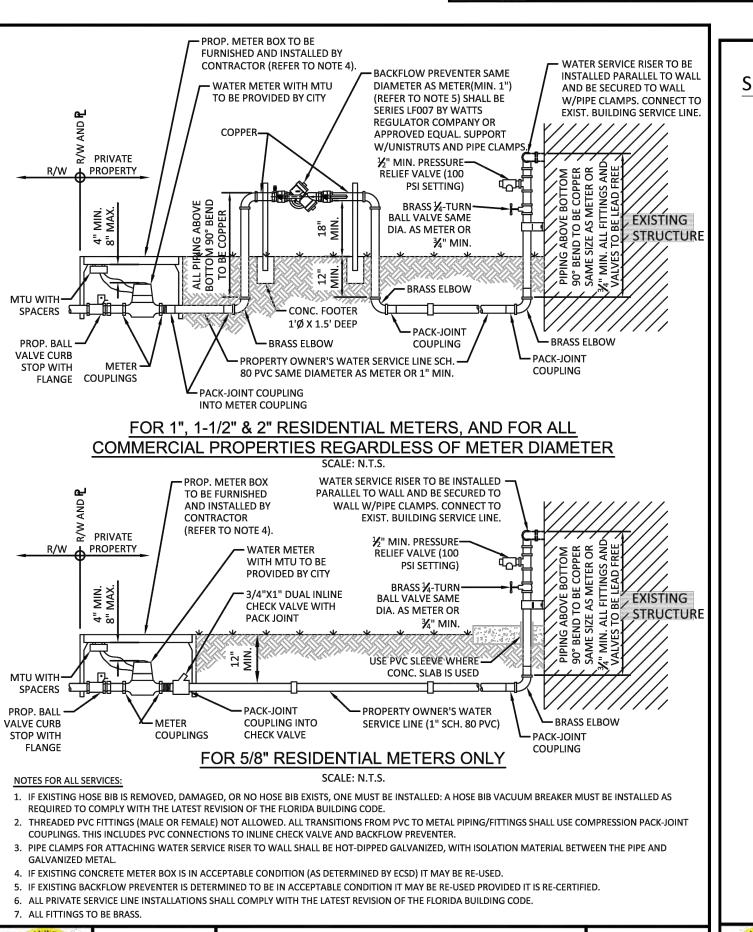

REVISED: 06/08/2

G-07

RAWING NO.

—SAW-CUT AND MATCH

EXISTING PAVEMENT

1,000 FEOR	ISSUED:	03/01/1994	DEPARTMENT OF PUBLIC UTILITIES STANDARD DETAIL	REVISED: (02/14/2
HOND 9	DRAWN:	EAM	TYPICAL WATER SERVICE FROM METER TO STRUCTURE FOR 5/8"	DRAWING N	١٥.
ORATE DIO	APPROVED	: XXX	THROUGH 2" METERS	W-	10

SEWER NOTES:

- 1. THE MINIMUM DEPTH OF COVER OVER D.I.P. SANITARY SEWER GRAVITY OR FORCE MAINS IS 30". THE MINIMUM DEPTH OF COVER OVER PVC SANITARY SEWER OR FORCE MAINS IS 36".
- 2. ALL CONNECTIONS TO EXISTING MAINS SHALL BE THE RESPONSIBILITY OF THE CONTRACTOR.
- 3. LEAKAGE TESTS AND ALIGNMENT (LAMPING) TESTS SHALL BE PERFORMED ON ALL NEW SEWER LINES UP TO THE CONNECTION POINT WITH THE EXISTING SEWER SYSTEM. THESE TESTS SHALL BE REQUESTED AND PAID FOR BY THE
- . LAMPING TESTS SHALL BE PERFORMED ON GRAVITY SEWERS FROM MANHOLE TO MANHOLE UP TO AND INCLUDING THE POINT OF CONNECTION TO THE EXISTING SEWER SYSTEM.
- . LEAKAGE TESTS SHALL BE PERFORMED ON ALL SEGMENTS OF A GRAVITY SEWER SYSTEM, INCLUDING SERVICE LATERALS AND MANHOLES, FOR A CONTINUOUS PERIOD OF NO LESS THAN 2 HOURS. AT THE END OF THE TEST, THE TOTAL MEASURED LEAKAGE SHALL NOT EXCEED 100 GALLONS PER INCH OF PIPE DIAMETER PER MILE PER DAY FOR ANY SECTION OF THE SYSTEM, WITH ZERO ALLOWABLE LEAKAGE FOR LATERALS AND MANHOLES. AN EXFILTRATION OR INFILTRATION TEST SHALL BE PERFORMED WITH A MINIMUM POSITIVE HEAD OF 2 FEET ON THE SECTION BEING
- FORCE MAINS SHALL BE PRESSURE-TESTED IN ACCORDANCE WITH RULE 62-555.330 (FAC). THE PRESSURE TEST SHALL CONSIST OF HOLDING A TEST PRESSURE OF 150 PSI ON THE PIPELINE FOR A CONTINUOUS PERIOD OF 2 HOURS THE MAXIMUM ALLOWABLE LEAKAGE SHALL BE DETERMINED BY THE FOLLOWING FORMULA:

 $L = S \times D \times \sqrt{P}$

L = ALLOWABLE LEAKAGE FOR SYSTEM IN GALLONS PER HOUR

D = PIPE DIAMETER IN INCHES

S = LENGTH OF LINES IN LINEAL FEET P = AVERAGE TEST PRESSURE IN PSI

CONTRACTOR SHALL BE RESPONSIBLE FOR IDENTYFYING CONFLICTS WITH FORCE MAINS PLACED AT MINIMUM COVER. IN CASE OF CONFLICT, FORCE MAIN SHALL BE LOWERED TO PASS UNDER CONFLICTS WITH 12" MINIMUM SEPARATION FROM WATER MAINS AND 6" MINIMUM SEPARATION FROM OTHER UTILITIES. NO ADDITIONAL PAYMENT SHALL BE DUE TO CONTRACTOR FOR LOWERING THE MAIN OR THE ADDITIONAL FITTINGS USED THEREON.

. WHENEVER IT IS NECESSARY, IN THE INTEREST OF SAFETY, TO BRACE THE SIDES OF A TRENCH, THE CONTRACTOR SHALL FURNISH, PUT IN PLACE AND MAINTAIN SUCH SHEETING OR BRACING AS MAY BE NECESSARY TO SUPPORT THE SIDES OF THE EXCAVATION TO ENSURE PERSONNEL SAFETY, AND TO PREVENT MOVEMENT WHICH CAN IN ANY WAY DAMAGE THE WORK OR ENDANGER ADJACENT STRUCTURES. THE CONTRACTOR SHALL BE SOLELY RESPONSIBLE FOR THE SEQUENCE, METHODS AND MEANS OF CONSTRUCTION, AND FOR THE IMPLEMENTATION OF ALL OSHA AND OTHER SAFETY REQUIREMENTS.

03/01/1994 DEPARTMENT OF PUBLIC UTILITIES STANDARD DETAIL REVISED: 06/08/20 DRAWING NO. SANITARY SEWER MAIN **CONSTRUCTION NOTES** S-01




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SCALE: N.T.S.

3-4-24



2. SPILLWAYS SHALL BE CONSTRUCTED BETWEEN PIPES WITH DIFFERENT INVERT

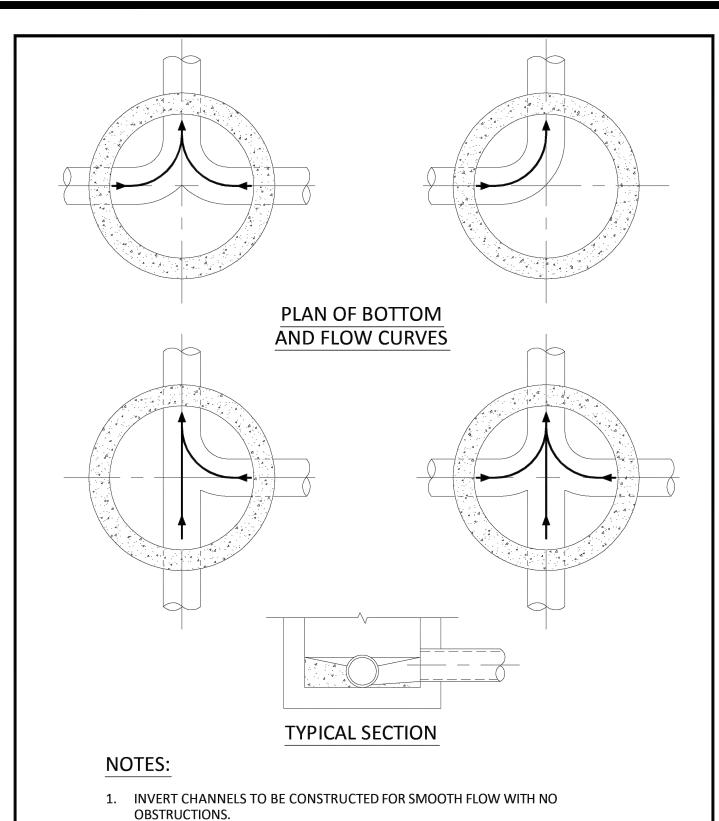4. WHEN FLOW LINE DEFLECTS MORE THAN 45°, A DROP OF 0.10' IS REQUIRED.

3. CHANNELS FOR FUTURE CONNECTIONS (STUBS) SHALL BE CONSTRUCTED FILLED WITH

MANHOLE FLOW PATTERNS


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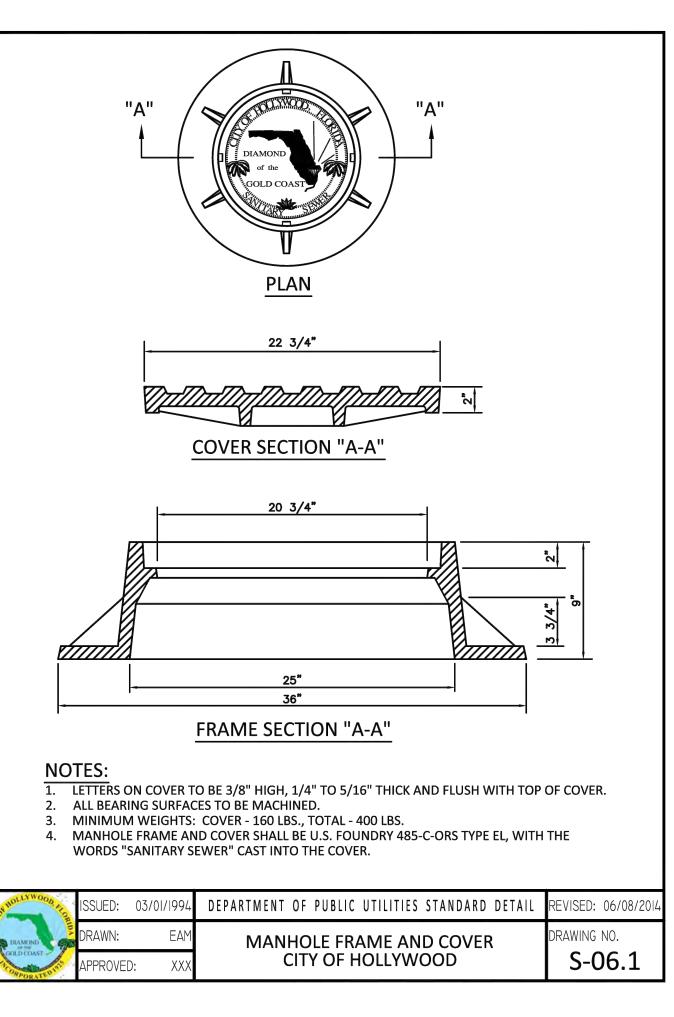
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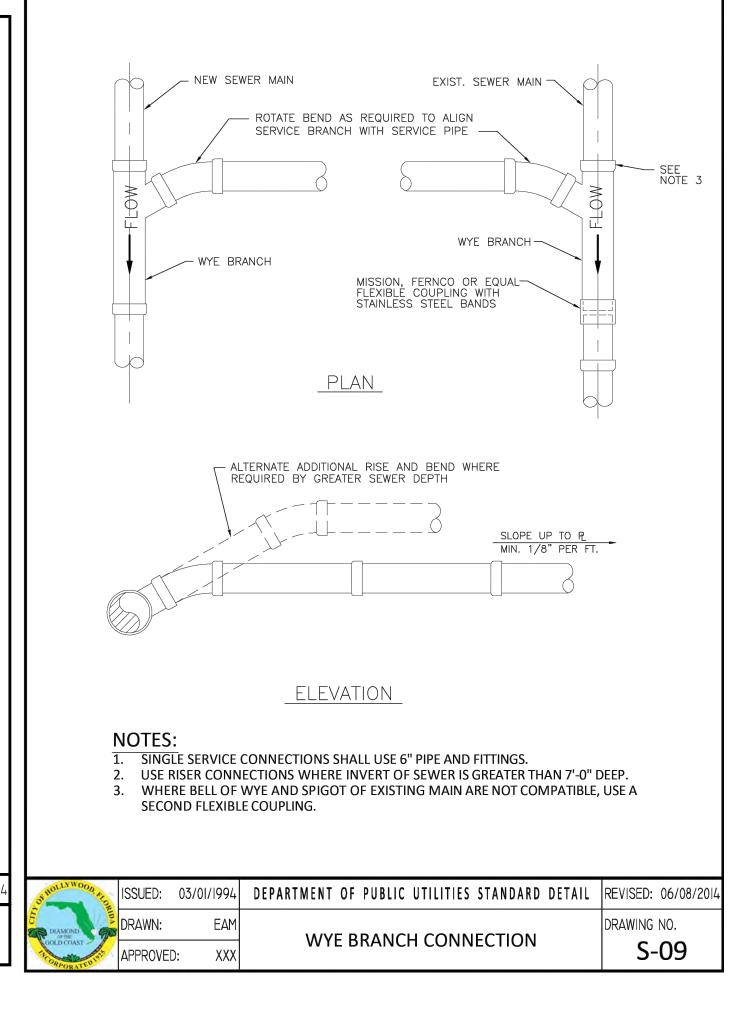
S-12


ELEVATIONS PROVIDING SMOOTH FLOWS.

SAND & COVERED WITH 1" OF MORTAR.






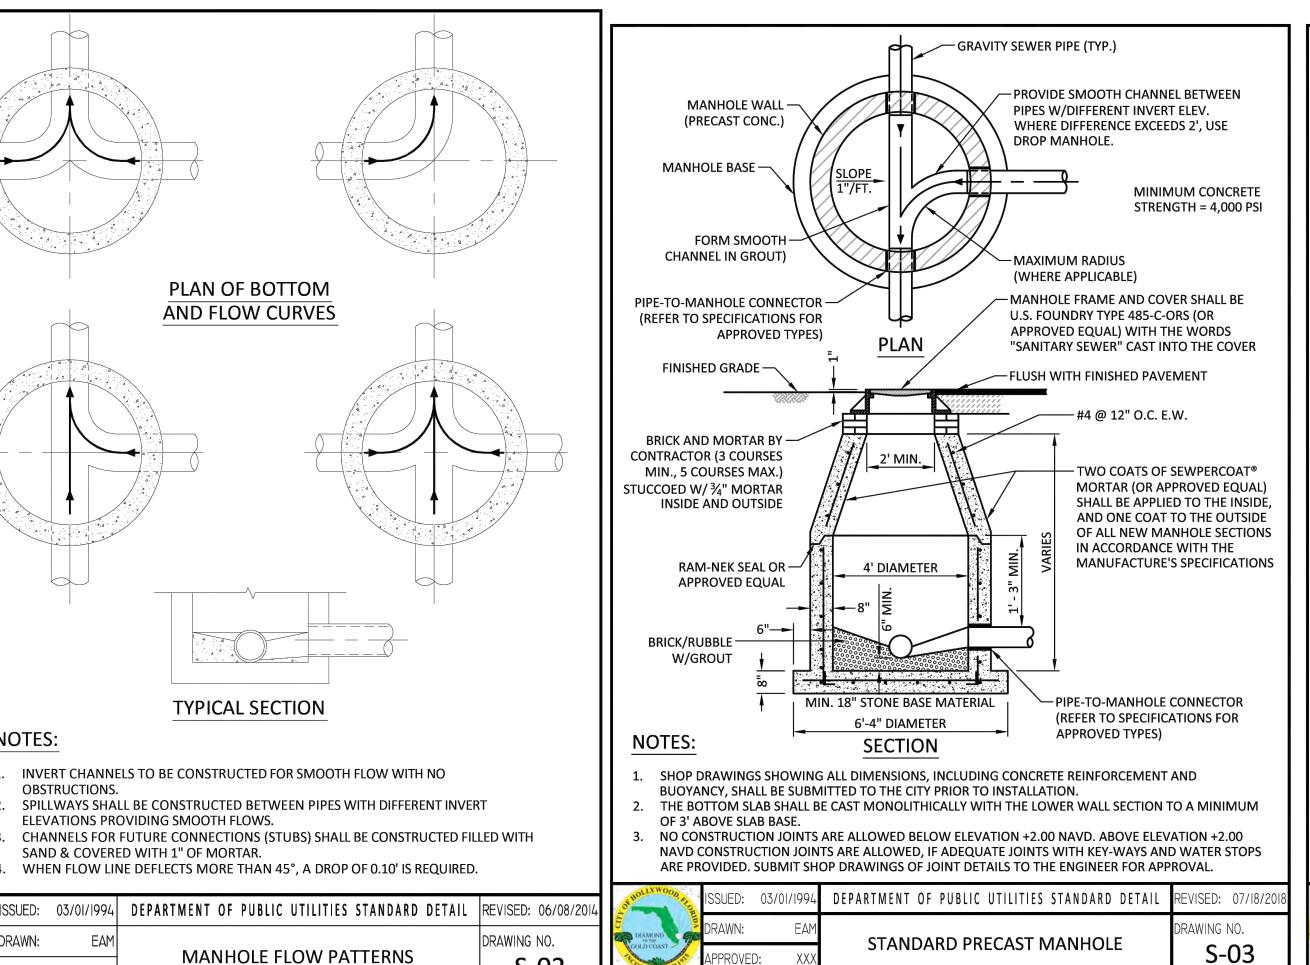


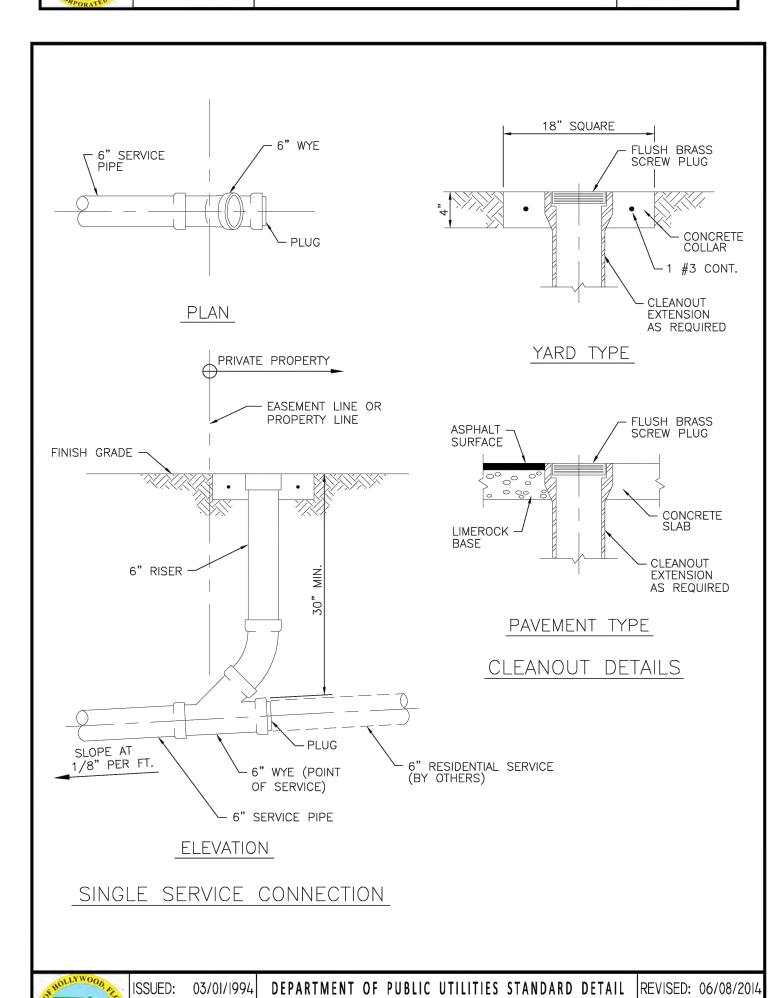


SEWER SERVICE CONNECTION AND

CLEANOUT AT PROPERTY LINE

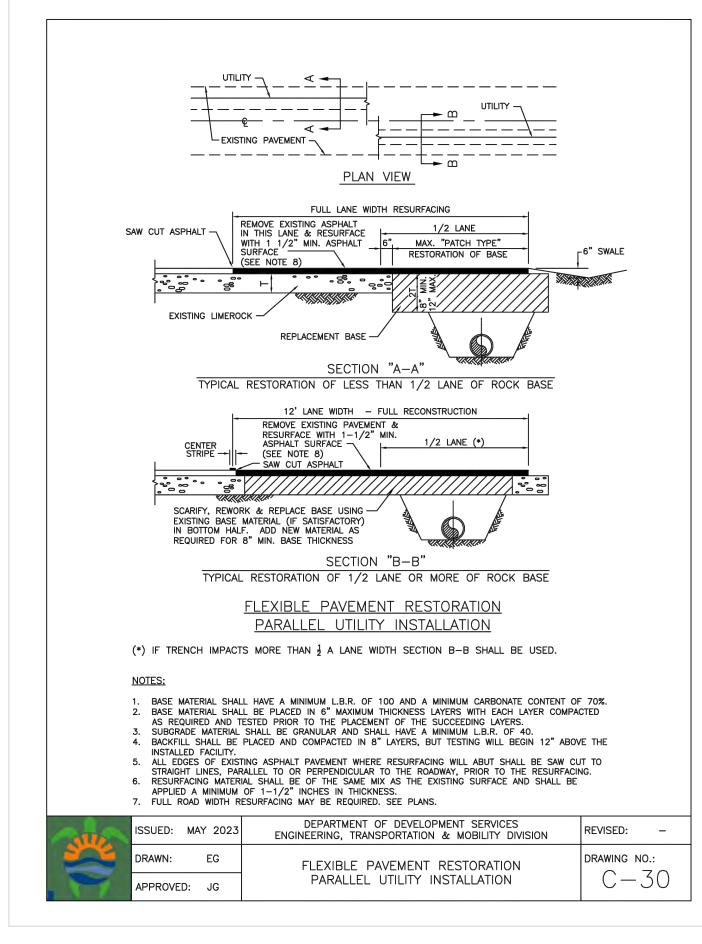

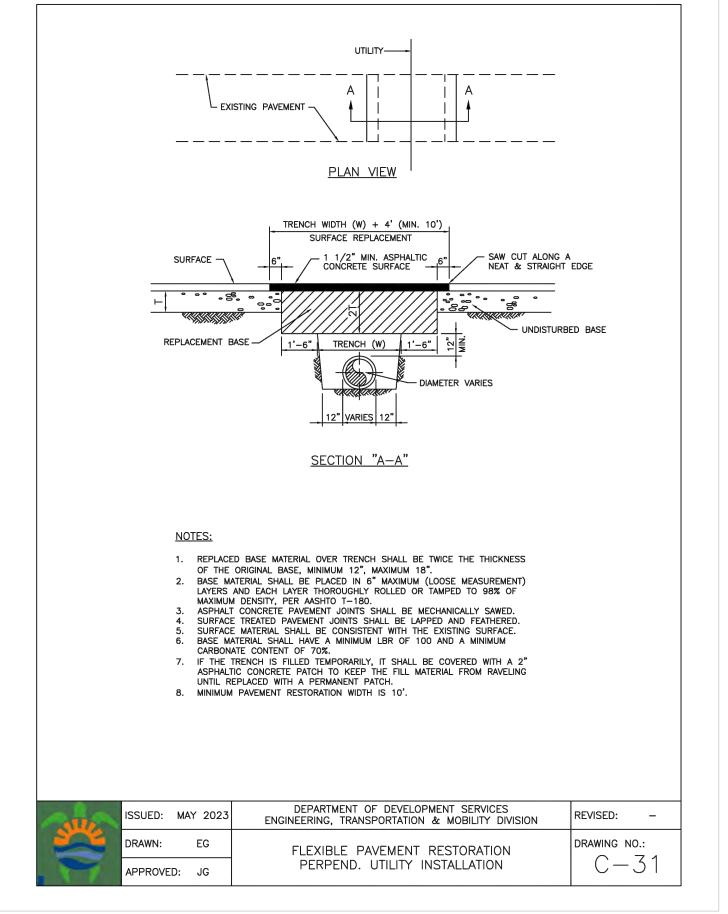


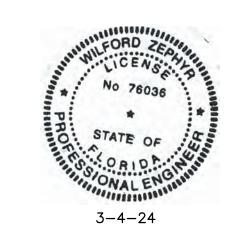

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UTILITIES DETAILS II



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P.E.#:76036 DATE: 8/29/23

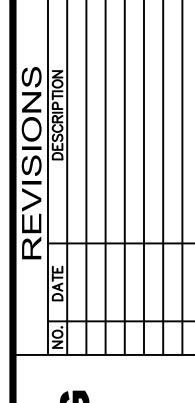SCALE: N.T.S. SHEET NO.:

11 OF 11 PROJECT NO.: 23-40



A Civil Engineering Firm
Tel: (786)302-7693 • Email: wilford@zephyrengineeringfl.com

January 24, 2024

FIRE FLOW CALCULATIONS POLK STREET APARTMENTS

2543 Polk Street Hollywood, FL 33020

These calculations are for a four-story building. The total area of the three (3) largest floors is 29,577 SF. The floors used for the fire flow calculations are as follow:

2nd Floor: 9,859 SF 3rd Floor: 9,859 SF 4th Floor: 9,859 SF

Fire Flow Area = 29,577 SF

Per NFPA 18.4, Fire Flow Requirements, the required fire flow for Type II (222) construction for the above-referenced fire flow area is 1,750 GPM.

Per NFPA 18.4.5.3.2, a reduction in required fire flow of 75% shall be permitted when the building is protected throughout by an approved automatic sprinkler system. The resulting fire flow may not be less than 1000 gpm.

(1,750 GPM)X0.75=1,312.50 GPM (fire flow credit for automatic sprinkler system)

(1,750 GPM) - (1,312.50 GPM) = 437.50 GPM

Fire flow required=1,000 GPM

Prepared by:

No 76036

STATE OF

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Wilford Zephyr, P.E., LEED AP, CFM

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