



# **GENERAL APPLICATION**

	A CONTRACT OF A SECOND CONTRAC	
APPLICATION DATE:		
2600 Hollywood Blvd Room 315 Hollywood, FL 33022	APPLICATION TYPE (CHECK AL Technical Advisory Committee Planning and Development Board City Commission	L THAT APPLIES):  Art in Public Places Committee  Historic Preservation Board  Administrative Approval
Tel: (954) 921-3471		
Email: Development@	PROPERTY INFORMATION	
Hollywoodfl.org		E ST & 2224 PIERCE ST, HOLLYWOOD FL 33020  ock(s): BLK 10 Subdivision: H' LITTLE RANCHES
SUBMISSION REQUIREMENTS:	Folio Number(s): 514216014040 & 51	4216014250
One set of signed & sealed plans (i.e. Architect or Engineer)	Zoning Classification: DH-2 (RAC)  Existing Property Use: RESIDENTIAL	Land Use Classification: RESIDENTIAL Sq Ft/Number of Units: 62 UNITS
One electronic <u>combined</u> PDF     submission (max. 25mb)	Is the request the result of a viol	ation notice? Yes No If yes, attach a copy of violation to the City before? If yes, check all that apply and provide File
Completed Application     Checklist		
Application fee	Explanation of Request: NEW CONS	STRUCTION, 62 UNIT, RENTAL APARTMENT BUILDING
	Phased Project: Yes ☐ No ☑ Nun	nber of Phases:
	Project	Proposal
	Units/rooms (# of units)	# UNITS: 62 #Rooms 90
NOTE:	Proposed Non-Residential Uses	F [S.F.)
This application must be completed in full	Open Space (% and SQ.FT.)	Required %: 20 (Area: 8,204 S.F.)
and submitted with all documents to be placed	Parking (# of spaces)	PARK. SPACES: (# 99 )
on a Board or Committee's agenda.	Height (# of stories)	(# STORIES) 4 ( 45 FT.)
The applicant is	Gross Floor Area (SQ. FT)	Lot(s) Gross Area ( -45,150 FT.)
responsible for obtain- ing the appropriate checklist for each type of application.	THE PROPERTY OF THE PROPERTY O	DILYWOOD BLVD, HOLLYWOOD FL 33020 ail Address: ROY@DREAMTEAMDEVELOPER.COM
<ul> <li>Applicant(s) or their authorized legal agent <u>must</u> be present at all Board or Committee</li> </ul>	Applicant JOSEPH B. KALLER Address: 2417 HOLLYWOOD BLVD, HO	Consultant ☑ Representative ☑ Tenant ☐
meetings.	Email Address: JOSEPH@KALLERARG	
	Email Address #2: JDIAZ@KALLERAR	
	Date of Purchase: 02-09-2021 Is	s there an option to purchase the Property? Yes No
	If Yes, Attach Copy of the Contract.	
OLIEK WERE FOR FORMS LEBECKLETS X		omissions only) : CUTRO ASSOCIATES
	C mail Address sutroplaning@ushes	An ma



# **GENERAL APPLICATION**

### CERTIFICATION OF COMPLIANCE WITH APPLICABLE REGULATIONS

The applicant/owner(s) signature certifies that he/she has been made aware of the criteria, regulations and guidelines applicable to the request. This information can be obtained in Room 315 of City Hall or on our website at <a href="www.hollywoodfl.org">www.hollywoodfl.org</a>. The owner(s) further certifies that when required by applicable law, including but not limited to the City's Zoning and Land Development Regulations, they will post the site with a sign provided by the Office of Planning and Development Services. The owner(s) will photograph the sign the day of posting and submit photographs to the Office of Planning and Development Services as required by applicable law. Failure to post the sign will result in violation of State and Municipal Notification Requirements and Laws.

(I)(We) certify that (I) (we) understand and will comply with the provisions and regulations of the City's Zoning and Land Development Regulations, Design Guidelines, Design Guidelines for Historic Properties and City's Comprehensive Plan as they apply to this project. (I)(We) further certify that the above statements and drawings made on any paper or plans submitted herewith are true to the best of (my)(our) knowledge. (I)(We) understand that the application and attachments become part of the official public records of the City and are not returnable.

Signature of Current Owner	Date: 04-15-2025
PRINT NAME: LEON ROY HAUSMANN	Date: 04-15-2025
Signature of Consultant/Representative: Asly Black	Date: 04-15-2025
PRINT NAME: JOSEPH B. KALLER	Date: 04-15-2025
Signature of Tenant:	Date:
PRINT NAME:	Date:
I am the current owner of the described real property and that I am aware of the PLANNING & DEVELOPMENT BOARD REVIEW to my property, which is hereby made JOSEPH B. KALLER to be my legal representative before the PLANNING Committee) relative to all matters concerning this application.	by me or I am hereby authorizing
Sworn to and subscribed before me	the state of the s
Notary Public - State of Florida Commission # HH 146030  My Comm. Expires Jun 27, 2025  LEO	nature of Current Owner
y bonded through National Notace Acces	t Name
State of Florida	and Identification
My Commission Expires: (Check One) Personally known to me; OR Production	ced identification



### **Kaller**Architecture

May 13, 2025

City of Hollywood 2600 Hollywood Boulevard Hollywood, FL 33022

Reference: Fillmore Street Apartments
2231 Fillmore Street & 2224 Pierce Street
Hollywood, Florida
File #23-DP-45

To Whom It May Concern,

The following is our project description summary for the above referenced Residential Building.

This proposed residential development consists of a modern mid-rise building with 62 units on a 0.94-acre site (41,020 SF) (Lot 19 and Lot 4, Block 10). The project reaches the allowed 45-foot height and features a clean, contemporary design with large windows, private balconies, and a mix of warm materials.

Total amount of units: 62

UNIT MIX	QTY.	%
3 BEDROOM UNITS	6	9.68
2+DEN BEDROOM UNITS	13	20.97
2 BEDROOM UNITS	3	4.84
1+DEN BEDROOM UNITS	2	3.23
1 BEDROOM UNITS	38	61.29
TOTAL	62	100.00

The development includes 99 parking spaces (including 28 tandem spaces for unit owners), surpassing the 80 required, along with 4 ADA-compliant spaces. All required setbacks are met, and one off-street loading space is provided.

This project offers a thoughtfully designed, well-integrated residential community that contributes to the local housing supply and urban environment.

Sincerely,

Joseph B. Kaller



April 16, 2025

City of Hollywood 2600 Hollywood Boulevard Hollywood, FL 33022

Reference: Fillmore Street Apartments

2231 Fillmore Street & 2224 Pierce Street

Hollywood, Florida

File #23-DP-45

To Whom It May Concern,

The following is our analysis of Criteria and findings for Review for the above referenced Residential Building as per the City of Hollywood Zoning and Land Development Regulations.

### **DESIGN REVIEW**

GENERAL CRITERIA: All plans/architectural drawings shall be reviewed based upon the evaluation of compatibility with the City's Design Guidelines, including the following elements:

CRITERION 1: Architectural and Design components. Architecture refers to the architectural elements of exterior building surfaces. Architectural details should be commensurate with the building mass. The use of traditional materials for new architectural details is recommended. Design of the building(s) shall consider aesthetics and functionality, including the relationship of the pedestrian with the built environment.

ANALYSIS: The proposed apartment building showcases a modern, horizontal design with clean lines and strong geometric forms. A bold white frame and extended balconies emphasize the building's linearity, while vertical wood paneling adds warmth and contrast. The darker, glazed base creates a clear transition from street to structure, enhancing the pedestrian experience. Varied facade depths and recessed balconies break up the massing, giving the building a lighter, more dynamic appearance. Landscaping and thoughtful setbacks further integrate the building with its surroundings.

CRITERION 2: Compatibility. The relationship between existing architectural styles and proposed construction, including how each building along the street relates to the whole and

the pattern created with adjacent structures and the surrounding neighborhood. Buildings should contain architectural details that are characteristic of the surrounding neighborhood.

ANALYSIS: The proposed building follows the intent of the District per the Downtown Master Plan. Its defined base supports active pedestrian engagement along the street, reflecting a common design approach in the neighborhood. Its use of stucco, neutral tones, and modern materials reflects the character of nearby developments and maintains neighborhood consistency.

CRITERION 3: Scale/Massing. Buildings shall be proportionate in scale, with a height which is consistent with the surrounding structures. Building mass shall reflect a simple composition of basic architectural details in relation to its length, width, height lot coverage, and setting of the structure in context with adjacent buildings. Architectural details include, but are not limited to, banding, molding, and fenestration.

ANALYSIS: The proposed building maintains a scale that is proportionate to its context and consistent with allowable height (45') in the surrounding area. The massing is thoughtfully articulated through recessed balconies, vertical wood paneling, and horizontal banding that break up the building's volume. The clean stucco surfaces and glass fenestration offer a simple yet refined architectural composition. Overall, the design reflects a balanced relationship between height, width, and depth, contributing to a cohesive urban streetscape that aligns with neighboring developments.

CRITERION 4: Landscaping. Landscaped areas should contain a variety of native and other compatible plant types and forms and be carefully integrated with existing buildings and paved areas. Existing mature trees and other significant plants on the site should be preserved.

ANALYSIS: The proposed design incorporates the use of native plants selected specifically for use in this area with careful consideration of insects and diseases common to the area. The proposed planting also creates variations of color and texture and are integrated in the front yards of the apartment units and simultaneously along the public sidewalks.

Should you have any questions, please feel free to contact this office.

Sincerely,

Kaller Architecture

Joseph B. Kaller AIA, LEED AP BD+C

President

# FILLMORE STREET APARTMENTS

PACO • 04/03/23

PRE TAC • 05/01/23

FINAL TAC • 07/17/23

P&D BOARD • T.B.D.

2231 FILLMORE ST. and 2224 PIERCE ST. HOLLYWOOD, FL 33020

LOT 19, BLOCK 10, HOLLYWOOD LITTLE RANCHES, A SUBDIVISION, ACCORDING TO THE PLAT THEREOF AS RECORDED IN PLAT BOOK 1, PAGE 26, OF THE PUBLIC RECORDS FOR BROWARD COUNTY, FLORIDA

LOT 4, BLOCK 10, LESS THE SOUTH 10 FEET THEREOF FOR ROAD RIGHT-OF-WAY, HOLLYWOOD LITTLE RANCHES AMENDED, ACCORDING TO THE PLAT THEREOF, AS RECORDED IN PLAT BOOK 1, PAGE 26, OF THE PUBLIC RECORDS OF BROWARD COUNTY, FLORIDA.

### OWNER

DTD 190, LLC 2719 HOLLYWOOD BLVD HOLLYWOD, FL 33020

### **ARCHITECT**

JOSEPH B. KALLER AND ASSOCIATES, P.A. CONTACT: Mr. JOSEPH B. KALLER ADDRESS: 2417 HOLLYWOOD BLVD. HOLLYWOOD, FL 33019 joseph@kallerarchitects.com

### **SURVEYOR**

STONER & ASSOCIATES, INC. ADDRESS: 4341 SW 62nd AVE, TOWN OF DAVIE, FL 33314 (954)-585-0997 www.stonersurveyors.com

ZEPHYR ENGINEERING. CBE, SBE & DBE Firm CONTACT: WILFORD ZEPHYR, P.E. ADDRESS: 5451 PIERCE ST, HOLLYWOOD, FL 33021 wilford@zephyrengineeringfl.com

LANDSCAPE

FOLIAGE EXPRESSIONS

CONTACT: GUILLERMO SALAZAR, M.S., ISA CERTIFIED ARBORIST

ADDRESS: 8801 SW 192nd TERRACE CUTLER BAY, FL 33157 (754)-234-1024 PHONE: guillesala8@gmail.com

# **ARCHITECTURE**

COVER A-R.1 RENDERING RENDERING A-R.2 SITE DATA / AREA CHART FAR DIAGRAM CALCULATION / ROW DEDICATION DIAGRAM A-0.3 OPEN SPACE CALCULATION / TRAFFIC CIRCULATION PLAN A-1.1 GROUND FLOOR PLAN A-1.2 SECOND FLOOR PLAN A-1.3 THIRD FLOOR PLAN FOURTH FLOOR PLAN A-1.4 FIFTH FLOOR (ROOF TERRACE) A-1.5 A-2.1 **ELEVATIONS** A-3.1 DETAILS SE ISOMETRIC SW ISOMETRIC A-I3 NW ISOMETRIC A-14 NE ISOMETRIC

# CIVIL


**EROSION & SEDIMENT CONTROL PLAN** PAVING, GRADING & DRAINAGE PLAN CIVIL DETAILS I CIVIL DETAILS II PAVEMENT MARKINGS & SIGNAGE PLAN PAVEMENT MARKINGS DETAILS WATER & SEWER CONNECTION PLAN UTILITIES DETAILS I

UTILITIES DETAILS II

# **LANDSCAPE**

REMOVAL PLAN DT-2 **EXISTING TREES CHART** LP-1 LANDSCAPE PLAN GROUND LEVEL PLANT SCHEDULE, CODE CHART & DETAILS LP-2 LANDSCAPE ROOF TERRACE, PLANT SCHEDULE LP-4 COLORED PLAN GROUND LEVEL LP-5 COLORED PLAN ROOF DECK HOLLYWOOD CITY NOTES, GENERAL NOTES

RAC

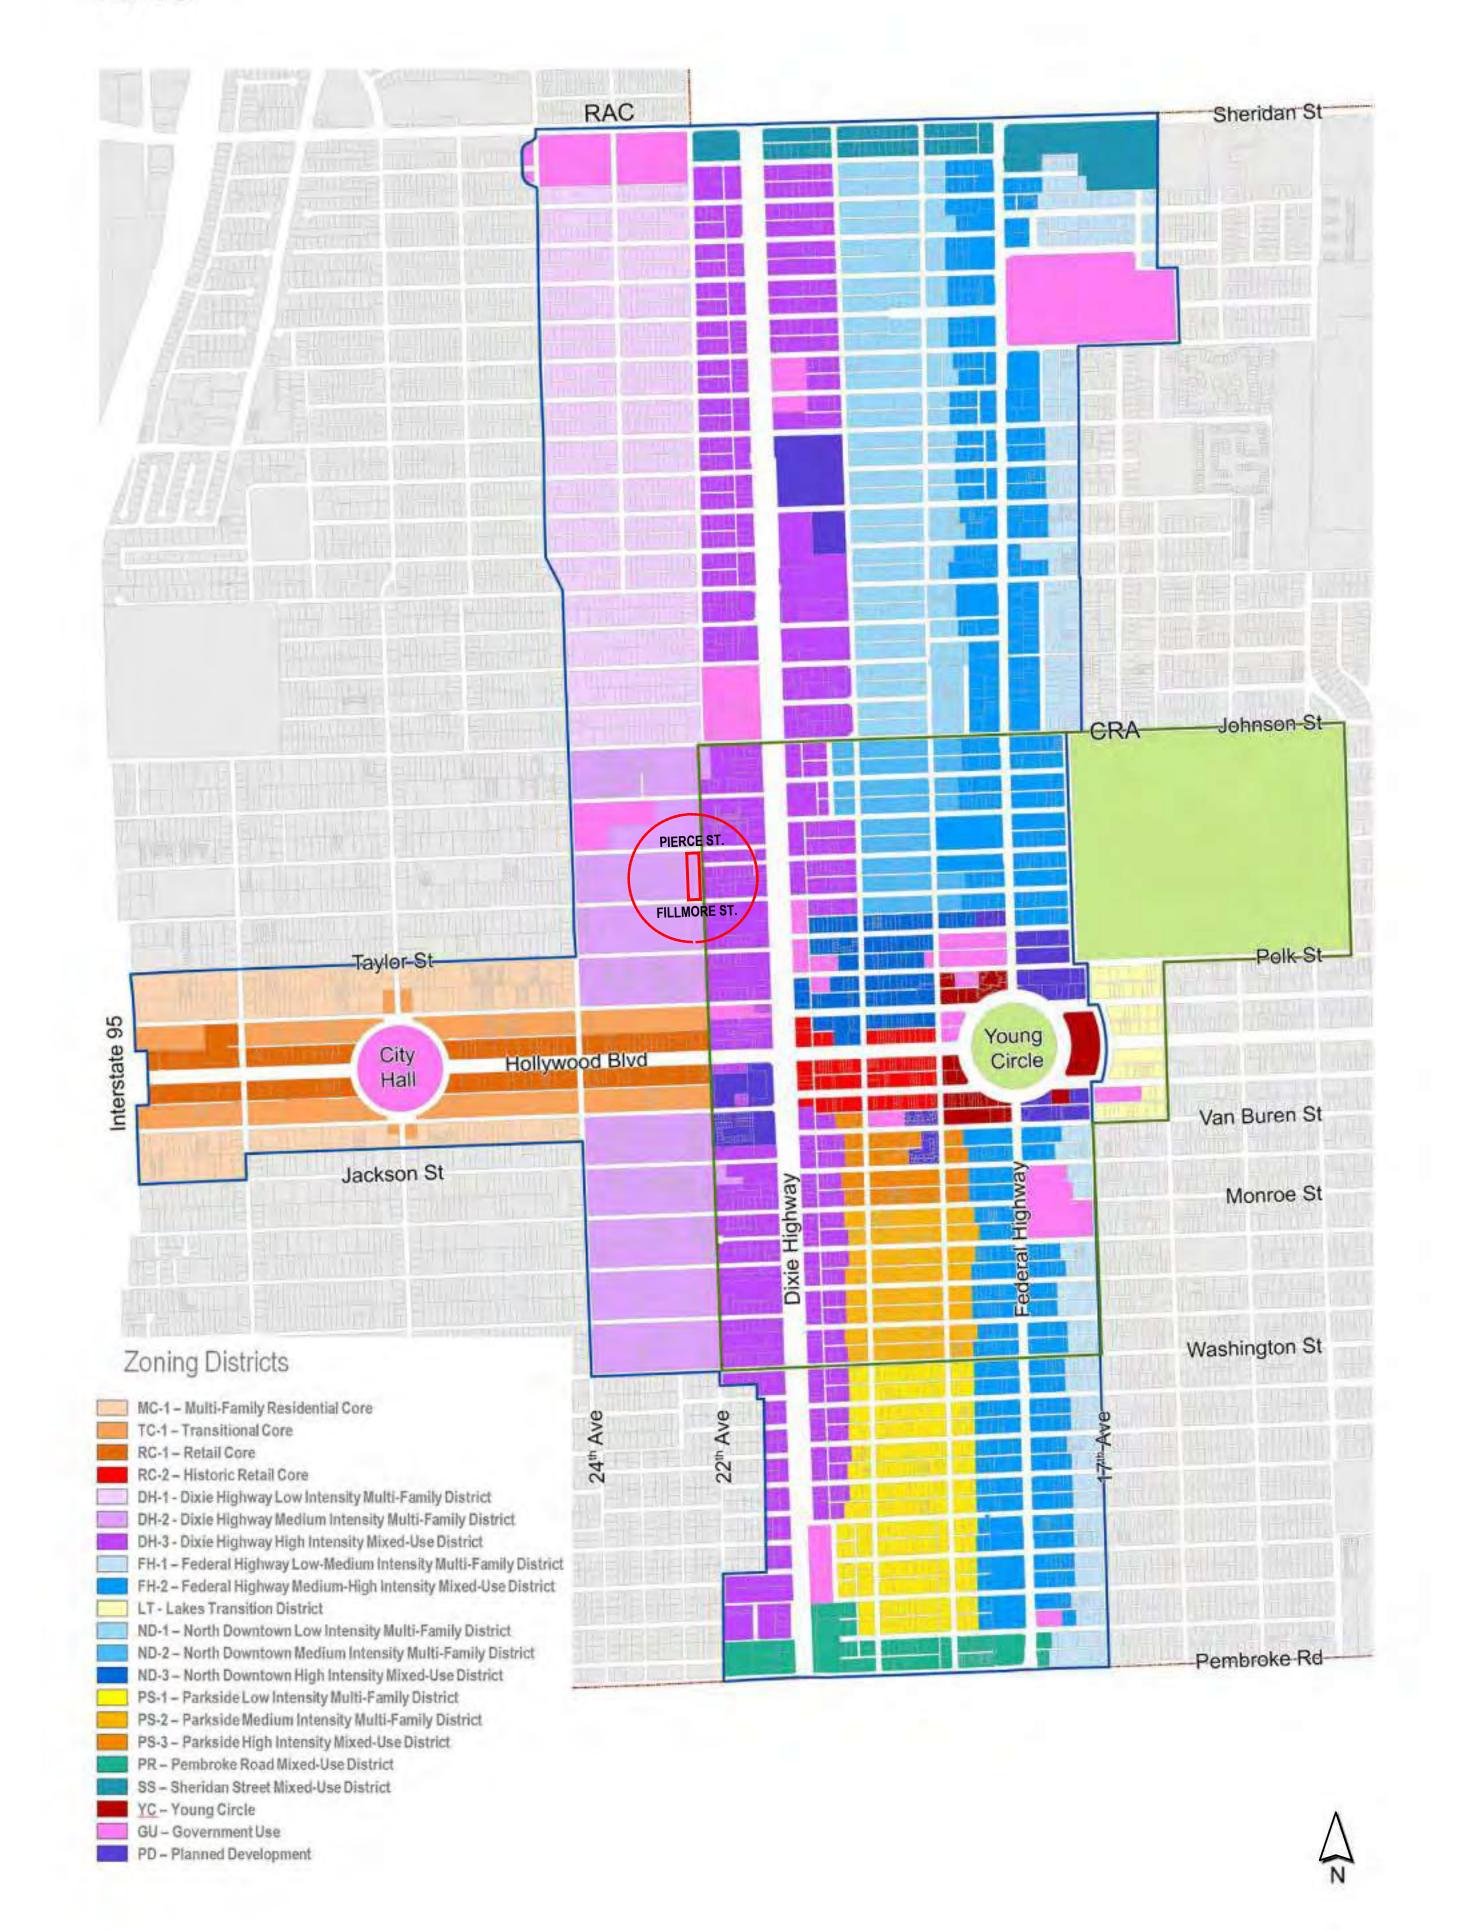



**Kaller** Architecture AA# 26001212 2417 Hollywood Blvd. Hollywood Florida 33020 954.920.5746 joseph@kallerarchitects.com

www.kallerarchitects.com

FLORIDA R.A. # 0009239

ST ST FILLMORE 24 PIERCE 5 31 22 HOL

COVER / LOCATION MAP

MEETING DATES

DATE DESCRIPTION COMMITE 04/03/23 FILE# 23-DP-45 PRE TAC 05/01/23 FILE# 23-DP-45 FINAL TAC 07/17/23 FILE# 23-DP-45 P&D BOARD | T.B.D | FILE# 23-DP-45

This drawing, as an instrument of service, is and shall remain the property of the Architect and shall not be reproduced, published or used in any way without the permission of the Architect.

PROJECT No.: DATE: 04.15.25 SCHIFFINO DRAWN BY: CHECKED BY: JBK

SHEET

LOCATION MAP

PUBLIC RECORDS OF BROWARD COUNTY, FLORIDA.

CERTIFIED TO: DTD 190 LLC

PROPERTY ADDRESS 2224 PIERCE STREET # 1-4 2231 FILLMORE STREET HOLLYWOOD, FL 33020

ALTA/NSPS LAND TITLE SURVEY INVOICE # 44293/44294 SURVEY DATE 05/03/23

FLOOD ZONE X0.2% MAP DATE 08/18/14 MAP NUMBER 125113 0569H

### OWNERSHIP & ENCUMBRANCES REPORT

PROVIDED BY SNYDER INTERNATIONAL LAW GROUP, P.A.

PREPARED BY FIRST AMERICAN TITLE INSURANCE COMPANY: DATES SEARCHED: FROM JULY 3, 1922 THROUGH APRIL 12, 2023 AT 8:00 AM, AS TO THE FOLLOWING DESCRIBED PROPERTY:

Lot 4, Block 10, LESS the South 10 feet thereof for Road Right-of-Way, HOLLYWOOD LITTLE RANCHES, a subdivision, according to the Plat thereof, as recorded in Plat Book 1, Page 26, of the Public Records of Broward County, Florida.

1. AMENDED PLAT OF HOLLYWOOD LITTLE RANCHES RECORDED IN PLAT BOOK 1 AT PAGE 26 OF THE PUBLIC RECORDS OF BROWARD COUNTY, FLORIDA. (AS SHOWN ON SURVEY) 2. The property has a parcel square footage of approximately 20,502 square feet according to the Broward County Property Appraiser's website. (NOT A SURVEY MATTER) 3. UNSATISFIED ENCUMBRANCES ABUTTING THE PROPERTY BOUNDARY

DTD 190, LLC, a Florida limited liability company, by virtue of that Warranty Deed recorded

NECESSARY FOR LEGAL ACCESS TO THE PROPERTY: NONE (NOT A SURVEY MATTER) 4. ENCUMBRANCES LYING WITHIN/ON THE PROPERTY BOUNDARIES: None (NOT A SURVEY MATTER) 5. GRANTEE(S) IN LAST DEED OF RECORD:

under Instrument Number 117062180. (NOT A SURVEY MATTER) 6. RECORDED MORTGAGES: None (NOT A SURVEY MATTER)

7. RECORDED CONSTRUCTION LIENS, CONTRACT LIENS AND JUDGMENTS: None (NOT A SURVEY MATTER)

8. GENERAL EXCEPTIONS: a. Taxes and assessments for the year 2023 and subsequent years, which are not yet due

and payable. (NOT A SURVEY MATTER) b. Any adverse ownership claim by right of sovereignty to any portion of the lands insured hereunder, including tidelands, submerged, filled and artificially exposed lands and lands accreted to such lands or dispute as to the boundaries purportedly caused by a change in the location of any water body within or adjacent to the land. (NOT A SURVEY

c. Any rights, interests or claims of parties in possession not shown by the public records. (NOT A SURVEY MATTER) d. Easements or claims of easements not shown by the public records. (NOT A SURVEY

MATTER, SEE NOTE #13) e. Any lien provided by Chapter 159, Florida Statutes, in favor of any city, town, village or port authority for unpaid service charges by any water, sewer or gas systems supplying

the property. (NOT A SURVEY MATTER) f. Any encroachment, encumbrance, violation, or adverse circumstance affecting the title that would be disclosed by an accurate and complete land survey of the land. The term encroachment includes encroachments of existing improvements located on the land onto adjoining land, and encroachments on the land of existing improvements located on

9. SPECIAL EXCEPTIONS: a. Easements, dedications, restrictions, covenants and conditions as set forth in the Plat of HOLLYWOOD LITTLE RANCHES, A SUBDIVISION, recorded in Plat Book 1, page 26. (AS

b. Resolution No. 06-DPV-03 set forth in O.R. Book 43034, at Page 1942. (NOT A SURVEY MATTER)

c. Resolution No. 06-DPV-03a set forth in O.R. Book 45436, at Page 808. (ORB 43436, PG 808 DOES NOT PERTAIN TO A RESOLUTION, DOES NOT PERTAIN TO PROPERTY)

# OWNERSHIP & ENCUMBRANCES REPORT

PROVIDED BY SNYDER INTERNATIONAL LAW GROUP, P.A.

PREPARED BY FIRST AMERICAN TITLE INSURANCE COMPANY; DATES SEARCHED: FROM JULY 3, 1922 THROUGH APRIL 20, 2023 AT 8:00 AM, AS TO THE FOLLOWING DESCRIBED PROPERTY:

Lot 19, Block 10, HOLLYWOOD LITTLE RANCHES, a subdivision, according to the Plat thereof, as recorded in Plat Book 1, Page 26, of the Public Records of Broward County,

1. PLAT RECORDED ON JULy 3, 1922 AND IS ATTACHED HERETO AS EXHIBIT "A" (AS SHOWN ON SURVEY) 2. SQUARE FOOTAGE:

The property has a parcel square footage of approximately 20,518 square feet and a gross square footage of 22,520 square feet, pursuant to ALTA Survey prepared by Stoner & Associates, Inc. under Project Number 20-9116. (NOT A SURVEY MATTER) 3. ENCUMBRANCES ABUTTING THE PROPERTY BOUNDARY NECESSARY FOR LEGAL ACCESS TO

THE PROPERTY: NONE (NOT A SURVEY MATTER) 4. ENCUMBRANCES LYING WITHIN/ON THE PROPERTY BOUNDARIES:

Easements, dedications, restrictions, covenants and conditions as set forth in the plat of HOLLYWOOD LITTLE RANCHES, A SUBDIVISION, recorded in Plat Book 1, page 26. (AS SHOWN

ON SURVEY) 5. GRANTEE(S) IN LAST DEED OF RECORD:

DTD 190, LLC, a Florida limited liability company, by virtue of that Warranty Deed recorded under Instrument Number 116985211. (NOT A SURVEY MATTER)

6. RECORDED MORTGAGES: None (NOT A SURVEY MATTER)

7. RECORDED CONSTRUCTION LIENS, CONTRACT LIENS AND JUDGMENTS:

None (NOT A SURVEY MATTER) 8. GENERAL EXCEPTIONS:

a. Taxes and assessments for the year 2023 and subsequent years, which are not yet due and payable. (NOT A SURVEY MATTER)

b. Any adverse ownership claim by right of sovereignty to any portion of the lands insured hereunder, including tidelands, submerged, filled and artificially exposed lands and lands accreted to such lands or dispute as to the boundaries purportedly caused by a change in the location of any water body within or adjacent to the land. (NOT A SURVEY MATTER)

c. Any rights, interests or claims of parties in possession not shown by the public records. (NOT A SURVEY MATTER)

d. Easements or claims of easements not shown by the public records. (NOT A SURVEY MATTER, SEE NOTE #13) e. Any lien provided by Chapter 159, Florida Statutes, in favor of any city, town, village

or port authority for unpaid service charges by any water, sewer or gas systems supplying the property. (NOT A SURVEY MATTER) f. Any encroachment, encumbrance, violation, or adverse circumstance affecting the title


that would be disclosed by an accurate and complete land survey of the land. The term encroachment includes encroachments of existing improvements located on the land onto adjoining land, and encroachments on the land of existing improvements located on adjoining land. (NOT A SURVEY MATTER) 9. SPECIAL EXCEPTIONS:


a. Easements, dedications, restrictions, covenants and conditions as set forth in the Plat of HOLLYWOOD LITTLE RANCHES, A SUBDIVISION, recorded in Plat Book 1, page 26. (AS


b. Resolution No. 06-DPV-03 set forth in O.R. Book 43034, at Page 1942. (NOT A

c. Resolution No. 06-DPV-03a set forth in O.R. Book 45436, at Page 808. (ORB 43436, PG 808 DOES NOT PERTAIN TO A RESOLUTION, DOES NOT PERTAIN TO PROPERTY)

# ALTA/NSPS LAND TITLE SURVEY

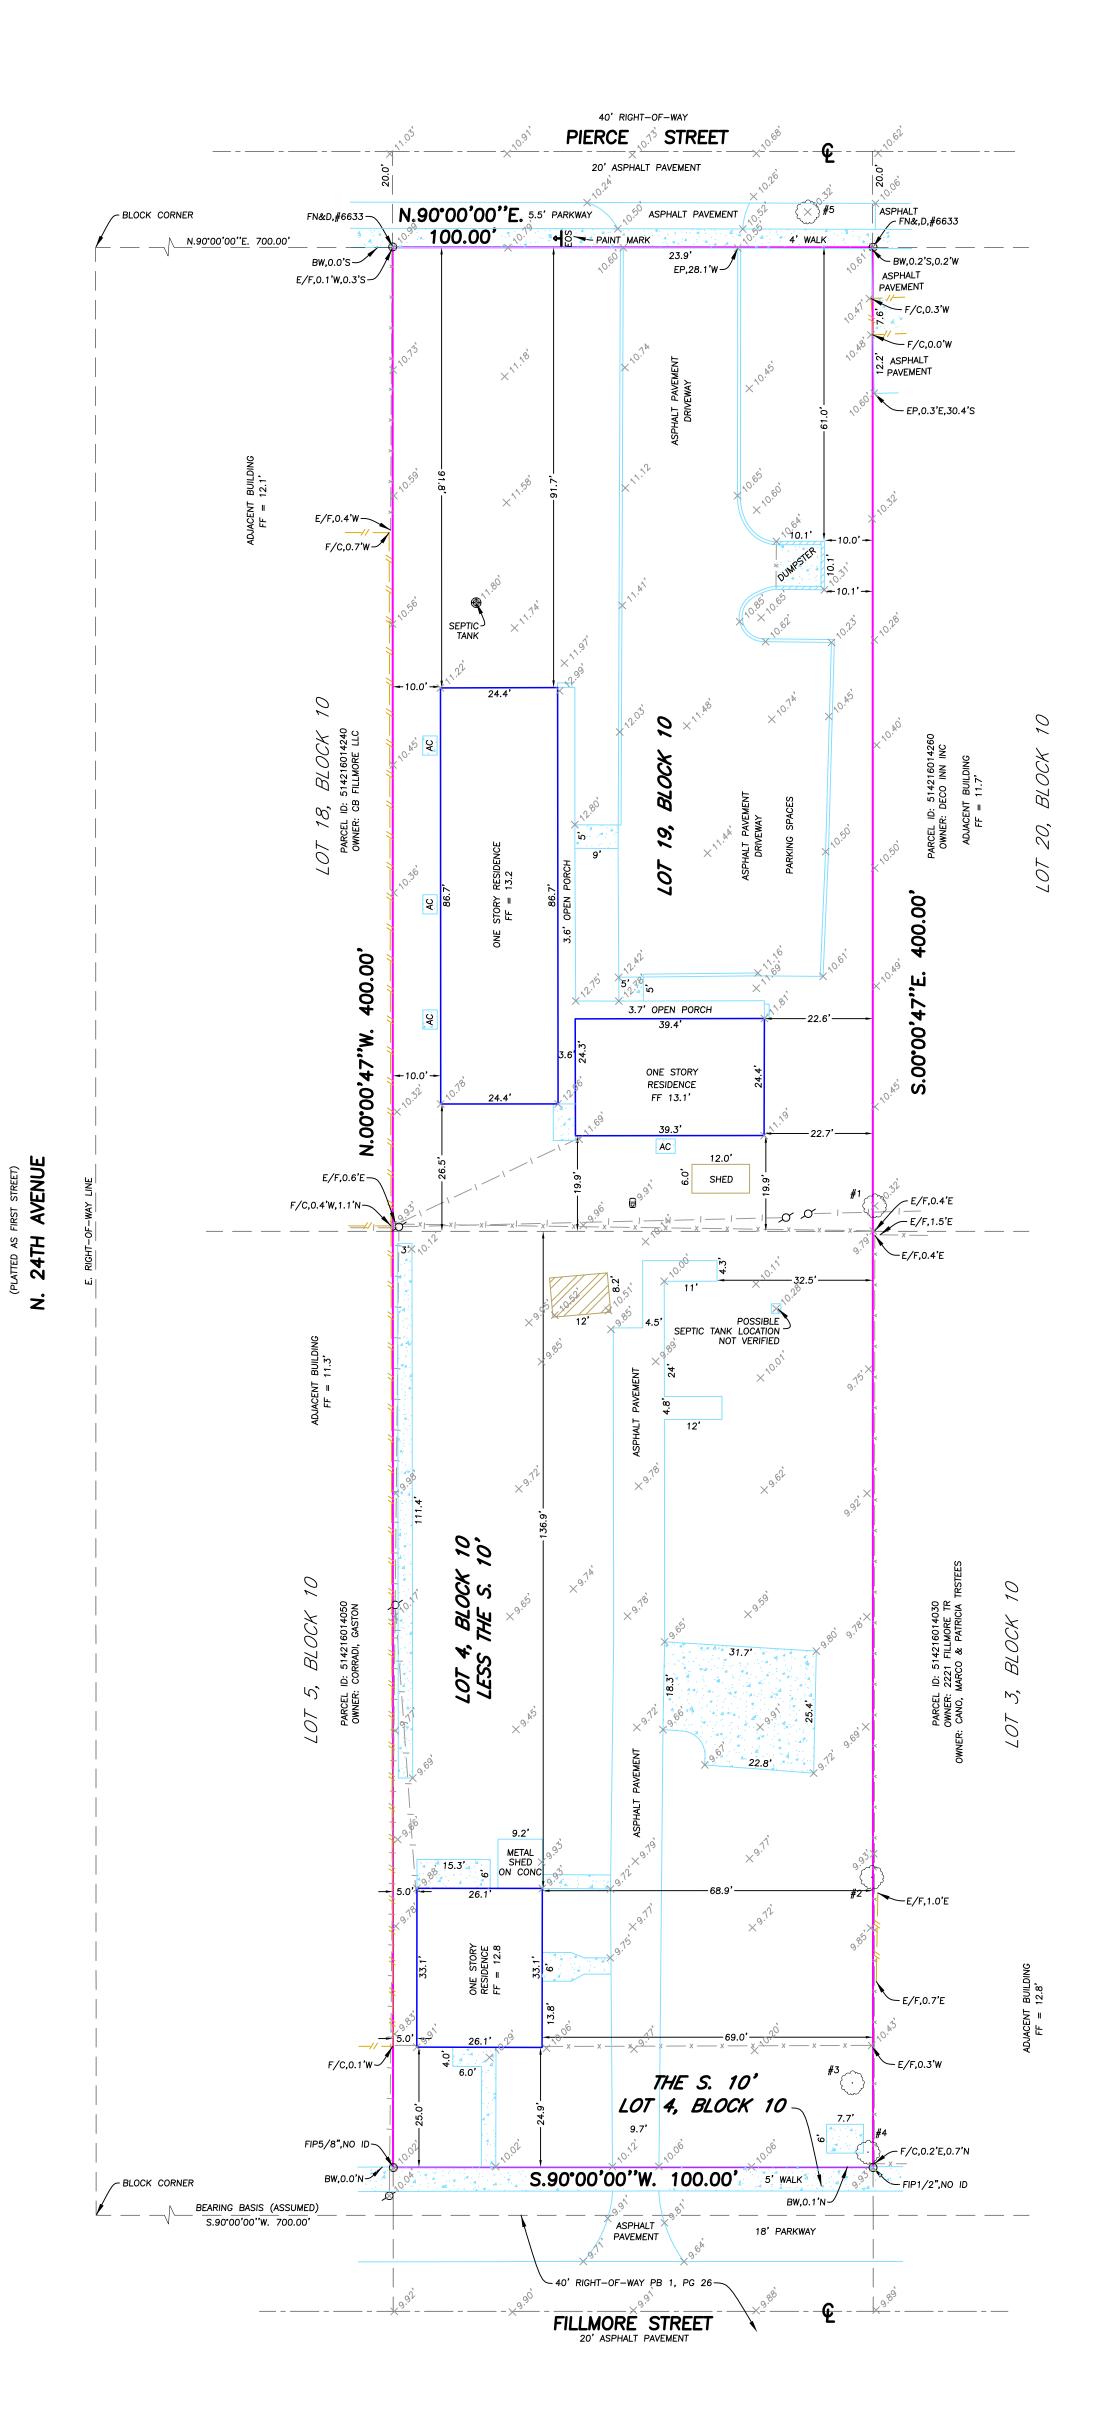

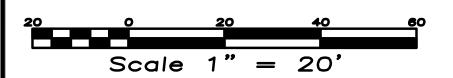

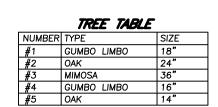

OPTIONAL SURVEY RESPONSIBILITIES AND SPECIFICATIONS

ITEM 4: BENCHMARK OF ORIGIN = NGS BENCHMARK: AD5675, ELV = 5.24' ITEM 11A: NO PLANS AND/OR REPORTS PROVIDED BY CLIENT. ITEM 17: NO PROPOSED CHANGES IN STREET RIGHT OF WAY LINES MADE AVAILABLE TO THE SURVEYOR. NO EVIDENCE OF RECENT STREET OR SIDEWALK CONSTRUCTION OR REPAIRS OBSERVED IN THE PROCESS OF CONDUCTING THE


# SURVEYOR'S NOTES

I. BASIS OF BEARINGS ASSUMED UNLESS OTHERWISE INDICATED ON SKETCH. LEGAL DESCRIPTION PROVIDED BY CLIENT OR PROPERTY APPRAISER WEBSITE.
 THE LANDS SHOWN HEREON WERE NOT ABSTRACTED BY THIS OFFICE FOR EASEMENTS, RIGHT-OF-WAYS, OWNERSHIP OR OTHER INSTRUMENTS OF RECORD.
4. UNDERGROUND OR INTERIOR PORTIONS OF FOOTINGS, FOUNDATIONS, WALLS OR OTHER NON-VISIBLE IMPROVEMENTS WERE NOT LOCATED.


5. ELEVATIONS ARE BASED ON NORTH AMERICAN VERTICAL DATUM OF 1988 UNLESS OTHERWISE INDICATED ON SKETCH.

6. FLOOR ELEVATION OBTAINED FROM MAIN ENTRY WAY OF STRUCTURE UNLESS 7. FENCE TIES ARE TO THE CENTER-LINE OF FENCE. WALL TIES ARE TO THE FACE OF WALL.
8. IN SOME INSTANCES GRAPHIC REPRESENTATIONS HAVE BEEN EXAGGERATED TO MORE CLEARLY ILLUSTRATE THE CONTROL THE LOCATION OF THE IMPROVEMENTS OVER SCALED POSITIONS. 9. THE DIMENSIONS AND DIRECTIONS SHOWN HEREON ARE IN SUBSTANTIAL AGREEMENT WITH RECORD VALUES UNLESS OTHERWISE NOTED. 10. PARTY WALLS ARE CENTERED ON PROPERTY LINE AND ARE 0.7' WIDE UNLESS 11. EXISTING CORNERS FOUND OFFSETS WITNESS PROPERTY CORNERS 12. OBSTRUCTED CORNERS ARE WITNESSED BY IMPROVEMENTS.
13. NO ATTEMPT WAS MADE TO LOCATE WRITTEN OR UNWRITTEN EASEMENTS OR

RIGHTS-OF-WAY, OTHER THEN THOSE SHOWN HEREON.

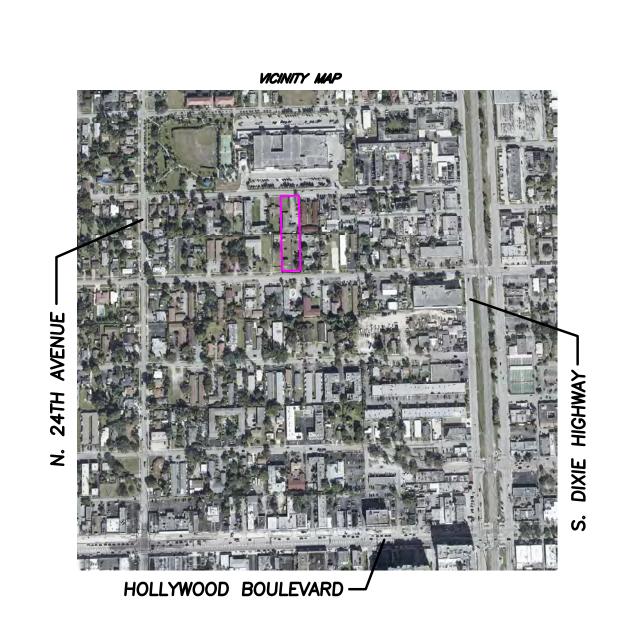

SURVEYOR'S CERTIFICATE This is to certify that this map or plat and the survey on which it is based were made in accordance with the 2021 Minimum Standard Detail Requirements for ALTA/NSPS Land Title Surveys, jointly established and adopted by ALTA and NSPS, and includes Items 2, 3, 5, 8, 11a, 13, 17, 18 of Table A thereof, The field work was completed on May 03, 2023. Date of Plat or Map: May 05, 2023.

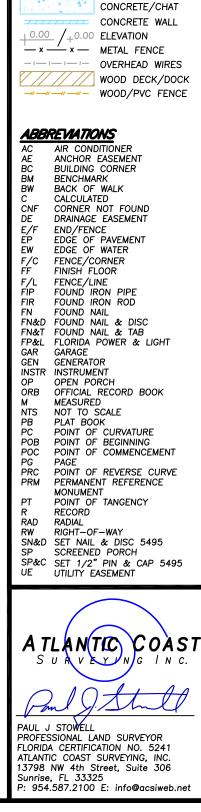

CATCH BASI

BRICK/TILE PAVERS

└─||FP&L BOX

☑ CONTROL VALVE O CLEAN OUT

—)GUY ANCHOR ∰ MANHOLE -Ó- FIRE HYDRANT ⊃ WATER VALVE

CENTERLINE

☑ CABLE JUNCTION BOX Z ELECTRIC SERVICE POOL EQUIPMENT O POWER/LIGHT POLE → SPRINKLER SYSTEM





AA# 26001212 2417 Hollywood Blvd. Hollywood Florida 33020 954.920.5746

joseph@kallerarchitects.com www.kallerarchitects.com

JOSEPH B. KALLER FLORIDA R.A. # 0009239

MEETING DATES

PRE TAC 05/01/23 FILE# 23-DP-45 FINAL TAC 07/17/23 FILE# 23-DP-45 P&D BOARD T.B.D FILE# 23-DP-45

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CHECKED BY: JBK





www.kallerarchitects.com

SEAL

OF FLO

R.A.

9239

FRED AR

JOSEPH B. KALLER
FLORIDA R.A. # 0009239

2231 FILLMORE ST & 2224 PIERCE ST HOLLYWOOD, FL. 33020

PROJECT TITLE

ATIC DESIGN PACKAGE RING

SCHEMA RENDEF

MEETING DATES

BOARD/ COMMITE DATE DESCRIPTION

PACO 04/03/23 FILE# 23-DP-45

PRE TAC 05/01/23 FILE# 23-DP-45

FINAL TAC 07/17/23 FILE# 23-DP-45

T.B.D FILE# 23-DP-45

FILE# 23-DP-45

FILE# 23-DP-45

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PROJECT No.: 20189

PROJECT No.: 2018


DATE: 04.1!

DRAWN BY: SCHI

CHECKED BY: JBK

SHEE

A-R.2

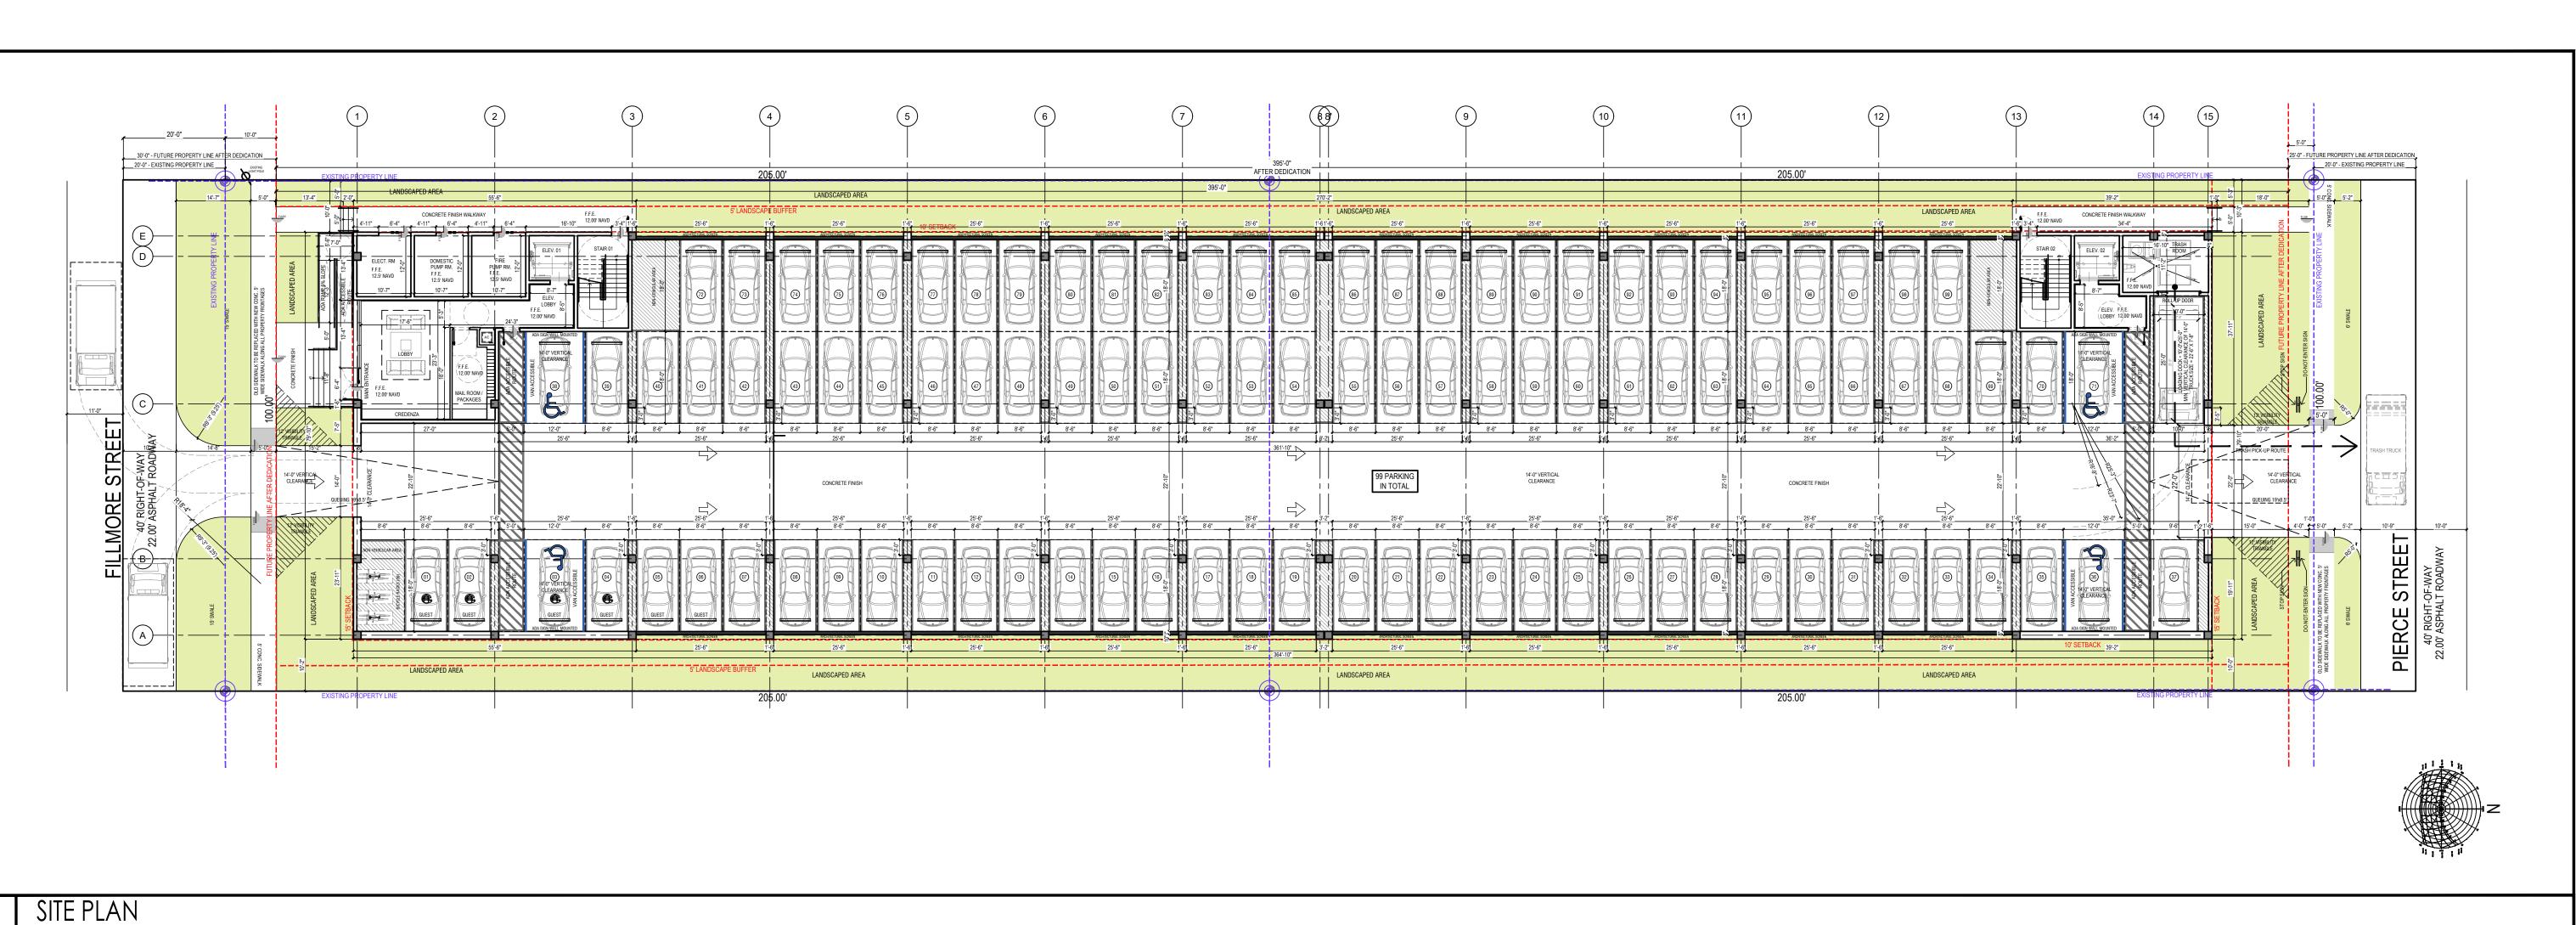

2231 FILLMORE ST. & 2224 PIERCE ST. HOLLYWOOD, FL 33020

**ZONING INFO** 

1/16" = 1'-0"

Regional Activity Center (RAC) Municipal Future Land Use: DH-2 Zone: **Existing Building Use:** 

Single Family Residential **Existing Land Use:** Residential County Future Land Use: Regional Activity Center Allowed Use(s) - Primary: Residential, Lodging, Office,

Commercial, Civic, Educational

**FEMA** 

New Flood Zone: X - Below 500 Year Flood Plain N/A New NAVD 88 Elevation:

Old Flood Zone:

**100 YEAR MAP** 

Future Conditions 100-Year Flood Elevation (Feet NAVD88)

Elevation: 12.0

SETBACKS AT GROUND LEVEL

Minimum Primary Frontage Setback: 15.00 ft Minimum Secondary Frontage Setback: N/A Minimum Side Setback: 10.00 ft 20.00 ft Minimum Rear Setback: Minimum Water Setback: N/A

AT-GRADE PARKING LOT AND VEHICULAR USE AREAS

**SETBACK REQUIREMENTS** 10 feet Front:

5 feet Interior: 5 feet

Amount of Required Off-Street Parking Units of one bedroom or less;

1 space per unit; Units exceeding one bedroom (including dens): 1.5 space per unit; plus 1 space per 10 units for guest parking

Off-Street loading spaces; general provisions Multiple Family or Apt./Hotel Bldg: 50-100 Units - 1 space + 1 space for each additional 100 units or major fraction.

# PROJECT INFO

Lot Area:

LOT 19, BLOCK 10: 20,518 sf (0.47 Acre) LOT 4, BLOCK 10: 20,502 sf (0.47 Acre) TOTAL AREA: 41,020 sf (0.94 Acre)

Maximum Building Height:

45 ft Allowed: 45 ft Proposed:

Floor Area Ratio (FAR) 1.75: 71,785 sf (1.75) Allowed:

Open Space:

Proposed:

20% (8,204 sf) Minimum: 32% (13,131 sf) Proposed:

62,754 sf (1.52)

Front Setback (Fillmore ST): 15'-0" Minimum: 15'-0" Proposed:

Front Setback (Pierce ST.): Minimum: 15'-0" 15'-0" Proposed:

Side Setback:

10'-0" Minimum: 10'-0" Proposed:

# Parking Requirement:

One Bed Unit (38un x 1): 38 spaces One Bed + Den (2un x 1.5): 3 spaces 4.5 spaces Two Bed (3un x 1.5): Two Bed + Den (13un x 1.5): 19.5 spaces 09 spaces Three Bed Unit (6un x 1.5):

74 spaces Guests (62un / min. 1 per 10): 6 spaces Total Parking Required: 80 spaces Total Parking Proposed: 99 spaces

(28 TANDEM SPACES PROVIDED FOR **UNIT OWNERS)** 

ADA parking spaces:

Required: 4 spaces

4 spaces (Van Accessible) Proposed:

# Off-Street loading spaces:

1 space (25'-0" X 10'-0") Required: 1 space (25'-0" X 10'-0") Proposed: Min. Vertical Clearance of 14'-0"

TYPE	TAG	A/C AREA	TERRACE	SELLABLE AREA	QTY.	%	REQ. PARKING
ONE BED	A1	677	149	826	25	40.3226	25
	A1.1	696	405	1101	4	6.45161	4
	A1.2	696	257	953	9	14.5161	9
ONE BED + DEN	A4	968	149	1117	1	1.6129	1.5
	A4.1	968	257	1225	1	1.6129	1.5
TWO BED	A2	1,004	186	1190	2	3.22581	3
	A2.1	1,004	321	1325	1	1.6129	1.5
TWO BED + DEN	А3	1,016	223	1239	9	14.5161	13.5
	A3.1	1,016	608	1624	4	6.45161	6
THREE BED	A5	1,035	227	1262	4	6.45161	6
	A5.1	1,035	620	1655	2	3.22581	3

TOTALS IN BUILDING		50,339	15,344	65 <i>,</i> 683	62	100	74.0
UNIT MIX	QTY.	%		PARKING CAL	CULATION		
3 BEDROOM UNITS	6	9.68		REQ. RESIDENTS	74.0		
2+DEN BEDROOM UNITS	13	20.97		REQ. ADA	4		
2 BEDROOM UNITS	3	4.84		REQ. GUESTS	6.0		
1+DEN BEDROOM UNITS	2	3.23					
1 BEDROOM UNITS	38	61.29		TOTAL REQ.	80		
TOTAL	62	100.00		TOTAL PROVIDED	<u>99</u>		
CUMULATE AVE. UNIT SIZE REQ.	500	SF					

# NOTES

CUMULATE AVE. UNIT SIZE PROP.

1. ALL CHANGES TO THE DESIGN WILL REQUIRE PLANNING REVIEW AND MAY BE SUBJECT TO BOARD APPROVAL


812

- 2. SUBJECT BUILDING TO BE GREEN CERTIFIED THROUGH THE FLORIDA GREEN BUILDING COALITION CERTIFICATION PROCESS (GREEN GLOBE).
- I. MINIMUM RADIO SIGNAL STRENGTH FOR FIRE DEPARTMENT COMMUNICATIONS BE MAINTAINED AT A LEVEL DETERMINED BY THE AHJ FOR ALL NEW AND EXISTING BUILDINGS INCLUDING COMPLYING WITH NFPA 72 (2016 EDITION). BDA SYSTEM MAY BE REQUIRED.
- I. PER NFPA 1, 12.3.2\* A QUALITY ASSURANCE PROGRAM FOR THE INSTALLATION OF DEVICES AND SYSTEMS INSTALLED TO PROTECT PENETRATION AND JOINTS SHALL BE PREPARED AND MONITORED BY THE REGISTERED DESIGN PROFESSIONAL RESPONSIBLE FOR DESIGN. INSPECTIONS OF FIRE STOP SYSTEMS AND FIRE-RESISTIVE JOINT SYSTEMS SHALL BE IN ACCORDANCE WITH 12.3.2.1 AND
- 5. PER SECTION 7.1.I. PROVIDED TANDEM SPACE (VERTICAL OR HORIZONTAL) SHALL BE ASSIGNED TO AND FOR THE SOLE USE OF A SINGLE UNIT; NOT TO INCLUDE REQUIRED GUEST SPACES.
- 6. ALL SIGNAGE SHALL BE IN COMPLIANCE WITH THE ZONING AND LAND DEVELOPMENT REGULATIONS ARTICLE 8.0.
- 7. ANY LIP FROM 1/4" BUT NOT GREATER THAN  $\frac{1}{2}$ " WILL BE BEVELED TO MEET ADA REQUIREMENTS. 8. MAXIMUM 0.5 FOOT CANDLE LEVEL AT ALL PROPERTY LINES.
- 9. ALL ROADS ADJACENT TO THE PROJECT AREA WILL BE FULLY MILLED AND RESTORED.
- 10. ALL UNDERGROUND FIRE MAIN WORK MUST BE COMPLETED BY FIRE PROTECTION CONTRACTOR HOLDING A CLASS I,II, OR V LICENSE PER FS 633.102.
- 11. NO SECURITY GATES TO BE INSTALLED AT THE DRIVEWAY ENTRANCE / EXIT.



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 $\infty$ FILLMORE 224 PIERCE 22 22 HOL 7

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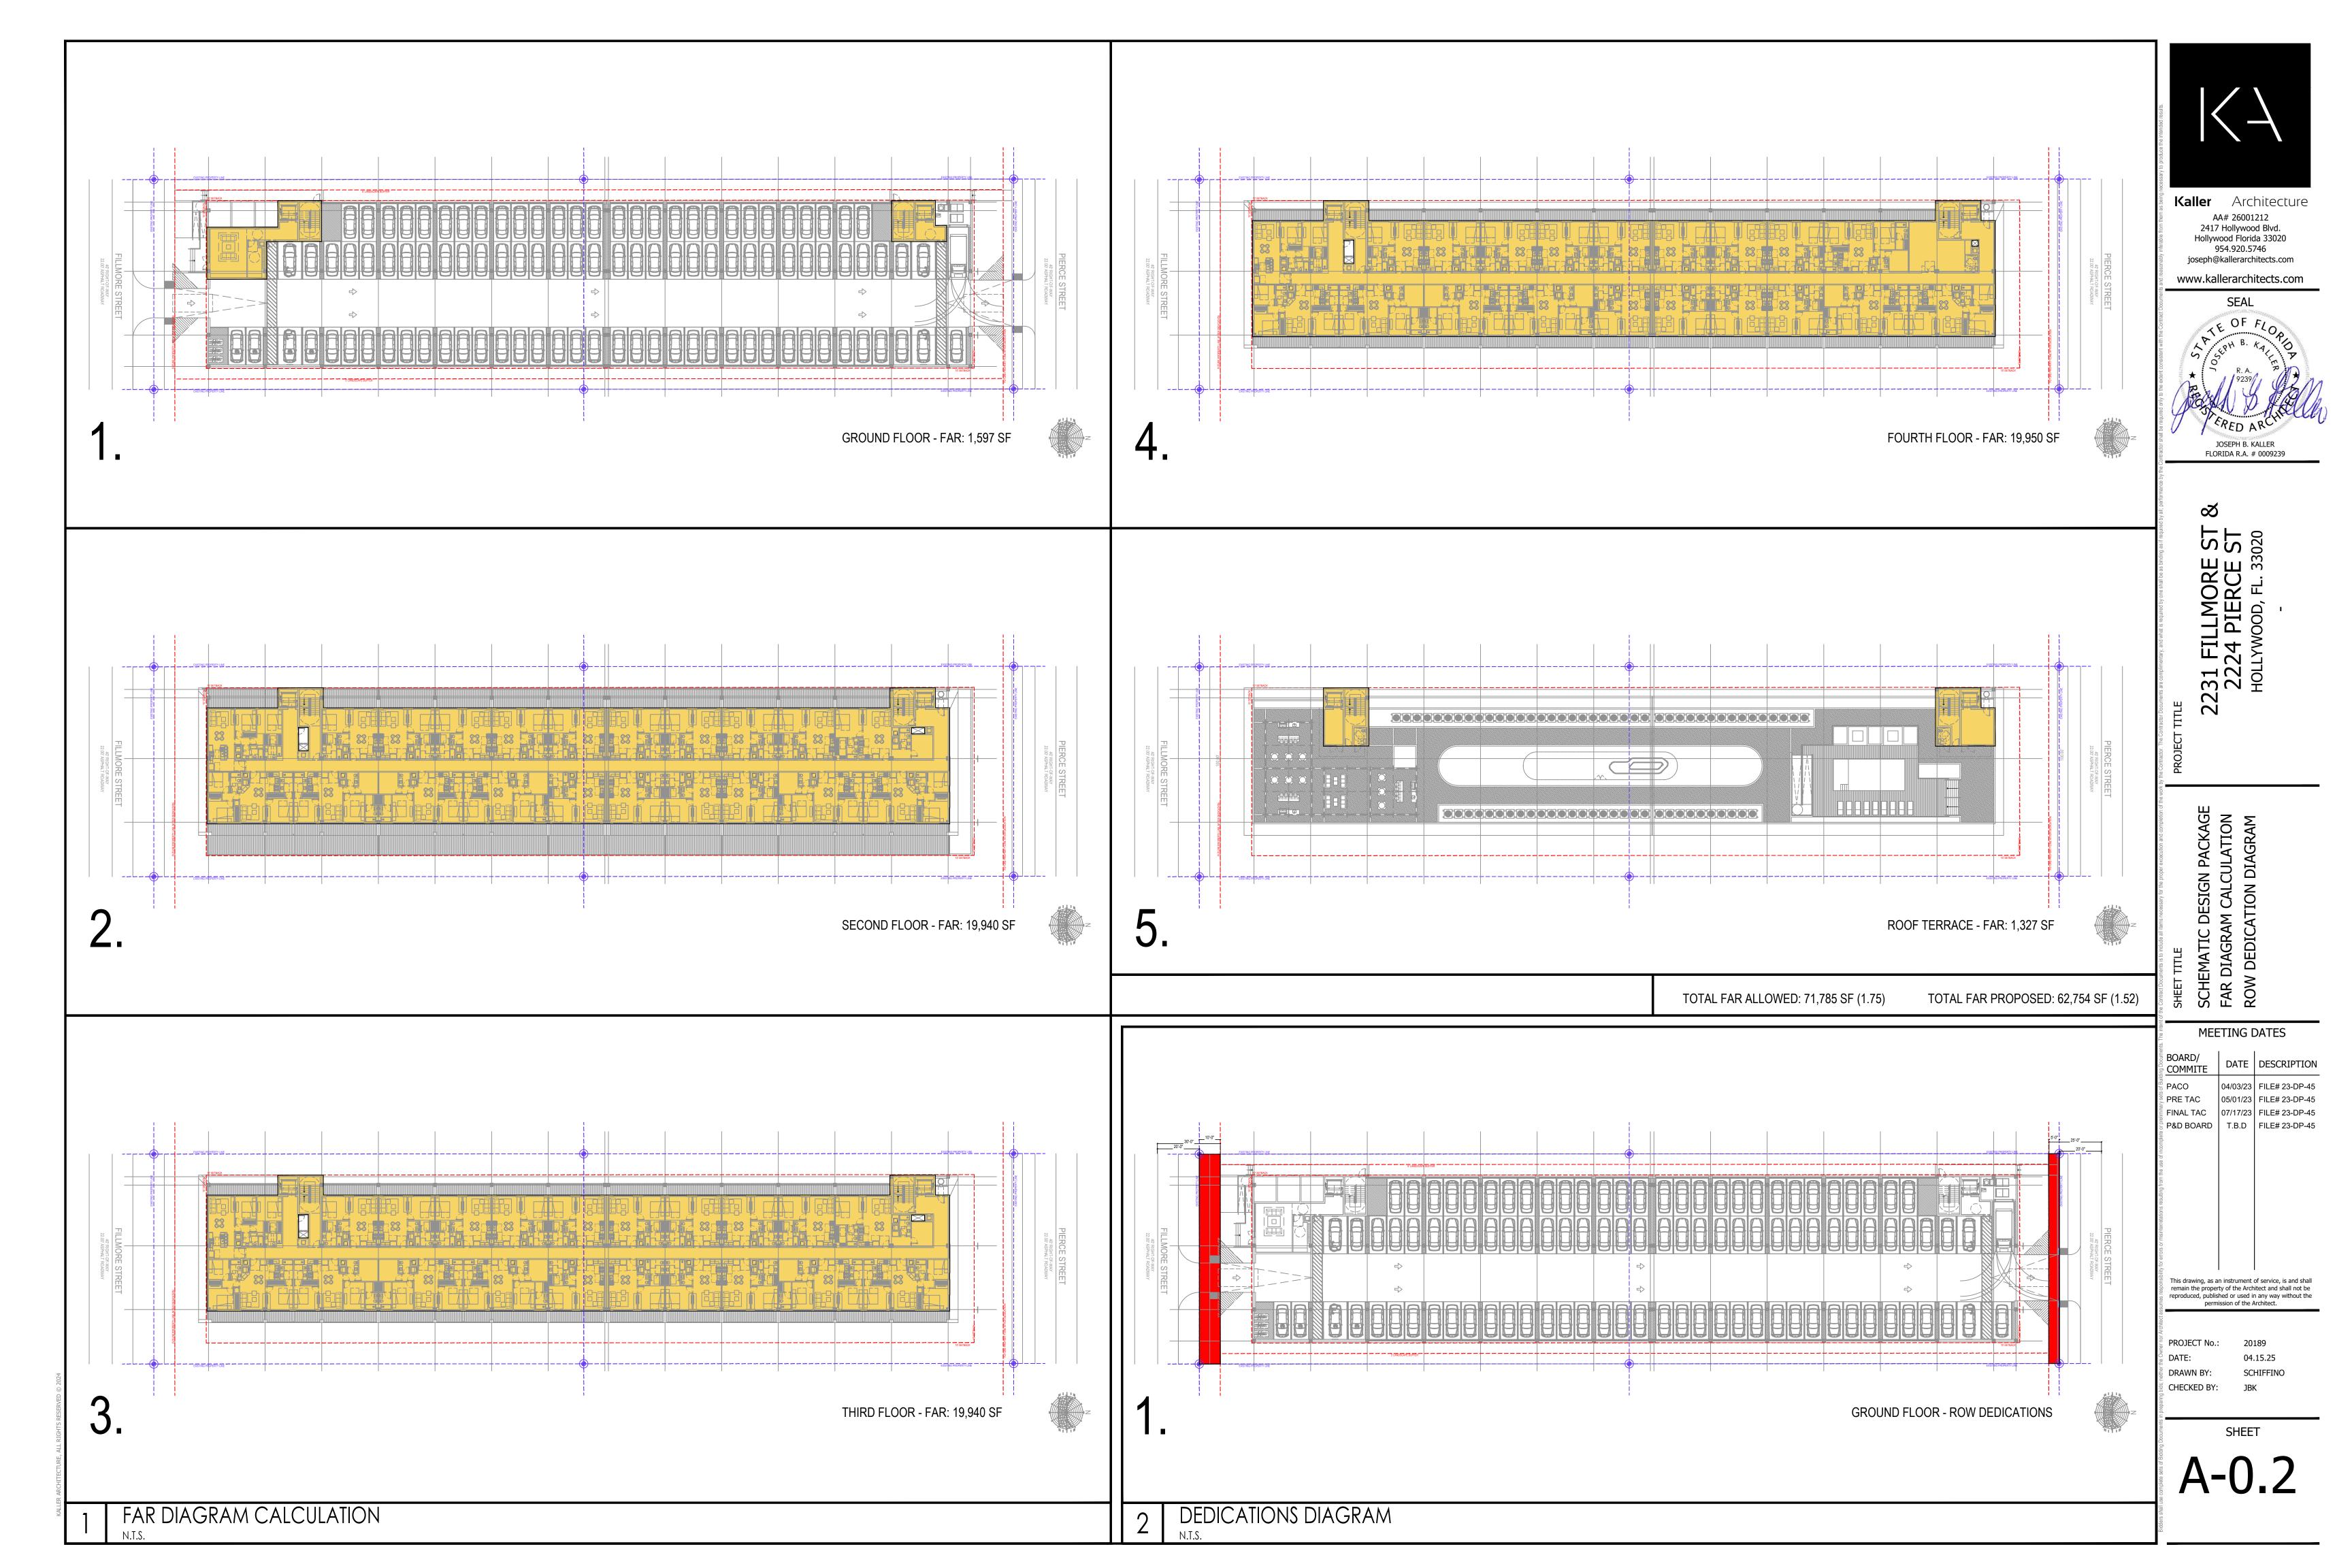
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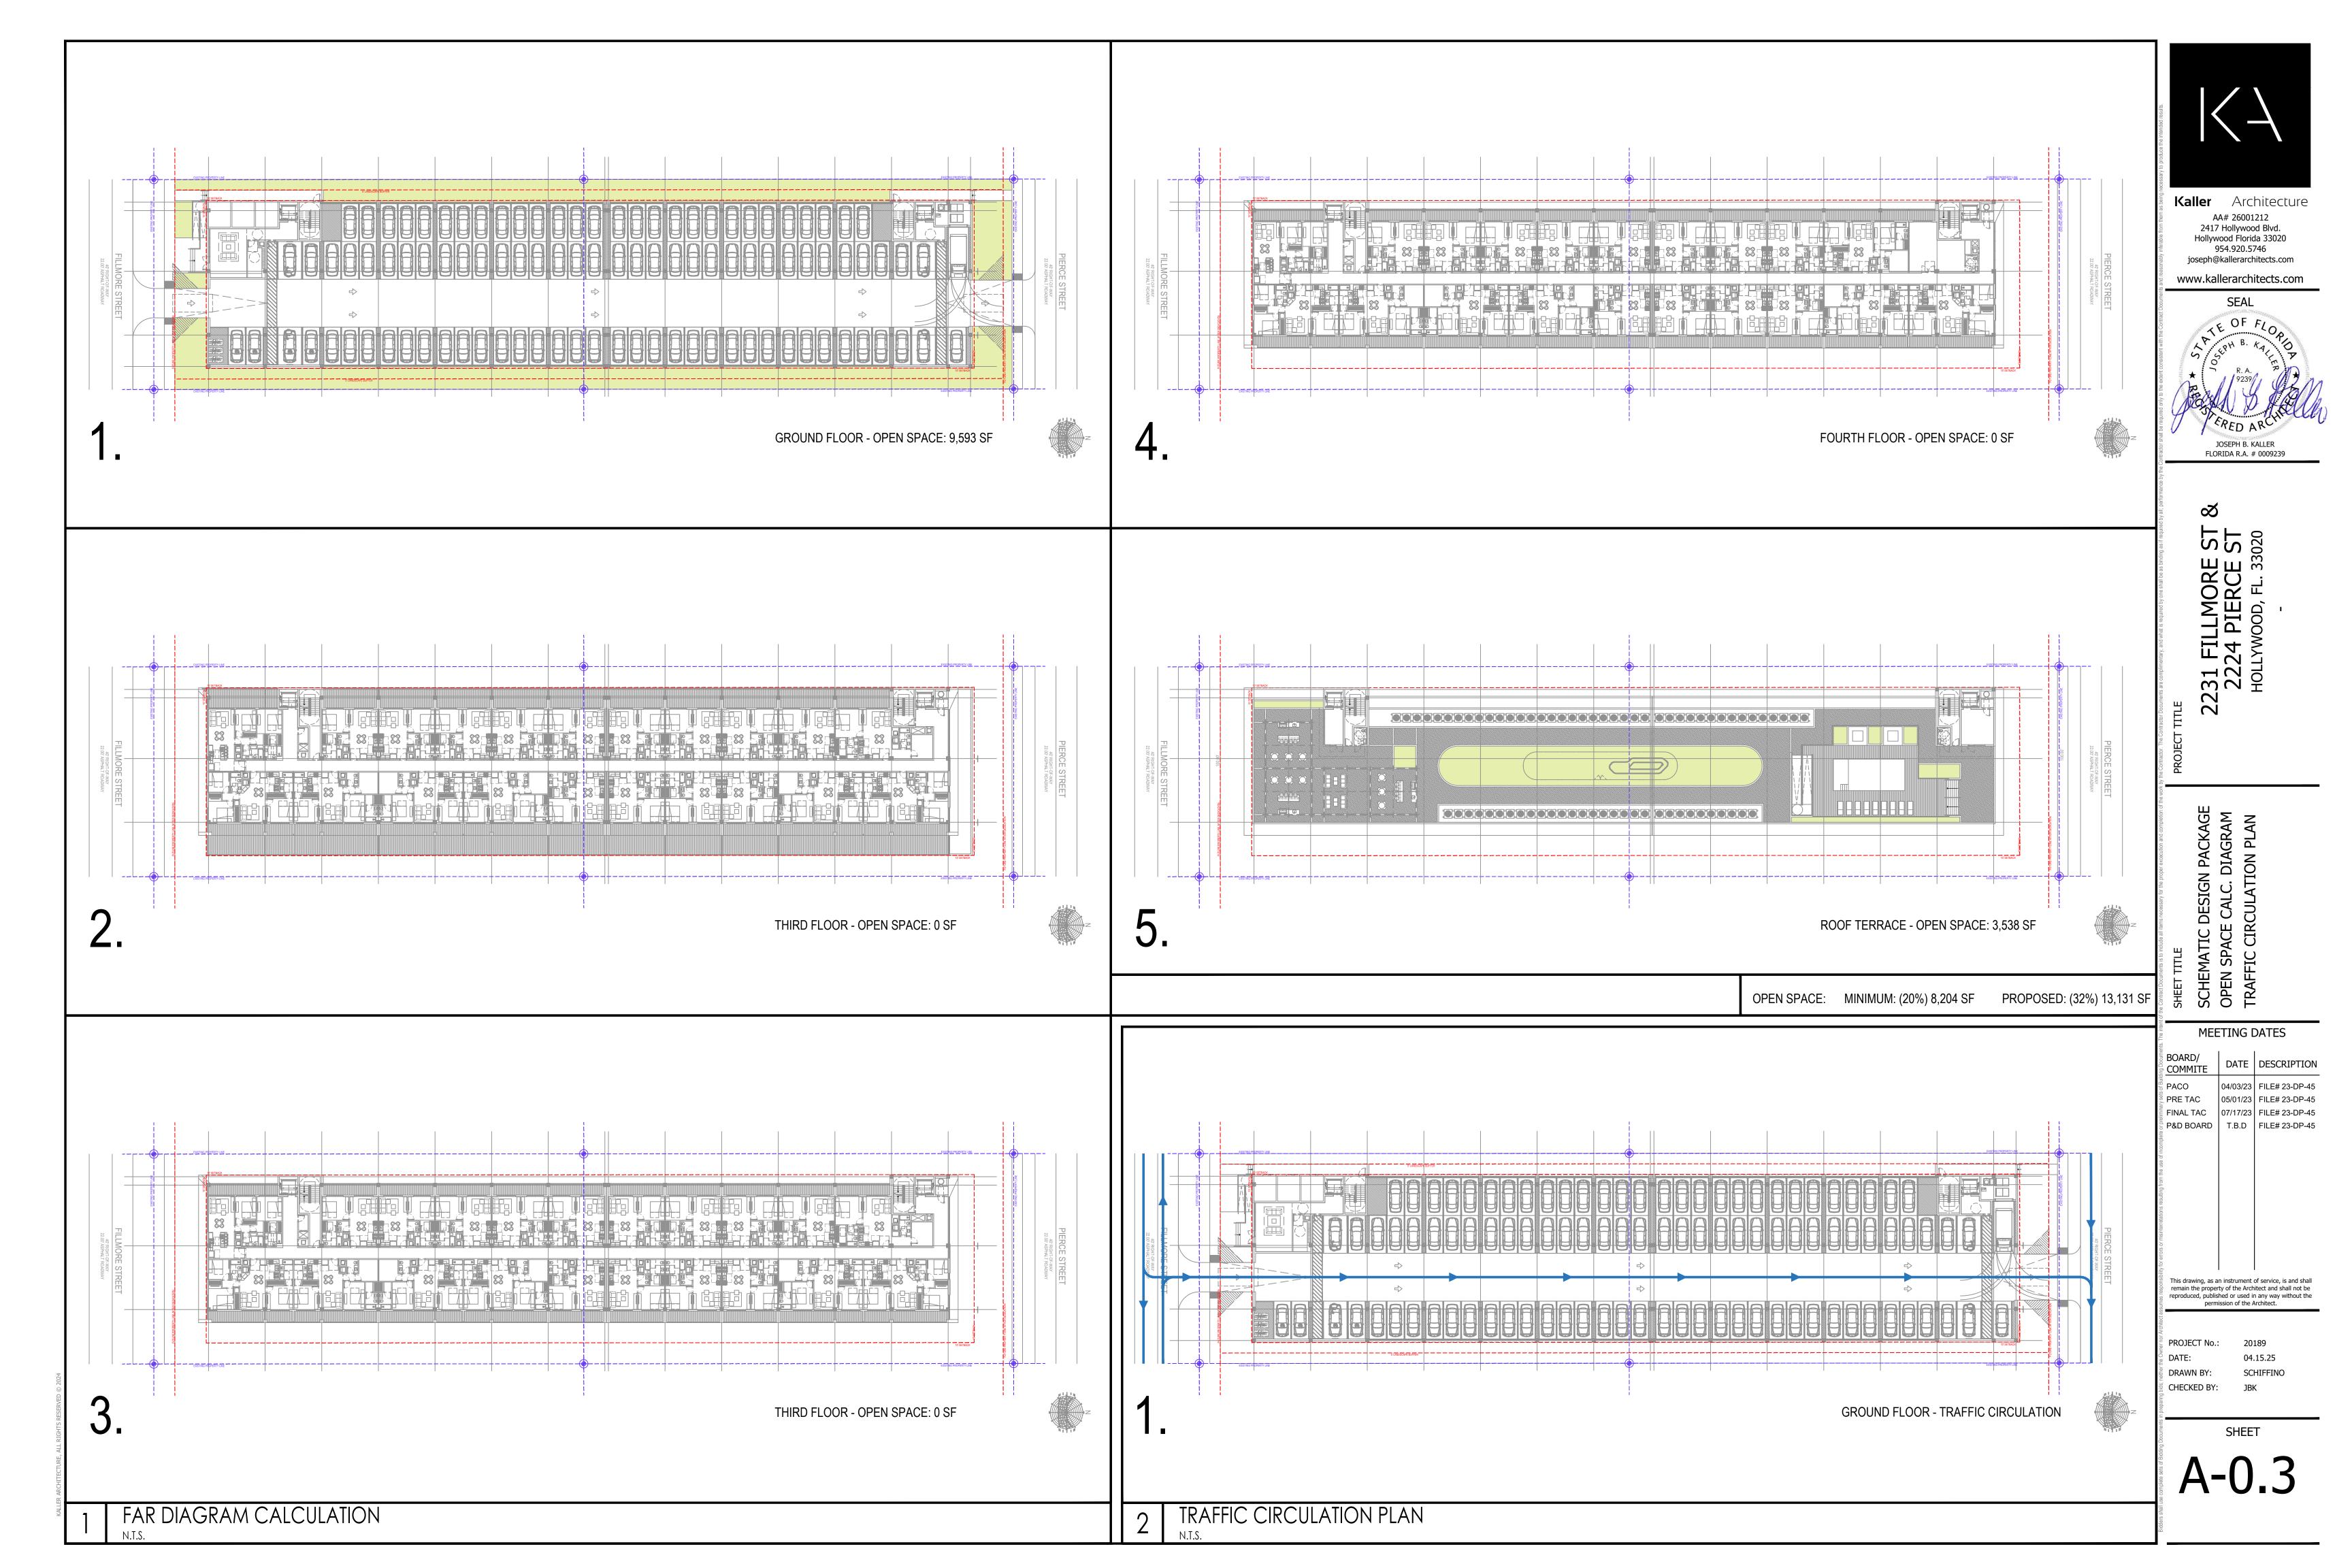
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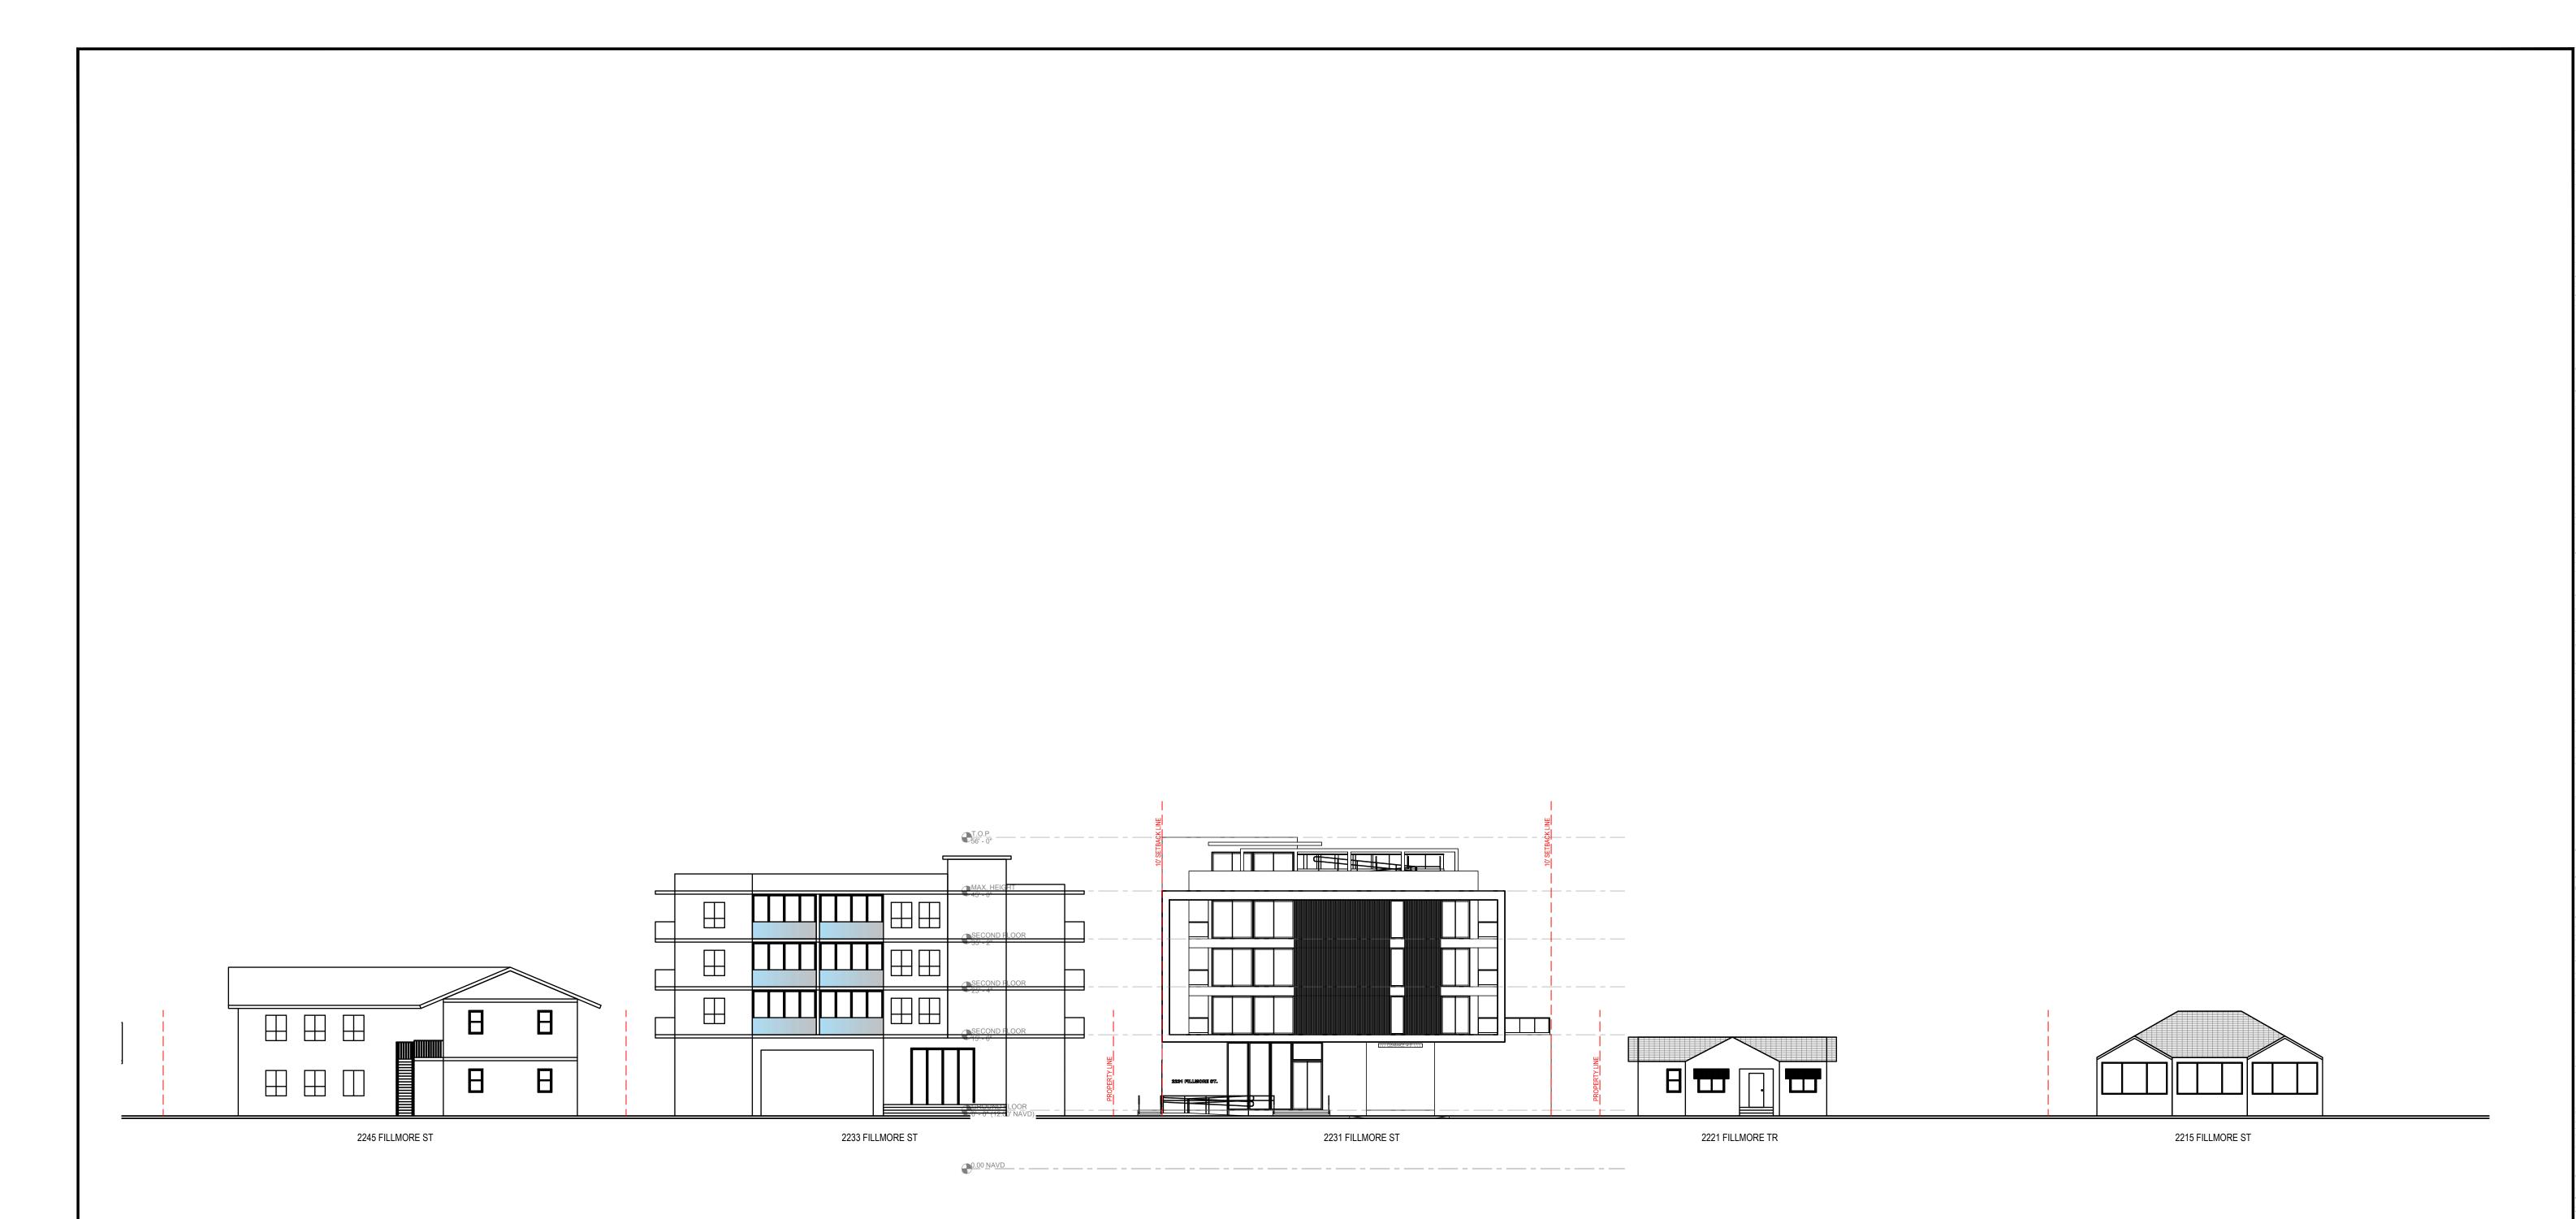
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JBK
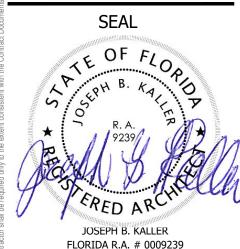
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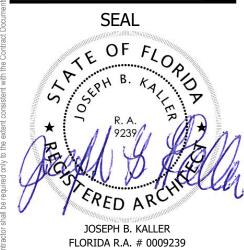








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2231 FILLMORE ST & 2224 PIERCE ST HOLLYWOOD, FL. 33020

SHEET TITLE

STREET PROFILE

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MEETING DATES

BOARD/ COMMITE DATE DESCRIPTION

PACO 04/03/23 FILE# 23-DP-45

PRE TAC 05/01/23 FILE# 23-DP-45

07/17/23 FILE# 23-DP-45

T.B.D FILE# 23-DP-45

FILE# 23-DP-45

FILE# 23-DP-45

FILE# 23-DP-45

FILE# 23-DP-45

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2 AERIAL KEY VIEW

2300 PIERCE ST





T B 2555 POLK STREET C 2230 LINCOLN ST FOLIO # 514216014230 D 2220 PIERCE ST FOLIO # 514216014260 E 2210 PIERCE ST FOLIO # 514216014270







N.T.S.

FOLIO # 514216014270



G 2245 FILLMORE ST



H 2238 FILLMORE ST FOLIO # 514216013950





T 2230 FILLMORE ST 50LIO # 514216014240 J 2230 FILLMORE ST FOLIO # 514216013960 K 2222 FILLMORE ST FOLIO # 514216013970 L 2221-2223 FILLMORE ST FOLIO # 514216014030 M 2215 FILLMORE ST







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**Kaller** Architecture

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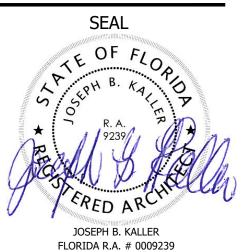
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COLORED SITE PLAN

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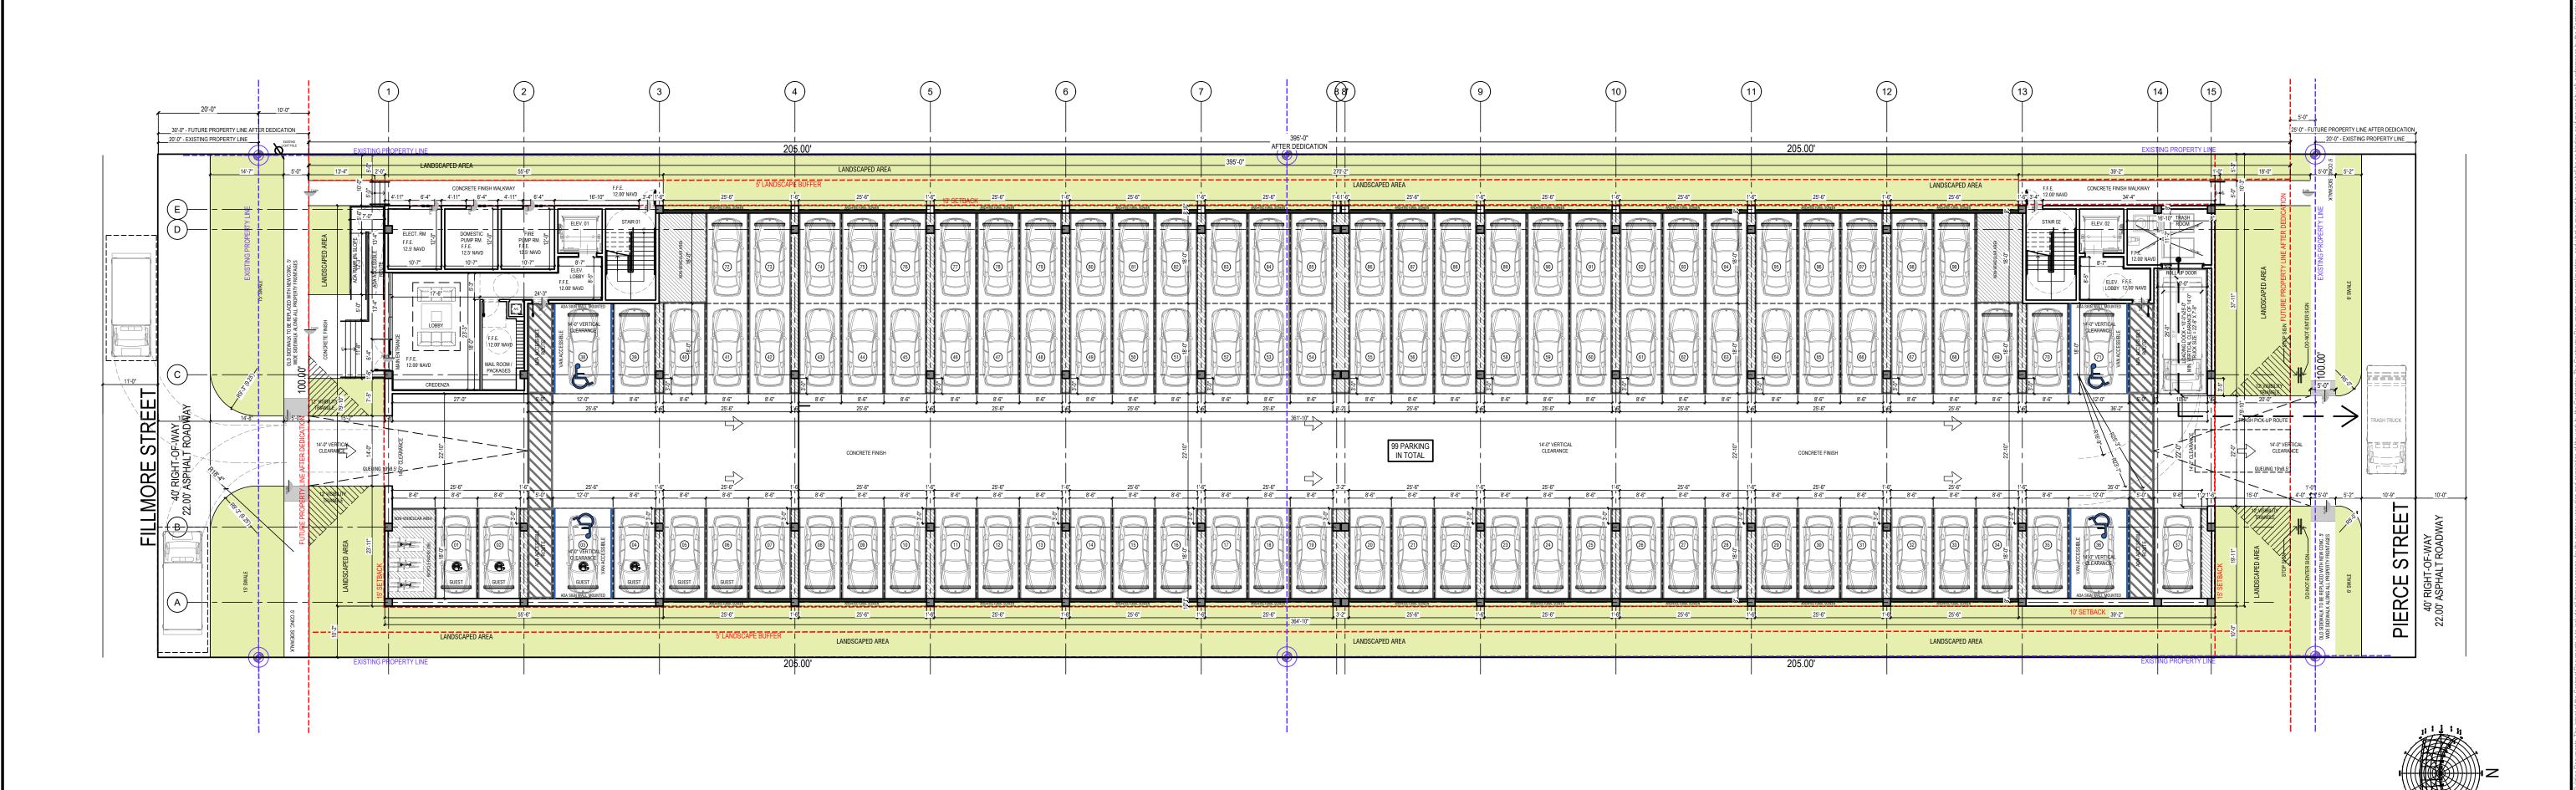
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GROUND FLOOR

MEETING DATES

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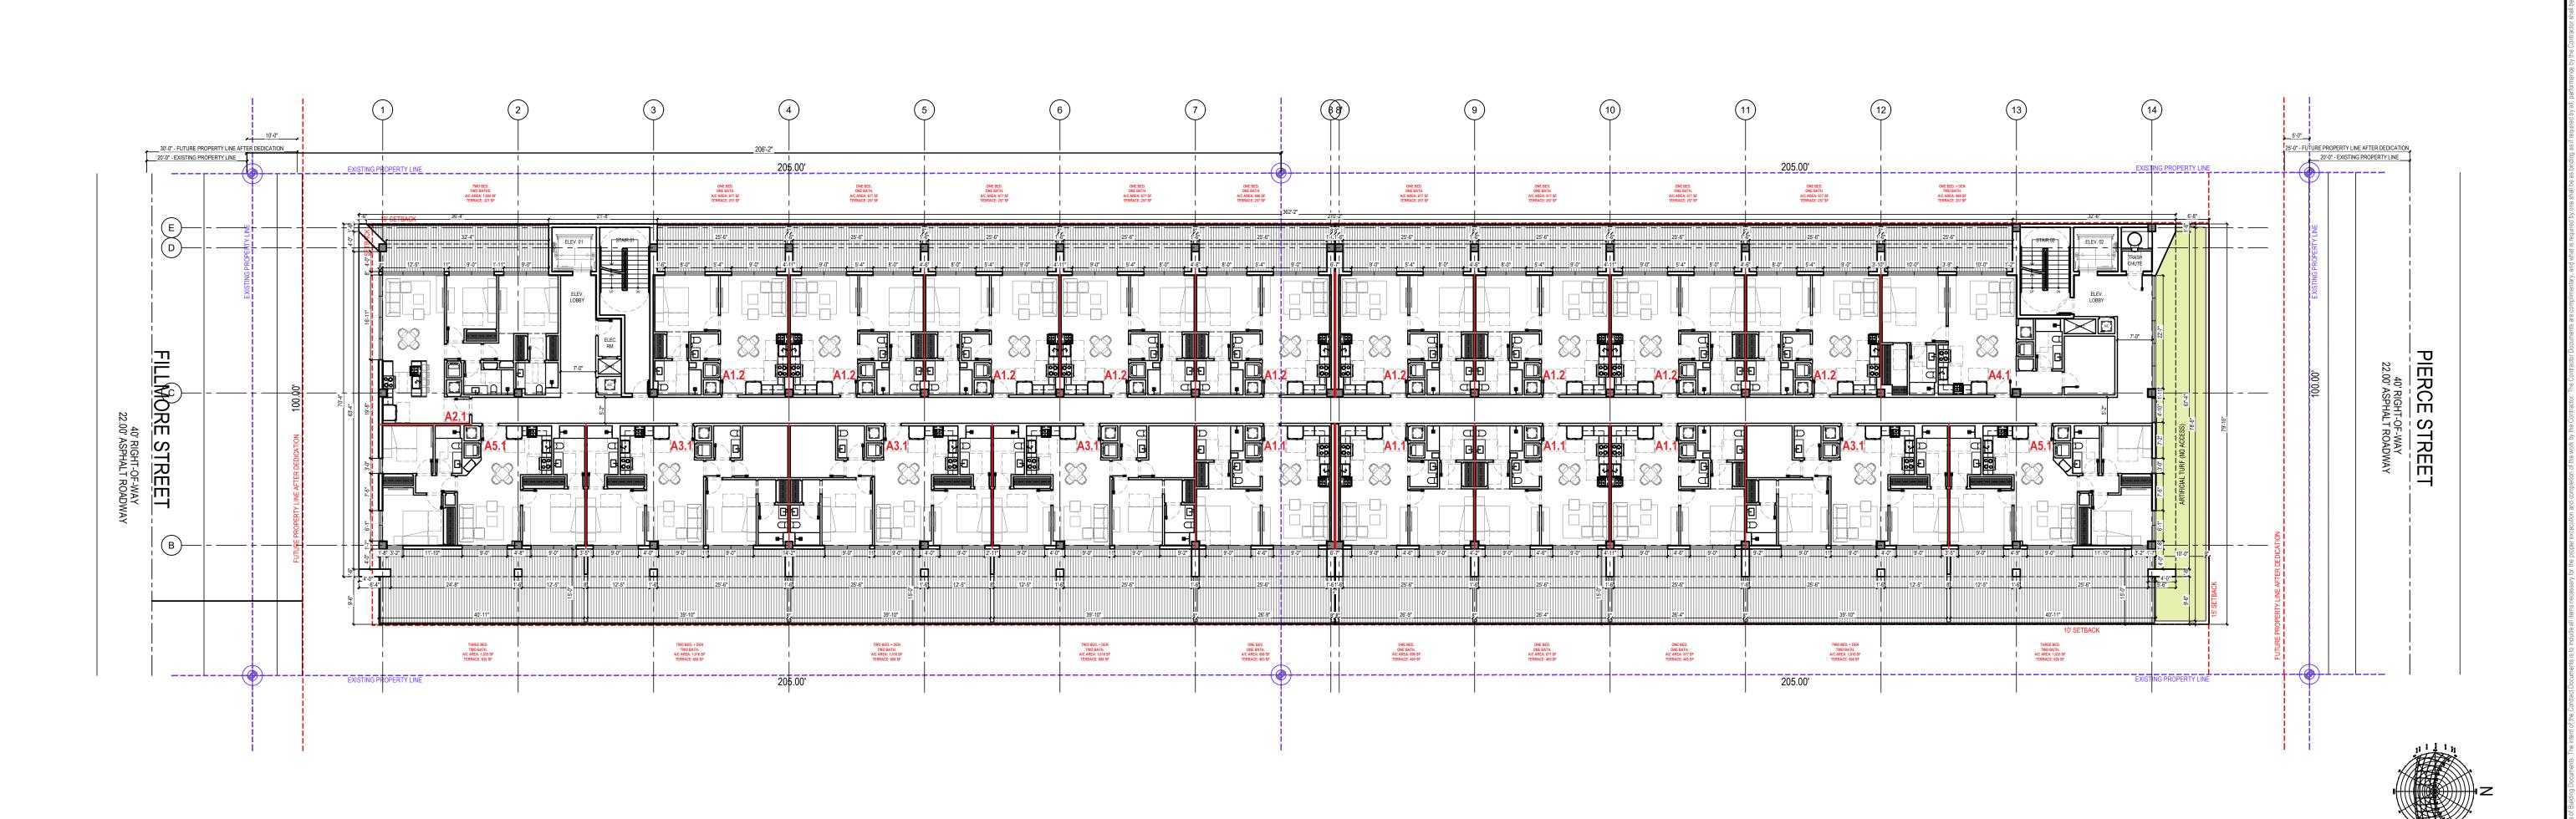
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SECOND FLOOR

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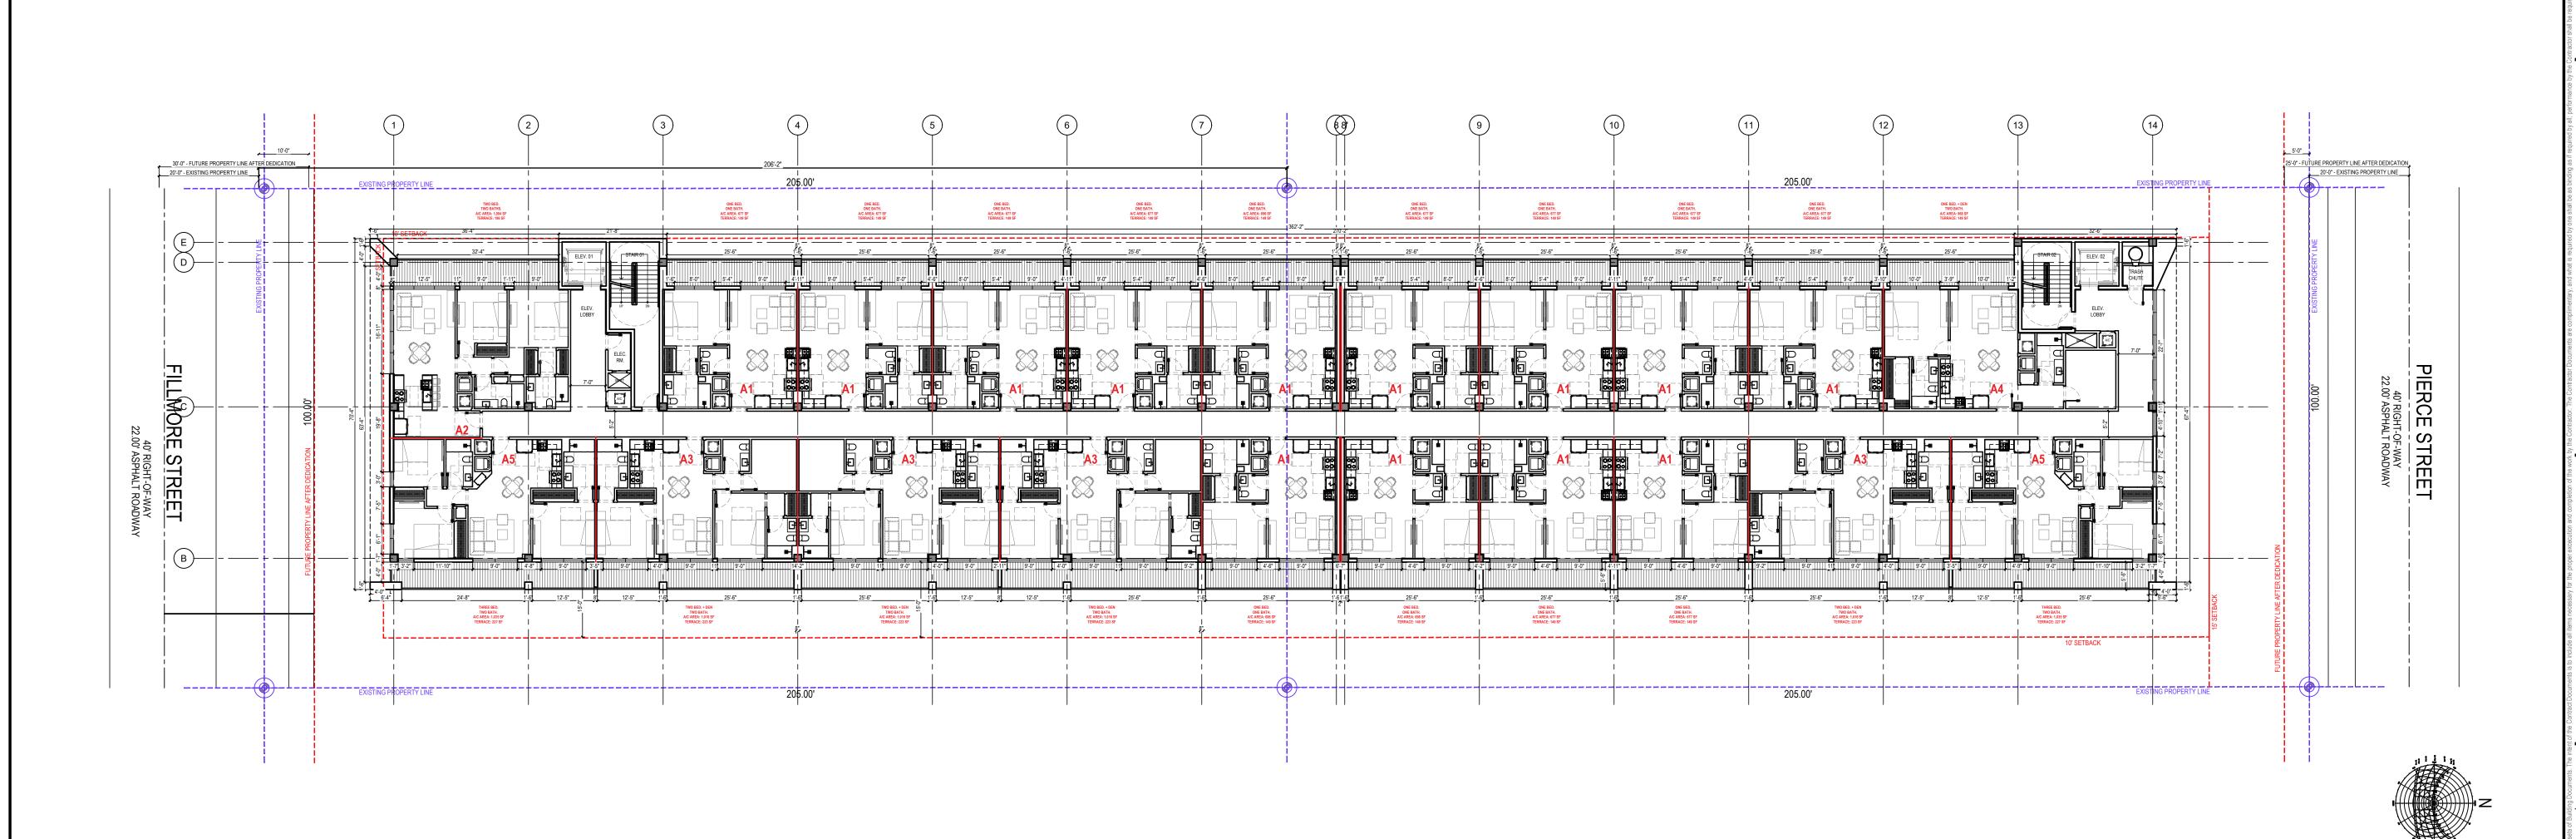
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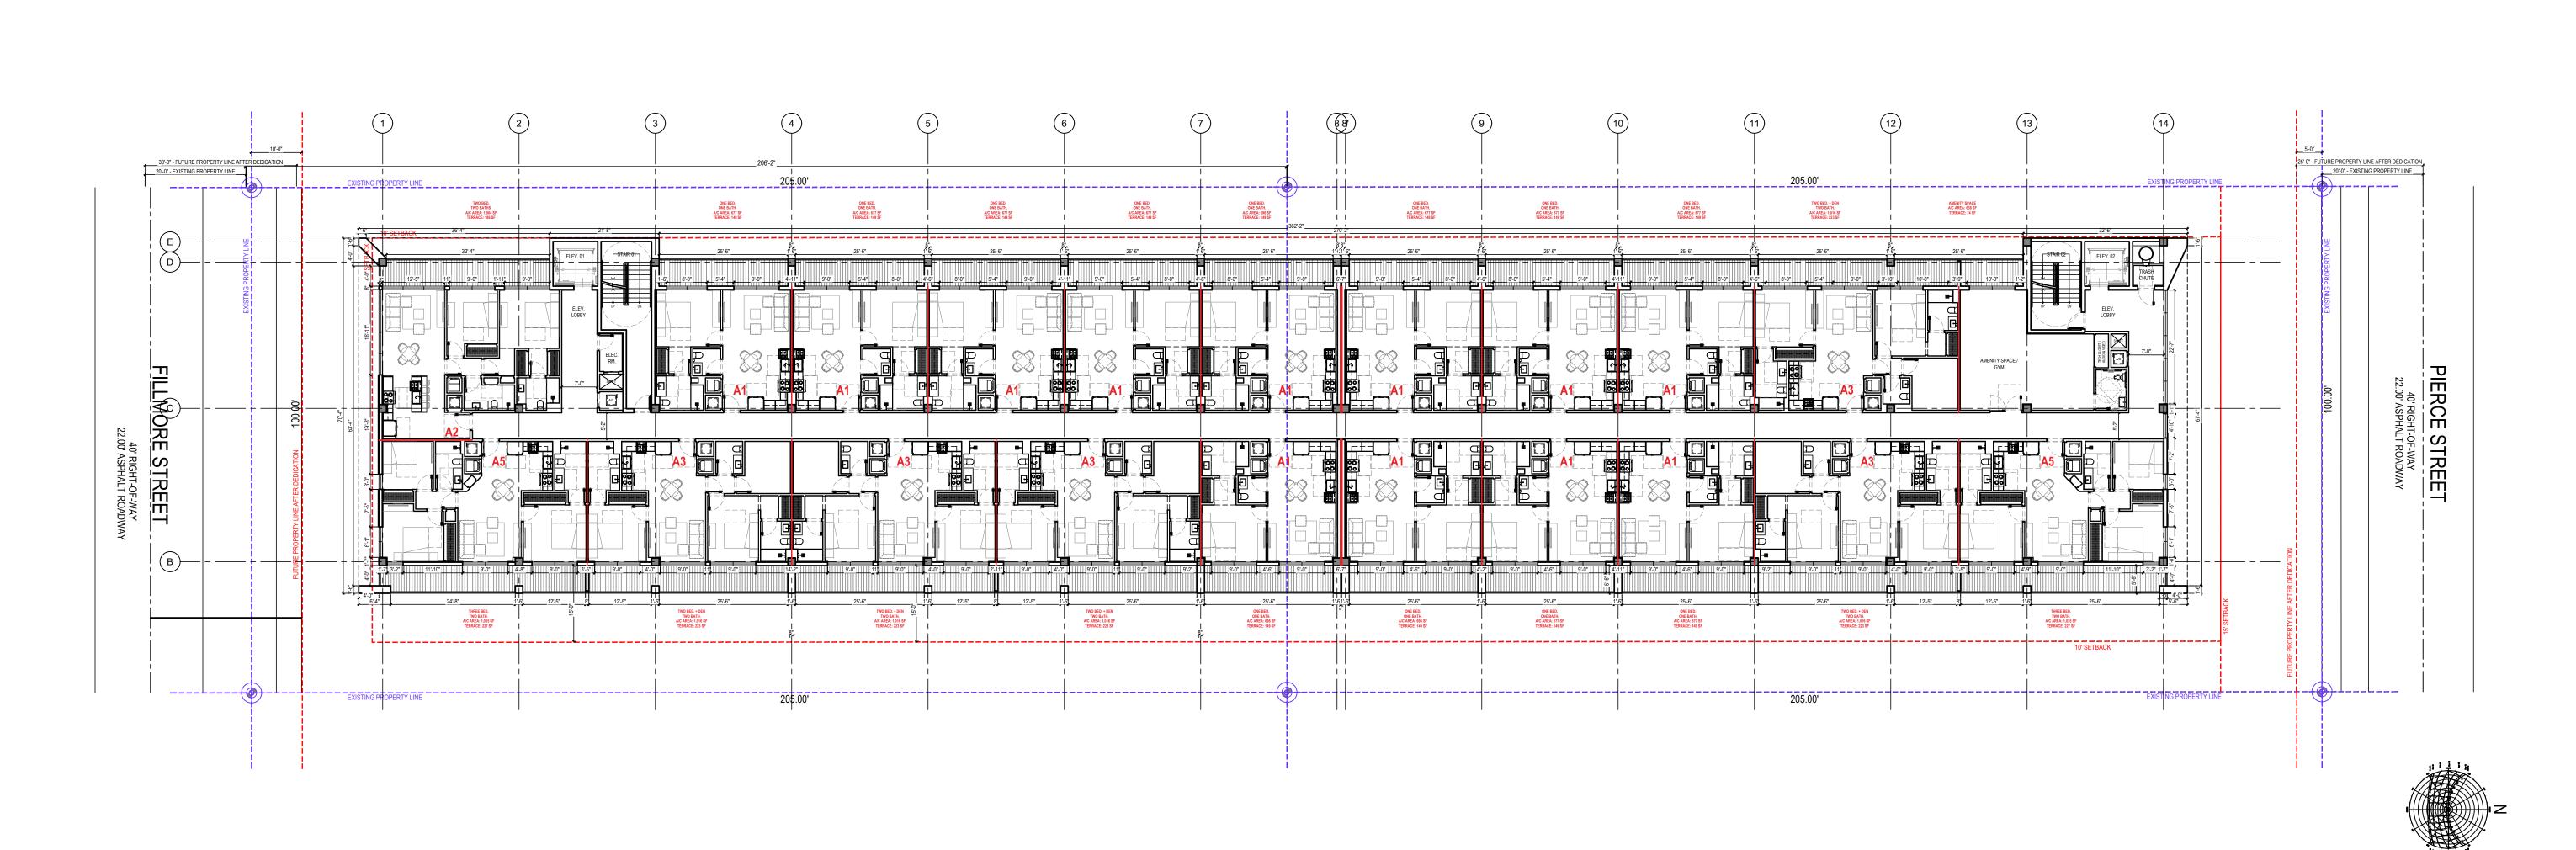
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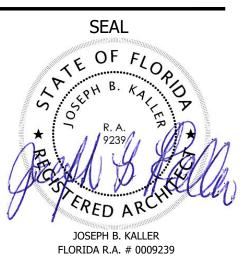
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FOURTH FLOOR

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FILE# 23-DP-45

T.B.D

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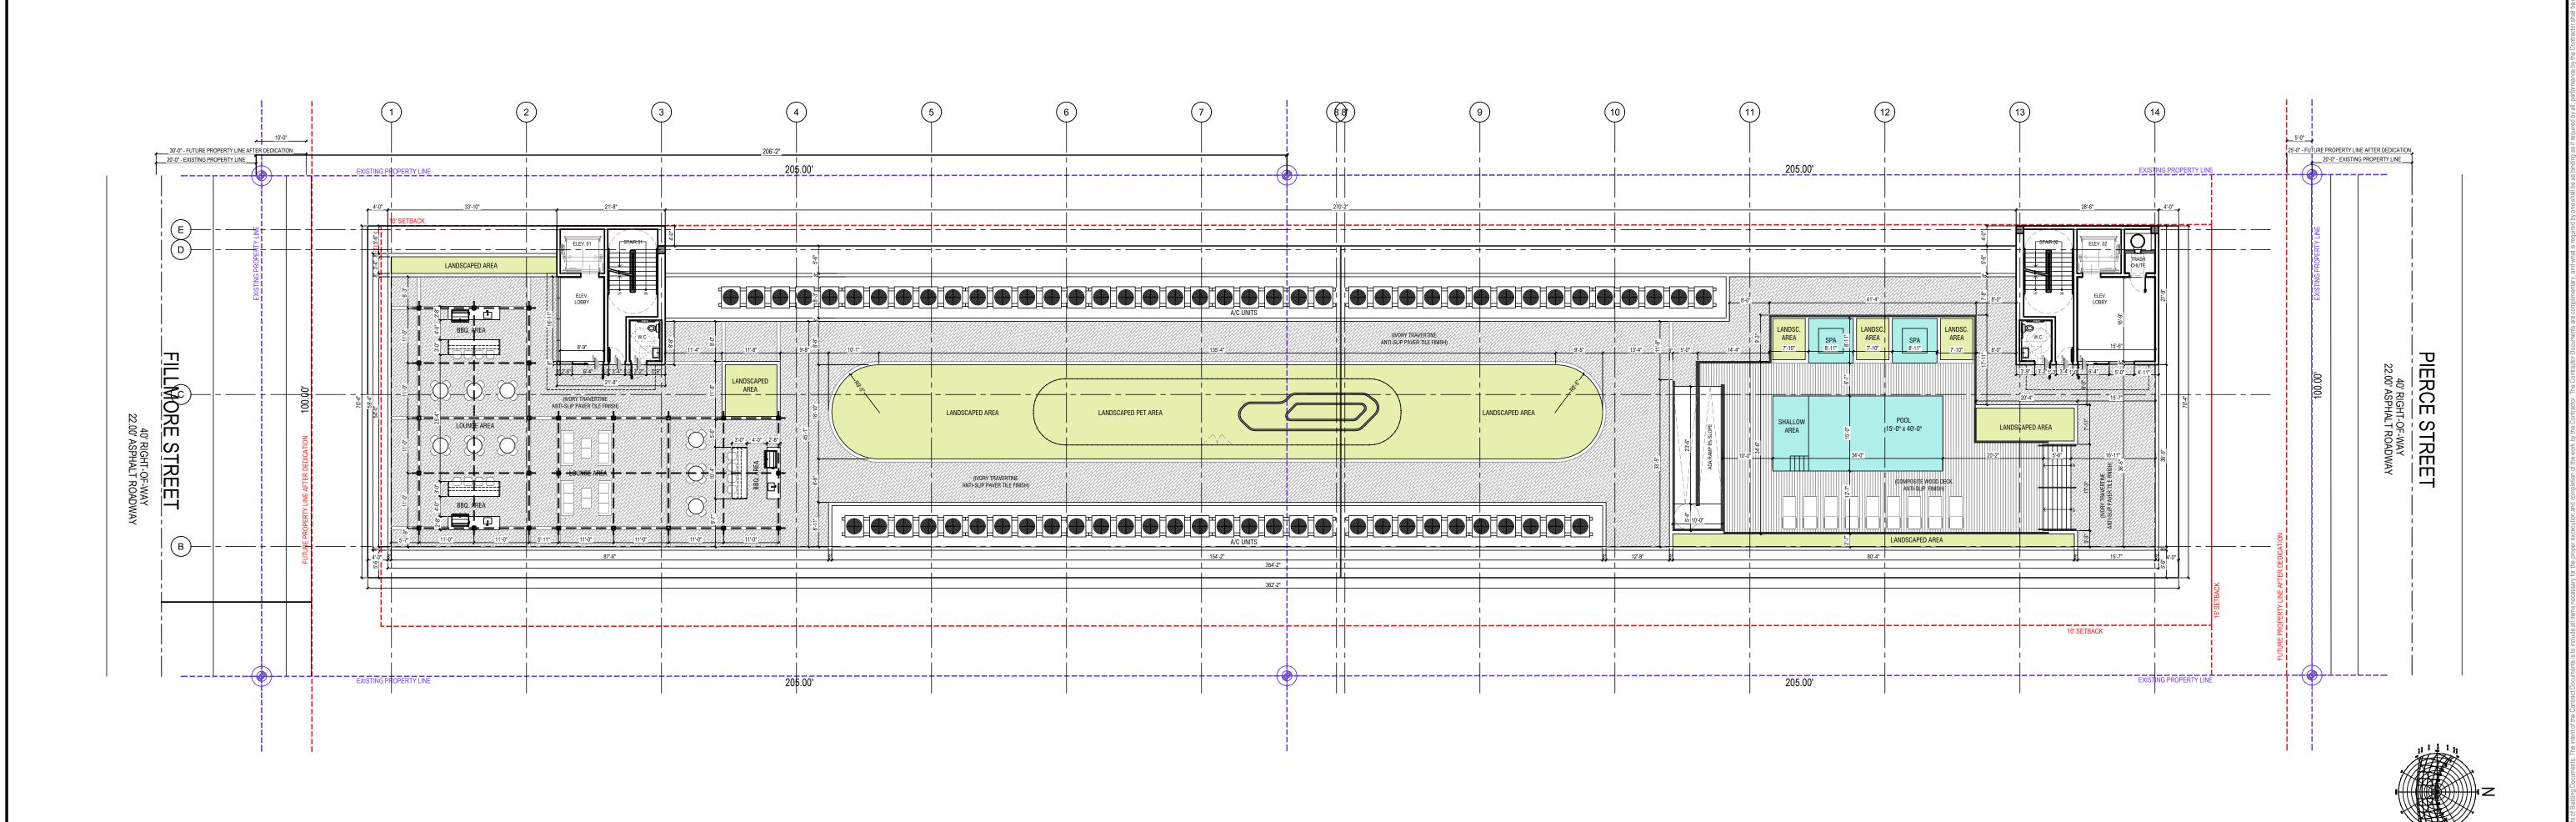
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FIFTH FLOOR (ROOF TERRACE)

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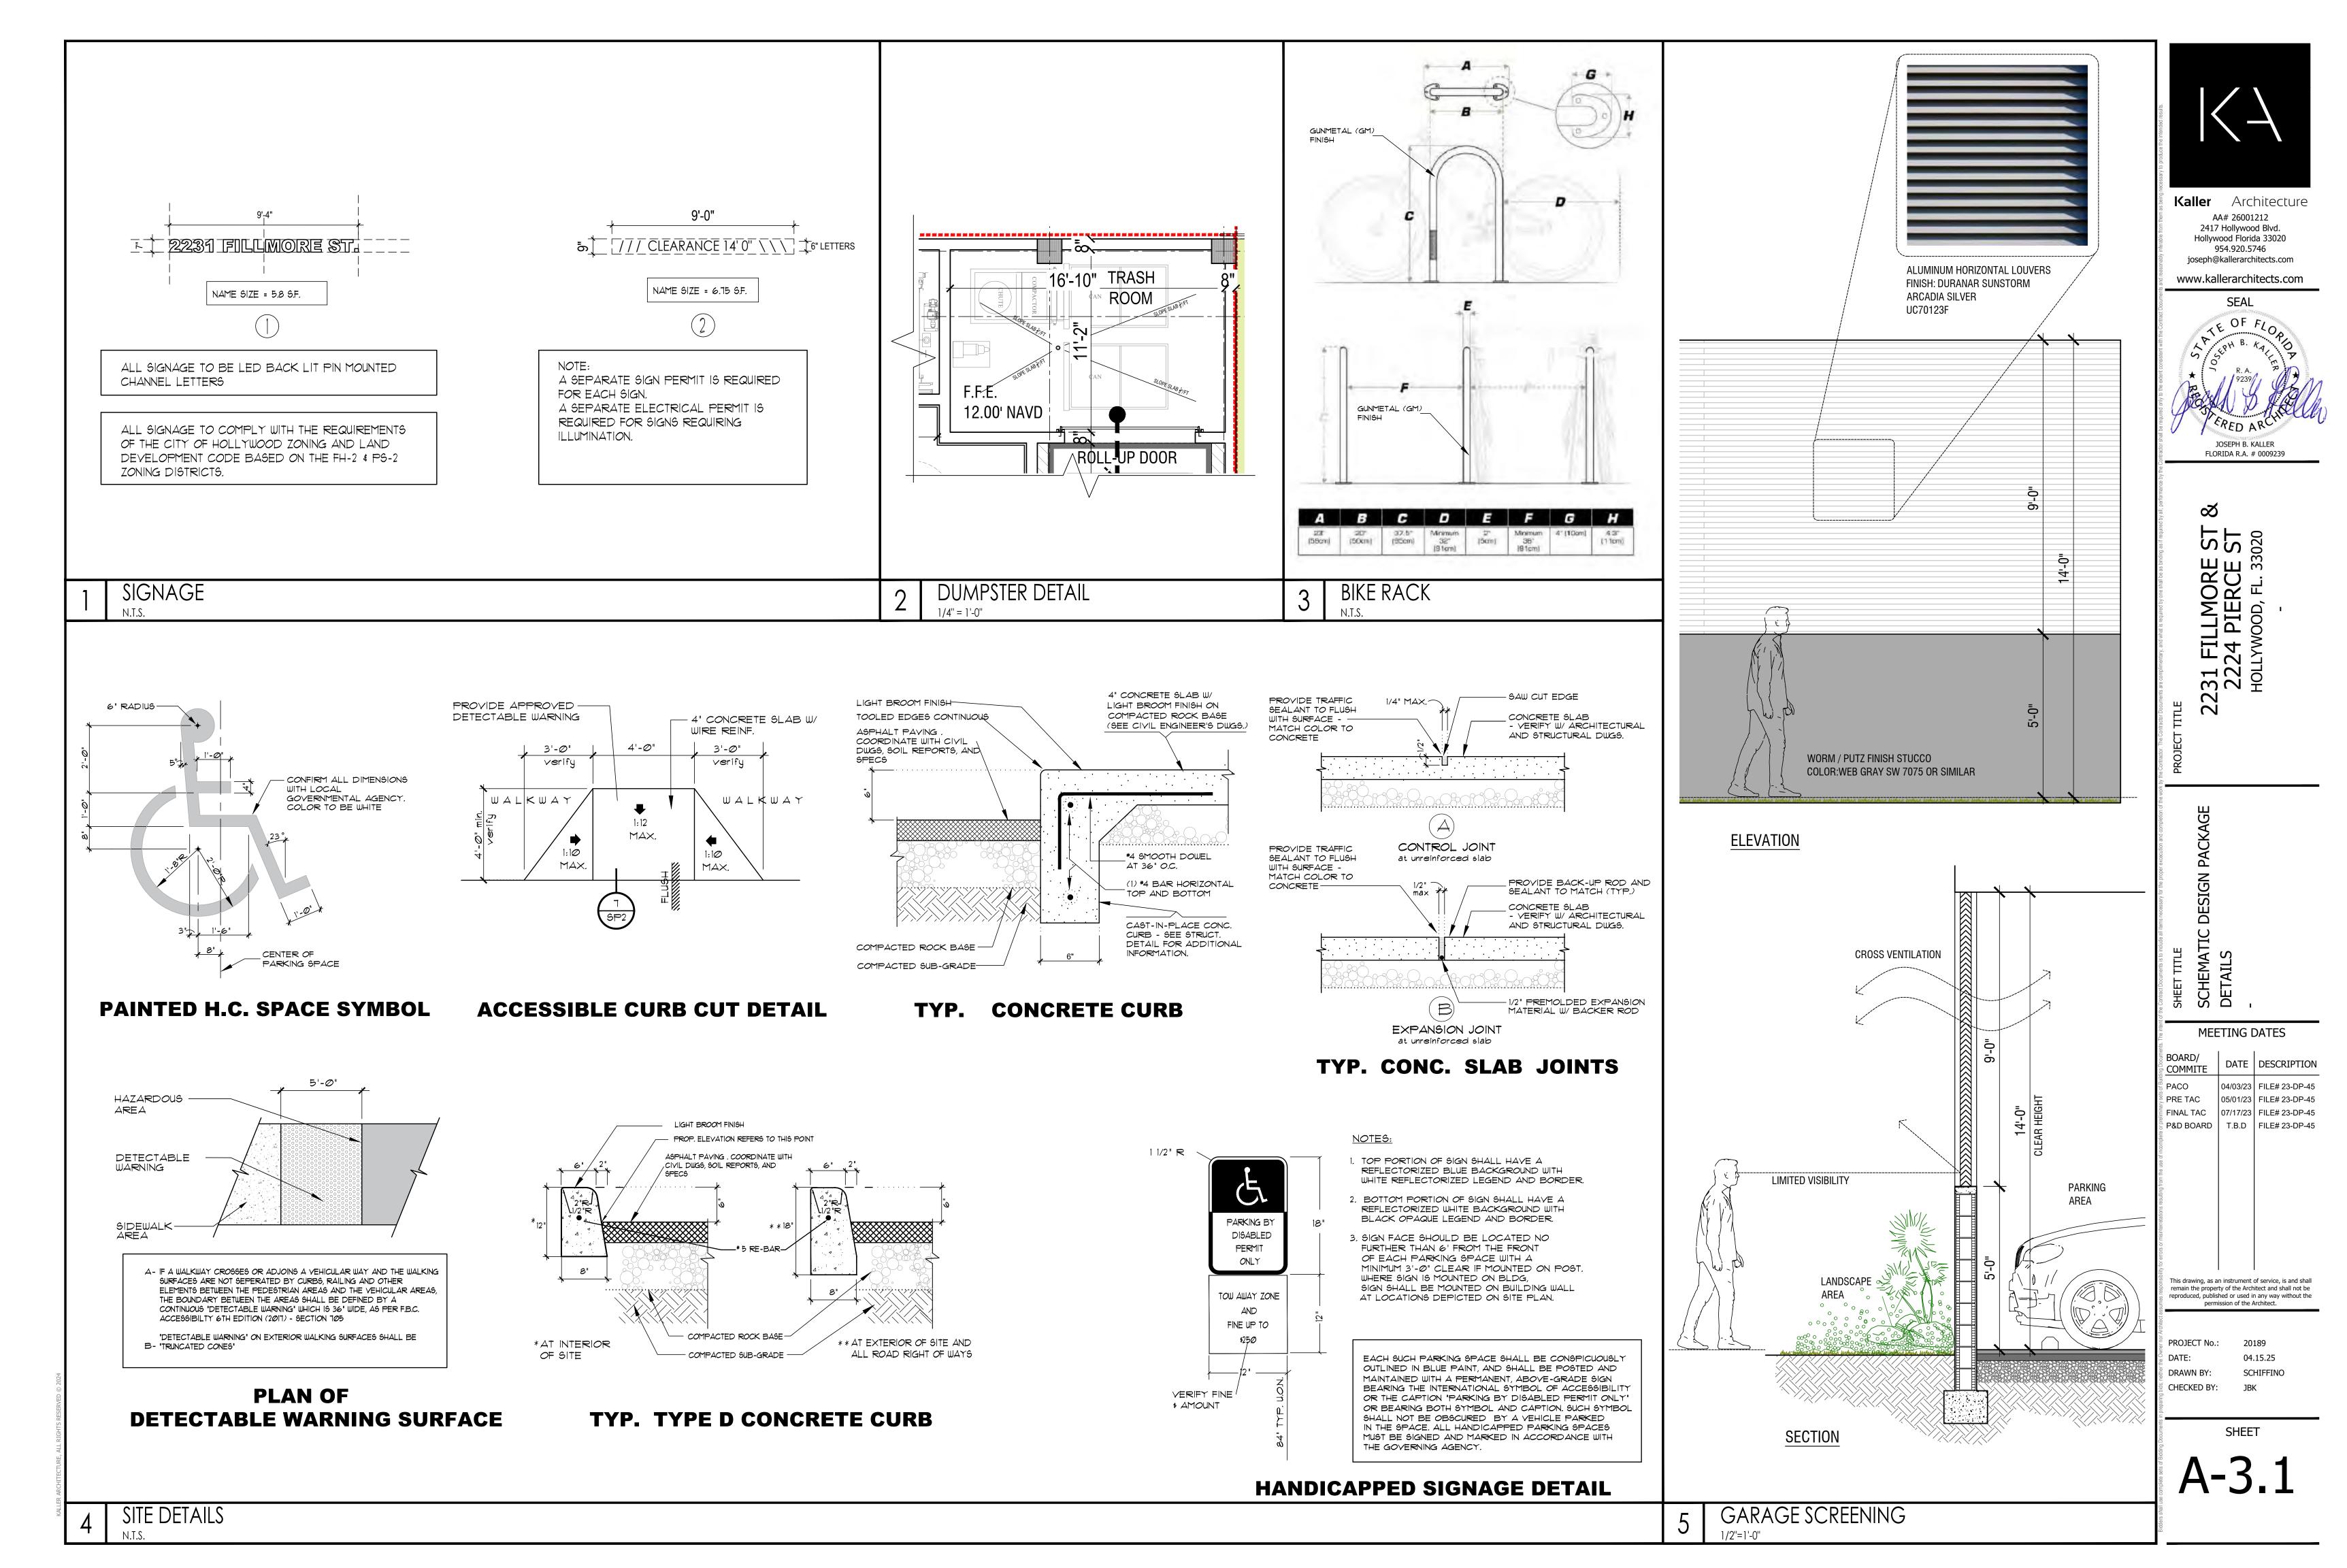
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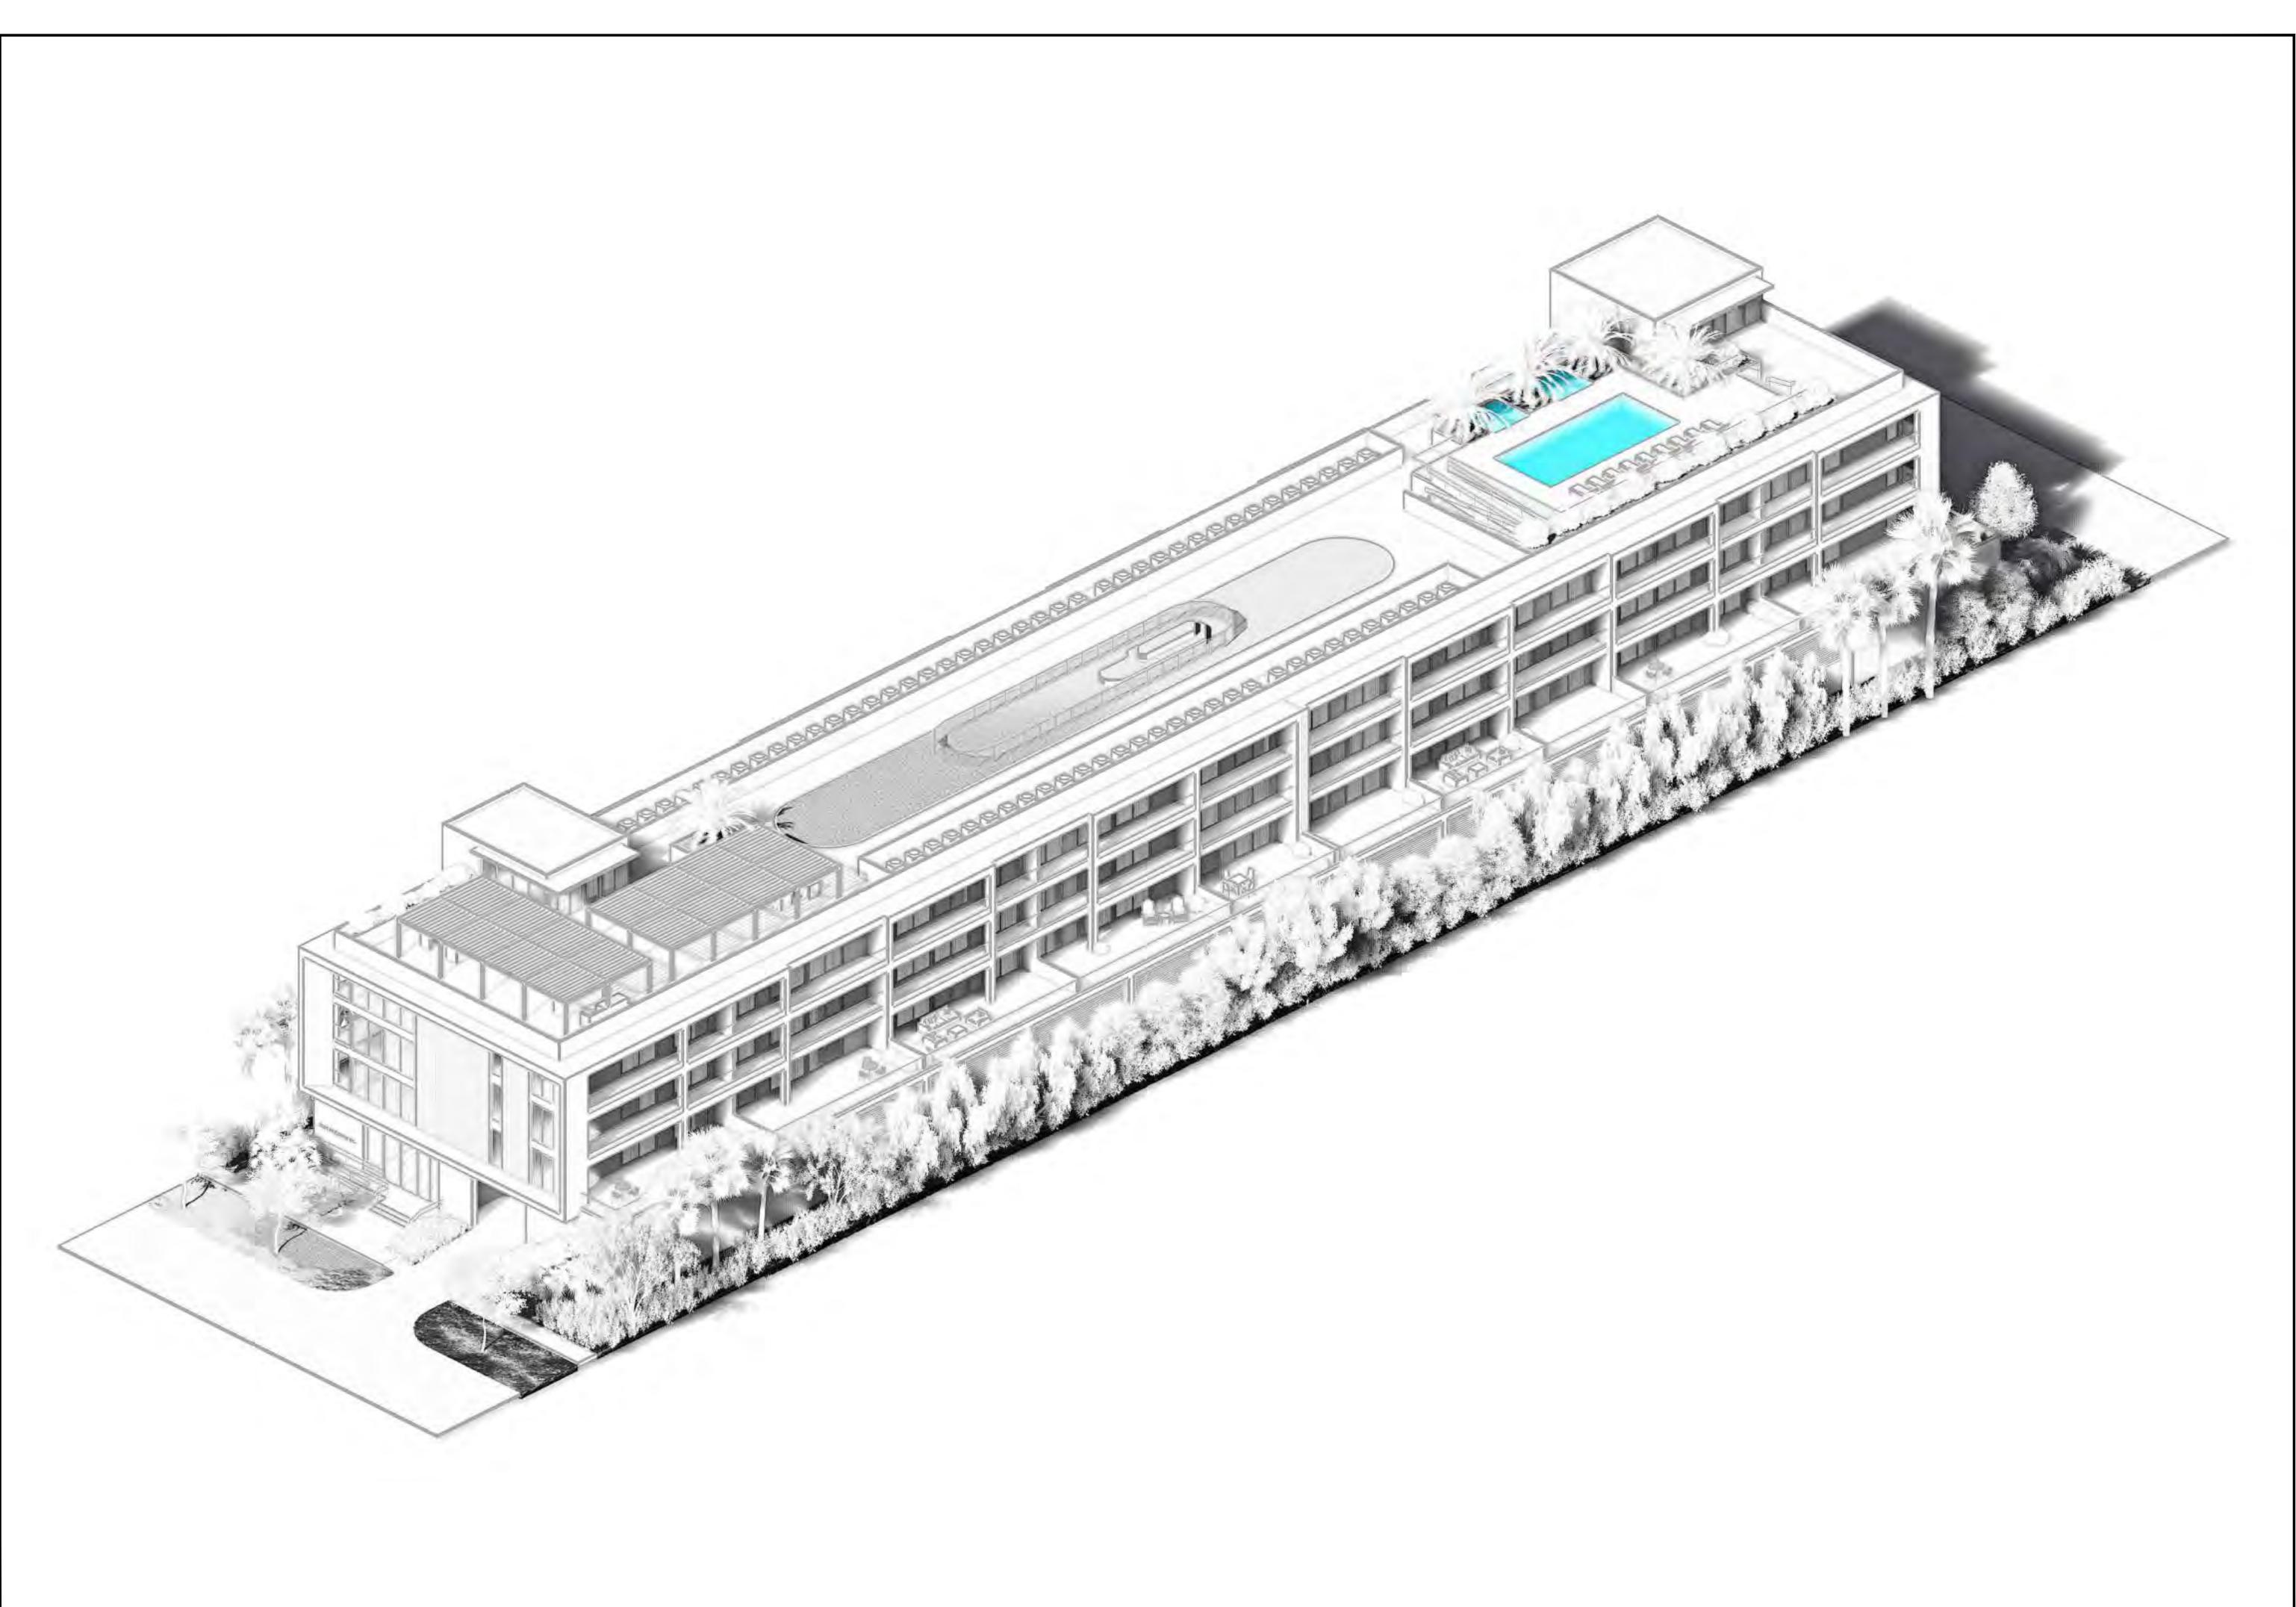
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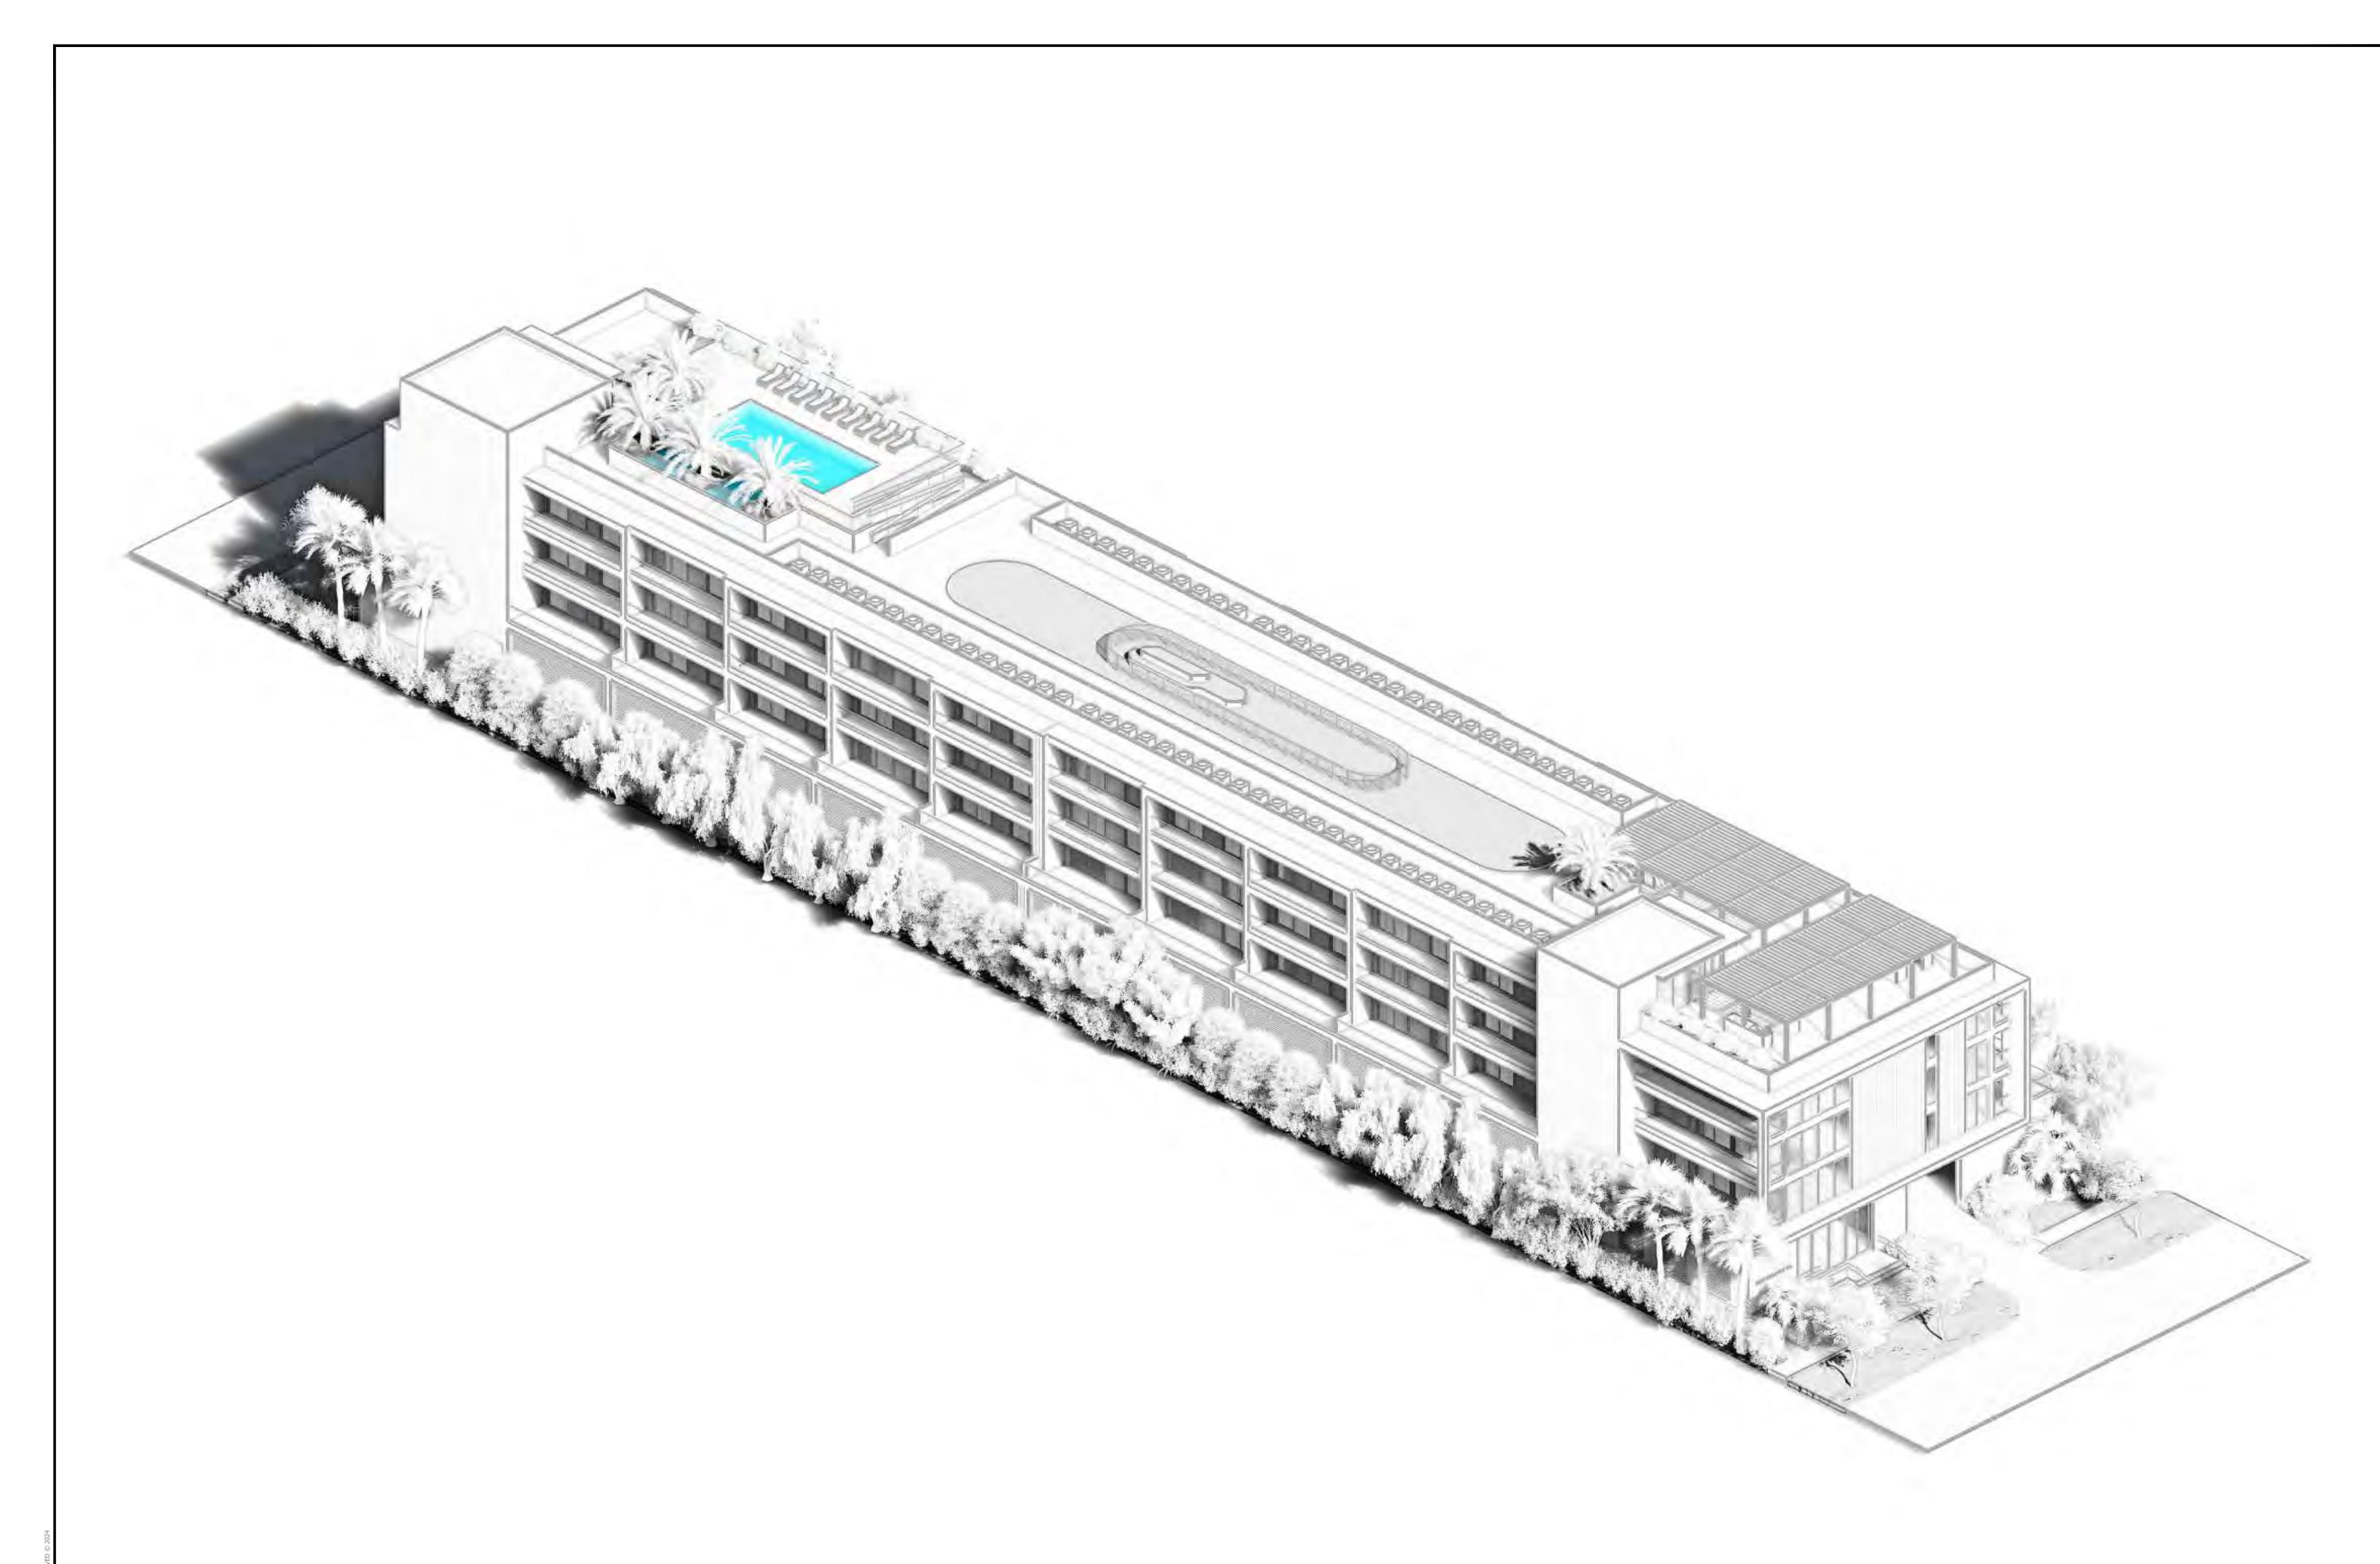
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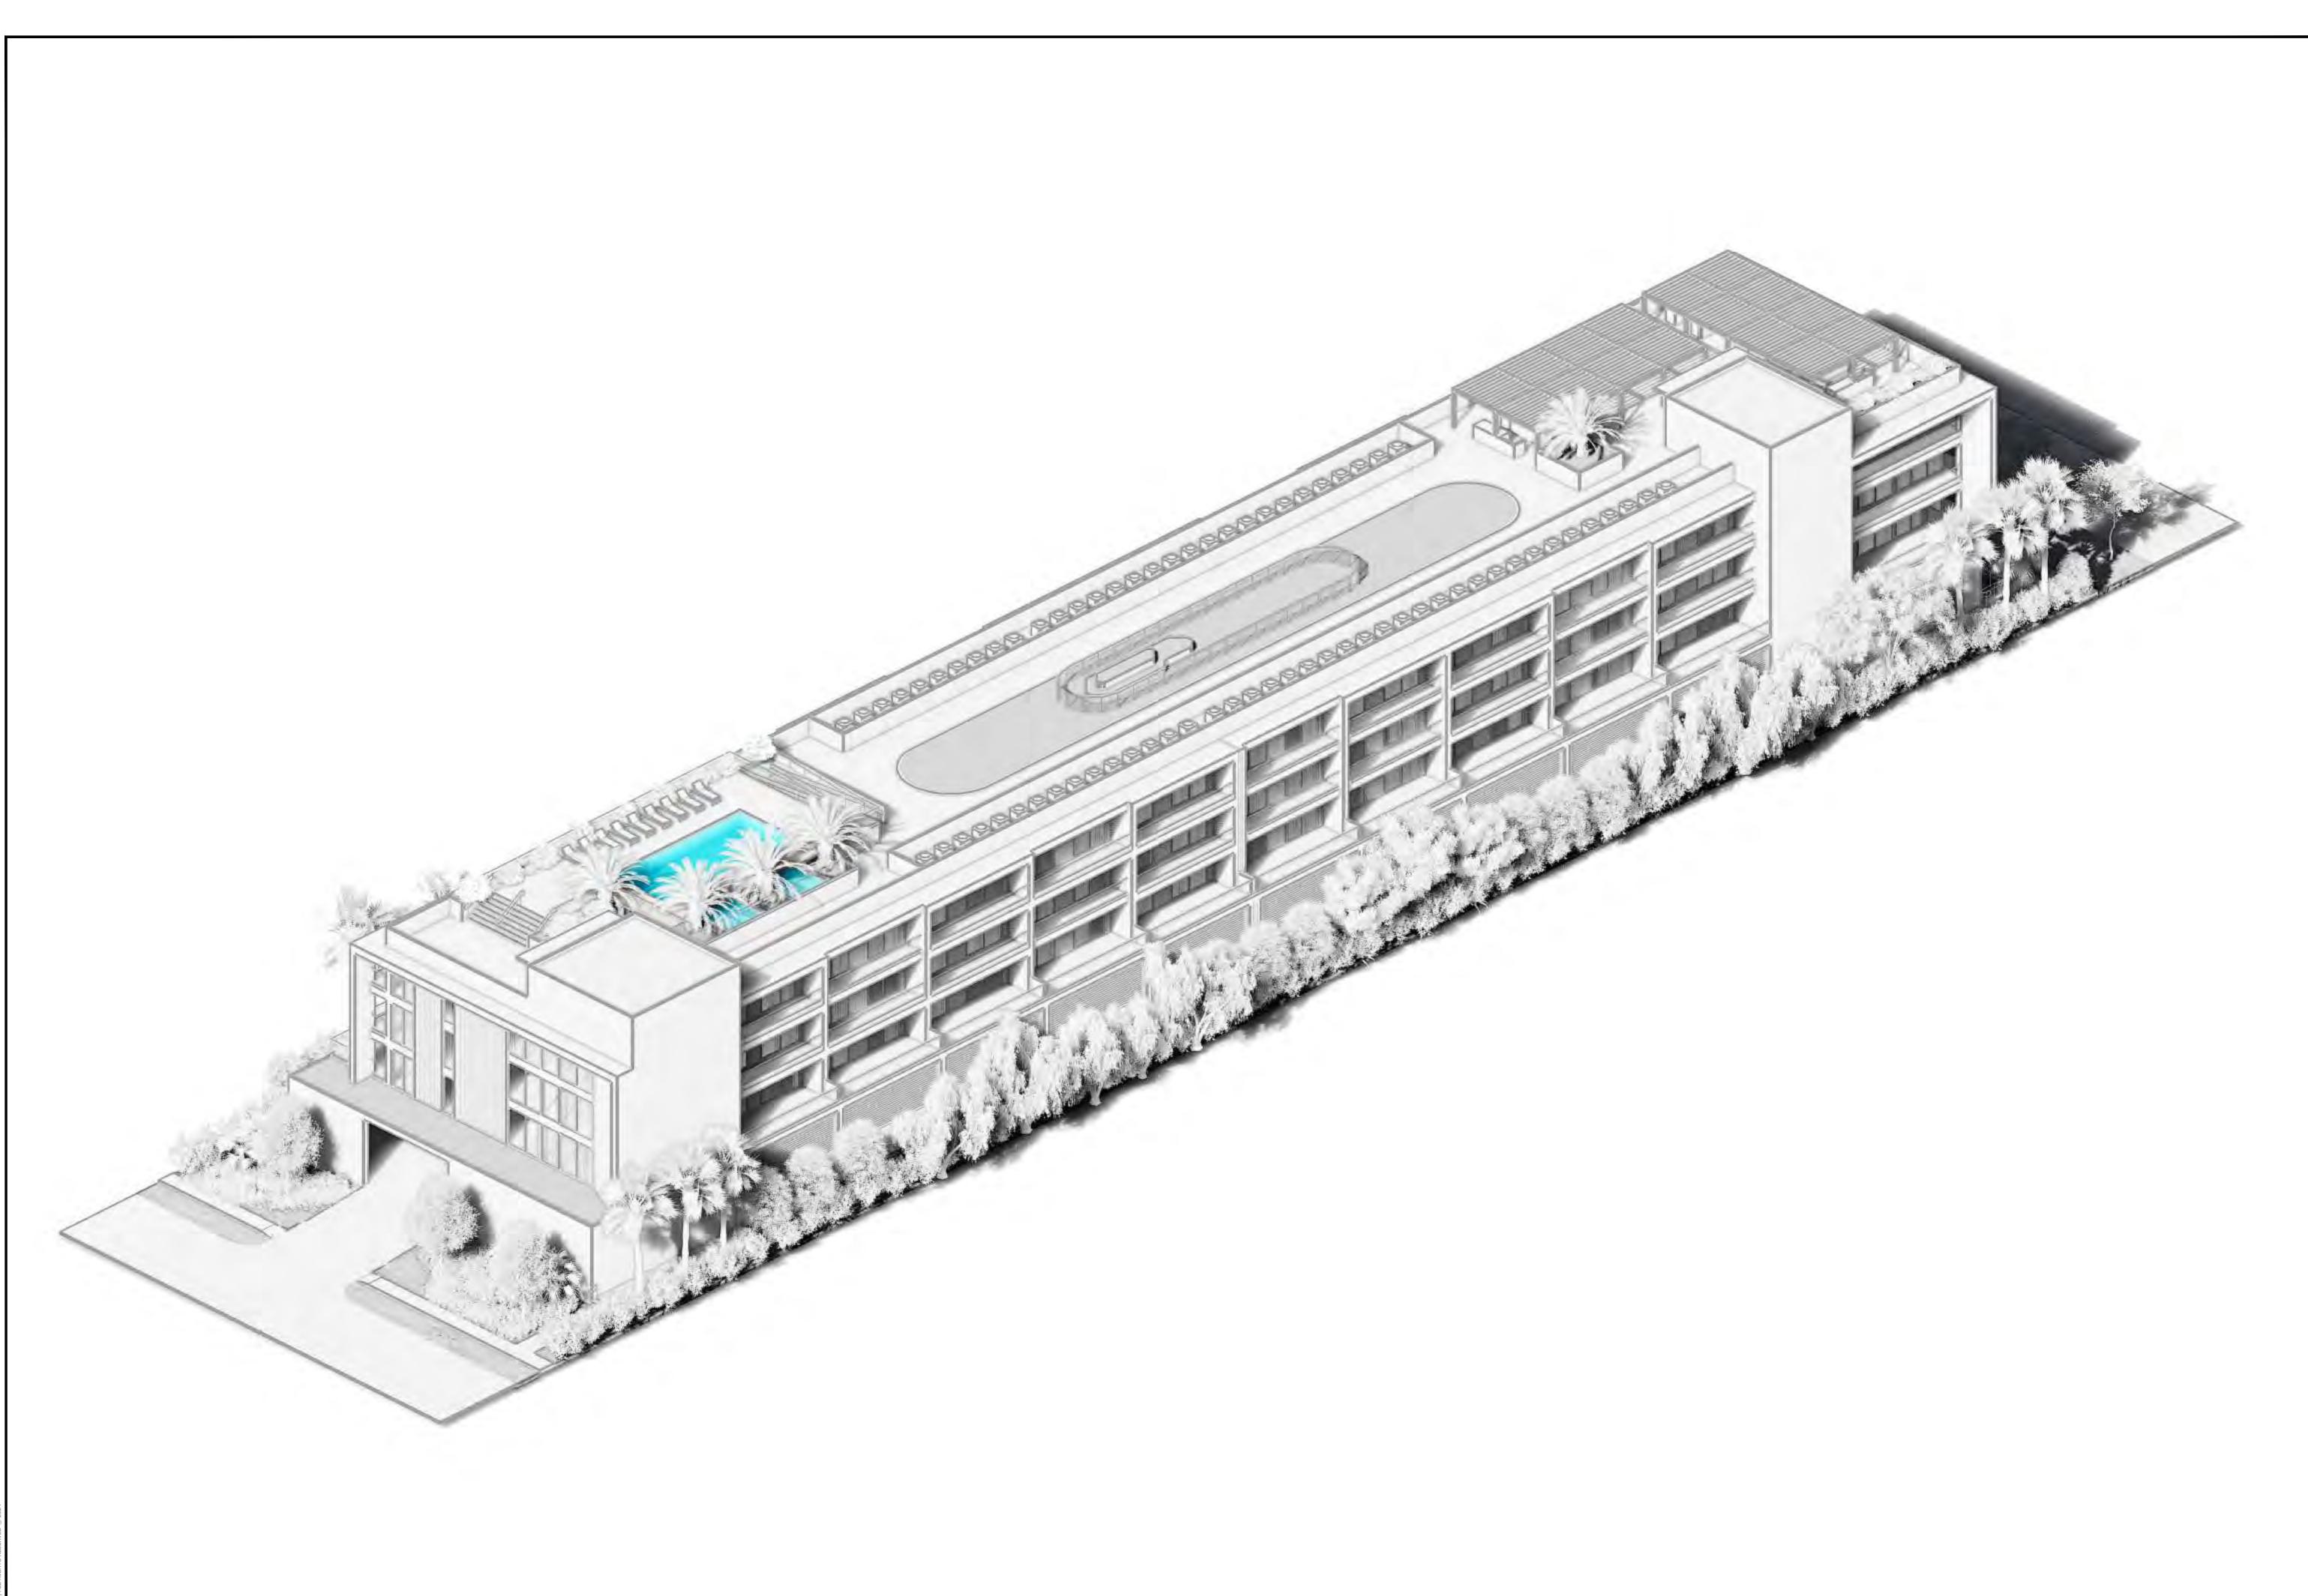
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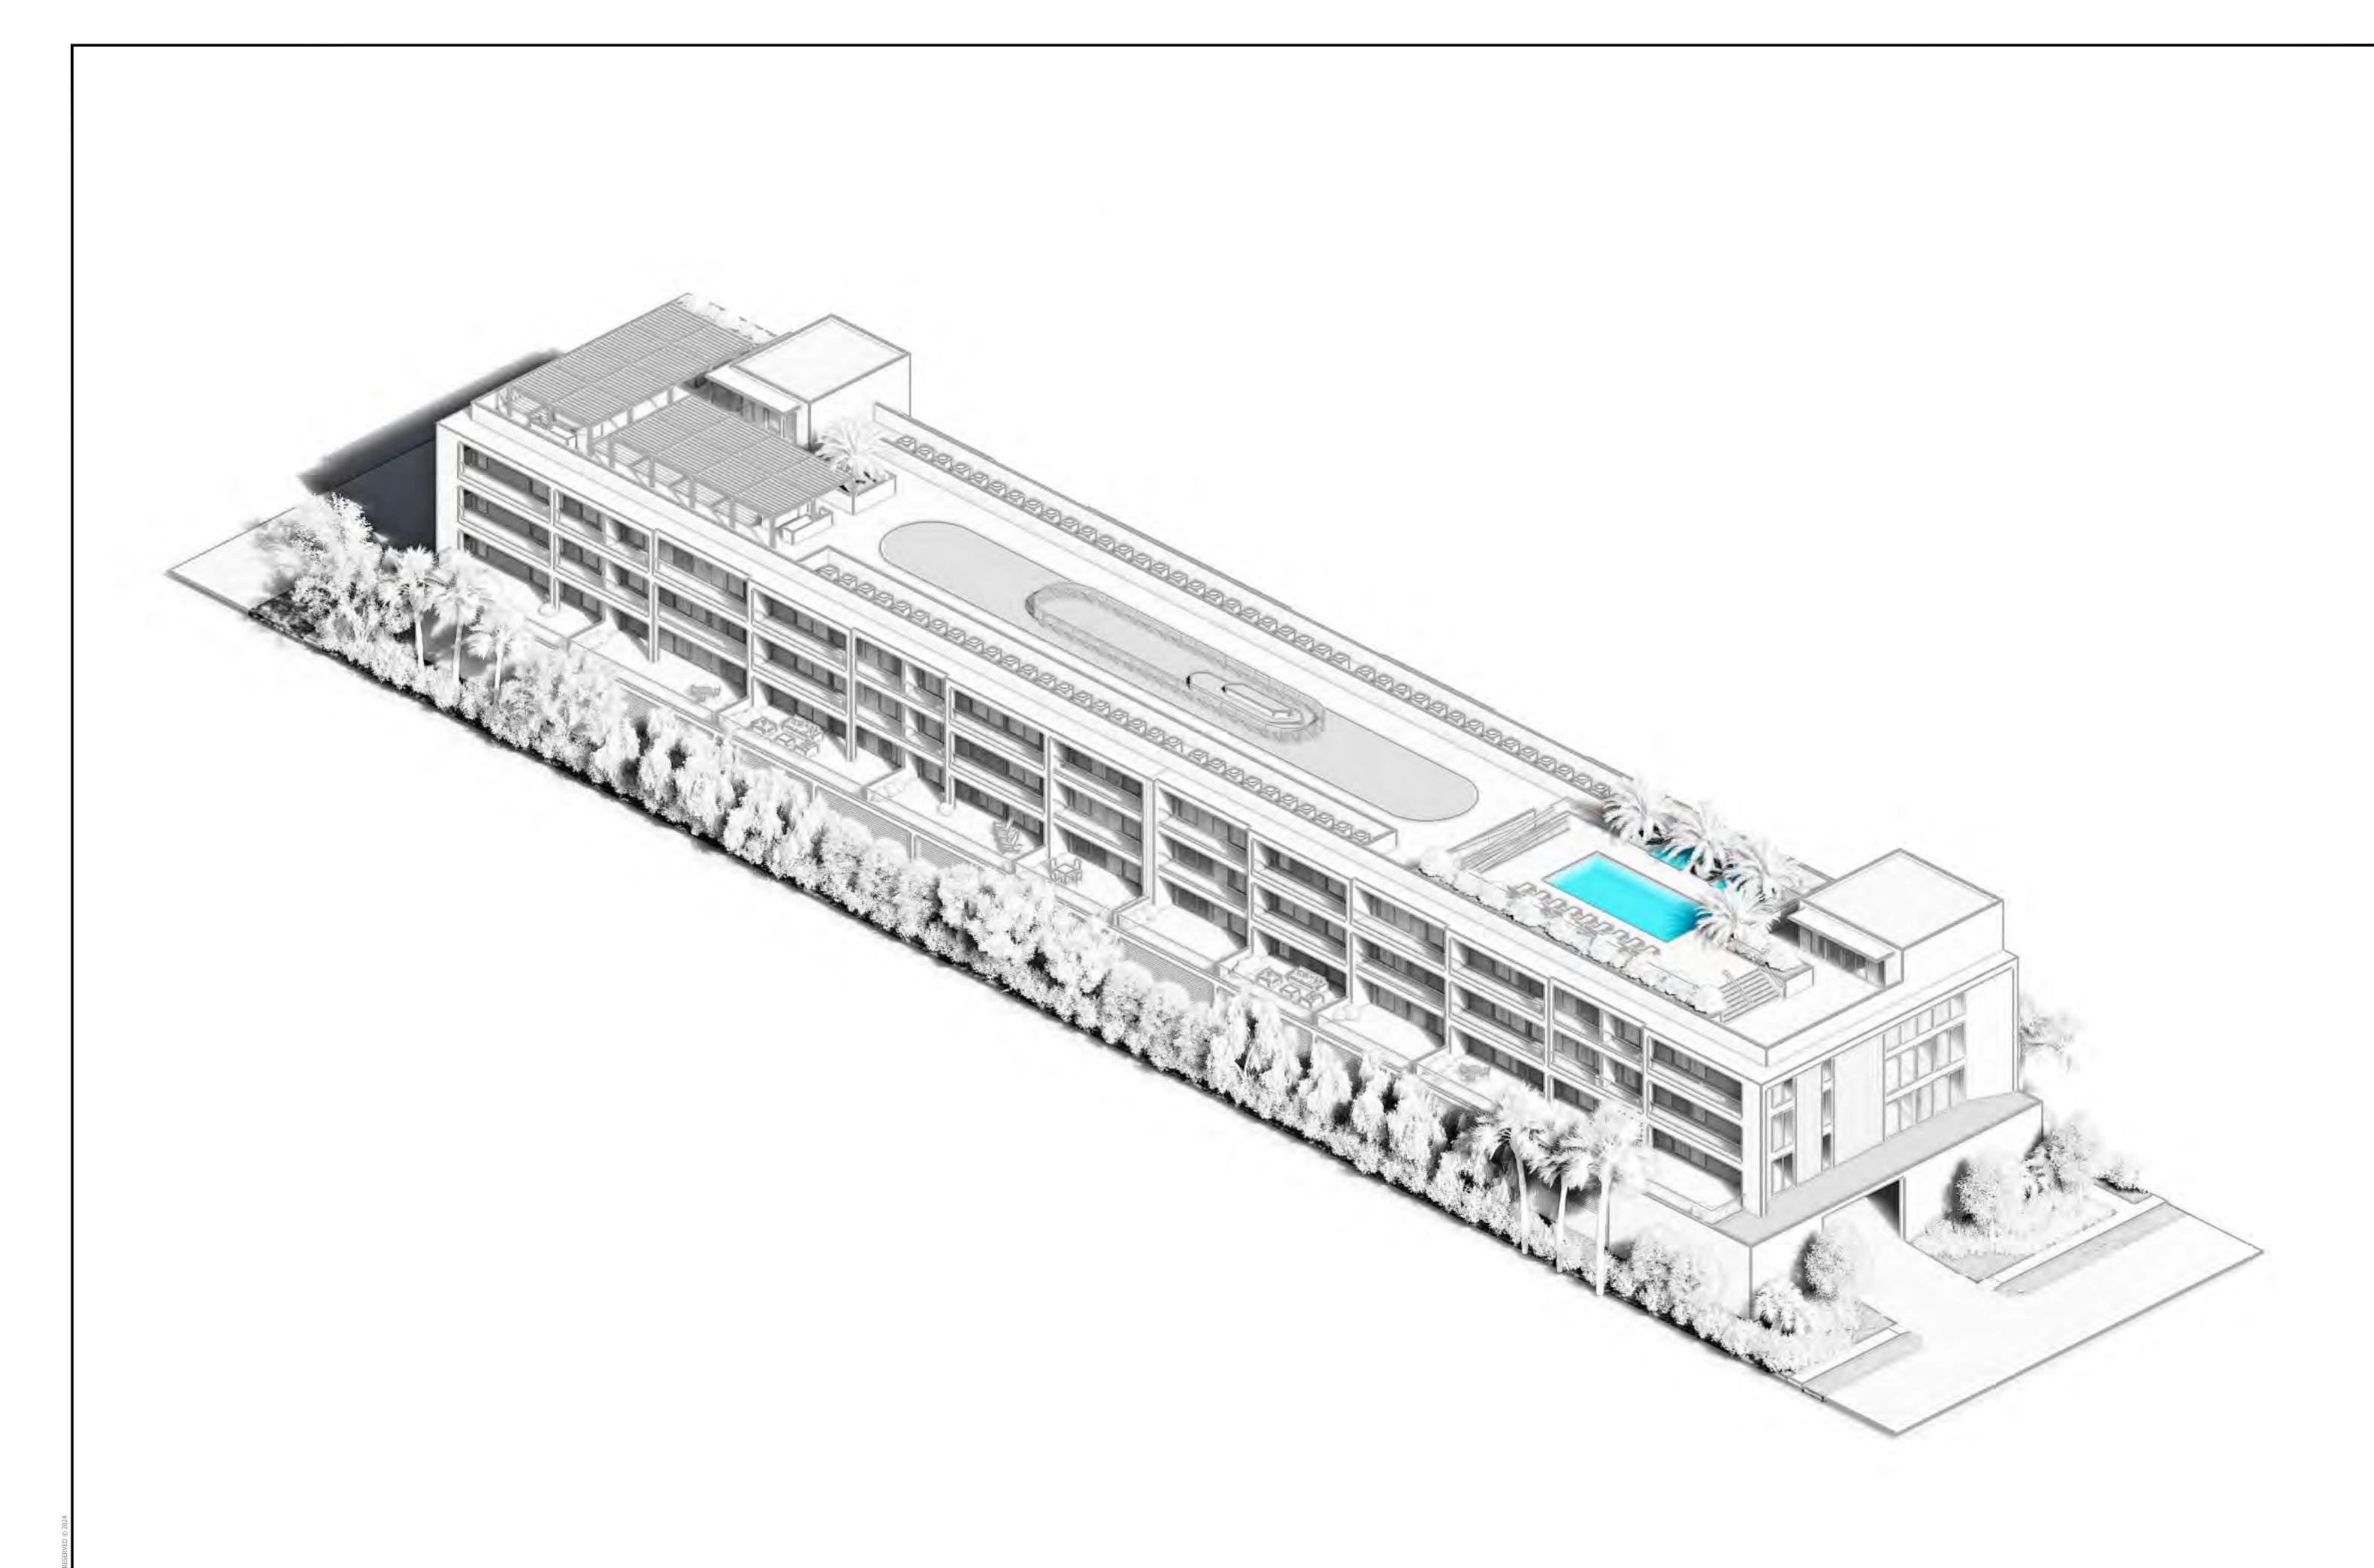
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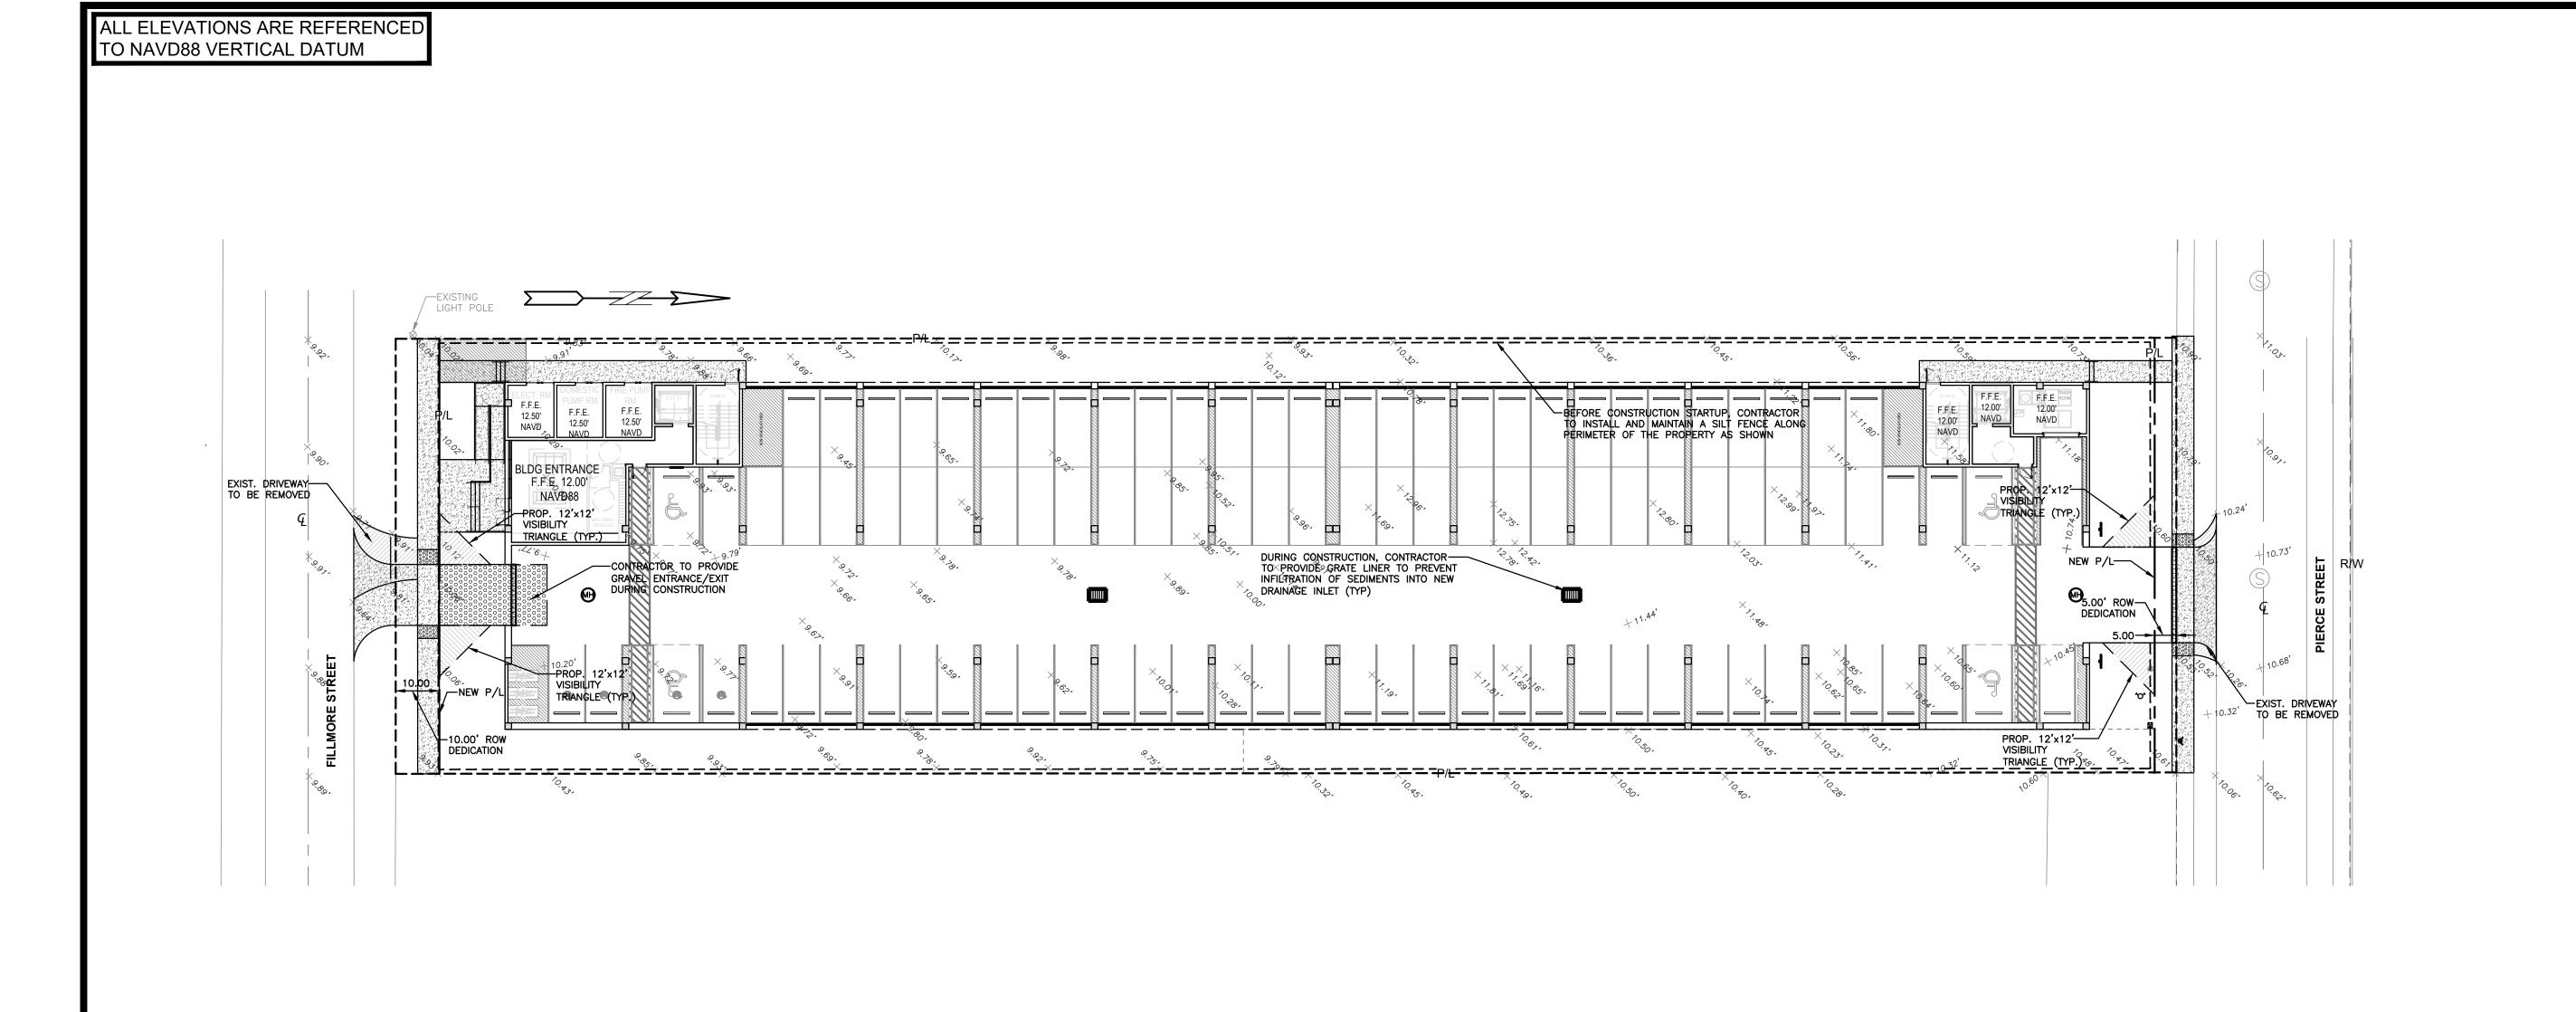
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BMP NOTES:

1. ALL SEDIMENT CONTROL MEASURES ARE TO BE ADJUSTED TO MEET FIELD CONDITIONS AT THE TIME OF CONSTRUCTION AND BE CONSTRUCTED PRIOR TO ANY GRADING OR DISTURBANCE OF EXISTING SURFACE MATERIAL ON BALANCE OF SITE. PERIMETER SEDIMENT BARRIERS SHALL BE CONSTRUCTED TO PREVENT SEDIMENT OR TRASH FROM FLOWING OR FLOATING ON TO ADJACENT

2. PERIODIC INSPECTION AND MAINTENANCE OF ALL SEDIMENT CONTROL STRUCTURES MUST BE PROVIDED TO ENSURE INTENDED PURPOSE IS ACCOMPLISHED. THE DEVELOPER, OWNER AND/OR CONTRACTOR SHALL BE CONTINUALLY RESPONSIBLE FOR ALL SEDIMENT CONTROLS. SEDIMENT CONTROL MEASURES SHALL BE IN WORKING CONDITION AT THE END OF EACH WORKING DAY.

3. SEDIMENT WILL BE PREVENTED FROM ENTERING ANY STORM WATER SYSTEM, DITCH OR CHANNEL. ALL STORMWATER INLETS THAT ARE MADE OPERABLE DURING CONSTRUCTION SHALL BE PROTECTED SO THAT SEDIMENT-LADEN WATER CANNOT ENTER THE CONVEYANCE SYSTEM WITHOUT FIRST BEING FILTERED OR OTHERWISE TREATED TO REMOVE SEDIMENT.

4. WHERE CONSTRUCTION VEHICLE ACCESS ROUTES INTERSECT PAVED PUBLIC ROADS, PROVISIONS SHALL BE MADE TO MINIMIZE THE TRANSPORT OF SEDIMENT BY TRACKING ONTO THE PAVED SURFACE. WHERE SEDIMENT IS TRANSPORTED ONTO A PUBLIC ROAD SURFACE WITH CURBS AND GUTTERS, THE ROAD SHALL BE CLEANED THOROUGHLY AT THE END OF EACH DAY. SEDIMENT SHALL BE REMOVED FROM THE ROADS BY SHOVELING OR SWEEPING AND TRANSPORTED TO A SEDIMENT CONTROL DISPOSAL AREA. STREET WASHING SHALL BE ALLOWED ONLY AFTER SEDIMENT IS REMOVED IN THIS MANNER. THIS PROVISION SHALL APPLY TO INDIVIDUAL SUBDIVISION LOTS AS WELL AS TO LARGER LAND DISTURBING ACTIVITIES.

5. PERMANENT OR TEMPORARY SOIL STABILIZATION SHALL BE APPLIED TO DENUDED AREAS WITHIN SEVEN (7) DAYS AFTER FINAL GRADE IS REACHED ON ANY PORTION OF THE SITE. TEMPORARY SOIL STABILIZATION SHALL BE APPLIED WITHIN SEVEN (7) DAYS TO DENUDED AREAS THAT MAY NOT BE AT FINAL GRADE BUT WILL REMAIN UNDISTURBED FOR LONGER THAN THIRTY (30) DAYS. PERMANENT STABILIZATION SHALL BE APPLIED TO AREAS THAT ARE TO BE LEFT UNDISTURBED FOR MORE THAN ONE YEAR.

6. DURING CONSTRUCTION OF THE PROJECT, SOIL STOCKPILES SHALL BE STABILIZED, COVERED OR CONTAINED WITH SEDIMENT TRAPPING MEASURES. THE CONTRACTOR IS RESPONSIBLE FOR THE TEMPORARY PROTECTION AND PERMANENT STABILIZATION OF ALL SOIL STOCKPILES ON SITE AS WELL AS SOIL INTENTIONALLY TRANSPORTED FROM THE PROJECT SITE.

7. ALL TEMPORARY EROSION AND SEDIMENT CONTROL MEASURES SHALL BE REMOVED WITHIN 30 DAYS AFTER FINAL SITE STABILIZATION OR AFTER THE TEMPORARY MEASURES ARE NO LONGER


8. PROPERTIES AND WATER WAYS DOWNSTREAM FROM CONSTRUCTION SITE SHALL BE PROTECTED FROM SEDIMENT DEPOSITION AND EROSION AT ALL TIMES DURING CONSTRUCTION.

9. CONTRACTOR IS RESPONSIBLE FOR ALL SURFACE WATER DISCHARGES, RAINFALL RUN OFF OR DEWATERING ACTIVITIES.

10. CONTRACTOR MUST INCORPORATE ALL BMP'S NECESSARY TO MEET OR EXCEED STATE WATER QUALITY AND SWPPP REQUIREMENTS.

11. THE POLLUTION PREVENTION PLAN IS A MINIMUM GUIDELINE ONLY. ADDITIONAL BMP'S MAY BE NECESSARY AT CONTRACTOR'S EXPENSE.

CONTRACTOR TO LIFT GRATE OFF AREA DRAINS AND INSTALL FILTER FABRIC ACROSS INLET OPENING. REPLACE GRATE TO HOLD FABRIC SECURELY IN PLACE CATCH BASIN -STRUCTURE 1. FILTER FABRIC TO MEET FDOT INDEX NO. 199, 280 SPECIFICATIONS AND FDOT SECTION 985. 2. CONTRACTOR TO REMOVE FILTER FABRIC FROM CATCH BASIN JUST PRIOR TO PAVING AND/OR SEALCOATING. POLLUTION PREVENTION FOR CATCH BASIN

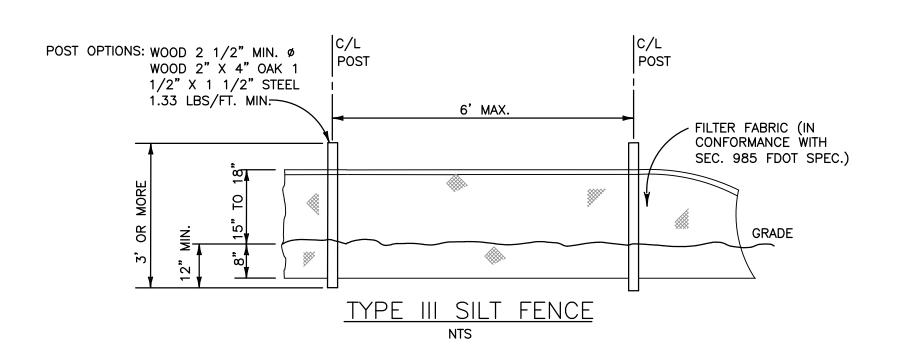

STATE OF 10-16-24

LEGEND

PROPOSED CONCRETE

PROPOSED ASPHALT PROPOSED GRADE EXISTING ELEVATION

PROPOSED CATCH BASIN

EXISTING CATCH BASIN PROPOSED WATER METER

EXISTING WATER METER

EXISTING WATER VALVE PROPOSED BFP DEVICE EXISTING SAN. SEWER MH

EXISTING FIRE HYDRANT

INEERING R. P.E.

ZEPH

PAR TRE

THIS ITEM HAS BEEN DIGITALLY SIGNED AND SEALED BY WILFORD ZEPHYR ON THE DATE ADJACENT TO THE SEAL.

PRINTED COPIES OF THIS DOCUMENT ARE NOT CONSIDERED SIGNED AND SEALED AND THE SIGNATURE MUST BE VERIFIED

P.E.#:76036 DATE: 5/31/23

SCALE: 1"=20'

**EROSION & SEDIMENT CONTROL PLAN** 

ON ANY ELECTRONIC COPIES.

1 OF 9 PROJECT NO.: 23-18

LEGEND PROPOSED CONCRETE PROPOSED ASPHALT

SOD RESTORATION TRENCH/ASPHALT RESTORATION AREA MILLING & RESURFACING AREA

PROPOSED GRADE EXISTING ELEVATION ШШ PROPOSED CATCH BASIN

EXISTING CATCH BASIN PROPOSED WATER METER


EXISTING WATER METER

EXISTING WATER VALVE PROPOSED BFP DEVICE

EXISTING FIRE HYDRANT

EXISTING SAN. SEWER MH

SCALE: 1"=20'

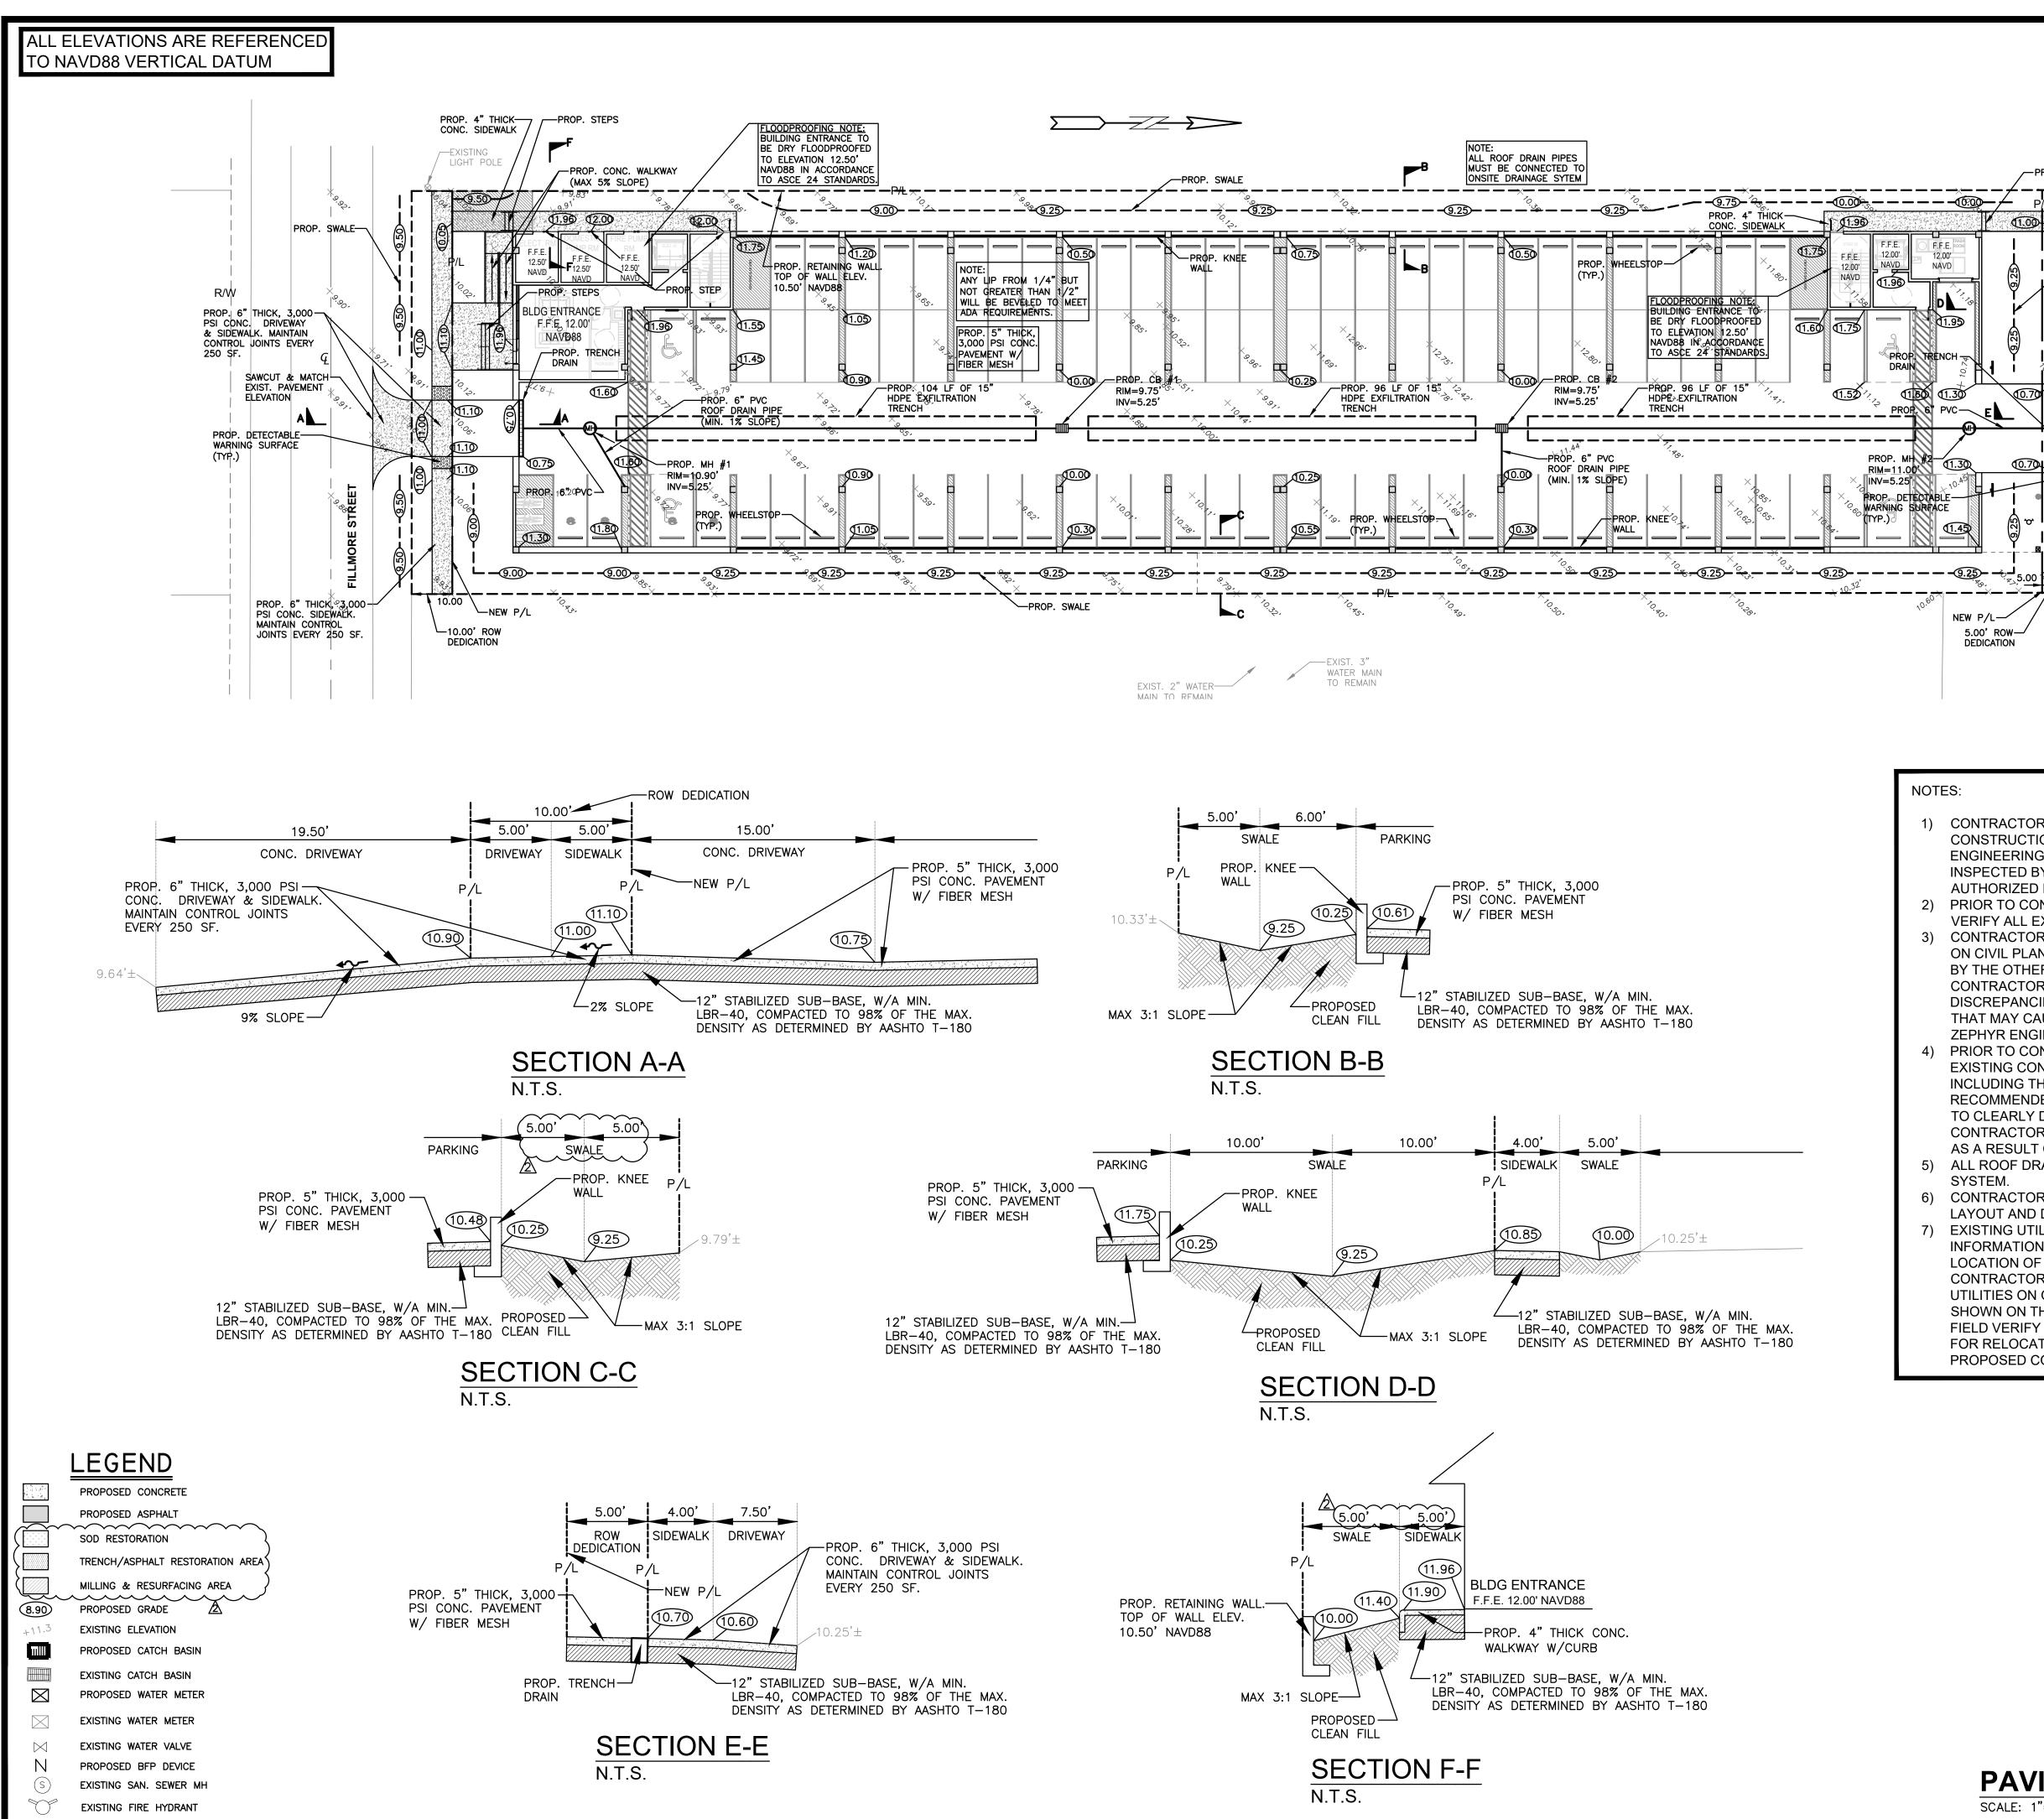

1) CONTRACTOR MUST NOTIFY ZEPHYR ENGINEERING OF THE START OF CONSTRUCTION DATE PRIOR TO START OF CONSTRUCTION, ZEPHYR ENGINEERING WILL NOT CERTIFY ANY CONSTRUCTION THAT WAS NOT INSPECTED BY ZEPHYR ENGINEERING, OR ZEPHYR ENGINEERING'S **AUTHORIZED REPRESENTATIVE** 

EXIST. PAVEMENT

-PROP. 6" THICK, 3,000

& SIDEWALK. MAINTAIN

-PROP. 6" THICK, 3,000

PSI CONC. SIDEWALK.
MAINTAIN CONTROL JOINTS EVERY 250 SF.

CONTROL JOINTS EVERY

- 2) PRIOR TO CONSTRUCTION, CONTRACTOR RESPONSIBLE TO FIELD VERIFY ALL EXISTING ELEVATIONS.
- 3) CONTRACTOR MUST COORDINATE PROPOSED IMPROVEMENTS SHOWN ON CIVIL PLANS WITH EXISTING SITE CONDITIONS & PROPOSED PLANS BY THE OTHER DESIGN PROFESSIONALS PRIOR TO CONSTRUCTION. CONTRACTOR MUST ALSO VERIFY THAT THERE ARE NO DISCREPANCIES BETWEEN THE WATER, SEWER & DRAINAGE PLANS THAT MAY CAUSE CONFLICTS PRIOR TO CONSTRUCTION. CONTACT ZEPHYR ENGINEERING IF DISCREPANCIES EXIST.
- 4) PRIOR TO CONSTRUCTION, CONTRACTOR RESPONSIBLE TO DOCUMENT EXISTING CONDITIONS ON AND AROUND THE PROJECT AREA, INCLUDING THE R.O.W. AND ADJACENT PROPERTIES. IT'S RECOMMENDED THAT CONTRACTOR TAKE PHOTOGRAPHS & VIDEOS TO CLEARLY DOCUMENT CONDITIONS PRIOR TO CONSTRUCTION CONTRACTOR RESPONSIBLE TO REPAIR ALL DAMAGES CAUSED BY OR AS A RESULT OF THE PROPOSED CONSTRUCTION.
- 5) ALL ROOF DRAINS MUST BE CONNECTED TO THE ONSITE DRAINAGE
- 6) CONTRACTOR TO REFER TO ARCHITECTURAL PLANS FOR SITE PLAN LAYOUT AND DIMENSIONS.
- 7) EXISTING UTILITIES SHOWN ARE BASED ON BEST AVAILABLE INFORMATION. CONTRACTOR'S RESPONSIBLE TO FIELD VERIFY LOCATION OF ALL EXISTING UTILITIES PRIOR TO CONSTRUCTION. CONTRACTOR TO BE AWARE THAT THERE MAY BE SOME EXISTING UTILITIES ON OR ADJACENT TO THE PROJECT SITE THAT MAY NOT BE SHOWN ON THE CIVIL PLANS, AND CONTRACTOR IS RESPONSIBLE TO FIELD VERIFY THOSE UTILITIES AS WELL. CONTRACTOR RESPONSIBLE FOR RELOCATION OF EXISTING UTILITIES THAT CONFLICTS WITH PROPOSED CONSTRUCTION.



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**PAVING, GRADING & DRAINAGE PLAN** 

SHEET NO.:

PROJECT NO.: 23-18

P.E.#:76036 DATE: 5/31/23

EERIN

ZEPH

PAR TRE

SCALE: 1"=20'

2 OF 9

SCALE: N.T.S.

REVISIONS
DATE DESCRIPTION

MLFORD ZEPHYR, P.E.
HOLLYWOOD, FL
(786)302-7693

RE STREET APARTMENTS 31 FILLMORE STREET HOLLYWOOD, FL 33020

P.E.#:76036

DATE: 5/31/23 SCALE: N.T.S.

SHEET NO.: 3 OF 9

PROJECT NO.: 23–18



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SHEET NO .:

EERING




ZEPH


APARTMENT STREET L 33020

P.E.#:76036


DATE: 5/31/23 SCALE: N.T.S.

4 OF 9 PROJECT NO.: 23-18

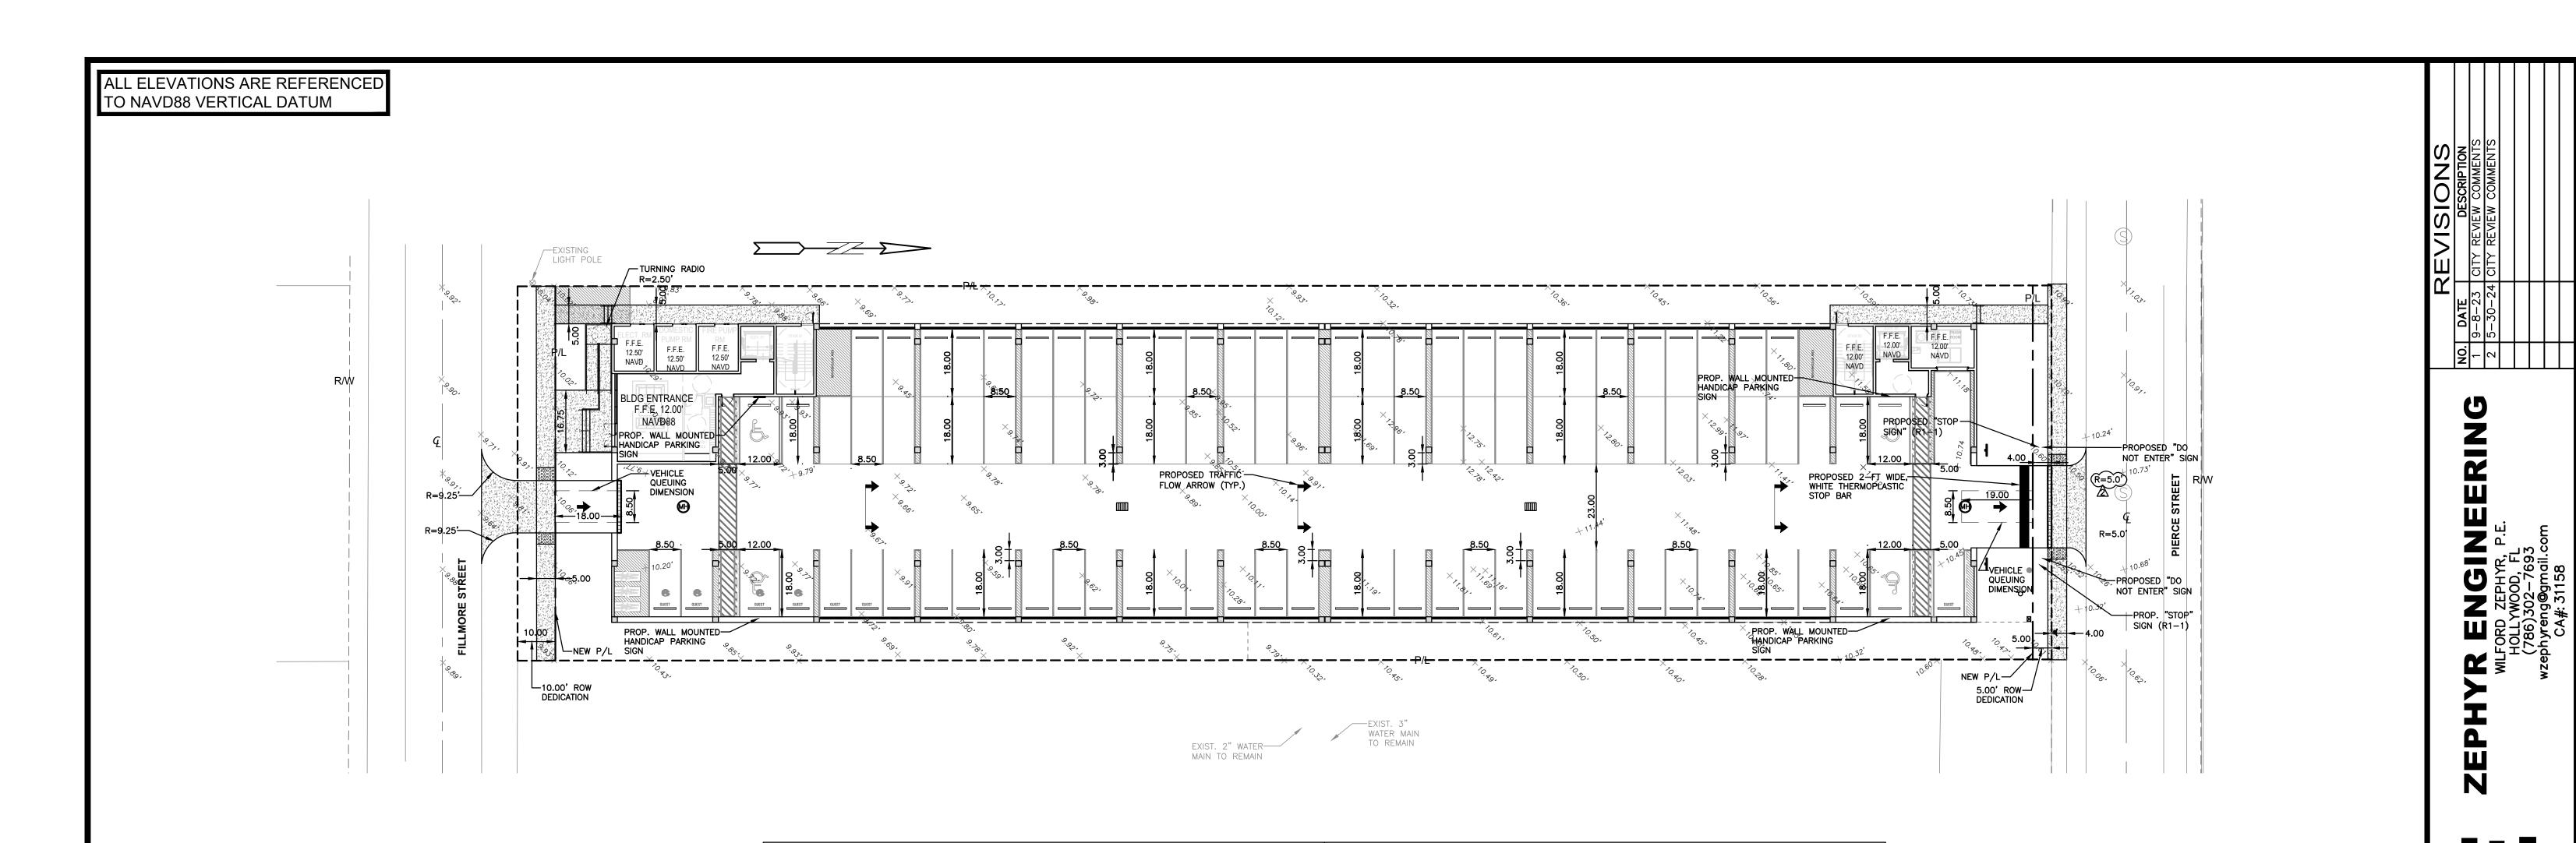


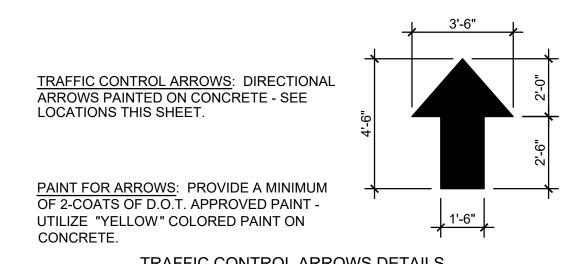



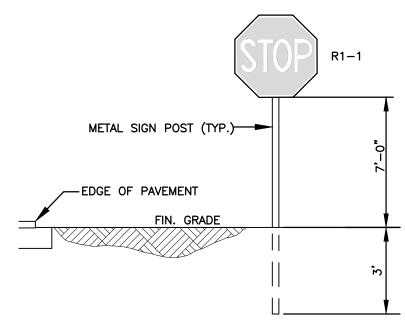



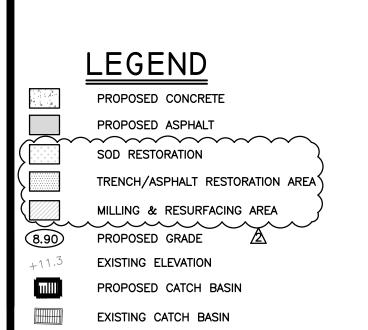

PROPOSED WATER METER


EXISTING WATER METER


EXISTING WATER VALVE

PROPOSED BFP DEVICE

EXISTING SAN. SEWER MH

EXISTING FIRE HYDRANT

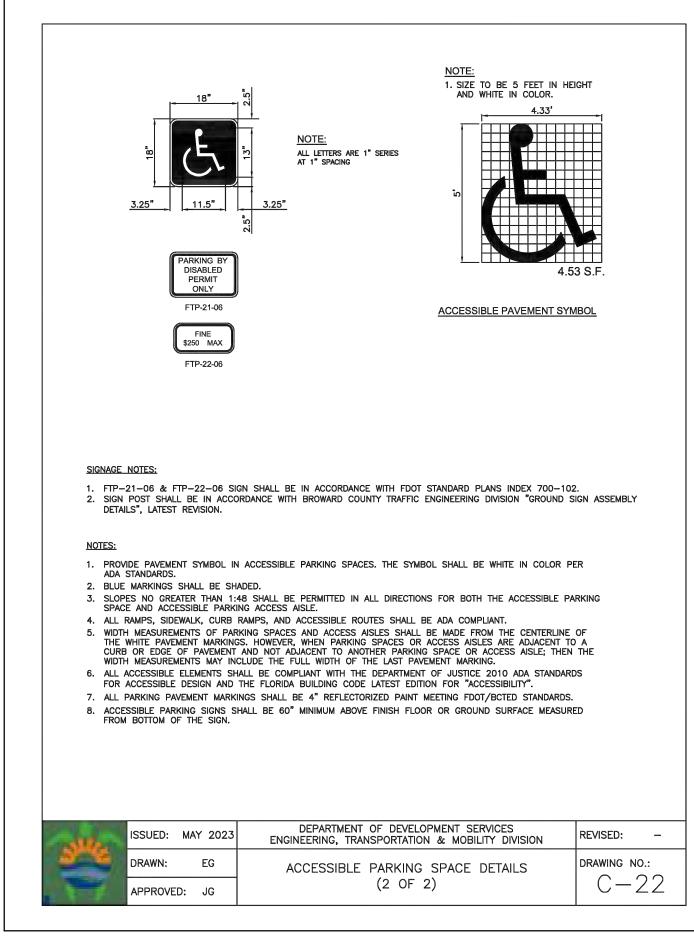

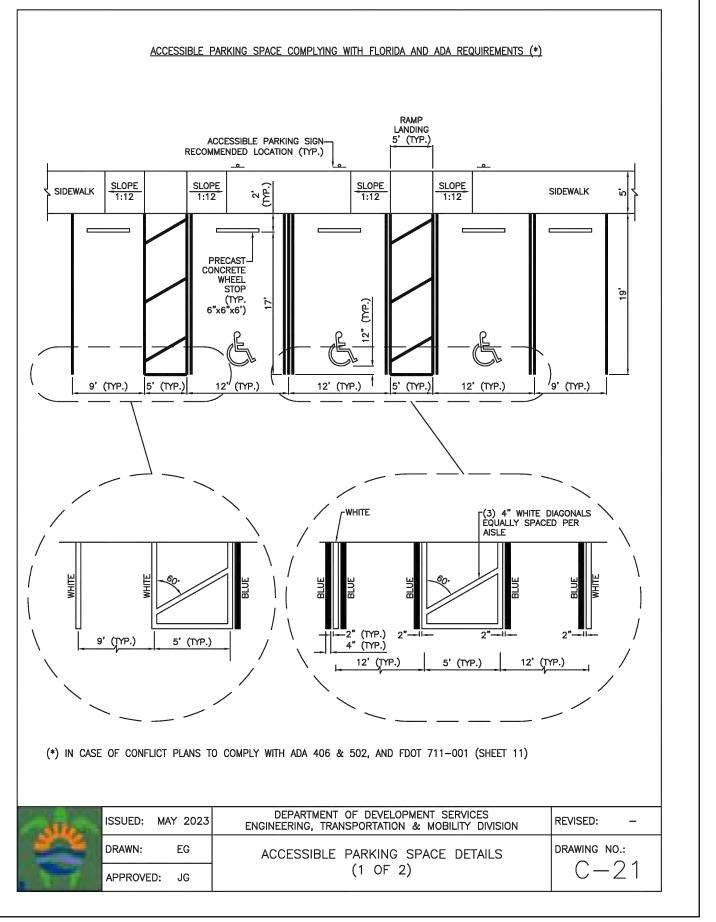



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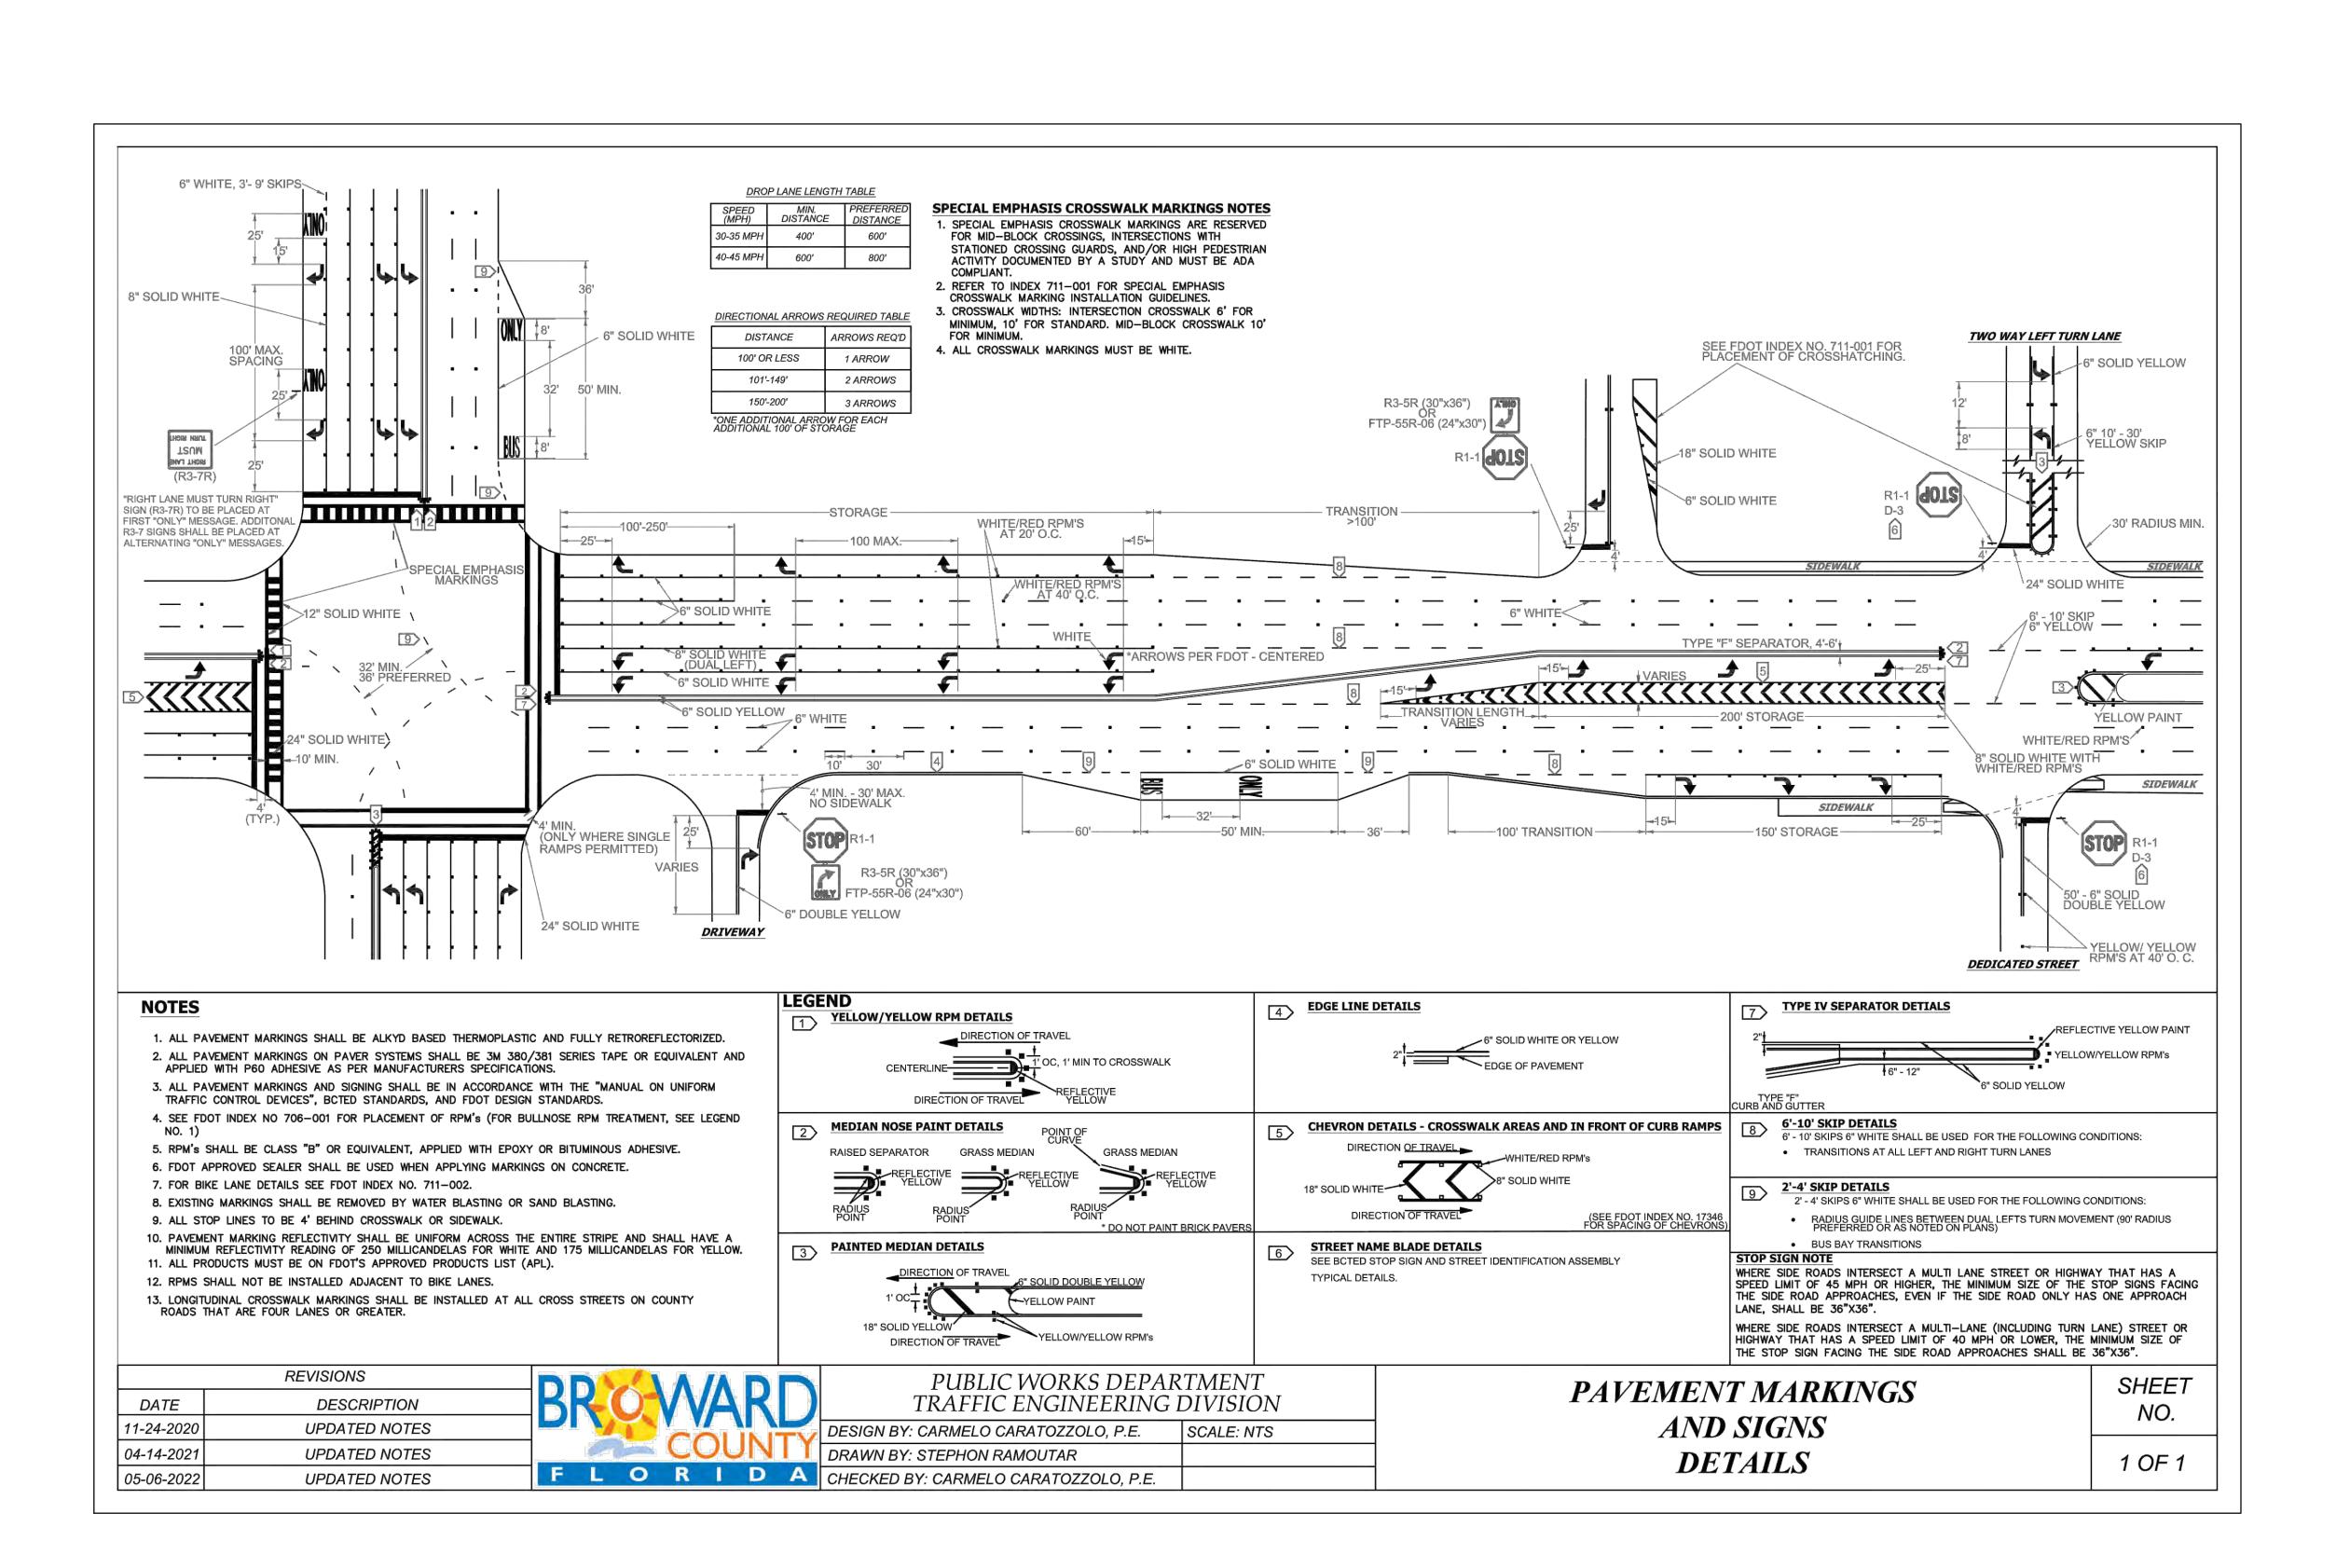
PAVEMENT MARKINGS & SIGNAGE PLAN SCALE: 1"=20'


P.E.#:76036

PAR TRE

DATE: 5/31/23

5 OF 9 PROJECT NO.: 23-18



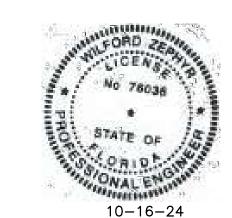

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**PAVEMENT MARKINGS DETAILS** 

SCALE: N.T.S.


INEERING M. P.E. ZEPH


PAR TRE

P.E.#:76036

DATE: 5/31/23 SCALE: N.T.S.

6 OF 9 PROJECT NO.: 23-18

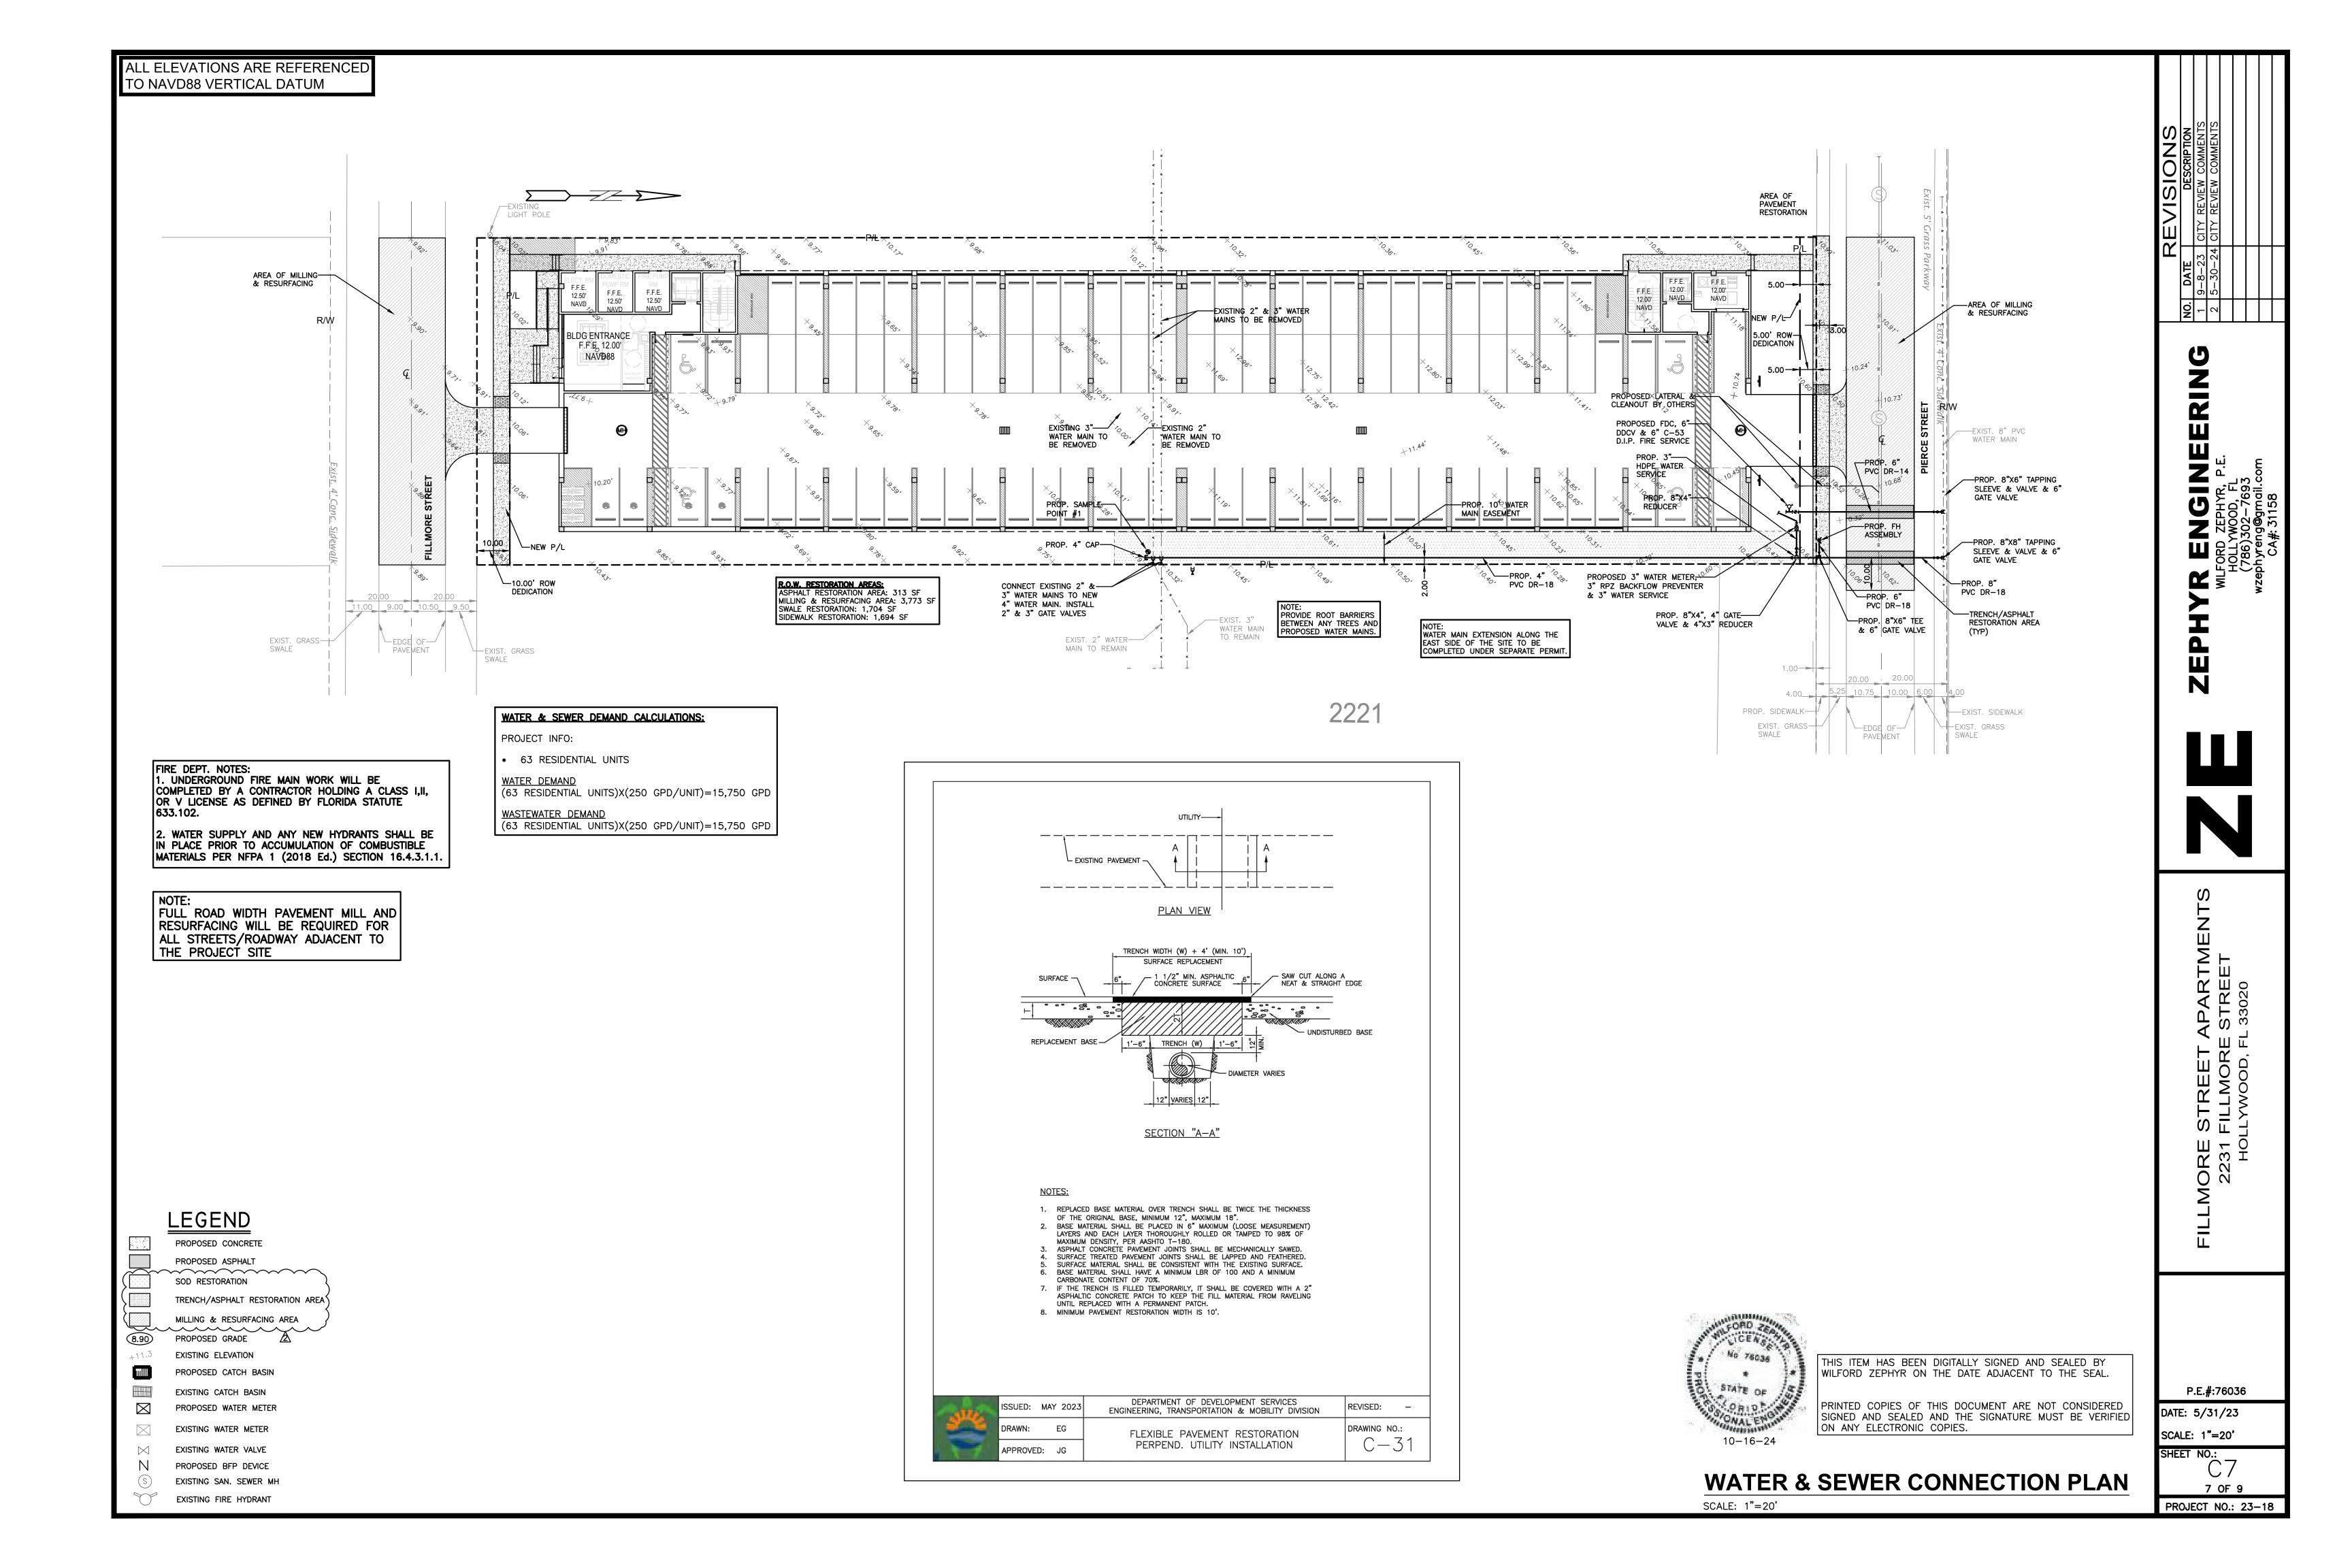

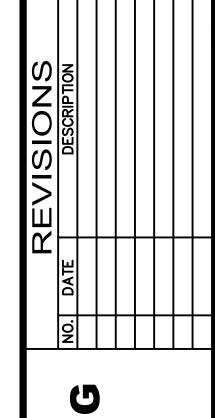

INEERING M. P.E.

ZEPHY

REET APARTMENT


MORE STREET

VOOD, FL 33020

P.E.#:76036 DATE: 5/31/23

SCALE: N.T.S. SHEET NO.:

8 OF 9 PROJECT NO.: 23-18

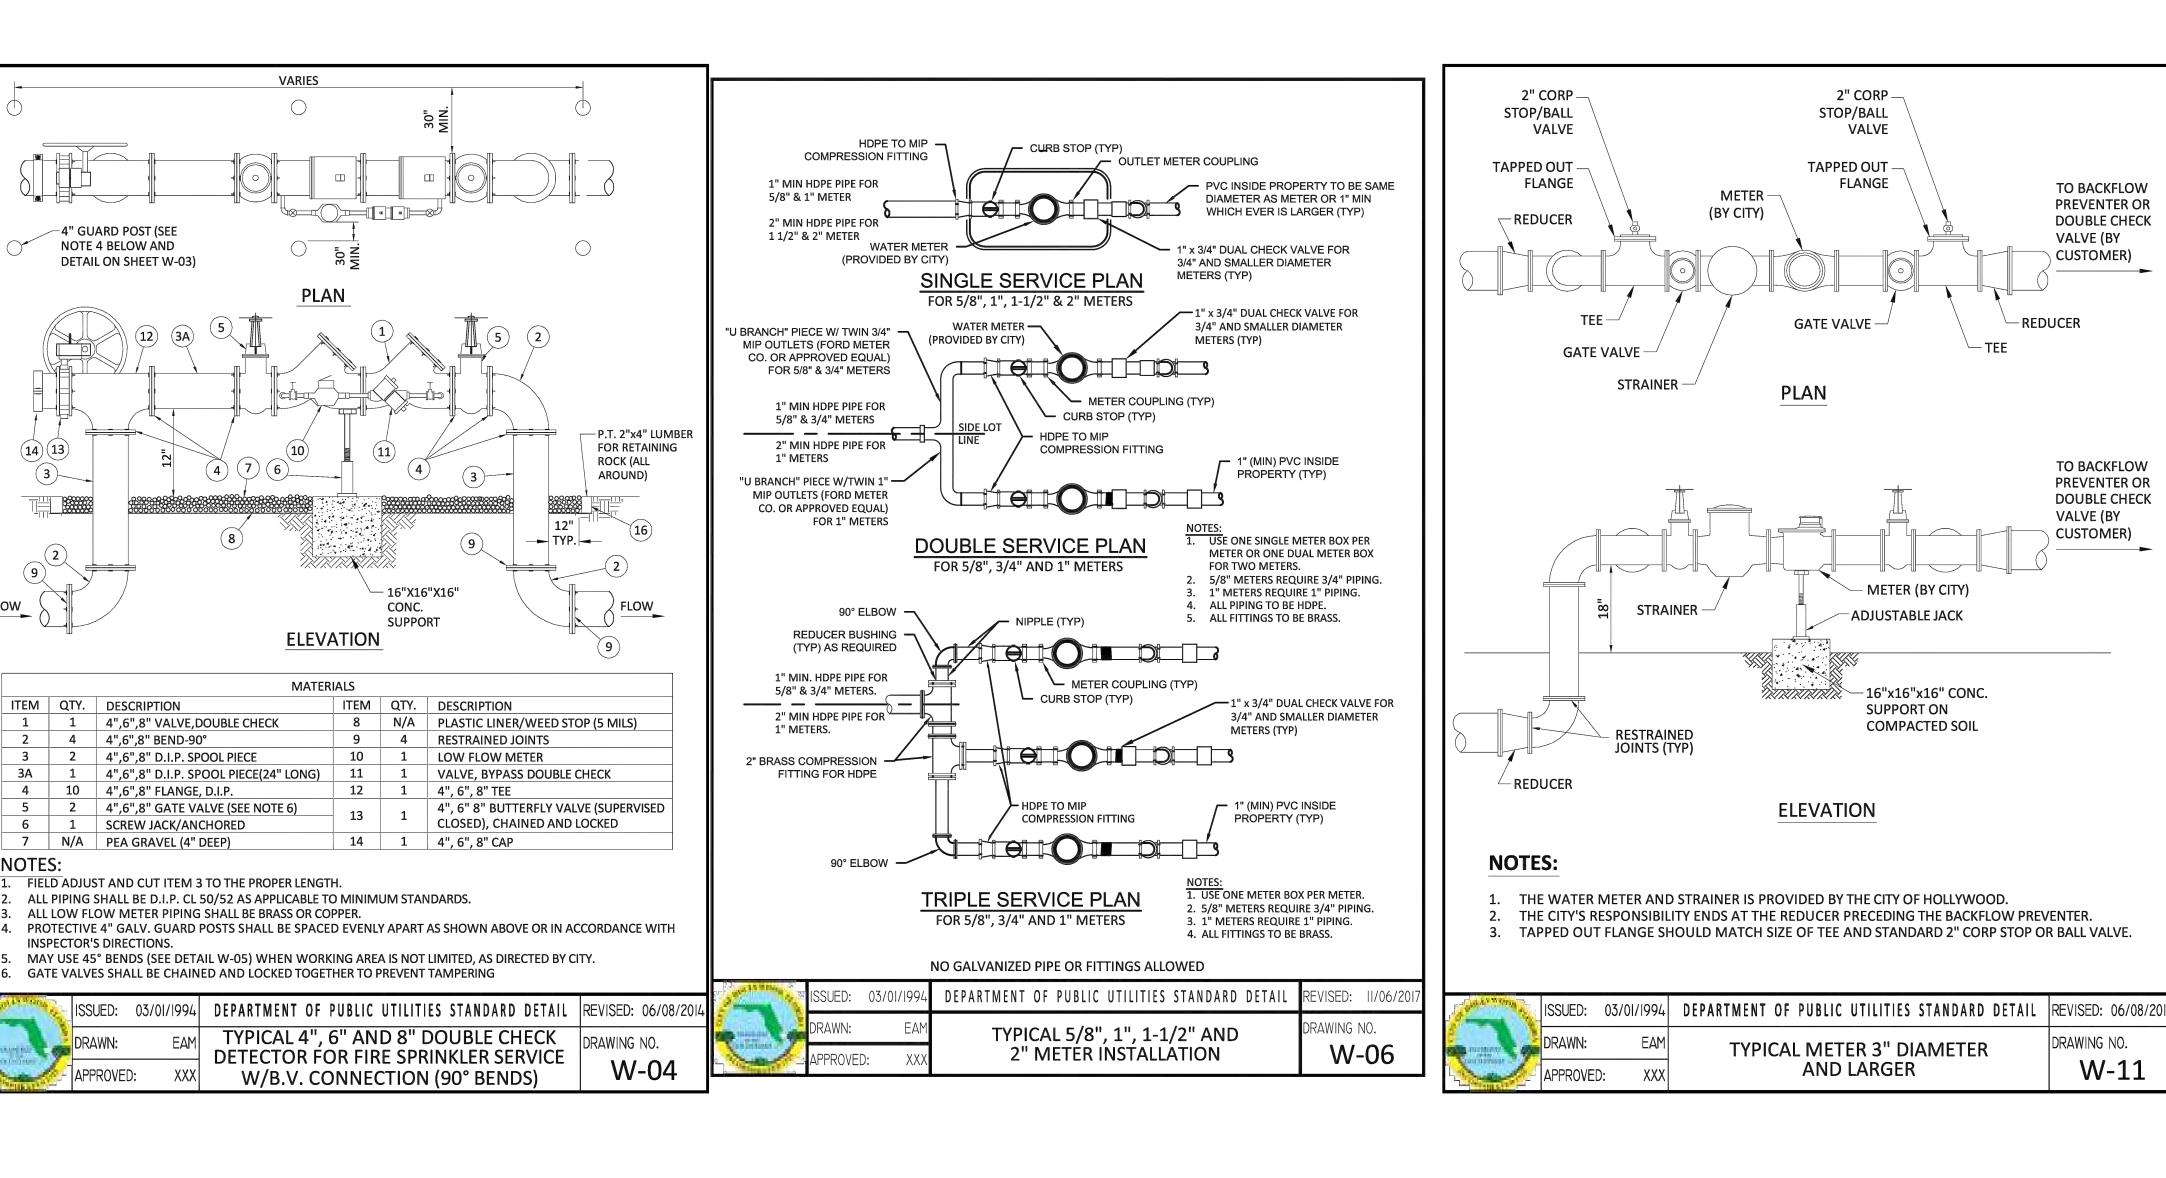

- 16"X16"X16"

SUPPORT

ITEM QTY. DESCRIPTION

12 1 4", 6", 8" TEE

14 1 4", 6", 8" CAP

DETECTOR FOR FIRE SPRINKLER SERVICE

W/B.V. CONNECTION (90° BENDS)

4 RESTRAINED JOINTS

LOW FLOW METER

N/A PLASTIC LINER/WEED STOP (5 MILS)

VALVE, BYPASS DOUBLE CHECK

CLOSED), CHAINED AND LOCKED

CONC.

**ELEVATION** 

MATERIALS

ROCK (ALL

AROUND)

-4" GUARD POST (SEE

DETAIL ON SHEET W-03)

NOTE 4 BELOW AND

ITEM QTY. DESCRIPTION

INSPECTOR'S DIRECTIONS.

**NOTES:** 

1 4",6",8" VALVE,DOUBLE CHECK

4",6",8" D.I.P. SPOOL PIECE

1. FIELD ADJUST AND CUT ITEM 3 TO THE PROPER LENGTH.

ALL LOW FLOW METER PIPING SHALL BE BRASS OR COPPER.

4",6",8" D.I.P. SPOOL PIECE(24" LONG)

5 2 4",6",8" GATE VALVE (SEE NOTE 6) 13 1

2. ALL PIPING SHALL BE D.I.P. CL 50/52 AS APPLICABLE TO MINIMUM STANDARDS.


6. GATE VALVES SHALL BE CHAINED AND LOCKED TOGETHER TO PREVENT TAMPERING

5. MAY USE 45° BENDS (SEE DETAIL W-05) WHEN WORKING AREA IS NOT LIMITED, AS DIRECTED BY CITY.

4 4",6",8" BEND-90°

4 10 4",6",8" FLANGE, D.I.P.

6 1 SCREW JACK/ANCHORED 7 N/A PEA GRAVEL (4" DEEP)

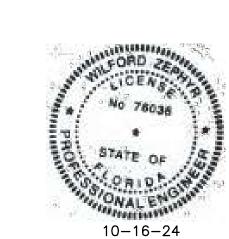

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# **UTILITIES DETAILS I**

SCALE: N.T.S.

### **SEWER NOTES:**

- 1. THE MINIMUM DEPTH OF COVER OVER D.I.P. SANITARY SEWER GRAVITY OR FORCE MAINS IS 30". THE MINIMUM DEPTH OF COVER OVER PVC SANITARY SEWER OR FORCE MAINS IS 36".
- 2. ALL CONNECTIONS TO EXISTING MAINS SHALL BE THE RESPONSIBILITY OF THE CONTRACTOR.
- 3. LEAKAGE TESTS AND ALIGNMENT (LAMPING) TESTS SHALL BE PERFORMED ON ALL NEW SEWER LINES UP TO THE CONNECTION POINT WITH THE EXISTING SEWER SYSTEM. THESE TESTS SHALL BE REQUESTED AND PAID FOR BY THE
- 4. LAMPING TESTS SHALL BE PERFORMED ON GRAVITY SEWERS FROM MANHOLE TO MANHOLE UP TO AND INCLUDING THE POINT OF CONNECTION TO THE EXISTING SEWER SYSTEM.
- 5. LEAKAGE TESTS SHALL BE PERFORMED ON ALL SEGMENTS OF A GRAVITY SEWER SYSTEM, INCLUDING SERVICE LATERALS AND MANHOLES, FOR A CONTINUOUS PERIOD OF NO LESS THAN 2 HOURS. AT THE END OF THE TEST, THE TOTAL MEASURED LEAKAGE SHALL NOT EXCEED 100 GALLONS PER INCH OF PIPE DIAMETER PER MILE PER DAY FOR ANY SECTION OF THE SYSTEM, WITH ZERO ALLOWABLE LEAKAGE FOR LATERALS AND MANHOLES. AN EXFILTRATION OR INFILTRATION TEST SHALL BE PERFORMED WITH A MINIMUM POSITIVE HEAD OF 2 FEET ON THE SECTION BEING
- 6. FORCE MAINS SHALL BE PRESSURE-TESTED IN ACCORDANCE WITH RULE 62-555.330 (FAC). THE PRESSURE TEST SHALL CONSIST OF HOLDING A TEST PRESSURE OF 150 PSI ON THE PIPELINE FOR A CONTINUOUS PERIOD OF 2 HOURS THE MAXIMUM ALLOWABLE LEAKAGE SHALL BE DETERMINED BY THE FOLLOWING FORMULA:


# $L = S \times D \times \sqrt{P}$

L = ALLOWABLE LEAKAGE FOR SYSTEM IN GALLONS PER HOUR

- D = PIPE DIAMETER IN INCHES
- S = LENGTH OF LINES IN LINEAL FEET P = AVERAGE TEST PRESSURE IN PSI
- 7. CONTRACTOR SHALL BE RESPONSIBLE FOR IDENTYFYING CONFLICTS WITH FORCE MAINS PLACED AT MINIMUM COVER. IN CASE OF CONFLICT, FORCE MAIN SHALL BE LOWERED TO PASS UNDER CONFLICTS WITH 12" MINIMUM SEPARATION FROM WATER MAINS AND 6" MINIMUM SEPARATION FROM OTHER UTILITIES. NO ADDITIONAL PAYMENT SHALL BE DUE TO CONTRACTOR FOR LOWERING THE MAIN OR THE ADDITIONAL FITTINGS USED THEREON.
- 8. WHENEVER IT IS NECESSARY, IN THE INTEREST OF SAFETY, TO BRACE THE SIDES OF A TRENCH, THE CONTRACTOR SHALL FURNISH, PUT IN PLACE AND MAINTAIN SUCH SHEETING OR BRACING AS MAY BE NECESSARY TO SUPPORT THE SIDES OF THE EXCAVATION TO ENSURE PERSONNEL SAFETY, AND TO PREVENT MOVEMENT WHICH CAN IN ANY WAY DAMAGE THE WORK OR ENDANGER ADJACENT STRUCTURES. THE CONTRACTOR SHALL BE SOLELY RESPONSIBLE FOR THE SEQUENCE, METHODS AND MEANS OF CONSTRUCTION, AND FOR THE IMPLEMENTATION OF ALL OSHA AND OTHER SAFETY REQUIREMENTS.

ISSUED: 03/01/1994 DEPARTMENT OF PUBLIC UTILITIES STANDARD DETAIL REVISED: 06/08/2014

SANITARY SEWER MAIN CONSTRUCTION NOTES DRAWING NO.

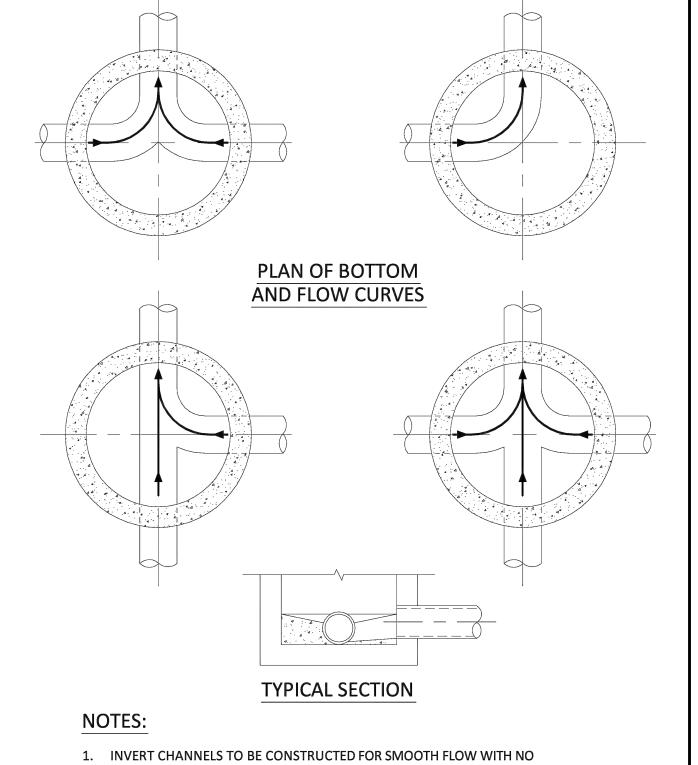

- OBSTRUCTIONS. 2. SPILLWAYS SHALL BE CONSTRUCTED BETWEEN PIPES WITH DIFFERENT INVERT
- ELEVATIONS PROVIDING SMOOTH FLOWS.
- 3. CHANNELS FOR FUTURE CONNECTIONS (STUBS) SHALL BE CONSTRUCTED FILLED WITH SAND & COVERED WITH 1" OF MORTAR.
- 4. WHEN FLOW LINE DEFLECTS MORE THAN 45°, A DROP OF 0.10' IS REQUIRED.

			VERSION ONE THANK IS AND OF ONE IS REQUIRED.	
art 15 Wilman	ISSUED:	03/01/1994	DEPARTMENT OF PUBLIC UTILITIES STANDARD DETAIL	REVISED: 06/08/2014
and die	DRAWN:	EAM	MANHOLE FLOW PATTERNS	DRAWING NO.
	APPROVE	o: XXX	IVIAINTIOLE FLOW PATTERINS	S-02

ROTATE BEND AS REQUIRED TO ALIGN SERVICE BRANCH WITH SERVICE PIPE -

<u>PLAN</u>

- ALTERNATE ADDITIONAL RISE AND BEND WHERE

REQUIRED BY GREATER SEWER DEPTH

ELEVATION

SINGLE SERVICE CONNECTIONS SHALL USE 6" PIPE AND FITTINGS.

SECOND FLEXIBLE COUPLING.


EXIST. SEWER MAIN -

WYE BRANCH -

SLOPE UP TO PL MIN. 1/8" PER FT.

MISSION, FERNCO OR EQUAL-FLEXIBLE COUPLING WITH STAINLESS STEEL BANDS

- NEW SEWER MAIN

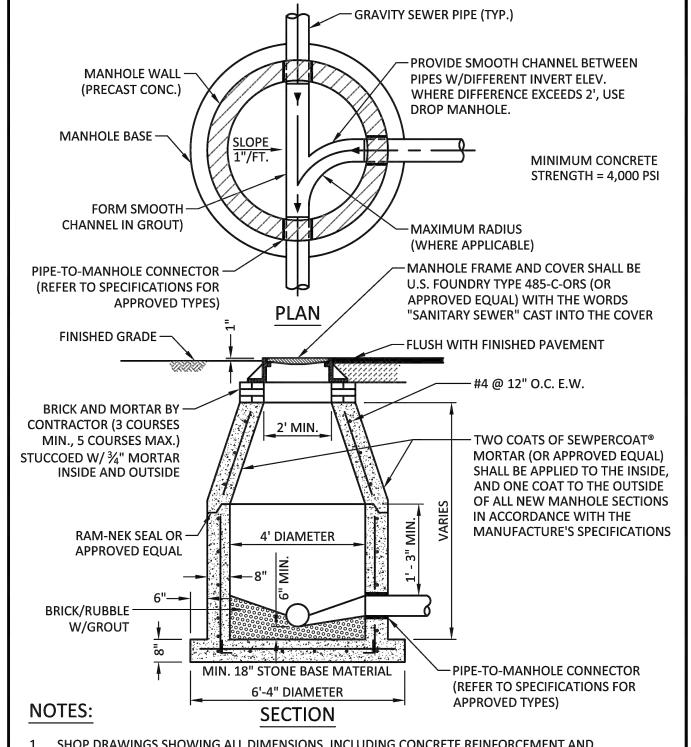



OF 3' ABOVE SLAB BASE. NO CONSTRUCTION JOINTS ARE ALLOWED BELOW ELEVATION +2.00 NAVD. ABOVE ELEVATION +2.00 NAVD CONSTRUCTION JOINTS ARE ALLOWED, IF ADEQUATE JOINTS WITH KEY-WAYS AND WATER STOPS

THE BOTTOM SLAB SHALL BE CAST MONOLITHICALLY WITH THE LOWER WALL SECTION TO A MINIMUM

ARE P	ROVIDED.	SUBMIT SH	OP DRAWINGS OF JOINT DETAILS TO THE ENGINEER FOR APP	ROVAL.
AND DESCRIPTION OF THE PERSON	ISSUED:	03/01/1994	DEPARTMENT OF PUBLIC UTILITIES STANDARD DETAIL	REVISED: 07/18/2018
	DRAWN:	EAM	STANDARD PRECAST MANHOLE	DRAWING NO.
-	APPROVE	): XXX	STAINDAND PRECAST MAINHOLE	S-03


" SERVICE

18" SQUARE

SCREW PLUG

DRAWING NO.

S-12

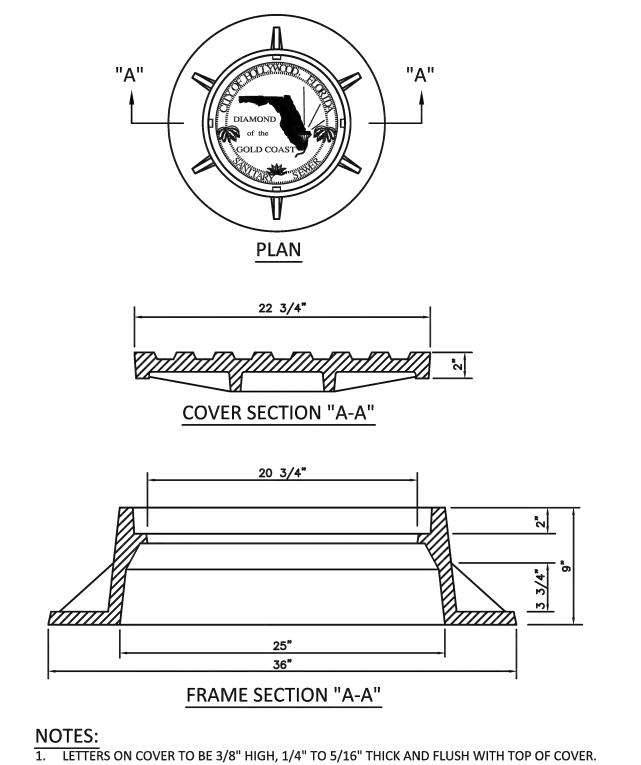

2. ALL BEARING SURFACES TO BE MACHINED.

3. MINIMUM WEIGHTS: COVER - 160 LBS., TOTAL - 400 LBS.

4. MANHOLE FRAME AND COVER SHALL BE U.S. FOUNDRY 485-C-ORS TYPE EL, WITH THE WORDS "SANITARY SEWER" CAST INTO THE COVER.

A STATE OF THE PARTY OF THE PAR	ISSUED:	03/01/1994	DEPARTMENT OF PUBLIC UTILITIES STANDARD DETAIL	REVISED: 06/08/2014
a motton &	DRAWN:	EAM	MANHOLE FRAME AND COVER	DRAWING NO.
The state of the s	APPROVEI	D: XXX	CITY OF HOLLYWOOD	S-06.1





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# **UTILITIES DETAILS II**

SCALE: N.T.S.

└-1 #3 CONT. PLAN EXTENSION AS REQUIRED YARD TYPE PRIVATE PROPERTY - EASEMENT LINE OR PROPERTY LINE - FLUSH BRASS SCREW PLUG SURFACE FINISH GRADE -LIMEROCK -6" RISER -EXTENSION AS REQUIRED PAVEMENT TYPE CLEANOUT DETAILS SLOPE AT 1/8" PER FT. " RESIDENTIAL SERVICE - 6" WYE (POINT OF SERVICE) ← 6" SERVICE PIPE ELEVATION SINGLE SERVICE CONNECTION

ISSUED: 03/01/1994 DEPARTMENT OF PUBLIC UTILITIES STANDARD DETAIL REVISED: 06/08/2014

SEWER SERVICE CONNECTION AND

**CLEANOUT AT PROPERTY LINE** 

AND TARREST	E.	ISSUED:	03/01/1994	DEPARTMENT OF PUBLIC UTILITIES STANDARD DETAIL	REVISED: 06/08/2014
	490	DRAWN:	EAM	WYE BRANCH CONNECTION	DRAWING NO.
-	4-	APPROVED	: XXX	WIE BRAINCH CONNECTION	S-09

USE RISER CONNECTIONS WHERE INVERT OF SEWER IS GREATER THAN 7'-0" DEEP.


3. WHERE BELL OF WYE AND SPIGOT OF EXISTING MAIN ARE NOT COMPATIBLE, USE A



P.E.#:76036 DATE: 5/31/23


SCALE: N.T.S.

SHEET NO.: 9 OF 9 PROJECT NO.: 23-18

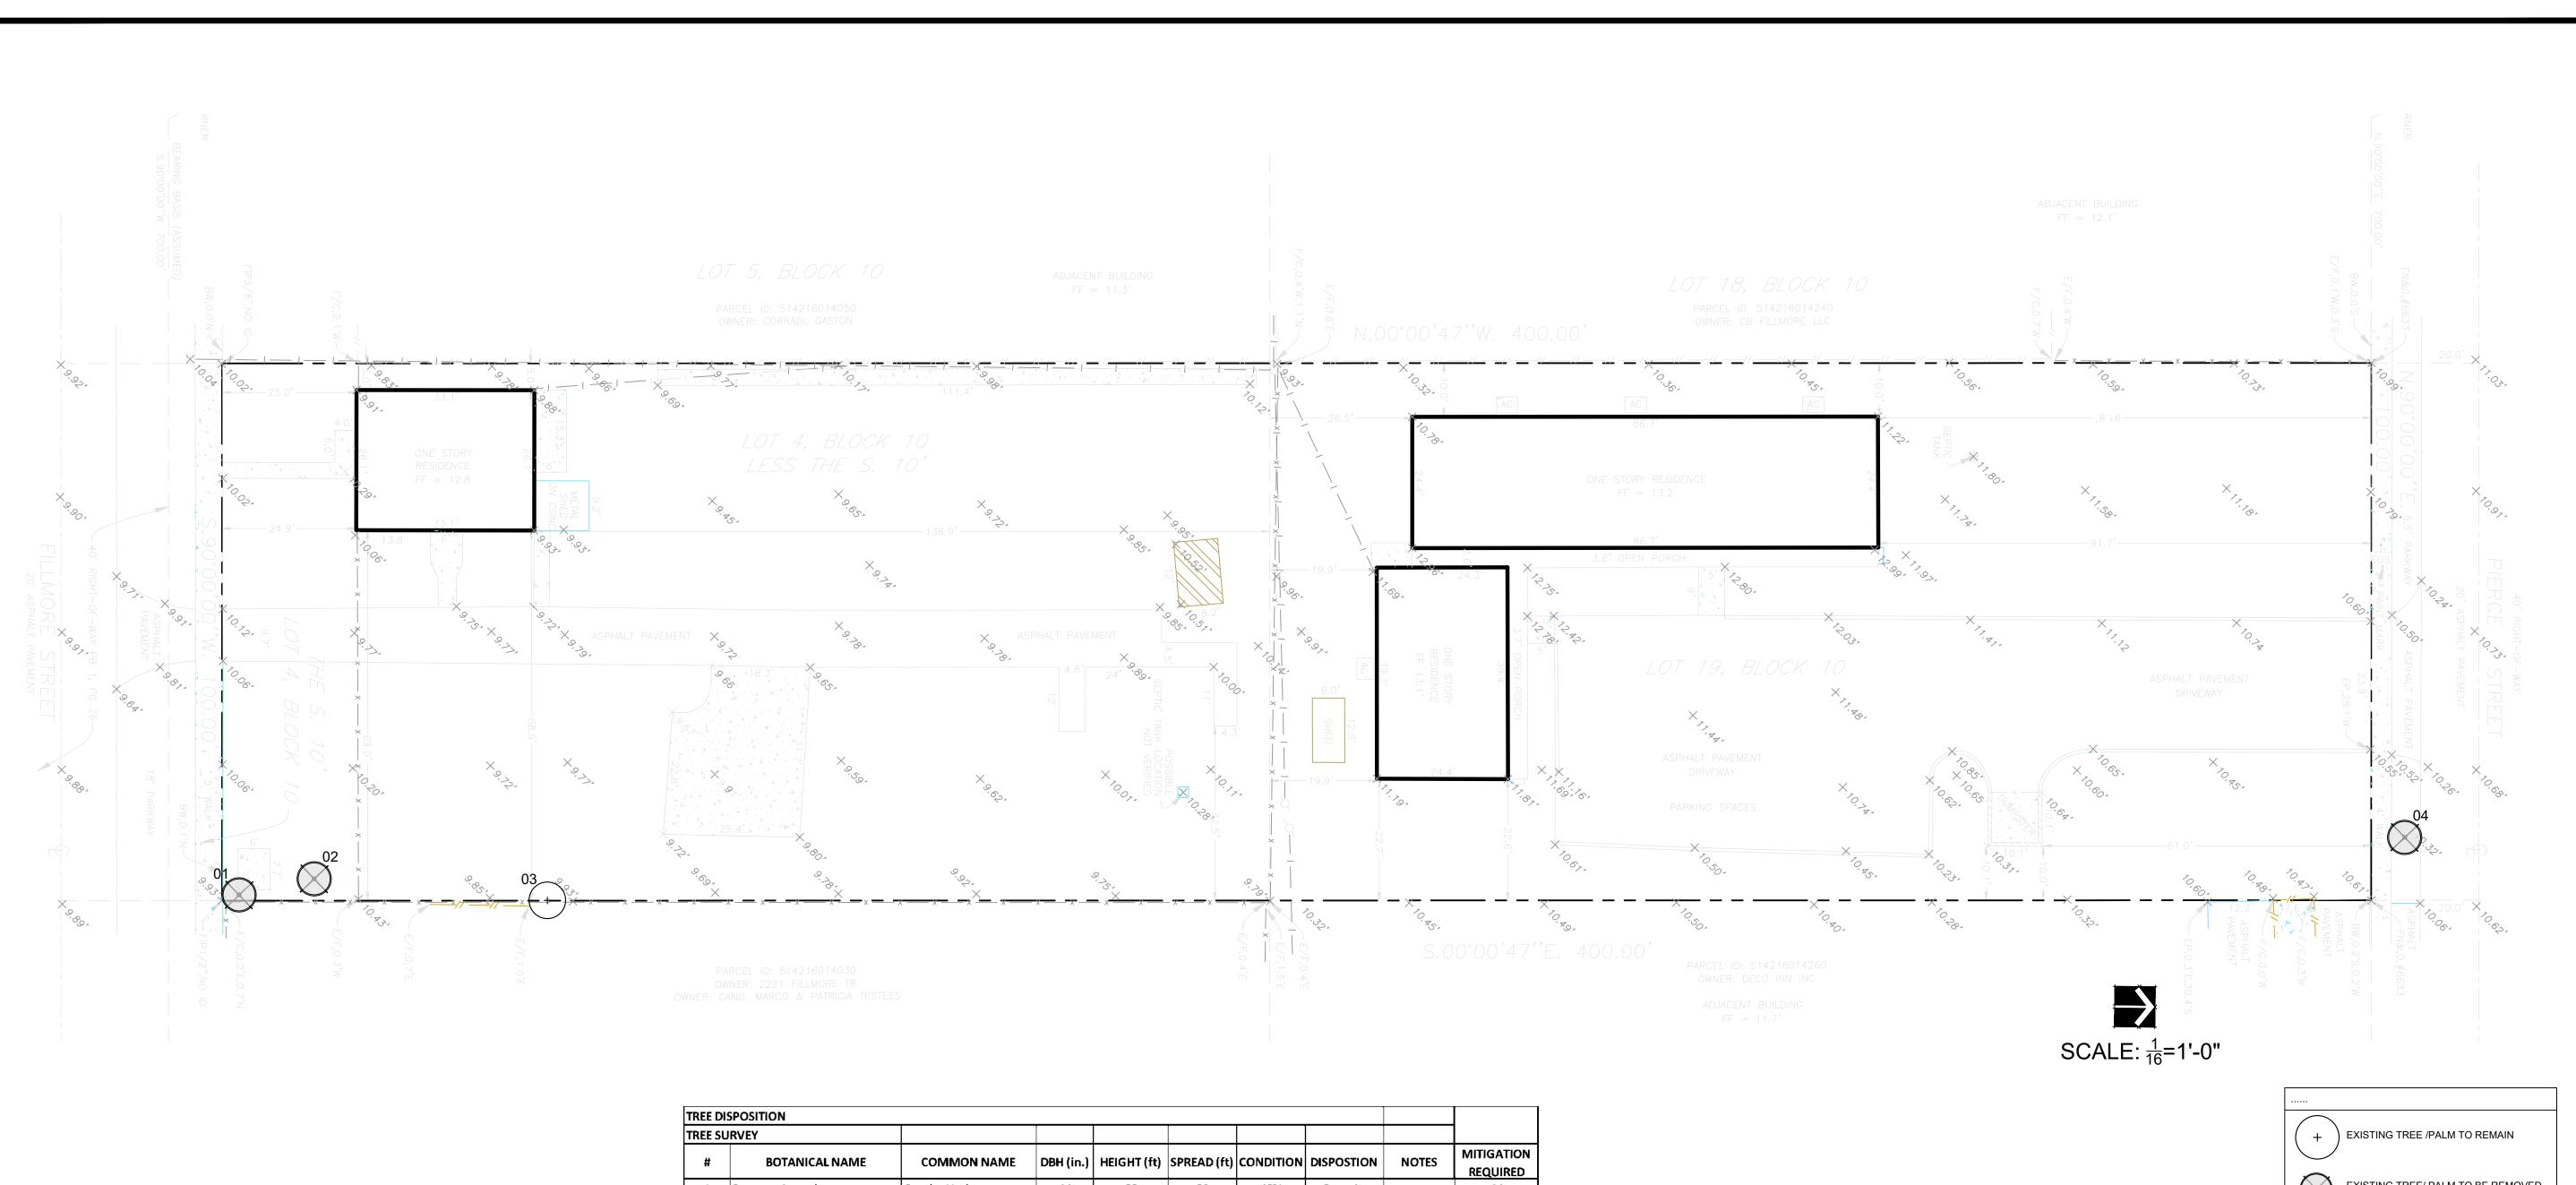

REE S	URVEY								
#	BOTANICAL NAME	COMMON NAME	DBH (in.)	HEIGHT (ft)	SPREAD (ft)	CONDITION	DISPOSTION	NOTES	MITIGATION REQUIRED
1	Bursera simaruba	Gumbo Limbo	14	20	20	40%	Remain		14
2	Delonix regia	Royal Poinciana	48	30	35	60%	Remove		48
3	Quercus virginiana	Live oak	30	30	30	70%	Remain		
4	Quercus virginiana	Live oak	14	20	12	30%	Remove		14
								Total	76


	3 TREES WILL BE REMO	OVED WITH A TOTAL OF 76"	
	DIAMETER INCHES TO	BE MITIGATED. PLEASE SEE BREAK	
	DOWN OF REPLACEME	ENT AS FOLLOWS:	
12	DAHOON HOLLY	4" EACH	48
3	CRAPE MYRTLE	4" EACH	12
4	PINK TABEBUIA	4" EACH	16
	TOTAL DIAMETER INCH	HES PROVIDED	76

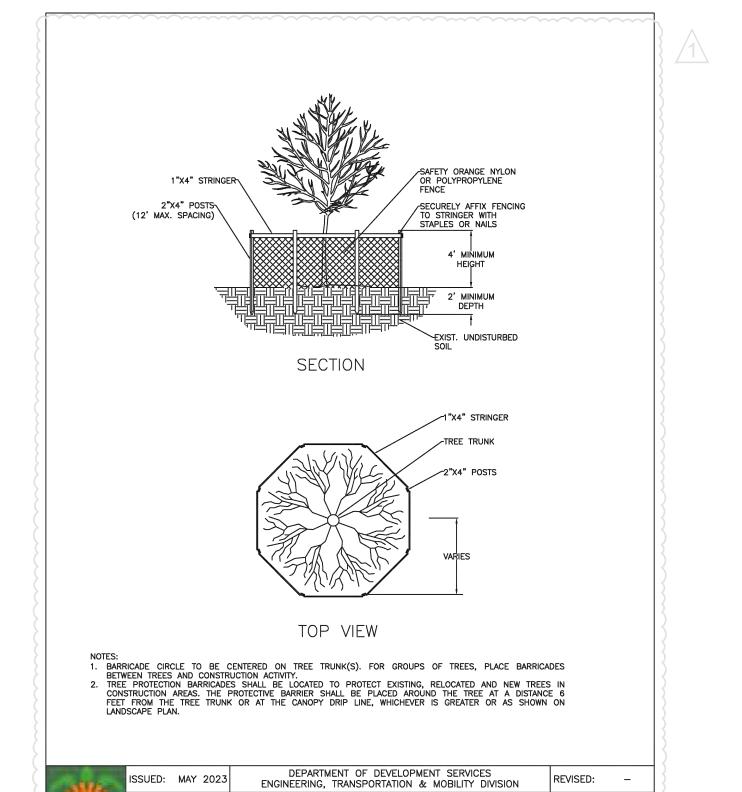

TREE PROTECTION DETAIL

DRAWING NO.:

L-08

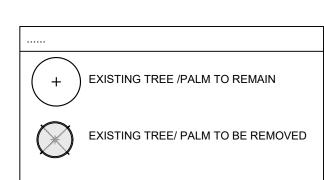

1 FILLMORE ST. 8 224 PIERCE ST. HOLLYWOOD, FLORIDA 33020 231 DISTRIBUTION:

**EXPRESSIONS** 


FOLIAGE

DATE: PERMIT COMMENTS 09-25-23 PERMIT REVISION 04-19-24

DRAWING NAME: TREE DISPOSITION

DRAWING NUMBER: L-200



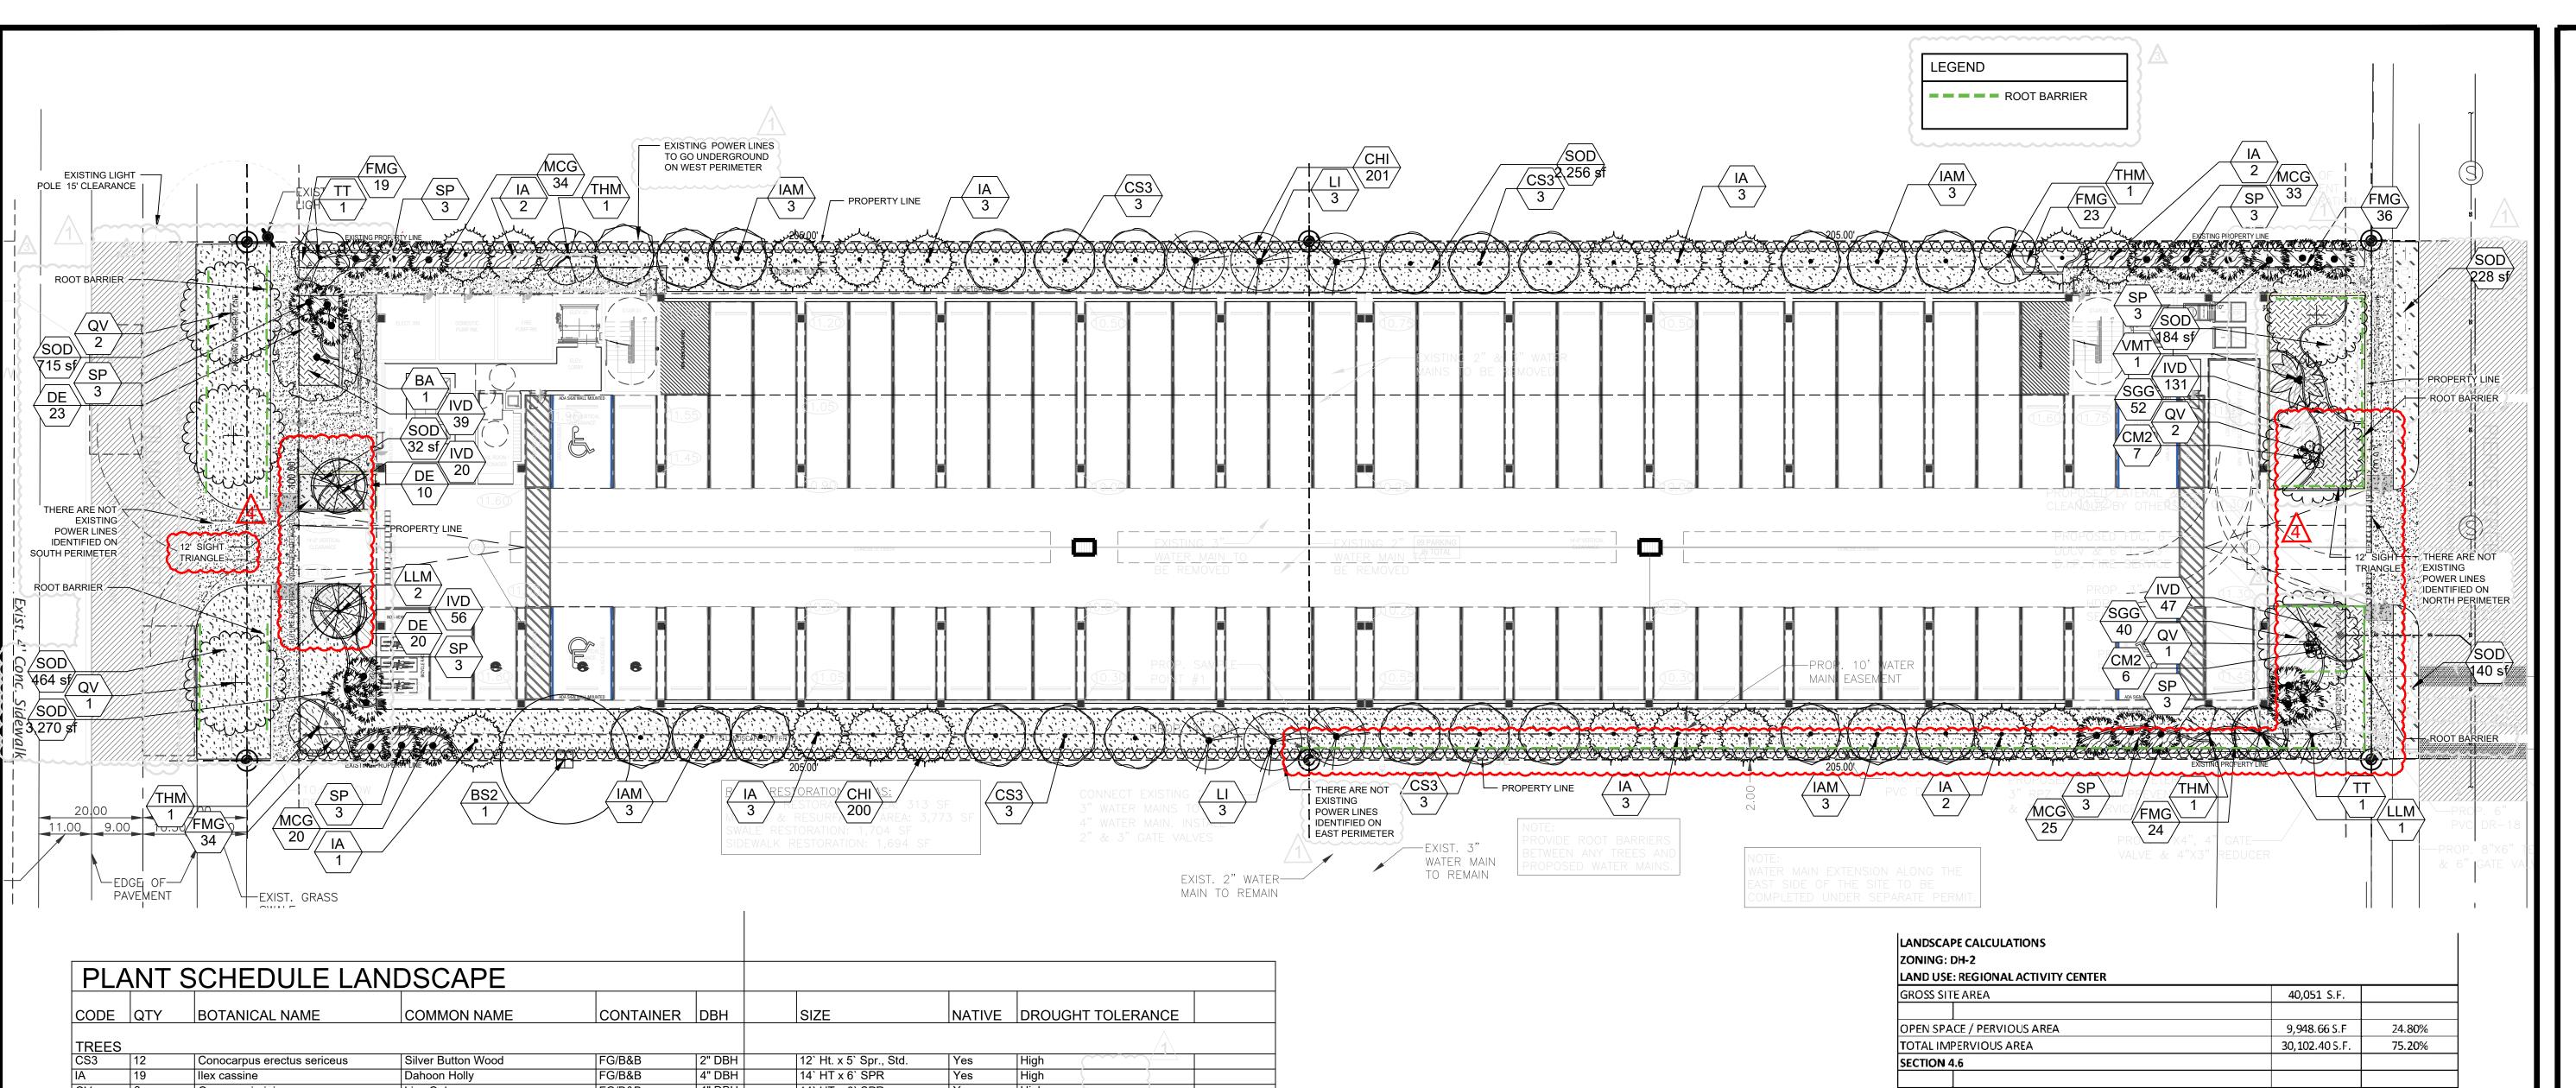

PI A		SCHEDULE LAN	DSCAPE							
CODE	QTY	BOTANICAL NAME	COMMON NAME	CONTAINER	DBH		SIZE	NATIVE	DROUGHT TOLERANCE	
REES										
CS3	12	Conocarpus erectus sericeus	Silver Button Wood	FG/B&B	2" DBH		12` Ht. x 5` Spr., Std.	Yes	High	
4	19	Ilex cassine	Dahoon Holly	FG/B&B	4" DBH		14` HT x 6` SPR	Yes	High	
V	6	Quercus virginiana	Live Oak	FG/B&B	4" DBH		14` HT x 6` SPR	Yes	High	
XISTIN	NG TREES	S							}	
S2	1	Bursera simaruba	Gumbo Limbo	EXISTING				Yes	High	
	RING TRI	FFS							{	
LOVVE A	1	Bulnesia arborea	Verawood	FG/B&B	4" DBH		14` HT x 6` SPR	No	High	
	6	Lagerstroemia indica `Tuscarora`	Tuscarora Crape Myrtle `Standard`	FG/B&B	4" DBH		14'HT x 6'SPR, STD	No	High	
Т	2	Tabebuia heterophylla	Pink Trumpet Tree	FG/B&B	4" DBH		14` HT x 6` SPR	No	High	
NTIO 1	TION! TO:		•	•			•	1	}	· ·
<u>11TIGA</u> AM	TION TRE	Ilex cassine	Dahoon Holly	FG/B&B	4" DBH		14` HT x 6` SPR	Yes	High	
LM	3	Lagerstroemia indica 'Lavender'	Lavender Crape Myrtle	FG/B&B FG/B&B	4" DBH		14 HT x 6 SPR 14 HT x 6 SPR, STD	No	High	
-ivi HM	$\frac{13}{4}$	Tabebuia heterophylla	Pink Tabebuia	FG/B&B	4" DBH		14 HT x 6 SPR, STD	No	High	
		}	I mik razosala	1 0/202	1. 55			1110	111911	
<u>PALM T</u> P	REES  24	Sabal palmetto	Cabbage Palmetto	FG/B&B			14`-20` OA, Vary Heights	Yes	High	
MT	1	Veitchia montgomeryana	Montgomery Palm	FG/B&B			12-16` OA, Triple Trunk	No	Medium	
CODE	QTY	BOTANICAL NAME	COMMON NAME	SIZE	CONTAIN	NER	SIZE	NATIVE	DROUGHT TOLERANCE	SPACING
HRUB	S									
:HI	401	Chrysobalanus icaco	Coco Plum	-			42" H. X 24" SPR.	Yes	High	24" o.c.
M2	13	Codiaeum variegatum `Mammy`	Mammy Croton	-			18"x18"	No	High	24" o.c.
ODE	QTY	BOTANICAL NAME	COMMON NAME	SIZE	CONTAIN	NER	SIZE	NAITVE	DROUGHT TOLERANCE	SPACING
םו וסעי	AREAS									
E (	153	Duranta erecta `Gold Mound`	Gold Mound Duranta	-			18"HT x 18"SPR	Yes	High	18" o.c.
GG	92	Schefflera arboricola `Gold Capella`	Gold Capella Arboricola	-			24"HT x 24"SPR	No	High	24" o.c.
ODE	QTY	BOTANICAL NAME	COMMON NAME	SIZE	CONTAIN	NER	SIZE	NATIVE	DROUGHT TOLERANCE	SPACING
	•	•		•		-	•			
<u>ROUN</u> MG	ID COVE	RS Ficus microcarpa `Green Island`	Green Island Ficus	1			14" HT x 16" SPR	No	High	18" o.c.
VIG 'D	136 293	Ilex vomitoria `Stokes dwarf`	Dwarf Yaupon Holly	-			14" HT x 16" SPR	No Yes	High High	18" o.c.
~~~~	1200	IIION VOITIILOTIA OLONGO UWATI	Dwait Taupon Hony	_ [ -	1		14 111 ¥ 10 OI IV	103		10 0.0.
OD/SE										
OD	7,289 sf	Stenotaphrum secundatum `Floritam`	`Floritam` St. Augustine Sod	sod				No	High	
		COLUEDO								
ALL G	KONND (	VERO المالية ا			l					

Police department Note: Tree canopies should not be lower than 6ft in height.

LAND U	SE: REGIONAL ACTIVITY CENTER		
GROSS :	SITE AREA	40,051 S.F.	
	PACE / PERVIOUS AREA	9,948.66 S.F	24.80%
	MPERVIOUS AREA	30,102.40 S.F.	75.20%
SECTIO	<b>N 4.</b> 6		
PERIME	 TER LANDSCAPE	REQUIRED	PRÓVIDED
	1 TREE EVERY 30' O.C.		
	FILLMORE STREET 100 L.F./30=3.3	3 TREES	3 TREES
	PIERCE STREET 100 L.F./30=3.3	3 TREES	3 TREES
	5 FOOT LANDSCAPE BUFFER WITH 1 TREE EVERY 20 LINEAR FEET OF REQUIRED BUFFER		
	EAST BUFFER 400 LF /20=20	20 TREES	20 TREES
	WEST BUFFER 400 LF /20=20	20 TREES	20 TREES
INTERIC	DR LANDSCAPE FOR AT GRADE PARKING LOT AND VUA		
	1 TREE PER EACH PARKING ISLAND	N/A	N/A
OPEN S	PACE		
	MINIMUM 1 TREE PER EVERY (1,000) S.F. OF PERVIOUS AREA		
	PERVIOUS AREA 9,948 S.F./ 1,000 S.F.=9.9	10 TREES	12 TREES
	TOTAL TREES	56 TREES	58 TREES
	MINIMUM 60% NATIVE (56X60%=34	34 (60% MIN.)	50% +
	PERCENT OF PALMS NO MORE THAN 50%	28(78 PALMS)	9 (28 PALMS) (16
	PERCENT OF NATIVE SHRUBS 50% 559X50%=280	280	454


REE MITI	GATION		
	3 TREES WILL BE REMOVED W		
	DIAMETER INCHES TO BE MITI		
	DOWN OF REPLACEMENT AS I		
12	DAHOON HOLLY	4" EACH	48
3	CRAPE MYRTLE	4" EACH	12
4	PINK TABEBUIA	4" EACH	16
	TOTAL DIAMETER INCHES PRO	VIDED	76

SCALE: <sup>1</sup>/<sub>16</sub>=1'-0"

KNOW WHAT'S BELOW
ALWAYS CALL 811
BEFORE YOU DIG

It's fast, It's free, it's the law. Call <u>811</u> two business days before digging



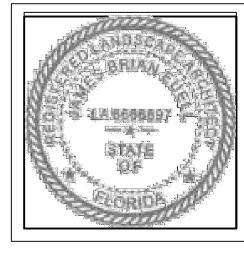




2231 FILLMOF 2224 PIERC

DISTRIBUTION: PERMIT COMMENTS 09-25-23 PERMIT REVISION 02-27-24 PERMIT REVISION 04-19-24 PERMIT REVISION 09-24-24


DRAWING NAME: LANDSCAPE PLAN

DRAWING NUMBER:

L-210

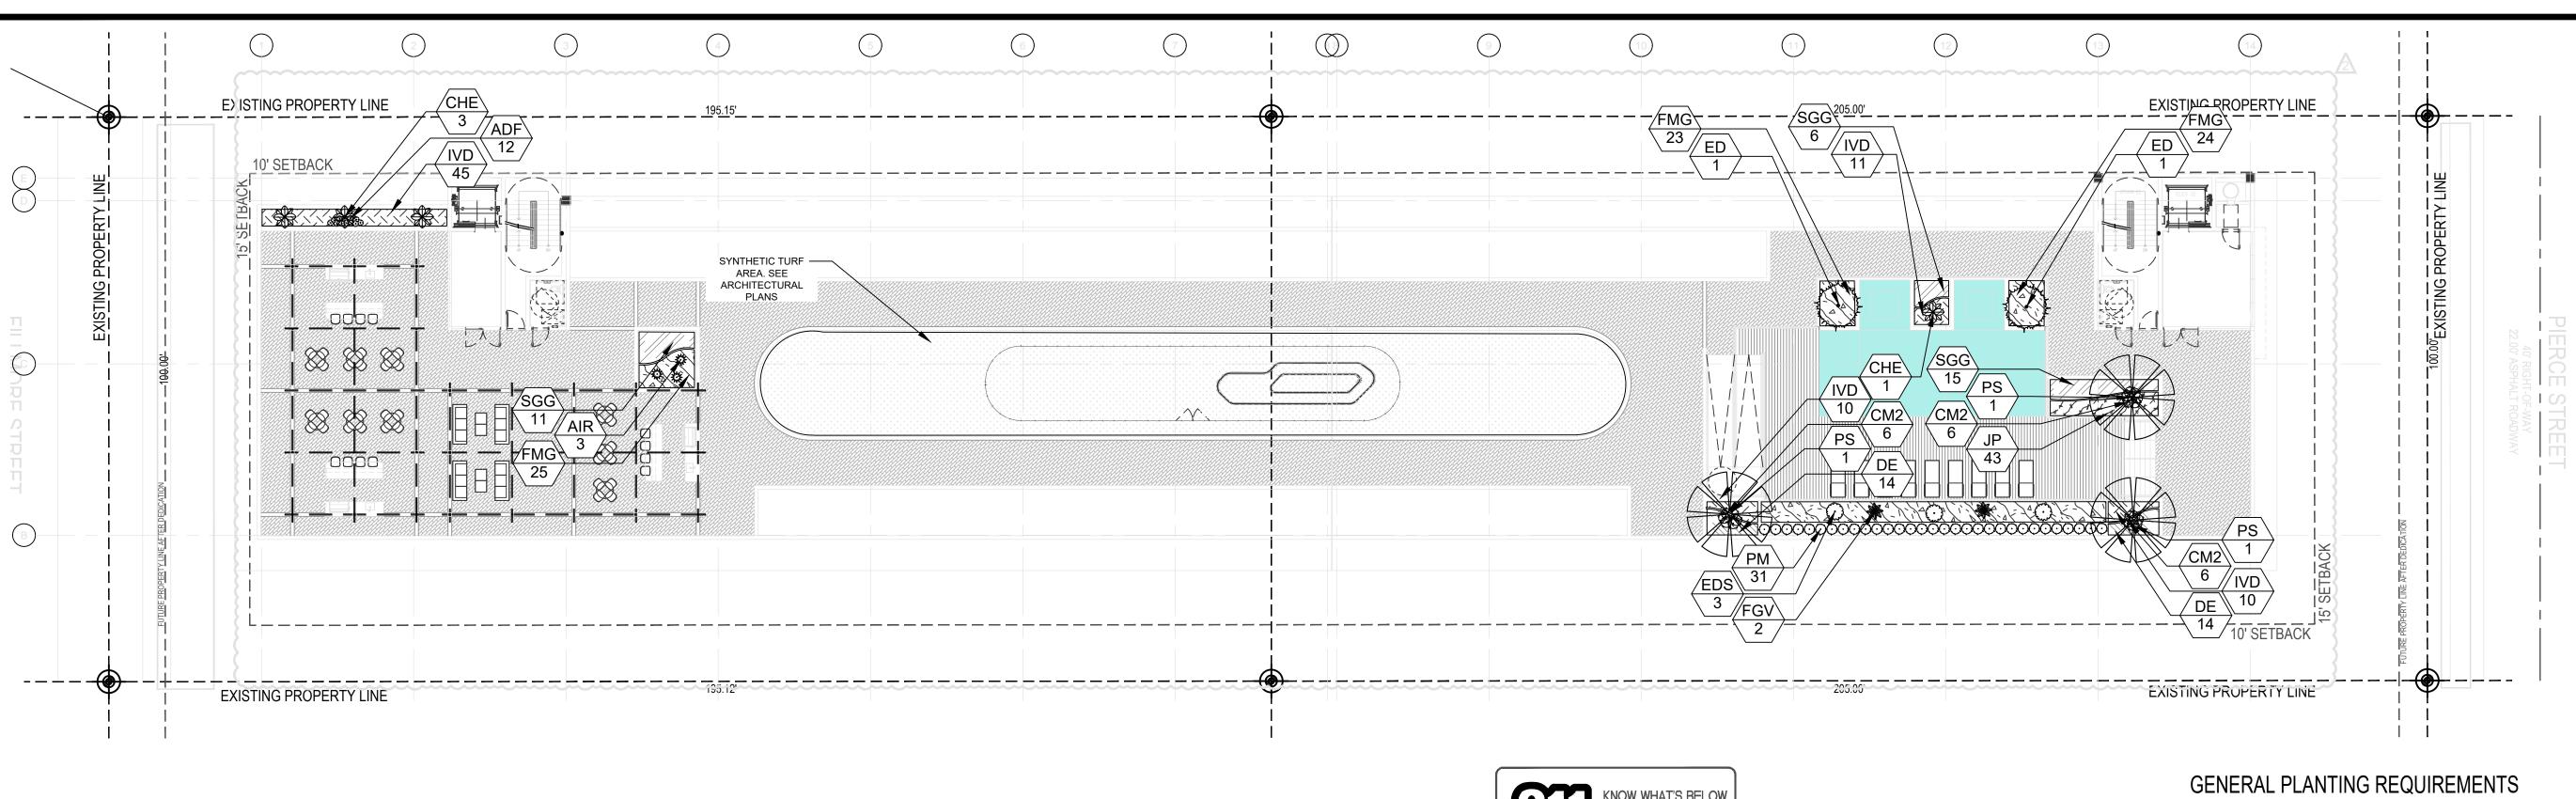

# SCALE: \(\frac{1}{16} = 1' - 0''\)

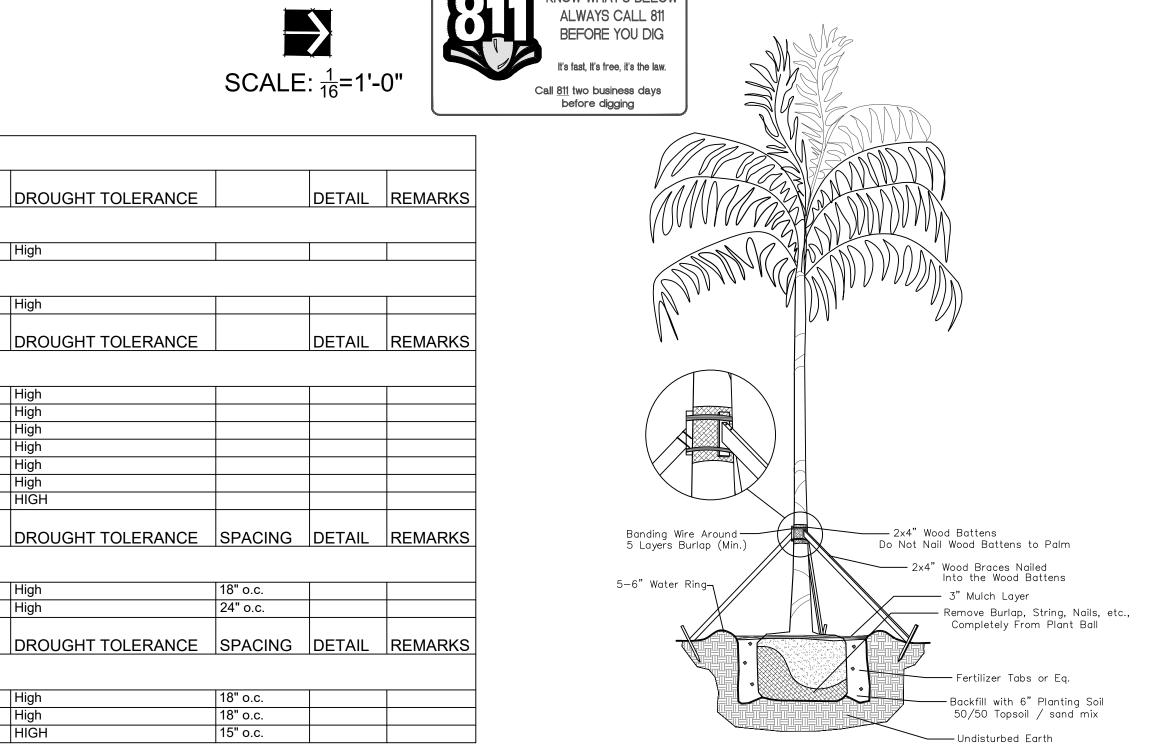

# Palm Planting Detail

18" o.c.


24" o.c.

18" o.c.

18" o.c.

15" o.c.

NATIVE DROUGHT TOLERANCE

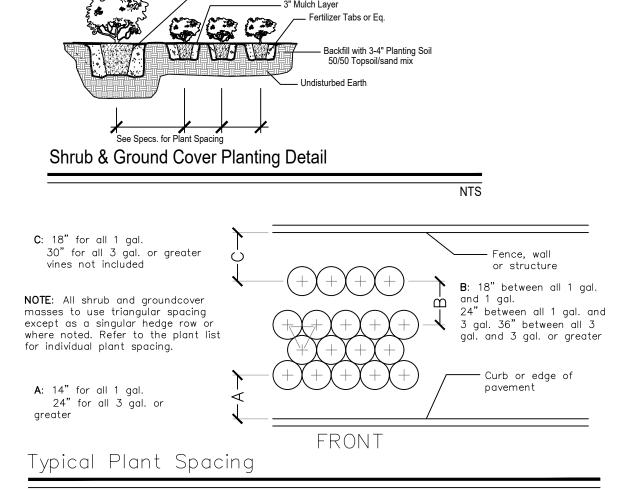

PLANT SCHEDULE ROOF DECK

Elaeocarpus decipiens / Japanese Blueberry Tree

Alcantarea imperialis 'Rubra' / Rubra Imperial Bromeliad

Podocarpus macrophyllus 'Maki' / Maki Yew Podocarpus

Schefflera arboricola `Gold Capella` / Gold Capella Arboricola

Chamaerops humilis cerifera `Silver Select` / Silver Mediterranean Fan Palm

Elaeocarpus decipiens 'MonProud' / Japanese Blueberry Tree Dwarf

Asparagus densiflorus `Myers` / Myers Asparagus

Codiaeum variegatum `Mammy` / Mammy Croton

Duranta erecta `Gold Mound` / Gold Mound Duranta

| 174 | Ficus microcarpa `Green Island` / Green Island Ficus


76 Ilex vomitoria `Stokes dwarf` / Dwarf Yaupon Holly

43 Juniperus chinensis 'Parsonii' / Parsoni Juniper

Furcraea gigantea `Variegata` / False Agave

CODE QTY BOTANICAL / COMMON NAME

**PALM TREES** 

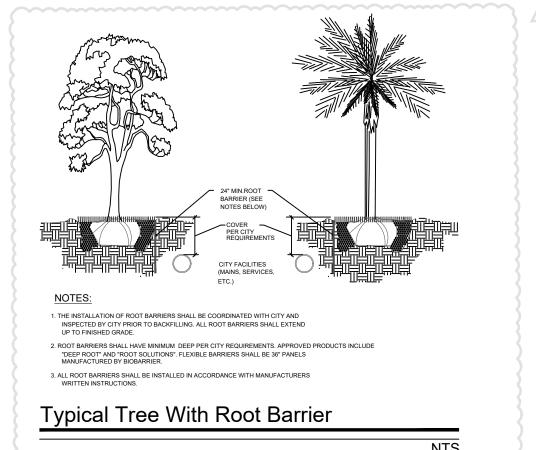

10` HT. x 5` SPR

12` O.A. SINGLE

18"x18"

4` OA., TRIPLE

24" H. X 24" SPR.

18"HT x 18"SPR

24"HT x 24"SPR

14" HT x 16" SPF

14" HT x 16" SPR

12"HT x 12"SPR @


6' OA.: FULL TO BASE. CONE


FG/B&B

3" DBH

CONTAINER SIZE

CONTAINER SIZE

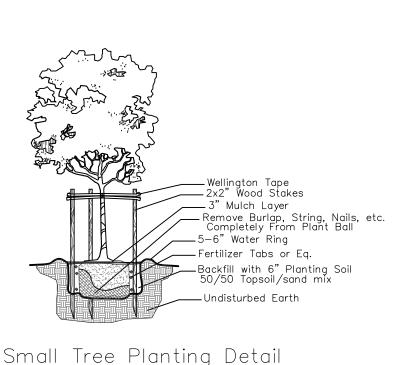

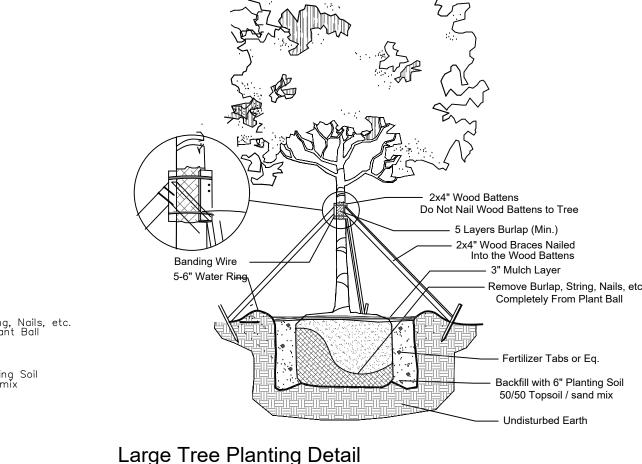


SPECIAL INSTRUCTIONS

- Remove Burlap, String, Nails, etc. General site and berm grading to +/- 1 inch (1") shall be provided by the general contractor. All finished site grading and final decorative berm shaping shall be provided by the landscape contractor.

> secundatum, St. Augustine 'Palmetto' solid sod. It shall be the responsibility of the landscape contractor to include in the bid, the repair of any sod which may be damaged from the landscape installation operations.

**EXPRESSIONS** OLIAGE



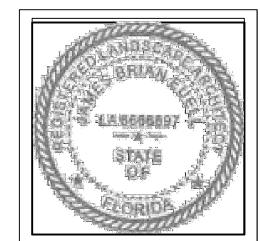

Soil must be free of all rocks, sticks, and objectionable material including weeds and weed seeds as per CSI specifications. Twelve inches (12") of planting soil 50/50 sand/topsoil mix is required around

and beneath the root ball of all trees and palms, and 1 cubic yard per 50 bedding or groundcover plants. All landscape areas shall be covered with Eucalyptus or sterilized seed free

All sizes shown for plant material on the plans are to be considered Minimum.

All plant material must meet or exceed these minimum requirements for both

All plant material furnished by the landscape contractor shall be Florida #1 or better as established by "Grades and Standards for Florida Nursery Plants" and

All plant material (except SOD) as included herein shall be warranted by the

All plant material shall be planted in planting soil that is delivered to the site in

a clean loose and friable condition. All soil shall have a well drained characteristic.

"Grades and Standards for Florida Nursery Trees". All material shall be installed

on the plan(s) will also be required for final acceptance.

landscape contractor for a minimum period of 12 months,

as per CSI specifications.

height and spread. Any other requirements for specific shape or effect as noted

Melaleuca mulch to a minimum depth of three inches (3") of cover when settled. A four-inch clear space must be left for air between plant bases and the mulch. Cypress bark mulch shall not be used.

All plant material shall be thoroughly watered in at the time of planting; no dry planting permitted. All plant materials shall be planted such that the top of the plant ball is flush with the surrounding grade.

All landscape and lawn areas shall be irrigated by a fully automatic sprinkler system adjusted to provide 100% coverage of all landscape areas. All heads shall be adjusted to 100% overlap as per manufacturers specifications and performance standards utilizing a rust free water source. Each system shall be

installed with a rain sensor. It is the sole responsibility of the landscape contractor to insure that all new plantings receive adequate water during the installation and during all plant warranty periods. Deep watering of all new trees and palms and any supplemental watering that may be required to augment natural rainfall and site irrigation is mandatory to insure proper plant development and shall be provided as a part of this contract.

All plant material shall be installed with fertilizer, which shall be State approved as a complete fertilizer containing the required minimum of trace elements in addition to N-P-K, of which 50% of the nitrogen shall be derived from an organic source as per CSI specifications.

Contractors are responsible for coordinating with the owners and appropriate public agencies to assist in locating and verifying all underground utilities prior to excavation.

The plan takes precedence over the plant list.

NTS

All sod areas as indicated on the planting plan shall receive Stenotaphrum

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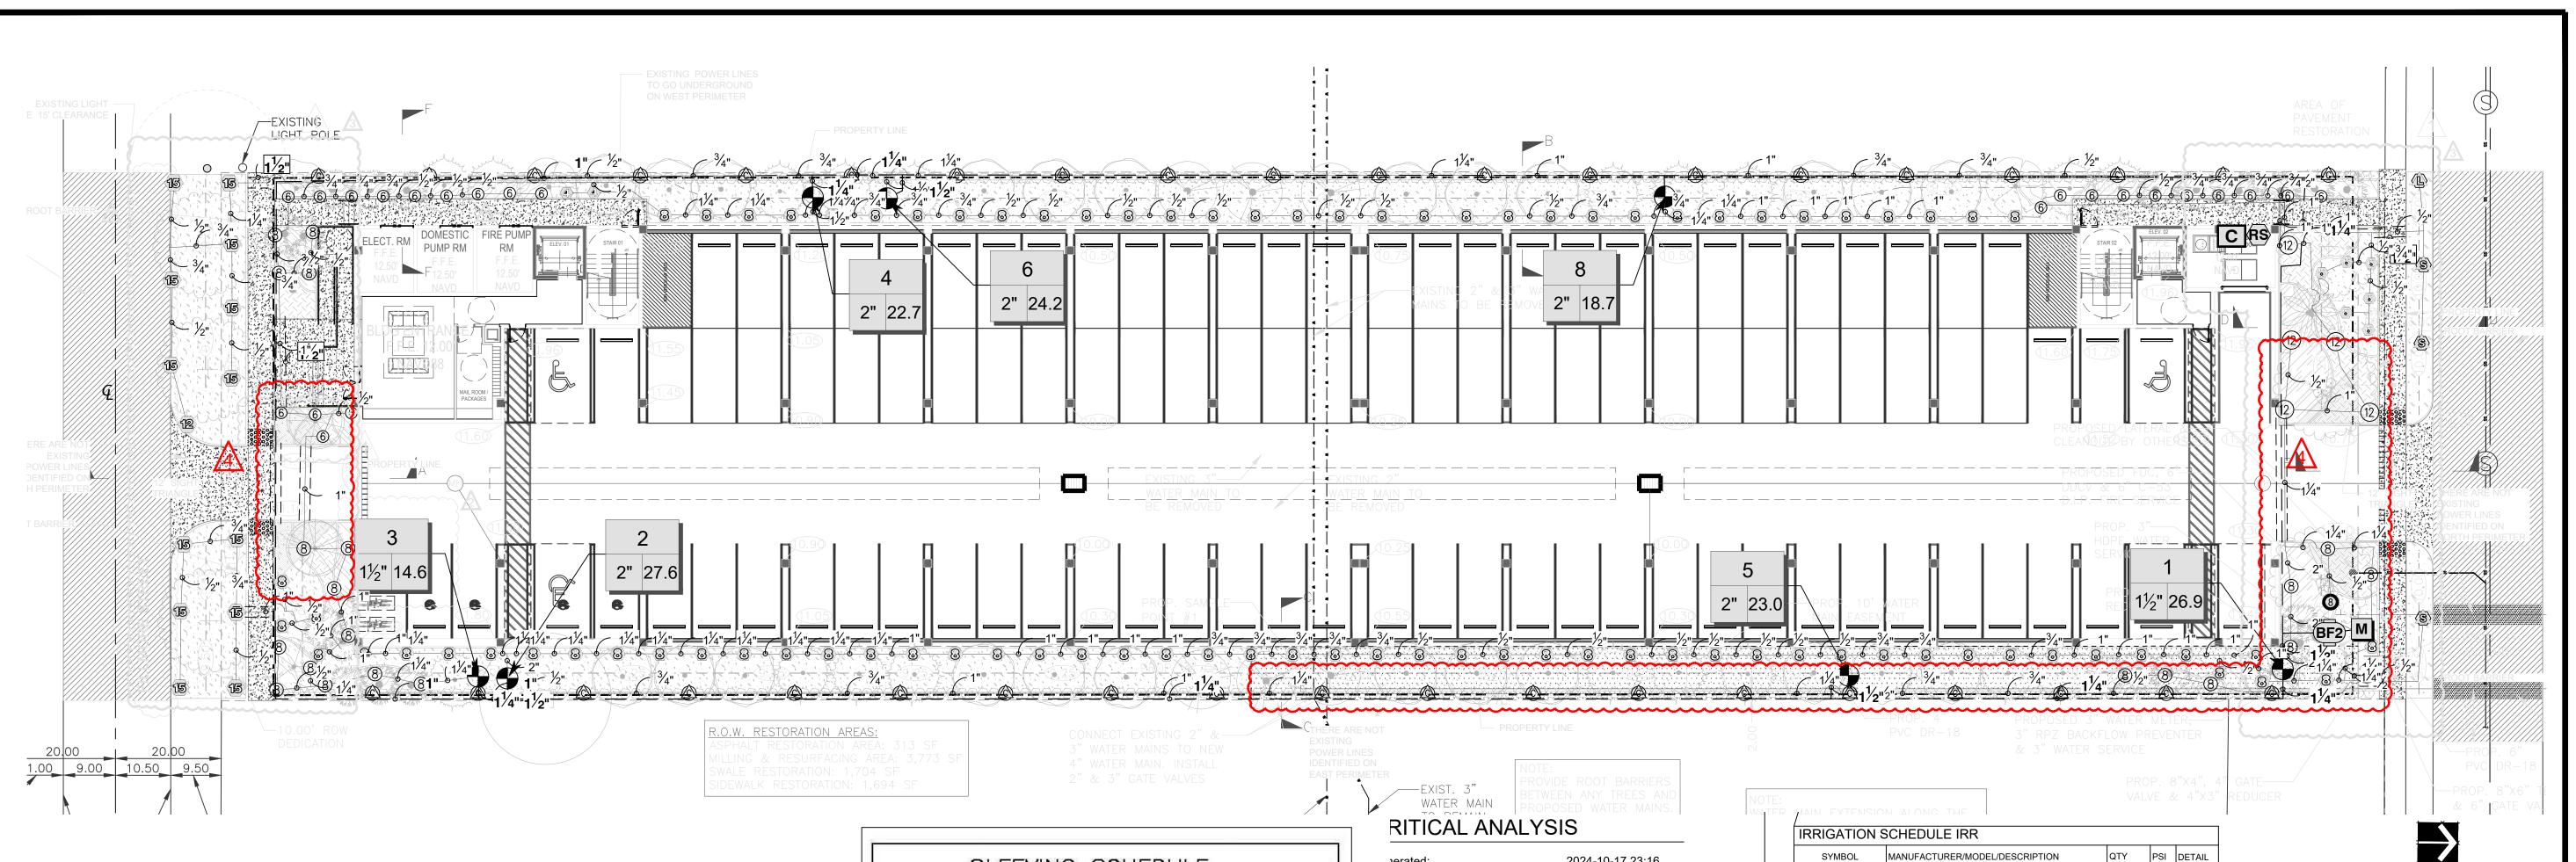
DISTRIBUTION: DATE:

PERMIT COMMENTS 09-25-23 PERMIT REVISION 02-27-24

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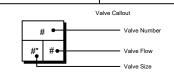
DRAWING NAME: LANDSCAPE NOTES AND DETAILS

DRAWING NUMBER: L-211



SLEEVIN	G SCHEDULE			
PIPE SIZE	SLEEVING PIPE SIZE			
3/4"	2"			
1"	2" 3" 3" 4"			
1-1/4"				
1-1/2"				
2"				
3"	6"			
4"	8"			
6"	12"			
8"	16"			

	, i	IRRIGATION	SCHEDULE IRR		
nerated:	2024-10-17 23:16	SYMBOL	MANUFACTURER/MODEL/DESCRIPTION	QTY	PS
.C. NUMBER: 01	2021 10 17 20.10	EST LCS RCS CST SST	Rain Bird 1806-PRS 15 Strip Series Turf Spray 6.0" Pop-Up Sprinkler with Co-Molded Wiper Seal. Side and Bottom Inlet. 1/2" NPT Female Threaded Inlet. Pressure Regulating.	4	30
ter Source Information: )W AVAILABLE		<b>② ③ 18</b> 4V 6V 18V	Rain Bird 1806-PRS ADJ Turf Spray 6.0" Pop-Up Sprinkler with Co-Molded Wiper Seal. Side and Bottom Inlet. 1/2" NPT Female Threaded Inlet. Pressure Regulating.	9	30
ter Meter Size: v Available	3" 170.11 GPM	© 08HE-VAN 12HE-VAN 15HE-VAN	Rain Bird 1806-PRS ADJ Turf Spray 6.0" Pop-Up Sprinkler with Co-Molded Wiper Seal. Side and Bottom Inlet. 1/2" NPT Female Threaded Inlet. Pressure Regulating.	101	30
ESSURE AVAILABLE tic Pressure at POC:	80 PSI	(A) (A) (A) (A) (B) (B) (B) (B) (B) (B) (B) (B) (B) (B	Rain Bird 1800-PA-8S-PRS 15 Strip Series Shrub Spray on fixed riser with the PA-8S-PRS Pressure Regulating Shrub Adapter. Use with 1/2" MPT threaded risers.	39	30
vation Change: vice Line Size:	5.00 ft 3"		Rain Bird 1800-PA-8S-PRS 8 Series MPR Shrub Spray on fixed riser with the PA-8S-PRS Pressure Regulating Shrub Adapter. Use with 1/2" MPT threaded risers.	1	30
gth of Service Line: ssure Available:	20 ft 77 PSI	<b>4 6 18</b> 4v 6v 18v	Rain Bird 1800-PA-8S-PRS ADJ Shrub Spray on fixed riser with the PA-8S-PRS Pressure Regulating Shrub Adapter. Use with 1/2" MPT threaded risers.	23	30
SIGN ANALYSIS	07 TO ODM	(8) 08HE-VAN (12) 12HE-VAN (15) 15HE-VAN	Rain Bird 1800-PA-8S-PRS ADJ Shrub Spray on fixed riser with the PA-8S-PRS Pressure Regulating Shrub Adapter. Use with 1/2" MPT threaded risers.	26	30
cimum Station Flow:	27.58 GPM	SYMBOL	MANUFACTURER/MODEL/DESCRIPTION	QTY	
w Available at POC: idual Flow Available:	170.11 GPM 142.53 GPM	•	Rain Bird PEB-PRS-D 1-1/2" 1", 1-1/2", 2" Plastic Industrial Valves. Low Flow Operating Capability, Globe Configuration. With Pressure Regulator Module.	2	
ical Station: ∋sign Pressure:	6 30 PSI	•	Rain Bird PEB-PRS-D 2" 1", 1-1/2", 2" Plastic Industrial Valves. Low Flow Operating Capability, Globe Configuration. With Pressure Regulator Module.	5	
iction Loss:	5.39 PSI	<u> </u>	Febco 860 Master Series 3" Reduced Pressure Backflow Preventer		1
tings Loss: evation Loss:	0.54 PSI 0 PSI	C	Rain Bird ESP4ME with (1) ESP-SM3 7 Station, Hybrid Modular Outdoor Controller. For Residential or Light Commercial Applications.	1	
ss through Valve: ssure Req. at Critical Station:	4.8 PSI 40.7 PSI	RS	Rain Bird RSD-BEx Rain Sensor, with metal latching bracket, extension wire.	1	
s for Fittings:	0 PSI	М	Water Meter 3"	1	
s for Main Line:	7.6 PSI		Irrigation Lateral Line: PVC Schedule 40 1/2"	792.3 l.f.	T
s for POC to Valve Elevation: s for Backflow:	0 PSI 11.5 PSI		Irrigation Lateral Line: PVC Schedule 40 3/4"	433.4 l.f.	
s for Water Meter:	1 PSI		Irrigation Lateral Line: PVC Schedule 40 1"	569.5 l.f.	
cal Station Pressure at POC:	60.8 PSI		Irrigation Lateral Line: PVC Schedule 40 1 1/4"	594.7 l.f.	
ssure Available: idual Pressure Available:	77 PSI 16.2 PSI		Irrigation Lateral Line: PVC Schedule 40 1 1/2"	11.1 l.f.	
			Irrigation Lateral Line: PVC Schedule 40 2"	28.1 l.f.	
			Irrigation Mainline: PVC Schedule 40 1"	243.8 l.f.	



----- Irrigation Mainline: PVC Schedule 40 1 1/4"

Irrigation Mainline: PVC Schedule 40 1 1/2"


Pipe Sleeve: PVC Class 200 SDR 21


39.6 l.f.



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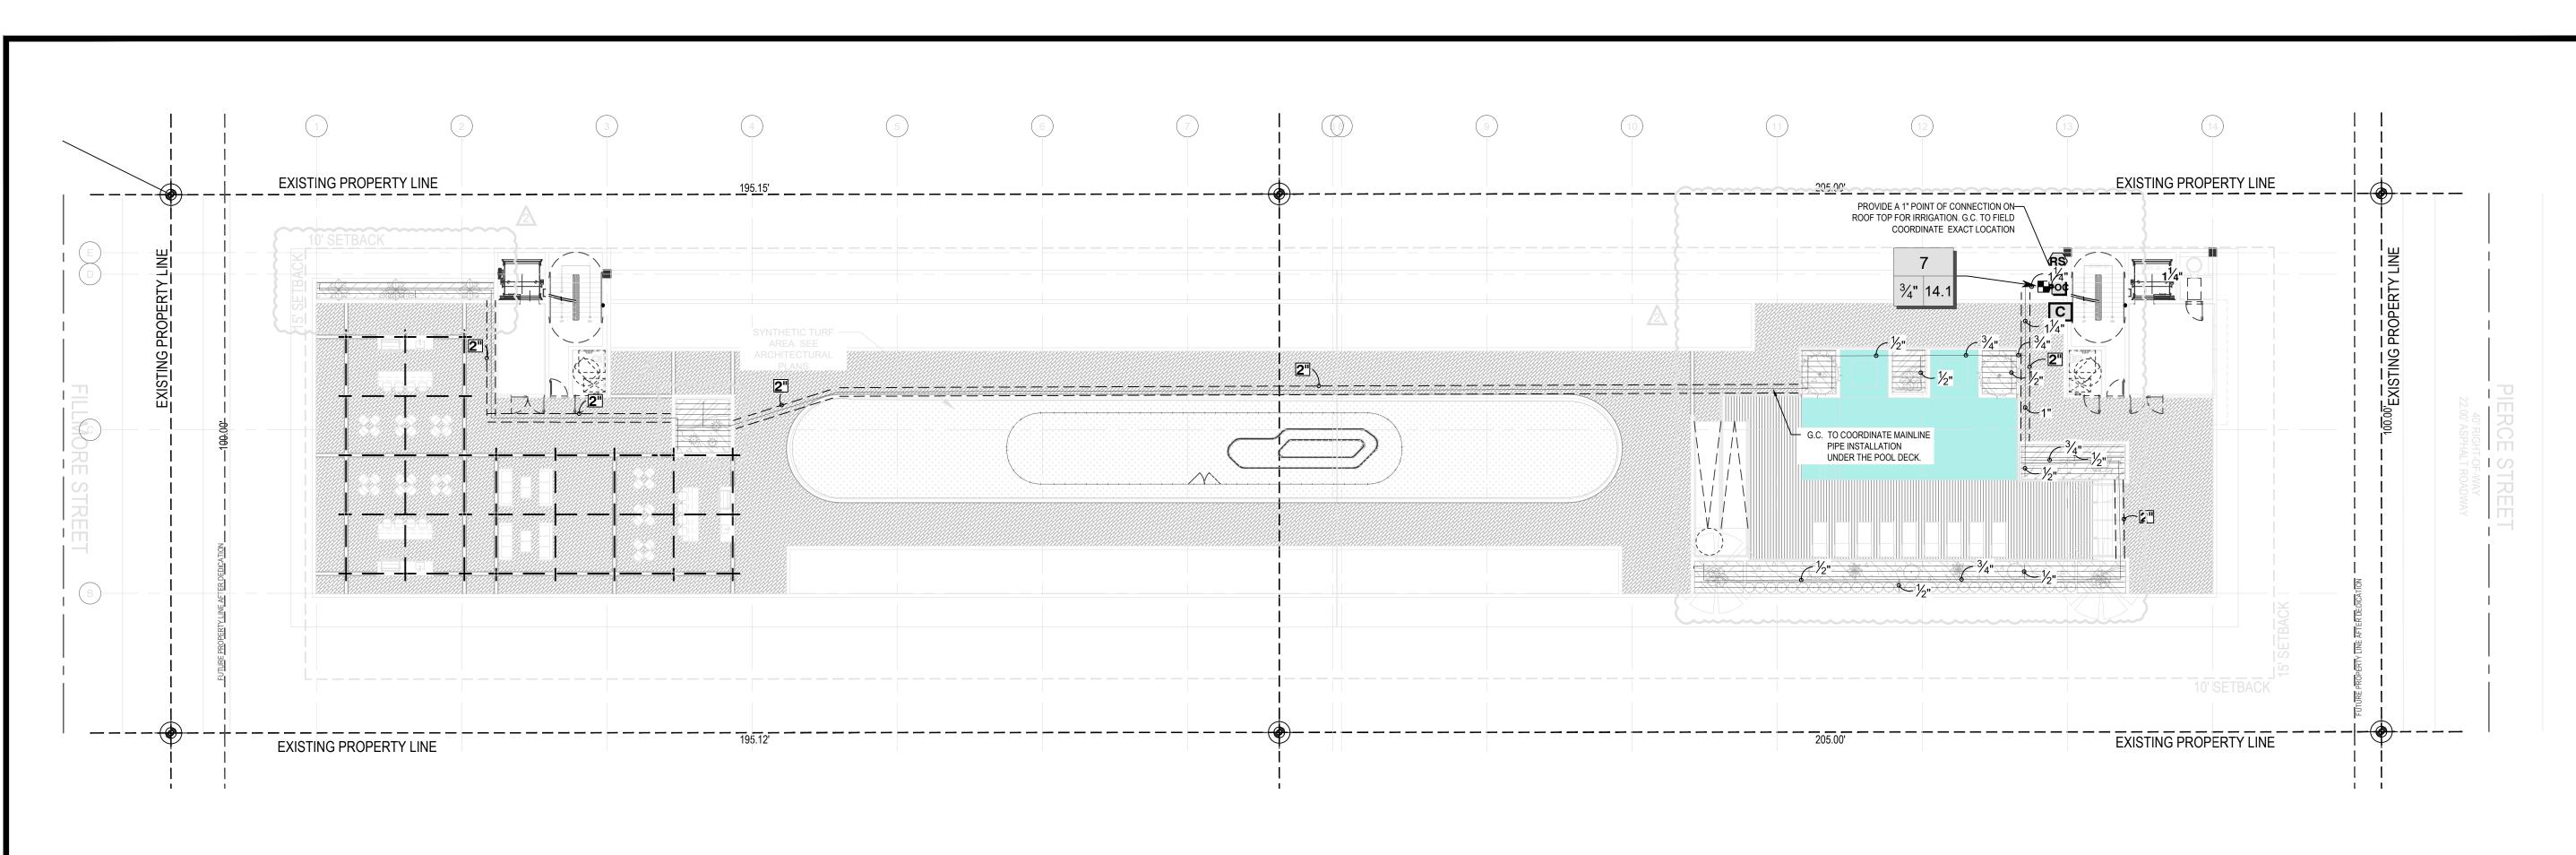


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DATE: DISTRIBUTION: PERMIT COMMENTS 09-25-23 PERMIT REVISION 02-27-24 /3\ PERMIT REVISION | 04-19-24 PERMIT REVISION 09-24-24

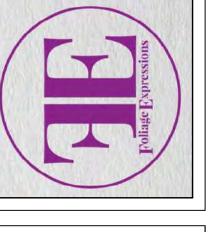DRAWING NAME: **IRRIGATION** PLAN

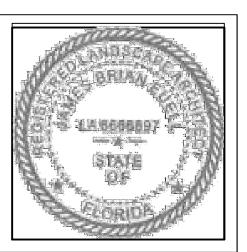DRAWING NUMBER:









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**EXPRESSIONS** 

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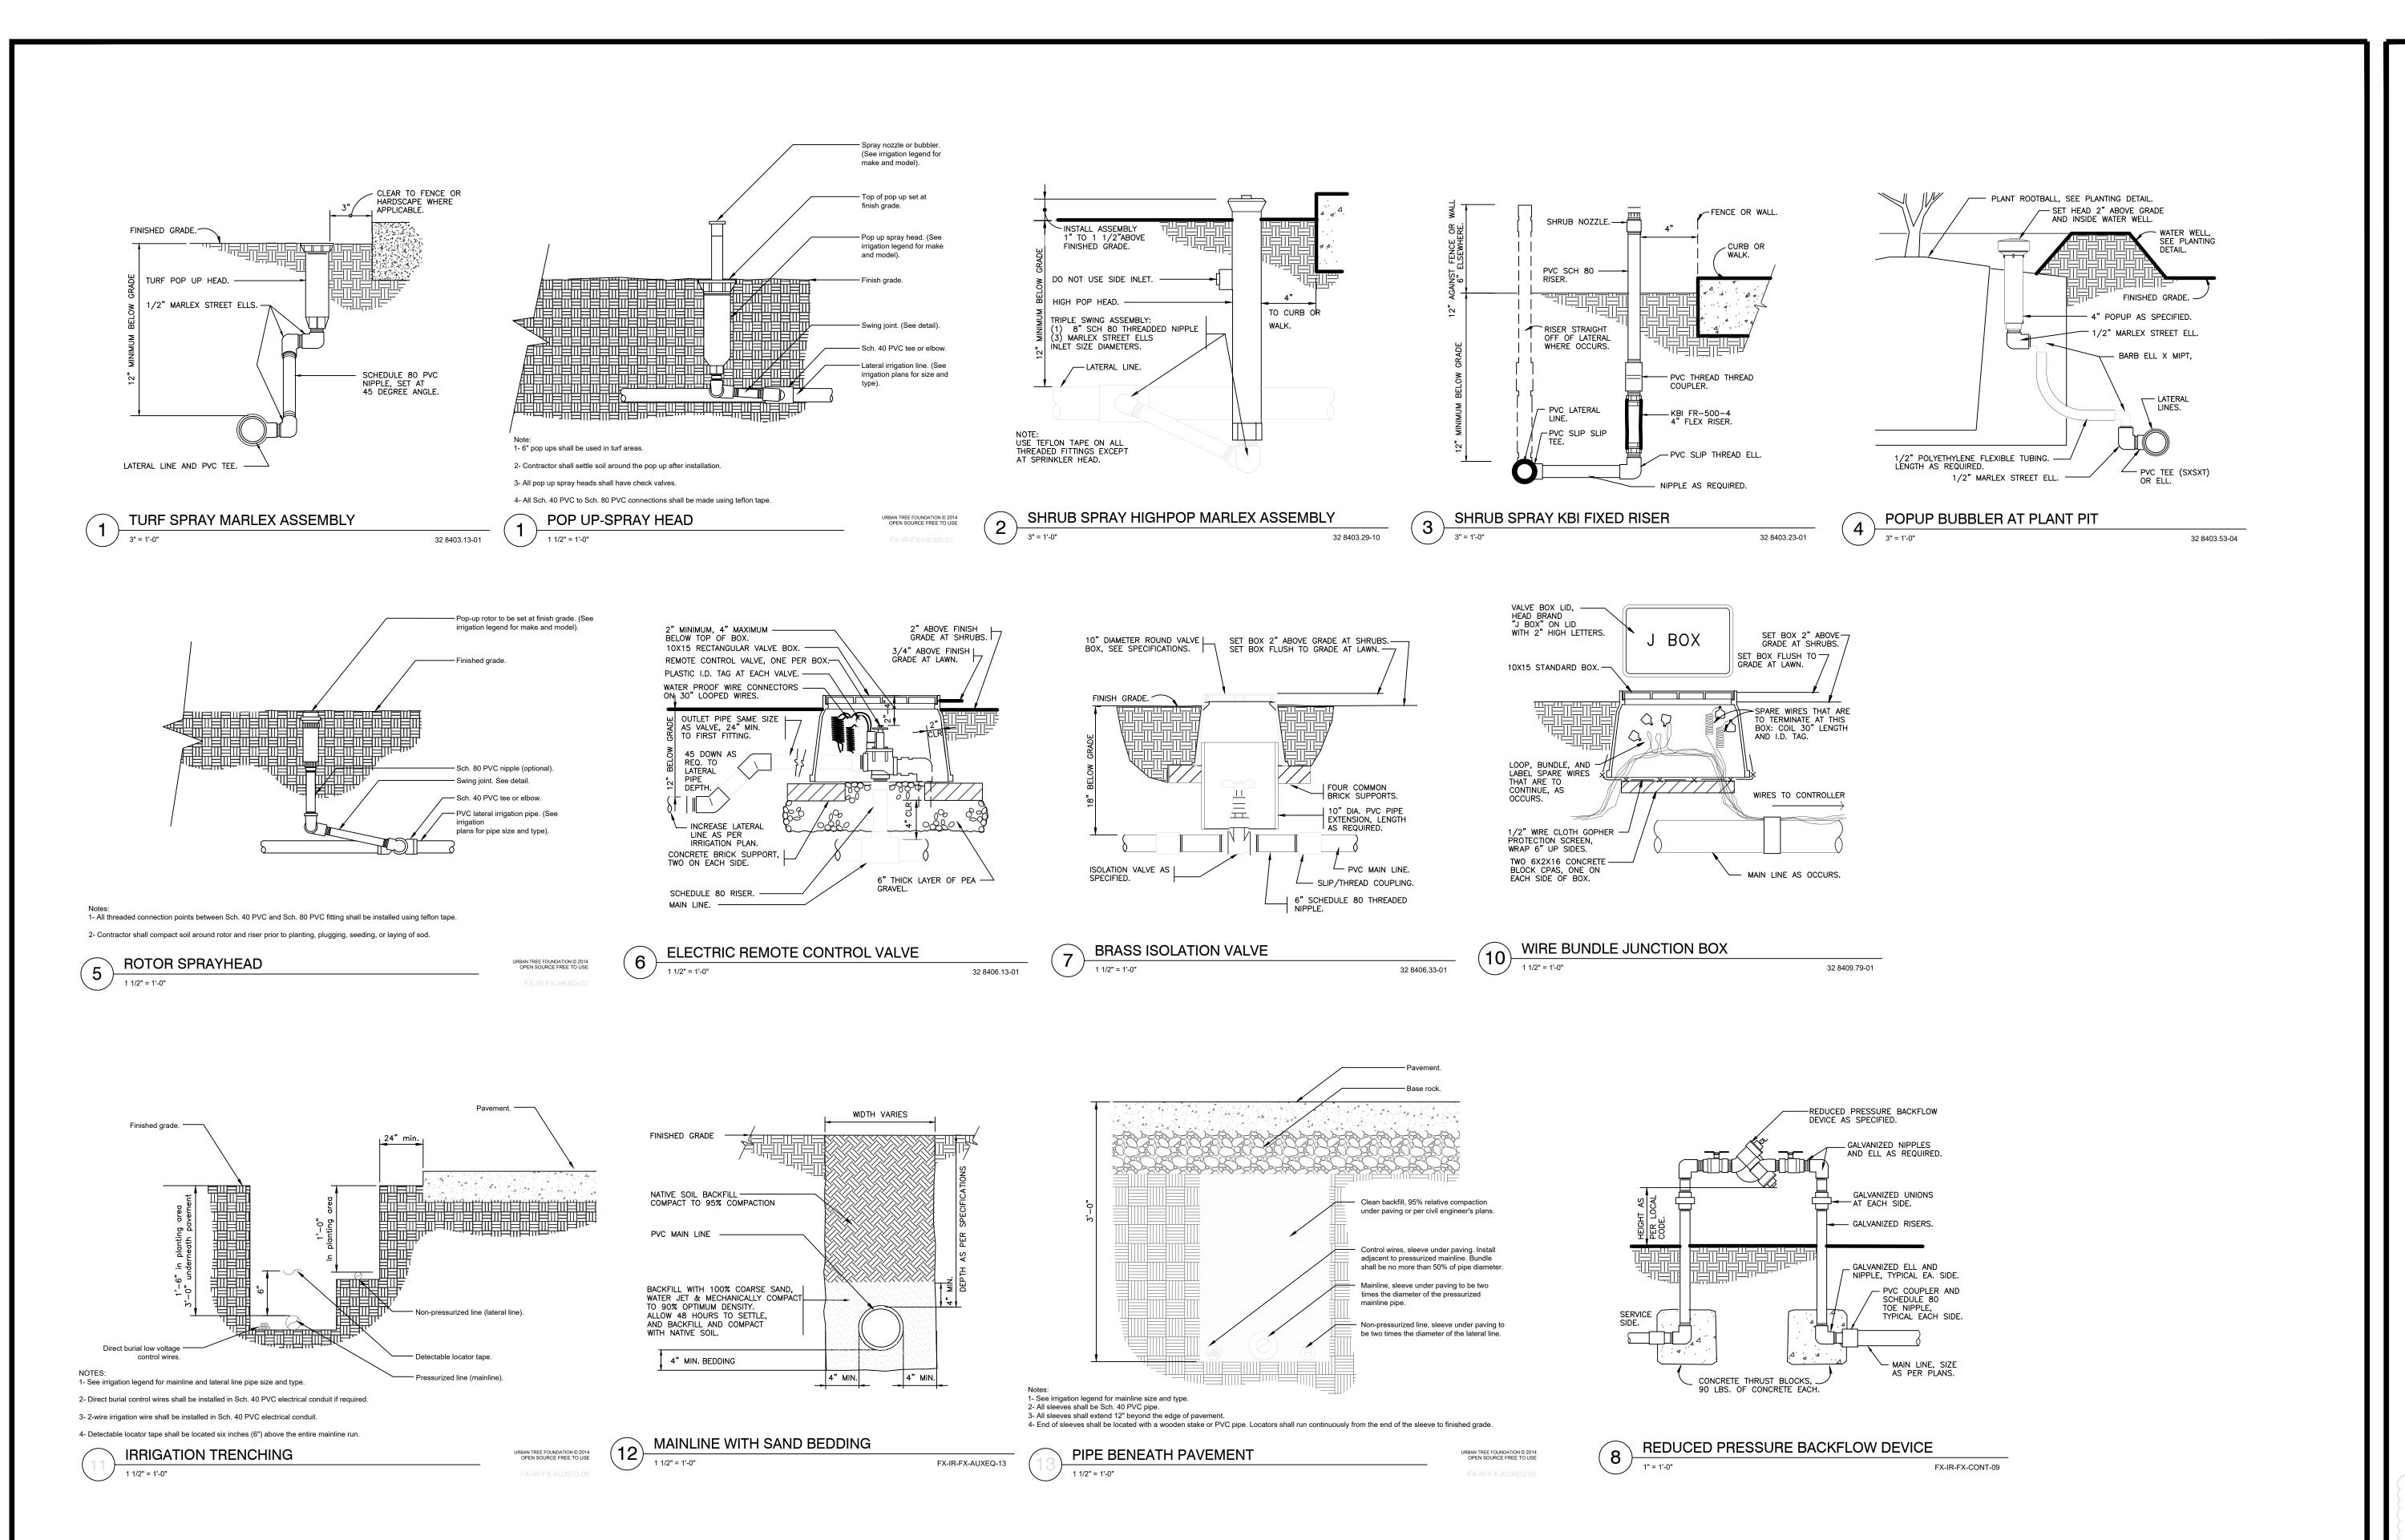
DISTRIBUTION: DATE: /\frac{1}{2} PERMIT COMMENTS | 09-25-23 PERMIT REVISION 02-27-24 /3\ PERMIT REVISION 04-19-24

DRAWING NAME:

**ROOF DECK IRRIGATION** PLAN

DRAWING NUMBER: L-301

IRRIGATION SCHEDULE ROOF TOP MANUFACTURER/MODEL/DESCRIPTION QTY DETAIL RAIN BIRD XACZ-075-PRF 3/4" LOW FLOW DRIP CONTROL KIT, 3/4IN. LOW FLOW ANTI-SIPHON VALVE, 3/4IN. PRESSURE REGULATING RBY FILTER, AND 1 30PSI PRESSURE REGULATOR, FOR ABOVE GRADE INSTALLATION. 0.2 GPM-5 AREA TO RECEIVE DRIPLINE RAIN BIRD XFS-CV-PS-9-12 XFS-CV 0.9 GPH LANDSCAPE DRIPLINE W/ 938.9 L.F. PURPLE STRIPE. MANUFACTURER/MODEL/DESCRIPTION QTY DETAIL RAIN BIRD ESPLXME2 12 STATION TRADITIONALLY-WIRED, COMMERCIAL CONTROLLER. INDOOR/OUTDOOR, PLASTIC WALL-MOUNT ENCLOSURE. RAIN BIRD RSD-BEX RAIN SENSOR, WITH METAL LATCHING BRACKET, EXTENSION WIRE. POINT OF CONNECTION IRRIGATION LATERAL LINE: PVC 415.8 L.F. SCHEDULE 40 1/2" IRRIGATION LATERAL LINE: PVC 100.1 L.F. SCHEDULE 40 3/4" IRRIGATION LATERAL LINE: PVC 19.5 L.F. SCHEDULE 40 1" IRRIGATION LATERAL LINE: PVC 16.0 L.F. SCHEDULE 40 1 1/4" IRRIGATION MAINLINE: PVC SCHEDULE 40 | 2.8 L.F. ====== PIPE SLEEVE: PVC CLASS 200 SDR 21 294.7 L.F.







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DISTRIBUTION: DATE: PERMIT COMMENTS 09-25-23

DRAWING NAME: **IRRIGATION DETAILS** 

DRAWING NUMBER: L-302
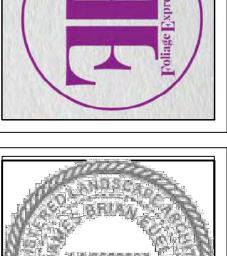
### WIRING

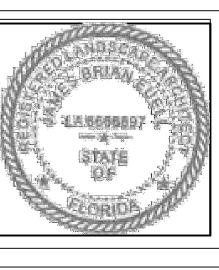Irrigation control wire shall be thermoplastic solid copper, single conductor, low voltage irrigation controller wire, suitable for direct burial and continuous operation at rated voltages.

Tape and bundle control wire every 10' and run alongside the mainline. At all turns in direction, make a 2' coil of wire. At all valve boxes coil wire around a ¾" piece of PVC pipe to make a coil using 30 linear inches of wire. Make electrical connections with 3MDBY/R connectors.

Number all wires, using an electrical book of numbers, according to the plans. Number wires in all valve boxes, junction boxes and at the controller.

### Wire sized, numbered and colored as follows:

- #14 white for common
- #14 spare black common
- #14 individual color coded hot wire#14 spare yellow hot wire

### Spare wires

Leaving each controller, run four spare wires in both directions (eight spare wires total). Install as 1 common spare (2 total) and 3 hot wires (6 total). Loop these wires into each RCV along their path and terminate in the last valve box controlled by the wires respective controller. The loop into each valve box shall extend up into the valve box a minimum of 8" and be readily accessible by opening the valve box lid. These wires must all be color coded and numbered as required in the plans.

Controller and pump station Control Panel grounding - Contractor to utilize 4"x8"x5" copper grounding plates, 5%"x10' copper clad grounding rods, 'One Strike' CAD wells at all connection points, #6 insulated copper wire, and earth contact material. Install these and other required components as outlined in the detail. Contractor to verify that the earth to ground resistance does not exceed 10 ohms. Contractor shall provide a written certification, on a licensed electrical contractors letter head, showing the date of the test, controller/pump location, and test results. Each controller/pump shall be so grounded an tested. Each component must have its own separate ground grid, unless they are sitting side by side, in which case up to two controllers can share a common grounding grid.

### LAYOUT

Lay out irrigation system mainlines and lateral lines. Make the necessary adjustments as required to take into account all site obstructions and limitations prior to excavating trenches.

Stake all sprinkler head locations. Adjust location and make the necessary modifications to nozzle types, etc. required to ensure 100% head to head coverage. Refer to the Edge of Pavement Detail on the Irrigation Detail sheet.

Spray heads shall be installed 4" from sidewalks or curbed roadways and 12" from uncurbed roadways and building foundations. Rotors shall be installed 4" from sidewalks or curbed roadways, 12" from building foundations, and 36" from uncurbed roadways.

Shrub heads shall be installed on \(\frac{3}{4}\)" Sch 40 PVC risers. The risers shall be set at a minimum of 18" off sidewalks, roadway curbing, building foundations, and/or any other hardscaped areas. Shrub heads shall be installed to a standard height of 2" above maintained height of plants and shall be installed a minimum of 6" within planted masses to be less visible and offer protection. Paint all shrub risers with flat black or forest green paint, unless irrigation system will utilize reuse water; in this case the risers shall be purple PVC and shall not be painted.

Locate valves prior to excavation. Ensure that their location provides for easy access and that there is no interference with physical structures, plants, trees, poles, etc. Valve boxes must be placed a minimum of 12" and a maximum of 15" from the edge of pavement, curbs, etc. and the top of the box must be 2" above finish grade. No valve boxes shall be installed in turf areas without approval by the irrigation designer - only in shrub beds. Never install in sport field areas.

### VALVE

Sequence all valves so that the farthest valve from the POC operates first and the closest to the POC operates last. The closest valve to the POC should be the last valve in the programmed sequence.

Adjust the flow control on each RCV to ensure shut off in 10 seconds after deactivation by the irrigation controller

Using an electric branding iron, brand the valve ID letter/number on the lid of each valve box. This brand must be 2"-3" tall and easily legible.

### EQUIPMENT

All pop-up heads and shrub risers shall be pressure compensating. All pop-up heads shall be mounted on flex-type swing joints. All rotors shall be installed with PVC triple joints unless otherwise detailed.

All sprinkler equipment, not otherwise detailed or specified on these plans, shall be installed as per manufacturer's recommendations and specifications, and according to local and state laws.

# TRENCHING

Excavate straight and vertical trenches with smooth, flat or sloping bottoms. Trench width and depth should be sufficient to allow for the proper vertical and horizontal separation between piping as shown in the pipe installation detail on the detail sheet.

Protect existing landscaped areas. Remove and replant any damaged plant material upon job completion. The replacement material shall be of the same genus and species, and of the same size as the material it is replacing. The final determination as to what needs to be replaced and the acceptability of the replacement material shall be solely up to the owner or owner's representative.

# INSTALLATION

Solvent Wld Pipe: Cut all pipe square and deburr. Clean pipe an fittings of foreign material; then apply a small amount of primer while ensuring that any excess is wiped off immediately. Primer should not puddle or drip from pipe or fittings. Next apply a thin coat of PVC cement; first apply a thin layer to the pipe, next a thin layer inside the fitting, and finally another very thin on the pipe. Insert the pipe into the fitting. Insure that the pipe is inserted to the bottom of the fitting, then urn the pipe a \frac{1}{4} turn and hold for 10 seconds. make sure that the pipe doesn't recede from the fitting. If the pipe isn't at the bottom of the fitting upon completion, the glue joint is unacceptable and must be discarded.

Pipes must curve a minimum of 30 minutes prior to handling and placing into trenches. A longer curing time may be required; refer to the manufacturer's specifications. The pipe must cure a minimum of 24 hous prior to filling with water.

# BACK FILL

The back fill 6" below, 6" above, and around all piping shall be clean sand and anything beyond that in the trench can be of native material but nothing larger than 2" in diameter. All piping and excavations shall be backfilled and compacted to a density of 95% modified Proctor, or greater.

# Main line pipe depth measure to the top of pipe shall be:

24" minimum for  $\frac{3}{4}$ " -  $2\frac{1}{2}$ " PVC with a 30" minimum at vehicular crossings; 30" minimum for 3" & 4" PVC with a 36" minimum at vehicular crossings.

# Lateral line denths measure to ton of nine shall h

Lateral line depths measure to top of pipe shall be:

# 18" minimum for $\frac{3}{4}$ " - 3" PVC with a 30" minimum at vehicular crossings; 24" minimum for 4" PVC and above with a 30" minimum at vehicular crossings.

Contractor shall backfill all piping, both mainline and laterals, prior to performing any pressure tests. The pipe shall be backfilled with the exception of 2' on each side of every joint (bell fittings, 90's, tees, 45's, etc). These joints shall not be backfilled until all piping has satisfactorily passed its appropriate pressure test as outlined below.

# FLUSHING

Prior to the placement of valves, flush all mainlines for a minimum of 10 minutes or until lines are completely clean of debris, whichever is longer.

Prior to the placement of heads, flush all lateral lines for a minimum of 10 minutes or until lines are completely clean of debris, whichever is longer.

Use screens in heads and adjust heads for proper coverage avoiding excess water on walks, walls and paving.

# TESTING

Schedule testing with Owner's Representative a minimum of three (3) days in advance of testing.

Mainline: Remove all remote control valves and cap using a threaded cap on SCH 80 nipple. Hose bibs and gate valves shall not be tested against

during a pressure test unless authorized by written permission from the owner. fill mainline with water and pressurize the system to 125 PSI. Monitor the system pressure at two gauge locations; the gauge locations must be at opposite ends of the mainline. With the same respective pressures, monitor the gauges for two hours. There can be no loss in pressure at either gauge for solvent-welded pipe.

If these parameters are exceeded, locate the problem; repair it; wait 24 hours and retry the test. This procedure must be followed until the mainline passes the test.

Lateral lines: The lateral lines must be fully filled to operational pressure and visually checked for leaks. Any leaks detected must be repaired.

Operational Testing - Once the mainline and lateral lines have passed their respective tests, and the system is completely operational, a coverage test and demonstration of the system is required. The irrigation contractor must demonstrate to the owner, or his/her representative, that proper coverage is obtained and the system works automatically from the controller. This demonstration requires each zone to be turned on, in the proper sequence as shown on the plans, from the controller. Each zone will be inspected for proper coverage and function. The determination of proper coverage and function is at the sole discretion of the owner or owner's representative.

Upon completion of the operational test, run each zone until water begins to puddle or run off. This will allow you to determine the number of irrigation start times necessary to meet the weekly evapotranspiration requirements of the planting material in each zone. In fine sandy soils, it is possible no puddling will occur. If this is experienced, then theoretical calculations for run times will be required for controller programming.

### SUBMITTALS

<u>Pre-Construction:</u> Deliver five (5) copies of submittals to Owner's Representative within ten (10) working days from date of Notice to Proceed. Furnish information in 3-ring binder with table of contents and index sheet. Index sections for different components and label with specification section number and name of component. Furnish submittals for components on material list. Indicated which items are being supplied on catalog cut sheets when multiple items are shown on one sheet. Incomplete submittals will be returned without review. in lieu of hardcopies, an electronic package in PDF format can be submitted.

### After project completion:

As a condition of final acceptance, the irrigation contractor shall provide the owner with:

1. Irrigation As-builts - shall be provided accurately locating all mainlines, sleeves, remote control valves, gate valves, independent wire runs, wire splice boxes, controllers, high voltage supply sources/conduit path, control mechanisms, sensors, wells and water source connections. All mainline and independent runs of wire shall be located every 30' for straight runs and at every change of direction. Sleeves will be located at end points and every 20' of length. All underground items shall include depth in inch format.

2. Controller charts - Upon completion of "as-built" prepare controller charts; one per controller. Indicate on each chart the area controlled by a remote control valve (using a different color for each zone). This chart shall be reduced to a size that will fit inside the controller door. The reduction shall be hermetically sealed inside two 2ml pieces of clear plastic.

3. Grounding Certification - Provide ground certification results for each controller and pump panel grounding grid installed. This must be on a licensed electrician letter head indication location tested (using IR plan symbols), date, time, test method and testing results.

INSPECTIONS AND COORDINATION MEETINGS REQUIRED - Contractor is required to schedule, perform, and attend the following, and demonstrate to the owner and/or owners representative to their satisfaction, as follows:

- 1.Pre-construction meeting Designer and contractor to review entire install process and schedule with owner/general contractor.2. Mainline installation inspection(s) All mainline must be inspected for proper pipe, fittings, depth of coverage, backfill and installation
- nethod.
- 3. Mainline pressure test All mainline shall be pressure tested according to this design's requirements.
- 4. Flow meter calibration All flow meters must be calibrated. Provide certified calibration report for all flow meters.
- 5. Coverage and operational test
- 6. Final inspection7. Punch list inspection

### FINAL ACCEPTANCE

Final acceptance of the irrigation system will be given after the following documents and conditions have been completed and approved. Final payment will not be released until these conditions are satisfied.

- 1.All above inspections are completed, documented, approved by owner.
- 2.Completion and acceptance of 'as-built' drawings.
- 3. Acceptance of required controller charts and placement inside controllers.

GUARANTEE: The irrigation system shall be guaranteed for a minimum of one calendar year from the time of final acceptance.

# MINIMUM RECOMMENDED

IRRIGATION MAINTENANCE PROCEDURES

1. Every irrigation zone should be checked monthly and written reports generated describing the date(s) each zone was inspected, problems identified, date problems repaired, and a list of materials used in the repair. At minimum, these inspections should include the following tasks:

- A. Turn on each zone from the controller to verify automatic operation.
- B. Check schedules to ensure they are appropriate for the season, plant and soil type, and irrigation method. Consult an I.A. certified auditor for methods used in determining proper irrigation scheduling requirements.
  - C. Check remote control valve to ensure proper setting, if present.
  - D. Check setting on pressure regulator it verify proper setting, if present.
  - E.Check flow control and adjust as needed; ensure valve closure within 10-15 seconds after deactivation by controller.
  - F. Check for leaks mainline, lateral lines, valves, heads, etc.
- G. Check all heads as follows:
  - Check all heads as follows:

    1. Proper set height (top of sprinkler is 1" below mow height)
  - 2. Verify head pop-up height 6" in turf, 12" in groundcover, and riser in shrub beds
  - 3. Check wiper seal for leaks if leaking, clean head and re-inpect.
  - 4. If still leaking, replace head with the appropriate head with pressure regulator and built-in check valve.
    5. All nozzles checked for proper pattern, clogging, leaks, correct make & model, etc. replace as needed
  - 6. Check for proper alignment perfectly vertical; coverage area is correct;p minimize over spray onto hardscapes
  - 7. Riser height raised/lowered to accommodate plant growth patterns and ensure proper coverage. 8. Verify pop-ups retract after operation. If not, repair/replace as needed.
- H. Check controller/C.C.U. grounds for resistance (10 ohms or less) once per year. Submit written reports.
- I. check rain shut-off device monthly and clean/repair/replace as needed.
- J. Inspect all valve boxes to ensure they are in good condition, lids are in place and locked.
- K. Inspect backflow devices by utilizing a properly licensed backflow inspector. This should be done annually, at minimum.
- L. Inspect all filters monthly and clean/repair/replace as needed.
- M. Check pump stations fpr proper operation, pressures, filtration, settings, etc. refer to pump station operations manual.
- N. Check and clean intake screens on all suction lines quarterly, at minimum. Clean and/or repair, as needed.
- O. Winterize, if applicable, as weather in your area dictates. follow manufacturer recommendations and blow out all lines and equipment using compressed air. Perform seasonal startup of system as per manufacturer recommendations.
  - P. Conduct additional inspections, maintenance tasks, etc. that are particular for your site.


# SOIL MOISTURE SENSOR (When applicable)

- 1. Place all soil moisture sensor wiring in 1" SCH 40 PVC conduit
- 2. Soil moisture sensor should be placed in the middle of a spray or drip area as per manufacturer's recommendations.
- 3. Controller shall be set to the Florida Automated Weather Network's urban scheduler settings using the SMS as a moisture cut off device (like a rain switch) per manufacturer directions.

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1 FILLMORE ST. 8 224 PIERCE ST.

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DISTRIBUTION: DATE:

A PERMIT COMMENTS 09-25-23
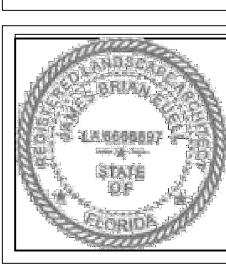
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