


ENGINEERING NOTES:

- 1. IF DISCREPANCIES FOUND ON THESE PLANS ARE BETWEEN THESE PLANS AND ACTUAL FIELD CONDITIONS OR ANY OMISSIONS OR ERRORS THAT MIGHT PRODUCE DAMAGES DERIVED FROM THIS DESIGN, IT SHALL BE BROUGHT TO THE ENGINEER PRIOR TO BIDDING OR START OF ANY CONSTRUCTION.
- 2. CONTRACTOR, PRIOR TO START OF ANY CONSTRUCTION, SHALL VERIFY LOCATION OF ALL EXISTING UTILITIES ON THE FIELD WITH THE APPROPRIATE UTILITY COMPANY. IN THE EVENT THAT ANY ADJUSTMENT BE NECESSARY DUE TO A DISCREPANCY FOR UTILITY LOCATION, THE CONTRACTOR SHALL NOTIFY THE ENGINEER 48 HOURS BEFORE PROCEEDING. THE CONTRACTOR SHALL EXERT CARE AND CAUTION IN PROTECTING AL UTILITIES DURING THE COMPLETION OF HIS WORK. IN THE EVENT OF ANY DAMAGE THI CONTRACTOR SHALL IMMEDIATELY NOTIFY THE APPROPRIATE UTILITY COMPANY. ANY AND ALL COSTS INCURRED DUE TO DAMAGE SHALL BE THE SOLE RESPONSIBILITY OF THE CONTRACTOR. FORTY-EIGHT (48) HOURS BEFORE DIGGING CALL SUNSHINE, TOLL FREE 1-800-432-4770.
- 3. EXISTING UTILITY LOCATIONS SHOWN ON THESE PLANS ARE APPROXIMATE. THE ENGINEER ASSUMES NO RESPONSIBILITY FOR THE ACCURACY OF EXISITING UTILITIES SHOWN OR FOR ANY EXISTING UTILITIES NOT SHOWN. THE CONTRACTOR SHALL BE RESPONSIBLE FOR DAMAGE TO ANY EXISTING UTILITIES FOR WHICH HE FAILS TO REQUEST LOCATIONS FROM THE UTILITY OWNER. HE IS RESPONSIBLE AS WELL FOR DAMAGE TO ANY EXISTING UTILITIES WHICH ARE PROPERLY LOCATED.
- 4. IF UPON EXCAVATION, AN EXISTING UTILITY IS FOUND TO BE IN CONFLICT WITH THE PROPOSED CONSTRUCTION OR TO BE OF A SIZE OR MATERIAL DIFFERENT FROM THAT SHOWN ON THE PLANS, THE CONTRACTOR SHALL IMMEDIATELY NOTIFY THE ENGINEER.
- 5. INDIVIDUAL SHOP DRAWINGS FOR ALL PRECAST STRUCTURES ARE REQUIRED. THE ENGINEER IS TO REVIEW THEM AND BE PAID.
- 6. ALL INSPECTIONS WILL BE MADE BY THE ENGINEER OF RECORD AND BE PAID. CONTRACTOR SHALL NOTIFY 48 HOURS IN ADVANCE THE ENGINEER OF RECORDS FOR INSPECTION. THE ENGINEER SHOULD BE ABLE TO PROVIDE CERTIFICATION FOR CONSTRUCTION COMPLETION BASED ON VISUAL INSPECTIONS, IF REQUIRED.
- 7. ALL OPEN TRENCHES AND HOLES ADJACENT TO ROADWAYS OR WALKWAYS SHALL BE PROPERLY MARKED AND BARRICADED TO ASSURE THE SAFETY OF BOTH VEHICULAR
- 8. ALL FILL AND LIMEROCK BASE COURSE SHALL BE TESTED WITH DENSITY TESTS ACCORDING TO AASTHO SPECIFICATION T-180. COPIES OF RESULTS SHALL BE PROVIDED TO ENGINEER OF RECORDS PRIOR TO PLACING ASPHALT PAVEMENT.
- 9. UPON COMPLETION OF CONSTRUCTION, THE CONTRACTOR SHALL SUBMIT TO THE ENGINEER OF RECORD ONE COMPLETE SET OF AS-BUILT CONSTRUCTION DRAWINGS. THESE DRAWINGS SHALL BE MARKED TO SHOW AS-BUILT.
- 10. ALL AS-BUILT DRAWINGS SHALL BE SIGNED AND SEALED BY A FLORIDA REGISTERED LAND SURVEYOR.
- 11. NO MODIFICATIONS TO THESE PLANS ARE ALLOWED WITHOUT THE WRITTEN CONSENT OF THE ENGINEER. NO AGENCY INSPECTOR, CONTRACTOR, NOR THE OWNER ARE AUTHORIZED TO UNILATERALLY MODIFY THESE PLANS.
- 12. IT IS THE INTENT OF THE PLANS TO BE IN ACCORDANCE WITH APPLICABLE CODES AND AUTHORITIES HAVING JURISDICTION. ANY DISCREPANCIES BETWEEN THESE PLANS AND APPLICABLE CODES SHALL BE IMMEDIATELY BROUGHT TO THE ATTENTION OF THE
- 13. ALL DRIVING SURFACES MUST BE CONSTRUCTED ON AN EIGHT (8) INCH ROCK BASE THAT WILL PRODUCE A C.B.R. VALUE OF NO LESS THAN 25 WHEN COMPACTED TO A MINIMUM FIELD DENSITY OF 98% OF MAX. DENSITY AS DETERMINED BY AASTHO T-180. WITH REINFORCED CONCRETE SLAB. SEE STRUCTURAL PLANS FOR DETAILS.
- 14. ALL DIMENSIONS IN THESE PLANS SHALL BE VERIFIED BY THE CONTRACTOR IN THE FIELD.
- 15. ALL WORK SHALL MEET CITY OF HOLLYWOOD PUBLIC WORK DEPARTMENT STANDARDS.
- 16. WATER TABLE PER BROWARD COUNTY PLATE WC 2.2 IS 1.5 NAVD.
- 17. ALL ELEVATIONS SHOWN ARE REFERRED TO NORTH AMERICAN VERTICAL DATUM 1988
- 18. UNDERGROUND CONTRACTOR SHALL COMPLY WITH THE TRENCH SAFETY ACT HB 3183, FLORIDA STATUTES.
- 19. ALL MUCK, PEAT, AND/OR CLAY WITH HIGH PERCENTAGE OF ORGANIC MATERIAL AND OR EXISTING UNSUITABLE FILL MATERIAL SHALL BE REMOVED FROM PROPOSED RIGHT OF WAY OR PROPOSED PAVEMENT AREAS IF ANY.
- 20. ALL TOP FINISHED GRADES FOR EXISTING MANHOLES, VALVE LIDS AND SIMILAR UTILITIES STRUCTURES SHALL BE ADJUSTED TO NEW FINISHED GRADES, IF AFFECTED FOR NEW GRADING.
- 21. THESE PLANS WERE PREPARED USING INFORMATION FROM SURVEY DONE BY NOSTER,
- 22. FLOOD INSURANCE RATE MAP, ZONE 'X NEW FLOOD PANEL 12011C0569H, MAP 08/18/2014.
- 23. SHOWN INFORMATION FOR EXISTING UTILITIES AS IT WAS RECEIVED BY UTILITIES OWNERS UNDER CHAPTER 556, FLORIDA STATUTES.
- 24. DRAINAGE PIPING HIGH DENSITY POLYETHYLENE SHALL CONFORM ASTM F477, AASHTO M294, M252 REQUIREMENTS.

PAVING, GRADING & DRAINAGE PLANS FOR PARKSIDE VUE 1807-1809 MADISON ST. HOLLYWOOD, FL

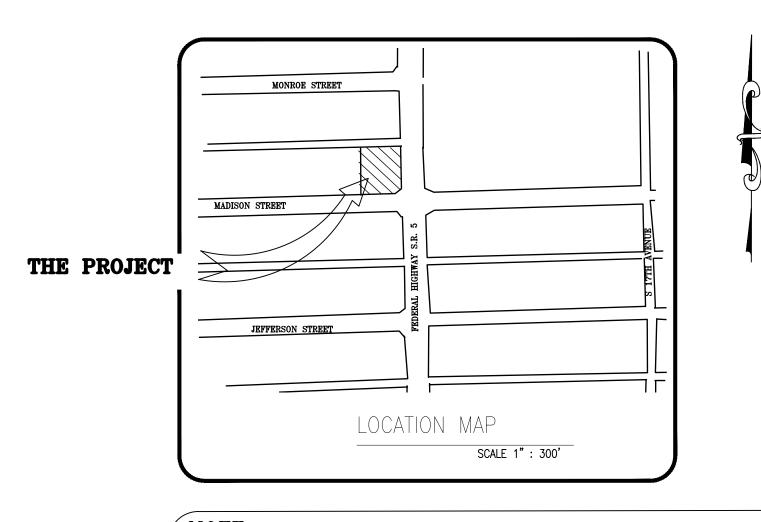

ALL ELEVATIONS SHOWN HERE ON ARE REFERENCED TO NORTH AMERICAN VERTICAL DATUM (1988)

LEGAL DESCRIPTION:

LOT 13, IN BOCK 36, OF TOWN OF HOLLYWOOD, ACCORDING TO THE PLAT THEREOF, AS RECORDED IN PLAT BOOK 1, AT PAGE 21, OF THE PUBLIC RECORDS OF BROWARD COUNTY, FLORIDA AND

LOT 14 AND 15, LESS THE EAST 15 FEET THEREOF, AND ALSO LESS SO MUCH THEREOF INCLUDED IN THE EXTERNAL AREA FORMED BY A 15 FOOT RADIUS ARC WHICH IS TANGENT TO THE SOUTH LINE TO ALINE WITCH IS 15 FEET WEST OF AND PARALLEL TO THE EAST LINE OF SAID LOT 15, IN BLOCK 36, OF TOWN OF HOLLYWOOD, ACCORDING TO THE PLAT THEREOF, AS RECORDED IN PLAT BOOK 1, AT PAGE 21. OF THE PUBLIC RECORDS OF BROWARD COUNTY FLORIDA




FOLIO # 51-4215-017-110

SEC. 15-51-42

INDEX: COVER SHEET PAVING, GRADING & DRAINAGE PLAN MARKING & SIGNING-DRAINAGE DETAILS SEDIMENT & EROSION CONTROL PLAN PAVING & DRAINAGE DETAILS

> PAVEMENT MARKINGS & SIGN PLANS AT SECOND & THIRD FLOORS

> > THIS ITEM HAS BEEN DIGITALLY SIGNED AND SEALED BY MARVIN J. ABARCA, P.E. ON THE DATE ADJACENT TO THE SEAL. PRINTED COPIES OF THIS DOCUMENT ARE NOT CONSIDERED SIGNED AND SEALED AND THE SIGNATURE MUST BE VERIFIED ON ANY ELECTRONIC COPIES.

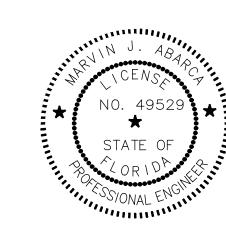

MARVIN J. ABARCA P.E. No. 49529

DATE: 03-10-2023 PROJ.: P23-0309-04

PARKSIDE COVER

SHEET

VUE

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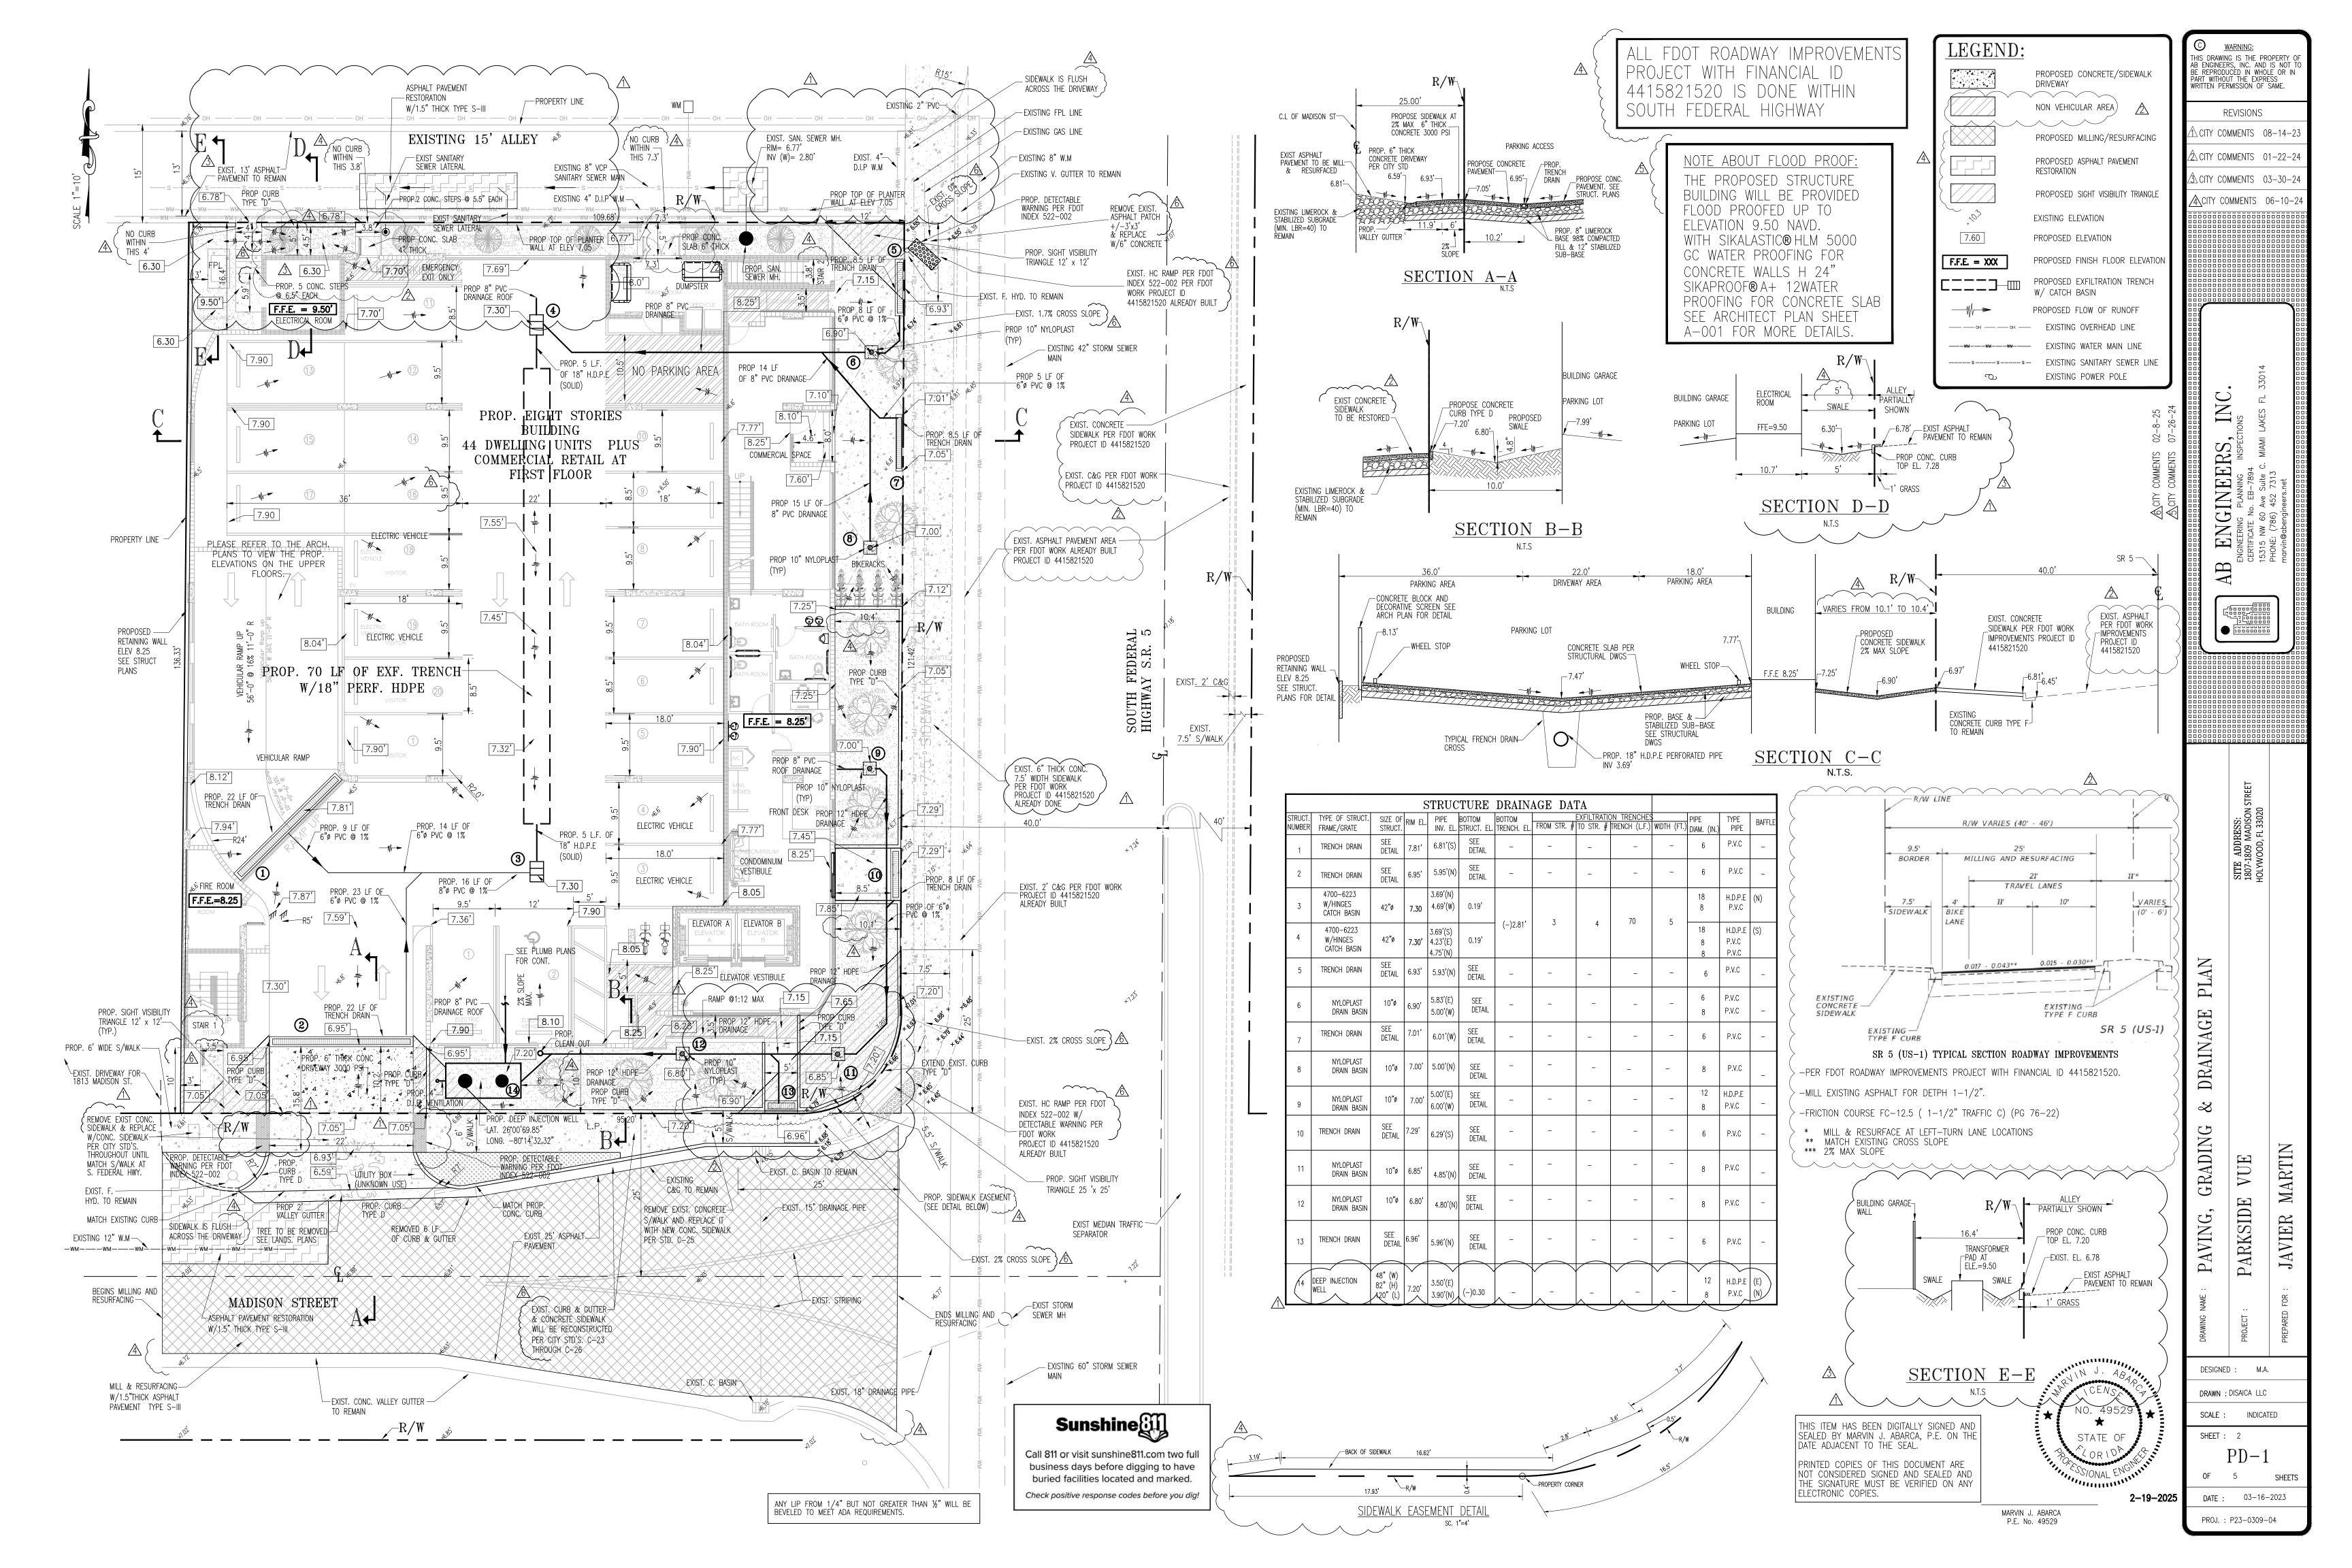
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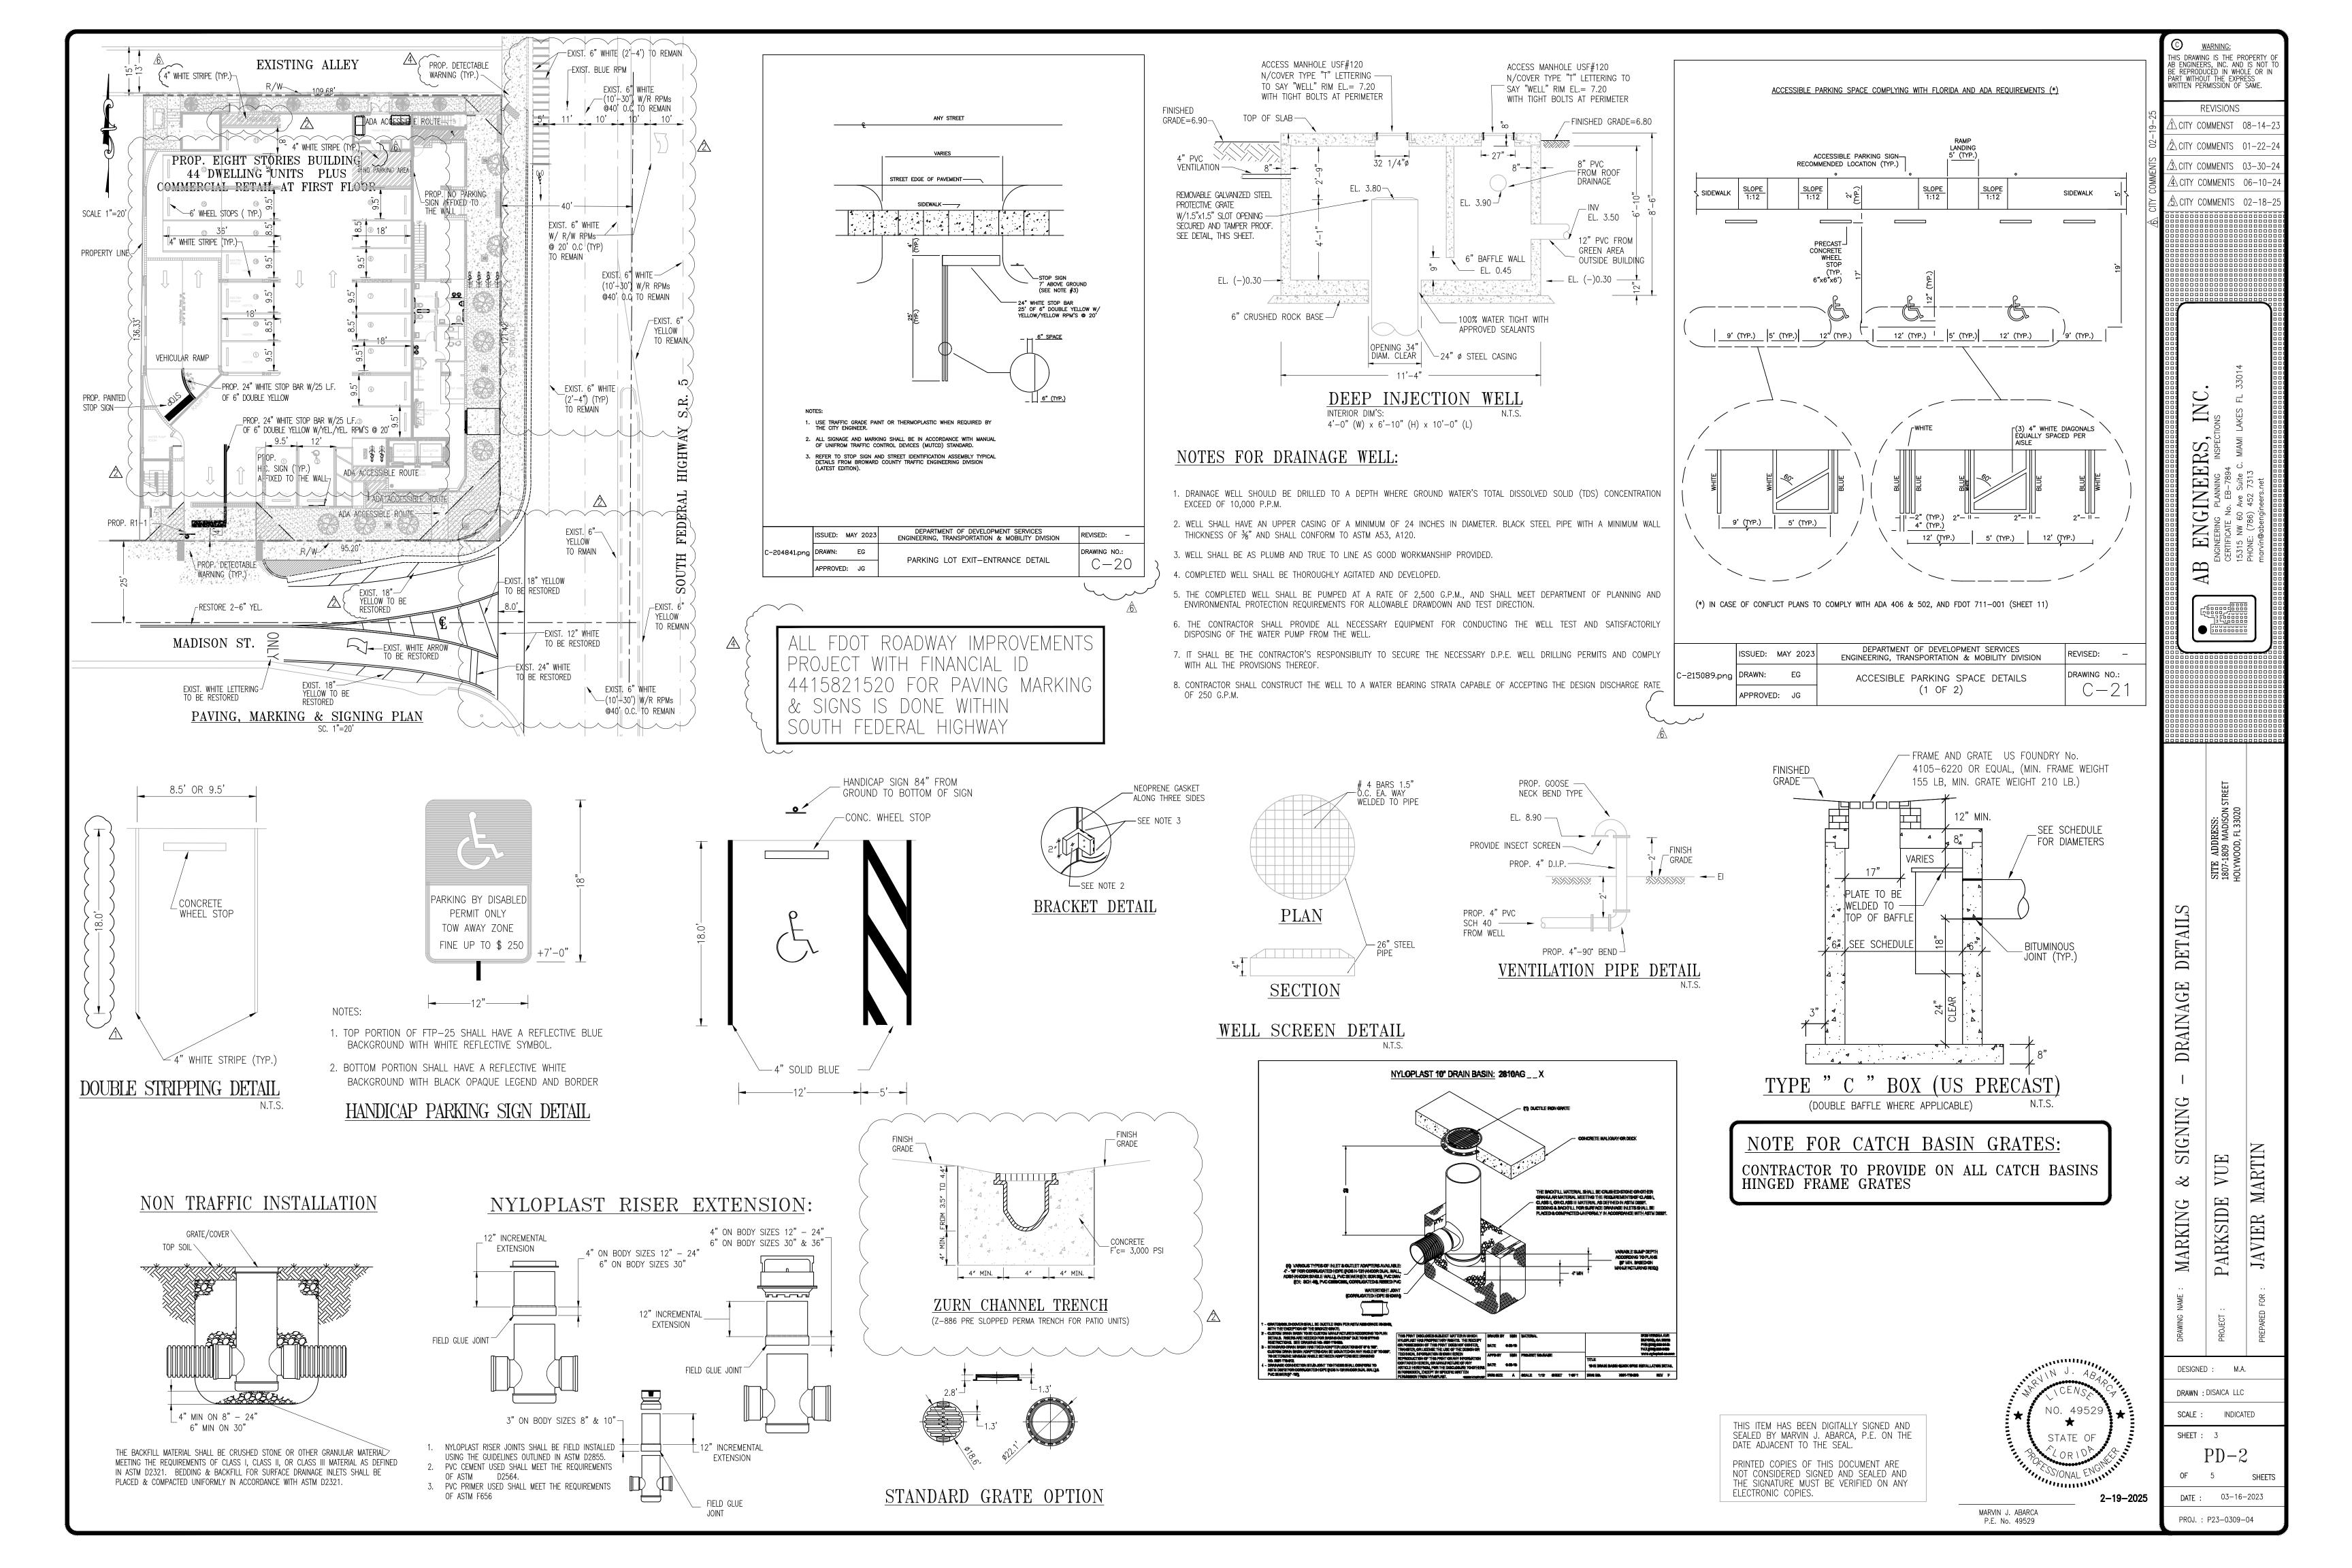
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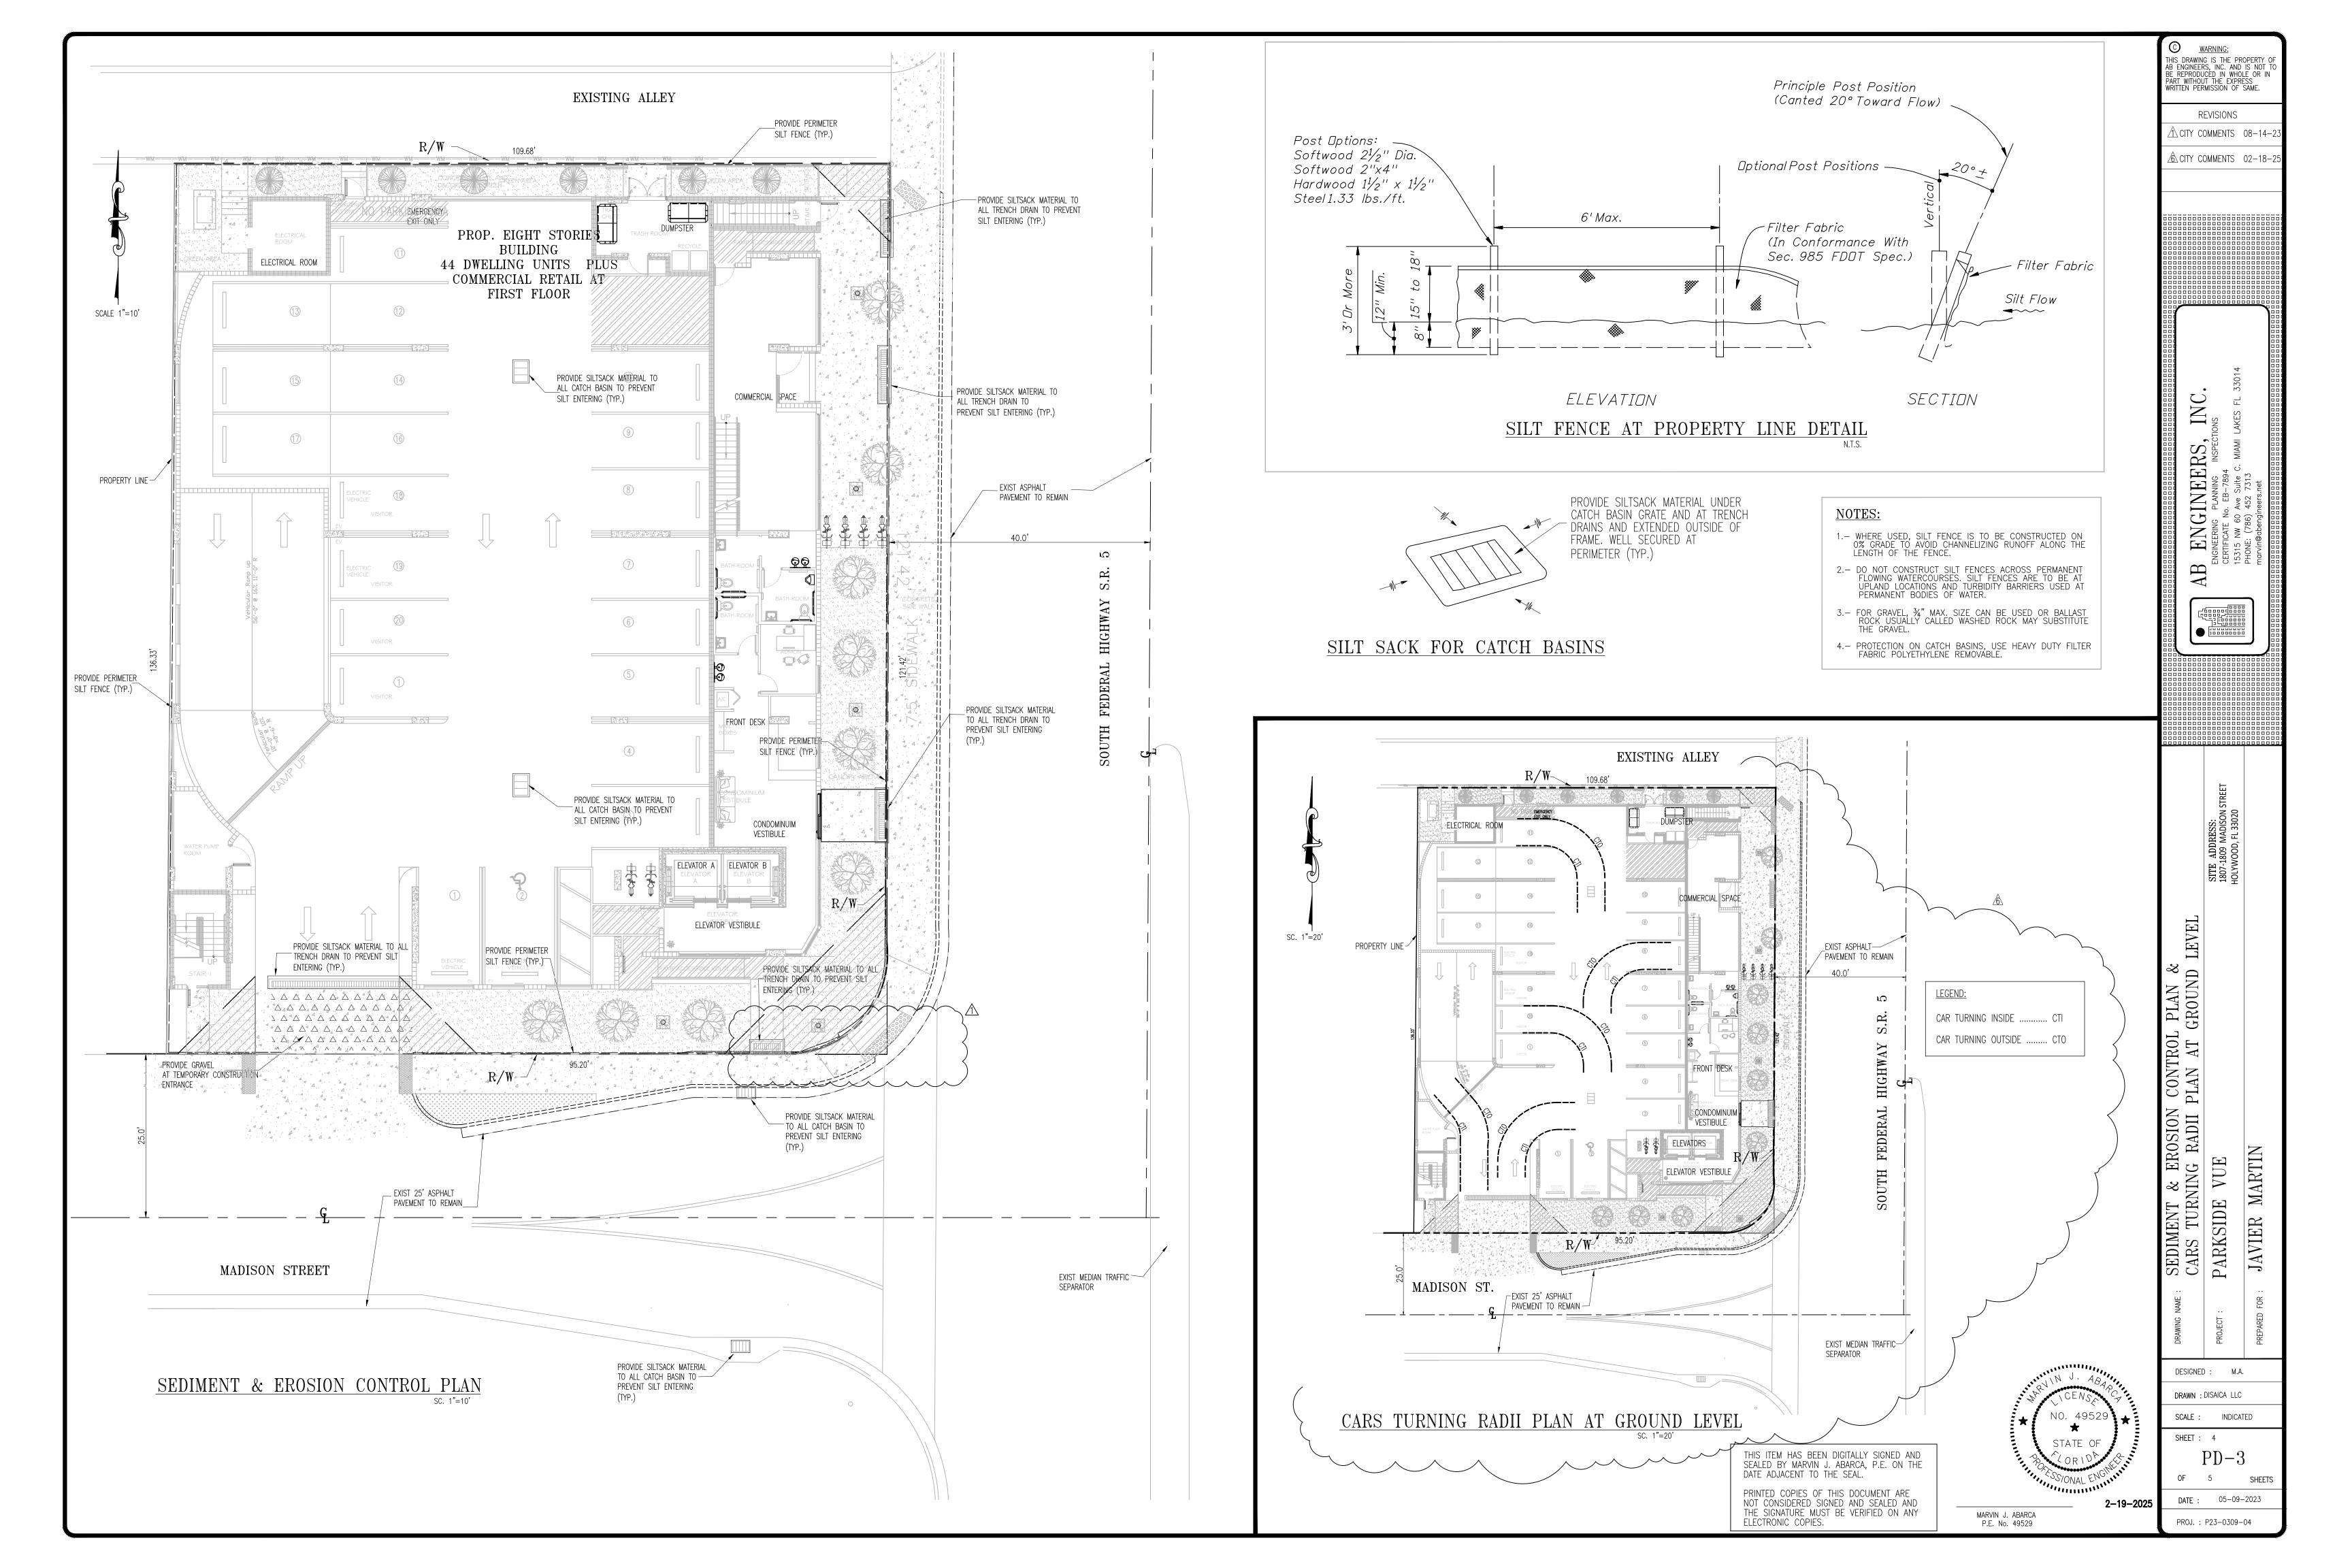
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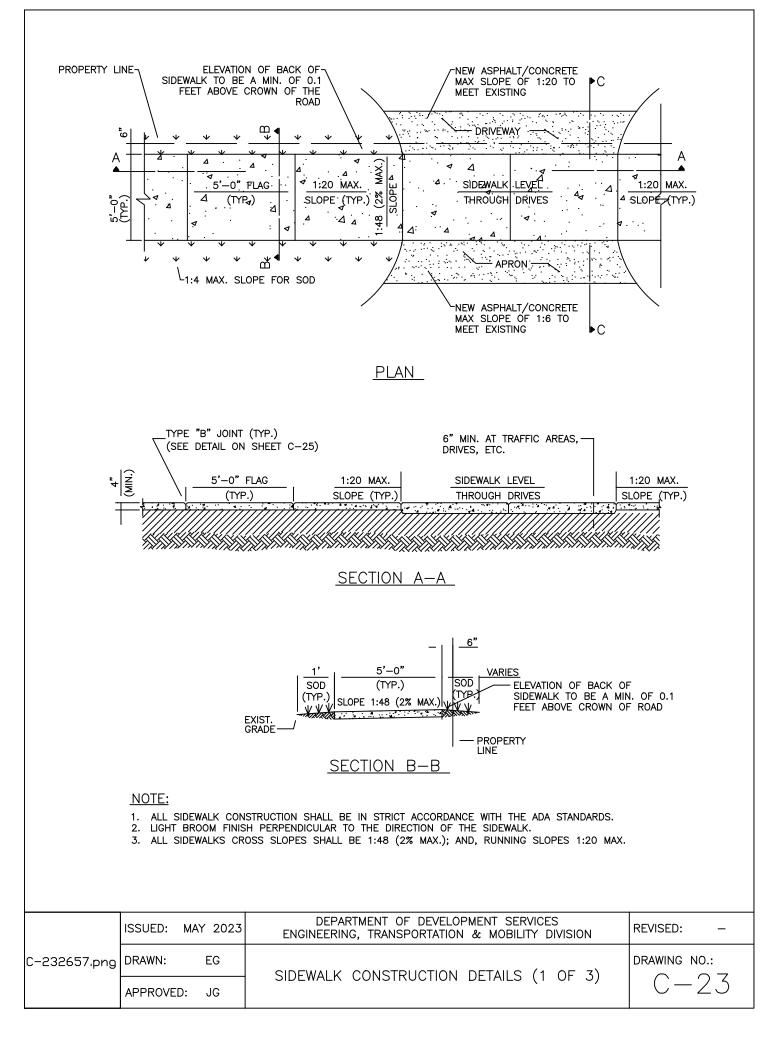
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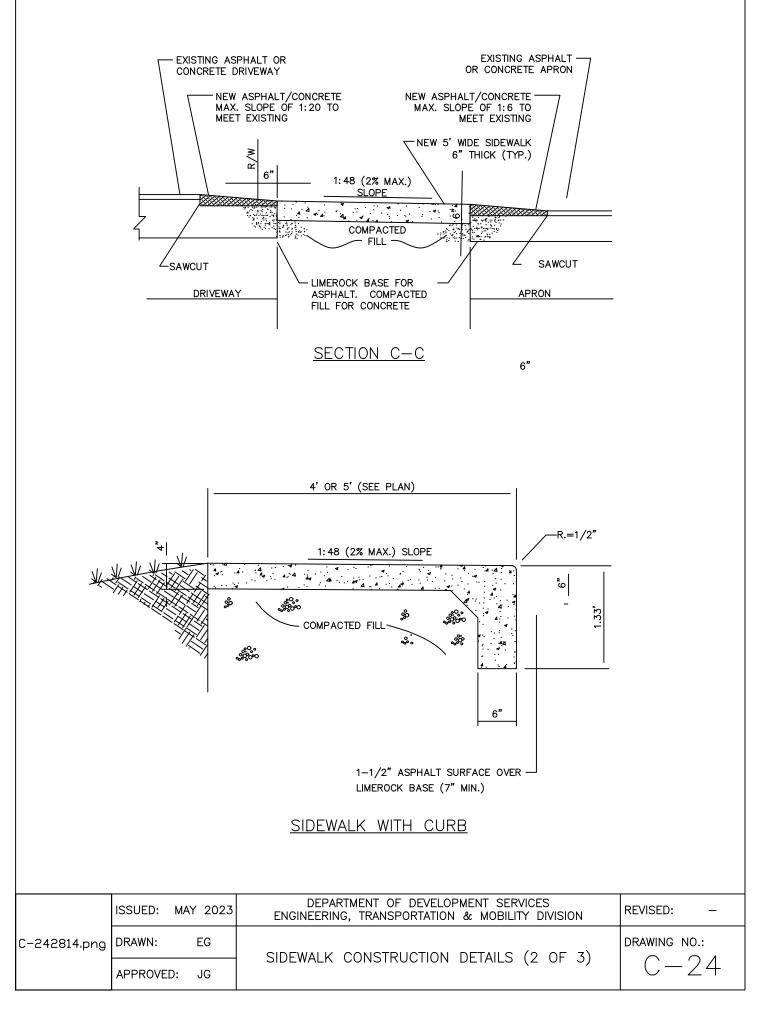
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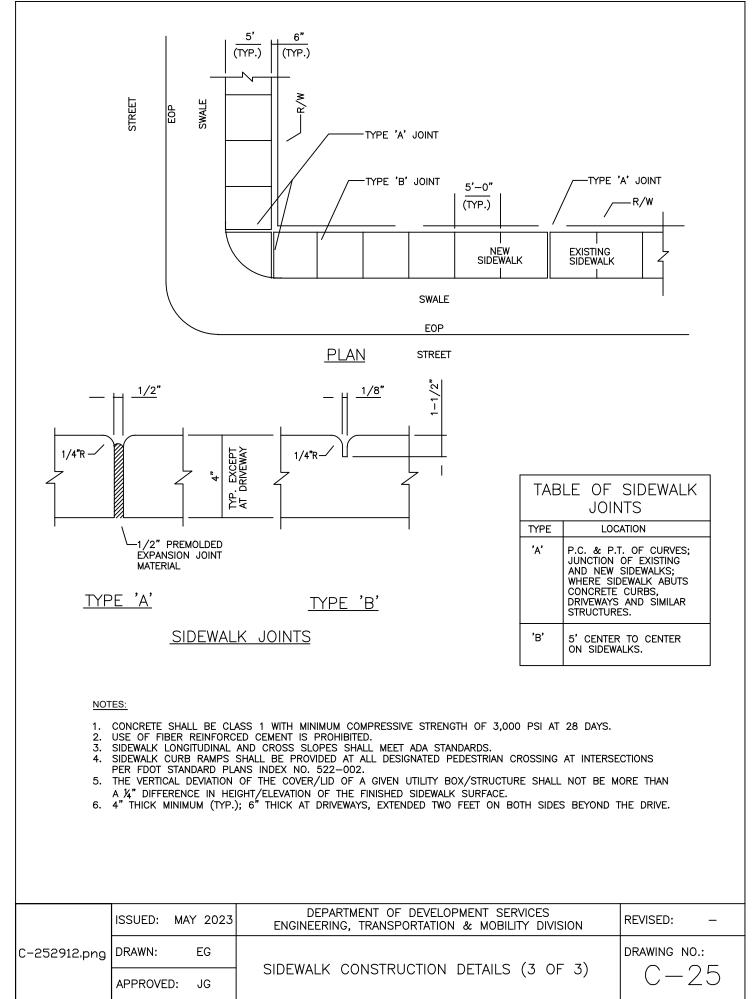















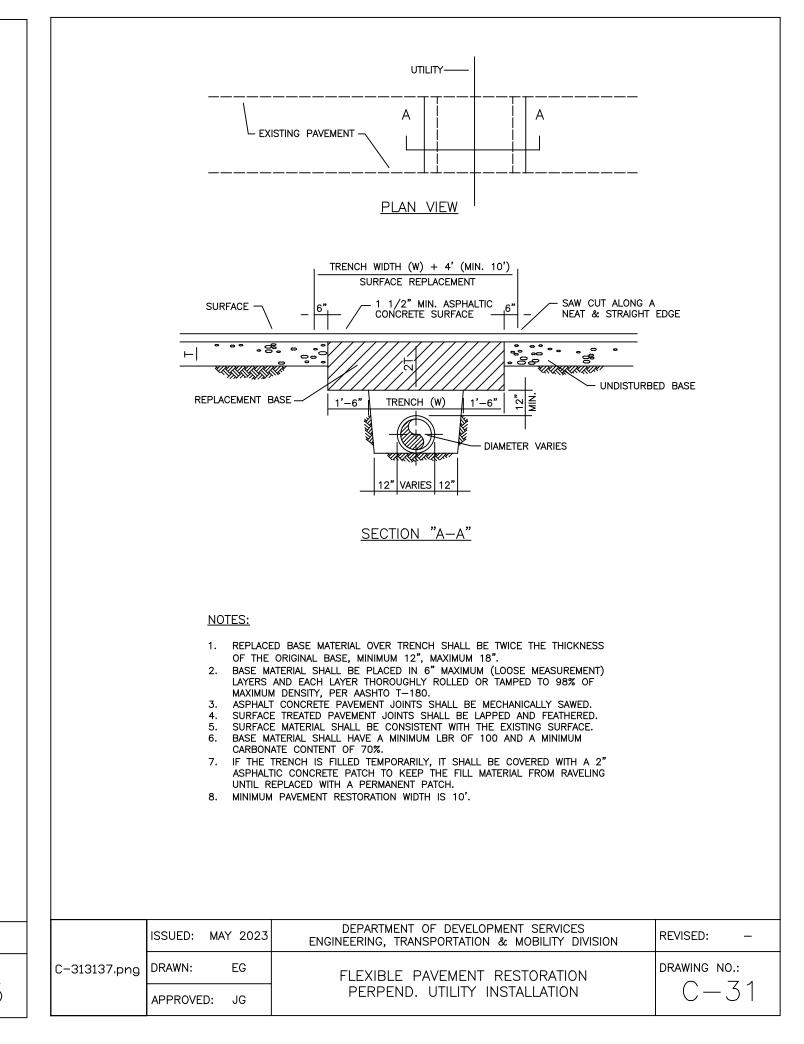

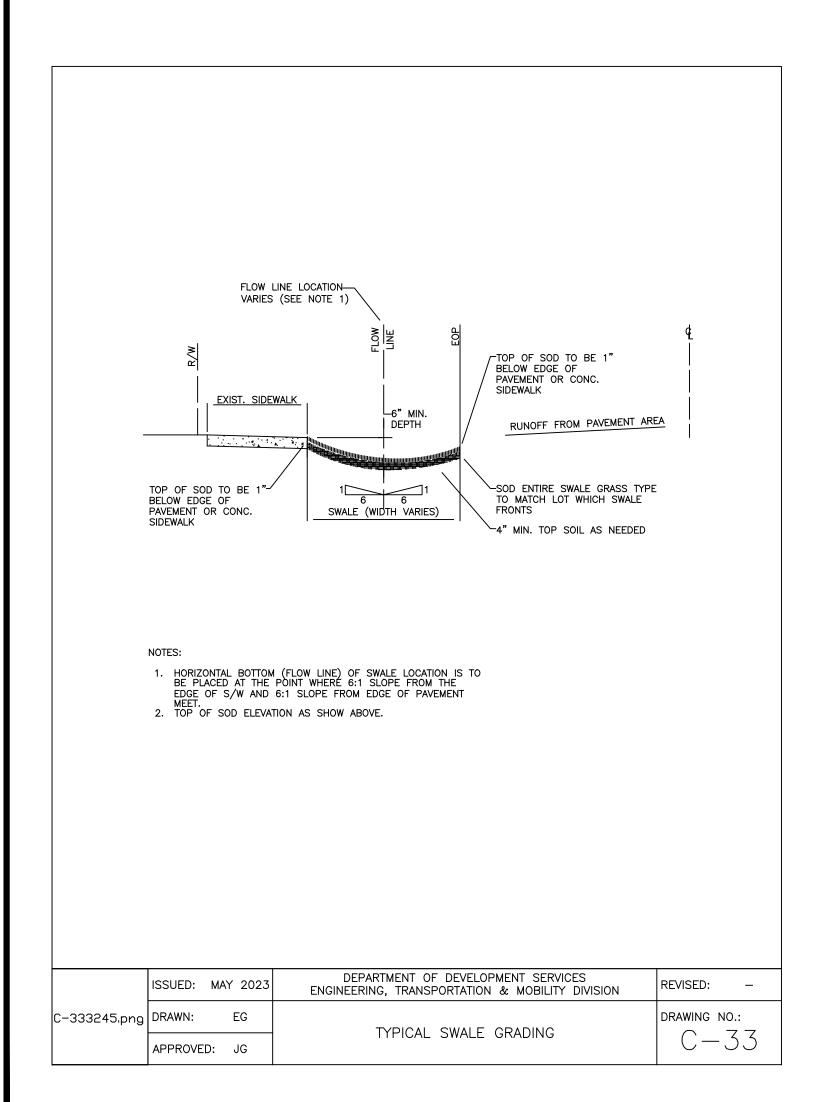

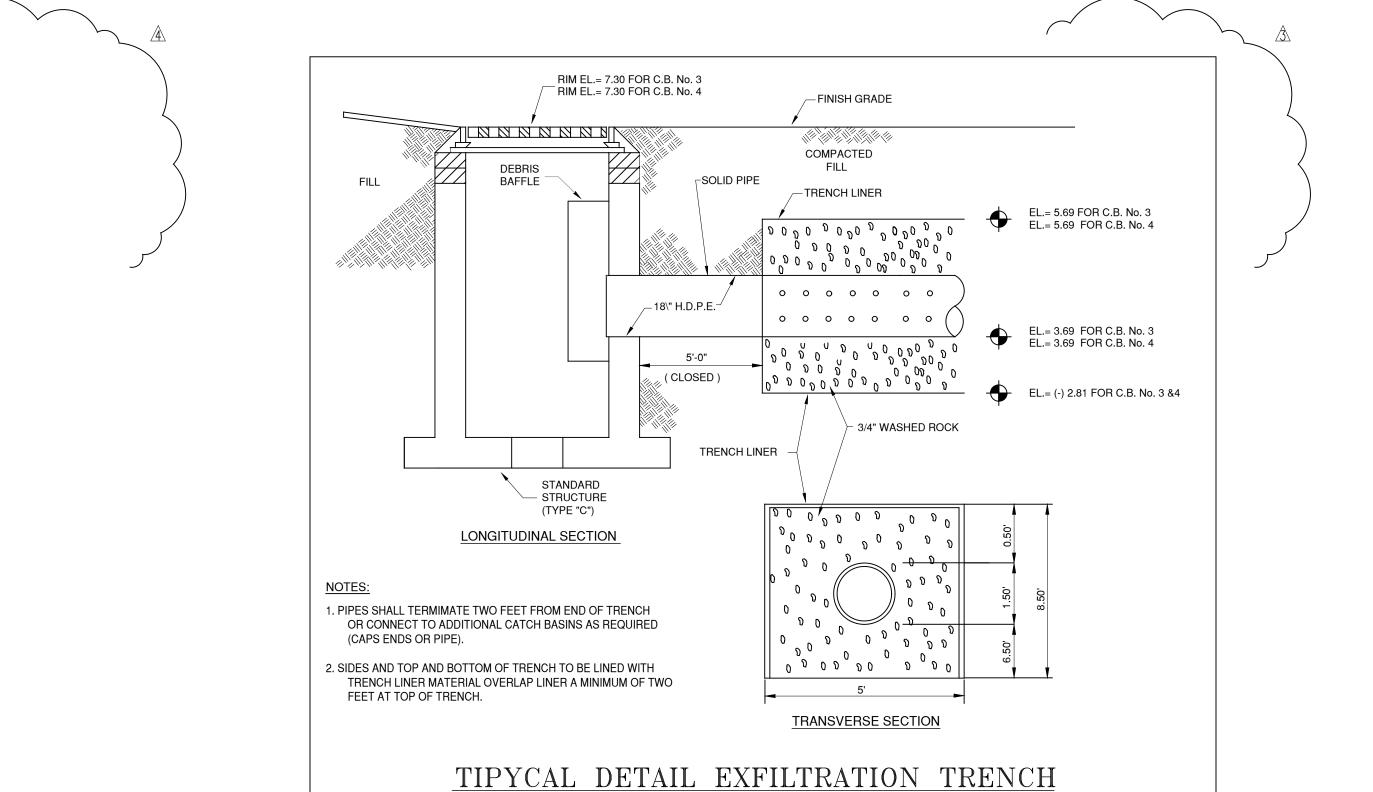

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NO. 49529

STATE OF

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MARVIN J. ABARCA

P.E. No. 49529

DESIGNED: M.A.

DRAWN: DISAICA LLC

SCALE: INDICATED

PD-4

OF 5

SHEETS

DATE: 08-14-2023

PROJ.: P23-0309-04

DETAILS

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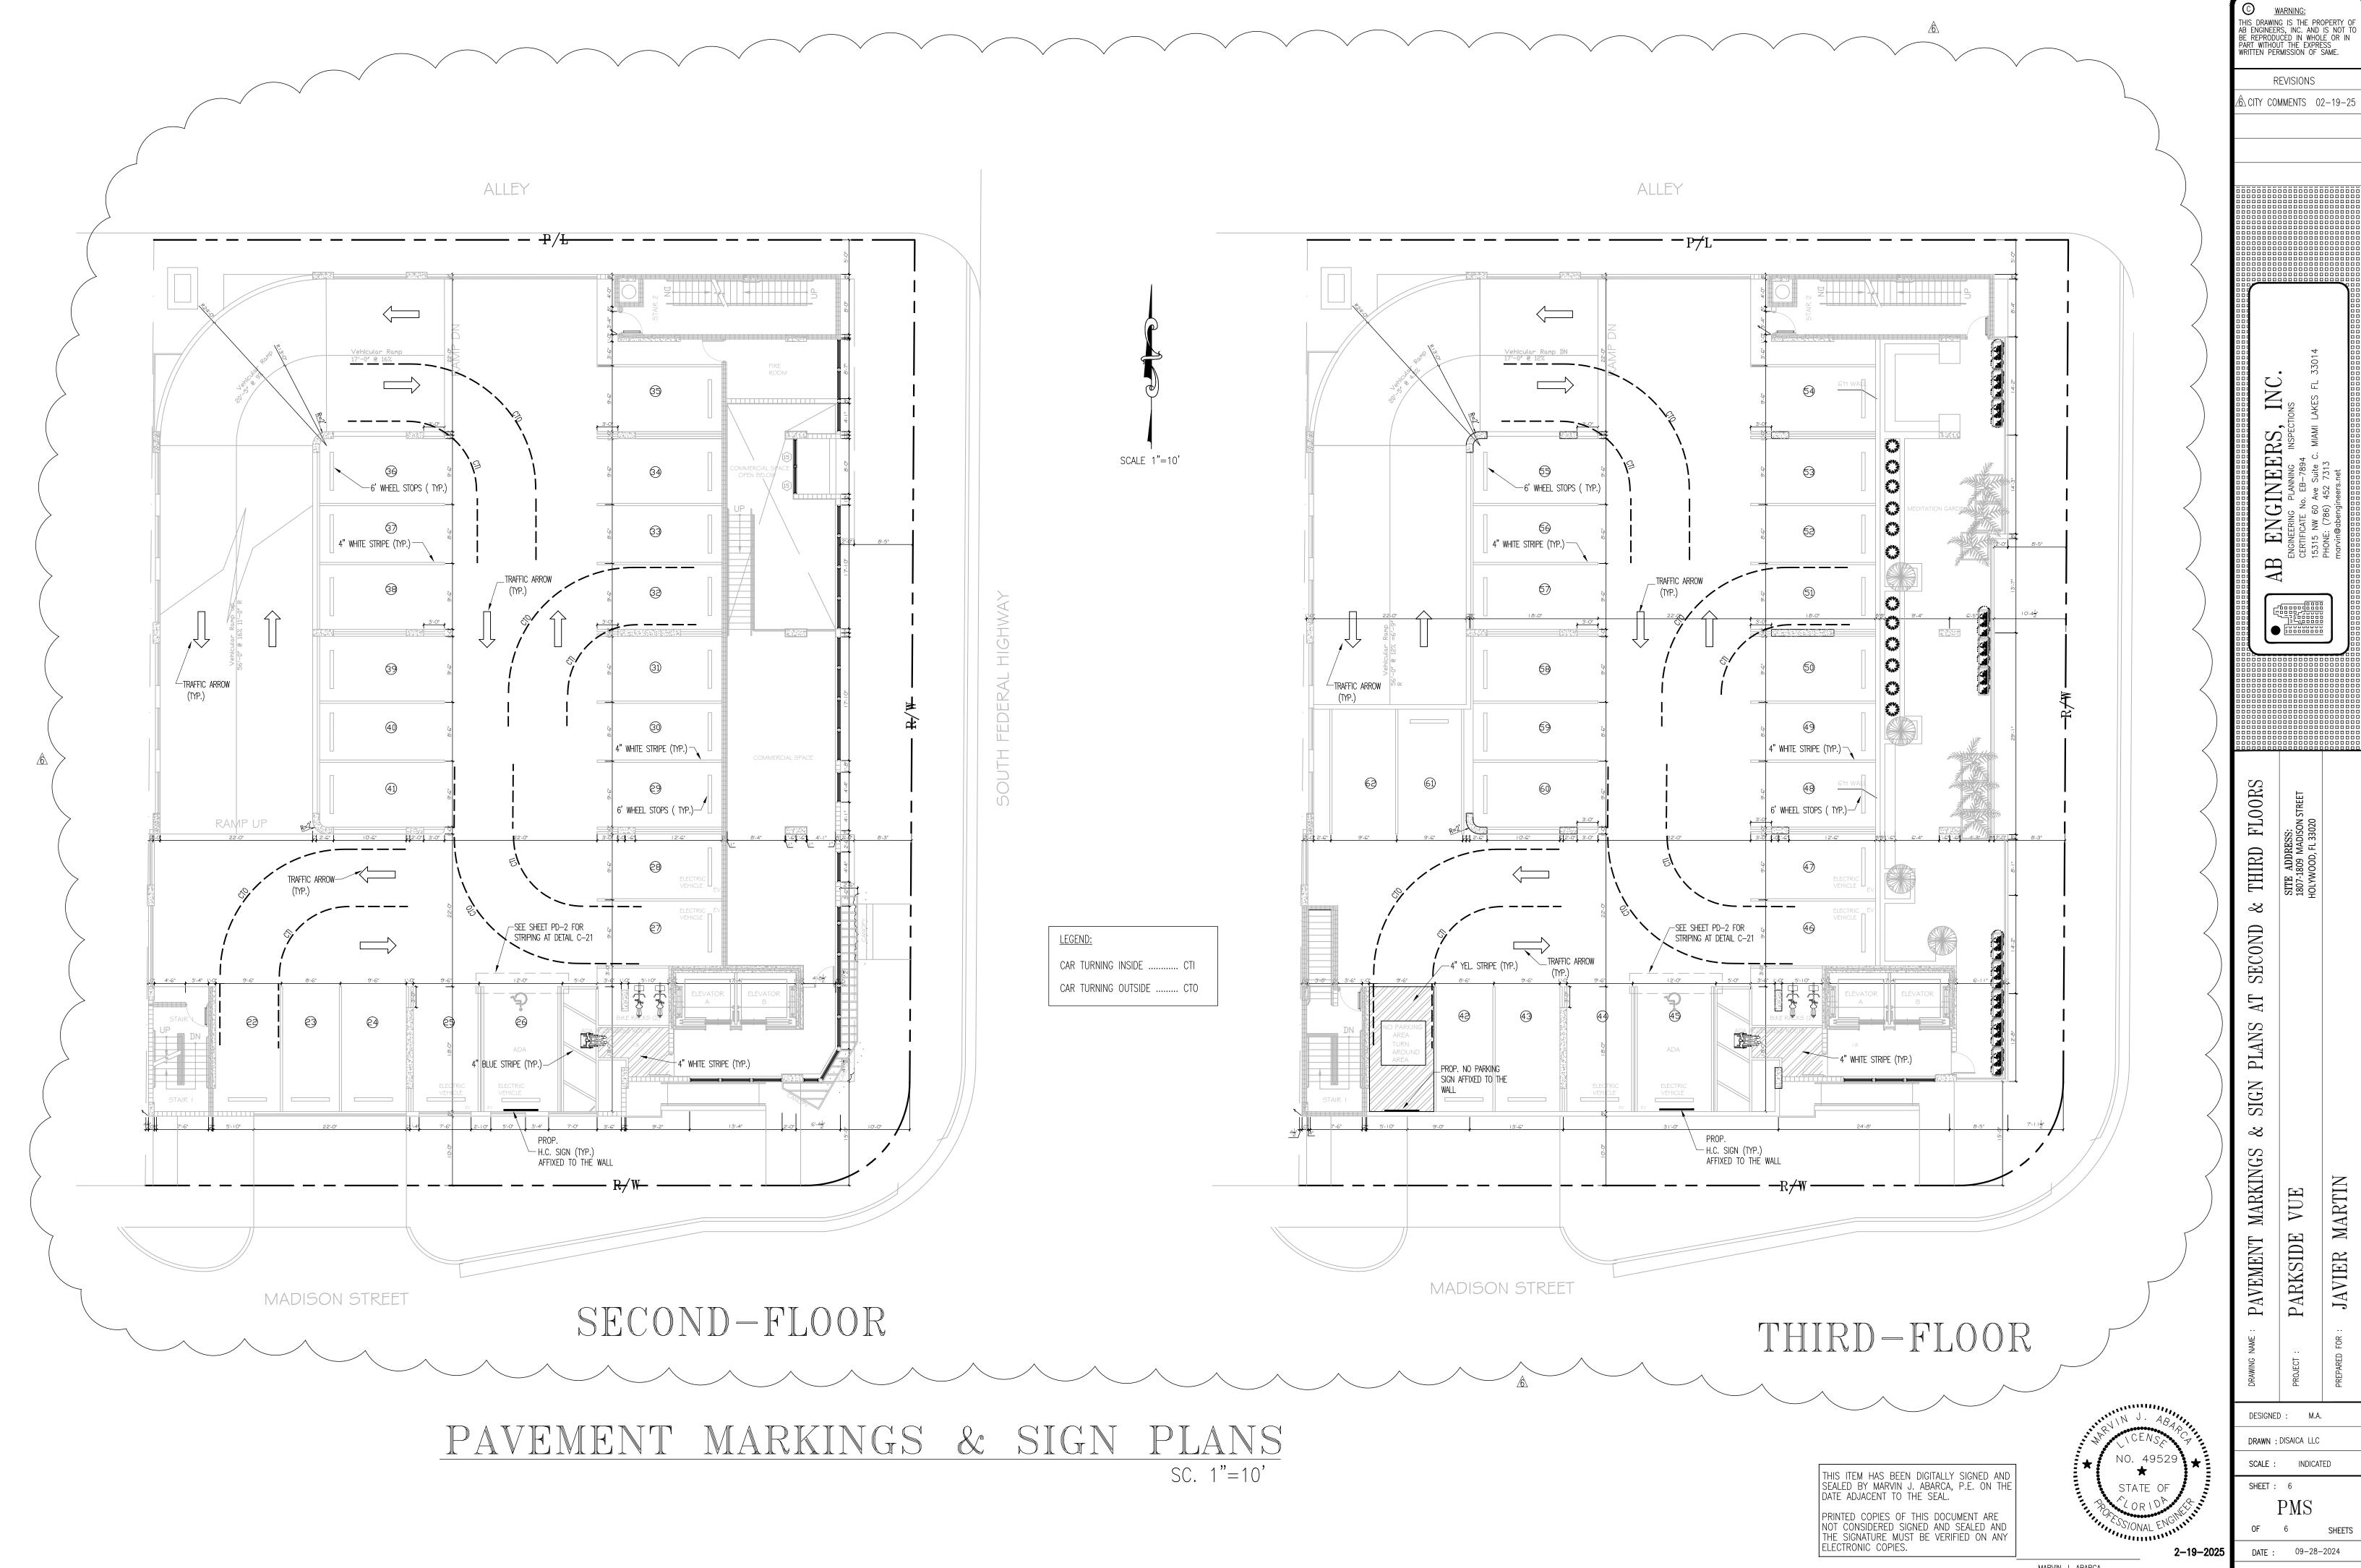
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③ CITY COMMENTS 03-30-2

 \triangle CITY COMMENTS 06-10-2

ENGINEERS



MARVIN J. ABARCA P.E. No. 49529

WATER & SEWER SERVICE CONNECTION PLAN FOR PARKSIDE VUE 1807-1809 MADISON ST. HOLLYWOOD, FL

MONROE STREET MADISON STREET THE PROJECT JEFFERSON STREET LOCATION MAP SCALE 1": 300'

LEGAL DESCRIPTION:

LOT 13, IN BOCK 36, OF TOWN OF HOLLYWOOD, ACCORDING TO THE PLAT THEREOF, AS RECORDED IN PLAT BOOK 1, AT PAGE 21, OF THE PUBLIC RECORDS OF BROWARD COUNTY, FLORIDA AND

GEODETIC VERTICAL DATUM OF 1929 (NGVD)

ALL ELEVATIONS SHOWN HERE ON ARE REFERENCED TO NATIONAL

PARCEL 3: LOT 14 AND 15, LESS THE EAST 15 FEET THEREOF, AND ALSO LESS SO MUCH THEREOF INCLUDED IN THE EXTERNAL AREA FORMED BY A 15 FOOT RADIUS ARC WHICH IS TANGENT TO THE SOUTH LINE TO ALINE WITCH IS 15 FEET WEST OF AND PARALLEL TO THE EAST LINE OF SAID LOT 15, IN BLOCK 36, OF TOWN OF HOLLYWOOD, ACCORDING TO THE PLAT THEREOF, AS RECORDED IN PLAT BOOK 1, AT PAGE 21. OF THE PUBLIC RECORDS OF BROWARD COUNTY FLORIDA

ENGINEERING NOTES

1. IF DISCREPANCIES FOUND ON THESE PLANS OR BETWEEN THESE PLANS AND ACTUAL FIELD CONDITIONS OR ANY OMISSIONS OR ERRORS THAT MIGHT PRODUCE DAMAGES DERIVED FROM THIS DESIGN, I SHALL BE BROUGHT TO THE ENGINEER PRIOR TO BIDDING OR START OF ANY CONSTRUCTION.

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REVISIONS

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- 2. IT IS THE OBLIGATION OF THE BIDDER OR THE CONTRACTOR TO MAKE HIS OWN INVESTIGATION AND SATISFY HIMSELF FULLY OF THE SUB-SURFACE CONDITIONS PRIOR TO SUBMITTING HIS BID. FAILURE TO DO SO WILL RELIEVE HIM OF HIS OBLIGATION TO COMPLETE THE WORK FULLY AND ACCEPTABLE TO THE ENGINEER AND THE OWNER FOR THE CONSIDERATION SET FORTH IN HIS BID.
- 3. CONTRACTOR, PRIOR TO START OF ANY CONSTRUCTION, SHALL VERIFY LOCATION OF ALL EXISTING UTILITIES ON THE FIELD WITH THE APPROPRIATE UTILITY COMPANY. IN THE EVENT THAT ANY ADJUSTMENT BE NECESSARY DUE TO A DISCREPANCY FOR UTILITY LOCATION, THE CONTRACTOR SHALL NOTIFY THE ENGINEER 48 HOURS BEFORE PROCEEDING. CONTRACTOR SHALL EXERT CARE AND CAUTION IN PROTECTING ALL UTILITIES DURING THE COMPLETION OF HIS WORK. IN THE EVENT OF ANY DAMAGE THE CONTRACTOR SHALL IMMEDIATELY NOTIFY THE APPROPRIATE UTILITY COMPANY, ANY AND ALL COSTS INCURRED DUE TO DAMAGE SHALL BE SOLE RESPONSIBILITY OF THE CONTRACTOR. FORTY-EIGHT (48) HOURS BEFORE DIGGING CALL SUNSHINE, TOLL FREE 1-800-432-4770.
- 4. EXISTING UTILITY LOCATIONS SHOWN ON THESE PLANS ARE APPROXIMATE. THE ENGINEER ASSUMES NO RESPONSIBILITY FOR THE ACCURACY OF EXISTING UTILITIES SHOWN OR FOR ANY EXISITING UTILITIES NOT SHOWN. THE CONTRACTOR SHALL BE RESPONSIBLE FOR DAMAGE TO ANY EXISTING UTILITIES FOR WHICH HE FAILS TO REQUEST LOCATIONS FROM THE UTILITY OWNER. HE IS REPONSIBLE AS WELL FOR DAMAGE TO ANY EXISTING UTILITIES WHICH ARE PROPERLY
- 5. IF UPON EXCAVATION, AN EXISTING UTILITY IS FOUND TO BE IN CONFLICT WITH THE PROPOSED CONSTRUCTION OR TO BE OF A SIZE OR MATERIAL DIFFERENT FROM THAT SHOWN ON THE PLANS, THE CONTRACTOR SHALL IMMEDIATELY NOTIFY THE ENGINEER.
- 6. INDIVIDUAL SHOP DRAWINGS FOR ALL PRECAST STRUCTURE ARE REQUIRED. THE ENGINEER IS TO REVIEW THEM AND BE PAID.
- 7. ALL INSPECTIONS WILL BE MADE BY THE ENGINEER OF RECORD AND
- 8. ALL OPEN TRENCHES AND HOLES ADJACENT TO ROADWAYS OR WALKWAYS SHALL BE PROPERLY MARKED AND BARRICADED TO ASSURE THE SAFETY OF BOTH VEHICULAR AND PEDESTRIAN TRAFFIC.
- 9. ALL REQUIRED DENSITY AND LBR TEST RESULTS FOR LIMEROCK SHALL BE PROVIDED TO THE ENGINEER AND CITY ENGINEER PRIOR TO PLACING ASPHALT.
- 10. UPON COMPLETION OF CONSTRUCTION, THE CONTRACTOR SHALL SUBMIT TO THE ENGINEER OF RECORD ONE COMPLETE SET OF AS-BUILT CONSTRUCTION DRAWINGS. THESE DRAWINGS SHALL BE MARKED TO SHOW AS-BUILT.
- 11. ALL AS-BUILT DRAWINGS SHALL BE SIGNED AND SEALED BY A FLORIDA REGISTERED LAND SURVEYOR.
- 12. NO MODIFICATIONS TO THESE PLANS ARE ALLOWED WITHOUT THE WRITTEN CONSENT OF THE ENGINEER. NO AGENCY INSPECTOR, CONTRACTOR, NOR THE OWNER ARE AUTHORIZED TO UNILATERALLY MODIFY THESE PLANS.
- 13. ALL WORK SHALL MEET CITY OF HOLLYWOOD COUNTY STANDARDS AND
- 14. CONTRACTOR SHALL NOTIFY 48 HOURS IN ADVANCE THE ENGINEER OF RECORDS FOR INSPECTION. THE ENGINEER SHOULD BE ABLE TO PROVIDE CERTIFICATION FOR CONSTRUCTION COMPLETION BASED ON VISUAL INSPECTIONS, IF REQUIRED AND BE PART OF ENGINEER'S CONTRACT WITH OWNER OR DEVELOPER.
- 15. THESE PLANS WERE PREPARED USING INFORMATION FROM SURVEY DONE BY NOSTER LLC

NOTE FOR FIRE MAIN WORK

ALL UNDERGROUND FIRE MAIN WORK MUST BE COMPLETED BY FIRE PROTECTION CONTRACTOR HOLDING A CLASS I, II, OR V LICENSE PER FS 633.102.

FIRE FLOW CALCULATIONS

NEW MIXED USE Federal Highway Medium-High Intensity FH-2 AN EIGHT (8) STORY MIXED USE BUILDING Property Address: 1807 MADISON ST., HOLLYWOOD 1809 MADISON ST., HOLLYWOOD

ENTIRE BUILDING IS NON-COMBUSTIBLE CONSTRUCTION.

FIRE FLOW AREA=22,503 S.F.

FOOTAGE OF THE THREE LARGEST FLOORS, WHICH IS 22,503 SQUARE FEET.

FOR 2 HOURS.

1,500 GPM X 75%= 1,125 GPM (FIRE FLOW CREDIT)

THE MINIMUM FIRE FLOW PER NFPA 18.4.5.3.2 IS 1,000 GPM

FIRE FLOW REQUIRED = 1,000 GPM

THESE CALCULATIONS ARE FOR AN EIGHT (8) STORY MIXED USE BUILDING, WITH A TOTAL GROUND FLOOR SQUARE OF 2,756 S.F. THE

BASED ON TYPE II (2220 CONSTRUCTION. PER NFPA 18.4.4.1 FIRE FLOW AREA, THE FIRE FLOW AREA IS BASED ON THE TOTAL SQUARE

PER TABLE 18.4.5.2.1, THE FIRE FLOW REQUIREMENT IS 1,500 GPM

NFPA 18.4.5.3.2 STATES THAT THE REQUIRED FIRE FLOW CAN BE REDUCED BY 75% IF THE BUILDING HAS AUTOMATIC SPRINKLERS.

1,500 GPM - 1,125 GPM = 375 GPM

INDEX:

WATER & SEWER PLAN


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2-19-202

DATE: 03-10-2023 PROJ.: P23-0309-04

VUE

PARKSIDE

DESIGNED: MARVIN ABARCA

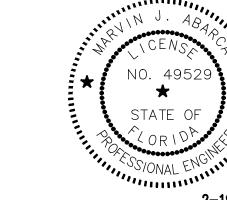DRAWN : DISAICA LLC

SHEET :

SCALE: INDICATED

SHEETS

SHEET

COVER

MARVIN J. ABARCA P.E. No. 49529

39. CONTRACTOR SHALL BE RESPONSIBLE FOR PROVIDING DEWATERING PER SPECIFICATION SECTION 02140

HOURS IN ADVANCE OF TRAFFIC DETOUR IN ACCORDANCE WITH SECTION 336.07 OF FLORIDA STATUTES.

GENERAL NOTES:

 THE INFORMATION PROVIDED IN THESE DRAWINGS IS SOLELY TO ASSIST THE CONTRACTOR IN ASSESSING THE NATURE AND EXTENT OF CONDITIONS WHICH WILL BE ENCOUNTERED DURING THE COURSE OF THE

2. ALL CONSTRUCTION AND MATERIALS SHALL CONFORM TO APPLICABLE STANDARDS AND SPECIFICATIONS

OF THE CITY OF HOLLYWOOD DEPARTMENT OF PUBLIC UTILITIES, ENGINEERING AND CONSTRUCTION

SERVICES DIVISION (ECSD), AND ALL OTHER LOCAL, STATE AND NATIONAL CODES, WHERE APPLICABLE.

TIME OF THE PREPARATION OF THESE PLANS; AND DO NOT PURPORT TO BE ABSOLUTELY CORRECT. ALSO, THERE MAY HAVE BEEN OTHER IMPROVEMENTS, UTILITIES, ETC., WITHIN THE PROJECT AREA WHICH WERE

3. LOCATIONS, ELEVATIONS, SIZES, MATERIALS, ALIGNMENTS, AND DIMENSIONS OF EXISTING FACILITIES, UTILITIES AND OTHER FEATURES ARE SHOWN ACCORDING TO THE BEST INFORMATION AVAILABLE AT THE

CONSTRUCTED AFTER THE PREPARATION OF THESE PLANS AND/OR THE ORIGINAL SITE SURVEY. THE

AVOID CONFLICT WITH EXISTING UTILITIES (NO ADDITIONAL COST SHALL BE PAID FOR THIS WORK).

4. THE CONTRACTOR SHALL COORDINATE WITH ALL UTILITIES TO ARRANGE FOR THE RELOCATION AND

TEMPORARY SUPPORT OF UTILITY FEATURES, ETC. AS NECESSARY TO COMPLETE THE WORK

DURING CONSTRUCTION UNLESS APPROVED OTHERWISE BY THE UTILITY OWNER.

5. IT SHALL BE THE CONTRACTOR'S RESPONSIBILITY TO LOCATE AND PROTECT ANY AND ALL EXISTING

CONTRACTOR SHALL ADJUST ALL EXISTING UTILITY CASTINGS INCLUDING VALVE BOXES, MANHOLES.

7. THE CONTRACTOR IS REQUIRED TO OBTAIN ALL APPLICABLE CONSTRUCTION AND ENVIRONMENTAL

THE CONTRACTOR SHALL NOTIFY ECSD AT LEAST 48 HOURS PRIOR TO BEGINNING CONSTRUCTION.

9. PRIOR TO THE COMMENCEMENT OF CONSTRUCTION AND INSTALLATION OF THE PROPOSED

10. THE CONTRACTOR SHALL NOTIFY ECSD IMMEDIATELY FOR ANY CONFLICT ARISING DURING

CONSTRUCTION OF ANY IMPROVEMENTS SHOWN ON THESE DRAWINGS. THIS WORK BY THE

11. ELEVATIONS SHOWN ARE IN FEET AND ARE REFERENCED TO THE NORTH AMERICAN VERTICAL DATUM OF

13. CONTRACTOR SHALL HAUL AWAY EXCESSIVE STOCKPILE OF SOIL FOR DISPOSAL EVERY DAY. NO STOCKPILE

14. CONTRACTOR SHALL CLEAN / SWEEP THE ROAD AT LEAST ONCE DAY OR AS REQUIRED BY THE ENGINEER.

16. THE CITY OF HOLLYWOOD HAS A NOISE ORDINANCE (CHAPTER 100) WHICH PROHIBITS EXCAVATION AND

17. SUITABLE EXCAVATED MATERIAL SHALL BE USED IN FILL AREAS. NO SEPARATE PAY ITEM FOR THIS WORK,

18. ALL ROAD CROSSINGS ARE OPEN CUT AS PER THE REQUIREMENTS OF THE ECSD UNLESS OTHERWISE

THE CONTRACTOR SHALL REPLACE ALL PAVING, STABILIZING EARTH, DRIVEWAYS, PARKING LOTS,

SIDEWALKS, ETC. TO SATISFY THE INSTALLATION OF THE PROPOSED IMPROVEMENTS WITH THE SAME

EQUIPMENT. IN CASE WORK ON PRIVATE PROPERTY IS NEEDED, A CITY OF HOLLYWOOD "RIGHT OF ENTRY"

TYPE OF MATERIAL THAT WAS REMOVED DURING CONSTRUCTION OR AS DIRECTED BY ECSD FIELD

20. THE CONTRACTOR SHALL NOT ENCROACH INTO PRIVATE PROPERTY WITH PERSONNEL, MATERIAL OR

CONTRACTOR IS RESPONSIBLE TO MAINTAIN ACCESS AT ALL TIMES TO PRIVATE HOMES/BUSINESSES 21. THE CONTRACTOR SHALL BE RESPONSIBLE FOR DAMAGE, REMOVAL OR MODIFICATION, CAUSED TO ANY IRRIGATION SYSTEM (PRIVATE OR PUBLIC) ACCIDENTALLY OR PURPOSELY, THE CONTRACTOR SHALL REPLACE ANY DAMAGED, REMOVED OR MODIFIED IRRIGATION PIPES, SPRINKLER HEADS OR OTHER PERTINENT APPURTENANCES TO MATCH OR EXCEED EXISTING CONDITIONS AT NO ADDITIONAL COST TO

22. MAIL BOXES, FENCES OR OTHER PRIVATE PROPERTY DAMAGED DURING THE CONSTRUCTION OF THE PROPOSED IMPROVEMENTS SHALL BE REPLACED TO MATCH OR EXCEED EXISTING CONDITION.

24. NO TREES ARE TO BE REMOVED OR RELOCATED WITHOUT PRIOR APPROVAL FROM THE ECSD FIELD

25. THE CONTRACTOR IS RESPONSIBLE FOR OBTAINING THE NECESSARY TREE REMOVAL OR RELOCATION

26. IT IS THE INTENT OF THESE PLANS TO BE IN ACCORDANCE WITH APPLICABLE CODES AND AUTHORITIES HAVING JURISDICTION. ANY DISCREPANCIES BETWEEN THESE PLANS AND APPLICABLE REGULATORY

STANDARDS / REQUIREMENTS SHALL BE IMMEDIATELY BROUGHT TO THE ATTENTION OF ECSD.

27. THE CONTRACTOR SHALL BE RESPONSIBLE FOR MAINTAINING THE INTEGRITY OF AND MAKING THE

OWNER. CONTRACTOR SHALL REPORT ANY DAMAGE TO SIDEWALK, DRIVEWAY, ETC., PRIOR TO

29. UNDER NO CIRCUMSTANCES SHALL THE CONTRACTOR LEAVE EXCAVATED TRENCHES, OR PARTS OF,

FIRMLY SECURED AND MARKED ACCORDINGLY FOR PEDESTRIAN / VEHICULAR TRAFFIC.

REPAIRS TO EXISTING PAVEMENT, SIDEWALKS, PIPES, CONDUITS, CURBS, CABLES, ETC., WHETHER OR NOT

SHOWN ON THE PLANS DAMAGED AS A RESULT OF THE CONTRACTORS OPERATIONS AND/OR THOSE OF

HIS SUBCONTRACTORS, AND SHALL RESTORE THEM PROMPTLY AT NO ADDITIONAL EXPENSE TO THE

28. WHERE NEW PAVEMENT MEETS EXISTING, CONNECTION SHALL BE MADE IN A NEAT STRAIGHT LINE AND

30. ALL EXCAVATED MATERIAL REMOVED FROM THIS PROJECT SHALL BE DISPOSED OF OFF THE PROPERTY BY

31. ALL DUCTILE IRON PRODUCTS SHALL BE DOMESTIC MADE HEAVY DUTY CLASSIFICATION SUITABLE FOR

33. THE CONTRACTOR SHALL BE RESPONSIBLE FOR THE PROVISION, INSTALLATION AND MAINTENANCE OF ALL

TRAFFIC CONTROL AND SAFETY DEVICES, IN ACCORDANCE WITH SPECIFICATIONS OF THE LATEST REVISION

OF FDOT DESIGN STANDARDS. IN ADDITION, THE CONTRACTOR IS RESPONSIBLE FOR THE RESETTING OF

ALL TRAFFIC CONTROL AND INFORMATION SIGNAGE REMOVED DURING THE CONSTRUCTION PERIOD.

34. EXCAVATED OR OTHER MATERIAL STORED ADJACENT TO OR PARTIALLY UPON A ROADWAY PAVEMENT

35. TEMPORARY PATCH MATERIAL MUST BE ON THE JOB SITE WHENEVER PAVEMENT IS CUT, OR THE CITY'S

36. CONTRACTOR MUST PROVIDE FLASHER ARROW SIGNAL FOR ANY LANE THAT IS CLOSED OR DIVERTED.

37. CONTRACTOR SHALL NOTIFY LAW ENFORCEMENT AND FIRE PROTECTION SERVICES TWENTY-FOUR (24)

EXPOSED OR OPENED AT THE END OF THE WORKING DAY, WEEKENDS, HOLIDAYS OR OTHER TIMES, WHEN

THE CONTRACTOR IS NOT WORKING, UNLESS OTHERWISE DIRECTED. ALL TRENCHES SHALL BE COVERED,

PERMITS FROM THE CITY OF HOLLYWOOD BUILDING DEPARTMENT FOR TREES LOCATED IN THE PUBLIC

CITY OF HOLLYWOOD DEPARTMENT OF PUBLIC UTILITIES STANDARDS.

FLUSH WITH EXISTING PAVEMENT TO MATCH EXISTING CONDITIONS.

32. ALL GRASSED AREAS AFFECTED BY CONSTRUCTION SHALL BE RE-SODDED.

SHALL BE ADEQUATELY MARKED FOR TRAFFIC SAFETY AT ALL TIMES.

38. CONTRACTOR TO RESTORE PAVEMENT TO ORIGINAL CONDITION AS REQUIRED.

THE CONTRACTOR AT THE CONTRACTOR'S EXPENSE.

HIGHWAY TRAFFIC LOADS, OR 20,000 LB.

INSPECTOR WILL SHUT THE JOB DOWN.

23. CONTRACTOR SHALL PROVIDE MAINTENANCE OF TRAFFIC IN ACCORDANCE WITH FDOT STANDARDS AND

FORM MUST BE SIGNED BY PROPERTY OWNER AND THE DIRECTOR OF PUBLIC UTILITIES. THE

CONSTRUCTION BEFORE 8:00 A.M. AND AFTER 6:00 P.M., MONDAY THROUGH SATURDAY AND ALL DAY

15. CONTRACTOR SHALL PROTECT CATCH BASINS WITHIN / ADJACENT TO THE CONSTRUCTION SITE AS

12. CITY OF HOLLYWOOD SHALL NOT PROVIDE STAGING / STORAGE AREA. CONTRACTOR SHALL SECURE

CONTRACTOR SHALL BE CONSIDERED INCIDENTAL TO THE CONTRACT AND NO ADDITIONAL

OBTAIN ANY OTHER AGENCY SHOP DRAWING APPROVAL, IF REQUIRED.

STAGING / STORAGE AREA AS NECESSARY FOR CONSTRUCTION WORK.

SOIL IS ALLOWED TO BE LEFT ON THE CONSTRUCTION SITE OVER NIGHT

UTILITIES ON THIS PROJECT, AND TO ENSURE THAT EXISTING UTILITIES ARE MAINTAINED IN SERVICE

HAND-HOLES, PULL-BOXES, STORMWATER INLETS, AND SIMILAR STRUCTURES IN CONSTRUCTION AREA TO

IMPROVEMENTS, SHOP DRAWINGS SHALL BE SUBMITTED TO ECSD IN ACCORDANCE WITH THE CONTRACT

DOCUMENT'S REQUIREMENTS, FOR APPROVAL. IN ADDITION, IT IS THE CONTRACTOR'S RESPONSIBILITY TO

EXISTING UTILITIES SHALL BE MAINTAINED IN SERVICE DURING CONSTRUCTION UNLESS OTHERWISE

CONTRACTOR SHALL VERIFY THE LOCATIONS. ELEVATIONS, AND OTHER FEATURES AFFECTING HIS/HER

WORK PRIOR TO CONSTRUCTION, AND NOTIFY THE ENGINEER IMMEDIATELY WHEN CONFLICT BETWEEN

DRAWINGS AND ACTUAL CONDITIONS ARE DISCOVERED. THE ENGINEER ASSUMES NO RESPONSIBILITY FOR

ANY FACILITIES SHOWN OR NOT SHOWN ON THE PLANS. THE CONTRACTOR SHALL WORK AS NEEDED TO

THAT WILL BE ENCOUNTERED, AND UPON WHICH BIDS WILL BE BASED.

APPROVED BY THE RESPECTIVE UTILITY OWNER.

BE OVERLAID WITH ASPHALT PAVEMENT.

COMPENSATION SHALL BE ALLOWED.

REQUIRED BY NPDES REGULATIONS.

NOTED ON THE DRAWINGS.

BEGINNING WORK IN ANY AREA.

1988 (NAVD 88).

PERMITS PRIOR TO THE START OF CONSTRUCTION.


WORK. THE CONTRACTORS ARE DIRECTED, PRIOR TO BIDDING, TO CONDUCT WHATEVER INVESTIGATIONS

THEY DEEM NECESSARY TO ARRIVE AT THEIR OWN CONCLUSION REGARDING THE ACTUAL CONDITIONS

COVER SHEET

WATER PROFILES

WATER DETAILS

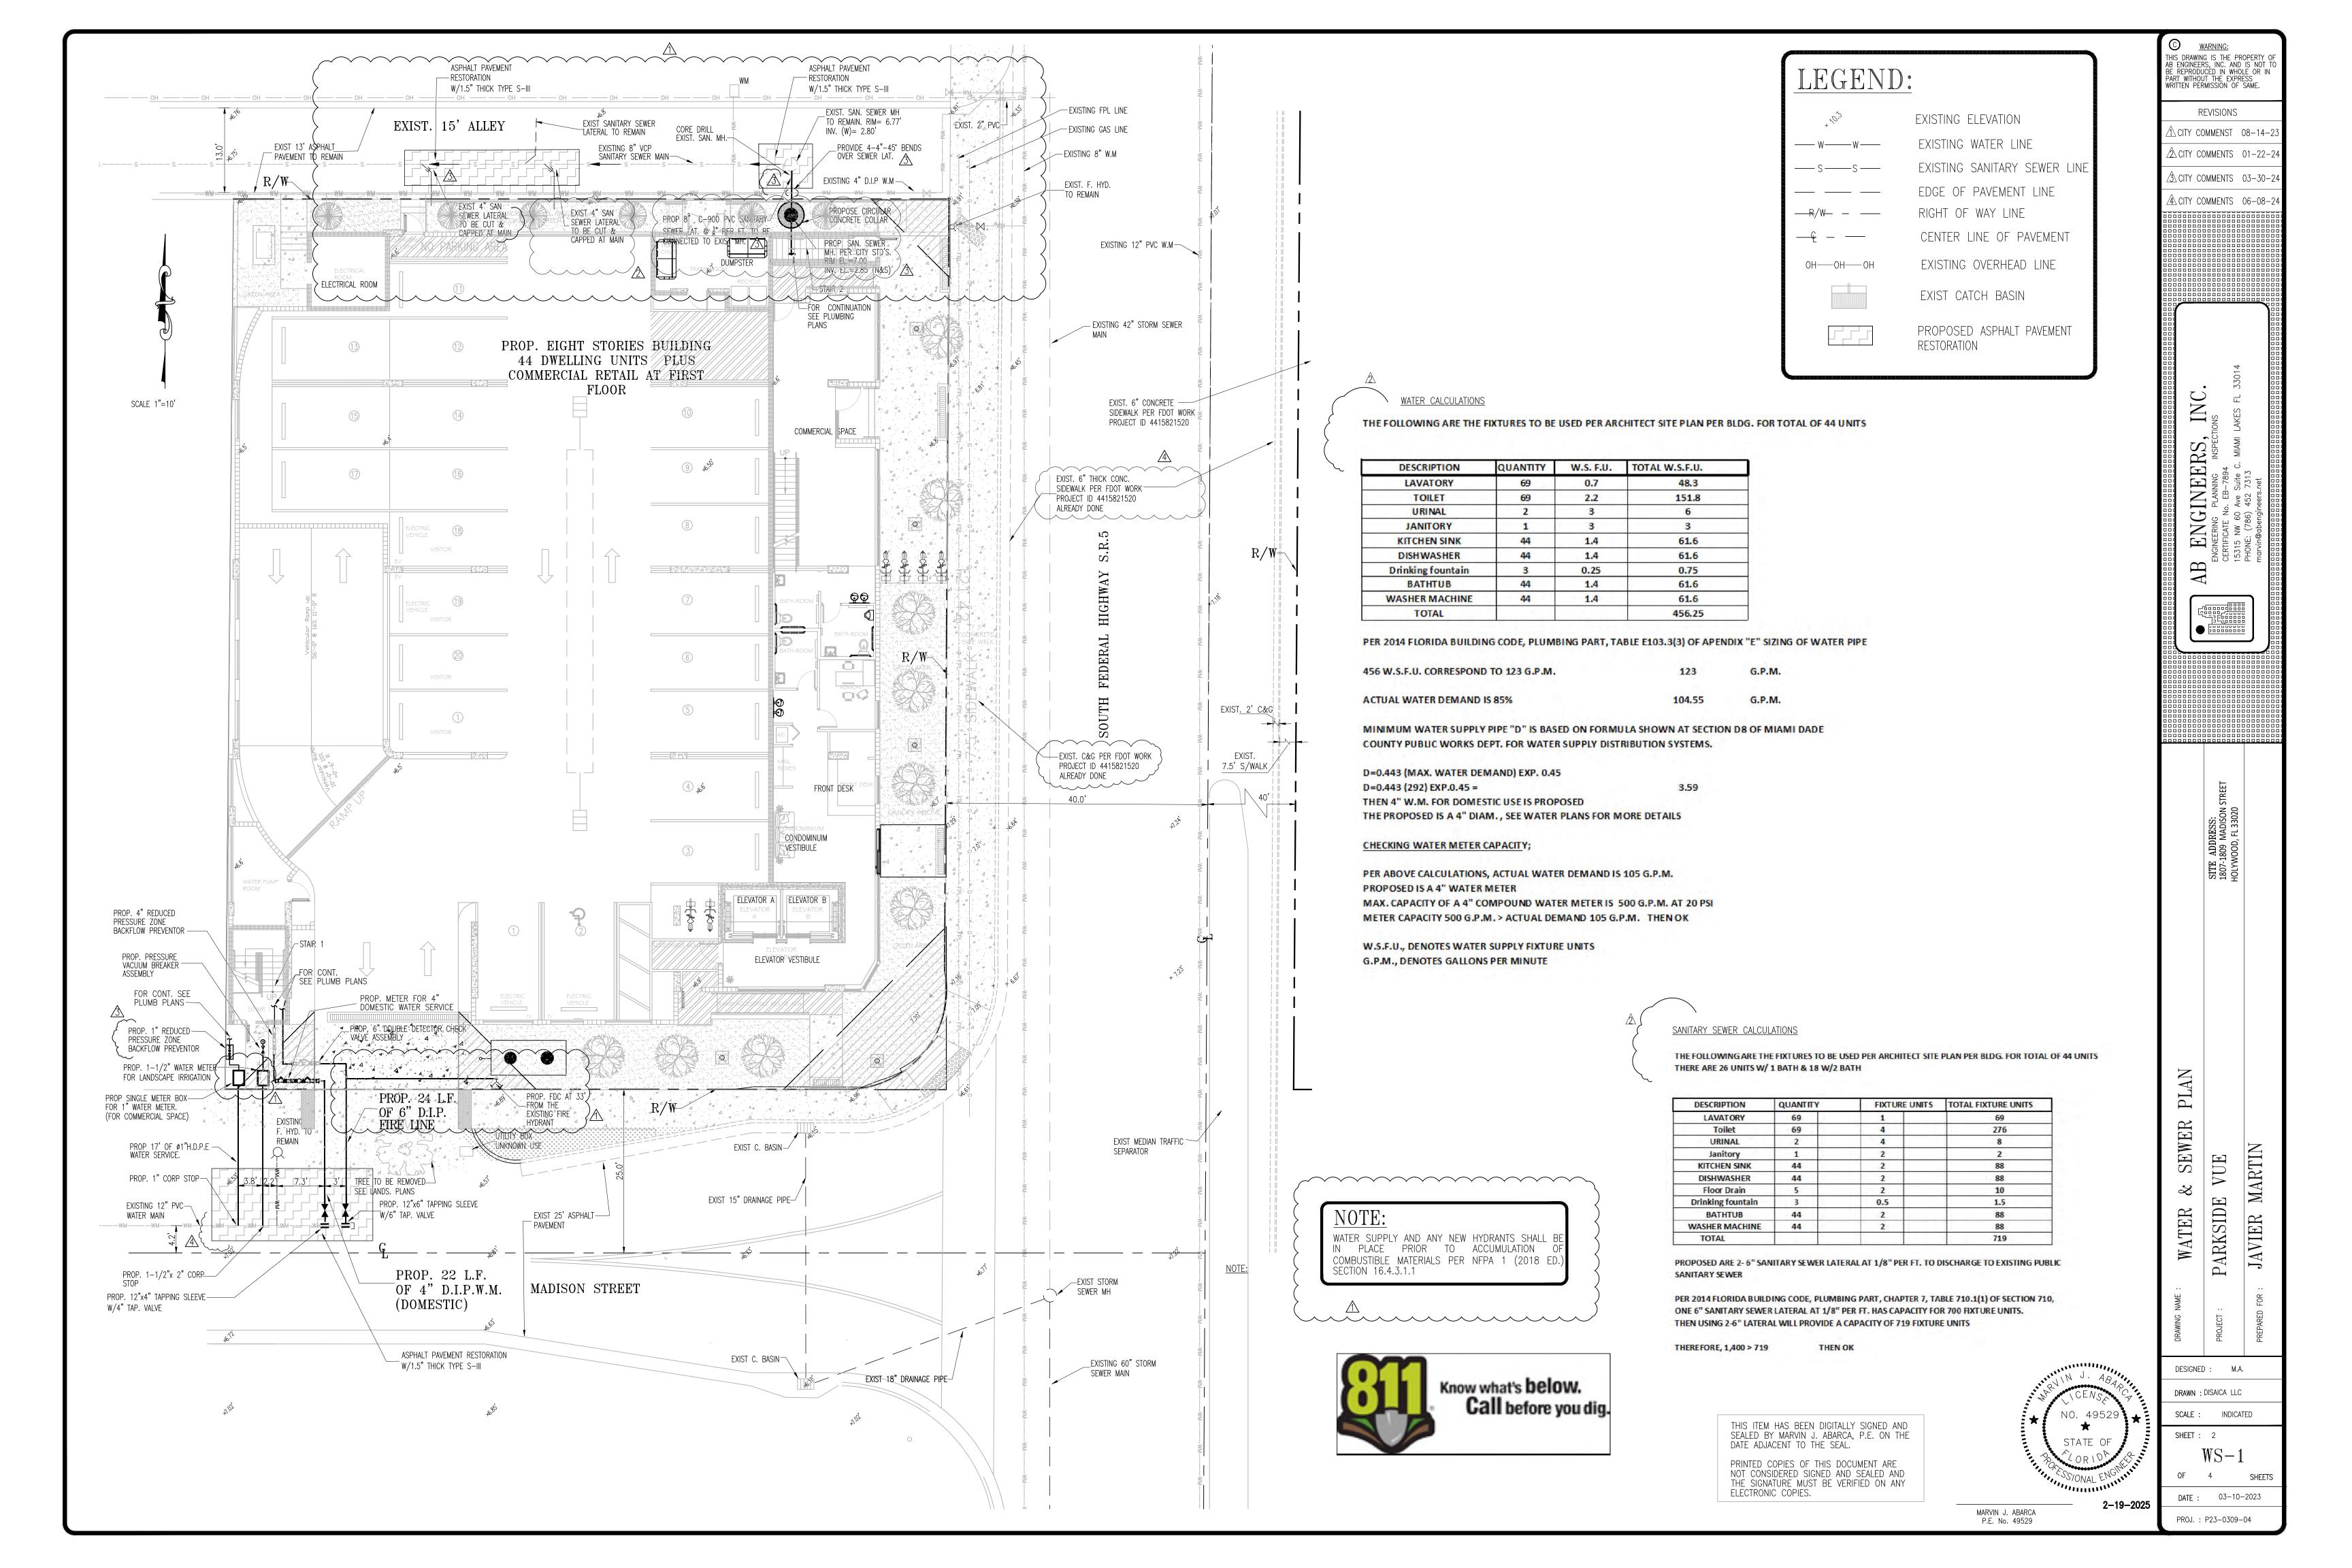


MADISON ST__ EXIST. FINISH GRADE — TO PROP. 6" DOUBLE DETECTOR CHECK VALVE ASSEMBLY PROP.CONC. SIDEWALK EXIST. GRASS —— AREA PROP. 6" D.I.P. | FIRE LINE ____ELEV 2.88' EXISTING 12" PVC W.M PROP. ONE (1) 6"-90° — BENDS (RESTRAINED) PROP. 12"x6" TAPPING SLEEVE
W/6" TAP VALVE 0

FIRE LINE PROFILE

HOR. 1"=1' VER. 1"=10'

WATER MAIN PROFILE
HOR. 1"=10' VER. 1"=1'

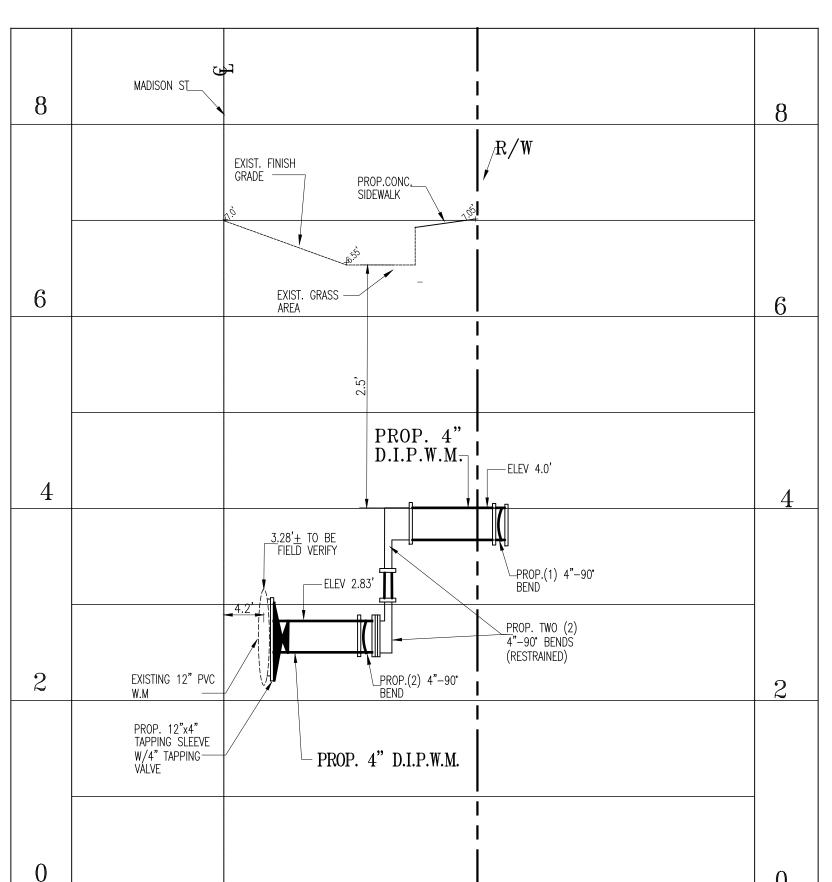

THIS ITEM HAS BEEN DIGITALLY SIGNED AND SEALED BY MARVIN J. ABARCA, P.E. ON THE DATE ADJACENT TO THE SEAL.

PRINTED COPIES OF THIS DOCUMENT ARE NOT CONSIDERED SIGNED AND SEALED AND THE SIGNATURE MUST BE VERIFIED ON ANY ELECTRONIC COPIES.

AB ENGINEERS, INC. ENGINEERING INSPECTIONS WATER PROFILES MARTIN VUE PARKSIDE JAVIER DESIGNED : M.A. DRAWN : DISAICA LLC

SCALE: INDICATED

DATE: 03-10-2023

PROJ.: P23-0309-04

SHEETS

SHEET: 3


2-19-2025

MARVIN J. ABARCA P.E. No. 49529

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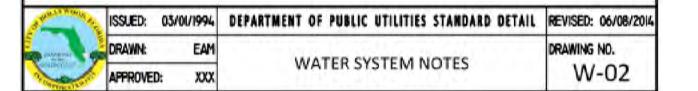
WATER SYSTEM NOTES:


- NEW OR RELOCATED UNDERGROUND WATER MAINS INCLUDED IN THIS PROJECT THAT WILL CROSS ANY
 EXISTING OR PROPOSED GRAVITY OR VACUUM-TYPE SANITARY SEWER OR STORM SEWER WILL BE LAID SO
 THE OUTSIDE OF THE WATER MAIN IS AT LEAST SIX INCHES ABOVE THE OTHER PIPELINE OR AT LEAST 12
 INCHES BELOW THE OTHER PIPELINE.
- NEW OR RELOCATED UNDERGROUND WATER MAINS INCLUDED IN THIS PROJECT THAT WILL CROSS ANY EXISTING OR PROPOSED PRESSURE-TYPE SANITARY SEWER, WASTEWATER OR STORM WATER FORCE MAIN, OR PIPELINE CONVEYING RECLAIMED WATER WILL BE LAID SO THE OUTSIDE OF THE WATER MAIN IS AT LEAST 12 INCHES ABOVE OR BELOW THE OTHER PIPELINE. [FAC 62-555.314(2); EXCEPTIONS ALLOWED UNDER FAC 62-555.314(5)].
- 3. AT ALL UTILITY CROSSINGS DESCRIBED ABOVE, ONE FULL LENGTH OF WATER MAIN PIPE WILL BE CENTERED ABOVE OR BELOW THE OTHER PIPELINE SO THE WATER MAIN JOINTS WILL BE AS FAR AS POSSIBLE FROM THE OTHER PIPELINE, OR THE PIPES WILL BE ARRANGED SO THAT ALL WATER MAIN JOINTS ARE AT LEAST THREE FEET FROM ALL JOINTS IN VACUUM-TYPE SANITARY SEWERS, STORM SEWERS, STORM WATER FORCE MAINS, OR PIPELINES CONVEYING RECLAIMED WATER REGULATED UNDER PART III OF CHAPTER 62-610, F.A.C., AND AT LEAST SIX FEET FROM ALL JOINTS IN GRAVITY OR PRESSURE-TYPE SANITARY SEWERS, WASTEWATER FORCE MAINS, OR PIPELINES CONVEYING RECLAIMED WATER NOT REGULATED UNDER PART III OF CHAPTER 62-610, F.A.C. [FAC 62-555.314(2); EXCEPTIONS ALLOWED UNDER FAC 62-555.314(5)].
- NEW UNDERGROUND WATER MAINS INCLUDED IN THIS PROJECT TO BE DUCTILE IRON PIPE (D.I.P.) WHEN CROSSING BELOW SANITARY SEWER MAINS.
- 5. POLYETHYLENE ENCASEMENT MATERIAL SHALL BE USED TO ENCASE ALL BURIED DUCTILE IRON PIPE, FITTINGS, VALVES, RODS, AND APPURTENANCES IN ACCORDANCE WITH AWWA C105, METHOD A. THE POLYETHYLENE TUBING SHALL BE CUT TWO FEET LONGER THAN THE PIPE SECTION AND SHALL OVERLAP THE ENDS OF THE PIPE BY ONE FOOT. THE POLYETHYLENE TUBING SHALL BE GATHERED AND LAPPED TO PROVIDE A SNUG FIT AND SHALL BE SECURED AT QUARTER POINTS WITH POLYETHYLENE TAPE. EACH END OF THE POLYETHYLENE TUBING SHALL BE SECURED WITH A WRAP OF POLYETHYLENE TAPE.
- THE POLYETHYLENE TUBING SHALL PREVENT CONTACT BETWEEN THE PIPE AND BEDDING MATERIAL, BUT IS NOT INTENDED TO BE A COMPLETELY AIRTIGHT AND WATERTIGHT ENCLOSURE. DAMAGED POLYETHYLENE TUBING SHALL BE REPAIRED IN A WORKMANLIKE MANNER USING POLYETHYLENE TAPE, OR THE DAMAGED SECTION SHALL BE REPLACED. POLY WRAP WILL NOT BE PAID FOR AS A SEPARATE BID ITEM. IT SHALL BE CONSIDERED TO BE A PART OF THE PRICE BID FOR WATER MAINS.
- FIRE HYDRANT BARRELS SHALL BE ENCASED IN POLY WRAP UP TO THE GROUND SURFACE AND THE WEEP HOLES SHALL NOT BE COVERED BY THE POLY WRAP.
- B. GATE VALVES FOR USE WITH PIPE LESS THAN THREE INCHES (3") IN DIAMETER SHALL BE RATED FOR TWO HUNDRED (200) PSI WORKING PRESSURE, NON-SHOCK, BLOCK PATTERN, SCREWED BONNET, NON-RISING STEM, BRASS BODY, AND SOLID WEDGE. THEY SHALL BE STANDARD THREADED FOR PVC PIPE AND HAVE A MALLEABLE IRON HANDWHEEL. GATE VALVES 3" THROUGH 16" IN DIAMETER SHALL BE RESIDENT SEAT AND BIDIRECTIONAL FLOW ONLY. VALVES FOR SPECIAL APPLICATIONS WILL REQUIRE CITY UTILITY APPROVAL.
- 9. VALVE BOXES AND COVERS FOR ALL SIZE VALVES SHALL BE OF CAST IRON CONSTRUCTION AND ADJUSTABLE SCREW-ON TYPE. THE LID SHALL HAVE CAST IN THE METAL THE WORD "WATER" FOR THE WATER LINES. ALL VALVE BOXES SHALL BE SIX INCH (6") NOMINAL DIAMETER AND SHALL BE SUITABLE FOR DEPTHS OF THE PARTICULAR VALVE. THE STEM OF THE BURIED VALVE SHALL BE WITHIN TWENTY-FOUR INCHES (24") OF THE FINISHED GRADE UNLESS OTHERWISE APPROVED BY THE CITY.
- ALL WATER MAIN INSTALLATIONS SHALL COMPLY WITH THE COLOR CODING REQUIREMENTS OF CHAPTER 62-555.320 F.A.C.

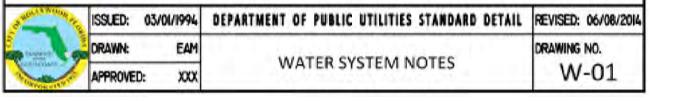


WATER SYSTEM NOTES (CONTINUED):


- ALL WATER MAIN INSTALLATIONS SHALL COMPLY WITH THE COLOR CODING REQUIREMENTS OF CHAPTER 62-555.320 F.A.C.
- ALL PVC PIPE SHALL CONFORM TO THE REQUIREMENTS OF ANSI/AWWA C900 LATEST REVISION AND CLASS DR 18. ALL DIP WATER MAINS SHALL BE DUCTILE IRON PRESSURE CLASS 350, WITH WALL THICKNESS COMPLYING WITH CLASS 52. ALL DUCTILE IRON PIPE SHALL CONFORM TO THE REQUIREMENTS OF ANSI/AWWA C151/A21.51-02 AND BE CEMENT LINED AND SEAL COATED PER ANSI/AWWA C104/A21.4-03.
- FITTINGS SHALL BE DUCTILE IRON, MEETING ANSI/AWWA C153/A21.53-00 SPECIFICATIONS, WITH 350 PSI
 MINIMUM WORKING PRESSURE. FITTINGS MUST BE CEMENT LINED AND SEAL COATED PER ANSI/AWWA
 C104/A21.4-03. ALL DUCTILE IRON PIPE AND FITTINGS MUST BE MANUFACTURED IN THE UNITED STATES OF
 AMERICA.
- ALL DUCTILE IRON PIPE TO BE MECHANICAL JOINTS, WRAPPED IN POLY. ADEQUATE PROTECTIVE MEASURES
 AGAINST CORROSION SHALL BE USED AS DETERMINED BY DESIGN.
- 15. PAVEMENT RESTORATION SHALL BE CARRIED OUT IN ACCORDANCE WITH THE REQUIREMENTS OF THE CITY.
- ALL TRENCHING, PIPE LAYING, BACKFILL, PRESSURE TESTING, AND DISINFECTING MUST COMPLY WITH THE CITY OF HOLLYWOOD SPECIFICATIONS.
- 17. THE MINIMUM DEPTH OF COVER OVER WATER MAINS IS 30" (DIP) OR 36" (PVC).
- 18. MINIMUM HORIZONTAL SEPARATION BETWEEN STORM STRUCTURES AND WATER MAINS SHALL BE 31.
- MAXIMUM DEFLECTION PER EACH JOINT SHALL BE 50% OF MANUFACTURES RECOMMENDATION (MAXIMUM) WHERE DEFLECTION IS REQUIRED.
- 20. CONTRACTOR SHALL BE RESPONSIBLE FOR IDENTIFYING CONFLICTS WITH WATER MAINS PLACED AT MINIMUM COVER. IN CASE OF CONFLICT, WATER MAIN SHALL BE LOWERED TO PASS UNDER CONFLICTS WITH 18" MINIMUM VERTICAL SEPARATION, NO ADDITIONAL PAYMENT SHALL BE DUE TO CONTRACTOR FOR LOWERING THE MAIN OR THE ADDITIONAL FITTINGS USED THEREON.
- 21. PIPE JOINT RESTRAINT SHALL BE PROVIDED BY THE USE OF DUCTILE IRON FOLLOWER GLANDS MANUFACTURED TO ASTM A 536-80. TWIST-OFF NUTS SHALL BE USED TO ENSURE PROPER ACTUATING OF THE RESTRAINING DEVICES. THE MECHANICAL JOINT RESTRAINING DEVICES SHALL HAVE A WORKING PRESSURE OF 250 PSI MINIMUM, WITH A MINIMUM SAFETY FACTOR OF 2:1, AND SHALL BE EBAA IRON INC., MEGALUG OR APPROVED EQUAL JOINT RESTRAINTS SHALL BE PROVIDED AT A MINIMUM OF THREE JOINTS (60 FEET) FROM ANY FITTING.
- 22. WHENEVER IT IS NECESSARY, IN THE INTEREST OF SAFETY, TO BRACE THE SIDES OF A TRENCH, THE CONTRACTOR SHALL FURNISH, PUT IN PLACE AND MAINTAIN SUCH SHEETING OR BRACING AS MAY BE NECESSARY TO SUPPORT THE SIDES OF THE EXCAVATION TO ENSURE PERSONNEL SAFETY, AND TO PREVENT MOVEMENT WHICH CAN IN ANY WAY DAMAGE THE WORK OR ENDANGER ADJACENT STRUCTURES. THE CONTRACTOR SHALL BE SOLELY RESPONSIBLE FOR THE SEQUENCE, METHODS AND MEANS OF CONSTRUCTION, AND FOR THE IMPLEMENTATION OF ALL OSHA AND OTHER SAFETY REQUIREMENTS.




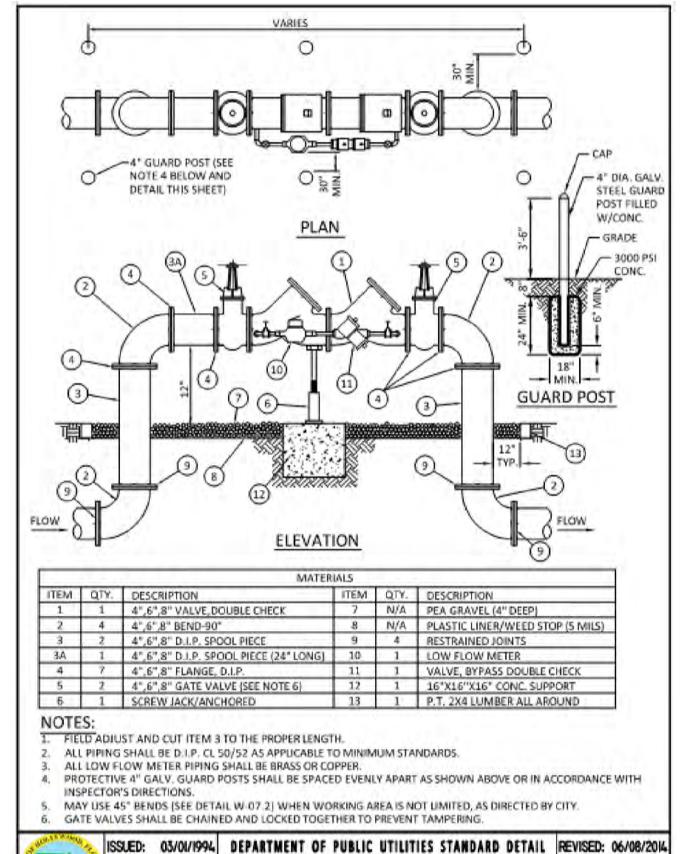



Married &	ISSUED:	03/01/1994	DEPARTMENT OF PUBLIC UTILITIES STANDARD DETAIL	REVISED: 06/08/2014
Digital Control	DRAWN:	EAM	TYPICAL 4", 6" AND 8" DOUBLE CHECK DETECTOR ASSEMBLY FOR FIRE	DRAWING NO.
William St.	APPROVED	: XXX	SPRINKLER SERVICE (90° BENDS)	W-03

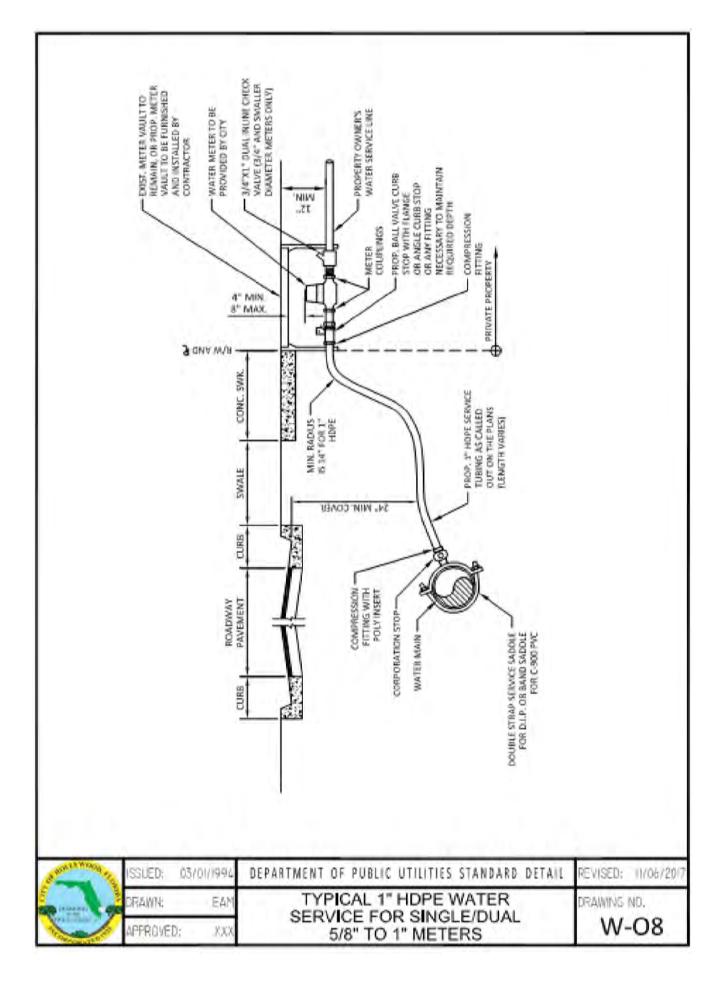


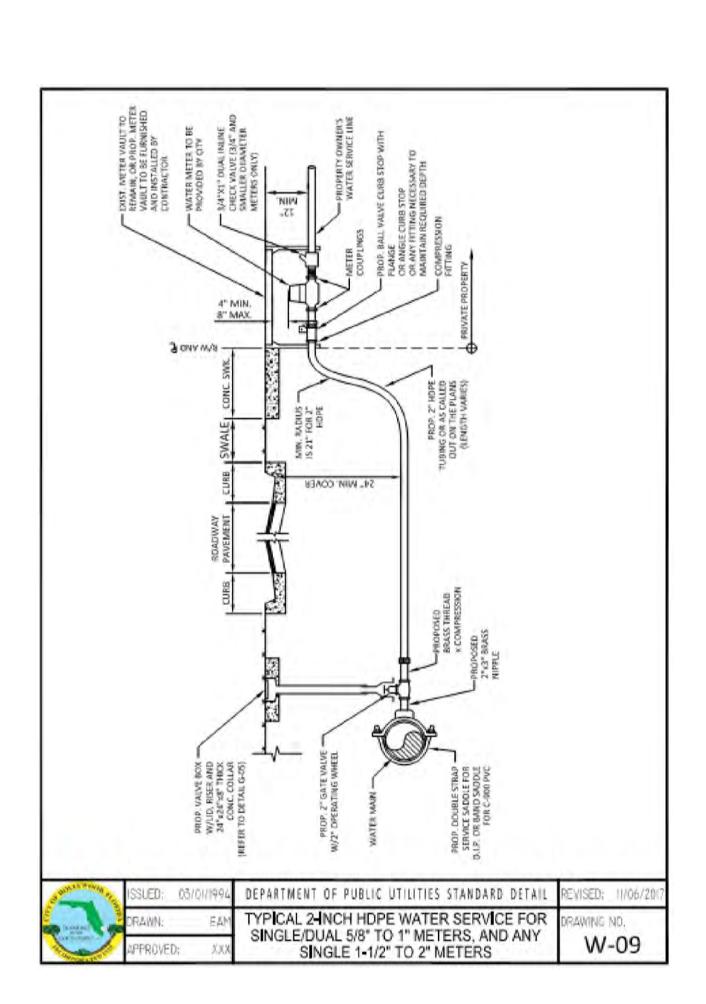

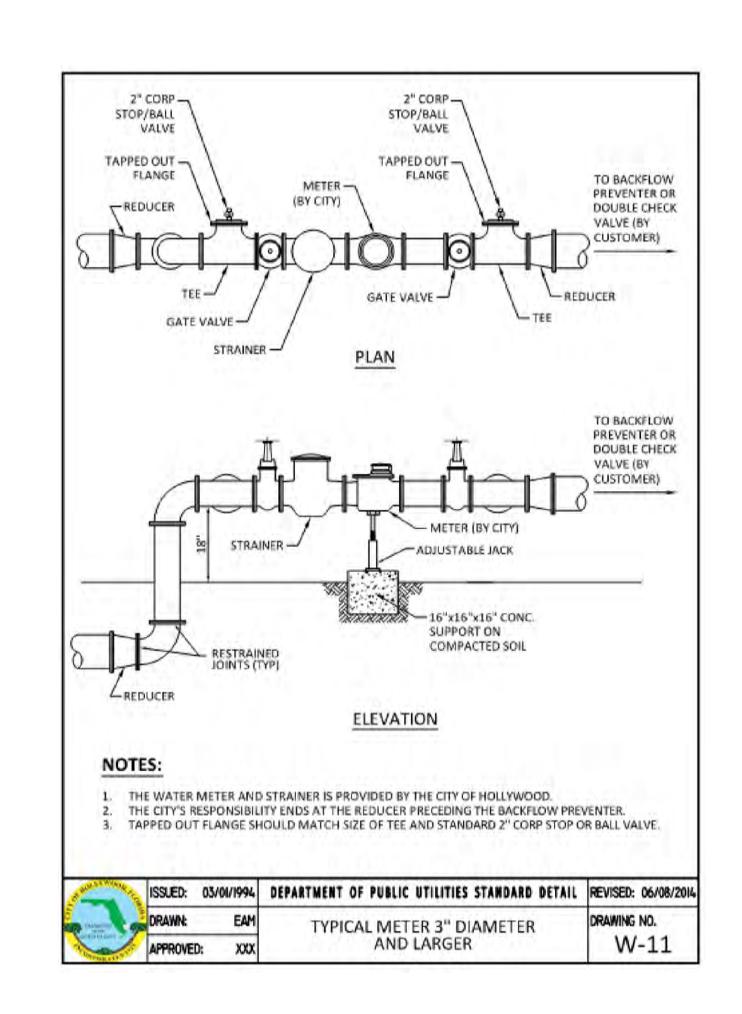

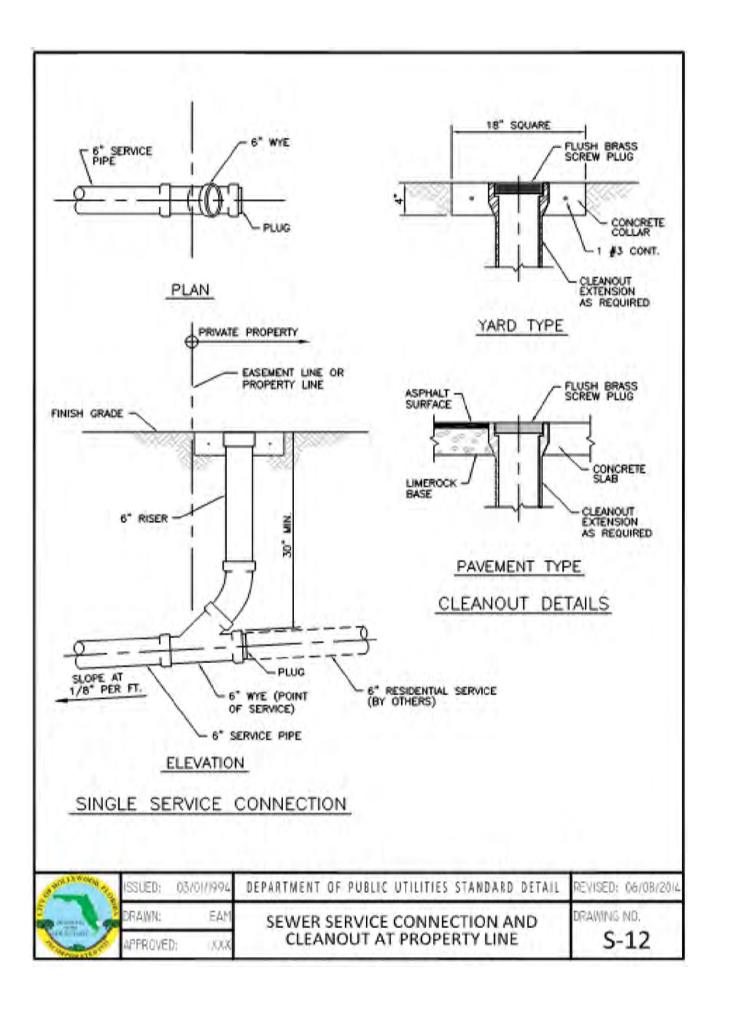

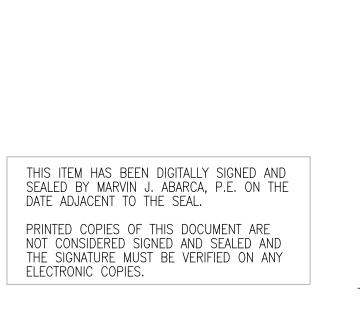

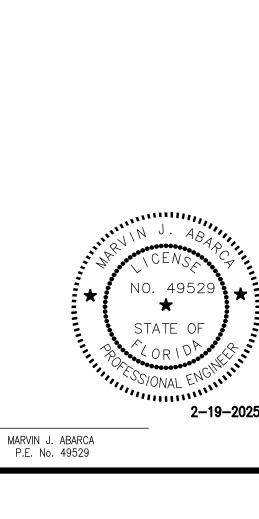

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REVISIONS

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EERS

NGI

DETAILS

WATER

VUE

PARKSIDE

DESIGNED: M.A.

DRAWN : DISAICA LLC

INDICATED

DATE: 03-10-2023


PROJ.: P23-0309-04


SHEETS

SCALE :


ARTI

IAVIER

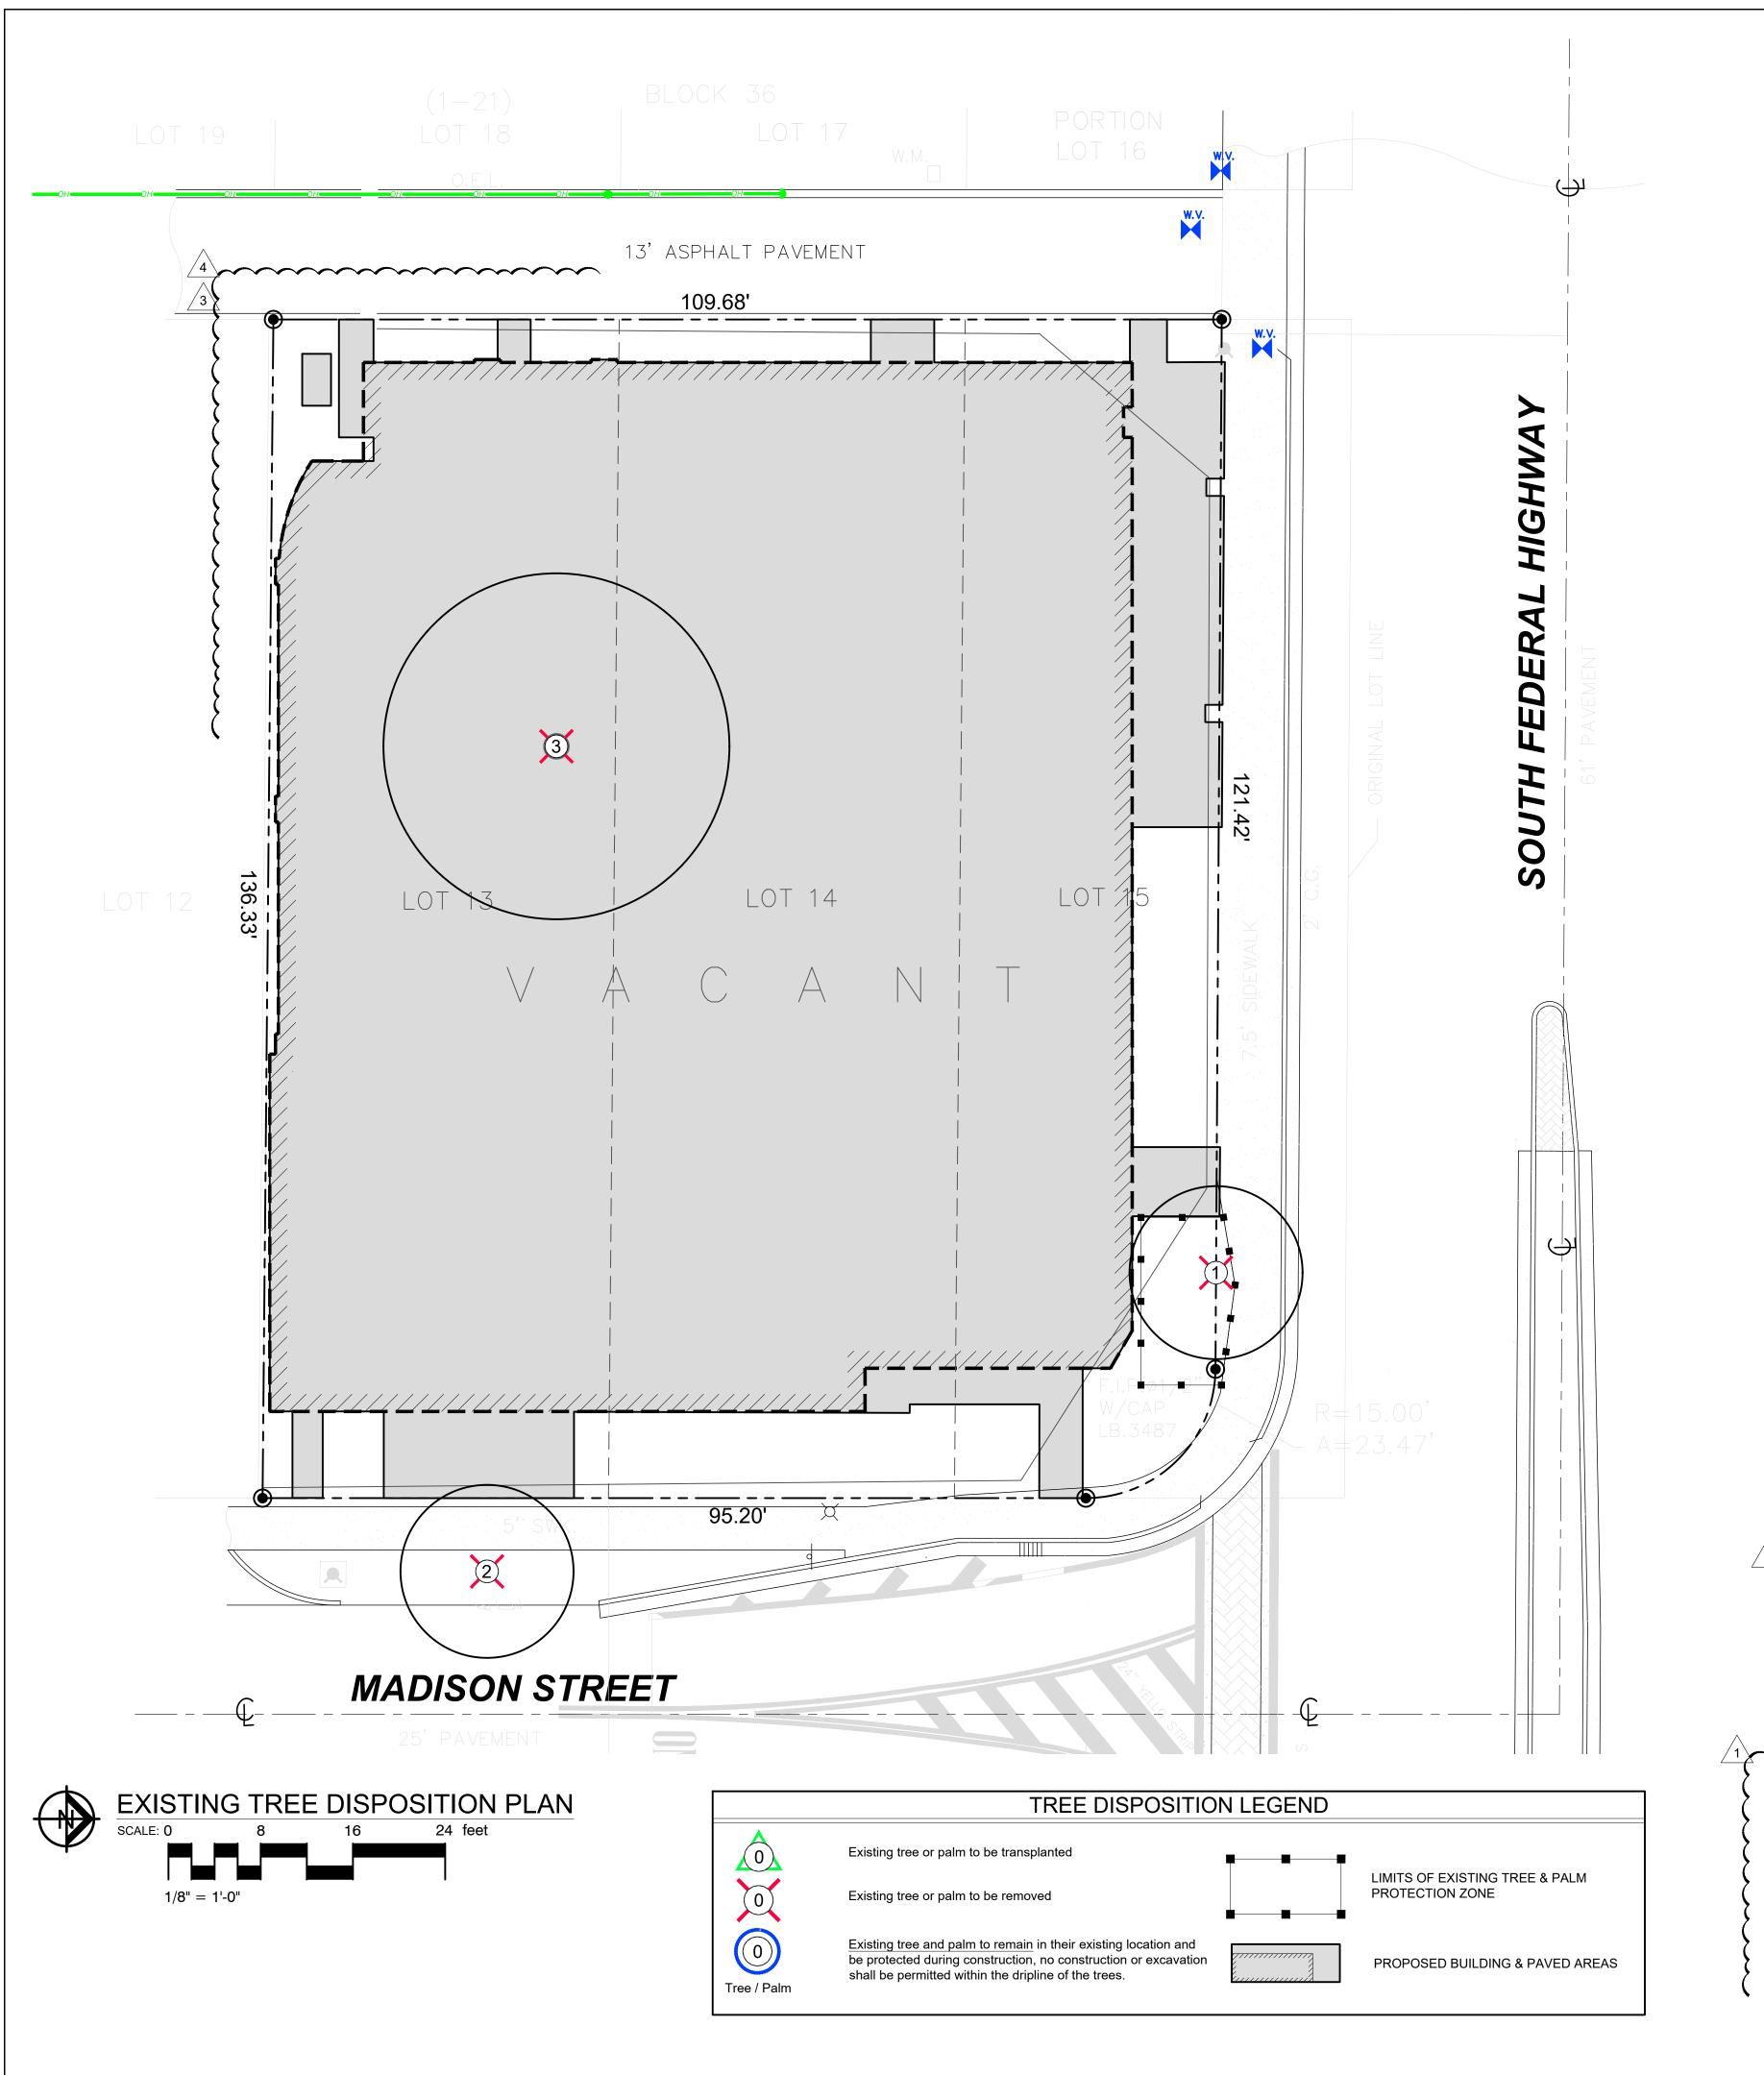

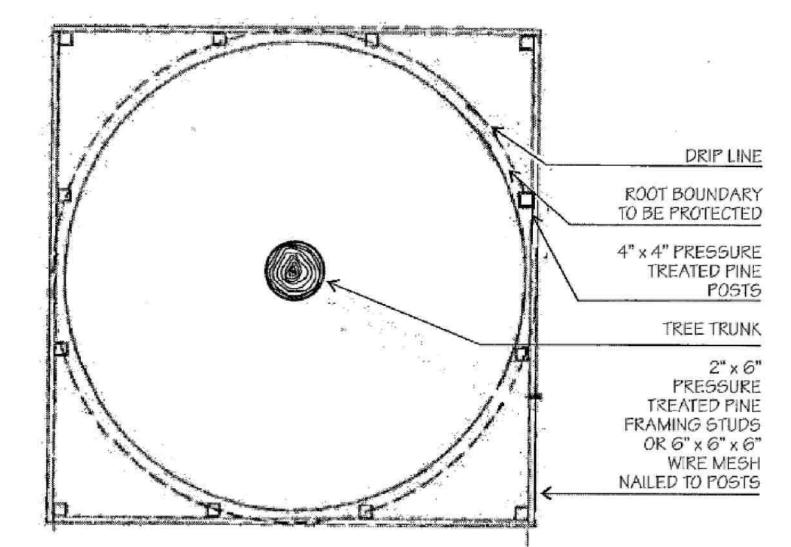

IT IS CRITICAL TO EXISTING TREE SURVIVAL TO PROVIDE PROTECTION DURING CONSTRUCTION. THIS DETAIL CAN BE USED AROUND ONE OR MORE TREES AND WILL PROVIDE PROTECTION FROM CONSTRUCTION EQUIPMENT.

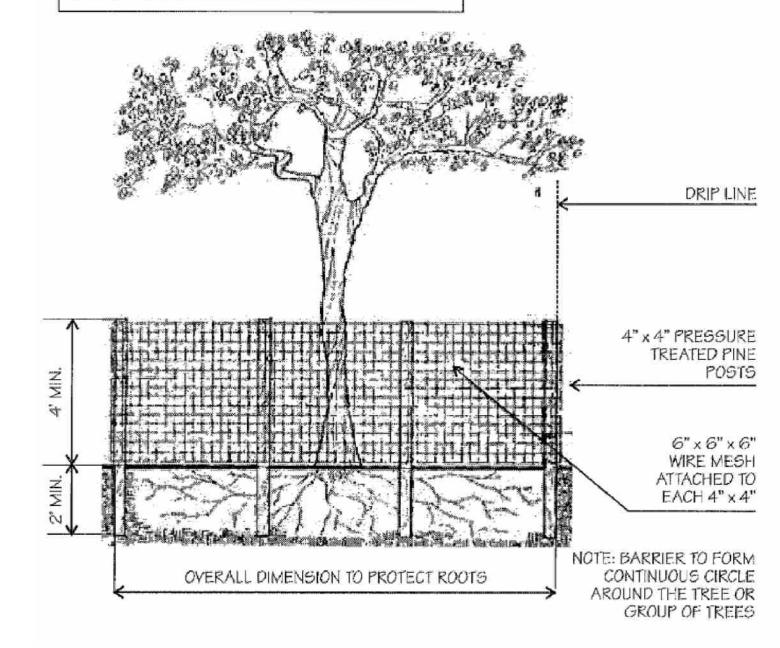

EXITING TREE PROTECTION DETAILS

NOTE:
Trees and Palms shall not be removed without first obtaining an approved Tree Removal Permit from the City of Hollywood.

Call 811 or www.sunshine811.com two full business days before digging to have utilities

located and marked.


Check positive response codes before you dig!

No.	Common Name	Scientific Name	Diameter DBH (in)	DBH (in) for Mitigation	Height (ft)	Spread (ft)	Condition	Disposition
1	Bucida buceras 'Shady Lady'	Black Olive	20	0	20	20	Poor	Remove
2	Bucida buceras 'Shady Lady'	Black Olive	19	19	20	20	Fair	Remove
3	Mangifera indica	Mango	29	29	20	40	Fair	Remove

30 Trees (2" DBH / 12' OA) can not be reasonably replaced on the property. Tree Trust Fund contribution of \$10,500 will be required for the mitigation deficit

DERICK LANGEL Landscape Architect LA666705 ISA Certified Arborist FL6439A	Landscape (Architecture + Plant Information) (305) 303 7059 / 4459 NW 97 CT. Doral, FL 33178 www.alllandscapedata.net www.alllandscapedata.com
REVISIONS:	City Comments and Coordination 10-28-23 City Comments and Coordination 03-12-24 Coordination 11-05-24
PROJET NAME	PARK SIDE VEW 1807 MADISON STREET HOLLYWOOD, FL 33020
SHEET INFORMATION:	Drawing Size 24x36 Project #: 2022-12-156 IAAI Drawn By: ALD Checked By: DL Title: EXISTING TREE DISPOSITION PLAN Sheet Number: L-100

Date: - March 15, 2023

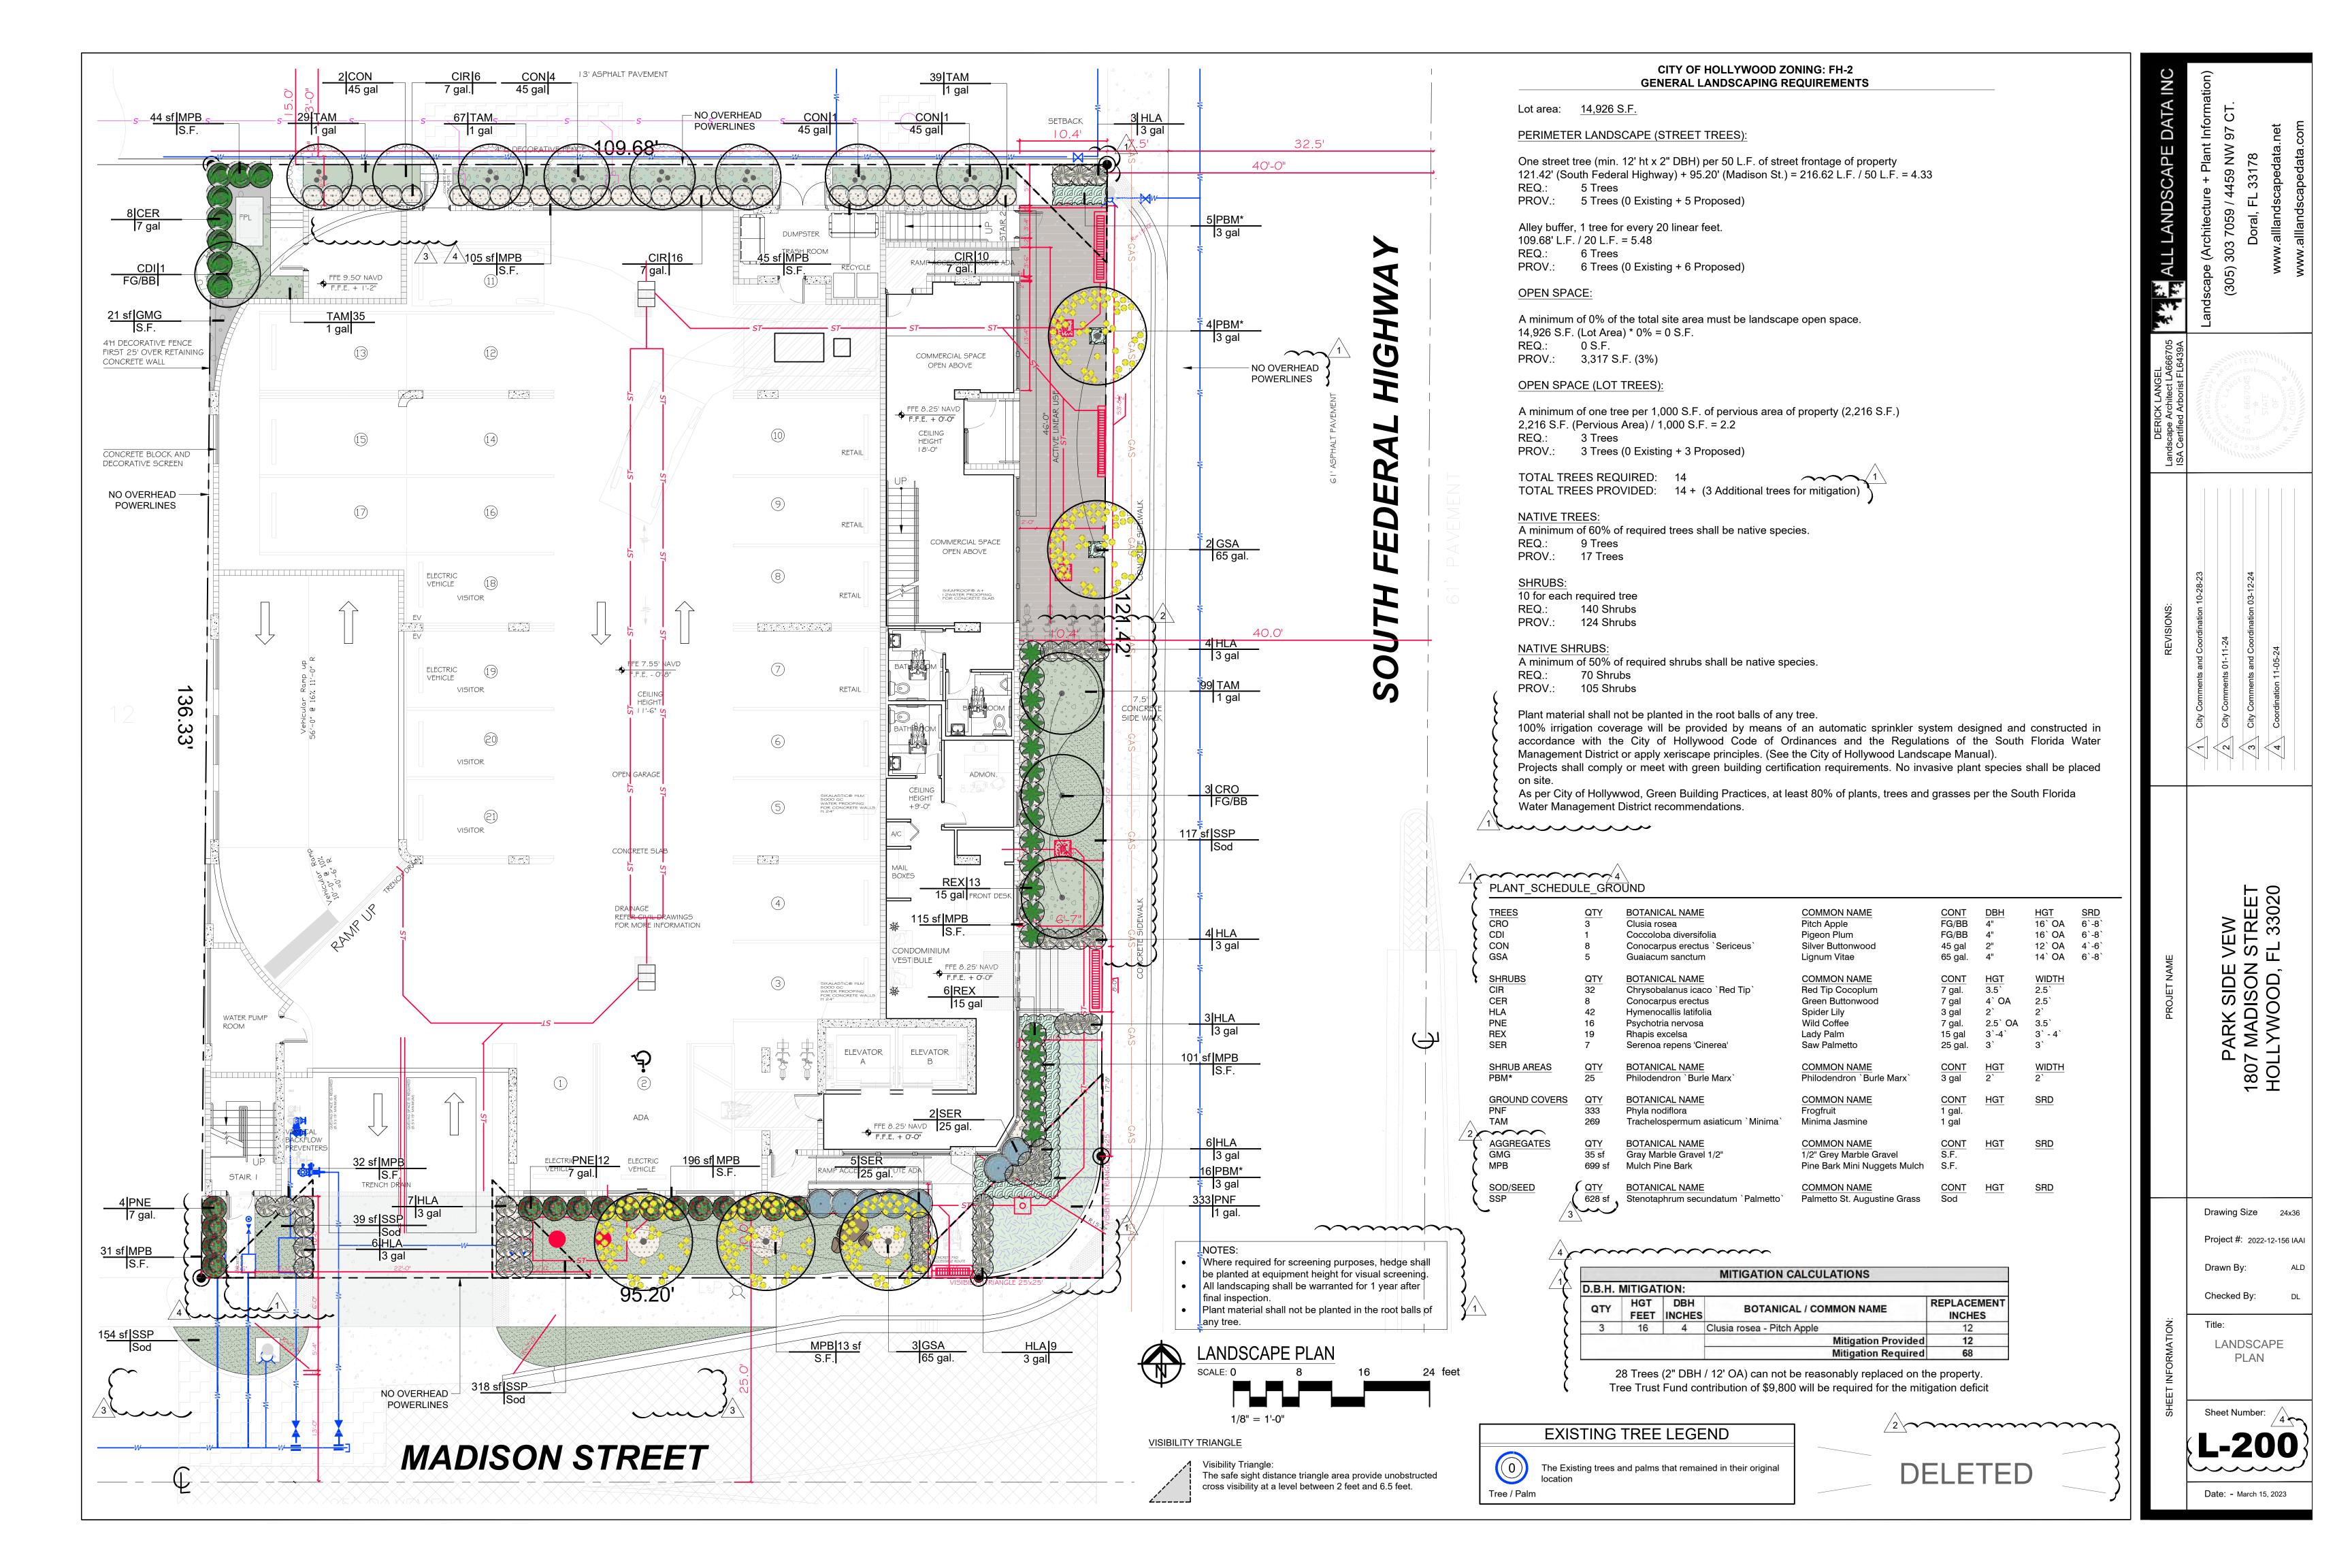


$\sim\sim$ PLANT SCHEDULE GROUND CONT FG/BB **BOTANICAL NAME COMMON NAME** REMARKS TREES SRD Florida Native - Drought Tolerant -CRO 16` OA 6`-8` Pitch Apple Clusia rosea WaterWise: South Florida Landscapes Plant Guide CDI FG/BB STD - Florida Native - WaterWise: Pigeon Plum 16` OA 6`-8` Coccoloba diversifolia South Florida Landscapes Plant Guide CON Drought Tolerant - STD - Florida Silver Buttonwood 12` OA 4`-6` Conocarpus erectus `Sericeus` 45 gal Native - 4' CT Minimum - WaterWise: South Florida Landscapes Plant Guide GSA Guaiacum sanctum Lignum Vitae 65 gal. 4" 14` OA 6`-8` Florida Native - WaterWise: South Florida Landscapes Plant Guide CONT SHRUBS **BOTANICAL NAME** COMMON NAME Chrysobalanus icaco `Red Tip` Red Tip Cocoplum 7 gal. 3.5` 2.5` Florida Native - WaterWise: South Florida Landscapes Plant Guide CER Green Buttonwood 4` OA Florida Native - WaterWise: South 7 gal 2.5` Conocarpus erectus Florida Landscapes Plant Guide Native - WaterWise: South Florida HLA Hymenocallis latifolia Spider Lily 3 gal Landscapes Plant Guide 2.5` OA 3.5` Florida Native - WaterWise: South Wild Coffee Psychotria nervosa 7 gal. Florida Landscapes - Plant Guide REX Shade Grown - WaterWise: South Lady Palm 15 gal 3`-4` 3` - 4` Rhapis excelsa Florida Landscapes Plant Guide SER Florida Native - Drought Tolerant -Saw Palmetto Serenoa repens 'Cinerea' 25 gal. 3` WaterWise: South Florida Landscapes Plant Guide **BOTANICAL NAME** COMMON NAME SPACING SHRUB AREAS 24" o.c. Philodendron `Burle Marx` Philodendron `Burle Marx` GROUND COVERS QTY **BOTANICAL NAME COMMON NAME** CONT SPACING Phyla nodiflora Frogfruit 1 gal. 9" o.c. Florida Native TAM Trachelospermum asiaticum `Minima` Minima Jasmine 15" o.c. WaterWise: South Florida Landscapes 1 gal Plant Guide $^{/2}$ AGGREGATES **BOTANICAL NAME** COMMON NAME **SPACING** SRD Gray Marble Gravel 1/2" 3" Layer - Substitute for Gray Pearock 1/2" Grey Marble Gravel if Desired Pine Bark Mini Nuggets Mulch S.F. MPB 703 sf Mulch Pine Bark 3" Layer SOD/SEED SSP **BOTANICAL NAME** COMMON NAME SPACING Stenotaphrum secundatum `Palmetto` Shade tolerant

Palmetto St. Augustine Grass

	SITE FURNISHINGS	
SYMBOL	DESCRIPTION	QTY
	Old Town Fiberglass Planter CL4830 CYLINDER WITH RIM 48"DIA. x 30"H **3" RIM** SUB SAUCER	8
	Old Town Fiberglass Planter CF481824 CARDIFF TAPERED RECTANGLE 48"L x 18"W x 24"H (42 lbs) SUB SAUCER Built in Perforated Sub-floor- Specify Siphon Tube or Drain Plug with Over Flow Plug	11



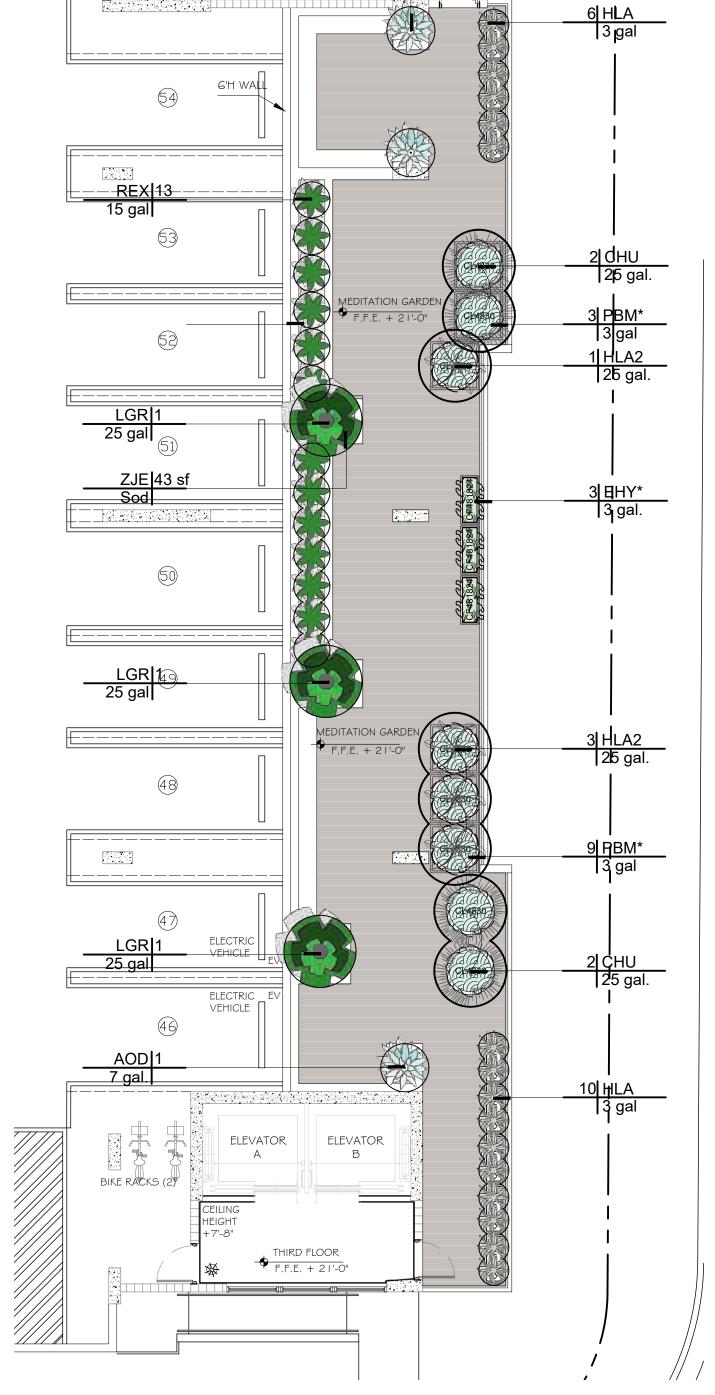

DATA INC

ALL

Drawing Size 24x36

Project #: 2022-12-156 IAAI


LANDSCAPE PLAN, SCHEDULE & IMAGES

Date: - March 15, 2023

Drawn By:

Checked By:




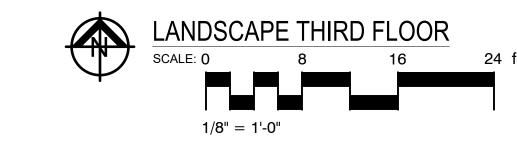


\frac{1}{5}	PLANT SCHED	ULE TH	HIRD FLOOR							
}	PALMS CHU	QTY 4	BOTANICAL NAME Chamaerops humilis	COMMON NAME Mediterranean Fan Palm	CONT 25 gal.	DBH Multi Stems	HGT 5`-6`	SRD 4`-6`		REMARKS
(HLA2	4	Hyophorbe lagenicaulis	Bottle Palm	25 gal.	4"-6"	6`-8` OA	5`-6`		Single
(SHRUBS AOD	QTY 3	BOTANICAL NAME Alcantarea odorata	COMMON NAME Giant Silver Bromeliad	CONT 7 gal.	HGT 3`	WIDTH 3`-4`			
(HLA	16	Hymenocallis latifolia	Spider Lily	3 gal	2`	2`			Native - WaterWise: South Florida Landscapes Plant Guide
}	REX	13	Rhapis excelsa	Lady Palm	15 gal	3`-4`	3` - 4`			Shade Grown - WaterWise: South Florida Landscapes Plant Guide
(LARGE SHRUBS LGR	QTY 3	BOTANICAL NAME Licuala grandis	COMMON NAME Licuala Palm	CONT 25 gal	<u>HGT</u> 3"	WIDTH 6`OA			
	SHRUB AREAS EHY* PBM*	QTY 9 24	BOTANICAL NAME Equisetum hyemale Philodendron `Burle Marx`	COMMON NAME Horsetail Reed Grass Philodendron `Burle Marx`	CONT 3 gal. 3 gal	HGT 2` OA 2`	WIDTH 1` 2`		SPACING 18" o.c. 24" o.c.	Native - Drought Tolerant
	AGGREGATES MBP	QTY 48 sf	BOTANICAL NAME Mexican Black Pebbles	COMMON NAME Black Pebbles	CONT S.F.	<u>HGT</u>	SRD		SPACING	
	MPB	80 sf	Mulch Pine Bark	Pine Bark Mini Nuggets Mulch	S.F.					3" Layer

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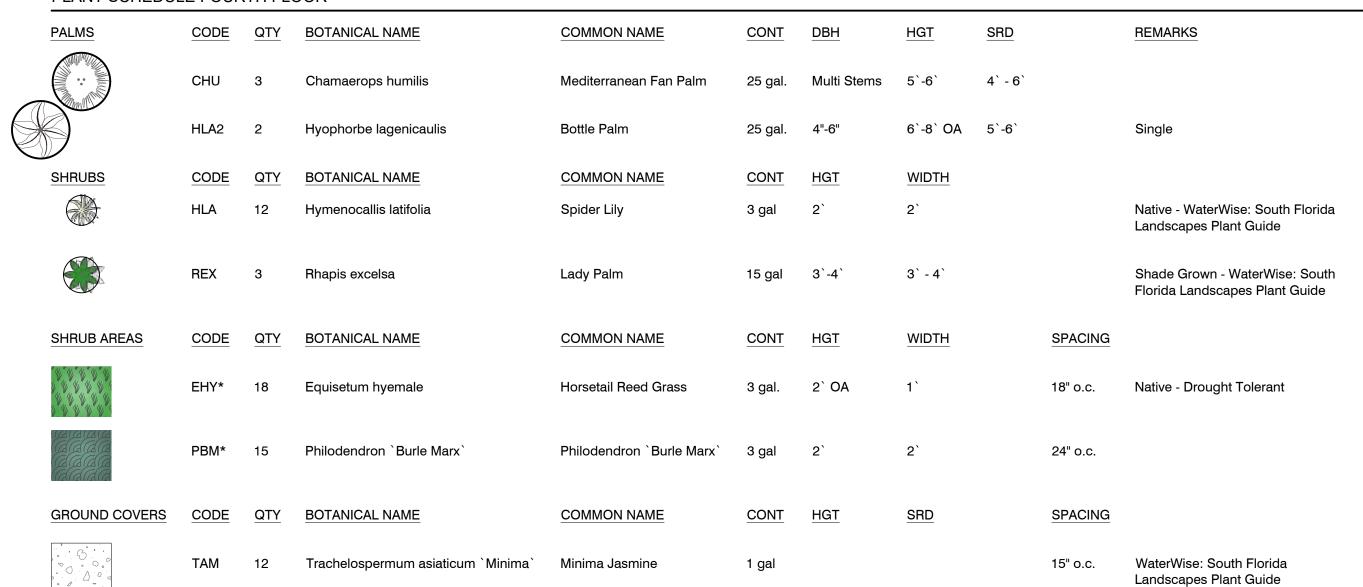


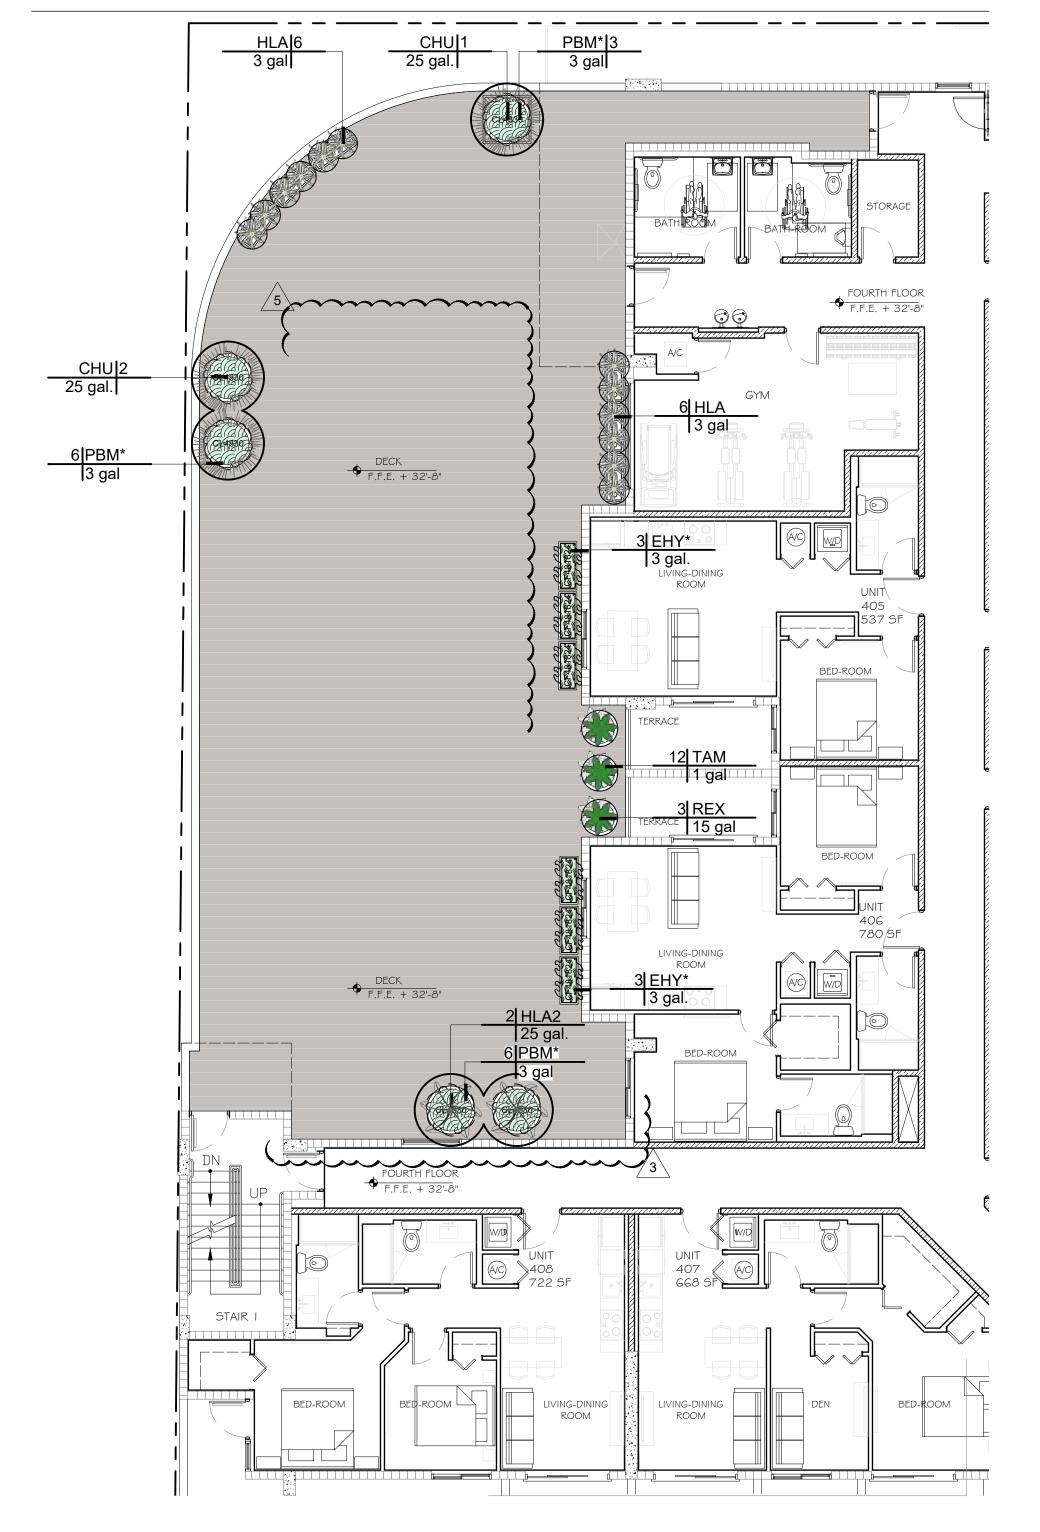

CHU - Mediterranean Fan Palm HLA - Bottle Palm

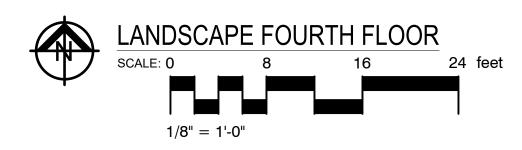

PLANT SCHEDULE F	OURTH FLOOR





Old Town Fiberglass Planter CL4830 CYLINDER WITH RIM 48"DIA. x 30"H **3" RIM** SUB SAUCER Old Town Fiberglass Planter CU3642 CURRENT PLANTER 36" DIA x 42"H x 26" BASE (80 lbs) SUB SAUCER Built in Perforated Sub-floor- Specify Siphon Tube or Drain Plug with Over Flow Plug Old Town Fiberglass Planter CF481824 CARDIFF TAPERED RECTANGLE 48"L x 18"W x 24"H (42 lbs)	SYMBOL	SITE FURNISHINGS DESCRIPTION	QTY	DETAIL
CYLINDER WITH RIM 48"DIA. x 30"H **3" RIM** SUB SAUCER Old Town Fiberglass Planter CU3642 CURRENT PLANTER 36" DIA x 42"H x 26" BASE (80 lbs) SUB SAUCER Built in Perforated Sub-floor- Specify Siphon Tube or Drain Plug with Over Flow Plug Old Town Fiberglass Planter CF481824 6	<u> </u>	<u> </u>	<u> </u>	<u>= = : : : : = : : : : : : : : : : : : :</u>
SUB SAUCER Old Town Fiberglass Planter CU3642 CURRENT PLANTER 36" DIA x 42"H x 26" BASE (80 lbs) SUB SAUCER Built in Perforated Sub-floor- Specify Siphon Tube or Drain Plug with Over Flow Plug Old Town Fiberglass Planter CF481824 6		Old Town Fiberglass Planter CL4830	10	
Old Town Fiberglass Planter CU3642 CURRENT PLANTER 36" DIA x 42"H x 26" BASE (80 lbs) SUB SAUCER Built in Perforated Sub-floor- Specify Siphon Tube or Drain Plug with Over Flow Plug Old Town Fiberglass Planter CF481824 6	((CL4830))	CYLINDER WITH RIM 48"DIA. x 30"H **3" RIM**		
CURRENT PLANTER 36" DIA x 42"H x 26" BASE (80 lbs) SUB SAUCER Built in Perforated Sub-floor- Specify Siphon Tube or Drain Plug with Over Flow Plug Old Town Fiberglass Planter CF481824 6		SUB SAUCER		
SUB SAUCER Built in Perforated Sub-floor- Specify Siphon Tube or Drain Plug with Over Flow Plug Old Town Fiberglass Planter CF481824 6	CF481824	Old Town Fiberglass Planter CU3642	6	
Built in Perforated Sub-floor- Specify Siphon Tube or Drain Plug with Over Flow Plug Old Town Fiberglass Planter CF481824 6				
Over Flow Plug Old Town Fiberglass Planter CF481824 6				
\\ //		, , , , , , , , , , , , , , , , , , ,		
\\ //	CU3642	Old Town Fiberglass Planter CF481824	6	
	00012		Ü	
SUB SAUCER		· · · · · · · · · · · · · · · · · · ·		
Built in Perforated Sub-floor- Specify Siphon Tube or Drain Plug with		Built in Perforated Sub-floor- Specify Siphon Tube or Drain Plug with		

PARK SIDE VEW 1807 MADISON STREET HOLLYWOOD, FL 33020 Drawing Size 24x36 Project #: 2022-12-156 IAAI Drawn By: Checked By: Title: LANDSCAPE NOTES & DETAILS Sheet Number:

L-201A

Date: - March 15, 2023

- 1. All mechanical equipment including, but not limited to Back Flow Preventor, Pumps, Electric, Phone or Cable Boxes, Lift Stations, Etc. shall be screened on 3 sides from view using an approved hedge, fence or wall.
- 2. All light poles if any shown on plan shall be a minimum of 15' from tree locations.
- 3. The Landscape Architect must be notified when the plant material has been set in place to approve final locations, prior to installation.

GENERAL NOTES

- 1. Landscape Contractor is responsible for verifying locations of all underground and overhead utilities and easements prior to commencing work. All Utility companies and/or the General Contractor shall be notified to verify utility locations prior to digging. Utility trenching is to be coordinated with the Landscape plans prior to beginning of project. The Owner or Landscape Architect shall not be responsible for damage to utility or irrigation lines.
- 2. Landscape Contractor shall examine the site and become familiar with conditions affecting the installation prior to submitting bids. Failure to do so shall not be considered cause for change orders.
- 3. Landscape Contractor is responsible for verifying all plant quantities prior to bidding and within (7) seven calendar days of receipt of these plans shall notify the Landscape Architect in writing of any and all discrepancies. In case of discrepancies planting plans shall take precedence over plant list.
- 4. No substitutions are to be made without prior consent of the Landscape Architect. Plant material supply is the responsibility of the Landscape Contractor, and he/she shall take steps to insure availability at time of planting.
- 5. All plant material shall meet or exceed the size on the plant list. In all cases meeting the height and the spread specifications shall take precedence over
- 6. All planted areas to be outfitted with automatic irrigation system providing 100% coverage and 50% overlap. A rain sensor must be part of the irrigation
- 7. Landscape Contractor shall be responsible for providing temporary hand watering to all proposed & landscape areas, during construction.
- 8. The Landscape Contractor is responsible for coordinating tree and palm removals and transplants shown on the Tree/Palm Disposition Plan. The Landscape
- Contractor is to remove and discard from site existing unwanted trees, palms, shrubs, groundcovers, sod and weeds within landscape areas. 9. All permitting and fees to be the responsibility of the Contractor.

PLANTING NOTES

- 1. Landscape Contractor shall furnish and install all trees, palms, shrubs, groundcover, sod, planting soil, herbicide, preemergence herbicide, seed, and mulch.
- Landscape Contractor to provide Landscape Architect with at least 5 days notice prior to tree installation. 2. Landscape Contractor shall guarantee all plant material for a period of one year from the day of final acceptance by the Landscape Architect.
- 3. All plant material shall be Florida #1 or better, as defined in the Grades and Standards for Nursery Plants, Part I and II by the State of Florida Department of
- 4. Landscape Contractor is responsible for scheduling a nursery visit for Landscape Architect to approve all trees, palms and shrubs prior to delivery to the
- Landscape Contractor shall coordinate his work with that of the Irrigation and Landscape Lighting Contractor.
- 6. The Landscape Contractor shall treat planted areas with preemergence herbicide after weeds and grass have been removed. Landscape Contractor shall apply pre emergent herbicide per manufacturer's recommendation, wait period prior to planting as specified. Planting soil mix/backfill shall be clean and free of construction debris, weeds, rock and noxious pests and disease.
- 7. All soil mix in plant beds for ground covers, shrubs, palms and trees shall be as per details. All other areas shall be dressed with a minimum of 4" topsoil "if
- 8. All planting areas and planting pits shall be tested for sufficient percolation prior to final planting and irrigation installation to ensure proper drainage. Plant beds in parking lots and in areas compacted by heavy equipment shall be de-compacted so that drainage is not impeded.
- 9. All synthetic burlap, string, cords or wire baskets shall be removed before trees are planted, without breaking the soil ball. All synthetic tape shall be removed from branches and trunks prior to final acceptance. The top 1/3 of natural burlap shall be removed, after the tree is set in the planting hole and before the tree is backfilled. Landscape Contractor is to check for root defects including deep planting in the root ball and circling roots, trees with root problems will not be accepted.
- 10. Landscape Contractor is responsible for mulching all plant beds and planters with a minimum 3" layer of natural color Eucalyptus or Enviromulch immediately
- after planting. In no case shall Cypress mulch be used. 11. All Trees/Palms in sod areas are to receive a 48" diameter mulched saucer at the base of the trunk respectively.
- 12. Landscape Contractor shall guy and stake all trees and palms as per specifications and details. No nails, screws or wiring shall penetrate the outer surface of trees and palms. All guying and staking shall be removed twelve months after planting.
- 13. All palm and tree guy wires and bracing are to be flagged for visibility, for their duration. All unattended and unplanted tree pits shall be properly barricaded
- and flagged during construction. 14. All broken branches and clear trunk branches on street trees are to be pruned according to ANSI A - 300 Guidelines for Tree Pruning to min. 5' - 0" height
- clearance to the base of canopy. 15. Landscape Contractor shall fertilize plant material as needed to support optimum healthy plant growth. All fertilization shall be performed in compliance with
- the latest ANSI A300 (Part 2) Standards.
- 16. Stake all trees and palms for approval by Landscape Architect prior to installation.
- 17. Any sod areas damaged by construction are to be replaced with St. Augustine 'Floratam' sod.
- 18. All areas within limits of work not covered by walks, buildings, playground, and/or any other hardscape feature shall be sodded with St. Augustine 'Floratam'
- 19. St. Augustine 'Floratam' Contractor's responsibility to verify quantity. 20. Install rootbarrier as per manufacturer's recommendation on all large trees that are 6' or closer to any pavement or building, as shown on details page.
- 21. Root barrier shall be Vespro Inc. or approved equal.



ONE YEAR - TREE MAINTENANCE PLAN All newly planted trees to be guaranteed for a period of one year and in accordance with the following:

- Keep roots moist; **do not** allow the roots to dry out.
- Remove turf from planting area. - Dig planting hole wide and shallow. The hole should be 2-3 times wider in all directions than the root spread.
- Prune only dead or broken branches.
- Remove all twine or rope from trunk and branches. - Remove planting container and burlap (any material that would constrict growth of roots; wire, plastic, wooden basket)
- Make sure that root flare is at soil level. (Rule of thumb first root closest to soil should be an inch below soil surface). - Do not use amendments in the planting hole - Water tree at planting to remove air pockets. After backfilling gently firm soil, do not pack soil. Heavy packing will remove
- air space in -soil. - Do not mound soil against trunk of tree.
- Fertilizer is not recommended for newly planted trees. (Consider time-released fertilizer, if there is a need to fertilize).

- Mulch over entire rooting area with 2-4" of mulch (wood chips, shredded bark, etc.) Keep mulch 2-4" from trunk of tree

After Planting:


since this could create a favorable

- Plants shall be watered in accordance with specification as provided on the irrigation plans.
- All lawn areas shall be mowed weekly during growing season and bi-weekly in non-growing season. - Fertilizer shall be applied in the fall or early spring. Although it is not harmful to apply fertilizer at any time during the year.
- Inspect trees for disease or insect problems. Monitor health and vigor of trees.
- Pruning of all shrubs shall be done regularly to control shape and form.All pruning shall be done in accordance with the American National Standards Institute (ANSI) A-300 standards.


After One Year:

- Continue to monitor trees health and vigor. Inspect for disease and insect problems. Inspect evergreen trees for winter injury and fruit trees for rodent damage.
- Remove tree wrap from thin bark trees in spring.
- Remove stakes from trees planted previous year. - All plants shall be mulched on a yearly basis or as needed to maintain healthy grown and reduce weed growth.
- Begin corrective pruning trees one year after trees are planted (general rule of thumb is to remove no more than $\frac{1}{4}$ of the foliage at one time). All pruning shall
 - be done in accordance with the American National Standards Institute (ANSI) A-300 standards. - Continue watering trees when needed.
- Replace dead trees as needed, If trees have died in first year notify nursery that planted trees. They should guarantee trees for at least one year.




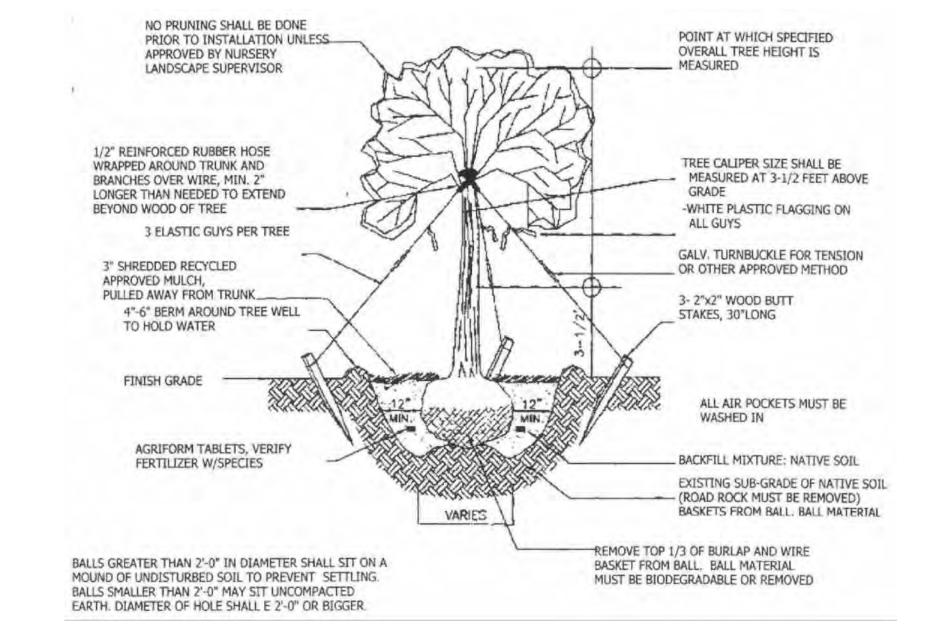


TREE PLANTING DETAIL

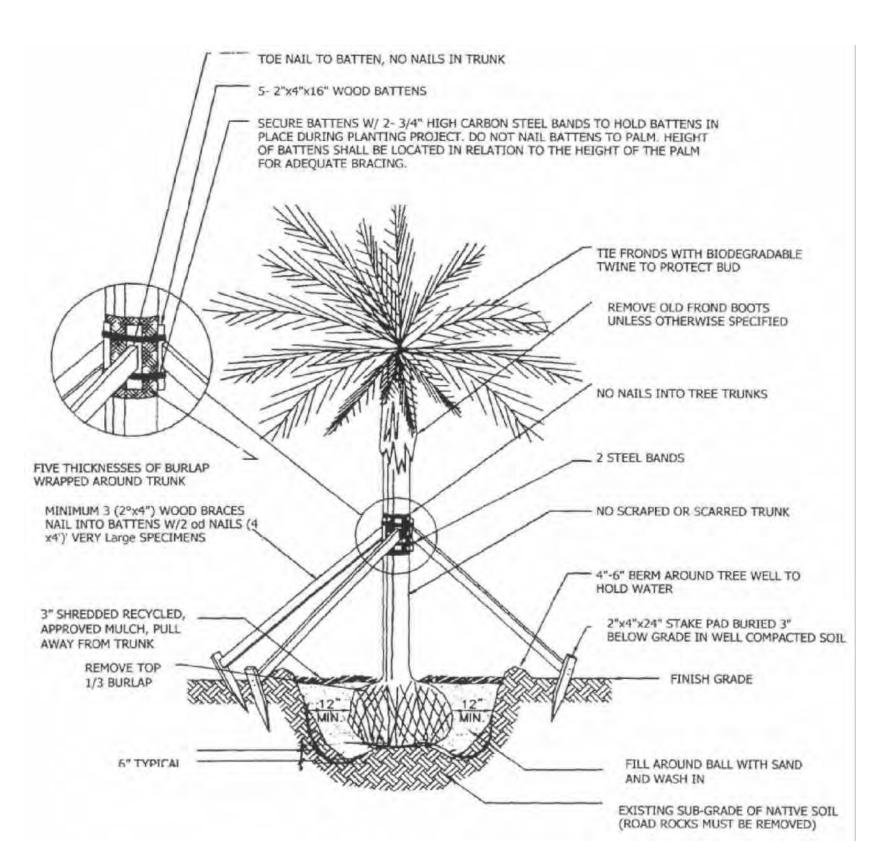




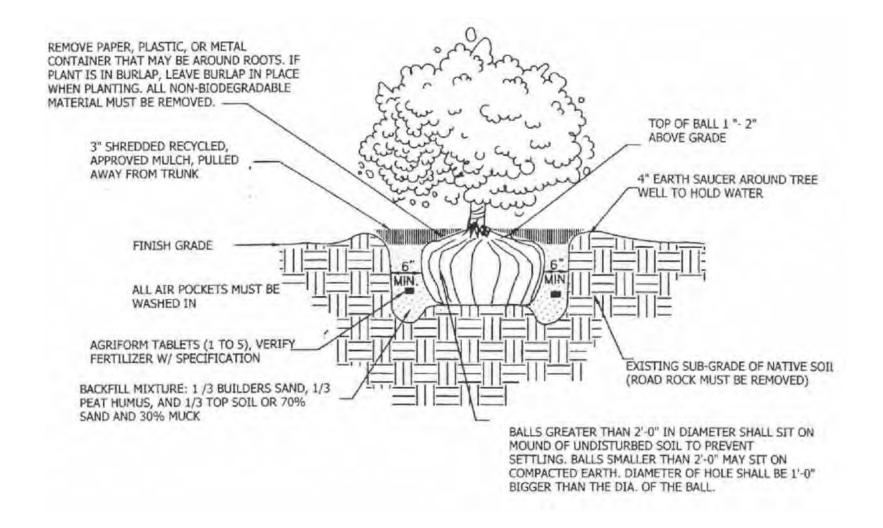


SHRUBS PLANTING DETAIL

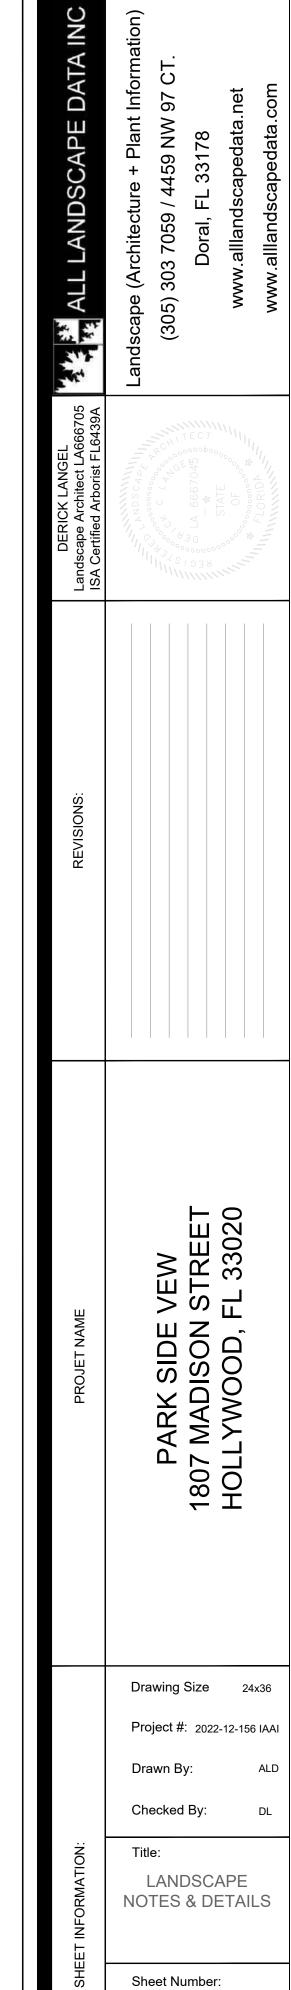

Date: - March 15, 2023

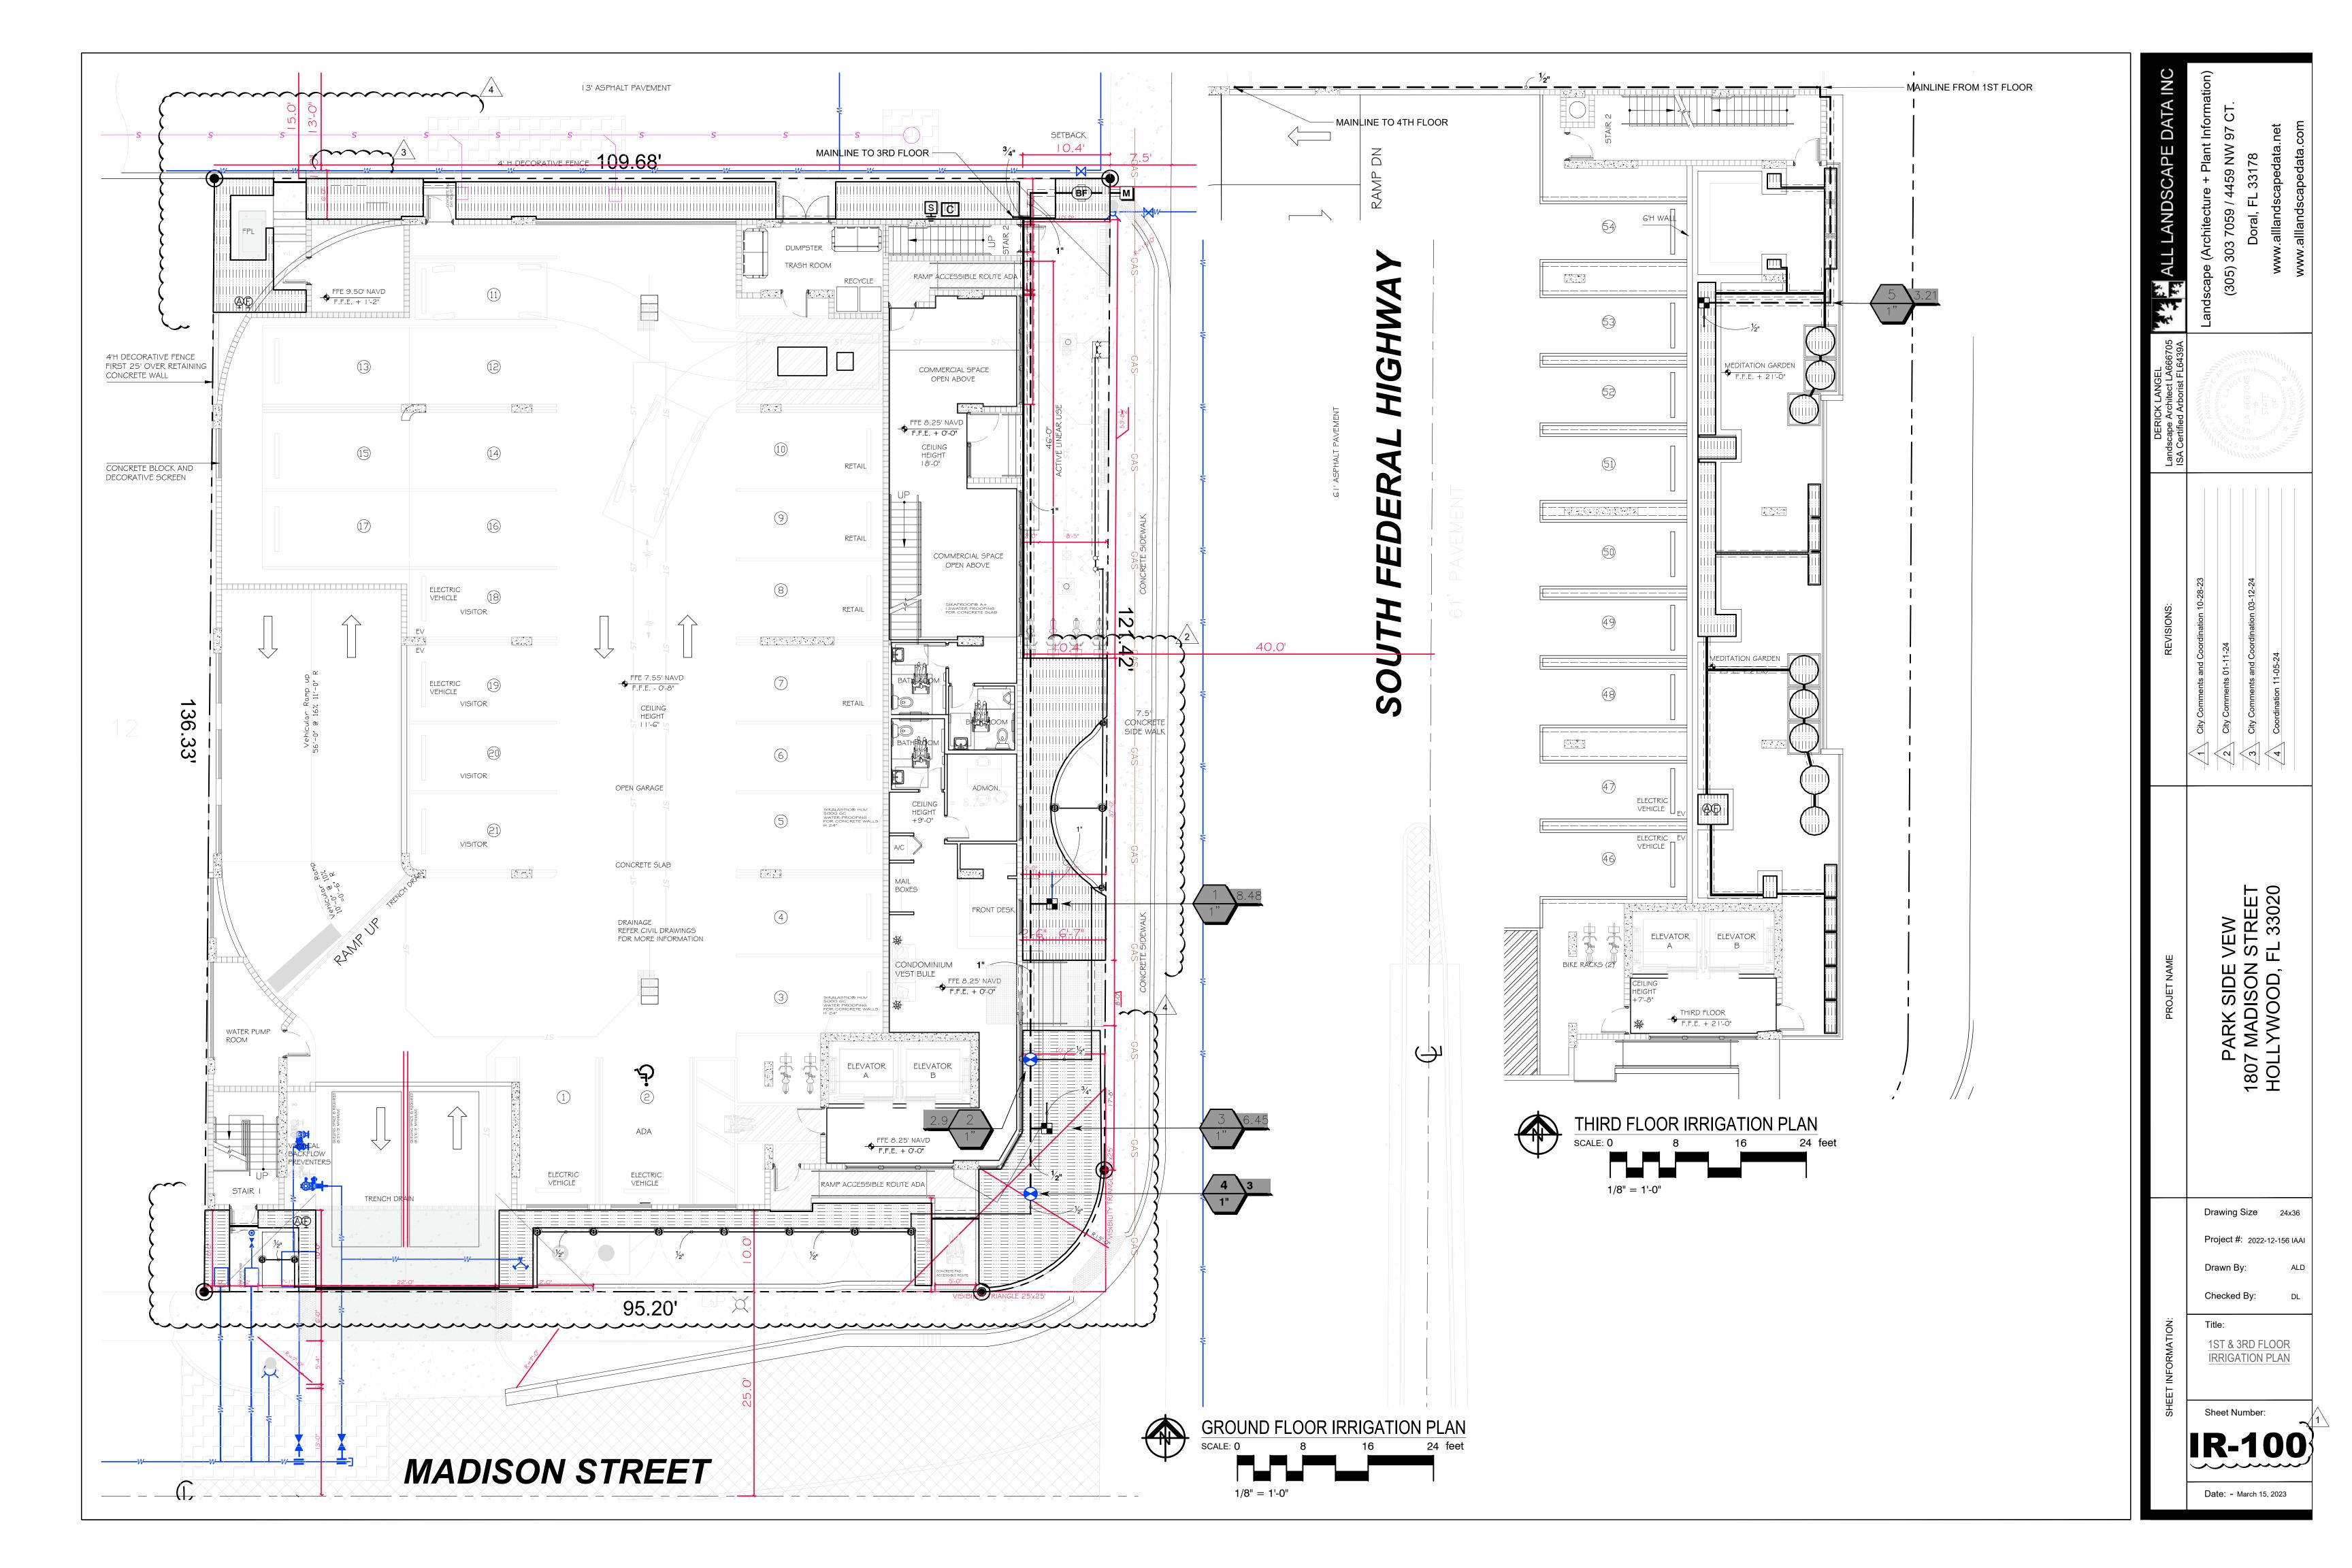

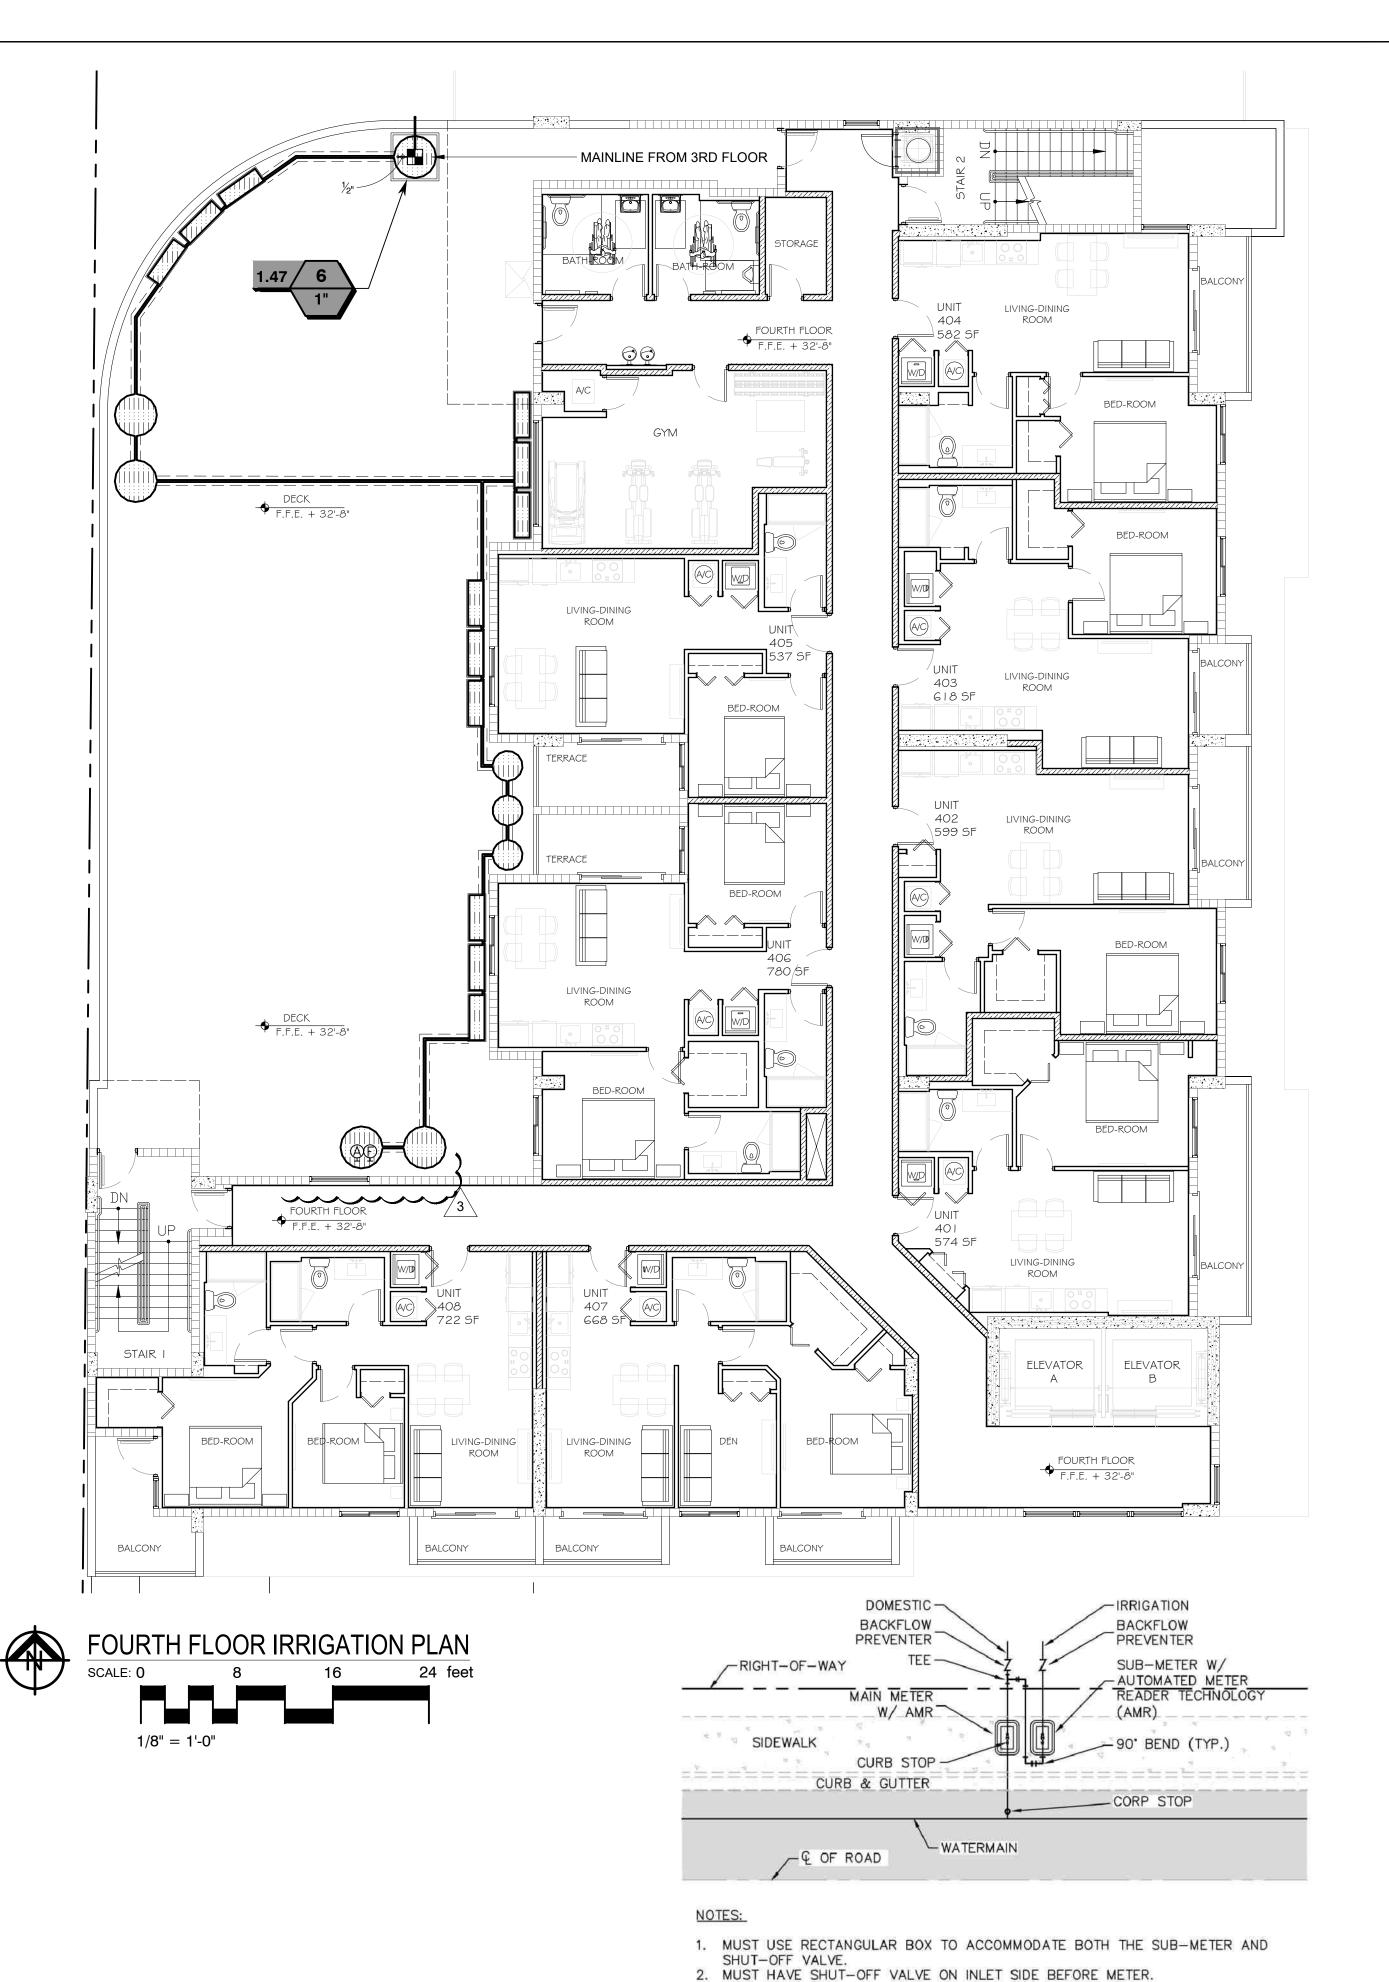

3. MUST PLACE SUB-METER BOX WITHIN 5 FEET OF MAIN METER, EASILY

FOR FINAL INSPECTION IN ORDER TO OBTAIN SEWER CREDIT.

4. MUST CALL METER SHOP AT 305-673-7681 WHEN INSTALLATION IS COMPLETED


SUB-METER INSTALLATION DETAIL

5. SUB-METER CANNOT BE LARGER THAN THE DOMESTIC METER WATER SERVICE

ACCESSIBLE TO METER READER.

SCALE: N.T.S.

ANTI-SIPHON PRESSURE TYPE VACUUM BREAKER METER VAULT CONC. SLAB -PLAN VIEW

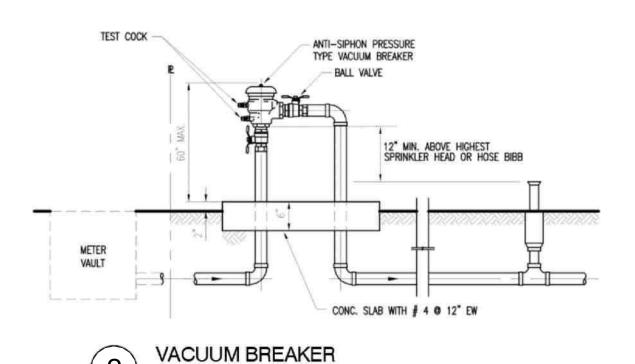

IRRIGATION SHALL BE INSTALLED IN ACCORDANCE WITH LOCAL CODES, CONTRACT DRAWINGS, CONTRACT SPECIFICATIONS, AND APPENDIX "F" OF THE FLORIDA BUILDING CODE.

IRRIGATION DESIGN BASED ON "PLANTING PLAN". CONTRACTOR SHALL REFER TO THIS PLAN TO COORDINATE SPRINKLER LOCATIONS AND PIPE ROUTING WITH NEW AND EXISTING PLANT LOCATIONS.

THIS PLAN SHALL BE USED AS A GUIDE ONLY. IRRIGATION SHALL BE INSTALLED TO MATCH ON SITE CONDITIONS AND TO OVERCOME THE INHERENT INACCURACIES THAT RESULT WHEN DESIGNING FROM BASE PLANS.

THIS IRRIGATION HAS BEEN DESIGNED AS A TYPICAL BLOCK VALVE TYPE USING TORO SPRINKLERS, IN-LINE VALVES AND CONTROL SYSTEM. A RAIN SENSOR SHALL BE INSTALLED TO CONSERVE WATER.

IRRIGATION SHALL BE INSTALLED AND MAINTAINED TO MINIMIZE UNDESIRABLE OVERTHROW ONTO PAVEMENT, SIDEWALKS, AND BUILDINGS.

CONTRACTOR SHALL VISIT THE SITE TO BECOME FAMILIAR WITH SITE CONDITIONS, AND SHALL REFER TO THE PLANS FOR ADDITIONAL INFORMATION.

TO ENSURE PROPER OPERATION, SOURCE SIZE,

VALVE SIZES, ZONE CAPACITIES, AND SPRINKLER. PIPE AND WIRE SIZES, AND INSTALLATION NOTES AND DETAILS SHALL BE FOLLOWED AS SHOWN. CONTRACTOR IS TO PROVIDE AN AS-BUILT

DRAWING OF THE IRRIGATION SYSTEM TO THE OWNER AND LANDSCAPE ARCHITECT.

PIPE ROUTING IS SCHEMATIC ONLY AND SHALL BE ADJUSTED FOR ON SITE CONDITIONS.

PIPE SHALL BE INSTALLED IN ACCORDANCE WITH LOCAL CODES, SECTION "F" OF THE FLORIDA BUILDING CODE, AND PIPE MANUFACTURER'S INSTRUCTIONS.

PIPE ROUTED UNDER HARDSCAPED AREAS SHALL BE SLEEVED IN SCH 40 PVC. EACH SLEEVE SHALL BE: (1) BURIED TO A MINIMUM DEPTH OF 24", (2) TWO PIPE SIZES LARGER THAN CARRIER PIPE, AND (3) EXTENDED 3' BEYOND HARDSCAPED AREA ON EACH END. CONTRACTOR SHALL REFER TO LOCATION OF EXISTING SLEEVES.

PIPE SIZED TO LIMIT FLOW VELOCITIES TO 5 FEET/SECOND AND TO LIMIT FRICTION LOSS IN THE PIPING NETWORK.

PIPE SHALL BE INSTALLED AT SUFFICIENT DEPTH BELOW GROUND TO PROTECT IT FROM HAZARD SUCH AS VEHICULAR TRAFFIC OR ROUTINE OCCURRENCES WHICH OCCUR IN THE NORMAL USE AND MAINTENANCE OF THE PROPERTY. DEPTHS OF COVER SHALL MEET OR EXCEED SCS CODE 430-DD. REFER TO THE APPLICABLE DETAIL FOR ADDITIONAL INFORMATION.

BACKFILL SHALL BE OF SUITABLE MATERIAL, FREE OF ROCKS, STONES, AND OTHER DEBRIS THAT WOULD DAMAGE IRRIGATION SYSTEM COMPONENTS.

A GATE VALVE SHALL BE INSTALLED FOR ISOLATION. THIS VALVE SHALL BE TO LINE SIZE AND INSTALLED IN A VALVE BOX. POROUS MATERIAL SHALL BE INSTALLED PER BOX TO PROMOTE DRAINAGE.

SPRINKLER LOCATIONS ARE SCHEMATIC ONLY AND SHALL BE ADJUSTED FOR LANDSCAPING, FENCES, SITE LIGHTING, PREVAILING WIND, MOUNDING, ETC., TO ENSURE PROPER COVERAGE WITH MINIMAL UNDESIRABLE OVERTHROW. A PRIME OBJECTIVE SHALL BE TO ELIMINATE OVERTHROW ONTO PAVEMENT, SIDEWALKS, AND THE RESIDENCE.

POP-UP TYPE LOCATED IN SOD, MULCH, AND GROUND COVERS SHALL BE INSTALLED ON FLEXIBLE SWING JOINTS CONSISTING OF THICKWALLED POLY PIPE AND 1/2" INSERT ELBOWS.

EACH SPRINKLER SHALL BE EQUIPPED WITH THE APPROPRIATE PRECISION SPRAY NOZZLE AND SHALL HAVE THE X-FLOW FEATURE.

ADJUSTMENT FEATURES OF SPRINKLERS SPECIFIED SHALL BE UTILIZED TO ENSURE PROPER COVERAGE WITH MINIMAL UNDESIRABLE OVERTHROW. LOW ANGLE, FLAT SPRAY, AND ADJUSTABLE ARC NOZZLES SHALL BE USED TO MINIMIZE OVERTHROW.

SPRINKLERS LOCATED ADJACENT TO HARDSCAPED AREAS SHALL BE INSTALLED AWAY FROM HARDSCAPED AREAS TO MINIMIZE OVERTHROW AND THE CHANCE OF DAMAGE BY VEHICLES, PEDESTRIANS, AND LAWN MAINTENANCE PRESONNEL. AS A GENERAL RULE, 6" POP-UP SPRAY HEADS SHALL BE INSTALLED IN 4". SHRUB HEADS AND 12" POP-UP SPRAY HEADS SHALL BE INSTALLED IN 12".

CONTROLLER SHALL BE INSTALLED IN ACCORDANCE WITH LOCAL CODES AND MANUFACTURER'S INSTRUCTIONS. PROPER GROUNDING EQUIPMENT SHALL BE PROVIDED.

CONTROLLER LOCATION SHALL BE APPROVED BY THE OWNER'S REPRESENTATIVE. A 110 VAC ELECTRIC SOURCE IS REQUIRED.


CONTROL LINES FROM AUTOMATIC CONTROLLER TO IN-LINE AUTOMATIC VALVES SHALL BE #14 AWG DIRECT BURIAL UF TYPE WHICH SHALL BE: (1) INSTALLED IN ACCORDANCE WITH LOCAL CODES, (2) INSTALLED IN SCH 40 PVC WIRE CONDUIT, (3) BURIED TO A MINIMUM DEPTH OF 15", (4) COLORED CODED TO FACILITATE TROUBLESHOOTING, AND (5) SPLICED MOSTLY AT VALVE LOCATIONS. SPLICES SHALL BE MADE WATERPROOF USING APPROVED METHODS. SPARE WIRES SHALL BE ROUTED FROM THE CONTROLLER IN ALL DIRECTIONS TO THE FARTHEST VALVES CONTROLLED.

AN INDIVIDUAL CONTROL WIRE SHALL BE ROUTED TO EACH VALVE AND VALVES WHICH OPERATE SIMULTANEOUSLY SHALL BE TEED TOGETHER AT THE CONTROLLER.

AUTOMATIC VALVE LOCATIONS ARE SCHEMATIC ONLY AND SHALL BE ADJUSTED FOR ON SITE CONDITIONS. EACH VALVE SHALL BE INSTALLED IN A VALVE BOX. A MINIMUM OF ONE CUBIC FOOT OF GRAVEL SHALL BE PROVIDED PER BOX TO PROMOTE DRAINAGE.

THE RAIN SENSOR SHALL BE INSTALLED IN ACCORDANCE WITH MANUFACTURER'S INSTRUCTIONS.

TIMING AND PRECIPITATION TIMING OF EACH STATION SHALL BE SET IN THE FIELD TO MATCH LOCAL REQUIREMENTS. REFER TO ZONE SUMMARY CHART FOR RECOMMENDED RUN TIMES TO APPLY 1.0 INCHES/WEEK.

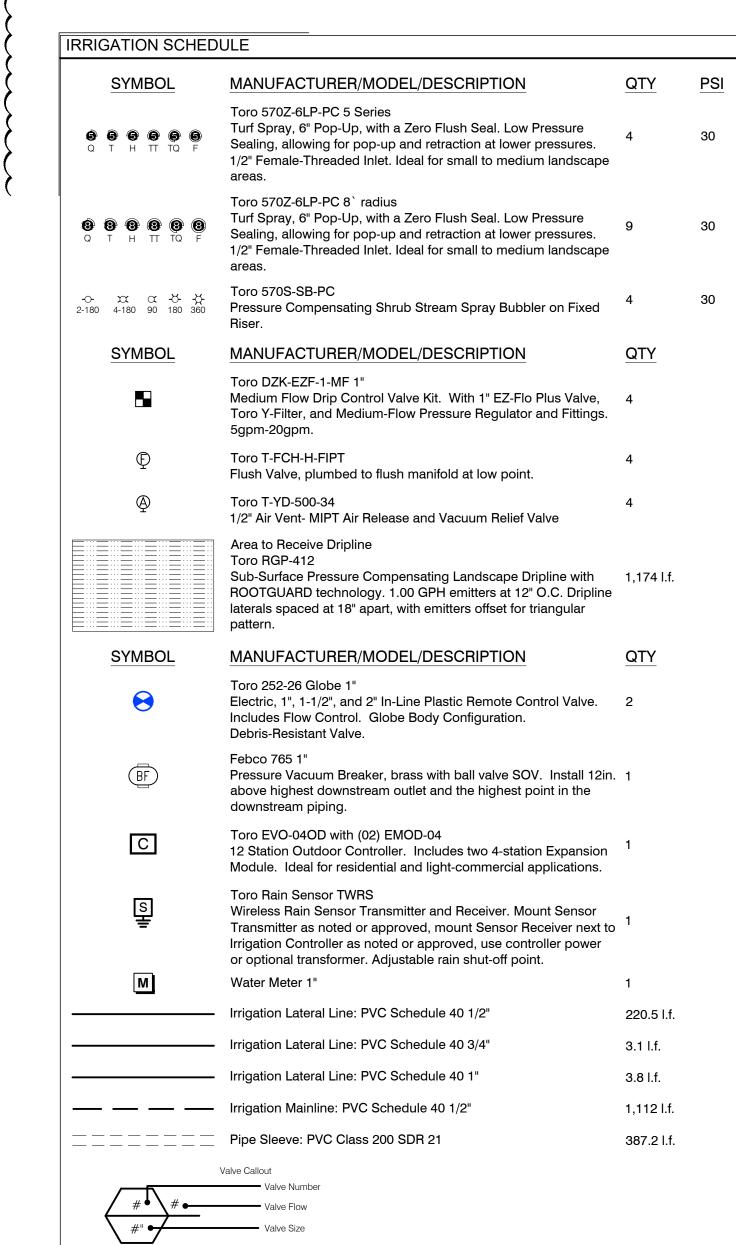

DATA

180 HOI

Drawing Size 24x36

Project #: 2022-12-156 IAAI

FOURTH FLOOR

IRRIGATION PLAN

NOTES

& SCHEDULE

Sheet Number:

Date: - March 15, 2023

Drawn By:

Title:

Checked By:


VALVE SCHEDULE	

NUMBER	MODEL	SIZE	TYPE	GPM	WIRE	PSI	PSI @ POC	PRECIF
1	Toro DZK-EZF-1-MF	1"	Area for Dripline	8.48	842.4	47.6		1.07 in/h
2	Toro 252-26 Globe	1"	Turf Spray	2.9	858.8	35.1		1.67 in/h
3	Toro DZK-EZF-1-MF	1"	Area for Dripline	6.45	869.2	43.2		1.07 in/h
4	Toro 252-26 Globe	1"	Turf Spray	3	875.2	34.5		0.7 in/h
5	Toro DZK-EZF-1-MF	1"	Area for Dripline	3.21	799.1	39.6		1.07 in/h
6	Toro DZK-EZF-1-MF	1"	Area for Dripline	1.47	937.7	38.9		1.07 in/h
	Common Wire		·		1,112			,

- 2. GUARD POSTS SHALL BE INSTALLED IF THE ASSEMBLY IS EXPOSED TO POSSIBLE DAMAGE FROM VEHICULAR TRAFFIC, AS DETERMINED BY THE DEPARTMENT.
- 3. THE ASSEMBLY SHALL BE INSTALLED IN AN ACCESSIBLE LOCATION, APPROVED BY THE DEPARTMENT.
- 4. PIPING SHALL BE SCHEDULE 40 BRASS OR TYPE K COPPER PIPE WITH THREADED FITTINGS IN ACCORDANCE WITH WASD CONSTRUCTION SPECIFICATIONS FOR DONATION WATER MAINS. PVC PIPING IS NOT ACCEPTED BY WASD.
- 5. THE DEPARTMENT SHALL HAVE UNRESTRICTED AND CONTINUOUS ACCESS TO THE VACUUM BREAKER
- 6. SEE SPECIFICATIONS AND CONTACT DEPARTMENT FOR CURRENTLY APPROVED TYPES OF BACKFLOW PREVENTION ASSEMBLIES AND PRESSURE VACUUM BREAKERS (SEE WS 4.18 SHEET 4 OF 4)

1 THE ASSEMBLY SHALL BE INSTALLED WITH MINIMUM HORIZONTAL CLEARANCES OF 30 INCHES FREE FROM OBSTRUCTIONS IN ALL DIRECTIONS.

IRRIGATION NOTES

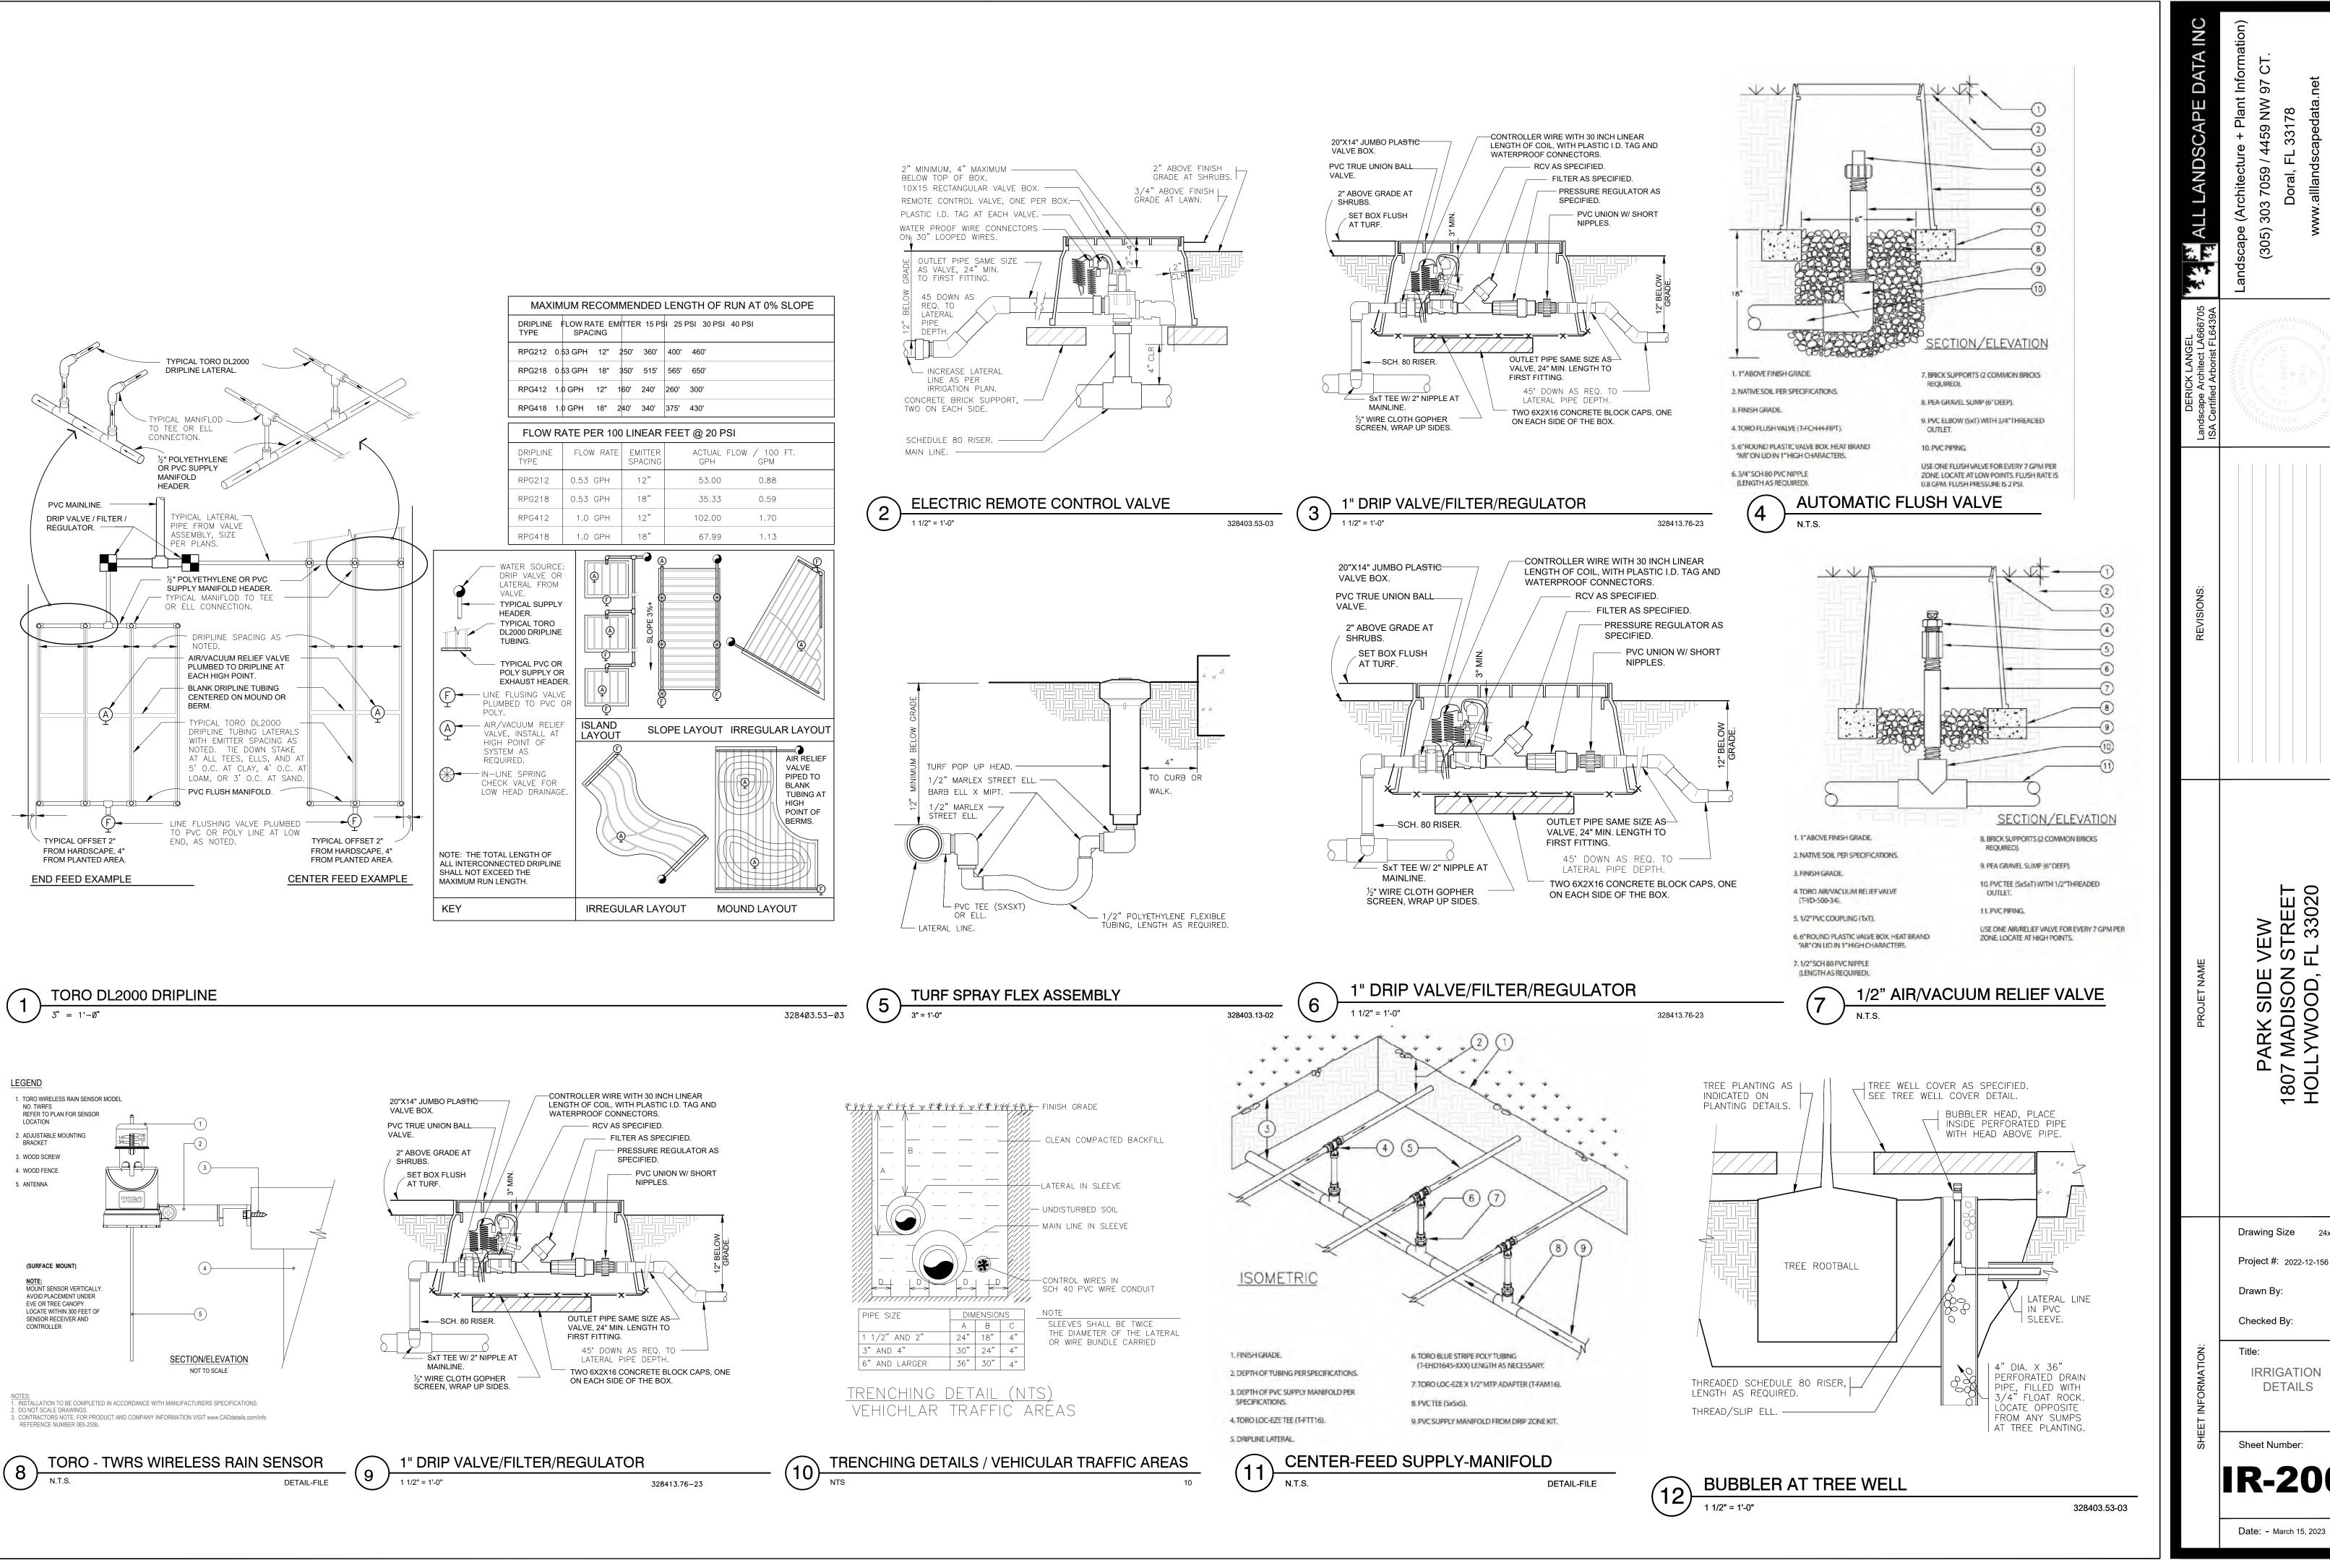

Drawing Size Project #: 2022-12-156 IAAI Drawn By: Checked By: IRRIGATION **DETAILS** Sheet Number: