


GENERAL APPLICATION

AP	PLICATION DATE:	ANUARY 5 2024	
Ro	00 Hollywood Blvd om 315 ollywood, FL 33022	APPLICATION TYPE: ☑ Technical Advisory Committe ☐ City Commission	□ Variance/Special Exception Requested □ Administrative Approvals □ Historic Preservation Board □ Planning and Development Board
Em Ho	l: (954) 921-3471 nail: Development@ illywoodfl.org BMISSION REQUIREMENTS:	Lot(s): 7 Blo Folio Number(s): 5141241201	oroke Rd Hollywood, FI 33023 ock(s): Subdivision: 30; 514124120140; 51414120150 120170;514125120180; 514124120181
	One set of digitally signed & sealed plans (i.e. Architect or Engineer) One electronic combined PDF submission (max. 25mb)	Existing Property Use: Vaca Is the request the result of a violati	Land Use Classification: Reatil Sq Ft/Number of Units: 0 / N/A on notice? () Yes () No If yes, attach a copy of violation to the City before? If yes, check all that apply and provide
•	Completed Application Checklist Application fee (per review)	DEVELOPMENT PROPOSAL Explanation of Request: Comerc	
		Project	Proposal (Array 5 000 C.F.)
NO	TE:	Units/rooms (# of units) Proposed Non-Residential Uses	10 (Area: 5.000 S.F.) Shopping S.F.
	This application must be completed in full and submitted with all documents to be placed on a Board or Committee's agenda.	Open Space (% and SQ.FT.) Parking (# of spaces) Height (# of stories)	32% (Area: 6.805 S.F.) 21 + Driveway area (Area: 8.700 S.F.) 1 (5.000 FT.)
	The applicant is responsible for obtaining the appropriate checklist for each type of application.	Name of Current Property Owner Address of Property Owner: Calle Telephone: 573127771807 En	: OB HOUSE LLC 8 # 38-90 Santillana de los vientos casa 21 CO mail Address: andresorozcoa@hotmail.com
	Applicant(s) or their authorized legal agent must be present at all Board or Committee meetings.	Applicant Alexander Mendez Address: 17138 sw 93rd st Mi Email Address: alexandermend Email Address #2: Date of Purchase: 2018	Consultant Representative Tenant (check one) iami fl 33196
FOF	CK HERE FOR RMS, CHECKLISTS, & ETING DATES	If Yes, Attach Copy of the Contract. Noticing Agent (FTAC & Board su E-mail Address:	bmissions only) :

PLANNING DIVISION

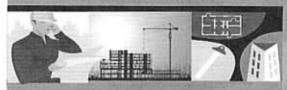

2600 Hollywood Boulevard Room 315 Hollywood, FL 33022

Notary Public - State of Florida

Commission # HH 457284
My Comm. Expires Nov 18, 2027
Bonded through National Notary Asso.

File No. (internal use only):

GENERAL APPLICATION

CERTIFICATION OF COMPLIANCE WITH APPLICABLE REGULATIONS

The applicant/owner(s) signature certifies that he/she has been made aware of the criteria, regulations and guidelines applicable to the request. This information can be obtained in Room 315 of City Hall or on our website at www.hollywoodfl.org. The owner(s) further certifies that when required by applicable law, including but not limited to the City's Zoning and Land Development Regulations, they will post the site with a sign as approved by the Division of Planning & Urban Design. The owner(s) will photograph the sign the day of posting and submit photographs to the Office of Planning and Development Services as required by applicable law. Failure to post the sign will result in violation of State and Municipal Notification Requirements and Laws.

(I)(We) certify that (I) (we) understand and will comply with the provisions and regulations of the City's Zoning and Land Development Regulations, Design Guidelines, Design Guidelines for Historic Properties and City's Comprehensive Plan as they apply to this project. (I)(We) further certify that the above statements and drawings made on any paper or plans submitted herewith are true to the best of (my)(our) knowledge. (I)(We) understand that the application and attachments become part of the official public records of the City and are not returnable.

PRINT NAME: ANDRES OROZCO BETANCOURT ANGELA	Date: February 20 2024
Signature of Consultant/Representative:	Date: February 20 2024
RINT NAME: ALEXANDER MENDEZ	Date: February 20 2024
Signature of Tenant:	Date:
PRINT NAME:	Date:
Current Owner Power of Attorney	50 50 50 50 50 50 50 50 50 50 50 50 50 5
am the current owner of the described real property and that I am aware of the Hollywood City fl Planning Division to my property, which is hereby made Alexander Mendez to be my legal representative before the TAC Committee) relative to all matters concerning this application.	nature and effect the request fo
am the current owner of the described real property and that I am aware of the Hollywood City fl Planning Division to my property, which is hereby made Alexander Mendez to be my legal representative before the TAR Committee) relative to all matters concerning this application. Sworn to and subscribed before me his 20 day of February 2024 ANGELA HA BETALLOWET A	e nature and effect the request for by me or I am hereby authorizing (Board and/o
am the current owner of the described real property and that I am aware of the Hollywood City fl Planning Division to my property, which is hereby made Alexander Mendez to be my legal representative before the TACCOMMITTEE TAIL COMMITTEE TO BE ANGELA HA BETANCOVET	e nature and effect the request for by me or I am hereby authorizing Committee (Board and/o

Notary Public - State of Florida

MY COMMISSION # HH 310252



TECHNICAL ADVISORY COMMITTEE REPORT

January 22, 2024

OB House LLC. 17138 SW 93rd Street Miami, FL 33196

FILE NUMBER: 24-DP-01

SUBJECT: Preliminary Site Plan review for a building of approximately 5,250 square feet.

SITE DATA

Owner/Applicant: OB House LLC.

Address/Location: 5701 Pembroke Road

Net Size of Property: 21,251 sq. ft. (0.49 acres)

Land Use: Regional Activity Center (RAC)

Zoning: Medium Intensity Commercial District (C-3)

Present Use of Land: Vacant Year Built: N/A

ADJACENT LAND USE

North: Low Residential (LRES) South: City of West Park

East: General Business (GBUS)
West: General Business (GBUS)

ADJACENT ZONING

North: Single Family Residencial (RS-6)

South: City of West Park

East: Medium Intensity Commercial District (C-3)
West: Medium Intensity Commercial District (C-3)

APPLICANTS MUST ADDRESS ALL COMMENTS AND FINDINGS AS IDENTIFIED BY MEMBERS OF THE TECHNICAL ADVISORY COMMITTEE BOTH IN WRITING (IDENTIFY PAGE NUMBER OF THE CORRECTION) AND ON THE SITE PLAN (ALL CHANGES MUST BE IDENTIFIED, I.E. BUBBLED). City of Hollywood May 8th, 2024

Division of Planning and Urban Design Technical Advisory Committee 2600 Hollywood Boulevard, Room 315 Hollywood, FL 33022-9045

Subject: (Proposed) OB House LLC, Commercial Shopping Center located at 5701 Pembroke Road, Hollywood, Florida 33907.

To Whom it may concern,

I am writing to you on behalf of OB House LLC, regarding the above-referenced project. Our purpose is to address and resubmit supporting documentation in response to the Technical Advisory Committee Review Comments. Enclosed within this resubmission are the following documents:

1. Comment and Response Log; We have responded to the Preliminary Technical Advisory Committee Comments.

2. Revised Project Drawings:

- a. Dimensioned Typical Floor Plans
- b. Street Profile and Elevation
- c. Dimensioned Landscape Plans
- d. Dimensioned Schematic Paving, Grading, and Drainage Plan

3. Color Rendering

4. Public Notice; Mailing Notification and Property Posting Requirements

We are committed to working closely with the City of Hollywood's Division of Planning and Urban Design and the Technical Advisory Committee to ensure the successful approval of this application and the overall completion of this project. Should you have any questions or require further clarification, please do not hesitate to contact me directly.

Sincerely,

Alexander Mendez

OB House, LLC Authorized Representative alexandermendezz@yahoo.com

786.312.4813

APPLICATION SUBMITTAL

Application Form:

- A. On the Application, under units and proposal, shall be N/A, since this is a commercial building.
 - Acknowledged. The application was updated and re-submitted.
- B. Existing property use is "vacant".
 - Acknowledged. The application was updated and shows the property as "vacant."
- C. Name of Current Property Owner correct name per Title Insurance and BCPA, name is listed as "OB House LLC".
 - Acknowledged. The application was revised and shows the correct property owner name.
- D. Who are the authorized agents to sign on behalf of OB House LLC. Provide Sunbiz information.
 - According to Sunbiz, the authorized agents to sign on behalf of OB House LLC are both Andres Orozco and Angela Betancourt.
- E. If there are multiple owners, provide a signed and notarized Certification of Compliance with Applicable Regulations form for all owners, including proof the signatory is authorized to sign for the owner. DONE
 - A notarized certification of compliance with applicable regulations form for both owners, including proof that the signatories are authorized to sign, has been submitted.

Ownership and Encumbrance Report:

- A. Indicate it was searched from time of platting or 1953 (earliest of the two). DONE
 - Broward County's Platting Determination Letter will be attached to this package.
- B. Who prepared the Ownership and Encumbrance Report and date. DONE
 - Acknowledged. Ownership and Encumbrance Report will be attached to this package. Report was prepared by Home Sweet Home Tilte, LLC on November 7,2023.
- C. Names of all current owners. DONE
 - Acknowledged. Current owners will be reflected in the Ownership and Encumbrance Report.
- D. Work with the Engineering Division to ensure the O&E is accurate and all easements and dedications are indicated. DONE
 - Coordination efforts with the Engineering Division and communications are attached to this package showing proof of the nonexistence of easements in the property as per the Engineering Division's records.
- E. Ensure O&E addresses the requirements on the TAC submittal checklist: http://www.hollywoodfl.org/ArchiveCenter/ViewFile/Item/453.
 - o Acknowledged.

Alta Survey:

- A. Work with the Engineering Division to ensure the survey includes the appropriate elements such as all easements and dedications are indicated. COMPLETED
 - Coordination efforts with the Engineering Division and communications are attached to this package showing proof of the nonexistence of easements in the property as per the Engineering Division's records.
- B. Provide plat determination letter from the County. Should platting be necessary, prior to Final TAC submittal County Plat comments are required. Plat shall be submitted for recordation prior to submitting for Planning and Development Board. Include several copies of plat documents in future submittals. COMPLETED
 - o Broward County's Platting Determination Letter will be attached to this package.
- C. Indicate past, current and future meeting dates as they happen (not submittal dates) on Cover Sheet. Indicate specific Board/Committee (i.e. TAC, PDB, etc.) For future Board/Committee dates not known, leave blank until staff has advised of the next meeting date.
- D. A public participation outreach meeting shall be required for Land Use, Rezoning, Special Exception, and Site Plan requests. Applicants shall conduct at least one public participation outreach meeting and provide mailed written notice to all property owners and certified/registered civic and neighborhood association(s) within 500 feet of the proposed project. Fifteen days prior to the meeting, the applicant shall mail such notice and post a sign on the property, including the date, time, and place of the public participation outreach meeting. Such meeting shall occur prior to the applicable Committee, Board or City Commission submittal and the Applicant shall include in its application packet a letter certifying the date(s), time(s), location(s), a copy of the sign-in sheet, presentation material and general summary of the discussion, including the Visit comments expressed during meeting(s). http://www.hollywoodfl.org/204/Neighborhood-Association-Contact-List Contact Information, COMPLETED
 - The public participation outreach meeting, including mailed written notice to all property owners and associations within 500 feet, posted sign on the property, and corresponding letter in the application packet has been completed and submitted. Proof of the public participation outreach communication efforts will be attached to this package.

Zoning:

- 1. Provide a Unity Title. Please refer to the Unity Title PDF.
 - Acknowledged. Unity Title will be attached to this package.

2. Site Plan.

- A. Include a note on the site plan indicating that all changes to the design will require planning review and may be subject to Board approval. DONE
- Acknowledged. On the right side of the page, in between the location map and zoning legend, a circled note indicating all changes to the design will require planning review and may be subject to Board approval.
- B. The front setback required is 15 ft. and the rear setback adjacent to a residential district is 15 ft. DONE
- Acknowledged. On the zoning legend, it specifies the 15.0 ft. setbacks required, front and rear, alongside the provided setback specifications: 15.0 ft. for the front setback and 56.0 ft. for the rear setback adjacent to a residential district. The distances have also been specified in the site plan.
- C. The queuing of the vehicles at the entrance and exit shall not block a parking space. DONE
- Acknowledged. Please refer to the site plan SP-01.
- D. The two-way drive shall be 24 ft. min. DONE
- Acknowledged. Below parking space #13, the circled line indicates that the two-way drive measures 24.0 ft., as specified on the site plan.
- E. Provide visibility triangles at all driveway accesses. Indicate the curbing around the parking spaces. Wheel stops are not necessary. DONE.
- The visibility triangles can be seen next to the main entrance on the right side of the site plan and handicapped parking spot, by S 57th Avenue. The curbing around the parking has been indicated please refer to SP-01 by parking number
 13
- F. Provide Vehicular Use Area (VUA). Provide 25% of landscape area. Provide calculations. Landscape areas for VUA shall not include landscape buffers. DONE
- In the legend, under Site Area Calculations, the landscape area, or "Green Area" meets and notes the 25.00% requirement. Vehicular Use Area is under "Driveway & Parking Spaces," noted to be 40.93%. These can be seen on the site plan as well.
- G. Dimension of ADA shall be 12 ft. plus 5 ft. stripe area. DONE
- ADA specification can be noted through symbol on lower right hand corner of the site plan. The 12 ft. plus 5 ft. stripe area is noted as well.
- H. Rear sidewalk behind the building is 2'-7", it shall be wider at least 3 ft. Please see Engineering comments. DONE
- The rear sidewalk behind the building has been accommodated to 4.0 ft.

- Dumpster location shall face the interior of the lot for pickup. The truck shall not block vehicle or pedestrian traffic. Please see comments from Public Works. DONE
- The dumpster has been relocated to meet the requirement of facing the interior of the lot for pickup. It is found in the top left of the site plan, with sufficient space not blocking vehicle or pedestrian traffic. A no parking area has been designated underneath as well.
- 3. Site Tabular Data.
 - A. Legal description shall be revised to match the survey. Done
- 4. The curb cuts are exceeding the curb cut allowed which is 30% of the lot width.
 - A. Acknowledged, The curb cuts have been reduced meet the 30% requirement.
- 5. Work with the City's Landscape Architect to ensure that all landscape requirements are met. Please refer to the Landscape Plans that have been attached.

ARCHITECTURE AND URBAN DESIGN

- A. Include the property lines and setbacks to the building and balconies on the floor plans and elevations.
 - Property lines and setbacks to the building are included in the floor plan. For elevations, please refer to pages A-5.0 and A-6.0. Balconies not applicable on this project.
- B. The elevations shall be labeled east, west, south, and north. DONE
 - Refer to page A-5.0 to see the east, west, south, and north elevations.
- C. No color schedule was provided. Consider adding additional colors and finishes for the building, rather than stucco.
 - Acknowledged, please refer to page A-9.0.
- D. Provide color, finish, and materials legend for all elevations. This should not be limited to paint colors and shall include all finishes/materials. DONE
 - a. Acknowledged, Please refer to page A-9.0.
- E. What material is the awning in the rear? DONE
 - The solid awning in the rear will be made of aluminum material.
- F. Ensure that all plumbing, mechanical, and electrical fixtures and equipment are indicated on the Site Plan and Elevations.
 - For electrical please refer to pages E-1.0 E-2.0 E-3.0 E-4.0, For Plumbing refer to P-1.0 P-2.0 P-3.0 P-4.0 and for mechanical please refer to M-1.0 M-2.0.
- G. Work with the Building Department to ensure that adequate ventilation is provided for the parking garage.
 - Not Applicable.

SIGNAGE

A. Provide the following note: "All signage shall be in compliance with the Zoning and Land Development regulations". DONE

- a. Note is added towards the right of the site plan, above the Zoning Legend, on page ST-1.0
- B. Provide note on Site Plan: "All signs, which are electrically illuminated by neon or other means, shall require a separate electrical permit and inspection. Separate permits are required for each sign." DONE
 - a. Note is added towards the right of the site plan, above the Zoning Legend, on page ST-1.0

LIGHTNING

- A. Provide note on Site Plan: "Maximum foot candle level at all property lines maximum 0.5 if adjacent to residential". DONE
 - Note is added towards the right of the site plan, above the Zoning Legend, on page ST-1.0

GREEN BUILDING & ENVIRONMENTAL SUSTAINABILITY

- A. Indicate on the site plan where the infrastructure necessary for future installation of electric vehicle-charging equipment will be located. (See 151.154, Ordinance O-2016-02) Consider placing it adjacent to a handicapped space so that the future charger will be accessible from both types of spaces. DONE
 - a. On page ST-1.0, two vehicle charging stations are provided: One located at the ADA parking space, near the SE corner of the lot, and another in the NE corner of the lot on parking space 01.
- B. Work with Building Department to ensure compliance with Green Building Ordinance. Review and adjust drawings as necessary. Indicate on drawings Green Building certification to be achieved and remove the list of Green Building Practices. Done

ENGINEERING

- 1. Survey is sealed, not signed. Provide a signed and sealed survey from the surveyor.
 - a. The survey has been digitally signed and sealed by Julio S. Pita.
- 2. Provide plat determination letter from the Broward County Planning Council. DONE!!!
 - Broward County's Platting Determination Letter will be attached to this package.
- 3. Provide a Pre-Application Letter from FDOT. awaiting a response from FDOT to see if Pre-Application is necessary.
- 4. Please modify the survey to include and show that currently a 100' right of way is available and provided on Pembroke Road. Acknowledge
- 5. Please list all the variances being requested on the Cover Sheet. Clearly call out the requested variances in the Site Plan. Done.
- 6. Please provide a site plan for the project including and dimensioning all features of City streets within the full City right-of-way, from property line to adjacent property lines. (Swales, sidewalks, gutters along DONE

- a. ST-1.0 includes sidewalks, gutters, curbs, and right-of-way, 100' ROW is included.
- 7. Please identify and label the property line on all sheets. PENDING DIBUJANTE
 - a. Acknwleded, the property line has been provided.
- 8. Please identify and provide dimensions for the ADA parking stall setback east of the property along S 57th Street at the most critical locations. (i.e. north and south curbs of the driveway curb cut. DONE,
 - a. Dimensions are identified and provided: setback to S 57th Ave. is 12.9' and setback to Pembroke Road is 27.7'.
- Please identify the bus stop location on the plans and the bench and signage in the area associated with relocated bus stop. Coordination with Broward County Transit (BCT) will be required. DONE
 - a. Acknowledged. Bus stop and signage is shown.
- 10. All driveway access shall have visibility triangles at the intersection of the property line and the driveway. Please show on plans all visibility triangles at all driveway accesses. A visibility triangle is an area adjacent to a driveway and the private property line where the driveway intersects a street/alley. If the property line is less than 12 feet from the edge of pavement in the rights-of-way, provide a 12'X12' visibility triangle along the property line and driveway within the private property. If the distance is greater than 12 feet provide a 12' (along driveway on private property) X 6' (along property line) visibility triangle. All fences, walls, bushes, hedges, and any other landscaping or plant material, within the view triangle shall provide unobstructed cross visibility at a level between 30 inches and 72 inches above ground level. Please address in plans. ACKNOLEDGED.
 - a. Visibility triangles are included on ST-1.0 at all driveway accesses.
- 11. Please show the corner setbacks on the site plan. Minimum City required corner setback for both the intersection of S 57th Ave. and Pembroke Road (25' X 25'). The corner setback area is the area lying adjacent to a street or alley as delineated by a line connecting points measured 25 feet distant along the property lines at the intersection of a street or six feet along the property lines at the intersection of an alley and a street. The height of bushes, hedges, fences and walls located within corner setback area is restricted to two feet.
 - Please refer to ST-1.0.
- 12. On sheet ST-1.0, the parking calculation table states that 2 transit zones are provided. Please show on site plan where are the 2 transit zones located. Acknowledged,

The parking calculation table mentions 1 transit zone and it has been indicated.

- 13. Please identify the sidewalk on the site plan. Additionally, please indicate for sidewalk in the rights-of way to removed and replaced with new 5-foot-wide sidewalk along all frontages of the property. Sidewalks should be flush through driveway opening, provide ADA detectable warning and include detail. DONE
 - a. All 5-foot sidewalks are indicated and identified on page ST-1.0, including ADA detectable warning, detail, adjacent sidewalks, and prop walkway ramp has been proposed.

- 14. Please provide detectable warnings in compliance with FDOT. Provide FDOT standard detectable warning detail in plans. (At corners and at driveway entrances.) Ensure to label that the corner sidewalk area will be ADA compliant on the plans. DONE
 - a. FDOT detectable warning is provided both on the driveway entrance along S 57th Ave. and at SE corner. ADA (5-foot width) compliance on corner sidewalk area has been met. It is now labeled ADA compliant.
- 15. All walkways shall be dimensioned with length, width, and thickness. Please provide the width of the connection provided between the sidewalk in the ROW and the sidewalk on private property connection provided between the sidewalk in the ROW and the sidewalk on private property. " DONE
 - a. Walkways are dimensioned with length and width, thickness is now included. The width of the Row and the sidewalk of the private property has been included please refer to SP-1.0 in between the entrance of the parking and detectable warning in the entrance.
- 16. ADA accessible route is required between accessibility parking and building access as well as accessible route to the public rights-of-way (Sidewalk) show routes on plans. Please provide dimensions for all walkways and or sidewalks depicted as accessible routes. Show any change in elevation along the route on the plan if the transition is flush, identify the transition as flush on the plans, provide ramp slopes as applicable. Please add a note on the site plan and Civil plans stating any lip from 1/4" but not greater than ½" will be beveled to meet ADA requirements. route to the public rights-of-way (Sidewalk) show routes on plans. DONE
 - a. Dimensions for all walkways are presented, but change in elevation along route is now identified, and ramp slope drawing is also identified. Note that the lip being beveled is included above the zoning legend on ST-1.0. The sidewalk route to the public right of way is visible.
- 17. Walkway provided on North side of structure is only 2.7' and will not provide the necessary width for ADA compliance. It is recommended that walkways provided on private property be 4' wide at a minimum. Please provide dimension of the sidewalk width including the curb. DONE
 - a. The walkway on north side of the building is 4.0', dimension is notated between locals #4 and #5.
- 18. Please identify the ADA turning radius at all landings.
 - i. Acknowledged, please refer to SP-1.0.
- 19. Please identify all proposed setbacks, for the vehicle turnaround area (back of curb to property line), walkways on private property (South side) etc. DONE,
 - a. Vehicle turnaround area has a 6.5' setback from the west property line. The other turn around areas are included in both the entrance and exit of the property.
- 20. Please provide details for the dumpster enclosure and dumpster access pad. Pad is to connect to the edge of pavement in the ROW. Additionally, an accessible pedestrian gate shall be provided. Please review 50.02 of the City code for all Dumpster Enclosure requirements.DONE

- a. Dumpster enclosure measurements are 14 x 13 feet, notated on ST-1.0. Pad connects to the edge of the pavement in ROW. The pedestrian gate has been clarified.
- 21. Please identify All parking stall dimensions, if typical please label one stall and state (TYP.) after the dimension. DONE
 - a. All parking stalls measure 8'-5" x 19,' notated on parking spaces 14 and 04. TYP has been stated on parking space 04.
- 22. Please identify the width of the aisle space provided for the parking stalls. Must be a minimum of 24 feet. DONE
 - a. The width of the aisle space is 24.0', found underneath parking space 13 on the site plan, page ST-1.0.
- 23. The turnaround area is to match the width of the drive aisles. DONE Turnaround area width is now 24.0 while the width of drive aisles is 24.0'
- 24. Please label vehicle turn around area with stripping that differs from the ADA stripping and include a pavement marking that states "No Parking". DONE Vehicle turnaround Striping now differs from ADA striping.
- 25. Please include a stop sign (R1-1) and stop bar at the egress/ingress to the site. Please refer to the City of Hollywood engineering standard details for pavement marking.
 - a. The stop sign is now explicitly included at egress/ingress area.
- 26. Please follow City of Hollywood engineering standard details and BCTED for the placement of the sign southbound along S 57th Avenue and identify the type of traffic sign proposed.
 - a. Acknowledged, please refer to SP-1.0.
- 27. Please label the side street to the site correctly. The correct name is S 57th Avenue, not SW 57th Avenue. Acknowledged.
- 28. Please fully dimension the ADA handicap stall and accessible aisle. Additionally identify where the signage for the stall will be posted. DONE
 - a. ADA stall is fully dimensioned 12' x 20' and the accessible aisles are dimensioned to be 5' x 20'. Signage for the stall is indicated directly above the vehicle charging station indication, on the southernmost part of the ADA stall.
- 29. Please call out all materials for the walkways, drive aisles and vehicular parking areas. Ensure the material requirements align with City of Hollywood Code: "a. Concrete: Concrete driveways on private property will be 5-inch thick, 3,000 PSI with fiber mesh while the portion of the driveway located within the ROW (Outside of the property lines) will be a minimum of 6 inches thick, 3,000 psi, with no metal or fiber mesh and will be constructed flush with the existing roadway and sidewalk. The entire driveway will maintain control joints located every 250 sq.ft and the existing asphalt in the City ROW will be sawcut for a clean straight edge. " "b. Pavers: Paver driveways require a minimum 2 3/8th inch pavers placed over a 1-1/2 inch sand base and compacted subbase. In addition to a Minimum 6-inch edge restraint (concrete border) is required around perimeter to interlock pavers. The driveway is to be constructed flush with the existing roadway and the existing asphalt in the City ROW will be sawcut for a clean straight edge. " c. Asphalt: Asphalt driveway is required to be a minimum 6-inch limerock base, tack coat, and 1-inch layer of S-III asphalt. The driveway is to be constructed flush

- with the existing roadway and the existing asphalt in the City ROW will be sawcut for a clean straight edge. Acknowledged, Please refer to page CS-3.0.
- 30. Provide a full set of civil plans for the proposed project to include water and sewer utility plans. Show location of existing water and sewer mains on plans and show how you are planning to connect to the city system. For water and sanitary sewer connection, show any pavement restoration and details required for connections within City rights-of-way. Full road width pavement mill and resurface is required for adjacent road to the parcel. Provide City of Hollywood pavement, sidewalks and swale grading details in plan set.
 - a. Acknowledged, Refer to page P-4.0
- 31. Please provide a pavement marking plan for both on and off-site. These pavement markings are to comply with the City of Hollywood Standard Details in addition to the Broward County Traffic Engineering Division Standard details. Please provide any applicable details in the plan set. Ensure pavement markings across plan sets are identical.
 - Acknowledged, please refer to the Civil Engineering Plans labeled under C-1.0 through C-6.0.
- 32. Please provide standard details for the proposed retention wall near the property line along the west and north side of the site.
 - Proposed retention wall details show to be 10.20' made out of concrete blocks and stucco finished. As for the paint it would be HAILSTORM GRAY PPU24-17
- 33. All roads and alleys adjacent to the property are to be milled and resurfaced. Please make a note on the Site plan and Civil plans, provide hatching to show limitations.

 Acknowledged, please refer to the Civil Engineering Plans labeled under C-1.0 through C-6.0.
- 34. The vehicular queueing space must not interfere with any existent parking stalls. DONE
 - a. There is 19.0' of space between the queuing area and parking space 01, the first one.
- 35. Please include the latest standard City of Hollywood details in the plan set. Applicant is using old standards.
 - https://www.hollywoodfl.org/1459/Standard-Details-for-Engineering-and-Lan include all applicable details
 - Acknowledged, please refer to the plan set.
- 36. Please identify clearly the proposed location of swales on the site.
 - Acknowledged, There are no swales in the property.
- 37. BCTED approval will be required for all pavement markings being restored in the ROW. Please provide a plan showing the proposed pavement markings to be restored. Acknowledged.
- 38. For utilities work within City rights-of-way, ROW permit will be required at the time of permit.
 - Acknowledged.
- 39. MOT plans are required at the time of City Building Permit review. Acknowledged.
- 40. All outside agency permits are required at the time of City building permit review. Acknowledged.

41. "This project will be subject to impact fees (inclusive of park impact fee) under the new City Ordinance PO2022-17, effective September 21, 2022. Impact fees payments to be made at the time of City Building Permit issuance. More comments may follow upon review of the requested information."

Acknowledged.

LANDSCAPING

- 1. Satellite images show existing trees/palms. DONE
 - 1. Please refer to sheet L-01 Disposition Plan
- Provide a Tree disposition plan and landscape plan on separate sheets by a registered professional licensed Landscape Architect in the State of Florida that compliments the building architecture and uses, provides for shade, beautifies the site, accentuates site features, and serves as a buffer where appropriate. DONE
 - 1. Please refer to sheet L-01 Disposition Plan
- 3. According to Chapter 155.52 of the Code of Ordinances and the City of Hollywood Landscape Manual, Shade trees to be installed at a minimum size of 2" DBH/ 12' height. Existing trees meeting this criteria may be used as credit toward total requirement. Palm trees count toward tree requirements on a 3:1 basis, meaning 3 palms equal 1 broadleaf tree. Palms must be 8' CT min. DONE
 - 1. Please refer to page L-2.0 in the Proposed Ground Level Plan List section. This fine
- 4. Provide sight triangles on plans at intersection of driveway and property line Sec. 155.12 (d) DONE
 - 1. Refer to page L-02
- 5. Native plant requirements; 60% trees, 50% shrubs Sec. 3.4. DONE
 - Refer to page L-02, under the City of Hollywood Landscape table. Label all sides
 of property weather there are 'Existing Overhead Powerlines' or 'No Overhead
 Powerlines'. Provide FPL approved trees for planting under powerlines. DONE
- 7. Add note: 'Trees and Palms shall not be removed without first obtaining an approved Tree Removal Permit from the City of Hollywood.' DONE
 - 1. See page L-01, under Notes: Tree Protection Requirements During Construction
- 8. Above ground equipment: Where required for screening purposes, hedge shall be planted at equipment height for visual screening.
 - 1. Refer to sheet L-02
- 9. Add note: All landscaping shall be warranted for 1 year after final inspection. DONE

- See number 15 under "General Landscape Notes" found on page L-03. Provide site requirements as per project zoning. See section 2.4 for landscape code requirements. DONE
- 1. See pages L-02 and L-03.
- 11. Add note: 100% irrigation coverage shall be provided. DONE
 - 1. See page IR-02, in Landscape and Irrigation Note box.
- 12. All driveway access shall have visibility triangles at the intersection of the property line and the driveway. Please show on plans all visibility triangles at all driveway accesses. A visibility triangle is an area adjacent to a driveway and the private property line where the driveway intersects a street/alley. If the property line is less than 12 feet from the edge of pavement in the rights-of-way, provide a 12'X12' visibility triangle along the property line and driveway within the private property. If the distance is greater than 12 feet provide a 12' (along driveway on private property) X 6' (along property line) visibility triangle. All fences, walls, bushes, hedges, and any other landscaping or plant material, within the view triangle shall provide unobstructed cross visibility at a level between 30 inches and 72 inches above ground level. Please address in plans. DONE
 - 1. Refer to sheet L-02
- 13. Work with the City's Landscape Architect to ensure that all landscape requirements are met. -Noted
- 14. Landscape plans to be submitted should coordinate with civil plans to accommodate for drainage features. Done– Refer to sheet L-02

UTILITIES

- 1. Submit Utilities plans indicating proposed Water and Sewer connections. Awcknolegded, please refer to page P-4.0.
- 2. Show Water and Sewer demand calculations on proposed utilities plans. Awcknolegded, please refer to page P-4.0.
- 3. Request Utility Atlas via email to Mr. Juan Picon at jpicon@hollywoodfl.org. DONE!!!
 - Acknowledged. Utility Atlas was requested and received for the proposed area.
 Please find attached in this package.
- 4. Include the City's latest applicable standard Water and Sewer details. The details are available on the City's website via the following link: http://www.hollywoodfl.org/1169/Standard-Details-and-Public-Notices
 Awcknolegded, please refer to page P-4.0.
- 5. This site resides currently within FEMA Flood Zone X. The proposed Finished Floor Elevations (FFE) shall comply with the greatest of the following three (3) conditions, as applicable.PENDING DIBUJANTE

- a. Section 154.50 of the City's Code of Ordinances requires the minimum FFE for non-residential shall be, at a minimum, 6-inches above the elevation of the crown of the adjacent.
- Broward County Preliminary 2019 FEMA Flood Maps (as recommended), available online via the following link: https://bcgis.maps.arcgis.com/apps/View/index.html?appid=ea44837317bd47eaa 5373ce3e2f01b6e; OR
- c. Broward County Future Conditions 100-year Flood Map 2060 (in effect as of July 2021), available online via the following link: https://bcgis.maps.arcgis.com/apps/webappviewer/index.html?id=ec160b81e7f84 bdeacda62575e817380
- 7. Ensure all stormwater is retained onsite. Cross-sections must demonstrate onsite stormwater runoff retention.

DONE

- -Please refer to the SP-1.0.
- 8. Indicate how roof drainage will be collected and connected to the on-site drainage system. Done

Please refer to page A-4.0

- 9. Provide preliminary drainage calculations. Drainage system was provided on PGD plan, but calculations must be provided to support it. Pending.
- 10. Erosion and Sediment Control plan must be updated with silt fence around property perimeter to prevent sediment flow across property lines. Silt fence detail shall be provided showing filter fabric stretched across and attached to supporting posts and entrenched. Plan shall also show temporary gravel construction entrance, and other Best Management Practices to mitigate environmental hazards caused by proposed construction.

 Acknowledged, please refer to C-6.0.
- 11. Permit approval from outside agencies will be required. Acknowledged.
- 12. Landscape plans to be submitted should coordinate with civil plans to accommodate for drainage features.

Done.

13. Additional comments may follow upon further review of requested items. Done.

BUILDING

No comments received.

FIRE

- 1. Fire review for TAC is limited to fire department access and minimum fire flow requirements for water supply for firefighting purposes. --- A complete architectural review will be completed during formal application of architectural plans to the building department. DONE
- 2. Water supply shall meet the requirements of NFPA 1 (2018 Ed.) Section 18.4.5.3. --- To determine the After the results are completed, the civil engineer shall show on civil drawings the calculations using table 18.4.5.2.1 showing that the project meets the minimum fire flow requirements for the building.

For your convenience, I have attached a sample Fire Flow Calculation letter which can be used as a template. minimum fire flow required for firefighting purposes, a Hydrant Flow Test will need to be scheduled through our Underground Utilities Department via email. --- underground@hollywoodfl.org DONE

PUBLIC WORKS

1. No Kindly rejecting Project 24-DP-01 (5701 Pembroke Road) with the following comments: According to

Sheet no.: ST-1.0 on the plans, the dumpster enclosure outlined on this sheet (labeled as "PROP DUMPSTER"), the dumpster seems to be positioned facing east directly adjacent to SW 57 Avenue. This positioning seemingly will allow the garbage truck to block pedestrian traffic on the sidewalk and possibly create vehicular challenges along the SW 57 Avenue corridor during collection periods. Requesting the applicant reposition the dumpster, allowing the garbage truck to enter onto private parcel completely to perform collection services. I realize the dumpster enclosure is not on ROW but their anticipated activities will seemingly have performance on ROW, and we can't allow it. According to the code, all collection activities shall performed on private property. Additionally, do you mind rechecking the code language as it relates to having dumpster enclosures near residentially zoned properties. I believe there is a required landscaping or civil buffer to block activity from the residents view, and if verified, I believe this construction will be directly near two (2) adjacent residential properties: 5680 Fletcher Street; and, 1650 S. 57 Avenue. DONE

COMMUNITY DEVELOPMENT

No comments received.

ECONOMIC DEVELOPMENT

- 1. Have you received any commitments from retailers/business owners? NO
- 2. If not, what are the types of retail envisioned for these spaces? PENDING-Local businesses and service offices such as; barbershops and hair salons, beauty supplies, law firms, and insurance companies.
- 3. How many new jobs are expected or estimated to be created as a result of this project? 15 new jobs.



March 21, 2024

Alexander Mendez OB House, LLC 17138 Southwest 93 Street Miami, Florida 33196 Via Email Only

Dear Mr. Mendez:

Re: Platting requirements for a parcel legally described as Lots 13-16, Block 71, "West Carver Ranches Addition No. 2," according to the Plat thereof, as recorded in Plat Book 26, Page 36, of the Public Records of Broward County, Florida; less a portion of Lot 13 for right-of-way purposes. This parcel is generally located on the northwest corner of Pembroke Road and South 57 Avenue, in the City of Hollywood.

This letter is in response to your correspondence regarding the Broward County Land Use Plan's platting requirements for a proposed non-residential development on the above referenced parcel.

Planning Council staff has determined that replatting <u>would not be required</u> by Policy 2.13.1 of the Broward County Land Use Plan (BCLUP) for the proposed development, subject to compliance with any applicable Broward County Trafficways Plan requirement.

As per the criteria of Policy 2.13.1, replatting is required for the issuance of building permits when constructing a non-residential or unified residential development, unless all of the following conditions are met:

- a. The lot or parcel is smaller than 10 acres and is unrelated to any adjacent development;
- b. A majority of the lot or parcel has been specifically delineated in a recorded plat;
- c. All land within the lot or parcel which is necessary to comply with the County Trafficways Plan has been conveyed to the public by deed or easement; and
- d. The proposed development is in compliance with the applicable land development regulations.

The subject parcel is less than 10 acres (approximately 0.5 acres) and meets the specifically delineated requirement. This platting interpretation is subject to the municipality finding that the proposed development is unrelated to any adjacent development, as noted in "a." above. It is noted that lands dedicated for right-of-way purposes do not negatively impact whether or not a subject property meets the specifically delineated requirement.

Alexander Mendez March 21, 2024 Page Two

Some jurisdictions may be more restrictive and require platting in more situations than the BCLUP. The City of Hollywood's platting requirements should be investigated.

The contents of this letter are not a judgment as to whether this development proposal complies with State or local vehicular access provisions, the Broward County Trafficways Plan, permitted uses and densities, local zoning, the land development regulations of the municipality or the development review requirements of the BCLUP, including concurrency requirements.

If you have any additional questions concerning the BCLUP's platting requirements, please contact Huda Ashwas at your convenience.

Respectfully,

Barbara Blake Boy Executive Director

BBB:HHA

cc/email: George R. Keller, Jr., CPPT, City Manager

City of Hollywood

Andria Wingett, Director, Development Services

City of Hollywood





PROPOSED RETAIL COMMERCIAL BUILDING 5701 PEMBROKE Rd. HOLLYWOOD FL.



SEA

ROLANDO NIGAGLIONI PE 60494 7837 W. Sample Road, Suite 104 Coral Springs, FL 33065

LTANT

CARLOS SLEBI PALACIO
Phone: (786) 905-9830
scccengineeringlic@gmail.com

REVISIONS

ALIZATION OF LOCAL PROJECT
- PEMBROKE Rd. HOLLYWOOD FL.

COVER

.. <u>|</u>

SCALE : | | /2 "= | '-

G-1.0



PROPOSED RETAIL COMMERCIAL BUILDING 5701 PEMBROKE Rd. HOLLYWOOD FL.



SEA

ROLANDO NIGAGLIONI PE 60494 7837 W. Sample Road, Suite 104 Coral Springs, FL 33065

JLTANT

CARLOS SLEBI PALACIO
Phone: (786) 905-9830
scccengineeringlic@gmail.com

REVISIONS

JECT INFORMATION: GALIZATION OF LOCAL PROJECT 21 - PEMBROKE Rd. HOLLYWOOD F

RENDER

.. <u>|</u>

SCAIF . 11/2 "- 1' 0'

G-2.0



PROPOSED RETAIL COMMERCIAL BUILDING 5701 PEMBROKE Rd. HOLLYWOOD FL.



SEA

ROLANDO NIGAGLIONI PE 60494 7837 W. Sample Road, Suite 104 Coral Springs, FL 33065

JLTANT

CARLOS SLEBI PALACIO
Phone: (786) 905-9830
scccengineeringlic@gmail.com

REVISIONS

ROJECT INFORMATION:

EGALIZATION OF LOCAL PROJEC

701 - PEMBROKE Rd. HOLLYWOOD
3023


RENDER

DRAWN BY: A.G.R.A.

DATE: 04-15-24

G-3.0

SKETCH OF BOUNDARY SURVEY ALTA / NSPS LAND TITLE SURVEY

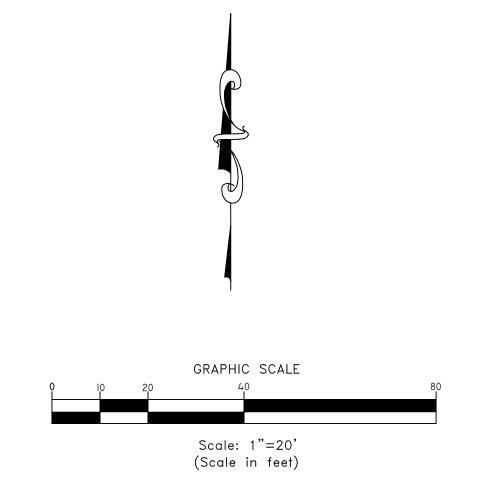

5701 PEMBROKE ROAD, HOLLYWOOD FL 33023

SURVEYOR'S CERTIFICATION: ALEXANDER MENDEZ

SURVEYOR'S NOTES:

1) The above captioned property was surveyed and described based on the above legal description: provided by client.

2) This certification is only for the lands as described. it is not a certification of title, zoning, easements, or freedom of encumbrances. abstract not reviewed

3) There may be additional restrictions not shown on this survey that may be found in the public records of this county, examination of abstract of title will have to be made to determine recorded instruments, if any affecting this property.

4) The accuracy obtained for all horizontal control measurement and office calculation of a closed geometric figures, meets or exceeds the current Standards of Practice as set forth by the Florida Board of Professional Surveyors and Mappers as contained in chapter 5J-17.051 (3) (b), 15.b.II, of 1 foot in 10 000 feet for Commercial Areas.

5) Foundations and/or footings that may cross beyond the boundary lines of the parcel herein described are not shown hereon. underground encroachments not

6) Not valid without the signature and the original raised seal of a Florida Licensed Surveyor and Mapper. Additions or deletions to survey maps or reports by other than the signing party or parties is prohibited without written consent of the signing party or parties.

7) Underground utilities are not depicted hereon: contact the appropriate authority prior to any design work or construction on the property herein described, for building and zoning information. Surveyor shall be notified as to any deviation from utilities shown hereon.

8) In some cases graphic representation have been exaggerated to more clearly illustrate a particular area where dimensions shall have preference over graphic

9) Area of the property: Lot Net Area: ± 21251.72 Square Feet. / ± 0.487 Acres

10) This survey does not reflect or determine ownership. Ownership subject to opinion of title

11) Type of Survey: ALTA / NSPS Land Title Survey.

12) The survey depicted here is not covered by Professional Liability Insurance. The Liability of this survey is limited to the cost of the survey.

North arrow direction and bearings are based on an assumed meridian.

14) Elevations are based on the National American Vertical Datum of 1988.

F.N.&D. = FOUND NAIL AND DISC

= IDENTIFICATION

= MEASURED

L.M.E. = LAKE MAINTENANCE EASEMENT

F.P.R.M. = FOUND PERMANENT REFERENCE MONUMENT

15) There are no wetlands found within the property.

16) The property described on this Sketch of ALTA / NSPS Land Title Survey is the same property as described in Schedule "A" in Old Republic National Title Insurance Company, Issuing Office File number: 23-1104; with an effective date of November 7, 2023 at

8:00 AM, issued by Old Republic National Title Insurance Company, commitment number 23118155 DP1

17) The 2021 Minimum Standard Detail Requirements for ALTA / NSPS Land Title Surveys are Effective February 23, 2021. As of that date, all previous versions of the Minimum Standard Detail Requirements for ALTA / ACSM Land Title Surveys


are superseded by these standards. Adopted by the Board of Governors, American Land Title Association (ALTA), on October 8, 2015. Adopted by the Board of Directors, National Society of Professional Surveyors (NSPS), on October 9, 2015.

S.N.&D. = SET NAIL & DISC

WM = WATER METER

= DELTA

U.E. = UTILITY EASEMENT

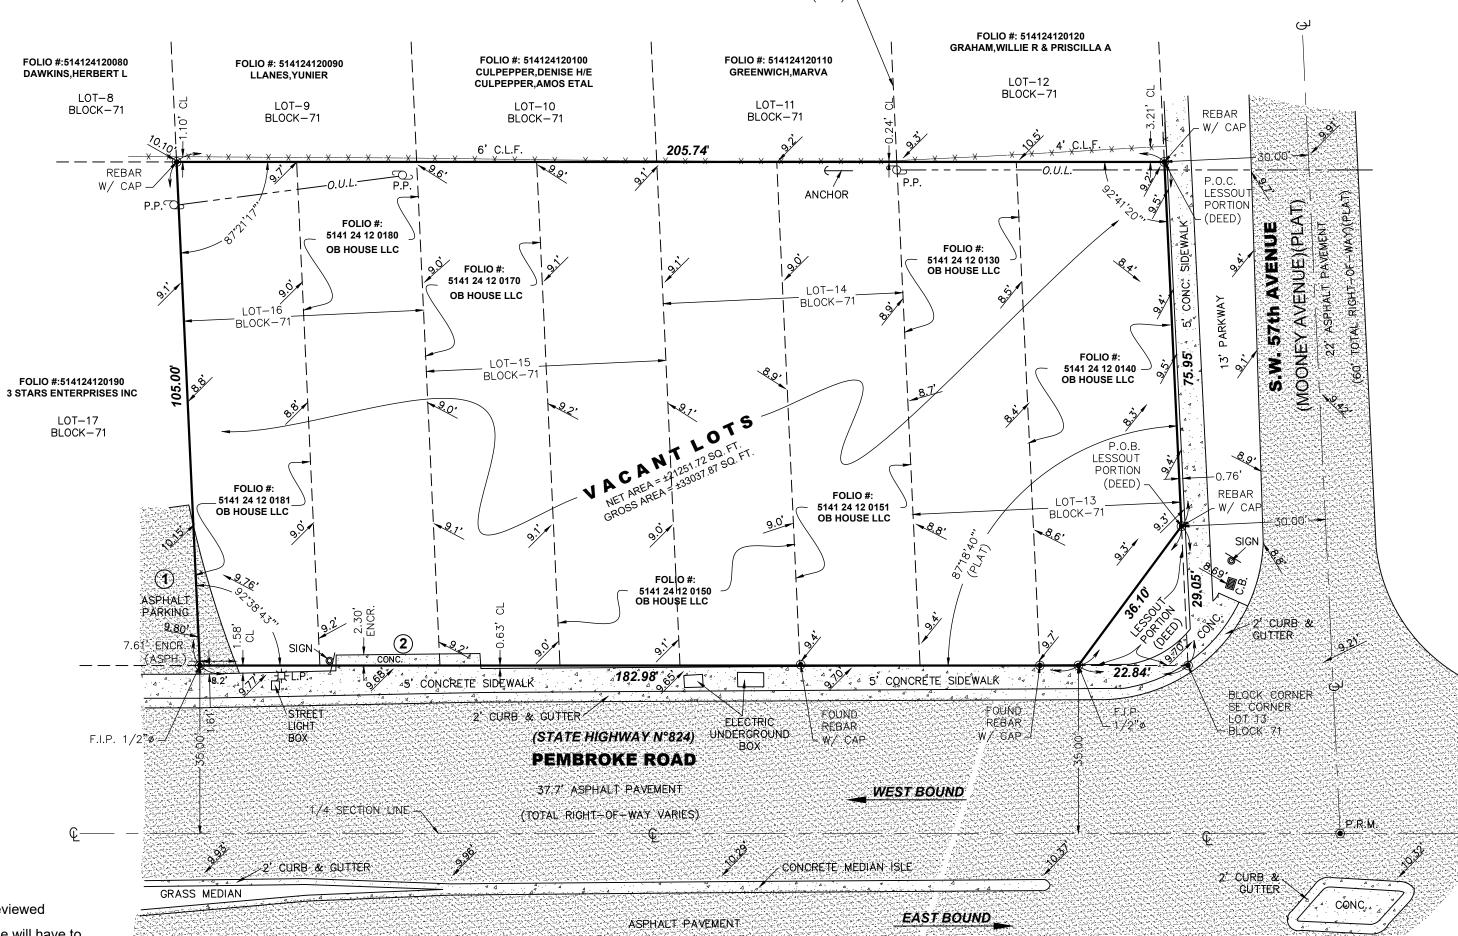

LEGAL DESCRIPTION:

Parcel 1:

The West Twenty Five feet (25ft.) of Lot 13, Block 71, West Carver Ranches Addition No. 2, according to plat thereof as recorded in Plat Book 26, Page 36, of the Public Records of Broward County, Florida.

Parcel 2:

The East 30.82 feet of Lot 13, LESS the portion described as Commencing at the Northeast corner of Lot 13, thence South 75.95 feet to the point of beginning; thence South 29.05 feet, thence West 22.84 feet; thence Northeast 36.10 feet to the Point of Beginning, Block 71, West Carver Ranches Addition No. 2, according to plat thereof as recorded in Plat Book 26, Page 36, of the Public Records of Broward County, Florida.

The West 1/2 of Lot 14 and the East 1/2 of Lot 15, Block 71, West Carver Ranches Addition No. 2, according to plat thereof as recorded in Plat Book 26, Page 36, of the Public Records of Broward County, Florida.

Parcel 4:

The West 1/2 of Lot 16, Block 71, West Carver Ranches Addition No. 2, according to plat thereof as recorded in Plat Book 26, Page 36, of the Public Records of Broward County, Florida.

The West 1/2 of Lot 15, Block 71, West Carver Ranches Addition No. 2, according to plat thereof as recorded in Plat Book 26, Page 36, of the Public Records of Broward County, Florida.

The East 1/2 of Lot 16, Block 71, West Carver Ranches Addition No. 2, according to plat thereof as recorded in Plat Book 26, Page 36, of the Public Records of Broward County, Florida.

Parcel 7:

The East 1/2 of Lot 14, Block 71, West Carver Ranches Addition No. 2, according to plat thereof as recorded in Plat Book 26, Page 36, of the Public Records of Broward County, Florida.

PROJECT SITE



LOCATION MAP NOT TO SCALE

TITLE REVIEW NOTES

- Defects, liens, encumbrances, adverse claims or other matters, if any created, first appearing in the public records or attaching subsequent to the effective date hereof but prior to the date the proposed Insured acquires for value of record the estate or interest or mortgage thereon covered by this Commitment. **GENERAL EXCEPTIONS**
- 2. Facts which would be disclosed by an accurate and comprehensive survey of the premises herein described. **GENERAL EXCEPTIONS**
- 3. Rights or claims of parties in possession. **GENERAL EXCEPTIONS**
- 4. Construction, Mechanic's, Contractors' or Materialmen's lien claims, if any, where no notice thereof appears of record. GENERAL EXCEPTIONS
- Easements or claims of easements not shown by the public records. **GENERAL EXCEPTIONS**
- Any adverse ownership claim by the State of Florida by right of sovereignty to any portion of the lands insured hereunder, including submerged, filled, and artificially exposed lands and lands accreted to such lands. **NOT SURVEY RELATED**
- 7. General or special taxes and assessments required to be paid in the year 2023 and subsequent years. Easements, restrictions and other matters affecting title searched: **GENERAL EXCEPTIONS**
- 8. Restrictions, conditions, reservations, easements, and other matters contained on the Plat of WEST CARVER RANCHES ADDITION NO 2, as recorded in Plat Book 26, Page(s) 36, Public Records of Broward County, Florida. DOES APPLY TO SUBJECT PROPERTY AND ARE PLOTTED ON THE SURVEY(IF ANY)
- 9. Ordinances recorded in O.R. Book 29230, Page 942 and O.R. Book 34145, Page 1891, Public Records of Broward County, Florida. **NOT SURVEY RELATED**
- 10. Rights of tenants and/or parties in possession, and any parties claiming, by through or under said tenants or parties in possession, as to any unrecorded leases or rental agreements. **NOT SURVEY RELATED**
- 11. Any lien provided by County Ordinance or by Ch. 159, F.S., in favor of any city, town, village or port authority, for unpaid service charges for services by any water systems, sewer systems or gas systems serving the land described herein; and any lien for waste fees in favor of any county or municipality. **NOT** SURVEY RELATED

1). Asphalt Parking Encroaches into the Property (S.W. 2)

2). Concrete Sidewalk Encroaches into the Property (South R)

3). ELEVATIONS SHOWN REFER TO N.A.V.D. 1988 BM# 1146 (BROWARD) ELEVATION = 11.510' (NGVD29)

LEGEND AND ABBREVIATIONS:	MONUMENT LINE
A. = ARC	N.A.V.D. = NORTH AMERICAN VERTICAL DATUM
A/C = AIR CONDITIONER PAD	N.G.V.D. = NATIONAL GEODETIC VERTICAL DATUM
ALTA = AMERICAN LAND TITLE ASSOCIATION CH. = CHORD	NSPS = NATIONAL SOCIETY OF PROFESSIONAL SURVEYORS
CH. BEAR = CHORD BEARING	O/L = ON LINE
B.S. = BUILDING SETBACK	O/S = OFF SET
C.B. = CATCH BASIN	PG. = PAGE
C.L.F. = CHAIN LINK FENCE © = CENTER LINE	P.B. = PLAT BOOK
↓ = CENTER LINE CL. = CLEAR	P.C. = POINT OF CURVATURE
CONC. = CONCRETE	P.C.P. = PERMANENT CONTROL POINT
C.B.S. = CONCRETE BLOCK STRUCTURE	P.T. = POINT OF TANGENCY
ENC. = ENCROACHMENT	P.B. = PLAT BOOK
F.F.EL. = FINISH FLOOR ELEVATION	PL = PLANTER
F.P.C.P. = FOUND PERMANENT CONTROL POINT	R.P. = RADIUS POINT
F.I.P.1/2" = FOUND IRON PIPE 1/2"	R.& M. = RECORD AND MEASURE
F.I.R.1/2" = FOUND IRON REBAR 1/2"	R/W = RIGHT OF WAY
F.N. = FOUND NAIL	SWK. = SIDEWALK

GAVY & ASSOCIATES, INC LAND SURVEYORS LB # 6971

SYMBOL

WATER VALVE

□WATER CONNECTOR

S STOP SIGN

O TRAFFIC SIGN

(ID) LID

∭·∭ INLET

oxtimes CABLE

FIRE HYDRANT

ELECTRIC BOX

CATCH BASIN

₩ WATER METER

UTILITY POLE

O BOLLARDS

LIGHT POWER POLE

S SANITARY SEWER


2657 S.W. 145th AVENUE MIAMI, FL. 33175 PHONE: (786) 236-8344

SURVEYOR'S CERTIFICATION:

This is to certify that this map or plat and the survey on which it is based were made in accordance with the 2021 Minimum Standard Detail Requirements for ALTA/NSPS Land Title Surveys, jointly established and adopted by ALTA and NSPS, and includes items 1, 2, 3, 4, 5, 7 (a)(1), 8, 9, 10(a) 11(a), 13 and 14, and 19 of Table A thereof. The field work was completed on 11/29/2023 Date of Plat or Map: 11/29/2023

JULIO S. PITA, P.L.S STATE OF Professional Land Surveyor License No. PSM 5789 State of Florida Not valid without the signature and original raised seal of a Florida Licensed Surveyor and Mapper

COI	MMUNITY NAME AND NUME	JOB Nº: 23-2229		
PAN	NEL NUMBER AND SUFFIX:	FIELD CREW : R.A.		
FIR	M PANEL EFFECTIVE DATE	DRAWN: J.A.		
FLC	OOD ZONE: X	BASE FLC	OD ELEVATION : N/A	CHECKED: J.P.
COL	JNTY NAME: BROWARD		STATE: FLORIDA	FIELD DATE: 11/29/2023
BM#	USED: 1146 (BROWARD)	ELEVATION:	11.510 (NGVD 1929)	DATE: 11/29/2023
No.		RE\	/ISIONS	SCALE 1" = 20'
				SHEET
		SHEET		
				I of 1
		· · ·		

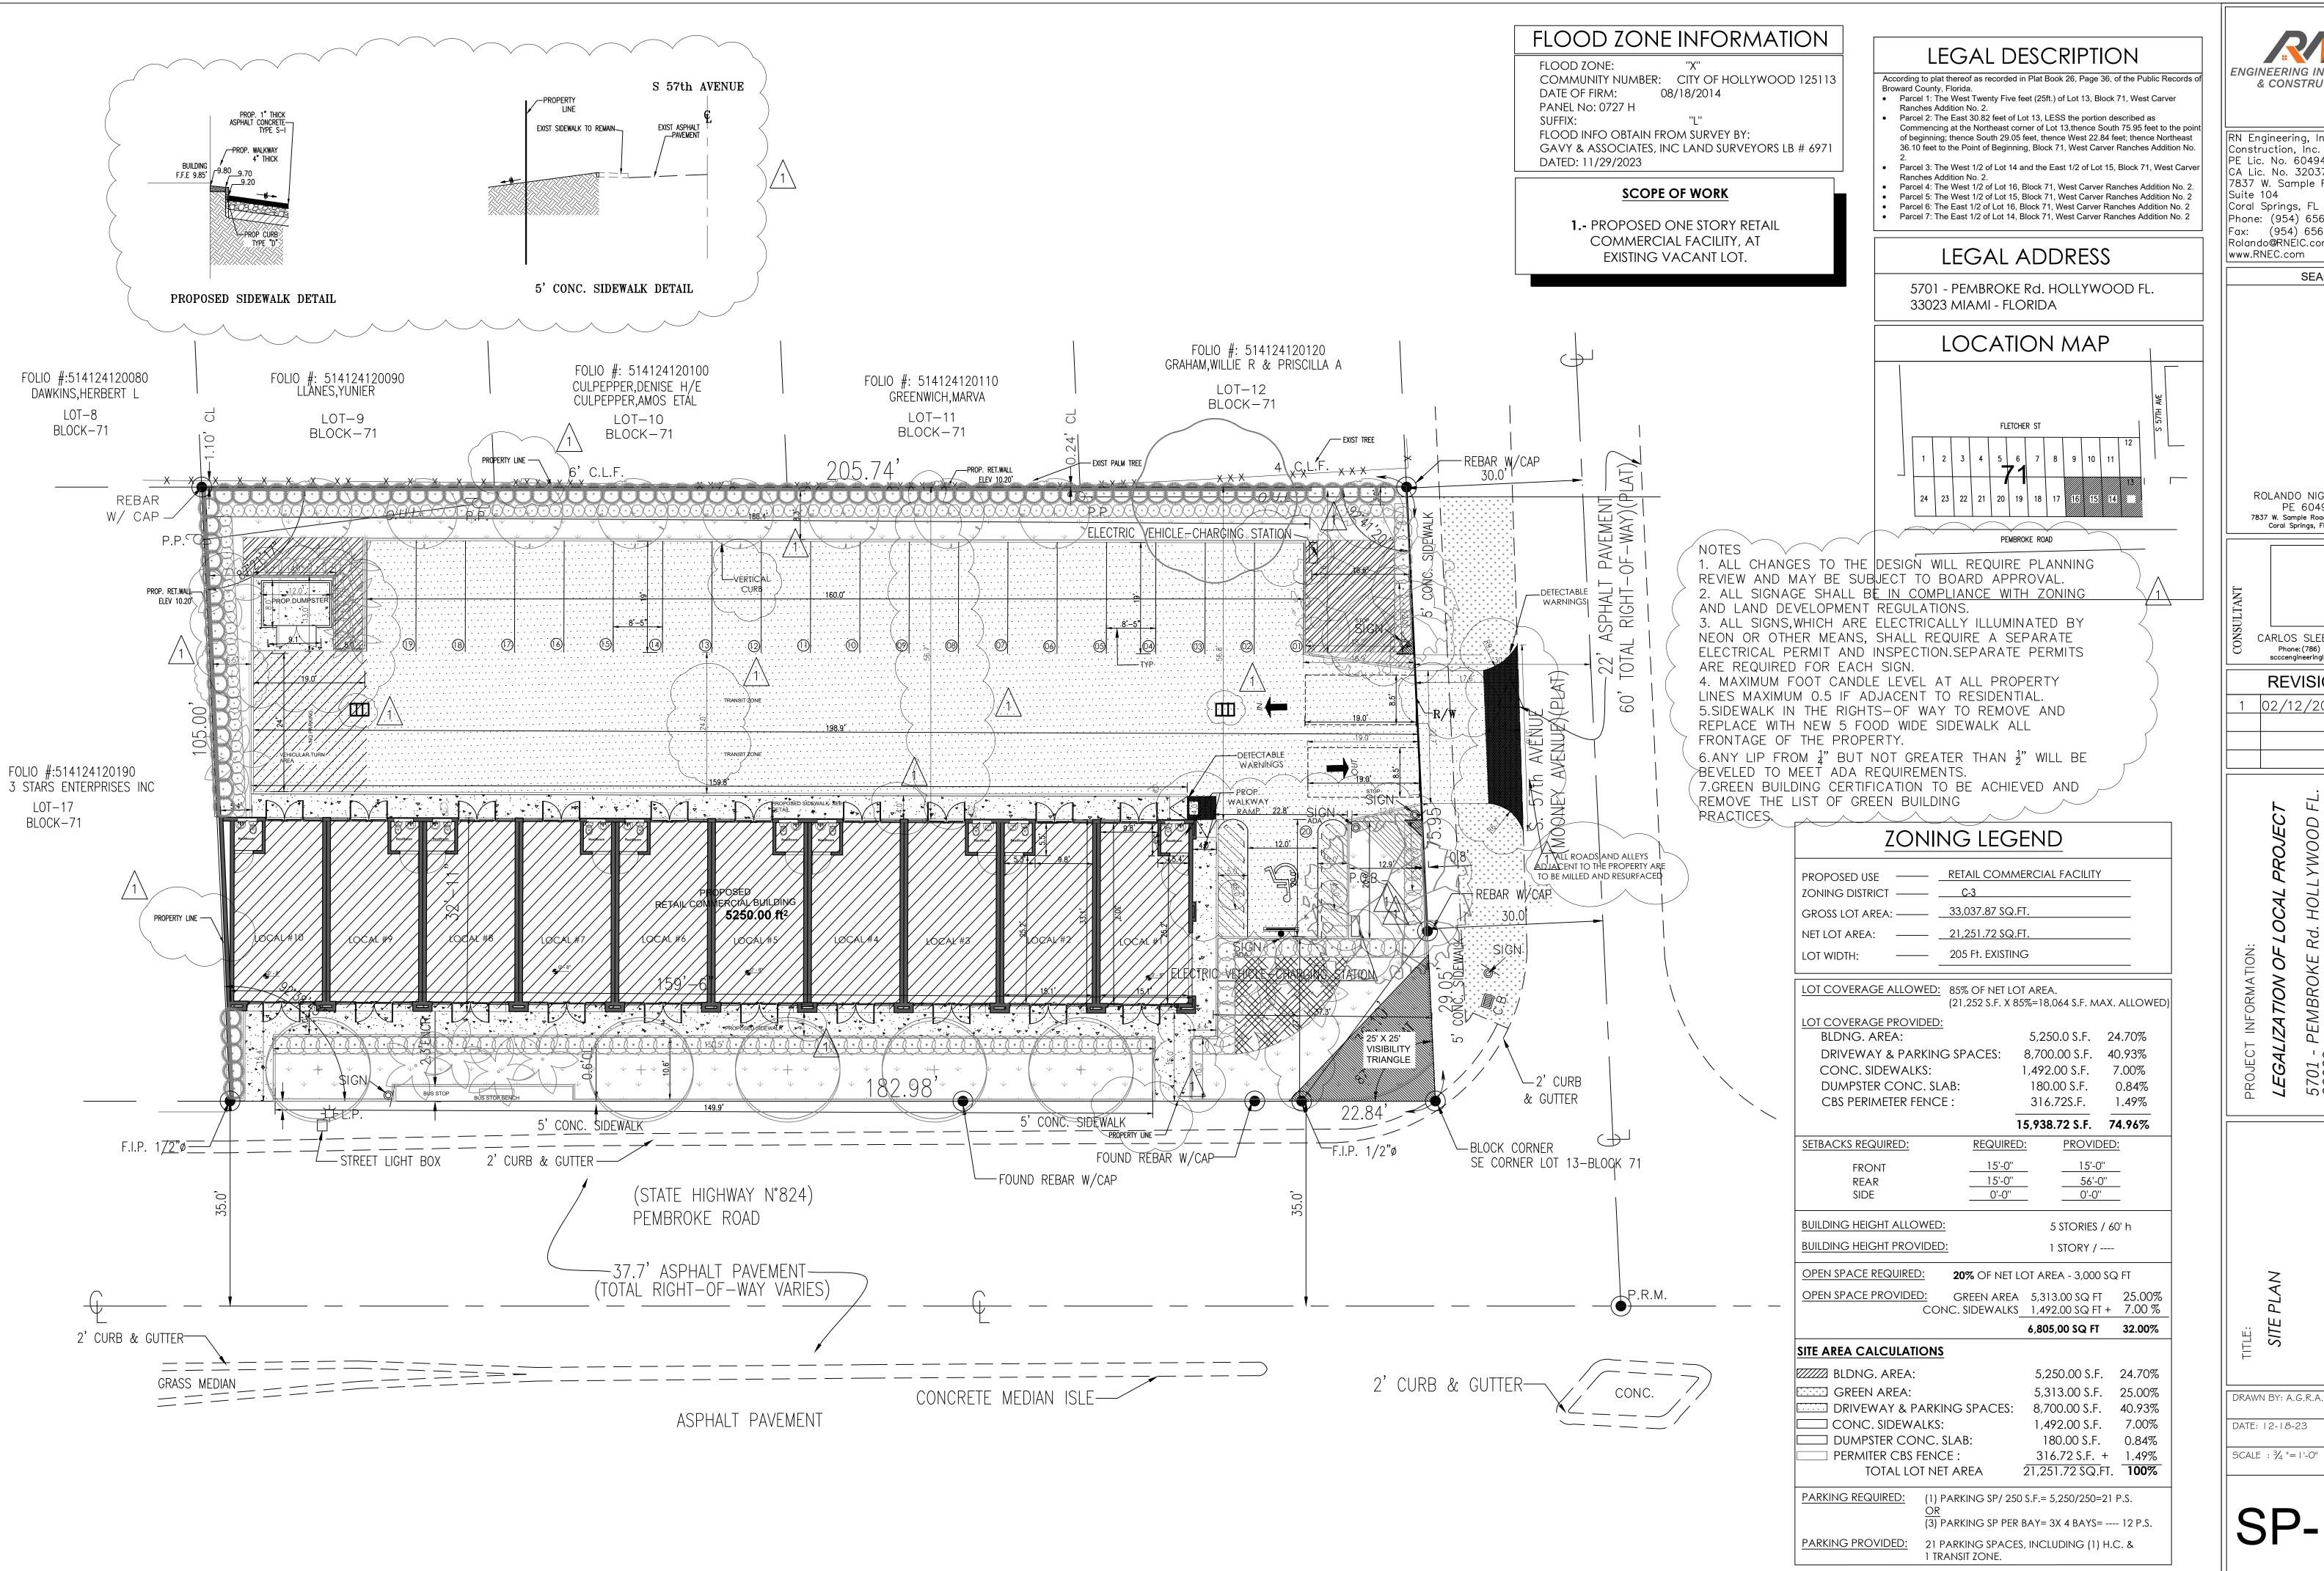

& CONSTRUCTION

RN Engineering, Inspection & Construction, Inc. PE Lic. No. 60494 CA Lic. No. 32037 7837 W. Sample Road, Suite 104 Coral Springs, FL 33065 Phone: (954) 656-2594 Fax: (954) 656-2595 Rolando@RNÉIC.com www.RNEC.com

SEAL

ROLANDO NIGAGLIONI PE 60494 7837 W. Sample Road, Suite 104 Coral Springs, FL 33065

CARLOS SLEBI PALACIO

Phone: (786) 905-9830 scccengineeringllc@gmail.com **REVISIONS**


1 02/12/2024

H .C.1 QOF PEMBROKE LEGALIZA TION

SITE

DRAWN BY: A.G.R.A. DATE: 12-18-23

SP-1.0

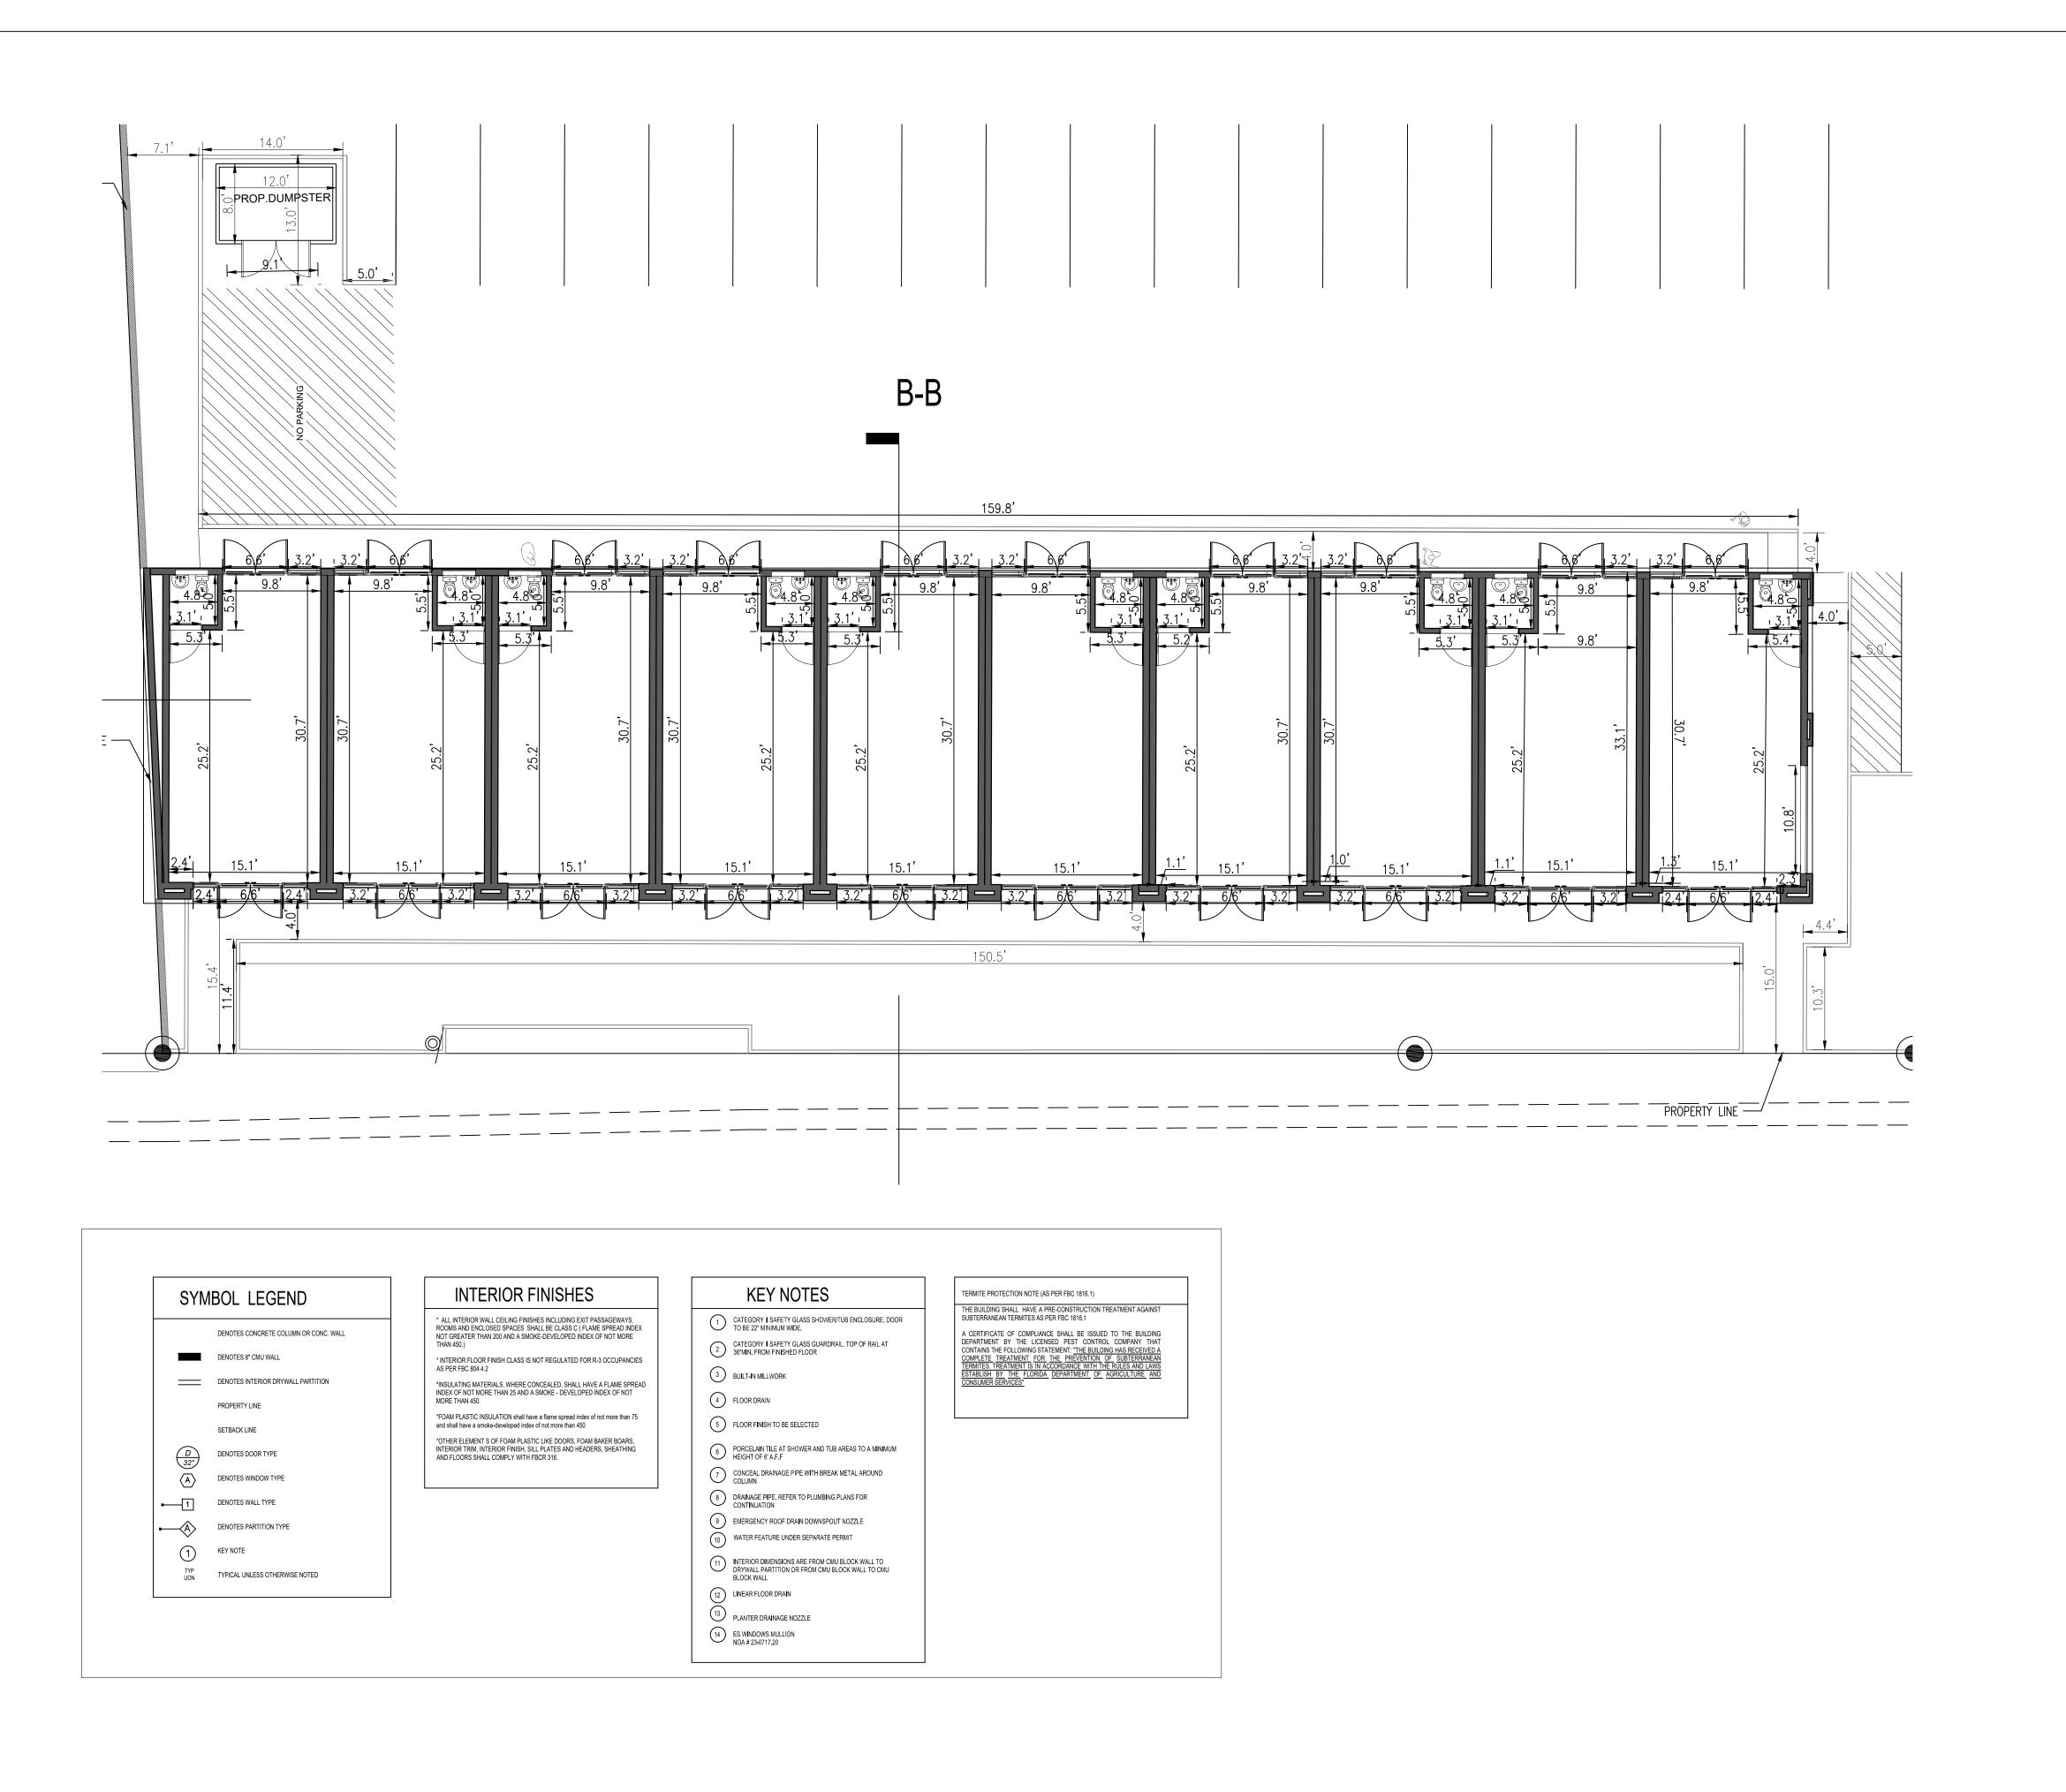

LEGAL DESCRIPTION

According to plat thereof as recorded in Plat Book 26, Page 36, of the Public Records of Broward County, Florida.

• Parcel 1: The West Twenty Five feet (25ft.) of Lot 13, Block 71, West Carver

Ranches Addition No. 2.

• Parcel 2: The East 30.82 feet of Lot 13, LESS the portion described as
Commencing at the Northeast corner of Lot 13,thence South 75.95 feet to the point
of beginning; thence South 29.05 feet, thence West 22.84 feet; thence Northeast
36.10 feet to the Point of Beginning, Block 71, West Carver Ranches Addition No.

2.
Parcel 3: The West 1/2 of Lot 14 and the East 1/2 of Lot 15, Block 71, West Carver Ranches Addition No. 2.

Parcel 4: The West 1/2 of Lot 16, Block 71, West Carver Ranches Addition No. 2.
Parcel 5: The West 1/2 of Lot 15, Block 71, West Carver Ranches Addition No. 2
Parcel 6: The East 1/2 of Lot 16, Block 71, West Carver Ranches Addition No. 2

Parcel 7: The East 1/2 of Lot 14, Block 71, West Carver Ranches Addition No. 2

LEGAL ADDRESS

5701 - PEMBROKE Rd. HOLLYWOOD FL. 33023 MIAMI - FLORIDA

SCOPE OF WORK

1.- PROPOSED ONE STORY RETAIL COMMERCIAL FACILITY, AT EXISTING VACANT LOT.



RN Engineering, Inspection & Construction, Inc.
PE Lic. No. 60494
CA Lic. No. 32037
7837 W. Sample Road,
Suite 104
Coral Springs, FL 33065
Phone: (954) 656—2594
Fax: (954) 656—2595
Rolando@RNEIC.com
www.RNEC.com

SEAL

ROLANDO NIGAGLIONI PE 60494 7837 W. Sample Road, Suite 104 Coral Springs, FL 33065

CARLOS SLEBI PALACIO
Phone: (786) 905–9830
sccengineeringlic@gmail.com

REVISIONS

PROJECT INFORMATION:

LEGALIZATION OF LOCAL PROJECT

5701 - PEMBROKE Rd. HOLLYWOOD FL.

33023


TITLE:
ARCHITECTURE PLAI

DRAWN BY: A.G.R.A.

DATE: 04-15-23

SCALE : | | /2 "= | '-0"

A-1.0

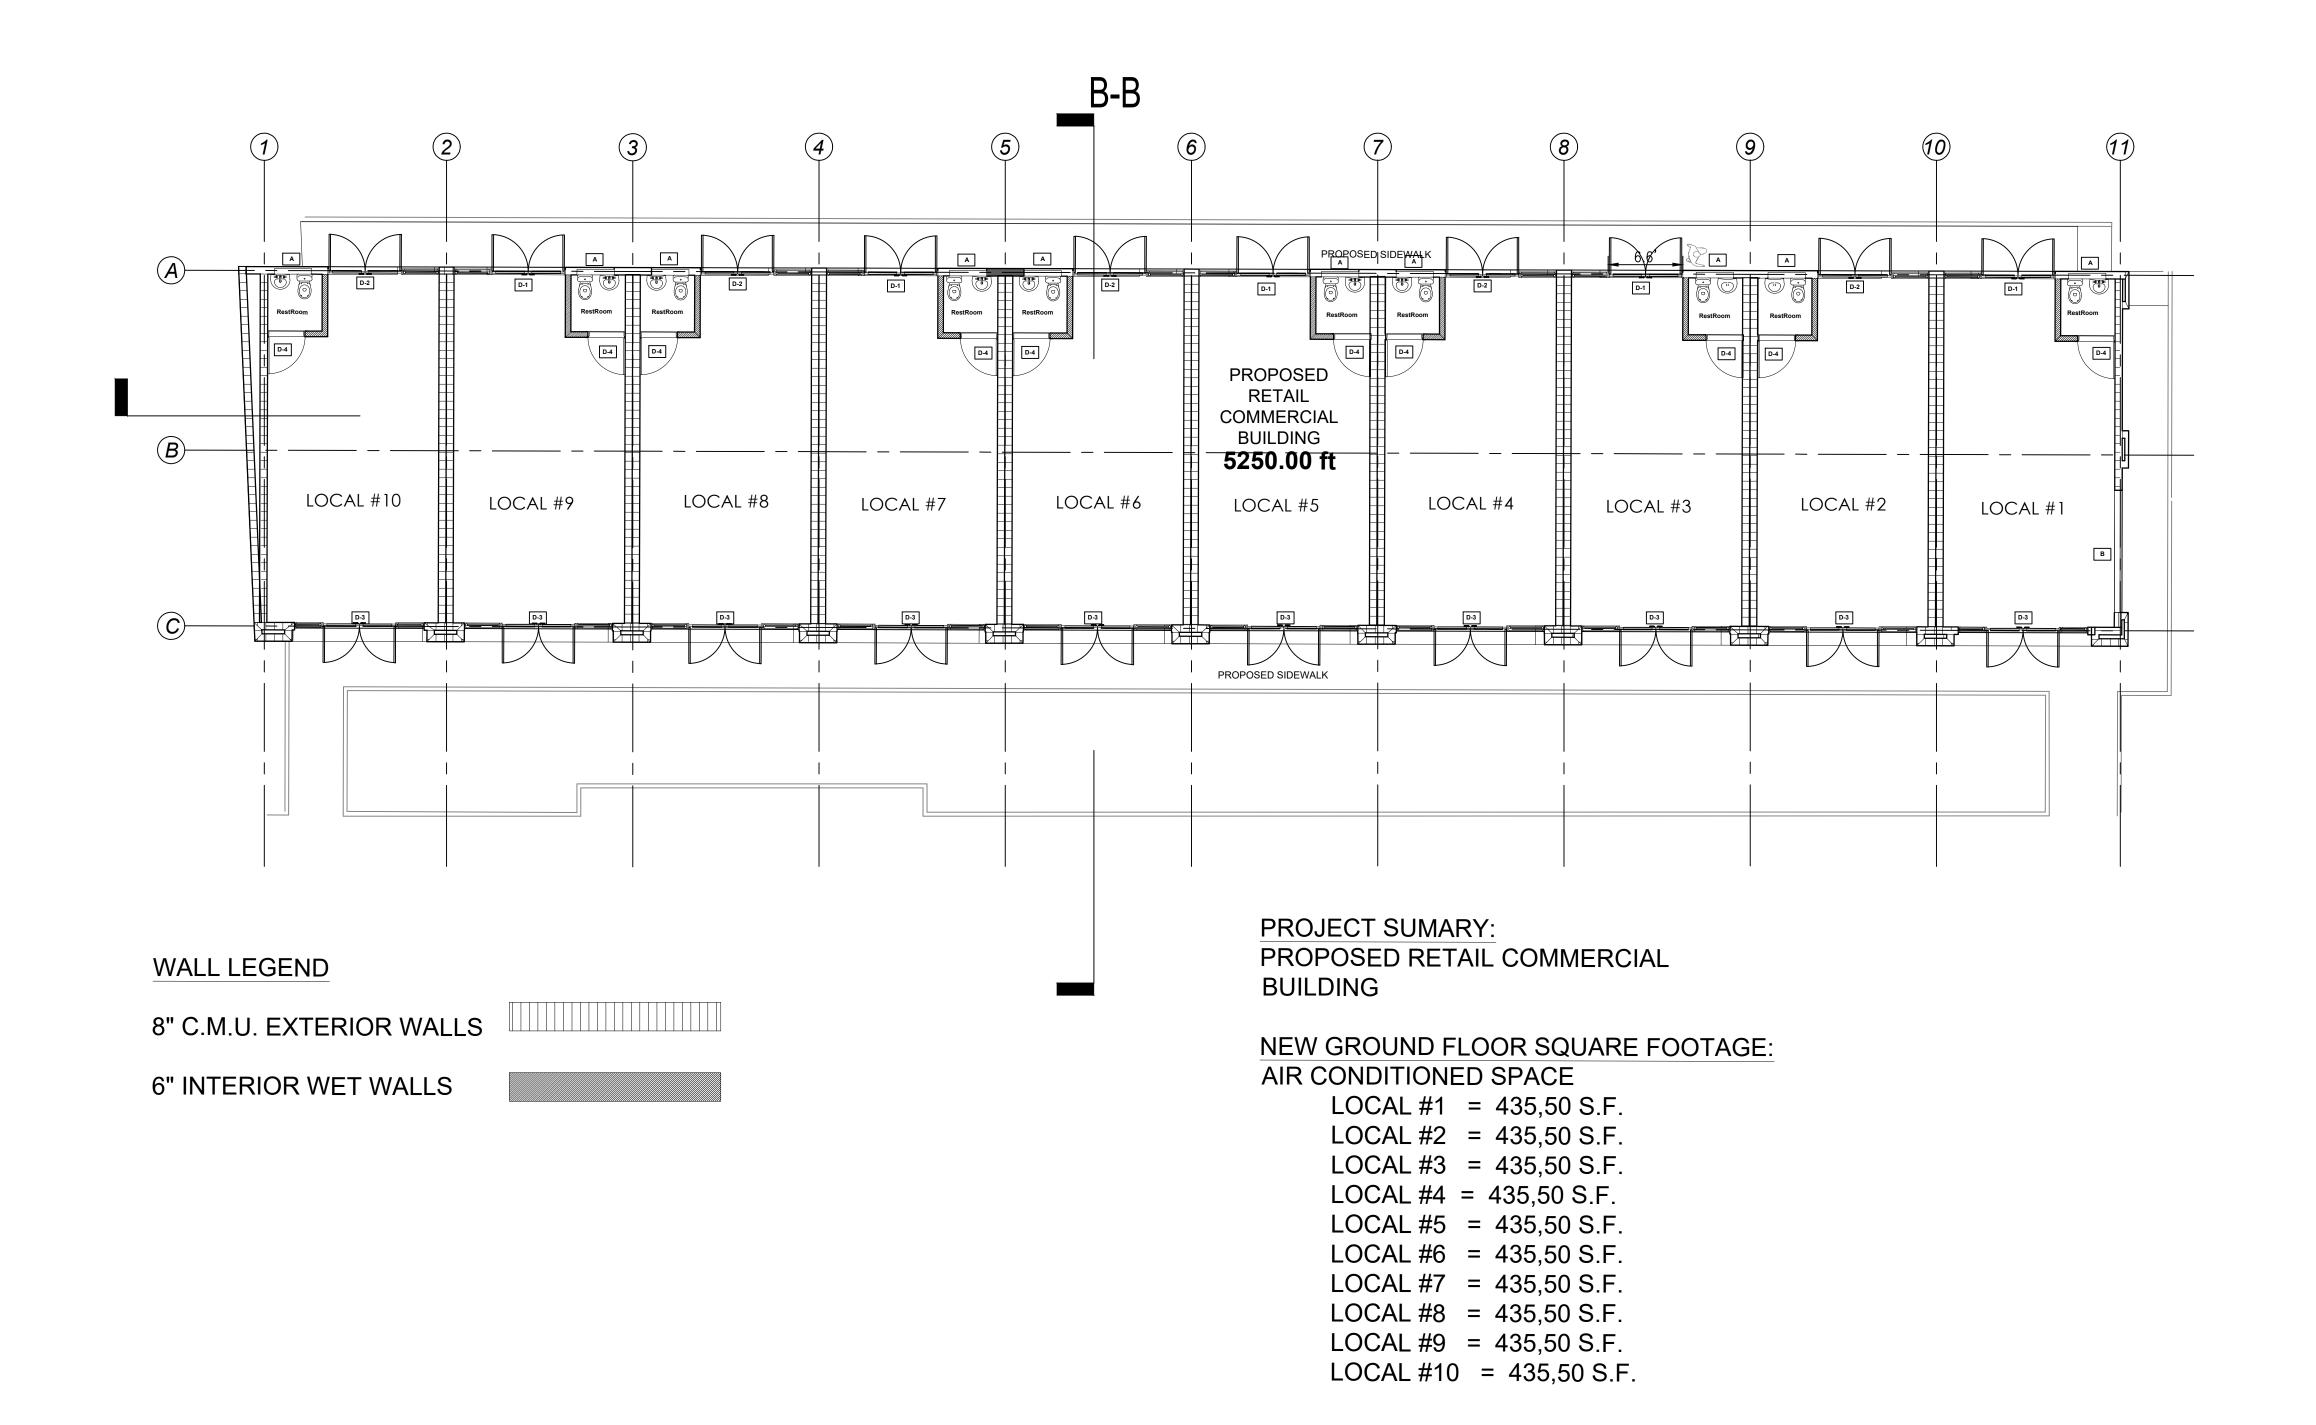

LEGAL DESCRIPTION

According to plat thereof as recorded in Plat Book 26, Page 36, of the Public Records of Broward County, Florida.

• Parcel 1: The West Twenty Five feet (25ft.) of Lot 13, Block 71, West Carver

Ranches Addition No. 2.

Parcel 2: The East 30.82 feet of Lot 13, LESS the portion described as Commencing at the Northeast corner of Lot 13, thence South 75.95 feet to the point of beginning; thence South 29.05 feet, thence West 22.84 feet; thence Northeast 36.10 feet to the Point of Beginning, Block 71, West Carver Ranches Addition No.

2.
Parcel 3: The West 1/2 of Lot 14 and the East 1/2 of Lot 15, Block 71, West Carver Ranches Addition No. 2.

Parcel 7: The East 1/2 of Lot 14, Block 71, West Carver Ranches Addition No. 2

Parcel 4: The West 1/2 of Lot 16, Block 71, West Carver Ranches Addition No. 2.
Parcel 5: The West 1/2 of Lot 15, Block 71, West Carver Ranches Addition No. 2
Parcel 6: The East 1/2 of Lot 16, Block 71, West Carver Ranches Addition No. 2

LEGAL ADDRESS

5701 - PEMBROKE Rd. HOLLYWOOD FL. 33023 MIAMI - FLORIDA

SCOPE OF WORK

1.- PROPOSED ONE STORY RETAIL COMMERCIAL FACILITY, AT EXISTING VACANT LOT.



RN Engineering, Inspection & Construction, Inc.
PE Lic. No. 60494
CA Lic. No. 32037
7837 W. Sample Road,
Suite 104
Coral Springs, FL 33065
Phone: (954) 656—2594
Fax: (954) 656—2595

Rolando@RNÉIC.com

www.RNEC.com

SEAL

ROLANDO NIGAGLIONI PE 60494 7837 W. Sample Road, Suite 104 Coral Springs, FL 33065

CARLOS SLEBI PALACIO
Phone: (786) 905-9830
scccengineeringlic@gmail.com

REVISIONS

GALIZATION OF LOCAL PROJECT

11 - PEMBROKE Rd. HOLLYWOOD FL.


TITLE:
ARCHITECTURE PLAN

DRAWN BY: A.G.R.A.

DATE: 04-15-23

SCALE : | |/2 "=|'-0"

A-2.0

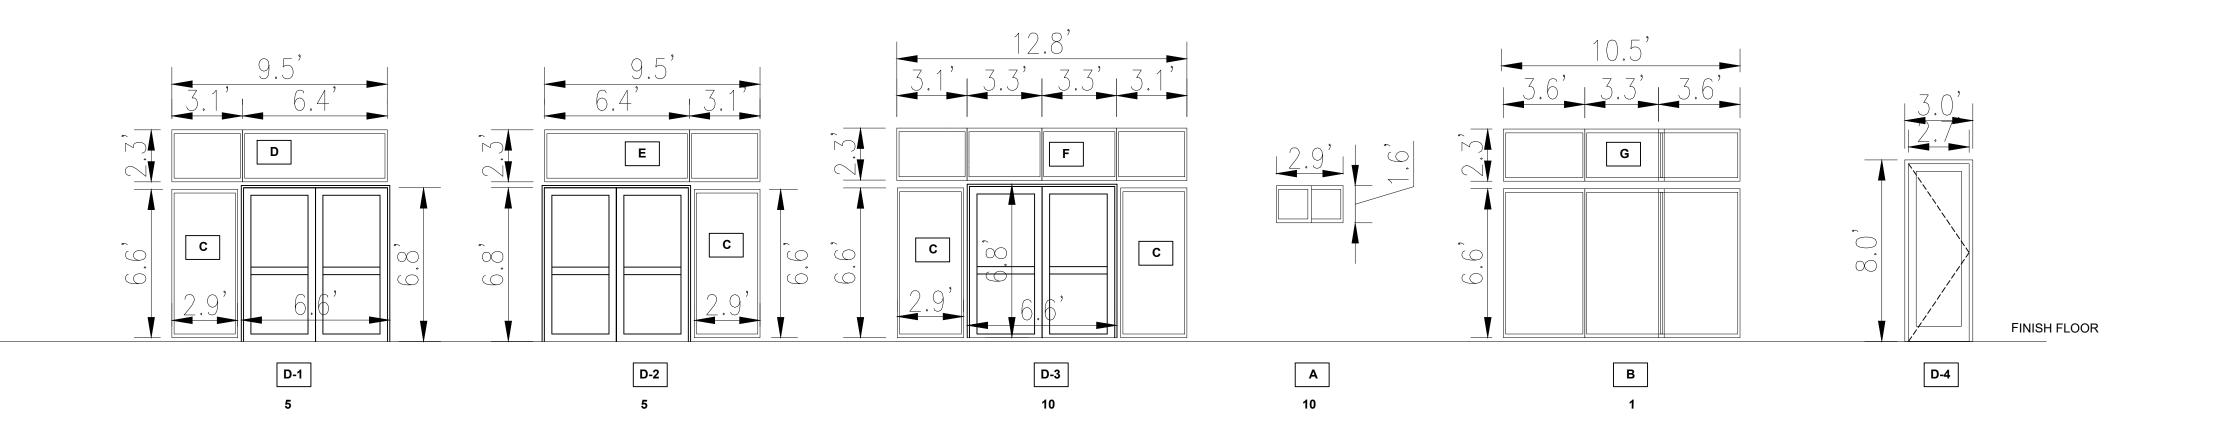

DOOR SCHEDULE

	MARK	MANUFACTURER	TYPE	STYLE	QUANTITY	DO	No. OF LEAVES	
	177 11 11 1	IN A COLOR COLOR		01122	Q0/111111	WIDTH	HEIGHT	No. or ELAVES
DOORS	D1	ES WINDOWS	SWING DOOR		5	79.2"	81.6"	2
2 000	D2	ES WINDOWS	SWING DOOR		5	79.2"	81.6"	2
TERIOR	D3	ES WINDOWS	SWING DOOR		10	79.2"	81.6"	2
EXT								

ORS	D14	TO BE SELECTED	SWING DOOR	10	34"	96"	1
8							
TERIOR							

1. GLASS PANELS SHALL BE CATEGORY II "SAFETY GLAZING" COMPLYING WITH 16CFR 1201, SAFETY STANDARD FOR ARCH. GLAZING MATERIALS, CONSUMER PRODUCT SAFETY COMMISSION AND, AS DESCRIBED IN FBC 2411.3.1.3.1 THROUGH 2411.3.1.3.5

2. ALL DIMENSIONS SHALL BE VERIFIED AT SITE PRIOR TO FABRICATION

WINDOW SCHEDULE

MARK	MANUFACTURER	TYPE	STYLE	QUANTITY	WINDO	ALUM FINISH		
1417 (1 (1 (Wir divol 7 to 1 of the t	1112	31122	Qo/uviii	WIDTH	HEIGHT	/ LOWITH WOLL	
Α	ES WINDOWS	WINDOW WALL		10	34.8"	19.2"	WHITE	
В	ES WINDOWS	WINDOW WALL		1	126"	79.2"	WHITE	
С	ES WINDOWS	WINDOW WALL		30	34.8"	79.2"	WHITE	
D	ES WINDOWS	WINDOW WALL		5	114"	27.6"	WHITE	
Е	ES WINDOWS	WINDOW WALL		5	114"	27.6"	WHITE	
F	ES WINDOWS	WINDOW WALL		10	153.6"	27.6"	WHITE	
G	ES WINDOWS	WINDOW WALL		1	126"	27.6"	WHITE	

1. GLASS PANELS SHALL BE CATEGORY II "SAFETY GLAZING" COMPLYING WITH 16CFR 1201, SAFETY STANDARD FOR ARCH. GLAZING MATERIALS, CONSUMER PRODUCT SAFETY COMMISSION AND, AS DESCRIBED IN FBC 2411.3.1.3.1 THROUGH 2411.3.1.3.5

2. ALL DIMENSIONS SHALL BE VERIFIED AT SITE PRIOR TO FABRICATION

DOOK AND WINDOW HOILS -=-

- CONTRACTOR TO SUBMIT MIAMI-DADE CERTIFICATE OF PRODUCT CONTROL APPROVAL FOR ALL WINDOWS AND EXTERIOR DOORS FOR ARCHITECT'S/ ENGINEER'S REVIEW.
- CONTRACTOR TO VERIFY ALL REQUIRED MASONRY OPENINGS WITH DOOR AND WINDOW MANUFACTURES PRIOR TO COMMENCEMENT OF WORK.
 CONTRACTOR TO SUBMIT DOOR AND WINDOW SHOP DRAWINGS FOR ARCHITECT'S/ ENGINEER'S REVIEW.
 ALL NEW WINDOWS AND EXTERIOR DOORS TO BE MANUFACTURED BY PGT OR APPROVED EQUAL (IMPACT RESISTANT ASSEMBLY PRODUCTS).
 ALL NEW WINDOW AND EXTERIOR DOOR COLOR TO BE SELECTED BY OWNER /ARCHITECT FROM MANUFACTURE STANDARD COLORS, UNLESS OTHERS
- 6. ALL NEW WINDOW AND DOOR PLACEMENT IS AS PER DETAILS CONTRACTOR IS TO NOTIFY ARCHITECT OF ANY CONFLICTS DURING CONSTRUCTION.

 1. ALL NEW WINDOW AND EXTERIOR DOORS TO BE SECURED USING NUMBER AND TYPE OF FASTENERS REQUIRED BY MANUFACTURE OR LATEST APPROVED F.B.C ORDINANCE, WHICHEVER IS MORE STRICT.
- INTERIOR DOOR NOTES
- 1. EVERY CLOSET DOOR LATCH SHALL BE SUCH THAT CHILDREN CAN OPEN THE DOOR FROM INSIDE THE CLOSET.
 2. EVERY BATHROOM DOOR LOCK SHALL BE DESIGN TO PERMIT THE OPENING OF THE LOCKED DOOR FROM THE OUTSIDE DURING AN EMERGENCY.
 3. NO DOOR IN ANY MEANS OS ESCAPE SHALL BE LOCKED AGAINST EGRESS WHEN THE BUILDING IS OCCUPIED. ALL LOCKING DEVICES WHICH IMPEDE
- DOOR HARDWARE NOTES
- 1. CONTRACTOR TO SUBMIT COMPLETE HARDWARE SCHEDULE DESCRIBING ALL HARDWARE TO BE USED ON A DOOR BY DOOR BASIS FOR
- ARCHITECT/OWNER'S REVIEW AND APPROVAL.

 2. ALL EXTERIOR DOORS SHALL HAVE BOTTOM SEALS AND FRAME GASKETS.

OR PROHIBIT EGRESS OR WHICH CANNOT BE EASILY DISENGAGED SHALL BE PROHIBITED.

SECURITY AND FORCE ENTRY PREVENTION NOTES

- ALL LOCKS ON EXTERIOR DOORS SHALL BE CAPABLE OF RESISTING A FORCE 300 LBS. APPLIED IN ANY MOVABLE DIRECTION.
 ALL SINGLE EXTERIOR SWING DOORS SHALL HAVE A LOCK TO BE KEY OPERATED FROM THE EXTERIOR WITH A MINIMUM 6,000 POSSIBLE KEY
 CHANGES OR LOCKING COMBINATIONS. IF KEY KNOB IS USED, AN AUXILIARY DEAD BOLT WITH HARDENED BOLT OR INSERTS SHALL BE PROVIDED.
 THE ACTIVE LEAF OF PAIRS OF EXTERIOR SWING DOORS SHALL HAVE SAME LOCKS AS REQUIRED FOR SINGLE EXTERIOR SWING DOORS. THE INACTIVE
- LEAF SHALL HAVE MULTIPLE POINTS OF LOCKS WITH 5/8" MIN. THROW BOLTS WITH INSERTS.

 4. OVERHEAD DOORS SHALL BE PROVIDED WITH MULTIPLE POINT LOCKS OR BE LOCKED AT MORE THAN ONE POINT WITH HARDENED BOLTS OR BOLTS WITH INSERTS ENGAGING AT LEAST TWO OPPOSITE POINTS A MINIMUM OF OTHER LOCKING DEVICES SHALL NOT BE REQUIRED WHERE SUCH DOORS
- ARE CONTROLLED AND LOCKED BY ELECTRIC POWER. 5. HINGES ON EXTERIOR OUT SWINGING DOORS SHALL HAVE NON EXPOSED SCREWS AND NON REMOVABLE PINS.
- 6. JAMBS OF ALL EXTERIOR OFFSET TYPE IN-SUING DOORS SHALL BE RABBETED OR OF SIMILAR FABRICATION TO PREVENT DEFEATING THE PURPOSE OF THE STRIKE AND THE INTEGRITY OF THE LOOKS AND LATCHES.
- 1. SINGLE SWINGING EXTERIOR DOORS, IF WOOD, SHALL BE SOLID CORE OF NOT LESS THAN 1 } "THICK.
 8. GLASS TO EXTERIOR DOORS SHALL COMPLY WITH THE AMERICAN NATIONAL STANDARDS INSTITUTES Z97.1.
- 9. VISION PANELS IN EXTERIOR DOORS, OTHER THAN GLAZING WITHIN 40 " OF THE INSIDE LOCKING ACTIVATING DEVICE OS LOCKS AND SWINGING GLASS DOORS SHALL COMPLY WITH THE AMERICAN NATIONAL STANDARDS INSTITUTE, STANDARD Z79.1.
- 10. VENTS IN OVERHEAD GARAGE DOORS SHALL NOT BE INSTALLED CLOSER THAN 40 " TO THE INSIDE LOCK ACTIVATING DEVICE.

 11. SINGLE SWING EXTERIOR AND SWING DOORS CONNECTING LIVING AREAS WITH GARAGE AREAS SHALL BE SECURED WITH A LATCH AND A SINGLE DEAD BOLT WITH ONE INCH MINIMUM THROWS OR A COMBINATION OF DEAD LATCH AND DEAD BOLTS HAVING A 1" THROW. DOORS SHALL HAVE A MINIMUM I 3 "THICK SOLID CORE.

TERMITE PROTECTION NOTES

I. MUST COMPLY WITH 2020 FBC, 1TH EDTION CHAPTER 2304.124 PRIOR THE BUILDING FINAL INSPECTION A CERTIFICATE OF COMPLIANCE SHALL BE ISSUED TO THE BUILDING DEPARTMENT BY A LICENSED PEST CONTROL COMPANY ANY THAT CONTAINS THE FOLLOWING STATEMENT THE BUILDING HAS RECEIVED A COMPLETE TREATMENT FOR THE PREVENTION OF SUBTERRANEAN TERMITES. TREATMENT IS IN ACCORDANCE WITH RULES AND LAWS ESTABLISHED BY THE FLORIDA DEPARTMENT OF AGRICULTURE AND CONSUMER SERVICES. "INCLUDE UNDER SLAB PRE-TREATMENT.

INTERIOR/FINISHES NOTES

- 1. WALL & CEILING, FINISHES: ALL WALL & CEILING, FINISHES TO HAVE A FLAME SPREAD INDEX OF NOT GREATER THAN 200 AND A SMOKE DEVELOPED INDEX OF NOT GREATER THAN 450 AS PER ASTM E-84 OR UL 273, TO COMPLY WITH F.B.C. R 302.9.
- 2. WALL HUNG CABINETS & PLUMBING FIXTURE BACKING: PROVIDE DOUBLE STL STUDS OR 20 GA MIN OR 2 X4 STUDS AT 16" O. C. AT ALL WALL HUNG CABINETS AND PLUMBING FIXTURE LOCATIONS, 2X4 (MIN) HORIZONTAL MEMBER SECURELY FASTENED TO NOT LESS THAN TWO STUDS FOR ATTACHMENT OF WALL HUNG PLUMBING FIXTURE (TYPICAL) TO COMPLY WITH 2020 F.B.C. TITH EDITION CHARTER 25 FOR BACKING.
- 3. INSULATION MATERIALS ALL INSULATION MATERIALS TO HAVE A FLAME SPREAD INDEX OF NOT MORE THAN 25 AND A SMOKE = DEVELOPED INDEX OF NOT MORE THAN 450 WHEN TESTED IN ACCORDANCE WITH ASTM E 84 OR UL 123 TO COMPLY WITH FBC SECTION R302. 10.1. INSULATION VALUE TO MEET ENERGY CALCULATIONS MINIMUM REQUIREMENTS

ENGINEERING INSPECTION & CONSTRUCTION

RN Engineering, Inspection & Construction, Inc.
PE Lic. No. 60494
CA Lic. No. 32037
7837 W. Sample Road,
Suite 104
Coral Springs, FL 33065
Phone: (954) 656—2594
Fax: (954) 656—2595
Rolando@RNEIC.com

www.RNEC.com

SEAL

ROLANDO NIGAGLIONI PE 60494 7837 W. Sample Road, Suite 104 Coral Springs, FL 33065

[Ā	
JL.	
ONSULTANT	CARLOS SLEBI PALACIO
Ξ	Phone: (786) 905–9830

REVISIONS

scccengineeringllc@gmail.com

CCT D FL.

JECT INFORMATION: GALIZATION OF LOCAL PROJ 31 - PEMBROKE Rd. HOLLYWOC 323

5000

SCHEDULES

DRAWN BY: A.G.R.A.

DATE: 04-15-23

SCALE : | | | | 2 "= | '-0"

A-3.0

LEGAL DESCRIPTION

According to plat thereof as recorded in Plat Book 26, Page 36, of the Public Records of Broward County, Florida.

• Parcel 1: The West Twenty Five feet (25ft.) of Lot 13, Block 71, West Carver

- Ranches Addition No. 2.

 Parcel 2: The East 30.82 feet of Lot 13, LESS the portion described as
 Commencing at the Northeast corner of Lot 13,thence South 75.95 feet to the point of beginning; thence South 29.05 feet, thence West 22.84 feet; thence Northeast 36.10 feet to the Point of Beginning, Block 71, West Carver Ranches Addition No.
- 2.
 Parcel 3: The West 1/2 of Lot 14 and the East 1/2 of Lot 15, Block 71, West Carver Ranches Addition No. 2.
 Parcel 4: The West 1/2 of Lot 16, Block 71, West Carver Ranches Addition No. 2.
- Parcel 4: The West 1/2 of Lot 16, Block 71, West Carver Ranches Addition No. 2.
 Parcel 5: The West 1/2 of Lot 15, Block 71, West Carver Ranches Addition No. 2.
 Parcel 6: The East 1/2 of Lot 16, Block 71, West Carver Ranches Addition No. 2.
 Parcel 7: The East 1/2 of Lot 14, Block 71, West Carver Ranches Addition No. 2.

LEGAL ADDRESS

5701 - PEMBROKE Rd. HOLLYWOOD FL. 33023 MIAMI - FLORIDA

SCOPE OF WORK

1.- PROPOSED ONE STORY RETAIL COMMERCIAL FACILITY, AT EXISTING VACANT LOT.



RN Engineering, Inspection & Construction, Inc.
PE Lic. No. 60494
CA Lic. No. 32037
7837 W. Sample Road,
Suite 104
Coral Springs, FL 33065
Phone: (954) 656-2594
Fax: (954) 656-2595
Rolando@RNEIC.com
www.RNEC.com

SEAL

ROLANDO NIGAGLIONI PE 60494 7837 W. Sample Road, Suite 104 Coral Springs, FL 33065



REVISIONS

5C7

PROJECT INFORMATION:

LEGALIZATION OF LOCAL PROJE
5701 - PEMBROKE Rd. HOLLYWOOL
33023


ROOF PLAN


DRAWN BY: A.G.R.A.


DATE: 04-15-23

SCALE : | | | 2 "= | '-0"

A-4.0

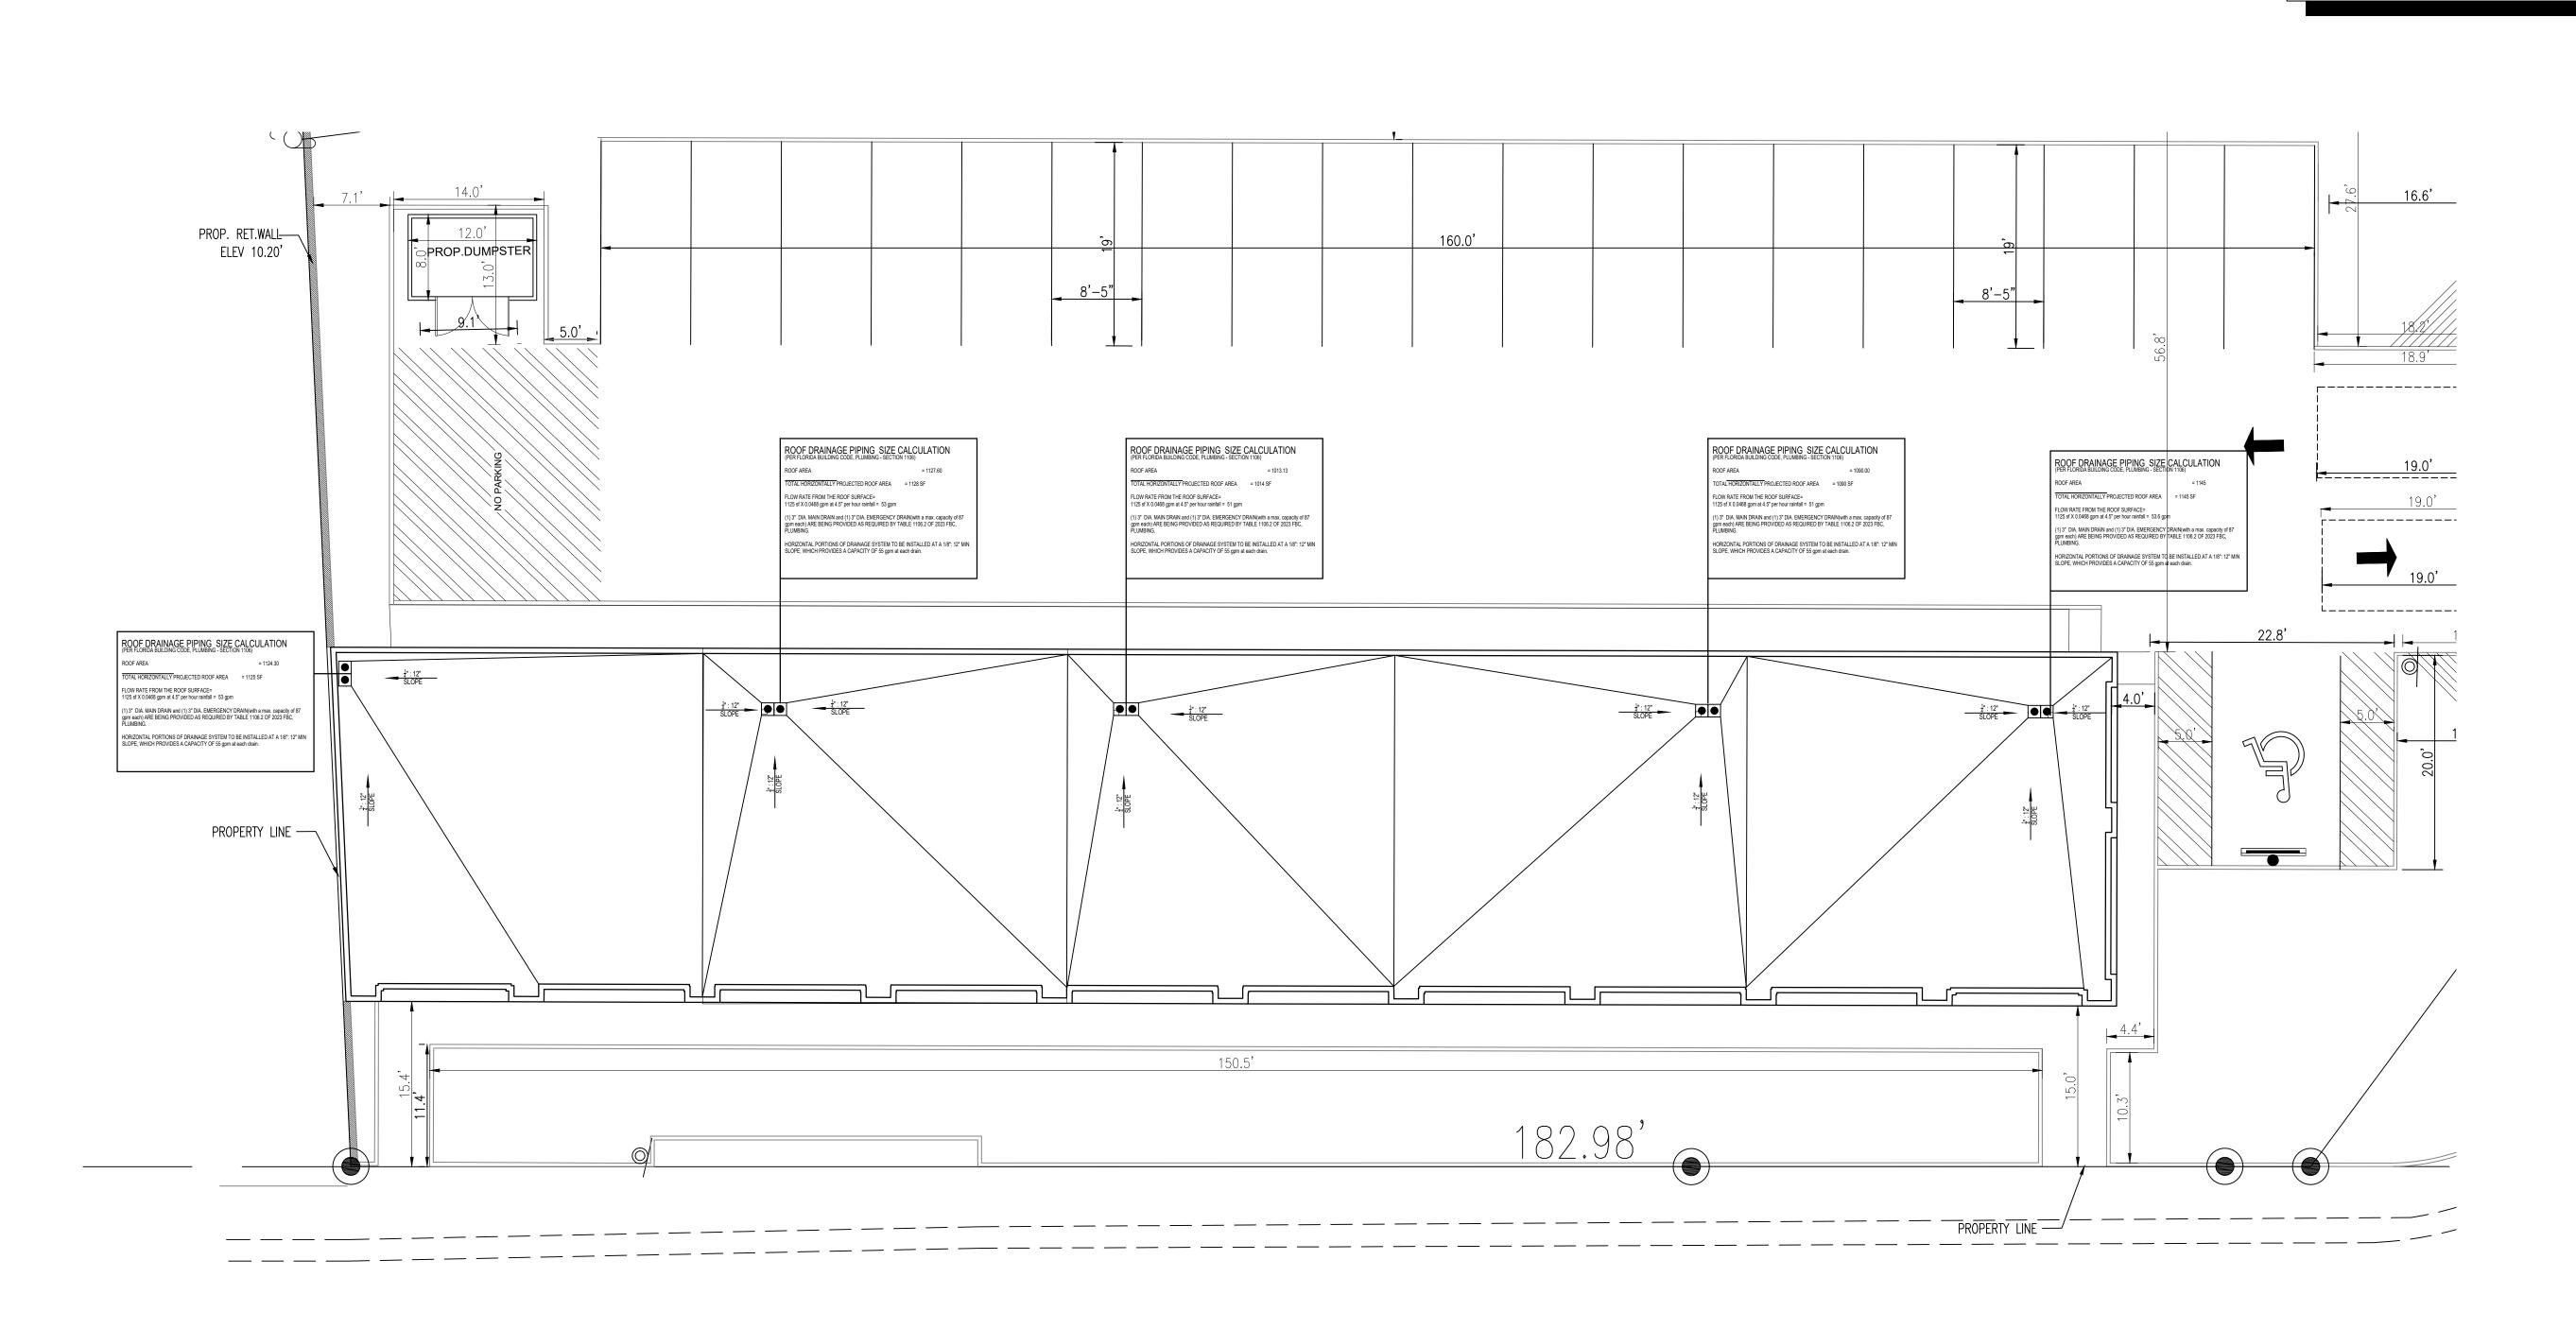


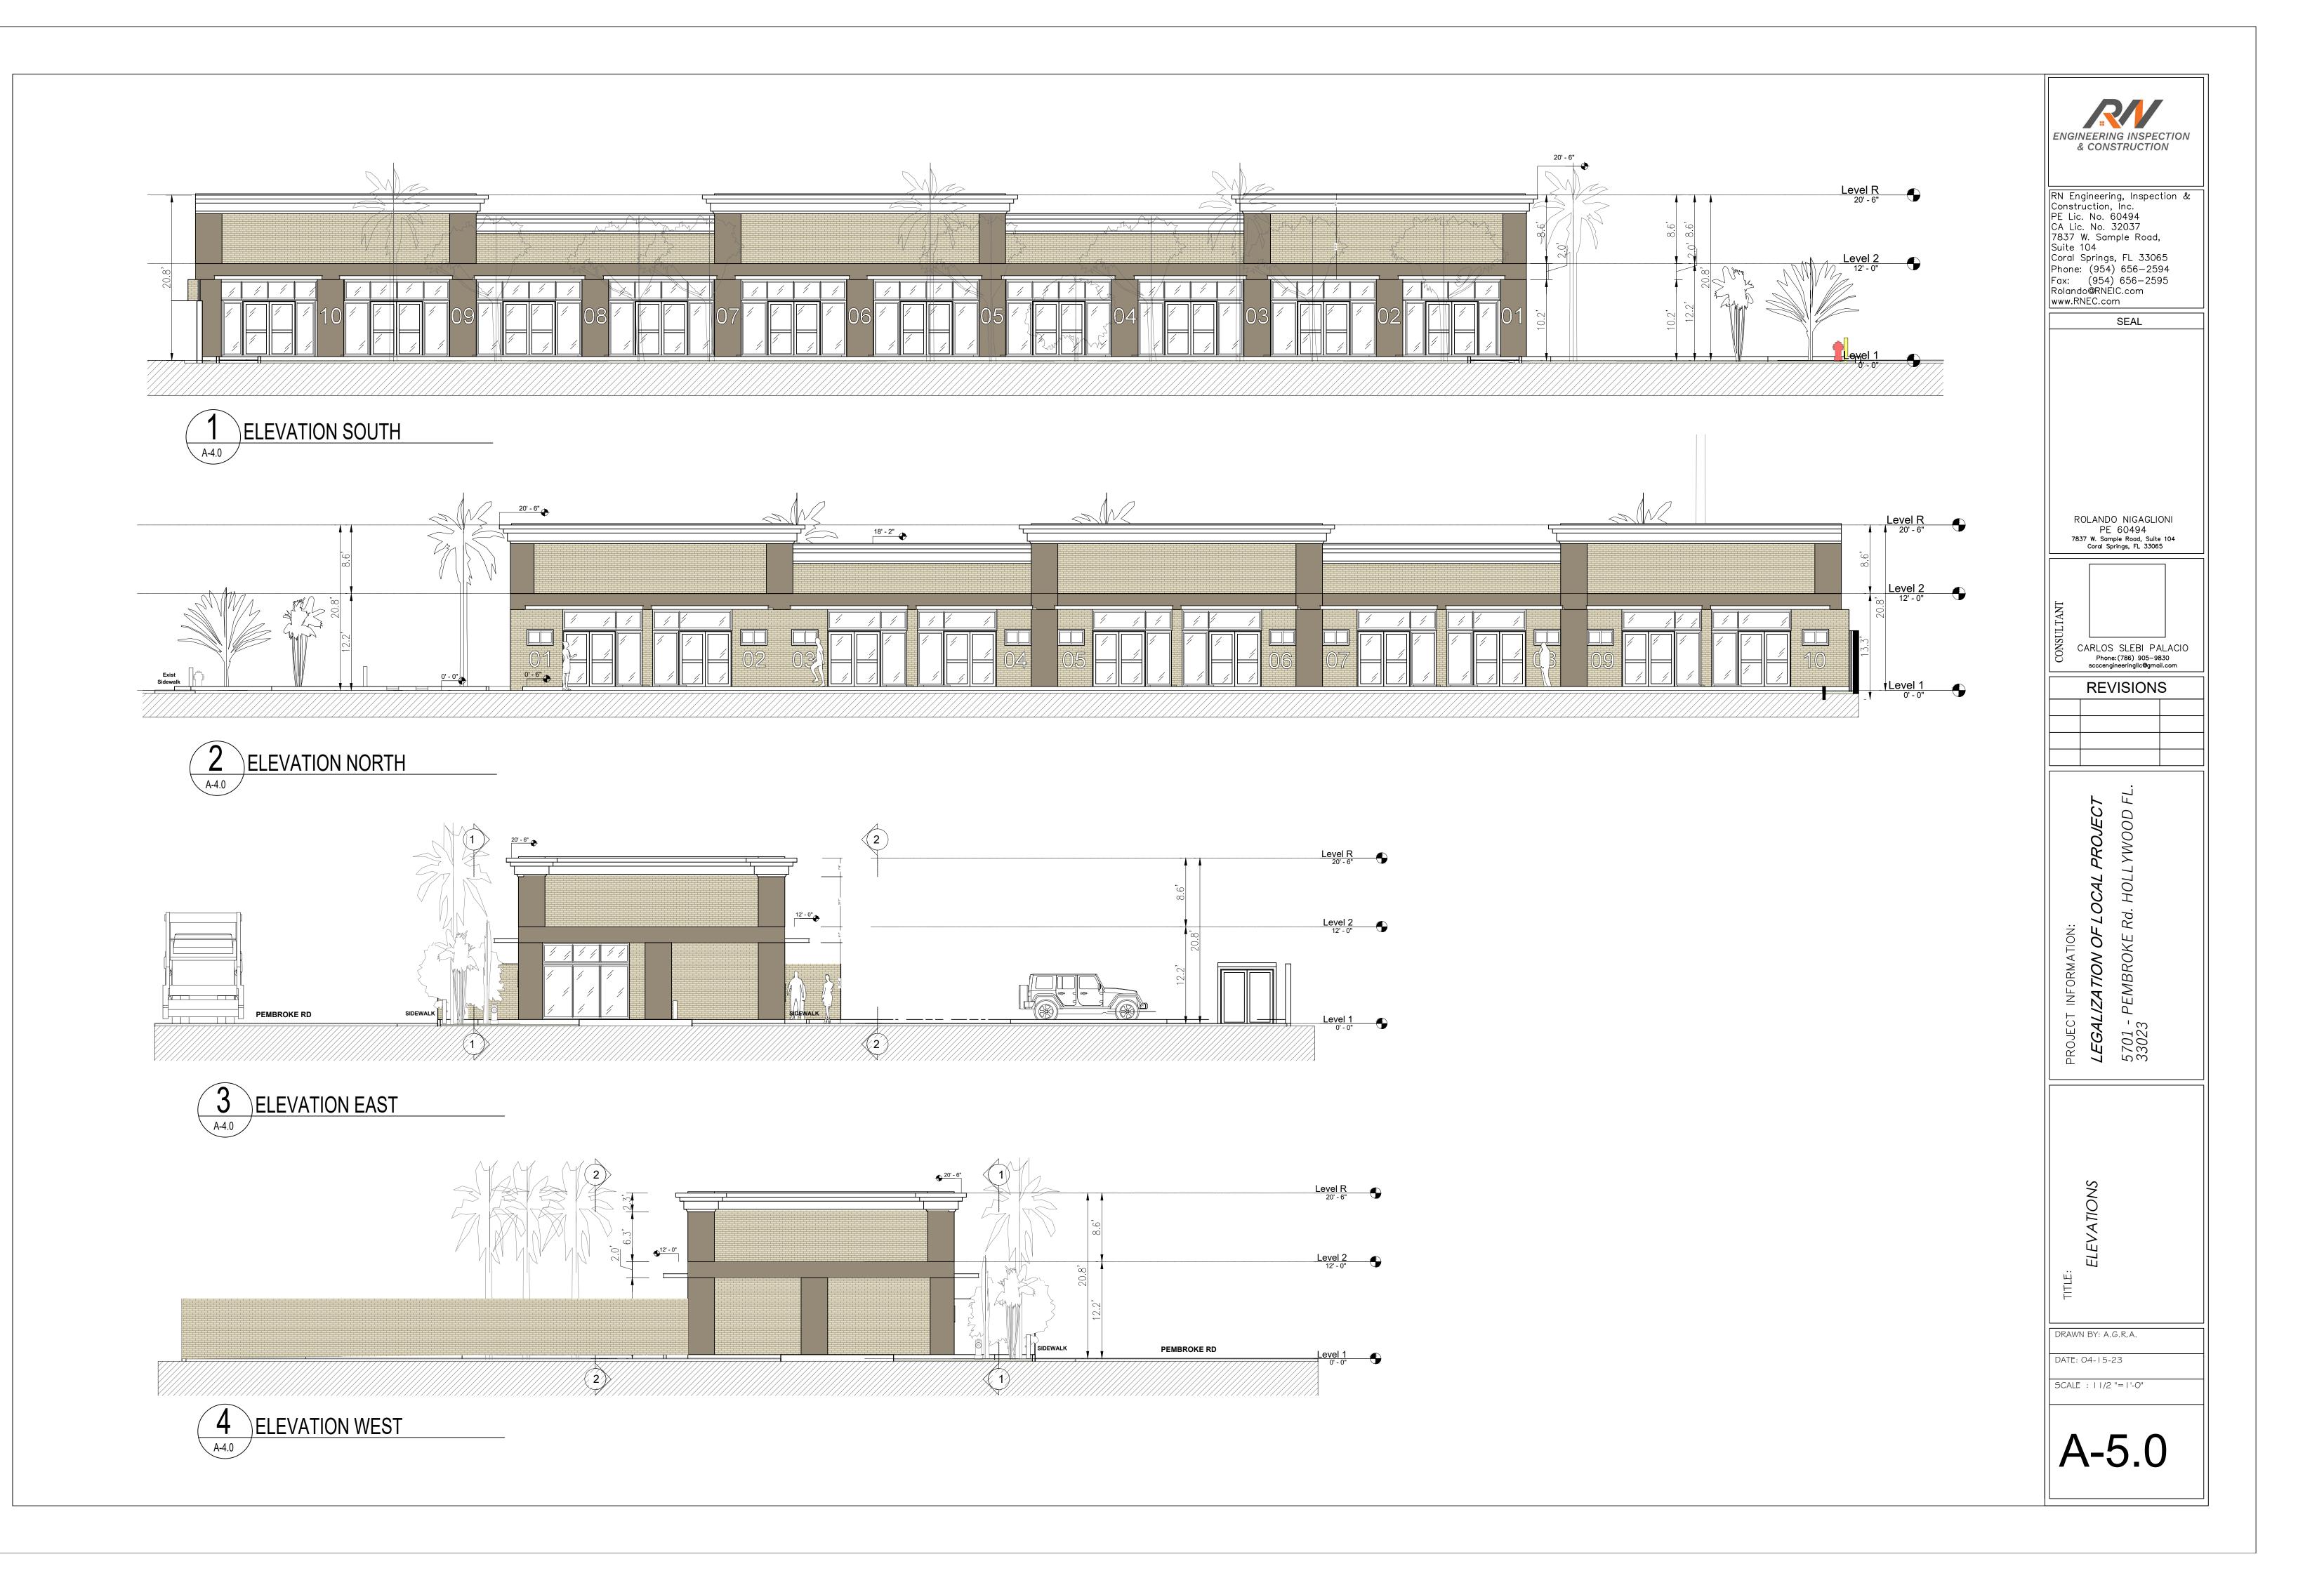

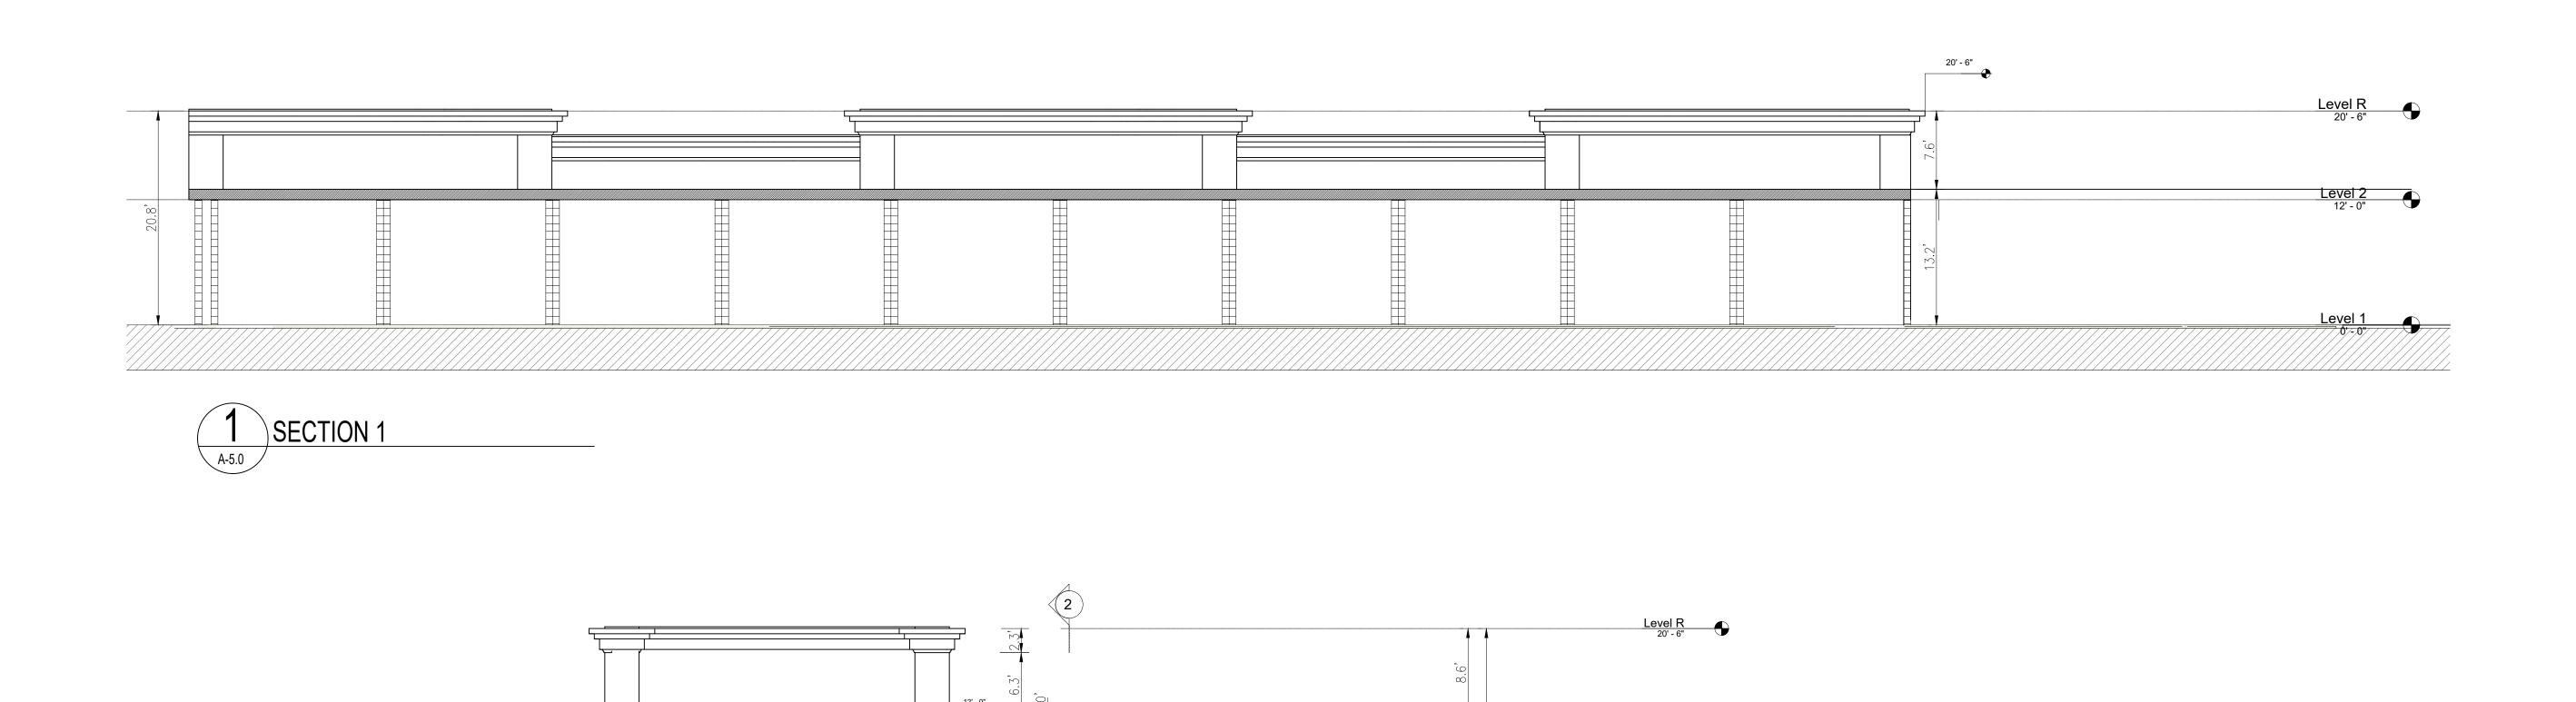

Level 2 12' - 0"

Level 1 0' - 0"

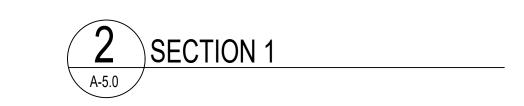

ENGINEERING INSPECTION & CONSTRUCTION

RN Engineering, Inspection & Construction, Inc.
PE Lic. No. 60494
CA Lic. No. 32037
7837 W. Sample Road,
Suite 104
Coral Springs, FL 33065
Phone: (954) 656-2594
Fax: (954) 656-2595
Rolando@RNEIC.com
www.RNEC.com

SEA

ROLANDO NIGAGLIONI PE 60494 7837 W. Sample Road, Suite 104 Coral Springs, FL 33065

CONSTITUTION CARLOS SLEBI PALACIO
Phone: (786) 905–9830
sccengineeringlic@gmail.com

REVISIONS

T FL.

PROJECT INFORMATION:

LEGALIZATION OF LOCAL PROJECT
5701 - PEMBROKE Rd. HOLLYWOOD FL.
33023

SECTIONS

DRAWN BY: A.G.R.A.

SCALE : | | /2 "= | '-0"

DATE: 04-15-23

A-6.0











SEAL

ROLANDO NIGAGLIONI PE 60494 7837 W. Sample Road, Suite 104 Coral Springs, FL 33065

ELWEIT

CARLOS SLEBI PALACIO
Phone: (786) 905-9830
scccengineeringllc@gmail.com

REVISIONS

CT D FL.

1LIZATION OF LOCAL PRO-PENBROKE Rd. HOLLYW

RENDERS

.. <u>-</u>

DRAWN BY: A.G.R.A.

SCALE : 11/2 "-1"

A-7.0







SEA

ROLANDO NIGAGLIONI PE 60494 7837 W. Sample Road, Suite 104 Coral Springs, FL 33065

CARLOS SLEBI PALACIO
Phone: (786) 905-9830
scccengineeringllc@gmail.com

REVISIONS

4*LIZATION OF LOCAL PROJECT*- PEMBROKE Rd. HOLLYWOOD FL


E: PENIDEPS

DRAWN BY: A.G.R.A.

DATE: 04-15-23

SCALE : 11/2 "=1'-0"

A-8.0

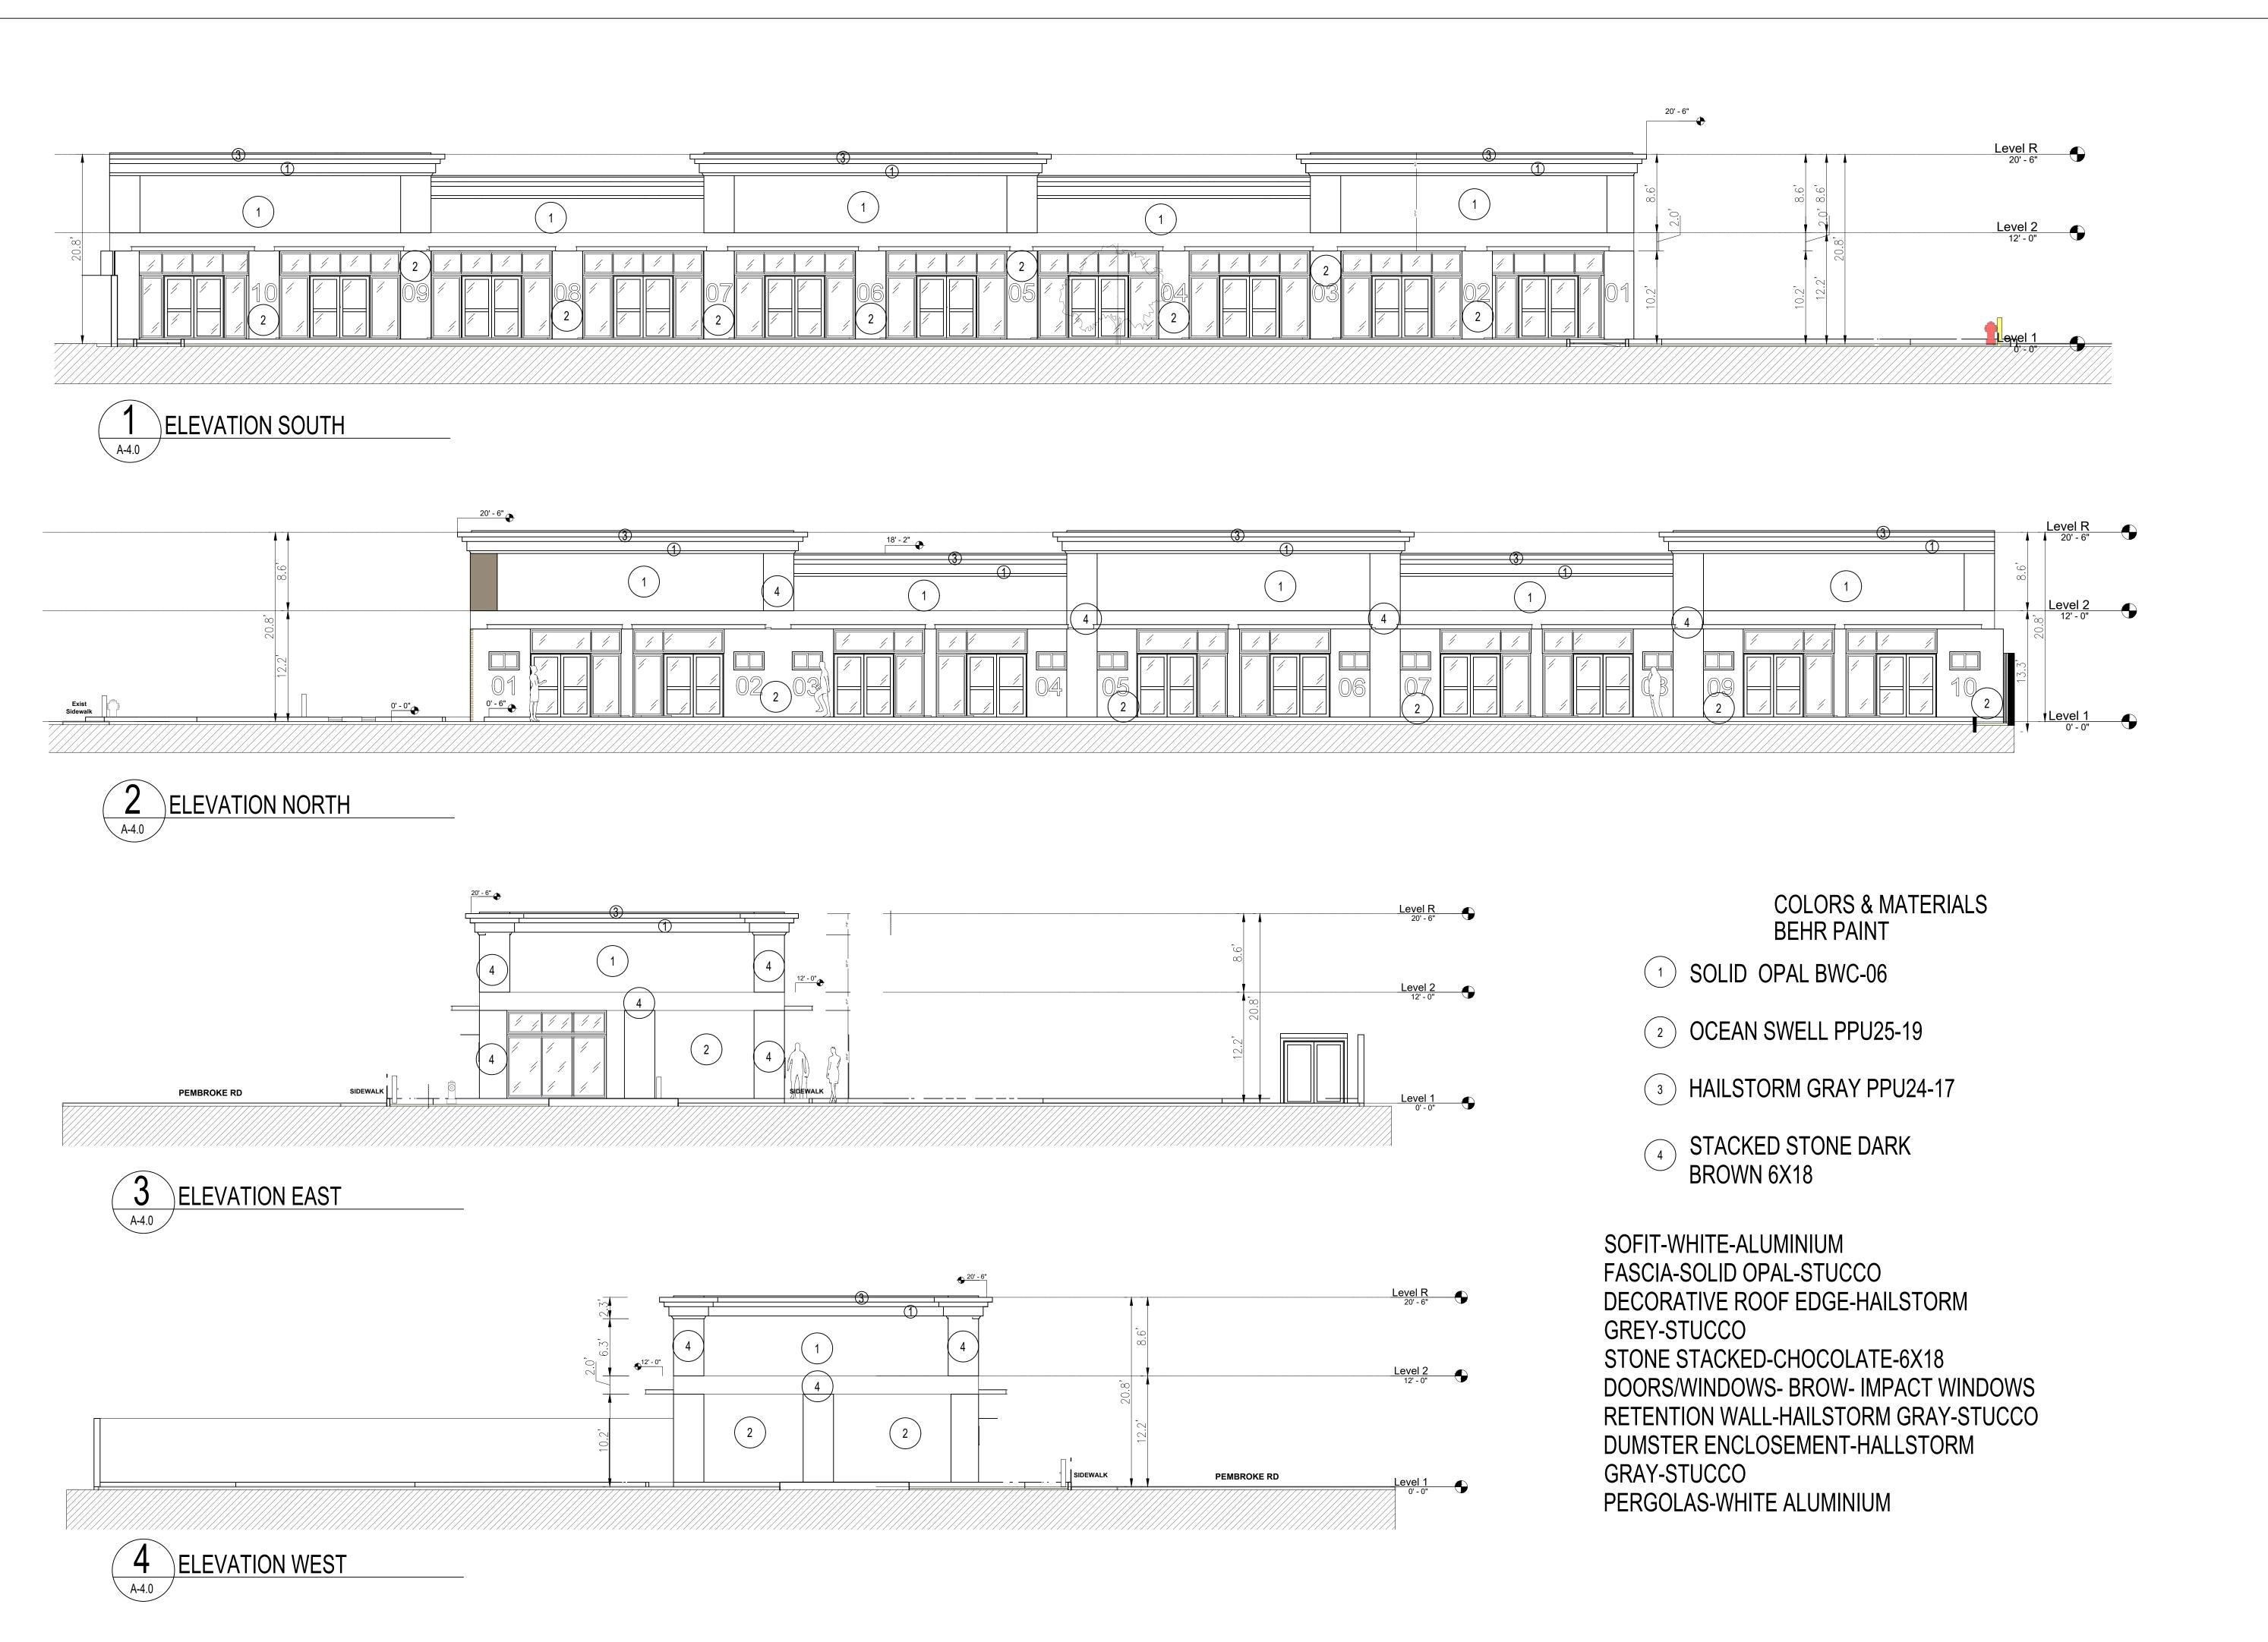

ENGINEERING INSPECTION & CONSTRUCTION

RN Engineering, Inspection & Construction, Inc.
PE Lic. No. 60494
CA Lic. No. 32037
7837 W. Sample Road,
Suite 104
Coral Springs, FL 33065
Phone: (954) 656-2594
Fax: (954) 656-2595
Rolando@RNEIC.com

www.RNEC.com

SEVI

ROLANDO NIGAGLIONI PE 60494 7837 W. Sample Road, Suite 104 Coral Springs, FL 33065

CARLOS SLEBI PALACIO

Phone: (786) 905-9830
scccengineeringlic@gmail.com

REVISIONS

PROJECT INFORMATION:

LEGALIZATION OF LOCAL PROJECT

5701 - PEMBROKE Rd. HOLLYWOOD FL.
33023

COLORS & MATERIALS

DRAWN BY: A.G.R.A.


SCALE : | | | 2 "= | '-0"

DATE: 04-15-23

A-9.0

- 1. IF DISCREPANCIES FOUND ON THESE PLANS ARE BETWEEN THESE PLANS AND ACTUAL FIELD CONDITIONS OR ANY OMISSIONS OR ERRORS THAT MIGHT PRODUCE DAMAGES DERIVED FROM THIS DESIGN, IT SHALL BE BROUGHT TO THE ENGINEER PRIOR TO BIDDING OR START OF ANY CONSTRUCTION.
- 2. CONTRACTOR, PRIOR TO START OF ANY CONSTRUCTION, SHALL VERIFY LOCATION OF ALL EXISTING UTILITIES ON THE FIELD WITH THE APPROPRIATE UTILITY COMPANY. IN THE EVENT THAT ANY ADJUSTMENT BE NECESSARY DUE TO A DISCREPANCY FOR UTILITY LOCATION, THE CONTRACTOR SHALL NOTIFY THE ENGINEER 48 HOURS BEFORE PROCEEDING. THE CONTRACTOR SHALL EXERT CARE AND CAUTION IN PROTECTING ALL UTILITIES DURING THE COMPLETION OF HIS WORK. IN THE EVENT OF ANY DAMAGE THE CONTRACTOR SHALL IMMEDIATELY NOTIFY THE APPROPRIATE UTILITY COMPANY. ANY AND ALL COSTS INCURRED DUE TO DAMAGE SHALL BE THE SOLE RESPONSIBILITY OF THE CONTRACTOR. FORTY—EIGHT (48) HOURS BEFORE DIGGING CALL SUNSHINE, TOLL FREE 1—800—432—4770.
- 3. EXISTING UTILITY LOCATIONS SHOWN ON THESE PLANS ARE APPROXIMATE. THE ENGINEER ASSUMES NO RESPONSIBILITY FOR THE ACCURACY OF EXISITING UTILITIES SHOWN OR FOR ANY EXISTING UTILITIES NOT SHOWN. THE CONTRACTOR SHALL BE RESPONSIBLE FOR DAMAGE TO ANY EXISTING UTILITIES FOR WHICH HE FAILS TO REQUEST LOCATIONS FROM THE UTILITY OWNER. HE IS RESPONSIBLE AS WELL FOR DAMAGE TO ANY EXISTING UTILITIES WHICH ARE PROPERLY LOCATED.
- 4. IF UPON EXCAVATION, AN EXISTING UTILITY IS FOUND TO BE IN CONFLICT WITH THE PROPOSED CONSTRUCTION OR TO BE OF A SIZE OR MATERIAL DIFFERENT FROM THAT SHOWN ON THE PLANS, THE CONTRACTOR SHALL IMMEDIATELY NOTIFY THE ENGINEER.
- 5. INDIVIDUAL SHOP DRAWINGS FOR ALL PRECAST STRUCTURES ARE REQUIRED. THE ENGINEER IS TO REVIEW THEM AND BE PAID.
- 6. ALL INSPECTIONS WILL BE MADE BY THE ENGINEER OF RECORD AND BE PAID. CONTRACTOR SHALL NOTIFY 48 HOURS IN ADVANCE THE ENGINEER OF RECORDS FOR INSPECTION. THE ENGINEER SHOULD BE ABLE TO PROVIDE CERTIFICATION FOR CONSTRUCTION COMPLETION BASED ON VISUAL INSPECTIONS, IF REQUIRED.
- 7. ALL OPEN TRENCHES AND HOLES ADJACENT TO ROADWAYS OR WALKWAYS SHALL BE PROPERLY MARKED AND BARRICADED TO ASSURE THE SAFETY OF BOTH VEHICULAR AND PEDESTRIAN TRAFFIC.
- 8. ALL FILL AND LIMEROCK BASE COURSE SHALL BE TESTED WITH DENSITY TESTS ACCORDING TO AASTHO SPECIFICATION T-180. COPIES OF RESULTS SHALL BE PROVIDED TO ENGINEER OF RECORDS PRIOR TO PLACING ASPHALT PAVEMENT.
- 9. UPON COMPLETION OF CONSTRUCTION, THE CONTRACTOR SHALL SUBMIT TO THE ENGINEER OF RECORD ONE COMPLETE SET OF AS-BUILT CONSTRUCTION DRAWINGS. THESE DRAWINGS SHALL BE MARKED TO SHOW AS-BUILT.
- 10. ALL AS-BUILT DRAWINGS SHALL BE SIGNED AND SEALED BY A FLORIDA REGISTERED LAND SURVEYOR.
- 11. NO MODIFICATIONS TO THESE PLANS ARE ALLOWED WITHOUT THE WRITTEN CONSENT OF THE ENGINEER. NO AGENCY INSPECTOR, CONTRACTOR, NOR THE OWNER ARE AUTHORIZED TO UNILATERALLY MODIFY THESE PLANS.
- 12. IT IS THE INTENT OF THE PLANS TO BE IN ACCORDANCE WITH APPLICABLE CODES AND AUTHORITIES HAVING JURISDICTION. ANY DISCREPANCIES BETWEEN THESE PLANS AND APPLICABLE CODES SHALL BE IMMEDIATELY BROUGHT TO THE ATTENTION OF THE FNGINFER
- 13. ALL DRIVING SURFACES MUST BE CONSTRUCTED ON AN EIGHT (8) INCH ROCK BASE THAT WILL PRODUCE A C.B.R. VALUE OF NO LESS THAN 25 WHEN COMPACTED TO A MINIMUM FIELD DENSITY OF 98% OF MAX. DENSITY AS DETERMINED BY AASTHO T—180. WITH REINFORCED CONCRETE SLAB. SEE STRUCTURAL PLANS FOR DETAILS.
- 14. ALL DIMENSIONS IN THESE PLANS SHALL BE VERIFIED BY THE CONTRACTOR IN THE FIELD.
- 15. ALL WORK SHALL MEET SUNNY ISLES BEACH PUBLIC WORK DEPARTMENT STANDARDS.
- 16. WATER TABLE PER WC 2.2 IS 2.00 N.G.V.D.
- 17. ALL ELEVATIONS SHOWN ARE REFERRED TO NATIONAL GEODETIC VERTICAL DATUM 1929.
- 18. UNDERGROUND CONTRACTOR SHALL COMPLY WITH THE TRENCH SAFETY ACT HB 3183, FLORIDA STATUTES.
- 19. ALL MUCK, PEAT, AND/OR CLAY WITH HIGH PERCENTAGE OF ORGANIC MATERIAL AND OR EXISTING UNSUITABLE FILL MATERIAL SHALL BE REMOVED FROM PROPOSED RIGHT OF WAY OR PROPOSED PAVEMENT AREAS IF ANY. FOR DETAILED SPECIFICATIONS SEE M.D.C.P.W.D. SPECS., SECTION 30.
- 20. ALL TOP FINISHED GRADES FOR EXISTING MANHOLES, VALVE LIDS AND SIMILAR UTILITIES STRUCTURES SHALL BE ADJUSTED TO NEW FINISHED GRADES, IF AFFECTED
- 21. THESE PLANS WERE PREPARED USING INFORMATION FROM SURVEY DONE BY BENNY SUAREZ SURVEYING INC.
- 22. FLOOD INSURANCE RATE MAP, ZONE 'X' MAP NUMBER 12086C0726L, BASE FLOOD NOT DETERMINDED, MAP REVISED SEPTEMBER 11, 2009.
- 23. SHOWN INFORMATION FOR EXISTING UTILITIES AS IT WAS RECEIVED BY UTILITIES OWNERS UNDER CHAPTER 556, FLORIDA STATUTES.
- 24. DRAINAGE PIPING HIGH DENSITY POLYETHYLENE SHALL CONFORM ASTM F477, AASHTO M294, M252 REQUIREMENTS.

PAVING, GRADING & DRAINAGE PLANS 5701 PEMBROKE Rd. HOLLYWOOD FL. RETAIL COMMERCIAL BUILDING

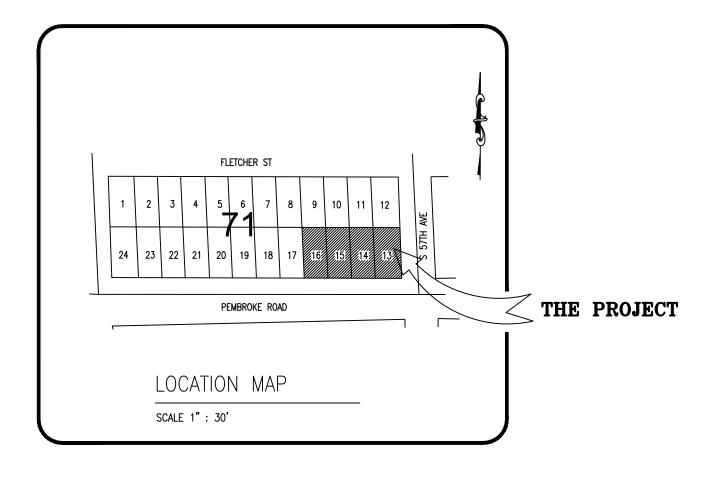

<u>LEGAL DESCRIPTION:</u>

LOTS 13 THRU 16, BLOCK 71 OF WEST CARVER RANCHES ADDITION NO. 2, ACCORDING TO THE PLAT THEREOF, AS RECORDED IN PLAT BOOK 26 AT PAGE 36 OF THE PUBLIC RECORDS OF BROWARD COUNTY, FLORIDA; LESS THE FOLLOWING DESCRIBED PORTION OF SAID LOT 13, COMMENCING AT THE NORTHEAST CORNER OF SAID LOT 13 THENCE SOUTH 75.95 FEET TO THE POINT OF BEGINNING; THENCE SOUTH 29.05 FEET, THENCE WEST 22.84 FEET, THENCE NORTHEAST 36.10 FEET TO THE POINT OF BEGINNING.

NOTE:

ALL ELEVATIONS SHOWN HERE ON ARE REFERENCED TO NATIONAL GEODETIC VERTICAL DATUM OF 1929 (NGVD)

INDEX:

C-1 COVER SHEET

C-2 PAVING, GRADING & DRAINAGE PLAN

-3 PAVING, GRADING & DRAINAGE PLAN

DRAINAGE DETAILS
DRAINAGE DETAILS

ENGINEERING INSPECTION & CONSTRUCTION

RN Engineering, Inspection & Construction, Inc.
PE Lic. No. 60494
CA Lic. No. 32037
7837 W. Sample Road,
Suite 104
Coral Springs, FL 33065
Phone: (954) 656—2594
Fax: (954) 656—2595
Rolando@RNEIC.com
www.RNEC.com

SEA

ROLANDO NIGAGLIONI PE 60494 7837 W. Sample Road, Suite 104 Coral Springs, FL 33065



REVISIONS

WG. HOLLYWOOD FL.

PROJECT INFORMATION:

PROPOSE RETAIL

COMMERCIAL BUILDING

5701 - PEMBROKE Rd. HOL

33023


COVER PAVING, GRADING & DRAINAGE


DRAWN BY: A.G.R.A.


DATE: 12-18-23


SCALE : AS SHOWN


C-'

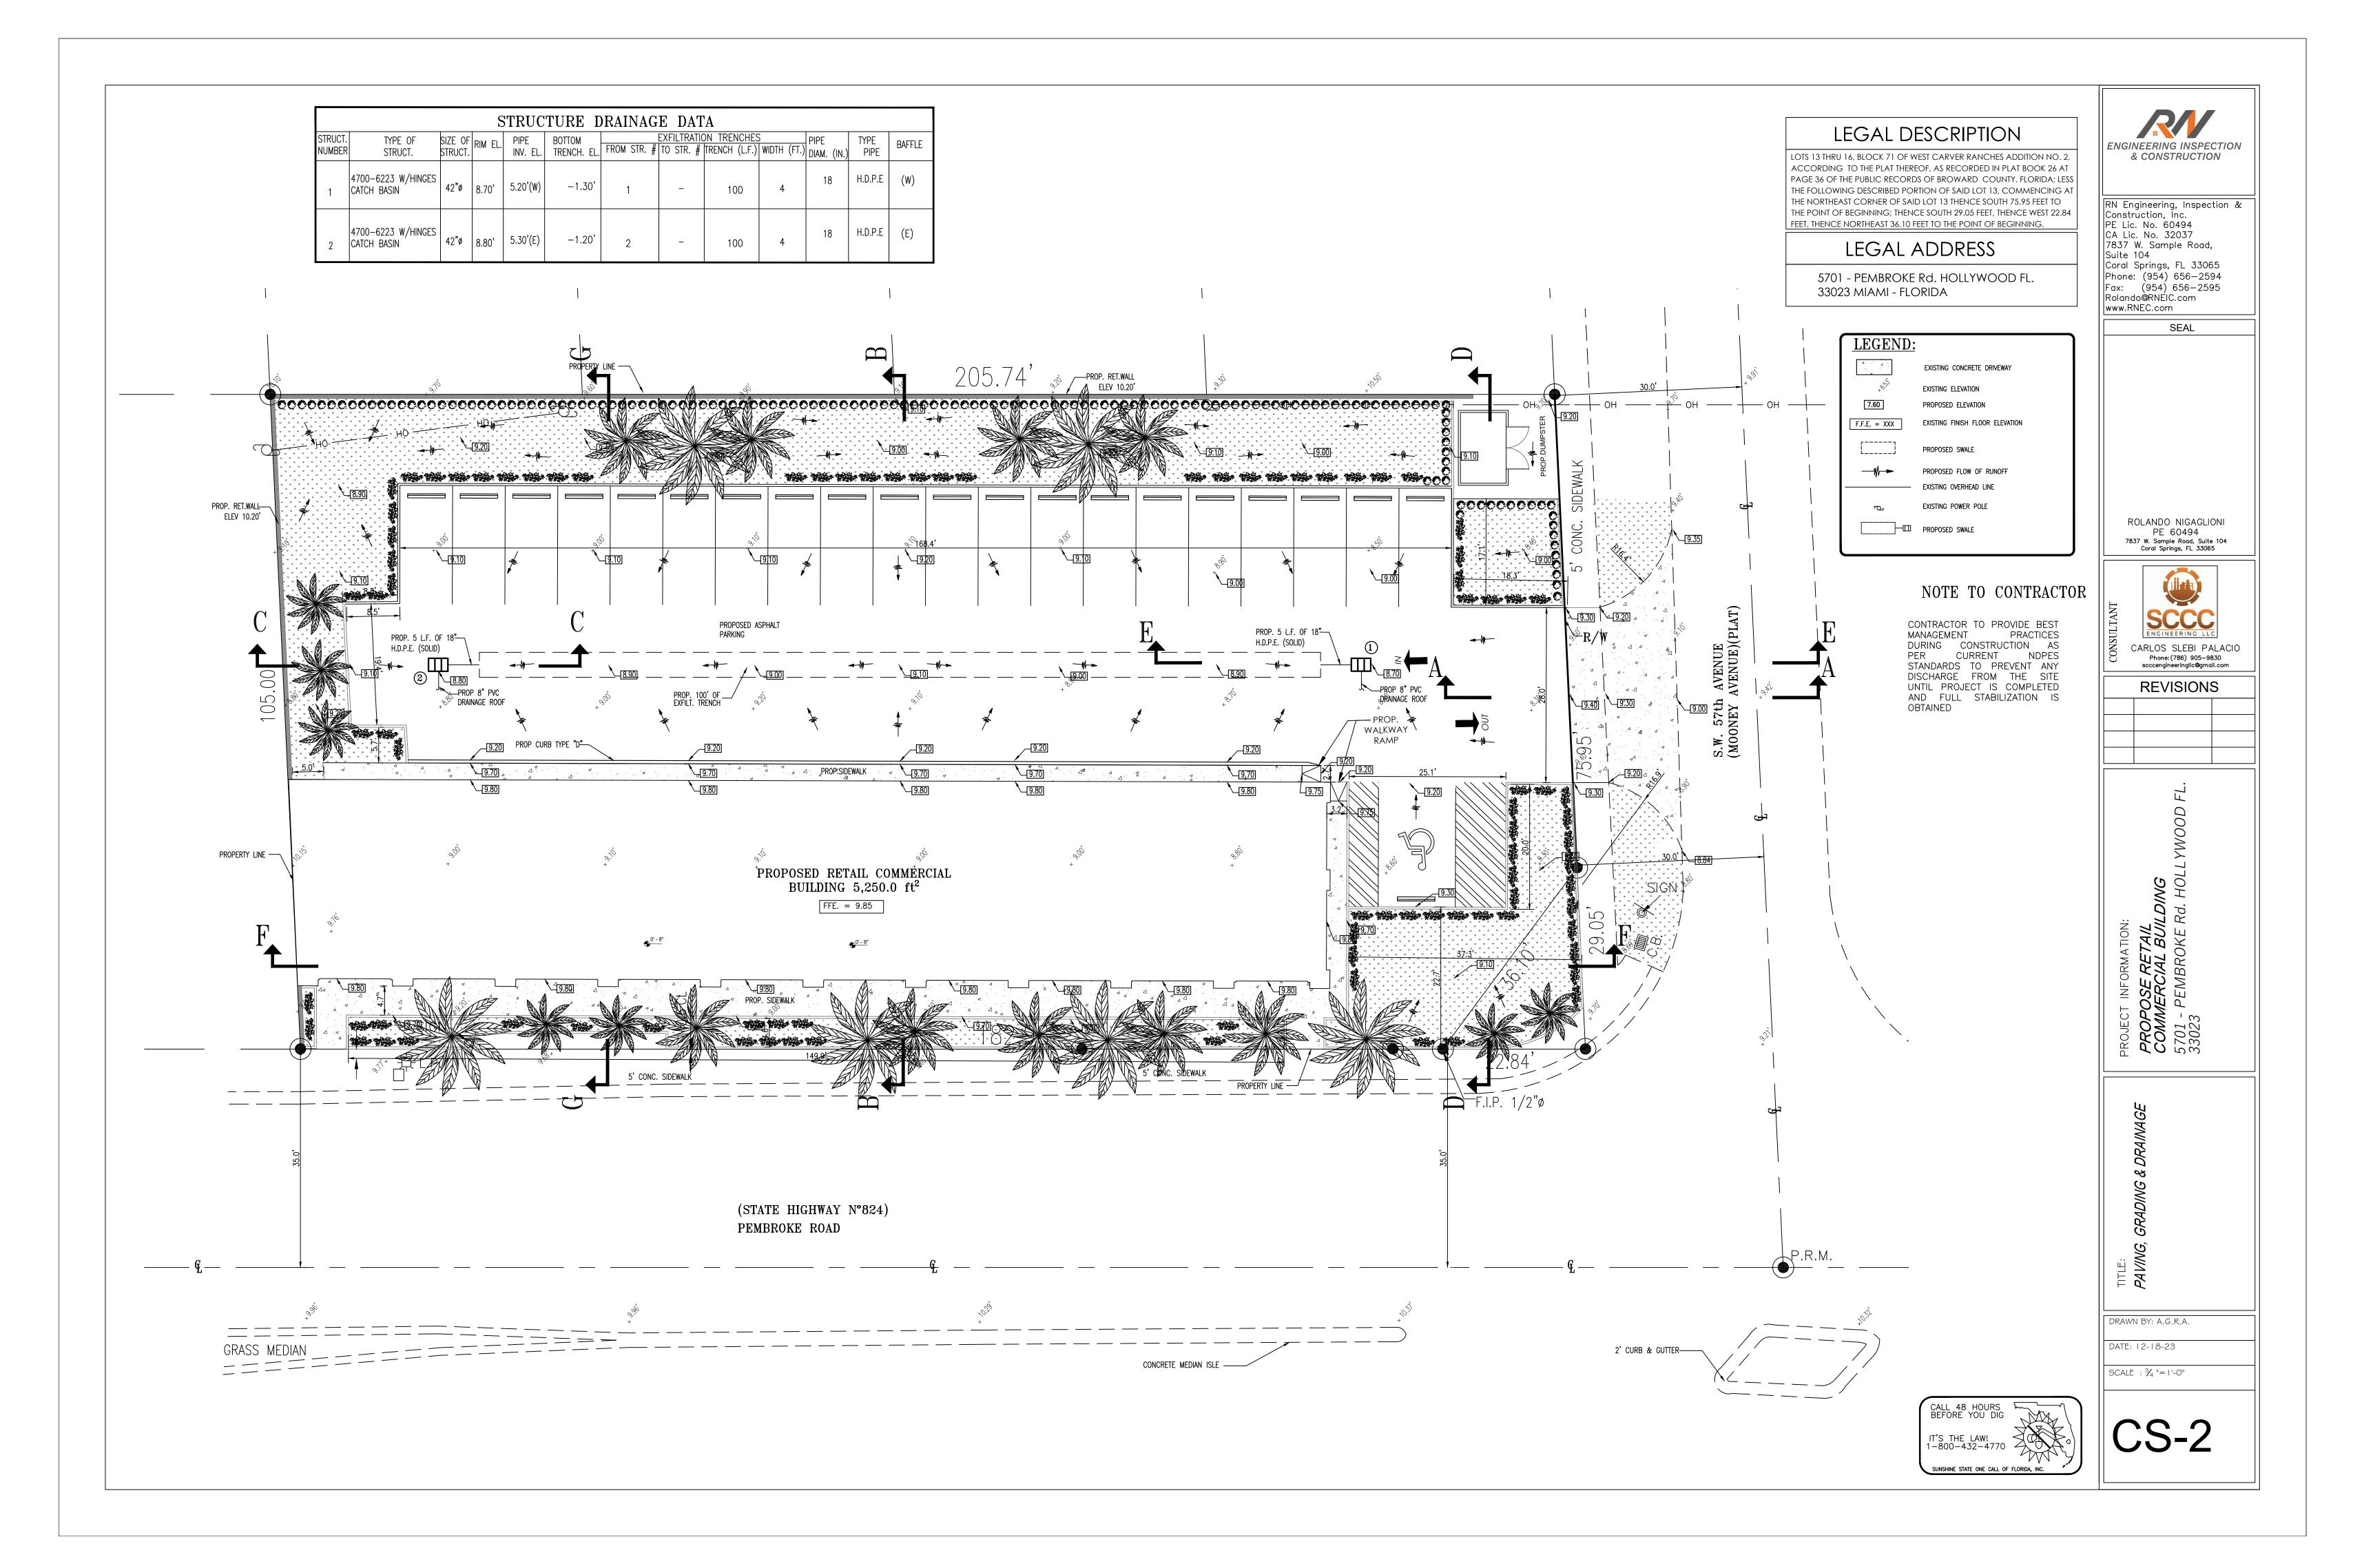

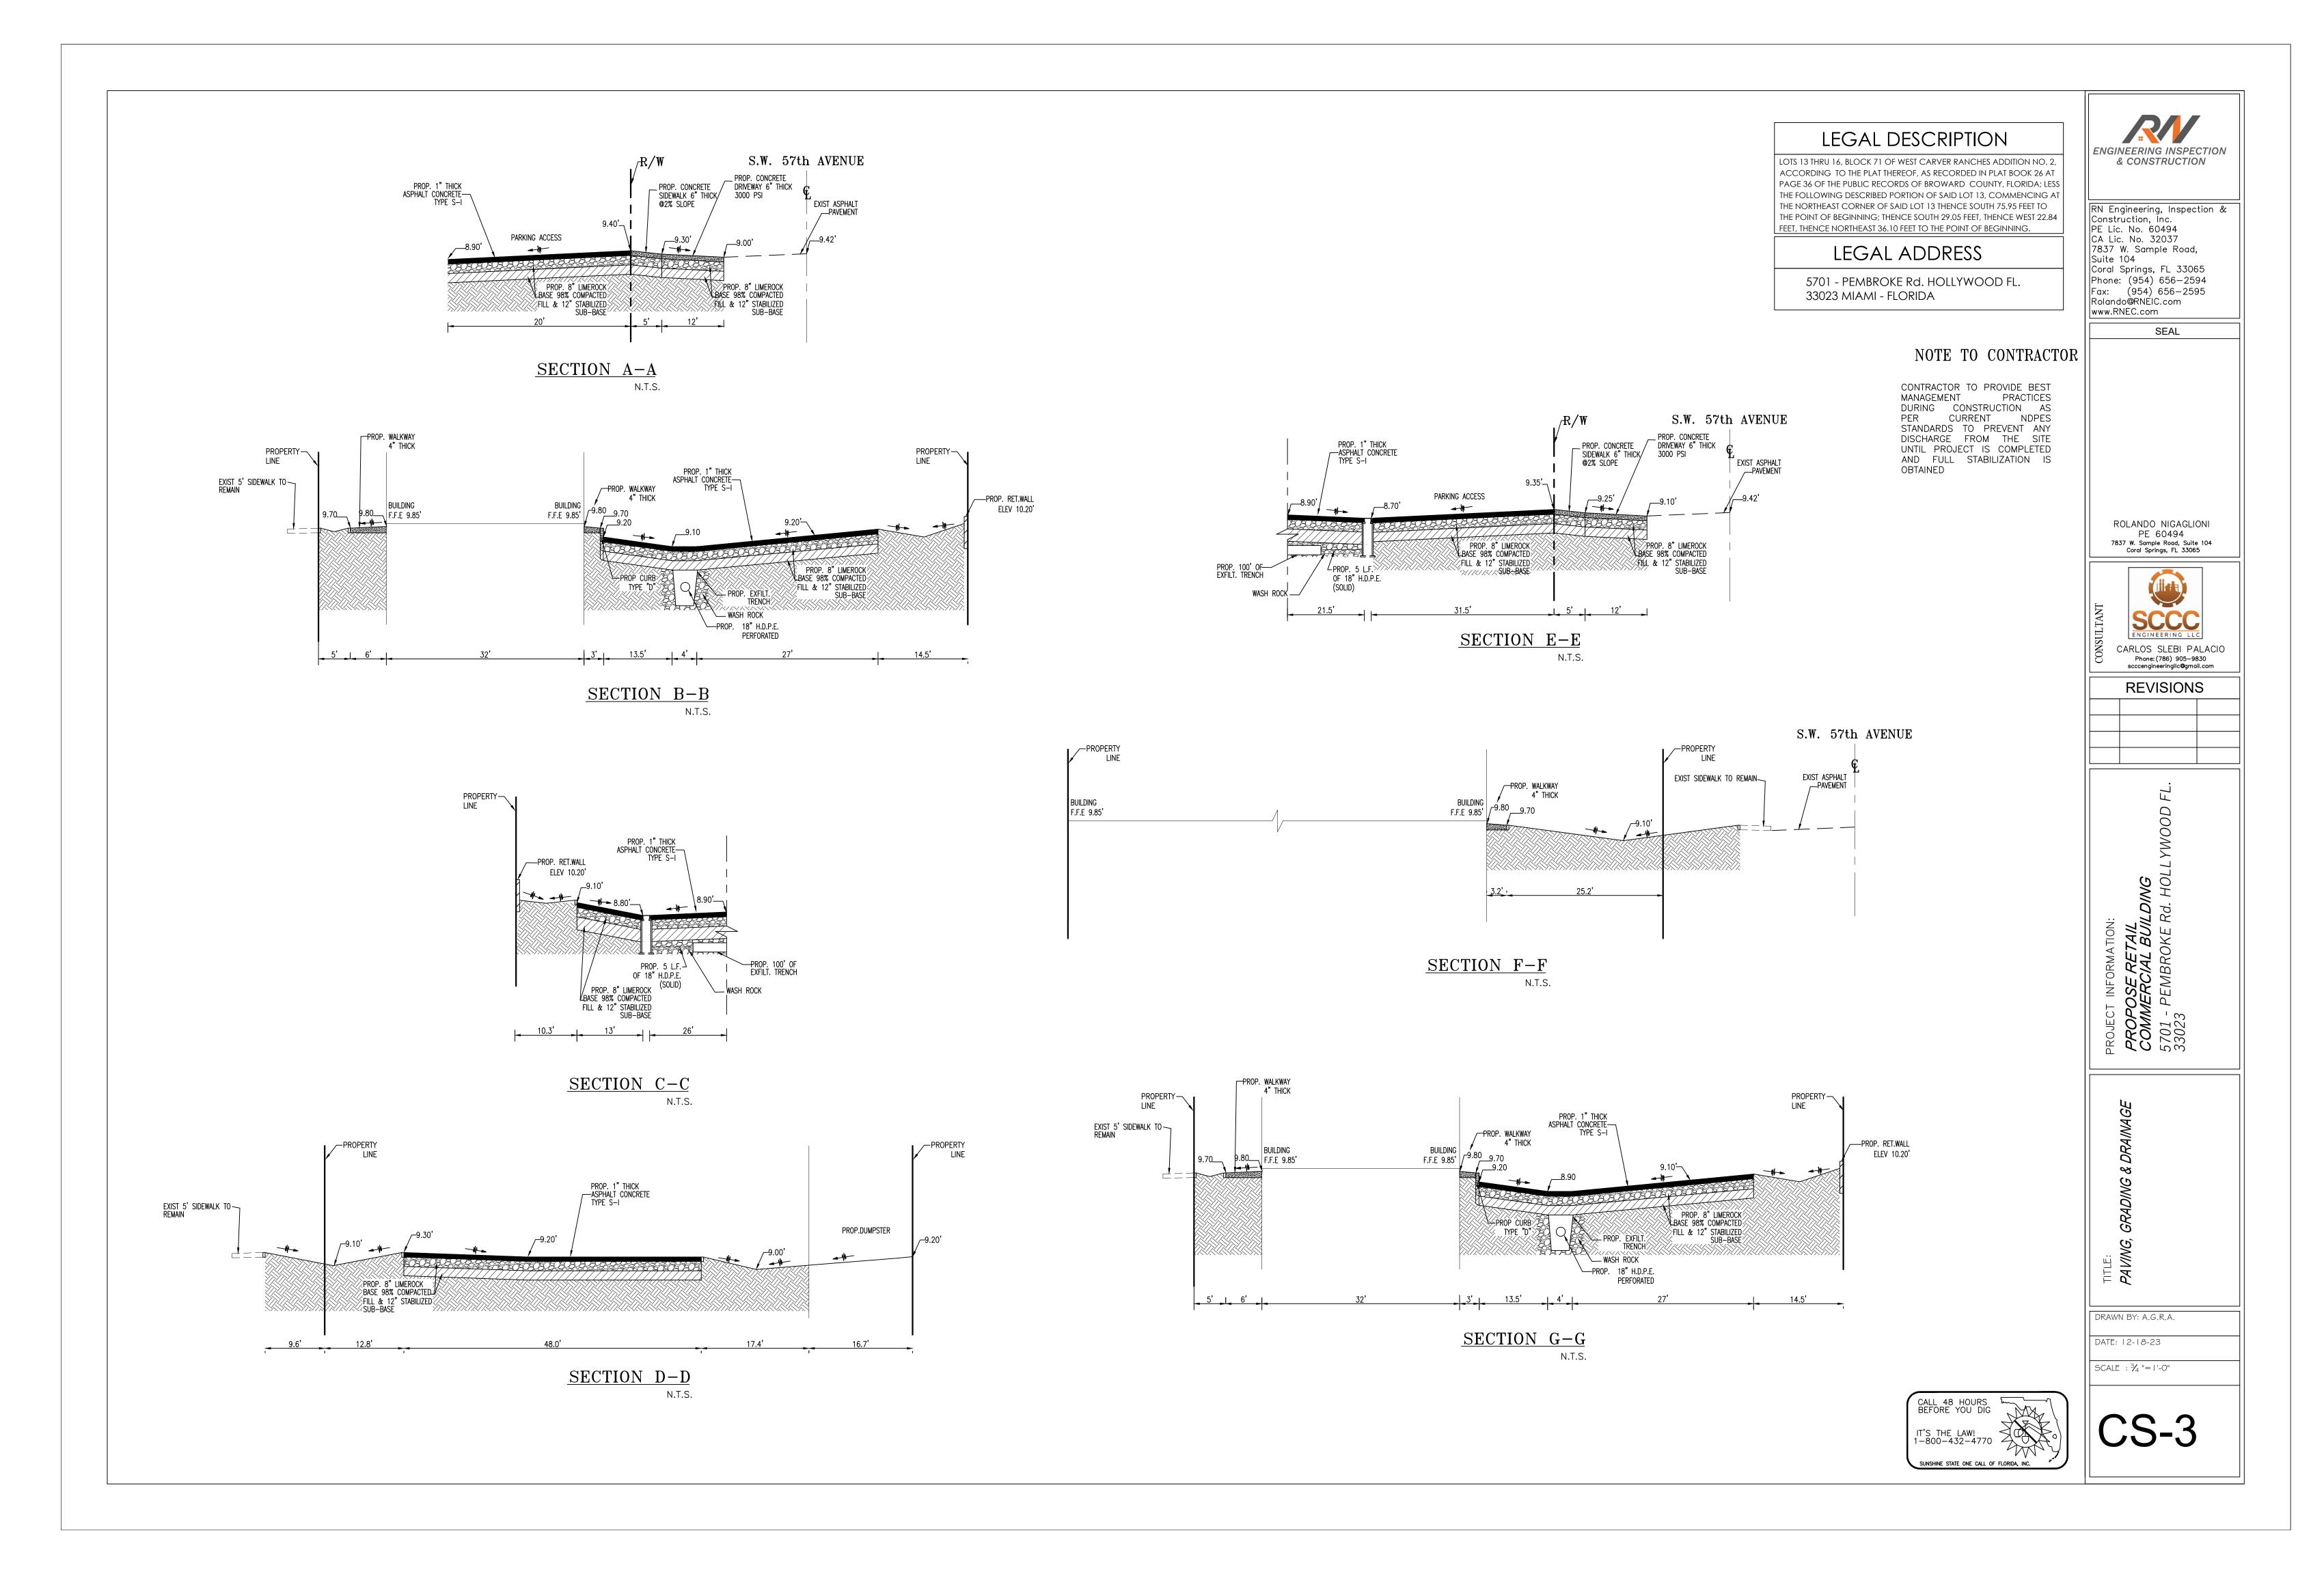

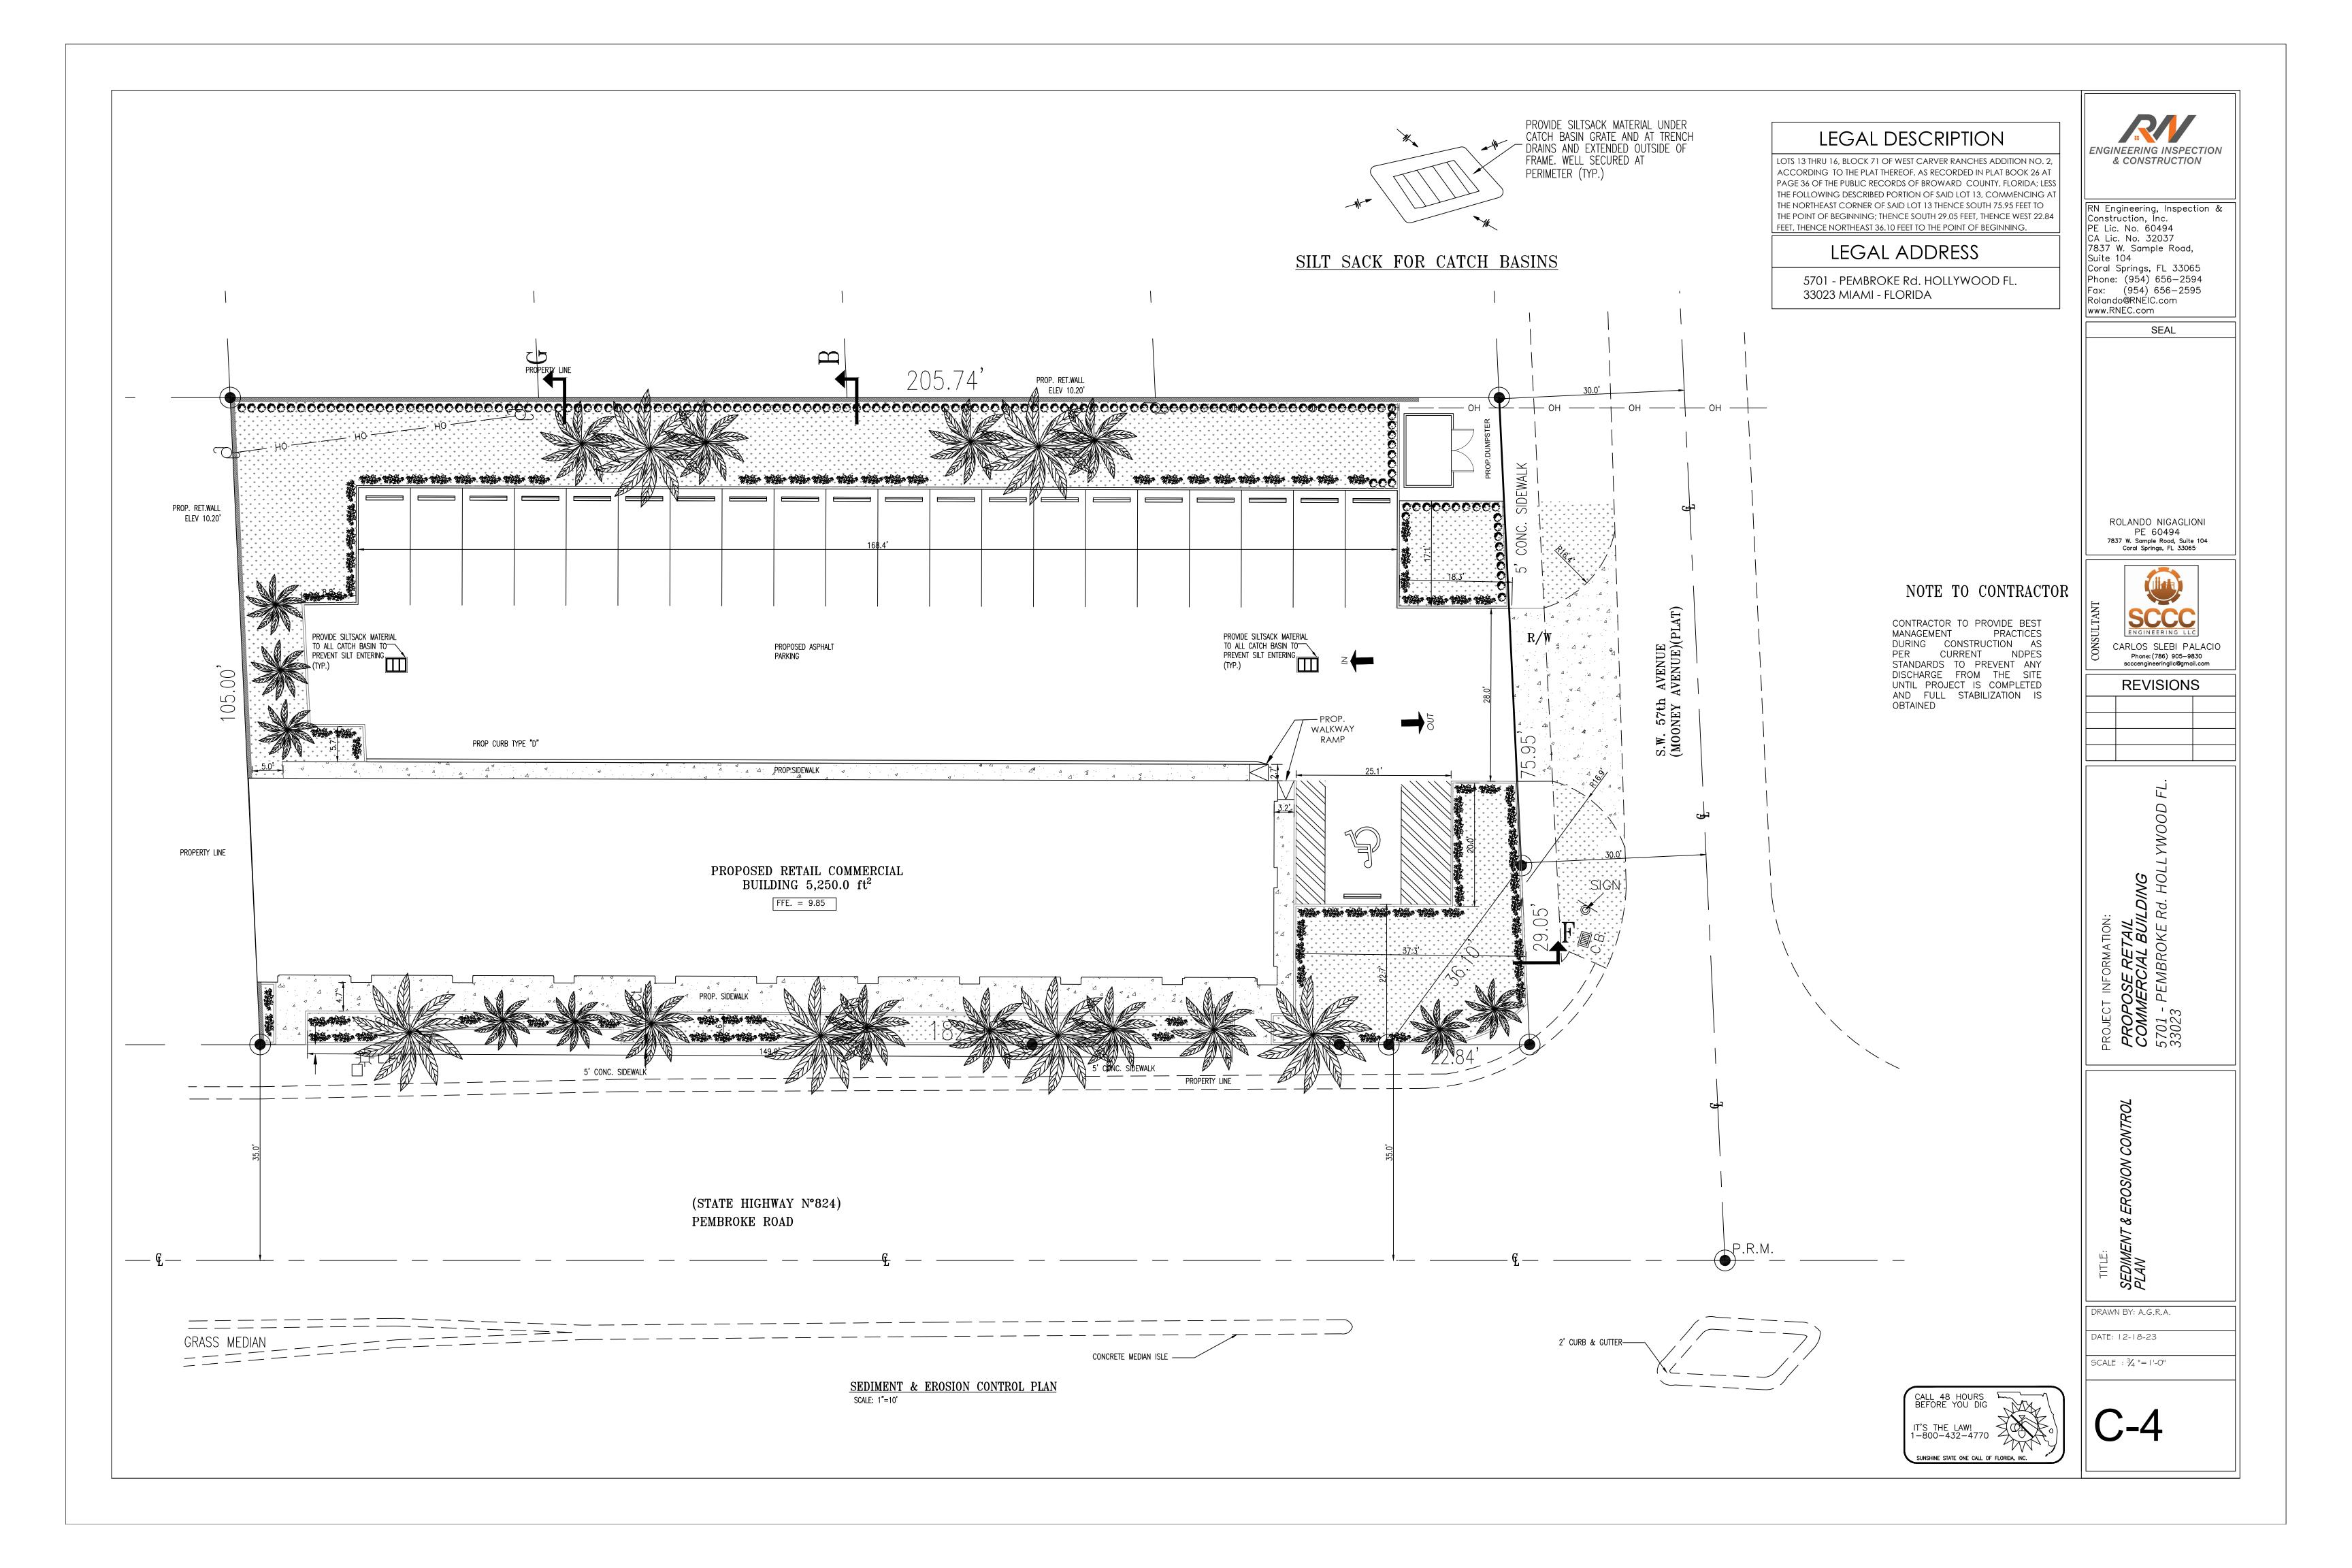

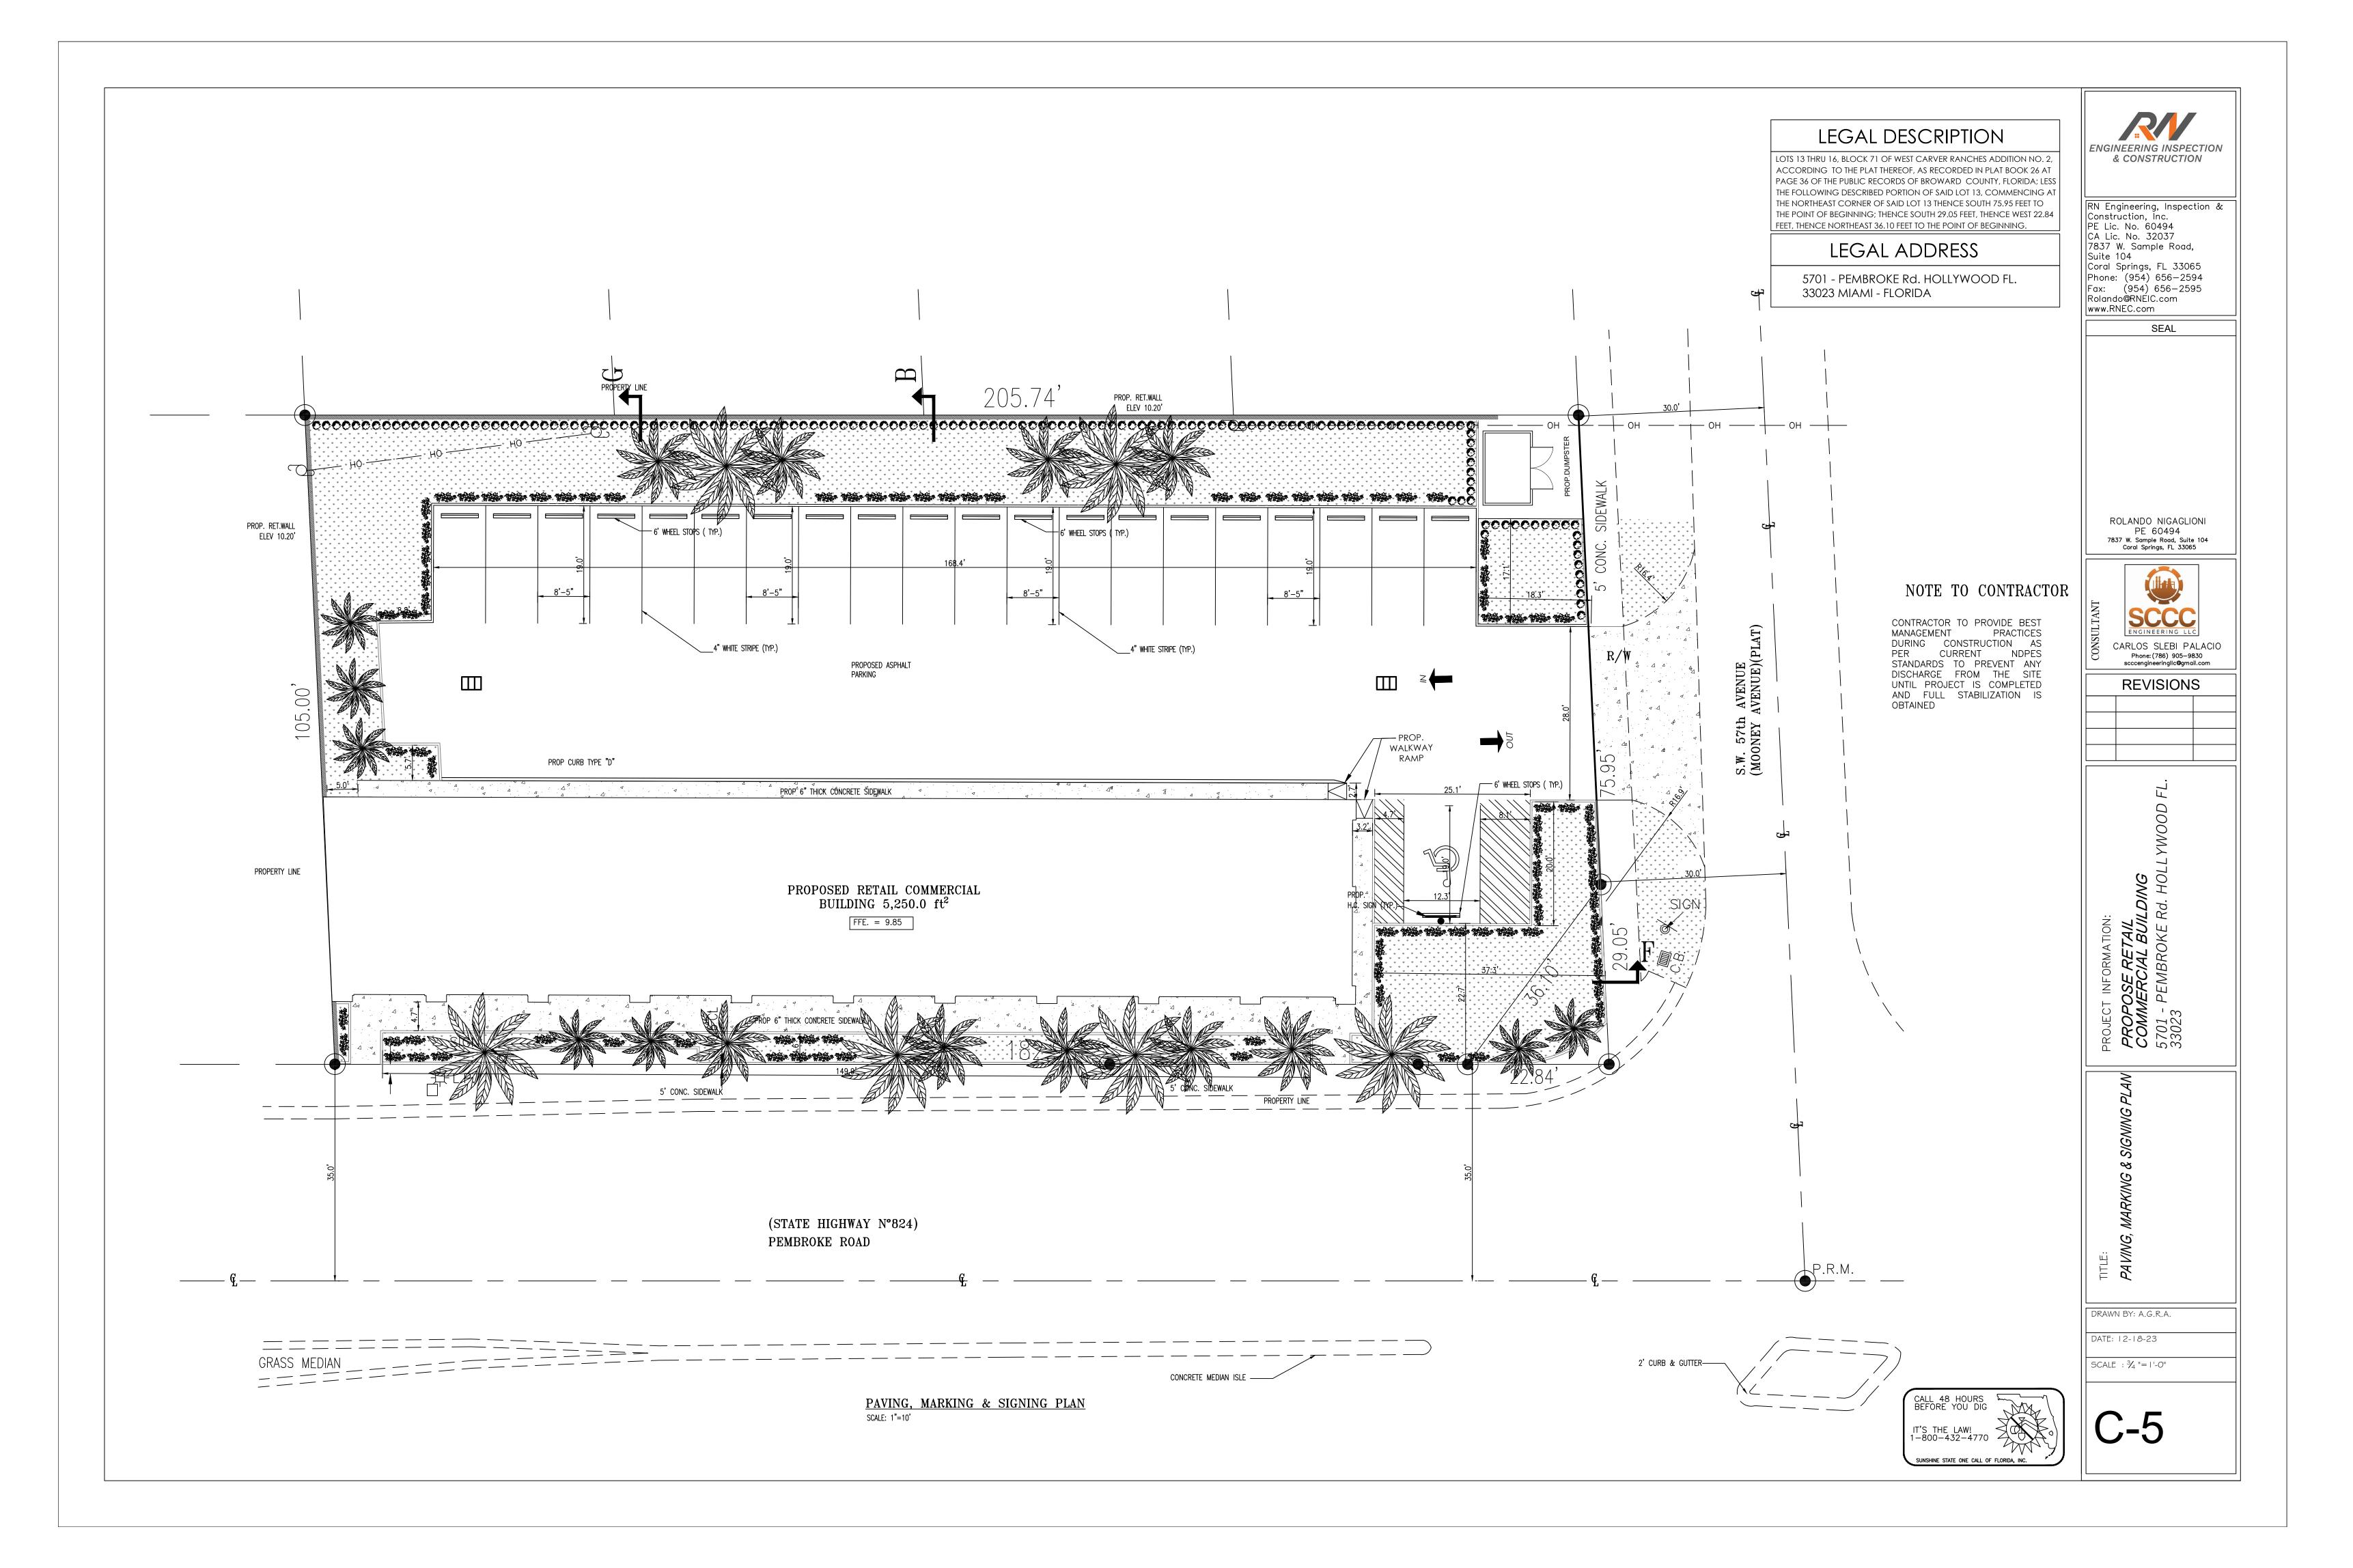

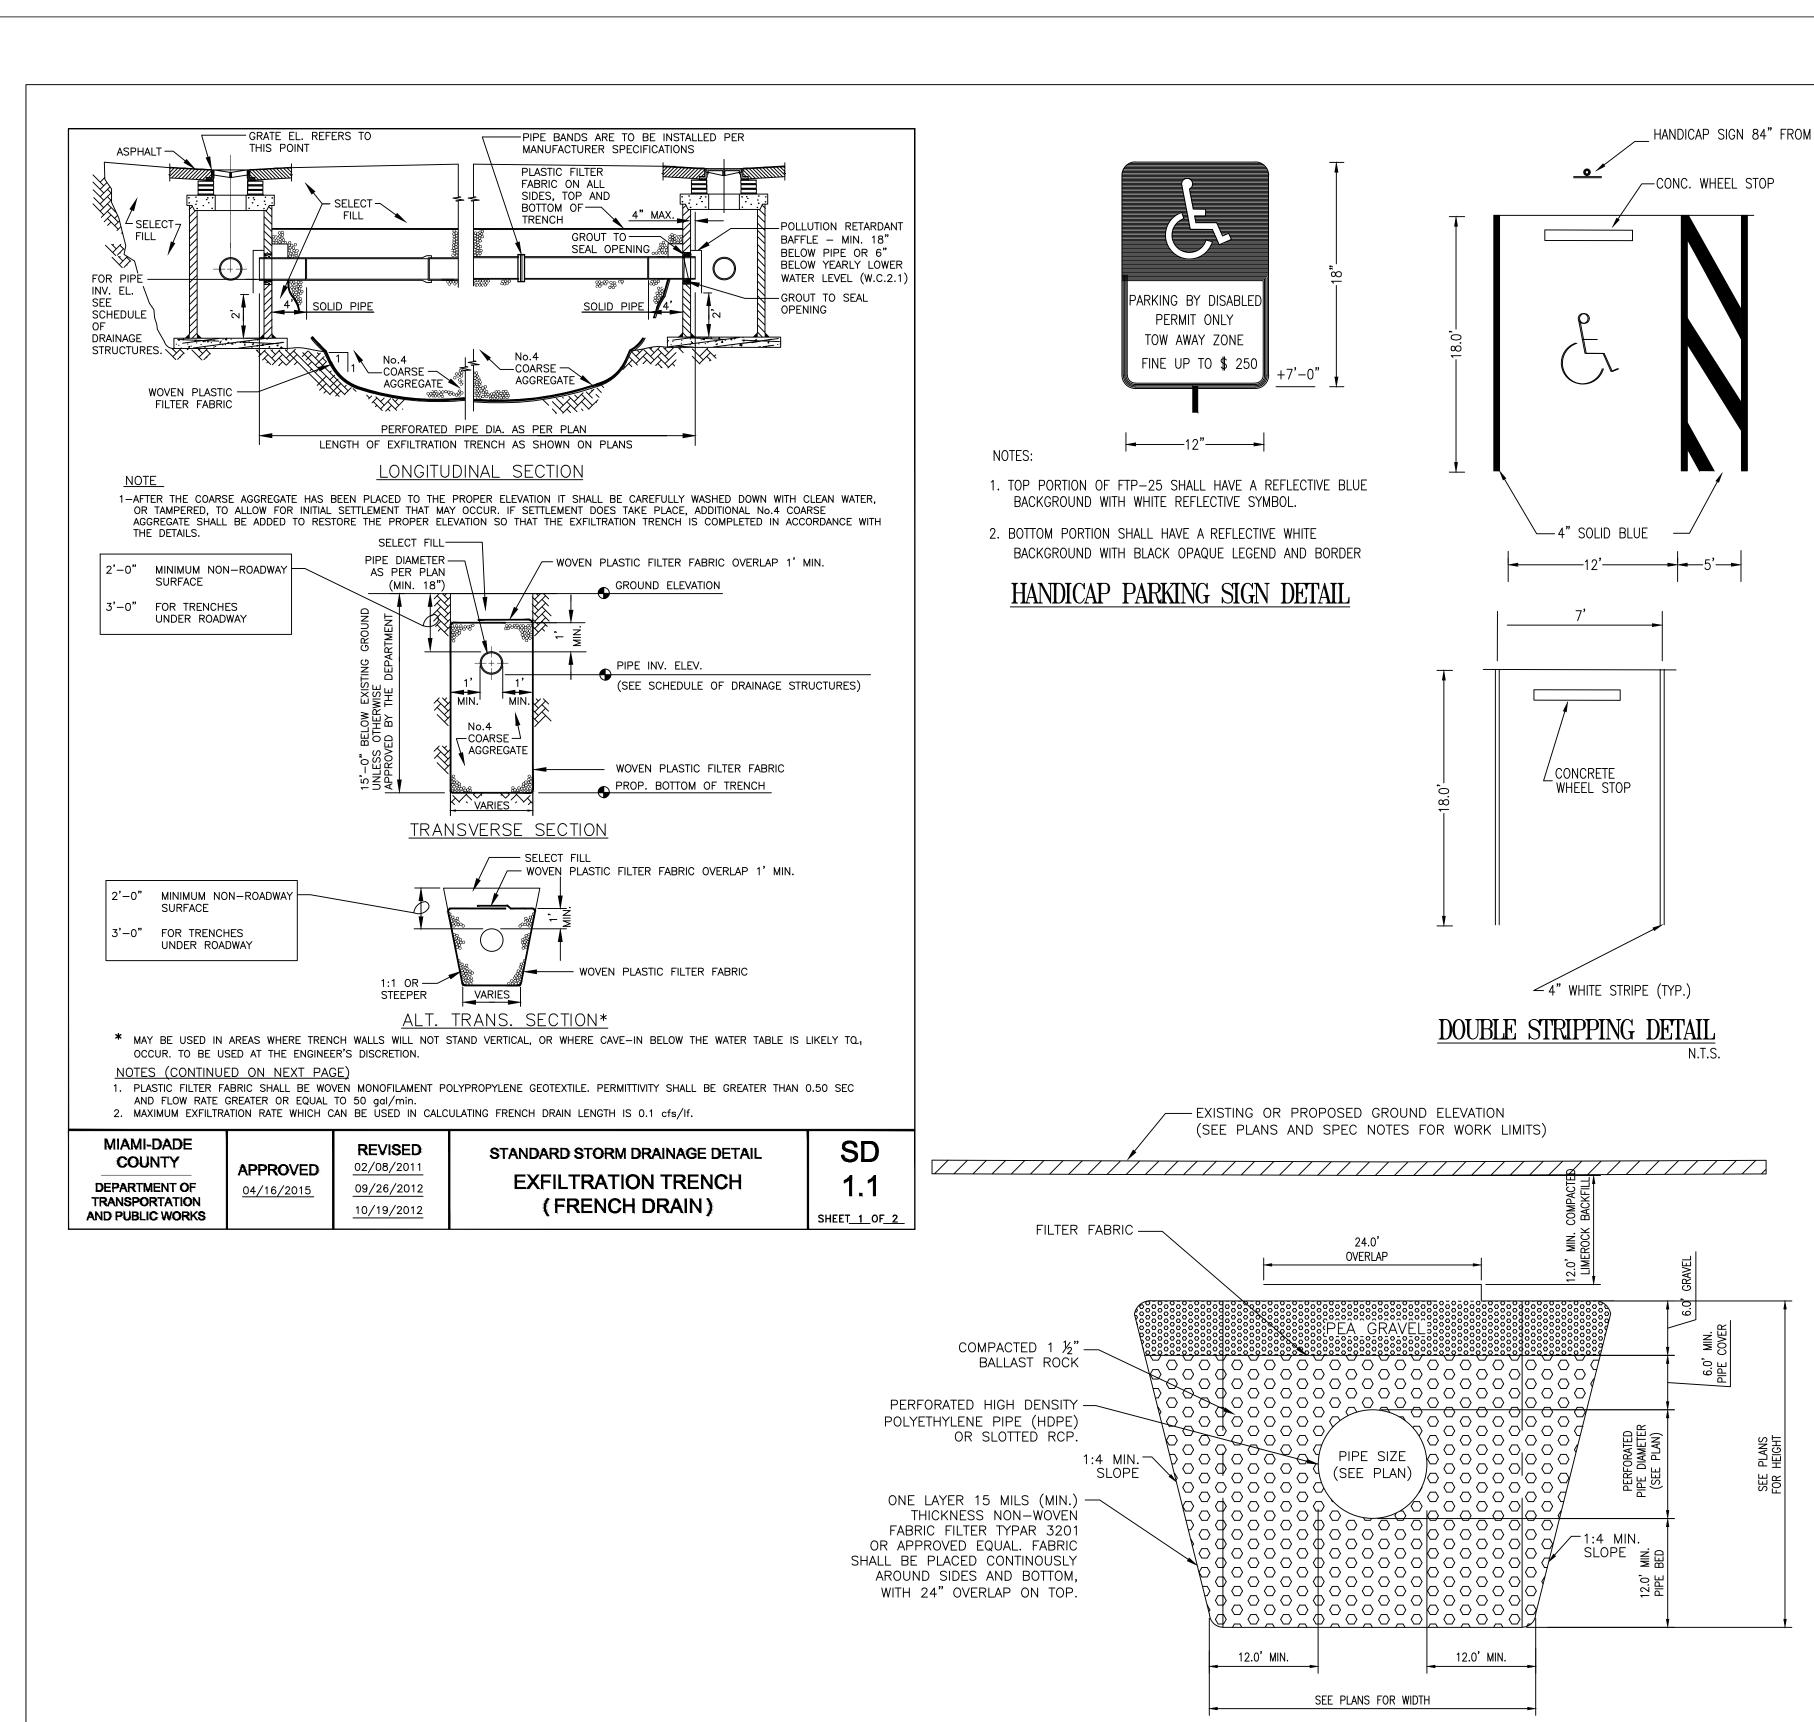


TRANSVERSE CROSS SECTION


NOTES:

- 1. CONTRACTOR MUST READ AND ABIDE THE CITY'S GENERAL CONSTRUCTION NOTES AND DRAINAGE DESIGN NOTES PRIOR TO STARTING CONSTRUCTION.
- 2. THE STANDARD CROSS SECTION SHALL BE CONSTRUCTED UNLESS OTHER SECTIONS ARE DESCRIBED OR DETAILED ON PLANS.
- 3. THE CONTRACTOR SHALL TAKE THE NECESSARY PRECAUTIONS TO PREVENT CONTAMINATION OF THE TRENCH WITH SAND, SILT AND FOREIGN MATERIALS.
- 4. THE 12" WEEP HOLE SHALL NOT BE USED IF THE BOTTOM OF THE INLET OR MANHOLE IS BELLOW THE NORMAL WATER TABLE, UNLESS OTHERWISE SHOWN ON PLANS.
- 5. FRENCH DRAINS MUST BE INSPECTED BY THE ENGINEERING INSPECTOR PRIOR TO CONTRACTOR BACKFILLING.

D620

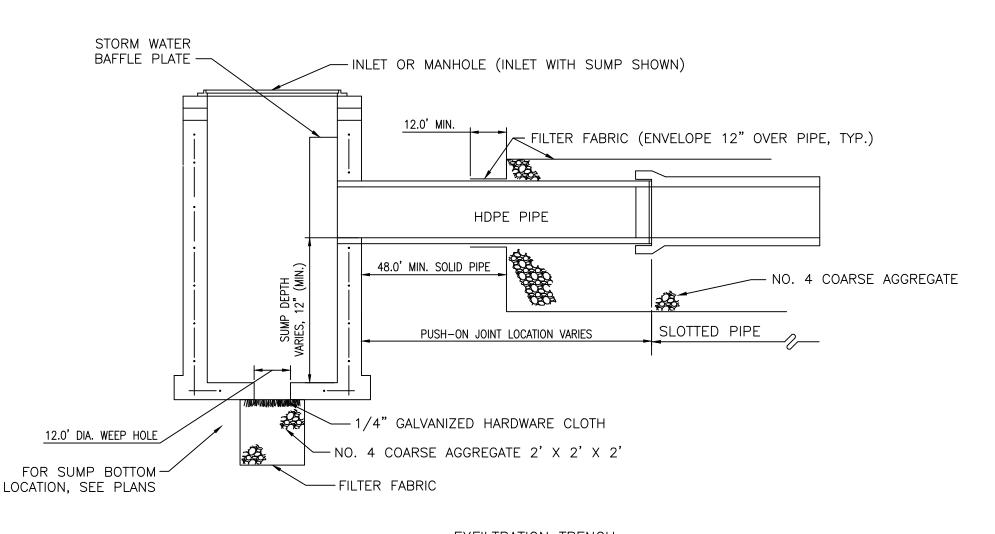

EXFILTRATION TRENCH LONGITUDINAL CROSS SECTION

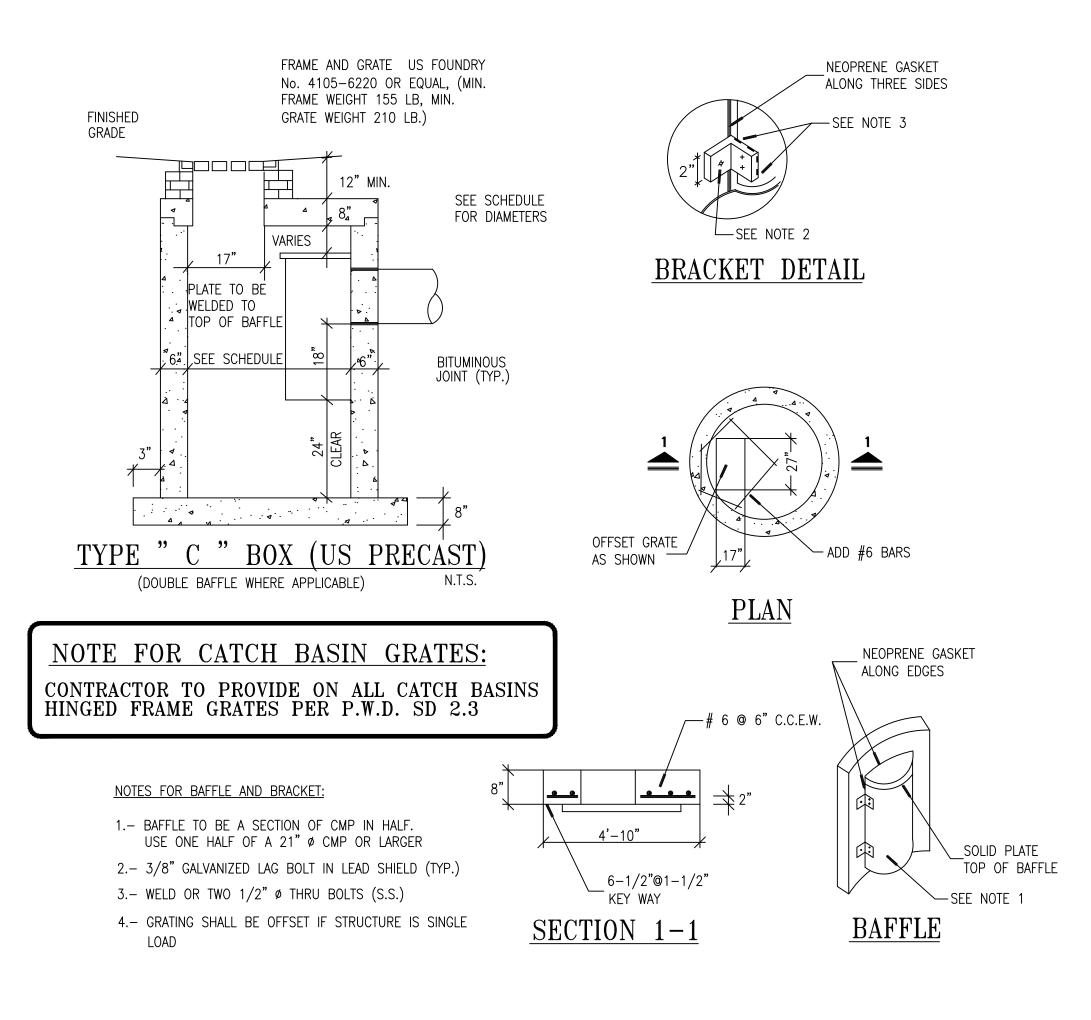

ENGINEERING INSPECTION & CONSTRUCTION

RN Engineering, Inspection & Construction, Inc.
PE Lic. No. 60494
CA Lic. No. 32037
7837 W. Sample Road,
Suite 104
Coral Springs, FL 33065
Phone: (954) 656-2594
Fax: (954) 656-2595
Rolando@RNEIC.com
www.RNEC.com

SEAL

ROLANDO NIGAGLIONI PE 60494 7837 W. Sample Road, Suite 104 Coral Springs, FL 33065



REVISIONS

OSE RETAIL

FRCIAL BUILDING

PEMBROKE Rd. HOLLYWOOD FL.

TITLE: DETAILS PAVING, GRADING & DRAINAGE


DRAWN BY: A.G.R.A.

DATE: 12-18-23

SCALE : 3/4 "= 1'-0"

C-6

EXFILTRATION TRENCH SYSTEM

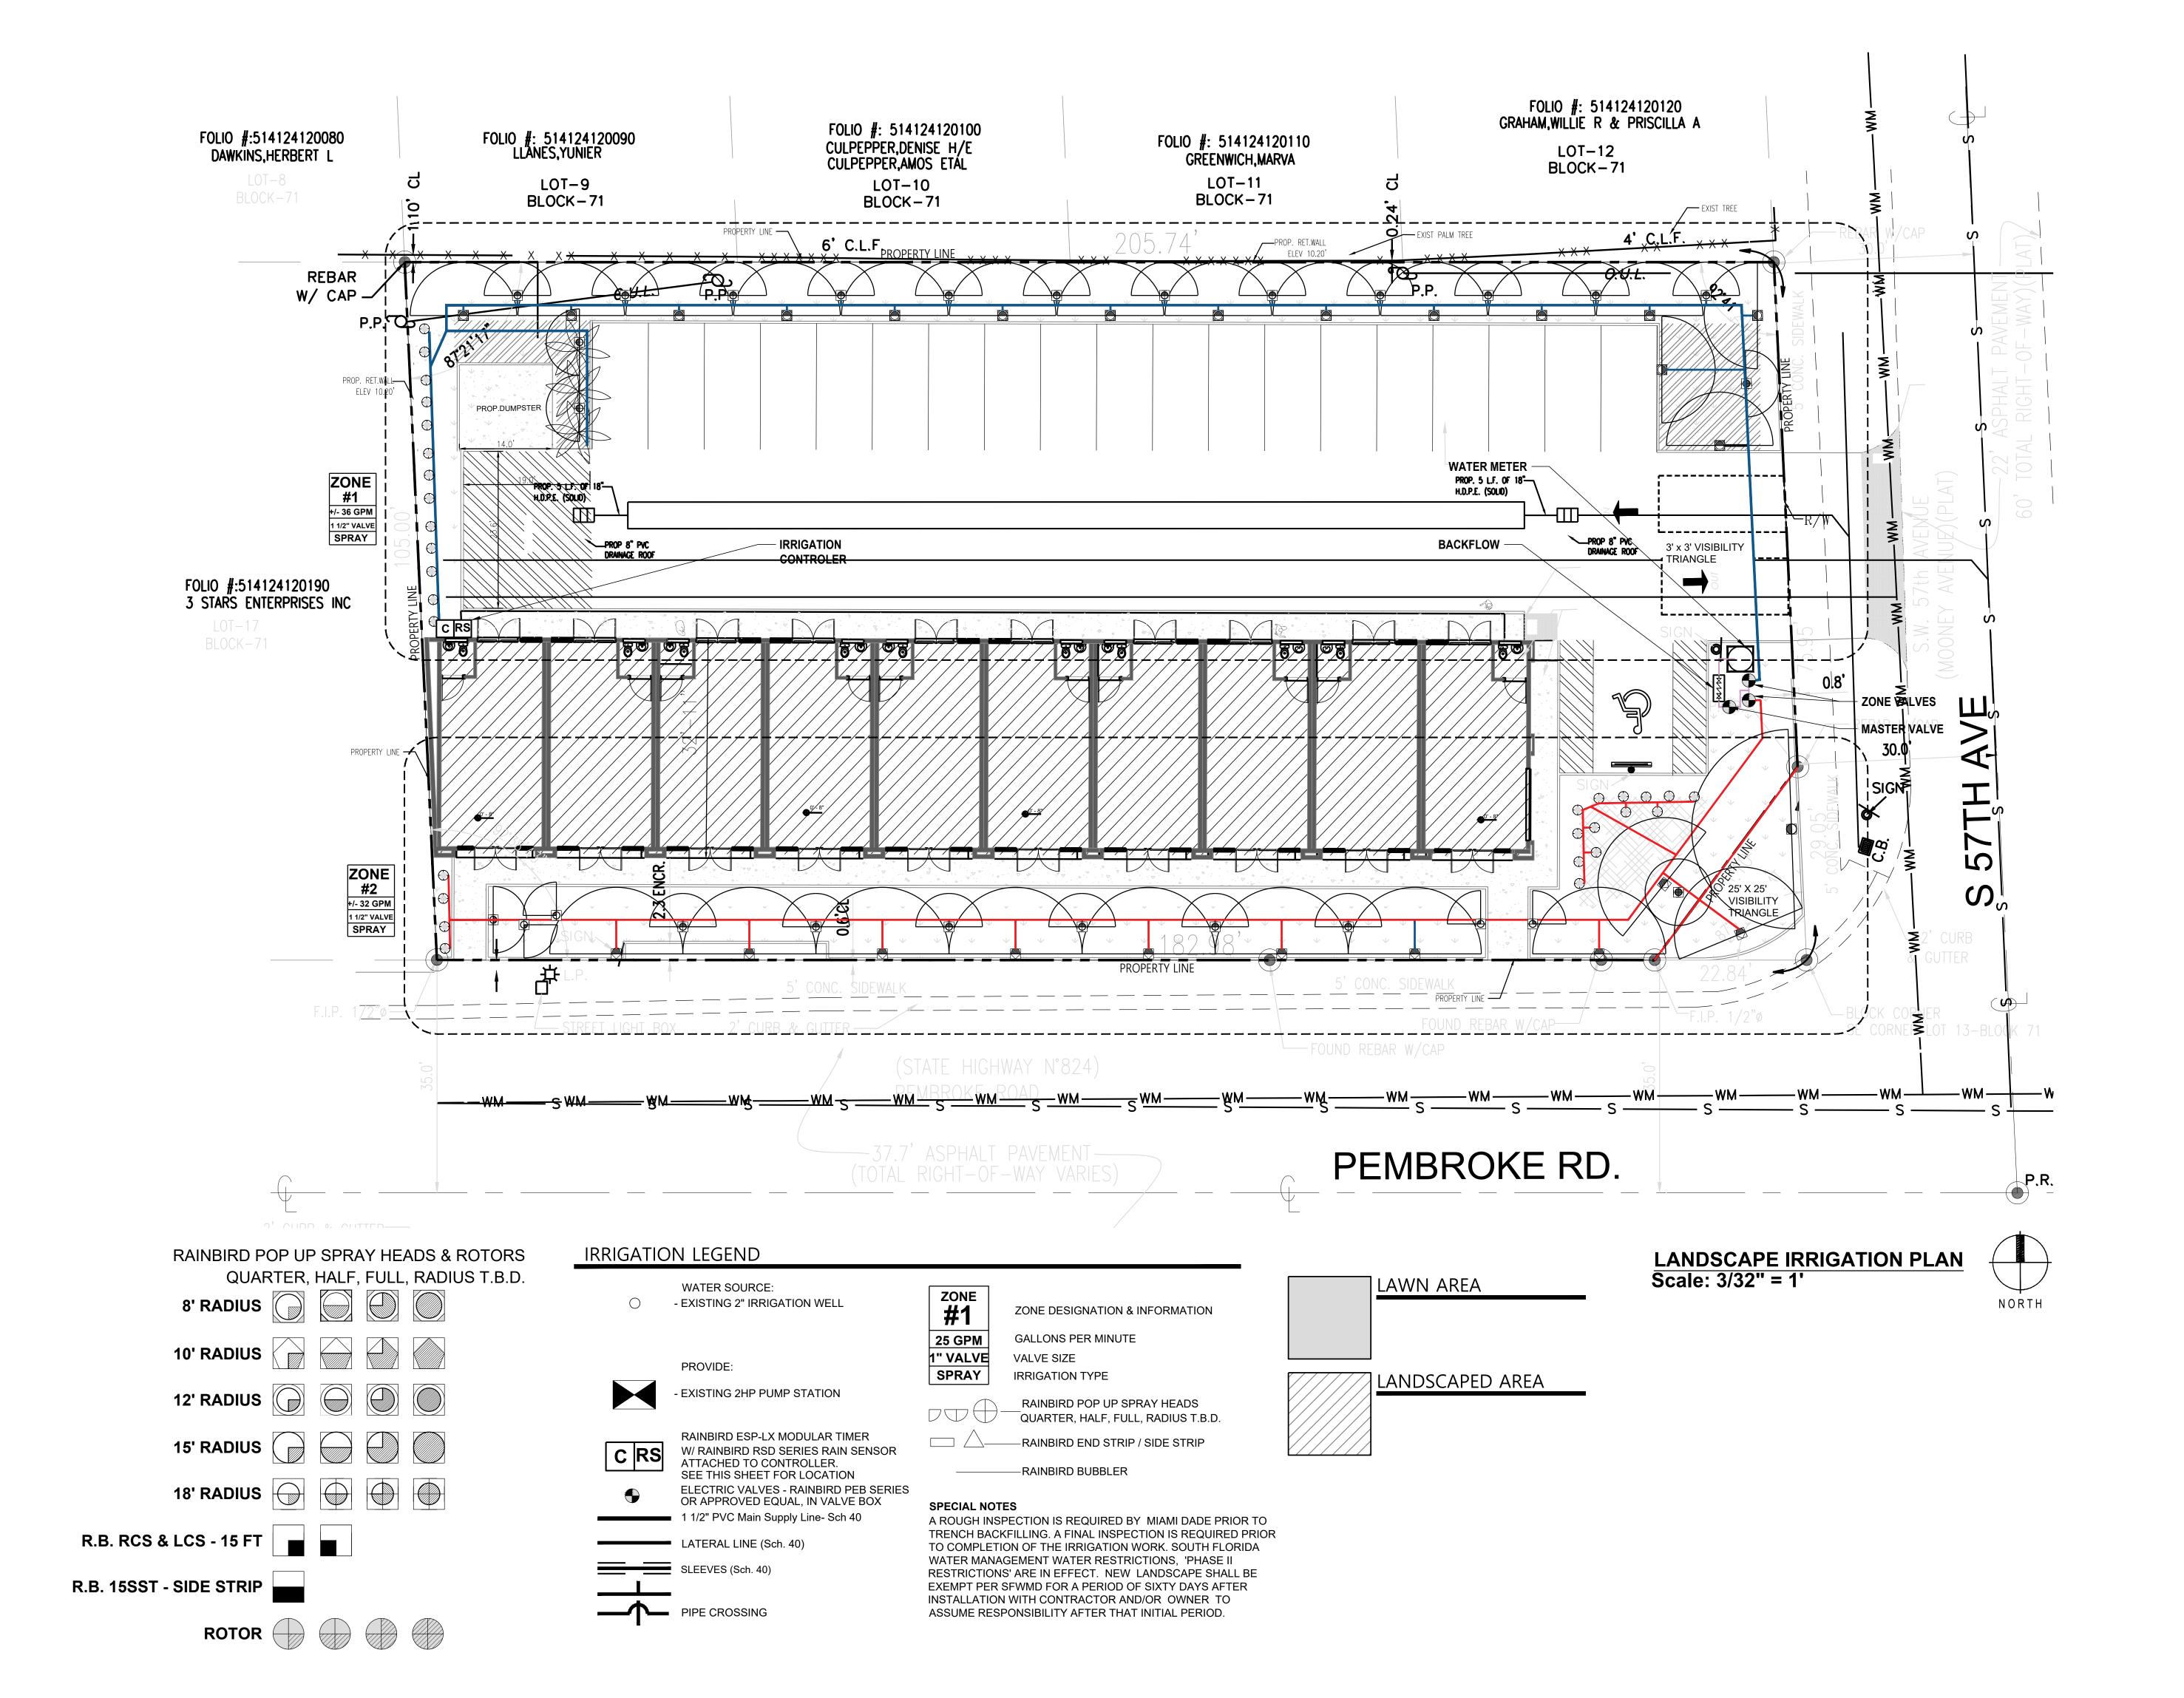

walk

Landscape + Urban Design Planning | Research | Consulting 6915 SW 57TH AVENUE Suite #203 Coral Gables, FL 33143 305.216.3352

REVISIONS / SUBMISSIONS

LE: 0 8' 16' 3 1/16" = 1'- 0"

5701 PEMBROKE ROAD HOLLYWOOD, FLORIDA 33023

IL COMMERCIA
PEMBROKE ROAD
WOOD, FLORIDA 33023

5701 RETAIL STOLPE




 DRAWN BY:
 SB,DC

 CHECKED BY:
 SC

 DATE:
 04.08.24

SHEET NUMBER:

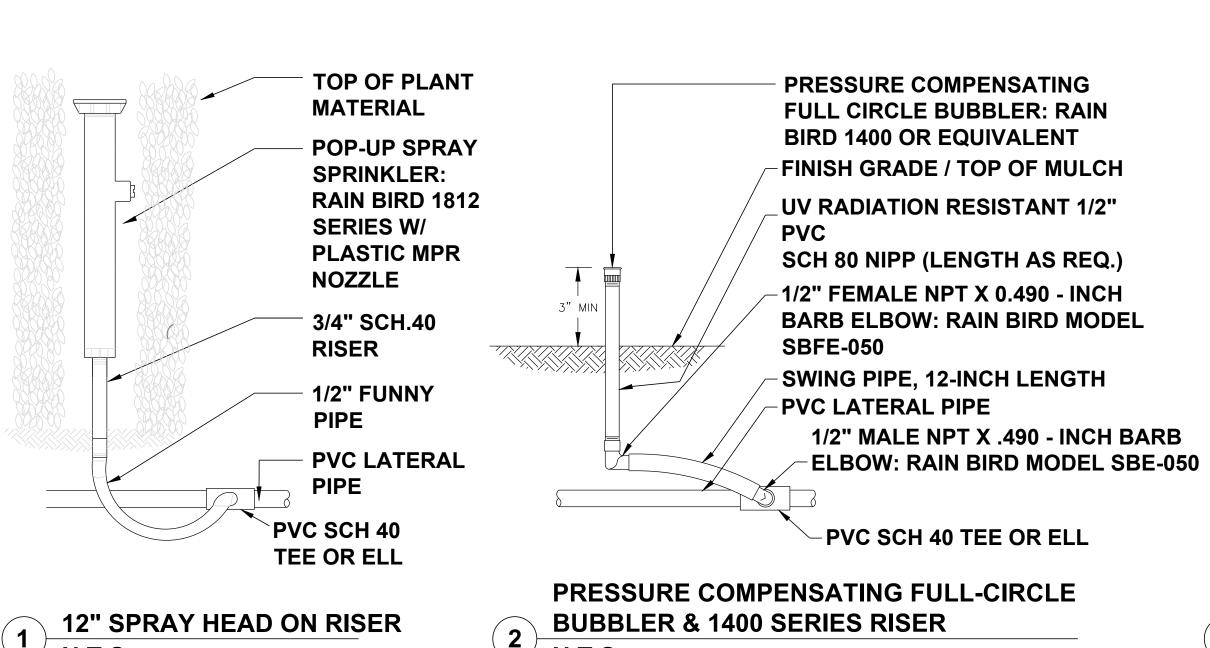

FINISH GRADE / TOP OF MULCH -POP-UP SPRAY **SPRINKLER: RAIN BIRD 1800** SERIES W/ PLASTIC MPR NOZZLE **1/2" FUNNY** PIPE **PVC LATERAL PVC SCH 40 TEE OR ELL**

RAIN BIRD **RAIN SENSOR IS EXPOSED TO UNOBSTRUCTED RAINFALL** AND IS CLEAR OF IRRIGATION SPRAY **COMMON WIRE TO CONTROL VALVES TYPICAL CONTROLER** COMMON TERMINAL STATIONS

RAIN SENSOR - INSTALL

IN AN OPEN AREA WHERE

IRRIGATION NOTES

backflow preventer as per local codes.

owner's authorized representative.

paving, etc.

1. Pipe sizes shall conform to those shown on the drawings. No substitutions of smaller pipe

rejected pipe shall be removed from the site at the time of said rejection.

spray with minimal overspray onto walks, streets, walls, etc.

locate all valves in shrub areas where possible.

manufacturer's recommendations and specifications.

14. All control wires shall be installed in PVC conduit.

pull points shall be installed in approved valves boxes with covers.

the owner's authorized representative.

authorized representative.

sizes shall be permitted, but substitutions of larger sizes may be approved. All damaged and

2. All mainline, lateral line and control wire conduit under paving shall be installed in separate

4. Final location of the backflow preventer and automatic controller shall be approved by the

electrical contractor shall make the final connection from the electrical source to the controller.

5. 120 VAC electrical power source at controller location shall be provided by others. The

6. All sprinkler heads shall be set perpendicular to finish grade unless otherwise specified.

7. The irrigation contractor shall flush and adjust all sprinkler heads and valves for optimum

8. This design is diagramatic. All piping, valves, etc., shown within paved areas is for design clarification only and shall be installed in planting areas wherever possible. The contractor shall

differences, location of walls, retaining walls, structures and utilities. The irrigation contractor

shall repair or replace all items damaged by his work. He shall coordinate his work with other

contractors for the location and installation of pipe sleeves through walls, under roadways and

10. Do not willingly install the sprinkler system as shown on the drawings when it is obvious

in the field that unknown obstructions, grade differences or differences in the area dimensions

exist that might not have been considered in the engineering. such obstructions or differences

should be brought to the attention of the owner's authorized representative. In the event this

notification is not performed, the irrigation contractor shall assume full responsibility for any

11. All sprinkler equipment not otherwise detailed or specified shall be installed as per

12. The irrigation contractor shall install check valves on all heads in areas where finish grade

exceeds 4:1, where post valve shut-off draining, of the irrigation head occurs or as directed by

13. The contractor shall provide 1800 PCS (pressure compensating screens) as necessary to

15. All remote control valves, gate valves, quick couplers, control wire and computer cable

reduce or eliminate overspray onto streets, walks or other areas as directed by the owner's

9. It is the responsibility of the irrigation contractor to familiarize himself with all grade

sleeves. Sleeves shall be a minimum of twice (2X) the diameter of the pipe to be sleeved.

3. Install all backflow prevention devices and all piping between the point of connection and the

TIMER AND RAIN SENSOR

POP-UP SPRAY SPRINKLER

WATER PROOF CONNECTION **VALVE BOX WITH COVER:** 12-INCH SIZE FINISH GRADE/TOP OF MULCH

> REMOTE CONTROL VALVE PVC SCH 80 NIPPLE **PVC SCH 40 ELL PVC SCH 80 NIPPLE**

(LENGTH AS REQUIRED) **SCH 40 TEE OR DUCTILE**

IRON SERVICE TEE SEE SPEC. SHEET FOR DETAIL **PVC MAINLINE PIPE**

PVC SCH 80 NIPPLE PVC LATERAL PIPE **PVC WIRELINE PIPE**

CZK-100-PRB-LC 1" LIGHT COMMERCIAL

CONTROL ZONE KIT OPTION 1

8 N.T.S.

REMOTE CONTROL VALVE

PAVING SAND BACKFILL COMPACTED TO THE DENSITY OF EXISTING SOIL **LATERAL LINES IN** SCH 80 SLEEVE **CONTROL WIRES IN SCH 80 SLEEVE** DI PI PIP -UNDISTURBED SOIL PREASURE MAINLINE IN **SCH 80 SLEEVE** SECTION VIEW - N.T.S.

OFF THE PIPE OR WIRE A | B | C | D DIMENSION DETAIL ALSO FOR PIPE 1 1/2" TO 6" IN SIZE 36" 24" 24" 4" INSTALLED IN ROCK SOI

SLEEVE INSTALLATION N.T.S.

1 - FINISH GRADE / TOP OF MULCH 2 - VALVE BOX WITH COVER, RAIN

4 - WATERPROOF CONNECTION:

RAIN BIRD DB SERIES

RAIN BIRD 100-PGA

6 - REMOTE CONTROL VALVE:

8 - PVC SCH 40 FEMALE ADAPTO

BIRD VB-STD

5 - ID TAG

PRB-100

9- LATERAL PIPE

11 - PVC SCH 40 ELL


14 - MAINLINE PIPE

GRAVEL

AND PVC SCH 40

13 - PVC SCH 40 TEE OR ELL

15 - 3-INCH MINIMUM DEPTH OF 3/4-INCH WASHED

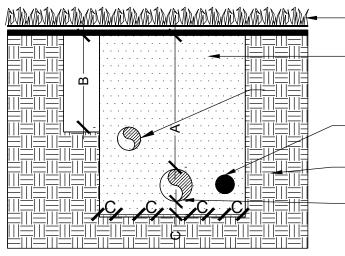

A B C 1/2" TO 2-1/2" IN SIZE | 18" | 12" | 4" 24" 3" TO 6" IN SIZE

PIPE INSTALLATION

N.T.S.

3 - 30-INCH LINEAR LENGTH OF WIRE, COILED (INCLUDED IN CZK-100PRB-LC KIT 7 - PRESSURE REGULATING BASKET FILTER: (INCLUDED IN CZK-100-PRB-LC KIR) 10 - PVC SCH 80 NIPPLE (LENGTH AS REQ.) 12 - PVC SCH 80 NIPPLE (2-INCH LENGTH, HIDDEN)

FINISH GRADE **ROTOR POP-UP SPRINKLER: RAIN BIRD 5000 SERIES 1/2" FUNNY PIPE PVC LATERAL PVC SCH 40 TEE OR ELL**

TURF ROTOR

FINISH GRADE SAND BACKFILL COMPACTED TO THE DENSITY OF EXISTING **CONTROL WIRES IN** SCH 80 SLEEVE

UNDISTURBED SOIL PREASURE MAINLINE IN

SCH 80 SLEEVE

FLORIDA BUILDING CODE- APPENDIX F PART V- A-6 FLORIDA BUILDING CODE- APPENDIX F PIPE INSTALLATION-DEPTH OF COVER VEHICLE TRAFFIC AREAS WATER PIPE SIZE SLEEVE SIZE DEPTH OF COVER (INCHES) PIPE SIZE (INCHES) 1 1/2" 3/4" 1/2" TO 2 1/2" 18" TO 24" 3" TO 5" 24" TO 30" 1 1/4" 2 1/2" 1 1/2" 6" OR GREATER 30 TO 36" NON-TRAFFIC AND NON-CULTIVATED AREAS 2" 4" 3" DEPTH OF COVER (INCHES) PIPE SIZE (INCHES) 6" 1/2" TO 1 1/4" 6" TO 12" 4" 12" TO 18" 1 1/2" TO 2" SLEEVES TO EXTEND A MIN. 3' BEYOND ALL PAVED AREAS, BACKFILL AND COMPACTION 2 1/2" TO 3" 18" TO 24" PER APPENDIX F

LANDSCAPE and IRRIGATION NOTE

24" TO 36"

1. THE PROPOSED LANDSCAPE and IRRIGATION DESIGN MEETS AND EXCEEDS THE LANDSCAPE CODE REQUIREMENTS AS STIPULATED IN CHAPTER 18-A, MIAMI DADE COUNTY LANDSCAPE ORDINANCE.

2. EXISTING SITE CONDITIONS HAVE BEEN FIELD VERIFIED BY LANDSCAPE ARCHITECT.

3. ALL LANDSCAPE AREAS TO BE 100% COVERED BY A FULLY AUTOMATIC IRRIGATION SYSTEM WITH RAIN SENSOR. SEE THIS SHEET FOR IRRIGATION LAYOUT.

NOTE:

- 12" MINIMUM **DISTANCE** FROM POINT OF **SERVICE (METER)**

1 - BALL VALVE

2 - TEST COCK

3 - Y-TYPE STRAINER (OPTIONAL)

10 BACKFLOW PREVENTOR ′ N.T.S.

REFER TO CIVIL FOR BACKFLOW PREVENTOR SPECIFICATION AND LOCATION.

walk

Landscape + Urban Design Planning | Research | Consulting **6915 SW 57TH AVENUE** Suite #203 Coral Gables, FL 33143

305.216.3352 **REVISIONS / SUBMISSIONS** 1/16" = 1'- 0"


5701 PEMBROKE ROAD HOLLYWOOD, FLORIDA 33023

LA 6667643 STATE


HECKED BY

SHEET NUMBER: **IR-02**

4" OR LARGER

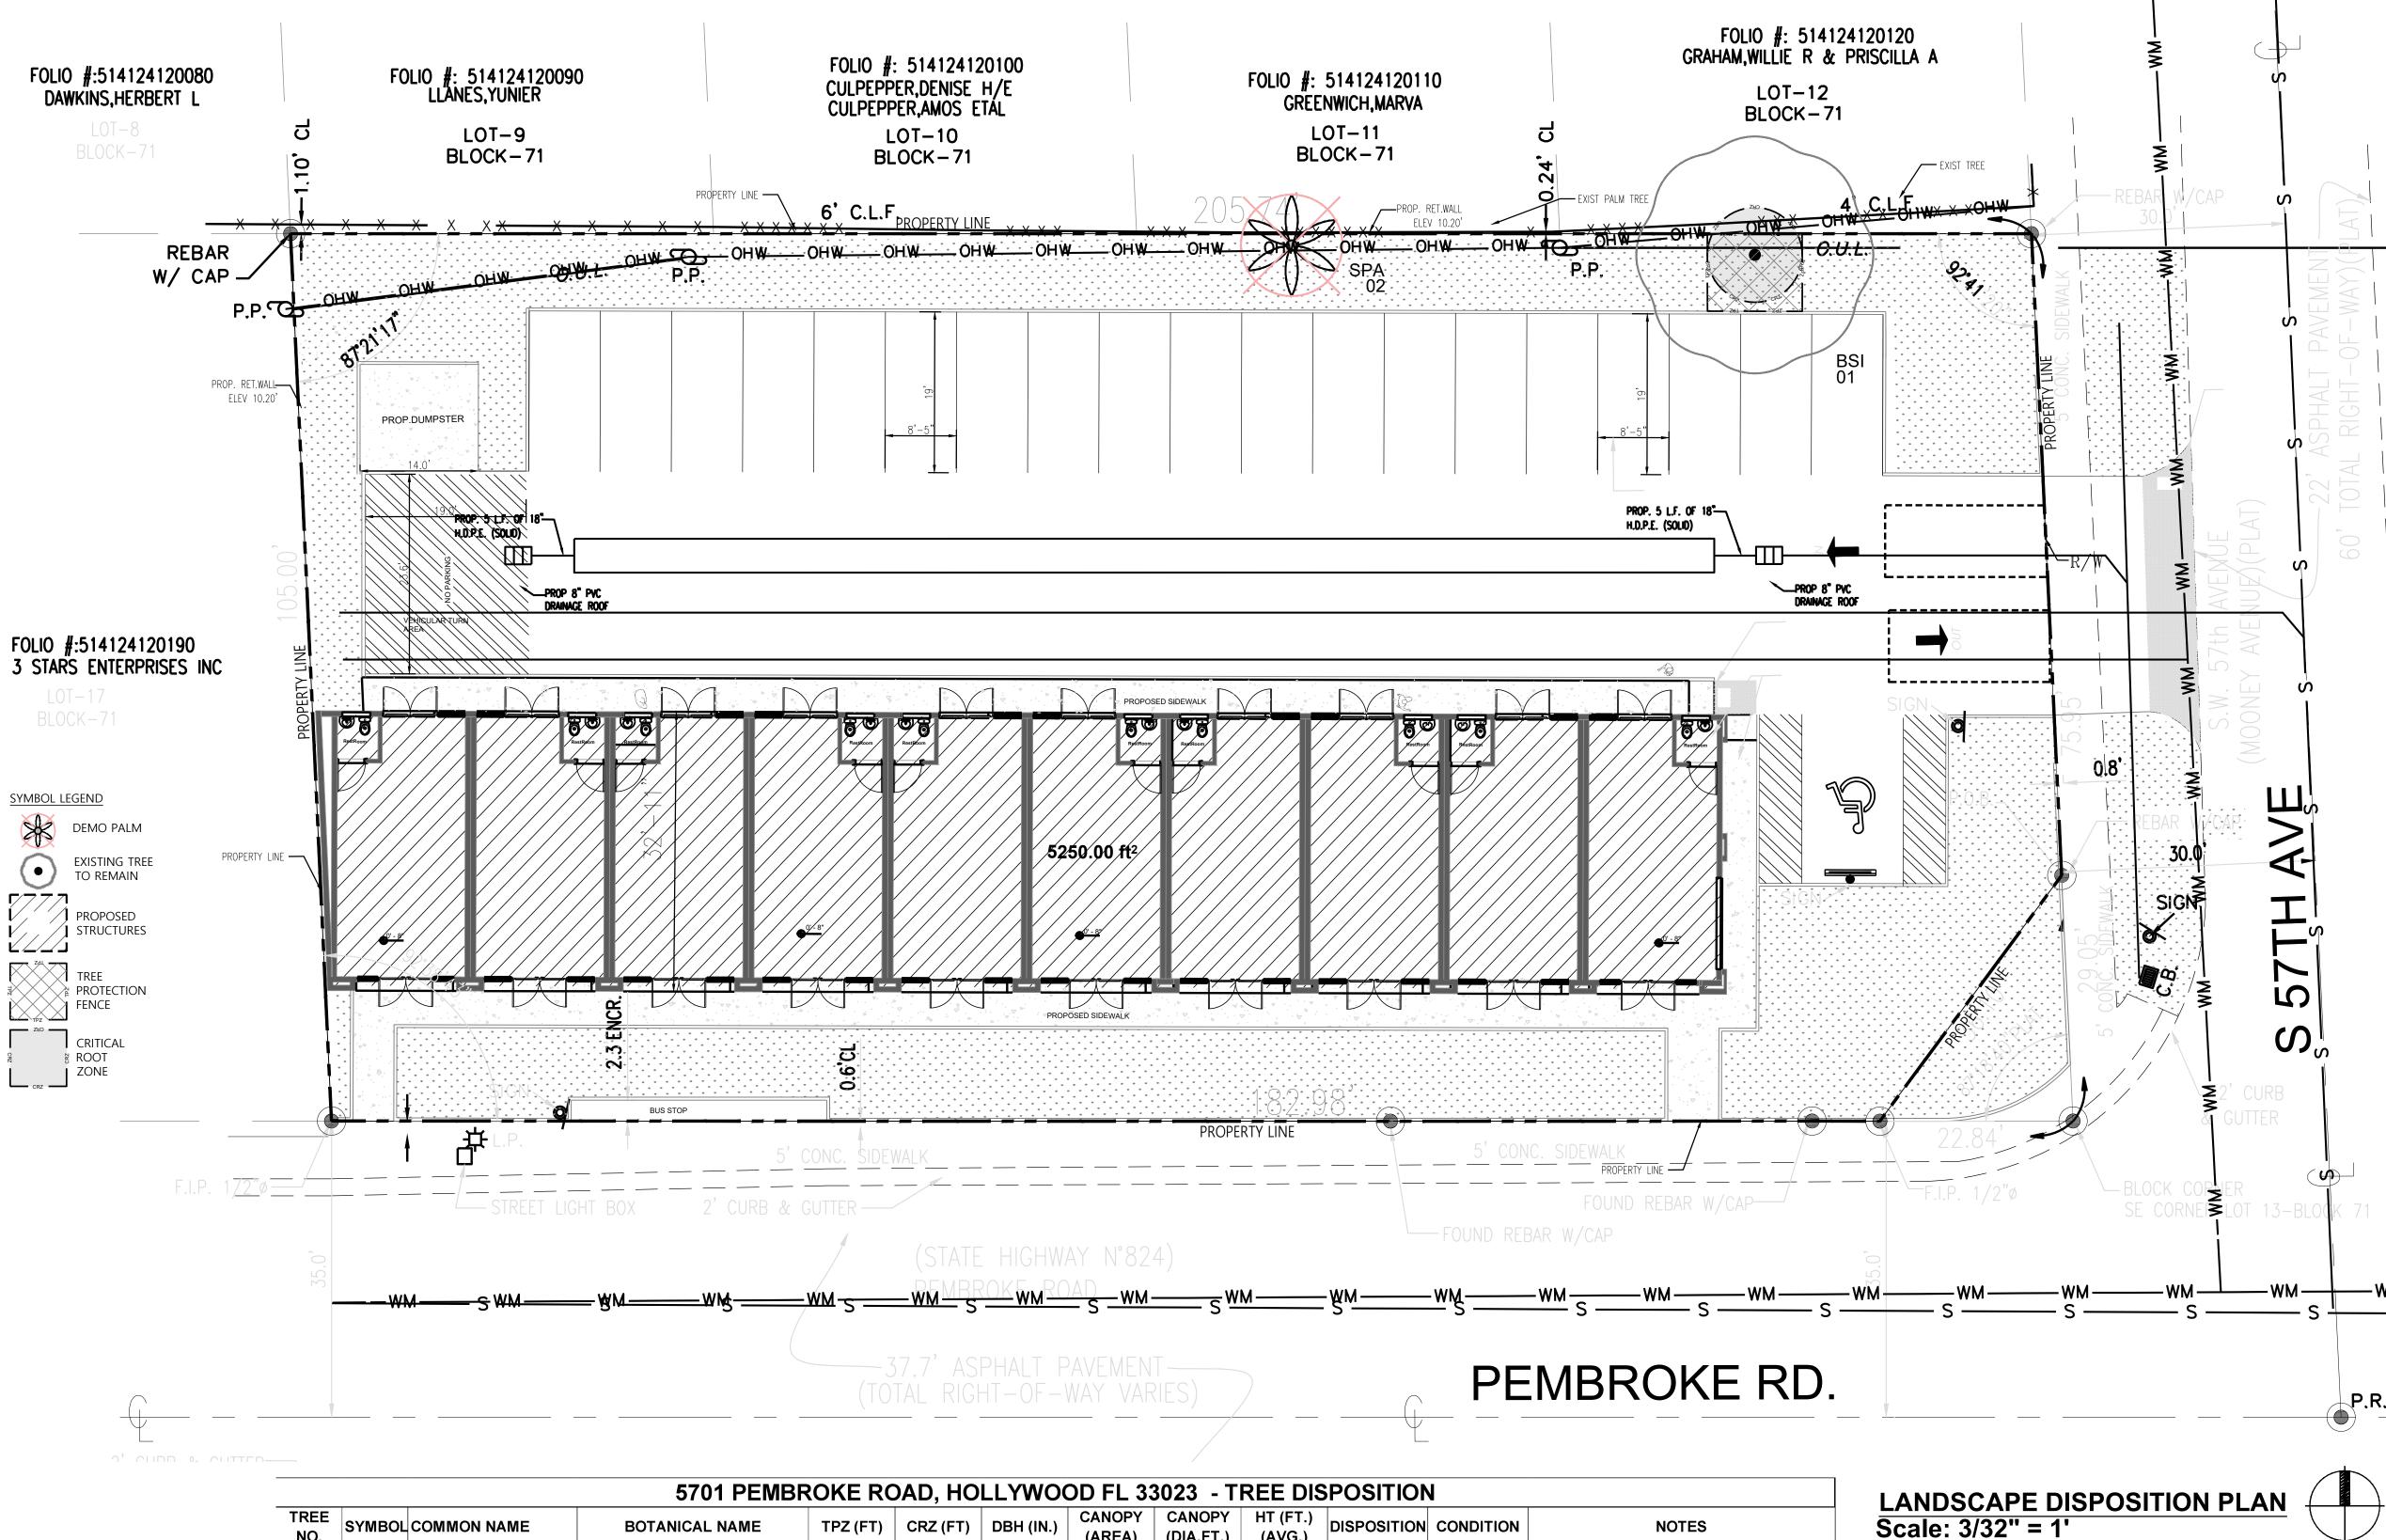

TREE PROTECTION DETAILS

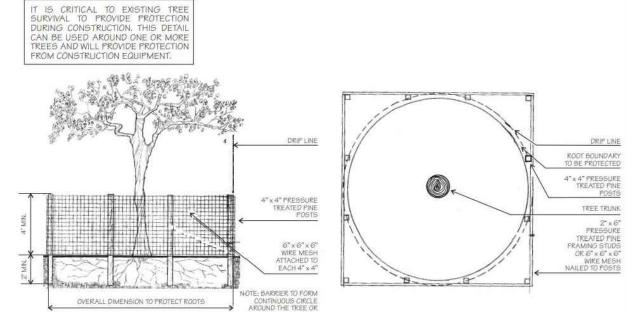

WIRE MESH BARRIER DETAIL WOOD BARRIER DETAIL PLAN

TREE PROTECTION DETAILS Scale: N.T.S.

	5701 PEMBROKE ROAD, HOLLYWOOD FL 33023 - TREE DISPOSITION											
TREE	SAMBOI	COMMON NAME	BOTANICAL NAME	TPZ (FT)	CRZ (FT)	DBH (IN.)	CANOPY	CANOPY	HT (FT.)	DISPOSITION	CONDITION	NOTES
NO.	STIVIBUL	DECOMINION NAME	BOTANICAL NAME	162 (61)	CRZ (FI)	DBH (IIV.)	(AREA)	(DIA.FT.)	(AVG.)	DISPOSITION	CONDITION	NOTES
01	BSI	Gumbo Limbo	Bursera simaruba	14	14	20	804	32	35	Remain	Good	ROW, Specimen tree.

N/A N/A N/A 113 12 10 Remove Good Under regulation size, 10' O.A. Height 02 SPA Sabal Palm Sabal palmetto NOTES: TREE PROTECTION REQUIREMENTS DURING CONSTRUCTION. A.PROTECTION REQUIREMENTS. DURING SITE DEVELOPMENT, PROTECTION REQUIREMENTS FOR TREES DESIGNATED FOR PRESERVATION UNDER AN APPROVED TREE REMOVAL PERMIT

AREAS SURROUNDED BY PROTECTIVE BARRIERS.

BY USING TECHNIQUES SUCH AS TUNNELING OR OVERHEAD UTILITY LINES

VII.FENCES AND WALLS SHALL BE CONSTRUCTED TO AVOID DISTURBANCE TO ANY PROTECTED TREE. POST HOLES AND TRENCHES LOCATED CLOSE TO TREES SHALL BE DUG BY HAND AND ADJUSTED AS NECESSARY, USING TECHNIQUES SUCH AS DISCONTINUOUS FOOTINGS, TO AVOID DAMAGE TO MAJOR ROOTS. VIII.ROOT BARRIERS SHALL BE INSTALLED WITH THE PLANTING OF NEW TREES IN INSTANCES WHERE THERE IS A LIKELY POSSIBILITY THAT FUTURE ROOT GROWTH WILL CAUSE DAMAGE TO

FOUNDATIONS, DRIVEWAYS, UTILITIES, OR OTHER INFRASTRUCTURE.

walk Landscape + Urban Design

Planning | Research | Consulting 6915 SW 57TH AVENUE **Suite #203** Coral Gables, FL 33143 305.216.3352

REVISIONS / SUBMISSIONS

5701 PEMBROKE ROAD HOLLYWOOD, FLORIDA 33023


INFORMATION UTILIZED IN THE PREPARATION OF

AND RELIANT UPON THE SURVEY PREPARED BY


SURVEYORS.

THE TREE DISPOSITION PLAN ASCERTAINED FROM

JULIO S. PITA FROM GAVY & ASSOCIATES, INC. LAND

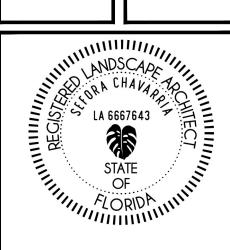

SHEET NUMBER: L-01

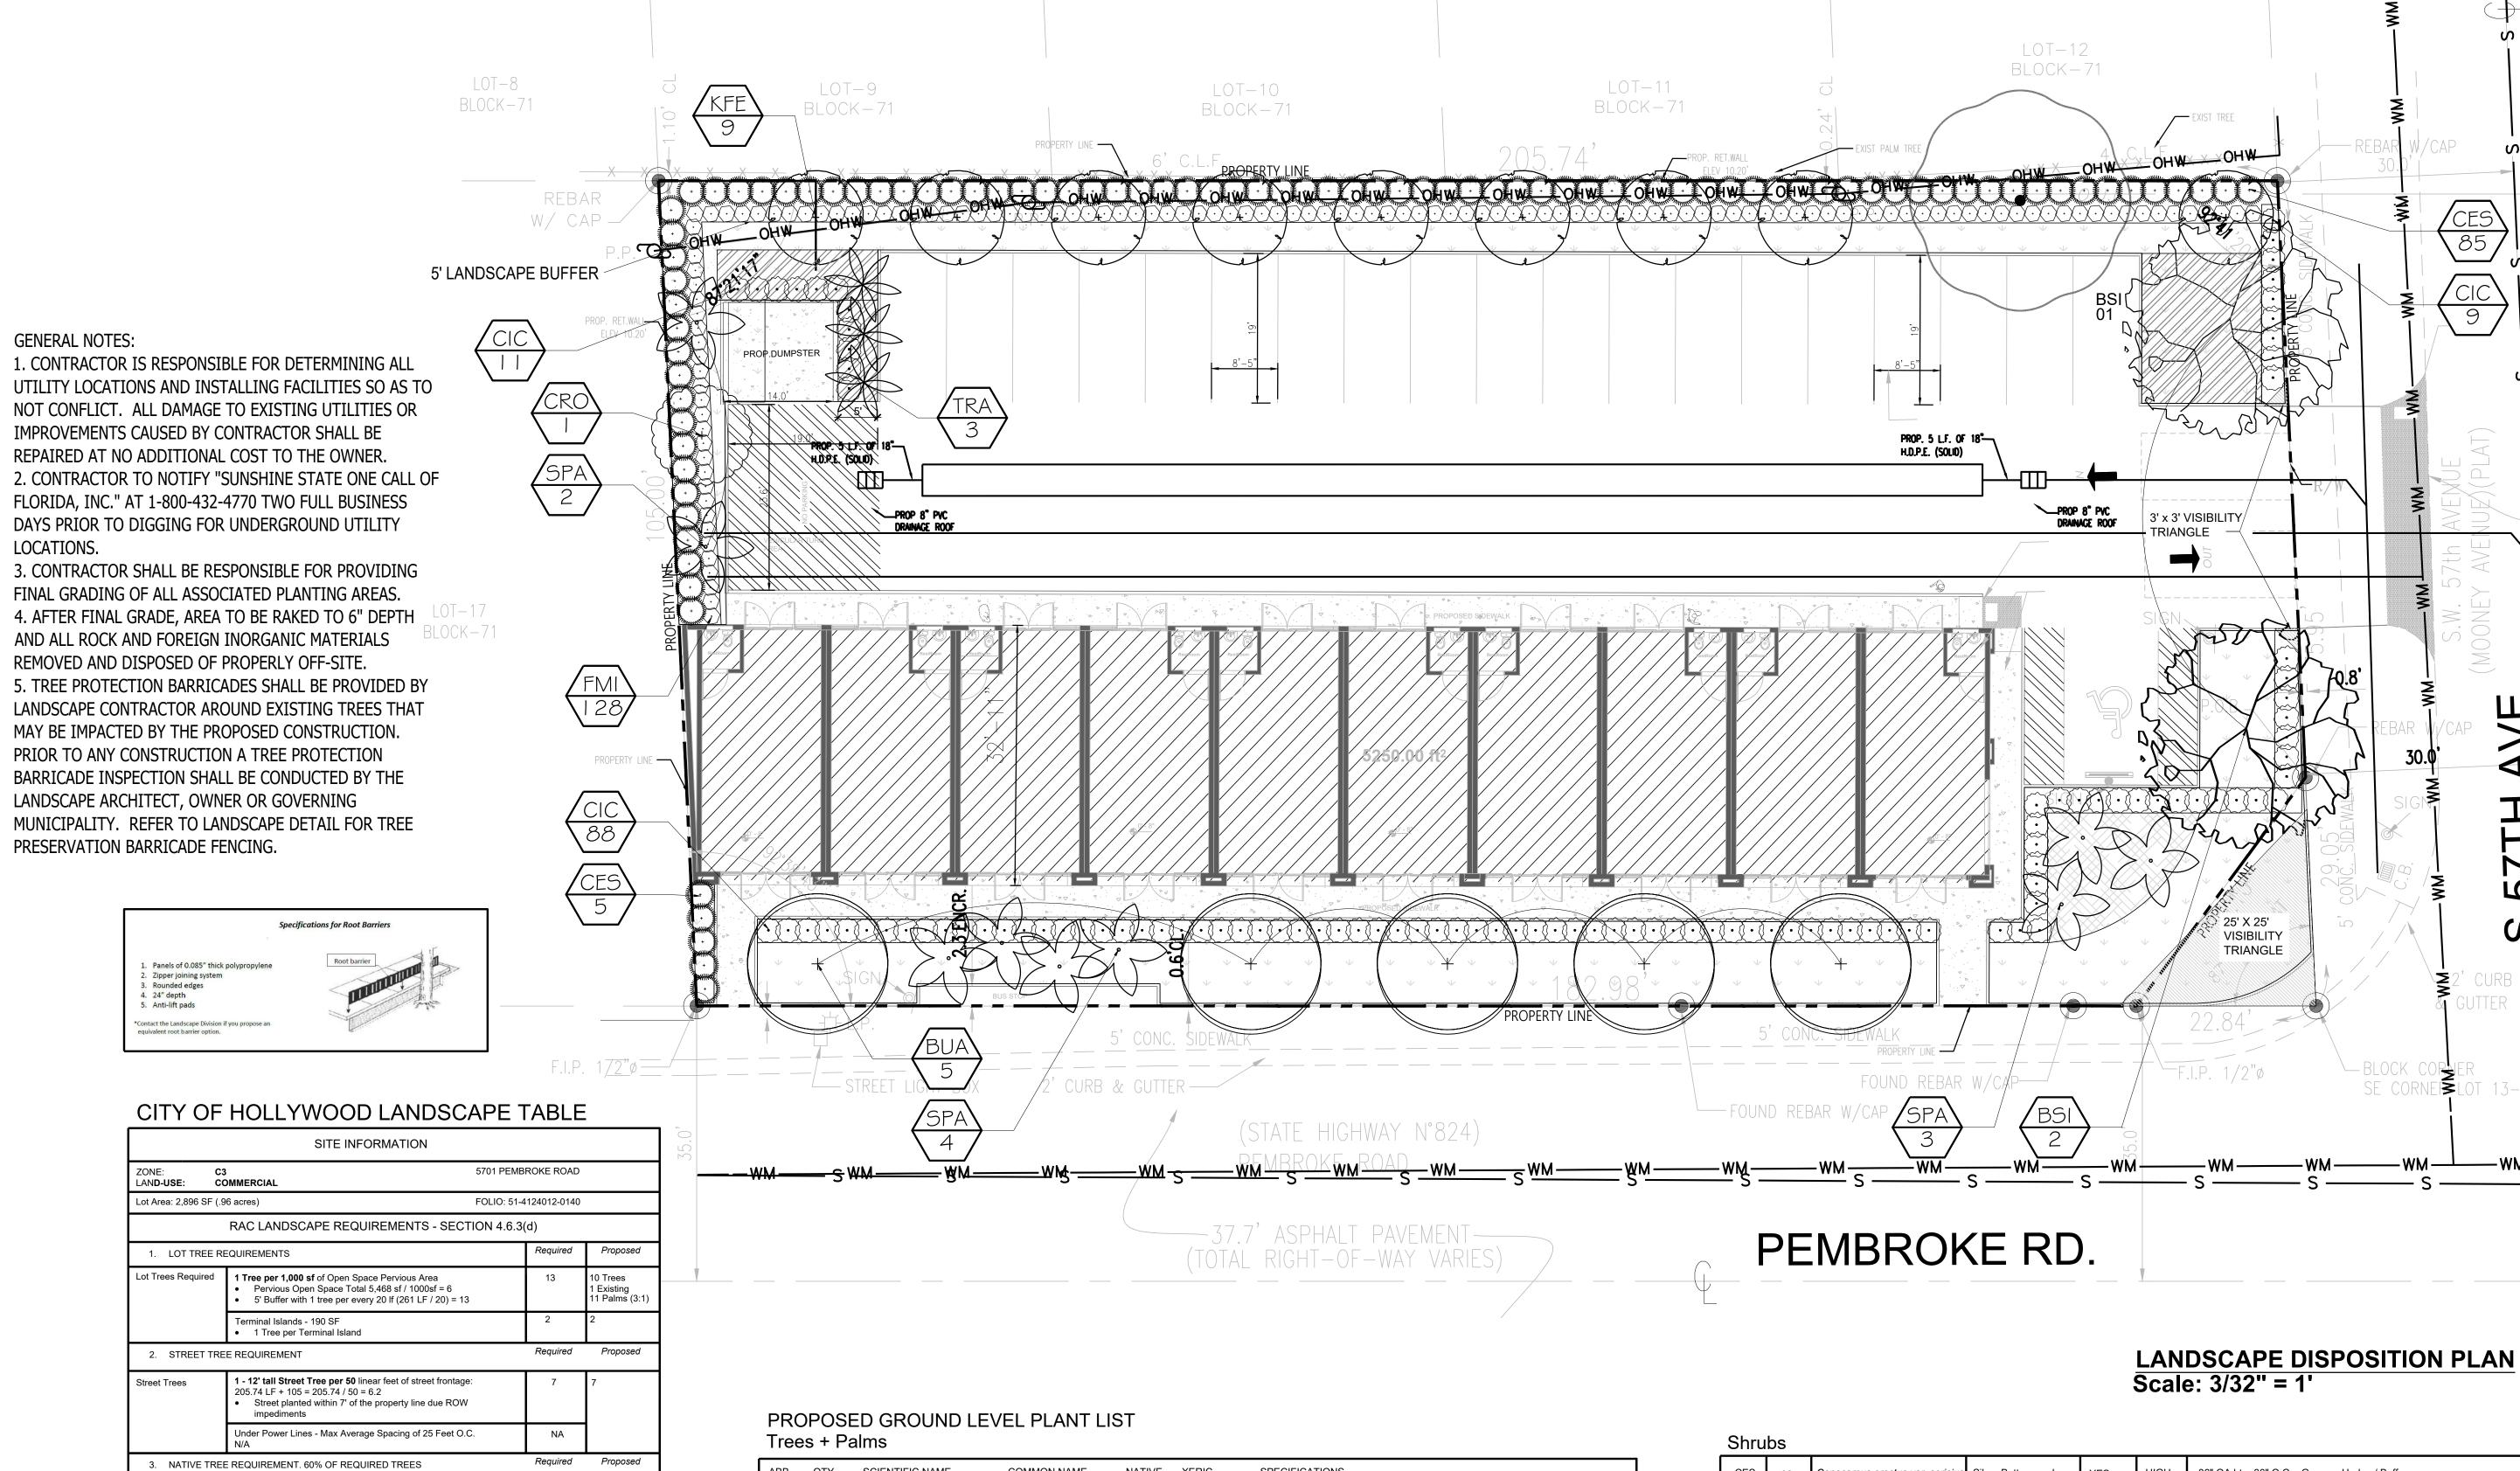



Native Trees

Native Shrubs

Required

Required Trees 17 x 60%

4. SHRUB REQUIREMENT. RATIO OF 10 PER REQUIRED TREE

5. NATIVE SHRUB REQUIREMENT. 50% OF REQUIRED SHRUBS

10 X 22 = 220

220 x 50% = 110

5. XERISCAPE PRINCIPLES - PROPOSED 100%

12 TREES

12 PALMS

220

110

LOCATIONS.

ABB.	QTY	SCIENTIFIC NAME	COMMON NAME	NATIVE	XERIC	SPECIFICATIONS
BUA	5	Bulnesia arborea	Verawood	NO	HIGH	Minimum: 12' Height OA - Min 4" DBH - 6.5' CT - Field Grown
BSI	2	Bursera simaruba	Gumbo Limbo	YES	HIGH	Minimum: 12' Height OA - Min 4" DBH - 6.5' CT - Field Grown
KFE	9	Krugiodendron ferreum	Black Ironwood	YES	HIGH	Minimum: 10' Height OA - Min 2 DBH - 4' CT - Field Grown
CRO	1	Clusea rosea	Pitch Apple	YES	HIGH	Minimum: 10' Height OA - Min 2 DBH - 4' CT - Field Grown
SPA	9	Sabal Palmetto	Sabal Palm	YES	HIGH	Minimum: 16' Height OA - Min 10" DBH - 8' CT - Field Grown - Boots on
TRA	3	Thrinax Radiata	Florida Thatch Palm	YES	HIGH	Minimum: 12' Height OA - Min 10" DBH - 6' CT - Field Grown - Boots on

Shrubs							
CES	92	Conocarpus erectus var. sericius	Silver Buttonwood	YES	HIGH	36" OA ht 36" O.C Grow as Hedge / Buffer	
FMI	128	Ficus microcarpa 'Green Island'	Green Island Fig	YES	HIGH	24" OA ht 24" O.C.	
CIC	136	Chrysobalanus icaco 'Red Tip'	Red Tip Cocoplum	YES	HIGH	24" OA ht 30" O.C.	
	36	Tripsacum dactyloides	Fakahatchee Grass	YES	HIGH	24" ht. 30" O.C.	
v v v v	3,199 sf	Stenotaphrum secundatum	St. Augustine Grass	YES	HIGH	Shall be well adapted to localized growing conditions.	
*Mulch		Organic-Nutra Mulch				As noted on plan and to be determined by contractor	

Planting bed to be mulched - "Mulches shall be applied and maintained in accordance with the most recent edition of the Florida Yards & Neighborhoods Handbook titled "A Guide to Florida Friendly Landscaping" by the University of Florida, Institute of Food and Agricultural Sciences (UF/IFAS) and available online at http://www.floridayards.org/landscape/FYN-Handbook.pdf. Cypress mulch shall not be used because its harvest degrades cypress wetlands".

walk Landscape + Urban Design

CES 85

 $\frac{\overline{CIC}}{9}$

 \mathbf{Q}_1°

NORTH

Planning | Research | Consulting 6915 SW 57TH AVENUE Suite #203 Coral Gables, FL 33143 305.216.3352

REVISIONS / SUBMISSIONS

5701 PEMBROKE ROAD HOLLYWOOD, FLORIDA 33023

STATE OF

CHECKED BY: 04.08.24

SHEET NUMBER: L-02

GENERAL LANDSCAPE NOTES:

- PLANT MATERIAL: ALL PLANT MATERIAL SHALL BE FLORIDA #1 OR BETTER AS ESTABLISHED BY "GRADES AND STANDARDS FOR NURSERY PLANTS" OF THE STATE OF FLORIDA (FL), DEPARTMENT OF AGRICULTURE. UNLESS OTHERWISE NOTED, ALL TREES SHALL BE SINGLE LEADER, FIELD GROWN/BALLED & BURLAPPED (FG/BB); CONTAINER GROWN TREES ARE NOT ACCEPTABLE & WILL BE IMMEDIATELY REJECTED UPON INSPECTION. ANY CHANGES TO THE APPROVED LANDSCAPE PLAN SHALL BE APPROVED BY THE CITY FORESTER & LA OF RECORD. ALL SUBSTITUTIONS AND CHANGES SHALL BE APPROVED IN WRITING PRIOR TO INSTALLATION. ANY DISCREPANCIES BETWEEN PLANS, SITE AND SPECIFICATIONS SHALL BE BROUGHT TO THE IMMEDIATE ATTENTION OF THE LANDSCAPE ARCHITECT, THE OWNER AND GOVERNING MUNICIPALITY. OPTIONS FOR ALTERNATE SPECIES BASED ON LACK OF STATEWIDE AVAILABILITY SHALL BE FURNISHED TO LANDSCAPE ARCHITECT OF RECORD A MINIMUM OF 30 DAYS BEFORE COMMENCEMENT OF CONSTRUCTION; LACK OF AVAILABILITY WILL BE VERIFIED USING THE LATEST INDUSTRY ACCEPTED PUBLICATION LISTINGS. PLANT SPACING SHALL SUPERCEDE PLANT QUANTITY TO FILL THE BED FOR SHRUBS AND GROUNDCOVERS. THE LOCATION OF NEW SHRUB AND GROUNDCOVER PLANTINGS SHALL BE A MINIMUM OF 3 FEET FROM THE TRUNK FLARES OF EXISTING TREES TO BE PRESERVED. NEW SHRUB AND GROUNDCOVER PLANTINGS UNDER THE DRIPLINES SHALL BE INSTALLED BY HAND WITH CARE IN BETWEEN ROOTS 1" DIAMETER AND GREATER.
- 2. ALL TREES, SHRUBS AND GROUNDCOVERS SHALL, AT A MINIMUM, BE OF THE SIZES AS SPECIFIED IN THE PLANT LIST. WHERE THERE IS A DISCREPANCY EITHER IN QUANTITIES, PLANT NAMES, SIZES OR SPECIFICATIONS
 BETWEEN THE PLAN OR PLANT LIST, THE PLAN TAKES PRECEDENCE. QUANTITIES LISTED ON THE THE PLANT LIST ARE FOR ESTIMATING PURPOSES. CONTRACTOR SHALL VERIFY ALL QUANTITIES. MULCH, TOPSOIL, FERTILIZER,
 ETC. SHALL BE INCLUDED IN THE UNIT COST OF THE PLANTS. THE PLANTING PLAN SHALL BE INSTALLED IN COMPLIANCE WITH ALL EXISTING CODES AND APPLICABLE DEED RESTRICTIONS.
- 3. AMENDED PLANTING SOIL: PLANTING SOIL FOR USE IN BACK FILLING PLANTING HOLES SHALL BE FORTY PERCENT (40%) TOPSOIL AND SIXTY PERCENT (60%) SAND AND BE FERTILE, FRIABLE, AND OF A LOAMY CHARACTER, WITHOUT MIXTURE OF SUBSOIL MATERIALS, AND OBTAINED FROM A WELL-DRAINED, ARABLE SITE. IT SHALL CONTAIN THREE (3) TO FIVE (5) PERCENT DECOMPOSED ORGANIC MATTER AND SHALL BE FREE FROM HEAVY CLAY, COARSE SAND, STONES, LIME, LUMPS, PLANTS, ROOTS OR OTHER FOREIGN MATERIALS, OR NOXIOUS WEEDS. IT SHALL NOT CONTAIN TOXIC SUBSTANCES WHICH MAY BE HARMFUL TO PLANT GROWTH. PH RANGE SHALL BE 5.0 TO 7.0 INCLUSIVE. ALL PLANT MATERIAL TO RECEIVE PLANTING SOIL AS PER DETAILS & NOTES.
- GENERAL RECOMMENDED PLANTING SOIL DEPTH: ALL TREES AND SHRUBS SHALL BE PLANTED WITH A MINIMUM OF 12" TOPSOIL AROUND AND BENEATH THE ROOTBALL. MINIMUM TOPSOIL SHALL BE 6" FOR GROUNDCOVER AREAS AND 2" FOR SODDED GRASS AREAS. THIS IS IN ADDITION TO A MINIMUM OF 10" OF UNDISTURBED OR NATIVE SOIL THAT WAS STORED/STOCKPILED ON SITE AND REUSED, OR CLEAN IMPORTED PLANTING SOIL WITH A RANGE OF ORGANIC MATTER BETWEEN 3-5% WITH NO STONES GREATER THAN AN INCH AND A HALF IN DIAMETER IN ANY DIRECTION. TOPSOIL DEPTHS PLUS PLANTING SOIL/EXISTING NATIVE SOIL MINIMUM DEPTHS ARE IN ADDITION TO ANY LIMESTONE/ LIMEROCK SUBGRADE, & IN ADDITION TO EXCAVATION WIDTHS REQUIRED FOR TREE PITS AS SHOWN ON THE PLANTING DETAILS. TREE PITS SHALL BE EXCAVATED & BACKFILLED TO A MINIMUM DEPTH OF 30".
- 5. CONTRACTOR TO NOTIFY "SUNSHINE STATE ONE CALL OF FLORIDA, INC." AT 1-800-432-4770 TWO FULL BUSINESS DAYS PRIOR TO DIGGING FOR UNDERGROUND UTILITY LOCATIONS.
- CONTRACTOR IS RESPONSIBLE FOR DETERMINING ALL UTILITY LOCATIONS AND INSTALLING FACILITIES SO AS TO NOT CONFLICT. ALL DAMAGE TO EXISTING UTILITIES OR IMPROVEMENTS CAUSED BY CONTRACTOR SHALL BE REPAIRED AT NO ADDITIONAL COST TO THE OWNER. CONTRACTOR SHALL VERIFY ALL EXISTING CONDITIONS IN THE FIELD AND REPORT ANY DISCREPANCIES IN THE SITE SURVEY OR DISPOSITION PLAN TO THE OWNER & LANDSCAPE ARCHITECT OF RECORD PRIOR TO STARTING WORK. ANY OVERHEAD POWERLINES, UNDERGROUND UTILITIES, EXISTING TREES, ETC. IN CONFLICT WITH PROPOSED LANDSCAPING, INCLUDING FPL RIGHT-TREE-RIGHT-PLACE GUIDELINES, SHALL BE REPORTED IMMEDIATELY TO THE OWNER'S REPRESENTATIVE OR DESIGNEE, AND TO THE LANDSCAPE ARCHITECT OF RECORD PRIOR TO SUBJECT PLANT MATERIAL INSTALLATION. FAILURE TO NOTIFY THE LANDSCAPE ARCHITECT & OWNER OF ANY DISCREPANCIES SHALL BE THE FULL RESPONSIBILITY OF THE CONTRACTOR AND WILL RESULT IN THE CONTRACTOR MOVING OR REPLACING THE PLANT MATERIAL AT THEIR OWN EXPENSE. LARGE MATURING SHADE TREES (THOSE THAT TYPICALLY GROW TO A SPREAD OR HEIGHT GREATER THAN 25 FEET) SHALL NOT BE PLANTED WITHIN 20 FEET OF ANY OTHER LARGE MATURING SHADE TREES UNLESS OTHERWISE SPECIFICALLY SHOWN ON THE LANDSCAPE PLAN. CONTRACTOR SHALL NOT WILLFULLY INSTALL PLANT MATERIALS IN CONFLICT WITH EXISTING OR PROPOSED SITE
- ROOT BARRIER SPECIFICATIONS: ROOT BARRIERS SHALL BE PROVIDED FOR WHERE NEW TREES ARE TO BE INSTALLED ADJACENT TO PROPOSED UTILITIES, AS PRESCRIBED HEREIN AND BY THE MANUFACTURER. SEE ROOT BARRIER DETAIL ON THIS SHEET. PRODUCT SHALL BE INSTALLED PER MANUFACTURER'S SPECIFICATIONS AND INSTRUCTIONS FOR ROOT CONTROL SYSTEMS. USE PRODUCT WHERE TREES ARE TO BE INSTALLED TEN FEET (10') OR LESS FROM HARDSCAPE SURFACES OR UNDERGROUND UTILITIES, INCLUDING BUT NOT LIMITED TO CURBS, SIDEWALKS, STEPS, ROADWAYS, WATER, DRAINAGE, EXFILTRATION TRENCH, & SEWER LINES. SMALL TREES THAT TYPICALLY MATURE AT 18' HEIGHT OR LESS REQUIRE ROOT BARRIERS WHERE SMALL TREES ARE WITHIN SIX FEET (6') OR LESS OF HARDSCAPE SURFACES OR UTILITIES. EXISTING TREES TO BE PRESERVED (WHERE THE EDGE ROOT FLARE IS LOCATED GREATER THAN TEN FEET (10') FROM ANY NEW HARDSCAPE AREAS OR UNDERGROUND UTILITIES) DO NOT REQUIRE ROOT BARRIERS. WHERE PROPOSED UNDERGROUND UTILITIES ARE TO BE INSTALLED 10 FEET OR LESS FROM THE ROOT FLARE OF EXISTING TREES, ROOT BARRIERS SHALL BE UTILIZED. ROOT BARRIERS ARE NOT REQUIRED WHERE PROPOSED TREES ARE LOCATED ADJACENT TO D-TYPE CURBING. THE USE OF ROOT BARRIERS SHALL BE MINIMUM 6' OVERALL LENGTH FROM THE CENTER OF THE TRUNK PARALLEL TO LINEAR FEATURES TO BE PROTECTED FOR SMALL TREES, OR MINIMUM 10' OVERALL LENGTH FROM THE CENTER OF THE TRUNK FOR MEDIUM TO LARGE MATURING SHADE TREES. MINIMUM LENGTHS OF ROOT BARRIER PRODUCTS MAY BE INCREASED (BUT NOT DECREASED) BASED ON LENGTH GRAPHICALLY DEPICTED ON PLAN, OR AT THE DISCRETION OF THE LANDSCAPE INSPECTOR. IN PARKING LOT ISLANDS ONLY, THE ROOT BARRIER LENGTH SHALL BE PROVIDED FOR THE FULL LENGTH OF FEATURE (UNDERGROUND UTILITY, STRUCTURE, OR PAVEMENT) TO BE PROTECTED. ROOT BARRIERS SHALL BE INSTALLED 1 FOOT HORIZONTAL DISTANCE FROM FEATURES TO BE PROTECTED.
- 8. CONTRACTOR SHALL BE RESPONSIBLE FOR PROVIDING FINAL GRADING OF ALL ASSOCIATED PLANTING AREAS. AFTER FINAL GRADE, AREA TO BE RAKED TO 6" DEPTH AND ALL ROCK AND FOREIGN INORGANIC MATERIALS REMOVED AND DISPOSED OF PROPERLY OFF-SITE.
- 9. ALL PLANTING HOLES TO BE HAND DUG EXCEPT WHERE MACHINE DUG HOLES WILL NOT ADVERSELY AFFECT OR DAMAGE UTILITIES OR IMPROVEMENTS. ALL TRENCHES & EXCAVATION REQUIRED FOR INSTALLATION OF UNDERGROUND UTILITIES OR IRRIGATION EQUIPMENT ADJACENT TO EXISTING TREES & VEGETATION TO BE PRESERVED SHALL BE HAND-DUG CAREFULLY AS FAR FROM THE TRUNK AS POSSIBLE.
- 10. NO PLUNGING OF ANY TREE OR PALM WILL BE ACCEPTED. TRUNK FLARE SHALL BE SET 1-2" ABOVE FINISH GRADE FOR ALL TREES & PALMS. ALL PLANTS TO BE PLANTED AT THE NURSERY GRADE OR SLIGHTLY HIGHER.
- 11. CONTRACTOR SHALL STAKE & GUY ALL TREES AND PALMS AT TIME OF PLANTING AS PER THE APPROPRIATE DETAIL. CONTRACTOR IS RESPONSIBLE FOR THE MAINTENANCE AND/OR REPAIR OF ALL STAKING AND GUYING DURING WARRANTY PERIOD AND REMOVAL & DISPOSAL OF STAKING AFTER ESTABLISHMENT PERIOD.
- 12. FERTILIZER FOR GRASS AREAS SHALL BE NPK 16-4-8 @ 12.5 LBS/1000 S.F. OR 545 LBS/ACRE. NITROGEN 50% SLOW RELEASE FORM & FERTILIZER TO INCLUDE SECONDARY MICRONUTRIENTS.
- 13. WATERING: ALL PLANT MATERIAL SHALL BE WATERED IN AT TIME OF PLANTING IN ACCORDANCE WITH STANDARD NURSERY PRACTICES. IN ADDITION, CONTRACTOR WILL CONTINUE WATERING OF PLANT MATERIAL UNTIL SUBSTANTIAL COMPLETION AND AS NEEDED THEREAFTER FOR A PERIOD OF 2 MONTHS.
- ALL PLANTS AND PLANTING MATERIALS INCLUDED UNDER THIS CONTRACT SHALL BE MAINTAINED BY WATERING, CULTIVATING, SPRAYING, AND ALL OTHER OPERATIONS (SUCH AS RE JSTAKING OR REPAIRING GUY SUPPORTS) NECESSARY TO INSURE A HEALTHY CONDITION BY THE CONTRACTOR UNTIL CERTIFICATION OF ACCEPTABILITY BY THE OWNER OR OWNER'S DESIGNEE. MAINTENANCE AFTER THE CERTIFICATION OF AN ACCEPTABILITY SHALL BE IN ACCORDANCE WITH THE SPECIFICATIONS IN THIS SECTION. CONTRACTORS AREREQUESTED TO PROVIDE A BID ESTIMATE TO COVER LANDSCAPE AND IRRIGATION MAINTENANCE FOR A PERIODOF NINETY (90) CALENDAR
- GUARANTEE: ALL NEW PLANT MATERIAL SHALL BE GUARANTEED FOR 1 YEAR FROM TIME OF FINAL ACCEPTANCE OF PROJECT. ANY PLANT MATERIAL NOT IN A HEALTHY GROWING CONDITION WILL BE REPLACED BY THE CONTRACTOR AT NO ADDITIONAL COST TO THE OWNER WITHIN 10 DAYS OF NOTIFICATION. FOR ALL REPLACEMENT PLANT MATERIAL, THE WARRANTY PERIOD SHALL BE EXTENDED AN ADDITIONAL 45 DAYS BEYOND THE ORIGINAL WARRANTY PERIOD. ALL TREES THAT LEAN OR ARE BLOWN OVER, CAUSED BY WINDS LESS THAN 75 MPH, WILL BE RE-SET AND BRACED BY THE CONTRACTOR AT NO ADDITIONAL COST TO THE OWNER. FINAL INSPECTION BY OWNER OR THEIR DESIGNEE AT THE END OF THE 1 YR GUARANTEE PERIOD SHALL INCLUDE PLANTING, CONSTRUCTION AND ALL OTHER INCIDENTAL WORK PERTAINING TO THIS CONTRACT. ANY PLANTS NOT MEETING THE CRITERIA OF HEALTHY, VIGOROUS, AND THRIVING AT THIS TIME, AND THAT HAVE NOT ALREADY BEEN REPLACED PREVIOUSLY UNDER SAID WARRANTY, SHALL BE SUBJECT TO THE SAME ONE (1) YEAR GUARANTEE (OR AS SPECIFIED BY THE OWNER IN WRITING) BEGINNING WITH THE TIME OF REPLACEMENT AND ENDING WITH THE SAME INSPECTION AND ACCEPTANCE HEREIN DESCRIBED.
- 16. THE SUCCESSFUL BIDDER SHALL FURNISH TO THE OWNER A UNIT PRICE BREAKDOWN FOR ALL MATERIALS.
- 17. NO PLANT MATERIAL WILL BE ACCEPTED SHOWING EVIDENCE OF CABLE, CHAIN MARKS, EQUIPMENT SCARS, OR OTHERWISE DAMAGED. PLANT MATERIAL WILL NOT BE ACCEPTED WHEN THE BALL OF EARTH SURROUNDING ITS ROOTS HAS BEEN CRACKED, BROKEN OR OTHERWISE DAMAGED.
- 18. ROOT-PRUNE ALL NEW TREES A MINIMUM OF (90) DAYS PRIOR TO PLANTING.
- 19. ALL LANDSCAPED AREAS WILL BE IRRIGATED BY AN UNDERGROUND, AUTOMATIC, RUST-FREE IRRIGATION SYSTEM PROVIDING 100% COVERAGE AND MINIMUM 50% SPRAY OVERLAP. THE SYSTEM SHALL BE MAINTAINED IN GOOD WORKING ORDER AND DESIGNED TO MINIMIZE WATER ON IMPERVIOUS SERVICES AND NOT OVERSPRAY WALKWAYS. A RAIN SENSOR DEVICE IS REQUIRED BY FL LAW & SHALL BE OPERATIONAL TO OVERRIDE THE IRRIGATION CYCLE OF THE SYSTEM WHEN ADEQUATE RAINFALL HAS OCCURRED.
- 20. ALL PLANT MATERIAL PLANTED WITHIN THE SIGHT DISTANCE TRIANGLE AREAS (SEE PLAN) SHALL PROVIDE UNOBSTRUCTED CROSS-VISIBILITY AT A HORIZONTAL LEVEL BETWEEN 30 INCHES AND 8 FEET ABOVE ADJACENT STREET GRADE.
- 21. NO CANOPY TREES SHALL BE PLANTED WITHIN 15 FEET OF A LIGHT POLE. NO PALM SPECIES SHALL BE PLANTED WITHIN 7.5 FEET OF A LIGHT POLE.
- TREE PROTECTION BARRICADES SHALL BE PROVIDED BY LANDSCAPE CONTRACTOR AROUND EXISTING TREES THAT MAY BE IMPACTED BY THE PROPOSED CONSTRUCTION. PRIOR TO ANY CONSTRUCTION A TREE PROTECTION BARRICADE INSPECTION SHALL BE CONDUCTED BY THE LANDSCAPE ARCHITECT, OWNER OR GOVERNING MUNICIPALITY. REFER TO LANDSCAPE DETAIL FOR TREE PRESERVATION BARRICADE FENCING.
- 23. IN ALL PEDESTRIAN AREAS, ALL TREES AND PALMS SHALL BE MAINTAINED TO ALLOW FOR CLEAR PASSAGE AT AN 8 FOOT CLEAR TRUNK.
- 24. ALL LANDSCAPE MATERIAL SHALL BE SETBACK A MINIMUM OF 7.5 FEET FROM THE FRONT/SIDES AND 4 FEET FROM THE BACK ANY FIRE HYDRANT.
- 25. MULCH SHALL BE FROM SHREDDED WOOD DERIVED FROM MELALEUCA OR OTHER INVASIVE TREE SPECIES AND SHALL BE STERILIZED TO EFFECTIVELY ELIMINATE ALL SEEDS, SPORES, ETC. AND RENDER THEM BARREN. MULCH MATERIAL SHALL BE MOISTENED AT THE TIME OF APPLICATION TO PREVENT WIND DISPLACEMENT AND APPLIED AT A DEPTH OF THREE INCHES (3"). MULCH IS TO BE KEPT 2-3" FROM THE STEM OF ALL GROUNDCOVERS & 3-6" FROM THE TRUNK OF ALL TREES & PALMS. MULCH SHALL BE GRADE 'B' SHREDDED, AND SHALL BE APPLIED EVENLY AND SMOOTH TO PLANTED AREAS. NO RED OR COLORED MULCH SHALL BE ACCEPTED UNLESS SPECIFIED ACCORDINGLY. NO CYPRESS MULCH OR PINE BARK SHALL BE USED.
- 26. PLANTINGS SHALL BE INSTALLED IN COMPLIANCE WITH ALL EXISTING CODES AND APPLICABLE DEED RESTRICTIONS. WHERE DISCREPANCIES EXIST, JURISDICTIONAL CODES, STANDARDS, & REGULATIONS SHALL GOVERN.

