

PLANNING DIVISION



2600 Hollywood Boulevard Room 315 Hollywood, FL 33022 File No. (internal use only):_

GENERAL APPLICATION

	Allen er	APPLICATION TYPE
Hole		☐ Technical Advisory Cor
	IIYWUUU	☐ City Commission
	FLORIDA	Date of Application:
Te	I: (954) 921-3471	Location Address: 1951, 19
3.00	x: (954) 921-3347	Lot(s): LOT 3,4,5,6 & 7
1		Folio Number(s): 5142 15 0
		Zoning Classification: ND-2 (
	application must be	Existing Property Use: RESIDE
	npleted <u>in full</u> and ed with all documents	Is the request the result of a
to be	placed on a Board or nmittee's agenda.	Has this property been prese Number(s) and Resolution(s):
200		☐ Economic Roundtable
	plicant is responsible aining the appropriate	☐ City Commission
check	dist for each type of application.	Explanation of Request: NEW
Ар	plicant(s) or their	40.11
pres	ed legal agent must be sent at all Board or	Number of units/rooms: 48 U
Con	nmittee meetings.	Value of Improvement: \$10,0
		Will Project be Phased? () Y
1000	east one set of the itted plans for each	
applica	ation must be signed	Name of Current Property Ow
and se	aled (i.e. Architect or Engineer).	Address of Property Owner: _
	5/.	Telephone: _(786) 863-0068
Docume	ents and forms can be	Name of Consultant/Represe
accessed	d on the City's website at	Address: 2417HOLLYWOODB
http://www	ww.hollywoodfl.org/Do	Fax: E
	Center/Home/View/21	Date of Purchase: 5-19-22
		If Yes, Attach Copy of the Con
	. 	List Anyone Else Who Should
	llw 1	

APPLICATION TYPE (CHECK ONE):	
☐ Technical Advisory Committee [☐ Historic Preservation Board
☐ City Commission	Planning and Development Board
Date of Application:	_
Location Address: 1951, 1935 - 1947 LINCOL Lot(s): LOT 3,4,5,6 & 7 Block(s): BLK Folio Number(s): 5142 15 01 2720 & 5142 15 Zoning Classification: ND-2 (RAC) Existing Property Use: RESIDENTIAL MULTIFAMILY	Subdivision: HOLLYWOOD 1-21 B 0 01 2750 Land Use Classification: RESIDENTIAL
) Yes (X) No If yes, attach a copy of violation.
	efore? If yes, check al that apply and provide File
☐ Economic Roundtable ☐ Technical Advis ☐ City Commission ☐ Planning and Do	ory Committee
Explanation of Request: NEW CONSTRUCTION	, 48 UNIT APARTMENT BUILDING FOR APPROVAL
Number of units/rooms: 48 UNITS	Sq Ft: 47,618
Value of Improvement: \$10,000,000 Es	
	If Phased, Estimated Completion of Each Phase
Name of Current Property Owner: VIVA HOLL	YWOOD LLC
Address of Property Owner:2721 EXECUTIVE	
Telephone: (786) 863-0068 Fax:	Email Address:_ik@arkplusgroup.com
Name of Consultant/Representative/Tenant (cir	cle one): _JOSEPH B. KALLER, AIA, LEED BD+C
Address: 2417 HOLLYWOOD BLVD, HOLLYWOOD F	
Fax: Email Address: _J	OSEPH@KALLERARCHITECTS.COM
	option to purchase the Property? Yes()No()
If Yes, Attach Copy of the Contract.	
List Anyone Else Who Should Receive Notice o	of the Hearing: ISAAC KHABIE
Addr	ress: Email Address: ik@ArkPlusGroup.com
	Lineil Address. INWARE Ideology.com

PLANNING DIVISION



2600 Hollywood Boulevard Room 315 Hollywood, FL 33022

Signature of Current Owner

File No. (internal use only):

GENERAL APPLICATION

Date: 3/22/2023

CERTIFICATION OF COMPLIANCE WITH APPLICABLE REGULATIONS

The applicant/owner(s) signature certifies that he/she has been made aware of the criteria, regulations and guidelines applicable to the request. This information can be obtained in Room 315 of City Hall or on our website at www.hollywoodfl.org. The owner(s) further certifies that when required by applicable law, including but not limited to the City's Zoning and Land Development Regulations, they will post the site with a sign provided by the Office of Planning and Development Services. The owner(s) will photograph the sign the day of posting and submit photographs to the Office of Planning and Development Services as required by applicable law. Failure to post the sign will result in violation of State and Municipal Notification Requirements and Laws.

(I)(We) certify that (I) (we) understand and will comply with the provisions and regulations of the City's Zoning and Land Development Regulations, Design Guidelines, Design Guidelines for Historic Properties and City's Comprehensive Plan as they apply to this project. (I)(We) further certify that the above statements and drawings made on any paper or plans submitted herewith are true to the best of (my)(our) knowledge. (I)(We) understand that the application and attachments become part of the official public records of the City and are not returnable.

Signature of Consultant/Representative:	Date: 3-22-23
	Date: 5 22 22
PRINT NAME: JOSEPH B. KALLER	Date: 3-22-23
Signature of Tenant:	Date:
PRINT NAME:	Date:
Current Owner Power of Attorney	
am the current owner of the described real property and that I am aware to my property, which is hereby to be my legal representative before the Committee) relative to all matters concerning this application. Sworn to and subscribed before me this day of Commission # HH 2696 My Comm. Expires May 12, 2024	made by me or I am hereby authorizing
Bonded through National Notary Assn.	0/22/2020
Notary Public Bonded through National Notary Assn.	Print Name



Site Address	1935 LINCOLN STREET, HOLLYWOOD FL 33020-3509	ID#	5142 15 01 2750
Property Owner	VIVA HOLLYWOOD LLC	Millage	0513
Mailing Address	2721 EXECUTIVE PARK DR #4 WESTON FL 33331	Use	08-06
Abbr Legal Description	HOLLYWOOD 1-21 B LOTS 4,5,6 & 7 BLK 17		

The just values displayed below were set in compliance with Sec. 193.011, Fla. Stat., and include a reduction for costs of sale and other adjustments required by Sec. 193.011(8).

	* 202	23 values are cor	nsidere	d "working values	" and	are subject to	change	€.	
			Prope	rty Assessment \	/alue	es			
Year	Land		Building / Improvement		Just / Market Value		Assessed / SOH Value		(
2023*	\$187,190	\$900,10	00	\$1,087,29	0	\$1,087	,290		
2022	\$187,190	\$432,58	30	\$619,770)	\$619,7	770	\$14,09 ⁻	1.85
2021	\$187,190	\$432,58	30	\$619,770)	\$619,7	770	\$14,149	9.95
		2023* Exempti	ons ar	nd Taxable Values	s by T	Гахing Autho	rity		
		Co	unty	School B	oard	Mun	icipal	Indep	endent
Just Value		\$1,087	7,290	\$1,087	7,290	\$1,08	7,290	\$1,	087,290
Portability			0		0		0		
Assessed/S	ОН	\$1,087	7,290	\$1,087	7,290	\$1,087,290		\$1,087,29	
Homestead			0		0	0		0	
Add. Homes	stead		0	0			0		0
Wid/Vet/Dis			0	0			0		0
Senior			0	0			0		0
Exempt Typ	е		0	0			0		0
Taxable		\$1,087	7,290	\$1,087,290		00 \$1,087,290		\$1,	087,290
		Sales History				Lan	d Calcu	lations	
Date	Type	Price	Boo	k/Page or CIN		Price	F	actor	Type
5/4/2022	WD-Q	\$1,240,000		118133590		\$9.00	2	0,799	SF
4/15/2020	WD-E	\$1,200,000		116469241					
4/24/2019	WD*-E	\$700,000	115779360						
2/28/2017	WD*-E	\$435,000		114233500					
5/10/2016	WD*-D	\$360,000	113689972			Adj. Bldg. S.F	. (Card	Sketch)	3441
* Denotes M	ulti-Parcel S	ale (See Deed)			Units			4	
		,				Eff./Act.	ear Bu	ilt: 1965/195	9

	Special Assessments							
Fire	Garb	Light	Drain	Impr	Safe	Storm	Clean	Misc
05								
R								
4								



Site Address	1951 LINCOLN STREET, HOLLYWOOD FL 33020	ID#	5142 15 01 2720
Property Owner	VIVA HOLLYWOOD LLC	Millage	0513
Mailing Address	2721 EXECUTIVE PARK DR #4 WESTON FL 33331	Use	01-01
Abbr Legal Description	HOLLYWOOD 1-21 B LOT 3 BLK 17		

The just values displayed below were set in compliance with Sec. 193.011, Fla. Stat., and include a reduction for costs of sale and other adjustments required by Sec. 193.011(8).

	* 202	3 values are co	onsider	ed "working value	s" a	and ar	e subject to	chan	ge.		
			Prop	erty Assessment	Va	lues					
Year	Land	Build Improve		Just / Market t Value		et	Assessed / SOH Value		Та	ıx	
2023*	\$36,400	\$279,2	200	\$315,60	00		\$315,6	600			
2022	\$36,400	\$279,2	200	\$315,60	00		\$180,5	540	\$4,88	3.79	
2021	\$36,400	\$218,8	830	\$255,23	30		\$164,1	130	\$4,31	8.20	
		2023* Exemp	tions a	ınd Taxable Value	s b	у Тах	king Authori	ity			
		Co	ounty	School E	Зоа	ırd	Munic	ipal	Inde	pendent	
Just Value		\$31	5,600	\$31	5,6	00	\$315,	600	\$	315,600	
Portability			0			0		0		0	
Assessed/S0	OH	\$31	5,600	\$31	5,6	00	\$315,600		\$	\$315,600	
Homestead			0		0		0			0	
Add. Homes	tead		0		0		0			0	
Wid/Vet/Dis			0	0		0	0			0	
Senior			0	0		0	0			0	
Exempt Type)		0	0		0		0		0	
Taxable		\$31	\$315,600 \$		5,6	\$315,600			\$	\$315,600	
		Sales History			1		Land	Calc	culations		
Date	Type	Price	Во	ok/Page or CIN			Price	Factor		Type	
5/19/2022	WD-Q	\$480,000		118180018	1[;	\$7.00		5,200	SF	
4/17/1995	QCD	\$100		23359 / 222	1[
8/1/1994	QCD	\$100		22599 / 159	1[
5/1/1987	WD	\$70,000									
	Î				1L	Ad	j. Bldg. S.F.	(Car	d, Sketch)	1808	
		н			- [Un	nits		1	
							Eff./Act. Ye	ear B	uilt: 1961/195	6	

Special Assessments									
Fire	Garb	Light	Drain	Impr	Safe	Storm	Clean	Misc	
05									
R									
1									



Legal Descriptions:

1935 Lincoln Street, Hollywood FL 33020

• Lots 4, 5, 6 and 7, Block 17, Hollywood, according to the plat thereof, as recorded in Plat Book 1, Page 21, ofthe Public Records of Broward County, Florida.

1951 Lincoln Street, Hollywood FL 33020

• Lot 3, Block 17, Hollywood, according to the map or plat thereof, as recorded in Plat Book 1, Page 21, of the Public Records of Broward County, Florida.



KallerArchitecture

Project Description:

Proposed new construction, 48 unit residential multifamily building comprised of 5 stories and a rooftop amenities area with on-grade parking underneath the building.



March 20, 2023

City of Hollywood 2600 Hollywood Boulevard Hollywood, FL 33022

Reference: Lincoln Street Apartments 1935-1951 Lincoln Street Hollywood, Florida File #22-DP-60

To Whom It May Concern,

The following is our analysis of Criteria and findings for Review for the above referenced Residential Building as per the City of Hollywood Zoning and Land Development Regulations.

DESIGN REVIEW

GENRAL CRITERIA: All plans/architectural drawings shall be reviewed based upon the evaluation of compatibility with the City's Design Guidelines, including the following elements:

CRITERION 1: Architectural and Design components. Architecture refers to the architectural elements of exterior building surfaces. Architectural details should be commensurate with the building mass. The use of traditional materials for new architectural details is recommended. Design of the building(s) shall consider aesthetics and functionality, including the relationship of the pedestrian with the built environment.

ANALYSIS: The proposed building design creates a clean and clear delineation of the building horizontality and verticality by protruding all of the units at the apartment levels. Also, the height and massing of the units is further broken up by creating it with an entirely different white stucco color from the rest of the building to give the effect that the units are popping out from the building. Second, the ground level has a white stucco architectural "frame out" around the lobby and garage entrances to better clarify where the base of the building activity is occurring at the pedestrian level. Furthermore, the ground floor uses elements of composite wood siding at the base, which helps to break up the horizontality of the ground floor and allow for communication between the base and the sidewalk as well.

CRITERION 2: Compatibility. The relationship between existing architectural styles and proposed construction, including how each building along the street relates to the whole and the pattern created with adjacent structures and the surrounding neighborhood. Buildings should contain architectural details that are characteristic of the surrounding neighborhood.

ANALYSIS: The proposed building follows the intent of the District per the Downtown Master Plan. The building design also provides a building base, a common design feature in the neighborhood, which encourages pedestrian movement around the building along the streets. The colors palate selected and use of stucco work are also elements common to the existing and proposed buildings in the surrounding neighborhood.

CRITERION 3: Scale/Massing. Buildings shall be proportionate in scale, with a height which is consistent with the surrounding structures. Building mass shall reflect a simple composition of basic architectural details in relation to its length, width, height lot coverage, and setting of the structure in context with adjacent buildings. Architectural details include, but are not limited to, banding, molding, and fenestration.

ANALYSIS: The proposed building scale is consistent with the height allowed by the Downtown Master Plan for the District. The overall scale of the building is broken up at the pedestrian level by the use of large windows and wood panels at the building base and façade movement by use of alternating stucco colors and composite wood treatments at the upper levels as well. The massing of the building is further broken up by protruding units with a white stucco color at the upper levels of the façade and the use of landscaping to further enhance the pedestrian base level.

CRITERION 4: Landscaping. Landscaped areas should contain a variety of native and other compatible plant types and forms and be carefully integrated with existing buildings and paved areas. Existing mature trees and other significant plants on the site should be preserved.

ANALYSIS: The proposed design incorporates the use of native plants selected specifically for use at this area with careful consideration of insects and diseases common to the area. The proposed planting also creates variations of color and texture and are integrated in the front yards of the ground units and along public sidewalks.

Should you have any questions, please feel free to contact this office.

Sincerely,

Kaller Architecture

Joseph B. Kaller AIA, LEED AP BD+C

President



Property Photos:

SUBJECT PROPERTY PHOTOS:







ADJACENT PROPERTY PHOTOS:












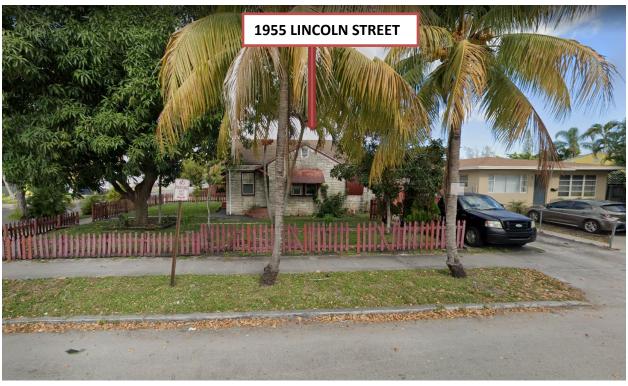





Notes Corresponding to Schedule B - Section II

THERE ARE NOT EASEMENTS SHOWN IN THIS SCHEDULE B-SECTION 2 THAT AFFECT THIS PROPERTY.

LOCATION MAP

NOT TO SCALE

200.00'(R) 10' ASPHALT PAVEMENT ۴۶۶۰ SLAB 30.15 RESIDENCE & # 1935 CONC DRIVEWAY CONC WALK STRUCTURE : FFE: 8.76' LOT 10 # 1935 BLOCK 17 + BLOCK 17 BLOCK 17 5.28' BLOCK 17 BLOCK 17 FFE: 10.15' BLOCK 17 ♦ (PARCEL 2) (PARCEL 1) (PARCEL 1) Commitment for Title Insurance: 5' CONC SIDEWALK ___ Issued by: Fidelity National Title Insurance Company 6' PARKWAY 200.53'(M) 200.00'(R) State: Florida 0.6' CURB -25' ASPHALT PAVEMENT County: Broward STREET LINCOLN Issuing Office File Number: 368 6' PARKWAY <u>Schedule A:</u> 5' CONC SIDEWALK Lot 25 Effective Date: April 12, 2022 at 11:00 PM Block 18 Block 18 Block 18 Folio #: 5142-15-01-3070 Block 18 Folio #: 5142-15-01-3080 Folio #: 5142-15-01-3090 Block 18 Owner: "UEBERLAUER, GRAZYNA Folio #: 5142-15-01-3100 Folio #: 5142-15-01-3110 Owner: HUANG, JIE YING 1930 LINCOLN ST, 1934 LINCOLN ST, HOLLYWOOD,FL, 33020 1940 LINCOLN ST 1-2, HOLLYWOOD, FL 33020 GONZALEZ, CARMEN WILLIAM A LE CALORE, HOLLYWOOD, FL 33020 1936 LINCOLN ST 1-2 BRIANA L 1946 LINCOLN ST, HOLLYWOOD, FL 33020

** FOR PROPER AND SCIENTIFIC TREE NAME

AN ARBORIST SHOULD BE CONTACTED.

Address:

71.53

(IN FEET)
1 INCH = 20 FEET.

FIR. 1/2" = FOUND IRON REBAR 1/2" FIP. 1/2" = FOUND IRON PIPE 1/2"

= PERMANENT REFERENCE MONUMENT

= NORTH AMERICAN VERTICAL DATUM 1988

0

2

BLOCK

CORNER

= POINT OF INTERSECTION

= OFFICIAL RECORDS BOOK

= UTILITY EASEMENT

= FOUND NAIL

= RECORD

= DIAMETER

= LENGTH = RADIUS

= DELTA

Symbol Legend

CATCH BASIN

FIRE HYDRANT

WOOD POWER POLE

METAL LIGHT POLE

☐ CONC LIGHT POLE

S STREET LIGHT METER

(D) Drainage Manhole

CLEAN OUT

CABLE BOX

S MANHOLE

⊗ BOLLARDS

WATER VALVE

O PARKING SIGN

TRAFFIC SIGN

E ELECTRIC METER

HANDICAP METAL LID --- ALUMINUM FENCE

—онw— OVERHEAD WIRE

—"—"— WOOD FENCE

----- CHAIN LINK FENCE

= CENTER LINE = RIGHT-OF-WAY

Abbreviations

1951 LINCOLN STREET, HOLLYWOOD, FLORIDA, 33020

PARCEL ID #: 5142-15-01-2720

Lots 29–30

Folio #: 5142-15-01-3130

1956 LINCOLN ST,

LOT 2

BLOCK 17

Legal Description:

LOT 3, BLOCK 17, HOLLYWOOD, ACCORDING TO THE PLAT THEREOF, AS RECORDED IN PLAT BOOK 1, PAGE 21, OF THE PUBLIC RECORDS OF BROWARD COUNTY, FLORIDA.

Folio #: 5142-15-01-3120

Owner: POLIGNAN, MIGUEL LUIS

& ADRIANA

1948 LINCOLN ST 1-2,

HOLLYWOOD, FL 33020

RESIDENCE

BLOCK 17

FFE: 10.54

Address:

1935 LINCOLN STREET, HOLLYWOOD, FLORIDA, 33020

PARCEL ID #: 5142-15-01-2750

Legal Description:

LOTS 4, 5, 6 AND 7, BLOCK 17, HOLLYWOOD, ACCORDING TO THE PLAT THEREOF, AS RECORDED IN PLAT BOOK 1, PAGE 21, OF THE PUBLIC RECORDS OF BROWARD COUNTY, FLORIDA.

Surveyor's Notes:

- 1. Unless otherwise noted record and measured data are in substantial
- 2. The Street Right-of-Way abutting this property are physically open unless otherwise noted.
- 3. Elevations if shown relative to The North American Vertical Datum of 1988.
- 4. Additions or deletions to survey map by other than the signing party or parties is prohibited without the written consent of the signing party of parties.
- 5. No underground installations or improvements have been located.
- 6. This survey map or the copies thereof are not valid without the signature and the original raised seal of a Florida Licensed Surveyor & Mapper.
- 7. This property lies in Zone X, Elevation N/A, per Fema Map 0569, Community 125113, Suffix H, Map Dated 8-18-2014.
- 8. Bench Mark Used: BM # P 239 Elevation 10.932' (NGVD 29)-1.5'= 9.432' (NAVD 88)
- 9. This property has 26,077.90 square feet more or less.
- 10. The survey reflects the Ownership and Encumbrance Reports FILE NO. 22124604 and 22124599 conducted by Old Republic National Title Insurance Company.

This is to certify that this map or plat and the survey on which it is based were made in accordance with the 2021 Minimum Standard Detail Requirements for ALTA/NSPS Land Title Surveys, jointly established and adopted by ALTA/NSPS, and includes items 2, 3, 4, 5, 7 (a), 7(b), 7(b)(1), 7(c), 8, 9, 13, 16 and 17 of Table A thereof.

06-06-2022

PEDRO L. MARTINEZ P.S.M. (FOR THE FIRM) PROFESSIONAL SURVEYOR AND MAPPER # 5443 STATE OF FLORIDA.

This survey map or the copies thereof are not valid without the signature and the original raised seal of a Florida licensed surveyor and mapper.



CHECKED BY: DATE: 10-03-2022

1 of 1 JOB NUMBER: 220530

SHEET:

 $\overline{\mathbb{S}}$ \mathbb{S}

PEDRO L. MARTINEZ P.S.M. (FOR THE FIRM PROFESSIONAL SURVEYOR AND MAPPER # 5443 STATE OF FLORIDA.

This survey map or the copies thereof are not valid without the signature an the original raised seal of a Florida licensed surveyor and manager.

LINCOLN STREET APARTMENTS

1951, 1935 - 1947 LINCOLN ST. HOLLYWOOD, FL 33020

1935-1947 Lincoln Street, Hollywood, Florida, 33139 (Parcel ID: 514215012750) PARCEL 1: Lots 4 and 5, Block 17, Hollywood, according to the Plat thereof, as recorded in Plat Book 1, Page 21, of the Public Records of Broward County, Florida. PARCEL 2: Lots 6 and 7, Block 17, Hollywood, according to the Plat thereof, as recorded in Plat Book 1, Page 21, of the Public Records of Broward County, Florida. 1951 Lincoln Street, Hollywood, Florida, 33139 (Parcel ID: 514215012720) Lots 3, Block 17, Hollywood, according to the Plat thereof, as recorded in

Plat Book 1, Page 21, of the Public Records of Broward County, Florida.

<u>OWNER</u>

Viva Hollywood, LLC 2721 Executive Park Dr, #4 Weston, FL 33331 (786) 863-0068

ARCHITECT

JOSEPH B. KALLER AND ASSOCIATES, P.A. ADDRESS: 2417 HOLLYWOOD BLVD. HOLLYWOOD, FL 33019 joseph@kallerarchitects.com

CIVIL ENGINEER

ZEPHYR ENGINEERING. CBE, SBE & DBE Firm CONTACT: WILFORD ZEPHYR, P.E. ADDRESS: 5451 PIERCE ST, HOLLYWOOD, FL 33021 wilford@zephyrengineeringfl.com

LANDSCAPE

THE MIRROR OF PARADISE

ADDRESS: 2881 E OAKLAND PARK BLVD, SUITE 315 FORT LAUDERDALE, FL 33306 PHONE: (954)-315-1707 ext. 1077 gabriela@themirrorofparadise.com

SURVEYOR

ALPHA C & N LAND SERVICES, LLC CONTACT: PEDRO LUIS MARTINEZ ADDRESS: 5801 NW 2nd STREET, **MIAMI FL 33126** alphalandservices@gmail.com

CONTACT: GABRIELA FOJT, ASLA, RLA

ARCHITECTURE

RENDERING RENDERING A-R2 A-R3 RENDERING A-1.01 AREA DIAGRAMS A-1.1 GROUND FLOOR / ZONING DATA A-1.2 SECOND FLOOR A-1.3 THIRD TO FOURTH FLOOR FIFTH FLOOR A-1.4 A-1.5 SIXTH FLOOR - ROOF TERRACE A-1.6 A-1.7 **ELEVATIONS** A-1.8 **ELEVATIONS** STREET PROFILE A-1.9 DETAILS A-1.10 SOUTH WEST ISOMETRIC A-1.11 SOUTH EAST ISOMETRIC

COVERSHEET

A-1.13


EROSION & SEDIMENT CONTROL PLAN PAVING, GRADING & DRAINAGE PLAN PAVEMENT MARKINGS & SIGNAGE PLAN WATER & SEWER PLANS & DETAILS UTILITIES DETAILS


NORTH EAST ISOMETRIC NORTH WEST ISOMETRIC


LANDSCAPE

REMOVAL PLAN DT-2 EXISTING TREES CHART LANDSCAPE PLAN GROUND LEVEL PLANT SCHEDULE, CODE CHART & DETAILS LP-2 LP-3 LANDSCAPE ROOF TERRACE, PLANT SCHEDULE LP-4 COLORED PLAN GROUND LEVEL LP-5 COLORED PLAN ROOF DECK HOLLYWOOD CITY NOTES, GENERAL NOTES




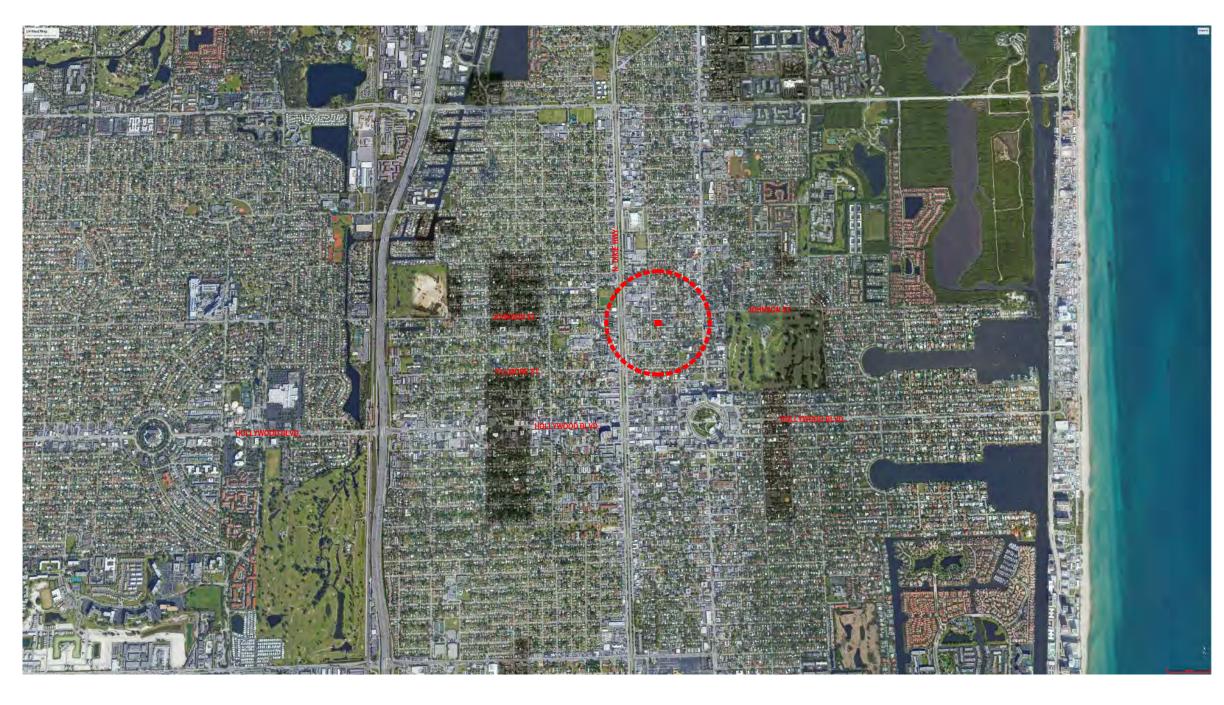

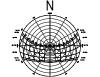

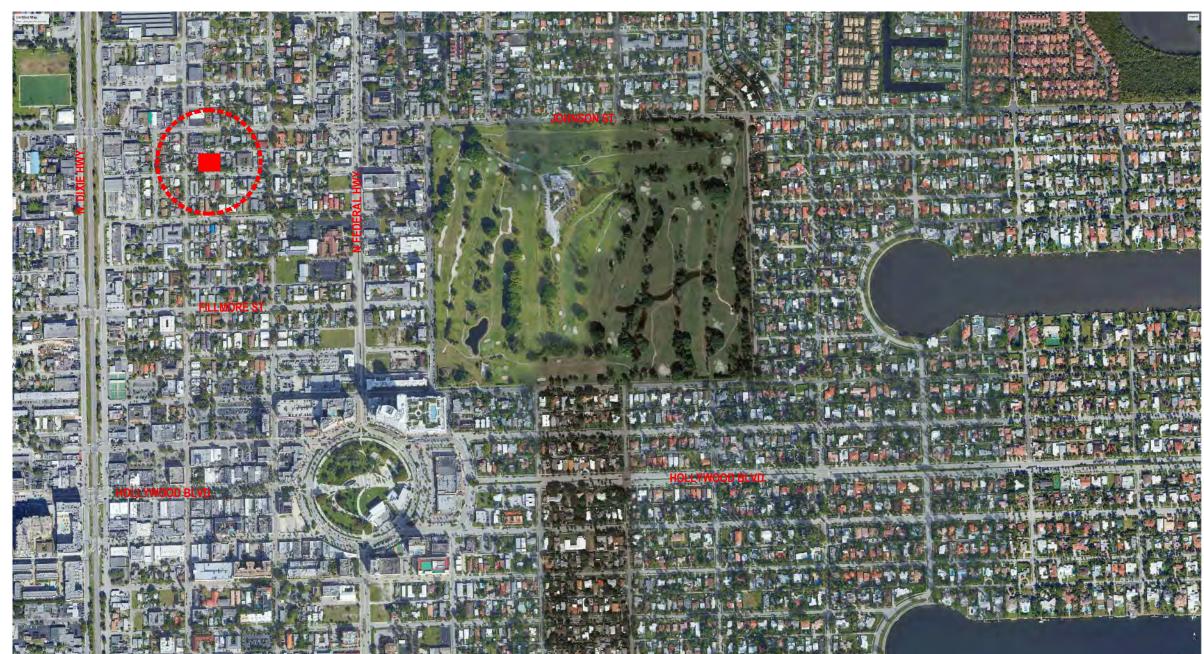



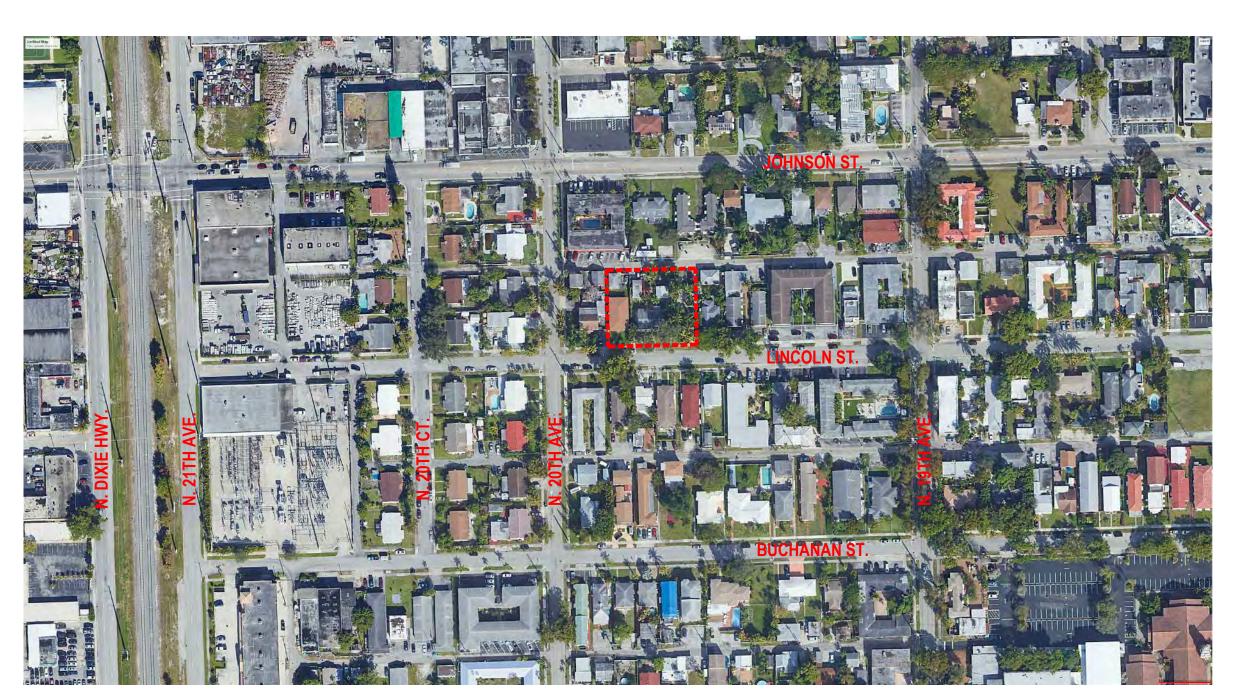



Kaller Architecture AA# 26001212 2417 Hollywood Blvd. Hollywood Florida 33020 954.920.5746 joseph@kallerarchitects.com

www.kallerarchitects.com

JOSEPH B. KALLER

FLORIDA R.A. # 0009239

MEETING DATES

DATE DESCRIPTION 09/06/22 FILE# 22-DP-60 PRE TAC | 11/07/22 | FILE# 22-DP-60 FINAL TAC | 12/19/22 | FILE# 22-DP-60 EP&D BOARD | T.B.D | FILE# 22-DP-60

This drawing, as an instrument of service, is and shall remain the property of the Architect and shall not be reproduced, published or used in any way without the

permission of the Architect.

DRAWN BY: SCHIFFINO CHECKED BY: JBK





www.kallerarchitects.com

JOSEPH B. KALLER FLORIDA R.A. # 0009239

MEETING DATES

BOARD/ COMMITE DATE DESCRIPTION 11/07/22 FILE# 22-DP-60 FINAL TAC 12/19/22 FILE# 22-DP-60 FRAD BOARD T.B.D FILE# 22-DP-60

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DRAWN BY:

g Checked by: Jbk





www.kallerarchitects.com

JOSEPH B. KALLER FLORIDA R.A. # 0009239

MEETING DATES

12/19/22 FILE# 22-DP-60 FINAL TAC ^gP&D BOARD T.B.D FILE# 22-DP-60

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DRAWN BY:

g CHECKED BY: JBK





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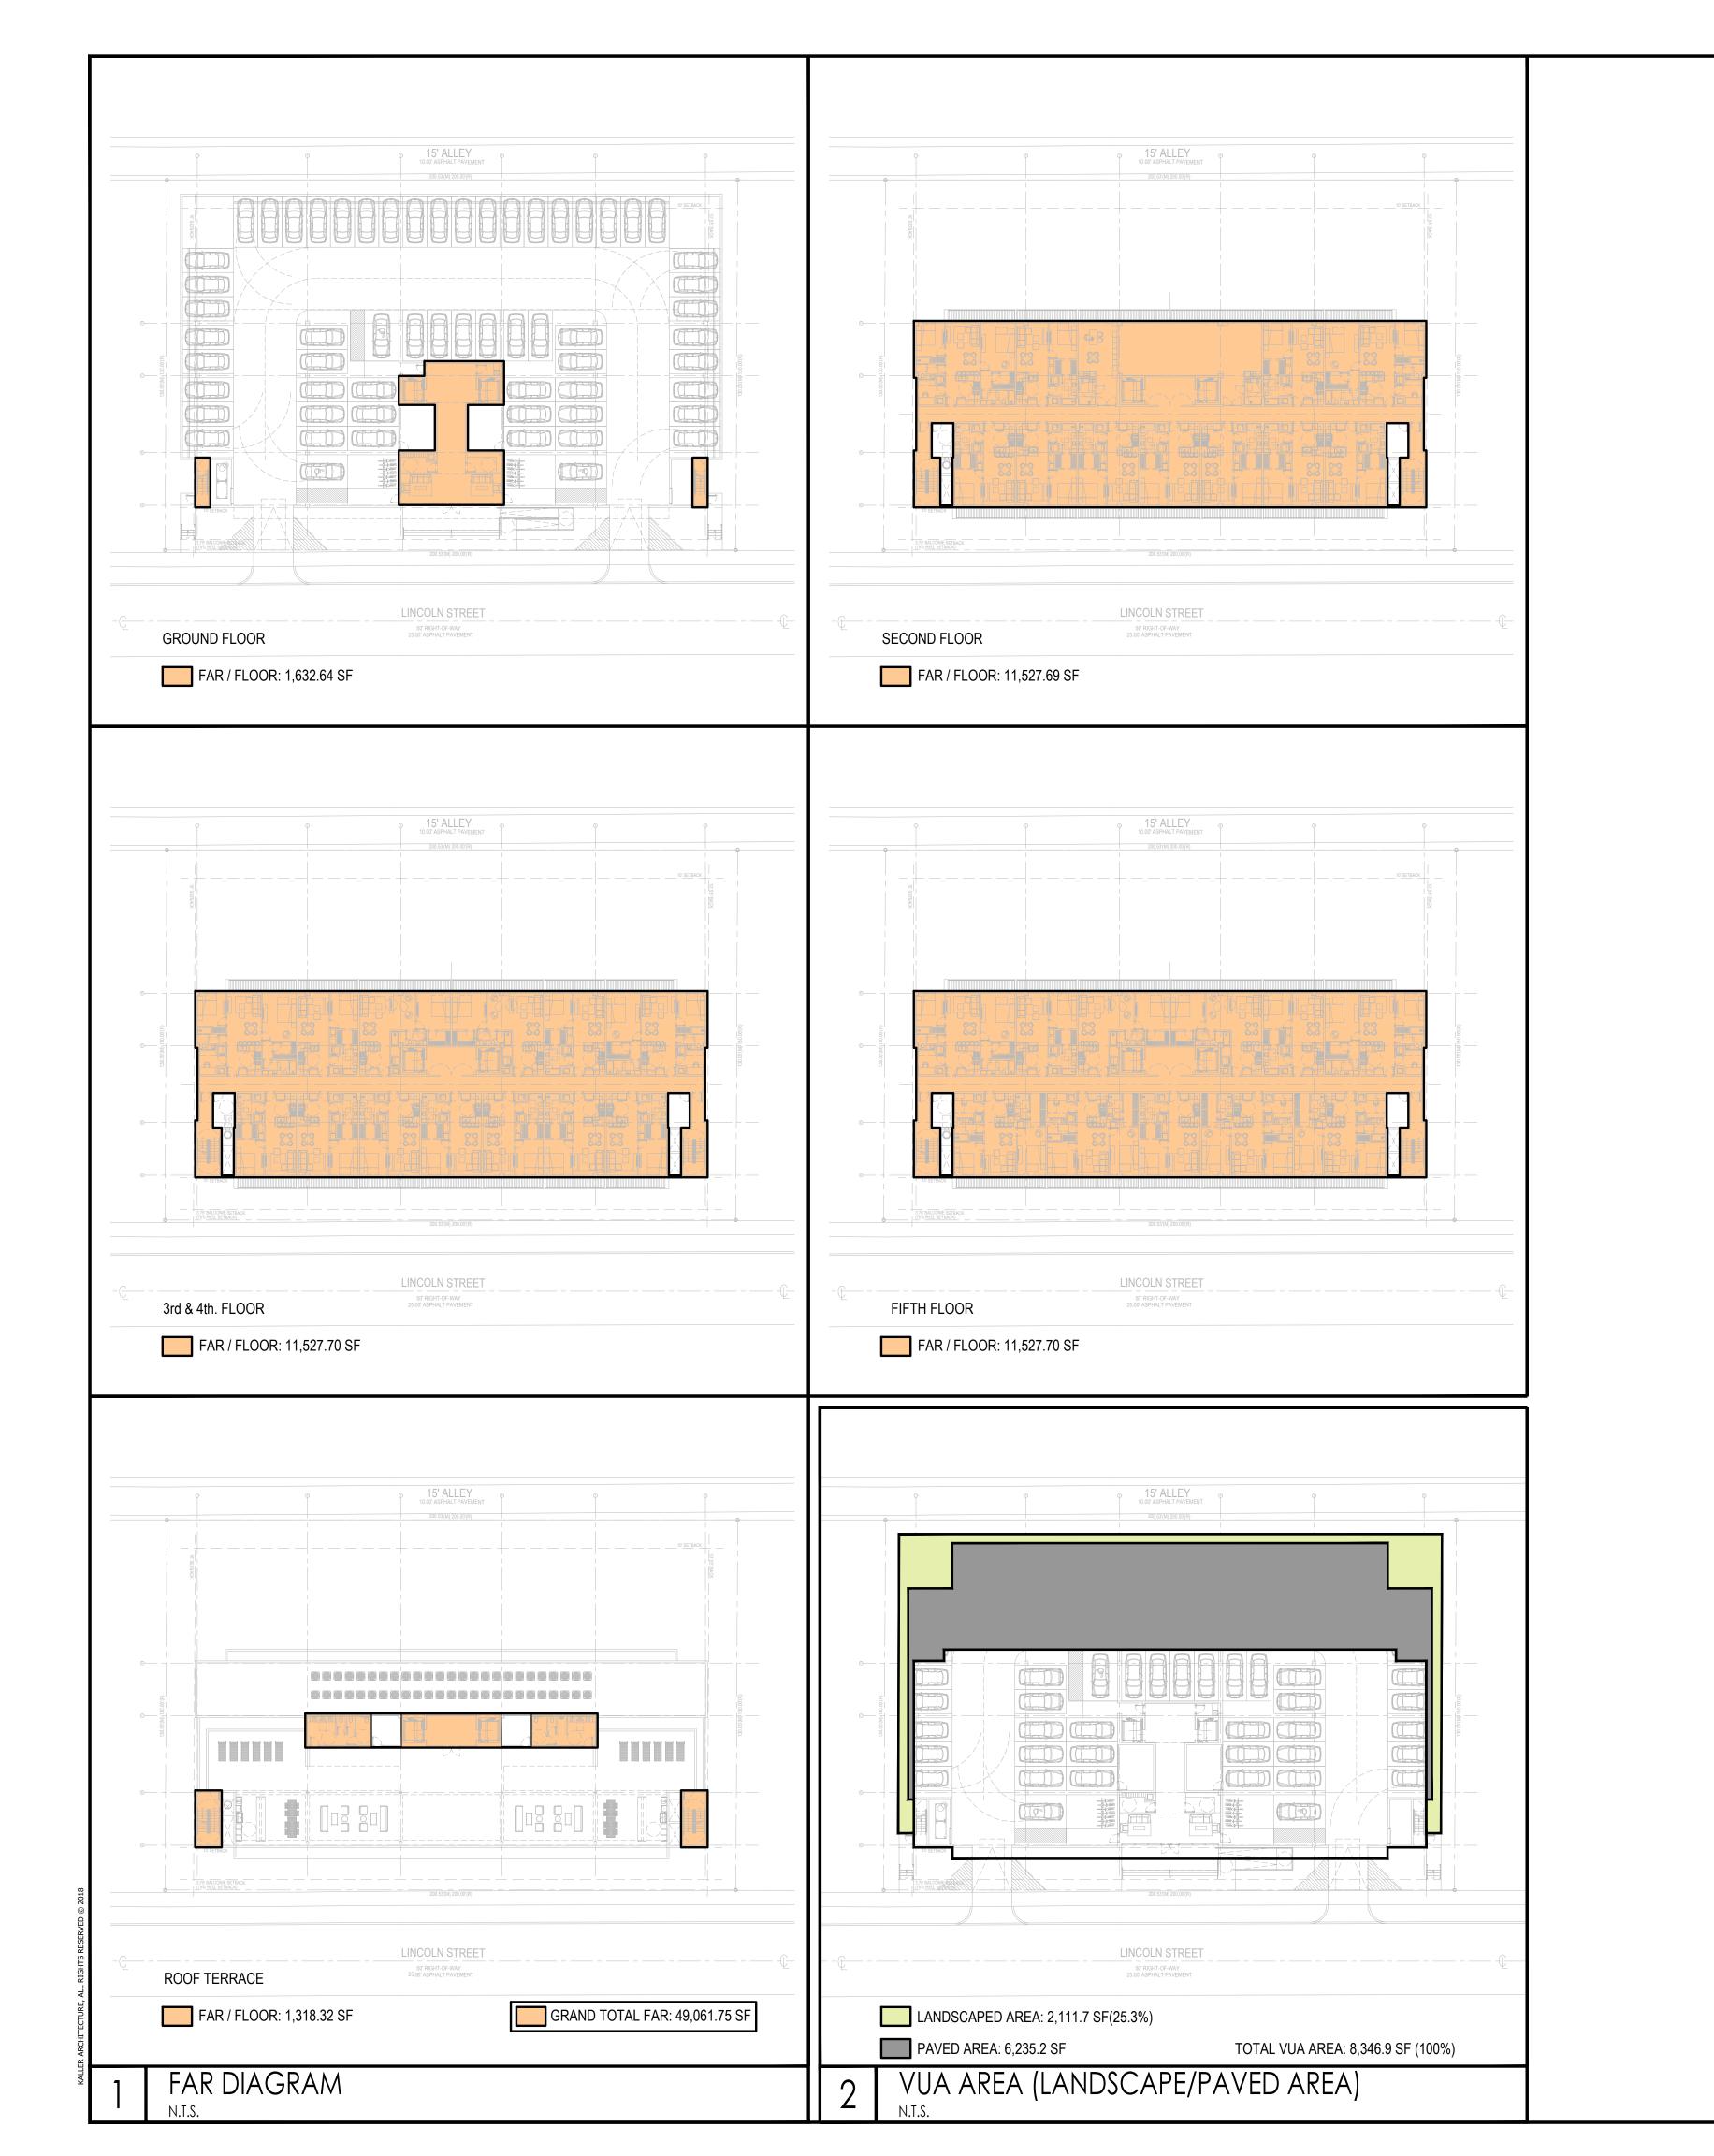
JOSEPH B. KALLER FLORIDA R.A. # 0009239

MEETING DATES

12/19/22 FILE# 22-DP-60 P&D BOARD T.B.D FILE# 22-DP-60

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DRAWN BY: g CHECKED BY: JBK





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joseph@kallerarchitects.com

www.kallerarchitects.com

JOSEPH B. KALLER FLORIDA R.A. # 0009239

APT

LINCOLN

MEETING DATES


BOARD/
COMMITE DATE DESCRIPTION 09/06/22 FILE# 22-DP-60 11/07/22 FILE# 22-DP-60 PRE TAC FINAL TAC 12/19/22 FILE# 22-DP-60 EP&D BOARD T.B.D FILE# 22-DP-60

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PROJECT No.:

DRAWN BY: CHECKED BY: JBK



3/32"=1'-0"

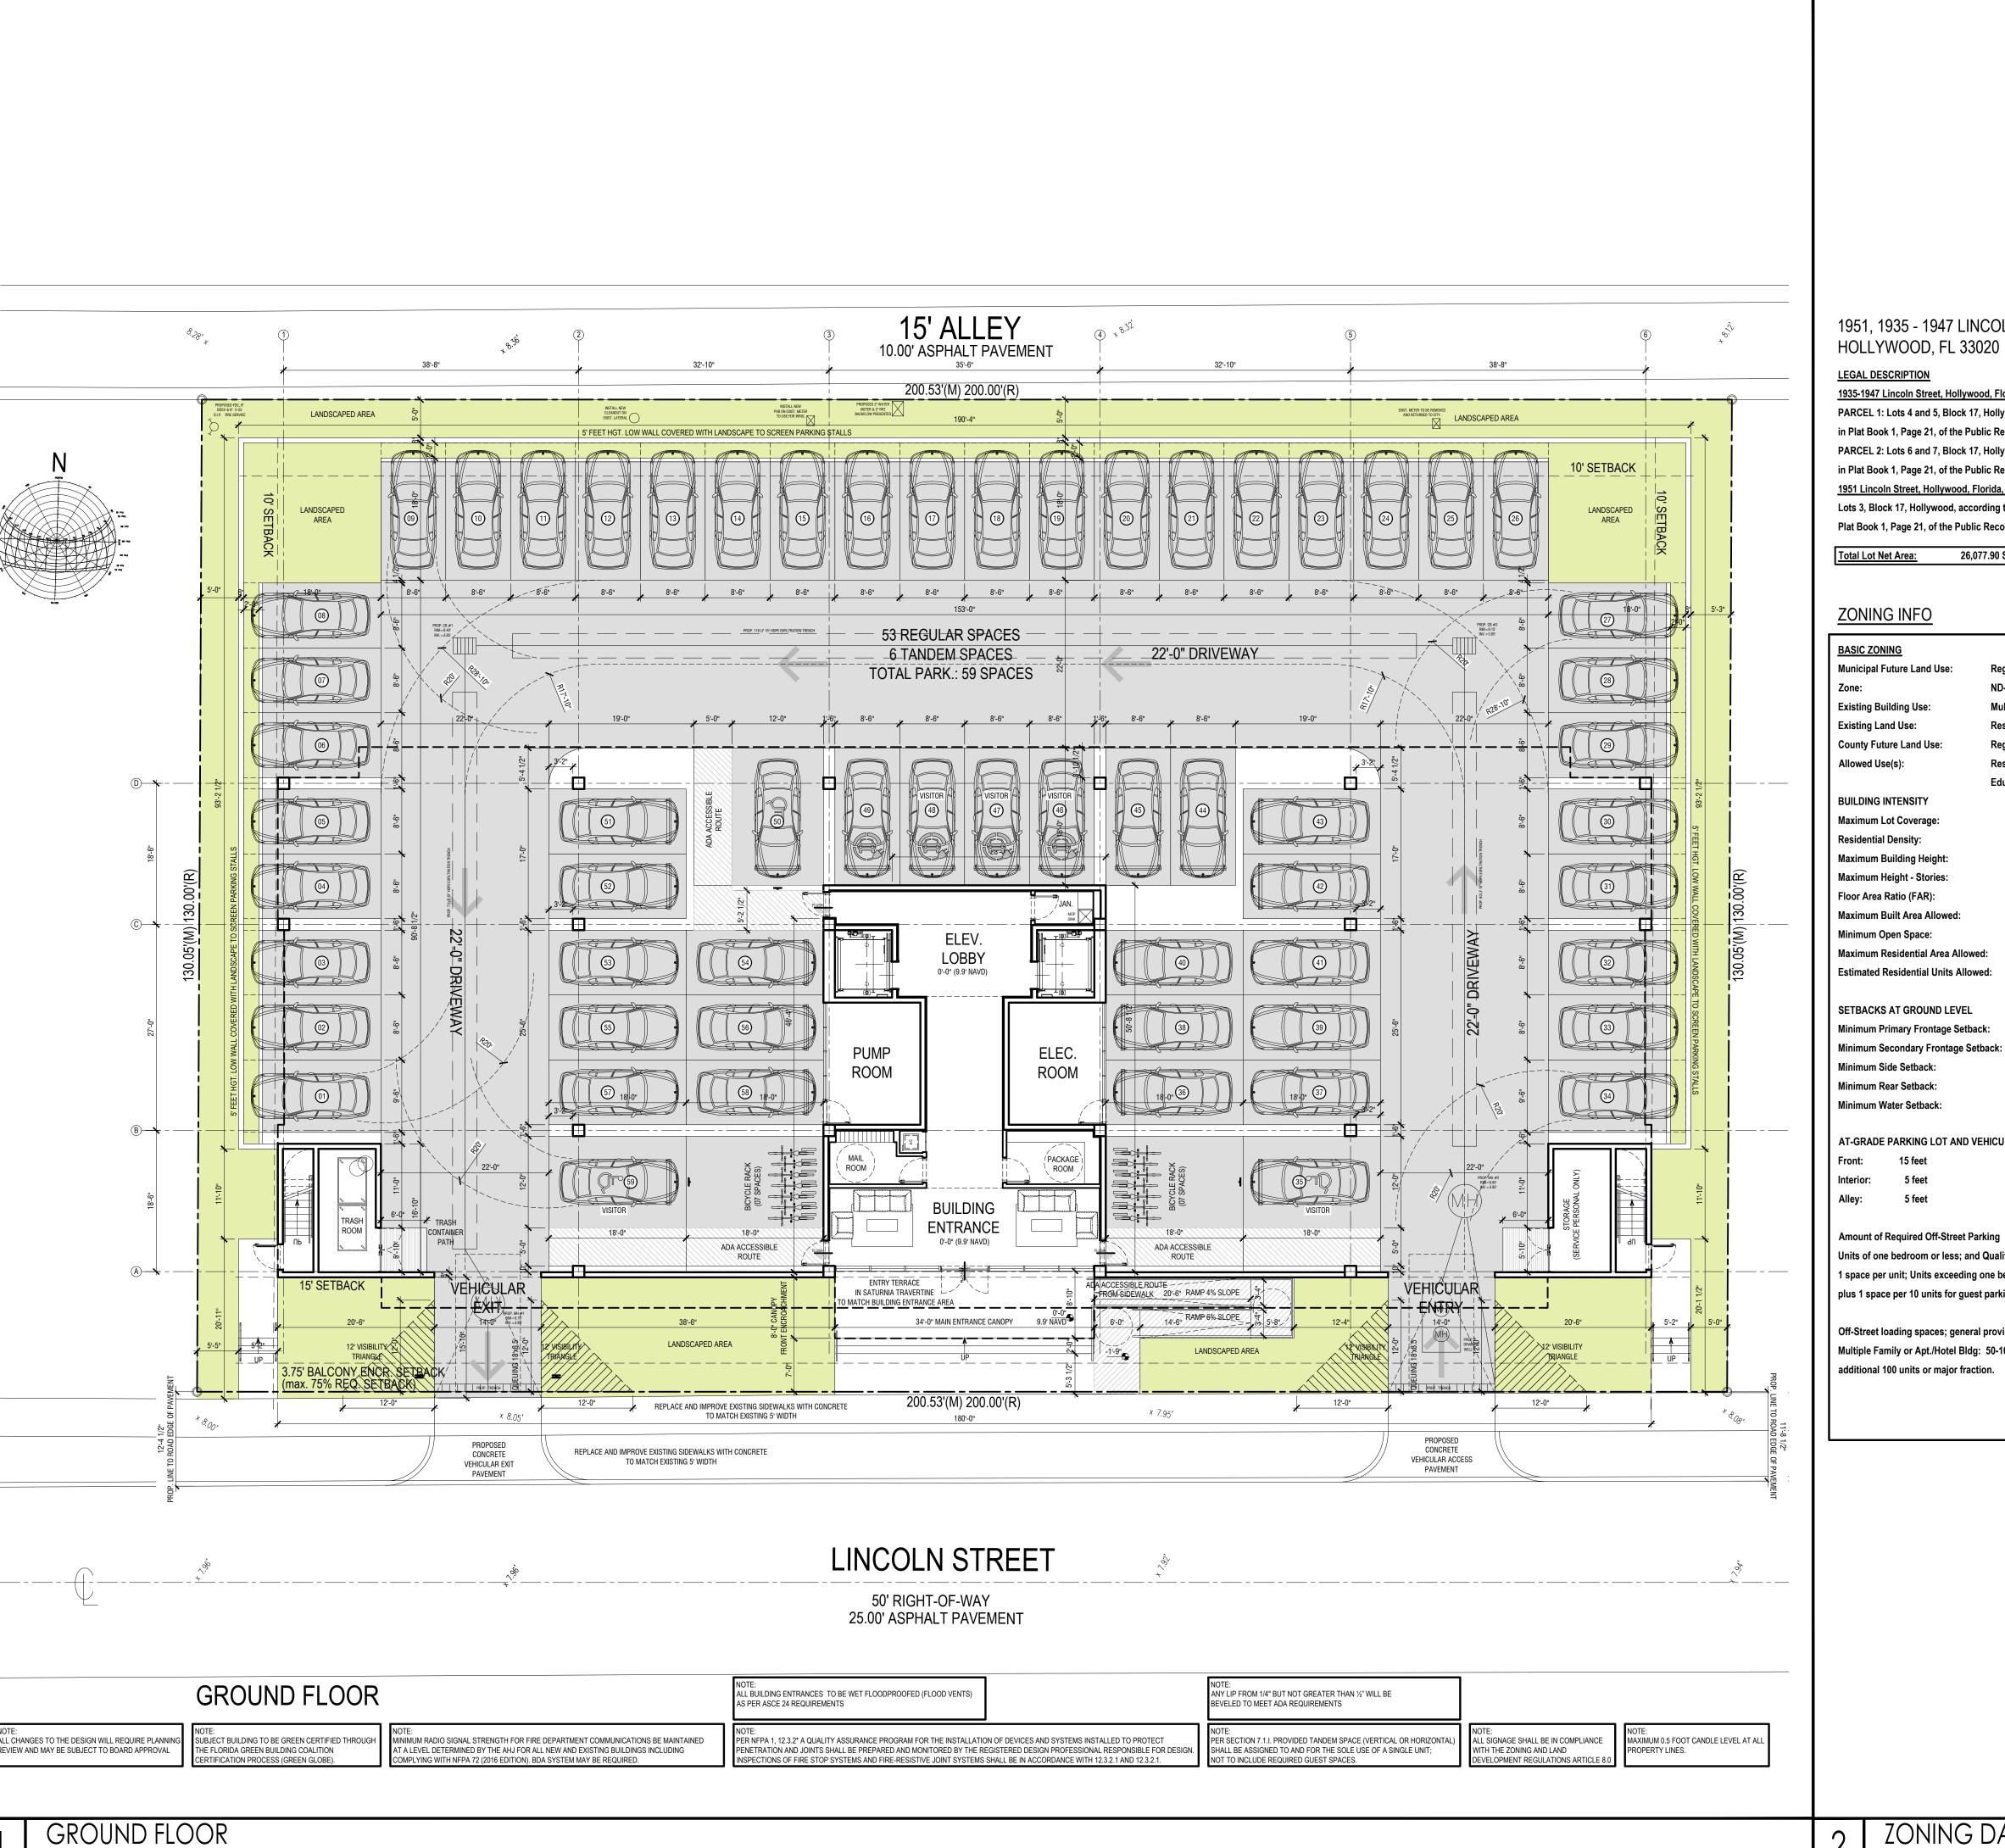1951, 1935 - 1947 LINCOLN ST.

1935-1947 Lincoln Street, Hollywood, Florida, 33139 (Parcel ID: 514215012750) PARCEL 1: Lots 4 and 5, Block 17, Hollywood, according to the Plat thereof, as recorded in Plat Book 1, Page 21, of the Public Records of Broward County, Florida. PARCEL 2: Lots 6 and 7, Block 17, Hollywood, according to the Plat thereof, as recorded in Plat Book 1, Page 21, of the Public Records of Broward County, Florida.

1951 Lincoln Street, Hollywood, Florida, 33139 (Parcel ID: 514215012720) Lots 3, Block 17, Hollywood, according to the Plat thereof, as recorded in Plat Book 1, Page 21, of the Public Records of Broward County, Florida.

26,077.90 SF (0.6 acres)

ZONING INFO		
BASIC ZONING		
Municipal Future Land Use:	Regio	nal Activity Center (RAC) Downtown District
Zone:	ND-2	
Existing Building Use:	Multi-	Family Dwellings (Generic, any combination 2
Existing Land Use:	Resid	ential
County Future Land Use:	Regio	nal Activity Center
Allowed Use(s):	Resid	ential, Lodging, Office, Commercial, Civic,
	Educa	itional, Industrial
BUILDING INTENSITY		
Maximum Lot Coverage:		N/A
Residential Density:		N/A
Maximum Building Height:		55 ft
Maximum Height - Stories:		5
Floor Area Ratio (FAR):		2.00
Maximum Built Area Allowed:		52,155.8 ft ²
Minimum Open Space:		20% (5,215 ft²)
Maximum Residential Area Allowed	:	52,155.8 ft ²
Estimated Residential Units Allowed	d:	Unlimited
SETBACKS AT GROUND LEVEL		
Minimum Primary Frontage Setback	c :	15.00 ft
Minimum Secondary Frontage Setba	ack:	N/A

Minimum Secondary Frontage Setback: N/A

AT-GRADE PARKING LOT AND VEHICULAR USE AREAS SETBACK REQUIREMENTS

Amount of Required Off-Street Parking

Units of one bedroom or less; and Qualifiable Affordable Housing Developments: 1 space per unit; Units exceeding one bedroom (including dens): 1.5 space per unit; plus 1 space per 10 units for guest parking

Off-Street loading spaces; general provisions Multiple Family or Apt./Hotel Bldg: 50-100 Units - 1 space + 1 space for each

PROJECT INFO

Maximum Building I	Height:	
Allowed:	55 ft	
Proposed:	55 ft	
Floor Area Ratio (FA	AR) 2.00:	
Floor Area Ratio (FA Allowed:	AR) 2.00:	52,155.80 ft² (2.00)

Gross Building Area: 55,366.38 ft²

Leasable / Salable Area: 41,443.24 ft²

Open Space (pervious): 20% (5,215 ft²) 5,708.37 ft² Ground: Roof Terrace: 1,117.31 ft²

26.18% (6,825.68 ft²)

Required Landscaping (pervious) of Paved Vehicular Use Area: Total VUA Area: 8,346.9 ft² (100%)

TOTAL:

25% (2,086.73 ft²) Proposed: 25.3% (2,111.76 ft²) Front Setback: 15'-0" Minimum: 15'-0"

Rear Setback: 10'-0" Proposed: Side Setback:

Parking Requirement: One Bed Unit (36un x 1): 36 spaces

Two Bed Unit (12un x 1.5): 18 spaces Visitors (48un / 10): 05 spaces Total Parking Required: 59 spaces **Total Parking Proposed:** 59 spaces (inc. 06 Tandem & 03 Handicap)

Accesible Parking spaces: 03 spaces 03 spaces Off-Street loading spaces: 0 space

0 space

UNIT MIX UNIT TYPE QUANTITY PERCENTAGE
 TYPE B
 08
 16.6%

 TYPE C
 06
 12.5%

 TYPE D
 04
 8.4%

Proposed:

TOTAL 100%

UNIT SIZE UNIT TYPE | ROOMS | A/C AREA | NON A/C AREA | TOTAL AREA
 TYPE A
 01
 652.16 SF
 86.71 SF
 738.87 SF

 TYPE B
 02
 1,061.08 SF
 100.75 SF
 1,161.83 SF

 TYPE C
 01
 791.86 SF
 130.07 SF
 921.93 SF

 TYPE D
 02
 978.24 SF
 130.07 SF
 1,108.31 SF

UNIT SIZE CUMULATIVE AVERAGE

863.03 SF

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JOSEPH B. KALLER

FLORIDA R.A. # 0009239

B

PT

STREET

LINCOL

SCHEMATIC DESIGN F GROUND FLOOR ZONING DATA

MEETING DATES

EP&D BOARD | T.B.D | FILE# 22-DP-60

COMMITE

PRE TAC

FINAL TAC

DATE DESCRIPTION

09/06/22 | FILE# 22-DP-60

11/07/22 FILE# 22-DP-60

12/19/22 FILE# 22-DP-60

PROJECT No.: 09.21.22

DRAWN BY:

CHECKED BY:

SCHIFFINO

SHEET

ZONING DATA



[/// CLEARANCE 10'0" \ \ \] __6" LETTERS

NAME SIZE = 6.75 S.F.

NAME SIZE = 14.06 S.F.


ALL SIGNAGE TO BE LED BACK LIT PIN MOUNTED CHANNEL LETTERS


ALL SIGNAGE TO COMPLY WITH THE REQUIREMENTS OF THE CITY OF HOLLYWOOD ZONING AND LAND DEVELOPMENT CODE BASED ON THE FH-2 & PS-2 ZONING DISTRICTS.


NOTE: A SEPARATE SIGN PERMIT IS REQUIRED FOR EACH SIGN.

A SEPARATE ELECTRICAL PERMIT IS REQUIRED FOR SIGNS REQUIRING ILLUMINATION.

SIGNAGE

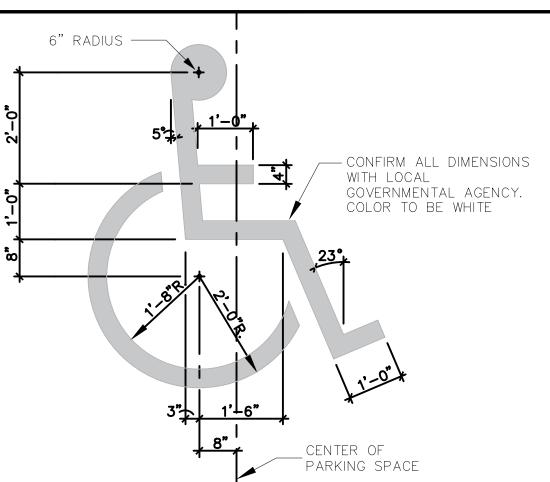

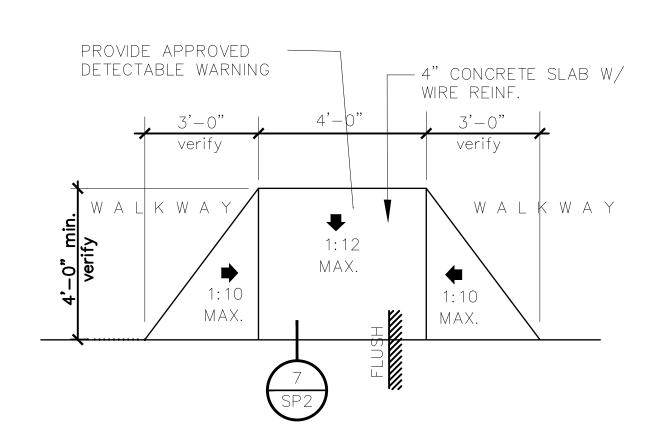


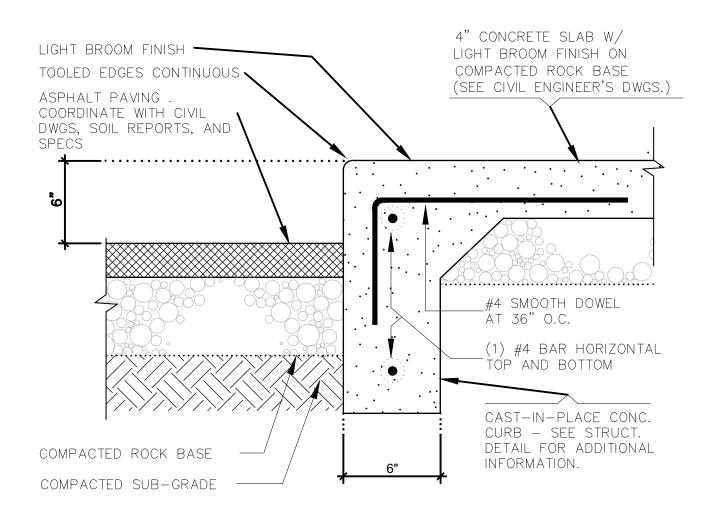


PAINTED H.C. SPACE SYMBOL

ACCESSIBLE CURB CUT DETAIL

TYP. CONCRETE CURB

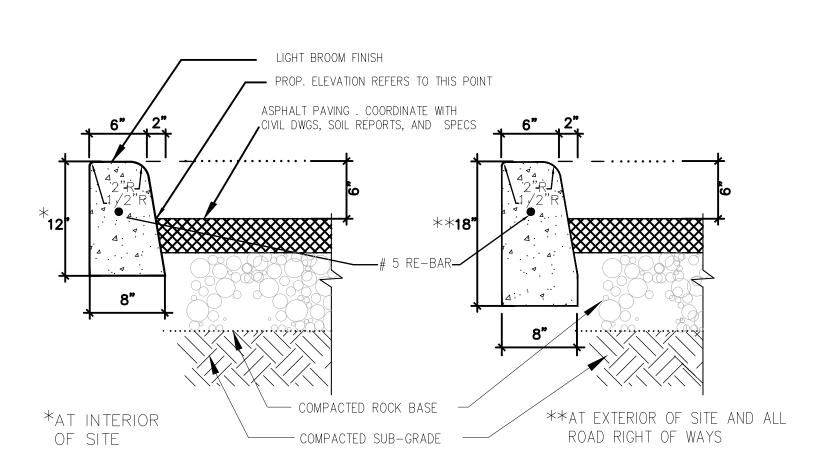


TYP. TYPE D CONCRETE CURB

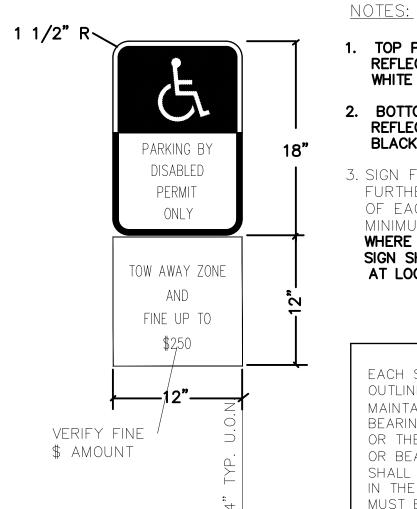

1. TOP PORTION OF SIGN SHALL HAVE A REFLECTORIZED BLUE BACKGROUND WITH WHITE REFLECTORIZED LEGEND AND BORDER. 2. BOTTOM PORTION OF SIGN SHALL HAVE A REFLECTORIZED WHITE BACKGROUND WITH BLACK OPAQUE LEGEND AND BORDER. 3. SIGN FACE SHOULD BE LOCATED NO FURTHER THAN 6' FROM THE FRONT OF EACH PARKING SPACE WITH A MINIMUM 3'-0" CLEAR IF MOUNTED ON POST. WHERE SIGN IS MOUNTED ON BLDG, SIGN SHALL BE MOUNTED ON BUILDING WALL AT LOCATIONS DEPICTED ON SITE PLAN.

EACH SUCH PARKING SPACE SHALL BE CONSPICUOUSLY OUTLINED IN BLUE PAINT, AND SHALL BE POSTED AND MAINTAINED WITH A PERMANENT, ABOVE-GRADE SIGN BEARING THE INTERNATIONAL SYMBOL OF ACCESSIBILITY OR THE CAPTION "PARKING BY DISABLED PERMIT ONLY" OR BEARING BOTH SYMBOL AND CAPTION. SUCH SYMBOL SHALL NOT BE OBSCURED BY A VEHICLE PARKED IN THE SPACE. ALL HANDICAPPED PARKING SPACES MUST BE SIGNED AND MARKED IN ACCORDANCE WITH THE GOVERNING AGENCY.

HANDICAPPED SIGNAGE DETAIL

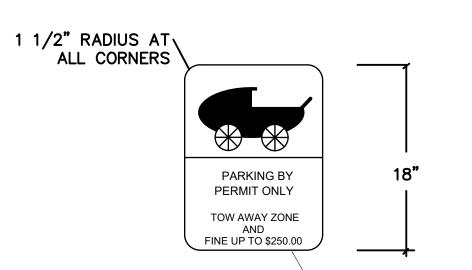

1/4" MAX.

CONTROL JOINT

at unreinforced slab

EXPANSION JOINT at unreinforced slab

TYP. CONC. SLAB JOINTS

VERIFY FINE \$\$ AMOUNT

PROVIDE TRAFFIC

SEALANT TO FLUSH

WITH SURFACE - -

MATCH COLOR TO

PROVIDE TRAFFIC

WITH SURFACE -MATCH COLOR TO

CONCRETE ---

SEALANT TO FLUSH

CONCRETE

ALL PROPERTY OWNERS WHO ARE REQUIRED BY THIS SECTION TO PROVIDE PARKING SPACES FOR PERSONS TRANSPORTING YOUNG CHILDREN AND STROLLERS SHALL PROVIDE WITHIN TWO YEARS FROM THE EFFECTIVE DATE OF THE ORDINANCE FROM WHICH THIS SECTION DERIVES (ORDINANCE NO. 94-104). IN NO EVENT SHALL THE NUMBER OF PARKING SPACES FOR THE PHYSICALLY HANDICAPPED AND/OR DISABLED BE REDUCED BELOW THE QUANTITY REQUIRED BY THE SOUTH FLORIDA BUILDING CODE. SEE SITE PLAN FOR LOCATIONS.

BABY STROLLER PARKING SIGN

— SAW CUT EDGE

CONCRETE SLAB

- VERIFY W/ ARCHITECTURAL

PROVIDE BACK-UP ROD AND

_CONCRETE SLAB _ VERIFY W/ ARCHITECTURAL

-1/2" PREMOLDED EXPANSION MATERIAL W/ BACKER ROD


AND STRUCTURAL DWGS.

AND STRUCTURAL DWGS.



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FLORIDA R.A. # 0009239 BLD(

STREET

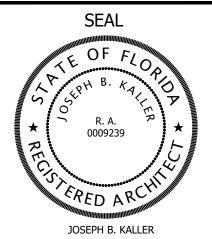
LINCOLN

MEETING DATES DATE DESCRIPTION COMMITE 09/06/22 | FILE# 22-DP-60 PRE TAC 11/07/22 | FILE# 22-DP-60 12/19/22 FILE# 22-DP-60 FINAL TAC EP&D BOARD | T.B.D | FILE# 22-DP-60

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PROJECT No.: DRAWN BY: SCHIFFINO

CHECKED BY:

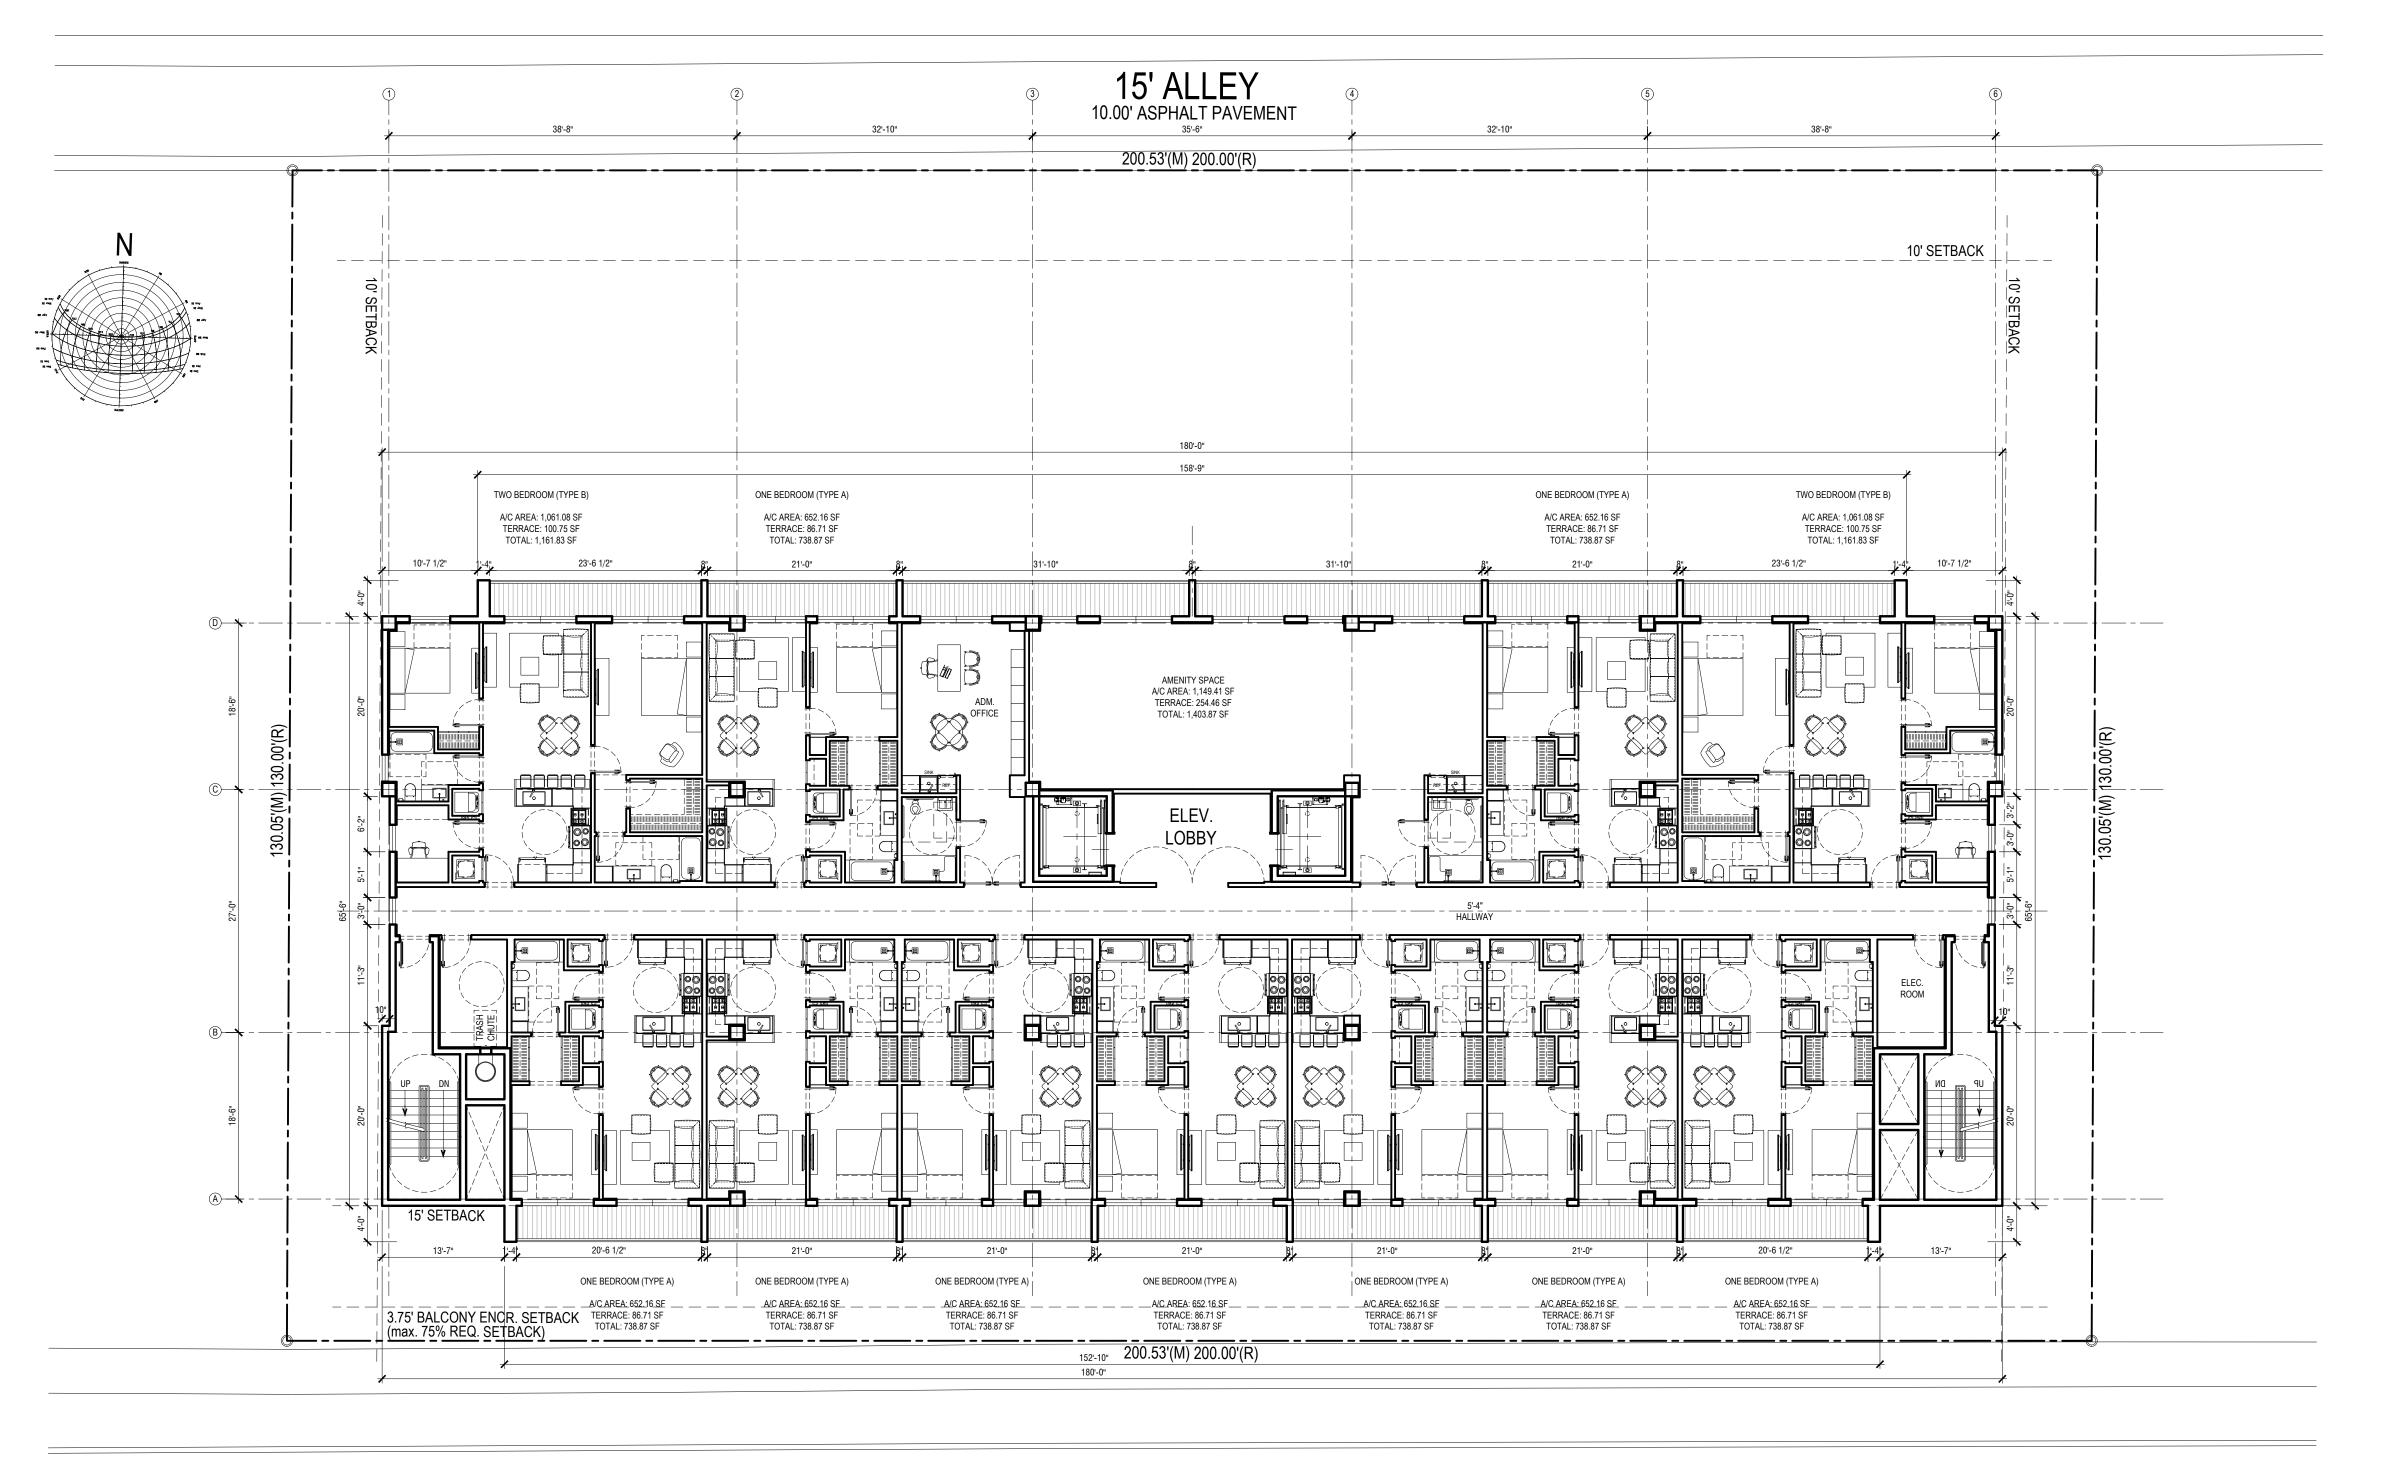

LINCOLN STREET

50' RIGHT-OF-WAY 25.00' ASPHALT PAVEMENT

11/07/22 FILE# 22-DP-60 FINAL TAC 12/19/22 FILE# 22-DP-60 EP&D BOARD | T.B.D | FILE# 22-DP-60

MEETING DATES

Kaller Architecture

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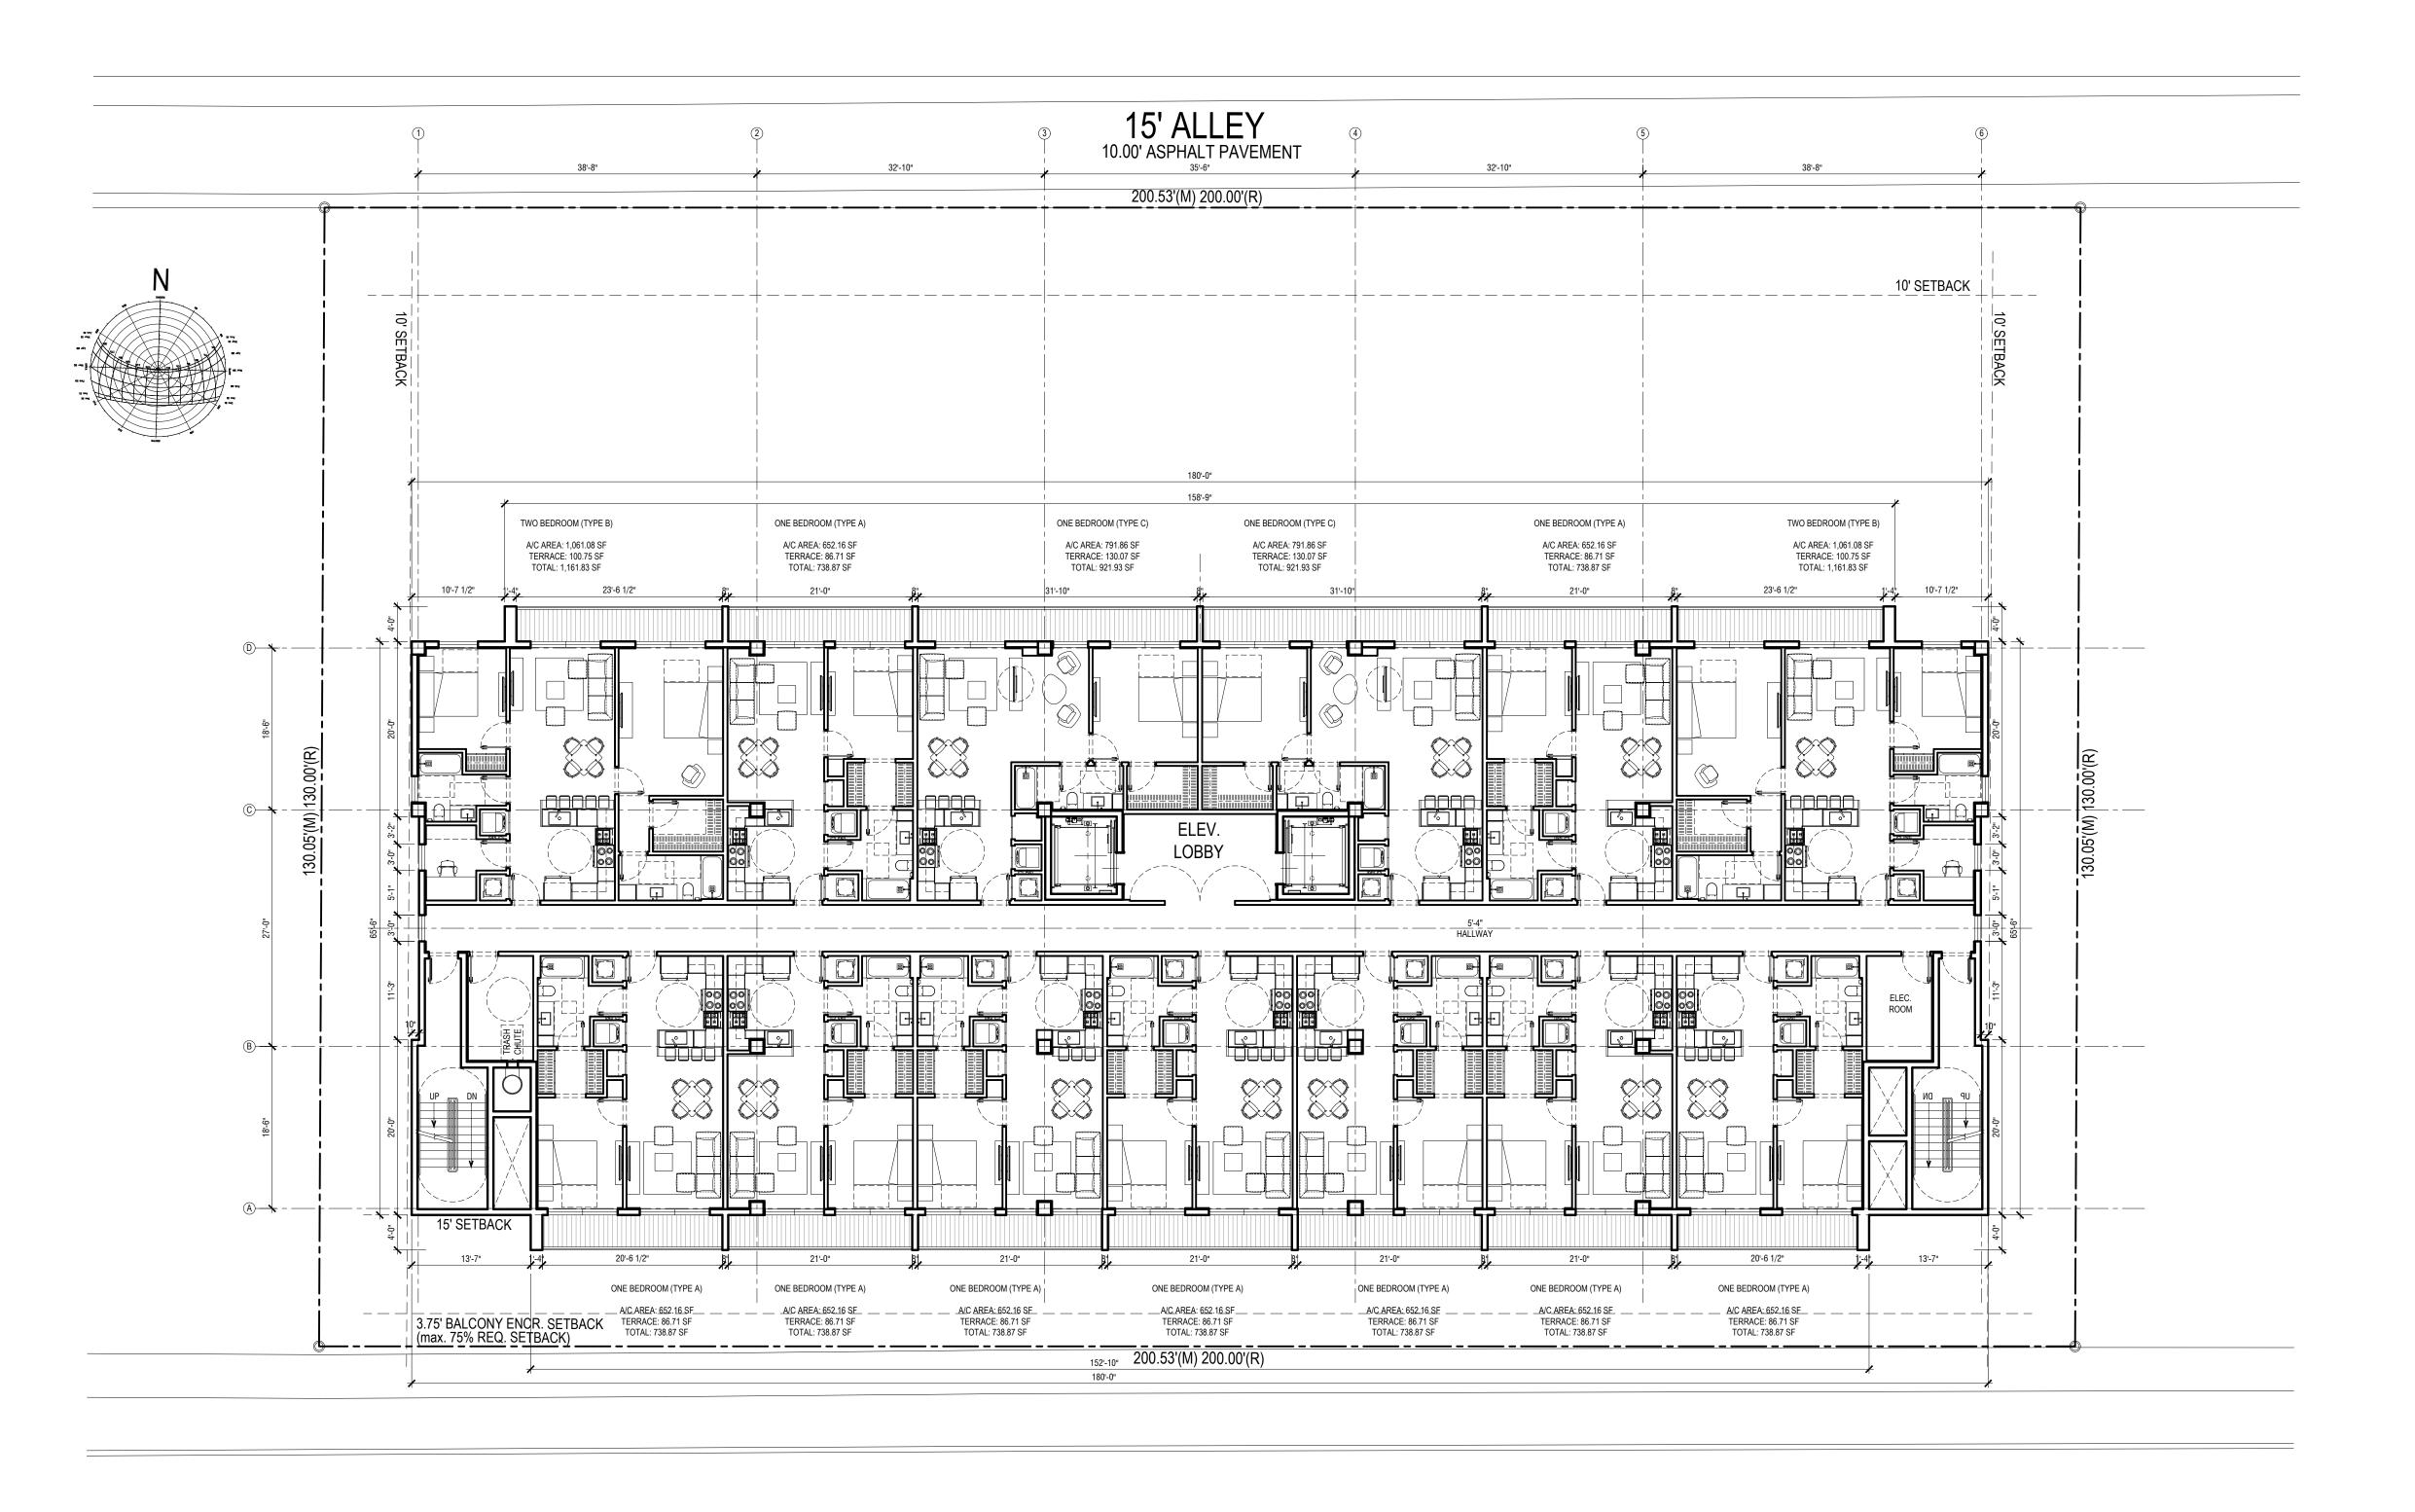
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DRAWN BY:

CHECKED BY: JBK

SECOND FLOOR

SECOND FLOOR



LINCOLN STREET


50' RIGHT-OF-WAY 25.00' ASPHALT PAVEMENT

3rd & 4th. FLOOR

y to produce the intended results.

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JOSEPH B. KALLER FLORIDA R.A. # 0009239

ET APT. BLDG. --

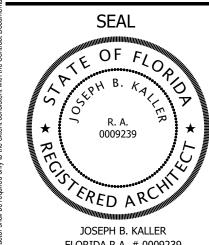INCOLN STREE

CHEMATIC DESIGN PACKAGE HIRD TO FOURTH FLOOR

MEETING DATES

BOARD/
COMMITE

DATE

DESCRIPTION

DESCRIPTION

DESCRIPTION

DESCRIPTION

DESCRIPTION

DESCRIPTION

DESCRIPTION

DESCRIPTION

FILE# 22-DP-60

FILE# 22-DP-60

T.B D - FILE# 22-DP-60

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PROJECT No.: 22042

DATE: 09.21.2


DRAWN BY: SCHIFF

CHECKED BY: JBK

SHEE

A-1.3

THIRD TO FOURTH FLOOR

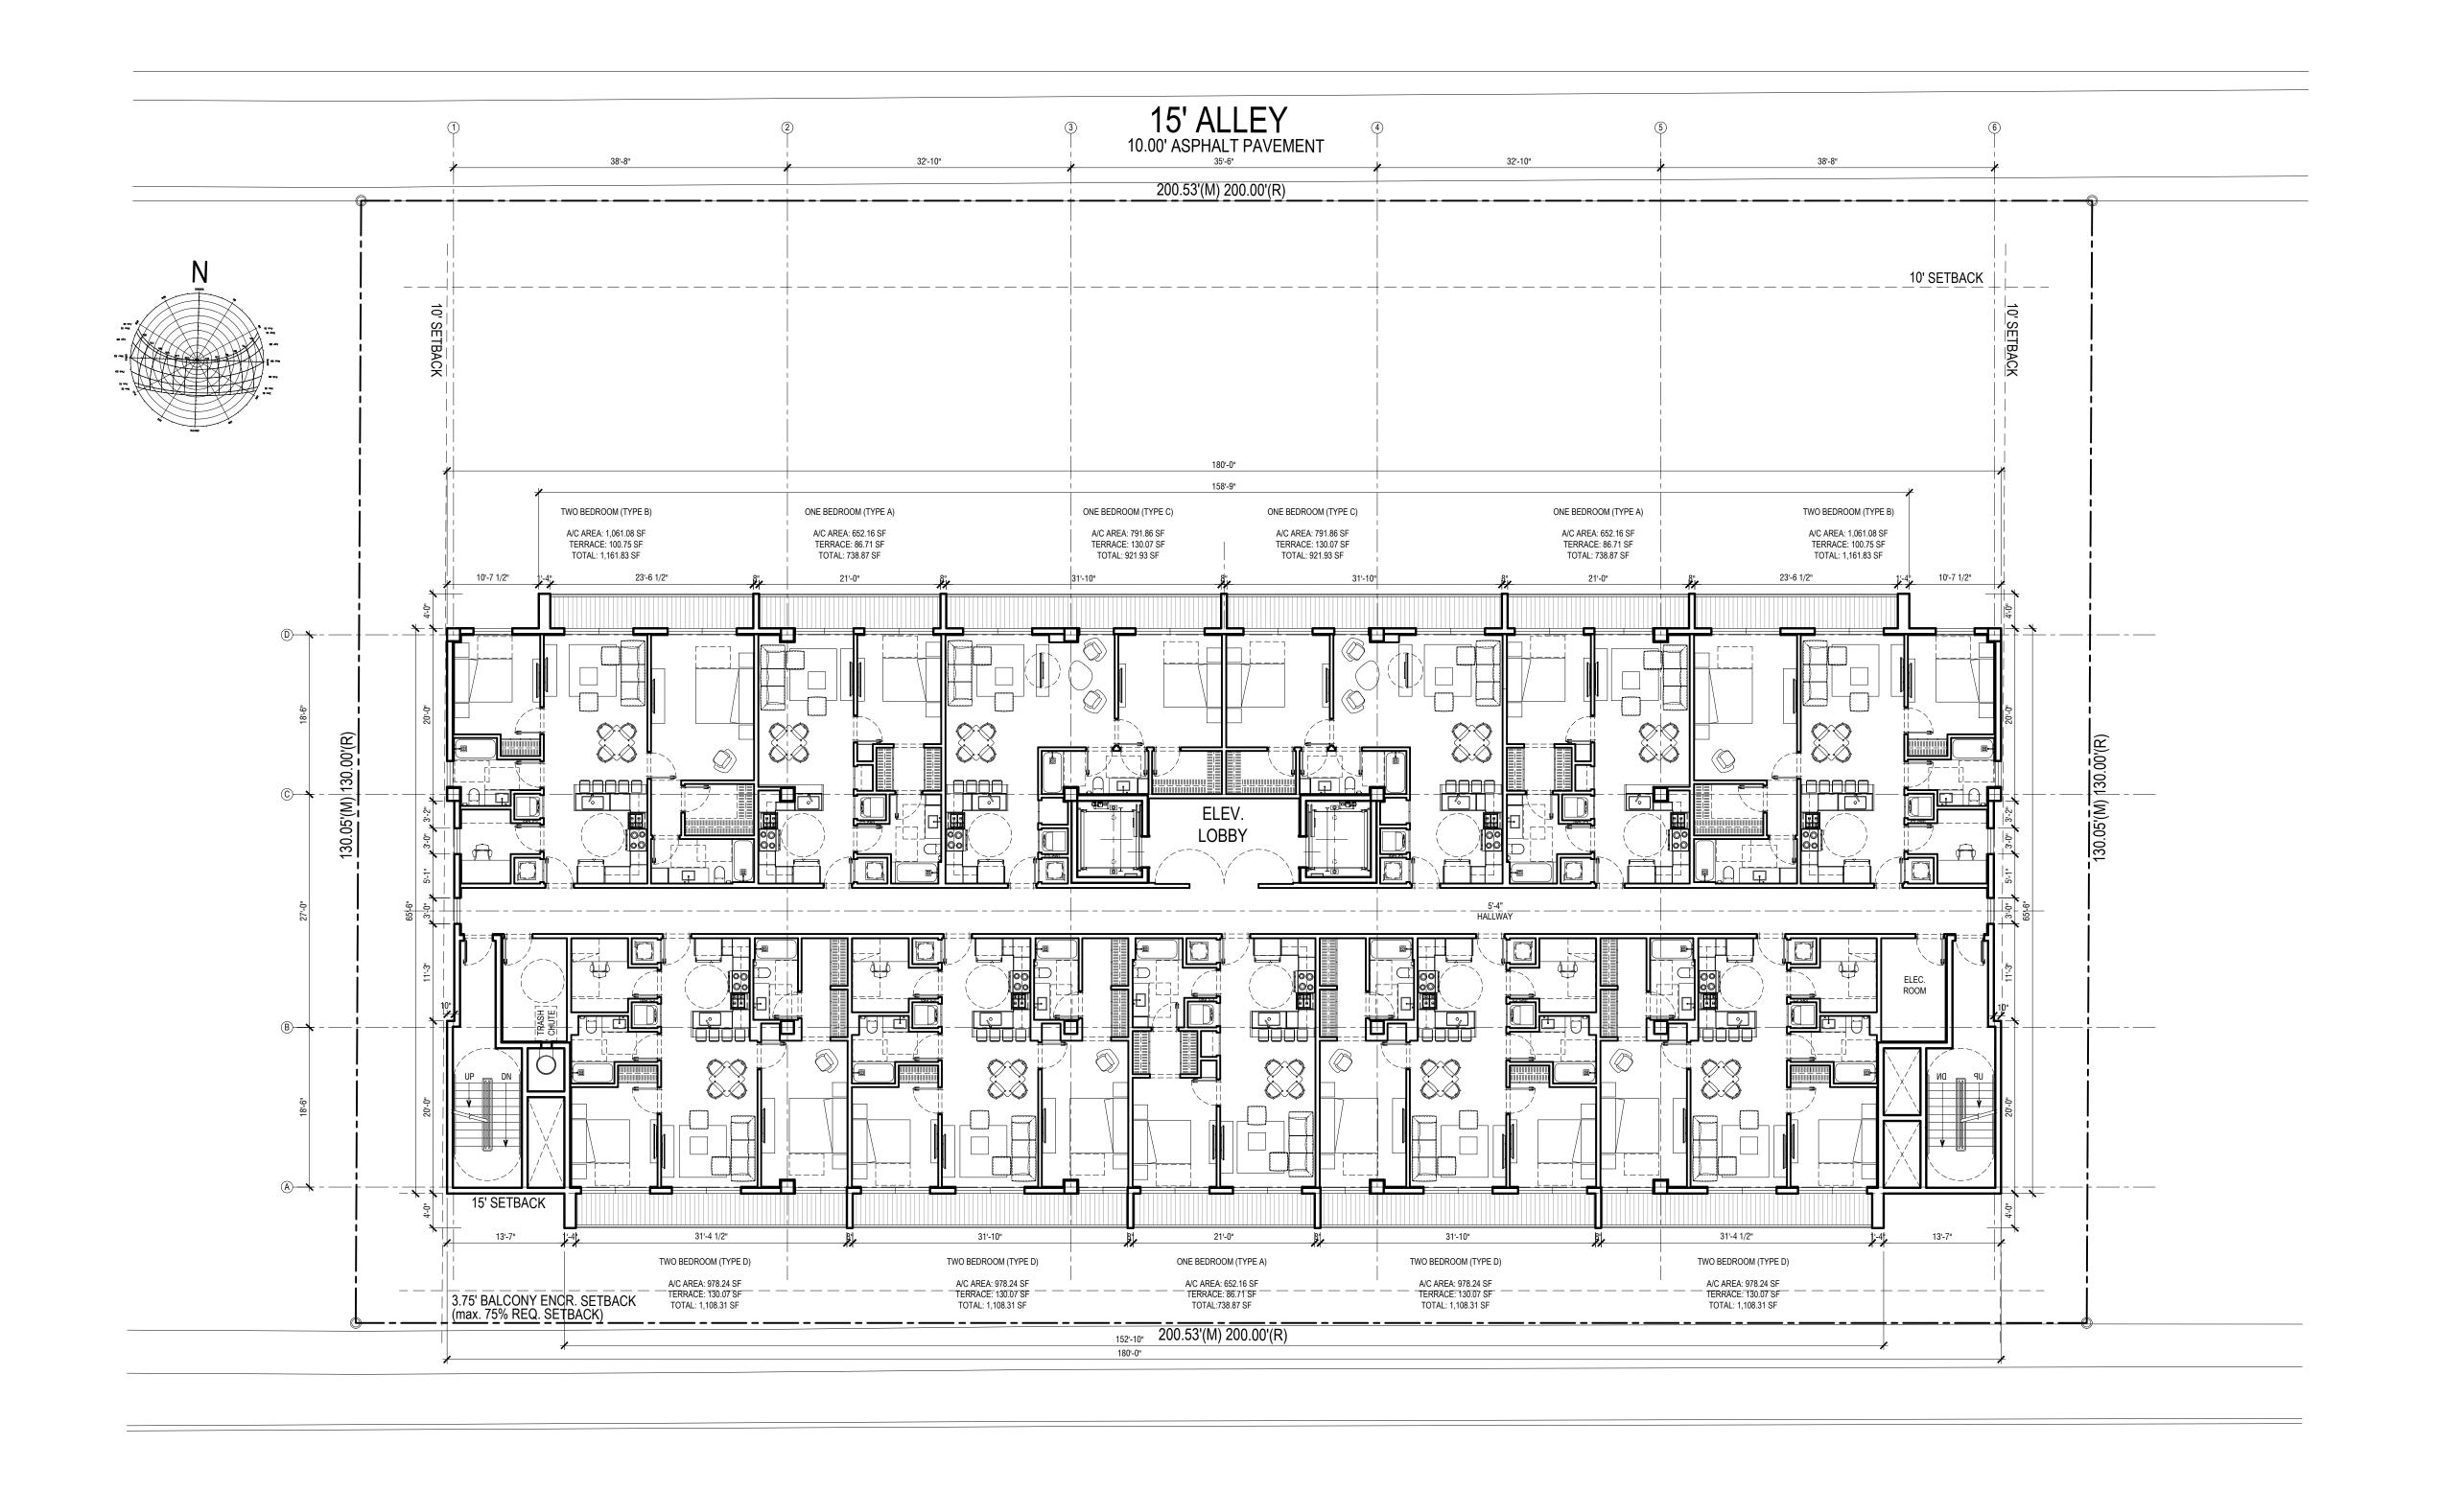


LINCOLN STREET

50' RIGHT-OF-WAY 25.00' ASPHALT PAVEMENT

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APT. BLDG.

COLN STREET AI

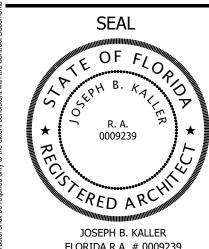EMATIC DESIGN PACKAGE H FLOOR

MEETING DATES

BOARD/
COMMITE
DATE
DESCRIPTION

09/06/22
FILE# 22-DP-60
11/07/22
FILE# 22-DP-60
12/19/22
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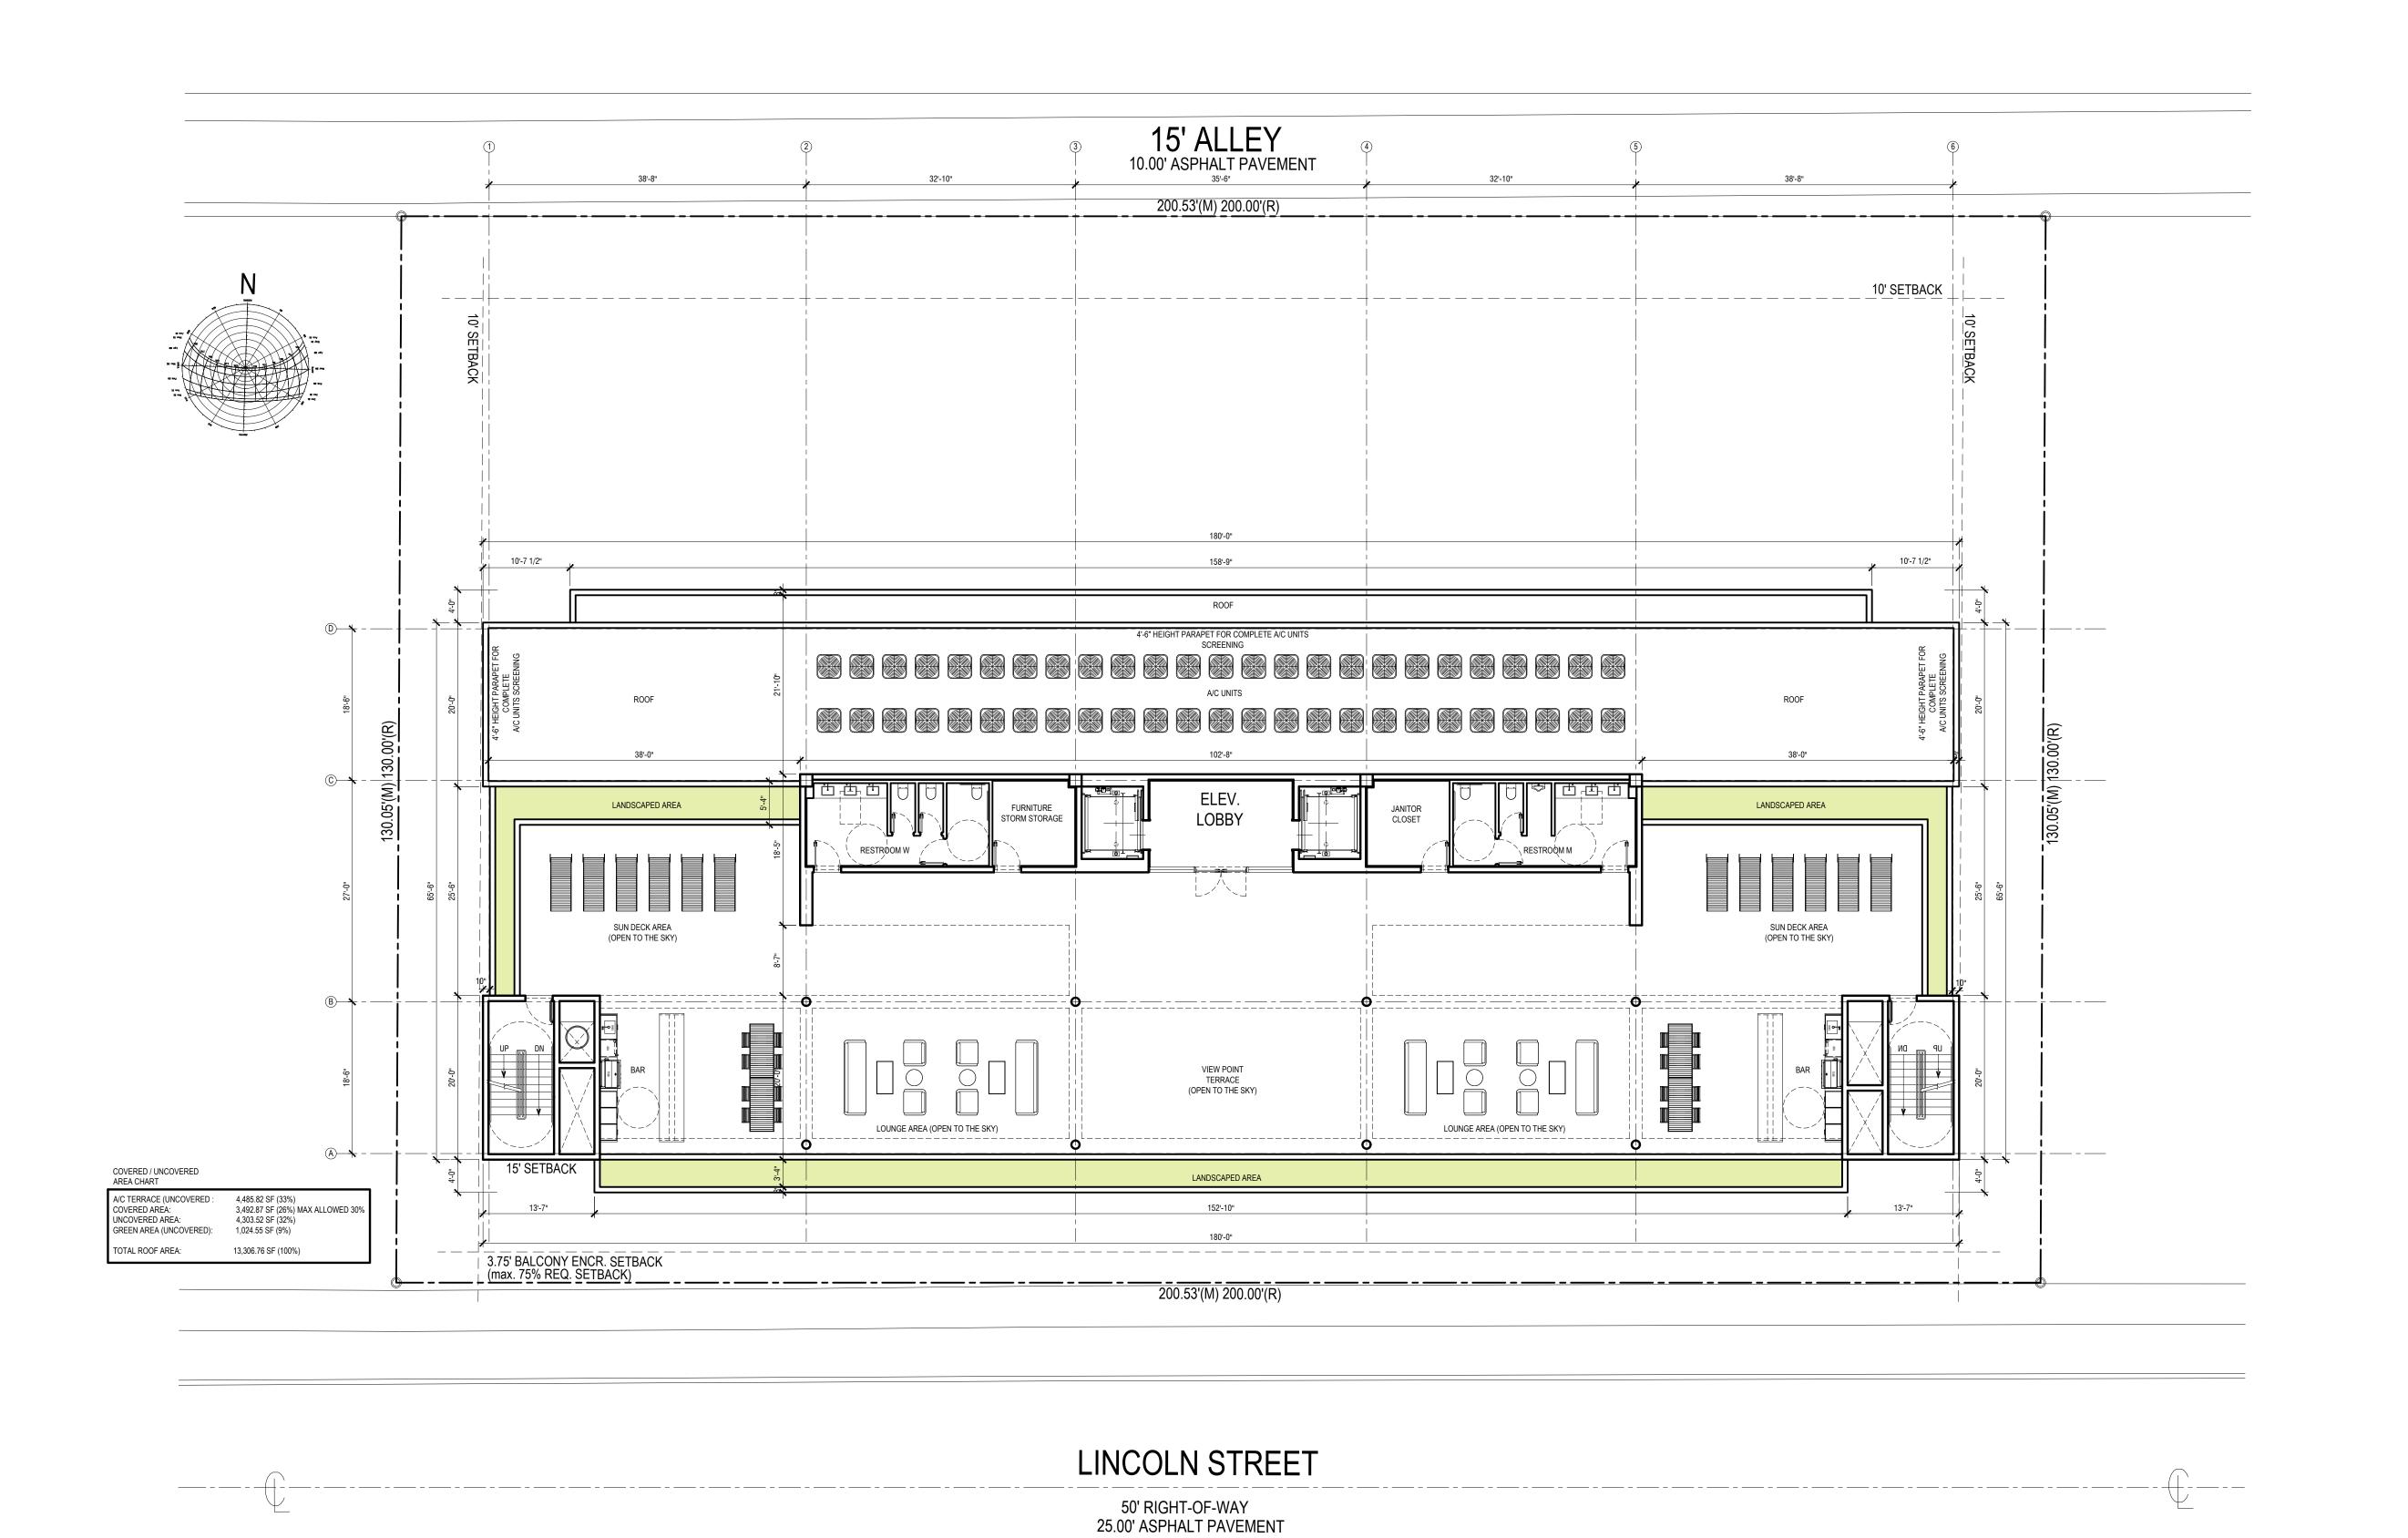
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CHECKED BY: JBK

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A-1.4


FIFTH FLOOR

FIFTH FLOOR



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APT. BLDG.

.N STREET APT. --

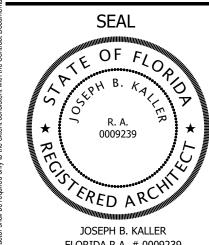I TNCO N S

CHEMATIC DESIGN PACKAGE
IXTH FLOOR - ROOF TERRACE

MEETING DATES

i I I L L	. 1 1110 L	DATES
BOARD/ COMMITE	DATE	DESCRIPTION
PACO	09/06/22	FILE# 22-DP-60
PRE TAC	11/07/22	FILE# 22-DP-60
FINAL TAC	12/19/22	FILE# 22-DP-60
EP&D BOARD	T.B.D	FILE# 22-DP-60

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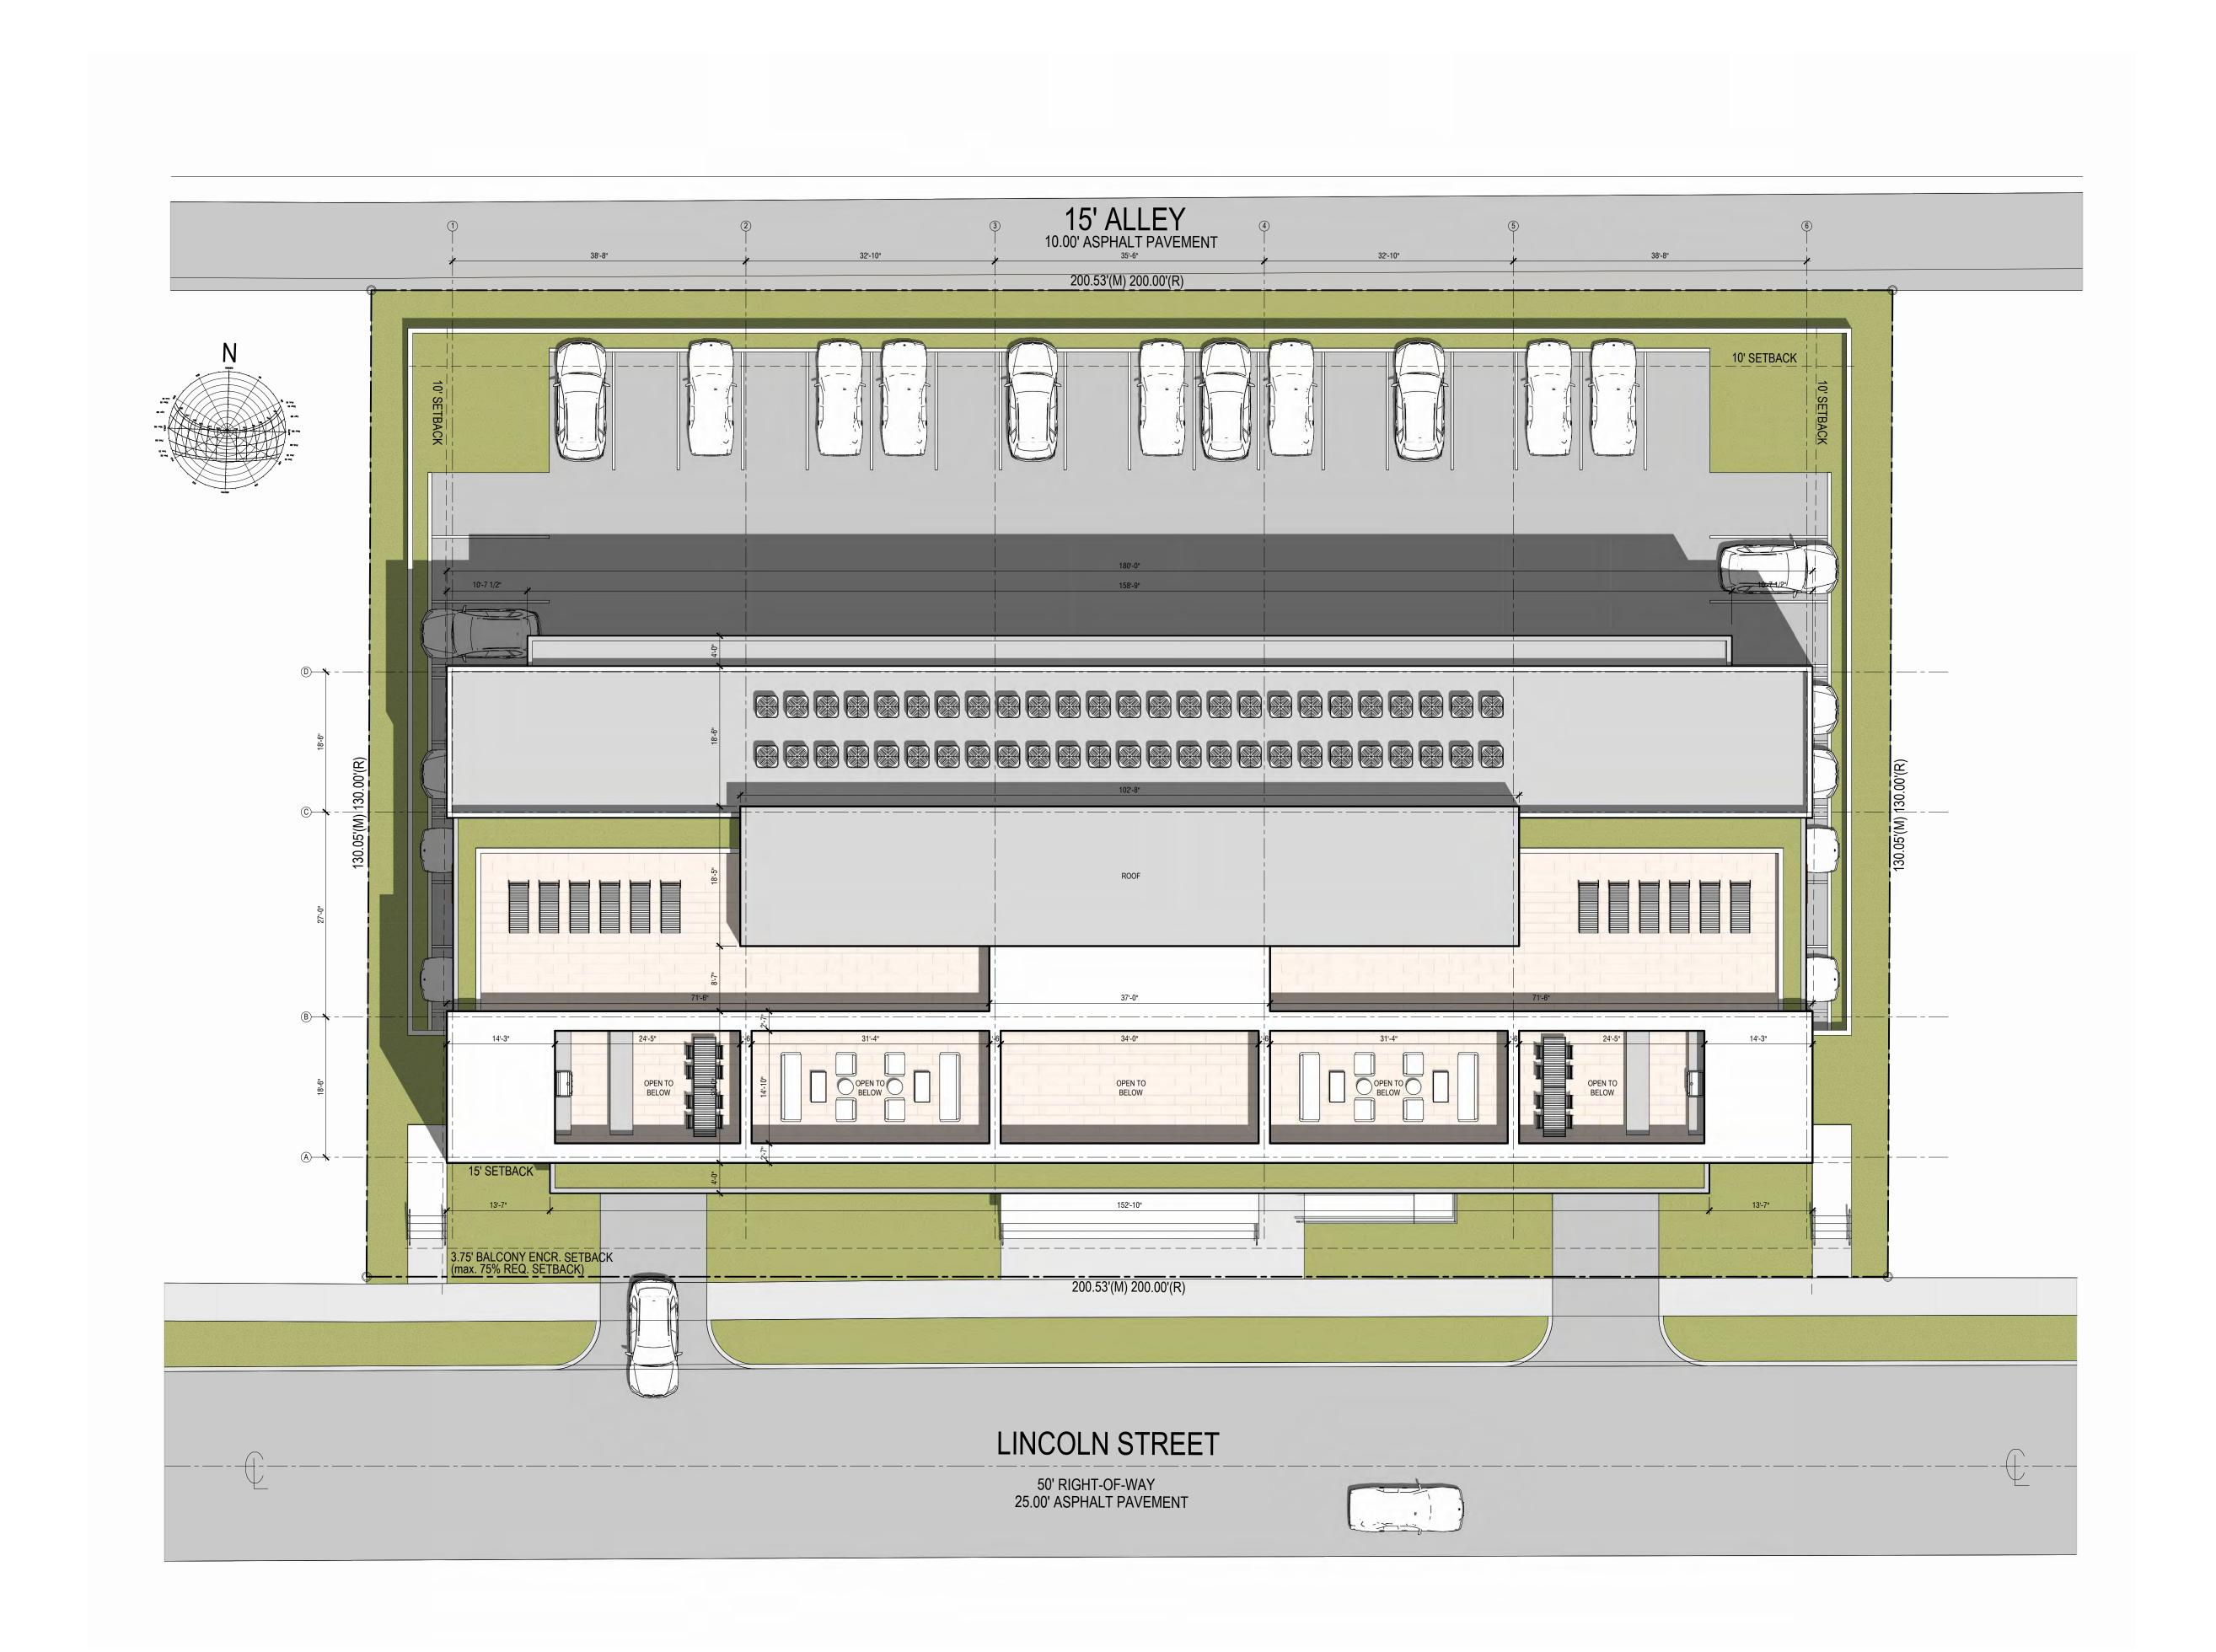
PROJECT No.: 22042

DATE: 09.21.2

DATE: 09.21.22
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SHEET

A-1.5





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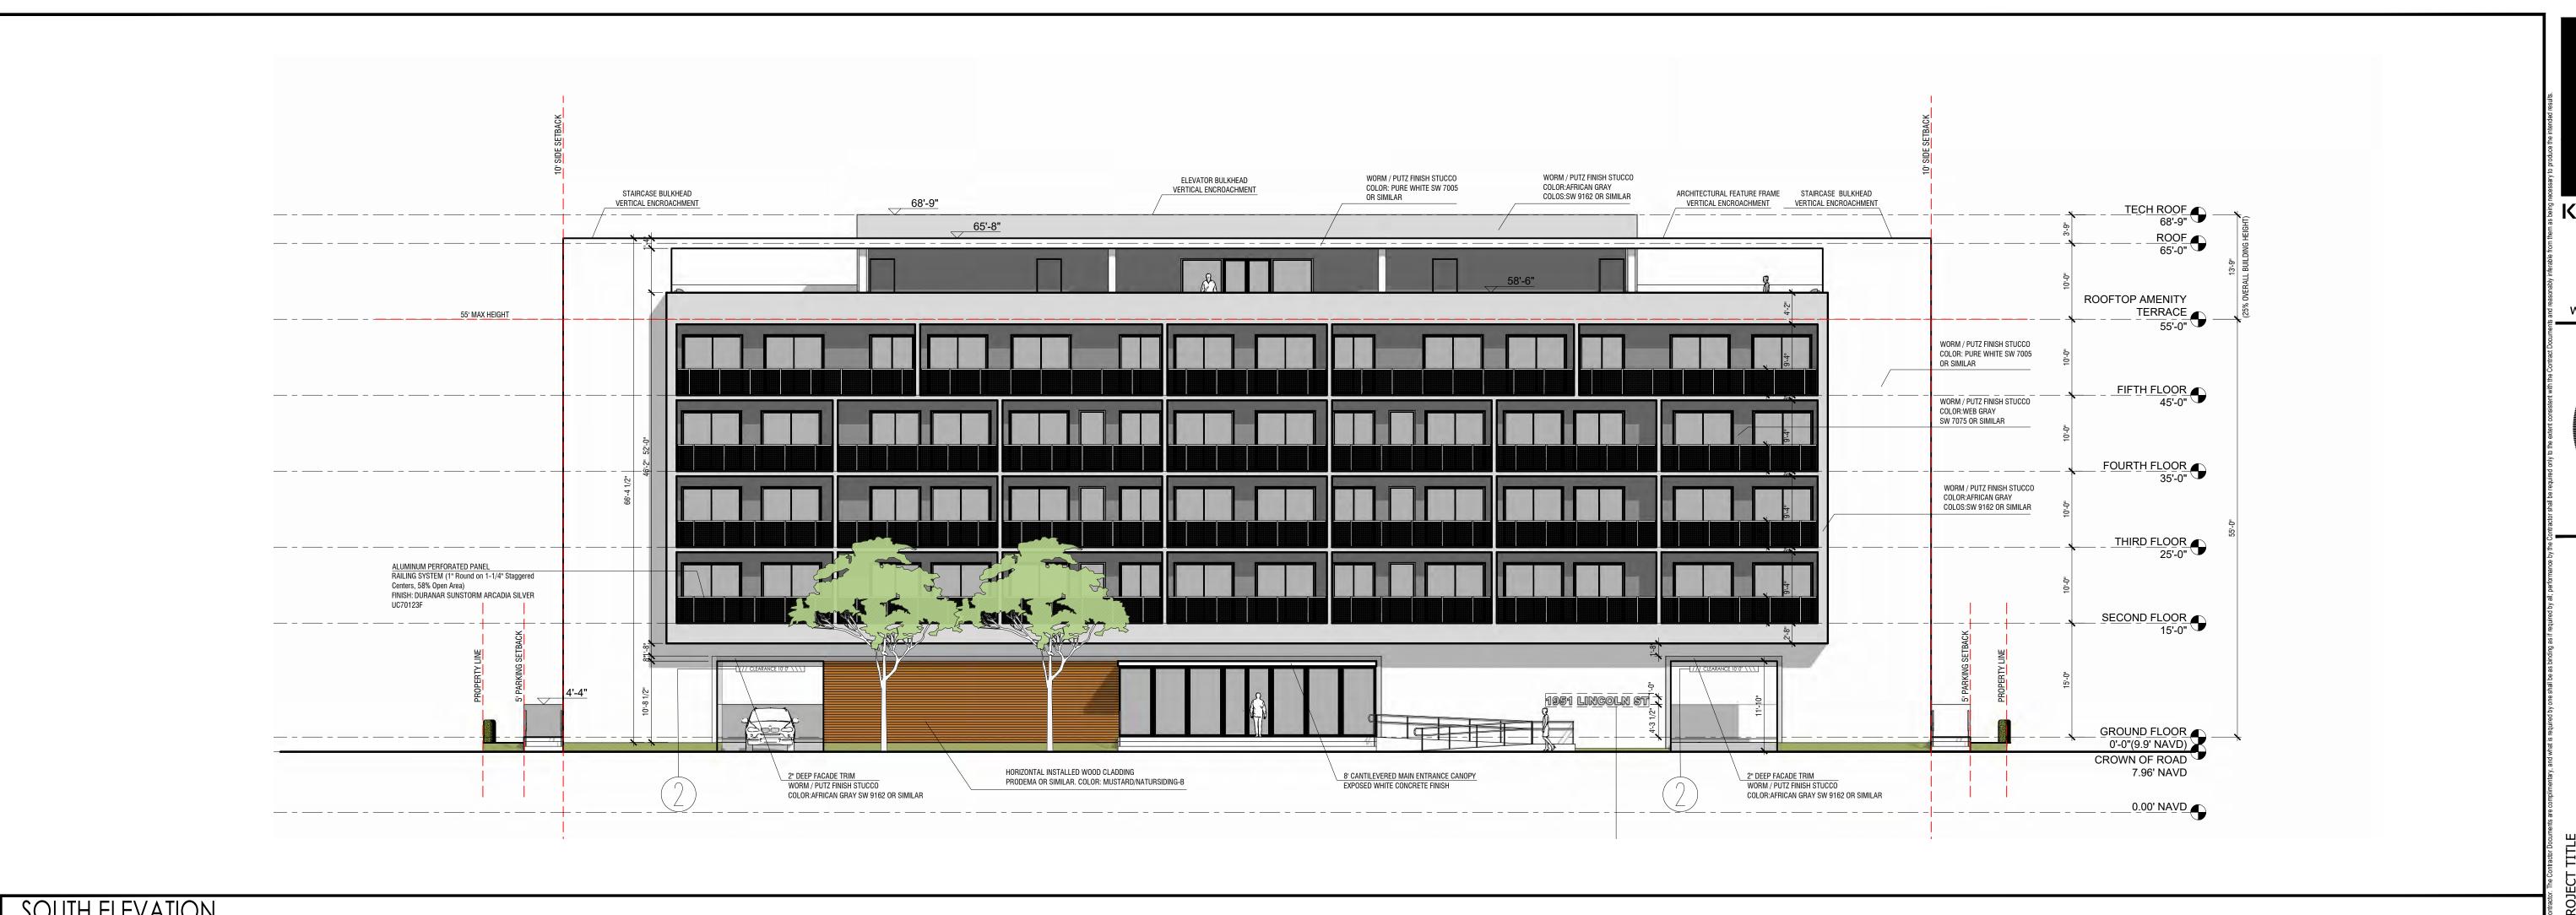
MEETING DATES

09/06/22 FILE# 22-DP-60 11/07/22 FILE# 22-DP-60 12/19/22 FILE# 22-DP-60 EP&D BOARD | T.B.D | FILE# 22-DP-60


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1 SOUTH ELEVATION
3/32"=1'-0"



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0009239

R. A.

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JOSEPH B. KALLER

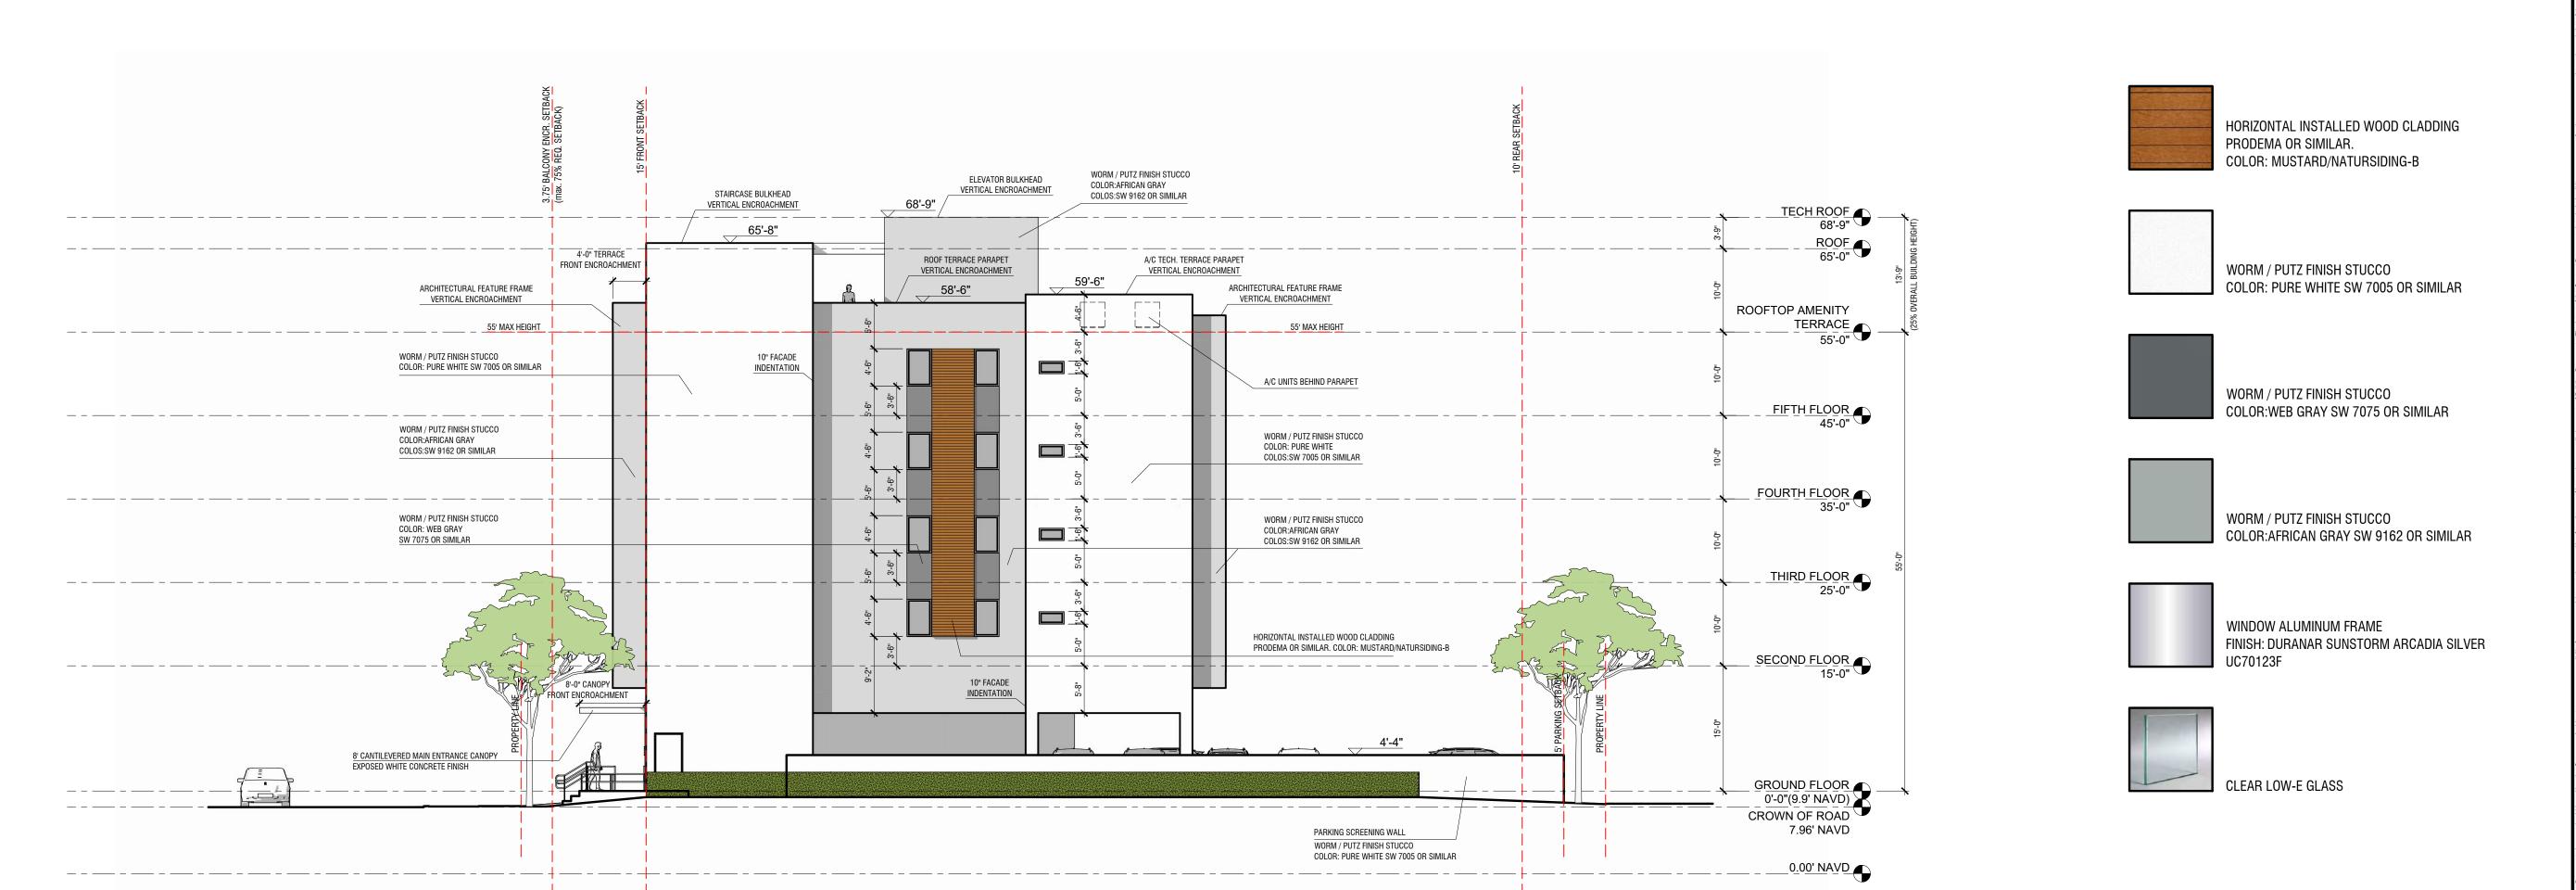JOSEPH B. KALLER FLORIDA R.A. # 0009239

STREET APT. BLDG

PROJECT TITLE

LINCOLN STF

SCHEMATIC DESIGN PACK/ ELEVATIONS

MEETING DATES

BOARD/COMMITE DATE DESCRIPTION

PACO 09/06/22 FILE# 22-DP-60
11/07/22 FILE# 22-DP-60
12/19/22 FILE# 22-DP-60
T.B.D FILE# 22-DP-60
FILE# 22-DP-60
T.B.D FILE# 22-DP-60

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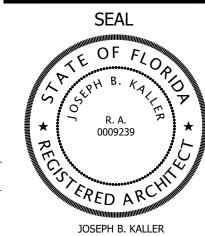
A-1.7



WORM / PUTZ FINISH STUCCO ELEVATOR BULKHEAD COLOR:AFRICAN GRAY COLOS:SW 9162 OR SIMILAR VERTICAL ENCROACHMENT STAIRCASE BULKHEAD 68'-9" VERTICAL ENCROACHMENT HORIZONTAL INSTALLED WOOD CLADDING 65'-8" PRODEMA OR SIMILAR. A/C TECH. TERRACE PARAPET COLOR: MUSTARD/NATURSIDING-B ROOF TERRACE PARAPET FRONT ENCROACHMENT VERTICAL ENCROACHMENT VERTICAL ENCROACHMENT ARCHITECTURAL FEATURE FRAME 59'-6" VERTICAL ENCROACHMENT ARCHITECTURAL FEATURE FRAME 58'-6" VERTICAL ENCROACHMENT ROOFTOP AMENITY TERRACE 55'-0" -----WORM / PUTZ FINISH STUCCO A/C UNITS BEHIND PARAPET COLOR:AFRICAN GRAY WORM / PUTZ FINISH STUCCO COLOS:SW 9162 OR SIMILAR INDENTATION COLOR: PURE WHITE SW 7005 OR SIMILAR WORM / PUTZ FINISH STUCCO COLOR: PURE WHITE SW 7005 OR SIMILAR FIFTH FLOOR 45'-0" WORM / PUTZ FINISH STUCCO COLOR: PURE WHITE SW 7005 OR SIMILAR WORM / PUTZ FINISH STUCCO COLOR: WEB GRAY SW 7075 OR SIMILAR _ FOURTH FLOOR WORM / PUTZ FINISH STUCCO COLOR:WEB GRAY SW 7075 OR SIMILAR WORM / PUTZ FINISH STUCCO COLOR:AFRICAN GRAY COLOS:SW 9162 OR SIMILAR THIRD FLOOR 25'-0" HORIZONTAL INSTALLED WOOD CLADDING PRODEMA OR SIMILAR. COLOR: MUSTARD/NATURSIDING-B WORM / PUTZ FINISH STUCCO W ... COLOR:AFRICAN GRAY SW 9162 OR SIMILAR SECOND FLOOR 15'-0" 10" FACADE INDENTATION WINDOW ALUMINUM FRAME 8' CANTILEVERED MAIN ENTRANCE CANOPY EXPOSED WHITE CONCRETE FINISH FINISH: DURANAR SUNSTORM ARCADIA SILVER GROUND FLOOR 0'-0"(9.9' NAVD) CROWN OF ROAD 7.96' NAVD PARKING SCREENING WALL WORM / PUTZ FINISH STUCCO COLOR: PURE WHITE SW 7005 OR SIMILAR 0.00' NAVD CLEAR LOW-E GLASS

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LINCOLN STREET APT.

SCHEMATIC DESIGN PACKAGE ELEVATIONS

меетing dates

BOARD/ COMMITE DESCRIPTION

PACO 09/06/22 FILE# 22-DP-60
11/07/22 FILE# 22-DP-60
12/19/22 FILE# 22-DP-60
T.B.D FILE# 22-DP-60
FILE# 22-DP-60
FILE# 22-DP-60

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PROJECT No.: 22042

PROJECT No.: 22042

DATE: 09.21.22

DRAWN BY: SCHIFFINO

CHECKED BY: JBK

SHEET

A-1.8

NORTH ELEVATION

3/32"=1'-0"



HOLLYWOOD, FL 33020









1931, 1927 LINCOLN ST. HOLLYWOOD, FL. 33020 1917 LINCOLN ST. HOLLYWOOD, FL. 33020

1911 LINCOLN ST. HOLLYWOOD, FL. 33020 1905 LINCOLN ST. HOLLYWOOD, FL. 33020

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SEAL

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R.A.

0009239

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RECS

RED ARCHIMAN

JOSEPH B. KALLER

JOSEPH B. KALLER FLORIDA R.A. # 0009239

TREET APT, BLDC --YWOOD, FL. 33020

LINCOLN ST

SCHEMATIC DESIGN PACKAGE STREET PROFILE

MEETING DATES

BOARD/
COMMITE

DATE

DESCRIPTION

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PROJECT No.: 22042

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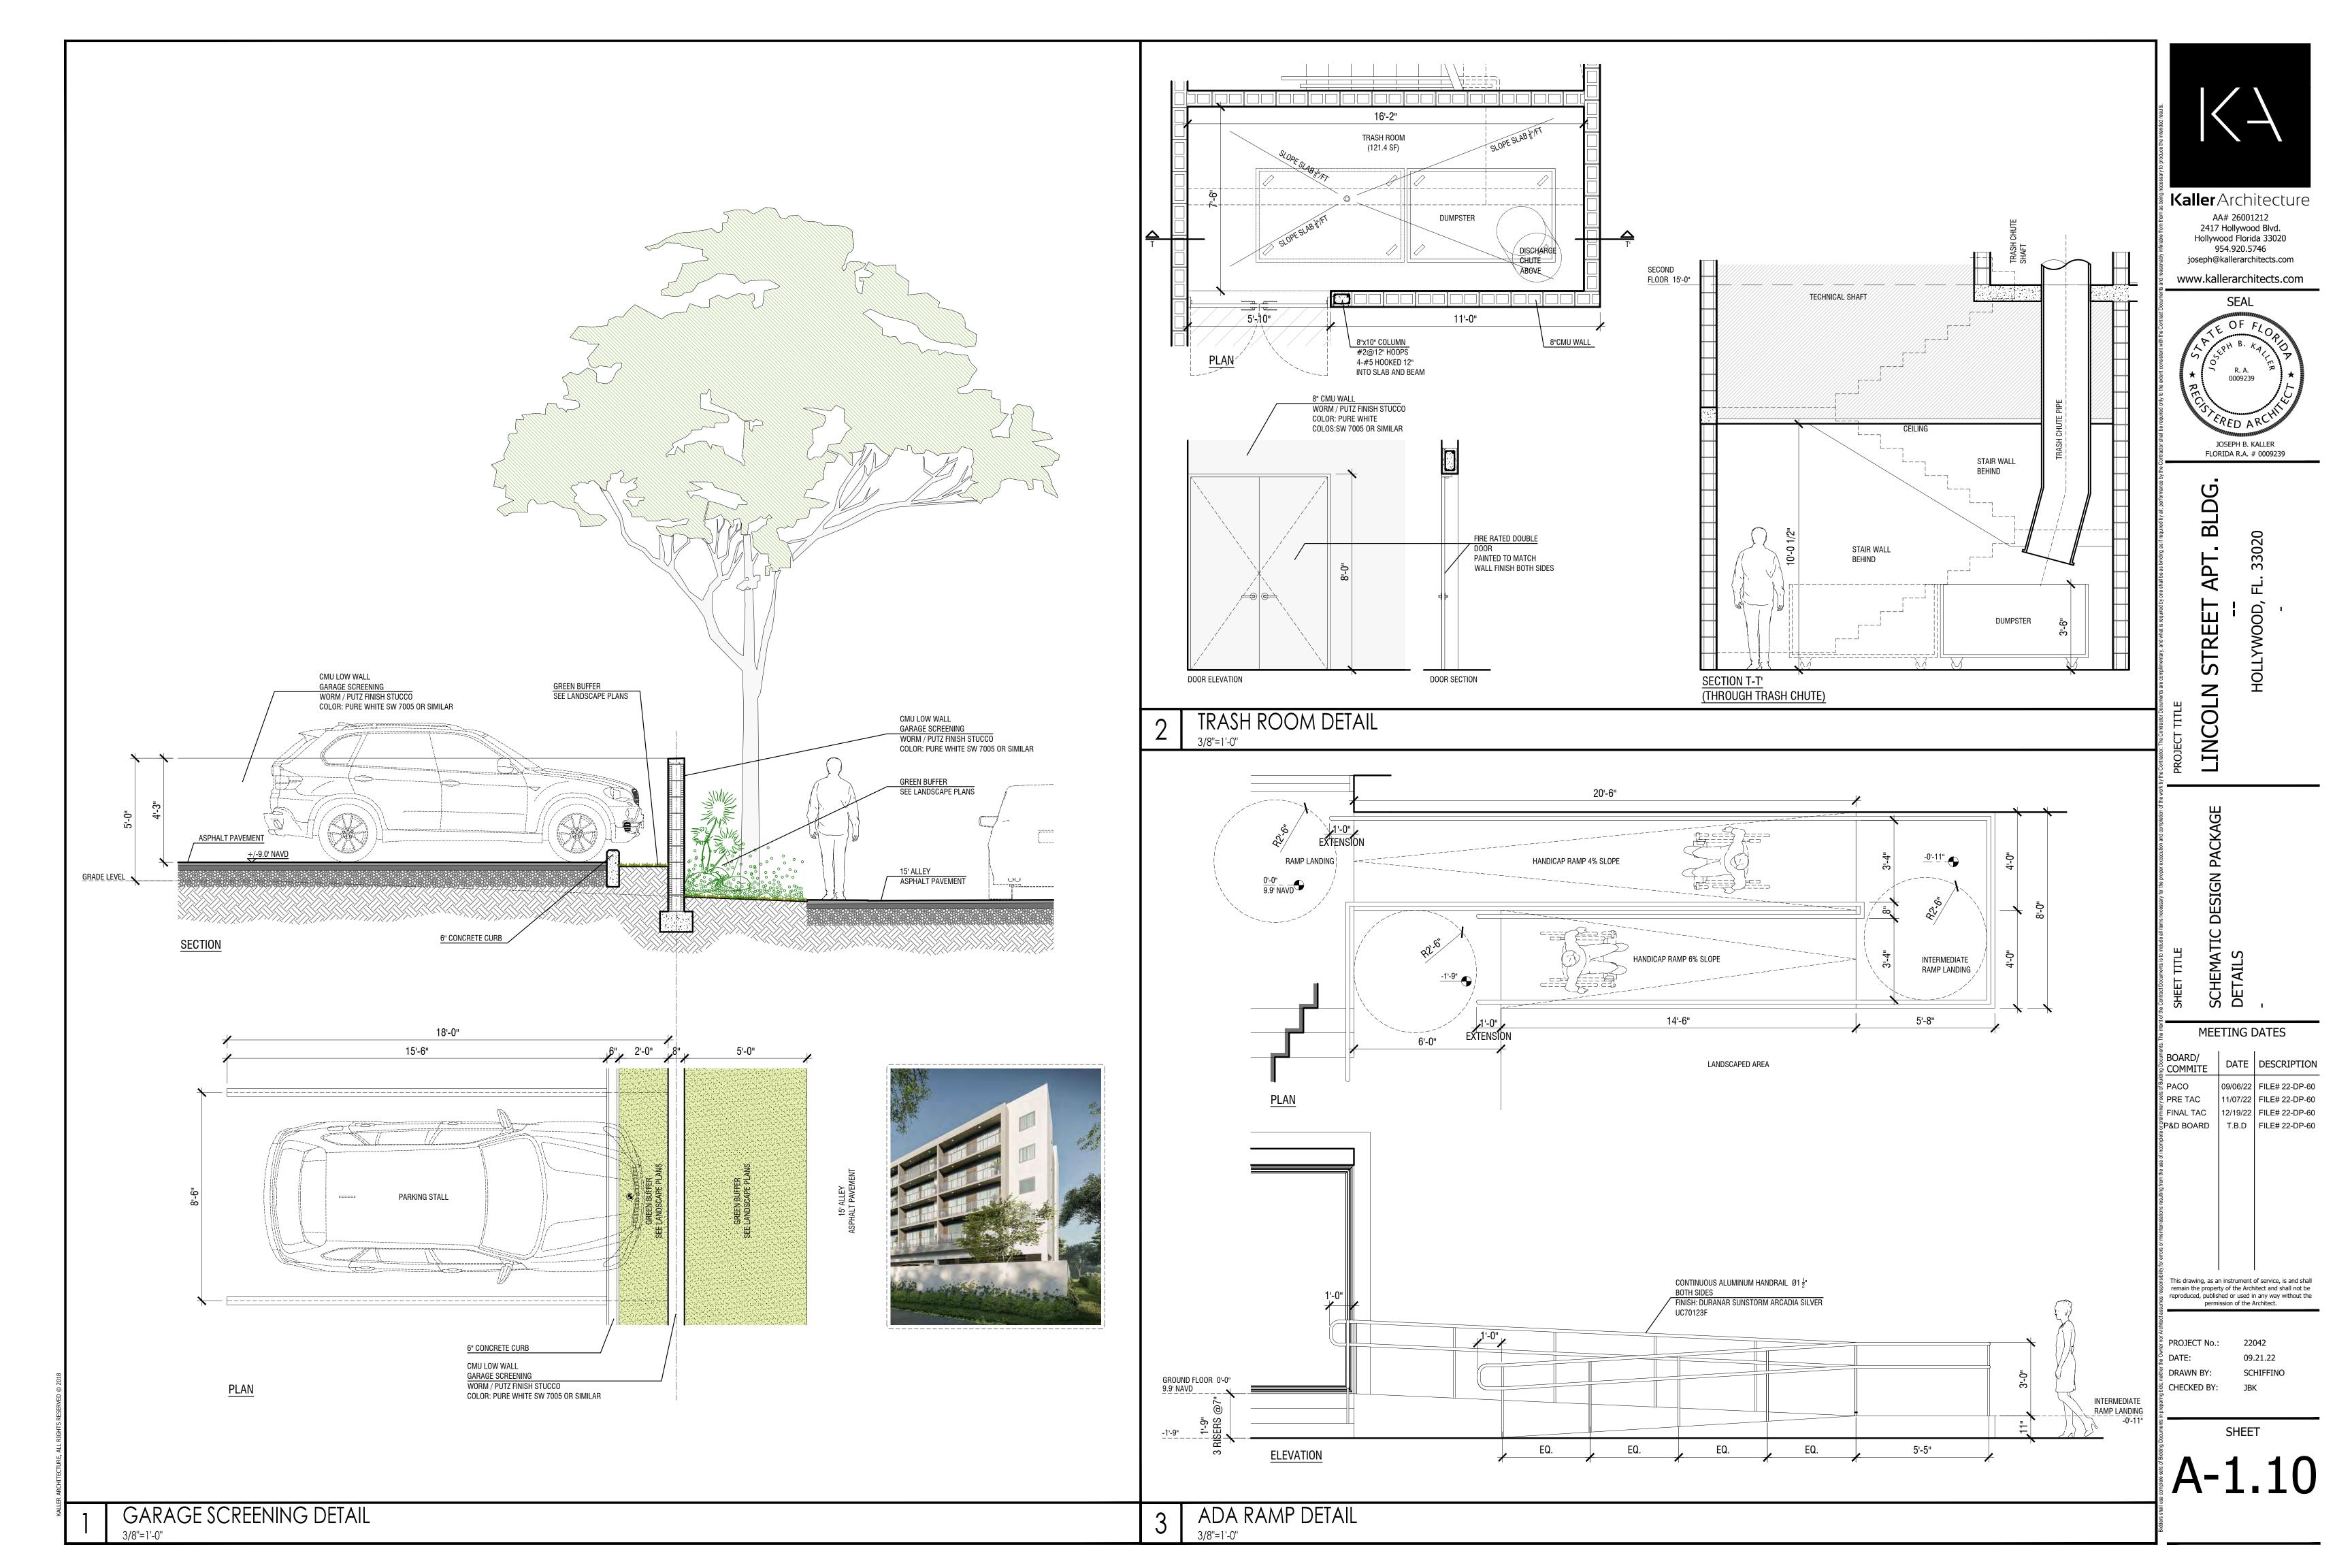
DRAWN BY: SCHIFFINO

CHECKED BY: JBK

SHEET

A-1.9


HOLLYWOOD, FL. 33020







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MEETING DATES

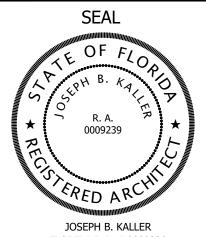BOARD/
COMMITE DATE DESCRIPTION 09/06/22 FILE# 22-DP-60 PRE TAC 11/07/22 FILE# 22-DP-60 FILE# 22-DP-60 T.B.D FILE# 22-DP-60 FILE# 22-DP-60

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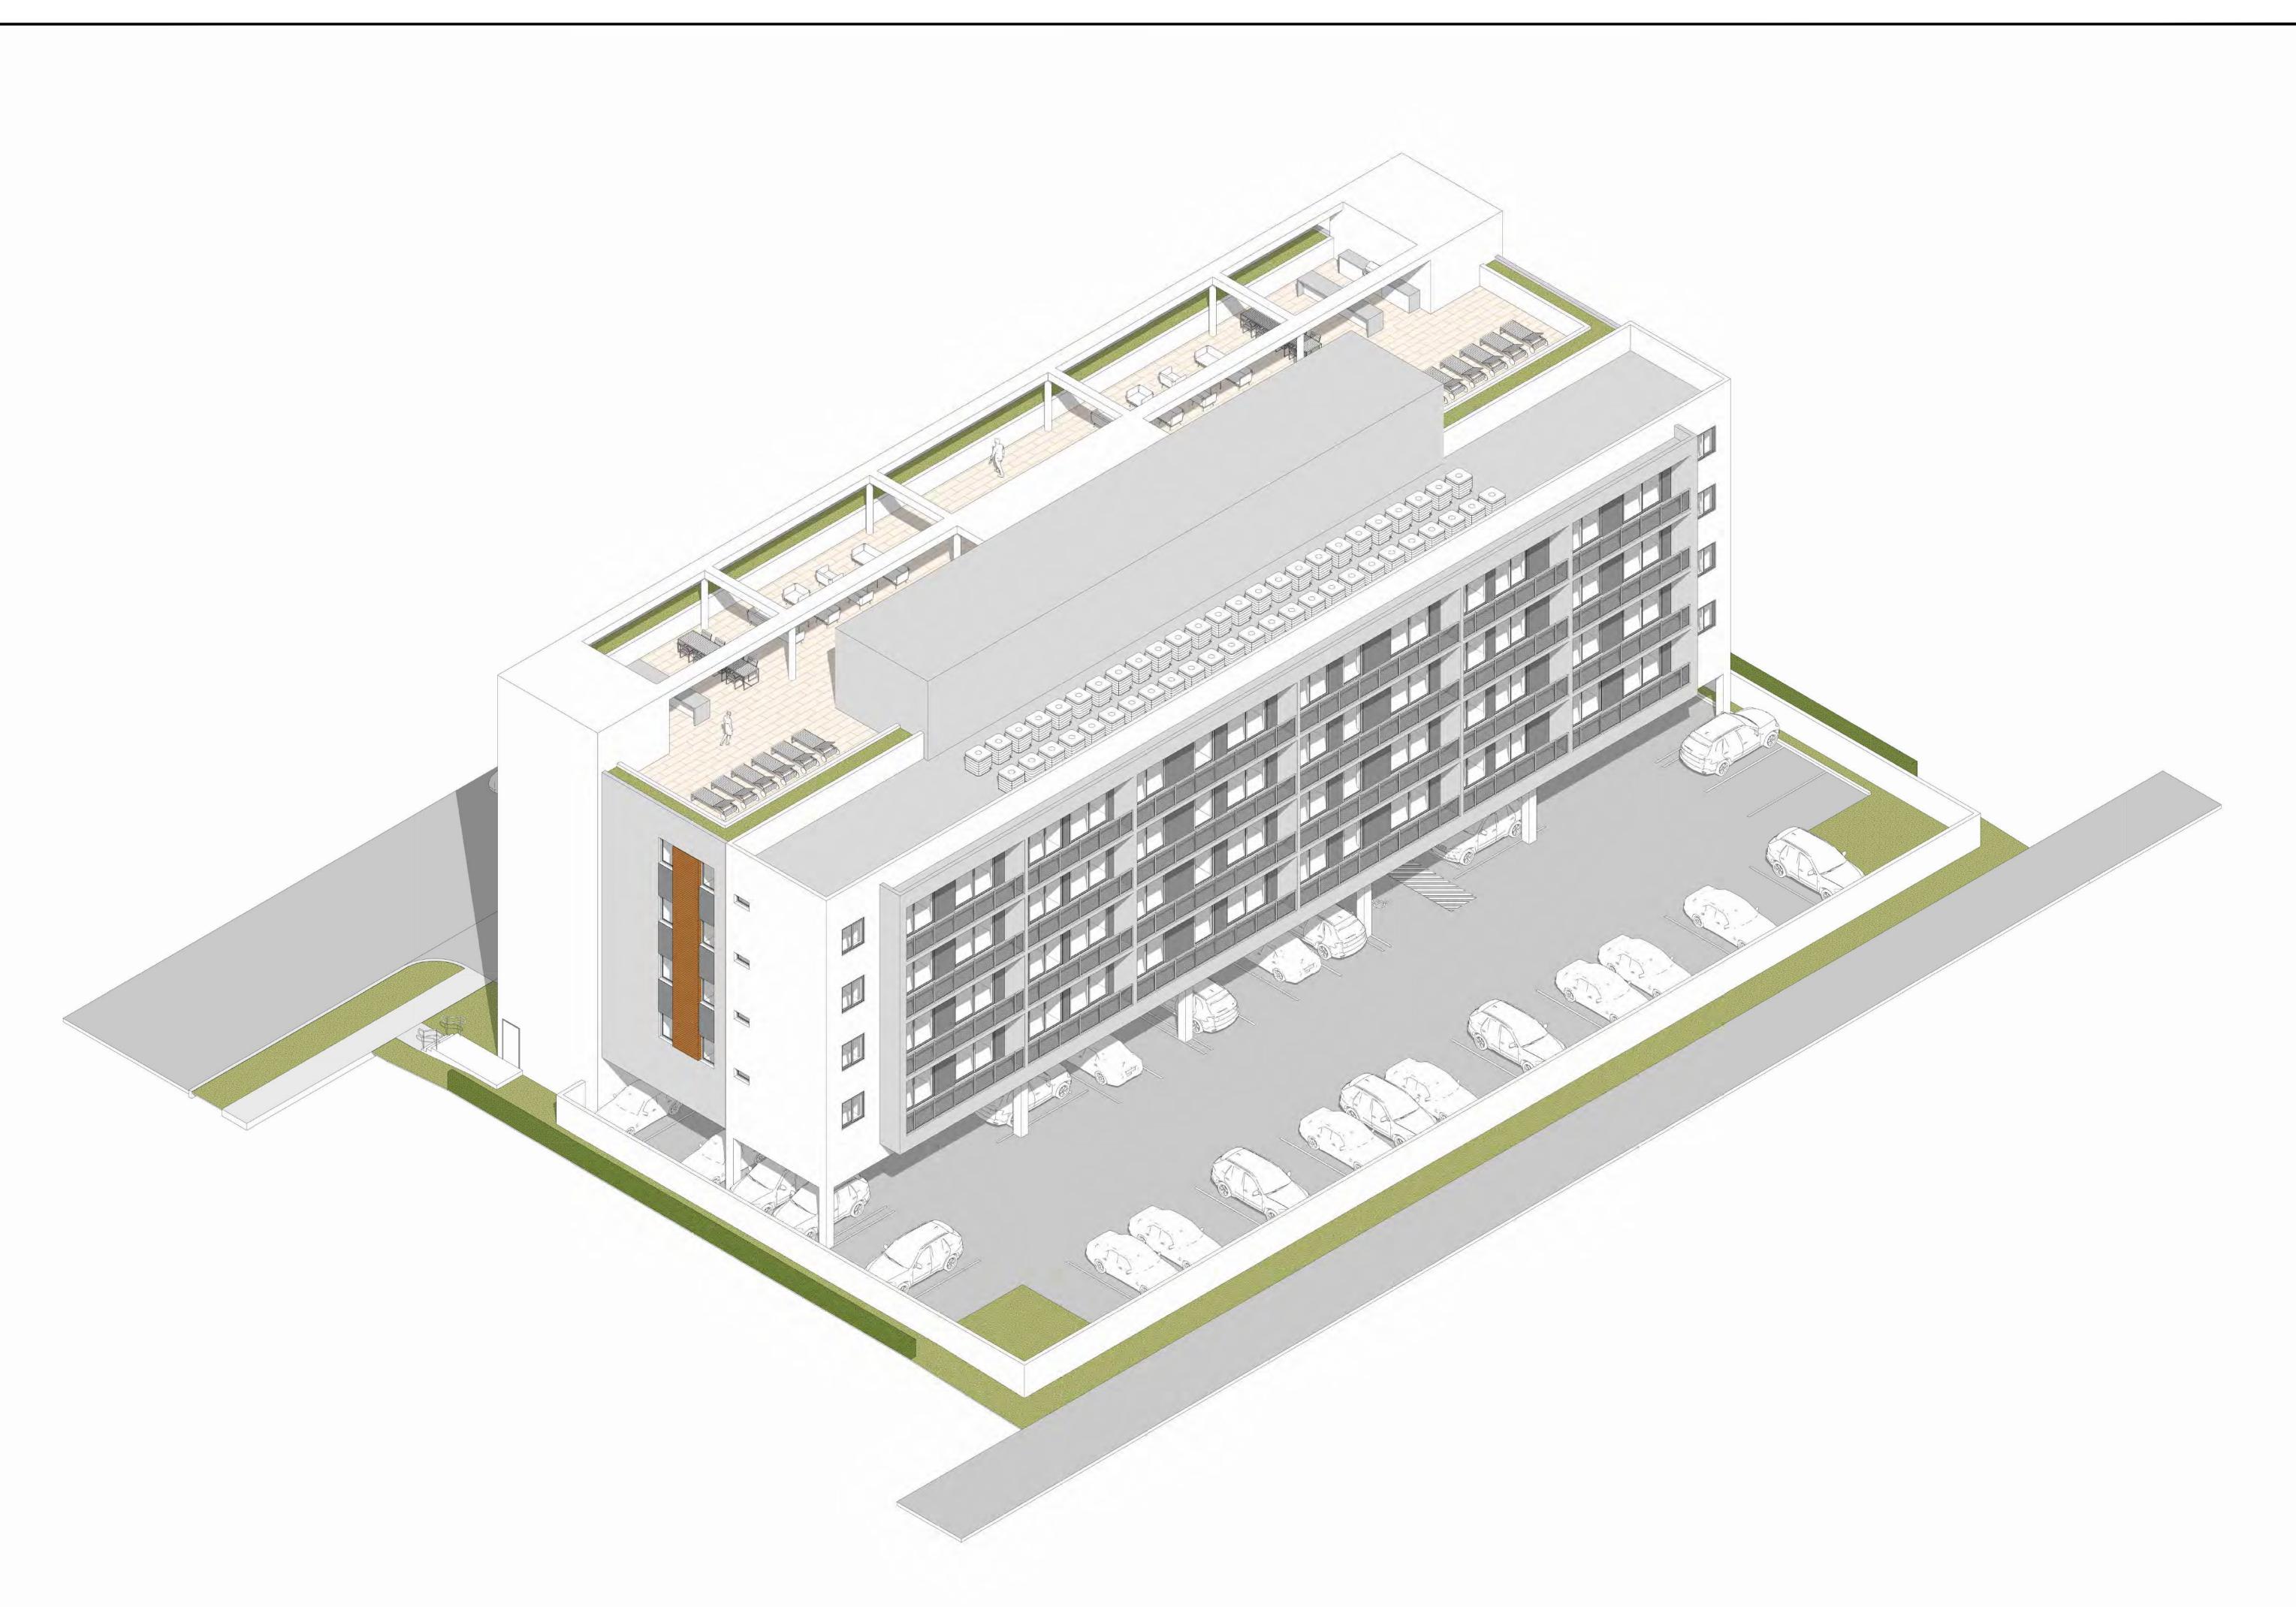
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MEETING DATES

BOARD/
COMMITE DATE DESCRIPTION 09/06/22 FILE# 22-DP-60 PRE TAC 11/07/22 FILE# 22-DP-60 FILE# 22-DP-60 T.B.D FILE# 22-DP-60 FILE# 22-DP-60

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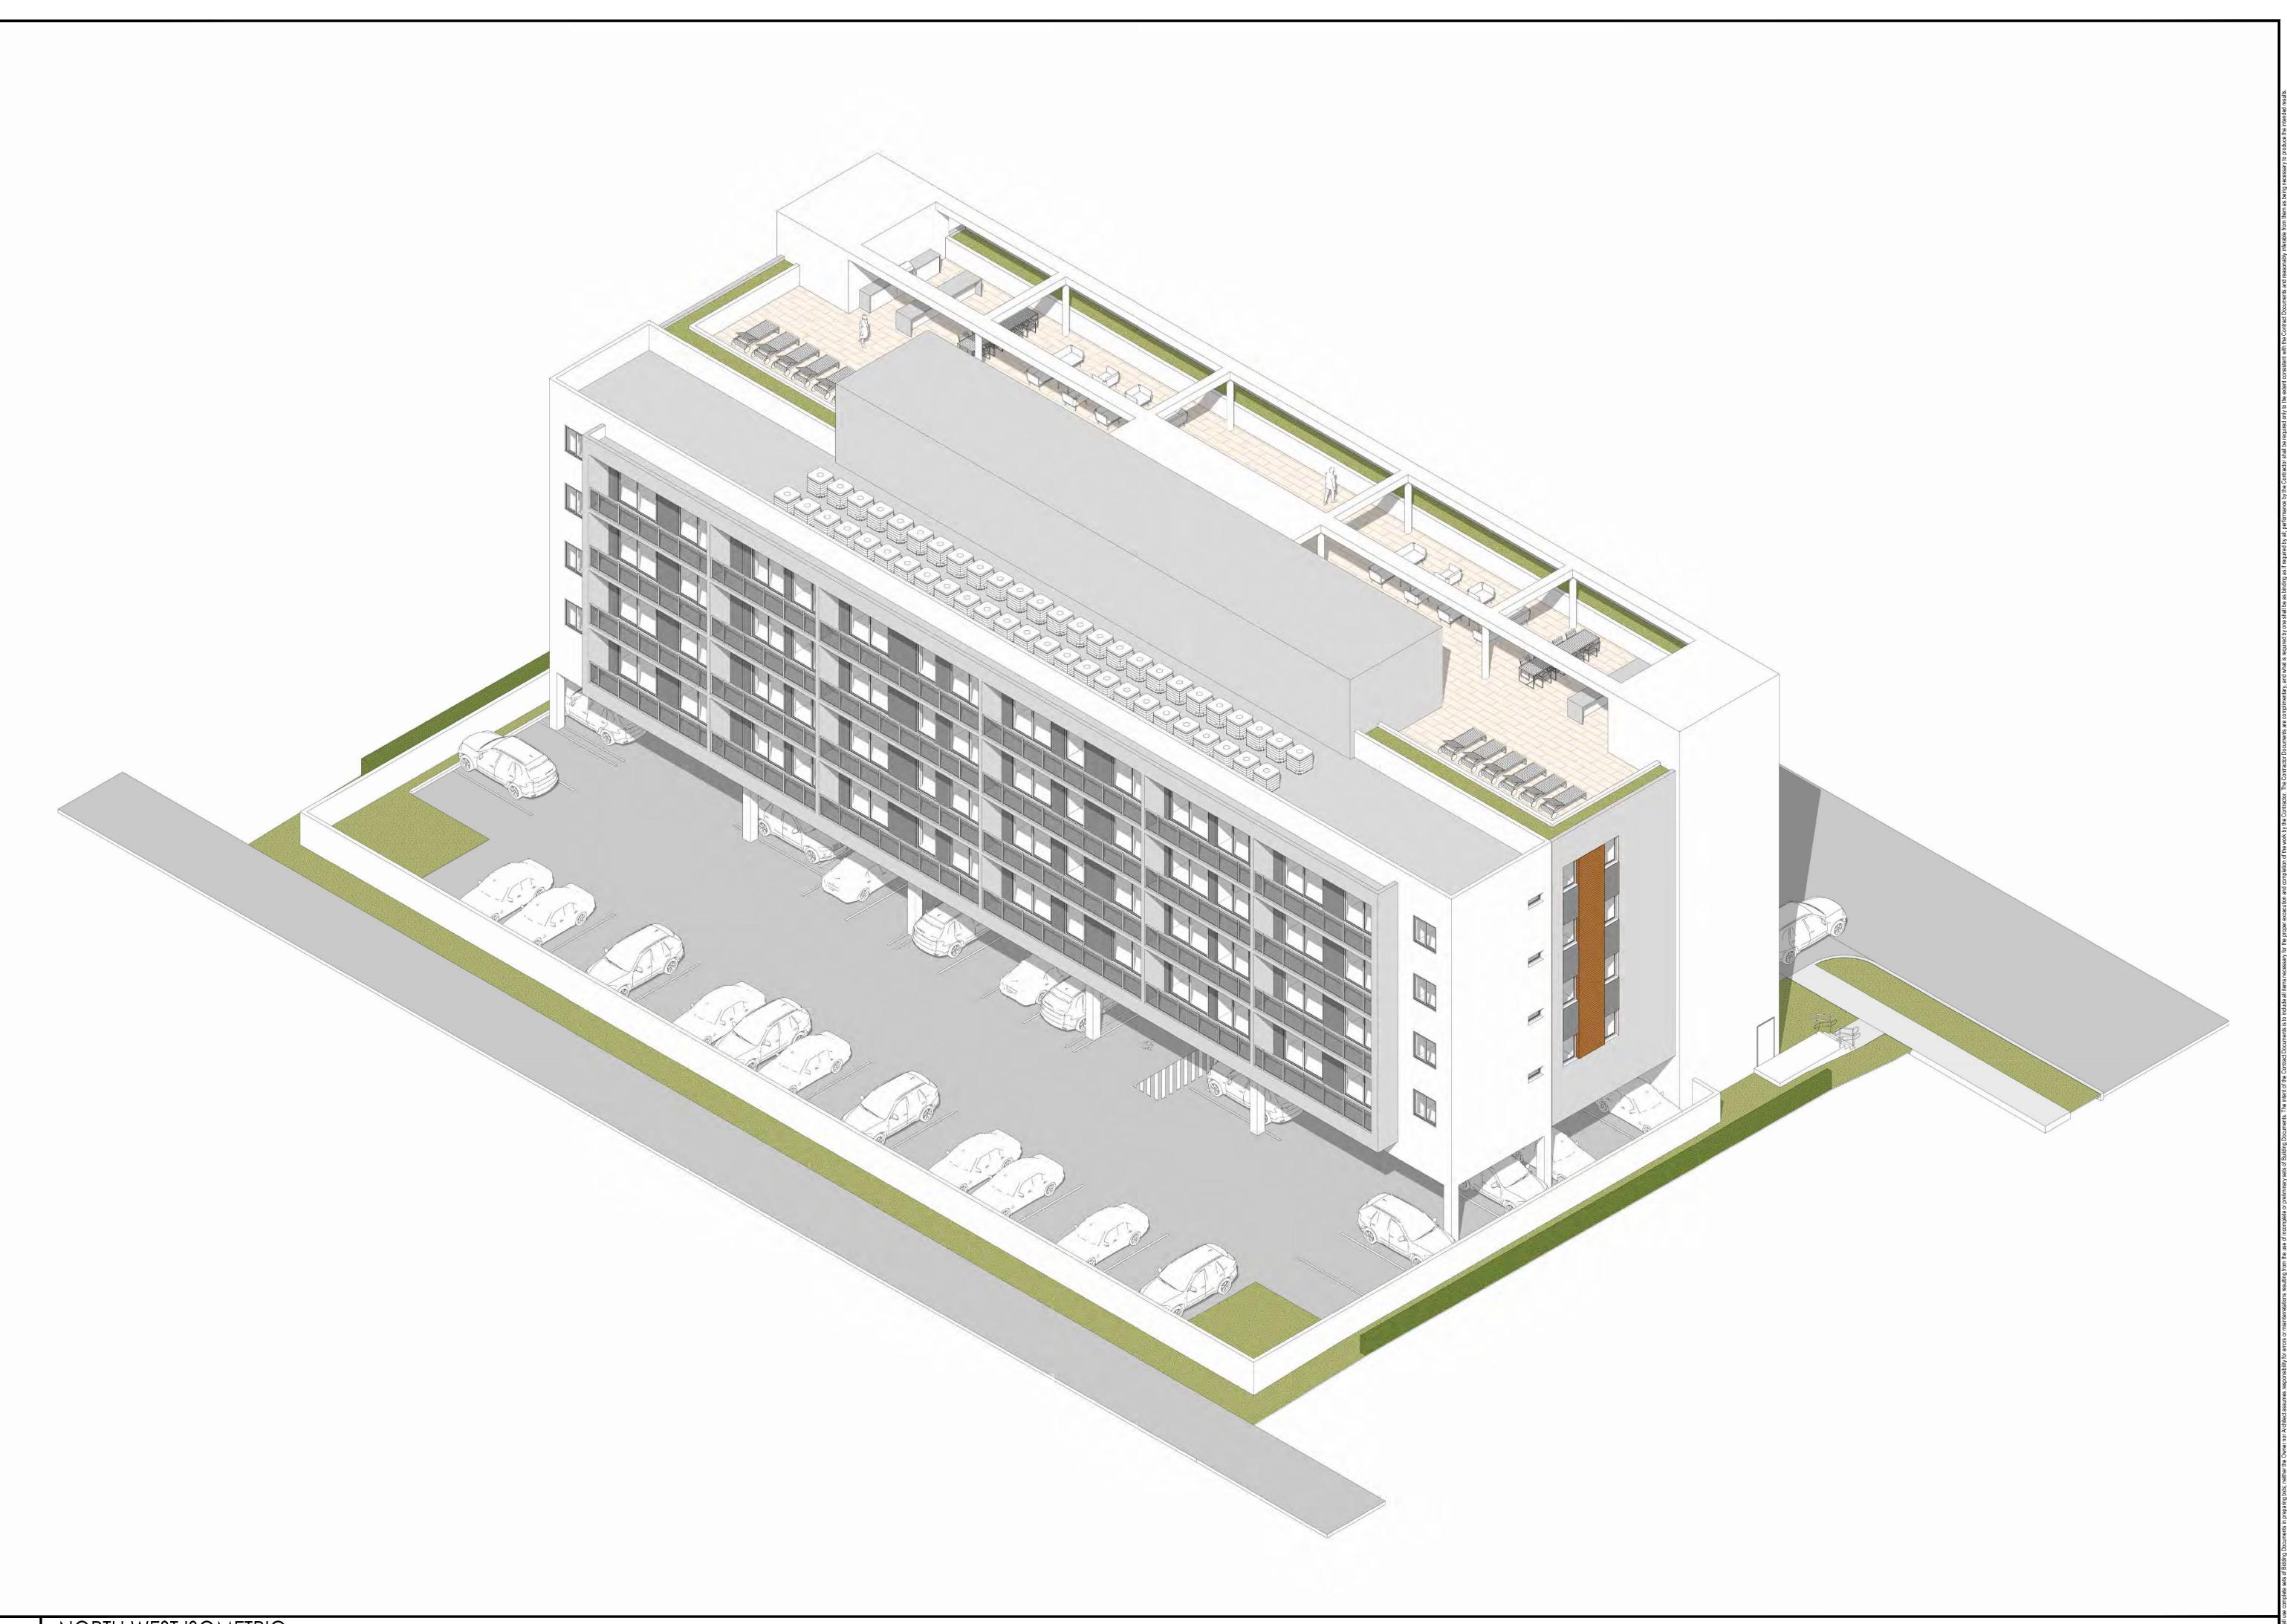
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COMMITE DATE DESCRIPTION 09/06/22 FILE# 22-DP-60

PRE TAC 11/07/22 FILE# 22-DP-60 FILE# 22-DP-60 T.B.D FILE# 22-DP-60 FILE# 22-DP-60

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PROJECT No.: 22042

SCHIFFINO DRAWN BY: g Checked by: Jbk

Grant St


Canada

O ŠŠ I

DATE: 11/2/22 SCALE: 1"=20'

SHEET NO.: 1 OF 6

PROJECT NO.: 22-82

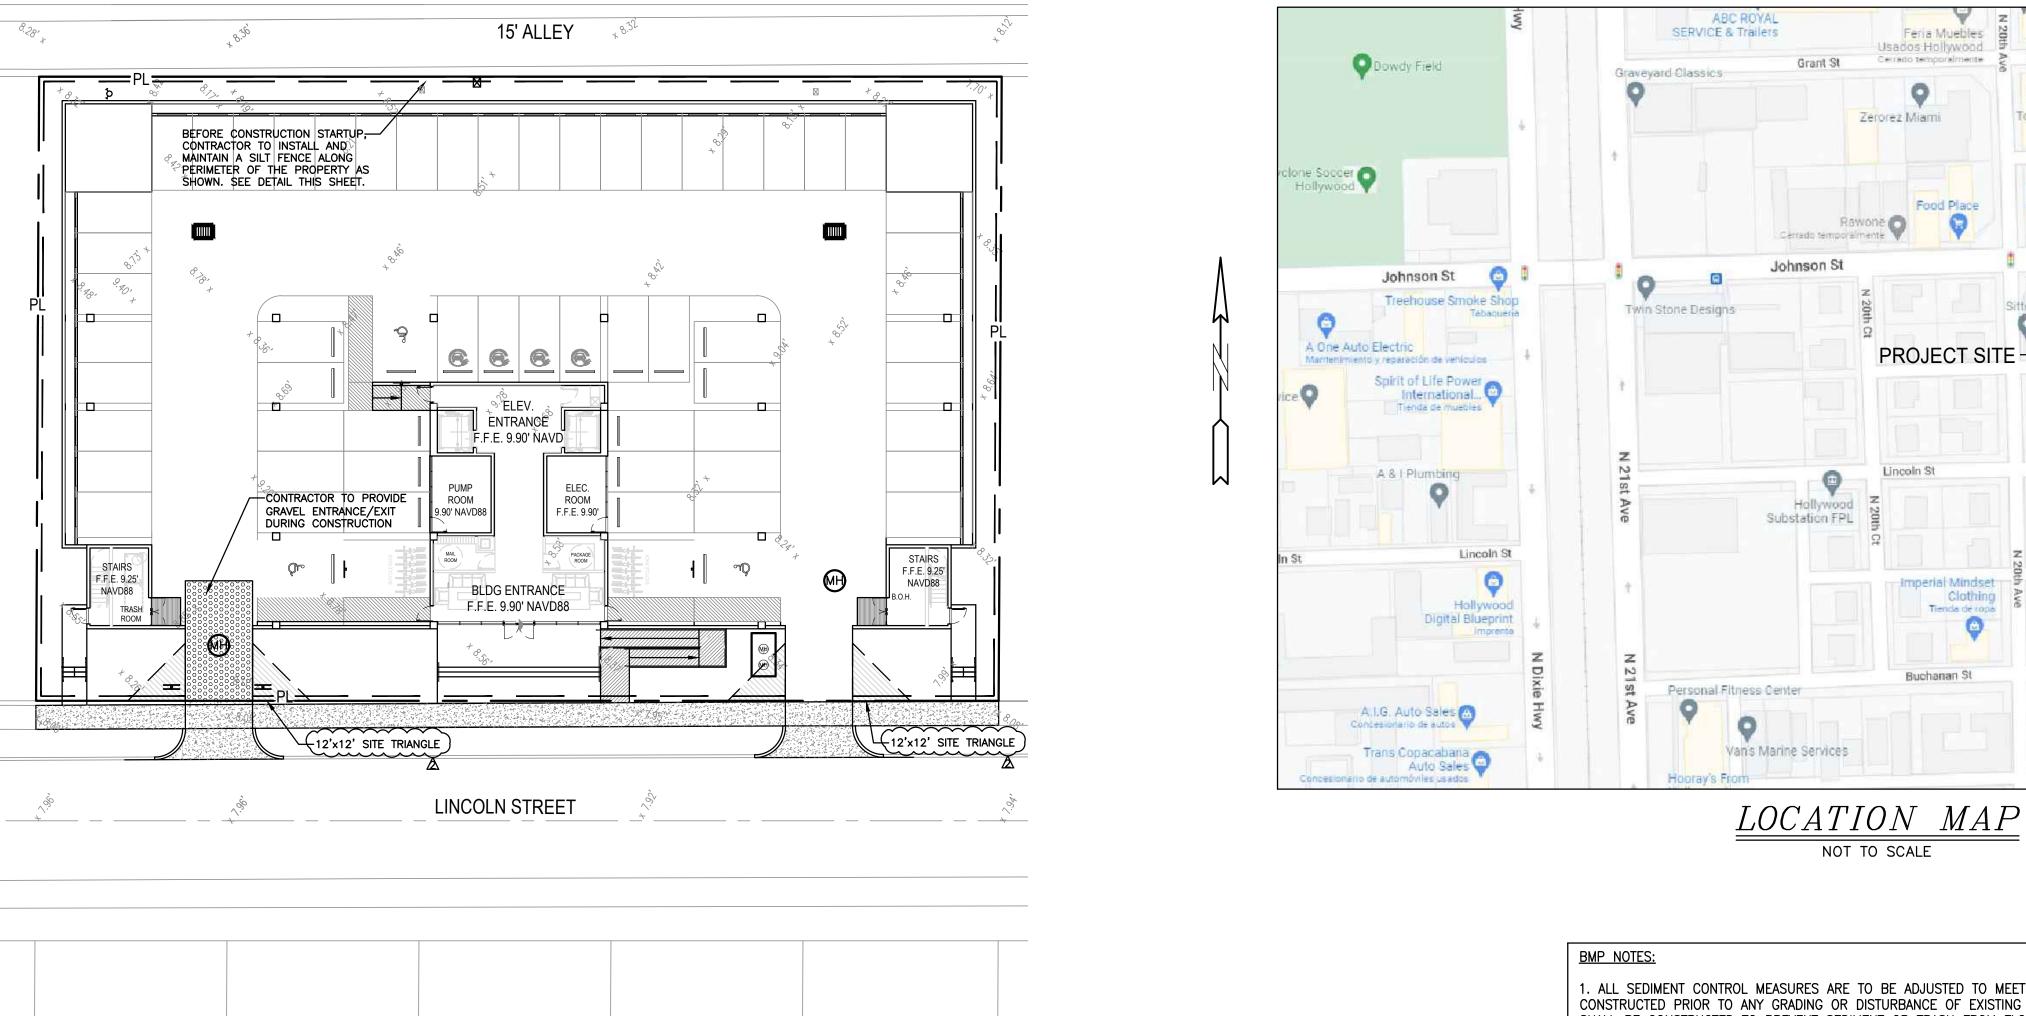

Block 18

Block 18

Block 18

POST

FILTER FABRIC (IN

CONFORMANCE WITH

SEC. 985 FDOT SPEC.)

GRADE

Block 18

6' MAX.

TYPE III SILT FENCE

Block 18

CATCH BASIN -

STRUCTURE

1. ALL SEDIMENT CONTROL MEASURES ARE TO BE ADJUSTED TO MEET FIELD CONDITIONS AT THE TIME OF CONSTRUCTION AND BE CONSTRUCTED PRIOR TO ANY GRADING OR DISTURBANCE OF EXISTING SURFACE MATERIAL ON BALANCE OF SITE. PERIMETER SEDIMENT BARRIERS

Feria Muebles

To Your Door Medical

Cuscatleco cafe
Order Delivery

Big City IT

Abbey Manor Retirement

2. PERIODIC INSPECTION AND MAINTENANCE OF ALL SEDIMENT CONTROL STRUCTURES MUST BE PROVIDED TO ENSURE INTENDED PURPOSE IS ACCOMPLISHED. THE DEVELOPER, OWNER AND/OR CONTRACTOR SHALL BE CONTINUALLY RESPONSIBLE FOR ALL SEDIMENT CONTROLS. SEDIMENT CONTROL MEASURES SHALL BE IN WORKING CONDITION AT THE END OF EACH WORKING DAY.

3. SEDIMENT WILL BE PREVENTED FROM ENTERING ANY STORM WATER SYSTEM, DITCH OR CHANNEL. ALL STORMWATER INLETS THAT ARE MADE OPERABLE DURING CONSTRUCTION SHALL BE PROTECTED SO THAT SEDIMENT-LADEN WATER CANNOT ENTER THE CONVEYANCE SYSTEM WITHOUT FIRST BEING FILTERED OR OTHERWISE TREATED TO REMOVE SEDIMENT.

4. WHERE CONSTRUCTION VEHICLE ACCESS ROUTES INTERSECT PAVED PUBLIC ROADS, PROVISIONS SHALL BE MADE TO MINIMIZE THE TRANSPORT OF SEDIMENT BY TRACKING ONTO THE PAVED SURFACE. WHERE SEDIMENT IS TRANSPORTED ONTO A PUBLIC ROAD SURFACE WITH CURBS AND GUTTERS, THE ROAD SHALL BE CLEANED THOROUGHLY AT THE END OF EACH DAY. SEDIMENT SHALL BE REMOVED FROM THE ROADS BY SHOVELING OR SWEEPING AND TRANSPORTED TO A SEDIMENT CONTROL DISPOSAL AREA. STREET WASHING SHALL BE ALLOWED ONLY AFTER SEDIMENT IS REMOVED IN THIS MANNER. THIS PROVISION SHALL APPLY TO INDIVIDUAL SUBDIVISION LOTS AS WELL AS TO LARGER LAND DISTURBING ACTIVITIES.

5. PERMANENT OR TEMPORARY SOIL STABILIZATION SHALL BE APPLIED TO DENUDED AREAS WITHIN SEVEN (7) DAYS AFTER FINAL GRADE IS REACHED ON ANY PORTION OF THE SITE. TEMPORARY SOIL STABILIZATION SHALL BE APPLIED WITHIN SEVEN (7) DAYS TO DENUDED AREAS THAT MAY NOT BE AT FINAL GRADE BUT WILL REMAIN UNDISTURBED FOR LONGER THAN THIRTY (30) DAYS. PERMANENT STABILIZATION SHALL BE APPLIED TO AREAS THAT ARE TO BE LEFT UNDISTURBED FOR MORE THAN ONE YEAR.

6. DURING CONSTRUCTION OF THE PROJECT, SOIL STOCKPILES SHALL BE STABILIZED, COVERED OR CONTAINED WITH SEDIMENT TRAPPING MEASURES. THE CONTRACTOR IS RESPONSIBLE FOR THE TEMPORARY PROTECTION AND PERMANENT STABILIZATION OF ALL SOIL STOCKPILES ON SITE AS WELL AS SOIL INTENTIONALLY TRANSPORTED FROM THE PROJECT SITE.

7. ALL TEMPORARY EROSION AND SEDIMENT CONTROL MEASURES SHALL BE REMOVED WITHIN 30 DAYS AFTER FINAL SITE STABILIZATION OR AFTER THE TEMPORARY MEASURES ARE NO LONGER NEEDED.

8. PROPERTIES AND WATER WAYS DOWNSTREAM FROM CONSTRUCTION SITE SHALL BE PROTECTED FROM SEDIMENT DEPOSITION AND EROSION AT ALL TIMES DURING CONSTRUCTION.

9. CONTRACTOR IS RESPONSIBLE FOR ALL SURFACE WATER DISCHARGES, RAINFALL RUN OFF OR DEWATERING ACTIVITIES.

10. CONTRACTOR MUST INCORPORATE ALL BMP'S NECESSARY TO MEET OR EXCEED STATE WATER QUALITY AND SWPPP REQUIREMENTS.

11. THE POLLUTION PREVENTION PLAN IS A MINIMUM GUIDELINE ONLY. ADDITIONAL BMP'S MAY BE NECESSARY AT CONTRACTOR'S EXPENSE.

No 76036 STATE OF

5-8-23

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EROSION & SEDIMENT CONTROL PLAN

SCALE: 1"=20'

CONTRACTOR TO LIFT

AND INSTALL FILTER FABRIC ACROSS INLET

OPENING. REPLACE

GRATE TO HOLD FABRIC SECURELY IN PLACE

1. FILTER FABRIC TO MEET FDOT INDEX NO. 199, 280 SPECIFICATIONS AND

FDOT SECTION 985.

2. CONTRACTOR TO REMOVE

AND/OR SEALCOATING.

FILTER FABRIC FROM CATCH BASIN JUST PRIOR TO PAVING

GRATE OFF AREA DRAINS

PROPOSED WATER METER EXISTING WATER METER EXISTING WATER VALVE PROPOSED BFP DEVICE

POST OPTIONS: WOOD 2 1/2" MIN. Ø

WOOD 2" X 4" OAK 1

1/2" X 1 1/2" STEEL

1.33 LBS/FT. MIN.—

PROPOSED ASPHALT 8.90 PROPOSED GRADE EXISTING ELEVATION PROPOSED CATCH BASIN EXISTING CATCH BASIN

LEGEND

PROPOSED CONCRETE

EXISTING SAN. SEWER MH

EXISTING FIRE HYDRANT


POLLUTION PREVENTION FOR CATCH BASIN


EXIST. SIDEWALK

CONC. DRIVEWAY

& SIDEWALK

SAWCUT & MATCH EXIST.—
PAVEMENT ELEVATION

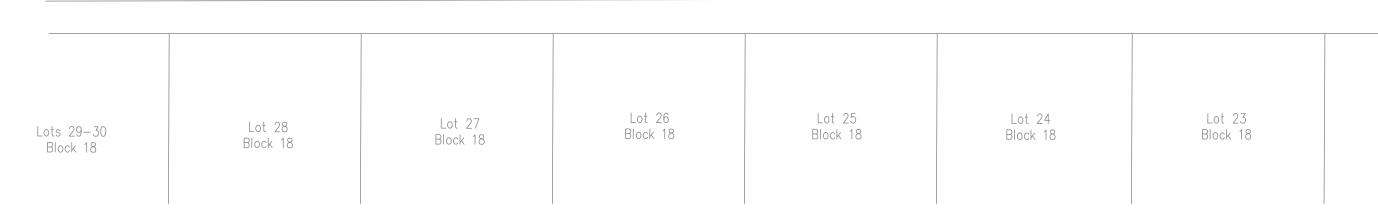

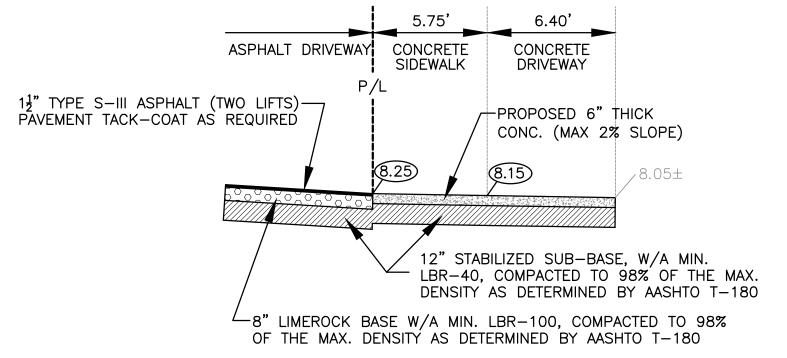

SECTION D-D N.T.S.

ASPHALT DRIVEWAY CONCRETE SIDEWALK DRIVEWAY $1\frac{1}{2}$ " TYPE S-III ASPHALT (TWO LIFTS)—PAVEMENT TACK—COAT AS REQUIRED -PROPOSED 6" THICK CONC. (MAX 2% SLOPE) 12" STABILIZED SUB-BASE, W/A MIN. LBR-40, COMPACTED TO 98% OF THE MAX. DENSITY AS DETERMINED BY AASHTO T-180

- PROP. 6" THICK

& SIDEWALK

CONC. SIDEWALK

SECTION E-E N.T.S.

LEGEND

PROPOSED CONCRETE PROPOSED ASPHALT 8.90 PROPOSED GRADE EXISTING ELEVATION PROPOSED CATCH BASIN EXISTING CATCH BASIN PROPOSED WATER METER

EXISTING WATER METER

EXISTING WATER VALVE PROPOSED BFP DEVICE EXISTING SAN. SEWER MH

EXISTING FIRE HYDRANT




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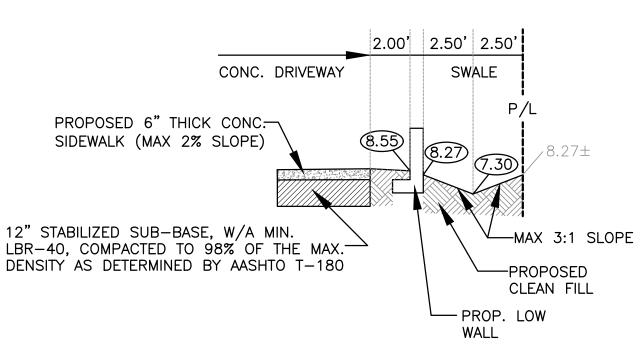
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NOTES:

N.T.S.

- CONTRACTOR MUST NOTIFY ZEPHYR ENGINEERING OF THE START OF CONSTRUCTION DATE PRIOR TO START OF CONSTRUCTION. ZEPHYR ENGINEERING WILL NOT CERTIFY ANY CONSTRUCTION THAT WAS NOT INSPECTED BY ZEPHYR ENGINEERING, OR ZEPHYR ENGINEERING'S AUTHORIZED REPRESENTATIVE.
- 2) PRIOR TO CONSTRUCTION, CONTRACTOR RESPONSIBLE TO FIELD VERIFY ALL EXISTING ELEVATIONS.
- 3) CONTRACTOR MUST COORDINATE PROPOSED IMPROVEMENTS SHOWN ON CIVIL PLANS WITH EXISTING SITE CONDITIONS & PROPOSED PLANS BY THE OTHER DESIGN PROFESSIONALS PRIOR TO CONSTRUCTION. CONTRACTOR MUST ALSO VERIFY THAT THERE ARE NO DISCREPANCIES BETWEEN THE WATER, SEWER & DRAINAGE PLANS THAT MAY CAUSE CONFLICTS PRIOR TO CONSTRUCTION. CONTACT ZEPHYR ENGINEERING IF DISCREPANCIES EXIST.
- 4) PRIOR TO CONSTRUCTION, CONTRACTOR RESPONSIBLE TO DOCUMENT EXISTING CONDITIONS ON AND AROUND THE PROJECT AREA, INCLUDING THE R.O.W. AND ADJACENT PROPERTIES. IT'S RECOMMENDED THAT CONTRACTOR TAKE PHOTOGRAPHS & VIDEOS TO CLEARLY DOCUMENT CONDITIONS PRIOR TO CONSTRUCTION. CONTRACTOR RESPONSIBLE TO REPAIR ALL DAMAGES CAUSED BY OR AS A RESULT OF THE PROPOSED CONSTRUCTION.
- 5) ALL ROOF DRAINS MUST BE CONNECTED TO THE ONSITE DRAINAGE
- 6) CONTRACTOR TO REFER TO ARCHITECTURAL PLANS FOR SITE PLAN LAYOUT AND DIMENSIONS.
- 7) EXISTING UTILITIES SHOWN ARE BASED ON BEST AVAILABLE INFORMATION. CONTRACTOR'S RESPONSIBLE TO FIELD VERIFY LOCATION OF ALL EXISTING UTILITIES PRIOR TO CONSTRUCTION. CONTRACTOR TO BE AWARE THAT THERE MAY BE SOME EXISTING UTILITIES ON OR ADJACENT TO THE PROJECT SITE THAT MAY NOT BE SHOWN ON THE CIVIL PLANS, AND CONTRACTOR IS RESPONSIBLE TO FIELD VERIFY THOSE UTILITIES AS WELL. CONTRACTOR RESPONSIBLE FOR RELOCATION OF EXISTING UTILITIES THAT CONFLICTS WITH PROPOSED CONSTRUCTION.



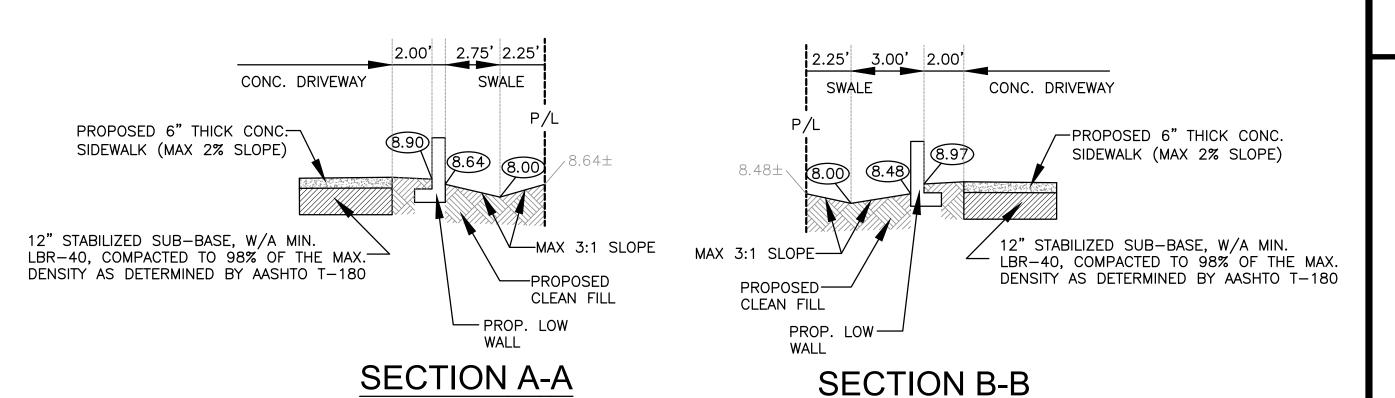

SECTION C-C N.T.S.

N.T.S.

PAVING, GRADING & DRAINAGE PLAN

EERIN

ZEPH

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P.E.#:76036

DATE: 11/2/22 SCALE: 1"=20'

2 OF 6

PROJECT NO.: 22-82

I. THE LOCATION OF EXISTING UTILITIES AND TOPOGRAPHY HAS BEEN PREPARED FROM THE MOST RELIABLE INFORMATION AVAILABLE TO THE ENGINEER. THIS INFORMATION IS NOT GUARANTEED AND IT IS THE RESPONSIBILITY OF THE CONTRACTOR TO DETER-MINE THE EXACT LOCATION OF ALL EXISTING UTILITIES

AND TOPOGRAPHY PRIOR TO CONSTRUCTION. 2. PRIOR TO CONSTRUCTION THE CONTRACTOR IS TO NOTIFY THE FOLLOWING

COMPANIES & AGENCIES AND ANY OTHERS SERVING THE AREA: FLORIDA POWER & LIGHT CO., CONSTRUCTION

BELLSOUTH COMCAST

LOCAL CITY / COUNTY ENGINEERING & UTILITY DEPARTMENTS FLORIDA DEPARTMENT OF TRANSPORTATION (FDOT), AS APPLICABLE UNDERGROUND UTILITIES NOIFICATION CENTER OF FLORIDA (S.U.N.S.H.I.N.E.)

PAVING, GRADING & DRAINAGE NOTES:

ALL UNSUITABLE MATERIALS, SUCH AS MUCK, HARDPAN, ORGANIC MATERIAL & OTHER DELETERIOUS MATERIAL AS CLASSIFIED BY AASHTO M-145, FOUND WITHIN THE ROAD & PARKING LOT AREAS SHALL BE REMOVED DOWN TO ROCK OR SUITABLE MATERIAL, & REPLACED W/ THE SPECIFIED FILL MATERIAL IN MAXIMUM 12" LIFTS COMPACTED TO NOT LESS THAN 100% MAXIMUM DRY DENSITY AT OPTIMUM MOISTURE IN ACCORDANCE W/ AASHTO T-99. THICKNESS OF LAYERS MAY BE INCREASED PROVIDED THE EQUIPMENT & METHODS USED ARE PROVEN BY FIELD DENSITY TESTING TO BE CAPABLE OF COMPACTING THICK LAYERS TO SPECIFIED DENSITIES.

2. ALL AREAS SHALL BE CLEARED & GRUBBED PRIOR TO CONSTRUCTION. THIS SHALL CONSIST OF THE COMPLETE REMOVAL & DISPOSAL OF ALL TREES, BRUSH, STUMPS, ROOTS, GRASS, WEEDS, RUBBISH & ALL OTHER OBSTRUCTION RESTING ON OR PROTRUDING THROUGH THE SURFACE OF THE EXIST. GROUND TO A DEPTH OF 12". ITEMS DESIGNATED TO REMAIN OR TO BE RELOCATED OR ADJUSTED SHALL BE SO DESIGNATED ON THE DWGS.

3. FILL MATERIAL SHALL BE CLASSIFIED AS A-1, A-3 OR A-2.4 IN ACCORDANCE W/ AASHTO M-145 & SHALL BE FREE FROM VEGETATION & ORGANIC MATERIAL. NOT MORE

THAN 12% BY WEIGHT OF FILL MATERIAL SHALL PASS THE NO. 200 SIEVE. 4. THE CONTRACTOR SHALL BE RESPONSIBLE FOR PROVIDING CERTIFIED MATERIAL TEST RESULTS TO THE ENGINEER OF RECORD PRIOR TO THE RELEASE OF FINAL CERTIFICATION BY THE ENG. TEST RESULTS MUST INCLUDE BUT MAY NOT BE LIMITED TO, DENSITIES FOR SUBGRADE & LIME ROCK, UTILITIES, EXCAVATION, ASPHALT GRADIATION REPORTS, CONC.

5. ALL INLETS & PIPE SHALL BE PROTECTED DURING CONSTRUCTION TO PREVENT SILTATION IN THE DRAINAGE SYSTEMS BY WAY OF TEMPORARY PLUGS & PLYWOOD OR PLASTIC COVERS OVER THE INLETS. THE ENTIRE DRAINAGE SYSTEM TO BE CLEAN OF DEBRIS PRIOR TO FINAL

6. WHERE NEW ASPHALT MEETS OR ABUTS EXIST. ASPHALT, THE EXIST. ASPHALT SHALL BE SAWCUT TO PROVIDE A STRAIGHT EVEN LINE. PRIOR TO REMOVING CURB OR GUTTER, THE ADJACENT ASPHALT SHALL ALSO BE SAWCUT TO PROVIDE A STRAIGHT EVEN LINE.

ALL PROPOSED GRADES (ELEVATIONS) REFER TO ASPHALT GRADES UNLESS INDICATED OTHERWISE.

8. SITE GRADING SHALL BE W/IN 0.1' OF THE REQUIRED ELEVATION & ALL AREAS SHALL BE GRADED TO DRAIN.

9. ALL SUBGRADE SHALL HAVE AN LBR OF 40 UNLESS OTHERWISE NOTED & SHALL BE COMPACTED TO 98% MAXIMUM DRY DENSITY PER AASHTO T-99.

10. ALL LIMEROCK SHALL BE COMPACTED TO 98% PER AASHTO T-180 & HAVE NOT LESS THAN 60% OF CARBONATES OF CALCIUM & MAGNESIUM UNLESS OTHERWISE DESIGNATED. ALL LIMEROCK SHALL BE PRIMED.

11 CONCRETE & ASPHALT THICKNESS SHALL BE OF TYPE DESIGNATED ON DWGS. (SEE SECTIONS)

12. PLASTIC FILTER FABRIC SHALL BE MIRAFI, TYPAR OR EQUAL CONFORMING TO SECTION 985 OF THE FDOT STANDARD SPECIFICATIONS. 13. CONC. SIDEWALKS SHALL BE 4" THICK ON COMPACTED SUBGRADE, W/ 1/2" EXPANSION

JOINTS PLACED AT A MAXIMUM OF 75'. CRACK CONTROL JOINTS SHALL BE 5' ON CENTER. THE BACK OF SIDEWALK ELEVATION SHALL EQUAL THE CROWN OF ROADWAY, UNLESS SPECIFIED OTHERWISE BY LOCAL CODES OR INDICATED ON DWGS. ALL CONC. SIDEWALKS THAT CROSS DRIVEWAYS SHALL BE 6" THICK.

14. PIPE SPECIFICATIONS: THE MATERIAL TYPE IS SHOWN ON THE DRAWINGS BY ONE OF THE FOLLOWING DESIGNATIONS -

RCP = REINFORCED CONC. PIPE, ASTM DESIGNATION C-76, TABLE III

CMP = CORRUGATED METAL (ALUM.) PIPE, TM DESIGNATION M-196: (SMOOTH LINED) CORRUGATED METAL (ALUM.) PIPE, ASTM DESIGNATION M-196

SCP = SLOTTED CONC. PIPE, FDOT SECTIONS 941 & 942 PVC = POLYVINYLCHLORIDE PIPE PCMP = PERFORATED CMP, FDOT SECTION 945

DIP = DUCTILE IRON PIPE HDPE = HIGH DENSITY POLYETHYLENE PIPE.

15. ASPHALT -

BITUMINOUS MATERIAL SHALL BE ASPHALT CEMENT, VISCOSITY GRADE AC-20, CONFORMING TO THE REQUIREMENTS OF FDOT STANDARD SPECIFICATIONS, 1986 EDITION, SECTION 916-1 PRIME COAT SHALL BE CUT BACK ASPHALT, GRADE RC-70 OR RC-250 CONFORMING TO

THE REQUIREMENTS SPECIFIED IN AASHTO DESIGNATION M-81-75 (1982). RATE - 0.10 GALS./S.Y. TACK COAT SHALL BE EMULSIFIED ASPHALT, GRADE RS-2 CONFORMING TO THE REQUIREMENTS SPECIFIED IN AASHTO DESIGNATION M-140-82. RATE - 0.02 TO 0.08

DESIGN MIX SHALL CONFORM TO FDOT SECTION 331 UNLESS OTHERWISE SPECIFIED.

PAVEMENT MARKING & SIGNING STANDARD NOTES :


1. STOP SIGNS SHALL BE 30"x30" (R1-1), HIGH INTENSITY.

2. ALL SIGNS SHALL BE PLACED AT A HEIGHT NOT LESS THAN 5' & NOT GREATER THAN 7', THE HEIGHT IS MEASURED FROM THE BOTTOM OF THE SIGN TO THE EDGE OF NEAREST PAVEMENT. THE SIGN POST SHALL BE PLACED A MINIMUM OF 6' TO A MAXIMUM OF 12' FROM THE ADJACENT PAVEMENT, & A MINIMUM OF 6' FROM THE CROSS TRAFFIC


3. STOP BARS SHALL BE 24" WHITE.


4. ALL SITE PAVEMENT MARKINGS SHALL BE PAINT. (UNLESS INDICATED OTHERWISE)


5. ALL PAVEMENT MARKINGS AND SIGNAGE IN THE ROAD RIGHT-OF-WAY SHALL BE THERMOPLASTIC & SHALL CONFORM TO MUTCD AND PBC TYPICAL T-P-06-001.

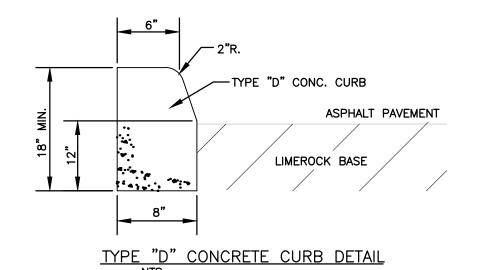


ALL ELEVATIONS ARE REFERENCED TO NAVD88 VERTICAL DATUM

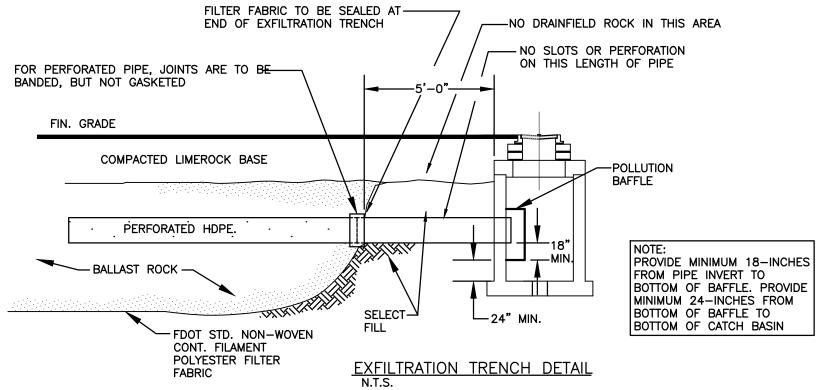


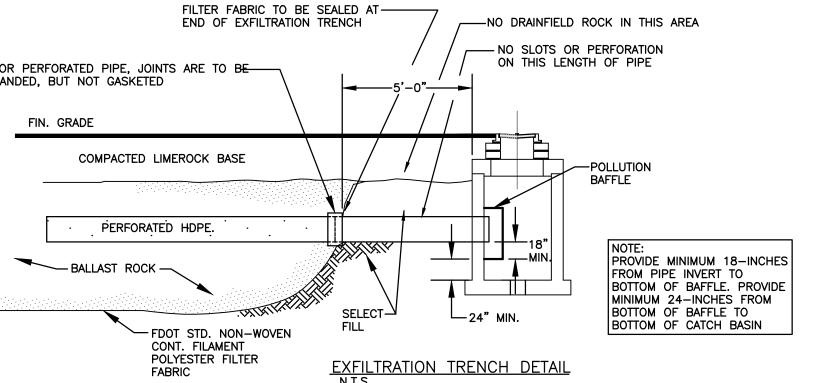


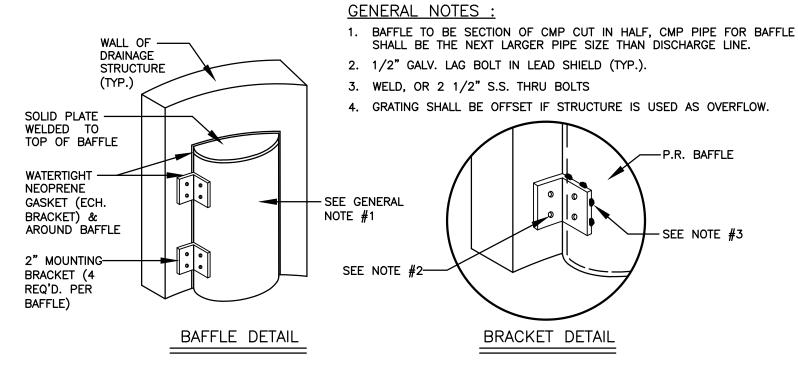

POLLUTION RETARDANT BAFFLE DETAIL

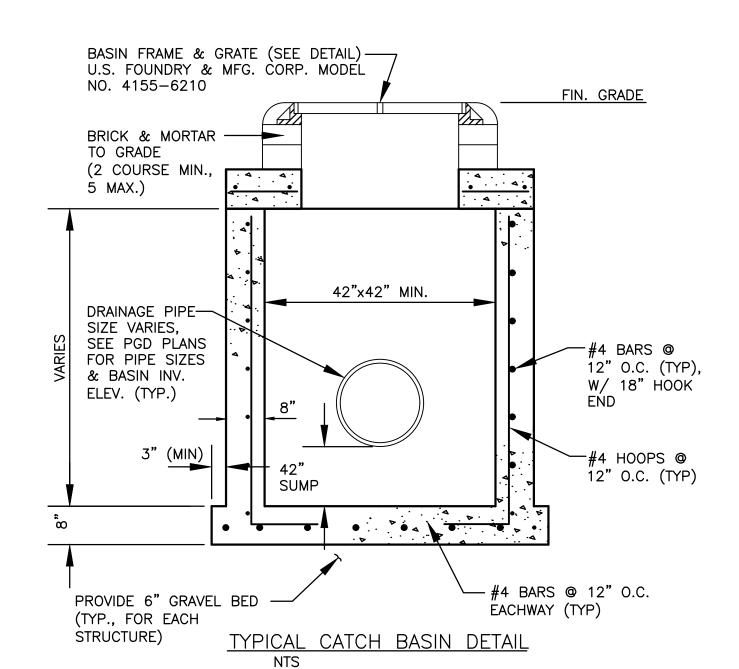

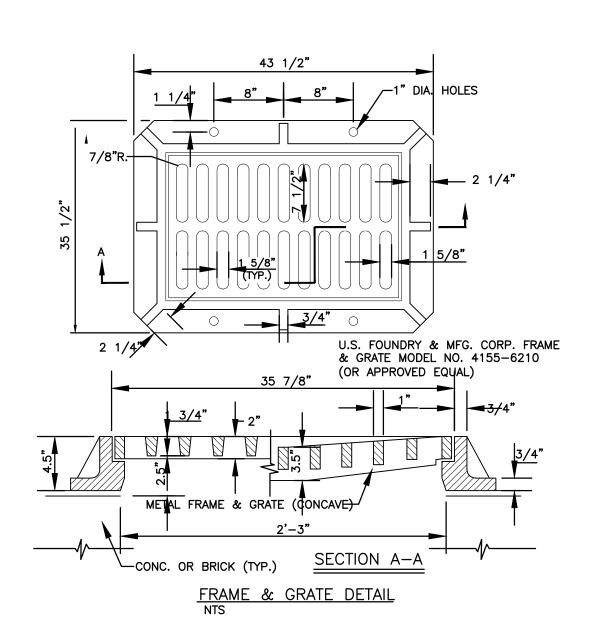

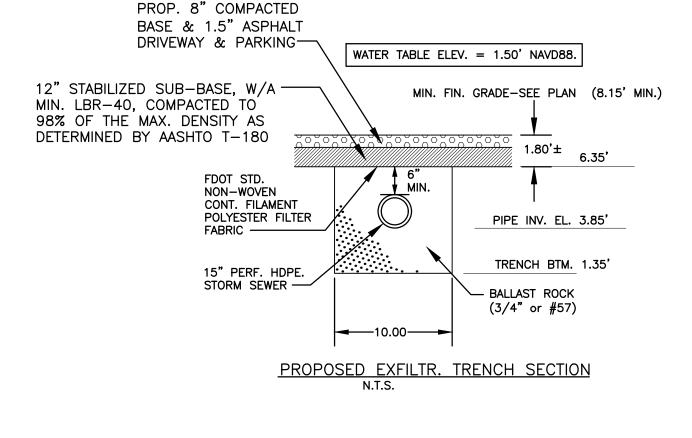

U.S.F. 1117 HEAVY DUTY-

M.H. FRAME & SOLID


COVER, TOP OF COVER

EL. = 8.65' NAVD88


U.S.F. 1117 HEAVY DUTY-

M.H. FRAME & SOLID COVER. TOP OF COVER

EL. = 8.65' NAVD88

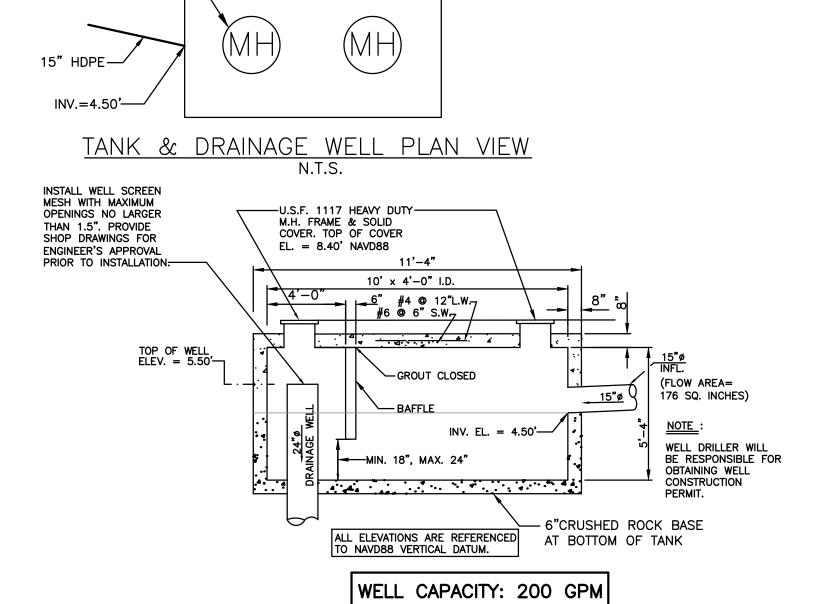

RE-INFORECED CONCRETE RETENTION TANK & DRAINAGE WELL DETAIL N.T.S.

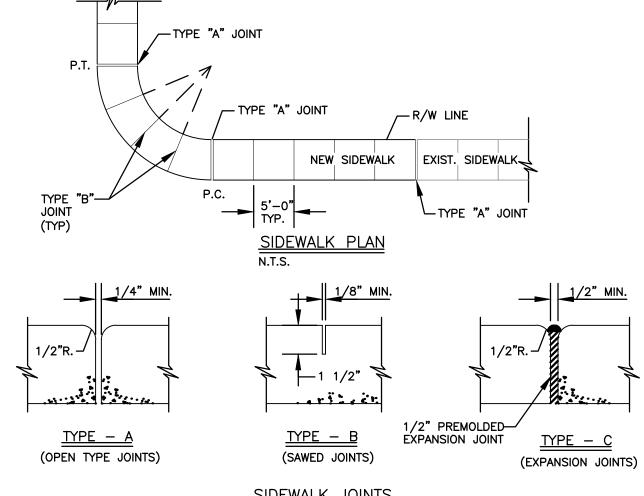

TYPICAL SIDEWALK THICKNESS (T)

LOCATION PEDESTRIAN AREAS DRIVEWAYS & OTHER

3. 8" THK. SIDEWALK

ACROSS DRIVEWAYS

1. EXPANSION JOINTS EVERY 50' O.C. 2. CONC. MIN. 2500 PSI, NO STEEL IN SIDEWALK

SIDEWALK JOINTS

TABLE OF SIDEWALK JOINTS

P.C. & P.T. OF CURVES & TIE-IN JUNCTION OF EXIST. TO NEW SIDEWALKS. 5'-0" O.C. ON SIDEWALKS. * WHERE SIDEWALK ABUTS CONC. CURBS DRIVEWAYS OR SIMILIAR STRUCTURES.

EXPANSION JOINTS EVERY 50' O.C. * INSTALLED AT THE DISCRETION OF THE ENGINEER

SIDEWALK DETAIL



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P.E.#:76036 DATE: 11/2/22

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SCALE: N.T.S. SHEET NO.: 3 OF 6

PROJECT NO.: 22-82

CIVIL DETAILS SCALE: N.T.S.

— SIGN "PARKING BY DISABLED PERMIT ONLY", TYP.

HC SYMBOL PAINTED WHITE


-WHEELSTOP


TYPICAL HANDICAP PARKING STALL NTS

DATE: 11/2/22 SCALE: 1"=20'

4 OF 6 PROJECT NO.: 22-82

PAVEMENT MARKINGS & SIGNAGE PLAN

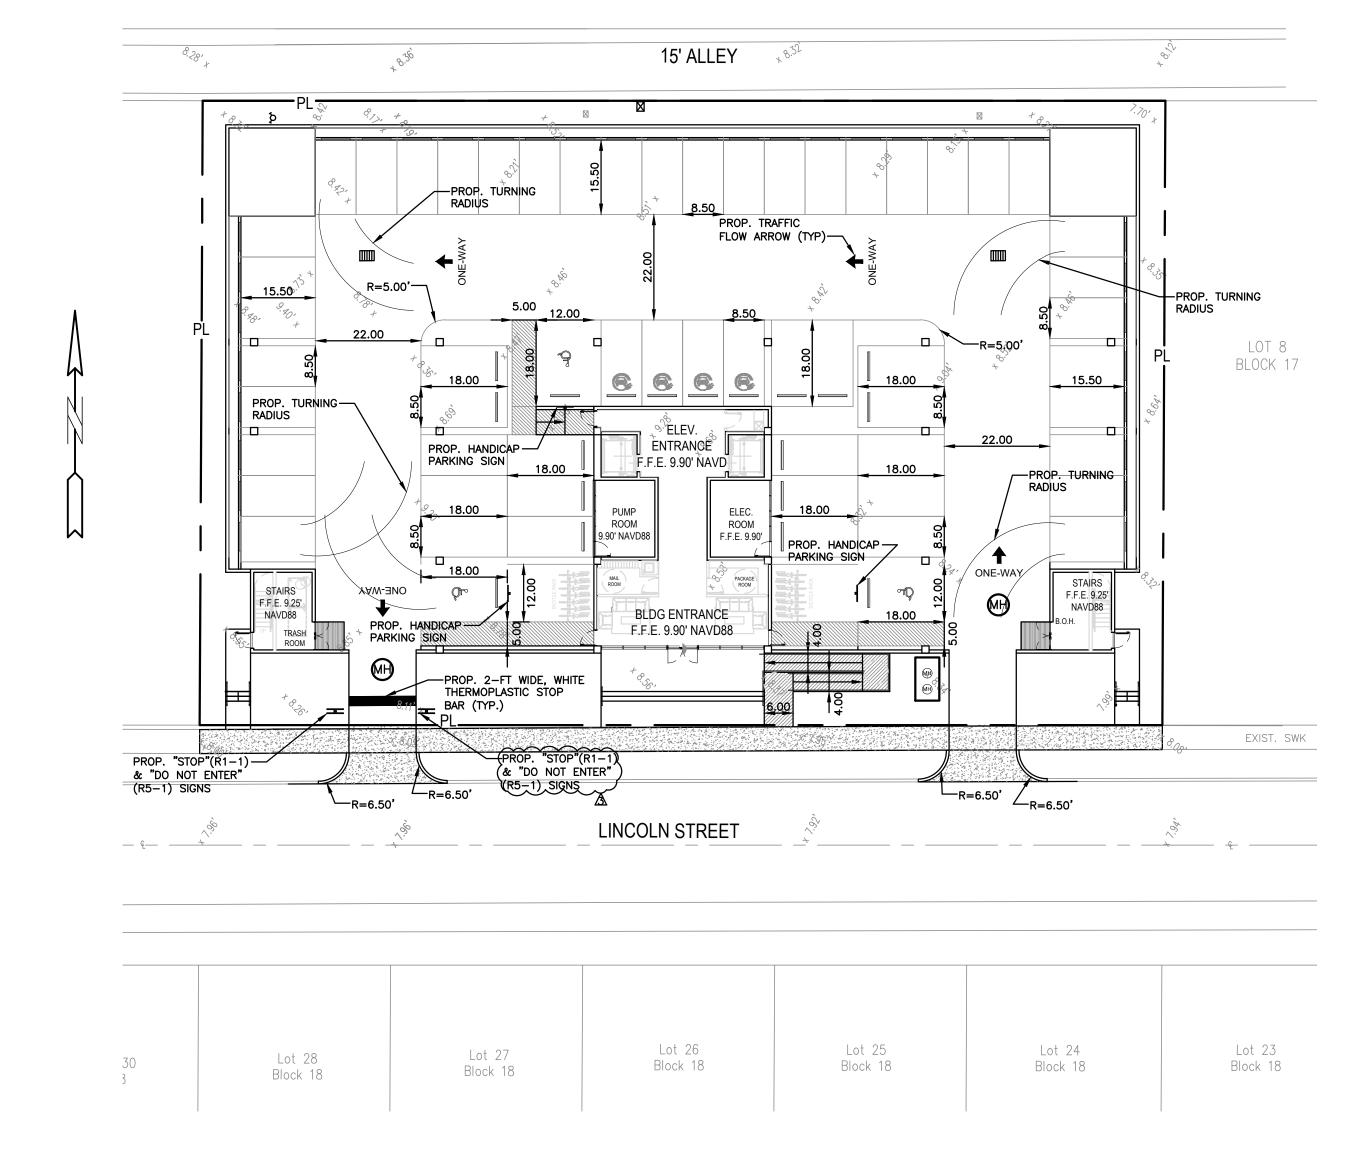

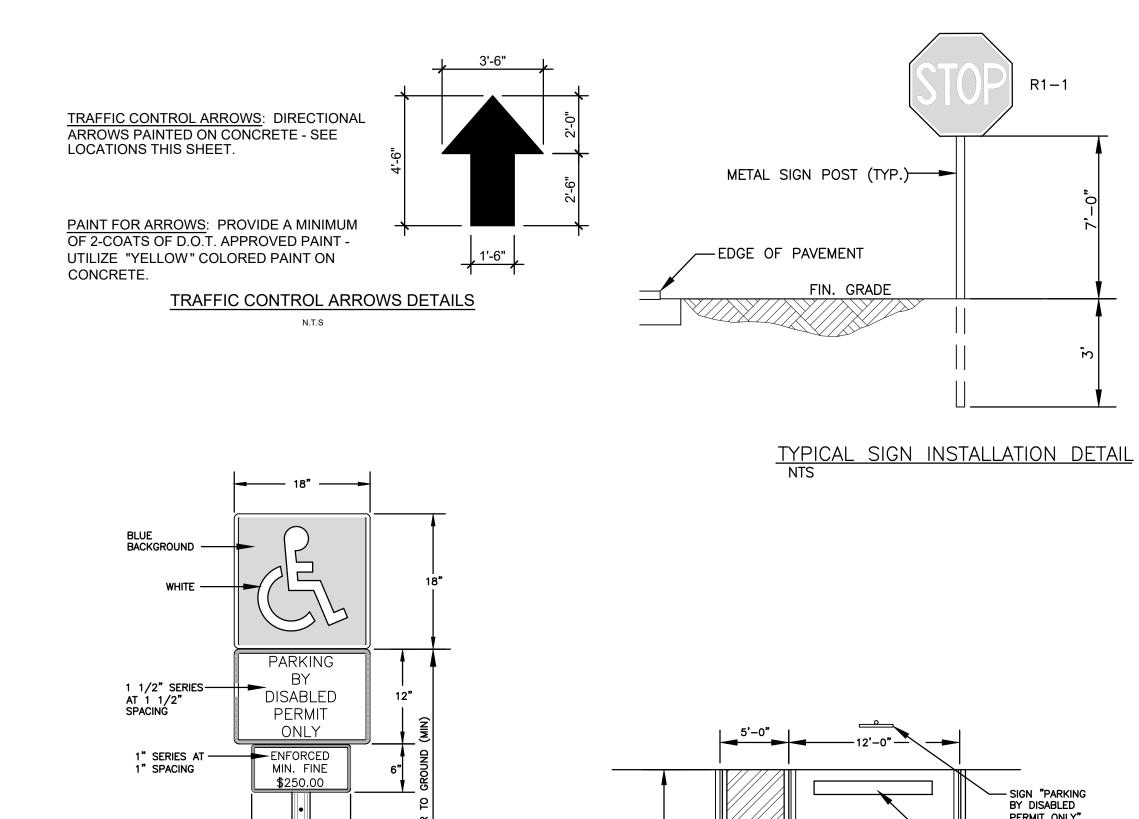

NOTES:

1. TOP PORTION OF SIGN SHALL HAVE A REFLECTORIZED BLUE BACKGROUND.

FINISHED — GRADE

IN CONC.≺ AREAS

2. BOTTOM PORTION OF SIGN SHALL HAVE A REFLECTORIZED WHITE BACKGROUND WITH BLACK OPAQUE LEGEND AND BORDER. 3. LOCATE SIGN AT CENTERLINE AND HEAD OF EACH HANDICAP PARKING STALL, WHERE APPLICABLE.

FTP-26 HANDICAP PARKING SIGN WITH SUPPLEMENTAL 12" x 6" "MINIMUM FINE \$250.00" SIGN

HANDICAP PARKING SIGN DETAIL

IN GRASS AREAS

LEGEND

PROPOSED CONCRETE PROPOSED ASPHALT 8.90 PROPOSED GRADE EXISTING ELEVATION mill PROPOSED CATCH BASIN EXISTING CATCH BASIN

PROPOSED WATER METER

EXISTING WATER VALVE PROPOSED BFP DEVICE


EXISTING FIRE HYDRANT


EXISTING WATER METER EXISTING SAN. SEWER MH



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WATER & SEWER DEMAND CALCULATIONS:

PROJECT INFO:

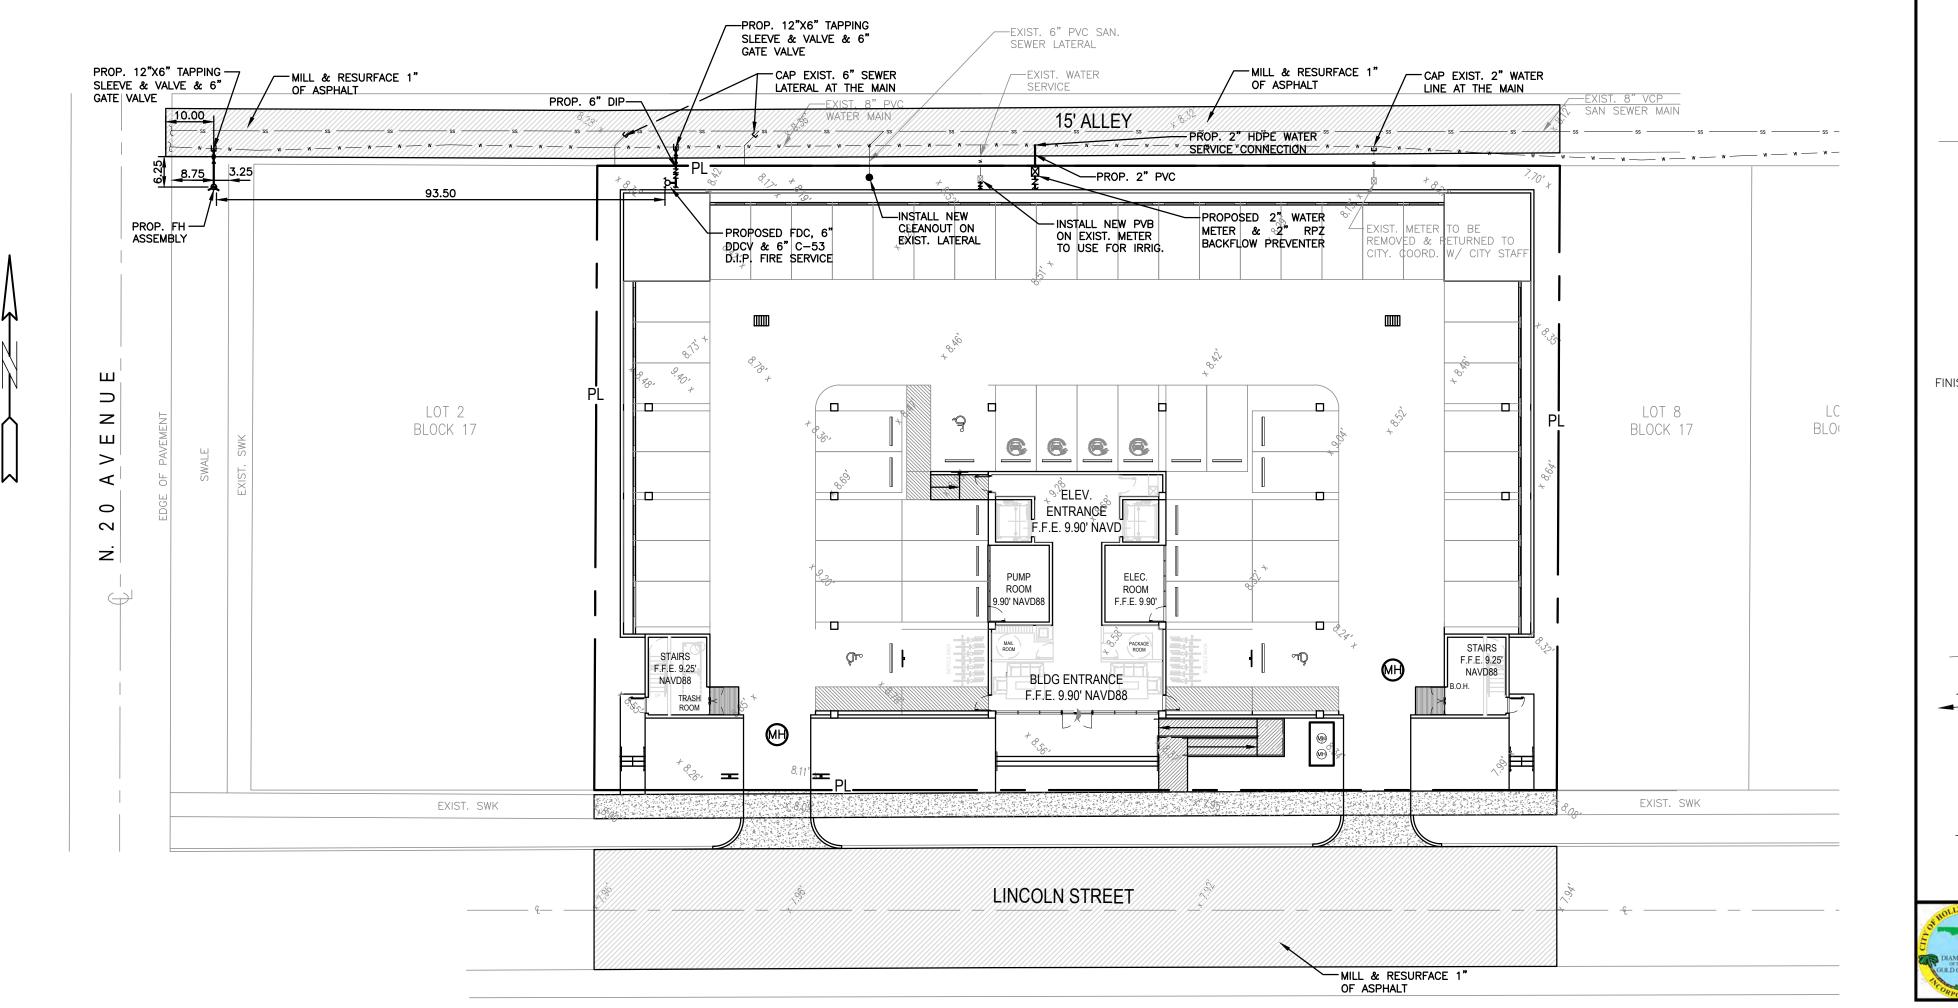48 RESIDENTIAL UNITS

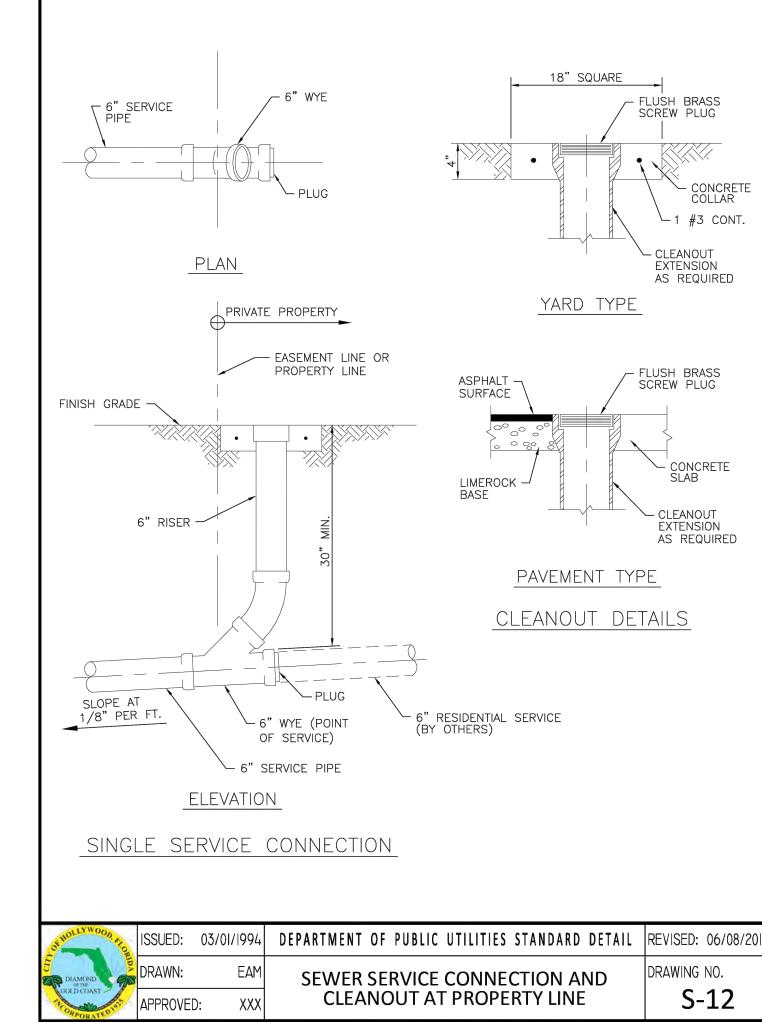(48 RESIDENTIAL UNITS)X(141 GPD/UNIT)=6,768 GPD

WASTEWATER DEMAND

(48 RESIDENTIAL UNITS)X(100 GPD/UNIT)=4,800 GPD

(PER BROWARD COUNTY WATER & WASTEWATER ENGINEERING DIVISION'S GUIDELINE FOR DETERMINING ABILITY TO PROVIDE POTABLE WATER & WASTEWATER SERVICE AND EQUIVALENT RESIDENTIAL UNIT FACTORS PUBLICATIONS)

NOTE:
UNDERGROUND FIRE MAIN WORK WILL BE COMPLETED
BY A CONTRACTOR HOLDING A CLASS I,II, OR V
LICENSE AS DEFINED BY FLORIDA STATUTE 633.102.

No 76036 5-8-23

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WATER & SEWER PLAN & DETAILS

SCALE: 1"=20'

P.E.#:76036 DATE: 11/2/22

SCALE: 1"=20'

LINCOLN S 1935-1951 HOLLYV

NEERING P.E.

ZEPHY

5 OF 6

PROJECT NO.: 22-82

LEGEND

PROPOSED CONCRETE PROPOSED ASPHALT PROPOSED GRADE EXISTING ELEVATION


EXISTING WATER VALVE

PROPOSED BFP DEVICE EXISTING SAN. SEWER MH

EXISTING FIRE HYDRANT

PROPOSED CATCH BASIN EXISTING CATCH BASIN PROPOSED WATER METER EXISTING WATER METER

SCALE: N.T.S.

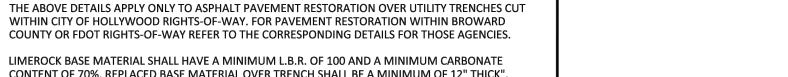

REVISED: 11/06/20

G-12

RAWING NO.

- CONTENT OF 70%. REPLACED BASE MATERIAL OVER TRENCH SHALL BE A MINIMUM OF 12" THICK".
- LIMEROCK BASE MATERIAL SHALL BE PLACED IN 12" MAXIMUM (LOOSE MEASUREMENT) THICKNESS OR TAMPED AND COMPACTED TO 100% OF HE SUCCEEDING LAYERS.

FLEXIBLE PAVEMENT RESTORATION NOTES

WATER SERVICE RISER TO BE

AND BE SECURED TO WALL

W/PIPE CLAMPS, CONNECT

INSTALLED PARALLEL TO WAL

- A MINIMUM L.B.R. OF 40.
- PIPE LAYING CONDITION BUT TESTING WILL BEGIN 12"
- CUT TO STRAIGHT LINES, RFACING.
- LIED A MINIMUM OF TWO
- ASPHALTIC CONCRETE PATCH RMANENT PATCH.
- E LIMEROCK BASE THICKNESS IMPACT, THE ENTIRE ND PROPERTY LINE OR ASPHALTIC CONCRETE THE CITY/ENGINEER.

OPERATING NUT TO BE WITHIN 24" OF FINISH GRADE. INSTALL EXTENSION IF REQUIRED	6" MIN. VALVE BOX (REFE STANDARD DETAIL	5. BACKFILL SHALL BE PLACED AND COMPACTED IN ACCORDANCE WITH THE PIPE LA TYPICAL SECTIONS IN DETAILS G-02 AND G-03, AND THE SPECIFICATIONS, BUT TE: ABOVE THE INSTALLED FACILITY. 6. ALL EDGES AND JOINTS OF EXISTING ASPHALT PAVEMENT SHALL BE SAW CUT TO PARALLEL TO OR PERPENDICULAR TO THE ROADWAY, PRIOR TO THE RESURFACING	STR. G. TIC (ENT TOPER LITIC
	DEPARTMENT OF PUBLIC UTILITIES STANDARD DETAIL F	EVISED: 06/08/2014	
ISSUED: 03/01/1994			: I A I
ISSUED: 03/01/1994 DRAWN: EAM	TYPICAL GATE VALVE AND VALVE BOX SETTING	RAWING NO. G-07 ISSUED: 03/01/1994 DEPARTMENT OF PUBLIC UTILITIES STANDARD DI PRAWN: EAM FLEXIBLE PAVEMENT RESTORATION	_

—SAW-CUT AND MATCH

EXISTING PAVEMENT


-24"x24"x8" THICK

CONCRETE COLLAR

1" BELOW GRADE

ALL AROUND FOR

PAVED AREAS ONLY

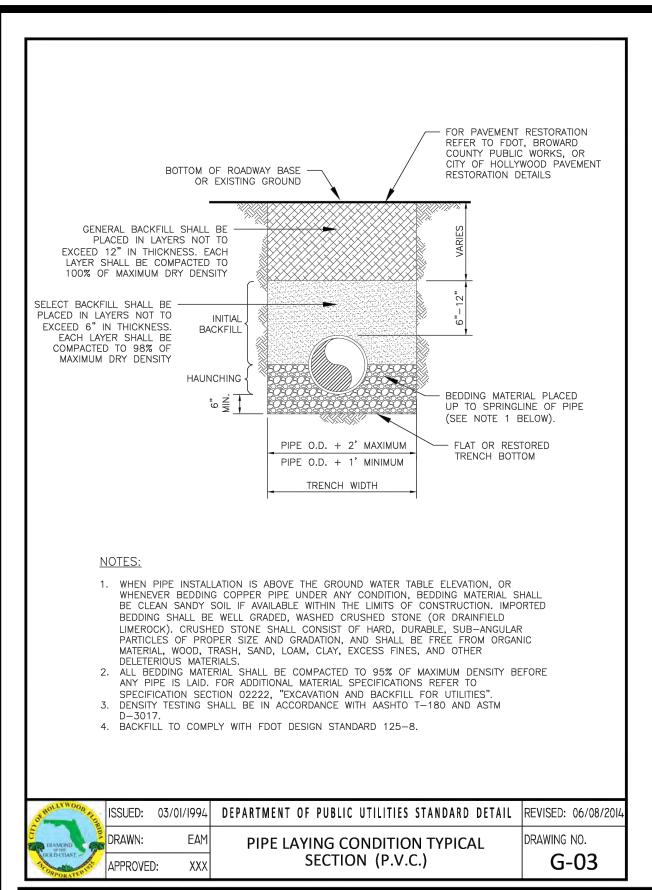

VARIES

PLAN

- 16"X16"X16'

SUPPORT

ITEM QTY. DESCRIPTION

12 | 1 | 4", 6", 8" TEE

14 1 4", 6", 8" CAP

RESTRAINED JOINTS

LOW FLOW METER

CONC.

ELEVATION

MATERIALS

12"

—4" GUARD POST (SEE)

NOTE 4 BELOW AND

FLOW

NOTES:

ITEM QTY. DESCRIPTION

INSPECTOR'S DIRECTIONS.

4",6",8" VALVE,DOUBLE CHECK

4",6",8" D.I.P. SPOOL PIECE(24" LONG)

2. ALL PIPING SHALL BE D.I.P. CL 50/52 AS APPLICABLE TO MINIMUM STANDARDS.

4",6",8" GATE VALVE (SEE NOTE 6)

4",6",8" D.I.P. SPOOL PIECE

4",6",8" BEND-90°

N/A PEA GRAVEL (4" DEEP)


4",6",8" FLANGE, D.I.P.

SCREW JACK/ANCHORED

1. FIELD ADJUST AND CUT ITEM 3 TO THE PROPER LENGTH.

. ALL LOW FLOW METER PIPING SHALL BE BRASS OR COPPER.

DETAIL ON SHEET W-03)

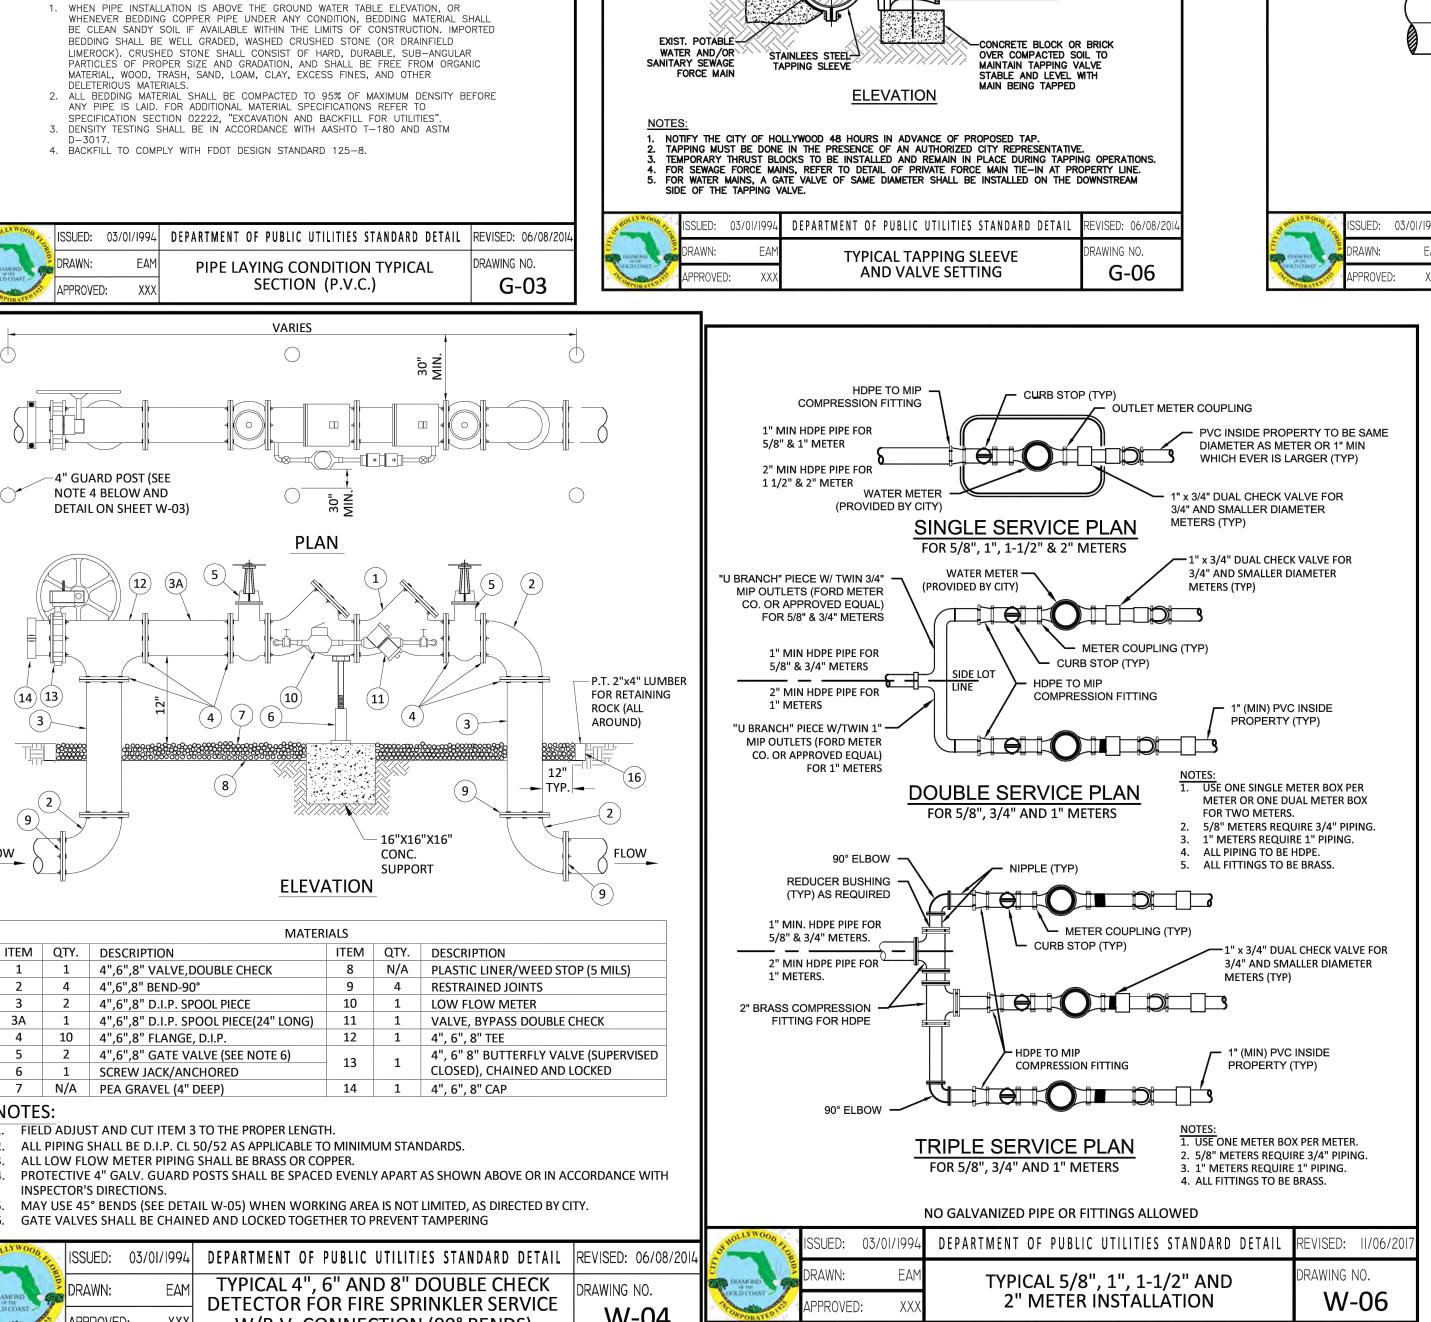

-SAW-CUT AND MATCH

24"x24"x8" THICK CONCRETE COLLAR 1" BELOW WIR FOR

ALL AROUND FOR PAVED AREAS ONLY


EXISTING PAVEMENT

STANDARD DETAIL G-05)

24"x24"x8" THICK CONCRETE-

IN UNPAVED AREAS ONLY

OR PAVEMENT

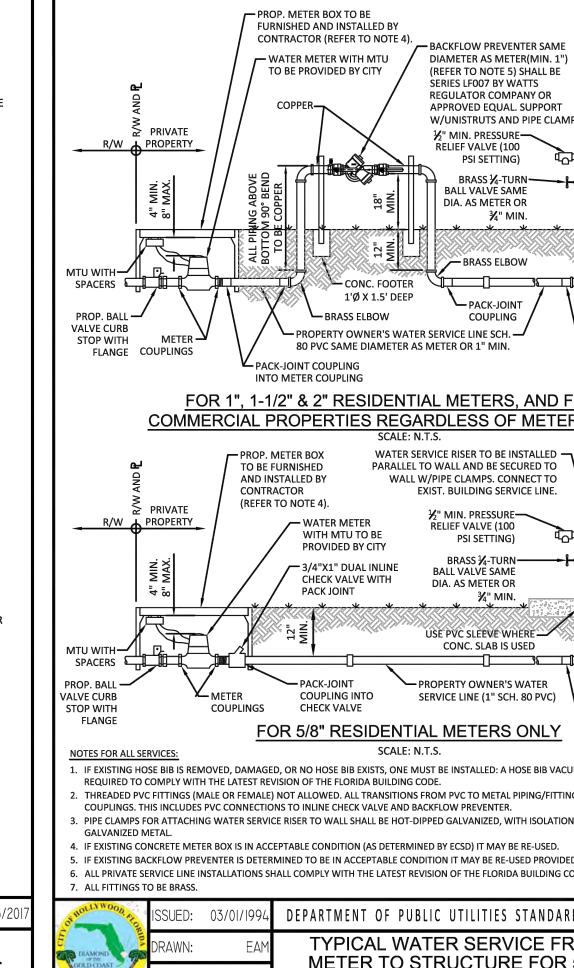

24"x24"x8" THICK-

CONCRETE COLLAR


UNPAVED AREAS ONLY

FINISHED-

GRADE OR

PAVEMENT

ALL AROUND FOR

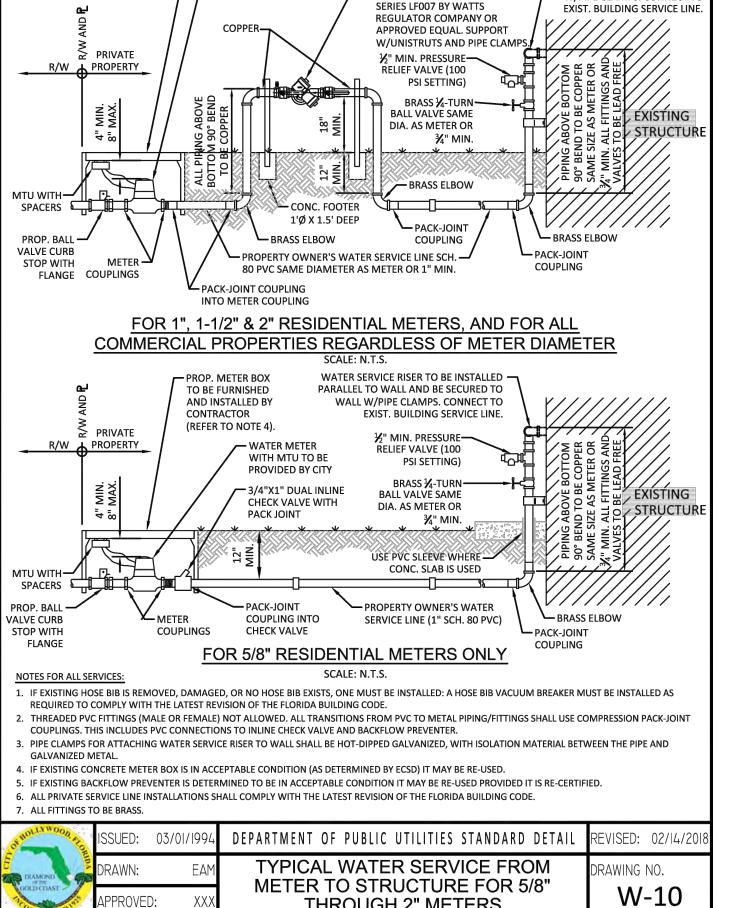

1. IF EXISTING HOSE BIB IS REMOVED, DAMAGED, OR NO HOSE BIB EXISTS, ONE MUST BE INSTALLED: A HOSE BIB VACUUM BREAKER MUST BE INSTALLED AS
REQUIRED TO COMPLY WITH THE LATEST REVISION OF THE FLORIDA BUILDING CODE.
2. THREADED PVC FITTINGS (MALE OR FEMALE) NOT ALLOWED. ALL TRANSITIONS FROM PVC TO METAL PIPING/FITTINGS SHALL USE COMPRESSION PACK-JOINT
COUPLINGS. THIS INCLUDES PVC CONNECTIONS TO INLINE CHECK VALVE AND BACKFLOW PREVENTER.

HULLIA MOOD SEE	ISSUED:	03/01/1994	DEPARTMENT OF PUBLIC UTILITIES STANDARD DETAIL	REVISE
DIAMOND	DRAWN:	EAM	TYPICAL WATER SERVICE FROM METER TO STRUCTURE FOR 5/8"	DRAWII
ORPORATEDIST.	APPROVED): XXX	THROUGH 2" METERS	\

SCALE: N.T.S.

GATE VALVES SHALL BE CHAINED AND LOCKED TOGETHER TO PREVENT TAMPERING ISSUED: 03/01/1994| DEPARTMENT OF PUBLIC UTILITIES STANDARD DETAIL |REVISED: 06/08/20 TYPICAL 4", 6" AND 8" DOUBLE CHECK DRAWING NO. DETECTOR FOR FIRE SPRINKLER SERVICE W-04 W/B.V. CONNECTION (90° BENDS)

MAY USE 45° BENDS (SEE DETAIL W-05) WHEN WORKING AREA IS NOT LIMITED, AS DIRECTED BY CITY.





THIS ITEM HAS BEEN DIGITALLY SIGNED AND SEALED BY WILFORD ZEPHYR ON THE DATE ADJACENT TO THE SEAL.

PRINTED COPIES OF THIS DOCUMENT ARE NOT CONSIDERED SIGNED AND SEALED AND THE SIGNATURE MUST BE VERIFIED ON ANY ELECTRONIC COPIES.

5-8-23

SHEET NO.: 6 OF 6 PROJECT NO.: 22-82

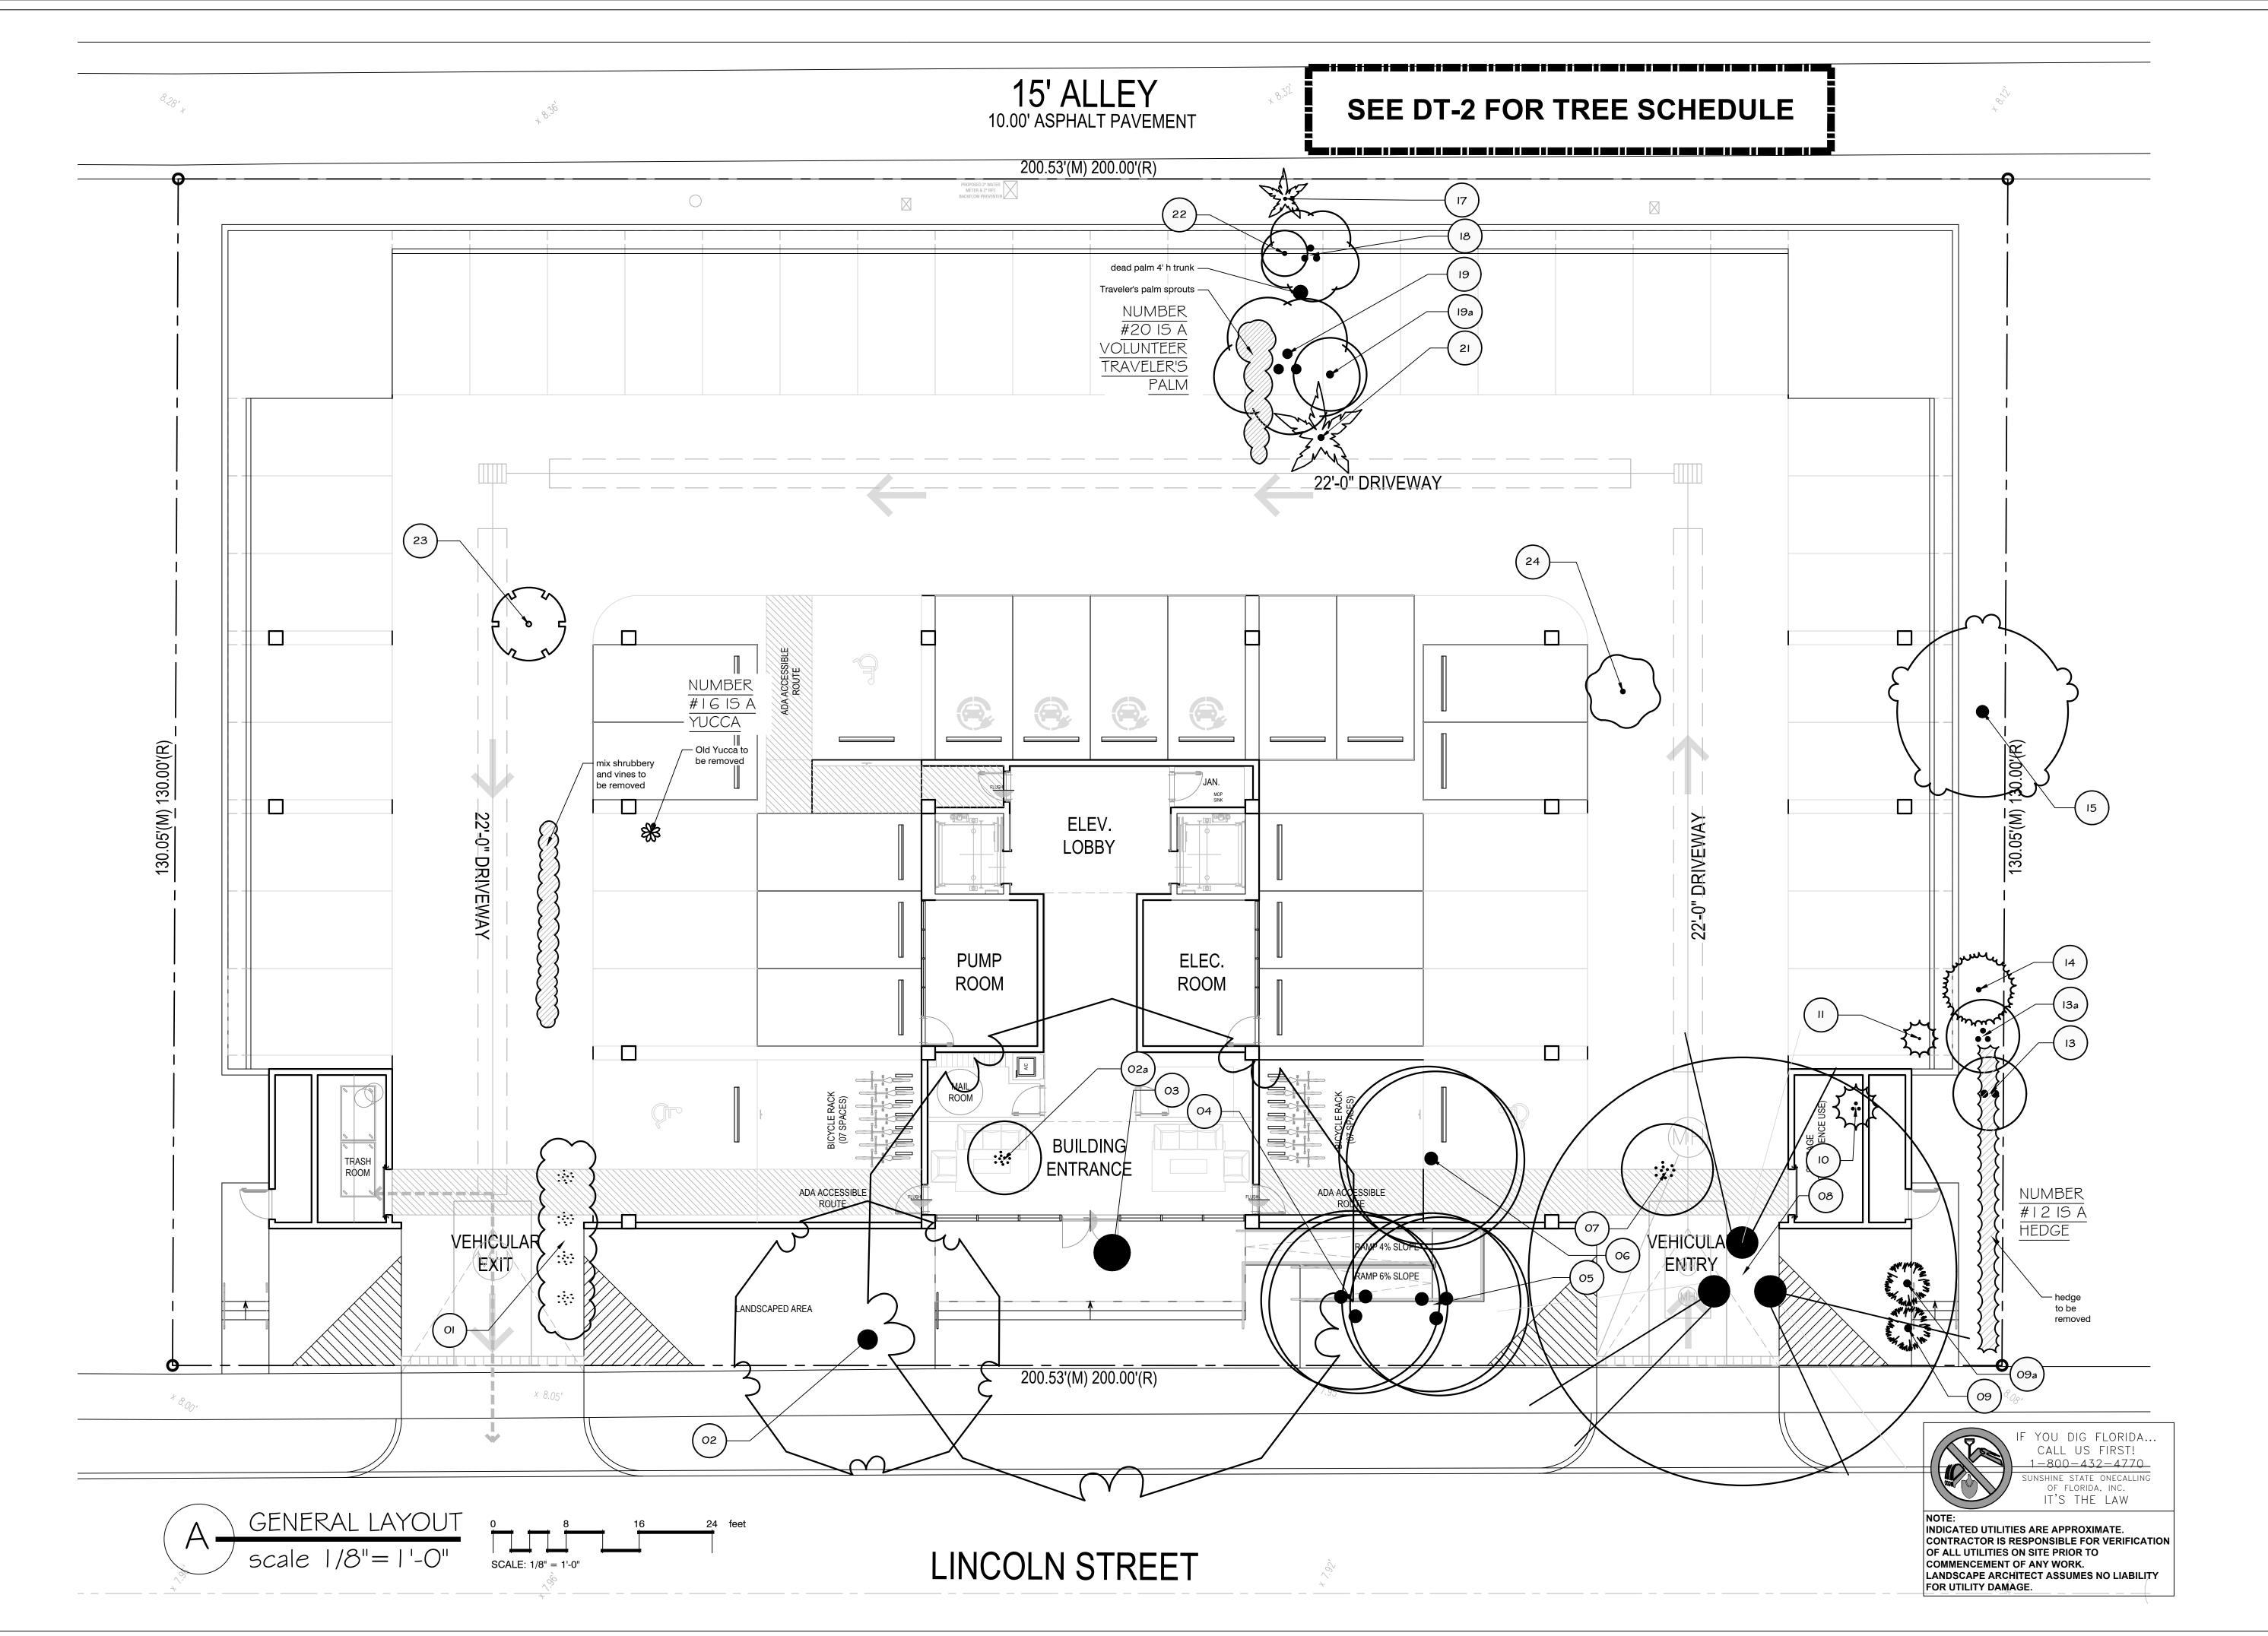

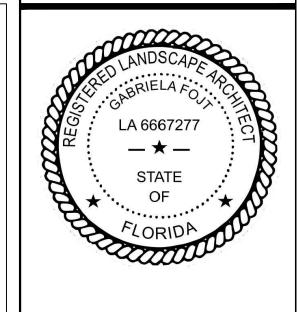


The Mirror of Paradise

Gabriela Fojt LA 6667277 LC 26000628

2881 E Oakland Park Blvd Fort Lauderdale FL 33306 p (954) 315 1707 c (954) 478 3064

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per city comments /	1 03.15.2023
per city comments /	<u>2</u> 04.28.2023

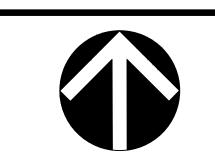1935, 1947, 1951 Lincoln : Hollywood Florida

DT -1 OF 2



TREES AND PALMS SHALL NOT BE REMOVED WITHOUT FIRST OBTAINING AN APPROVED TREE REMOVAL PERMIT FROM THE **CITY OF HOLLYWOOD**

NUMBERS WITH 'a' DESIGNATE TREES NOT INDICATED ON TREE SURVEY. NUMBERS 12, 16 & 20 ON SURVEY CORRESPOND IN REALITY TO PLANTS THAT ARE NOT TREES


TO BE REMOVED:

- 117.5"dbh
- 14 qualifying palms

PROVIDED AS MITIGATOIN 3 ADONIDIA PALMS 8'CT FOR 3 OF REMOVED ADONIDIAS. REMAINING MITIGATION TO BE PAID TO CITY TREE FUND:

- 117.5"/2"=58.75 x \$350=\$20,562.5 for hardwood
- 11 x \$350=\$3,850

TOTAL TO BE PAID **\$24,412.5**

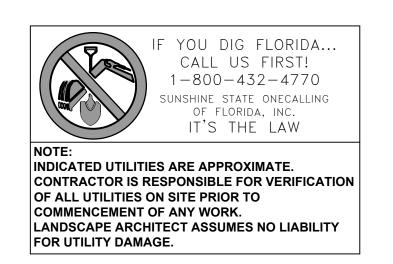




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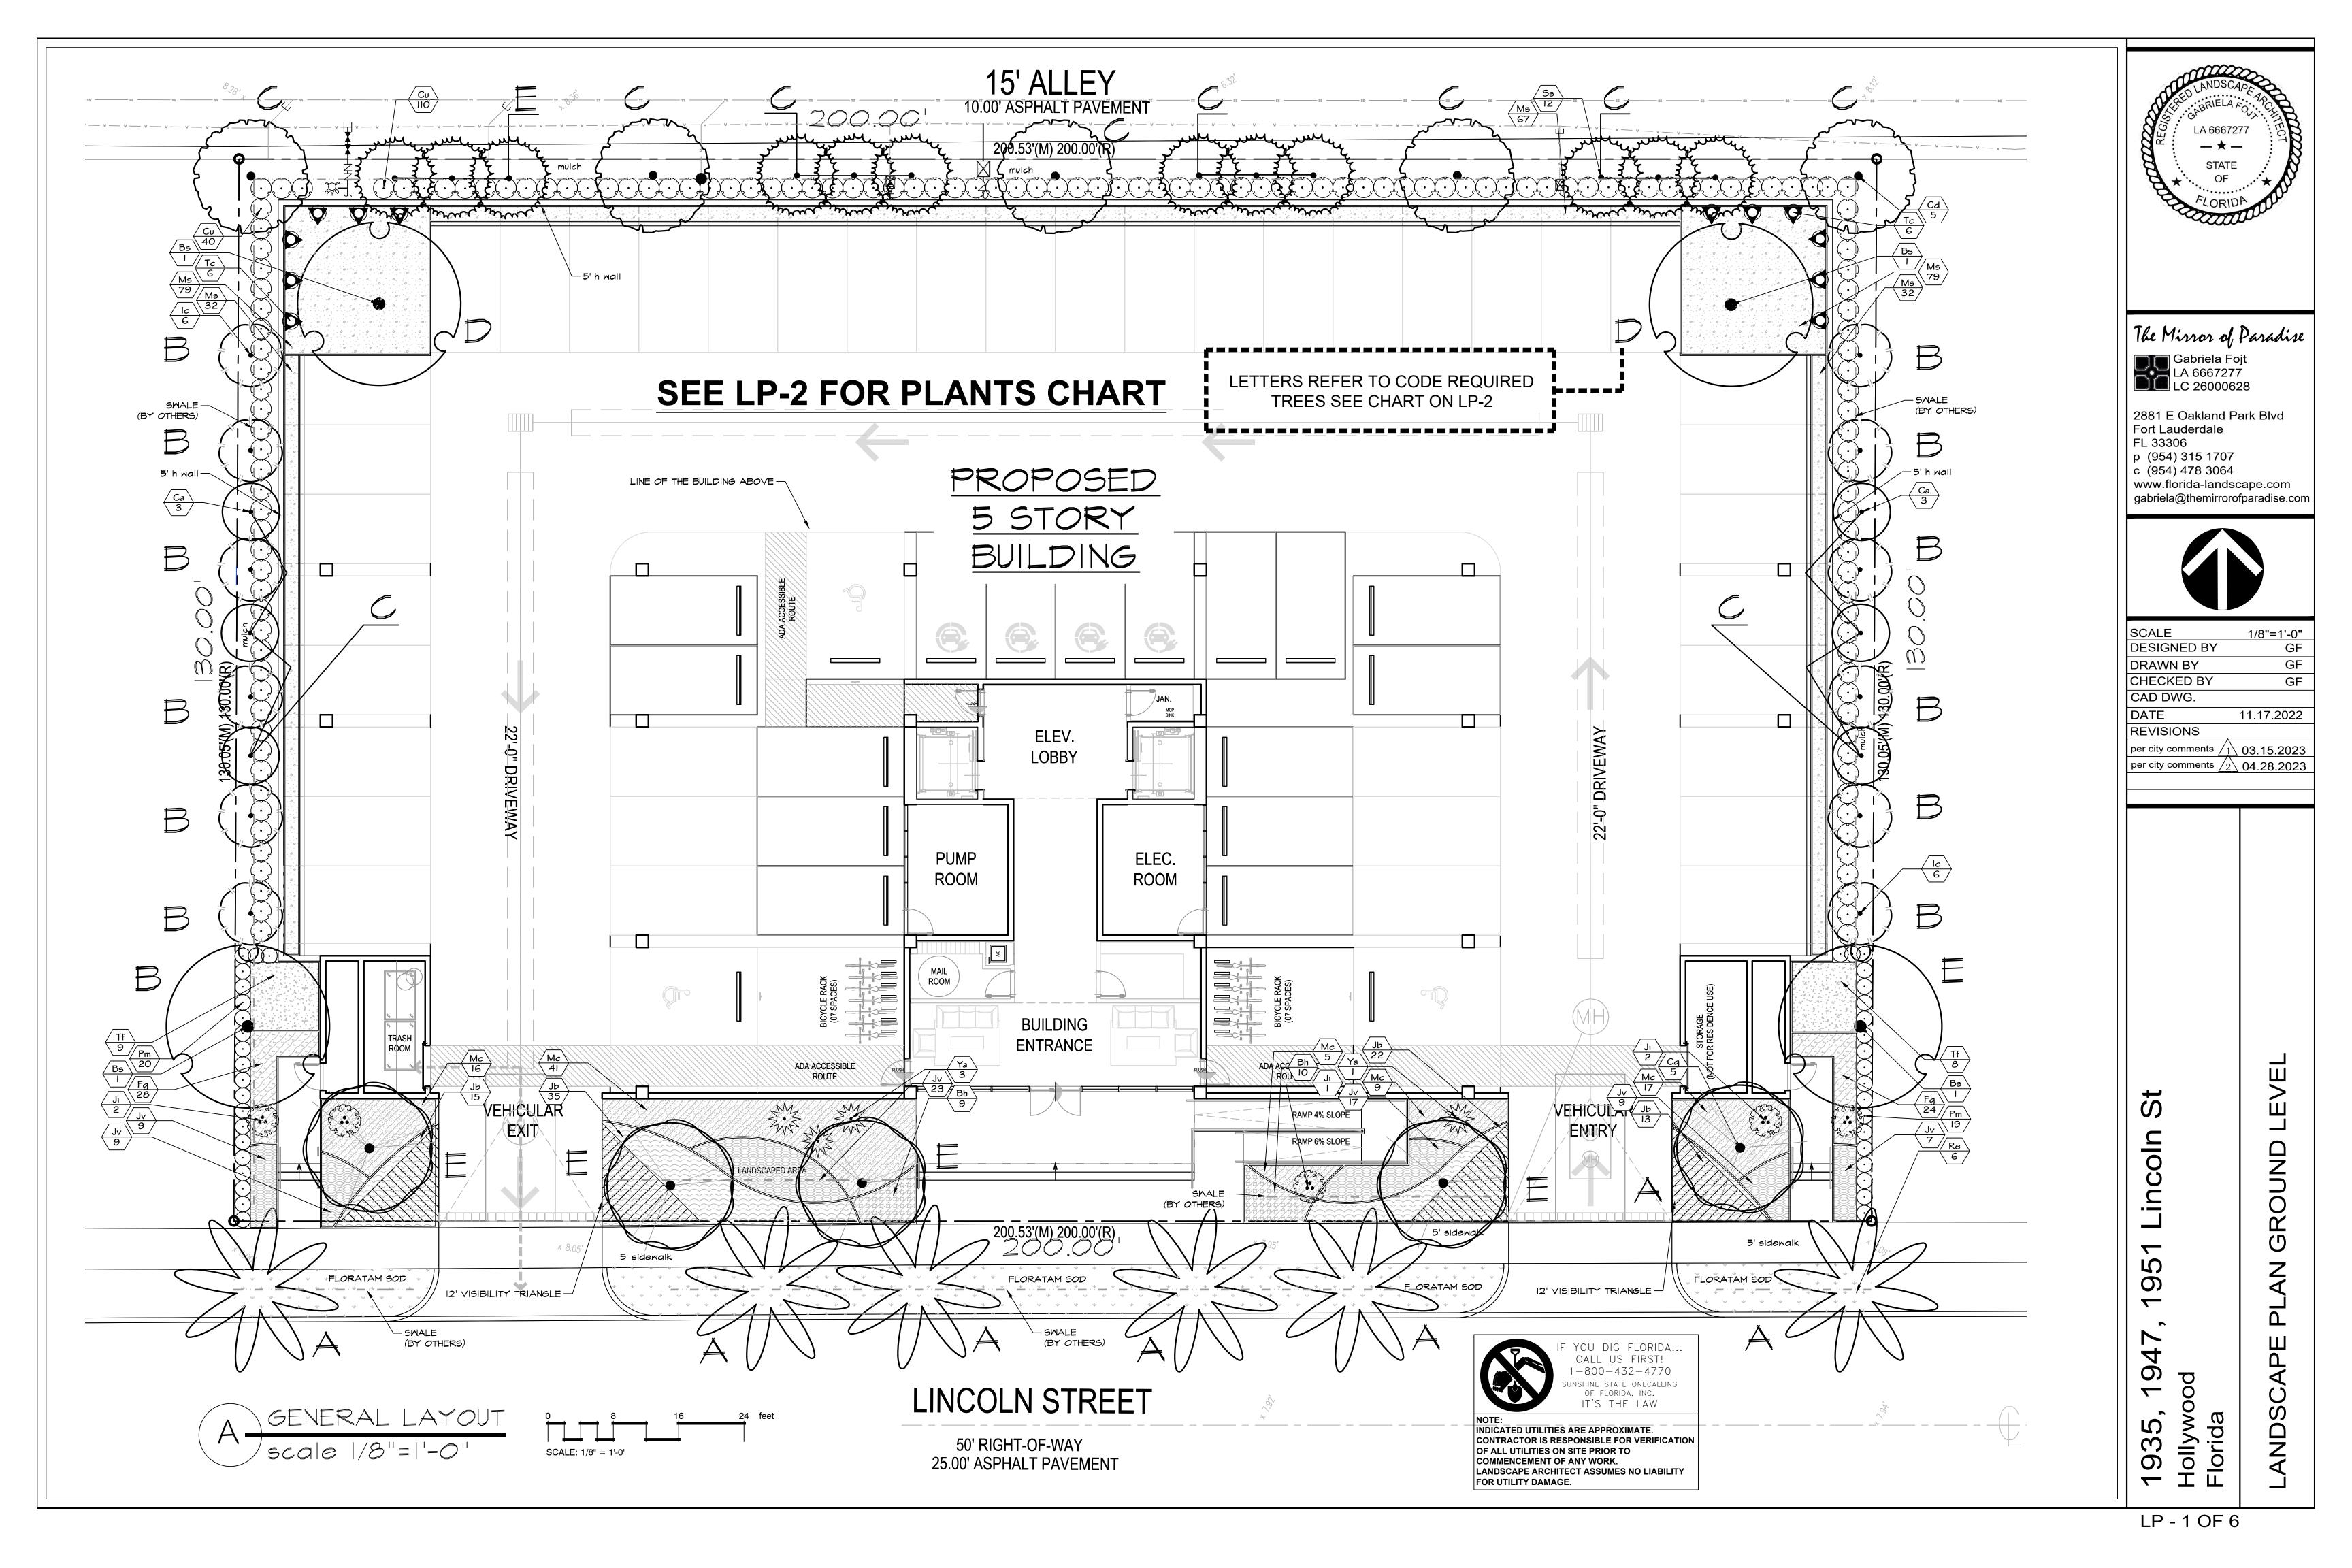


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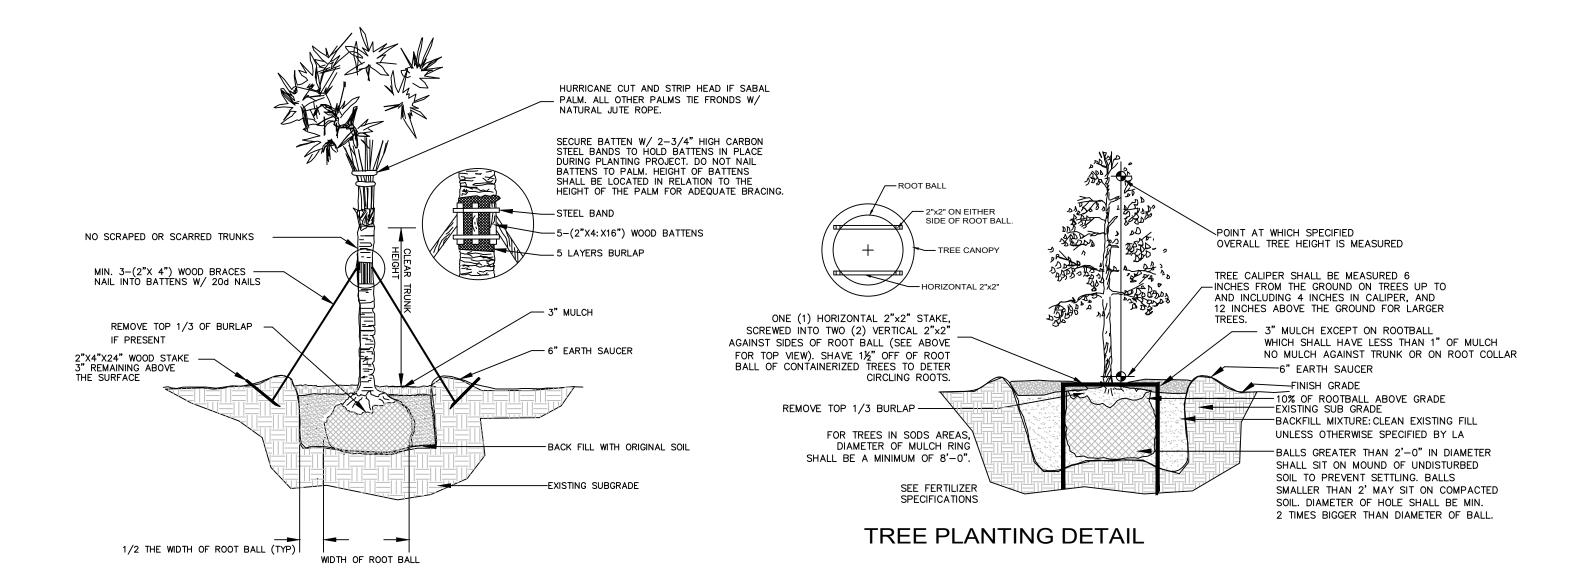
CHART


1935, Hollywd Florida

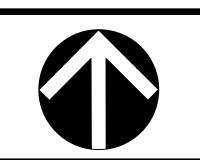


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PLANT SCH	IEDUL	E GR	OUND LEVEL					
TREES	CODE	<u>QTY</u>	BOTANICAL NAME	COMMON NAME	SIZE	SPACING	NATIVE	DROUGHT RESIST.
(·)	Bs	4	Bursera simaruba	Gumbo Limbo	12` x 4`-5`spr, 2"dbh	AS SHOWN	YES	HIGH
	Cg	5	Caesalpinia granadillo	Bridal Veil Tree	12` x 4`-5`spr, 2"dbh, matched	AS SHOWN	NO	HIGH
(\cdot)	Са	6	Carpentaria acuminata	Carpentaria Palm	12`-14`CT, matched	AS SHOWN	NO	HIGH
	Cd	5	Coccoloba diversifolia	Pigeon Plum	12` x 4`spr, 2"dbh, matched	AS SHOWN	YES	HIGH
	lc	12	llex cassine	Dahoon Holly	12` x 4`spr, 2"dbh, matched	AS SHOWN	YES	HIGH
No.	Re	6	Roystonea elata	Florida Royal Palm	8` CT matched	AS SHOWN	YES	HIGH
A CONTRACTOR OF THE CONTRACTOR	Ss	12	Sabal palmetto	Cabbage Palmetto	8` CT matched	AS SHOWN	YES	HIGH
SHRUBS	CODE	<u>QTY</u>	BOTANICAL NAME	COMMON NAME	SIZE	SPACING	<u>NATIVE</u>	DROUGHT RESIST.
	Cu	150	Coccoloba uvifera	Sea Grape	3gal, 2`x2`, ftb	30"OC	YES	HIGH
2. 2. 2. 2. 2. 2. 2. 2. 2. 2. 2. 2. 2. 2	Ji	5	Jatropha integerrima	Spicy Jatropha	6` x 3`-4`spr, multi	AS SHOWN	NO	HIGH
\odot	Pm	39	Podocarpus macrophyllus 'Maki'	Maki Podocarpus	3 gal, 2` x 1`spr, ftb	24"OC	NO	HIGH
Δ	Тс	12	Trachelospermum jasminoides 'Confederate'	Confederate Jasmine	3 gal, 30" x 12", full, trellis	AS SHOWN	NO	HIGH
Z.	Ya	4	Yucca aloifolia	Spanish bayonett	3`-4`OA, multi	AS SHOWN	YES	HIGH
SHRUB AREAS	CODE	<u>QTY</u>	BOTANICAL NAME	COMMON NAME	SIZE	SPACING	NATIVE	DROUGHT RESIST.
999999 949499 949999 949999	Bh	19	Bougainvillea x 'Helen Johnson'	Helen Johnson Compact Bougainvillea	1.5` x 1.5`, full	24"OC	NO	HIGH
	Fg	52	Ficus microcarpa 'Green Island'	Green Island Indian Laurel Fig	10"-12" x 10"-12", full	18"OC	NO	HIGH
	Jv	74	Jasminum volubile	Wax Jasmine	1.5` x 1.5`, full	24"OC	NO	HIGH
	Jb	85	Juniperus conferta 'Blue Pacific'	Blue Pacific Shore Juniper	12" x 12", full	30"OC	NO	HIGH
	Мс	88	Muhlenbergia capillaris	Pink Muhly Grass	12"-24" x 12"	30"OC	YES	HIGH
	Tf	17	Tripsacum dactyloides	Fakahatchee Grass	30" x 18"	36"OC	YES	HIGH
GROUND COVERS	CODE	<u>QTY</u>	BOTANICAL NAME	COMMON NAME	SIZE	<u>SPACING</u>	NATIVE	DROUGHT RESIST.
	Ms	289	Mimosa strigillosa	Sunshine Mimosa	1 gal, 6"-10"spr	24"OC	YES	HIGH
* * * * * * * * * * * * * * * * * * *	Sr	908 sf	Stenotaphrum secundatum	St Agustine sod	sod			



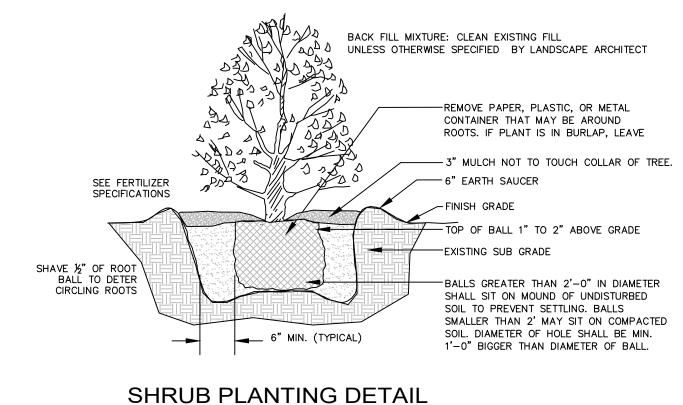

PALM PLANTING DETAIL

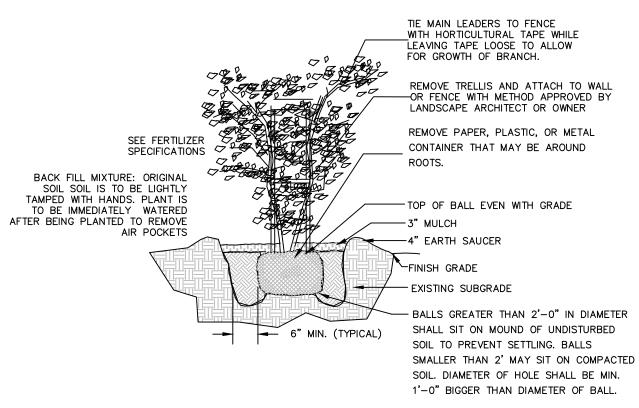

VINE PLANTING DETAIL

- SOD AS INDICATED.
- 2. MULCH ALL BEDS AS INDICATED ON DETAIL. 3. IT IS THE CONTRACTOR'S RESPONSIBILITY TO VERIFY PLANT, SOD AND MULCH
- AMOUNTS FOR BIDDING PURPOSES.
- 4. PLAN DRAWING TAKES PRECEDENCE OVER ANY QUANTITY SCHEDULES.

ode letter	Code requirement	Required	Proposed	Provided
	Perimeter landscape			
Α	Street tree - one 12'OA tree/each 30 If of street frontage	200 lf/30= 7 trees	6 Royal palms, 1 Bridal veil	7 provided
В	Residential buffer - one tree/each 20 If of perimeter	260 lf/20= 13 trees	1 Gumbo, 12 Holly	13 provided
С	Abutting residential across an alley -one tree/each 20 If	200lf/20= 10 trees	6 Carentaria (2 trees), 5 Pigeon, 9 Sabals (3 trees)	10 provided
	VUA landscape			
D	Terminal islands - 1 tree	2 trees	2 Gumbo limbo	2 provided
	Open space			
E	1 tree per 1,000 sf of pervious area of property: 6,020 sf	7 trees	4 Bridalveil, 3 Sabals (1 tree), 1 Gumbo, 3 Adonidia (1 tree)	7 provided
	Min. 20% of site to be landscaped (5,200 sf)	5,200 sf	6,020 sf	6,020 sf provide
	60% of required trees to be native (39 x .6=23.4)	24 native trees	21 trees, 6 palms 1:1, 12 palms 3:1	31 trees provide
	No more than 50% of trees to be palms (3:1 count)	max. 20 trees to be substituted by palms		10 provided
	Automated irrigation to provide 100%+ coverage		100% coverage irrigation	provided
M	Mitigation trees		3 8'CT Adonidia palms	3 palms provide




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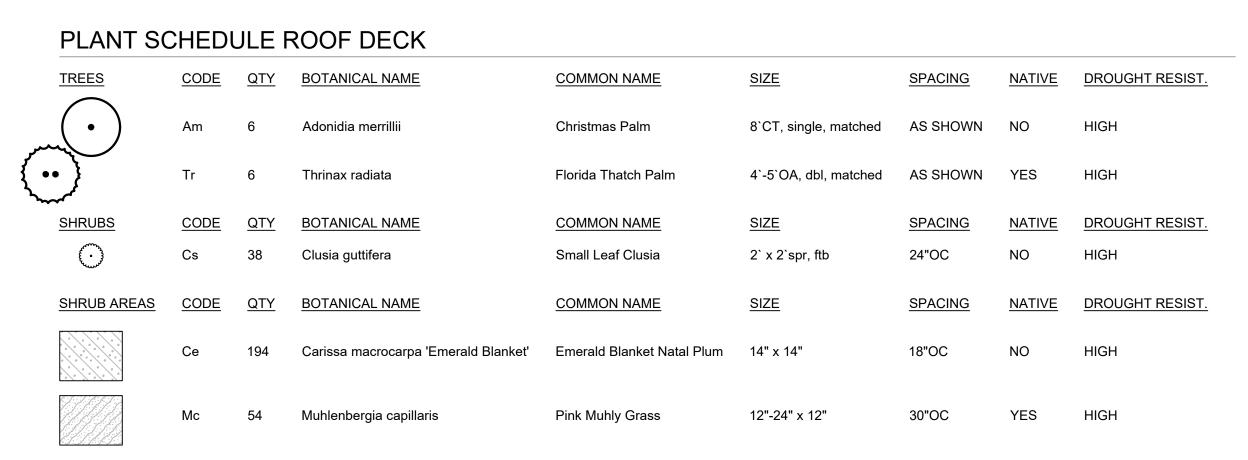
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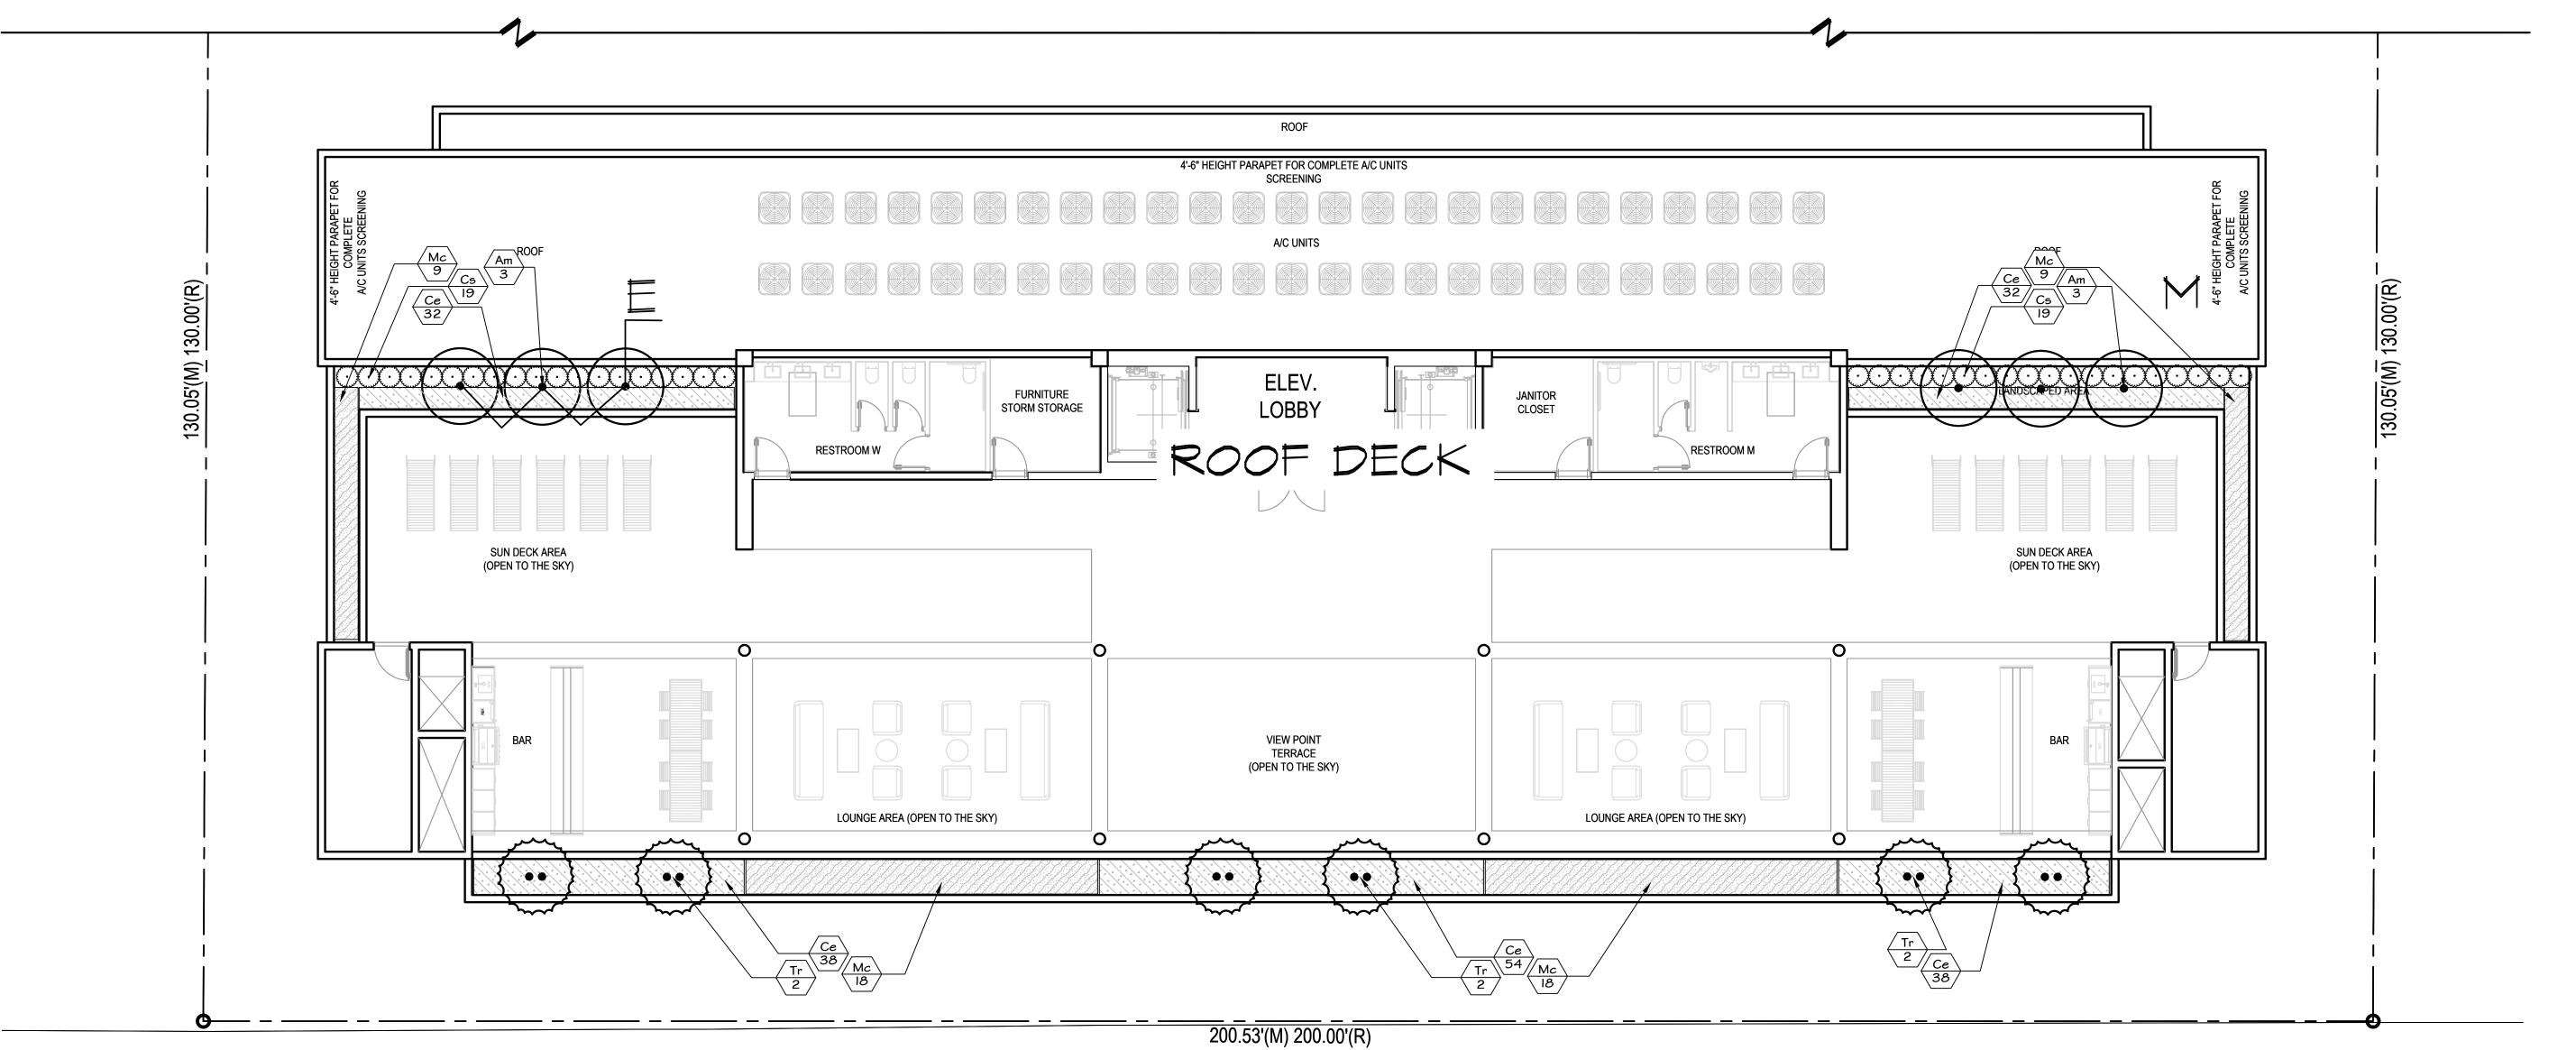
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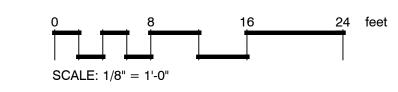
Hollywd Florida



- 1. MULCH ALL BEDS AS INDICATED ON DETAIL.
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- 3. PLAN DRAWING TAKES PRECEDENCE OVER ANY QUANTITY SCHEDULES.



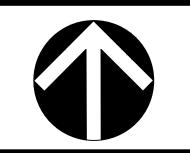



LINCOLN STREET

50' RIGHT-OF-WAY 25.00' ASPHALT PAVEMENT



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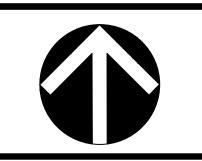
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SCHEDUL

ROOF ANDSCAPE

Hollywo Florida

IF YOU DIG FLORIDA..

<u>CALL US FIRST!</u>

SUNSHINE STATE ONECALLING OF FLORIDA, INC. IT'S THE LAW


INDICATED UTILITIES ARE APPROXIMATE.

OF ALL UTILITIES ON SITE PRIOR TO

CONTRACTOR IS RESPONSIBLE FOR VERIFICATION

COMMENCEMENT OF ANY WORK.

LANDSCAPE ARCHITECT ASSUMES NO LIABILITY
FOR UTILITY DAMAGE.

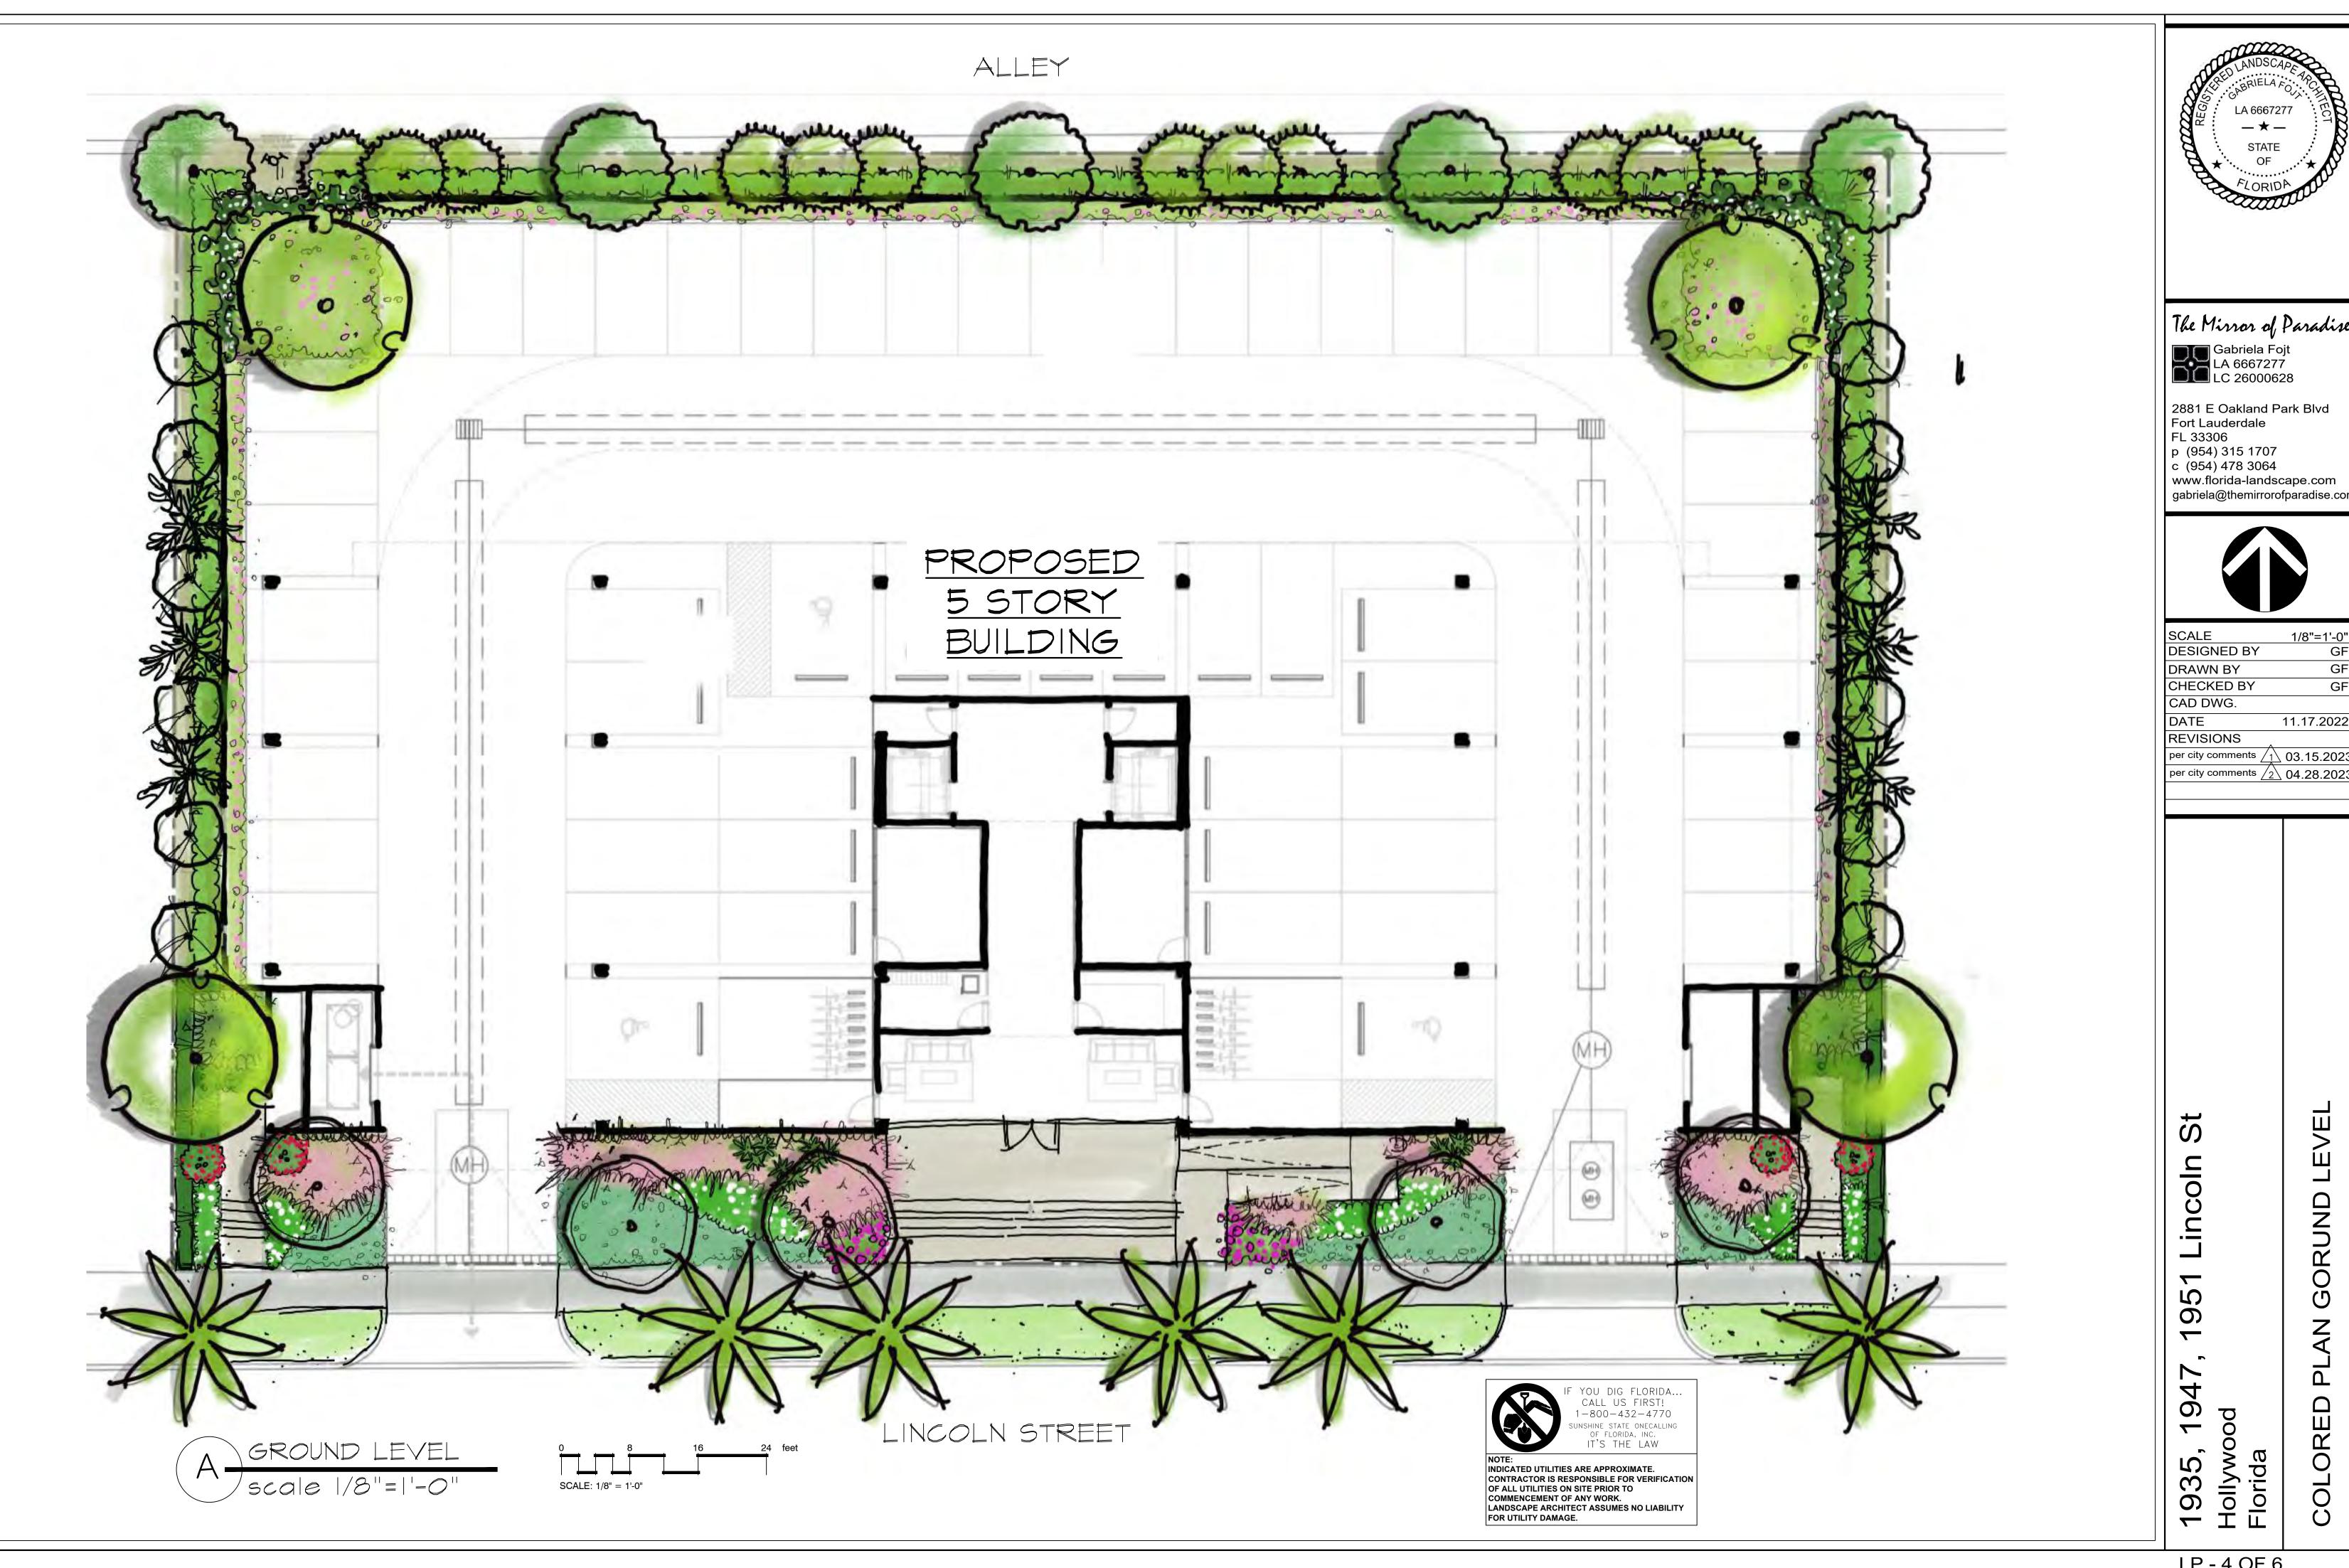


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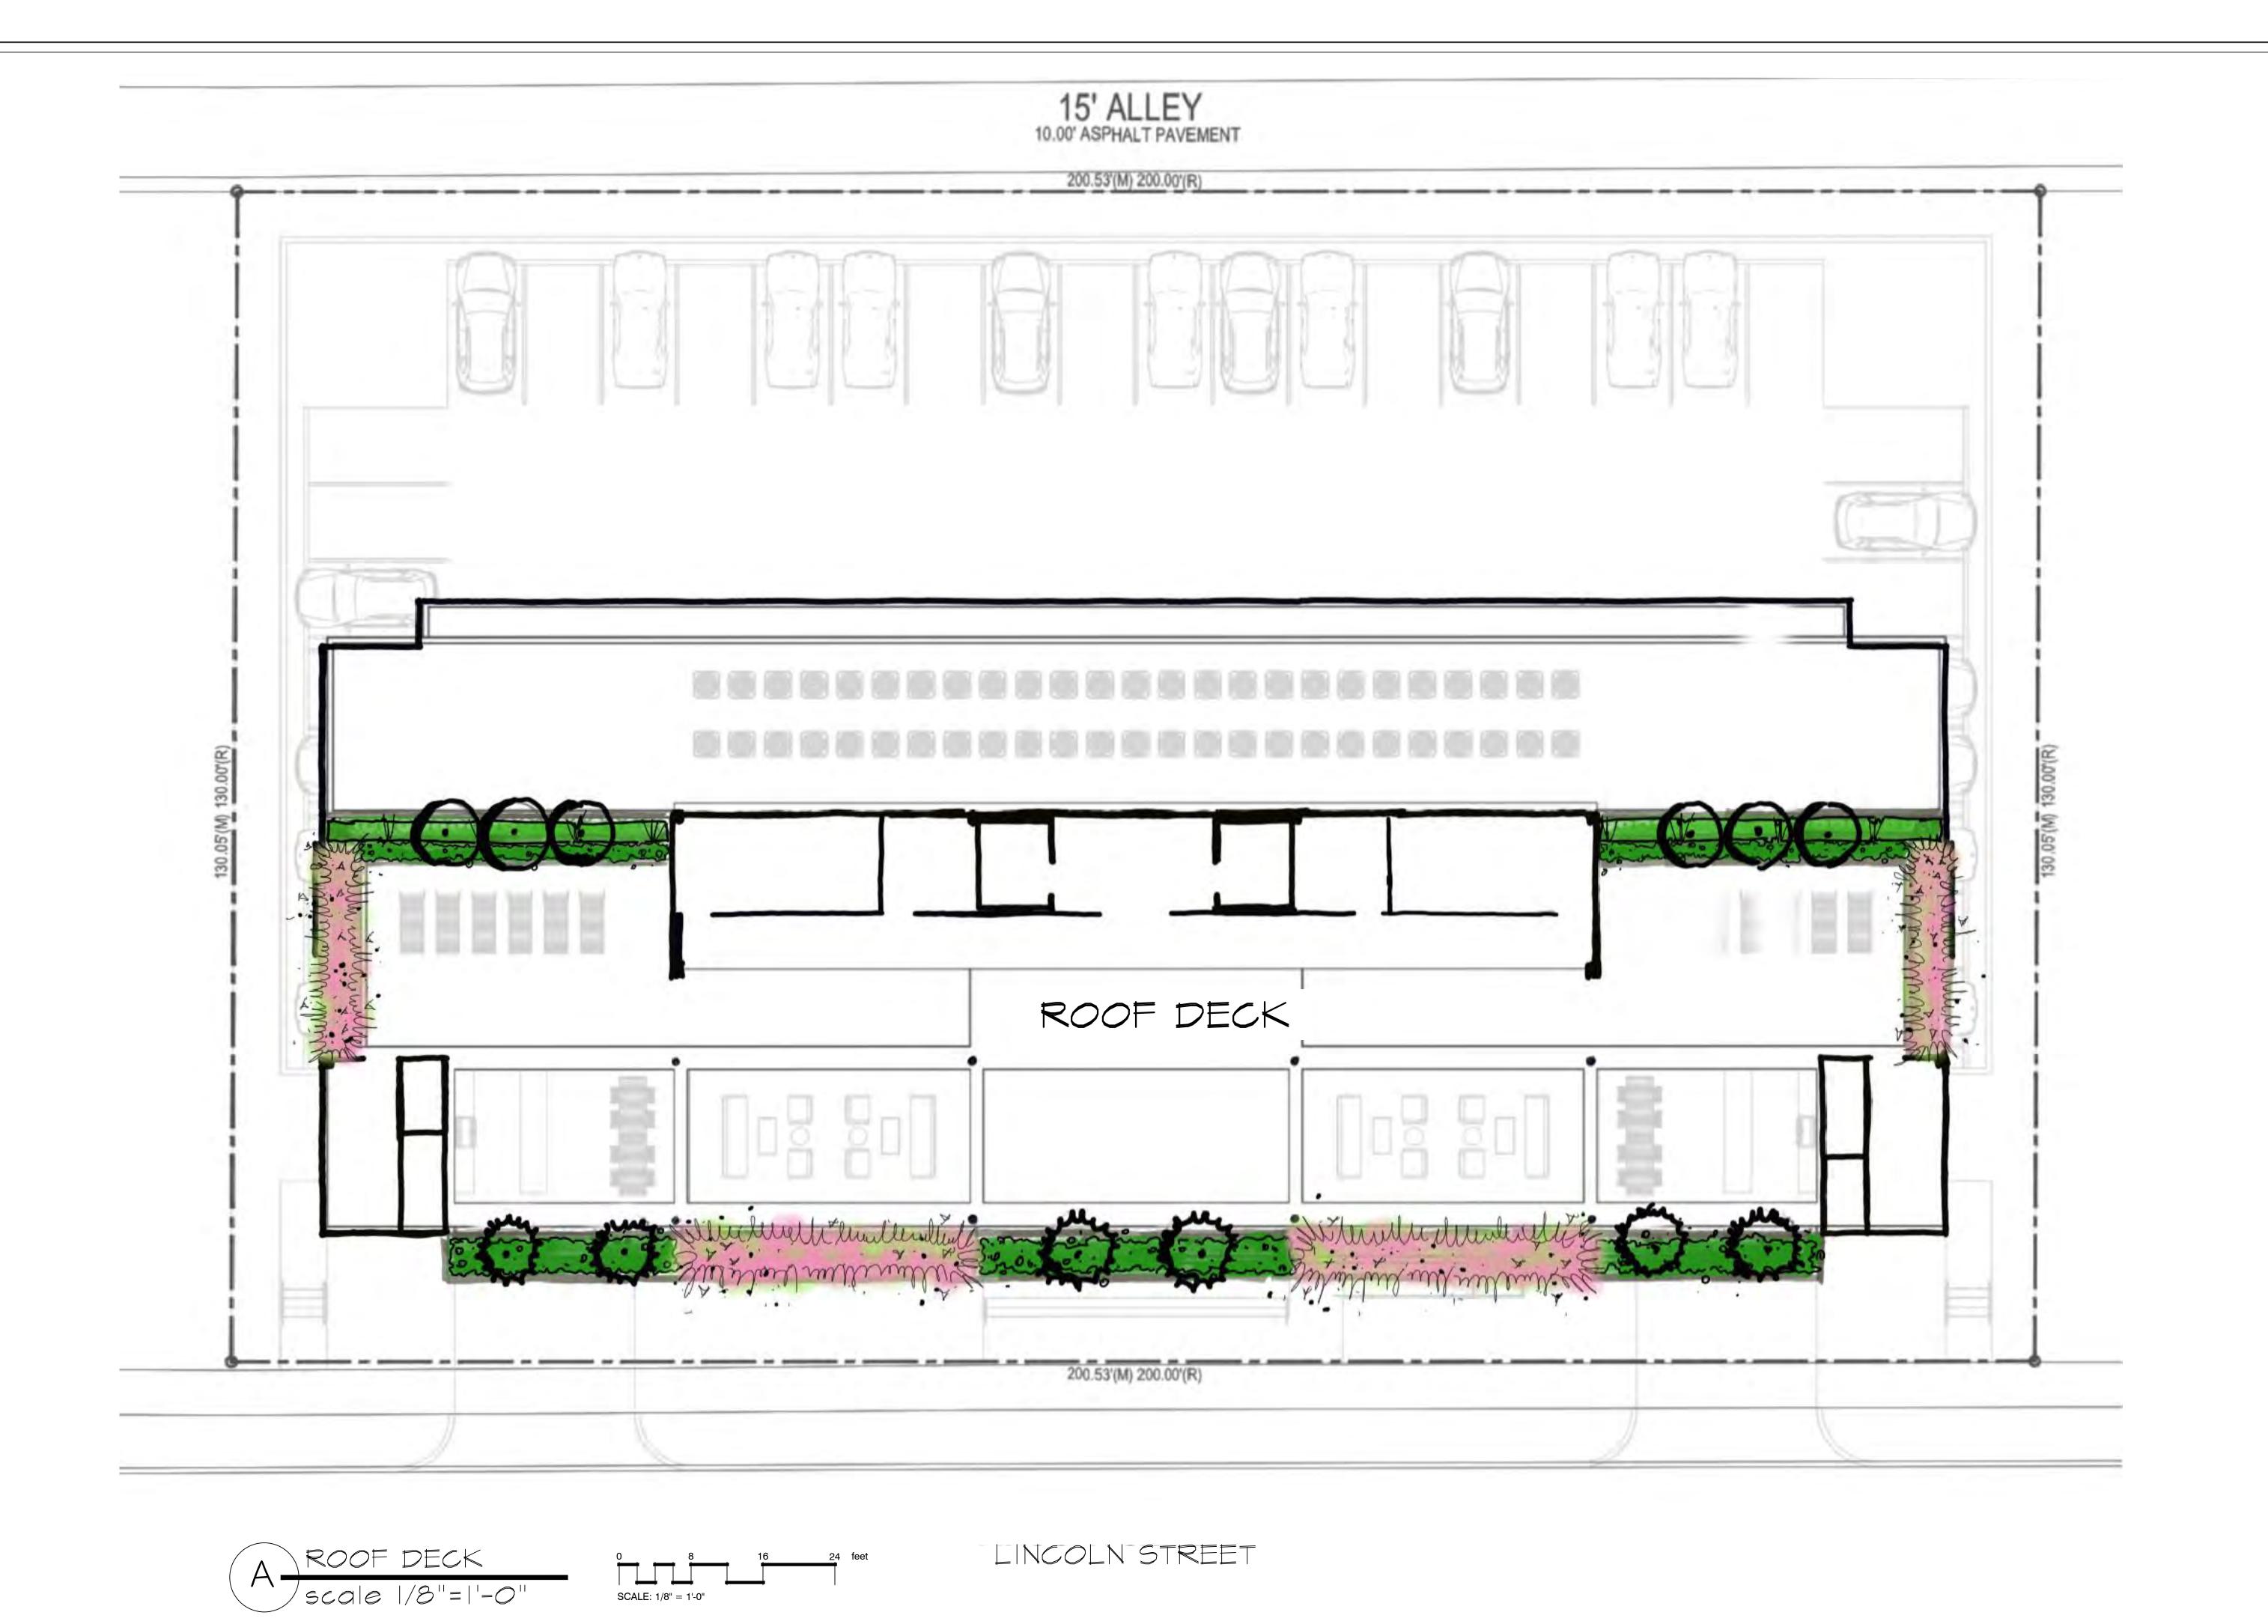
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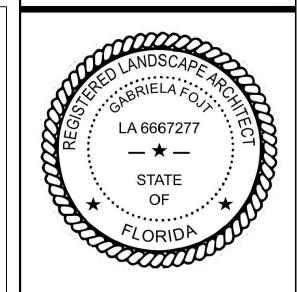


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LP - 4 OF 6



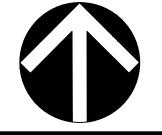


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DECK

COLORED PLAN ROOF

1935, 19 Hollywood Florida

LA 6667277 STATE OF CANDSCAPE ANDSCAPE AN

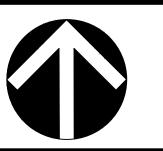JOB CONDITIONS:

Any building construction material or foreign material shall be removed from planting areas and replaced with acceptable top soil.

Care shall be taken not to disturb or damage any underground construction or utilities. Any damage to these facilities during the planting operations will be repaired at the expense of the Landscape Contractor in a manner approved by the Owner. Where underground obstructions will not permit the planting materials in accordance with the plans, new locations shall be approved by the Landscape Architect.

Landscape work shall be coordinated with the landscape irrigation work. Landscape Contractor shall ensure that no plantings will interfere with the proper coverage. Landscape Contractor shall point out situations where minor adjustments or relocation or addition of sprinklers heads may be most beneficial for the landscape work as a whole.

PLANT MATERIAL:

Plant species and size shall conform to those indicated on the drawings. Nomenclature shall conform to STANDARDIZED PLANT NAMES, LATEST EDITION. All plant material shall be in accordance with GRADES AND STANDARDS FOR NURSERY PLANTS, latest edition published by the Florida Department Agriculture and Consumer Services. All plants not otherwise specified as Florida Fancy, or Specimen, shall be Florida Grade Number 1 or better as determined by the Florida Grade Plant Industry. Specimen means an exceptionally heavy, symmetrical, tightly-knit plant, so trained or favored in its development that its appearance is unquestionable and outstandingly superior in form, number of branches, compactness and symmetry. All plants shall be sound, healthy, vigorous, well branched and free of disease and insect eggs and larvae and shall have adequate root systems. Trees and shrubs for planting rows shall be uniform in size and shape. All materials shall be subject to approval by the Landscape Architect. Where any requirements are omitted from the Plant List, the plants furnished shall be normal for the variety.

All container grown material shall be healthy, vigorous, well-rooted plants and established in the container. The plants shall have tops which are good quality and are in a healthy growing condition. An established container grown plant shall be transplanted into a container and grown in that container long enough for the new fibrous roots to have developed enough to hold the root mass together when removed from the container. Root bound plants will not be accepted.

Site water shall be verified by Contractor prior to submission of bids.

The use of natural material is strongly encouraged for balled and burlapped plants. All synthetic material shall be completely removed from root ball PRIOR to planting.

At time of bid, Contractor shall submit a written schedule of all sources for coconut palms as well as seed sources for coconuts. Coconuts shall be certified Malayan Green with a certified seed source from Jamaica

TREES:

The most critical factor for selecting a healthy Florida Number 1 tree is the structure. This consists of one central main trunk and leader. Branches are considered competing if they are 2/3 the diameter of the leader or greater. Competing branches may be acceptable if they occur above 50% of the overall height of the tree. Caliper of tree should meet specifications. Leader (center trunk) may have slight (<15 degree) bow (Tabebuia caraiba excluded), but must be intact with apical (leading) bud.

Branches should be spread evenly (staggered, alternating) through the tree branches spaced no closer than 4".

Canopy should be full to specifications with little or no openings or holes. A thinning canopy will be taken into consideration with field dug plant material.

Trees should have no open wounds or damage, flush cuts, chlorosis, shorter or taller than specified height, girdling roots, undersize loose root ball, crossing branches, smaller than normal leaves.

10% of root ball shall be above grade after planting. Root ball tying ropes removed from trunk and top of root

MULTIPLE TRUNK TREES:

Trees having no distinct leader. Trunks on these trees should not be touching and free of damage and similar in size. Canopy should be full and uniform.

MATERIALS LIS

Landscape Contractor shall be responsible for verifying all quantities for material shown on drawings prior to submitting a bid. Planting plan shall take precedence over the plant list. Final quantity of sod and mulch shall be verified.

SUBSTITUTIONS

No substitutions shall be made without the approval from the Landscape Architect and/or the Owner. Intended substitutions shall be indicated on the bid.

MEASUREMENTS:

Canopy Trees- Height shall be measured from the ground to the average height of canopy. Spread shall be measured to the end of branching equally around the crown from the center of the trunk. Caliper (d.b.h.) will be measured 4'-6" above grade.

Shrubs- Height shall be measured from the ground. Spread shall be measured to the end of branching equally around the shrub mass.

Palms- Clear trunk (C.T.) shall be measured from the ground to the point where the mature aged trunk

joins the immature or green part of the trunk or head.

Overall height (O.A.) shall be measured from the ground to the tip of the unopened bud.

IRRIGATION:

100% irrigation coverage shall be provided. Provide bubblers on separate zones for all newly planted and transplanted trees unless alternate approach to provide additional water is approved by Owner and Landscape Architect.

GUARANTEE:

All new plant materials shall be guaranteed for one year from the time of acceptance and shall be alive and in satisfactory growth for each specific kind of plant at the end of the guarantee period. The Landscape Contractor shall not be responsible for damage caused by vandalism, violent wind storms or other acts of God beyond control. Replacement shall occur within two weeks of rejection and guaranteed six months from date of installation. Landscape Contractor shall repair damage to other plants or lawns during plant replacements at no additional cost.

MULCH:

Mulch shall not contain sticks 1/4" in diameter or stones. Apply 3" of mulch except on top of tree rootballs and against woody shrubs. Rootballs will receive less than 1" mulch with no mulch touching trunk or root collar. Do not apply mulch against the trunks of woody shrubs.

SOD:

All sod shall be installed in such a manner that there is an even surface, staggered pattern. Sod will be green in color and in good health. NO overlap, gaps, damage, insects, disease and less than 10% chlorosis will be permitted. All gaps will be filled with clean native soil.

STAKING:

Landscape Contractor to suggest alternate means of staking for approval with Landscape Architect if staking methods shown are not feasible due to site conditions.

FERTILIZER:

Manufacturer's Specification: Submit manufacturer's specification sheet(s) for approval of product. Submit tags from bags of fertilizer used on site to the Architect. Submit copies of the manufacturer's specifications or analysis of all fertilizer for approval.

Composition and Quality: All fertilizer shall be uniform in composition and dry. Granular fertilizer shall be free flowing and delivered in unopened bags. Tablet fertilizer shall be delivered in unopened containers or boxes. All bags, containers or boxes shall be fully labeled with the manufacturer's analysis.

Fertilizer shall be slow release with ratio greater than 3 to 1 nitrogen to phosphorous applied on top of backfill, per manufacturer's recommendations.

All shall comply with the State of Florida fertilizer laws.

CLEANUP

Landscape Contractor shall at all times keep job site clean and free from accumulation of waste material, debris and rubbish.

INSPECTION:

Upon written request from the Contractor, Owner and/or Landscape Architect shall perform inspection to determine completion of Contract.

ACCEPTANCE:

Following inspection, Contractor will be notified, in writing, by Owner and/or Landscape Architect of acceptance of completion with regards to plant material and workmanship according to Contract.

GENERAL LANDSCAPE NOTES

- 1. CONTRACTOR IS RESPONSIBLE FOR REPAIRING FACILITIES HE DAMAGES AND IS TO COORDINATE WITH OTHER CONTRACTORS ON SITE.
- 2. CONTRACTOR IS RESPONSIBLE FOR FINISH GRADES- ROUGH GRADES BY GENERAL CONTRACTOR.
- 3. ALL PLANT MATERIALS TO BE FLORIDA NO.1 OR BETTER AS PER FLORIDA DEPT. OF AGRICULTURE GRADES & STANDARDS, MARCH 1998
- 4. PLANTING SOIL TO BE A WEED FREE MIXTURE OF MUCK & SAND (50/50) WITH 50 LBS OF MILORGANITE PER 6 CU, YDS.
- 5. TREES & PALMS GUARANTEED TO BE IN HEALTHY THRIVING CONDITION FOR ONE YEAR FROM PROJECT COMPLETION.
- 6. APPLY 3" MELALEUCA\EUCALYTUS MULCH AROUND ALL PLANTS WITHIN 2 DAYS.
- 7. CONTRACTOR TO COMPLY WITH ALL CITY LANDSCAPE ORDINANCE REQUIREMENTS.
- 8. WHERE THERE IS A DISCREPENCY EITHER IN QUANTITIES, PLANT NAMES, SIZES OR SPECIFICATIONS BETWEEN THE PLAN OR PLANT LIST, THE PLAN TAKES PREFERENCE. THE LANDSCAPE CONTRACTOR IS RESPONSIBLE FOR ANY VERIFICATION NECESSARY INVOLVING THE LANDSCAPE MATERIALS SHOWN ON THE PLAN.
- 9. ALL AREAS NOT COVERED BY PAVING OR STRUCTURES TO BE SODDED WITH FLORATAM SOD. SOD TO HAVE GOOD COMPACT GROWTH & ROOT SYSTEM. LAY WITH TIGHT JOINTS
- 10. ALL LANDSCAPED AREAS INSIDE PROPERTY AND ADJACENT ROW AREAS TO BE 100% COVERED WITH AUTOMATIC SPRINKLER SYSTEM WITH APPROXIMATELY 50% OVERLAP USING RUST FREE WATER AND A RAIN CHECK DEVICE.
- 11. TREES & PALMS TO BE STAKED AS NECESSARY IN A GOOD WORKMANLIKE MANNER WITH NO NAIL STAKING PERMITTED.
- *12. ROOT FLARES TO BE SET ABOVE GRADE AND VISIBLE WITH ROOT SYSTEMS 10% ABOVE FINAL GRADE AT TIME OF PLANTING.
- 13. LANDSCAPING SHALL COMPLY WITH ALL ZONING AND LAND DEVELOPMENT REGULATIONS.

HOLLYWOOD LANDSCAPE NOTES

- 1. PLANT MATERIAL WILL NOT BE PLANTED INTO ROOT BALLS OF TREES AND PALMS.
- 2. THERE WILL BE NO SUBSTITUTIONS WITHOUT THE APPROVAL OF HOLLYWOOD'S LANDSCAPE PLAN REVIEWER.



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NOTE:
INDICATED UTILITIES ARE APPROXIMATE.
CONTRACTOR IS RESPONSIBLE FOR VERI

CONTRACTOR IS RESPONSIBLE FOR VERIFICATION OF ALL UTILITIES ON SITE PRIOR TO COMMENCEMENT OF ANY WORK.

LANDSCAPE ARCHITECT ASSUMES NO LIABILITY FOR UTILITY DAMAGE.

The Mirror of Paradise

Gabriela Fojt LA 6667277 LC 26000628

2881 E Oakland Park Blvd Fort Lauderdale FL 33306 p (954) 315 1707 c (954) 478 3064

www.florida-landscape.com



SCALE 1/8"=1'-0"
DESIGNED BY GF
DRAWN BY GF
CHECKED BY GF
CAD DWG.
DATE 11.17.2022
REVISIONS
per city comments 1 03.15.2023
per city comments 2 04.28.2023

WOOD CITY NOTES, GENE

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Hollywo Florida

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