



GENERAL APPLICATION

APPLICATION DATE: APPLICATION TYPE (CHECK ALL THAT APPLIES): 2600 Hollywood Blvd Technical Advisory Committee Art in Public Places Committee Variance Planning and Development Board ☐ Historic Preservation Board Special Exception Room 315 City Commission Administrative Approval Hollywood, FL 33022 Tel: (954) 921-3471 PROPERTY INFORMATION Email: Development@ Location Address: 2640 N. State Road 7 Hollywoodfl.org Lot(s): Parcel A Subdivision: Gator 441 Block(s): N/A Folio Number(s): 5141 01 12 0010 SUBMISSION REQUIREMENTS: One set of signed & Land Use Classification: TOC Zoning Classification: C-MU sealed plans (i.e. Architect or Engineer) Existing Property Use: Car Wash Facility-out of business Sq Ft/Number of Units: 1,518 sq. ft. One electronic Is the request the result of a violation notice? \(\simeg\) Yes \(\vec{\pi}\) No If yes, attach a copy of violation. combined PDF Has this property been presented to the City before? If yes, check all that apply and provide File submission (max. 25mb) Number(s) and Resolution(s): N/A Completed Application Checklist **DEVELOPMENT PROPOSAL** Application fee Explanation of Request: Taco Bell drive-through only restaurant Phased Project: Yes INO IN Number of Phases: **Proposal Project** Units/rooms (# of units) # UNITS: 0 #Rooms 0 NOTE: Proposed Non-Residential Uses 1,600 S.F.) This application must Open Space (% and SQ.FT.) Required %: 21.88 S.F.) (Area: 3,021 be completed in full and submitted with all Parking (# of spaces) 5 (# PARK. SPACES: documents to be placed on a Board or Height (# of stories) (# STORIES) 1 21'-4" FT.) Committee's agenda. Gross Floor Area (SQ. FT) Lot(s) Gross Area (13,811 sq. FT.) The applicant is responsible for obtain-Name of Current Property Owner: Gator 441, Inc. ing the appropriate Address of Property Owner: 7850 NW 146 St. 4 Floor Miami Lakes, FL 33016 checklist for each type of application. Email Address: contact agent Telephone: contact agent Applicant(s) or their authorized legal agent Applicant Dwayne L. Dickerson/Miskel Backman, I Consultant ☐ Representative ☑ Tenant ☐ must be present at all Address: 14 SE 4th St. Suite 36 Boca Raton, FL 33432 Telephone: 561-405-3336 **Board or Committee** meetings. Email Address: ddickerson@miskelbackman.com Email Address #2: Is there an option to purchase the Property? Yes \(\subseteq No \(\subseteq \) Date of Purchase: If Yes, Attach Copy of the Contract.

Noticing Agent (FTAC & Board submissions only): Christina Matthews-Cutro & Associates

E-mail Address: cutroplanning@yahoo.com

CLICK HERE FOR FORMS, CHECKLISTS, & MEETING DATES



Signature of Current Owner:

GENERAL APPLICATION

Date: 12/6/2024

CERTIFICATION OF COMPLIANCE WITH APPLICABLE REGULATIONS

The applicant/owner(s) signature certifies that he/she has been made aware of the criteria, regulations and guidelines applicable to the request. This information can be obtained in Room 315 of City Hall or on our website at www.hollywoodfl.org. The owner(s) further certifies that when required by applicable law, including but not limited to the City's Zoning and Land Development Regulations, they will post the site with a sign provided by the Office of Planning and Development Services. The owner(s) will photograph the sign the day of posting and submit photographs to the Office of Planning and Development Services as required by applicable law. Failure to post the sign will result in violation of State and Municipal Notification Requirements and Laws.

(I)(We) certify that (I) (we) understand and will comply with the provisions and regulations of the City's Zoning and Land Development Regulations, Design Guidelines, Design Guidelines for Historic Properties and City's Comprehensive Plan as they apply to this project. (I)(We) further certify that the above statements and drawings made on any paper or plans submitted herewith are true to the best of (my)(our) knowledge. (I)(We) understand that the application and attachments become part of the official public records of the City and are not returnable.

James A. Goldsmith - President	
PRINT NAME: Gator 441, Inc.	Date:
Signature of Consultant/Representative:	Date:
PRINT NAME: Dwayne L. Dickerson	Date: 12/3/24
Signature of Tenant:	Date:
PRINT NAME:	Date:
Current Owner Power of Attorney	
I am the current owner of the described real property and that I am aware of the nature site plan approval & variance requests to my property, which is hereby made by me Dwayne L. Dickerson/Miskel Backman, LLito be my legal representative before the P&D Board & Committee) relative to all matters concerning this application.	or I am bereby authorizing
Sworn to and subscribed before me	/
this of day of CEM's LAKISHA MAYS Notary Public - State of Florida Commission # HH 444343 My Comm. Expires Sep 14, 2027 Bonded through National Notary Assn. Signatury of James A folds: My Comm. Expires Sep 14, 2027 Brint Name	Current Owner mith - President
State of Florida My Commission Expires: 9/1467(Check One) Personally known to me; OR Produced Iden	tification



File No. (internal use only):___

2600 Hollywood Boulevard Room 315 Hollywood, FL 33022

GENERAL APPLICATION



Tel: (954) 921-3471 Fax: (954) 921-3347

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http://www.hollywoodfl.org/DocumentCenter/Home/View/21



	APPLICATION TYPE (CHECK ONE):						
	☐ Technical Advisory Committee ☐ Historic Preservation Board						
	☐ City Commission ☐ Planning and Development Board						
	Date of Application:						
	Location Address: 2640 N. State Rd. 7						
	Lot(s): Parcel A Block(s): N/A Subdivision: Gator 441						
	Folio Number(s): 5141 01 12 0010						
	Zoning Classification: C-MU Land Use Classification: TOC						
	Existing Property Use: Car Wash Facility-Out of Business Sq Ft/Number of Units: 1,518 sq. ft.						
	Is the request the result of a violation notice? () Yes 💢 No If yes, attach a copy of violation.						
	Has this property been presented to the City before? If yes, check all that apply and provide File Number(s) and Resolution(s): N/A						
	☐ Economic Roundtable ☐ Technical Advisory Committee ☐ Historic Preservation Board						
	☐ City Commission ☐ Planning and Development						
	Explanation of Request: Taco Bell Drive-thru only restaurant with a variance request from						
ı	Section 4.6(D)(12)(d)(ii) to allow an active use liner on the ground floor along the State Rd. 7 building facade of 51.51% rather than 60%.						
ı	Number of units/rooms: 0 Sq Ft: 1,600						
ı	Value of Improvement: Estimated Date of Completion:						
	Will Project be Phased? () Yes ເĶNo If Phased, Estimated Completion of Each Phase						
	Name of Current Property Owner:						
ı	Address of Property Owner: 1 Glen Bell Way Irvine, CA 92618						
ı	Telephone: 609-617-2185 Fax: Email Address: diana.DeCicco@yum.co						
ı	Name of Consultant/Representative/Tenant (circle one): Dwayne L. Dickerson, Esq./Dunay, Miskel & Backr						
ı	Address: 14 SE 4th St. Suite 36 Boca Raton, FL 33432 Telephone: 561-405-3336						
	Fax: 561-409-2341 Email Address: ddickerson@dmbblaw.com						
	Date of Purchase: 9/6/22 Is there an option to purchase the Property? Yes () No 💢)						
	If Yes, Attach Copy of the Contract.						
List Anyone Else Who Should Receive Notice of the Hearing: N/A							
Address: Fmail Address:							



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Signature of Current Owner:	Date: 1/17/2023
PRINT NAME: Gator 441. Inc., by its President, James A. Gold	dsmith Date: 1/17/2023
Signature of Consultant/Representative:	Date: 1 18 23
PRINT NAME: Dwayne L. Dickerson, Esq.	Date: 118123
Signature of Tenant: N/A	Date:
PRINT NAME: N/A	Date:
Current Owner Power of Attorney I am the current owner of the described real property and that I am	
Site Plan Approval & Variance Requests to my property, which is everyne L. Dickerson, Esq./Dunsy, Miskel & Backman to be my legal representative before	hereby made by me or I am hereby authorizing
Committee) relative to all matters concerning this application.	
Sworn to and subscribed before me this 17th day of January, 2023 Notary Public State of Floric Marie F. Lopez My Commission HH 050920	Signature of Current Owner
Notary Public	Print Name
State of Florida	
My Commission Expires: 10/25/24 (Check One) Versonally known to me;	OR Produced Identification



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APPLICATION TYPE (CHECK ONE	Ξ):
☐ Technical Advisory Committee	☐ Historic Preservation Board
☐ City Commission	▼ Planning and Development Board
Date of Application:	
Location Address: 2640 N. State Rd. 7	
	N/A Subdivision: Gator 441
Folio Number(s): 5141 01 12 0010	
Zoning Classification: C-MU	Land Use Classification: TOC
Existing Property Use: Car Wash Facility-Out of E	Sq Ft/Number of Units: 1,518 sq. ft.
Is the request the result of a violation notice	e? () Yes 💢 No If yes, attach a copy of violation.
Has this property been presented to the C Number(s) and Resolution(s): N/A	ity before? If yes, check al that apply and provide File
☐ Economic Roundtable ☐ Technical A	Advisory Committee Historic Preservation Board
☐ City Commission ☐ Planning at	nd Development
Explanation of Request: Taco Bell Drive-t	thru only restaurant with a variance request from
Section 9.5(c)(1) to allow 15.28% landscape at	rea in the vehicular use area rather than 25%.
Number of units/rooms: 0	Sq Ft: 1,600
	Estimated Date of Completion:
Will Project be Phased?()Yes ⋉ No	If Phased, Estimated Completion of Each Phase
Name of Current Property Owner: Taco E	
Address of Property Owner: 1 Glen Bell \	
	Email Address: diana.DeCicco@yum.cor
Name of Consultant/Representative/Tenan	t (circle one): Dwayne L. Dickerson, Esq./Dunay, Miskel & Backm
	on, FL 33432 Telephone: 561-405-3336
	ddickerson@dmbblaw.com
Andrew and A. Cherter and an anti-	e an option to purchase the Property? Yes () No 💢)
If Yes, Attach Copy of the Contract.	N/A
List Anyone Else Who Should Receive Not	
	Address: Email Address:
-	



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PRINT NAME: Dwayne L. Dickerson, Esq.	Date: 118123
Signature of Tenant: N/A	Date:
PRINT NAME: N/A	Date:
Current Owner Power of Attorney I am the current owner of the described real property and that I am	
Site Plan Approval & Variance Requests to my property, which is everyne L. Dickerson, Esq./Dunsy, Miskel & Backman to be my legal representative before	hereby made by me or I am hereby authorizing
Committee) relative to all matters concerning this application.	
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Date of Application:							
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	N/A Subdivision: Gator 441						
Folio Number(s): 5141 01 12 0010	Subdivision.						
	Land Use Classification: TOC						
	Business Sq Ft/Number of Units: 1,518 sq. ft.						
	e? () Yes (No If yes, attach a copy of violation.						
Has this property been presented to the City before? If yes, check all that apply and provide File Number(s) and Resolution(s): N/A ☐ Economic Roundtable ☐ Technical Advisory Committee ☐ Historic Preservation Board ☐ City Commission ☐ Planning and Development							
						Explanation of Request: Taco Bell Drive-thru only restaurant with a variance request from Section 7.2(A)(28) to allow 5 parking spaces rather than 10.	
Number of units/rooms: 0	Sq Ft: 1,600						
	Estimated Date of Completion:						
Will Project be Phased? () Yes ⋈No If Phased, Estimated Completion of Each Phase							
Name of Current Property Owner: Taco B	Bell of America/Gator 441, Inc.						
Address of Property Owner: 1 Glen Bell V	Way Irvine, CA 92618						
Telephone: 609-617-2185 Fax:	Email Address: diana.DeCicco@yum.co						
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	Address: Email Address:						
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PRINT NAME: Dwayne L. Dickerson, Esq.	Date: 118123
Signature of Tenant: N/A	Date:
PRINT NAME: N/A	Date:
Current Owner Power of Attorney I am the current owner of the described real property and that I am	
Site Plan Approval & Variance Requests to my property, which is everyne L. Dickerson, Esq./Dunsy, Miskel & Backman to be my legal representative before	hereby made by me or I am hereby authorizing
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l	Date of Application:	<u> </u>				
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	Folio Number(s): 5141 01 12 0010	N/A Subdivision: Gator 441				
	Zoning Classification: C-MU	Land Line Classification: TOC				
		usiness Sq Ft/Number of Units: 1,518 sq. ft.				
		e? () Yes (x) No If yes, attach a copy of violation.				
		ty before? If yes, check al that apply and provide File				
	Number(s) and Resolution(s): N/A	-y == y ==, e.reen a. alar apply and provide i lie				
	☐ Economic Roundtable ☐ Technical A	dvisory Committee Historic Preservation Board				
	☐ City Commission ☐ Planning an					
Explanation of Request: Taco Bell Drive-thru only restaurant with a variance request from Section 4.6(D)(11)(c) to allow a window transparency on the ground floor along the State Rd. 7 building						
	Number of units/rooms: 0	Sq Ft: 1,600				
		Estimated Date of Completion:				
	Will Project be Phased? () Yes ⋈ No	If Phased, Estimated Completion of Each Phase				
	Name of Current Property Owner:	ell of America/Gator 441, Inc.				
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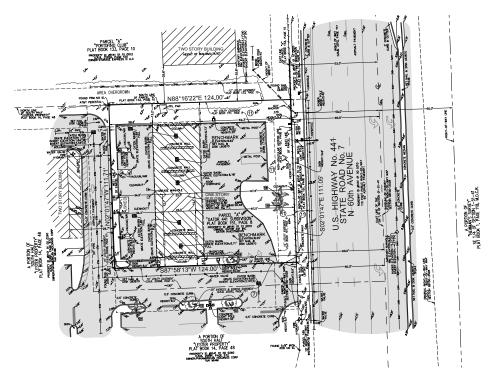
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Notary Public	Print Name
State of Florida	
My Commission Expires: 10/25/24 (Check One) Versonally known to me;	OR Produced Identification



TREE TABLE

Tree Number	Common Name	(inches)	Canopy (feet)	Height (feet)
1	PAUM TREE	10"	10'	14"
2	OAK TREE	6"	110'	16'
3	CIAK TREE	B*	10'	14'
4	OAK TREE	10"	15'	10"
5	PAUM TREE	8"	14'	19'
6	PAIM TREE	B ^a	157	157





LEGEND & ABBREVIATIONS

CONCRETE ASPHALT PAVEMENT ELEVATION

OVERHEAD WIRES

—s1w— UNDERGROUND STORM SEWER LINE -----UNDERGROUND SANITARY SEWER LINE UNDERGROUND WATER LINE

CENTERLINE FPL FLORIDA POWER & LIGHT COMPANY

LB LICENSED BUSINESS

PRM PERMANENT REFERENCE MONUMENT (BRASS DISK IN 4" X 4" CONCRETE MONUMENT)

7 TRAVERSE POINT (FOR FIELD INFORMATION ONLY)

PALM TREE OAK TREE

TREE IDENTIFICATION NUMBER

CERTIFICATION:

TO CKE GROUP, INC; TACO BELL OF AMERICA, LLC, A DELAWARE LIMITED LIABILITY COMPANY, AND ITS AFFILIATES, OR ITS SUCCESSORS AND ASSIGNS; CHICAGO TITLE INSURANCE COMPANY:

This is to certify that this map or plat and the survey on which it is based were made in accordance with the 2021 winnium stradard detail redurements for alta/neps land till survey. Only the stratage and adopted by alta and noss, and nollubes itms 1, $2,\,3,\,4,\,5,\,6(\lambda),\,6(B),\,7(A),\,7(B)(1),\,6,\,9,\,10(\lambda),\,10(B),\,1(\lambda),\,13,\,16,\,19,\,20\,0$ of table a thereof. The Fieldwork was converted to 8/2 or 10

DATE OF PLAT OR MAP: 8/5/24

- □ JOHN F. PULICE, PROFESSIONAL SURVEYOR AND MAPPER LS2691
 □ VCTOR R. GILBERT, PROFESSIONAL SURVEYOR AND MAPPER LS6274
 □ MICHAEL M. MOSSEY, PROFESSIONAL SURVEYOR AND MAPPER PSM5660
 STATE OF FLORIDA

LEGAL DESCRIPTION: (TITLE COMMITMENT)

PARCEL "A", "GATOR 441 SUBDIVISION", ACCORDING TO THE PLAT THEREOF, RECORDED IN PLAT BOOK 151, PAGE 8, OF THE PUBLIC RECORDS OF BROWARD COUNTY, FLORIDA.

SAID LANDS LYING AND BEING IN THE CITY OF HOLLYWOOD, BROWARD COUNTY, FLORIDA AND CONTANING A NET OF 13,811 SQUARE FEET (0.3171 ACRES) AND A GROSS OF 20,465 SQUARE FEET (0.470 ACRES), MORE OR LESS.

- NOTES:

 T. THIS SURVEY MAP AND REPORT OR THE COPIES THEREOF ARE NOT VALID WITHOUT THE ORIGINAL SIGNATURE AND SEAL OR AN ELECTRONIC SIGNATURE AND ELECTRONIC SEAL OF ELECTRONIC SIGNATURE AND ELECTRONIC SEAL OF ELECTRONIC SEAL OF SIGNATURE AND ELECTRONIC SEAL OF COUNTY BENCHMARK 2005S, ELEVATION: 13.79 FEET.

 FLOOD ZOME, S. BASÉ FLOOD ELEVATION: NOVE PAREL #20TICO5628; COMMUNITY #2051S, MAP DATE: 8/18/14, THIS SIGNATURE OF SIGNATURE

- 3. #2211.5. WAP DATE: 8,716/14.

 1. THIS STEE LES IN SECTION 1, TOWNSHIP ST SOUTH, ARNOX 41 EAST, BROWARD COUNTY, LIVED AND THE LES IN SECTION 1, TOWNSHIP ST SOUTH, ARNOX 41 EAST, BROWARD COUNTY, LIVED AND THE LES IN SECTION 1, TOWNSHIP ST SOUTH, ARNOX 41 EAST, BROWARD COUNTY, LIVED AND THE LES IN SECTION 1, TOWNSHIP ST SOUTH HE NORTH LINE OF PARCEL "A" BEINN MBBET 527E AS SHOWN ON SADE PLAT.


 6. REASONABLE EFFORTS WERE MADE REGARDING THE EXISTENCE AND THE LOCATION OF UNDERFORMOUTH STEEL OF THE PARCEL AND THE COUNTY AND THE PARCEL AND THE LOCATION OF THE STEEL OF THE WERFORD AND THE STEEL OF THE PARCEL ACCUPACY OF ELEVATIONS OF WELL DEFFELD MEDICAL PROPERTY IN SURVEY IS 20.07. HE WERFOLD ACCUPACY OF ELEVATIONS OF WELL DEFFELD MEDICAL PROPERTY IN SURVEY IS 20.07. HE WERFOLD ACCUPACY OF ELEVATIONS OF WELL DEFFELD MEDICAL PROPERTY IN SOUTH AND THE SURVEY IS 20.07. HE WERFOLD ACCUPACY OF ELEVATIONS OF WELL DEFFELD MEDICAL PROPERTY IN SOUTH AND THE SURVEY IS 20.07. HE WERFOLD HE DEFFELD AS A PROPERTY IN SOUTH AND THE SURVEY IS 20.07. HE WERFOLD HE DEFFELD AS A PROPERTY IN SOUTH AND THE SURVEY IS 20.07. HE WERFOLD HE PLOTTED.

 C. GROINANCE NO. 20.07. HIS IN SURVEY IS PLOTTED. SURVEY IS 20.07. HE WERFOLD HE PLOTTED.

 C. GROINANCE NO. 20.07. HIS IN SURVEY IS PLOTTED. SURVEY IN SURVEY IN PROPERTY TO THIS SITE BUT CANNOY BE PLOTTED.

 C. GROINANCE NO. 20.07. HIS IN SURVEY IS PLOTTED. THE SURVEY IN SURV

- 13. ZONING: C-MU (T.O.C.)
 15. THIS PROPERTY HAS A GROSS AREA OF 20.464 SQUARE FEET (0.4697 ACRES MORE OR LESS.)

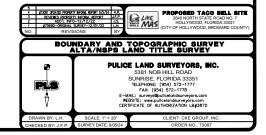

PROPOSED TACO BELL RESTAURANT

2640 N SR-7, Hollywood, FL 33021

OWNER

QATOR 441, INC. 7850 NW 146 ST., 4TH FLOOR MIAMI LAKES, FLORIDA 33016 (877) 459-9605 ATTN: JAMES GOLDSMITH

TENANT:

TACO BELL OF AMERICA 1 GLEN BELL WAY IRVINE, CALIFORNIA 92618

ARCHITECT:

CKE GROUP, INC.
17190 ROYAL PALM BLVD., SUITE 2
WESTON, FLORIDA 33326
(305) 558-4124
ATTN: EDUARDO L. CARCACHE, P.E.

ENGINEER:

CKE GROUP, INC. 17190 ROYAL PALM BLVD., SUITE 2 WESTON, FLORIDA 33326 (305) 558-4124 ATTN: EDUARDO L. CARCACHE, P.E.

SURVEYOR

PULICE LAND SURVEYORS, INC. 5381 NOB HILL ROAD SUNRISE, FLORIDA 33351 (954) 572-1777 ATTN: JOHN F. PULICE, P.S.M.

LANDSCAPE:

RICHARD BARTLETT LANDSCAPE, INC. 12773 W. FOREST HILL BLVD. SUITE 213 WELLINGTON, FLORIDA 33414 (561) 795-0443 ATTN: RICHARD BARTLETT





THIS SITE LIES IN SECTION 1, TOWNSHIP 51 SOUTH, RANGE 41 EAST, BROWARD COUNTY, FLORIDA.

LEGAL DESCRIPTION:

NAMES N." NOTES AT SECONDAY. ACCORDING TO THE PLAT THEREOF.

RECORDED IN PLAY BOOK 151, MAKE 8, OF THE PUBLIC RECORDS OF SHOWARD

COUNTY, FLORIDA.

SHOW JAMES THICK AND BEING IN THE CITY OF MICLIFOOD, BROWARD COUNTY,

FLORIDA AND CONTAINING 13,811 SQUARE FEET (0.3171 ACRES), MORE OR LESS.

FOLIO # 5141 O112 CO110

ENGINEER'S CERTIFICATION:

THIS PLAN WAS PREPARED UNDER MY DIRECTION HIS PLAN WAS PREPARED UNDER MY DIRECTION AND TO THE BEST OF MY KNOWLEDGE AND BELLEF COMPULES WITH THE INTENT OF THE MANUAL OF UNIFORM MINIMUM STANDARDS FOR DESIGN, CONSTRUCTION AND MAINTENANCE FOR STREETS AND HIGHWAYS, AS ADOPTED BY THE STATE OF FLORIDA LEGISLATURE, CHAPTER 72–328 F.S.

EDUARDO L. CARCACHE, PE 31914 CKE GROUP, INC. COA-4432

This item has been digitally signed and scaled by Eduardo L. Carcacho on the date indicated here.

INDEX OF DRAWINGS: COVER SHEET

PLAT SURVEY

SD-1 SITE DEMOLITION PLAN

C-1 SITE PLAN

C-1.1 SITE ACCESSIBLE ROUTES PLAN

C-1.2 VEHICULAR USE, LANDSCAPE BUFFER & OPEN SPACE LANDSCAPE DIAGRAMS C-2 PAVING AND GRADING PLAN

C-3 SITE UTILITY PLAN

C-3.1 SITE UTILITY DETAILS

C-4 SITE DETAILS

C-5 SITE DETAILS & PAVEMENT SECTIONS

C-6 STORMWATER POLILITION PREVENTION PLAN

C-6A STORMWATER POLLUTION PREVENTION DETAILS & NOTES C-7 TRASH ENCLOSURE DETAIL

C-8 PAVEMENT MARKING & SIGNAGE

CE-1 SITE LIGHTING PLAN

G-1.0 GREEN CHECKLIST

L-1 LANDSCAPE PLAN

L-2 LANDSCAPE SPECS L-3 EXISTING TREE DISPOSITION PLAN

IRRIGATION PLAN

L-5 IRRIGATION SPECS

A-1.0 FLOOR PLAN

A-4.0 EXTERIOR ELEVATIONS

MEETING DATES: DEC 19, 2022 FEB 6, 2023 FINAL TAC PDB

REVISIONS:


↑ 03/24/23 CITY COMMENTS
↑ 07/29/24 DRAINAGE COMMENTS
↑ 09/11/24 CITY COMMENTS

A 10/01/24 CITY COMMENTS

△ 10/23/24 CITY COMMENTS
△ 11/25/24 CITY COMMENTS

↑ 12/13/24 CITY COMMENTS



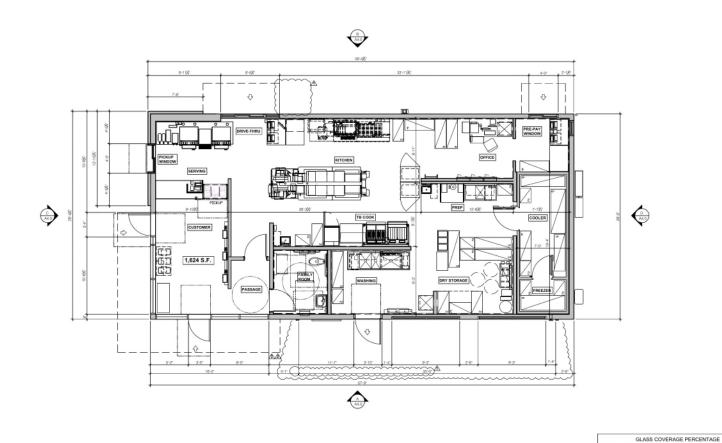



17190 ROYAL PALM BLVO.

SUTE #2

WESTON, FLORIDA 33326

PHONE: \$305.558-4124

FAX: \$305.826.0519

EB#C004412



CVIL ENGINEER PE 3191

Professional Engineer, License No. 31914
This form has been digitally signed and seeled by Eduardo L. Carcache on the da indicated here.
Printed copies of this document are not considered signed and seeled and the

	A 06-24-2024
D	A 12-65-2624
	A 12-10-2024
	Δ
	Δ
	Δ
-	Δ
	Δ
	Δ

CONTRACT DATE: 01.16
BUILDING TYPE
PLAN VERSION:
SITE NUMBER
STORE NUMBER: 4580

TACO BELL

2640 N. State Rd 7 Hollywood, Florida. 33021



FLOOR PLAN

A1.0

FLOOR PLAN 1/4"-1'40" A

34'-8"


100%

28% 32%

60%

BUILDING EAST ELEVATION LENGTH: 57°-9°
GLASS COVERAGE:
CLEAR GLASS 16°-2°
FAUX GLASS 18°-6"

TOTAL GLASS:

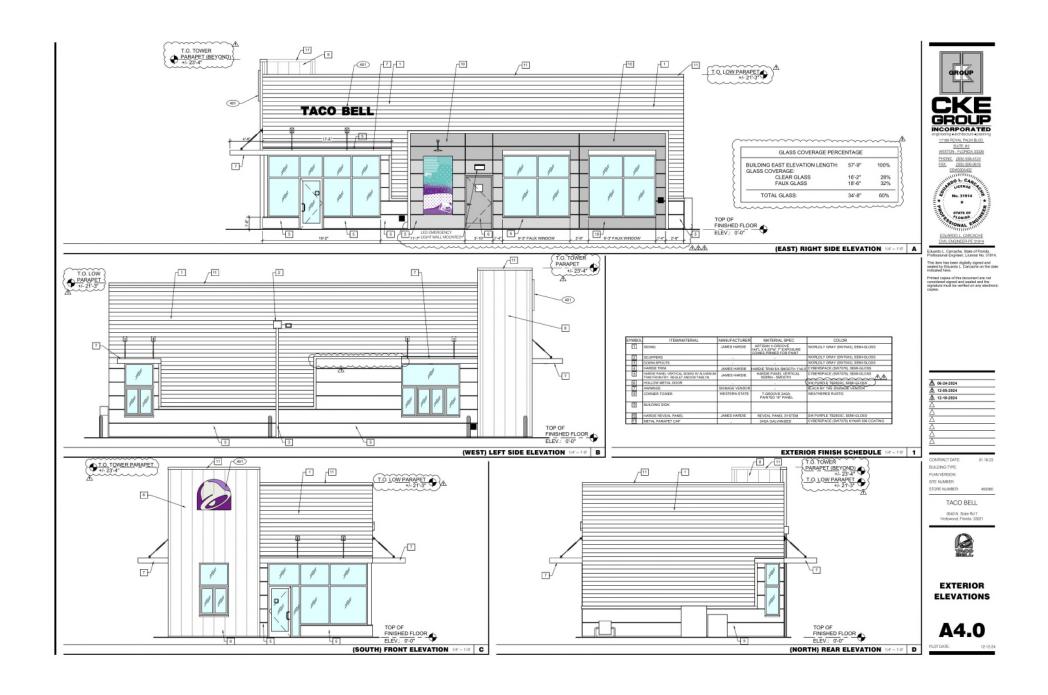

LEGAL DESCRIPTION:

PARCEL "A", "GATOR 441 SUBDIVISION", ACCORDING TO THE PLAT THEREOF, RECORDED IN PLAT BOOK 151, PAGE 8, OF THE PUBLIC RECORDS OF BROWARD COUNTY, FLORIDA.

SAID LANDS LYING AND BEING IN THE CITY OF HOLLYWOOD, BROWARD COUNTY, FLORIDA AND CONTAINING 13,811 SQUARE FEET (0.3171 ACRES), MORE OR LESS.



LOCATION MAP NOT TO SCALE





GROUP

GROUP

INCORPORATED 17190 ROYAL PALM BLVD

SUITE #2 WESTON , FLORIDA 33326

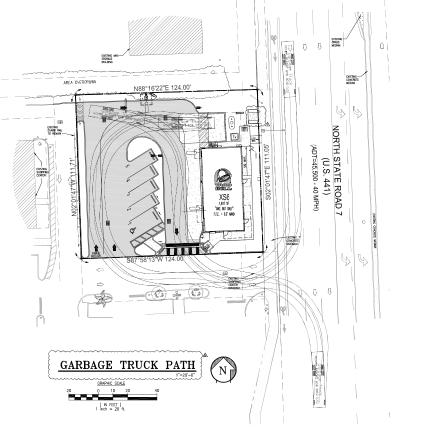

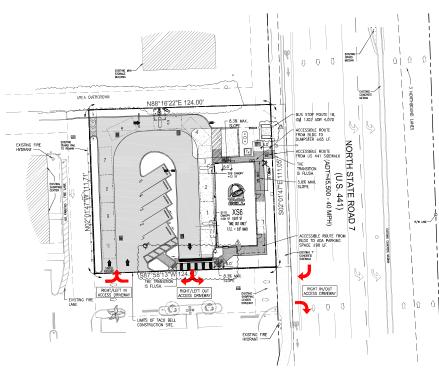

SITE ACCESSIBLE ROUTE PLAN







NOTES:

PARKING LOT SLOPES ARE TO BE ADA COMPLIANT AND VERIFIED BY G.C.
 ANY LIP FROM 1/4" BUT NOT GREATER THAN 1/2" WILL BE BEVELED TO MEET ADA REQUIREMENTS.



BUILDING TYPE:

JOB NO.:


PLAN VERSION: BRAND DESIGNER: DANIEL DICKSON

SITE NUMBER: STORE NUMBER: TB-459380 DIANA DeCICCO DRAWN BY:

TACO BELL 2640 N SR-7, HOLLYWOOD, FL 33021





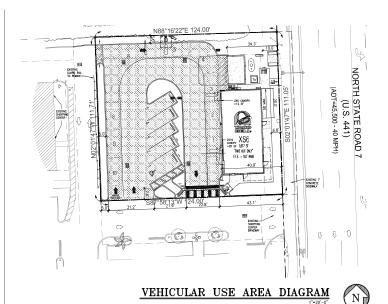

AT GRADE PARKING LOT & VEHICULAR USE SET BACKS PROVIDED 34.3" INTERIOR 5.0° 5.0° 5.0° / 7.6° 5.0° REAR ALLEY N/A



VEHICULAR USE AREA (7,708.2 S.F.)



THIS SITE LIES IN SECTION 1, TOWNSHIP 51 SOUTH, RANGE 41 EAST, BROWARD COUNTY, FLORIDA.

LEGAL DESCRIPTION:

PARCEL "A", "GATOR 441 SUBDIMISION", ACCORDING TO THE PLAT THEREOF, RECORDED IN PLAT BOOK 151, PAGE 8, OF THE PUBLIC RECORDS OF BROWARD COUNTY, FLORIDA.

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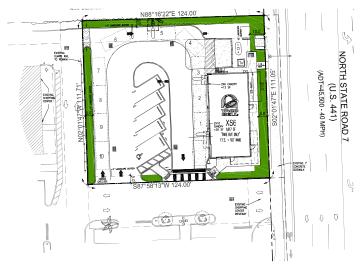
PHONE (305) 558-4124 FAX (305) 826-0619 EB#0004432

GROUP

GROUP


INCORPORATED 17190 ROYAL PALM BLVD SUITE #2 WESTON , FLORIDA 33326

This item has been digitally signed and scaled by Eduardo L. Carcache on the date indicated here.




LANDSCAPE BUFFER DIAGRAM



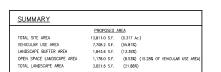

LANDSCAPE BUFFER (1.843.6 S.F.)

OPEN SPACE LANDSCAPE AREA (1,178.0 S.F.)

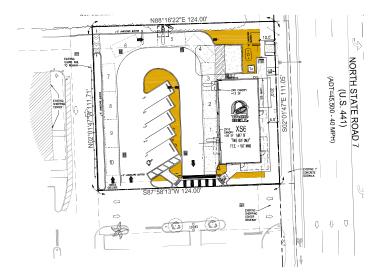

OPEN SPACE LANDSCAPE DIAGRAM





TACO BELL 2640 N SR-7, HOLLYWOOD, FL 33021


TB-459380

DIANA DeCICCO

BUILDING TYPE: PLAN VERSION: BRAND DESIGNER: DANIEL DICKSON SITE NUMBER: STORE NUMBER:

PA/PM:

DRAWN BY. JOB NO.:

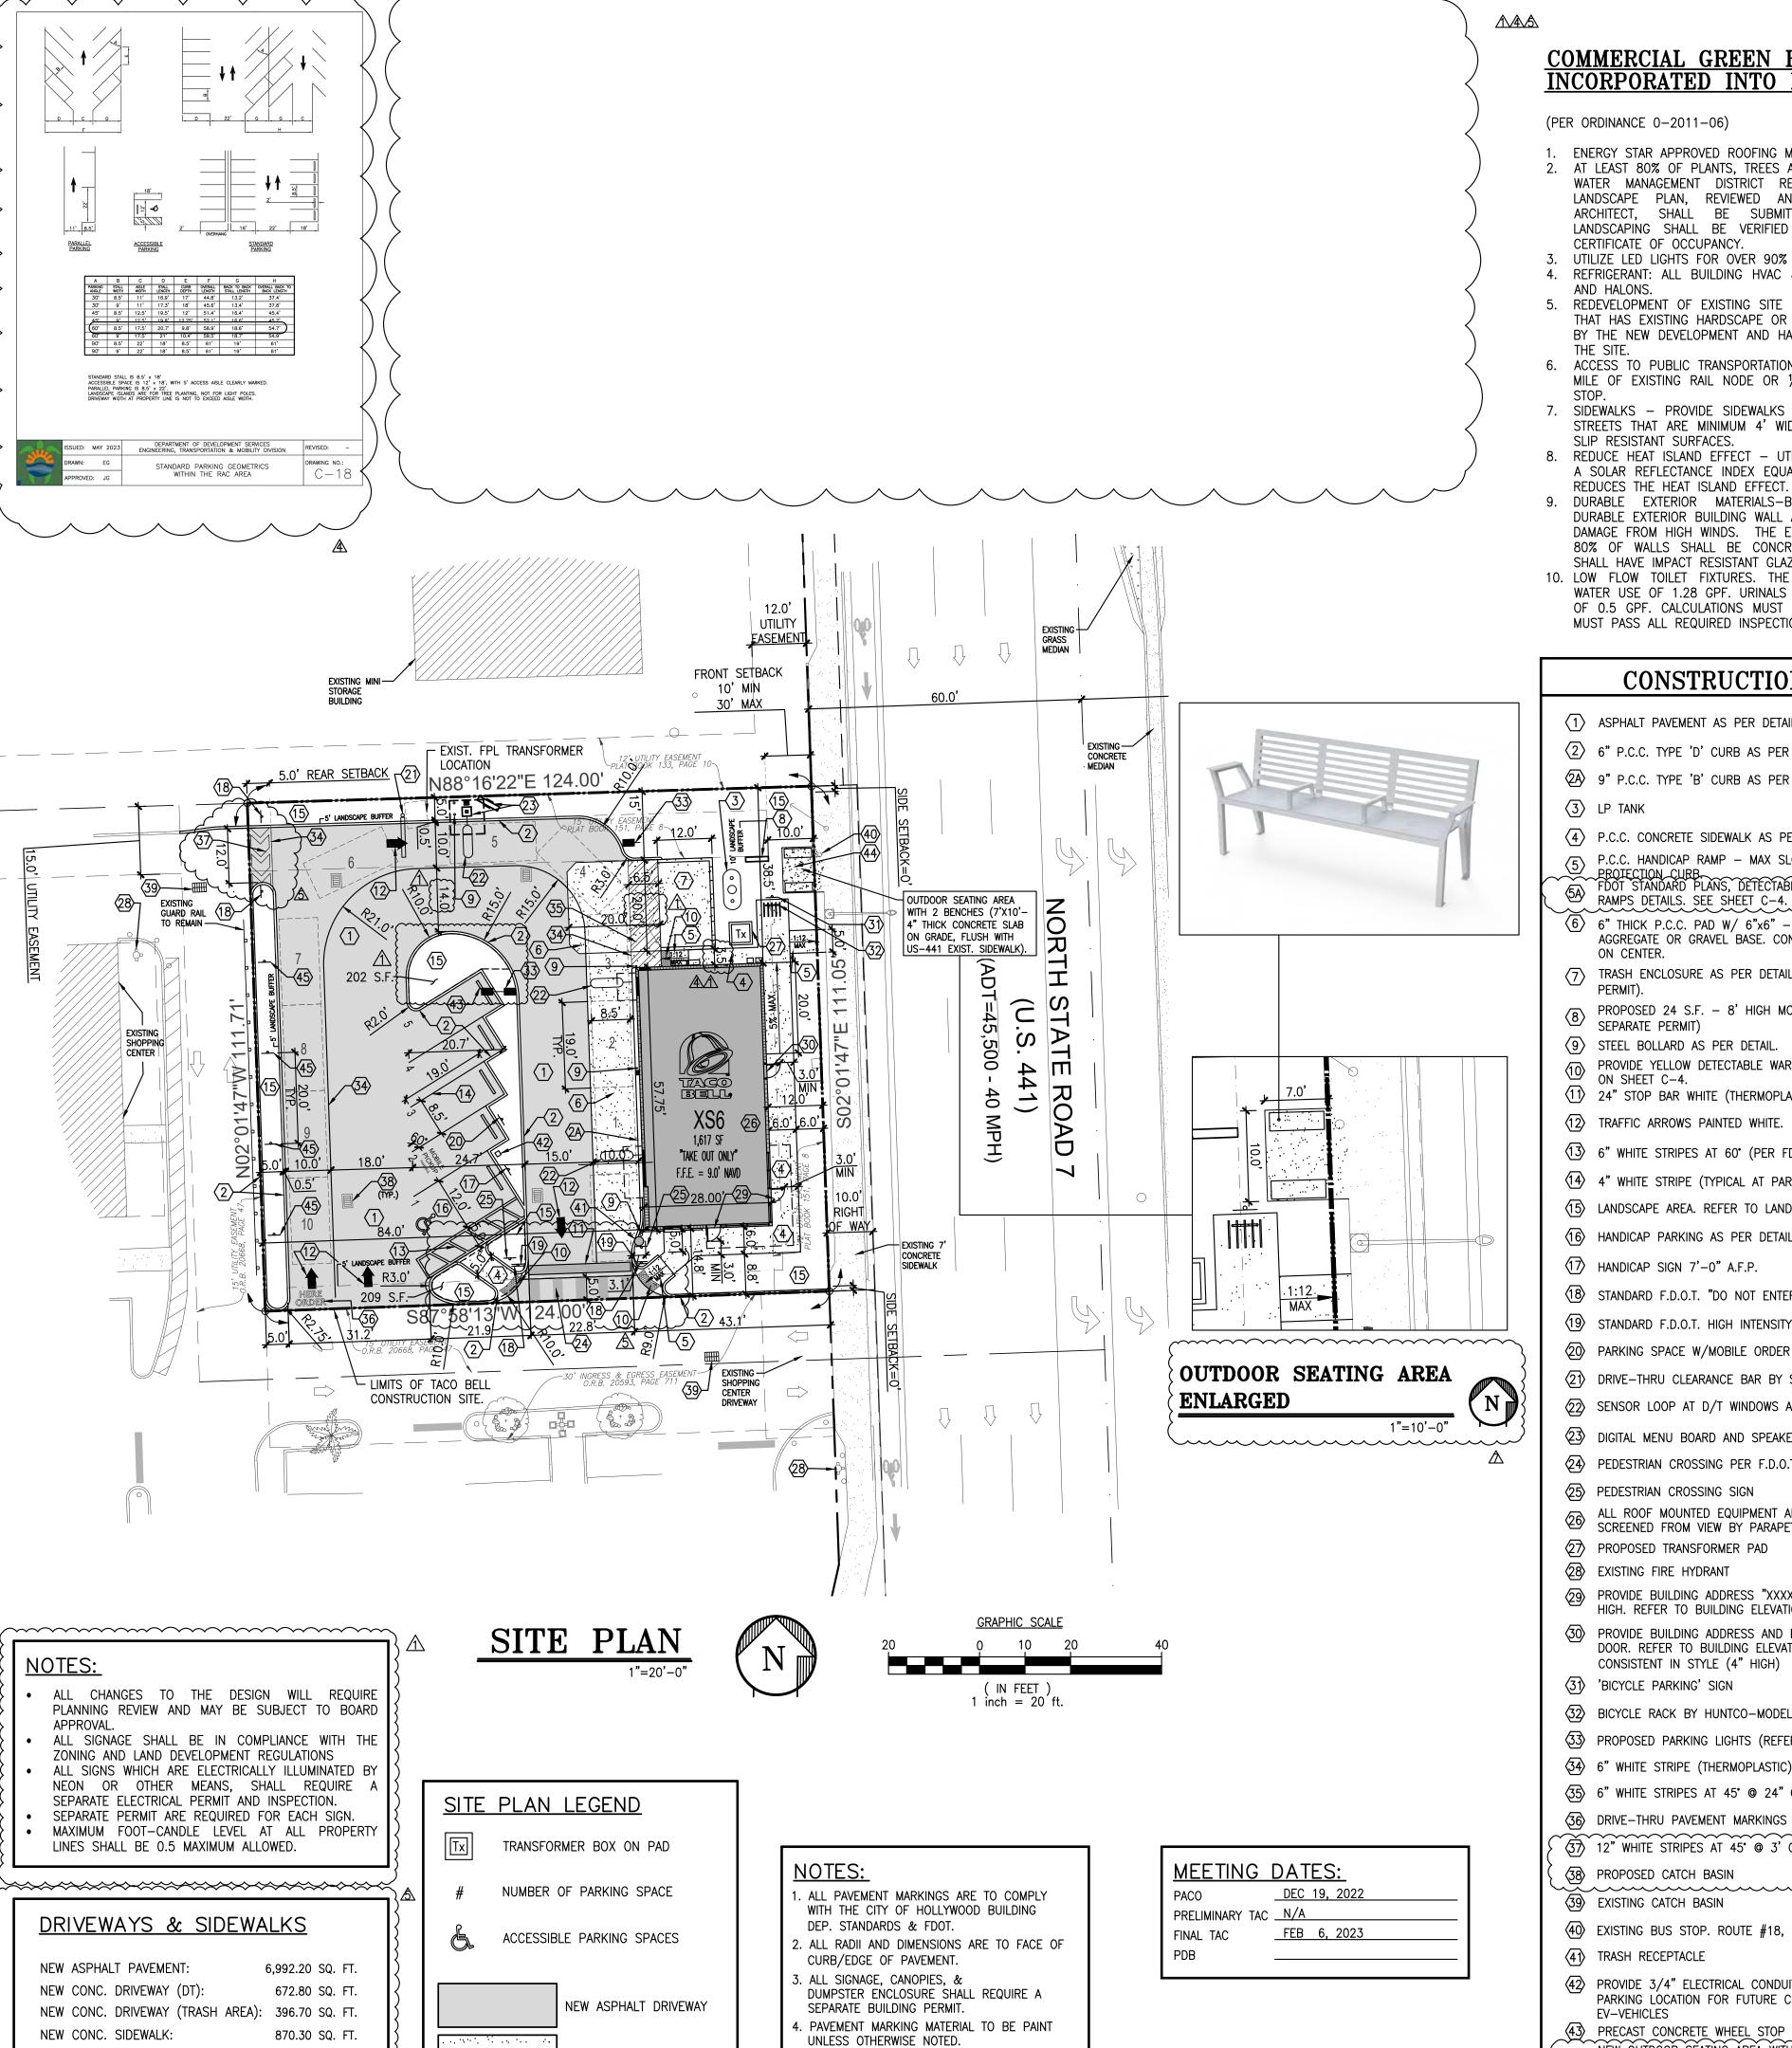

NEW CONC. SIDEWALK/

ALL LIGHTS AND LIGHTING SHALL BE DESIGNED

AND ARRANGED AS NOT TO CAUSE A DIRECT

GLARE INTO ADJACENT PROPERTIES.

NEW CONC. PAD (TRASH ENCLOSURE): 240.40 SQ. FT.

NEW LINEAR FT OF CURB (TYPE 'D'): 672.20 FT.


COMMERCIAL GREEN BUILDING PRACTICES INCORPORATED INTO PLANS

(PER ORDINANCE 0-2011-06)

- ENERGY STAR APPROVED ROOFING MATERIALS. 2. AT LEAST 80% OF PLANTS, TREES AND GRASS PER THE SOUTH FLORIDA WATER MANAGEMENT DISTRICT RECOMMENDATIONS (LATEST EDITION). LANDSCAPE PLAN, REVIEWED AND APPROVED BY A LANDSCAPE ARCHITECT, SHALL BE SUBMITTED WITH PERMIT APPLICATION. LANDSCAPING SHALL BE VERIFIED BY INSPECTION PRIOR TO FINAL CERTIFICATE OF OCCUPANCY.
- 3. UTILIZE LED LIGHTS FOR OVER 90% OF PARKING LOT LIGHTING. 4. REFRIGERANT: ALL BUILDING HVAC & R SYSTEMS ARE FREE OF CFU'S
- 5. REDEVELOPMENT OF EXISTING SITE LOCATE THE BUILDING ON A SITE THAT HAS EXISTING HARDSCAPE OR BUILDINGS THAT MUST BE REPLACED BY THE NEW DEVELOPMENT AND HAS EXISTING UTILITY CONNECTIONS TO
- 6. ACCESS TO PUBLIC TRANSPORTATION THE SITE IS LOCATED WITHIN 1/2 MILE OF EXISTING RAIL NODE OR 1/4 MILE OF AT LEAST 1 ACTIVE BUS
- 7. SIDEWALKS PROVIDE SIDEWALKS FOR ALL PATHS TO ADJACENT CITY STREETS THAT ARE MINIMUM 4' WIDE WITH CONCRETE OR OTHER FIRM, SLIP RESISTANT SURFACES.
- 8. REDUCE HEAT ISLAND EFFECT UTILIZE A COOL-ROOF THAT WILL HAVE A SOLAR REFLECTANCE INDEX EQUAL TO OR GREATER THAN 78, WHICH REDUCES THE HEAT ISLAND EFFECT.
-). DURABLE EXTERIOR MATERIALS—BUILDING DESIGN SHALL INCLUDE DURABLE EXTERIOR BUILDING WALL AND WINDOW MATERIALS TO PREVENT DAMAGE FROM HIGH WINDS. THE EXTERIOR SURFACE OF A MINIMUM OF 80% OF WALLS SHALL BE CONCRETE OR BRICK MASONRY. WINDOWS SHALL HAVE IMPACT RESISTANT GLAZING.
- 10. LOW FLOW TOILET FIXTURES. THE TOILETS SHALL HAVE A MAXIMUM WATER USE OF 1.28 GPF. URINALS SHALL HAVE A MAXIMUM WATER USE OF 0.5 GPF. CALCULATIONS MUST BE SUBMITTED WITH PLANS. SYSTEM MUST PASS ALL REQUIRED INSPECTIONS BY PLUMBING INSPECTOR.

CONSTRUCTION NOTES:

- (1) ASPHALT PAVEMENT AS PER DETAIL.
- (2) 6" P.C.C. TYPE 'D' CURB AS PER DETAIL.
- ②A 9" P.C.C. TYPE 'B' CURB AS PER DETAIL.
- 4 P.C.C. CONCRETE SIDEWALK AS PER DETAIL
- P.C.C. HANDICAP RAMP MAX SLOPE 1:12, WITH 6" EDGE
- PROTECTION CURB. FDOT STANDARD PLANS, DETECTABLE WARNINGS & SIDEWALK CUR RAMPS DETAILS. SEE SHEET C-4. $\langle 6 \rangle$ 6" THICK P.C.C. PAD W/ 6"x6" -10/10 W.W.M. OVER CRUSHED
- AGGREGATE OR GRAVEL BASE. CONSTRUCTION JOINTS AT 10 FEET ON CENTER.
- 7 TRASH ENCLOSURE AS PER DETAIL SHT. C-7 (UNDER SEPARATE
- 8 PRUPUSED 2. SEPARATE PERMIT) PROPOSED 24 S.F. — 8' HIGH MONUMENT SIGN (UNDER
- (9) STEEL BOLLARD AS PER DETAIL.
- PROVIDE YELLOW DETECTABLE WARNING SURFACE. SEE DETAIL #10 ON SHEET C-4.
- (11) 24" STOP BAR WHITE (THERMOPLASTIC)
- 12 TRAFFIC ARROWS PAINTED WHITE.
- (13) 6" WHITE STRIPES AT 60" (PER FDOT INDEX No. 17346)
- 4" WHITE STRIPE (TYPICAL AT PARKING SPACES)
- (15) LANDSCAPE AREA. REFER TO LANDSCAPE DRAWINGS.
- (16) HANDICAP PARKING AS PER DETAIL.
- 17 HANDICAP SIGN 7'-0" A.F.P.
- (18) STANDARD F.D.O.T. "DO NOT ENTER" SIGN (R5-1)
- (19) STANDARD F.D.O.T. HIGH INTENSITY "STOP" SIGN. R1-1 (30"x30")
- 20 PARKING SPACE W/MOBILE ORDER PICK-UP SIGN
 - (21) DRIVE-THRU CLEARANCE BAR BY SIGN CO.
 - SENSOR LOOP AT D/T WINDOWS AND MENU BOARD
 - 23 DIGITAL MENU BOARD AND SPEAKER PEDESTAL W/CANOPY (24) PEDESTRIAN CROSSING PER F.D.O.T. INDEX NO. 17346
 - (25) PEDESTRIAN CROSSING SIGN
- ALL ROOF MOUNTED EQUIPMENT AND ACCESSORIES SHALL BE SCREENED FROM VIEW BY PARAPET
- 27) PROPOSED TRANSFORMER PAD
- (28) EXISTING FIRE HYDRANT
- PROVIDE BUILDING ADDRESS "XXXX" WITH NUMERALS 9 INCHES HIGH. REFER TO BUILDING ELEVATION
- PROVIDE BUILDING ADDRESS AND BUSINESS NAME ON SERVICE DOOR. REFER TO BUILDING ELEVATION ALL LETTERS TO BE CONSISTENT IN STYLE (4" HIGH)
- (31) 'BICYCLE PARKING' SIGN
- 32 BICYCLE RACK BY HUNTCO-MODEL BR3 OR APPROVED EQUAL
- (33) PROPOSED PARKING LIGHTS (REFER TO SHEET CE-1)
- (34) 6" WHITE STRIPE (THERMOPLASTIC)
- (35) 6" WHITE STRIPES AT 45" @ 24" O.C. (THERMOPLASTIC)
- 37) 12" WHITE STRIPES AT 45" @ 3' O.C. (THERMOPLASTIC)
- (38) PROPOSED CATCH BASIN
- (40) EXISTING BUS STOP. ROUTE #18, ID#1302.
- (41) TRASH RECEPTACLE
- PROVIDE 3/4" ELECTRICAL CONDUIT FROM ELECTRICAL PANEL TO PARKING LOCATION FOR FUTURE CHARGING STATION FOR EV-VEHICLES
- 43 PRECAST CONCRETE WHEEL STOP (TYP. 6"x6"x6") NEW OUTDOOR SEATING AREA WITH 2 BENCHES (7'x10'- 4" THICK CONCRETE SLAB ON GRADE, FLUSH WITH US-441 EXIST. SIDEWAL
- 45 "NO PARKING" SIGN.

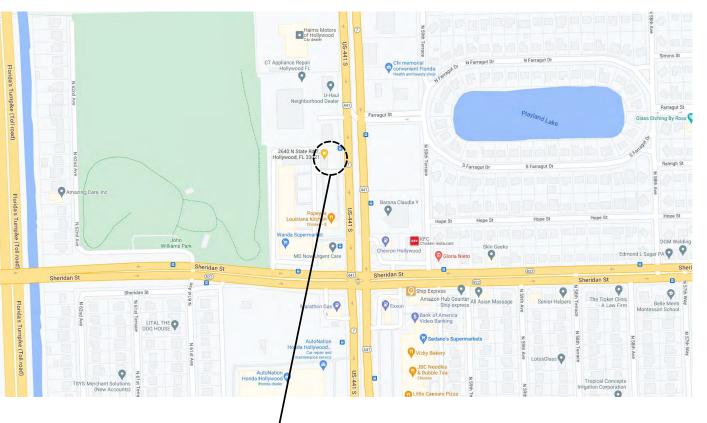

TACO BELL SITE -LOCATION MAP

THIS SITE LIES IN SECTION 1, TOWNSHIP 51 SOUTH, RANGE 41 EAST, BROWARD COUNTY, FLORIDA.

LEGAL DESCRIPTION (TITLE COMMITMENT)

NEW RESTAURANT

DESCRIPTION

DESCRIPTION

5 PARKING DATA

NEW RESTAURANT, TAKE OUT

5 DRIVE -THRU VEHICULAR STACKING

VEHICULAR STACKING

SUMMARY OF REQUESTS: VARIANCES, MODIFICATIONS AND SPECIAL EXCEPTION

VEHICULAR USE LANDSCAPE

PARKING SPACES

TRANSPARENCY

ACTIVE USE

7-PROJECT SUMIMARY

Bicycle Rack reduction

-Public Art reduction

SPECIAL EXCEPTION

VARIANCE

ALLOWED

MAXIMUM

PROVIDED DESCRIPTION

TOTAL STANDARD PARKING SPACES

PARCEL "A", "GATOR 441 SUBDIVISION", ACCORDING TO THE PLAT THEREOF, RECORDED IN PLAT BOOK 151, PAGE 8, OF THE PUBLIC RECORDS OF BROWARD COUNTY, FLORIDA.


SAID LANDS LYING AND BEING IN THE CITY OF HOLLYWOOD, BROWARD COUNTY, FLORIDA AND CONTAINING 13,811 SQUARE FEET (0.3171 ACRES), MORE OR LESS.

SITE AND CODE DATA									
DECCRIPTION			TACO BELL RESTAURANT						
DESCRIPTION CURRENT ZONING				Mixed-Use Distr	ict)				
CURRENT LAN				ed Corridor (TC					
CURRENT USE			Commercial	ea comaon (1	<i>50,</i> <u>71</u>				
0011112111 002			00111111010101						
1 GENERAL IN	GENERAL INFORMATION								
DESCRIPTION	DESCRIPTION								
NON-RESIDEN	NON-RESIDENTIAL			ТҮРЕ				GROSS BUILDING AREA	
			New Restaura	nt			1,617 SF		
FAR			N/A						
TOTAL SITE AR	EA		13,811 (NET) S	F	(0.317 Acres)		<u> </u>		
YOTAL BUILDIN	ıg [∨] ∨	~	1,617 SF		Y1.71%	κ ν ν			
TOTAL VEHICULAR USE AREA			7,738.2 SF		55.81%	6	<u> </u>	<u>\</u>	
INTERIOR LAN	DSCAPE AREA	(MINUS	1,178.0 SF	1,178.0 SF 15.28% of vehicular use area 🗸					
PERIMETER LA	NDSCAPE SET E	BACK AREA))		
TOTAL LANDS	APE AREA		3,021.6 SF 21.88%						
2 SETBACKS									
NE	EW RESTAURAI	NT							
DESCRIPTION	ALLOWED MIN-MAX	PROVIDED	DESCRIPTION	ALLOWED MIN-MAX	PROVIDED	DESCRIPTION	ALLQWED MIN-MAX	PROVIDED	
FRONT (EAST)	10'-0'/30'-0"	12'-0")	IVIII VIII VIII VIII VIII VIII VIII VI			1411 (4-141/-4/2		
REAR (WEST)	5'-0"	84'-0"							
SIDE (NORTH)	0'-0"	38'-6" 🛕							
SIDE (SOUTH)	0'-0"	14'-9.5" 🕰							
, ,	•	•		•	•	•	•		
3 WINIWINA	ACTIVE USES	<u></u>	/						
FRONTAGE				REQUIRED		PROVIDED			
U.S. 441 (111.0	05 FT)			60%		57.75'	(52%)		
4 HEIGHTS PR	OVIDED								
			1			1			

225	MIN-MAX	111017020		MIN-MAX		<u> </u>
)						△ 10/23/2
7						<u> </u>
						<u>A</u> 12/19/2
-)						
	•		<u> </u>			CONTRACT [
						BUILDING TY
	REQUIRED		PROV	/IDED		PLAN VERSION
	60%		57.75			BRAND DESI
	0078			(3270)		
						SITE NUMBE
			Τ			STORE NUM
						PA/PM:
DESCRIPTION	ALLOWED	PROVIDED	DESCRIPTION	ALLOWED	PROVIDED	DRAWN BY.:
JESCRIP HON	MAXIMUM	PROVIDED	DESCRIPTION	MAXIMUM	PROVIDED	JOB NO.:
						TAC
MINIMUM 1 PI	FD 150 SE RI III	DING AREA		REQUIRED	REQUIRED	264
	ER 130 31 BOIL	DING AREA		MINIMUM	MAXIMUM	HOLLYW
Standard parki				11 sp	-	
5% of 11 sp (se	e item #32 on	plan)		(0.55)		
5% of 11 sp (Gr	aphic Art - Bui	Iding East Elev	vation)	(0.55)		
				10 sp	-	
OARD PARKIN	G SPACES				D 5 SPACES	
	\checkmark			INCLU	DING 1 HC	-
				\		Ī
						<u> </u>
IN BO	UND	ОИТ	BOUND			
IN BO	UND PROVIDED	OUT REQUIRED	BOUND PROVIDED			
			1			
REQUIRED	PROVIDED	REQUIRED	PROVIDED			SIT
REQUIRED	PROVIDED	REQUIRED	PROVIDED			SIT
REQUIRED	PROVIDED 6	REQUIRED 1	PROVIDED			SIT
REQUIRED 6	PROVIDED 6	REQUIRED 1	PROVIDED			SIT
REQUIRED 6	PROVIDED 6	REQUIRED 1	PROVIDED			SIT
REQUIRED 6	PROVIDED 6	REQUIRED 1 (CEPTION	PROVIDED 1	7.2.28		SIT
REQUIRED 6 DIFICATIONS A ES	PROVIDED 6	REQUIRED 1 (CEPTION REQUIRED	PROVIDED 1 PROVIDED			SIT
REQUIRED 6 DIFICATIONS A	PROVIDED 6	REQUIRED 1 CCEPTION REQUIRED 10	PROVIDED 1 PROVIDED 5	7.2.28)(c)	SIT



17190 ROYAL PALM BLVD. SUITE #2 WESTON , FLORIDA 33326 PHONE: (305) 558-4124 FAX: (305) 826-0619

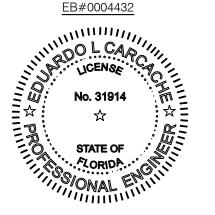

<u>SEAL</u> EDUARDO L. CARCACHE **CIVIL ENGINEER-PE 31914** RICARDO J. PEREZ ARCHITECT-AR 14985

Eduardo L. Carcache, State of Florida, Professional Engineer, License No. 31914.

This item has been digitally signed and sealed by Eduardo L. Carcache on the date indicated here. Printed copies of this document are not considered signed and sealed and the signature must be verified on any electronic

DATE REMARKS 03/24/23 CITY COMMENTS 0/01/24 CITY COMMENTS /23/24 CITY COMMENTS /13/24 CITY COMMENTS /19/24 CITY COMMENTS


TRACT DATE: ING TYPE: VERSION:

ID DESIGNER: DANIEL DICKSON NUMBER: E NUMBER: TB-459380 DIANA DeCICCO

TACO BELL 2640 N SR-7, OLLYWOOD, FL 33021



SITE PLAN

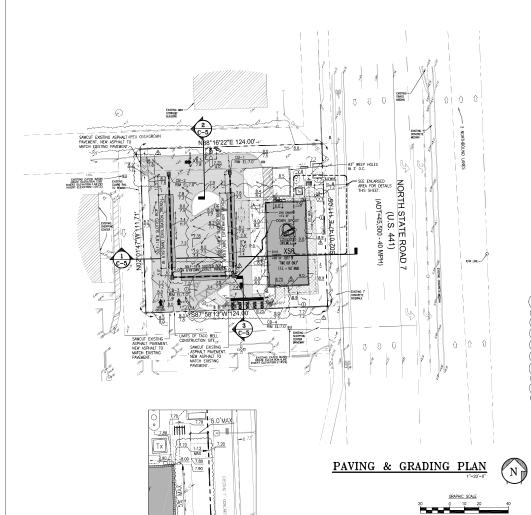

N

9.0

Δ

ENLARGED AREA



- . SITE CONTRACTOR SHALL GRADE ALL LANDSCAPED AREAS TO AN ELEVATION 3" BELOW TOP OF CURB
- 2. SITE CONTRACTOR IS RESPONSIBLE FOR GRADING ALL SITE, INCLUDING BERMS AND SWALES, IF ANY COORDINATE WITH LANDSCAPE DRAWINGS AND LANDSCAPE CONTRACTOR.
- SITE CONTRACTOR IS RESPONSIBLE FOR POSITIVE DRAINAGE OVER ENTIRE SITE.
- 4. GENERAL CONTRACTOR SHALL PROVIDE SLEEVES FOR LANDSCAPE IRRICATION LINES PRIOR TO PAMING, COORDINATE WITH IRRIGATION DRAWINGS AND IRRIGATION CONTRACTOR.

NOTE:

CONTRACTOR TO DEMOLISH EXISTING BUILDINGS (INCLUDING FOUNDATIONS AND UNDERGROUND STRUCTURES), REMOVE ALL DEBRIS, PROVIDE CLEAN AND GRADED SITE, AND VERIFI-LOCATION AND INVERT ELEVATIONS, PRIOR TO TACO BELL START CONSTRUCTION.



LOCATION MAP (N

THIS SITE LIES IN SECTION 1, TOWNSHIP 51 SOUTH, RANGE 41 EAST, BROWARD COUNTY, FLORIDA.

LEGAL DESCRIPTION:

PARCEL "A", "GATOR 441 SUBDIVISION", ACCORDING TO THE PLAT THEREOF, RECORDED IN PLAT BOOK 151, PAGE 8, OF THE PUBLIC RECORDS OF BROWARD COUNTY, FLORIDA.

PROPOSED DRAINAGE SCHEDULE

		INVERT ELEVATIONS					
STRUCTURE #	TYPE	GRATE EL.	N	S	E	٧	
C9-1	"F"-(4'x4")	7.0		2.5'*			
CB-2	"M"-(5'x5')	7.0		2.5'*			
CB-3	"M"-(5'x5')	7.0	2.5**		2.5'*		
CB-4	"M"-(5'x5')	7.0	2.5'*		(8"RD) 3.5'	2.5	

REQUIRED FINISH FLOOR ELEVATION

1 FT ABOVE FLOOD CRITERIA N/A-FLOOD ZONE "X" 6 INCHES ABOVE CROWN OF ROAD 8.46'+0.5'=8.96'

LEGEND



Know what's below.

Call before you dig.



PROP. DIRECTION OF DRAINAGE FLOW ARROW

PROPOSED ELEVATIONS







PROP. TOP OF CURB & FINISHED PAVEMENT ELEV.

G.C. TO VERIFY MAX. 2% SLOPE AT HANDICAP SPACE AND ACCESSIBILITY ROUTE

SLOPE ALONG ACCESS PATH NOT TO EXCEED 5% AND MAX. 2% CROSS SLOPE.

GENERAL NOTES

- ALL ORGANC OR DELETEROUS MATERIAL SHALL BE REMOVED FROM WITHIN 10 FEET OF ANY AREA TO BE FILLED. THIS INCLUDES ALL BUILDING AREAS AND PAVING AREA WHICH ARE BEING FILLED. ANY SOLIC MATERIAL SHALL BE REPLACED WITH APPROVED GRANULAR FILL WHICH SHALL BE COUPACTED IN 8" LAYERS TO 100% OF MAXIMUM DENSITY AS PER ASHYLL TO SHALL BE COUPACTED.
- ALL UTILITIES AND DRAINAGE INSTALLATIONS SHALL BE CONSTRUCTED, INSTALLED, AND ACCEPTED BY THE CITY OF HOLLYWOOD PUBLIC UTILITIES DEPARTMENT.
- LIMEROCK BASE COURSE SHALL CONFORM TO THE REQUIREMENTS OF SECTION 911 OF THE FLORIDA D. O. T. STANDARD SPECIFICATIONS, EXCEPT THAT THE MINIMUM PERCENTAGE OF CARBONATES OF CALCIUM AND MAGNESIUM SHALL BE 70%.
- ASPHALTIC CONCRETE SURFACE COURSE SHALL BE TYPE S-III.
- PRIME COAT AND TACK COAT FOR BASE COURSES SHALL CONFORM TO THE REQUIREMENTS OF SECTIONS 300-1 THROUGH 300-7 OF FLORIDA D. O. T. STANDARD SPECIFICATIONS. PRIME COAT SHALL BE APPLIED AT A RATE OF 0.25 GALTONS PER SOURIE YARD.
- ALL CONCRETE SHALL HAVE A MINIMUM COMPRESSIVE STRENGTH OF 3000 PSI AT 28 DAYS UNLESS OTHERWISE NOTED.
- PRECAST CONCRETE MANHOLES AND CATCH BASINS SHALL MEET THE REQUIREMENTS O A. S. T. M. SPECIFICATIONS C-478 AND 64T, AND THE CITY OF HOLLYWOOD UTILITIES DEPARTMENT MINIMUM STANDARDS.
- CONCRETE FOR PRECAST MANHOLE AND CATCH BASINS SHALL HAVE A MINIMUM COMPRESSIVE STRENGTH OF 4000 PSI AT 28 DAYS.
- REINFORCING STEEL FOR MANHOLES AND CATCH BASINS SHALL CONFORM TO A. S. T. M. SPECIFICATIONS A-615 AND A-305, LATEST REVISION.
- 11. ALL JOINTS IN CONCRETE STRUCTURES SHALL BE FINISHED WATERTIGHT
- ALL SPACES AROUND PIPING ENTERING OR LEAVING MANHOLES AND CATCH BASINS SHALL BE COMPLETELY FILLED WITH 2: 1 CEMENT MORTAR MIX.
- REINFORCED CONCRETE PIPE SHALL CONFORM TO THE REQUIREMENTS OF A. S. T. M. SPECIFICATION G-76, CLASS II, WALL THICKNESS "B", LATEST REVISION, AND AS MODIFIED BY SECTION 941 FLORBOA D. O. T. STANDARD SPECIFICATIONS. (LATEST EDITION)
- . ALL WORKMANSHIP, INSTALLATIONS, AND MATERIALS SHALL MEET THE THE CITY OF HOLLYWOOD UTILITIES DEPARTMENT MINIMUM STANDARDS.
- 6. THE LOCATION OF EXISTING UTILITIES SHOWN ON THE PLANS ARE APPROXIMATE AND ARE BASED ON AS-BUILT INFORMATION. ADDITIONAL UTILITIES MAY EXIST WHICH ARE NOT SHOWN ON THESE PLANS. THE CONTRACTOR SHALL BE RESPONSIBLE FOR LOCATING AND VERIFYING ALL UTILITIES PRIOR TO BEGINNING CONSTRUCTION.
- SHOP DRAWINGS OF ALL IMPERIALS BEING USED SIMIL BE SUBMITTED TO C. K. E. GROUP, INC. AND TO THE MIAMI DADE COUNTY PUBLIC WORKS DEPARTMENT FOR APPROVAL PRIOR TO ORDERING THE MATERIALS.
- THE CONTRACTOR SHALL BE RESPONSIBLE FOR PROVIDING CERTIFIED AS—BUILT DRAWINGS PRIOR TO FINAL INSPECTION BY THE CITY OF HOLLYWOOD OFFICIALS OF UNDERGROUND UTILITIES.
- SOIL BORING RECORDS ARE PART OF THE BID DOCUMENTS. IN THE EVENT OF DISCREPANCY BETWEEN THE SPECIFICATIONS AND THE SOILS REPORT RECOMMENDATIONS, THE MOST STRINGENT OF THE TWO SHALL BE USED.



SUITE #2 WESTON , FLORIDA 33326 PHONE: (305) 558-4124 FAX (305) 826-0619 EB#0004432



sonsidered signed and souled and the signature must be verified on any elec-copies.

BUILDING TYPE:

JOB NO.:

PLAN VERSION: BRAND DESIGNER: DANIEL DICKSON

SITE NUMBER: STORE NUMBER TB-459380 DIANA DeCICCO DRAWN BY.


TACO BELL 2640 N SR-7, HOLLYWOOD, FL 33021




XS6

PAVING AND GRADING PLAN

PLOT DATE:

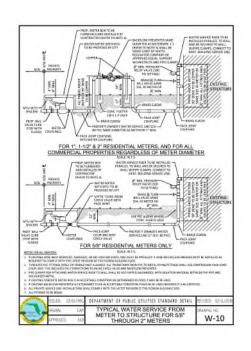


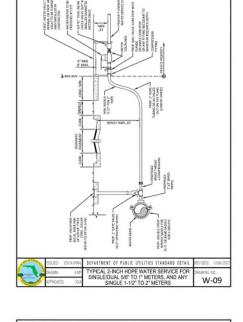



- 1. SUCCESSIVE TAPS INTO THE WATER MAIN SHALL BE SPACED NOT LESS THAN 18" DIN CENTER.
- P.E. TUBING SHALL BE IN ACCORDANCE WITH THE LATEST EDITION OF AWWA STANDARD CHOL. "POLYETHYLER: JPE; PRESSURE PIPE AND TUBING, 1/2 IN. (13mm) THROUGH 3 IN. (76 mm), FOR WATER SURVICE".
- MINIMUM SERVICE PIPE DIAMETER SHALL BE 2" FOR SINGLE OR DUAL 36" OR SINGLE 3" DIAMETER METERS.
- MINIMUM SERVICE PIPE DIAMETER SHALL BE 2" FOR SINGLE OR DUAL 1-X" OR SINGLE 2" DIAMETER METERS.
- FOR METER DIAMETERS LARGER THAN 2", THE MINIMUM SERVICE PIPE DIAMETER SHALL BE THE SAME AS THE METER DIAMETER.
- 6. APPROVED COPPER TUBING MAY BE USED AT THE CITY'S DISCRETION.
- FOR NEW METER INSTALLATIONS, ALL SADDLES, VALVES, PIRMO, PITTINGS, CURB STOPS, METER
 VALVES, METER COLPTUNGS, METER WALLTS AND COVERS SHALL BE FURNISHED AND INSTALLED
 BY THE CONTRACTOR. THE METER METERS WILL BE PROVIDED AND INSTALLED BY THE CITY OF
 HOLLYWOOD (NEW ACCOUNTS).
- FOR METER RELOCATIONS, ALL SADDIES, VALVES, PHING, PITTINGS, CURB STOPS, METER VALVES, METER COLVINGS, METER VALUTS AND COVERS SHALL BE FURRISHED AND INSTALLED BY THE CONTRACTOR. THE ERISTING WATER METER TO BE RELOCATED AND INSTALLED BY CONTRACTOR.
- FOR EXISTING METERS ABUTTING THE RIGHT-OF-WAY THAT ARE BEING DISCONNECTED FROM EXISTING MAINS AND RECONNECTED TO NEW MAINS, THE CONTRACTOR SHALL:
- CUT AND FLUG THE EXISTING SERVICE LINE AT THE MAIN AND AT THE METER, AND REMOVE THE EXISTING BALL VALVE CURB STOP.
- 6. FURNISH AND INSTALL SERVICE SADDLE, CORPORATION STOP OR SERVICE VALVE AND VALVE BOX, PIPING AND FITTINGS UP TO AND INCLUDING THE BALL VALVE CUITS STOP.
- THE ELEVATION AT THE TOP OF THE METER BOX SHALL MATCH THE ELEVATION OF THE BACK OF SIDEWALK, WHENEVER PRACTICAL.
- 13. AS PART OF THE SERVICE INSTALLATION, THE CONTRACTOR SHALL RESTORE THE RIGHT OF WAY TO MATCH EXISTING CONDITIONS, INCLUDING INDAMAY PAYMENT, PAYMENT MANISHES AND RHM, CONCIETE CLARIS DEPARKAS, RAMP (INCLUDING DETECTABLE WARRING SURFACE), SODDING, AND ALL OTHER IMPROVEMENTS REMOVED OR DAMAGED DURING THE SCREYCE INSTALLATION.
- 14. FOR UNPAVED AREAS, THE MINIMUM GROUND COVER ACCEPTED BY THE CITY IS SODDING.

	DRAWN.	EAM	WATER METER SERVICE NOTES FOR 5/8* THROUGH 2" METERS	DRIWING NO.
-	HBLED:	03/07/1494	DEFARTMENT OF PUBLIC UTILITIES STANDARD DETAIL	REVISED: 11/06/2017

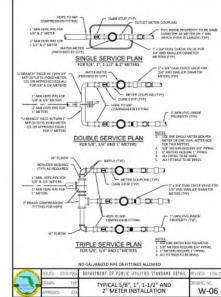





17190 ROYAL PALM BLVD SUITE #2 WESTON , FLORIDA 33326 PHONE: (305) 558-4124 FAX: (306) 869-6619 -B#0004432



EDUARDO L. CARCACHE
CIVIL ENGINEER-PE 31914
RICARDO J. PEREZ
ARCHITECT-AR 14985

Etuardo L. Carcache, State of Handa, Pedessonal Engineer, License No. 31914. This item has been digitally signed and oxided by Eduardo L. Carcache on the date indicated horse.




PLAN VERSION.
BRAND DESIGNER DANIEL DICKSON
SITE NUMBER: 315998
STORE NUMBER: TB-45930
STORE NUMBER: DIANA DeCICCO
DRAWN BY: AG
JOB NO.:

TACO BELL 2640 N SR-7, HOLLYWOOD, FL 33021



SITE UTILITY



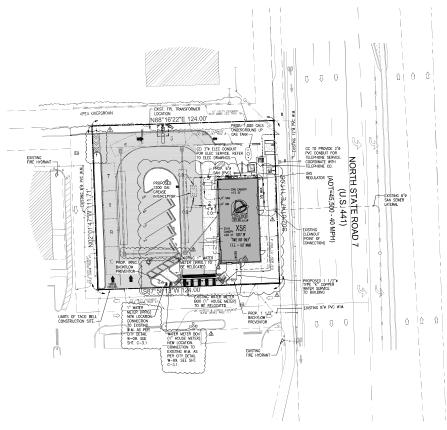

SITE UTILITY PLAN





SITE PLAN LEGEND

NUMBER OF PARKING SPACE







NOTES:

- 1. ALL HYDRANTS TO FALL WITHIN 2 FEET OF CURB, STEAMER CONNECTION TO FACE ROADWAY
- 2. WATER SHALL BE AVAILABLE TO ALL HYDRANTS PRIOR TO START OF CONSTRUCTION.

- 5. ALL CLEANOUTS IN DRIVEWAYS TO HAVE TRAFFIC BEARING CAPS (USG #7605 VALVE BOX).
- 7. CONTRACTOR TO VERIFY INVERTS AND EXACT LOCATION OF UTILITIES PRIOR TO COMMENCING WITH WORK.
- CONTRACTOR TO PROVIDE CLEANOUTS AT EACH CHANGE OF DIRECTION OF SEWER LINE AND AT INTERVALS NOT TO EXCEED 70 FT. 10. NO SOLVENT WELD SHALL BE USED.
- 11. REFER TO THE PUBLIC UTILITIES DEPARTMENT OF CITY OF HOLLYWOOD FOR ADDITIONAL DETAILS.
- ON SITE WATER AND SEWER NOT INSIDE UTILITY EASEMENTS MUST BE PERMITTED AND INSPECTED BY PLUMBING OFFICIALS AT PUBLIC UTILITIES DEPARTMENT.
- PHYSICAL SEPARATION BETWEEN THE BUILDING AND THE WATER AND SEWER SERVICE LINES IS REQUIRED PRIOR TO BUILDING DEMO.





LOCATION MAP


LEGAL DESCRIPTION:

PARCEL "A", "GATOR 441 SUBDIVISION", ACCORDING TO THE PLAT THEREOF, RECORDED IN PLAT BOOK 151, PAGE 8, OF THE PUBLIC RECORDS OF BROWARD COUNTY, FLORIDA.

THIS SITE LIES IN SECTION 1, TOWNSHIP 51 SOUTH, RANGE 41 EAST, BROWARD COUNTY, FLORIDA.

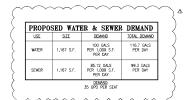

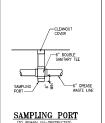

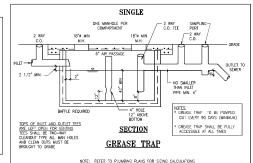

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SUITE #2 WESTON , FLORIDA 33326 PHONE (305) 558-4124 FAX (305) 826-0619 EB#0004432



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	DATE	REMARKS
Δ	03/24/23	CITY COMMENTS
Δ	07/29/24	DRAINAGE COMMENTS
Δ	09/11/24	CITY COMMENTS
Δ	10/23/24	CITY COMMENTS

CONTRACT DATE:

BUILDING TYPE: BRAND DESIGNER: DANIEL DICKSON SITE NUMBER: STORE NUMBER: TB-459380 PA/PM: DIANA DeCICCO


DRAWN BY:

JOB NO.: TACO BELL 2640 N SR-7, HOLLYWOOD, FL 33021




SITE UTILITY PLAN



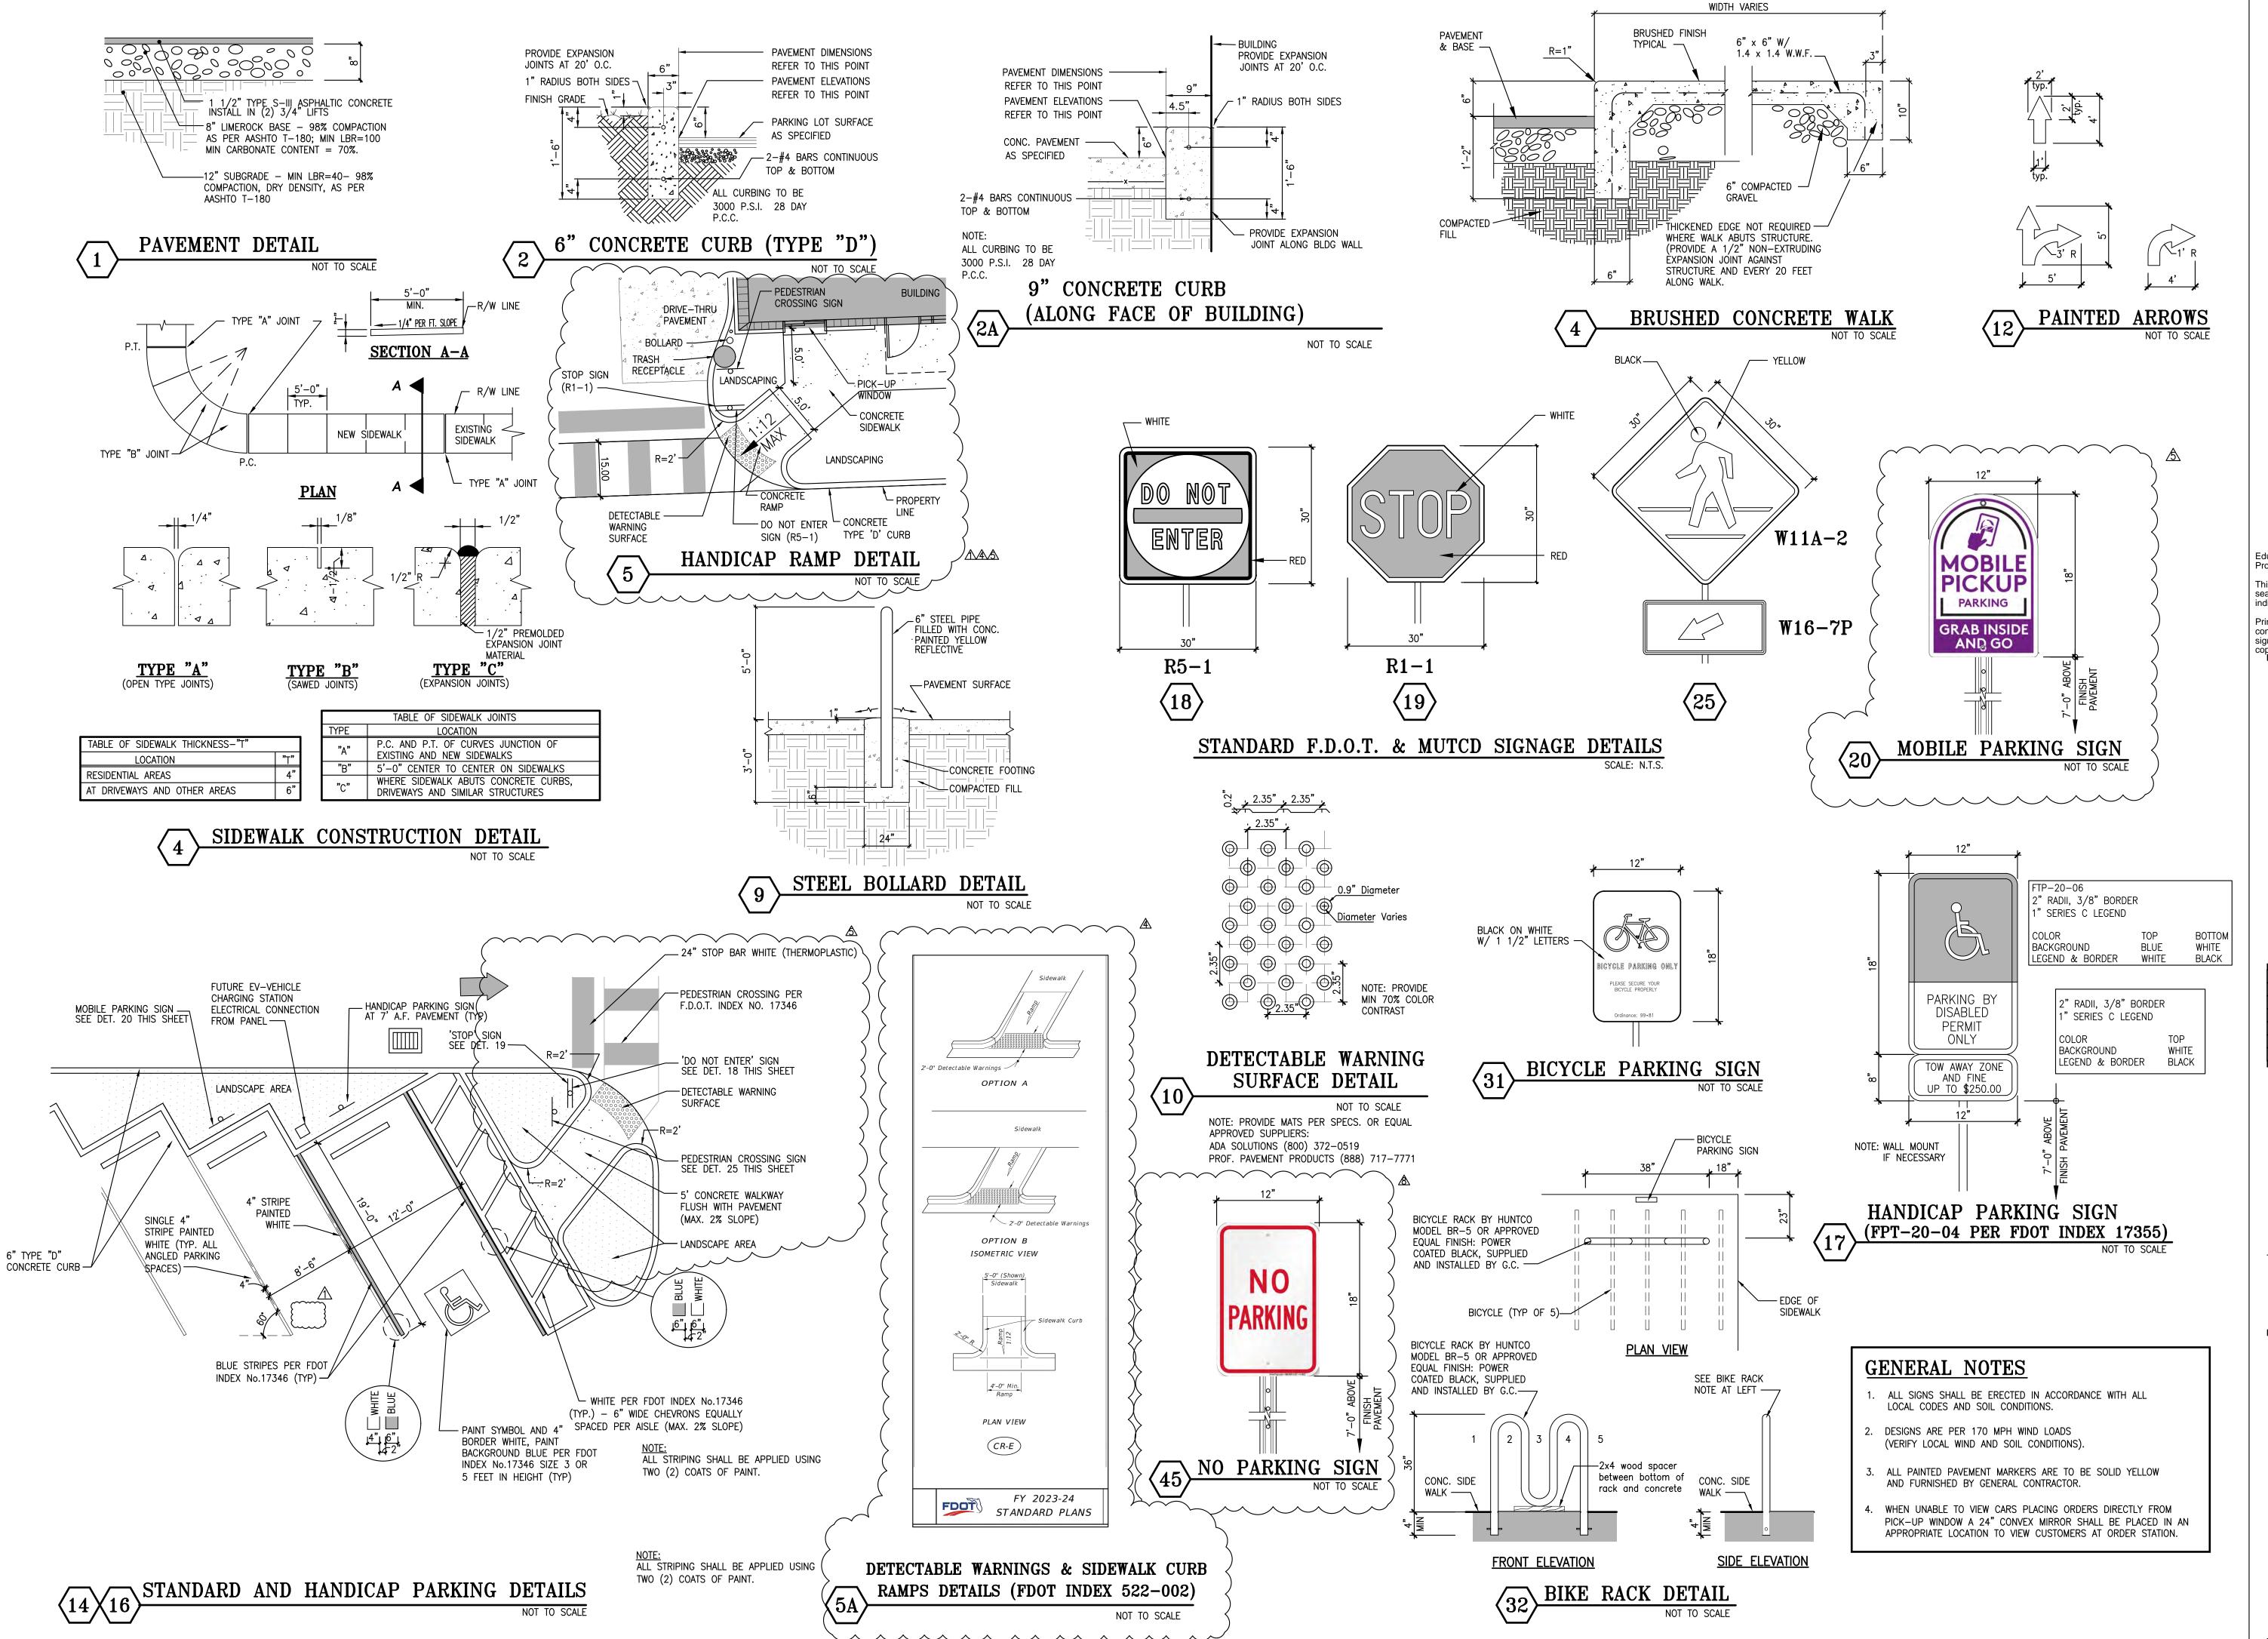



SUITE #2
WESTON , FLORIDA 33326
PHONE: (305) 558-4124
FAX: (305) 826-0619
EB#0004432

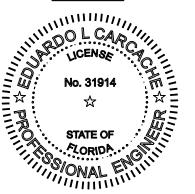

SEAL
EDUARDO L. CARCACHE
CIVIL ENGINEER-PE 31914
RICARDO J. PEREZ
ARCHITECT-AR 14985

Eduardo L. Carcache, State of Florida, Professional Engineer, License No. 31914. This item has been digitally signed and sealed by Eduardo L. Carcache on the date indicated here.

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	DATE	REMARKS
\triangle	03/24/23	CITY COMMENTS
\triangle	10/01/24	CITY COMMENTS
⋬	10/23/24	CITY COMMENTS
<u>&</u>	12/19/24	CITY COMMENTS

CONTRACT DATE:
BUILDING TYPE: XS6
PLAN VERSION:
BRAND DESIGNER: DANIEL DICKSON
SITE NUMBER: 315998
STORE NUMBER: TB-459380
PA/PM: DIANA DeCICCO
DRAWN BY.: AG
JOB NO.:


TACO BELL 2640 N SR-7, HOLLYWOOD, FL 33021



XS6

SITE DETAILS

C-4

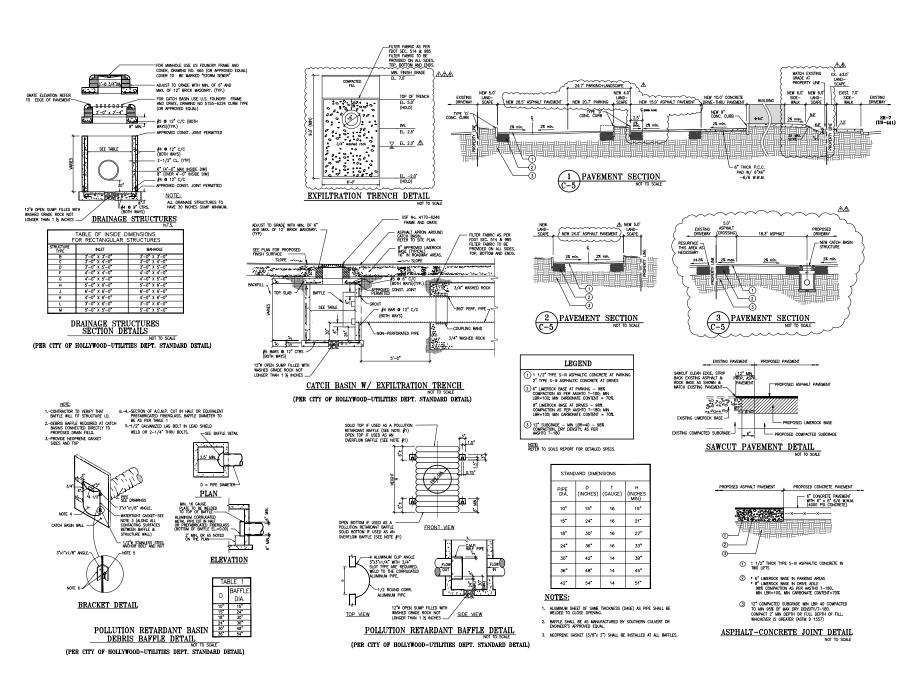



SUITE #2 WESTON , FLORIDA 33326 PHONE: (305) 558-4124 FAX: (305) 826-0619



ARCHITECT-AR 14985

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A 03/24/23 CITY COMMENTS

BUILDING TYPE: PLAN VERSION:

PA/PM:

DRAWN BY.


BRAND DESIGNER: D. STORE NUMBER

DIANA DeCICCO

JOB NO.: TACO BELL 2640 N SR-7, HOLLYWOOD, FL 33021



XS6 SITE **DETAILS &** PAVEMENT SECTIONS

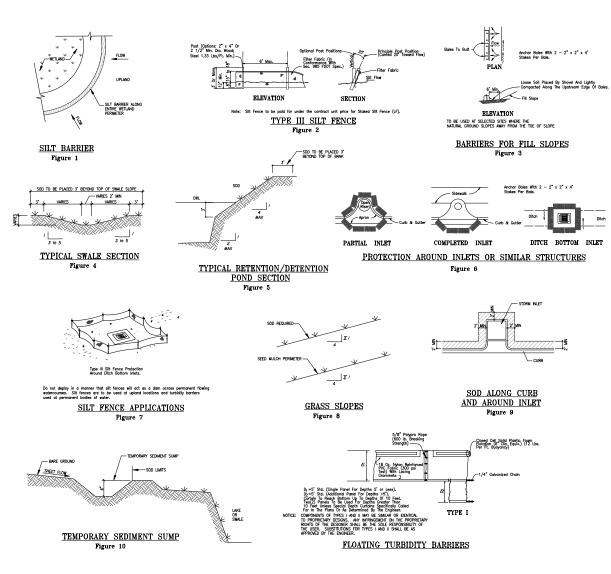

STORMWATER POLLUTION PREVENTION DETAILS

1. Protection of preserved/conserved wetland habitats during construction.

- 4. Protection of surface water quality during and after construction.

SECTION 1 PROTECTION OF PRESERVED/CONSERVED WETLAND HABITATS DURING CONSTRUCTION

1.4 Silt barriers used for wetland protection shall remain in place for the duration of any site—work or outliding construction located in the vicinity of the wetland. Sit barriers erected during development alone be designed and methodsed to not improve intermittent standing water for more than 7.2 hours, borriers, any sit which accumulates behind these barriers and any fit used to another the barriers shall be removed promptly duffer the end of the mediterance period specified for the barriers.

SECTION 2 PROTECTION OF PRESERVED/CONSERVED UPLAND HABITATS

2.1 Barricades shall be placed around all protected (preserved) habitats including mesic and uplands during development.

3.1 General erosion control BMPs shall be employed to minimize soil erosion and potential lake slop cave-ins. While the various techniques required will be site and plan specific, they should be employed as soon as possible during construction activities.

3.4 All gross slopes constructed steeper than 4H:1V shall be sodded as soon as practical after their construction as shown in Figure 8.

SECTION 4 PROTECTION OF SURFACE WATER QUALITY DURING AND AFTER CONSTRUCTION

4.1 Surface water quality shall be maintained by employing the following BMPs in the construction planning and construction of all improvements.

a. In general erosion shall be controlled at the furthest practical upstream location

4.5 Silt barriers, any silt which accumulates behind the barriers, and any fill used to anchor shall be removed promptly after the end of the maintenance period specified for the barriers. SECTION 5 CONTROL OF WIND FROSION

A fine carbon soul or Countered by employing the touckey intensions to intensional and depolarization. A fine carbon reason shall be widered during construction on reasons to inminisc the transport of inglifier dual. It may be increasing to find construction verifice speed it love earth has not been finely been as the construction verifice speed it love earth has not been been been been as the construction verification and the construction has the many that the construction has a sent and the construction but watering and/or vegetation are not effective in controlling and entering and/or vegetation are not effective in controlling water controlling with entering and/or vegetation are not effective in controlling water and and the representation and for temporary of the Office dual, their methods can are necessary for such controlling water and the representation and the representation of the controlling water and the representation of the controlling water and the representation of the controlling water and the cont

1. THE CONTRACTOR SHALL PROVIDE POLLUTION PREVENTION AND EROSION CONTROL MEASURES AS SPECIFIED IN FOOT INDEX ∯100 AND AS NECESSARY FOR EACH SPECIFIC APPLICATION



PHONE: (305) 558-4124 FAX: (305) 826-0619



ARCHITECT-AR 14985

CONTRACT DATE:							

BRAND DESIGNER: DANIEL DICKSON SITE NUMBER STORE NUMBER TB-459380


DIANA DeCICCO DRAWN BY. JOB NO.:

TACO BELL 2640 N SR-7, HOLLYWOOD, FL 33021



XS6

POLLUTION PREVENTION DETAILS

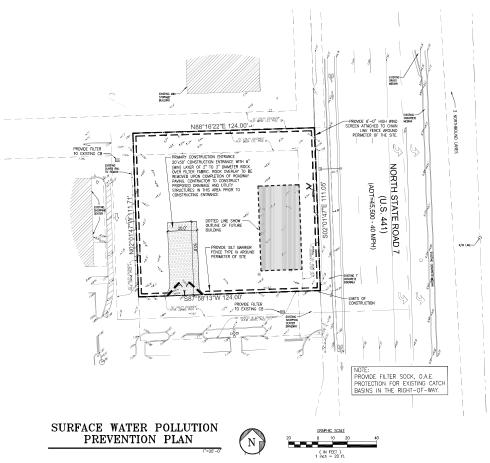





1. CONTRACTOR IS TO CLEAN INLET FILTER AFTER EVERY STORM.
2. CONTRACTOR TO REMOVE FAIRED JUST PRIOR TO PARRIE.

INLET FILTER DETAIL

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THE COTTANT SHILL SE MANTANED IN A CONDITION WHICH WILL PREVENT
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TEMPORARY GRAVEL CONSTRUCTION ENTRANCE

2% OR GREATER

NOTE: USE SANDBAGS, STRAW BALES OR OTHER APPROVED METHODS TO CHANNELIZE RUNOFF TO BASIN AS REQUIRED

MAINTENANCE NOTES

OF A 0.5" RAINFALL EVENT, AND CLEANED AND REPAIRED IN ACCORDANCE WITH THE FOLLOWING:

- THE CONSTRUCTION ENTRANCES SHALL BE MAINTAINED IN A CONDITION WHICH WILL PREVENT TRACKING OR FLOW OF MUI ONTO PUBLIC RIGHTS-OF-WAY, THIS MAY REQUIRE PERIODIC TOP DRESSING OF THE CONSTRUCTION ENTRANCES AS CONDITIONS DEMAND.
-), THE TEMPORARY PARKING AND STORAGE AREA SHALL BE KEPT IN GOOD CONDITION (SUITABLE FOR PARKING AND STORAGE). THIS MAY REQUIRE PERSIONS OF THE TEMPORARY PARKING AS CONDITIONS DEMAND.

CONSTRUCTION SEQUENCE

SECTION 'A-A'

2 3" COURSE ACCRECATE MIN. 6" THICK O

PLAN VIEW

1. THE ENTRANCE SHALL BE MAINTAINED IN A CONDITION THAT WILL PREVENT TRACKING OR FLOWING OF SEDMENT ONTO PUBLIC PROHISTOR WAY. THIS MAY REQUIRED TOP PRESSING, REPAIR AND/OR CLEANOUT OF ANY MEASURES USED TO TRAP SEDIMENT.

WHEN WASHING IS REQUIRED, IT SHALL BE DONE ON AN AREA STABILIZED WITH CRUSHED STONE THAT DRAINS INTO AN APPROVED SEDIMENT TRAP OR SEDIMENT BASIN.

SUPPLY WATER TO WASH WHEELS IF NECESSARY

- ALL SEEDED AREAS SHALL BE CHECKED REGULARLY TO SEE THAT A GOOD STAND IS MAINTAINED, AREAS SHOULD BE FERTILIZED, WATERED AND RESEEDED AS NEEDED.

- ALL MAINTENANCE OPERATIONS SHALL BE DONE IN A TIMELY WISE MANNER BUT IN NO CASE LATER THAN 7 CALENDAR DAYS FOLLOWING THE INSPECTION.


- EMPORARY CONSTRUCTION FEMIC SOLIT FINISE MID WIND SCREEN EDUCATION OF STREET STATES OF STREET TEMPORARY STATELIZATION TEMPORARY STATELIZATION TEMPORARY STATELIZATION TEMPORARY STATELIZATION TEMPORARY TRANSITION OF STATELI

LOCATION MAP (N

THIS SITE LIES IN SECTION 1, TOWNSHIP 51 SOUTH, RANGE 41 EAST, BROWARD COUNTY, FLORIDA.

LEGAL DESCRIPTION:

PARCEL "A", "CATOR 441 SUBDIVISION", ACCORDING TO THE PLAT THEREOF, RECORDED IN PLAT BOOK 151, PAGE 8, OF THE PUBLIC RECORDS OF BROWARD COUNTY, FLORIDA.

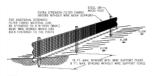



SILT FENCE INSTALLATION DETAILS



GROUP

GROUP

INCORPORATED 17190 ROYAL PALM BLVD SUITE #2 WESTON , FLORIDA 33326

PHONE: (305) 558-4124 FAX (305) 826-0619 EB#0004432

No. 31914

Eduardo L. Carcache, State of Florida, Professional Engineer, License No. 31914

This item has been digitally signed and social by Eduardo L. Carcache on the date indicated have


BRAND DESIGNER: DANIEL DICKSON SITE NUMBER: STORE NUMBER TB-459380 DIANA DeCICCO


DRAWN BY. JOB NO.:


> TACO BELL 2640 N SR-7, HOLLYWOOD, FL 33021



SURFACE WATER POLLUTION PREVENTION PLAN

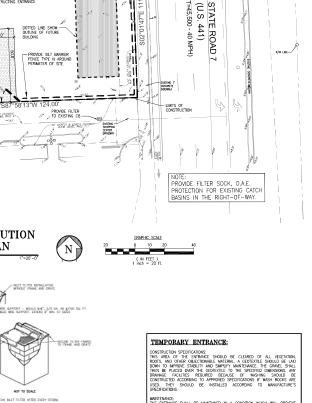

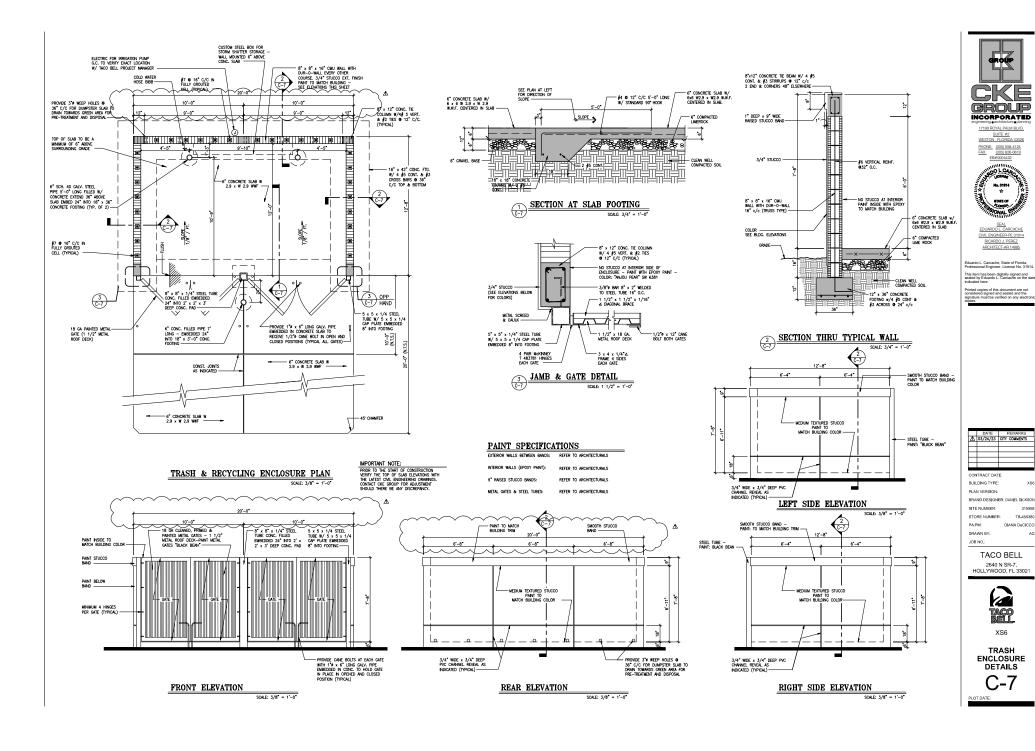

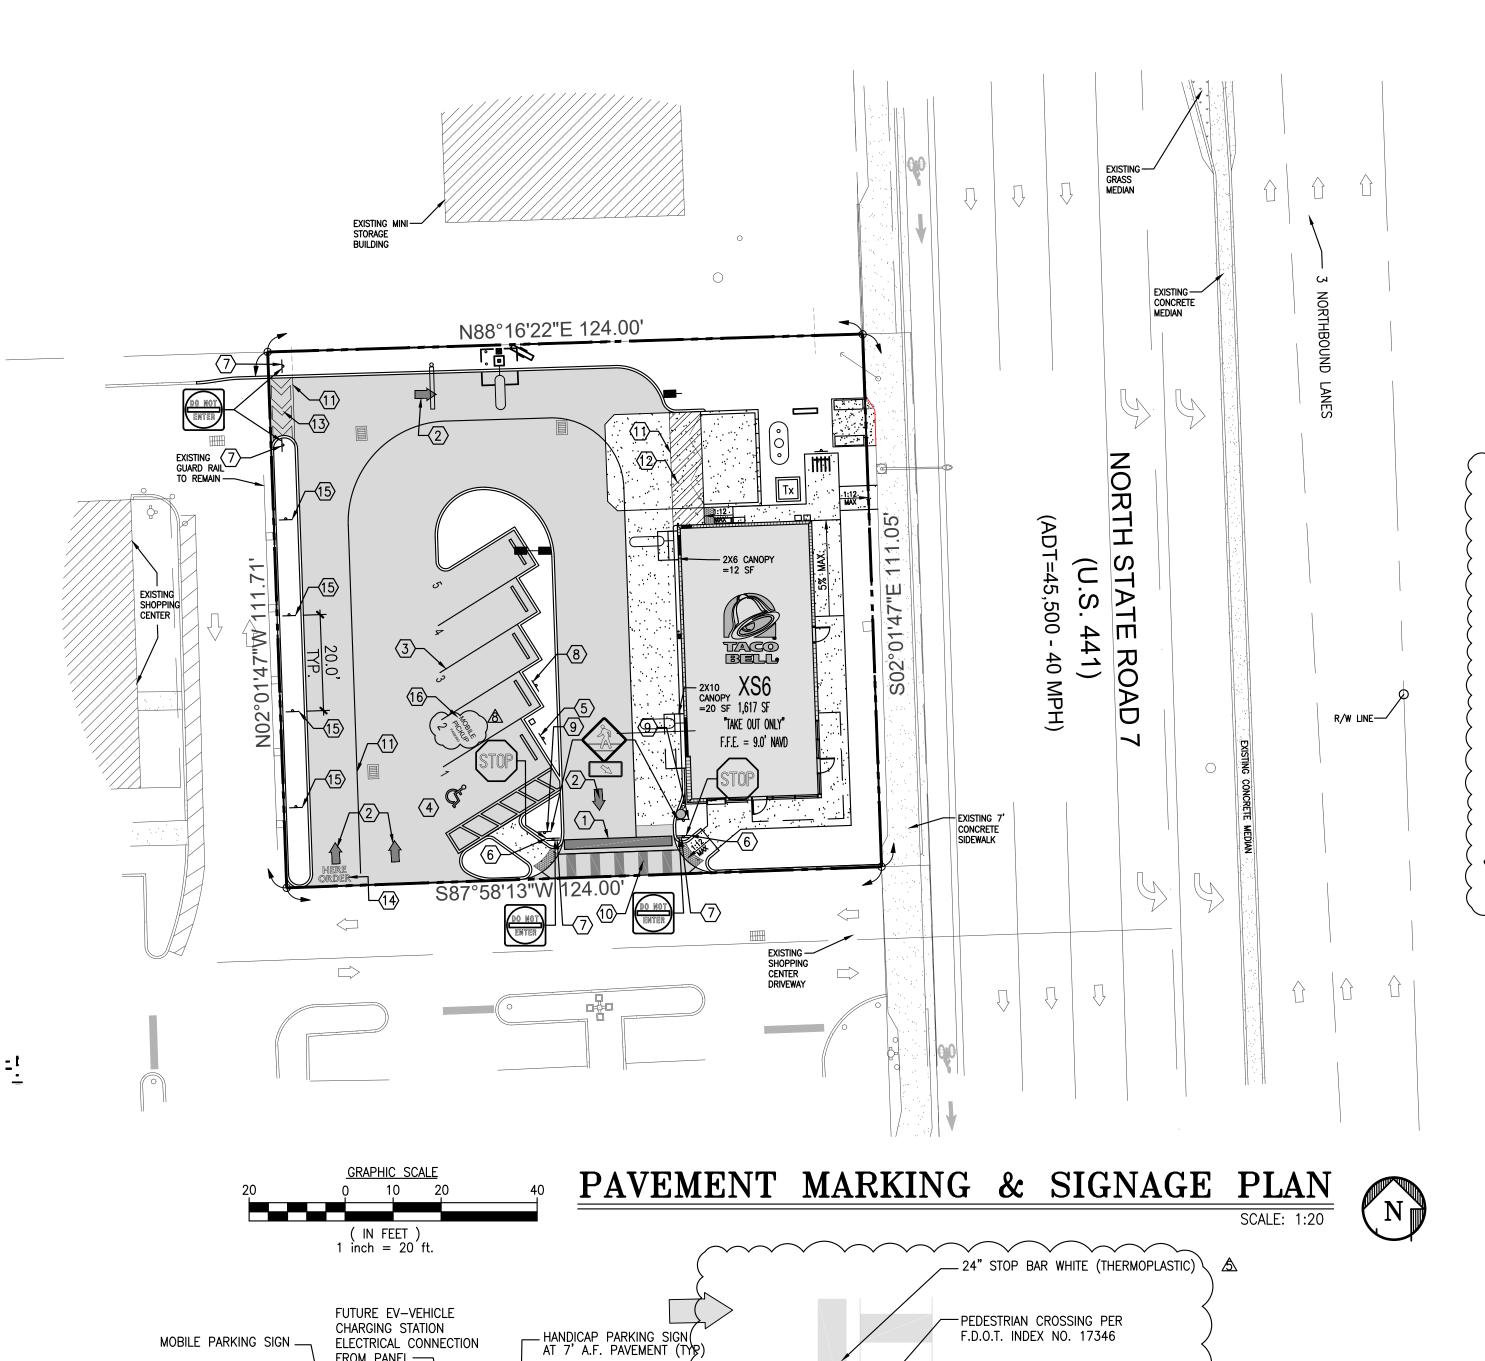

- 'DO NOT ENTER' SIGN SEE DET. 18 THIS SHEET

PEDESTRIAN CROSSING SIGN SEE DET. 25 THIS SHEET

NOTE: ALL STRIPING SHALL BE APPLIED USING

TWO (2) COATS OF PAINT.

5' CONCRETE WALKWAY

FLUSH WITH PAVEMENT

(MAX. 2% SLOPE)

LANDSCAPE AREA

- WHITE PER FDOT INDEX No.17346

(TYP.) - 6" WIDE CHEVRONS EQUALLY

SPACED PER AISLE (MAX. 2% SLOPE)

- PAINT SYMBOL AND 4"

BORDER WHITE, PAINT

5 FEET IN HEIGHT (TYP)

BACKGROUND BLUE PER FDOT INDEX No.17346 SIZE 3 OR

DETECTABLE WARNING

FROM PANEL -

LANDSCAPE AREA

4" STRIPE


SINGLE 4"
STRIPE PAINTED

WHITE (TYP. ALL ANGLED PARKING

6" TYPE "D" CONCRETE CURB PAINTED

BLUE STRIPES PER FDOT INDEX No.17346 (TYP)

STANDARD AND HANDICAP PARKING DETAILS

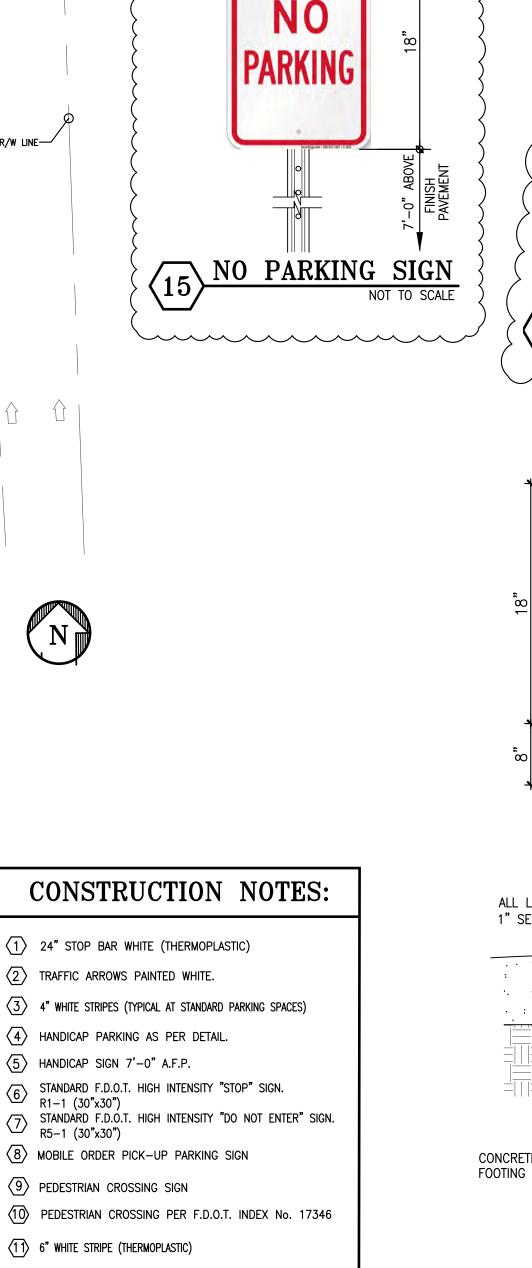


(12) 6" WHITE STRIPE- 45" @ 24" O.C. (THERMOPLASTIC)


(14) DRIVE-THRU PAVEMENT MARKING


(16) "MOBILE PICKUP PARKING" MARKING.

(15) "NO PARKING" SIGN.

13 12" WHITE STRIPES 45" @ 3' O.C. (THERMOPLASTIC)

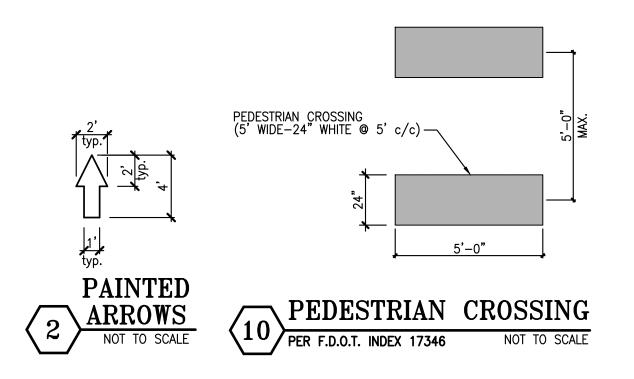

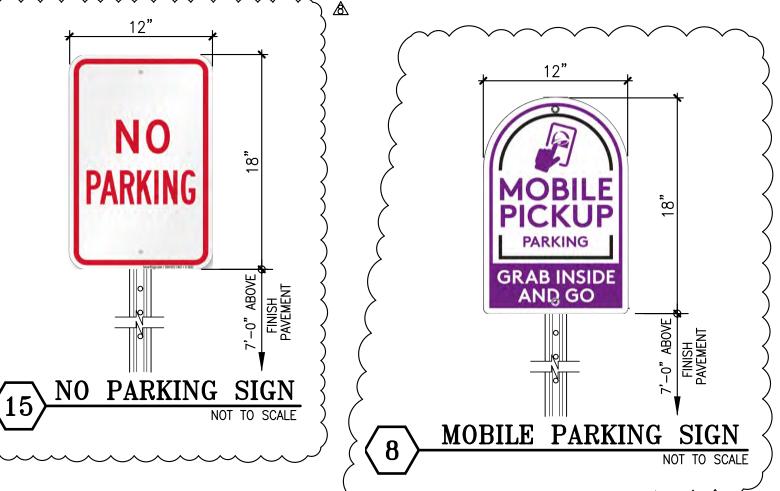

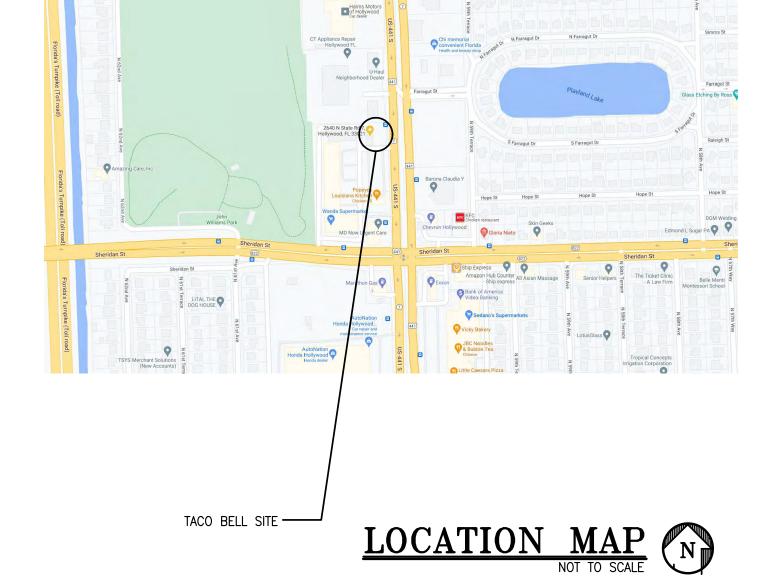

THIS SITE LIES IN SECTION 1, TOWNSHIP 51 SOUTH, RANGE 41 EAST, BROWARD COUNTY, FLORIDA.


LEGAL DESCRIPTION: (TITLE COMMITMENT)

PARCEL "A", "GATOR 441 SUBDIVISION", ACCORDING TO THE PLAT THEREOF, RECORDED IN PLAT BOOK 151, PAGE 8, OF THE PUBLIC RECORDS OF BROWARD COUNTY, FLORIDA.

SAID LANDS LYING AND BEING IN THE CITY OF HOLLYWOOD, BROWARD COUNTY, FLORIDA AND CONTAINING 13,811 SQUARE FEET (0.3171 ACRES), MORE OR LESS.



Know what's **below**. Call before you dig.

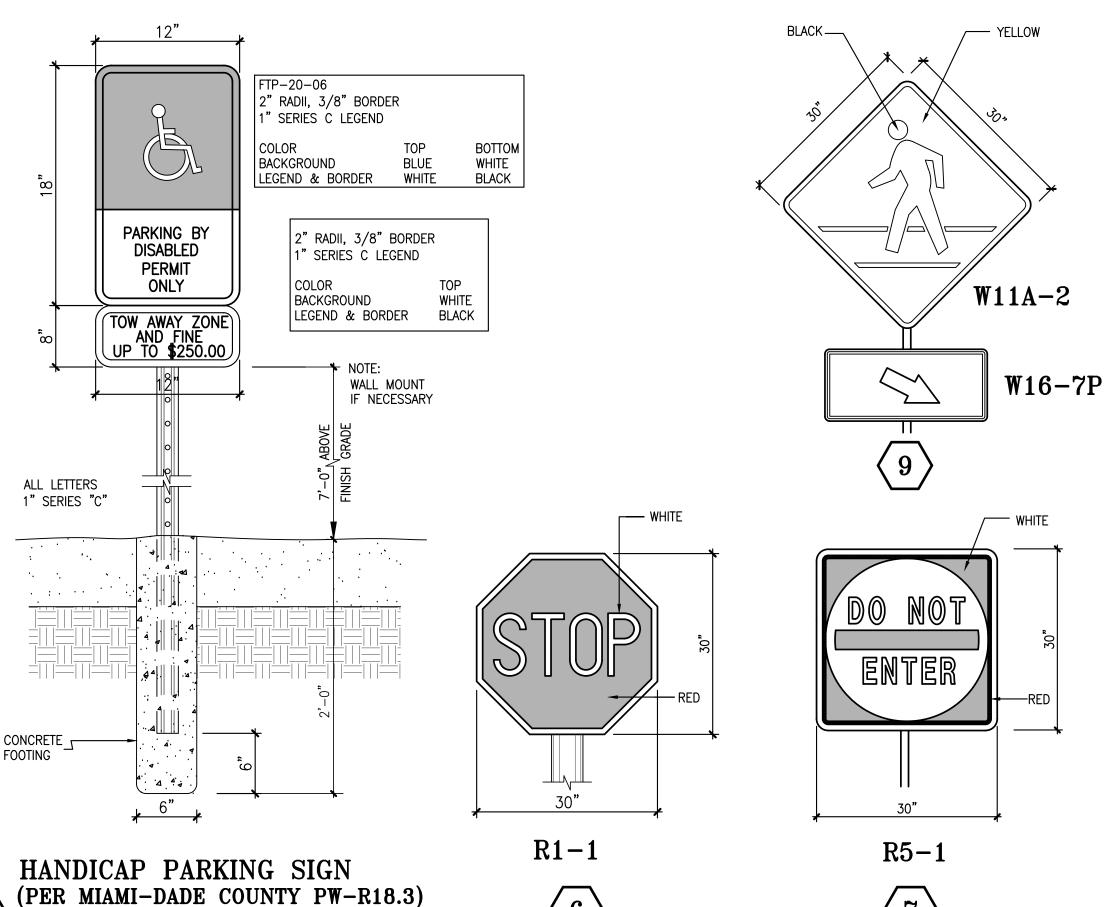

STANDARD F.D.O.T. & MUTCD SIGNAGE DETAILS

03/24/23 CITY COMMENTS 10/23/24 CITY COMMENTS 12/19/24 CITY COMMENTS

GROUP

INCORPORATED engineering • architecture • planning 17190 ROYAL PALM BLVD.

WESTON, FLORIDA 33326

PHONE: (305) 558-4124 FAX: (305) 826-0619 EB#0004432

<u>SEAL</u> EDUARDO L. CARCACHE

CIVIL ENGINEER-PE 31914 RICARDO J. PEREZ ARCHITECT-AR 14985

Eduardo L. Carcache, State of Florida, Professional Engineer, License No. 31914.

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CONTRACT DATE: BUILDING TYPE: PLAN VERSION: BRAND DESIGNER: DANIEL DICKSON SITE NUMBER:

TB-459380

DIANA DeCICCO

DRAWN BY. JOB NO.: TACO BELL

2640 N SR-7,

HOLLYWOOD, FL 33021

STORE NUMBER:


PA/PM:



XS6

PAVEMENT MARKING & SIGNAGE PLAN


PLOT DATE:

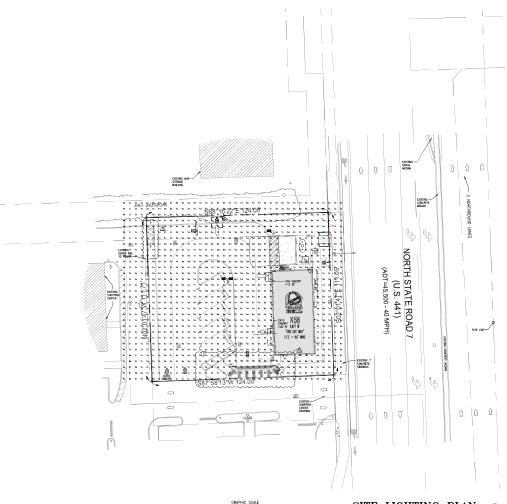







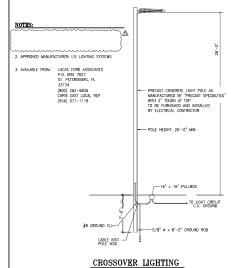



- ■POLES / LUMINARIES SHALL BE RATED FOR 170 MPH.
- ■LEVELS OF PARKING ILLUMINATION TO COMPLY WITH MIAMI-DADE COUNTY CODE SECTION 8C-3.



LOCATION MAP (N)

THIS SITE LIES IN SECTION 1, TOWNSHIP 51 SOUTH, RANGE 41 ASAT, BROWARD COUNTY, FLORIDA.

LEGAL DESCRIPTION:

PARCEL "A", "GATOR 441 SUBDIVISION", ACCORDING TO THE PLAT THEREOF, RECORDED IN PLAT BOOK 151, PAGE 8, OF THE PUBLIC RECORDS OF BROWARD COUNTY, FLORIDA.

- ■FIXTURE SUPPORT SHALL BE PER NEC 410-15.

GROUP GROUP INCORPORATED 17190 ROYAL PALM BLVD.

SUITE #2
WESTON, FLORIDA 3332E
PHONE: 305) 558-4124 EB#0004432



RICARDO J. PEREZ ARCHITECT-AR 14983

Eduardo L. Carcache, State of Fiorida, Professional Engineer, License No. 31914 This item has been digitally signed and sealed by Eduardo L. Carcache on the date indicated here.


Printed copies of this document are not considered signed and ecoled and the signature must be verified on any closing

	<u> </u>	JATE 10/23/24	REMARKS CITY COMMENTS	
	CON	TRACT DAT	TE:	
	BUILI	DING TYPE	XS	5
	PLAN	VERSION:		
	BRAN	ND DESIGN	ER: DANIEL DICKSO)
	SITE	NUMBER:	31599	9
	STOR	RE NUMBER	R: TB-45938	8
	PA/P	M:	DIANA DeCICC	
	DRAN	NN BY.:	A	4
	JOB	NO.:		
	Н	2640	D BELL N SR-7, OD, FL 33021	

XS6 SITE LIGHTING PLAN

315998 TB-459380 DIANA DeCICCO

CE-1 PLOT DATE:

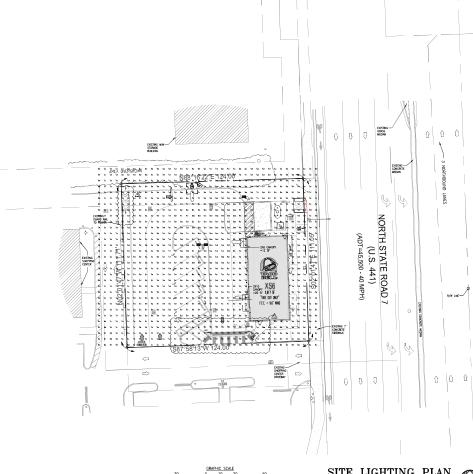



Description
SLM-LED-30L-SIL-FT-50-70CRI-SINGLE
SLM-LED-30L-SIL-SW-50-70CRI-D180

Calculation Sunnary

Lobel CalcType


CALCULATION PDINTS @ GRADE Illuminance


PARKING & DRIVING SUMMARY Illuminance

SITE LIGHTING PLAN

| Mounting Height | LLD | LLF | Arr. Lun Lunens | 24' PDLE+2' BASE | 1000 | 1000 | 31922 | 24' PDLE+2' BASE | 1000 | 1000 | 62474 |



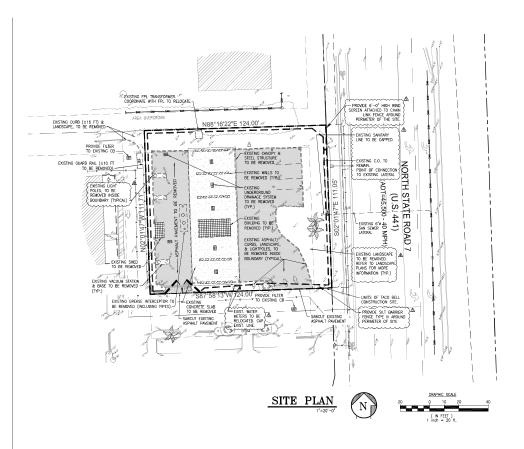

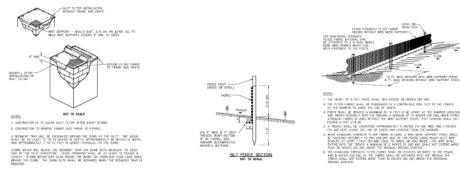

INLET FILTER DETAIL

SILT FENCE INSTALLATION DETAILS



THIS SITE LIES IN SECTION 1, TOWNSHIP 51 SOUTH, RANGE 41 EAST, BROWARD COUNTY, FLORIDA.

LEGAL DESCRIPTION:

PARCEL "A", "GATOR 441 SUBDIVISION", ACCORDING TO THE PLAT THEREOF, RECORDED IN PLAT BOOK 151, PAGE 8, OF THE PUBLIC RECORDS OF BROWARD COUNTY, FLORIDA.



GENERAL NOTES

- 2. THE CONTRACTOR SHALL BE FULLY RESPONSELE FOR THE DEMOLITION OF EXISTING ON SITE FACILITIES ABOVE AND UNDERGROUND. THE CONTRACTOR IS RESPONSELE FOR THE BEBUOKH, FROM THE SITE OF ALL DEMOLISHED MATERIALS, THE FILLING OF ALL DEPRESSIONS CAUSED BY DEMOLITION, AND THE CROWNING OF THESE RARGE SO AS NOT TO BE OBJECTIONABLE TO VIEW. THE CONTRACTOR SHALL DISEDVE ALL REQUIRED SAFETY PRECOLATIONS IN THE PETPERGAMENT OF IN HIS WORK.
- REMOVE ALL VEGETATION, ROLL AND COMPACT AREAS BEFORE REPACING FILL. FILL SHALL BE PLACED IN 12" LAYERS LOSSE MEASURE AND COMPACTED TO SOX OF MANIMUM DISBNITY AS DETERMINED BY MASTIGHTBO-TBO-TB. FILL SHALL BE LOCALLY ACCEPTABLE AND STRAIL BY FILL PROPERTY AS THE THE PLACE OF THE ACCEPTABLE THE DISBNIT SHALL BY COMPACT TO SEX OF MANIMUM DISBNITY AS DETERMINED BASE SHALL BE COMPACTED TO SEX OF MANIMUM DISBNITY AS DETERMINED BY ASSIGNMENT AS DETERMINED.
- DIMENSIONS, BUILDING LOCATION AND GRADING OF THIS SITE ARE BASED ON AVAILABLE INFORMATION AT THE OF LAYOUT. DEVAIDING MAY BE NOESSARY IN THE FIELD. ANY SUCH CHANGES OF CONFLICTS BETWELN THIS PLAN AND FELD COMMINIONS ARE TO BE REPORTED TO THE EMALTER PRIOR TO STRATING CONSTRUCTS.
- 5. IT IS THE CONTRACTOR'S FULL RESPONSIBILITY TO FURNISH AND INSTALL WATER SERVICES AS REQUIRED. LINES TO BE INSTALLED SHOULD BE EXTENDED FROM THE CLOSEST WATER MAIN CAP PLUGGED AT BUILDING. SEE C-3 FOR REQUIRED WATER SERVICE SIZE.
- LOCATION OF UNDERGROUND UTILITIES, EXISTING OR PROPOSED, ARE APPROXIMATE OR SCHEMATIC. LOCATION OF EXISTING UTILITIES MUST BE VERIFIED IN THE FIELD PRIOR TO ANY CONSTRUCTION.
- 7. ALL WORK TO BE PERFORMED THAT IS NOT COVERED BY THESE PLANS SHALL BE CONSTRUCTED IN ACCORDANCE WITH APPLICABLE STATE, COLINITY, OR LOCAL CLOSES, ALL WORK IN PUBLIC RIGHT OF WAYS SHALL BE IN ACCORDANCE WITH ALL STATE AND LOCAL REQUIREMENTS AND STRANDARD.
- PHYSICAL SEPARATION BETWEEN THE BUILDING AND THE WATER AND SEWER SERVICE LINES IS REQUIRED PRIOR TO BUILDING DEMO.

SITE PLAN LEGEND

BUILDING TO BE DEMOLISHED ASPHALT PAVEMENT TO BE CONCRETE TO BE REMOVED

DEMOLITION NOTES

- ALL EXISTING PAVEMENT MARKINGS AND SIGN WITHIN PROPERTY LINES TO BE REMOVED.
- 3. EXISTING ASPHALT PAVEMENT AND BASE WITHIN PROPERTY LINES TO BE REMOVED (DEPTH OF BASE REMOVAL BASED ON PROPOSED GRADES)

- DENOTES TO REMAIN

GROUP GROUP INCORPORATED 17190 ROYAL PALM BLVD SUITE #2 WESTON , FLORIDA 33326

PHONE: (305) 558-4124 FAX (305) 826-0619 EB#0004432



This nem has been digitally signed and oxaled by Eduardo L. Carcache on the date indicated here.

Printed copies of this document are not considered signed and scaled and the signature must be verified on any clost



BRAND DESIGNER: DANIEL DICKSON SITE NUMBER: STORE NUMBER TB-459380 DIANA DeCICCO DRAWN BY. JOB NO.:

TACO BELL 2640 N SR-7, HOLLYWOOD, FL 33021



XS6

SITE DEMOLITION PLAN



CHECK LIST NUMBER EXPLANATION:

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	(F.J.SB)	QES	²⁸ 0	NETRICO	MISS				
		1							
				П	FORMALDEHYDE LIMITS MAXIMUM FORMALDEHYDE EMISS	IONS IN PARTS PER MILLIO	N.		
				Г	PRODUCT		ENT LIMIT		
					HARDWOOD PLYWOOD VENE! HARDWOOD COMPOSITE COR PARTICLE BOARD MEDIUM DENSITY FIBER BOAR	E E	0.05 0.05 0.09 0.11		
					THIN MEDIUM DENSITY FIBER VALUES IN THIS TABLE ARE DI		0.13 IFIED BY THE CALLEGRAL	A AR RESOURCES BOARD, AR	
					2. THIN MEDIUM DENSITY FIBER		TESTED IN ACCORDANCE HICKNESS OF 5/15"	WITH ASTME 1333.	
					VOC CONTENT LIMITS FOR ARCHI GRAMS OF VOC PER LITER OF CO	TECTURAL COATINGS (C ATING, LESS WATER & LES	CONT.) S EXEMPT COMPOUNDS		
					PROF COATINGS	CURRENT	VOC LIMIT		
					RUST PREVENTATIVE COATING SUELLIACS	38	250		
					CLEAR CPAQUE • SPECIALTY PRIMERS, SEALER	SOMEO-CONTRACT & S	730 560 100		
					STAINS STONE CONSULTANTS		250 450		
					 TRAFFIC MARKING COATINGS TUB & TILE REFINISH COATING 	; 38	100 420		
					WATERPROOFING MEMBRANI WOOD COATINGS WOOD PRESERVATIVES	8	258 275		
					WOOD PRESERVATIVES ZINC-RICH PRIMERS		350 340		
					GRAMS OF VOC PER LITER OF 2, THE SPECIFIED LIMITS REMAIN I	UTER OF COATING, INCLU	IDING WATER & EXEMPT	COMPOUNDS	
					TABLE 3. VALUES IN THIS TABLE ARE DI ARCH TECTURAL CONTINGS: FROM THE AIR RESOURCES B	ERNED FROM THOSE SPEC	IFIED BY THE CALIFORNI	VAREI RESOURCE BOARD,	
					COATING CATEGORY	CURRENT	VOC UMIT		
					FLAT COATINGS NON-FLAT COATINGS NON-FLAT HIGH GLOSS COAT	N/20	50 100 150		
					SPECIALTY COATINGS	CURRENT			
					ALUMINUM ROOF COATINGS		400		
					BASEMENT SPECIALTY COATING BITUMINOUS ROOF COATING BITUMINOUS ROOF COATING	NGS 3	400 50		
					 BITUMNOUS ROOF COATING BOND BREAKER 	SPRIMER	350 350		
					BOND BREAKER CONCRETE CURING COMPOU CONCRETE / MASONRY SEALERS DRIVEWAY SEALERS	INDS FRS	358 100		
							50 150		
					FIRE RESISTIVE COATINGS FLOOR COATINGS		360 100		
					FORM-RELEASE COMPOUNDS HIGH TEMPERATURE COATING) 3S	250 420		
					 INDUSTRIAL MAINTENANCE O LOW SOUDS COATINGS MAGNESITE CONCRETE COAT 		250 120		
					 MAGNESITE CONCRETE COAT MASTIC TEXTURE COATINGS 	INGS	450 100		
					MASTIC TEXTURE CONTINGS PRETREATMENT WASH PRIME PRIMERS, SEALERS AND UND	R ERCOATS	350 100		
					PRIMERS, SEALERS AND UND REACTIVE PENETRATING SEAL		350		
					43.1 CONTROLLED BUILDING MAT A. IF FLUORESCENT LAN B. MAINTAIN THE TACO LIGHTING.	EMAL (REQUIRED) MPS ARE USED THEY SHALL BELL LAMPS POLICY OF ON	NOT EXCEED 80 PICOGR ILY USING LED LAMPS IN	AMIS PER LUMEN HOUR. ALL BUILDING, SITE AND SIGN	
	·	7		\Box	45.1 THERMAL COMFORT (REQUINSURE THAT THE HVAC SYSTEM I	IRED) PROVIDES THE FOLLOWING	COMFORT CONDITIONS	ON AVERAGE:	
		_		_	STORE OCCUPATION	MCOE	TEMP SET POINTS	MAX RELATIVE HUMDITY	
					CCCUPIED	DINING COOLING KITCHEN COOLING DINING HEATING KITCHEN HEATING	73-78 F 68-73 F 68-73 F 66-71 F	80% 80%	
					UNOCCUPIED	COOLING (MINIMUM) HEATING (MARIMUM)	80 F OR OFF 60 F		
					46.1 THERMAL VERIFICATION (RE A. AT THE 11 MONTH WA	QUIRED)	ADMINISTER THE THERW	AL COMFORT VERIFICATION	
			ш	ľ	SURVEY WITH A RESPON B. IF 20% OR MORE OF	ISE RATE OF 76% MINIMUM THE RESPONDERS ARE DIS	L SATISFIED THEN CORREC	AL COMFORT VERIFICATION TIVE ACTIONS SHALL TAKE	
					CORRECTIVE ACTION UNI C. IF CORRECTIVE ACTION COMFORT STANDARDS.	ILLESS THAN 20% ARE D ON IS REQUIRED GO BACK	ISSATISHED. AND INSURE THAT THE ST	TIVE ACTIONS SHALL TAKE ORE MEETS #28 THERMAL	
	•	7			48.1 LEED TEAM MEMBER (REQUEACH CONSULTANT SHALL HAVE.	A LEED AP MEMBER ON EA			
*	Ē	Ī			49.1 COMMISSIONING (OPTIONA COMMISSIONING REQUIRES UND DESIGN SO THEY CAN INSURE TH IS ALSO INTENDED TO INSURE TH	L) ERSTANDING THE OWNERS AT THEIR DESIGN MEETS! AT THE CONTRACTOR EXE	DESIGN INTENT PRIOR T AITH THE OWNER'S REQU CUTES THE DESIGN PER T	O STARTING SITE SPECIFIC IFEMENTS, COMMISSIONING ALSO HE OWNER'S REQUIREMENTS.	
								ITS WITH THE SITE SPECIFIC I HIGH TO STARTING DESIGN. AS THE CHECKLIST TO INSURE OLL REWENTS.	

				SETRICT	OT MARKE ON THE TOTAL OF THE TO		
		HENLT'S		, ayer	SEION	P = INDICATES THAT SCOPE IS ALREADY IN THE PROTOTYPE	DRAWINGS
	.09		igh of	Eli d	Mill	* - INDICATES OPTIONAL ITEMS	
	Š	Š	Ø	✓			
	✓	Р			37.1 RECYCLING REQUIRED) A. PROVIDE DEDICATED REC ACCOMMODATE PLASTIC, PA B. SEE THE "TRASH ENCLOS "LARGE" VERSION SHOULD B	CYCLING SPACE IN THE DIMING ROOM, KITCHEN AND SITE, RECY APER AND CIL. SELIRE STANDARIDS POSTED ON THE PLANS YUM.COM. LINLESS AN SELISED.	CLING SHOULD
			Ш	П	37.2 COOKING OIL RECYCLING (REC COLLECT COOKING OIL AND PROVIDE	QUIRED) E TO A THIRD PARTY VENDOR FOR RECYCLING.	
*			H	Ħ	37.3 CARDBOARD RECYCLING (OPT COLLECT USED CORRUGATED CARD	TIONAL) BOARD AND PROVIDE TO A THIRD PARTY VENDOR FOR RECYCLIN	ıg.
	۰	Ż			38. AIR VENTILATION (REQUIRED) 1. PROVIDE AIR VENTILATION 2. PROVIDE FRESH AIR PER	N AND EXHAUST RATES PER YUM BLUEUNE. YUM BLUEUNE.	
	✓	lacksquare				IOT SMOKING WITHIN THE RESTAURANT IN 25 FEET OF THE RESTAURANT	
					41.1 PROTECTION OF MATERIALS [F GC TO PROVIDE A IAO MANAGEMENT REQUIRED FOR SITE SPECIFIC COME A. PROTECT HAVE SYSTEM B. IMPLEMENT POLLUTION S C. PROTECT STORED MATER D. PROTECT INSTALLED MAT E. MAINTAIN CONSTRUCTION	RECURRED) I PLAN WITH BID, START WITH THE PROTOTYPE TEMPLATE AND M TURNES. SURPICE CONTROL MEASURES FERMUS STEEL FUSIONE STEEL OF THE PROTOTYPE TEMPLAS.	ODIFY AS
					AEROSQL ADHESIVES, A IJN UNITS OF PRODUCT, CONSIST OF MORE THAN	IND SMALLER UNIT SIZES OF ACHESIVES, AND SEALANT OR CAUL LESS PACKAGING, WHICH DO NOT WEIGH MORE THAN 1 POUND A N 18 FLUID CUNCES) SHALL COMPLY WITH SCAGNID.	4NG COMPOUN AND DO NOT
					PAINTS AND COATINGS. ARCHI	ITECTURAL PAINTS AND COATINGS SHALL COMPLY WITH VCC LIM	ITS IN SCAOMD.
					AEROSOL PAINTS AND COATINGS		
					VERFICATION. THE GENERAL C SHALL INCLUDE, BUT IS NOT LIMI 1. MANUFACTURERS PROD 2. FIELD VERFICATION OF I	CONTRACTOR SHALL PROVIDED DOCUMENTATION TO THE CM. DO TIED TO, THE FOLLOWING: DUCT SPECIFICATION. ON-SITE PRODUCT CONTAINERS.	DOLIMENTATION
					ADHESIVE VOC LIMITS		
			Ш	Ш	ARCHITECTURAL ADHESIVE APPL	LICATIONS CURRENT VOC LIMIT	
					CERAMIC TILE DRYWALL, PANEL & COVE BASE MULTI-PURPOSE	65 50 70	
					SINGLE PLY ROOTING SPECIALTY APPLICATIONS	250 CURRENT VCC LIMIT	
					PVC WELDING	510	
					CPVC WELDING ABS WELDING	490 375	
					ABS WELDING PLASTIC CEMENT WELDING ADHESIVE PRIMER FOR WELDING	325 250 800	
					CONTACT ADHESIVE SPECIAL PURPOSE CONTACT ADI	i 550 80	
						HESNE 250 DHESNE 140	
					TOP & TRIM ADHESINE	250	
					SUBSTRATE SPECIFIC APPLICATION	ONS CURRENT VOC LIMIT	
					METAL TO METAL	30	
					PLASTIC FOAMS POROUS MATERIALS (EXCEPT WO	50 COD) 50	
					WOOD FIBERGLASS	30 90	
			\Box			COMPOUNDS IN GRAMS PER LITER)	
			ш	Ш	SEALANT	CUMPOUNDS IN GHAMS PEH LITER) CURRENT LIMIT	
					ARCHITECTURAL	210	
					MARINE DECK	760	
					NON-MEMBRANE ROOF ROADWAY	300 250	
					SINGLE PLY ROOF MEMBRANE OTHER	450 420	
					SEALANT PRIMER	CURRENT LIMIT	
	1			1		CUPPENT UMI	
					ARCHITECTURAL NON-POROUS	250	
	1			1	POROUS MODIFIED BITUMINGUS	775 500	
	1			1	MARINE DECK OTHER	760 75	
					O. IEN	7.0	
	1			1			
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	1			1			

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LOCATION CONTROLLED CO		
LA COCUMEN COMMUNITY REQUIRED CONTROLLED SAN THE SENS CONTROLLED TO YARD DIMENS CONTROLLED SAN ALLONG THE LANGUAGE THE THE SENS ENGAGE THE TO SENS AND ALL DESCRIPTION OF THE SENS AND ALL DE	* \ \ \ \ \ \ \ \ \ \ \ \ \ \ \ \ \ \	
WELLALOW TO REAL TO PROVIDE CONTROL THE CO		
THE SAME IN A FALL OF A 50.000. PI HORDER DELOCATION STOCK ELODORS ENVIRONS OR ALTRIANA OF TWO ENDINGS. PRODUCE CHARGE AND LOCALES. SHAPEO (POTTACE). SO PROPERIO (POTTACE). 12 MET RICHARD THE SERVER RECORDED OF LOCAL ZORMO, SEC OFFEET, FRONCE SA PRETERED MANNER AND LOCALES. SO PROPERIO (POTTACE). 13 MET RICHARD. 14 MET RICHARD. 15 MET RICHARD. 16 MET RICHARD. 17 MET RICHARD. 18 MET RICHARD. 18 MET RICHARD. 18 MET RICHARD. 19 MET RICHARD. 19 MET RICHARD. 10 MET RICHARD. 11 MET RICHARD. 12 MET RICHARD. 13 MET RICHARD. 14 MET RICHARD. 15 MET RICHARD. 16 MET RICHARD. 16 MET RICHARD. 16 MET RICHARD. 17 MET RICHARD. 18 MET RICHARD. 18 MET RICHARD. 18 MET RICHARD. 19 MET RICHARD. 19 MET RICHARD. 19 MET RICHARD. 10 MET RICHARD. 11 MET RICHARD. 12 MET RICHARD. 13 MET RICHARD. 14 MET RICHARD. 15 MET RICHARD. 16 MET RICHARD. 16 MET RICHARD. 17 MET RICHARD. 18 MET RICHARD. 18 MET RICHARD. 18 MET RICHARD. 19 MET RICHARD. 19 MET RICHARD. 19 MET RICHARD. 19 MET RICHARD. 10 MET R		1.5 PAY UTLITIES DIRECTLY (REQUIRED) IF SITE IS LESSED INSURE THAT TAXO BELL WILL PAY THE UTILITIES DIRECTLY PATHER THAN ALLOWING THE LANDLORD TO PAY THEM. THIS
DESCRIPTION OFFICIAL STATES AND	*	22 PROMATIVEO BLS STOP (OPTIONAL) SITE IS WITHIN 1/4 A MILE OF A BUS STOP.
DO NOT DECEMPANT SPACES DIVISIONES SPACES TO COLUMNATORS. SECRETE S. PRIVATE ON PREFERENCE PARKINGS FOR CAPACIOL. P	Р	3.0 BICYCLE FACILITIES (REQUIRED) PROVIDE DEDICATED BOYCLE LOOMBLE PARKING FOR A MINIMUM OF TWO BICYCLES, PROVIDE CHANGING AREA AND LECCHABLE STORAGE FOR AMENIMUM OF TWO PEOPLE. SINGLE OCCUPANCY TOLLET FOOMS MILL SUFFICE AS A CHANGING AREA.
POWER PROFITS AND SERVICE MARKING MICHAEL SO CONSPRICTION FOUND CONTROL THAN CONTROL PAN. A CONSPRICTION FOUND CONTROL PAN. B CONSEQUENCE AND CONTROL H. TURKNOWN CONTROL PAN. A PROJECT SERVICE PROSENT ON TO THAN PROTECTION H. TURKNOWN CONTROL PAN. A PROJECT SERVICE PROSENT CONTROL R. WILLIAM CONTROL PAN. B C	*	5.1 PARKING (OPTIONAL). DO NOT EXCEED PARKING SPACES REQUIRED BY LOCAL ZONING. SEE CREDIT 5. PROVIDE 5% PREFERRED PARKING FOR CAPPOOL
C. SIT SEPERATURATIONS C. C. STANDAMED COL. STANDAME E. COMPAND COL. STANDAME F. COMPAND COMPAND F. COMPAND COMPAND F. COMPAND COMPAND F. COMPAND COMPAND F.	P	7.2 WHITE ROOF (REQUIRED) PROVIDE WHITE PAC SINGLE MEMBRANE ROOF MATERIAL.
P PROCESS MATER SQUEED P P P PROCESS MATER SQUEED ALL MADDORS DESIGNED REQUIRED ALL MADDORS DESIGNED REQUIRED ALL MADDORS DESIGNED REQUIRED 10. LAL MADDORS DESIGNED 1		C. STE WENTALAN ACCESS C. STEWNERS AND STEWNERS F. ECHAMED SOL STORMS F. ECHAMED SOLD STORMS F. ECHAMED SOLD STORMS F. ECHAMED SOLD SOLD SOLD SOLD SOLD SOLD SOLD SOL
ALL WASTER UND COLUMNATE SECURITION THE PROTOTORE COUNTED SHELL BE USED TO ALL GROUND-UP PROTOTORE CRITICAL CHARGES THE PROTOTORY FOR THE PROTOTORY SET ALL CHARGES THE PROTOTORY STATE ALL CH	Р	10.2 BUILDING WATER (REQUIRED) PROVIDE PILIMENING FIXTURES AS SPECIFIED IN THE PROTOTYPE DRAWINGS, SPECIFICATIONS AND EQUIPMENT MODEL.
** ALL LANGEOPTE CERTIFICATION CHILDREN STRUCTURES SHALL PROJUST THE LANGEOPTE STRUCTURE ON THE PLANS CALLOUT MEET INCOME THE	Р	11:2 PROCESS WATER (REQUIRED) ALL WATER USING EQUIPMENT SPECIFIED IN THE PROTOTYPE EQUIPMENT SCHEDULE SHALL BE USED FOR ALL GROUND-UP RESTAURANTS.
D. SEMPARTE PROTON A XABS. P. CHOCKNOW MANUAL PROMOTE THRUE C. PROCESSOR MANUAL PROMOTE THRUE C. PROCESSOR AND A PROMOTE CONTINUES. D. PRINSISSOR P. CHOCKNOW MANUAL PROMOTE THRUE C. PROMOTE SECURITION AND A CONTINUES. D. PROTON RESISSOR P. CHOCKNOW MANUAL PROMOTE THRUE C. PROTON AND A SECURITION AND A CONTINUES. D. CHOCKNOW MANUAL PROMOTE CONTINUES AND A CONTINUE PROTON PERSONANTS. D. CHOCKNOW MANUAL PROMOTE CONTINUES AND A CONTINUE PROTON PERSONANTS. D. CHOCKNOW MANUAL PROMOTE CONTINUES AND A CONTINUE PROTON PERSONANTS. D. CHOCKNOW MANUAL PROMOTE CONTINUES AND A CONTINUE PROTON PERSONANTS. D. CHOCKNOW MANUAL PROMOTE CONTINUES AND A CONTINUE PROTON PERSONANTS. D. CHOCKNOW MANUAL PROTON PERSONAN		12. LANDSCAPE DISIDIV, PROUPED) ALL ANDOORE DESIDOS FOR NEW GROUND-UP RESTAURANTS SHALL FOLLOW THE LANDSCAPE STANDARDS POSTED ON THE FLANS TAUDA WESTER. FLANS TAUDA WESTER.
P THE CURRENT LIGHT TO SPECIFICATIONS SHALL BE USED FOR ALL GROUNDLY PROTOTORS RESTURBANES. P THE CURRENT LIGHT TO SPECIFICATIONS SHALL BE USED FOR ALL GROUNDLY PROTOTORS RESTURBANES. P THE CURRENT SPECIFICATION SPECIFICATIONS SHALL BE USED FOR ALL GROUNDLY PROTOTORS RESTURBANES. P THE CURRENT SPECIFICATION SPECIFICATION SHALL BE USED FOR ALL GROUNDLY PROTOTORS RESTURBANES. P THE CURRENT SPECIFICATION SPECIFICATION SHALL BE USED FOR ALL GROUNDLY PROTOTORS RESTURBANES. P THE CURRENT SPECIFICATION SPECIFICATION SHALL BE USED FOR ALL GROUNDLY PROTOTORS RESTURBANES. P THE CURRENT SPECIFICATION SPECIFICATION SHALL BE USED FOR ALL GROUNDLY PROTOTORS RESTURBANES. P THE CURRENT SPECIFICATION SPECIFICATION SHALL BE SENDED FOR A SPECIFICATION. P THE CURRENT SPECIFICATION SPECIFICATION SHALL BE SENDED FOR A SPECIFICATION. P THE SPECIFICATION SPECIFICATION SHALL BE SENDED FOR A SPECIFICATION OF A SPECIFICATION. P THE SPECIFICATION SPECIFICATION SHALL BE SENDED FOR A SPECIFICATION OF A SPE		B. SEPARATE REPIGATION ZONES C. PROGRAM MONIMUM REPIGATION TIMING D. HIGHERFEIGENCY PERCATION SEPERALER HEADS
P	P	15.3 INTERIOR LIGHTING (PEOLIFIED) THE CURPENT LIGHTING SPECIFICATIONS SHALL BE USED FOR ALL GROUND-UP PROTOTYPE RESTAURANTS.
P	P	16.2 EXTERIOR LIGHTING (REQUIRED) THE CURRENT LIGHTING SPECIFICATIONS SHALL BE USED FOR ALL GROUND-UP PROTOTYPE RESTAURANTS.
P		17.2 SIGN LLUMINATION (REQUIRED) THE CURRENT SIGNAGE SPECIFICATIONS SHALL BE USED FOR ALL GROUND-UP PROTOTYPE RESTAURANTS.
P USE ACCURSON HAVE DIAMETER RESISTENCE ADMINISTRATION. P OFFICIAL PRINCIPLES IN INCIDENCE AND RESISTENCE ADMINISTRATION. P OFFICE AND RESISTENCE AND RESISTENCE AND RESISTENCE AND INSTALL PER THE QUERENT PROTOTYPE GROUND UP RESTAURANT. P OFFICE AND RESISTENCE AND RESISTENCE AND AND SPECIFIED AND INSTALL PER THE QUERENT PROTOTYPE GROUND UP RESTAURANT. P OFFICE AND RESISTENCE AND RESISTENCE AND RESISTENCE AND RESISTENCE AND THE HISTORY FROM T	P	161 DEPUIST HOODS; REQUIRED; THE CURPENT 457 BACK SHELF HOOD DESIGN AND EQUIPMENT PLACEMENT AS SHOWN IN THE GROUNDLE PROTOTYPE RESTAURANT SHALL BE USED.
P CHINGE NEXT COST AND SETS AND THE STANDARDS 20.1 MANNET FEMBERY, REQUIRED) DUE THE STANDARD HER FEMBERY (MINUMERR 120, REV.) AS SPECIFIED AND INSTALL FRA THE CURRENT PROTOTYPE CROUDO UP ERSTANDARD. P 20.1 SCOROUNDER FEMBER SETS COMMENTS (MINUMERR 120, REV.) AS SPECIFIED AND INSTALL FRA THE CURRENT PROTOTYPE CROUDOUR PROTOTYPE. P 20.1 COMPANIES AND THE COMPANIES OF THE STANDARD PROTOTYPE. 20.1 MOTHER PROTOTYPE CROUDED TO THE STANDARD REPORT REVOLUTION OF THE STANDARD REPORT REPORT REVOLUTION OF THE STANDARD REPORT RE	P	19.1 LICENSED HWAC ENGINEER (REQUIRED) USE A LICENSED HWAC ENGINEER FOR SYSTEM SITE ADAPTATION.
P USE THE SYMANOR HIGH FETTING ON MANUAL RER YOU RED AND ASSECTED AND NETALL PRETTY CURRENT PROTOTOPE CROUNDLY PROTOTOPE CROUND	P	19.2 OPTIMZE HVAC DESIGN (RECURRED) OPTIMZE HVAC DESIGN SYSTEM PER YUM BLUELINE STANDARDS
P USE AND/OFF PROMED BOOKS AND CONTROLS PRECINC TO AND COMPARISE WITH THE MILE SPECHED IN THE PROTOTYPE PARK OF THE PARK OF THE PROTOTYPE PARK OF THE PROTOTYPE PARK OF THE PARK OF TH	P	USE THE STANDARD HIGH EFFICIENCY (MINIMUM EER 12:0) RTU AS SPECIFIED AND INSTALL PER THE CURRENT PROTOTYPE GROUND UP
USE THE WATER RECITION THE FACE DELL PRACTURES. P		USE A FACTORY PROVIDED ECONOMIZER WITH DIFFERENTIAL CONTROLS INTEGRAL TO AND COMPATIBLE WITH THE RILL'S SPECIFIED IN THE
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USE MATERIALS THAT HAVE A WINNIUM OF 10% PECYCLED MATERIALS. (NOTE: GETTING THE CALCULATIONS IN PROCESS)	*	
34.1 CONSTRUCTION WASTE WANDERON (. RECURED) A. THE CONTRICCION WASTE WANDERON OF SIX. OF SIX. CONSTRUCTION WASTE AND PROVIDE RECORDS PER YUM BUILDING, THIS PRESENTED. B. THE GENERAL CONTRICCION DELLA PROVIDE A CONSTRUCTION WASTE MANAGEMENT PLANTO THE CONSTRUCTION WASTE CONTRICCION SCHOOL WASTE	Р	33.1 RECYCLED CONTENT (REQUIRED) USE MATERIALS THAT HAVE A MINIMUM OF 10% RECYCLED MATERIALS. (NOTE: GETTING THE CALCULATIONS IN PROCESS)
		SET CONSTRUCTION WASTE WANGELEAST (REQUIRED) A. THE CONTRUCTION SHALL RECORDE A WINNAM OF 5% OF ALL CONSTRUCTION WASTE AND PROVIDE RECORDS FRI YUM BELLIARIE, 25% DEFERENCED. B. THE CREMENT, CONTROLOR SHALL RHOUSE A CONSTRUCTION WASTE MANAGEMENT PLANT TO THE CONSTRUCTION MANAGEMENT THE HERBIE SUBMITTALE. THE CONTROLOR HE STATISTED FOR MESSING DISTRICT MANAGEMENT PLANT THE HERBIE SUBMITTAL. THE CONTROLOR HE STATISTED FOR MESSING DISTRICT MANAGEMENT PLANT THE HERBIE SUBMITTAL. THE CONTROLOR HE STATISTED FOR MESSING DISTRICT MANAGEMENT PLANT THE HERBIE SUBMITTAL. THE CONTROLOR HE STATISTED FOR MESSING DISTRICT MANAGEMENT PLANT THE PLANT THE PLANT TH





ARCHITECT-AR 14985

Eduardo L. Carcache, State of Florida, Professional Engineer, License No. 31914. This item has been digitally signed and sealed by Eduardo L. Carcache on the date indicated here.

BUILDING TYPE:

PLAN VERSION: BRAND DESIGNER: DANIEL DICKSON


SITE NUMBER: STORE NUMBER: TB-459380 PA/PM: DIANA DeCICCO

JOB NO.: TACO BELL 2640 N SR-7, HOLLYWOOD, FL 33021

DRAWN BY.:



GREEN CHECKLIST SHEET

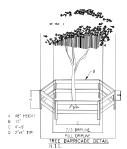


TREE BARRICADE NOTES:

GRAPHIC SCALE

/4\ (M

Sunshine

- 1. ALL PROPORTED TRACES TO BE STOCKED THAN 18 SECURITY OF THE PROPORT OF THE PROP
- ALL DISTING TREES SHILL COMPLY WITH THE "AMERICAN NATIONAL STANDARD INSTITUTE, (ALS)) A200—2005." CURRENT EDITION RESPECTATORY.
- 3. LANDSCAPE CONTRACTOR SHALL WATER RELOCATED TREES WITH TEMPORARY IRRIGATION EVERYDAY FOR THE FRST WONTH THEN 2-3 TIMES A WEEK UNTIL SYSTEM IS FULLY AUTOWATIC; OWNER TO SUPPLY WATER ON SITE.
- Existing thees to be barbicated prior to beginning of construction & shall beman in place during construction.
- 5. NO HEAVY EQUIPMENT, CONSTRUCTION MATERIALS OR SOIL BEPOSITS ARE TO BE ALLOWED INSIDE TREE BURSLESS.
- TOPSOL SHALL BE CLEAN & REASONABLY FREE OF CONSTRUCTION DEBRIS, WEEDS, ROCKS, & NOXIOUS PESTS & DISEASE (SEE SOIL PLANTING SPECIFICATIONS).
- 7. TREE REMOVAL PERMIT SHALL BE REQUIRED PROF TO CONSTRUCTION & MAY CLEARING OPERATIONS AS REQUIRED.
- TRANSPLANT TREE WITH 60" TREE SPACE OR TREE CRANE, TRANSPLANTING HOLE SHALL BE AT LEAST 1/3 BIGGER THAN THE AREA THAT WAS TRENCHED FOR TRANSPLANTING.
- 9. SET TREES NO DEEPER THAN IT WAS IN ITS CRICINAL GROWING WITH THE ROOT BALLS EVEN WITH , OR SUCHTY HIGHER (+- 1 $^{\circ}$) THAN THE FINISHED GRADE.

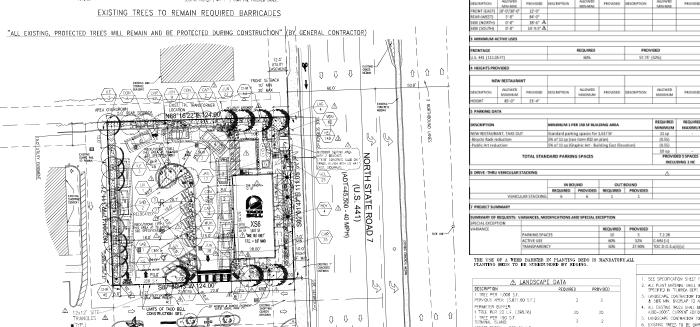

Ø6

DROUGHT TOLERANCE

COMMERCIAL GREEN BUILDING PRACTICES INCORPORATED INTO PLANS

1,600 SF

- DERFOY STAM APPROVED BODDING MATERIALS.
 AT LEST DOS OF PLANTS, RECTS AND SPASS FOR THE SOUTH FLORIDA.
 AT LEST DOS OF PLANTS, RECTS AND SPASS FOR THE SOUTH FLORIDA.
 AT LEST DOS OF PLANTS, RECTS AND SPASS FOR THE SOUTH FLORIDA.
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- MILE OF SERTING PAIL MODE OF \$1 WILE OF \$1 EAST 1 ACRIES BIDS STRUKENESS—PROPED SCROMAN OF AN LEARNING BLACKET OF STRUKENESS—PROPED SCROMAN OF AN LEARNING BLACKET OF STRUKENESS AND AN ARCHITECTURE AND ARCHITECTURE OF OTHER PIRM, PROPERTY AND ARCHITECTURE OF STRUKENESS AND ARCHITECTURE OF STRUKENESS AND ARCHITECTURE OF SERVING THAN 72, WHICH DIRECTURE EXTERNOR MICHAEL STRUKENESS AND ARCHITECTURE OF ANNIONIA OF THE ANNIONIA OF

LEGAL DESCRIPTION:

PARCEL "A", "GATOR 441 SUBDIMISION", ACCORDING TO THE PLAT THEREOF, RECORDED IN PLAT BOOK 151, PAGE 8, OF THE PUBLIC RECORDS OF BROWARD COUNTY, FLORIDA.

MEETING DATES: PACO DEC 19, 2022 PRELIMINARY TAC N/A FINAL TAC __FEB _6, 2023 P08

SCRIPTION	REQUIRED	PROVIDED	
TREE PER 1,000 S.F.			
RVIOUS AREA: (3,021.60 S.F.)	3	3	
RIMETER BUFFER:			
TREE PER 20 L.F. (398.76)	20	20	
TREE PER 190 S.F. RIMINAL ISLAND:	2	2	
REET TREES: 1 PER 50 L.F.			
REET FRONTAGE: 111.05 L.F.	2	2	
GRADE PARKING 1 TREE PER 20 L.F.	4	4	
ERIOR LANDSCAPE AREA - 15.00% OF (V.U.	A.): 1,127.80	1,178.00/15.28%	Δ
TAL TREES:	31	31	
TIVE/S.F.W.M. TREES 80% MIN.:	25	A 26 (84%)	
TIVE/S.F.W.M. SHRUBS 80% MIN.:	A 237/80%	A 276/93%	

SITE AND CODE DATA

21.88%

-MU (Central Mixed-Use D

New Restaurant

13.811 (NET) SF

3,021.65F

ΔA

Transit Oriented Corridor (TOC) /

IRRENT LAND USE

URRENT USE

TALSITE AREA

TAL BUILDING

SETBACKS

STAL OPEN SPACE AREA

AL VEHICULAR USE AREA
IRIOR LANDSCAPE AREA (MINUS
IMETER LANDSCAPE SET BACK AREA)

NEW RESTAURANT

FLORIDA -FRIENDLY LANDSCAPING & DESIGN SHALL BE UTILIZED GREEN BUILDING ORDINANCE REQUIRED SECTION 3-103 80% OF PLANTS, TREES, AND GRASSES PER "SOUTH FLORIDA

	** VEI	RY	TE	OF PLANTS, TREES, AND	OF PLANTS, TREES, AND GRASSES PER "SOUTH FLORIDA WATER MANAGEMENT DISTRICT" RECOMMENDATIONS (LATEST EDITION).					
	LANDSCAPE LEGEND									
DROUGH	KEY	0	TY.	PLANT NAME		TIVE				
TOLERAN	CE COCE	NEW E	EXISTING			NO				
**	LIV	2		QUERCUS VIRGINIANA / "CATHEDRAL"	YES		12'X6'-7' F.G. 2.5" D.B.H. 5' C.T.			
**	LAG	4		LAGERSTROEMIA INDICA / "NATCHEZ"		NO				
**	ROY	- 4		ROYSTONIA ELATA / FLORIDA ROYAL PALM	YES					
**	DON	9		DONOCARPUS SERICEUS / SILVER BUTTONNOOD	YES					
**	ILE	7		ILEX CASSINE / DAHGON HOLLY	YES					
**	SAB	- 1	2	SABAL PALMETTO / CABBAGE PALM	YES		12'-14'-16' C.T. F.G. 10' C.T. MINIMUM-RELOCATE (2) EXISTING			
**	CRA	3		LAGERSTROEMIA INDICA / "NATCHEZ"		NO				
**	JAS	17		TRACHELOSPERMUM JASMINOIDES/ STAR JASMINE			24"X18" 3 GAL 24" O.C. "TRELIIS"			
**	FUR	3		FURCRAEA FOETIDA / GIANT FALSE AGAVE		NO	30" X 30" AS SHOWN			
**	MUH	9		MUHLENBERGIA CAPILLARIS / PINK MUHLY GRASS	YES					
	CAP	7		SANDSTONE BOULDER/DESERT SAND COLOR	-		34"X28"X20" AS SHOWN (INSTALL HALF WAY INTO GROUND)			
**	MON	60		ILEX VONITORIA / DWARF YAUPON	YES		6" FULL 1 GAL 24" O.C.			
**	CHR	207		CHRYSOBALANUS ICACO/ RED TIP "	YES		24"X18" 3 GAL 24" D.C. FULL TO BASE			
**	JUN	69		JUNIPER HORIZONTALIS / CREEPING JUNIPER		NO	6" 1 GAL. 18" O.C. FULL POT			
**	HEL	165		HELIANTHUS DEBIUS / DUNE SUNFLOWER	YES		6" 1 GAL 18" O.C. FULL POT			
	SOD	725+		ST. AUGUSTINE "FLORATAM" SOLID SOC			AS SHOWN			

1. SEE SPECIFICATION SHEET FOR ADDITIONAL DETAILS

- ALL PLANT MATERIAL SHALL BE FLORIDA NO. 1 OR BETTER & SHALL BE INSTALLED AS SPECIFED IN "FLORIDA DEPT. OF AGRICULTURAL GRADES AND STANDARDS", CURRENT EDITION RESPECTIVELY.
- SECTION IN THOM OF THE RECOUNTING WASS, AND STANDARDS, CORRENT IDDION RESPECTANCY.

 A MODINE COMPANIOR TO PROMOTE AN AUTHORISE, DAME REGARDING STEEL SHEEMER SECOND CONTINUE

 A JOST MIN. DETERMINE ALL LANGUAGE AND ARREST STEEL HER A RAIN SECOND CONTE, AN RECOURSE

 A LESTING RESSORT ENTRING MAS SHEEL CHARLES

 A LESTING RESSORT SHEEMER AND SHEEL CHARLES

 A LESTING RESOLUTION RESPECTANCY.

 A LANGUAGE COMPANION TO REMOVE ALL LISTING DRAZUAM PEPER & FLORIDA HOLLY FROM STEE.
- EXISTING TREES TO BE BARRICADED PRIOR TO BEGINNING OF CONSTRUCTION & SHALL REMAIN IN PLACE DURING CONSTRUCTION AS PER CITY OF HOLLYWOOD. (SEE DETAIL)
- 7. NO HEAVY EQUIPMENT, CONSTRUCTION MATERIALS OR SOIL DEPOSITS ARE TO BE ALLOWED INSIDE TREE BARRIERS TOPSOIL SHALL BE CLEAN & REASONABLY FREE OF CONSTRUCTION DEBRIS, WEEDS, ROCKS, & NOXIOUS PESTS & DISEASE (SEE SOIL PLANTING SPECIFICATIONS).
- A DESCRIPTION OF THE TRANSPORT OF THE PROPERTY OF THE TRANSPORT OF THE TRA

- AS SECURED.

 LANGICARE CONTRICTOR TO CALL THE CITY OF HELLYWOOD LANGICARE INSPECTIOR AT (954)921-3471 TO SCHEDULE A RECONSTRUCTION MEETING PROPRIED TO INSTITULATION AS REQUIRED.

 A RECONSTRUCTION MEETING PROPRIED FOR MEETING PROPRIED PROPRIED RELOCATION OF EXISTING TRIESS OR PALMS FOR CONDITION OF EXISTING MEETING AND SHALL BE PRIMARED UPON INSPECTION OR IF DEEMED NOT FERSIBLE, THAN A HELL THE LETTER SHALL BE ARE THE LETTER SHALL SHALL BE ARE THE LETTE
- EXISTING TREES SHALL BE PROVED AND MAINTAINED TO HAVE 6'-8' MINIMUM CLEARANCE OVER SIDEWALKS AS REQUIRED
- ALL SOC TO BE HEALTHY, WEED/PEST FREE (INCLUDING FUNGUS AND DISEASE) ST. AUGUSTINE FLORATAM SOLID; LAID SMOOTH WITH TIGHT ALTERNATING/ABUTTING JOINTS WHICH CONFORM TO CURBS AND PLANTERS.
- MULCH RINGS SHALL BE PROVIDED FOR ALL TREES PLANTED IN SOD AREAS-4' MINIMUM DIAMETER, 6' DIAMETER FOR

(3)-CRAPE MYRTLE UPSIZED FROM 2" TO 4" D.B.H.= ADDITIONAL 6.0" D.B.H. PROVIDED ONSITE.
4.5" D.B.H. TREE SHORTFALL OPTION OF \$350.00 PER 2" D.B.H. AMOUNT OF \$787.50 TO BE PAID INTO





CONTRACT DATE: BILLI DING TYPE YSS BRAND DESIGNER: DANIEL DICKSON

STORE NUMBER TB-459380 DIANA DeCICCO DRAWN BY: AG JOB NO.: CKE 1746

TACO BELL 2640 N SR-7. HOLLYWOOD, FL 33021



LANDSCAPE PLAN

PLOT DATE:

NOTE: CONTRACTOR SHALL OBTAIN A TREE REMOVAL/RELOCATION PERMIT AND PROVIDE FOR ANY MITIGATION PRIOR TO OBTAINING A BUILDING PERMIT. LL LANDSCAPE MATERIALS SHALL BE PLANTED 6" MINIMUM DISTANCE AWAY FROM ALL TREE/PALM ROOTBALLS. NICSCAPE CONTRACTOR TO SCHEDULE A FINAL INSPECTION AND COMPLIANCE INSPECTION WITH THE LANDSCAPE ARCHITECT PRIOR TO C.O.

LANDSCAPE PLAN

FIRE HYDRANT ZONE

DICEPTONS OTHER FIRE HONING OR TRAFFIC POSTS TO PROPER THE DOLLMON

FRS HYTEMO-

△ △ 1 LIVE OAK TREE 10.5" D.B.H. TO BE REMOVED =X SEE L-3 TREE DISPOSITION PLAN

(M)= UPSIZED TREES IN LIEU OF CANOPY COMPENSATION MITIGATION PROVIDED AS SHOWN, SEE LEGEND

PLANTING | SPECIFICATIONS

2 REPERENCES

Company Manage Institute 2001 (Company Institute Company Institute

Martin Assessment Street, National Martin Special Int. O. C. All. Paralleles, Martin Special Street, National Co. C. C. Paralleles, Martin Special Special Int. O. C. All. Paralleles, Martin Special Special Int. (1997)

1.5.5.1/BAITTALS

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LA DIMLITY ASSURANCE

LE DELIVERIES, STORAGE AND HANDLING

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3.1 INSPECTION

3.23GIL PREPARATION

3.3 TREE PLANTING

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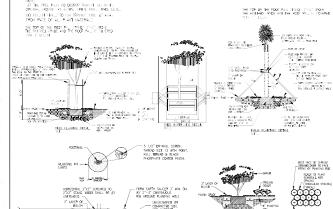
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E. Refer to Individual Sections 02915 - \$2940 for specific work below resolver ents.

5.11 PROTECTION

A. All lette reported to complete the contract or

SET THE TREE PAUL TO DEEPER THAT IT HAS IN IT. ORGANA, SROUND AT HE TO'S APOUE FINA, PRODUCEDE. DO DUJOH SHALL TO SON TRUMES, MILL 6" ANAI-FROM RASE OF ALL P ANT MATERIALS THE TOP OF THE ROOT PAIL (TAKET 1"-2" ABOVE THE THICKED VANCE AND THE ROOT PAIL IS TO ERED - 100 m to 100 cm (4 - (P1) (2P1) (4) (P (1 1.1.2) (1 1.1.2) (1 1.1.10) (1 1.1.2) (1 1.1.2) 0 (100 m) 0 (100 THE PLANTIN DITAL OF WORLD



UNEXCMATED OR COMPACTED SOIL FOR SUPPORT

CUT AND REVOVE ALL TIES & BURLAP FROM TOP 1/3 OF ROOT BALL

- VERTICAL (2) 2"X2" STAKES SHALL ABUT THE SIDE OF THE ROOTBALL



GROUP

17190 HOYAL PALM BLVD. SUITE #2 WESTON , PLOMIDA 3352/6

PHONE: (305) 558-4124 FAX: (305) 826-0619

SEAL EDUARDO L. CARCACHE CIVIL ENGINEER-PE 31914 HICARDO J. PEREZ ARCHITECT-AR 14985

This item has been digitally signed by Eduarda L. Carcache on the date adjacent to the seal.

MANTAN 12" MULCH DEA ZONE AT BED EDGE

PLAN VIEW

Printed copies of the document are not considered signed and scaled and the signature must be verified on any electronic copies.

MCHARD BARTITT LEMOSCAPT, INC.
MILLINGTON, 7. 15414
T.L.(261)726-7707
LEMOSCAPT ARCHITECTURE COSCAR
LEMOSCAPT ARCHITECTURE
LEMOSCAPT
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LAWARRANTY

introduced.

C. Points will be guaranteed to be true to species and variety or subtrar specified.

D. Occarriers exclude explications or plants destroyed by construpion acts of octave.

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PRO SERVICE 7 AB

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ACCIPECTED IN CENERAL PLANTING
-REEL ECONO

C: TC0 C:00:

MATE: PRODUCTS

Z.I PLANTS

regional, and home narrost holds of growth the final specific. H. Puri forms land that had be grown, certainly graving, and fine all weeks and finally grown bed, allevin in description, head or description streamed, will not be unsupped. Con positives or manners of 5th fact of all covering the open. Deliver to the size in Chinesh separate or Thinks with reflex positions. Devent weeks we than 3th forms that the position of the contract of the fact of the lattices of the size in Chinesh separate or Thinks with reflex positions. Devent weeks must have been between cross of conting and time at distance.

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B. Chmyraccal Familian Complete furtibur with an organic box.

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STEEL EDGING - SECTION

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1.4 STARINS

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SACIFABILE

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LANDSCAPE SPECIFICATIONS

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PRSF CAND.

PROFINED INFOS.

PROFINED IN

TREE GRATE/SIDEWALK STAKING DETAIL

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AND CAPE ASOMETIC CHA. SE NOTIFIED OF ANY CHANGE IN THE MATERIAL OF DECAMP SECOND OF THE SAIL. OWNER RESERVES THE ROOM TO REJECT ANY OR A., 2004.

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PLANT HATER OLD SHALL BE HANDLED IN A CARGETAL HANNER DURING TRANSPORTATION AND INSTALLATION.

PURITY THAT HOT SE SECTION OR TOPS DISCORDED AND AND INTEREST.

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C. OLATON, 1990 (ED) COMPANIE TO DEP THE EXTENSION OF CONTROL O

SHRUB PLANTING DETAIL

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PREPARED TOPSON.
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SEE SPECIFICATIONS

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PLANTING DETAILS

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DATE REMARKS

CONTRACT DATE: BUILDING TYPE:

PLAN VERSION: FEBRUARY 2022 BRAND DESIGNER: DANIEL DICKSON SITE NUMBER: 315998 STORE NUMBER: TB-459380 PA/PM: DIANA DeCICCO DRAWN BY:


TACO BELL 2640 N SR-7. HOLLYWOOD, FL 33021



XS6 LANDSCAPE SPECIFICATIONS

L-2

PLOT DATE:

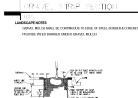


ROOT BARRIER DETAIL (TYPICAL)

OTE: A FOOT SUPPLEY SYSTEM SHALL BE INSTITUTED IN STUDIOGNS WHERE A TREE OF PAUL IS PLANTED WHICH IN' OF A PAULS SURFACE, STORM SEARS OF INFRISTRICTURE, MINICAL POOL SERVER ESCUPPANIED STORM SEARS OF INFRISTRICTURE. 1) PAUL CLEEN INCO. MONTHER STORM (1) HOUNDED EDGES 5) ANT-UTT PAULS 2) ZPEPER, DOIS STORM. 4) 32° CREET AND STORM. BO BARRERS SINCLE BE INSTALLED WHERE THESE ARE IN THE WONTY OF UNDERGROUND LINES, RICLD VERRY AS SEQUEND.



FIRE HYDRANT ZONE



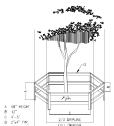



TREE BARRICADE DETAIL

ROUGH IN PLACE DURNO CONSTRUCTION, IF ROUGHTD SEE PLAN.

NO HEAV EQUIPMENT, CONSTRUCTION INTERHALS OR SOIL DEPOSITS ARE TO BE ALLOWED.

NODE TREE BURBLESS.

TOPOOL SHALL BE DIEAN AS READINGHT FREE OF CONSTRUCTION OFBERS, WELTIS.

11. CONTRACTOR SHALL HELD ADJUST NEW TREE LOCATIONS TO BE 15' WINNIUM FROM LIGHT STANDARDS.

FOR SELECATED AND/OR SEMIN PLANTED TREES/PAUNS THE INSIGNION SCHEDULE SHALL BE AS PER UF/TEAS PUBLICATION EINH-1061: DURING ESTABLISHMENT, TREES SHOULD BE IRRICATED 2-3 TIMES PER MEEN WITH 2 GULLONS PER INCH TRUNK CALPER. ALL THIS MARTE SHOULD BE ARRESTED AND THE TOP OF THE PROOF BUILD. SIREN OBJECTIVES

	TION SCHEDULES DEPEND ON SIZE		
SIZE OF UIRSERY	IRRIGATION SCHEE	NULE FOR	
STOCK	VIGOR	SURWINAL	
LESS THAN 2 INCH CALIPER	DAILY: 2 WEEKS EVERY OTHER DAY: 2 MONTHS WEEKLY: UNTIL ESTABLISHED	TMICE WEEKLY FOR 2-3 MONTHS	
2-4 INCH CALIPER	DAILY: 1 MONTH EVERY OTHER DAY: 3 MONTHS WEEKLY: UNTIL ESTABLISHED	TWICE WEEKLY FOR 3-4 WONTHS	
GREATER THAN 4 INCH CALIPER	DAILY: 6 WEEKS EVERY OTHER DAY: 5 MONTHS WEEKLY: UNTIL ESTABLISHED	TWICE WEEKLY FOR 4-5 WONTHS	
ESTABLISHVE	NT TAKES APPROXIMATELY 3 MONTHS	(HARDINESS ZONES 10-11)	

IRRIGATION SCHEDULE


ROURS, & NOXIOUS PERSES & DISEASE (SEE SOIL PLANTING SPECIFICATIONS).
THEE REMOVAL PERMIT SHALL BE REQUIRED PROR TO CONSTRUCTION & WAY CLEARING THE BOOK THOUSE WILL BE EXCENDED THAN TO CONSTRUCT AN OF CLOSES.

HE PROVIDED THE OF THE THOUSE THAN THE PROVIDED THAN THE PROVIDED THE OF CONSTRUCTION AND CODE ACCORDING TO CODE MISSIST PROTECTS AS THOUSED. THE PROVIDED THAN THE PROVIDED THE PROVIDED THAN THE PRO

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	NT TAKES APPROXIMATELY 3 MONTH	

ABLE 2. IRRIGA	TION SCHEDULES DEPEND ON SIZE.	OF NURSERY STOCK AND DESIR
SIZE OF NURSERY	IRRIGATION SCHEE	DULE FOR
STOCK	VIGOR	SURWAL
LESS THAN 2 INCH CALIPER	DAILY: 2 WEEKS EVERY OTHER DAY: 2 MONTHS WEEKLY: UNTIL ESTABLISHED	TMICE WEEKLY FOR 2-3 MONTHS
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GREATER THAN 4 INCH CALIPER	DAILY: 6 WEEKS EVERY OTHER DAY: 5 MONTHS WEEKLY: UNTIL ESTABLISHED	TWICE WEEKLY FOR 4-5 WONTHS
FETANI KHIJE	SHITMON 7 VISTAMINATORS ASSET TH	(HARDINESS ZONES 10-11)



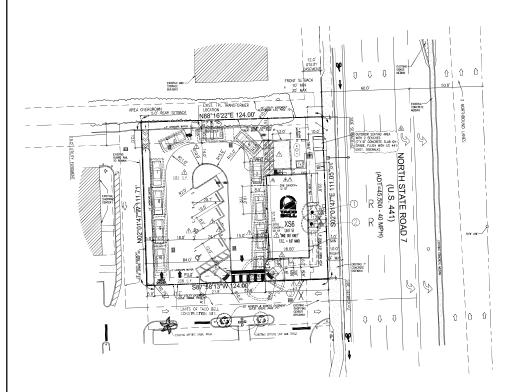



CONTRACTOR SHALL DETAIN A TREE REMOVAL/RELOCATION PERMIT AND PROVIDE FOR ANY MITIGATION PRIOR TO OBTAINING A BUILDING PERMIT. ALL LANDSCAPE MATERIALS SHALL BE PLANTED 6" MINIMUM DISTANCE AWAY FROM ALL TREE/PALM ROOTBALLS LANDSCAPE CONTRACTOR TO SCHEDULE A FINAL INSPECTION AND COMPLIANCE INSPECTION WITH THE LANDSCAPE ARCHITECT PRIOR TO C.O.

IRRIGATION SCHEDULE


IRRIGATION STILLOUS BE PREADN SHEDUE
FOR RECORDS MOVE SHED RESSPONS BE PREADN SHEDUE
SHALE E AS FER UF/BS FORDERION DIN-100F, DUPING ISSREDIMENT, TREES
SHOULD BE RESOLDED 2-3 TIMES FOR WIRE WITH 20 CLUBE FOR NOT HIS MINK OUPER.
ALL HIS MARE SHOULD BE APPLIED ONLY 10 THE 10°F OF THE BOOT BALL
THE 2E PROMOTION SHEDIUS DIFFERED ON STEED WIRESPECTSOON WID DESIRED OBJECTIVE-

SIZE OF NURSERY	PRIGATION SCHE	DULE FOR	
STOCK	WGDR	SURWAL	
LESS THAN 2 INCH CALIPER	DAILY: 2 WEEKS EVERY OTHER DAY: 2 MONTHS WEEKLY: UNTIL ESTABLISHED	THICE WEEKLY FOR 2-3 MONTHS	
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* ESTABLISHMENT TAKES APPROXIMATELY 3 MONTHS (HARDINESS ZONES 10-11)
4 MONTHS (HARDINESS ZONES 8-9) PER INCH TRUNK GAUPER.



"ALL EXISTING, PROTECTED TREES WILL REMAIN AND BE PROTECTED DURING CONSTRUCTION" (BY GENERAL CONTRACTOR)

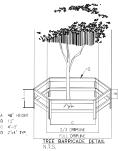

TREE BARRICADE NOTES:

- THE SHAPE DISCS TO BE EXCOUNTED SHAPL BE FROM PRIMED 8 WITHIS PRIME TO CONSTRUCTION AND DATE ACCOUNTS TO GOOD WARREST FRACTICE AS REQUIRED TO CONSTRUCTION AND DATE ACCOUNTS TO GOOD WARREST FRACTICE AS REQUIRED TO CONSTRUCT AND THE PRIMED TO SOLD WOOD, FRI CANTO THE SHAPE OF THE SHAPE OF THE PRIMED AND THE
- ALL DUSTING TREES SHALL COMPLY WITH THE "AMERICAN NATIONAL STANDARD INSTITUTE, (ANSI)
 A303-2005." CURRENT EDITION RESPECTIVELY.
- LANDSCAPE CONTRACTOR SHALL WATER RELOCATED TREES WITH TEMPORARY IRRIGATION EVERYDAY FOR THE FIRST MONTH THEN 2-3 TIMES A WEEK UNTIL SYSTEM IS FULLY AUTOMATIC: OWNER TO SUPPLY WATER ON SITE 4. EXISTING TREES TO BE BARRICADED PRIOR TO DEGINING OF CONSTRUCTION & SHALL REMAIN IN PLACE DURING CONSTRUCTION.
- NO HEAVY EQUIPMENT, CONSTRUCTION MATERIALS OR SOIL DEPOSITS ARE TO BE ALLOWED INSIDE TREE BARRIERS.
- TOPSOIL SHALL BE CLEAN & REASONABLY FREE OF CONSTRUCTION DEBRIS, WEEDS, ROCKS, & NOXICUS PESTS & DISEASE (SEE SOIL PLANTING SPECIFICATIONS).
- 7. TREE REMOVAL PERMIT SHALL BE REQUIRED PRIOR TO CONSTRUCTION & ANY CLEARING OPERATIONS AS REQUIRED.
- 8. I PRINCIPART THEY WITH 80 TIPES SPICE OF IREL CRAIN, TRANSPLANTING HOLE SHULL BE AT LEAST 1/3 BOORE HAN THE AREA THAT WAS TROUGHED FOR TRANSPLANTING. $9.561 \text{ TREES NO DESPERTHENT IT WAS NO TIS ORDINAL GROWING WITH THE PROOF BALLS EVEN WITH , OR SUGHT HORSE (<math>+$ + + +) That the moreous grade.

EXISTING TREES TO REMAIN REQUIRED BARRICADES

SEE SHEET L-1 LANDSCAPE PLAN FOR ADDITIONAL INFORMATION

R = TO BE RELOCATED

X = TO BE REMOVED

	EXISTING LANDSCAPE MATERIALS						
	KEY	CODE	AMOUNT	BOTANICAL NAME / COMMON NAME	SIZE	REMARKS	CONDITION
R	0	SAB	- 1	SABAL PALMETTO / CABBAGE PALM	16'-18' X 15'	(1) TO BE RELOCATED (12".O CALIPER)	GOOD/70%
R	0	SAB	1	SABAL PALMETTO / CABBAGE PALM	18'-20' X 15'	(1) TO BE RELOCATED (12".O CALIPER)	GOOD/70%
V X	(3)	LIV	1	QUERCUS VIRGINIANA / LIVE CAK	22'-24' X 30'	(1) TO BE REMOVED (10".5 CAUPER)	FOOR/40%

1 LIVE OAK TREE 10.5" D.B.H. TO BE REMOVED =X SEE PLAN
(3)—CRAPE MYRTLE UPSIZED FROM 2" TO 4" D.B.H. = ADDITIONAL 6.0" D.B.H. PROVIDED ONSITE. SEE L-1
4.5" D.B.H. TREE SHORTFALL OPTION OF \$350.00 PER 2" D.B.H. AMOUNT OF \$787.50 TO BE PAID INTO
CITY TREE TRUST FUND.

(M)= UPSIZED TREES IN LIEU OF CANOPY COMPENSATION MITIGATION PROVIDED AS SHOWN, SEE LEGEND







RBL#23-01-2199 CRAWN BY: RICK BARTLETT

	DATE	REMARKS
Δ	03/24/23	CITY COMMENTS
Δ	09/10/24	CITY COMMENTS
Δ	09/11/24	CITY COMMENTS
A	10/01/24	CITY COMMENTS
Δ	10/23/24	CITY COMMENTS
Æ.	12/13/24	CITY COMMENTS

CONTRACT DATE: BUILDING TYPE:

SITE NUMBER: STORE NUMBER: TB-459380 DIANA DeCICCO DRAWN BY: AG

JOB NO.:


TACO BELL 2640 N SR-7, HOLLYWOOD, FL 33021



XS6

TREE DISPOSITION PLAN

PLOT DATE:

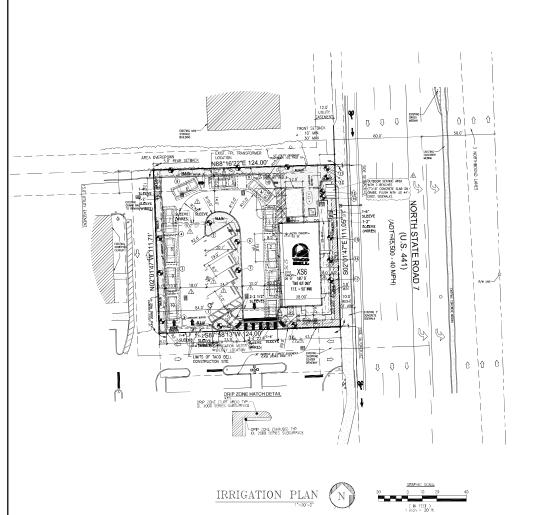



THIS SITE LIES IN SECTION 1, TOWNSHIP 51 SOUTH, RANGE 41 EAST, BROWARD COUNTY, FLORIDA.

LEGAL DESCRIPTION:

PARCEL "A", "GAIOR 441 SUBDIVISION", ACCORDING TO THE PLAT THEREOF, RECORDED IN PLAT BOOK 151, PAGE B, OF THE PUBLIC RECORDS OF BROWARD COUNTY, FLORIDA.

SAID LANDS LYING AND BEING IN THE CITY OF HOLLYWOOD, BROWARD COUNTY, FLORIDA AND CONTAINING 13,811 SQUARE FEET (0.3171 ACRES), MORE OR LESS.

		MODEL NO.
4" pop-up spray head	Torp	570Z-4PCOM
12" pap-up spray head installed in season color beds only	Taro	570Z-12P COM
spray head nazzles with pressure compensation	Toro	Precision Series Nocales
rotor sprinkler head	Tale	TSPRS
drip line	Yere	DL52000
controllers (up to 16 zones)	Tore	Evalution EVO-400 With EVOH-4/12 Expansion Modules
weather sensor	Tere	Evolution EVO-SC, EVO-WS
cuntrollers (16 to 24 zones)	Sero	TMC 424E-0D
weather sensors (with true 424e)	Irrital	CL-Wireless
electric valves (spray and retary sones), (drip sones)	Toro	TPVF100, DK-EZF
	NBCO	T-113
quick coupler valve & key	Toro	100-SLVLC, 100 SLK
swirel hase et1	Toro	100 MH5
bookflow preventer valve	FEBCO	Ax Required
10" round valve box	Amtec	181104
surge protection kit	Irrital	570-587

	IRRIGATION LEGEND
	2" SCH. 40 PIC MAIN LINE AS SHOWN
_	TORO MODEL THE 424E-OD 24 ZONE TIME CONTROLLER
•	TORO SERIES LOW VOLTAGE CONTROL VALVES 1" & 1 1/2" W/ DIRECT BURNIL #14 MRE AS REQUIRED
NH-	1" SUB-IRRIGATION WATER METER & FEBCO BACKFLOW PREVENTER (FIELD VERIFY BY OWNER)
	TORO CHEMIC USING OND CONCERT, WITH SUPPLY AND FLUSH MANIFOLDS AT EACH END TO CREATE A CLOSED-LOOP SYSTEM. S/8" THERE DAMETER DIL 2000 PC DRIPLINE WITH ROCCIOLARD, NORMAL FLOW 0.35 CPH AND 1.02 CPH 0.35 PSI MINIMUM.
_	TORG WEATHER SENSOR EVOLUTION EVO-SC, EVO-WS
	BES SEL (1224D) BES SEL (1224D) BES SEL (1224D) 1.74° 1.74° 1.74° 1.72° 22-0.0 1.72° 22-0.0

# HEADS	DRP	DRIP	DRIP	DRP	DRP	DRP	DRIP	DRIP	DEIP	CRP	DRIP	DRIF
G. P. N.	35.00	35.00	35.00	30.00	35.00	35.00	35.00	30.00	35.00	35.00	35.00	35.0
												_
			TOE	PA DP	IPI INF	DI 2	nnn-	ZONES				
			TOF	RO DR	IPLINE	DL 2	000-	ZONES				
20HE	13	14	TOF	RO DR	IPLINE 17	DL 2	000-	ZONES I 20	21	22	23	24
ZONE # HEADS		14 ORIP							21	22	23	24

TORO DRIPLINE DL 2000-ZONES

- ALL LABOURD AREA SHALL BE PROVIDE WITH AN LABOUR FROM PILLY APPOARD PROJECT OF STREET OF STREET AND ASSOCIATION OF THE SELECT OF STREET AND ASSOCIATION OF THE SELECT OF STREET AND ASSOCIATION OF THE SELECT OF STREET ASSOCIATION OF STREET ASSOCIATION OF THE SELECT OF THE SELECT OF THE SELECT OF STREET ASSOCIATION OF THE SELECT OF THE SEL
- GENERAL CONTRACTOR TO SUPPLY AND INSTALL SLEEVES AS SHOWN AND PROVIDE ELECTRICAL HOCK-UP AS REQUIRED.
- 3. MORR ALSO SHALL COURLY WITH THE AMERICAN SOCIETY FOR TESTING AND MATERIALS (ASTM).

 COBES AND STANDARDS: ALL WORK SHALL BE INSTALLED AND COMPLY WITH "FLORDAR BUILDING CODE APPENDIX (F) PART V—A—1.",
 NOLIDING ORDINALES AND RECOLATIONS OF ALL GOVERNIA AUTHORITES.
- PPE INSTALLATION IN VEHICLE THAFTIC AREAS SHALL BE AS FOLLOWS: PBC V-A-1::
 PBE SIDE (MCHES) DEPTH OF CORER (MCHES)
 17/2-2 1/2
 3-5 24-10"
 6 JMD LARGER 20-16"
 6 JMD LARGER 20-16"
- 5. ALL DRIPLINE LATERALS SHALL BE UNDER 3"-4" MULCH IN SHRUB AND BED AREAS; 4" UNDER TURE AREAS.
- 6 CONTRACTOR TO PRESSURE TEST WATER SERVICE UP TO EACH ZOIG WUVE IN THE RECORDON SYSTEM, MAIL LINE SHALL BE LEST CARROSO FOR MAILIN, CASSINATION PACER TO BRICKETL, AND REQUIRED APPROVAL BY CITY OF HOLLYWOOD, CALL CITY OF THATWOOD FOR RECORDOR PASSESSIONS.
- 7. IRRIGATION CONTRACTOR TO SUPPLY AND INSTALL BUBBLERS AT ALL NEW TREE AND PALM LOCATIONS.
- 8. SEE TACO BELL GENERAL NOTES AND SPECIFICATIONS.
- CONTRACTOR SHALL INSTALL DRIP ISROATION LAYOUT IN THE HATCHED AREAS INDICATED ON THE PLAN IN ACCORDANCE TO THE MANUFACTURES INSTALLATION MANUAL AND RECOMMEMBATIONS.
- 10. THE IRRIGATION SYSTEM SHOWN IS FOR GRAPHICAL CLARITY ONLY, CONTRACTOR TO ADJUST FOR REQUIRED 100% CONERAGE.
- 11. THE MAXIMUM LENGTH OF LATERAL RUN SHALL NOT EXCEED 150 LINEAR FEET.

 12. THE CONTRACTOR SHALL VERTY THE AVAILABLE GRM AND PSI PRIOR TO INSTALLATION OF THE SYSTEM.
- 13. A FINAL INSPECTION OF ALL IRRIGATION ZONES SHALL BE REQUIRED PRIOR TO A FINAL C/O.



IRRIGATION SCHEDULE

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FOR COLD SCHEDULE SHARE THE COLD SCHEDULE SHARE THE PART OF THE THE PART OF

NURSERY STOCK	WOOR	SURVIWIL.
LESS THAN 2 INCH CALIPER	DAILY: 2 WEEKS EVERY OTHER DAY: 2 MONTHS WEEKLY: UNTIL ESTABLISHED	TAICE NEEKLY FOR 2-3 MONTHS
2-4 INCH CALIFER	DAILY: 1 MONTH EVERY OTHER DAY: 3 MONTHS WEEKLY:UNBL ESTABLISHED	TAICE NEEKLY FOR 3-4 MONTHS
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RBL#23-01-2199 DRAWN BY: RICK BARTLETT CHECKED: RCB /MER

OFF	OTILU.		
		TE	REMARKS
Δ	03/2		CITY COMMENTS
A	10/0		CITY COMMENTS
Δ	10/2		CITY COMMENTS
AL.	12/1	3/24	CITY COMMENTS
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CON	ITRAC	T DAT	TE: 2/26/202
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BUIL PLAI BRA SITE	DING N VER ND DE NUM	TYPE SION: SIGN BER:	ER: DANIEL DICKSON 315998
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JOB NO.: CKE 1746 TACO BELL 2640 N SR-7, HOLLYWOOD, FL 33021

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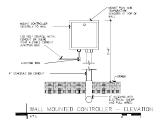


XS6

IRRIGATION PLAN

PLOT DATE:

IRRIGATION GENERAL NOTES






HOSEL BACKTON PREVENER AS REQUIRED BY LOCK, COAS AND HAVE'N COMMINGET, MOREY LOCK, REQUIREMENT PROP. TO ASSELLATION.

BACKFLOW PREVENTER



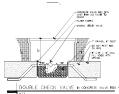

DOUBLE CHECK VALVE IN CONCRETE VALVE BOX - SEC

IRRIGATION | SPECIFICATIONS

1.2 OPERATION AND MAINTENANCE DATA


1.5 REGULATORY REQUIREMENTS.


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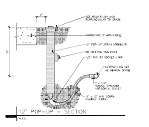
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Transaction of the Parket	situr spinklar head
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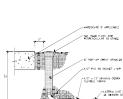
Com-unique head	See	STEZ-4P-COM
12" page-up-apray hand installed in secusion solar lands only	Sec	SPEZ-12F-COM
spray bound sugates with presquest surrepresentation	Sec	Precision Series Negates
sitts repitalischend	Sera	TSPRS
drip line	Yes	DUSINGS-
rosstrallars (op in 16 zeross)	Sen	Evolution EVCI-4DD With EVIDA: 4/12 Exponency Modules
weather sensor	Yes	Evolution EVO-SC, EVO-WS
rootrollers (16 to 34 zones)	Same	THC 434E-00
(with true 424a)	Irrital	CL-Wireless
electric values (ignery and retary senies), (drip senies)	See	TIMETOD, DE-EZF
	NECO	T-113-
quick measure yeter faller	See	100-SEVEC, 100-1EK
period hope et1	Serie	100 MHS
lackflow preventer rights	FEICD	Az Required
10" mund valve live.	Amtes	131104
surge protection lift	Irrital	970-147

NOTES: 1. AR/MACJUM FELET WANT CANNOT BE CONNECTED LOWER THAN EMPLINE LATERALS. 2. USE FOR 20ALS OF 1 GPM OF USSS ONLY (PLUMBLD TO PMC). -1/2" PVC OSUPLING (TAT -1/2" SON, 60 NOTES. DRIP - RELIEF VALVE - SECTION





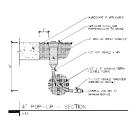

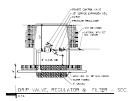

SOLENOID VALVE IN PLASTIC VALVE BOX - SECTION

PLASTIC VALVE NOV

PIC BULL VALVE, SAME SIZE AS SOLEHOLD VALVE -30" LONGTH OF WISE

LATERAL WITH

-LATERAL LINE SET AT IMPROVING GEPTH


IRRIGATION | SPECIFICATIONS


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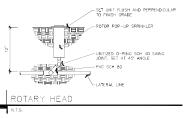





IRRIGATION SPECIFICATIONS

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STOLLAND

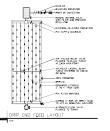

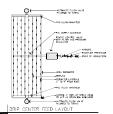

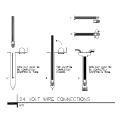

- INTEGRATION SPECIFICATIONS
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 OF 24 BIRD PROSE CORP. AND BELL CARRES A MINIMAL
 OF LINESTER MESS AND SECTION P.C. AND SECT

811

Know what's below. Call before you d

- CONTRICTOR TO SIZE MPMG (UNILESS OTHERWISE SHOWN) AND ADJUST SPRAY FLOS (CIDANIO). TO COMPOSE WITH WAITER BIDDIREDWINS OF ACTUAL LANGES, WHICH FOR ACCOUNTS WAITER CONTRICTOR. WAS AND ADJUST OF ACCOUNTS WAITER CONTRICTOR. AND ADJUST OF ACCOUNTS OF ACCOUNTS WAITER CONTRICTOR. AND ADJUST OF ACCOUNTS OF ACCOU
- ARRES NO WINDOWS _ DOES NOT WORKER SIDES SET STORES.

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- SYSTEM IS TO BE DESIGNED (IF NOT SHOWN ON PLAN) AND INSTALLED BY A QUALIFIED, LICENSED, AND INSURED LANDSCAPE PRIGATOR.
- MEDIANDAL DETECTS OF 10 IES 414 BRET LORAL (DU VIDE MAR PARAMETER PROGRAM CONTROL TO IES 414 BRET LORAL (DU VIDE MAR PARAMETER PARAMETER

- BASE WITE GOOT DOES TOWN TO A THE WORK OF THE THE THE WAY TO VALUE COORDING THE WAY TO WAS TO





CIVIL ENGINEER-PE 31914 ARCHITECT-AR 14985

This item has been digitally signed by Eduardo L. Carcache on the date adjacent to the seal.



RBL#23-01-2199 DRAWN BY: RICK BARTLETT CHECKED: RGB/MER


STORE NUMBER: TB-459380 DIANA DeCICCO DRAWN BY.: JOB NO.:

> TACO BELL 2640 N SR-7 HOLLYWOOD, FL 33021



IRRIGATION SPECIFICATIONS



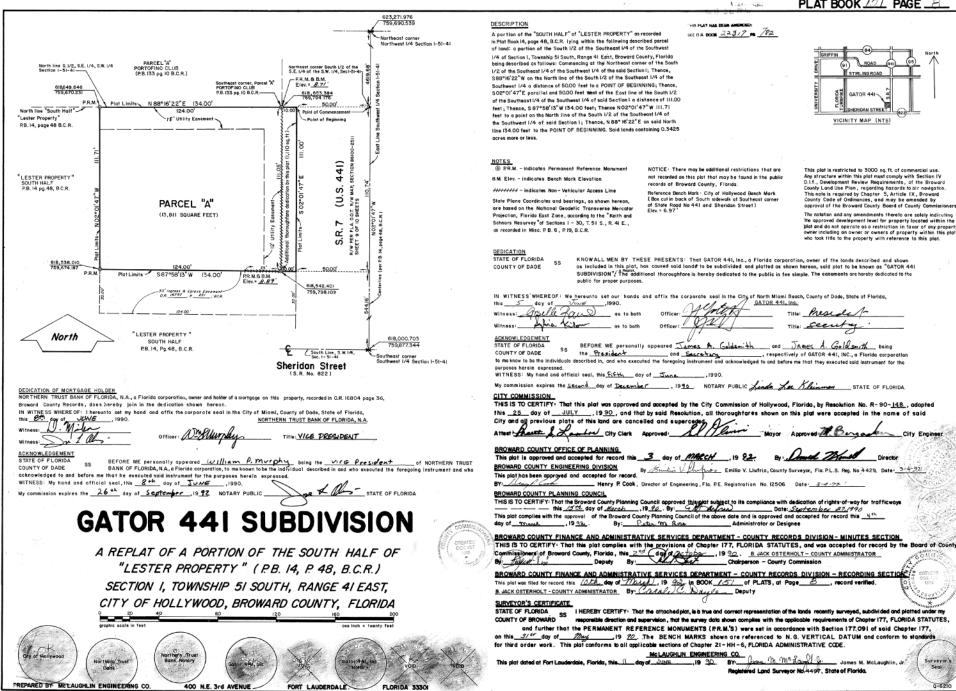




GLASS COVERAGE PERCENTAGE				
BUILDING EAST ELEVATION LENGTH: GLASS COVERAGE:	57'-9"	100%		
CLEAR GLASS	16"-2"	28%		
FAUX GLASS	18"-6"	32%		
TOTAL GLASS:	34'-8"	60%		

(EAST) RIGHT SIDE ELEVATION 1/4" = 1'-0" A

(WEST) LEFT SIDE ELEVATION 187-192 B



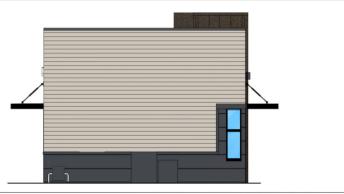

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A 06-24-2024	
A 12-05-2024	
A 12-10-2024	
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7	
X	
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CONTRACT DATE: 01.
BUILDING TYPE:
PLAN VERSION.
SITE NUMBER:
STORIE NUMBER: 44

TACO BELL

2640 N. State Rd 7 Hollywood, Florida. 33021



EXTERIOR ELEVATIONS

A4.0

(NORTH) REAR ELEVATION 1/4"-1-4" D









SEAL EDUARDO L. CARCACHE CML ENGINEER-PE 3191-

nis item has been digitally signed y Eduardo L. Carcache on the site adjacent to the seal.

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SW 7043 WORLD GRAY	1	SW 7076 CYBER SPACE	2	3	8	8	SW TB2630C PURPLE	4	7	WESTERN STATE - WEATHERED RUSTIC 6	5

CONTRACT DATE: 0914/2023

CONTRACT DATE: 0914/2023

BULDING TYPE: X323

BUADING TYPE: X323

BRAND DESCANER TEFANNE SHIFLY

SITE NUMBER: 159 0000

PAPM: EDDIE NUMEZ:

DRAWN BY: R. C.

JOB NO: CKE 1792

TACO BELL 2640 N. STATE RD. 7 HOLLYWOOD, FL. 33021

CUSTOM EXTERIOR ELEVATIONS

BLACK ANNODIZED	5

(EAST) RIGHT ELEVATION 1/4" = 1'-0" 1

SYMBOL	ITEMMATERIAL	MANUFACTURER	MATERIAL SPEC	GOLGR	CONTACT INFORMATION
1	SIONG	JAMES HARDIE	ARTISAN V-GROOVE 144'L X 8.25'W: 7' EXPOSURE COMES PRIMED FOR PAINT	WORLDLY GRAY (SW7043), SEM-GLOSS	SEE C/A72
2	HARDETRIM	JAMES HARDIE	HARDIE TRIM 5/4 SMOOTH 156.5°	CYBERSPACE (SW7076), SEMI-GLOSS	SEE C/A72
	HARDIE PANEL VERTICAL SIDING W/ ALUMINUM TRIM FROM FRY REGLET AND/OR TAMLYN	JAMES HARDIE	HARDIE PANBL VERTICAL SIDING - SMOOTH	CYBERSPACE (SW707N), SEMI-GLOSS	SEE C/A72
4	HOLLOW METAL DOOR			SW PURPLE TB260SC, SEWI-GLOSS	
5	AWININGS	SIGNAGE VENDOR		BLACK BY THE SIGNAGE VENDOR	
6	CORNER TOWER	WESTERN STATE	T-GROONE 24GA PAINTED 18" PANEL	WEATHERED RUSTIC	SEE C / A 7.2
7	HARDE REVEAL PANEL	JAMES HARDIE	REVEAL PANEL SYSTEM	SW PURPLE TB260SC, SEWI-GLOSS	SEE C / A 7/2
В	METAL PARAPET CAP		24GA GALVANIZED	CYBERSPACE (SW/ISW) KYNAR 500 COATING	

EXTERIOR FINISH SCHEDULE D










TACO BELLE

Store #315998 2640 N. State Rt. 7 Hollywood, FL 06/19/2024


FLOOR PLAN



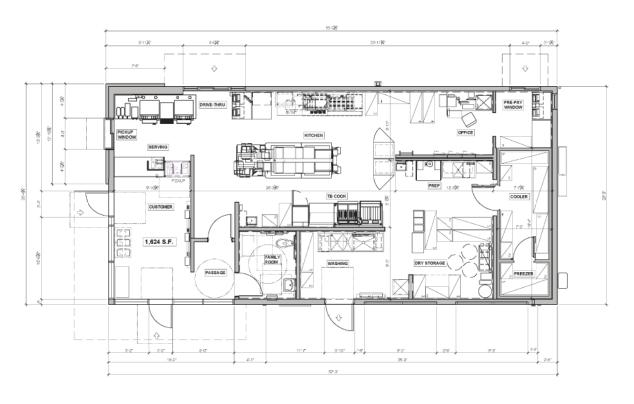






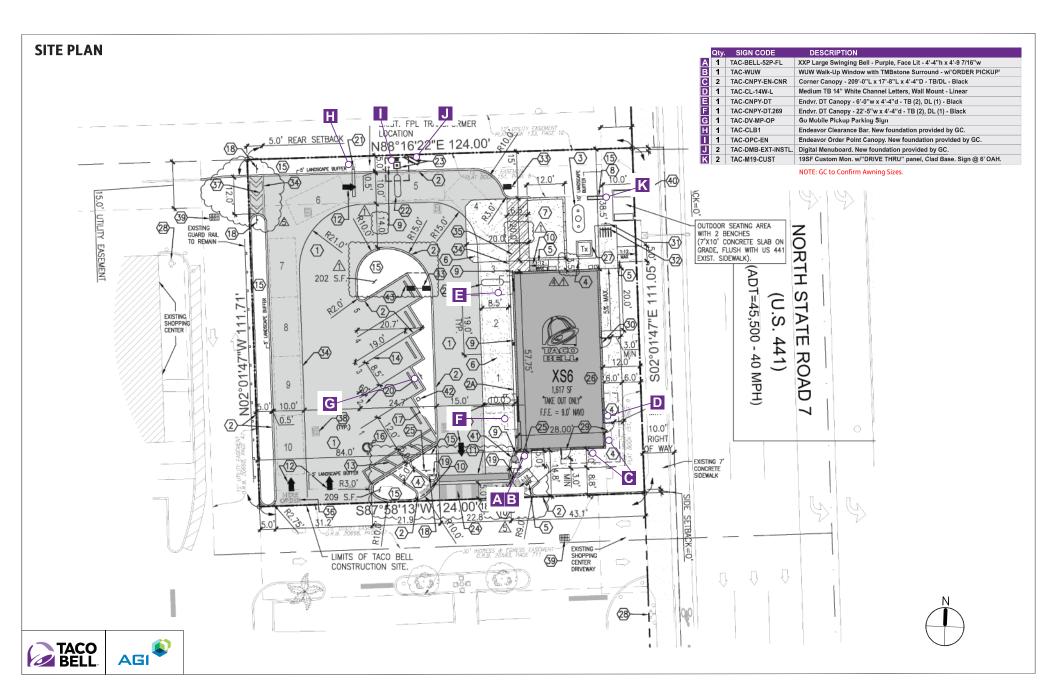

	Qty.	SIGN CODE	DESCRIPTION
Α	1	TAC-BELL-52P-FL	XXP Large Swinging Bell - Purple, Face Lit - 4'-4"h x 4'-9 7/16"w
В	1	TAC-WUW	WUW Walk-Up Window with TMBstone Surround - w/'ORDER PICKUP'
С	1	TAC-CNPY-EN-CNR	Corner Canopy - 20'-0"L x 4'-4"D - TB/DL - Black

NOTE: AWNING SIZES TO BE CONFIRMED BY GC, AND ARCHITECT

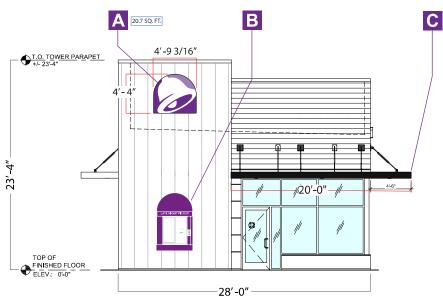

FRONT ELEVATION








	Qty.	SIGN CODE	DESCRIPTION
C	1	TAC-CNPY-EN-CNR	Corner Canopy - 17'-8"L x 4'-4"D - TB/DL - Black
D	1	TAC-CL-14W-L	Medium TB 14" White Channel Letters, Wall Mount - Linear

NOTE: AWNING SIZES TO BE CONFIRMED BY GC, AND ARCHITECT

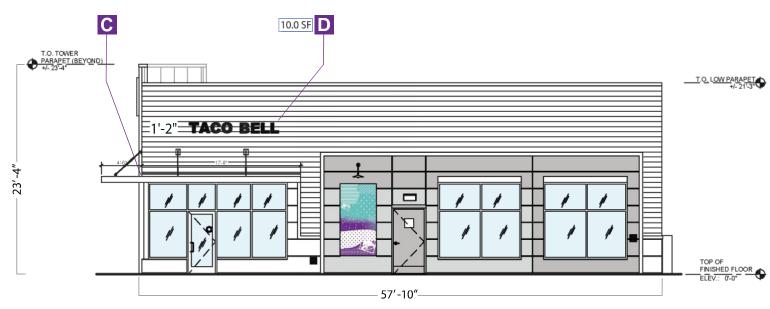

PORTAL ELEVATION








	Qty.	SIGN CODE	DESCRIPTION
E	1	TAC-CNPY-DT	Endvr. DT Canopy - 6'-0"w x 4'-4"d - TB (2), DL (1) - Black
F	1	TAC-CNPY-DT.285	Endvr. DT Canopy - 23'-9"w x 4'-4"d - TB (2), DL (1) - Black

NOTE: AWNING SIZES TO BE CONFIRMED BY GC, AND ARCHITECT

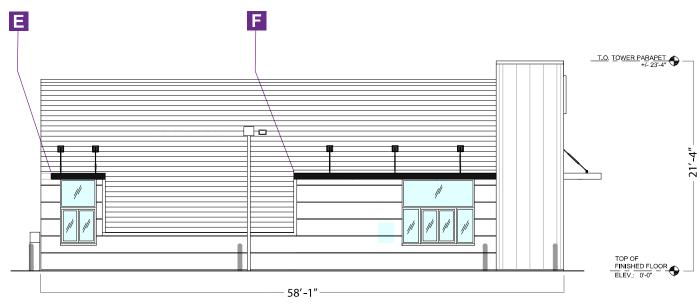


DRIVE-THRU ELEVATION







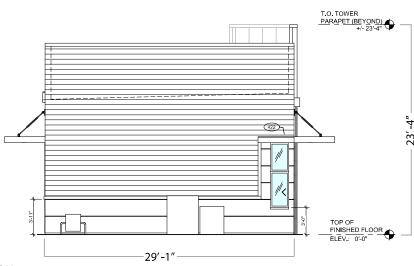

REAR ELEVATION








△ TAC-BELL-52P-FL

Qty. - 1

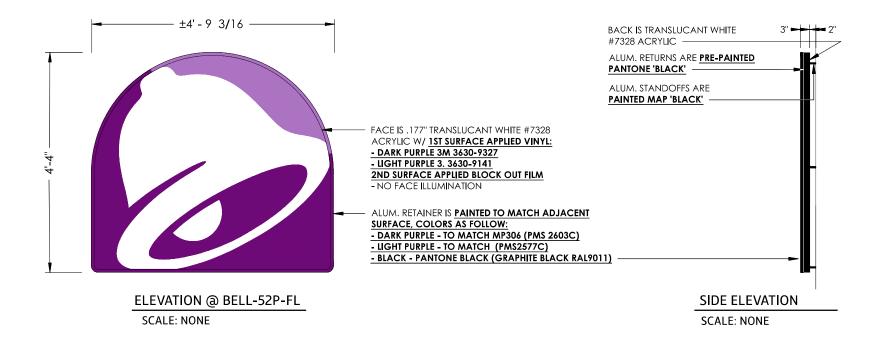





Windspeed: 115 MPH / IBC 2018

Illumination: ILLUMINATED

EXTERNAL DISCONNECT SWITCH

B TAC-WUW 3' - 11" 2' - 10 1/4" FABRICATED ALUM. CABINETS ARE LATE NIGHT PICKUP PAINTED DARK PURPLE TO MATCH MP306 (PMS 2603C) ON ALL EXPOSED SURFACES EXISTING ORDER WINDOW COPY IS 2ND SURFACE APPLIED A WINDOW AND VINYL 3M 3630-20 WHITE VINYL - COPY STYLE - CLIENT TO PROVIDE SPEC - SEE ENLARGED VIEW ON SH.9 PICKUP JO-DVF 3'-2 OMILY - LASTE POSICY -TOTAL TO GLOSSE COPY SURFACE APPLIED 3M 3630-20 WHITE VINYL - BOTH SIDES 2'-2" TO FINISHED GRADE FRONT ELEVATION SIDE ELEVATION FINISHED GRADE AGI Scale: 3/4"=1'-0"


G TAC-CANOPY-EN-CORNER


Front Elevation

NOTES:

- 1.) SHOP TO PROVIDE TOUCH UP PAINT TO INSTALLER.
- 2.) INSTALLER TO MOUNT AWNING SLOPED AWAY FROM BUILDING AS SHOWN.

NOTE: Architect to confirm quantity and position of turnbuckles and downlights.

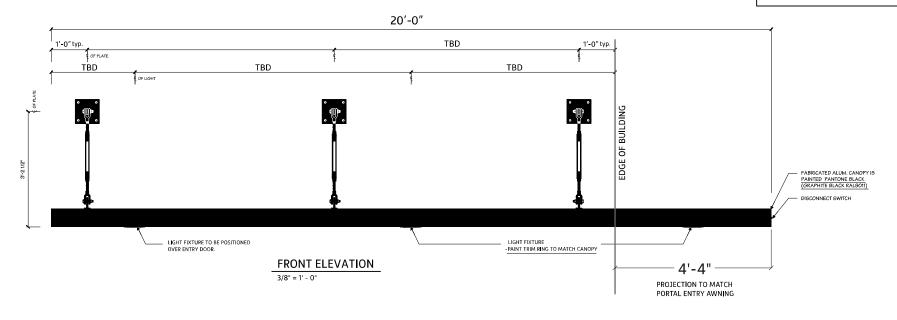

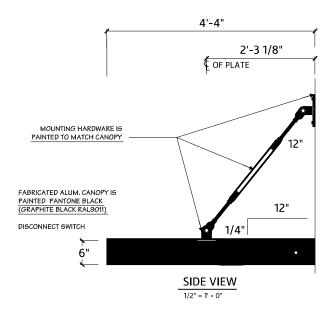






C TAC-CANOPY-EN-CORNER

Portal Elevation

NOTES:

- 1.) SHOP TO PROVIDE TOUCH UP PAINT TO INSTALLER.
- 2.) INSTALLER TO MOUNT AWNING SLOPED AWAY FROM BUILDING AS SHOWN.

NOTE: Architect to confirm quantity and position of turnbuckles and downlights.

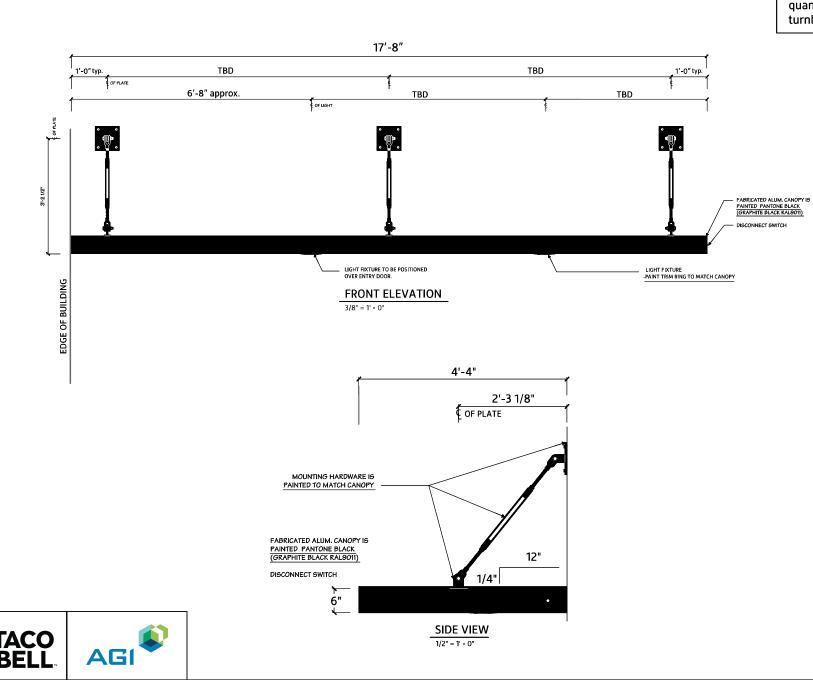

■ TAC-CL14W-L

MOUNTING APPLICATION			
INTERIOR	EXTERIOR		
	X		

	SIGN SCHEDULE						
	QTY	SIGN TYPE	'H'	'W'	'A'		
J		TB-10 - W	10"	± 6'-1 1/16"	N/A		
		TB-12 - W	12"	± 7'-3 11/16"	N/A		
	1	TB-14 - W	14"	± 8'-6 5/16"	N/A		
		TB-16 - W	16"	± 9'-9"	N/A		

NOTE:

- 1.) THIS DRAWING IS FOR INSTALLATION PURPOSES ONLY
- 2.) SHOP TO PROVIDE TOUCH UP PAINT TO INSTALLER.

MC	OUNTING HARDWARE
~ ~	3/8" ZINC PLATED STEEL THREAD


DED ROD Exterior - 3/8 ZINC FEATER STATES THRU WALL W/BLOCKING 3/8" SNAP TOGGLE BOLTS

NOTES:


- 1.) THREADED ROD WILL BE PROVIDED STANDARD, ALL OTHER HARDWARE IS TO BE PROVIDED BY THE INSTALLER AS REQUIRED.
- 2.) DESIGN INTENDED FOR NO GREATER THAN 3RD STORY MOUNTING - HIGHER ELEVATIONS REQUIRE REVIEW.

NOTES:


- 1.) VERIFY MOUNTING CONDITION.
- 2.) OWNER SUPPLIED POWER TO BE WITHIN 5'-0" OF AGI TRANSFORMER BOXES.
- 3.) SEAL ALL WALL PENETRATIONS TO PREVENT WATER INTRUSION AS FOLLOWS: INSTALL BUSHING AFTER E.I.F.S. APPLICATION HAS HARDENED. DRILL HOLE SLIGHTLY LARGER THAN BUSHING THROUGH INSULATION ONLY. STOP AT PLYWOOD. CAULK OPENING PRIOR TO INSERTING FASTENER TO SEAL PENETRATION.

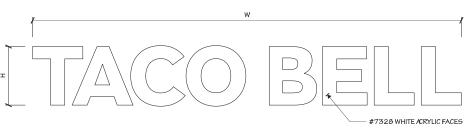

LINEAR FRONT ELEVATION

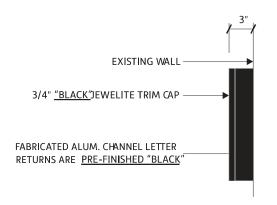

CHANNEL LETTER SIDE VIEW, TYP.

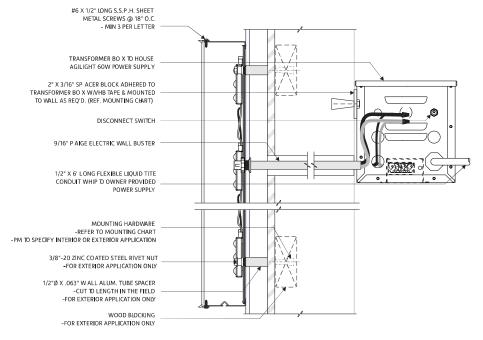








TAC-AWNING-DT-6X4.4-EN

NOTES:


- 1.) SHOP TO PROVIDE TOUCH UP PAINT TO INSTALLER.
- 2.) INSTALLER TO MOUNT AWNING SLOPED AWAY FROM BUILDING AS SHOWN.

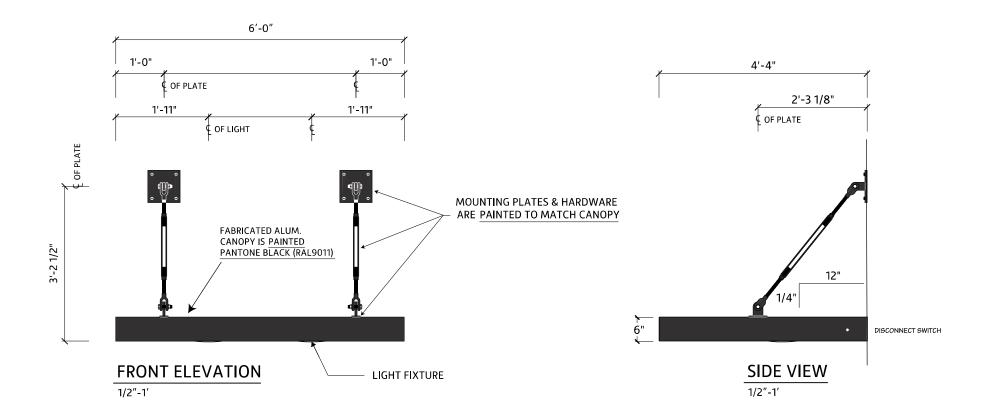





■ TAC-AWNING-DT-269 NOTES: 1.) SHOP TO PROVIDE TOUCH UP PAINT TO INSTALLER. 2.) INSTALLER TO MOUNT AWNING SLOPED AWAY FROM BUILDING AS SHOWN. NOTE: Architect to confirm quantity and position of turnbuckles and downlights. 22'-5" EQ. EQ. EQ. 1'-0" typ. 1'-0" typ. TBD TBD TBD FABRICATED ALUM. CANOPY IS PAINTED PANTONE BLACK (GRAPHITE BLACK RAL9011) DISCONNECT SWITCH LIGHT FIXTURE -PAINT TRIM RING TO MATCH CANOPY LIGHT FIXTURE TO BE POSITIONED OVER PICKUP WINDOW FRONT ELEVATION 3/8" = 1' - 0" 4'-4" 2'-3 1/8" OF PLATE

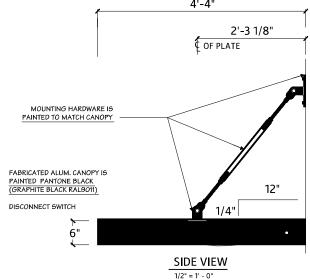





G TAC-DV-MP-OP Qty. - 1 PLAN VIEW 1' - 0" ALUM. PANEL W/ SURFACE APPLIED FULL COLOR PRINT - PAINT EXPOSED FASTENERS TO MATCH ADJACENT **PARKING** SURFACE GRAB INSIDE AND GO R=1/2" ALUM. TUBE IS PAINTED GRAPHITE BLACK RAL9011 Ξ̈ GRADE










Ⅲ TAC-CLB1

Qty. - 1

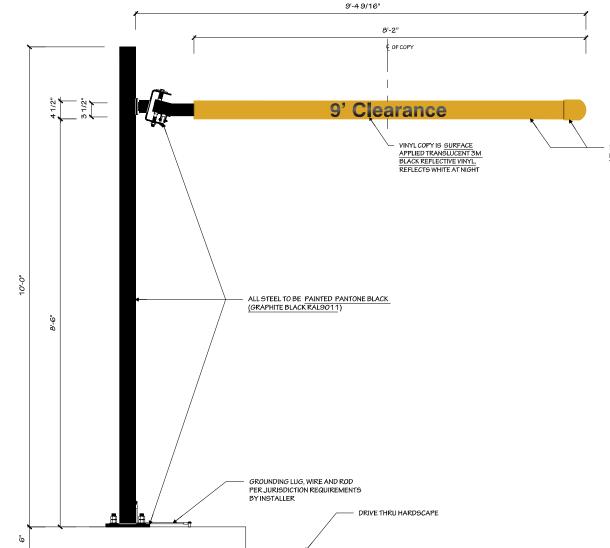

NOTES:

- 1.) PM TO SPECIFY COPY ORIENTATION PRIOR TO FABRICATION.
- 2.) SHOP TO PROVIDE INSTALL HARDWARE AND TOUCH UP PAINT TO INSTALLER.

X

COPY ORIENTATION				
X	POLE ON LEFT			
	POLE ON RIGHT			

PVC BAR AND END CAP ARE PAINTED MP 3236 'SAFETY YELLOW'

FRONT ELEVATION (COPY W/ POLE ON LEFT)

1/2" = 1' - 0"








■ TAC-CLEARANCE-EN - Foundation Types


NOTES:

1.) SHOP TO PROVIDE INSTALL HARDWARE AND TOUCH UP PAINT TO INSTALLER.

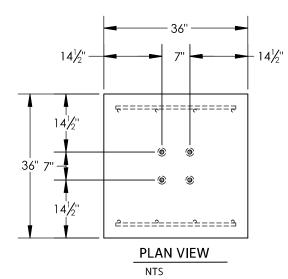

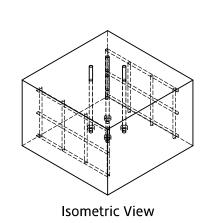

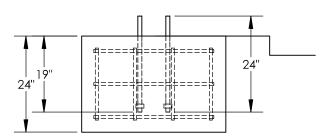

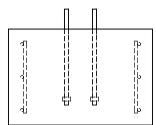


VERTICAL SLAB FOUNDATION

NTS


2,500 PSI CONCRETE FOUNDATION REINFORCED WITH #6AT 12" O.C. MAXIMUM, EACH WAY, EACH FACE.





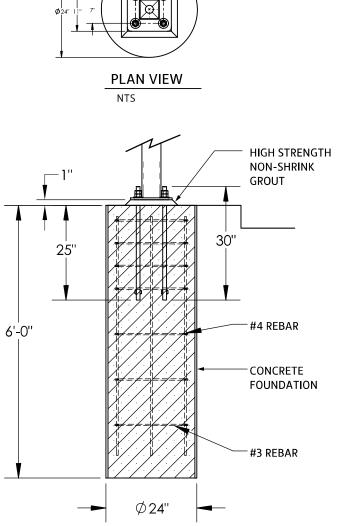


CAISSON FOUNDATION

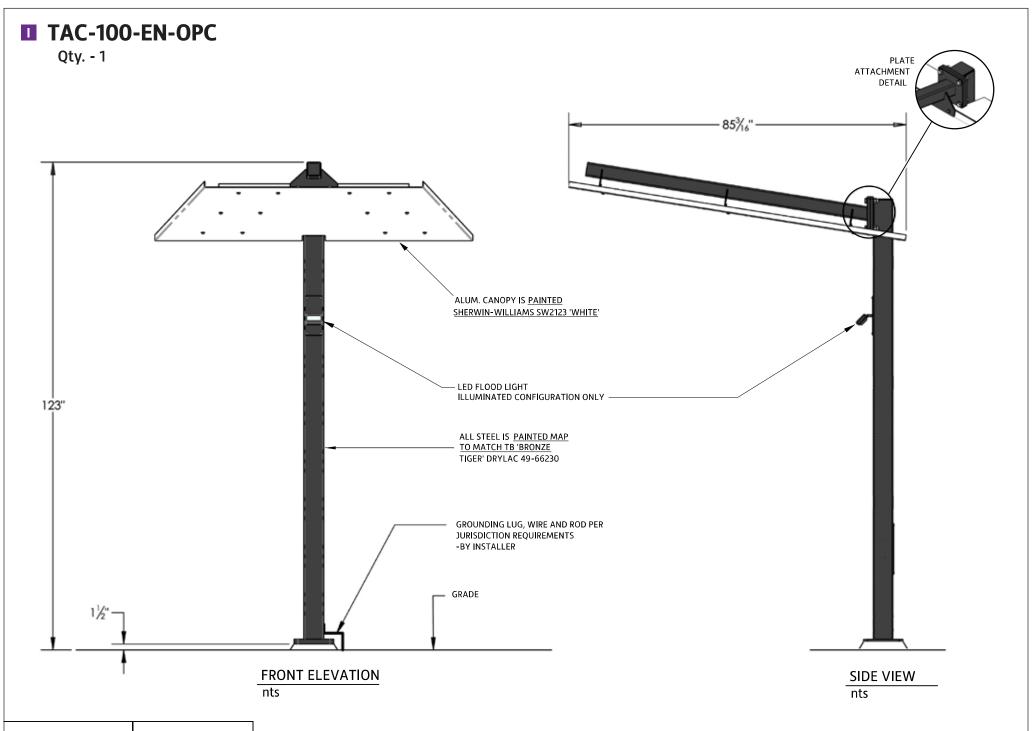






■ TAC-OPC-EN Foundation Types/Electrical Details

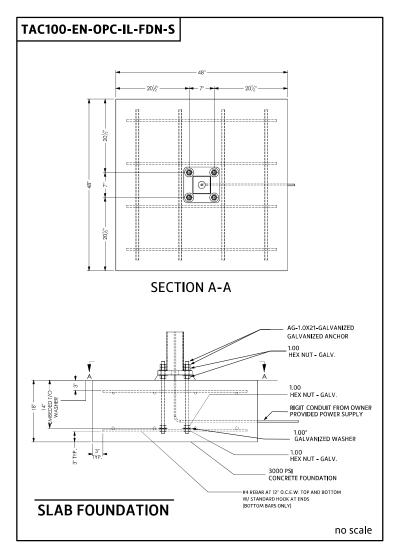

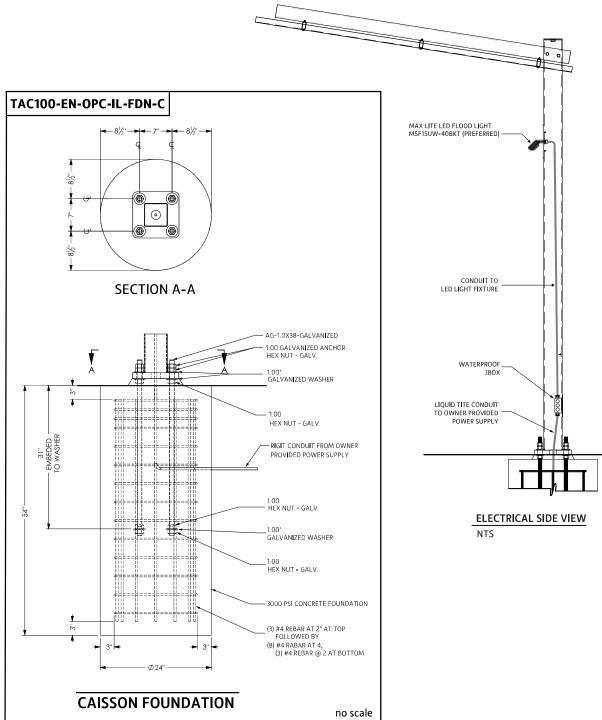







TAC-DMB-EXT-INSTALL

Qty. - 1

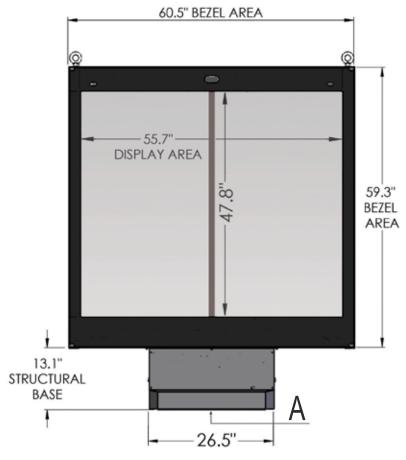

Front View

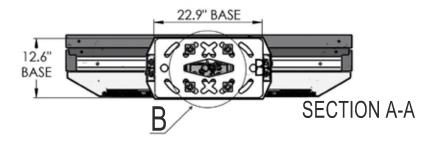



Material: Aluminum exterior with tube steel inner frame.
Certified 180 MPH

Surface Treatment:

Pretreatment - zinc primer& polyester powder coating

Surface Area:

- Display: 18.5 sq/ft
- Total surface: 24.9 sq/ft

Weight:

- Gross: 915 lbs / Net: 705 lbs


ELECTRICAL SPECS

Power:

- Hardwired AC Power
- 120/240V 50/60Hz
- 1150 W (@ max load)
- UL Rated @ 10 Amp

Backlight:

- LED Light Source
- 380 CD/M2 to 3,500 CD/M2
- Auto adjusting to outdoor ambient light levels

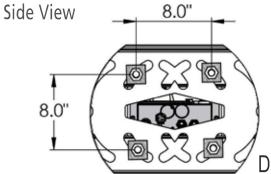

DETAIL B-B





Product Model #: STR-D12-120
Project #:

Date: 2019-12-03

STRATACACHE
MARKETING TECHNOLOGY

5.7"

13.1"

13.6"


13.1"


11.9"

STRATACACHE 40 N. Main Street Dayton, Ohio 45423 1-800-244-8915 Drawing #: STR-D12 v1.1
Date: 2019-12-03

Author: **B. Pupo**

TAC-DMB-EXT-INSTALL

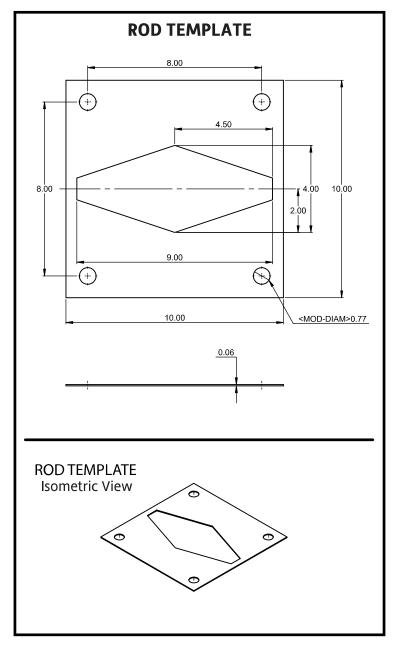

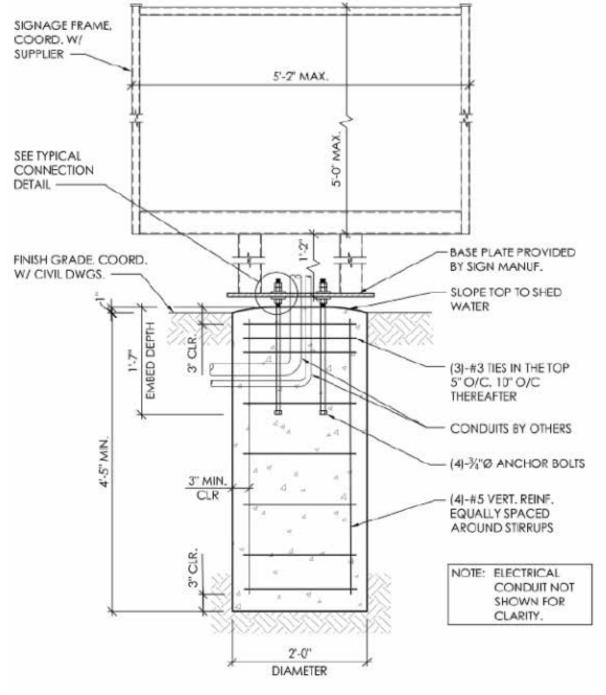






(MENU BOARD)

K TAC-M19

NOTE:

1.) SHOP TO PROVIDE TOUCH UP PAINT TO INSTALLER



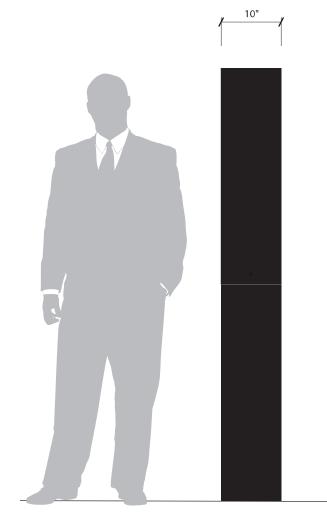

FRONT ELEVATION

3/4" = 1' - 0"

Custom M19 Monument

- -Logo face is routed aluminum painted white.
- -Acrylic backup with graphics as shown
- -Bell is first surface vinyl, two tone TB purple.
- -TACO BELL copy is first surface day/night vinyl
- -Ancillary panel painted white with first surface Black vinyl and routed out for copy.
- -Clad base to grade.











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Taco Bell Active Use Liner Variance Request Justification

Taco Bell of America, LLC ("Applicant") is the developer of a +/- .31 acre parcel of land located at 2640 N. State Rd. 7 in the City of Hollywood ("Property"). The Property is identified as folio number 514101120010 on the Broward County Property Appraiser's website. The Property has a zoning designation of C-MU (Central Mixed-Use District) and a future land use designation of TOC (Transit Oriented Corridor).

Currently, the Property contains an abandoned car wash facility. The Applicant is proposing to demolish the car wash facility and develop the Property with a +/- 1,600 square foot drive-thru and take-out only Taco Bell restaurant with no indoor or outdoor customer seating ("Project"). The restaurant will provide drive-thru and walk up orders only. At this time, the Applicant is requesting site plan approval and the following 4 variance requests to develop the Project: 1.) from Section 7.2(A)(28) to allow the Project to be developed with 5 parking spaces rather than 10 spaces as required by Code; 2.) from Section 4.6(D)(12)(d(ii) to allow an active use liner on the ground floor along the State Rd. 7 building façade (east façade) of 51.51% rather than 60% as required by Code; 3.) from Section 4.6(D)(11)(c) to allow a window transparency on the ground floor along the State Rd. 7 building façade (east façade) of 27.9% rather than 50% as required by Code; and 4.) from Section 9.5(C)(1) to allow 15.28% of vehicular use landscape area rather than a minimum of 25% as required by Code.

Variance Request

The Applicant has made every effort to comply with all code requirements for the Project, with all Code requirements being met other than these 4 variance requests. At this time, the Applicant is requesting a variance to allow a ground floor active use liner of less than 60% along the east building façade. In accordance with Section 5.3(F)(1), applicants must demonstrate compliance with the following criteria to receive variance approval:

a) That the requested Variance maintains the basic intent and purpose of the subject regulations, particularly as it affects the stability and appearance of the city; and

The requested variance to reduce the ground floor active use liner will maintain the basic intent and purpose of the zoning regulations and will not negatively impact the appearance of the City. Currently the Property contains an abandoned car wash facility. This request will redevelop the Property with a use that will serve the surrounding community and improve the appearance of the City by removing an unutilized building.

The intent of the requirements to provide a minimum 60% active use liner is to provide buildings along the State Rd. 7 corridor that are pedestrian friendly and have active uses

on the ground floor. The proposed plans will meet this requirement with a 51.51% active use liner along the State Rd. 7 corridor. The front portion of the east building façade (along State Rd. 7), near the building entrance will consist of all glass windows along the ground floor. While the back portion of this façade will not contain any windows, it will be covered with faux glass and artistic murals to enhance the building aesthetics.

Given the aforementioned improvements, the variance request will maintain the intent and purpose of the Code and improve the appearance of the City.

b) That the requested Variance is otherwise compatible with the surrounding land uses and would not be detrimental to the community; and

The requested variance is compatible with the surrounding land uses and will not be detrimental to the community. The Property is an outparcel located within an existing shopping center on the State Rd. 7 corridor. The adjacent properties to the north, south and west are all located within the same zoning designation as the Property, C-MU. Furthermore, the Property is surrounded by existing similar commercial uses that are compatible with the proposed take out only restaurant use.

Given the aforementioned improvements, the variance request is compatible with the surrounding land uses and will not be detrimental to the community.

c) That the requested Variance is consistent with and in furtherance of the Goals, Objectives and Policies of the adopted Comprehensive Plan, as amended from time to time, the applicable Neighborhood Plan and all other similar plans adopted by the city; and

The requested variance will facilitate the redevelopment of the Property as a take-out only restaurant. This use is consistent with the permitted uses for the TOC future land use designation listed on page LU-63 of the City's Future Land Use Element. Furthermore, the request is consistent with the following goals, objectives and policies of the City's Comprehensive Plan and the City Wide Master Plan (CWMP):

Goal I: Promote a distribution of land uses that will enhance and improve the residential, business, resort, and natural communities while allowing land owners to maximize the use of their property.

The granting of the variance will facilitate the redevelopment of an abandoned car wash facility with an active restaurant use that will serve the existing residents end employees of the surrounding community and allow the property owner to maximize the use of the Property.

Policy 10.5: Encourage expansion of businesses and public improvements that are "family oriented" and targeted to local residents and workers.

The granting of the variance will facilitate the redevelopment of an underutilized property with a family oriented take-out restaurant. Taco Bell is a popular fast food option for all demographics, including families. Furthermore, the development of the Taco Bell restaurant will bring jobs to the local community, providing employment opportunities for residents.

CWMP Policy 4.2: Concentrate retail commercial activities in defined development centers to build critical commercial mass at appropriate locations that are compatible with neighborhoods and with beach redevelopment objectives.

The granting of the variance will facilitate the redevelopment of an underutilized property along the State Rd. 7 corridor with an active commercial use. The State Rd. 7 corridor is a major commercial corridor that runs throughout several municipalities. This corridor is intended to be developed with commercial uses, including restaurants, making this use compatible with the surrounding community.

d) That the need for the requested Variance is not economically based or self-imposed; or

The requested variance is not economically based or self-imposed. The Applicant has designed a building that will provide the most efficient traffic flow on the Property and meets all the dimensional and design guideline requirements of the C-MU district other than the requested variance. The variance is needed due to the nature of the take-out only business operation with no on-site dining. As the majority of the building contains back of house kitchen and storage operations, placing windows along the majority of the east building façade is not feasible. However, the Applicant has mitigated the lack of windows and active liner use by placing faux glass and artistic murals along the State Rd. 7 façade that will enhance and beatify the façade.

e) That the variance is necessary to comply with State or Federal Law and is the minimum Variance necessary to comply with the applicable law.

The variance requested is the minimum variances necessary to develop the Project. As previously stated, the Applicant has worked diligently to design a building and site that will optimize the traffic flow and circulation while meeting all the dimensional standards and design guidelines within the C-MU district. Providing the required 60% active use liner along the State Rd. 7 façade is not feasible due to the take-out only business operations and the majority of the building being used for back of house kitchen and storage operations.

Given the aforementioned setbacks, the variance requested is the minimum variance necessary to develop the Project.



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Taco Bell Parking Variance Request Justification

Taco Bell of America, LLC ("Applicant") is the developer of a +/- .31 acre parcel of land located at 2640 N. State Rd. 7 in the City of Hollywood ("Property"). The Property is identified as folio number 514101120010 on the Broward County Property Appraiser's website. The Property has a zoning designation of C-MU (Central Mixed-Use District) and a future land use designation of TOC (Transit Oriented Corridor).

Currently, the Property contains an abandoned car wash facility. The Applicant is proposing to demolish the car wash facility and develop the Property with a +/- 1,600 square foot drive-through and take-out only Taco Bell restaurant with no indoor or outdoor customer seating ("Project"). The restaurant will provide drive-through and walk-up orders only. At this time, the Applicant is requesting site plan approval and the following 4 variance requests to develop the Project: 1.) from Section 7.2(A)(28) to allow the Project to be developed with 5 parking spaces rather than 10 spaces as required by Code; 2.) from Section 4.6(D)(12)(d(ii) to allow an active use liner on the ground floor along the State Rd. 7 building façade (east façade) of 51.51% rather than 60% as required by Code; 3.) from Section 4.6(D)(11)(c) to allow a window transparency on the ground floor along the State Rd. 7 building façade (east façade) of 27.9% rather than 50% as required by Code; and 4.) from Section 9.5(C)(1) to allow 15.28% of vehicular use landscape area rather than a minimum of 25% as required by Code.

Variance Request

The Applicant has made every effort to comply with all code requirements for the Project, with all Code requirements being met other than these 4 variance requests. At this time, the Applicant is requesting a variance to allow 5 parking spaces rather than 10 as required by Code. In accordance with Section 5.3(F)(1), applicants must demonstrate compliance with the following criteria to receive variance approval:

a) That the requested Variance maintains the basic intent and purpose of the subject regulations, particularly as it affects the stability and appearance of the city; and

The requested variance to reduce the amount of parking spaces will maintain the basic intent and purpose of the zoning regulations and will not negatively impact the appearance of the City. Currently the Property contains an abandoned car wash facility. This request will redevelop the Property with a use that will serve the surrounding community and improve the appearance of the City by removing an unutilized building.

The intent of the parking requirements is to provide sufficient parking for each use so as to not impede traffic flow and business operations. Taco Bell is implementing a new model

with technology-based operations designed to move customers quickly and efficiently through the property to take the food to go rather than eating on-site. There is no customer seating available inside or outside the building to allow customers to eat on-site, all orders are placed to go. Customers can place orders in the drive-through, place mobile orders using the Taco Bell app, place an order through a meal delivery service (i.e. Uber Eats or DoorDash), or place a to-go order inside the building utilizing the quick serve digital kiosk system.

Taco Bell has +/- 7,480 total stores nationwide. Of the +/- 7,480 stores, +/- 6,805 are franchise stores, +/- 493 are corporate owned, and +/- 182 are licensed restaurants within shopping malls, universities, airports, and military bases. This store will be corporate owned, with operating hours anticipated to be from 7:00 am – 2:00 am daily. With this project being a corporate owned store, Taco Bell has the ability to directly control the business operations, thus resulting in a more efficient flow of order and pick-up time, an average order ready time (ORT) of 3 minutes and 22 seconds nationally for corporate owned stores.

On average, around 70% of the orders at Taco Bell are placed through the drive-through. Among mobile orders, that percentage increases, with around 80% of mobile orders being picked up in the drive-through lane rather than parking and picking up the order inside the building or in the outdoor pick-up window. To ensure the drive-through lane can accommodate the amount of vehicles ordering and/or picking up orders, efficient traffic flow and site circulation has been prioritized in the design, with stacking for up to 10 vehicles in the drive-through facility.

In addition to using the drive-through lane, customers can pre-order and pick-up food at the walk-up window outside the building, or in the designated mobile order pick-up location inside the building. Customers place orders inside the building using an electronic kiosk. An employee is available to assist as necessary. On average, over 90% of the orders placed inside the building are done through the kiosk. Additionally, an employee will not be designated at the cash register to take orders, thus prioritizing kiosk orders and reducing the number of employees needed at the restaurant.

For customers who place a mobile order on the app, or through a meal delivery service, an order ready time will be provided. This reduces the amount of time customers will be on site waiting for their order to be ready. Customers will be given the order ready time, providing them the ability to arrive at the restaurant when the order is ready, quickly pick-up the order and exit the site. Additionally, Taco Bell recently implemented a new ordering system called Order Up. The system went live nationally on December 5, 2024. This ordering system improves ORT by assigning an order ready time based on the size of the order and the number of employees working during the shift. Smaller orders will be pushed through quicker, while larger orders will be given a longer lead time, allowing staff sufficient time to put the order together.

Additionally, every restaurant has the ability to set up a profile through delivery service apps. Restaurants have the ability to direct delivery drivers to pick-up their orders inside

the building or through the drive-through facility. Taco Bell will set the profile to instruct delivery drivers to pick up orders in the drive-through lane, thus reducing the need for delivery drivers to park on-site and go inside the building to pick up an order.

With the new technology being implemented through Order Up, and the prioritization of mobile orders and utilization of the drive-through lane, 10 parking spaces are not needed to provide sufficient parking for customer parking. The majority of the orders will be placed and/or picked up in the drive-through facility, thus reducing the amount of parking spaces needed for customer pick-up and ordering. Additionally, 5 parking spaces is sufficient to provide parking needed for employees. Taco Bell estimates that 4-5 employees will be needed for each shift, this includes 1 manager and 3-4 employee members. Based on data of Taco Bell restaurants located within the North Miami/Fort Lauderdale Market, around 90% of the employees are utilizing public transportation to get to work rather driving a vehicle. The State Road 7/441 corridor is a major transit route in Broward County, with the 441 Breeze bus route running from Sample Road to the Broward County/Miami-Dade County line. With a bus stop for the 441 Breeze route located directly adjacent to the Property, employees will easily be able to use mass transit to get to and from work. To further encourage use of the bus route, the project is providing an outdoor seating area with benches in the northeast corner of the property, adjacent to the bus stop. This will provide a seating area for employees and customers to sit and wait for the bus. Lastly, some employees will use bicycles or scooters to get to work. To accommodate this, a bike rack that will park 5 bicycles has been added to the site. Additionally, Taco Bell looks for opportunities to hire team members from within the local community, allowing employees to walk to work.

The advanced technology being implemented to increase order and delivery efficiency with the available mass transit option for employees reduces the parking demand that would be generated by a larger, traditional fast-food restaurant. As such, 5 parking spaces is sufficient to meet the parking demand for this new take-out only fast-food model and the variance request will maintain the intent and purpose of the Code.

b) That the requested Variance is otherwise compatible with the surrounding land uses and would not be detrimental to the community; and

The requested variance is compatible with the surrounding land uses and will not be detrimental to the community. The Property is an outparcel located within an existing shopping center on the State Rd. 7 corridor. The adjacent properties to the north, south and west are all located within the same zoning designation as the Property, C-MU. Furthermore, the Property is surrounded by existing similar commercial uses that are compatible with the proposed take out only restaurant use.

Given the aforementioned improvements, the variance request is compatible with the surrounding land uses and will not be detrimental to the community.

c) That the requested Variance is consistent with and in furtherance of the Goals, Objectives and Policies of the adopted Comprehensive Plan, as amended from time to time, the applicable Neighborhood Plan and all other similar plans adopted by the city; and

The requested variance will facilitate the redevelopment of the Property as a take-out only restaurant. This use is consistent with the permitted uses for the TOC future land use designation listed on page LU-63 of the City's Future Land Use Element. Furthermore, the request is consistent with the following goals, objectives and policies of the City's Comprehensive Plan and the City Wide Master Plan (CWMP):

Goal I: Promote a distribution of land uses that will enhance and improve the residential, business, resort, and natural communities while allowing land owners to maximize the use of their property.

The granting of the variance will facilitate the redevelopment of an abandoned car wash facility with an active restaurant use that will serve the existing residents and employees of the surrounding community and allow the property owner to maximize the use of the Property.

Policy 10.5: Encourage expansion of businesses and public improvements that are "family oriented" and targeted to local residents and workers.

The granting of the variance will facilitate the redevelopment of an underutilized property with a family oriented take-out restaurant. Taco Bell is a popular fast food option for all demographics, including families. Furthermore, the development of the Taco Bell restaurant will bring jobs to the local community, providing employment opportunities for residents.

CWMP Policy 4.2: Concentrate retail commercial activities in defined development centers to build critical commercial mass at appropriate locations that are compatible with neighborhoods and with beach redevelopment objectives.

The granting of the variance will facilitate the redevelopment of an underutilized property along the State Rd. 7 corridor with an active commercial use. The State Rd. 7 corridor is a major commercial corridor that runs throughout several municipalities. This corridor is intended to be developed with commercial uses, including restaurants, making this use compatible with the surrounding community.

d) That the need for the requested Variance is not economically based or self-imposed; or

The requested variance is not economically based or self-imposed. The Applicant has designed a building that will provide the most efficient traffic flow on the Property and meets all the dimensional and design guideline requirements of the C-MU district other than the requested variances. This variance is needed due to the small size of the parcel and

the inability to provide the required parking spaces while still meeting other code requirements for the drive-through lane stacking and landscaping.

e) That the variance is necessary to comply with State or Federal Law and is the minimum Variance necessary to comply with the applicable law.

The variance requested is the minimum variance necessary to develop the Project. As previously stated, the Applicant has worked diligently to design a building and site that will optimize the traffic flow and circulation while meeting all the dimensional standards and design guidelines within the C-MU district. Adding additional parking spaces would require reducing drive aisle widths and the vehicle stacking for the drive-through facility, having a negative impact on the traffic circulation throughout the site.



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Taco Bell Window Transparency Variance Request Justification

Taco Bell of America, LLC ("Applicant") is the developer of a +/- .31 acre parcel of land located at 2640 N. State Rd. 7 in the City of Hollywood ("Property"). The Property is identified as folio number 514101120010 on the Broward County Property Appraiser's website. The Property has a zoning designation of C-MU (Central Mixed-Use District) and a future land use designation of TOC (Transit Oriented Corridor).

Currently, the Property contains an abandoned car wash facility. The Applicant is proposing to demolish the car wash facility and develop the Property with a +/- 1,600 square foot drive-thru and take-out only Taco Bell restaurant with no indoor or outdoor customer seating ("Project"). The restaurant will provide drive-thru and walk up orders only. At this time, the Applicant is requesting site plan approval and the following 4 variance requests to develop the Project: 1.) from Section 7.2(A)(28) to allow the Project to be developed with 5 parking spaces rather than 10 spaces as required by Code; 2.) from Section 4.6(D)(12)(d(ii) to allow an active use liner on the ground floor along the State Rd. 7 building façade (east façade) of 51.51% rather than 60% as required by Code; 3.) from Section 4.6(D)(11)(c) to allow a window transparency on the ground floor along the State Rd. 7 building façade (east façade) of 27.9% rather than 50% as required by Code; and 4.) from Section 9.5(C)(1) to allow 15.28% of vehicular use landscape area rather than a minimum of 25% as required by Code.

Variance Request

The Applicant has made every effort to comply with all code requirements for the Project, with all Code requirements being met other than these 4 variance requests. At this time, the Applicant is requesting a variance to allow a window transparency that is less than 50% along the east building façade. In accordance with Section 5.3(F)(1), applicants must demonstrate compliance with the following criteria to receive variance approval:

a) That the requested Variance maintains the basic intent and purpose of the subject regulations, particularly as it affects the stability and appearance of the city; and

The requested variance to reduce the window transparency along the east building façade will maintain the basic intent and purpose of the zoning regulations and will not negatively impact the appearance of the City. Currently the Property contains an abandoned car wash facility. This request will redevelop the Property with a use that will serve the surrounding community and improve the appearance of the City by removing an unutilized building.

The intent of the requirements to provide a minimum 50% window transparency is to provide buildings along the State Rd. 7 corridor that are pedestrian friendly and have active

uses on the ground floor. The proposed plans will meet this requirement with 27.9% window transparency along the State Rd. 7 corridor. The front portion of the east building façade (along State Rd. 7), near the building entrance will consist of all glass windows along the ground floor. While the back portion of this façade will not contain any transparent windows, it will be covered with faux glass and artistic murals to enhance the building aesthetics. When including the percentage of faux glass, the project is providing a total of 60% window area.

Given the aforementioned improvements, the variance request will maintain the intent and purpose of the Code and improve the appearance of the City.

b) That the requested Variance is otherwise compatible with the surrounding land uses and would not be detrimental to the community; and

The requested variance is compatible with the surrounding land uses and will not be detrimental to the community. The Property is an outparcel located within an existing shopping center on the State Rd. 7 corridor. The adjacent properties to the north, south and west are all located within the same zoning designation as the Property, C-MU. Furthermore, the Property is surrounded by existing similar commercial uses that are compatible with the proposed take out only restaurant use.

Given the aforementioned improvements, the variance request is compatible with the surrounding land uses and will not be detrimental to the community.

c) That the requested Variance is consistent with and in furtherance of the Goals, Objectives and Policies of the adopted Comprehensive Plan, as amended from time to time, the applicable Neighborhood Plan and all other similar plans adopted by the city; and

The requested variance will facilitate the redevelopment of the Property as a take-out only restaurant. This use is consistent with the permitted uses for the TOC future land use designation listed on page LU-63 of the City's Future Land Use Element. Furthermore, the request is consistent with the following goals, objectives and policies of the City's Comprehensive Plan and the City Wide Master Plan (CWMP):

Goal I: Promote a distribution of land uses that will enhance and improve the residential, business, resort, and natural communities while allowing land owners to maximize the use of their property.

The granting of the variance will facilitate the redevelopment of an abandoned car wash facility with an active restaurant use that will serve the existing residents end employees of the surrounding community and allow the property owner to maximize the use of the Property.

Policy 10.5: Encourage expansion of businesses and public improvements that are "family oriented" and targeted to local residents and workers.

The granting of the variance will facilitate the redevelopment of an underutilized property with a family oriented take-out restaurant. Taco Bell is a popular fast food option for all demographics, including families. Furthermore, the development of the Taco Bell restaurant will bring jobs to the local community, providing employment opportunities for residents.

CWMP Policy 4.2: Concentrate retail commercial activities in defined development centers to build critical commercial mass at appropriate locations that are compatible with neighborhoods and with beach redevelopment objectives.

The granting of the variance will facilitate the redevelopment of an underutilized property along the State Rd. 7 corridor with an active commercial use. The State Rd. 7 corridor is a major commercial corridor that runs throughout several municipalities. This corridor is intended to be developed with commercial uses, including restaurants, making this use compatible with the surrounding community.

d) That the need for the requested Variance is not economically based or self-imposed; or

The requested variance is not economically based or self-imposed. The Applicant has designed a building that will provide the most efficient traffic flow on the Property and meets all the dimensional and design guideline requirements of the C-MU district other than the requested variance. The variance is needed due to the nature of the take-out only business operation with no on-site dining. As the majority of the building contains back of house kitchen and storage operations, placing windows along the majority of the east building façade is not feasible. However, the Applicant has mitigated the lack of windows by placing faux windows artistic murals along the State Rd. 7 façade that will enhance and beatify the façade.

e) That the variance is necessary to comply with State or Federal Law and is the minimum Variance necessary to comply with the applicable law.

The variance requested is the minimum variance necessary to develop the Project. As previously stated, the Applicant has worked diligently to design a building and site that will optimize the traffic flow and circulation while meeting all the dimensional standards and design guidelines within the C-MU district. Providing the required 50% window transparency along the State Rd. 7 façade is not feasible due to the take-out only business operations and the majority of the building being used for back of house kitchen and storage operations.

Given the aforementioned setbacks, the variance requested is the minimum variances necessary to develop the Project.



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Taco Bell Landscape Variance Request Justification

Taco Bell of America, LLC ("Applicant") is the developer of a +/- .31 acre parcel of land located at 2640 N. State Rd. 7 in the City of Hollywood ("Property"). The Property is identified as folio number 514101120010 on the Broward County Property Appraiser's website. The Property has a zoning designation of C-MU (Central Mixed-Use District) and a future land use designation of TOC (Transit Oriented Corridor).

Currently, the Property contains an abandoned car wash facility. The Applicant is proposing to demolish the car wash facility and develop the Property with a +/- 1,600 square foot drive-thru and take-out only Taco Bell restaurant with no indoor or outdoor customer seating ("Project"). The restaurant will provide drive-thru and walk up orders only. At this time, the Applicant is requesting site plan approval and the following 4 variance requests to develop the Project: 1.) from Section 7.2(A)(28) to allow the Project to be developed with 5 parking spaces rather than 10 spaces as required by Code; 2.) from Section 4.6(D)(12)(d(ii) to allow an active use liner on the ground floor along the State Rd. 7 building façade (east façade) of 51.51% rather than 60% as required by Code; 3.) from Section 4.6(D)(11)(c) to allow a window transparency on the ground floor along the State Rd. 7 building façade (east façade) of 27.9% rather than 50% as required by Code; and 4.) from Section 9.5(C)(1) to allow 15.28% of vehicular use landscape area rather than a minimum of 25% as required by Code.

Variance Request

The Applicant has made every effort to comply with all code requirements for the Project, with all Code requirements being met other than these 4 variance requests. At this time, the Applicant is requesting a variance to allow 15.28% vehicular use landscape area. In accordance with Section 5.3(F)(1), applicants must demonstrate compliance with the following criteria to receive variance approval:

a) That the requested Variance maintains the basic intent and purpose of the subject regulations, particularly as it affects the stability and appearance of the city; and

The requested variance to reduce the vehicular use landscape area will maintain the basic intent and purpose of the zoning regulations and will not negatively impact the appearance of the City. Currently the Property contains an abandoned car wash facility. This request will redevelop the Property with a use that will serve the surrounding community and improve the appearance of the City by removing an unutilized building.

The intent of the requirement to provide a minimum 25% landscape area within the vehicular use area is to provide sufficient landscaping in the parking lot. The 5 parking

spaces provided on site are terminal landscape islands on either end with curbing and landscaping running along the front of all the spaces. Additionally, the required 5' landscape buffers have been provided adjacent to the parking lot to the north and west.

Given the aforementioned improvements, the variance request will maintain the intent and purpose of the Code and improve the appearance of the City.

b) That the requested Variance is otherwise compatible with the surrounding land uses and would not be detrimental to the community; and

The requested variance is compatible with the surrounding land uses and will not be detrimental to the community. The Property is an outparcel located within an existing shopping center on the State Rd. 7 corridor. The adjacent properties to the north, south and west are all located within the same zoning designation as the Property, C-MU. Furthermore, the Property is surrounded by existing similar commercial uses that are compatible with the proposed take out only restaurant use.

Given the aforementioned improvements, the variance request is compatible with the surrounding land uses and will not be detrimental to the community.

c) That the requested Variance is consistent with and in furtherance of the Goals, Objectives and Policies of the adopted Comprehensive Plan, as amended from time to time, the applicable Neighborhood Plan and all other similar plans adopted by the city; and

The requested variance will facilitate the redevelopment of the Property as a take-out only restaurant. This use is consistent with the permitted uses for the TOC future land use designation listed on page LU-63 of the City's Future Land Use Element. Furthermore, the request is consistent with the following goals, objectives and policies of the City's Comprehensive Plan and the City Wide Master Plan (CWMP):

Goal I: Promote a distribution of land uses that will enhance and improve the residential, business, resort, and natural communities while allowing land owners to maximize the use of their property.

The granting of the variance will facilitate the redevelopment of an abandoned car wash facility with an active restaurant use that will serve the existing residents end employees of the surrounding community and allow the property owner to maximize the use of the Property.

Policy 10.5: Encourage expansion of businesses and public improvements that are "family oriented" and targeted to local residents and workers.

The granting of the variance will facilitate the redevelopment of an underutilized property with a family oriented take-out restaurant. Taco Bell is a popular fast food option for all demographics, including families. Furthermore, the development of the Taco Bell

restaurant will bring jobs to the local community, providing employment opportunities for residents.

CWMP Policy 4.2: Concentrate retail commercial activities in defined development centers to build critical commercial mass at appropriate locations that are compatible with neighborhoods and with beach redevelopment objectives.

The granting of the variance will facilitate the redevelopment of an underutilized property along the State Rd. 7 corridor with an active commercial use. The State Rd. 7 corridor is a major commercial corridor that runs throughout several municipalities. This corridor is intended to be developed with commercial uses, including restaurants, making this use compatible with the surrounding community.

d) That the need for the requested Variance is not economically based or self-imposed; or

The requested variance is not economically based or self-imposed. The Applicant has designed a building that will provide the most efficient traffic flow on the Property and meets all the dimensional and design guideline requirements of the C-MU district other than the requested variance. The variance is needed due to the small parcel size. Adding additional landscaping in the vehicular use are would require removing parking spaces or stacking area for the drive-thru lane.

e) That the variance is necessary to comply with State or Federal Law and is the minimum Variance necessary to comply with the applicable law.

The variance requested is the minimum variance necessary to develop the Project. As previously stated, the Applicant has worked diligently to design a building and site that will optimize the traffic flow and circulation while meeting all the dimensional standards and design guidelines within the C-MU district. Adding additional landscaping within the vehicular use area would require reducing drive aisle widths, parking spaces, or the vehicle stacking for the drive-thru, having a negative impact on the traffic circulation throughout the site.

Given the aforementioned setbacks, the variance requested is the minimum variance necessary to develop the Project.



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Taco Bell Design Criteria Responses

Per Section 5.3.H.4 of the City Code, the Applicant must demonstrate compliance with the following design criteria:

- 4. *Design criteria*. The Board and the Director shall review plans based upon the criteria below. If the Board or the Director (as applicable) determines that an application is not consistent with the criteria, reasons shall be set forth in writing substantiating the finding.
- a. *General criteria*. All plans/architectural drawings shall be reviewed based upon the evaluation of compatibility with the City's Design Guidelines, including the following elements:
- (1) Architectural and design components. Architecture refers to the architectural elements of exterior building surfaces. Architectural details should be commensurate with the building mass. Design of the building(s) shall consider aesthetics and functionality, including the relationship of the pedestrian with the built environment. The design should consider architectural elements that are characteristic of the surrounding neighborhood.

The design of this Taco Bell is intended to aesthetically enhance the surrounding environment and provide a pedestrian friendly development. Traditional materials are incorporated into the building design but with a modern aesthetic feel. This is a redevelopment that will remove an existing carwash no longer in operation. The Taco Bell is a significant improvement that is more in line with the city vision for the future of this area.

(2) Compatibility. The harmonious relationship between existing architectural language and composition and proposed construction, including how each building along the street relates to the whole and the pattern created with adjacent structures and the surrounding neighborhood, and with the established and adopted vision for the area.

The proposed Taco Bell modern design aesthetically enhances the neighboring environment setting. Placing the building close to the road and parking behind the building provides and example for future similar development in the area. The architectural design provides a fresh new look by incorporating different material.

(3) Scale/massing. Buildings shall be proportionate in scale, with a height which is consistent with the surrounding structures, and with the established and adopted vision of the area. Building geometries shall reflect a simple composition of basic architectural details in relation to its length, width, height lot coverage, and setting of the structure in context with adjacent buildings.

The proposed development is similar in scale and mass to the surrounding environment. The small scale of the restaurant provides inset into the building mass to help break up the larger mass and make it more appropriate for the surrounding environment. The small size of parcel limits the scale and size of the building but the placement of the building close tot the road enhances the visibility and also helps hide the vehicular area.

(4) Landscaping. Landscaped areas should contain a variety of native and other compatible plant types and forms, and be carefully integrated with existing buildings and paved areas. Existing mature trees and other significant plants on the site should be preserved.

The proposed landscaping contains a variety of native and compatible plant types and forms, again enhancing the architecture, pedestrian access ways and most importantly the overall environment.



November 5, 2024

Amanda Martinez, Land Planner Miskel Backman, LLP 14 Southeast 4 Street, Suite 36 Boca Raton, Florida 33432 Via Email Only

Dear Ms. Martinez:

Re: Platting requirements for a parcel legally described as Parcel A, "Gator 441 Subdivision," according to the Plat thereof, as recorded in Plat Book 151, Page 8, of the Public Records of Broward County, Florida. This parcel is generally located on the west side of State Road 7/U.S. 441, between Cedar Lane and Sheridan Street, in the City of Hollywood.

This letter is in response to your request regarding the Broward County Land Use Plan's platting requirements for a proposed non-residential development on the above referenced parcel.

Planning Council staff has determined that replatting **would not be required** by Policy 2.13.1 of the Broward County Land Use Plan (BCLUP). Policy 2.13.1 would not require replatting of parcels included in plats approved by the Broward County Commission and recorded after June 4, 1953. Information from the Broward County Records, Taxes and Treasury Division indicates that the above referenced plat was recorded on March 10, 1992. Land platted after June 4, 1953, may be divided by metes and bounds and developed in accordance with local regulations and the effective land use plan, unless local regulations are more restrictive and would require platting. The City of Hollywood's platting requirements should be investigated.

According to Article 4.5(A)(2) of the *Administrative Rules Document: BrowardNext*, compliance with the Broward County Trafficways Plan is required for all proposed development, but parcels that have been platted subsequent to June 4, 1953, are excepted and are subject to BCLUP Policy 2.17.6, which states:

In order to protect the transportation corridors identified on the Broward County Trafficways Plan, local governments shall require that development is set back from identified rights-of-way when issuing development orders while providing an administrative relief process to ensure such set back does not deny all beneficial use of the property proposed for development.

It is recommended that you contact Broward County's Urban Planning Division at 954-357-6666, to inquire about whether additional County review, such as a plat note modification, may be required.

Amanda Martinez November 5, 2024 Page Two

The contents of this letter are not a judgment as to whether this development proposal complies with State or local vehicular access provisions, the Broward County Trafficways Plan, permitted uses and densities, local zoning, the land development regulations of the municipality or the development review requirements of the BCLUP, including concurrency requirements.

If you have any additional questions concerning the BCLUP's platting requirements, please contact Alicia Joseph at your convenience.

Respectfully,

Barbara Blake Boy Executive Director

BBB:ACJ

cc: George R. Keller, Jr., CPPT, City Manager

City of Hollywood

Andria Wingett, Director, Development Services

City of Hollywood

