

PLANNING DIVISION



File No. (internal use only):_

2600 Hollywood Boulevard Room 315 Hollywood, FL 33022

GENERAL APPLICATION



Tel: (954) 921-3471 Fax: (954) 921-3347

This application must be completed in full and submitted with all documents to be placed on a Board or Committee's agenda.

The applicant is responsible for obtaining the appropriate checklist for each type of application.

Applicant(s) or their authorized legal agent must be present at all Board or Committee meetings.

At least one set of the submitted plans for each application must be signed and sealed (i.e. Architect or Engineer).

Documents and forms can be accessed on the City's website at

http://www.hollywoodfl.org/DocumentCenter/Home/View/21



	APPLICATION TYPE (CHECK ONE):
	☐ Technical Advisory Committee ☐ Historic Preservation Board
	☐ City Commission
١	Date of Application: January 25, 2024
	Location Address: 1914-1920 Pierce Street
	Lot(s): LOT 19,20 E1/2 Block(s): BLK 20 Subdivision: HOLLYWOOD 1-21
	Folio Number(s):5142 15 01 3490
	Zoning Classification: ND2 Land Use Classification: Residential
	Existing Property Use: multi family Sq Ft/Number of Units:
	Is the request the result of a violation notice? () Yes (X) No If yes, attach a copy of violation.
	Has this property been presented to the City before? If yes, check al that apply and provide File
	Number(s) and Resolution(s): PACO & 23-DP-20 Preliminary TAC
	☐ Economic Roundtable
	☐ City Commission ☐ Planning and Development
	Explanation of Request: request for site plan approval
	Number of units/rooms: 29 Sq Ft: 32,351 sq ft
	Value of Improvement: \$6.5 MIL Estimated Date of Completion: Winter 2025
	Will Project be Phased? () Yes (XNo If Phased, Estimated Completion of Each Phase
	Name of Current Property Owner: 1920 PIERCE LLC
	Address of Property Owner: 2199 PONCE DE LEON BLVD STE 301 CORAL GABLES FL 33134
	Telephone: 786-252-9459 Fax: Email Address: alexisbogo@abhre.com
	Name of Consultant/Representative/Tenant (circle one): Alexis Bogomolni
	Address: 2980 NE 207 Street SUITE 603
	Fax: Email Address:alexisbogo@abhre.com
	Date of Purchase: 05-30-2023
	If Yes, Attach Copy of the Contract.
	List Anyone Else Who Should Receive Notice of the Hearing: Alexis Bogomolni
	alexisbogo@abhre.com (786) 252-9459
	Pamela Butler (954) 471-6177 Email Address: pbutler@mg3developer.com

PLANNING DIVISION



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GENERAL APPLICATION

CERTIFICATION OF COMPLIANCE WITH APPLICABLE REGULATIONS

The applicant/owner(s) signature certifies that he/she has been made aware of the criteria, regulations and guidelines applicable to the request. This information can be obtained in Room 315 of City Hall or on our website at www.hollywoodfl.org. The owner(s) further certifies that when required by applicable law, including but not limited to the City's Zoning and Land Development Regulations, they will post the site with a sign provided by the Office of Planning and Development Services. The owner(s) will photograph the sign the day of posting and submit photographs to the Office of Planning and Development Services as required by applicable law. Failure to post the sign will result in violation of State and Municipal Notification Requirements and Laws.

(I)(We) certify that (I) (we) understand and will comply with the provisions and regulations of the City's Zoning and Land Development Regulations, Design Guidelines, Design Guidelines for Historic Properties and City's Comprehensive Plan as they apply to this project. (I)(We) further certify that the above statements and drawings made on any paper or plans submitted herewith are true to the best of (my)(our) knowledge. (I)(We) understand that the application and attachments become part of the official public records of the City and are not returnable.

Signature of Current Owner:	Date: 01/25/2024
PRINT NAME: Alexis Bogomolni	Date: _01/25/2024
Signature of Consultant/Representative:	Date:
PRINT NAME:	Date:
Signature of Tenant:	Date:
PRINT NAME:	Date:
Current Owner Power of Attorney	
I am the current owner of the described real property and that I am aware of the results of the property and that I am aware of the results of the property, which is hereby made by alberto Llorente, architect of record to be my legal representative before the Planning & Committee) relative to all matters concerning this application.	nature and effect the request for me or I am hereby authorizing Development Board (Board and/or
Sworn to and subscribed before me this day of language, 2024 Signate	ure of Current Owner
Notary Public Notary Public State of Florida State of Florida Print N Commission # HH 276428 My Comm. Expires Jun 14, 2026 Bonded through National Notary Assn.	is Eial Bogomolni ame
My Commission Expires:(Check One) Personally known to me; OR Produce	d Identification











ALTA/NSPS LAND TITLE SURVEY

NOTES:

- NOT VALID WITHOUT THE SIGNATURE AND THE ORIGINAL RAISED SEAL OF A FLORIDA LICENSED SURVEYOR AND MAPPER.
- THIS SURVEY WAS DONE SOLELY FOR BOUNDARY PURPOSES AND DOES NOT DEPICT THE JURISDICTION OF ANY MUNICIPAL, STATE, FEDERAL OR OTHER ENTITIES.
- 3. THE LAND DESCRIPTION SHOWN HEREON WAS PROVIDED BY THE CLIENT.
- 4. UNDERGROUND IMPROVEMENTS NOT SHOWN.
- ELEVATIONS SHOWN HEREON ARE BASED ON THE NORTH AMERICAN VERTICAL DATUM OF 1988.
- BENCHMARK REFERENCE: CITY OF HOLLYWOOD BENCHMARK: SQUARE CUT AT NW CORNER OF 24TH AVENUE AND POLK STREET. ELEVATION=10.50' (NAVD88)
- 7. THIS SURVEY WAS MADE IN ACCORDANCE WITH LAWS AND/OR MINIMUM STANDARDS OF THE STATE OF FLORIDA.
- 8. THE PROPERTY DESCRIBED HEREON (THE "PROPERTY") IS THE SAME AS THE PROPERTY DESCRIBED IN OWNERSHIP AND ENCUMBRANCE REPORT SEARCH NO.: 22-991-1-UPDATE 1, CERTIFIED FROM DATE OF PLAT (MAY 14, 1925) THROUGH THE 1ST DAY OF JANUARY 2023, AT 11:00 O'CLOCK P.M. AND THAT ALL EASEMENTS, COVENANTS AND RESTRICTIONS REFERENCED IN SAID TITLE COMMITMENT OR APPARENT FROM A PHYSICAL INSPECTION OF THE PROPERTY OR OTHERWISE KNOWN TO ME HAVE BEEN PLOTTED HEREON OR OTHERWISE NOTED AS TO THEIR EFFECT ON THE PROPERTY.


ENCUMBRANCES:


ITEM 1. EASEMENTS, RESTRICTIONS, RESERVATIONS, COVENANTS AND CONDITIONS SET FORTH ON PLAT OF HOLLYWOOD, PLAT BOOK 1, PAGE 21, PUBLIC RECORDS BROWARD COUNTY, FLORIDA. (AFFECTS/PLOTTED)

ITEM 2. CLAIM OF LIENS: CITY OF HOLLYWOOD, A FLORIDA MUNICIPAL CORPORATION TO AIR ABODES LLC, DATED DECEMBER 13, 2022, FILED DECEMBER 14, 2022, UNDER INSTRUMENT NO. 118571343. (AFFECTS/NOT PLOTTABLE)

ITEM 3. CLAIM OF LIENS: CITY OF HOLLYWOOD, A FLORIDA MUNICIPAL CORPORATION TO AIR ABODES LLC, DATED DECEMBER 13, 2022, FILED DECEMBER 14, 2022, UNDER INSTRUMENT NO. 118571359. (AFFECTS/NOT PLOTTABLE)

- ALL UTILITIES SERVING THE PROPERTY ENTER THROUGH ADJOINING PUBLIC STREETS AND/OR EASEMENTS OF RECORD.
- 10. THERE ARE NO ENCROACHMENTS ONTO ADJOINING PREMISES, STREETS OR ALLEYS BY ANY BUILDINGS, STRUCTURES OR OTHER IMPROVEMENTS LOCATED ON THE PROPERTY, AND NO ENCROACHMENTS ONTO THE PROPERTY BY BUILDINGS, STRUCTURES OR OTHER IMPROVEMENTS SITUATED ON ADJOINING PREMISES.
- 11. THE PROPERTY HAS DIRECT ACCESS TO PIERCE STREET, DEDICATED PUBLIC STREETS AS SHOWN ON PLAT BOOK 1, PAGE 21, SAME BEING PAVED AND DEDICATED PUBLIC ROADWAYS MAINTAINED BY THE CITY OF HOLLYWOOD, BROWARD COUNTY, FLORIDA.
- 12. THERE ARE NO STRIPED PARKING SPACES ON THE PROPERTY.
- 13. THERE IS NO OBSERVED EVIDENCE OF CURRENT EARTH MOVING WORK, BUILDING CONSTRUCTION OR BUILDING ADDITIONS AT THE PROPERTY.
- 14. THERE IS NO PROPOSED CHANGES IN STREET RIGHT OF WAY LINES AFFECTING THE PROPERTY, ACCORDING TO BROWARD COUNTY, FLORIDA.
- 15. THERE IS NO OBSERVED EVIDENCE OF RECENT STREET OR SIDEWALK CONSTRUCTION OR REPAIRS AFFECTING THE PROPERTY.
- 16. THERE IS NO OBSERVED EVIDENCE OF USE OF THE PROPERTY AS A SOLID WASTE DUMP, SUMP OR SANITARY LANDFILL.
- 17. NO FIELD DELINEATION OF WETLANDS MARKERS WERE OBSERVED.

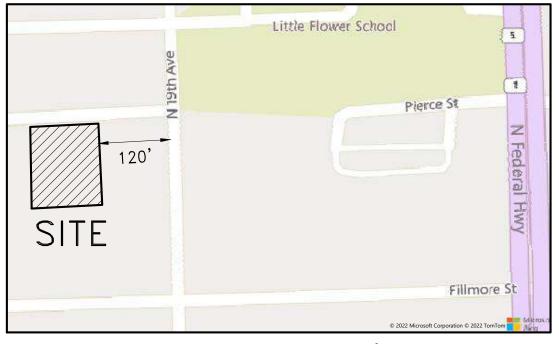

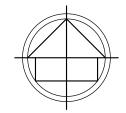

LOCATION MAP (NTS)

LEGEND:

CHECKED BY CKD CONC CONCRETE DWN DRAWN BY FB/PG FIELD BOOK AND PAGE SIR SET 5/8"IRON ROD & CAP #6448 SNC SET NAIL & CAP #6448 FIR FOUND IRON ROD FIP FOUND IRON PIPE FNC FOUND NAIL & CAP FND FOUND NAIL & DISK PRM PERMANENT REFERENCE MARKER P.B. PLAT BOOK BROWARD COUNTY RECORDS B.C.R. FPL FLORIDA POWER & LIGHT -X-CHAIN LINK FENCE -E-OVERHEAD UTILITY LINES WM WATER METER W۷ WATER VALVE SSMH SANITARY SEWER MANHOLE STORM DRAIN MANHOLE SDMH BACK FLOW PREVENTER BFP EΒ ELECTRIC BOX WPP WOOD POWER POLE MLP METAL LIGHT POLE CPP CONCRETE POWER POLE **ELEVATIONS** 0.00 UNK UNKNOWN TREE TYPE AMERICAN LAND TITLE ASSOCIATION ALTA NSPS NATIONAL SOCIETY OF PROFESSIONAL SURVEYORS

LAND DESCRIPTION:

LOTS 19, 20 AND 21, BLOCK 20 OF "HOLLYWOOD", ACCORDING TO THE MAP OR PLAT THEREOF, AS RECORDED IN PLAT BOOK 1, PAGE 21, OF THE PUBLIC RECORDS OF BROWARD COUNTY, FLORIDA.

CERTIFIED TO:

1920 PIERCE LLC, A FLORIDA LIMITED LIABILITY COMPANY ALEX D. SIRULNIK, P.A. FIDELITY NATIONAL TITLE INSURANCE COMPANY

SURVEYOR'S CERTIFICATION

THIS IS TO CERTIFY THAT THIS MAP OR PLAT AND THE SURVEY ON WHICH IT IS BASED WERE MADE IN ACCORDANCE WITH THE 2021 MINIMUM STANDARD DETAIL REQUIREMENTS FOR ALTA/NSPS LAND TITLE SURVEYS, JOINTLY ESTABLISHED AND ADOPTED BY ALTA AND NSPS, AND INCLUDES ITEMS 1, 2, 3, 4, 5, 6(A), 6(B), 7 (A), (B) AND (C), 8, 9, 13, 14, 16 17 AND 19 OF TABLE A THEREOF.

THE FIELDWORK WAS COMPLETED ON FEBRUARY 04, 2023.

RICHARD E. COUSINS

.____

RICHARD E. COUSINS
PROFESSIONAL SURVEYOR AND MAPPER
FLORIDA REGISTRATION NO. 4188

COUSINS SURVEYORS & ASSOCIATES, INC.



3921 SW 47TH AVENUE, SUITE 1011
DAVIE, FLORIDA 33314
CERTIFICATE OF AUTHORIZATION: LB # 6448
PHONE (954)689-7766 FAX (954)689-7799

PROJECT NUMBER: 9818-22

CLIENT :

MG3 GROUP


							Ξ
	REVISIONS	DATE	FB/PG	DWN	CKD	1	F
	ALTA/NSPS LAND TITLE SURVEY	06/28/22	SKETCH	АМ	REC][C
	UPDATE SURVEY	02/04/23	SKETCH	JD	REC][F
	REVISED PER O&E	04/19/23	SKETCH	АМ	REC	$\ [$	Z
						$\ $	E
l) (Ē

FLOOD ZONE INFO	ORMATION
COMMUNITY NUMBER	R 125113
PANEL NUMBER	0569H
ZONE	Х
BASE FLOOD ELEV	N/A
EFFECTIVE DATE	08/18/14

PROPERTY ADDRESS : 1914 & 1920 PIERCE STREET

SCALE: N/A

SHEET 1 OF 2

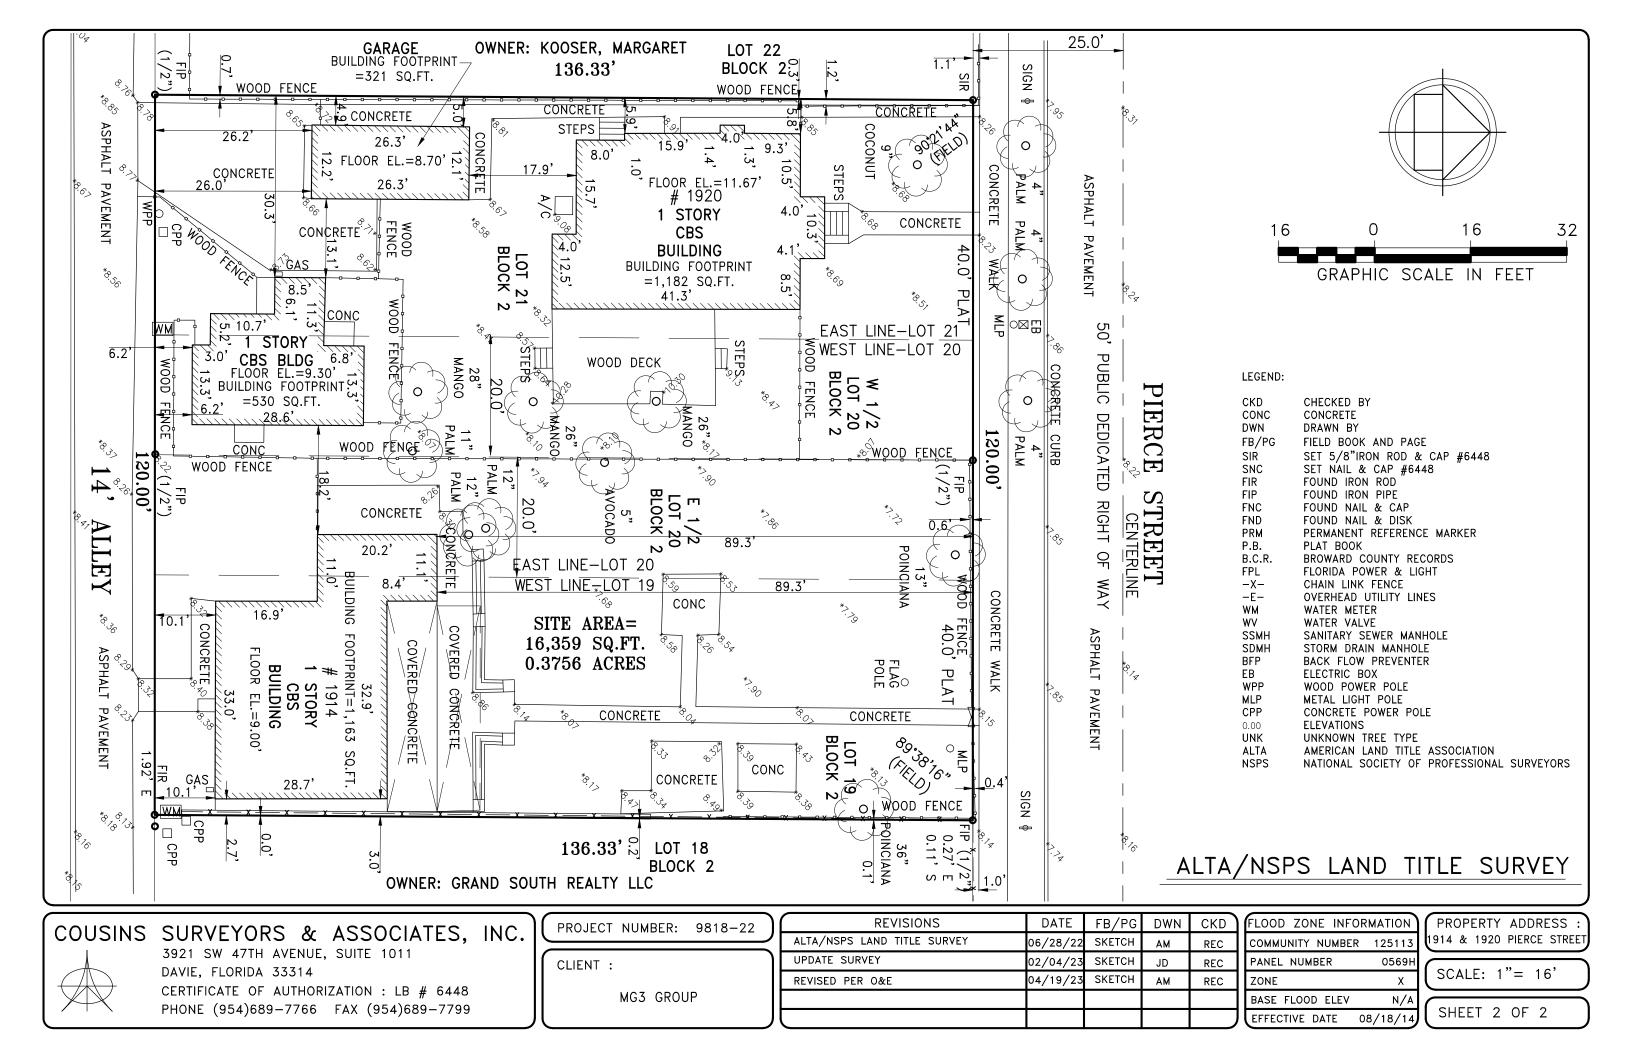


NEW 29 UNITS DEVELOPMENT AT DOWNTOWN HOLLYWOOD

1914 - 1920 PIERCE STREET HOLLYWOOD, FLORIDA 33020
(RESPONSE TO TAC SIGN OFF NO. 2 COMMENTS DATED FEBRUARY 03, 2024)



INDEX OF	INDEX OF DRAWINGS									
	ARCHIT	ECTURAL:								
REV. DATE	SHEET	<u>TITLE</u>								
2 01.11.24 2 01.11.24 2 01.11.24 2 01.11.24 2 01.11.24 2 01.11.24 2 01.11.24 2 01.11.24 2 01.11.24	A000 A100 A101 A102 A103 A104 A201 A202	COVER SHEET PROPOSED GROUND FLOOR / SITE PLAN AND NOTES FAR AND OPEN AREAS SQUARE FEET PLANS PROPOSED SECOND AND THIRD FLOOR PLANS PROPOSED FOURTH AND FIFTH FLOOR PLANS PROPOSED ROOF PLAN AND PARKLIFT DETAILS PROPOSED NORTH AND WEST EXTERIOR ELEVATIONS PROPOSED SOUTH AND EAST EXTERIOR ELEVATIONS								
	CIVIL:									
REV. DATE	SHEET	<u>TITLE</u>								
06.15.23 06.15.23 06.15.23 06.15.23 06.15.23 06.15.23 06.15.23 06.15.23 06.15.23	C-1 C-2 C-3 C-4 C-5 C-6 C-7 C-8	SITE PAVING, GRADING, AND DRAINAGE PLAN SITE PAVING, GRADING, AND DRAINAGE DETAILS WATER AND SEWER PLAN WATER AND SEWER DETAILS WATER AND SEWER DETAILS PAVEMENT MARKINGS AND SIGNAGE PLAN GENERAL NOTES STORMWATER POLLUTION PREVENTION PLANS								
	LANDSC	CAPE:								
REV. DATE	SHEET	<u>TITLE</u>								
03.28.23 03.28.23 03.28.23 03.28.23 03.28.23 03.28.23 03.28.23	TD-1 TD-2 L-1 L-2 L-3 L-4	TREE DISPOSITION PLAN TREE DISPOSITION DETAILS, SPECIFICATIONS SITE LANDSCAPE PLAN LANDSCAPE DETAILS, SPECIFICATIONS, ETC. SECOND LEVEL COURTYARD LANDSCAPE PLAN ROOF-POOL LEVEL LANDSCAPE PLAN								
03.28.23 03.28.23 03.28.23 03.28.23 03.28.23	IRR-1 IRR-2 IRR-3 IRR-4	SITE IRRIGATION PLAN IRRIGATION DETAILS, SPECIFICATIONS, ETC. SECOND LEVEL COURTYARD IRRIGATION PLAN ROOF-POOL LEVEL IRRIGATION PLAN								

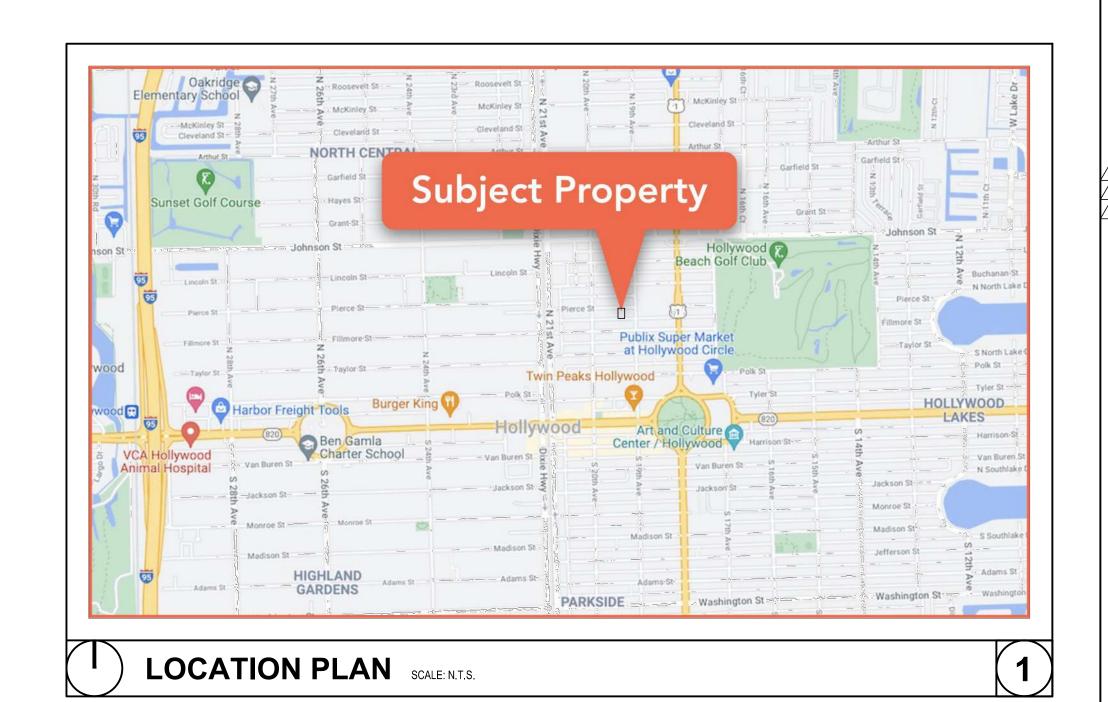

Llorente



AR-0012031




1914 - 1920 PIERCE STREET HOLLYWOOD, FL. 33020

DATE ISSUE DESCRIPTION \03.28.23 TAC COMMENTS 01.11.24 TAC COMMENTS 3 02.05.24 SIGN OFF


DRAWING INFORMATION:

CHECKED BY:

REF NUMBER:

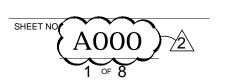

EXISTING 14' ALLEY 120.00' LINE OF BALCONY ---ABOVE.

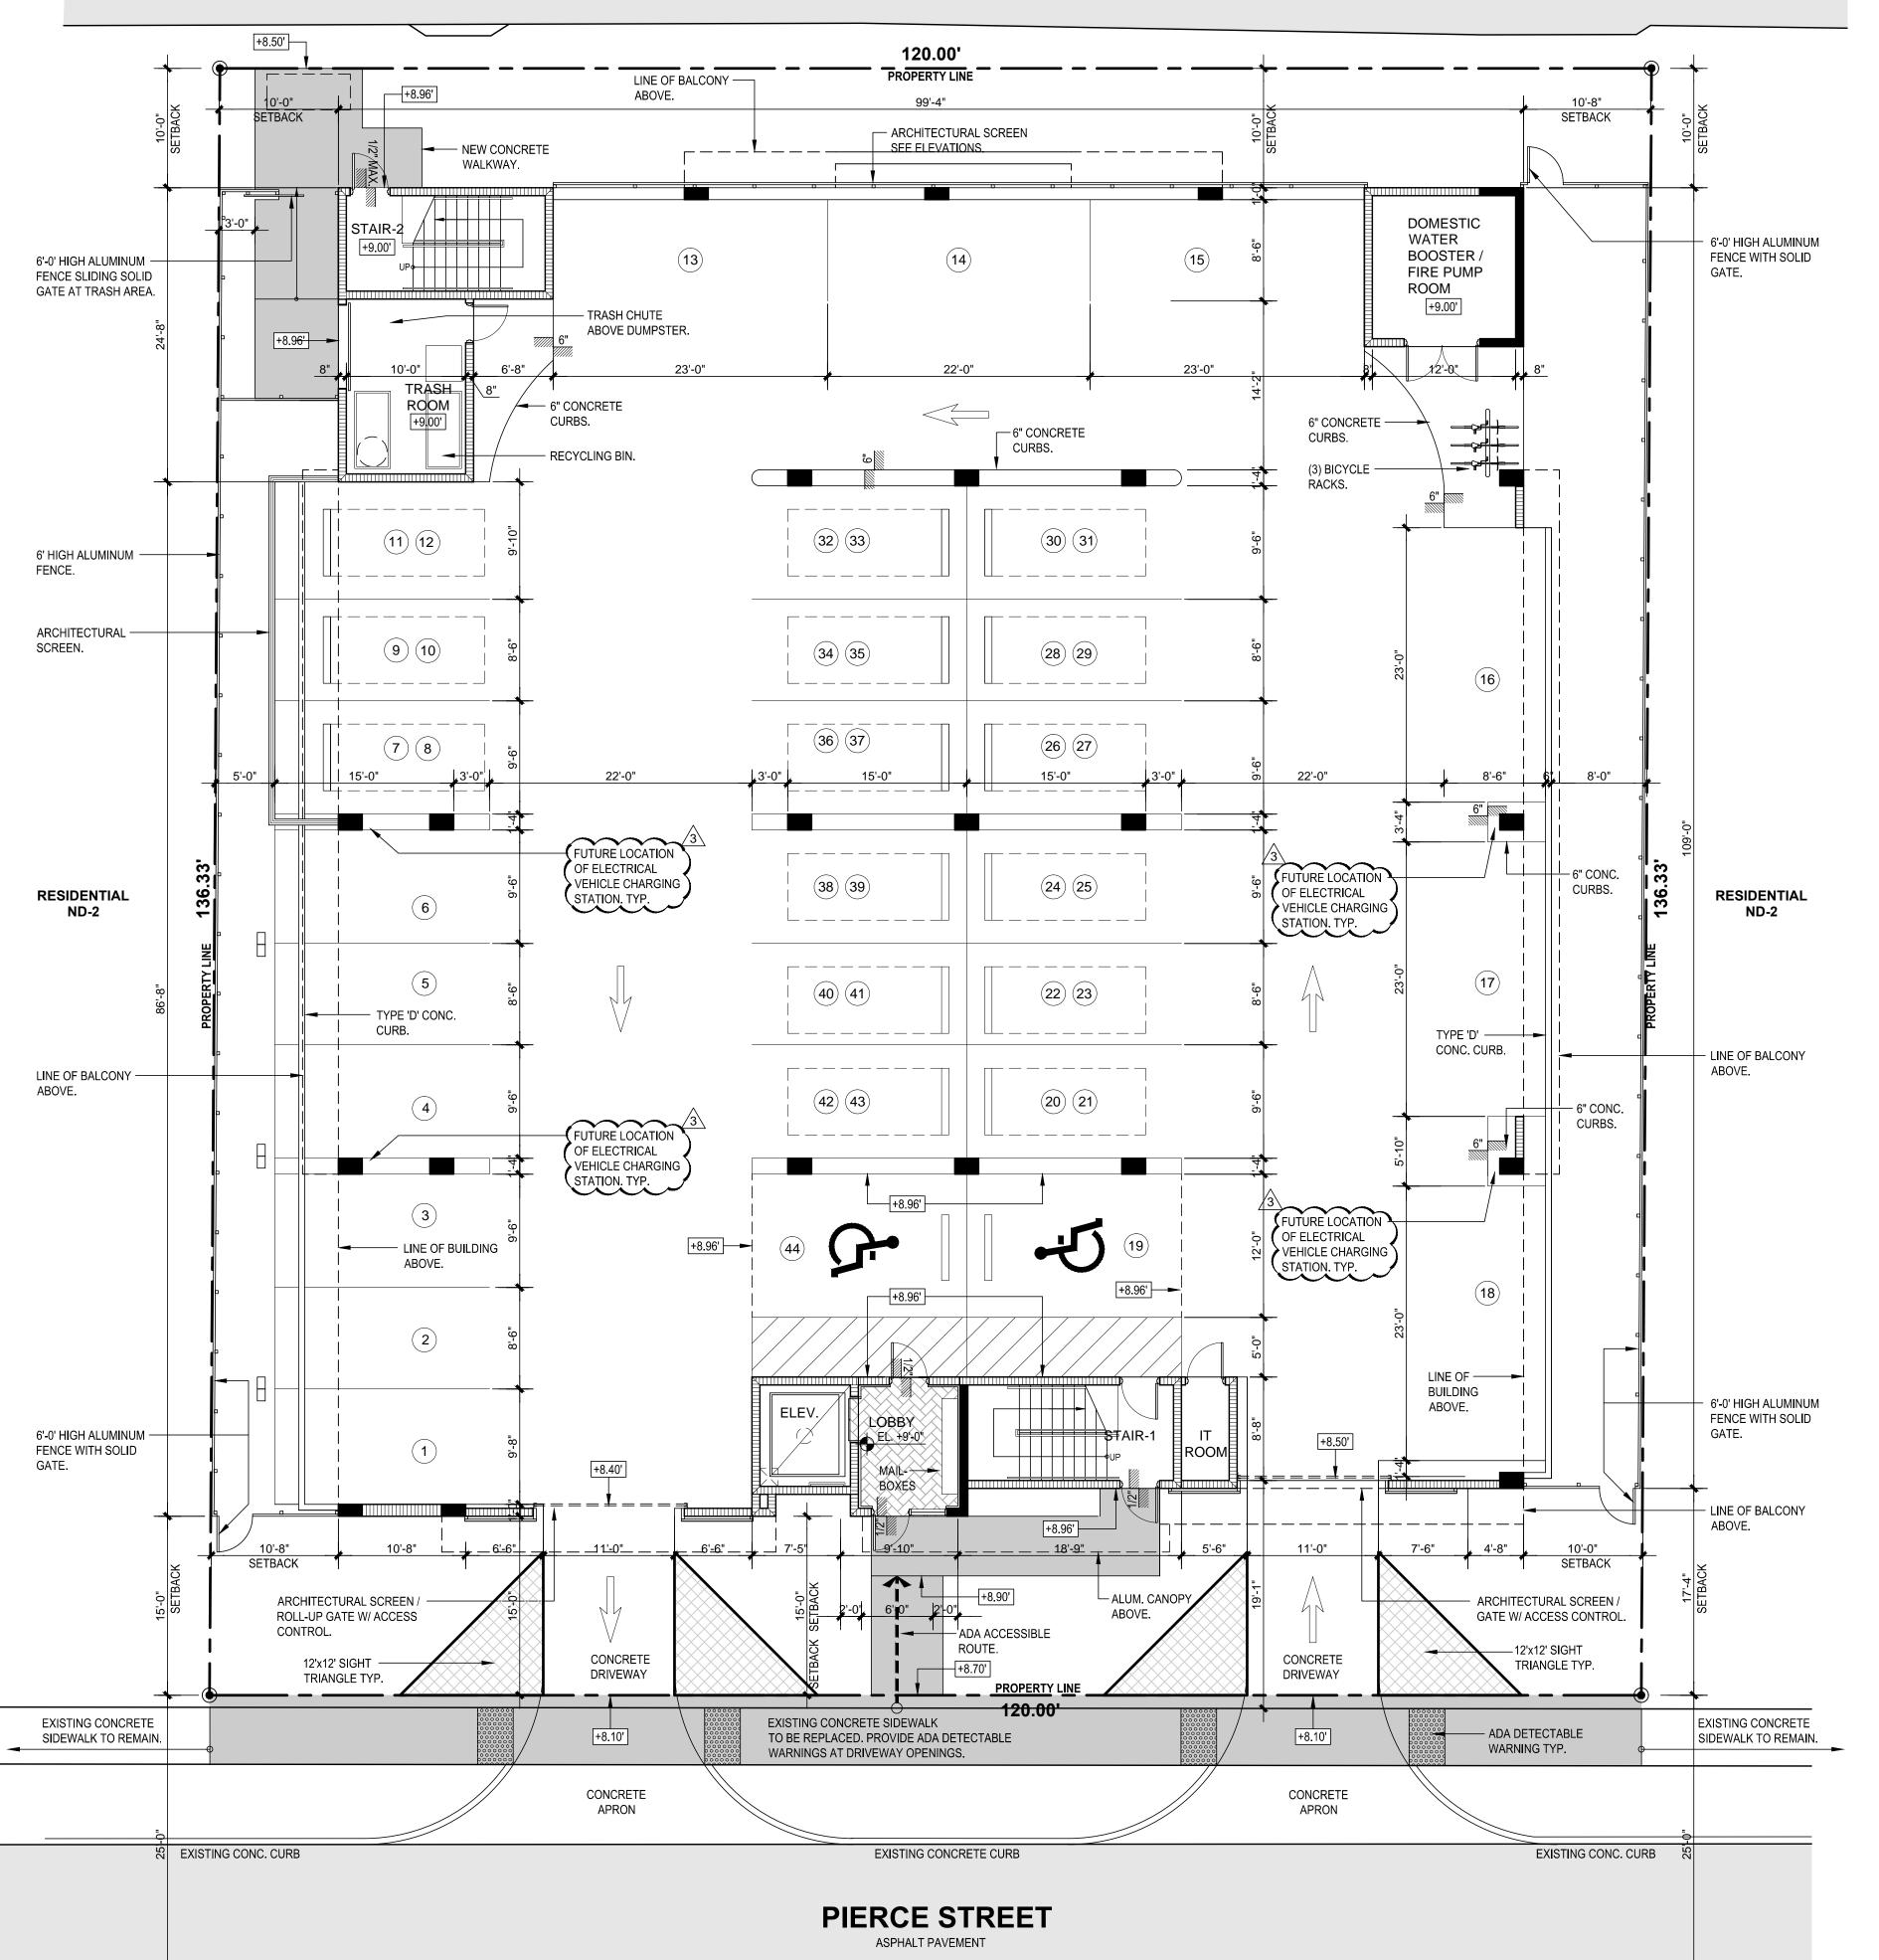

_-__-

GENERAL ZONING REQUIREMENTS BUILDING ADDRESS: ADDRESS: 1914-1920 PIERCE STREET HOLLYWOOD, FLORIDA **BUILDING ZONING:** EXISTING ZONING DESIGNATION: ND-2 LAND AREAS: LAND AREA NET SF. 16,360 SF. LAND AREA NET ACRES 0.3755 **BUILDING FAR:** ALLOWED: 2 16,360 X 2 = 32,720 SF. PROVIDED: 1.98 32,351 SF. LOT COVERAGE: PROPOSED LOT COVERAGE: 11,533 SF. / 70.49% PAVED AREA: PROPOSED PAVED AREA 688 SF. / 4.20% LANDSCAPE AREAS: PROPOSED LANDSCAPED AREA 4,136 SF. / 25.31% SETBACKS: FRONT REQUIRED: 15'-0" PROVIDED: 15'-0" REAR REQUIRED: 10'-0" PROVIDED: 10'-0" SIDES REQUIRED: 10'-0" PROVIDED: 10'-0" **BUILDING HEIGHT LIMITATIONS:** ALLOWED 5 STORIES 55'-0" PROVIDED 5 STORIES 55'-0" ROOF TOP AMENITIES PERMITTED (25% OF 55'-0') = 68'-9" POOL DECK PROVIDED 60'-0" TOP OF STAIR / ELEVATOR PROVIDED 68'-9" PARKING REQUIREMENTS FOR 29 CONDOS REQUIRED 1 PER 1 BEDROOM 14 SPACES REQUIRED (14) 1 BEDROOM REQUIRED 1.5 PER 2 BEDROOMS (12) 2 BEDROOMS **18 SPACES REQUIRED REQUIRED 1.5 PER 3 BEDROOMS** (3) 3 BEDROOMS **5 SPACES REQUIRED REQUIRED FOR GUEST 1 PER 10 UNITS** (29 UNITS / 10) 3 SPACES REQUIRED **TOTAL PARKING SPACES REQUIRED 40 SPACES REQUIRED** ADA PARKING **REQUIRED** (2 SPACES) PARKING PROVIDED FOR 29 CONDOS PROVIDED 1 PER 1 BEDROOM (14) 1 BEDROOM 14 SPACES PROVIDED PROVIDED 2 PER 2 BEDROOMS (12) 2 BEDROOMS 24 SPACES PROVIDED (DOUBLE STACK / LIFT)

(3) 3 BEDROOMS

6 SPACES PROVIDED (DOUBLE STACK / LIFT)

3 SPACES PROVIDED (IN LIEU OFF)

3 SPACES PROVIDED (IN LIEU OFF)

44 SPACES PROVIDED

NOTE

PROVIDED 2 PER 3 BEDROOMS

PROVIDED FOR GUEST 1 PER 10 UNITS

TOTAL PARKING SPACES PROVIDED

ADA PARKING **PROVIDED** (2 SPACES)

1. ANY CHANGES TO DESIGN, INCLUDING MATERIAL CHANGES, MAY REQUIRE PLANNING AND DEVELOPMENT BOARD APPROVAL PRIOR TO CONSTRUCTION.

- 2. PROVIDE 0.5 FOOT CANDLE LIGHTING.
- 3. BUILDING SHALL COMPLY WITH THE REQUIREMENT OF NFPA1 (2018 ED.) **SECTION 12.3.2**

GREEN BUILDING CERTIFICATION TO BE ACHIEVED.

- ELECTRIC VEHICLE PROVISIONS (INFRASTURE ONLY). HVAC 18 SEER OR HIGHER.
- PROGRAMMABLE THERMOSTATS OCCUPANCY / VACANCY SENSORS (NOT SURE IF THIS ONE CAN
- MERV AIR FILTERS AT LEAST 8

BE USED ONLY IN COMMON AREAS).

- ALL ENERGY-EFFICIENT OUTDOOR LIGHTING. DUAL FLUSH TOILETS (1/1.6 FLUSH)
- ENERGY STAR APPROVED ROOFING MATERIALS.
- ENERGY EFFICIENT (LOW-E) WINDOWS.
- ENERGY EFFICIENT DOORS.
- ADA NOTE: ANY LIP FROM 1/4" NOT GREATER THEN 1/2" WILL BE BEVELED TO MEET ADA REQUIREMENTS.

Llorente **Architects** 13421 SOUTHWEST 23 STREET MIAMI, FL. 33175 . (305) 525-2370 AA-26002273

IN ASSOCIATION WITH:

PROFESSIONAL SEAL:



Alberto Llorente AR-0012031

NEW 29 UNITS DOWNTOWN HOLLYWOOD

1914 - 1920 PIERCE STREET HOLLYWOOD, FL. 33020

DATE ISSUE DESCRIPTION \03.28.23 TAC COMMENTS


2\01.11.24 TAC COMMENTS 3 02.05.24 SIGN OFF

DRAWING INFORMATION: PROPOSED GROUND FLOOR /

SITE PLAN.

DELIVERY DATE: 03.28.2023

DRAWN BY: CHECKED BY REF NUMBER:

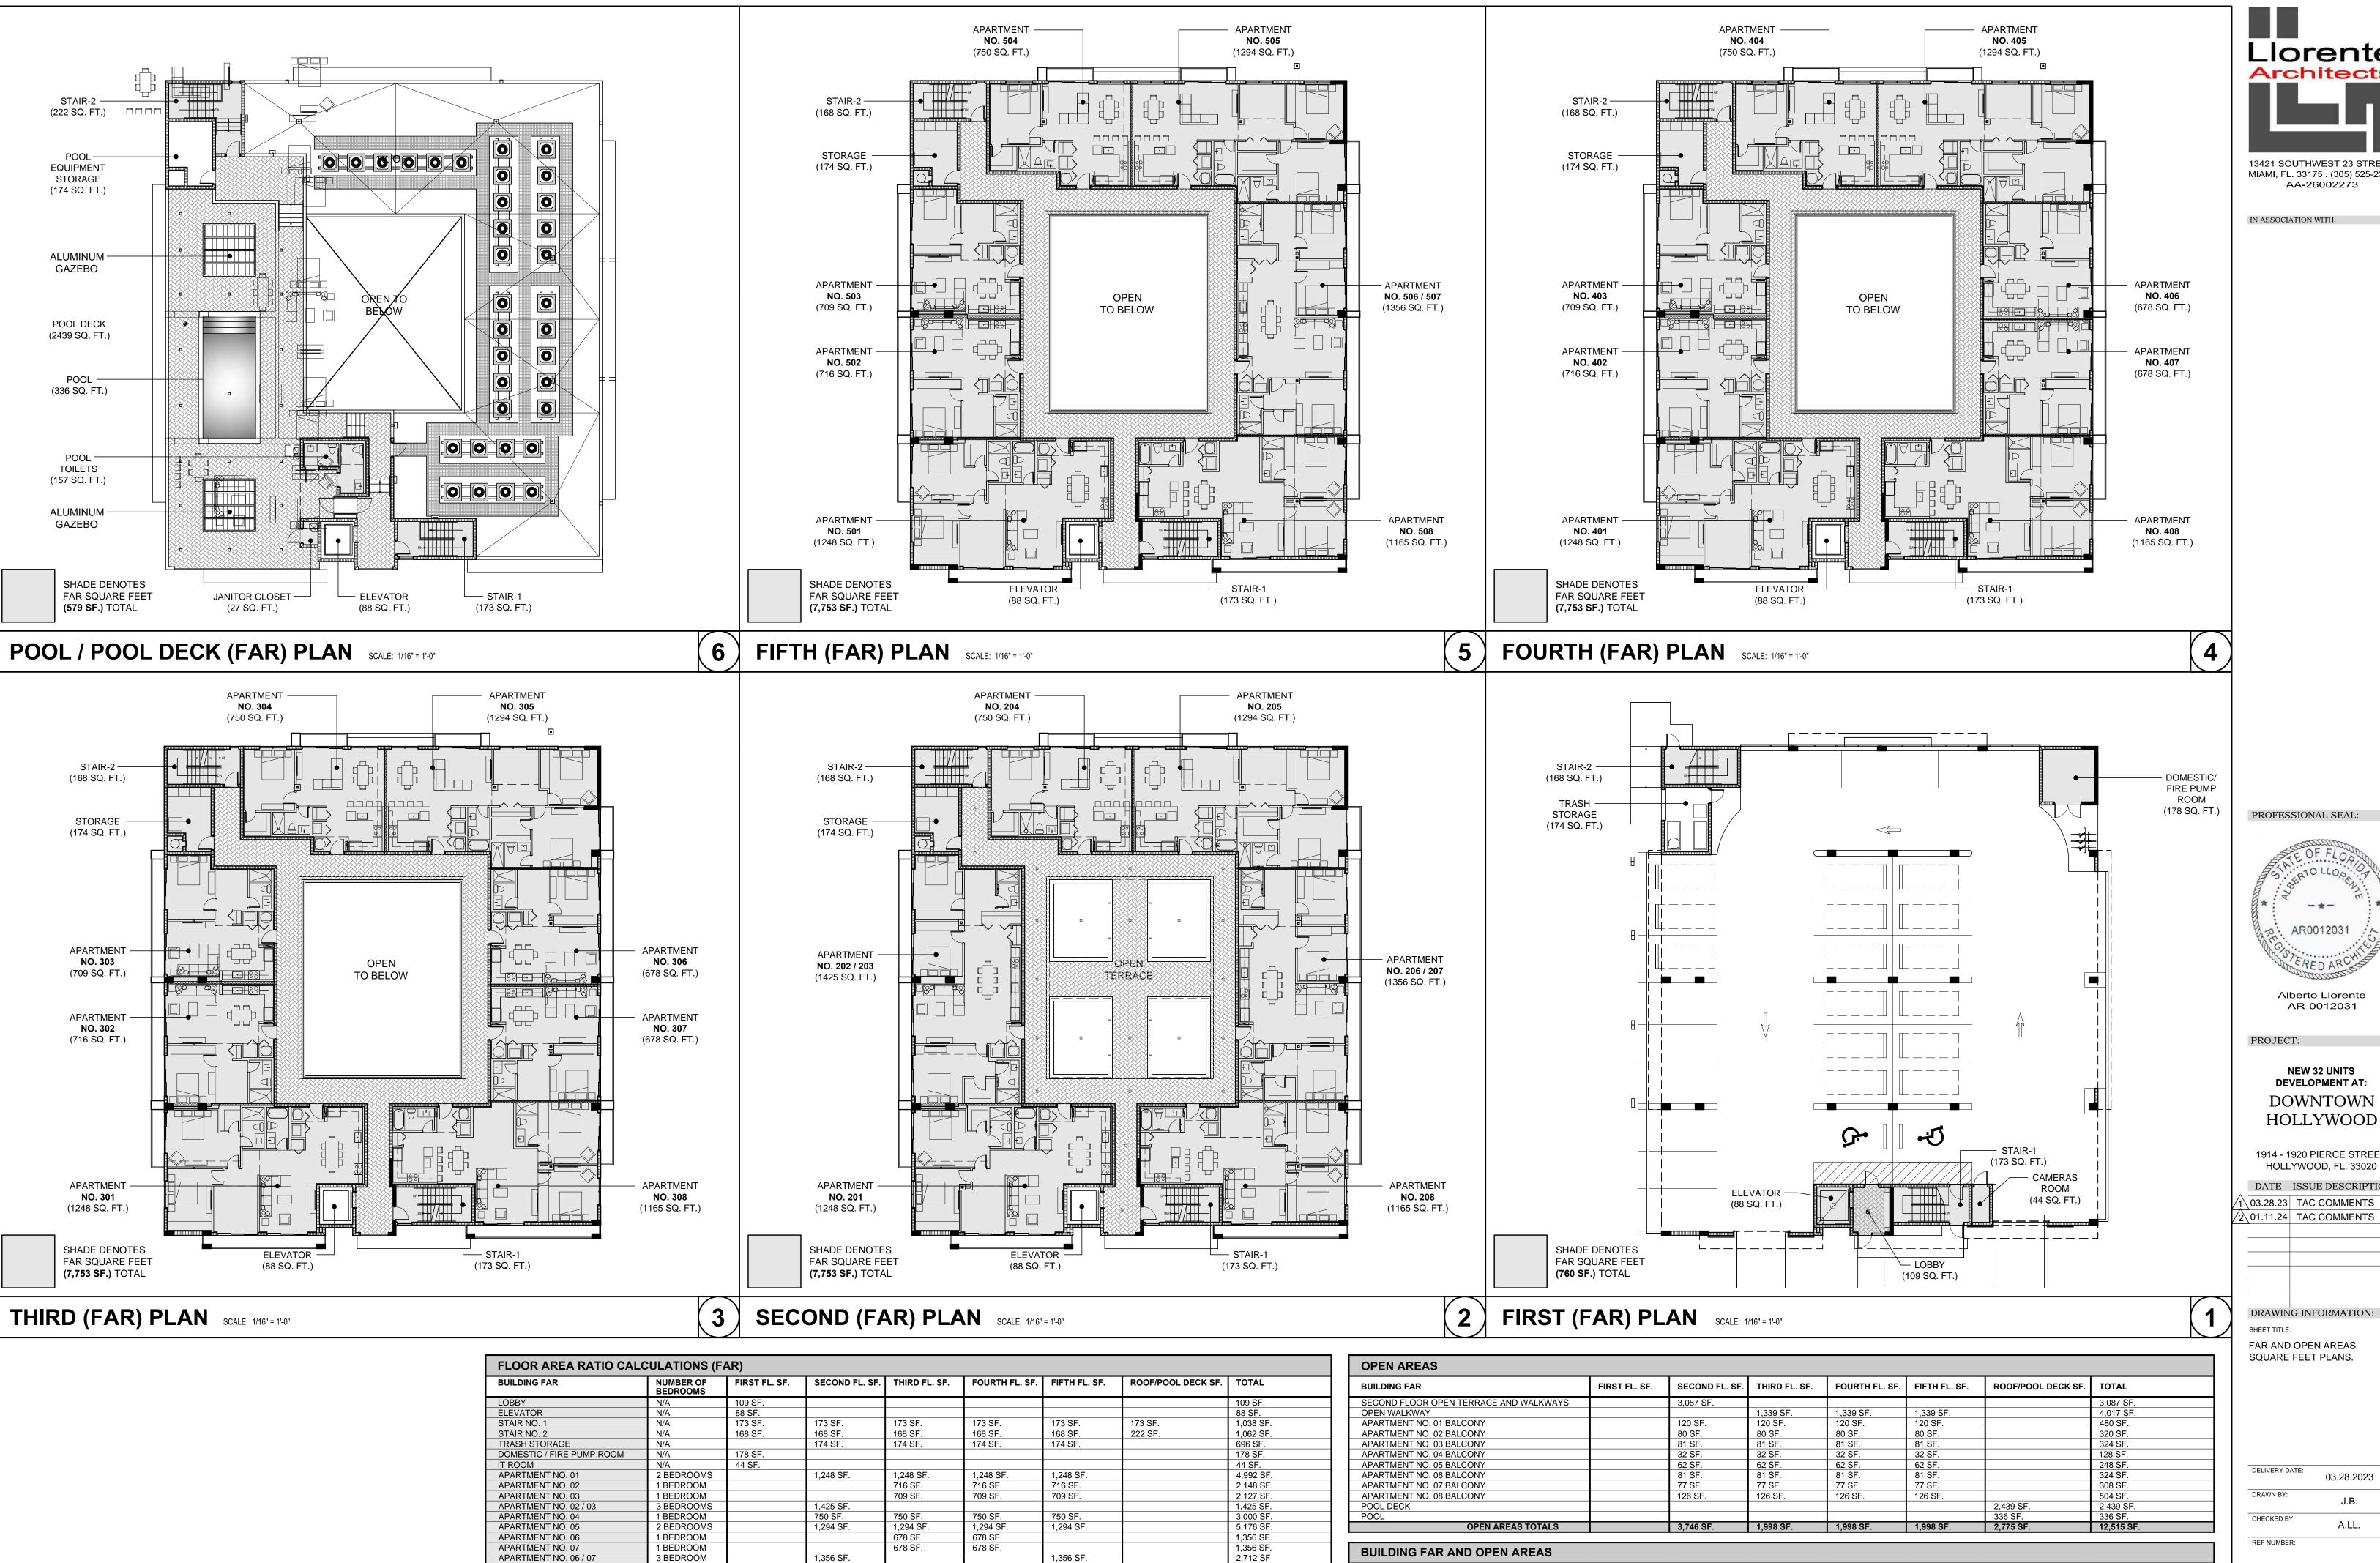

,356 SF.

,165 SF.

1,165 SF.

1,356 SF.

,165 SF.

1,165 SF.

APARTMENT NO. 06 / 0

APARTMENT NO. 08

POOL EQUIPMENT

POOL TOILETS

JANITOR CLOSET

3 BEDROOM

2 BEDROOMS

BUILDING FAR AND OPEN AREAS

7,753 SF. 3,746 SF.

1,998 SF.

FAR TOTALS OPEN AREAS TOTALS

4,660 SF.

157 SF. 27 SF.

32,351 SF.

Llorente 13421 SOUTHWEST 23 STREET MIAMI, FL. 33175 . (305) 525-2370

IN ASSOCIATION WITH:

AA-26002273

PROFESSIONAL SEAL:



Alberto Llorente AR-0012031

NEW 32 UNITS DEVELOPMENT AT: DOWNTOWN

1914 - 1920 PIERCE STREET HOLLYWOOD, FL. 33020 DATE ISSUE DESCRIPTION

DRAWING INFORMATION: FAR AND OPEN AREAS

DELIVERY DATE: 03.28.2023

(A101) 2


32,351 SF. 12,515 SF.

44,876 SF.

579 SF. 2,775 SF.

1,998 SF.

1,998 SF.

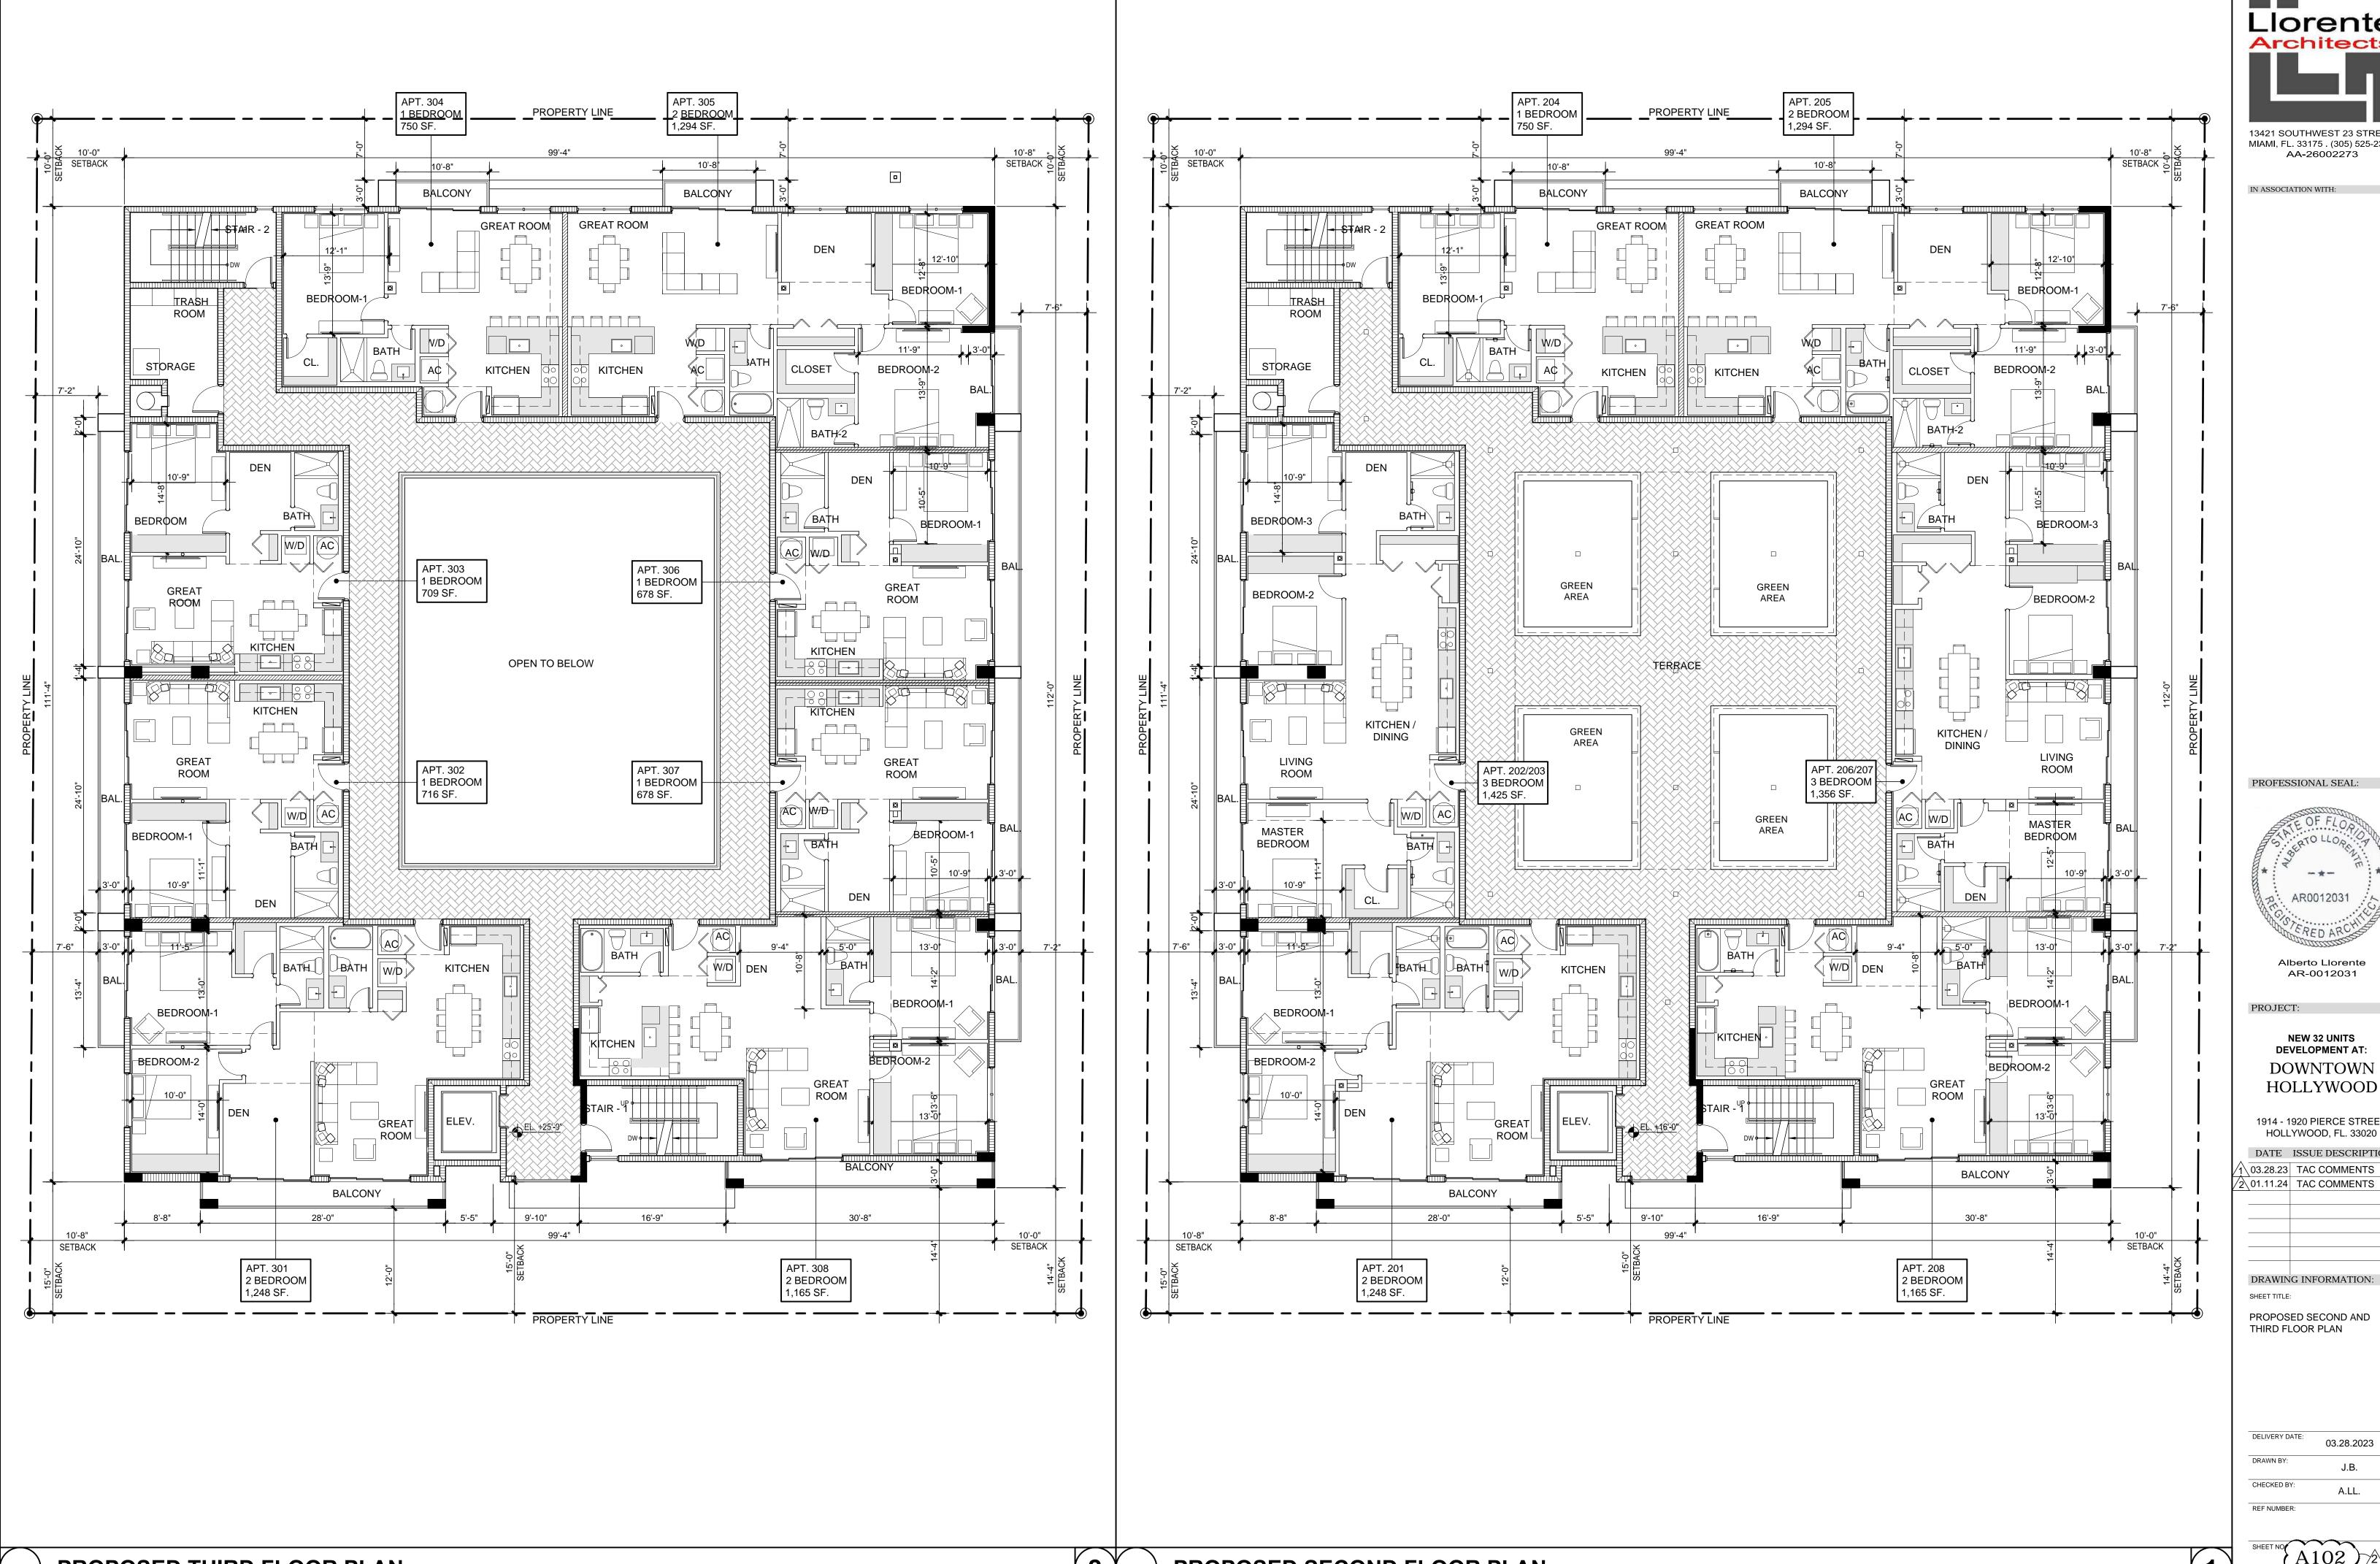

Llorente **Architects** 13421 SOUTHWEST 23 STREET MIAMI, FL. 33175 . (305) 525-2370

IN ASSOCIATION WITH:

PROFESSIONAL SEAL:



Alberto Llorente AR-0012031


NEW 32 UNITS DEVELOPMENT AT: DOWNTOWN HOLLYWOOD


1914 - 1920 PIERCE STREET HOLLYWOOD, FL. 33020 \03.28.23 TAC COMMENTS


DRAWING INFORMATION:

PROPOSED SECOND AND THIRD FLOOR PLAN

PIERCE ST.

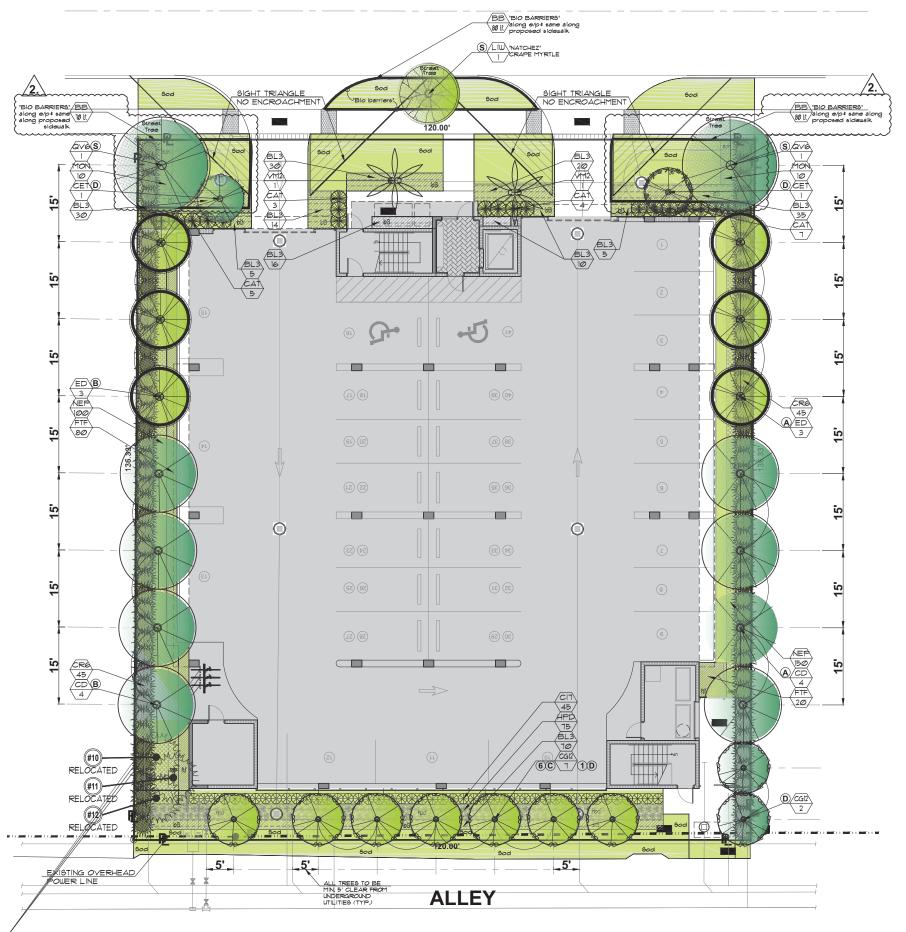

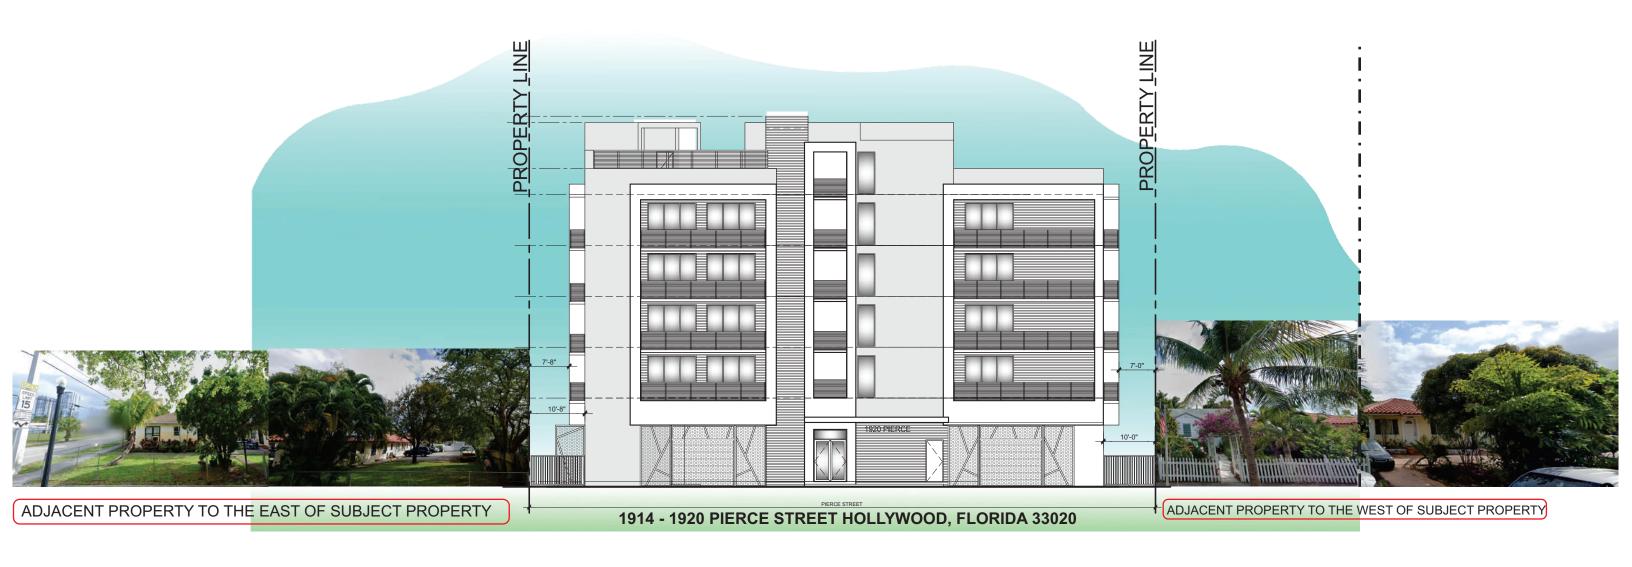

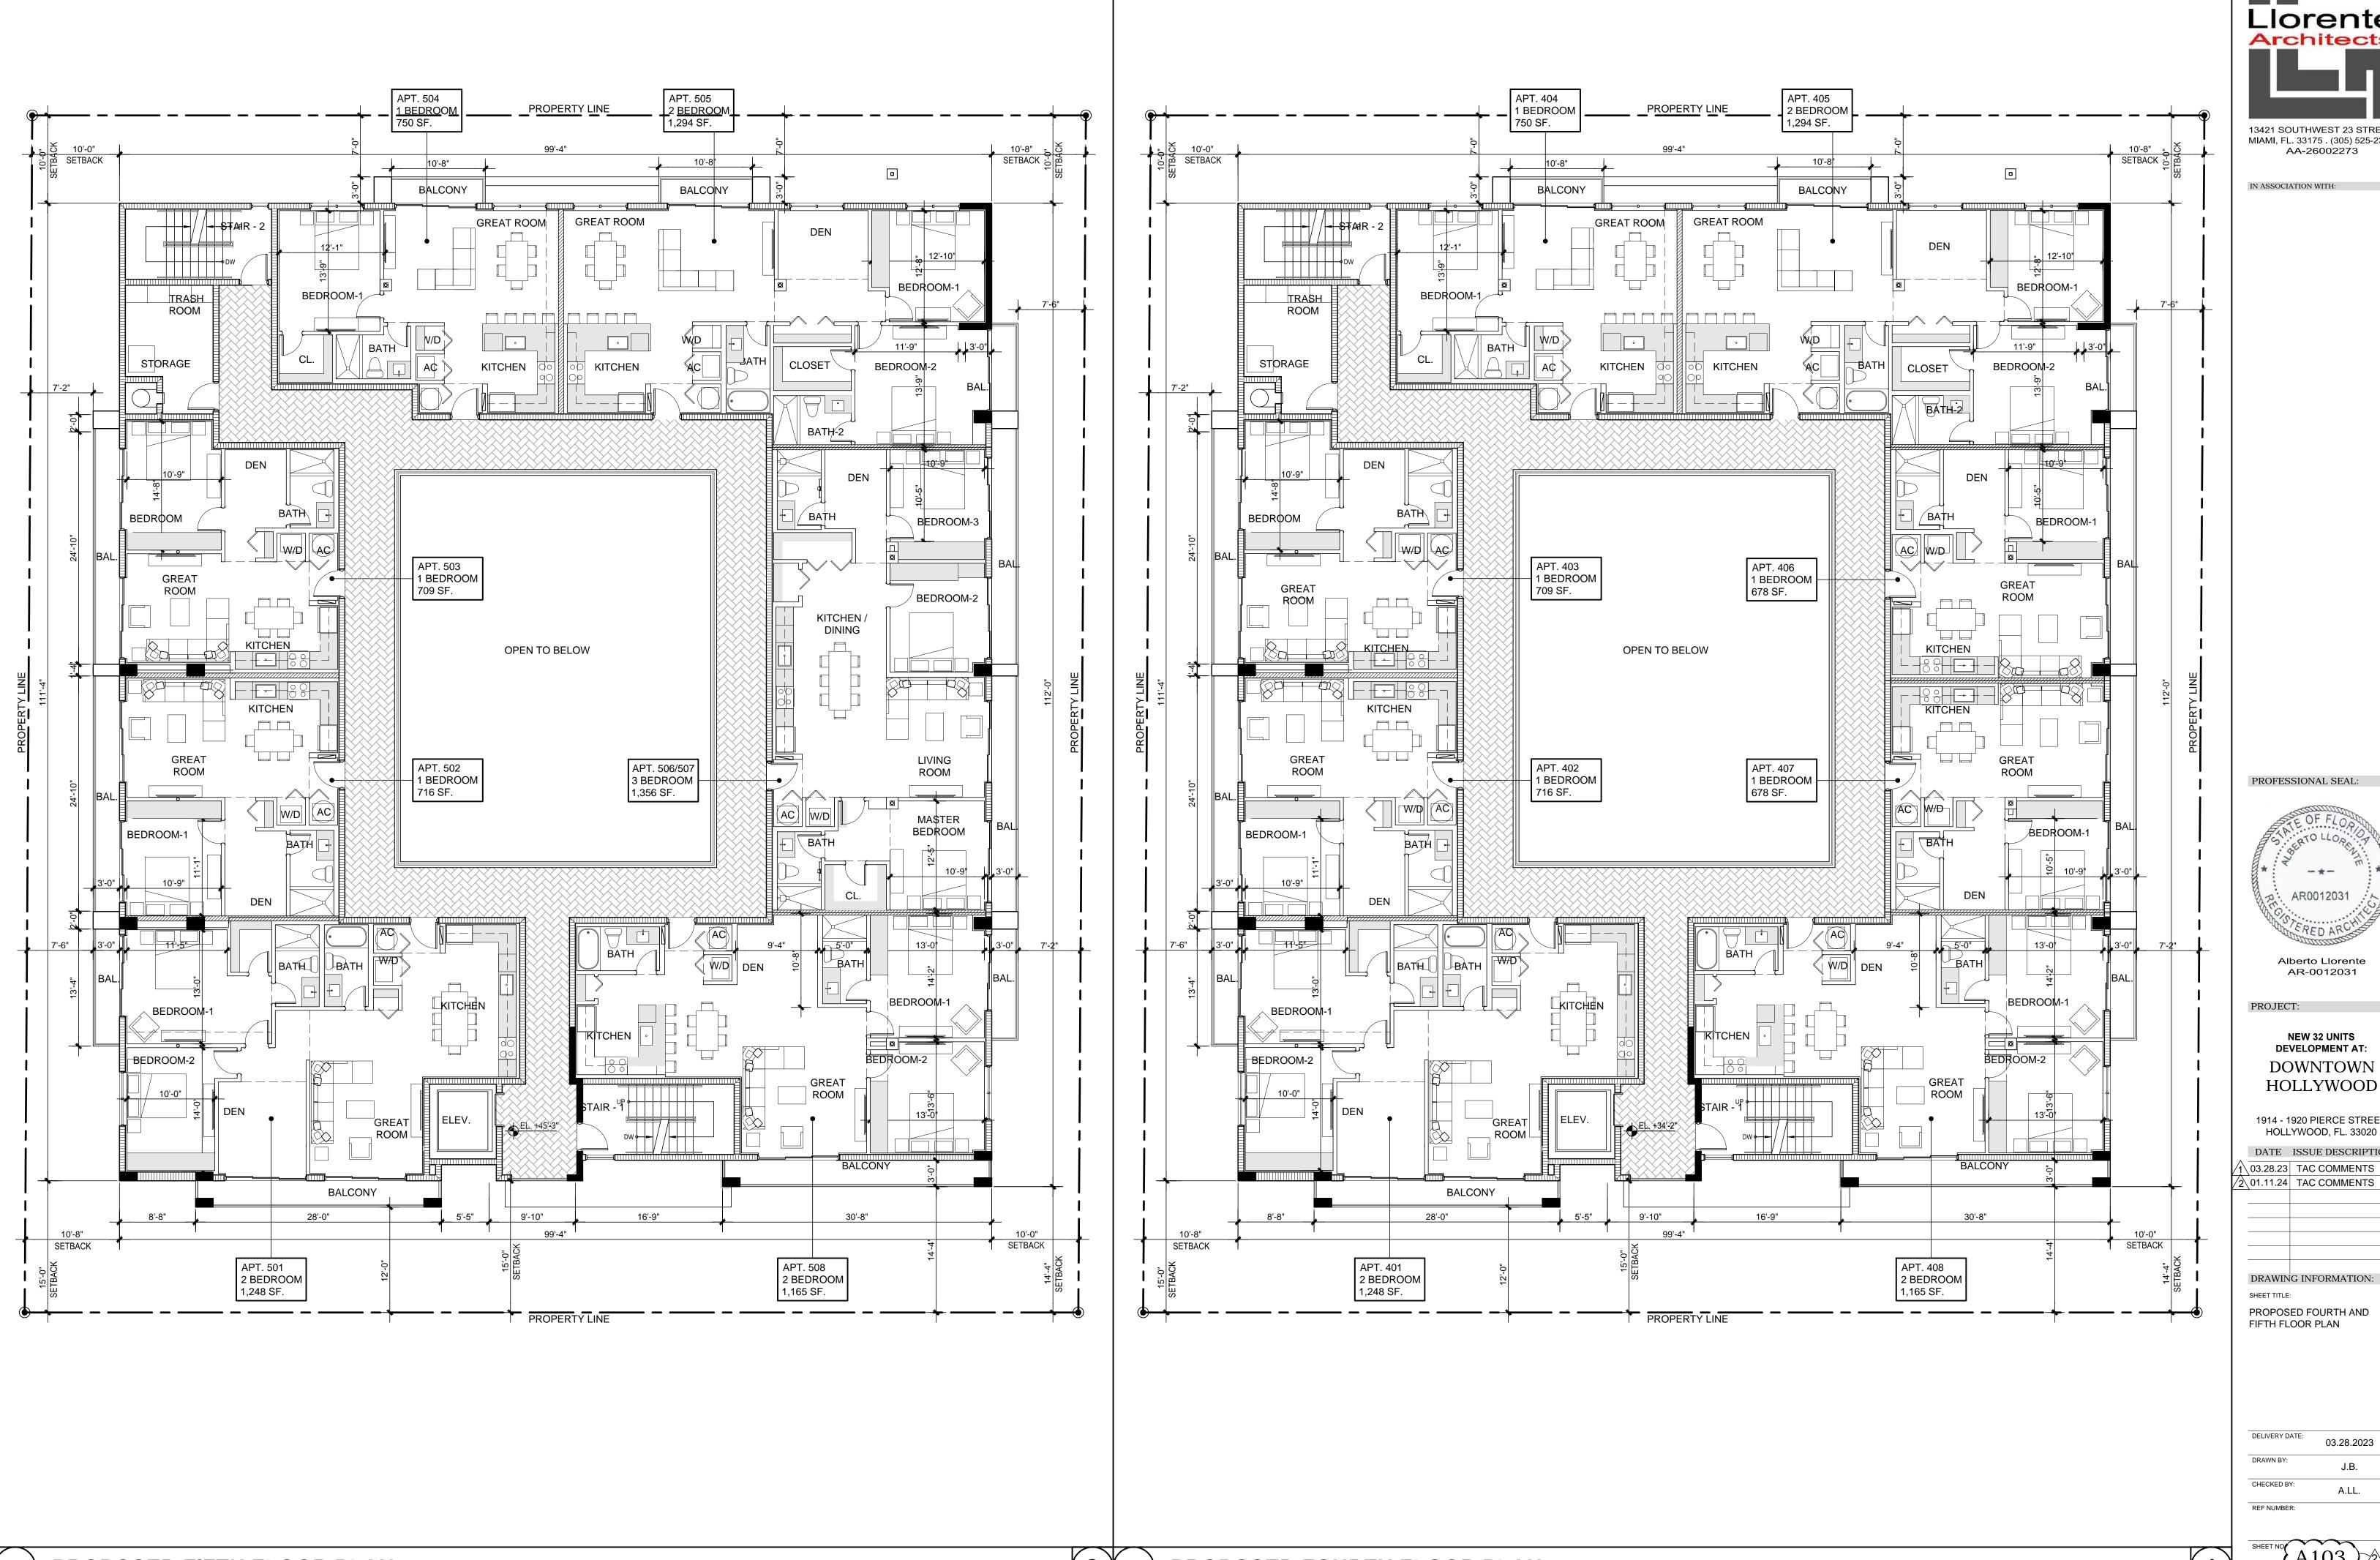

Llorente **Architects** 13421 SOUTHWEST 23 STREET MIAMI, FL. 33175 . (305) 525-2370

IN ASSOCIATION WITH:

PROFESSIONAL SEAL:




Alberto Llorente AR-0012031

NEW 32 UNITS DEVELOPMENT AT: DOWNTOWN HOLLYWOOD

1914 - 1920 PIERCE STREET HOLLYWOOD, FL. 33020 \03.28.23 TAC COMMENTS

DRAWING INFORMATION:

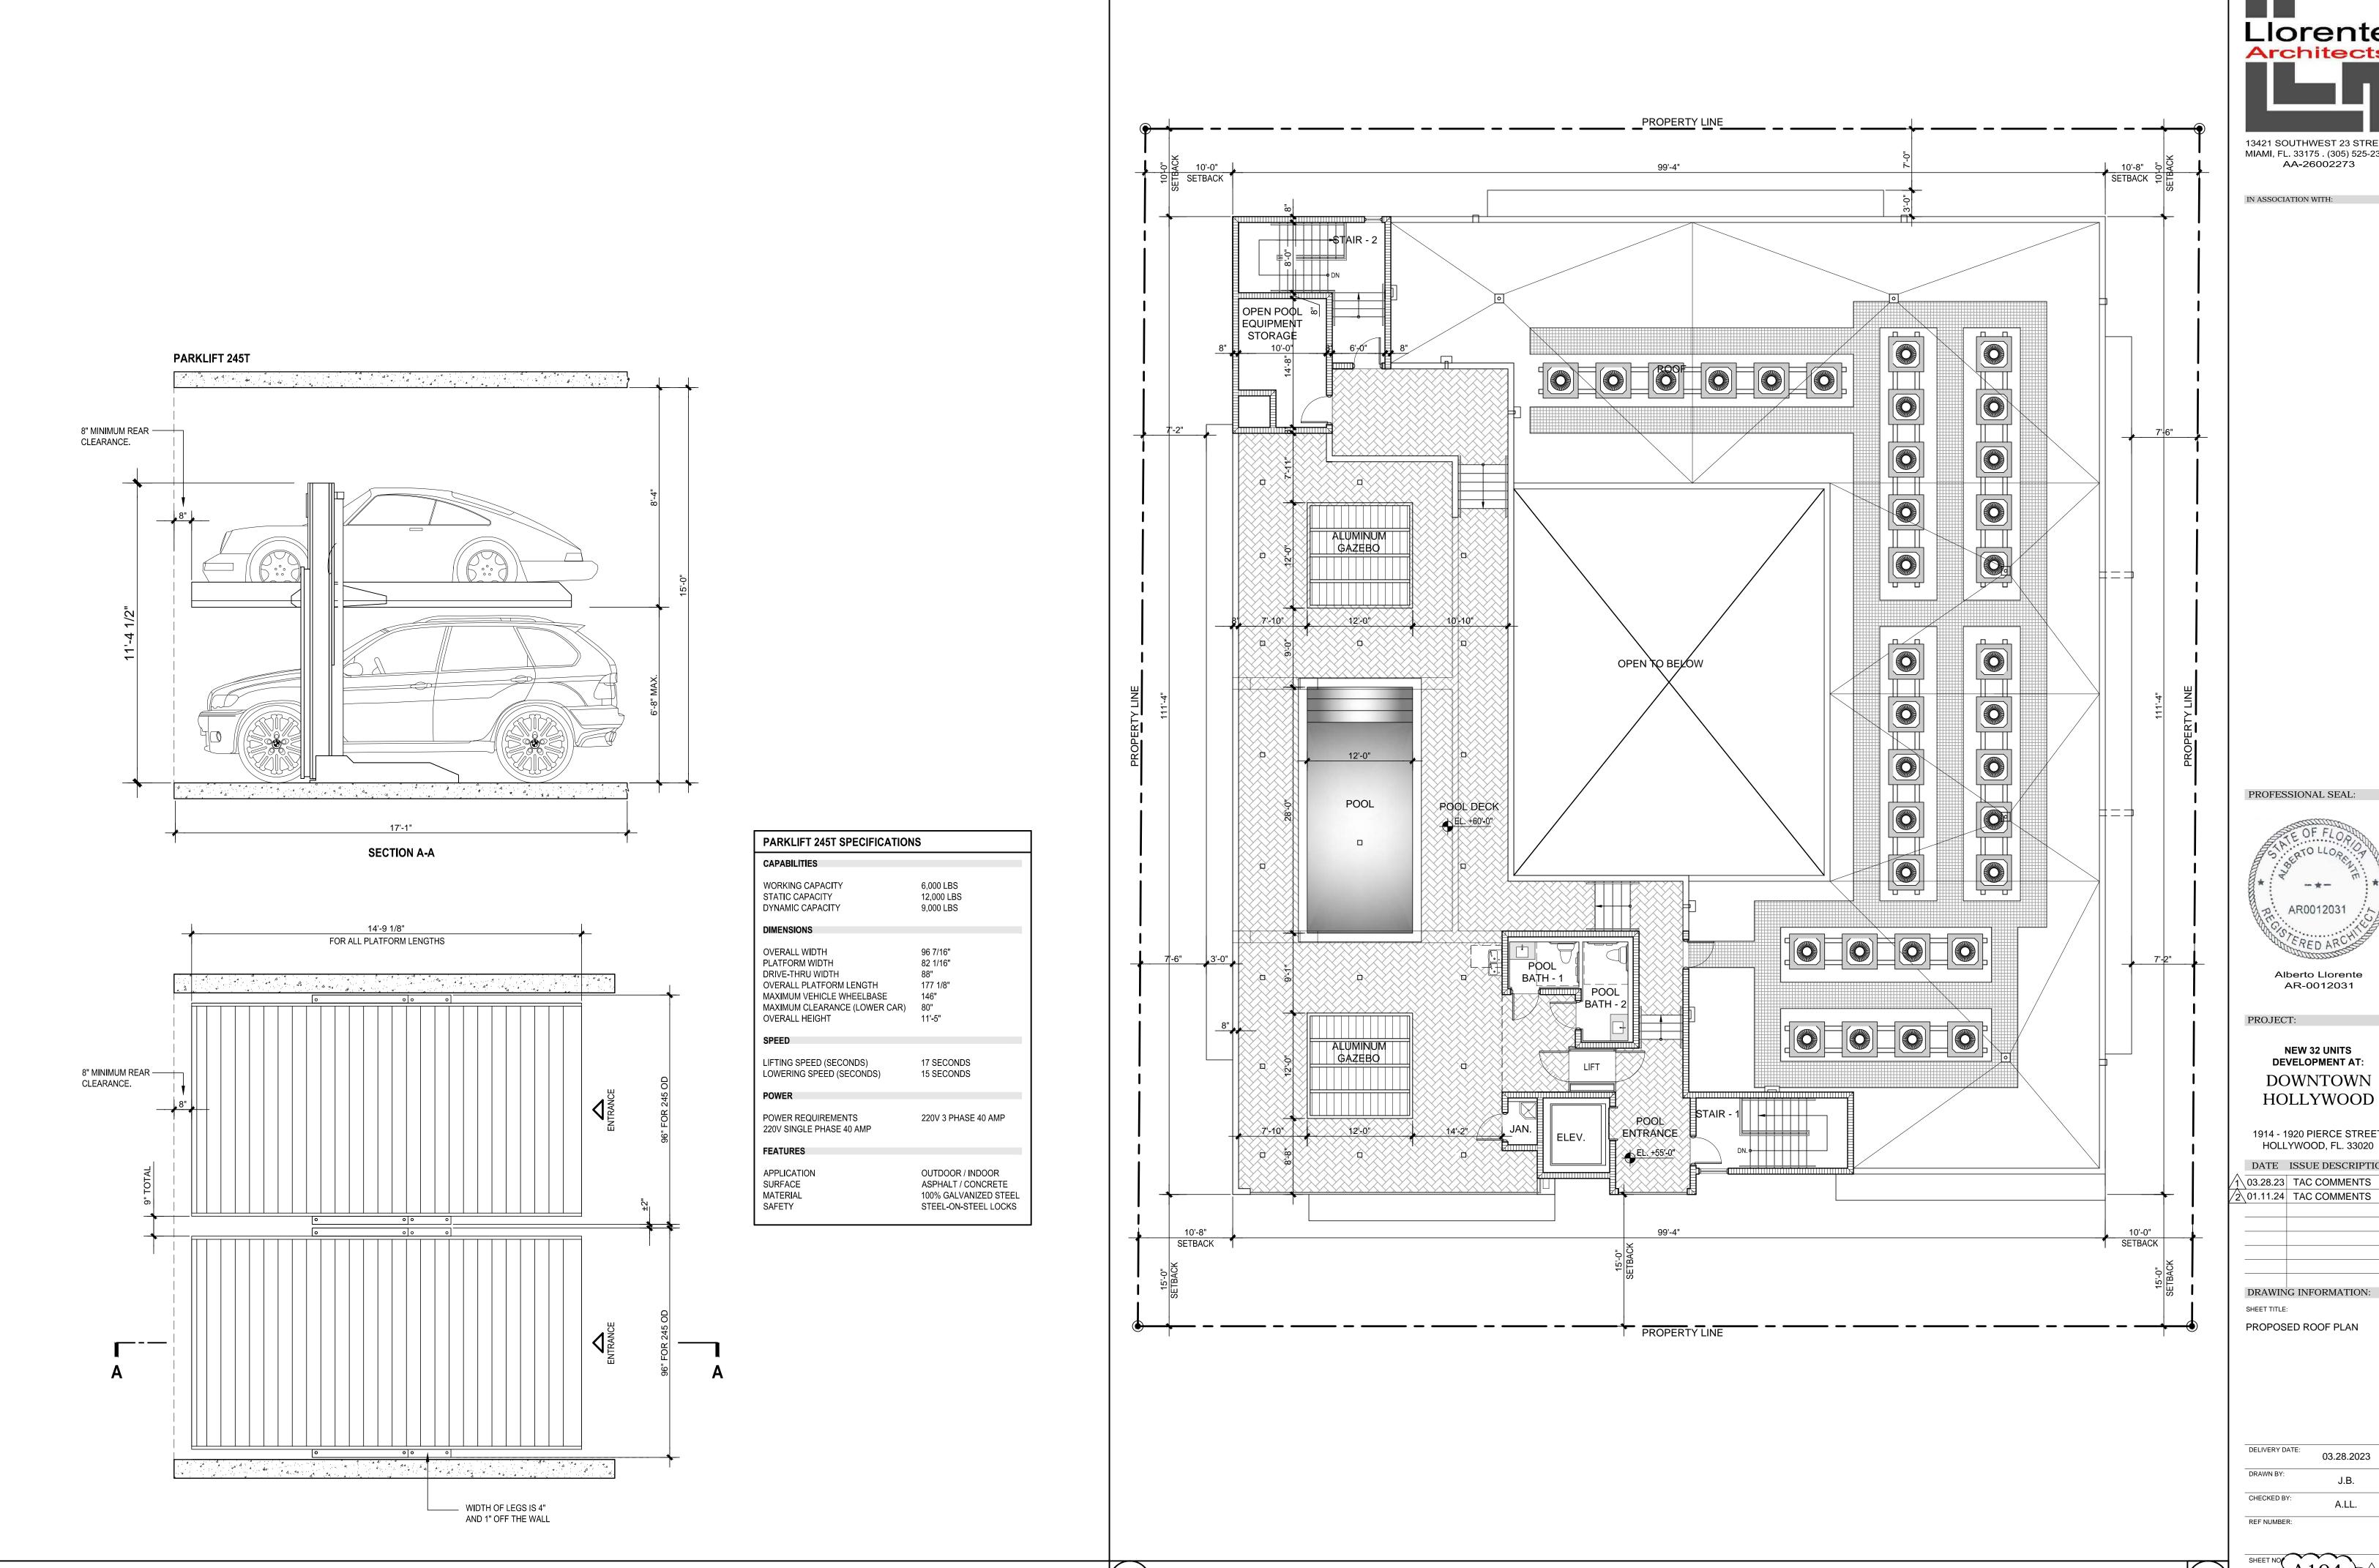

PARKLIFT DETAILS SCALE: 3/8" = 1'-0"



AA-26002273

IN ASSOCIATION WITH:

PROFESSIONAL SEAL:



Alberto Llorente AR-0012031

PROJECT:


NEW 32 UNITS DEVELOPMENT AT: DOWNTOWN HOLLYWOOD


1914 - 1920 PIERCE STREET HOLLYWOOD, FL. 33020 DATE ISSUE DESCRIPTION 03.28.23 TAC COMMENTS

DRAWING INFORMATION:

PROPOSED ROOF PLAN

DELIVERY DATE: DRAWN BY: CHECKED BY:

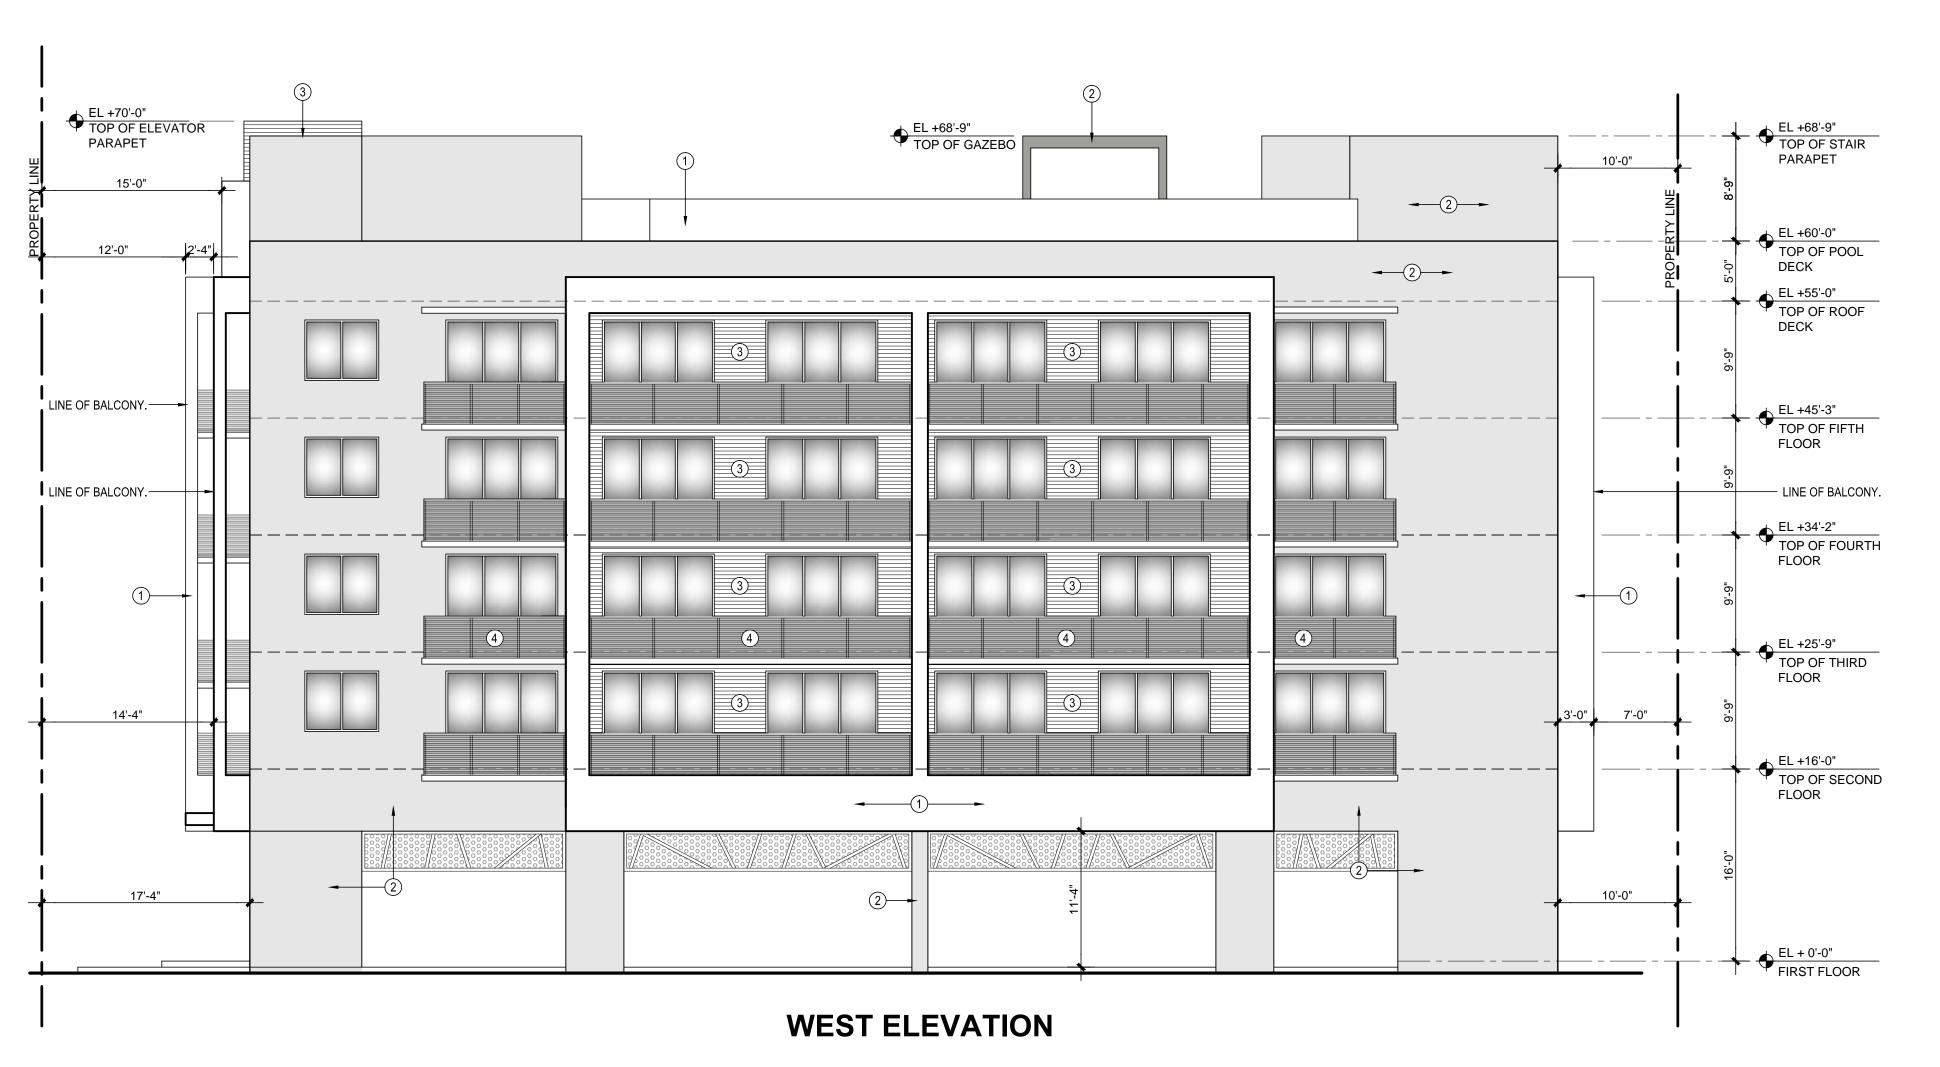

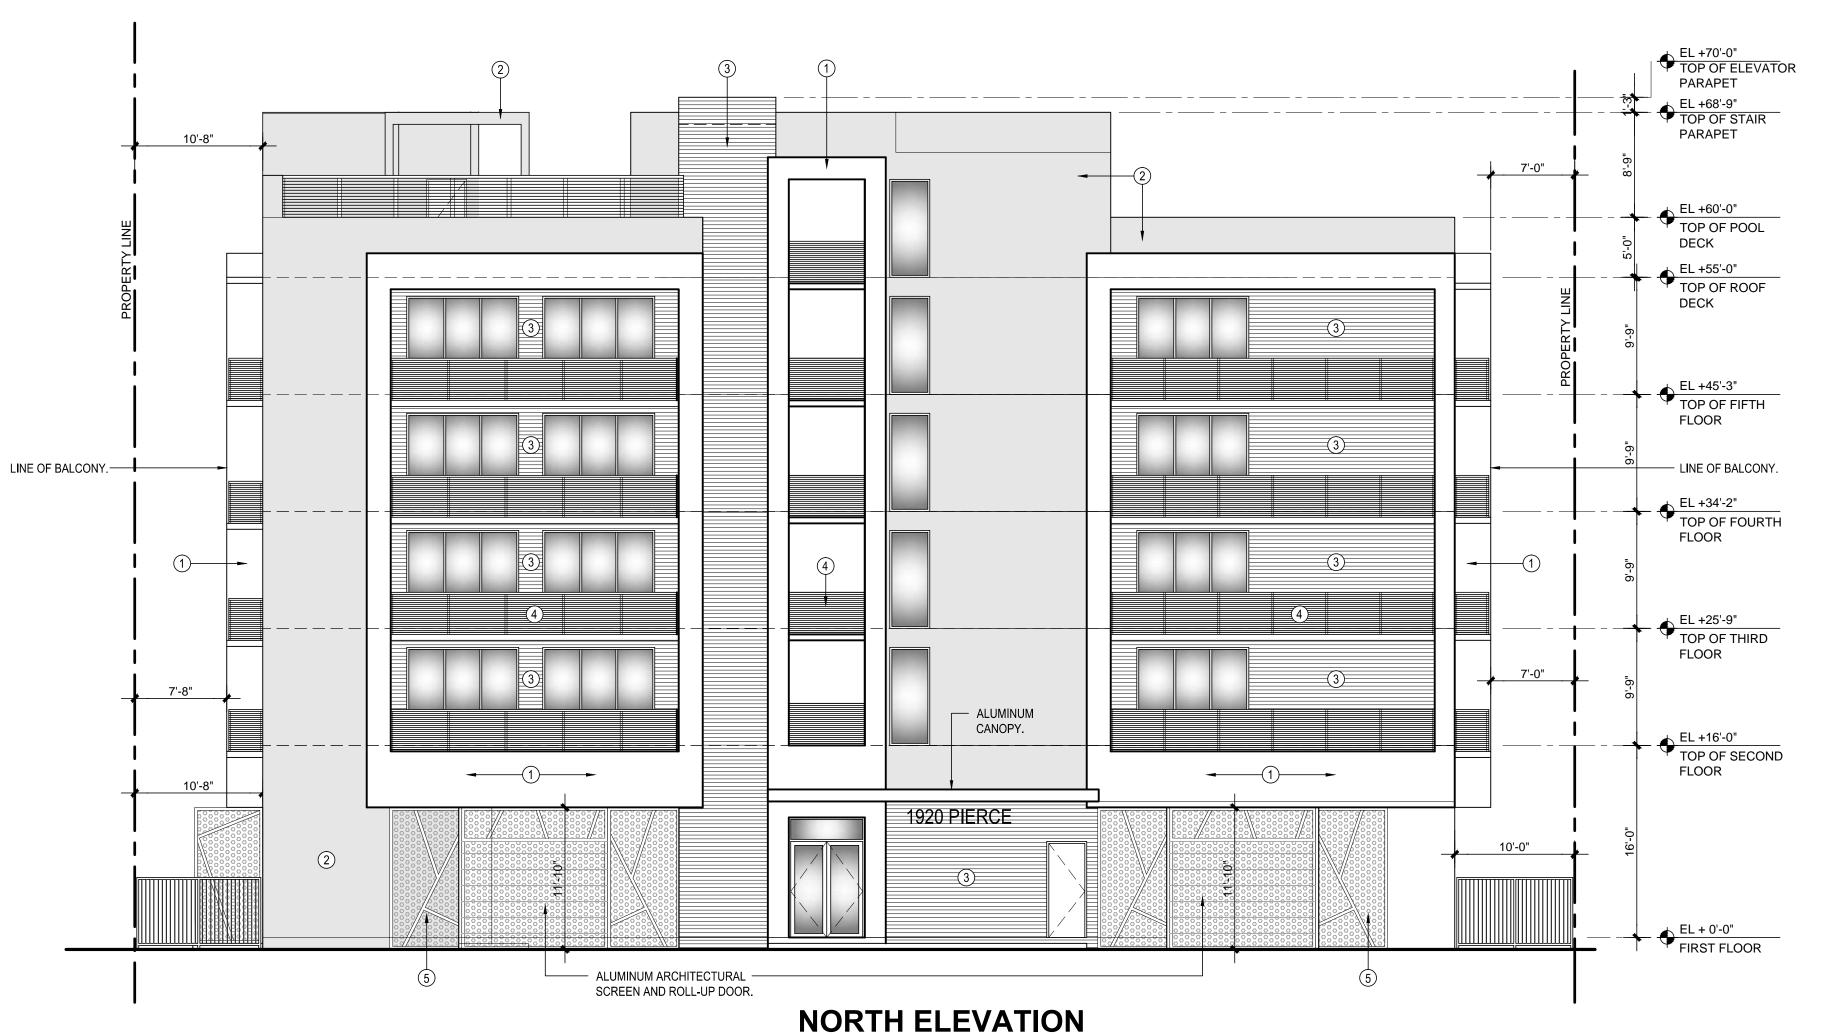



IN ASSOCIATION WITH:

PROFESSIONAL SEAL:



Alberto Llorente AR-0012031

PROJECT:

NEW 32 UNITS
DEVELOPMENT AT:
DOWNTOWN
HOLLYWOOD

1914 - 1920 PIERCE STREET HOLLYWOOD, FL. 33020

DATE ISSUE DESCRIPTION

03.28.23 TAC COMMENTS

2 01.11.24 TAC COMMENTS

DRAWING INFORMATION:

SHEET TITLE:


PROPOSED NORTH AND WEST ELEVATION

DELIVERY DATE: 03.28.2023

DRAWN BY: J.B.

CHECKED BY: A.LL.

REF NUMBER:

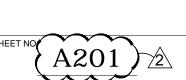

MATERIAL COLOR SELECTION

SW7653 SILVERPOINTE

SW7655 STAMPED CONCRETE

(1) COLOR 1 SHERWIN WILLIAMS

2 COLOR 2 SHERWIN WILLIAMS

(4) BLACK ALUMINUM RAILING.


SCREEN / ROLL-UP DOOR.


W/ GREY TINTED GLASS.

(3) WOOD TILE USA TILE TRAVEL 6"x48" GOLD

(5) ANODIZED ALUMINUM ARCHITECTURE

6 BRONZE ALUMINUM WINDOW / DOOR FRAME

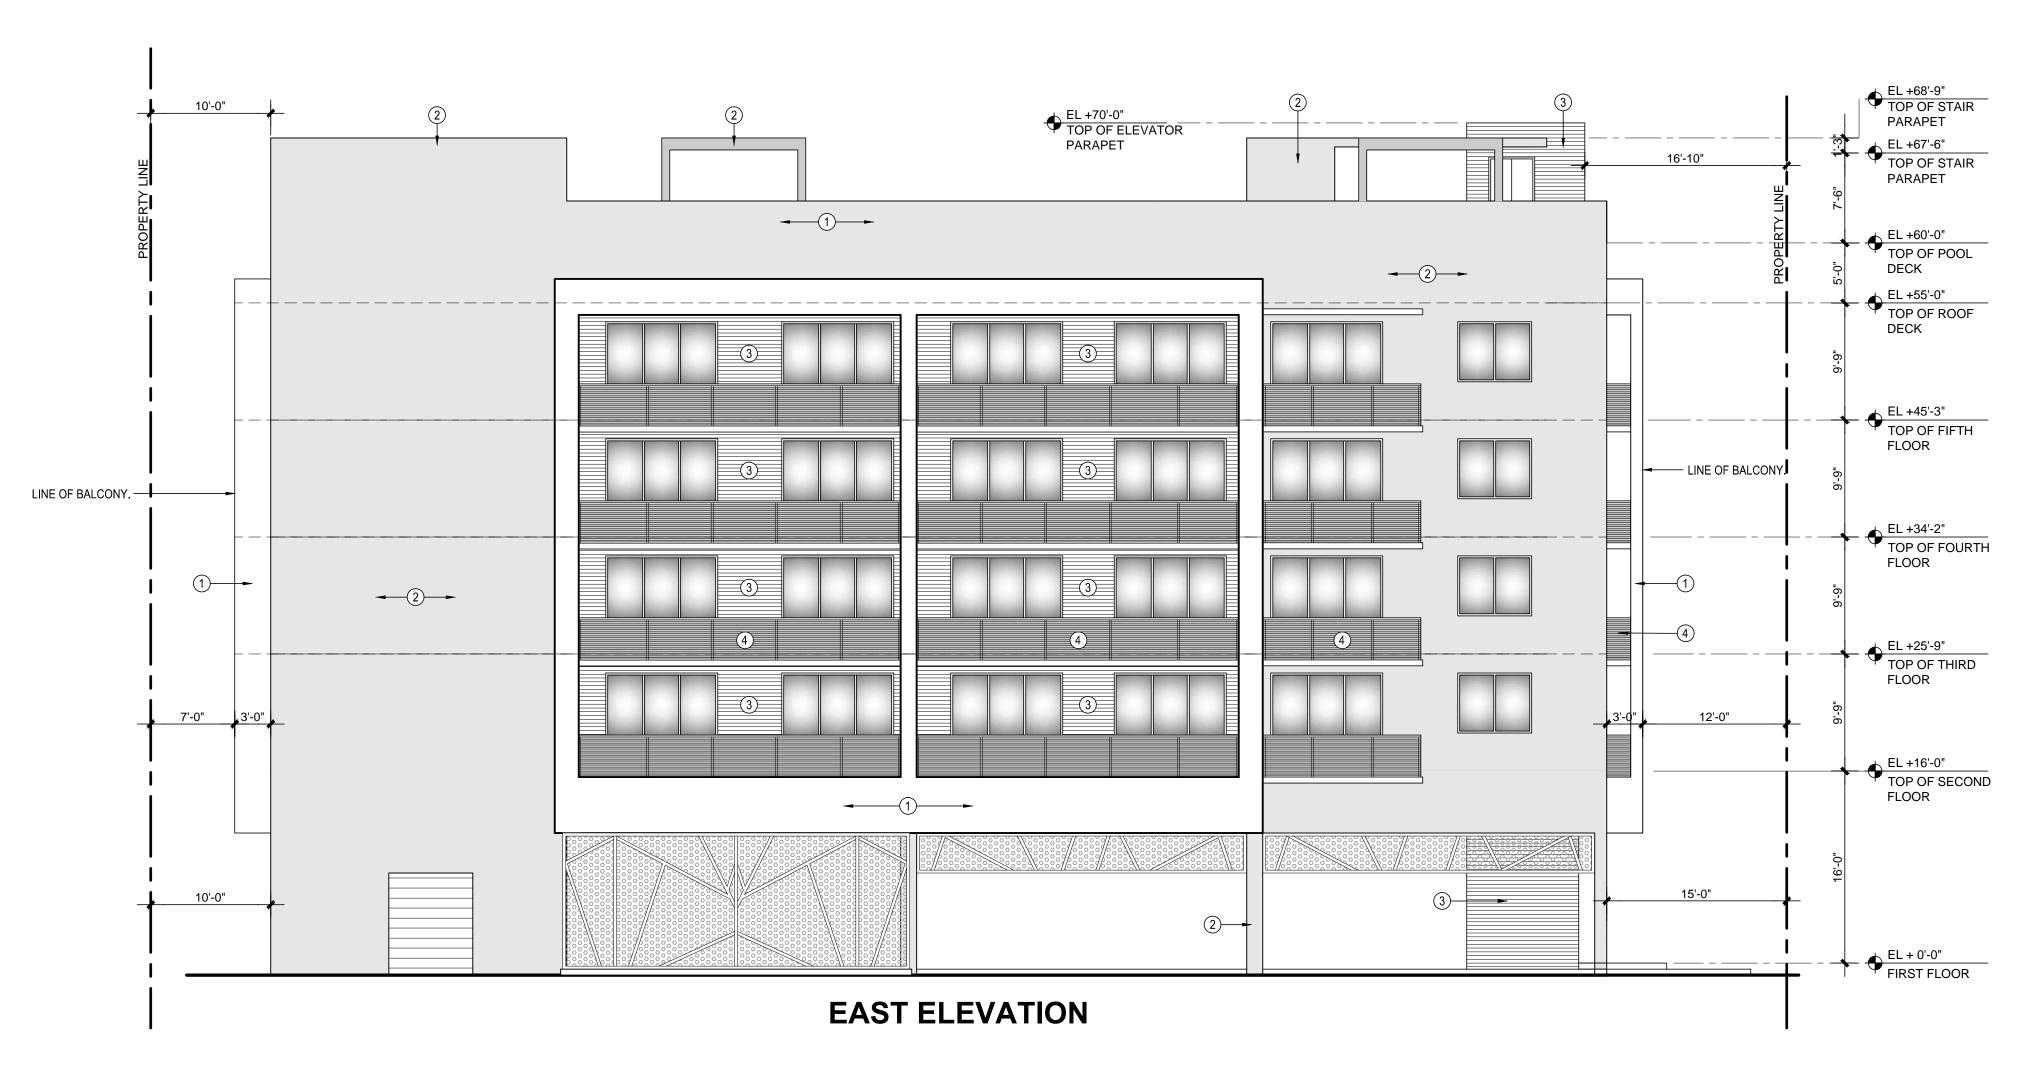

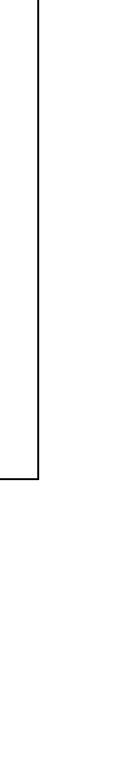

MATERIAL COLOR SELECTION

SW7653 SILVERPOINTE

SW7655 STAMPED CONCRETE

(1) COLOR 1 SHERWIN WILLIAMS

2 COLOR 2 SHERWIN WILLIAMS

(4) BLACK ALUMINUM RAILING.


SCREEN / ROLL-UP DOOR.

W/ GREY TINTED GLASS.

(3) WOOD TILE USA TILE TRAVEL 6"x48" GOLD

(5) ANODIZED ALUMINUM ARCHITECTURE

6 BRONZE ALUMINUM WINDOW / DOOR FRAME

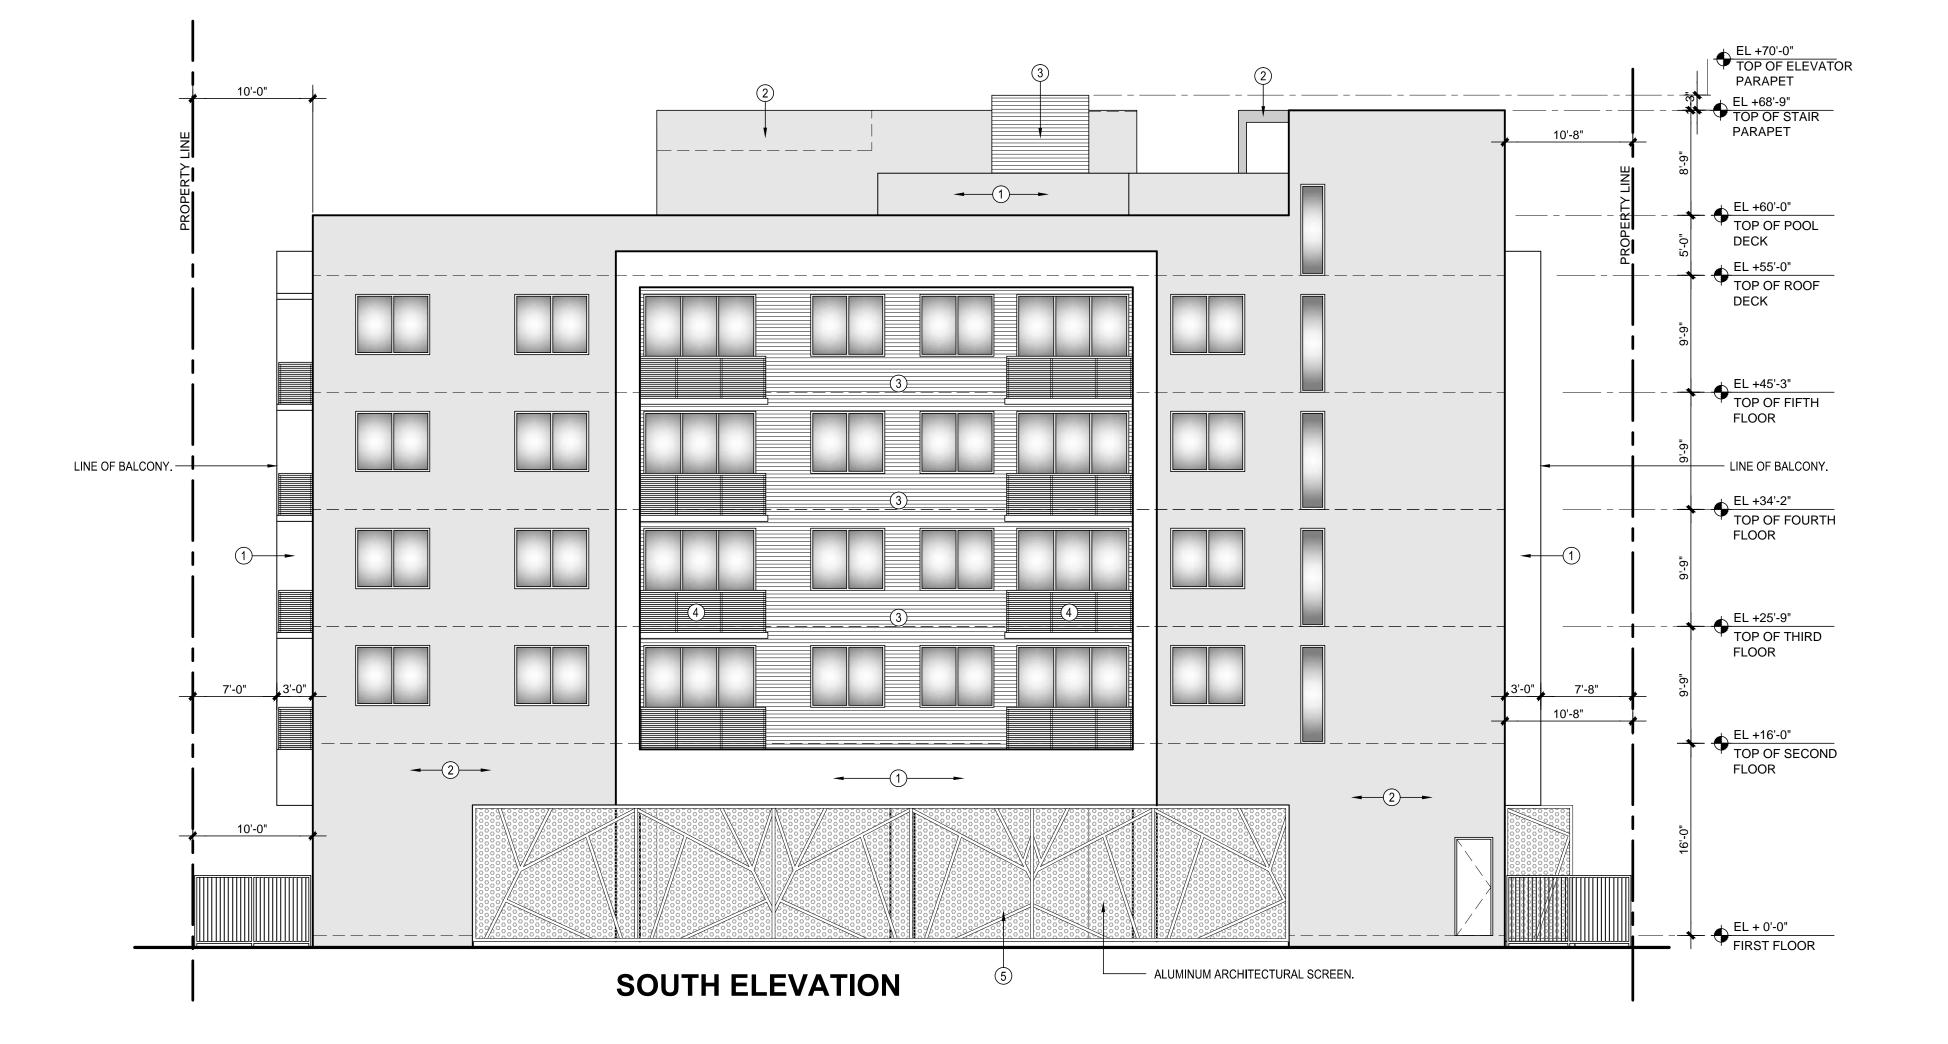



IN ASSOCIATION WITH:

PROFESSIONAL SEAL:



Alberto Llorente AR-0012031

PROJECT:

NEW 32 UNITS
DEVELOPMENT AT:
DOWNTOWN
HOLLYWOOD

1914 - 1920 PIERCE STREET HOLLYWOOD, FL. 33020 DATE ISSUE DESCRIPTION

\03.28.23 TAC COMMENTS

2 01.11.24 TAC COMMENTS

DRAWING INFORMATION:


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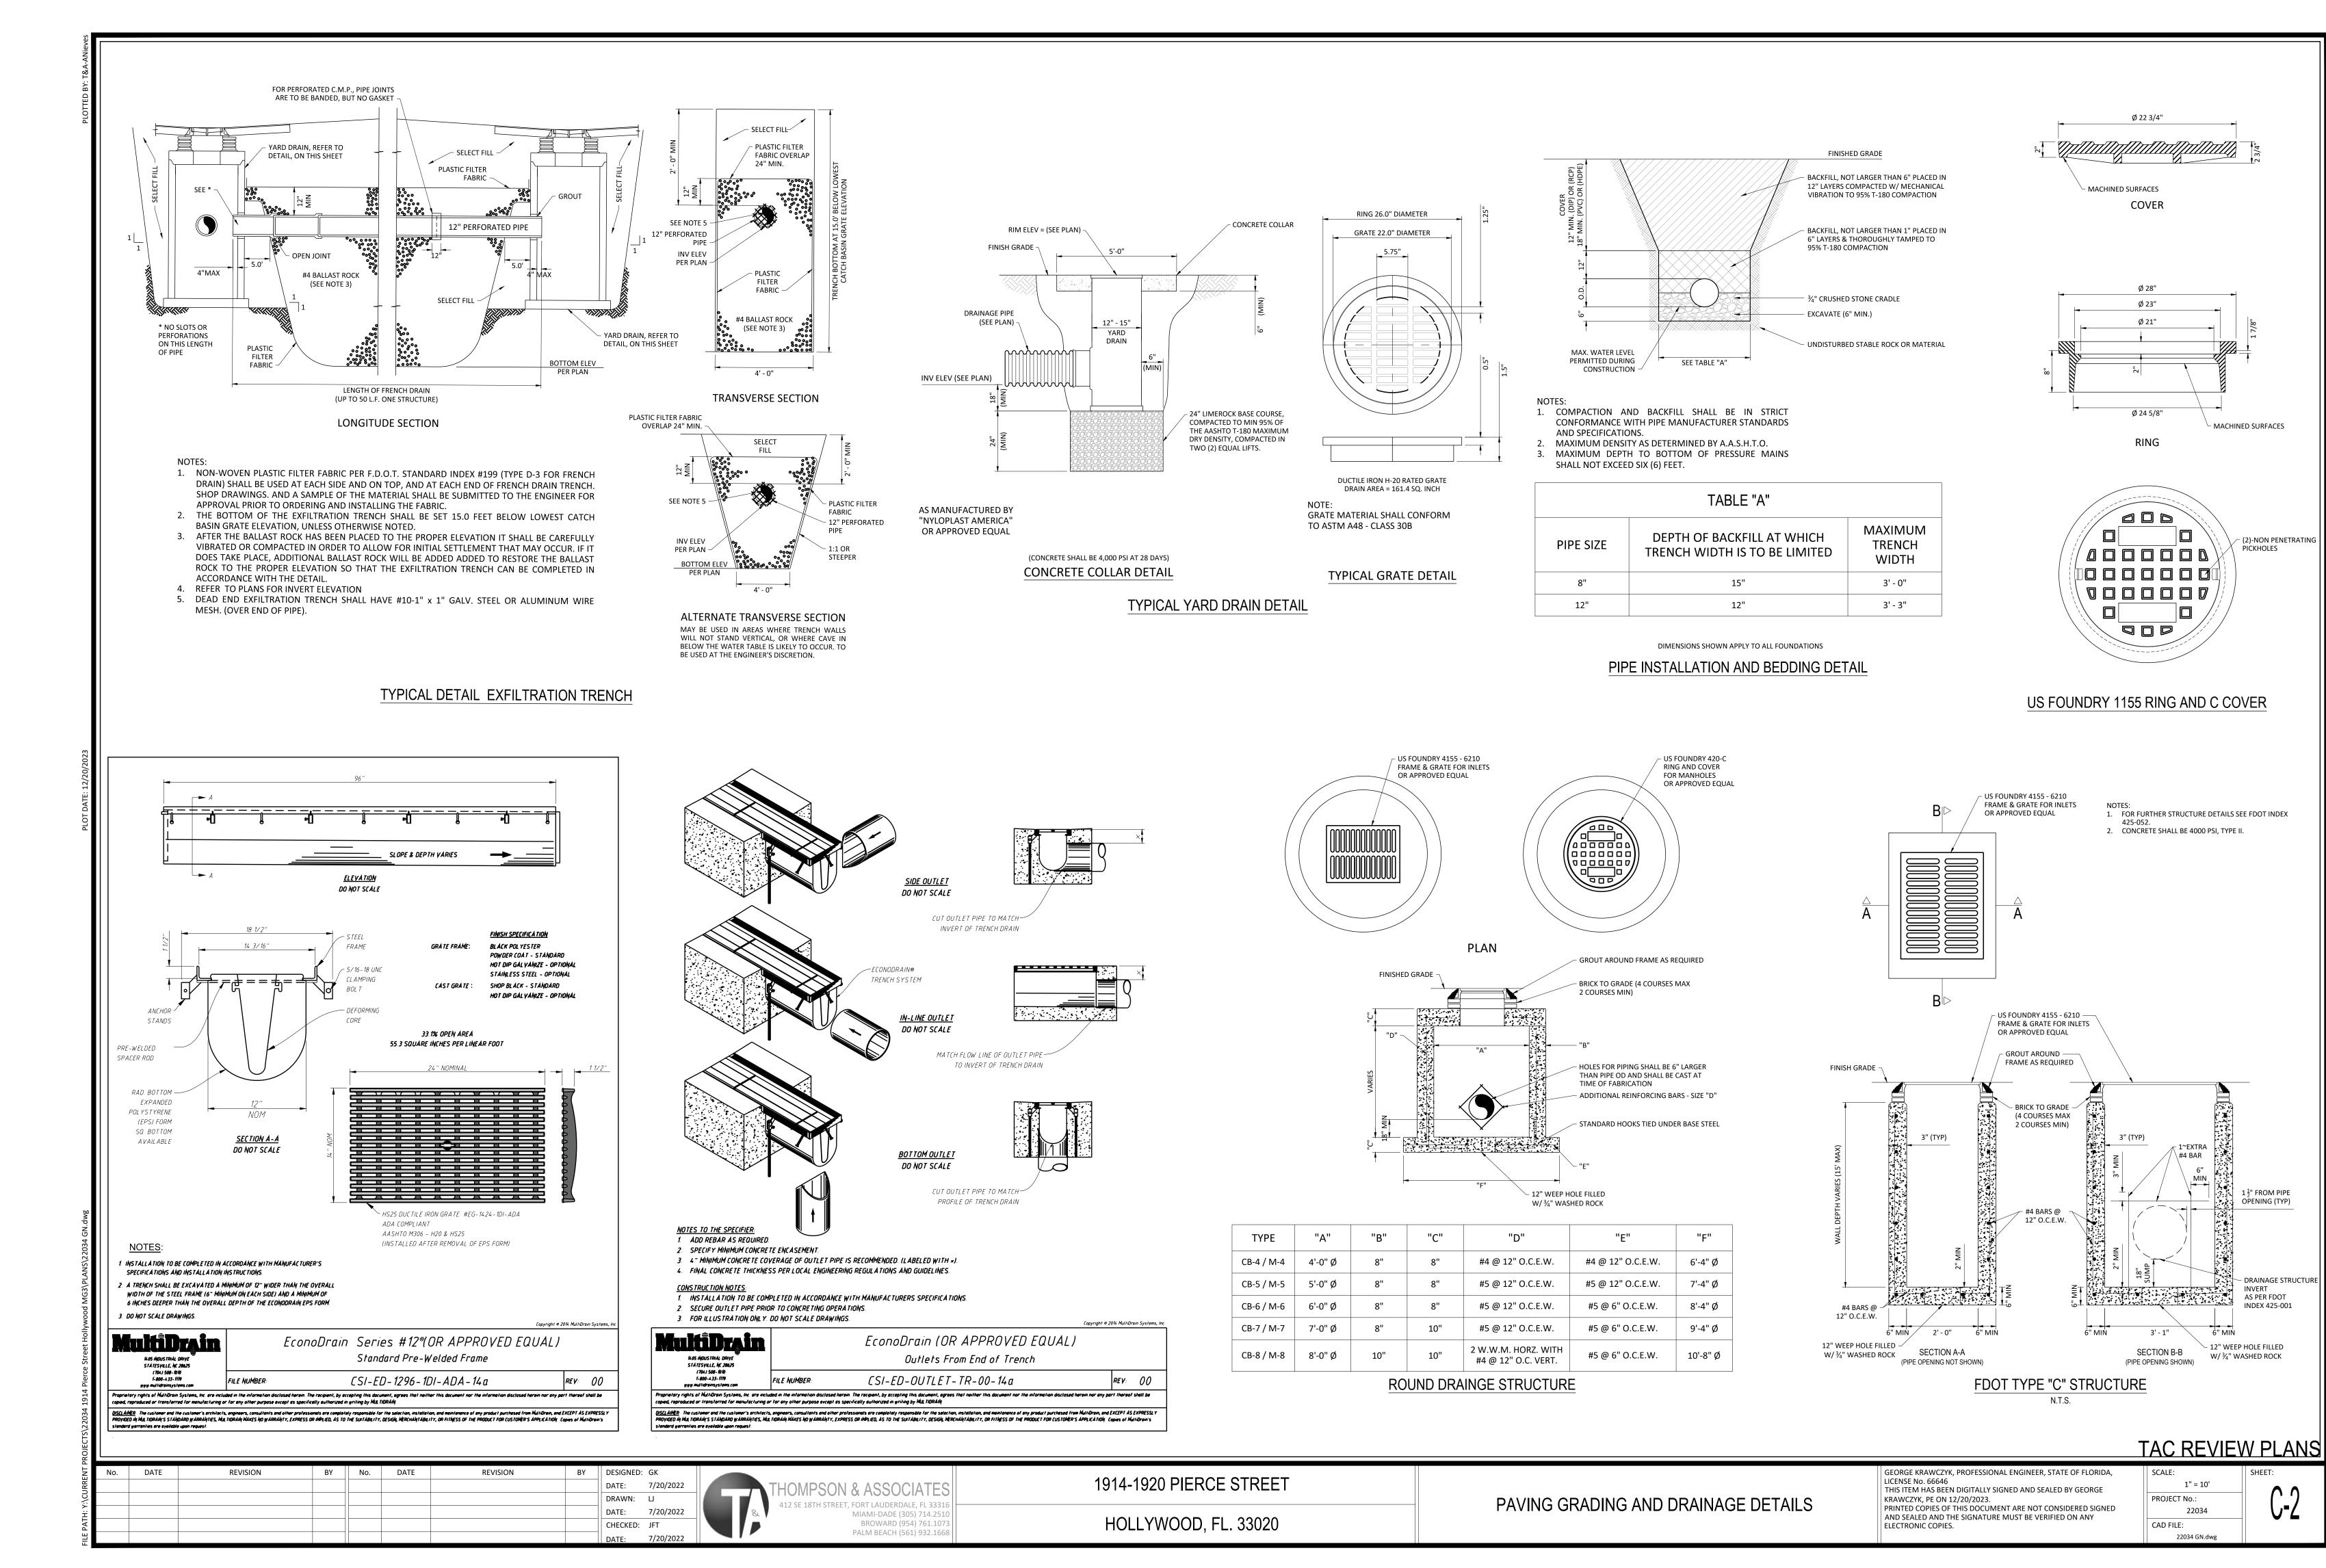
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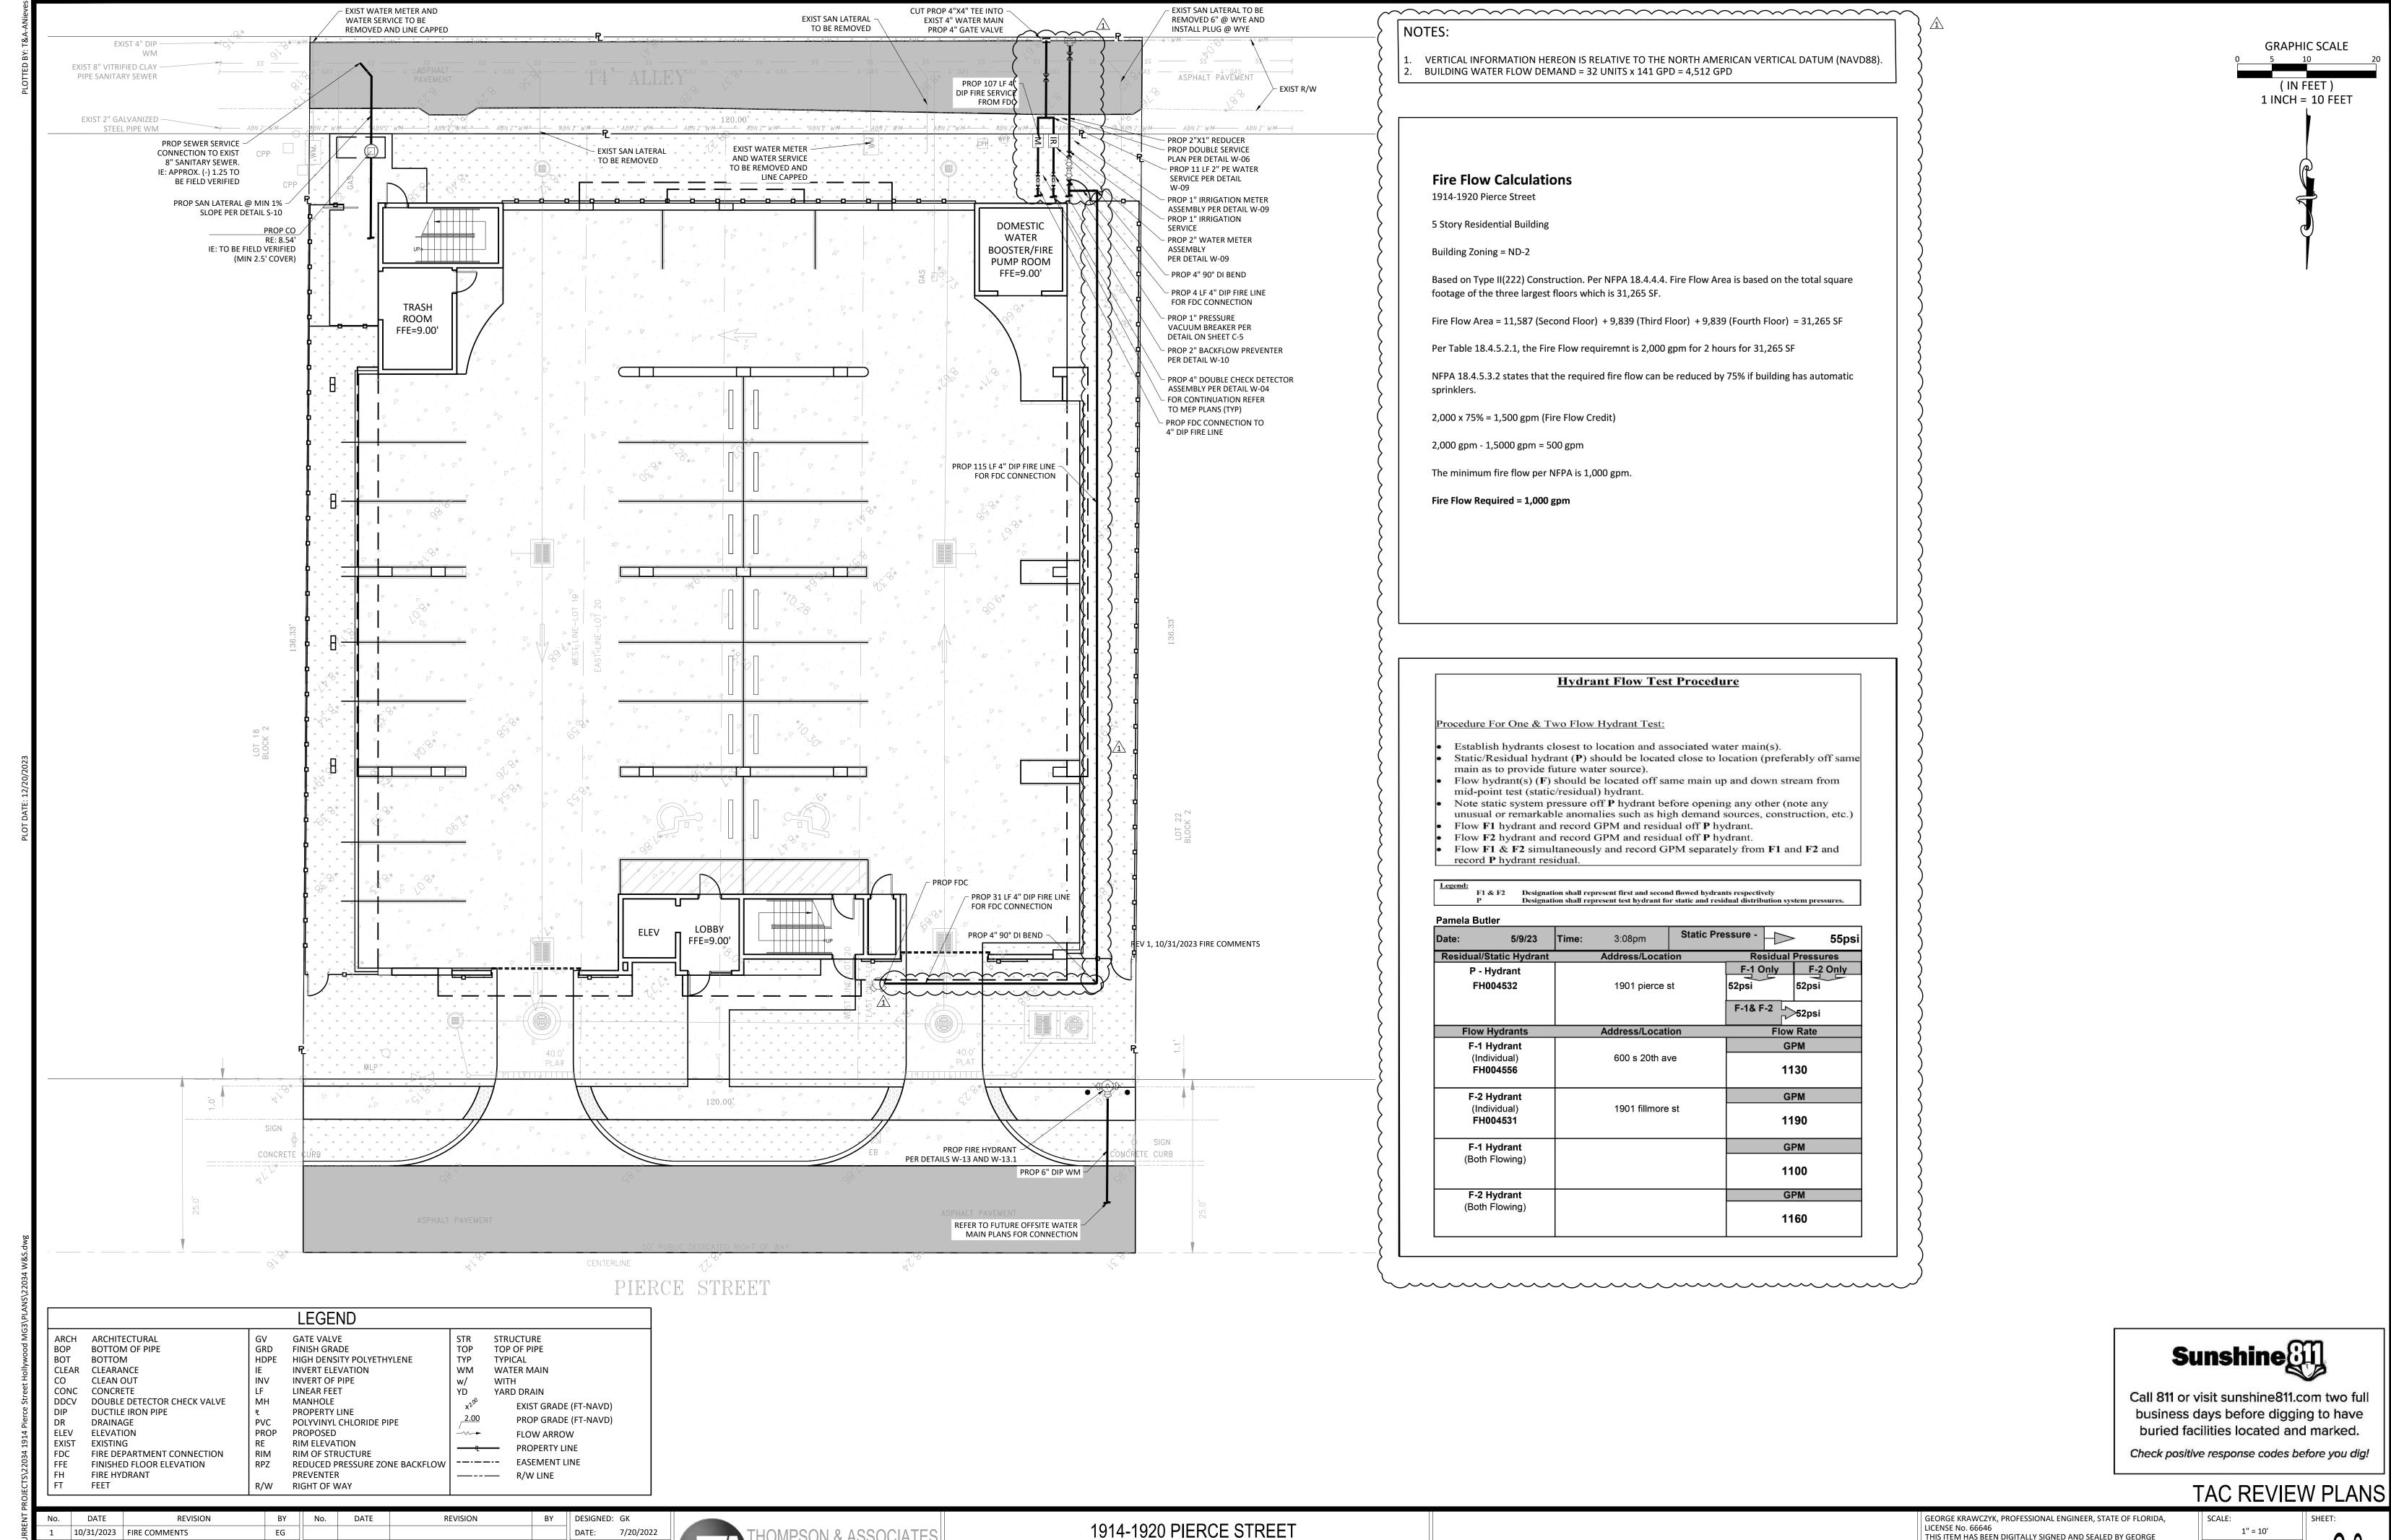
DRAWN BY: J.B.

CHECKED BY: A.LL.

REF NUMBER:





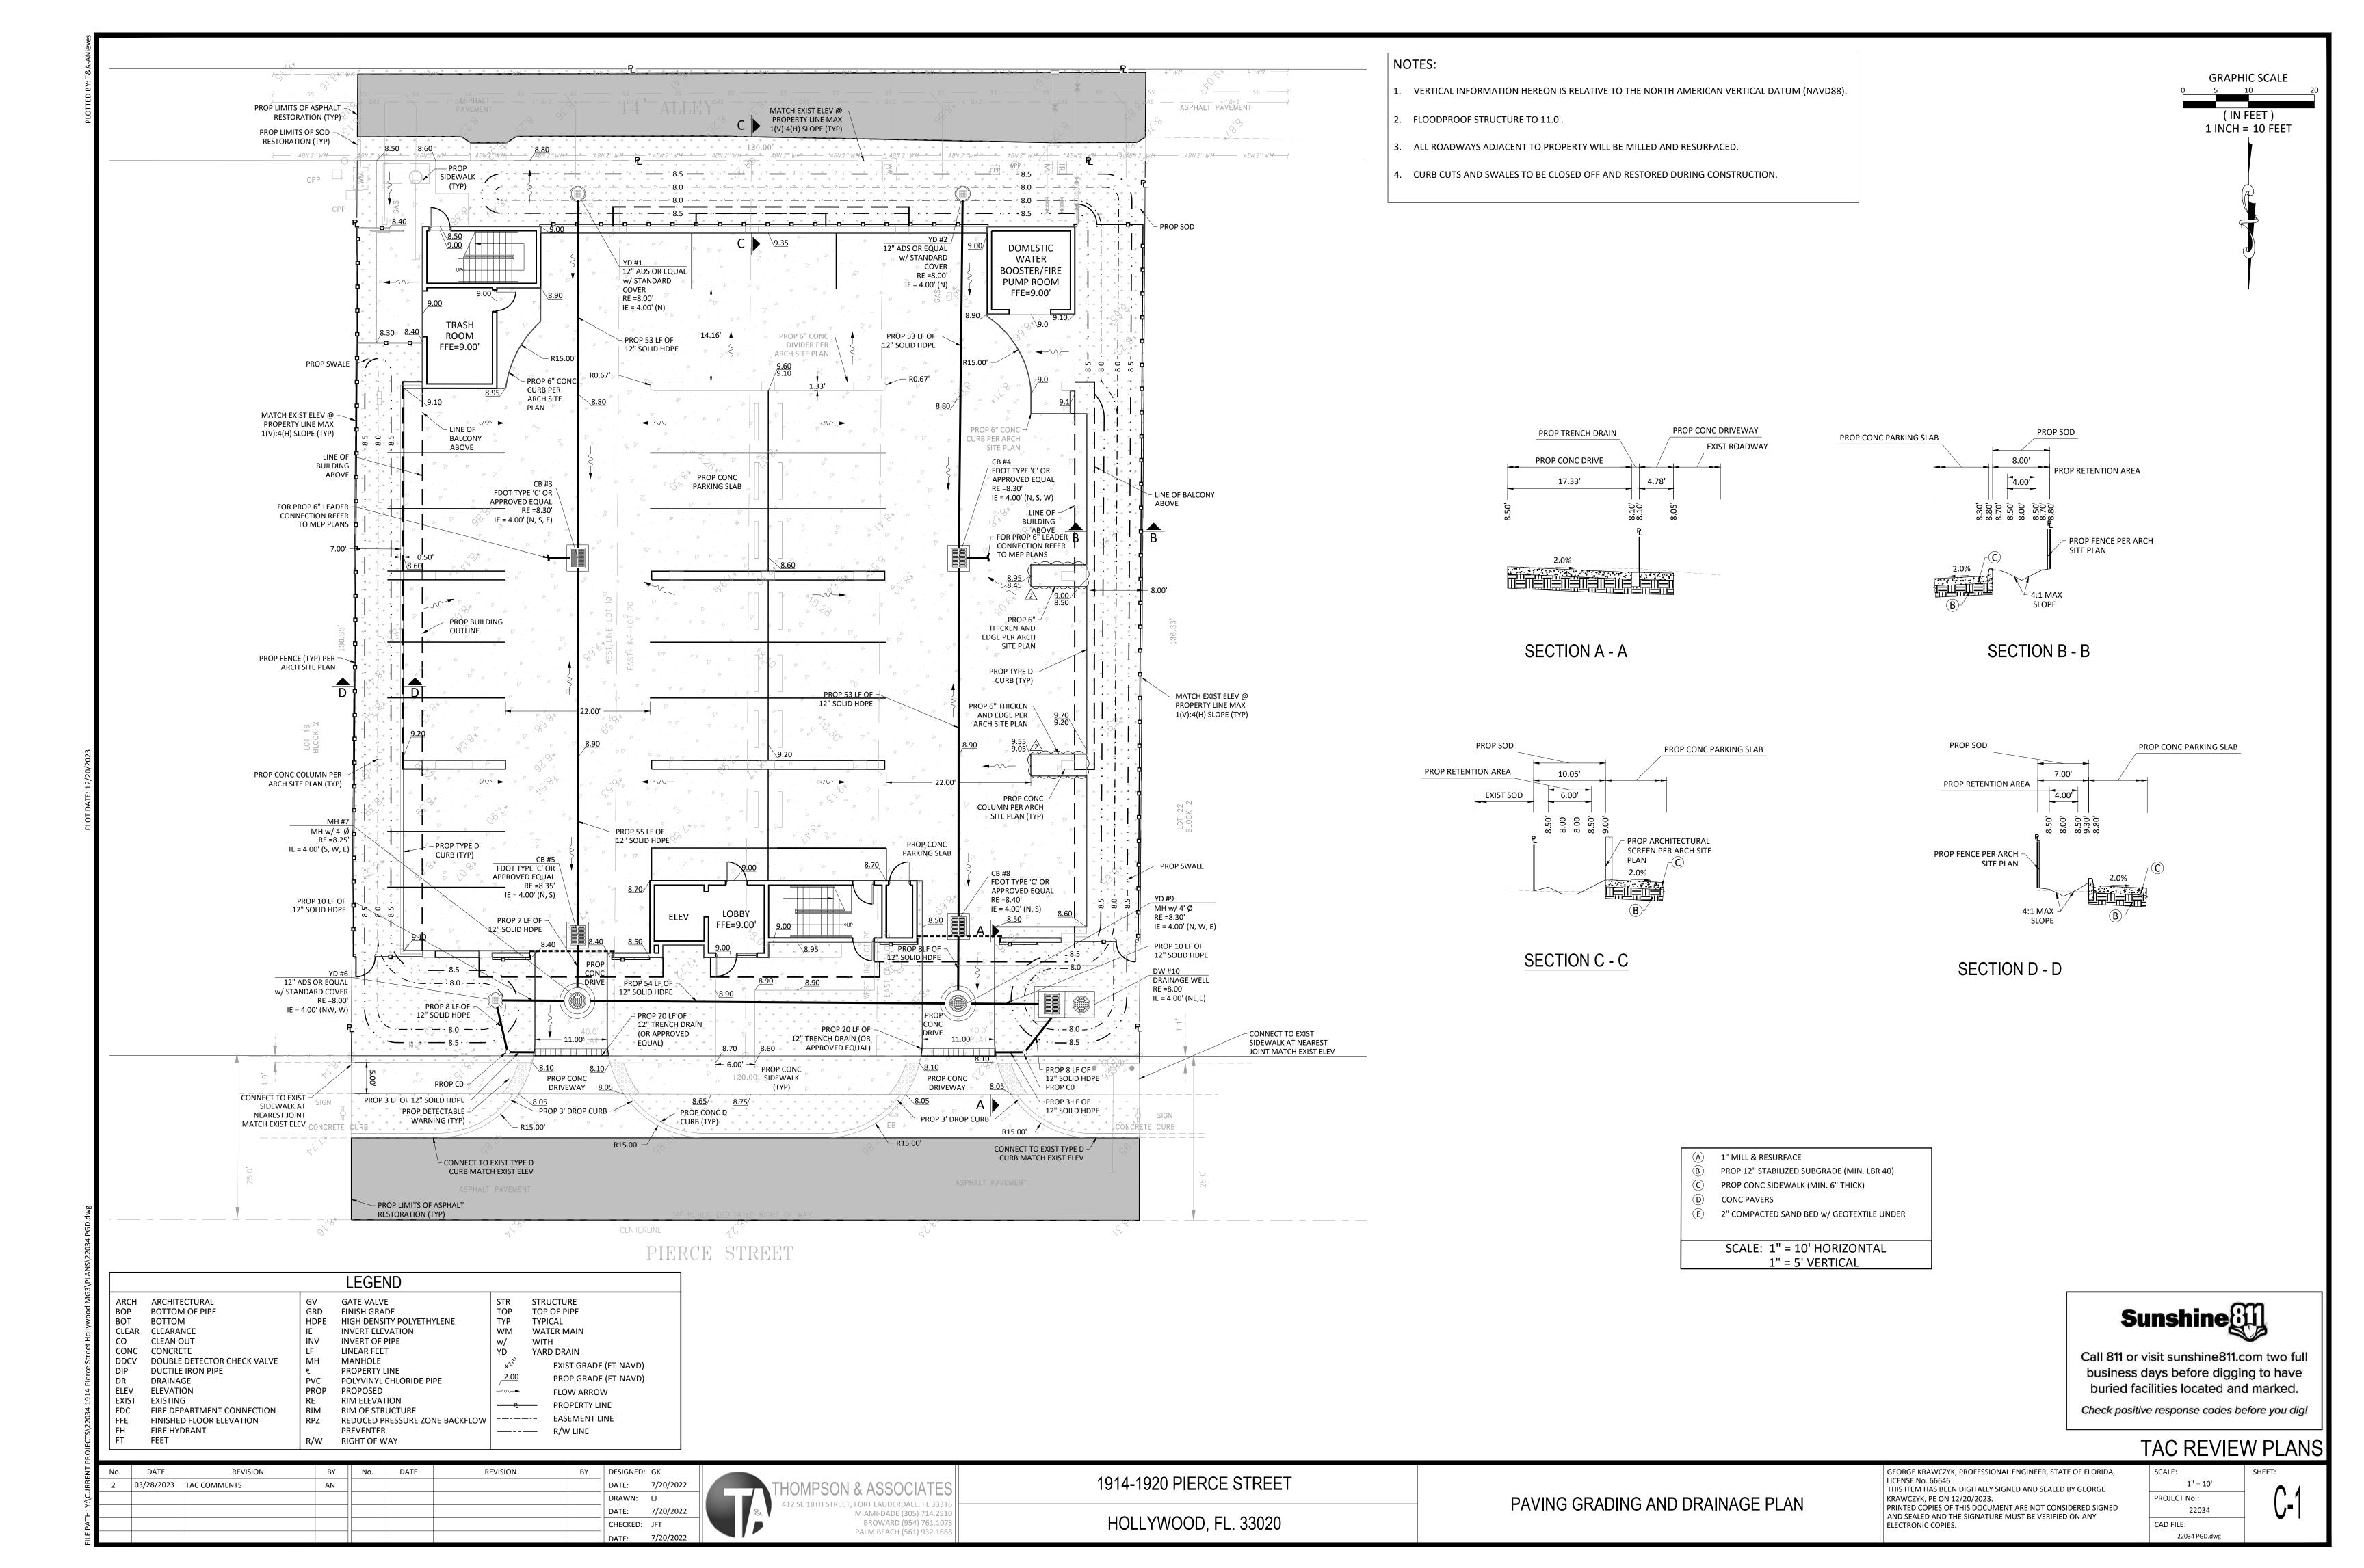

HOLLYWOOD, FL. 33020

DRAWN:

CHECKED: JFT

7/20/2022

MIAMI-DADE (305) 714.2510

PALM BEACH (561) 932.1668

BROWARD (954) 761.1073

DATE:

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KRAWCZYK, PE ON 12/20/2023.
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1" = 10'

PROJECT No.:
22034

CAD FILE:
22034 W&S.dwg

WATER SYSTEM NOTES:


- NEW OR RELOCATED UNDERGROUND WATER MAINS INCLUDED IN THIS PROJECT THAT WILL CROSS ANY EXISTING OR PROPOSED GRAVITY OR VACUUM-TYPE SANITARY SEWER OR STORM SEWER WILL BE LAID SO THE OUTSIDE OF THE WATER MAIN IS AT LEAST SIX INCHES ABOVE THE OTHER PIPELINE OR AT LEAST 12 INCHES BELOW THE OTHER PIPELINE.
- NEW OR RELOCATED UNDERGROUND WATER MAINS INCLUDED IN THIS PROJECT THAT WILL CROSS ANY EXISTING OR PROPOSED PRESSURE-TYPE SANITARY SEWER, WASTEWATER OR STORM WATER FORCE MAIN, OR PIPELINE CONVEYING RECLAIMED WATER WILL BE LAID SO THE OUTSIDE OF THE WATER MAIN IS AT LEAST 12 INCHES ABOVE OR BELOW THE OTHER PIPELINE. [FAC 62-555.314(2); EXCEPTIONS ALLOWED UNDER FAC 62-555.314(5)].
- AT ALL UTILITY CROSSINGS DESCRIBED ABOVE, ONE FULL LENGTH OF WATER MAIN PIPE WILL BE CENTERED ABOVE OR BELOW THE OTHER PIPELINE SO THE WATER MAIN JOINTS WILL BE AS FAR AS POSSIBLE FROM THE OTHER PIPELINE, OR THE PIPES WILL BE ARRANGED SO THAT ALL WATER MAIN JOINTS ARE AT LEAST THREE FEET FROM ALL JOINTS IN VACUUM-TYPE SANITARY SEWERS, STORM SEWERS, STORM WATER FORCE MAINS, OR PIPELINES CONVEYING RECLAIMED WATER REGULATED UNDER PART III OF CHAPTER 62-610, F.A.C., AND AT LEAST SIX FEET FROM ALL JOINTS IN GRAVITY OR PRESSURE-TYPE SANITARY SEWERS, WASTEWATER FORCE MAINS, OR PIPELINES CONVEYING RECLAIMED WATER NOT REGULATED UNDER PART III OF CHAPTER 62-610, F.A.C. [FAC 62-555.314(2); EXCEPTIONS ALLOWED UNDER FAC 62-555.314(5)].
- NEW UNDERGROUND WATER MAINS INCLUDED IN THIS PROJECT TO BE DUCTILE IRON PIPE (D.I.P.) WHEN CROSSING BELOW SANITARY SEWER MAINS.
- POLYETHYLENE ENCASEMENT MATERIAL SHALL BE USED TO ENCASE ALL BURIED DUCTILE IRON PIPE, FITTINGS, VALVES, RODS, AND APPURTENANCES IN ACCORDANCE WITH AWWA C105, METHOD A. THE POLYETHYLENE TUBING SHALL BE CUT TWO FEET LONGER THAN THE PIPE SECTION AND SHALL OVERLAP THE ENDS OF THE PIPE BY ONE FOOT. THE POLYETHYLENE TUBING SHALL BE GATHERED AND LAPPED TO PROVIDE A SNUG FIT AND SHALL BE SECURED AT QUARTER POINTS WITH POLYETHYLENE TAPE. EACH END OF THE POLYETHYLENE TUBING SHALL BE SECURED WITH A WRAP OF POLYETHYLENE TAPE.
- THE POLYETHYLENE TUBING SHALL PREVENT CONTACT BETWEEN THE PIPE AND BEDDING MATERIAL, BUT IS NOT INTENDED TO BE A COMPLETELY AIRTIGHT AND WATERTIGHT ENCLOSURE. DAMAGED POLYETHYLENE TUBING SHALL BE REPAIRED IN A WORKMANLIKE MANNER USING POLYETHYLENE TAPE, OR THE DAMAGED SECTION SHALL BE REPLACED. POLY WRAP WILL NOT BE PAID FOR AS A SEPARATE BID ITEM. IT SHALL BE CONSIDERED TO BE A PART OF THE PRICE BID FOR WATER MAINS.
- FIRE HYDRANT BARRELS SHALL BE ENCASED IN POLY WRAP UP TO THE GROUND SURFACE AND THE WEEP HOLES SHALL NOT BE COVERED BY THE POLY WRAP.
- GATE VALVES FOR USE WITH PIPE LESS THAN THREE INCHES (3") IN DIAMETER SHALL BE RATED FOR TWO HUNDRED (200) PSI WORKING PRESSURE, NON-SHOCK, BLOCK PATTERN, SCREWED BONNET, NON-RISING STEM, BRASS BODY, AND SOLID WEDGE. THEY SHALL BE STANDARD THREADED FOR PVC PIPE AND HAVE A MALLEABLE IRON HANDWHEEL. GATE VALVES 3" THROUGH 16" IN DIAMETER SHALL BE RESILIENT SEAT AND BIDIRECTIONAL FLOW ONLY. VALVES FOR SPECIAL APPLICATIONS WILL REQUIRE CITY UTILITY APPROVAL.
- VALVE BOXES AND COVERS FOR ALL SIZE VALVES SHALL BE OF CAST IRON CONSTRUCTION AND ADJUSTABLE SCREW-ON TYPE. THE LID SHALL HAVE CAST IN THE METAL THE WORD "WATER" FOR THE WATER LINES. ALL VALVE BOXES SHALL BE SIX INCH (6") NOMINAL DIAMETER AND SHALL BE SUITABLE FOR DEPTHS OF THE PARTICULAR VALVE. THE STEM OF THE BURIED VALVE SHALL BE WITHIN TWENTY-FOUR INCHES (24") OF THE FINISHED GRADE UNLESS OTHERWISE APPROVED BY THE CITY.
- 10. ALL WATER MAIN INSTALLATIONS SHALL COMPLY WITH THE COLOR CODING REQUIREMENTS OF CHAPTER 62-555.320 F.A.C.


PANOTIMOOD LIG	ISSUED:	03/01/1994	DEPARTMENT OF PUBLIC UTILITIES STANDARD DETAIL	REVISED: 06/08/2014
DIAMOND 900	DRAWN:	EAM	MATER SYSTEM NOTES	DRAWING NO.
GOLD COAST	APPROVED	PPROVED: XXX WATER SYSTEM NOTES		W-01

WATER SYSTEM NOTES (CONTINUED):

- 11. ALL WATER MAIN INSTALLATIONS SHALL COMPLY WITH THE COLOR CODING REQUIREMENTS OF CHAPTER 62-555.320 F.A.C.
- 12. ALL PVC PIPE SHALL CONFORM TO THE REQUIREMENTS OF ANSI/AWWA C900 LATEST REVISION AND CLASS DR 18. ALL DIP WATER MAINS SHALL BE DUCTILE IRON PRESSURE CLASS 350, WITH WALL THICKNESS COMPLYING WITH CLASS 52. ALL DUCTILE IRON PIPE SHALL CONFORM TO THE REQUIREMENTS OF ANSI/AWWA C151/A21.51-02 AND BE CEMENT LINED AND SEAL COATED PER ANSI/AWWA C104/A21.4-03.
- 13. FITTINGS SHALL BE DUCTILE IRON, MEETING ANSI/AWWA C153/A21.53-00 SPECIFICATIONS, WITH 350 PSI MINIMUM WORKING PRESSURE. FITTINGS MUST BE CEMENT LINED AND SEAL COATED PER ANSI/AWWA C104/A21.4-03. ALL DUCTILE IRON PIPE AND FITTINGS MUST BE MANUFACTURED IN THE UNITED STATES OF AMERICA.
- 14. ALL DUCTILE IRON PIPE TO BE MECHANICAL JOINTS, WRAPPED IN POLY. ADEQUATE PROTECTIVE MEASURES AGAINST CORROSION SHALL BE USED AS DETERMINED BY DESIGN.
- 15. PAVEMENT RESTORATION SHALL BE CARRIED OUT IN ACCORDANCE WITH THE REQUIREMENTS OF THE CITY
- 16. ALL TRENCHING, PIPE LAYING, BACKFILL, PRESSURE TESTING, AND DISINFECTING MUST COMPLY WITH THE CITY OF HOLLYWOOD SPECIFICATIONS.
- 17. THE MINIMUM DEPTH OF COVER OVER WATER MAINS IS 30" (DIP) OR 36" (PVC).
- 18. MINIMUM HORIZONTAL SEPARATION BETWEEN STORM STRUCTURES AND WATER MAINS SHALL BE 3'.
- 19. MAXIMUM DEFLECTION PER EACH JOINT SHALL BE 50% OF MANUFACTURES RECOMMENDATION (MAXIMUM) WHERE DEFLECTION IS REQUIRED.
- 20. CONTRACTOR SHALL BE RESPONSIBLE FOR IDENTIFYING CONFLICTS WITH WATER MAINS PLACED AT MINIMUM COVER. IN CASE OF CONFLICT, WATER MAIN SHALL BE LOWERED TO PASS UNDER CONFLICTS WITH 18" MINIMUM VERTICAL SEPARATION. NO ADDITIONAL PAYMENT SHALL BE DUE TO CONTRACTOR FOR LOWERING THE MAIN OR THE ADDITIONAL FITTINGS USED THEREON.
- 21. PIPE JOINT RESTRAINT SHALL BE PROVIDED BY THE USE OF DUCTILE IRON FOLLOWER GLANDS MANUFACTURED TO ASTM A 536-80. TWIST-OFF NUTS SHALL BE USED TO ENSURE PROPER ACTUATING OF THE RESTRAINING DEVICES. THE MECHANICAL JOINT RESTRAINING DEVICES SHALL HAVE A WORKING PRESSURE OF 250 PSI MINIMUM, WITH A MINIMUM SAFETY FACTOR OF 2:1, AND SHALL BE EBAA IRON INC., MEGALUG OR APPROVED EQUAL. JOINT RESTRAINTS SHALL BE PROVIDED AT A MINIMUM OF THREE JOINTS (60 FEET) FROM ANY FITTING.
- 22. WHENEVER IT IS NECESSARY, IN THE INTEREST OF SAFETY, TO BRACE THE SIDES OF A TRENCH, THE CONTRACTOR SHALL FURNISH. PUT IN PLACE AND MAINTAIN SUCH SHEETING OR BRACING AS MAY BE NECESSARY TO SUPPORT THE SIDES OF THE EXCAVATION TO ENSURE PERSONNEL SAFETY, AND TO PREVENT MOVEMENT WHICH CAN IN ANY WAY DAMAGE THE WORK OR ENDANGER ADJACENT STRUCTURES. THE CONTRACTOR SHALL BE SOLELY RESPONSIBLE FOR THE SEQUENCE, METHODS AND MEANS OF CONSTRUCTION, AND FOR THE IMPLEMENTATION OF ALL OSHA AND OTHER SAFETY REQUIREMENTS.

OF HOLLY WOOD ATO	ISSUED:	03/01/1994	DEPARTMENT OF PUBLIC UTILITIES STANDARD DETAIL	REVISED: 06/08/2014
DIAMOND GETHE	DRAWN:	EAM		DRAWING NO.
GOLD COAST	APPROVED): XXX	WATER SYSTEM NOTES	W-02

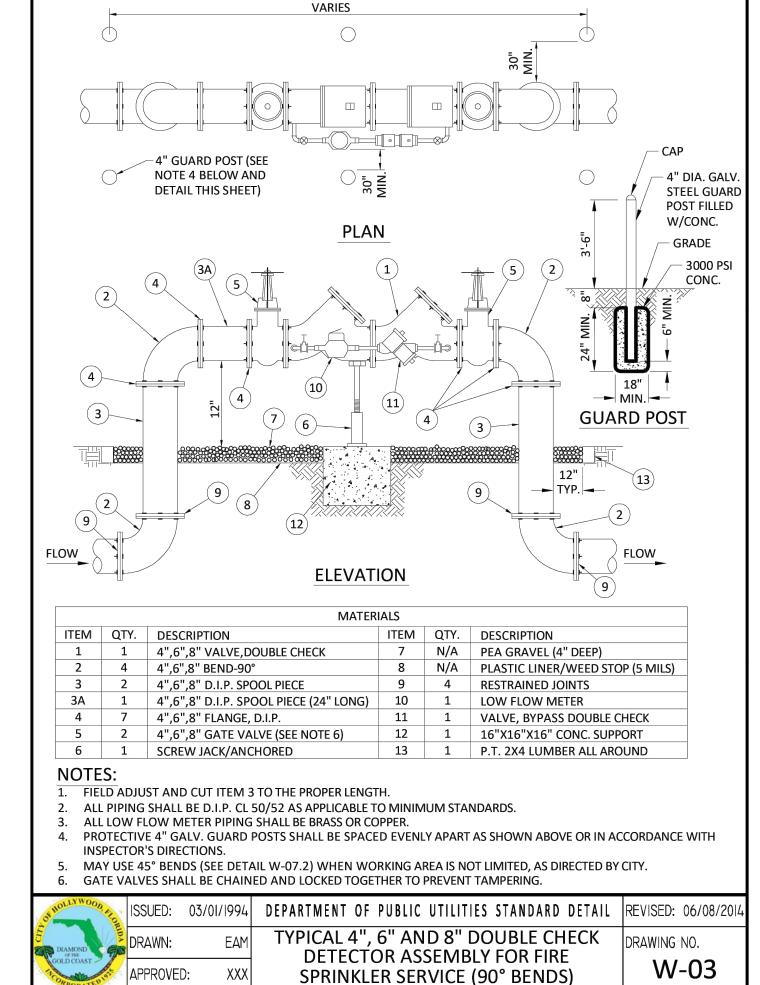


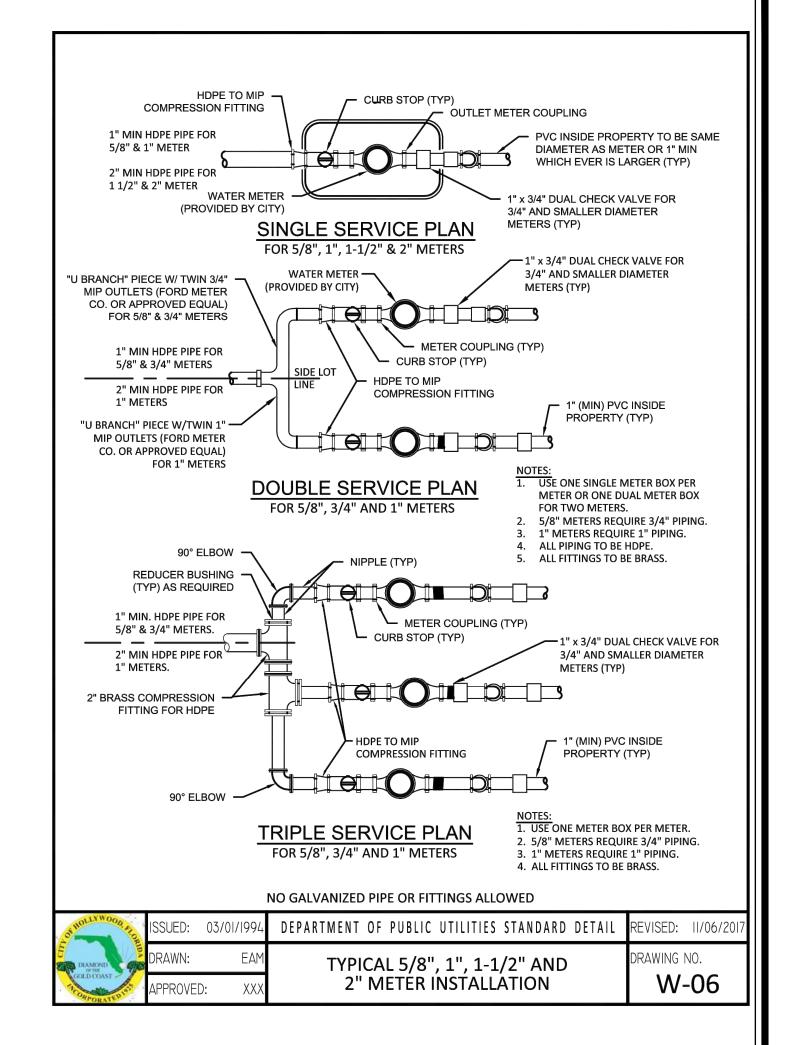





- SUCCESSIVE TAPS INTO THE WATER MAIN SHALL BE SPACED NOT LESS THAN 18" ON CENTER.
- P.E. TUBING SHALL BE IN ACCORDANCE WITH THE LATEST EDITION OF AWWA STANDARD C901. "POLYETHYLENE (PE) PRESSURE PIPE AND TUBING, 1/2 IN. (13mm) THROUGH 3 IN. (76 mm), FOR
- MINIMUM SERVICE PIPE DIAMETER SHALL BE 1" FOR SINGLE OR DUAL ¾" OR SINGLE 1"
- MINIMUM SERVICE PIPE DIAMETER SHALL BE 2" FOR SINGLE OR DUAL 1-½" OR SINGLE 2"
- FOR METER DIAMETERS LARGER THAN 2", THE MINIMUM SERVICE PIPE DIAMETER SHALL BE THE SAME AS THE METER DIAMETER.
- APPROVED COPPER TUBING MAY BE USED AT THE CITY'S DISCRETION.
- FOR NEW METER INSTALLATIONS, ALL SADDLES, VALVES, PIPING, FITTINGS, CURB STOPS, METER VALVES, METER COUPLINGS, METER VAULTS AND COVERS SHALL BE FURNISHED AND INSTALLED BY THE CONTRACTOR. THE WATER METERS WILL BE PROVIDED AND INSTALLED BY THE CITY OF HOLLYWOOD (NEW ACCOUNTS).
- FOR METER RELOCATIONS, ALL SADDLES, VALVES, PIPING, FITTINGS, CURB STOPS, METER VALVES, METER COUPLINGS, METER VAULTS AND COVERS SHALL BE FURNISHED AND INSTALLED BY THE CONTRACTOR. THE EXISTING WATER METER TO BE RELOCATED AND INSTALLED BY
- FOR EXISTING METERS ABUTTING THE RIGHT-OF-WAY THAT ARE BEING DISCONNECTED FROM EXISTING MAINS AND RECONNECTED TO NEW MAINS, THE CONTRACTOR SHALL:
- a. CUT AND PLUG THE EXISTING SERVICE LINE AT THE MAIN AND AT THE METER, AND REMOVE THE EXISTING BALL VALVE CURB STOP.
- b. FURNISH AND INSTALL SERVICE SADDLE, CORPORATION STOP OR SERVICE VALVE AND VALVE BOX, PIPING AND FITTINGS UP TO AND INCLUDING THE BALL VALVE CURB STOP.
- THE ELEVATION AT THE TOP OF THE METER BOX SHALL MATCH THE ELEVATION OF THE BACK OF
- AS PART OF THE SERVICE INSTALLATION, THE CONTRACTOR SHALL RESTORE THE RIGHT-OF-WAY TO MATCH EXISTING CONDITIONS, INCLUDING ROADWAY PAVEMENT, PAVEMENT MARKINGS AND RPMs, CONCRETE CURBS, SIDEWALKS, RAMPS (INCLUDING DETECTABLE WARNING SURFACE), SODDING, AND ALL OTHER IMPROVEMENTS REMOVED OR DAMAGED DURING THE SERVICE INSTALLATION.
- 14. FOR UNPAVED AREAS, THE MINIMUM GROUND COVER ACCEPTED BY THE CITY IS SODDING.

OF HOLLY WOOD THE	ISSUED:	03/01/1994	DEFINITION OF TODES OFFICE OFF	REVISED: 11/06/2017
DIAMOND or the GOLD COAST	DRAWN:	EAM	WATER METER SERVICE NOTES FOR	DRAWING NO.
TICORPORATEU ST	APPROVE	D: XXX	5/8" THROUGH 2" METERS	W-O7

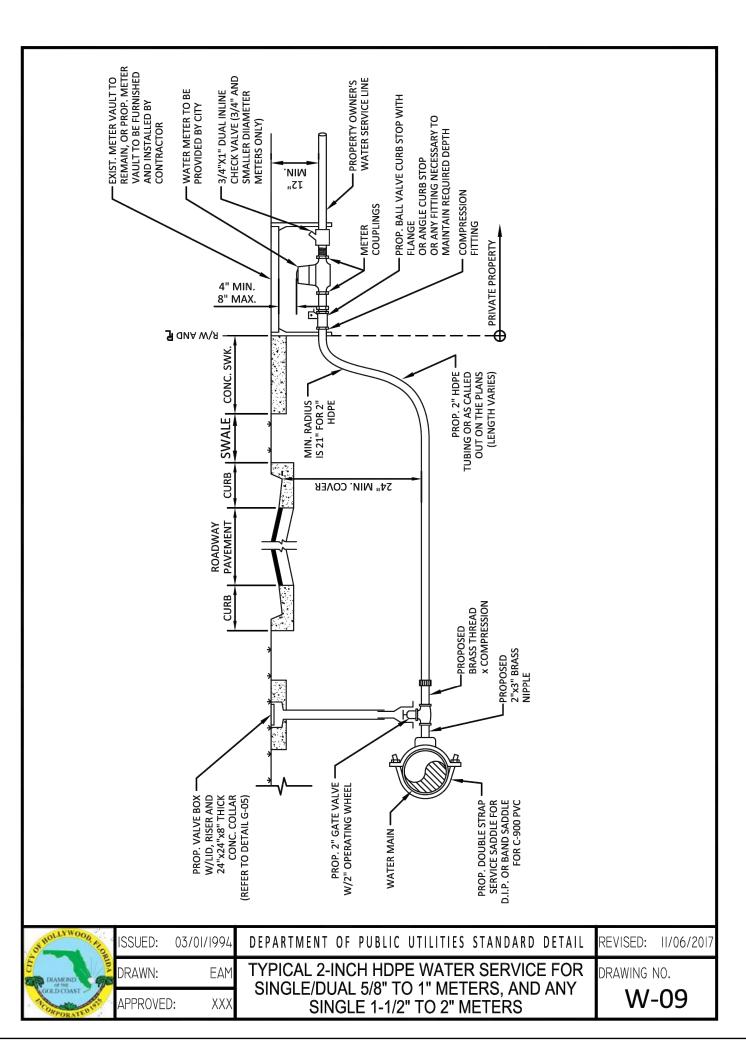

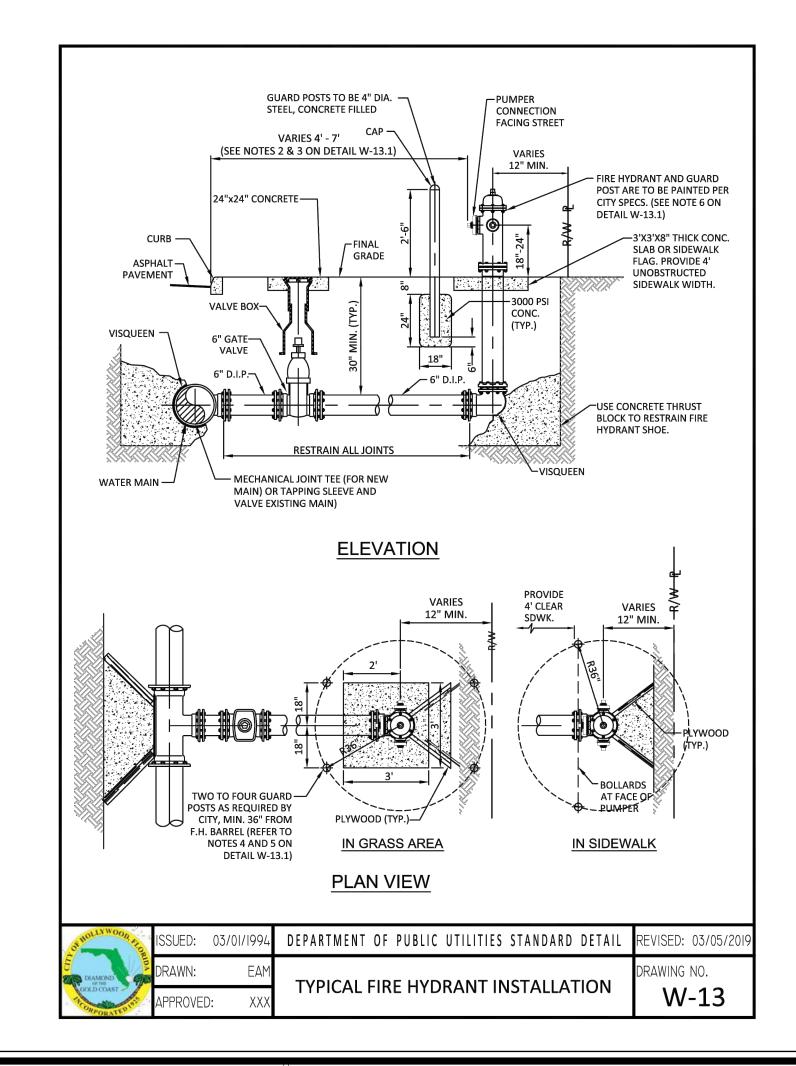

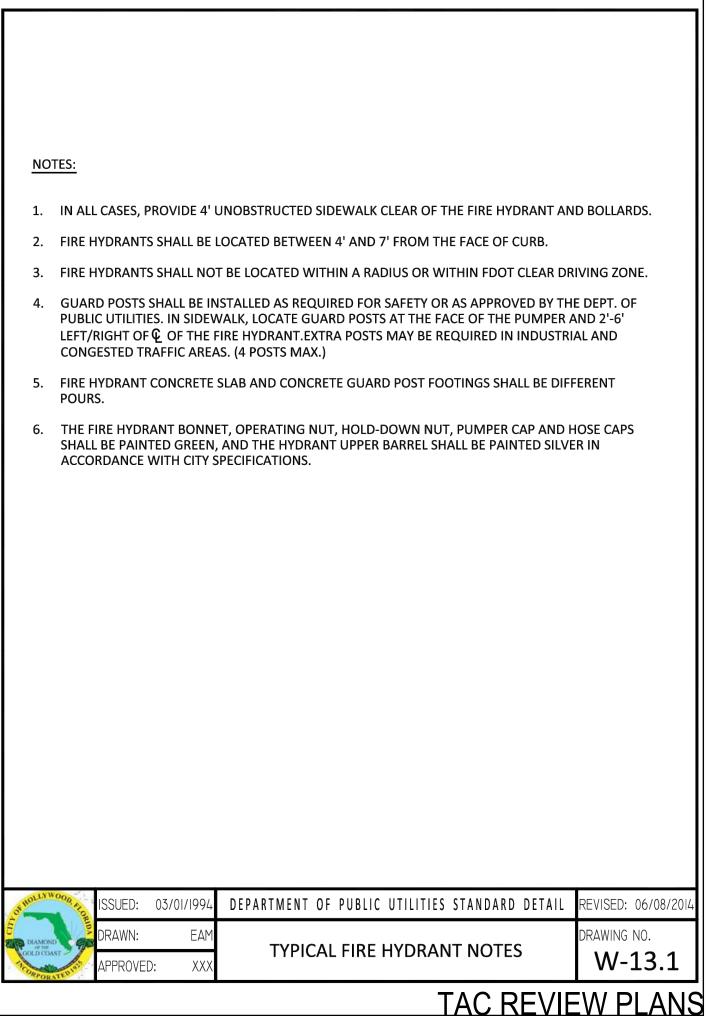

REVISION BY No. BY DESIGNED: GK DATE: 7/20/2022 DRAWN: DATF: 7/20/2022 CHECKED: JFT



1914-1920 PIERCE STREET


HOLLYWOOD, FL. 33020


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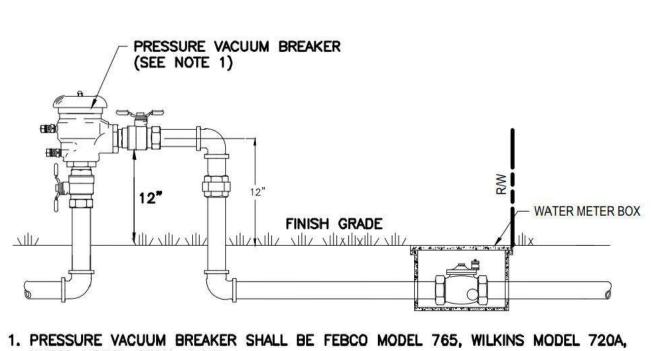
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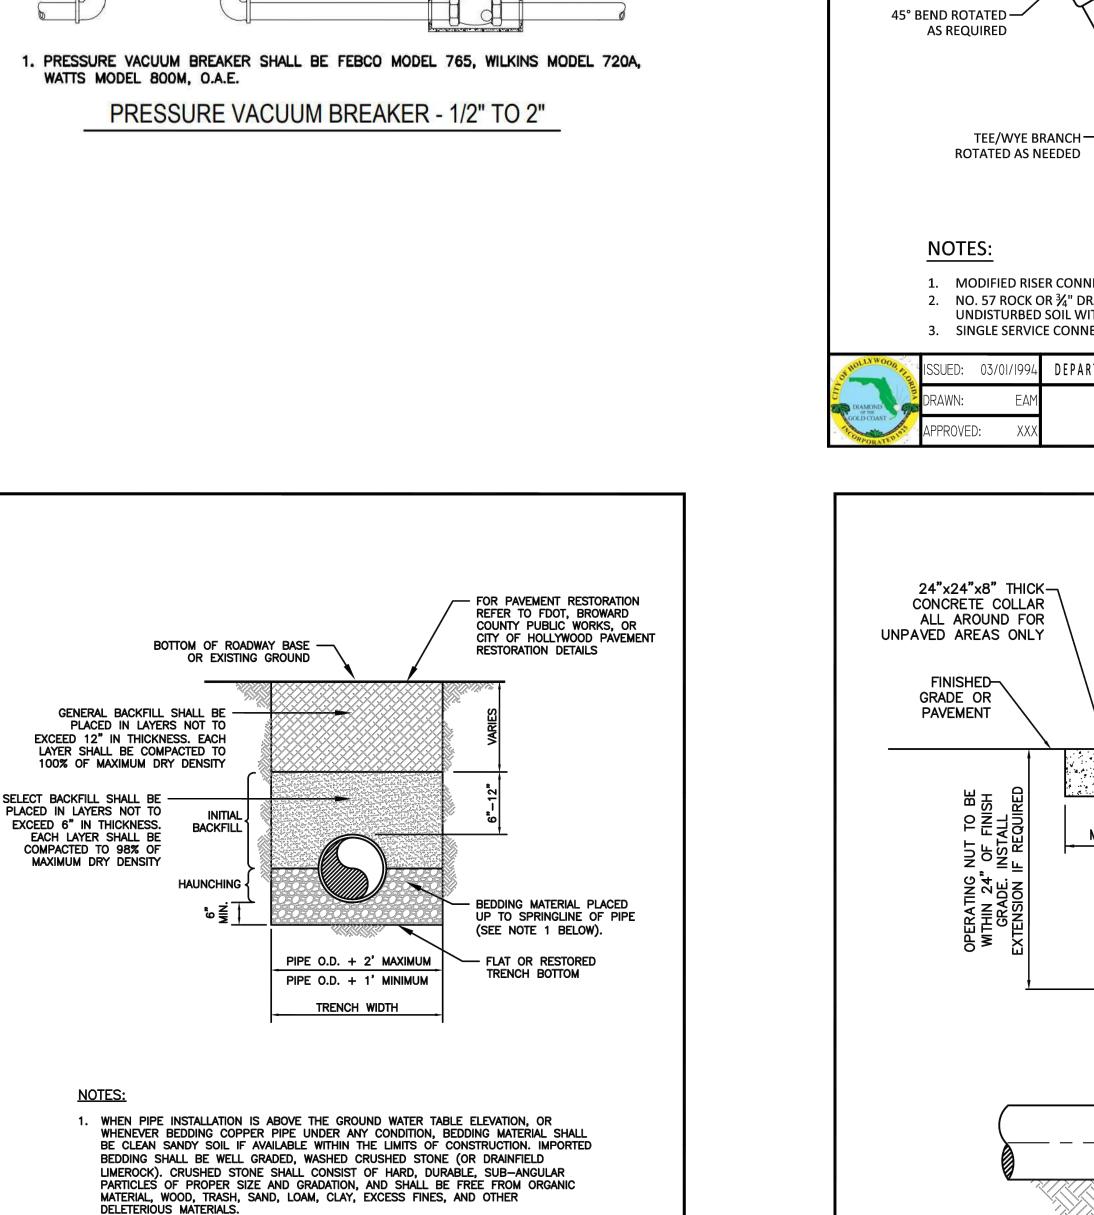
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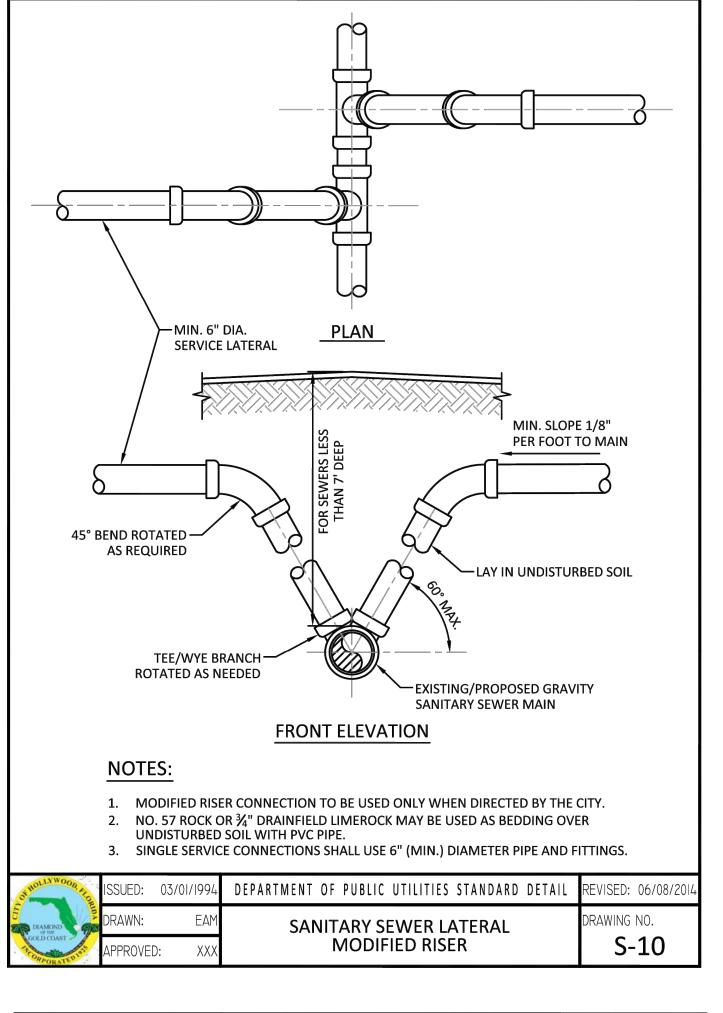









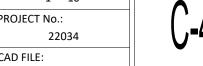

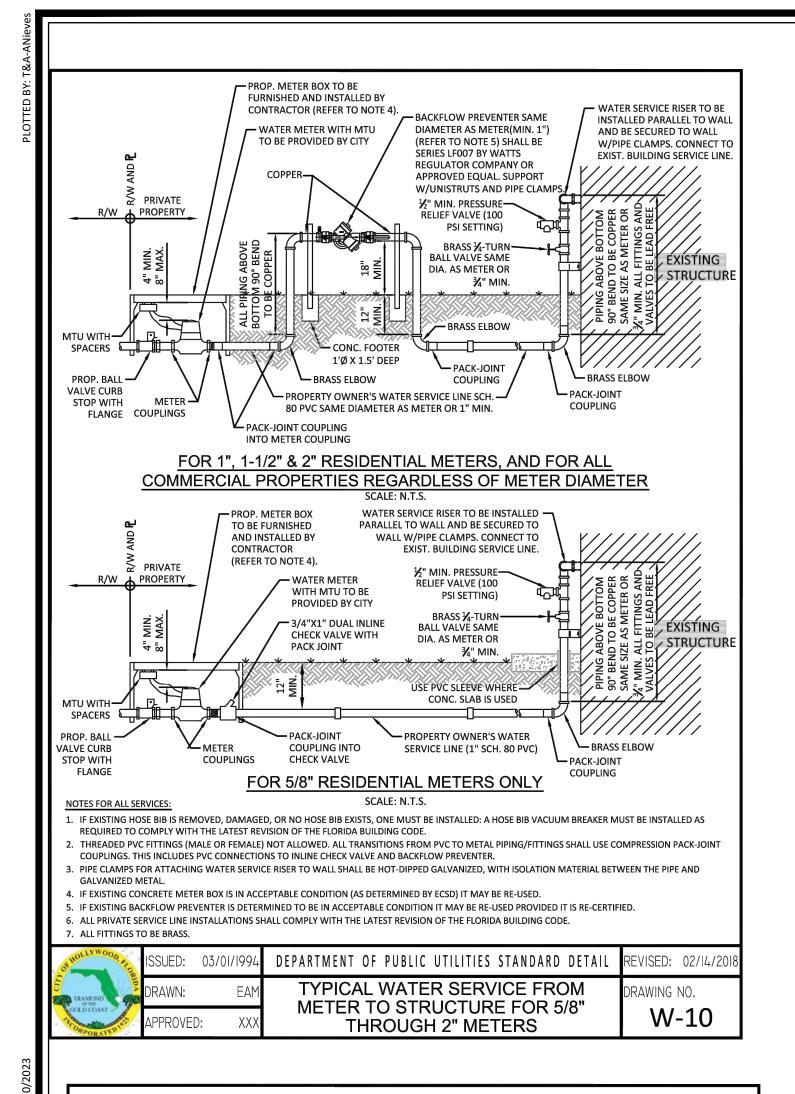

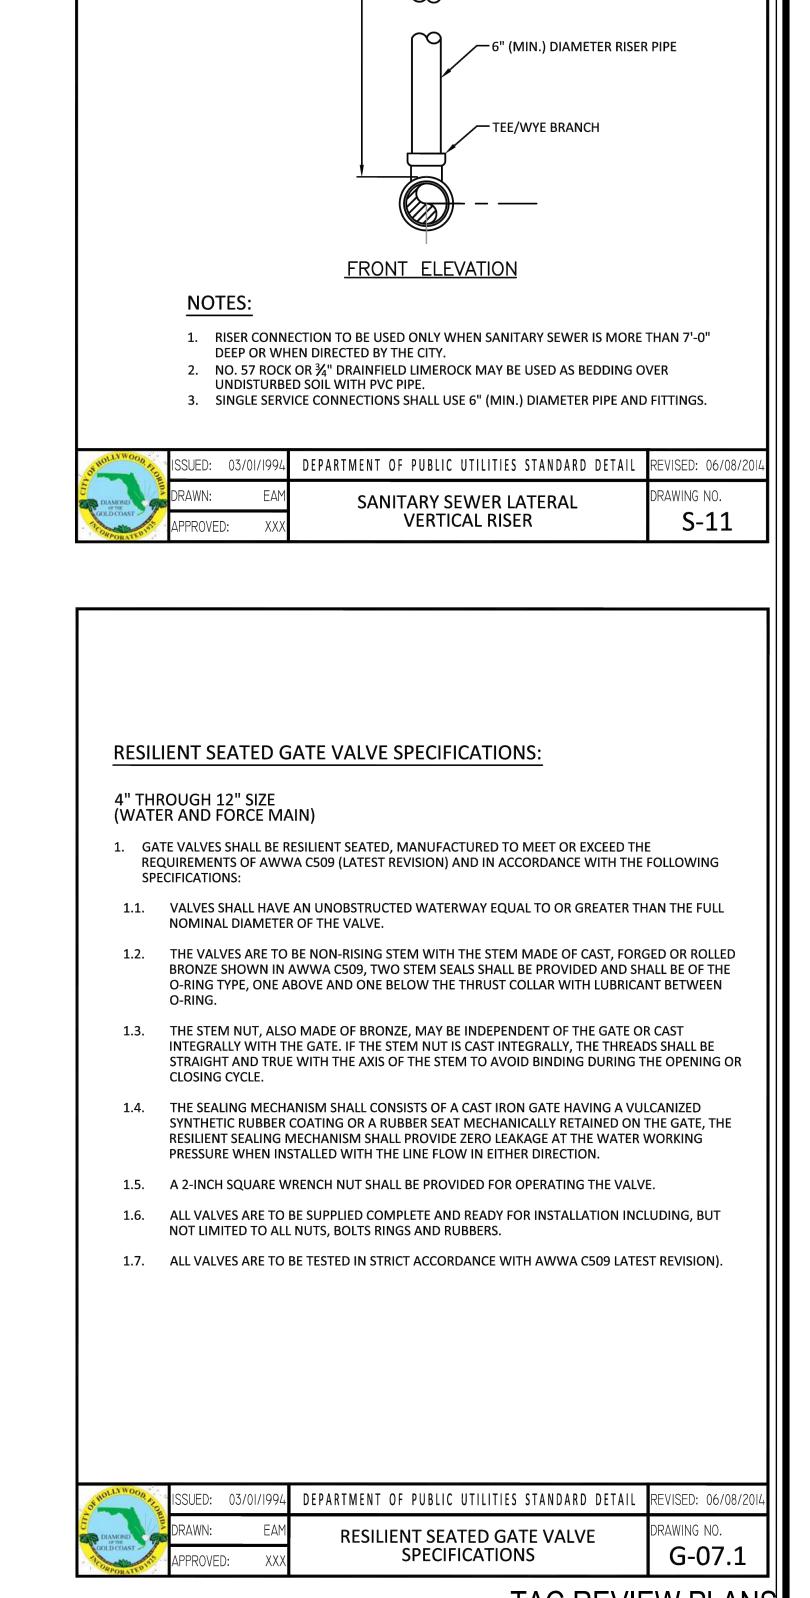


MIN. SLOPE 1/8"


─6"X6" (MIN.)

BRANCH


DIAMETER WYE


PER FOOT TO MAIN

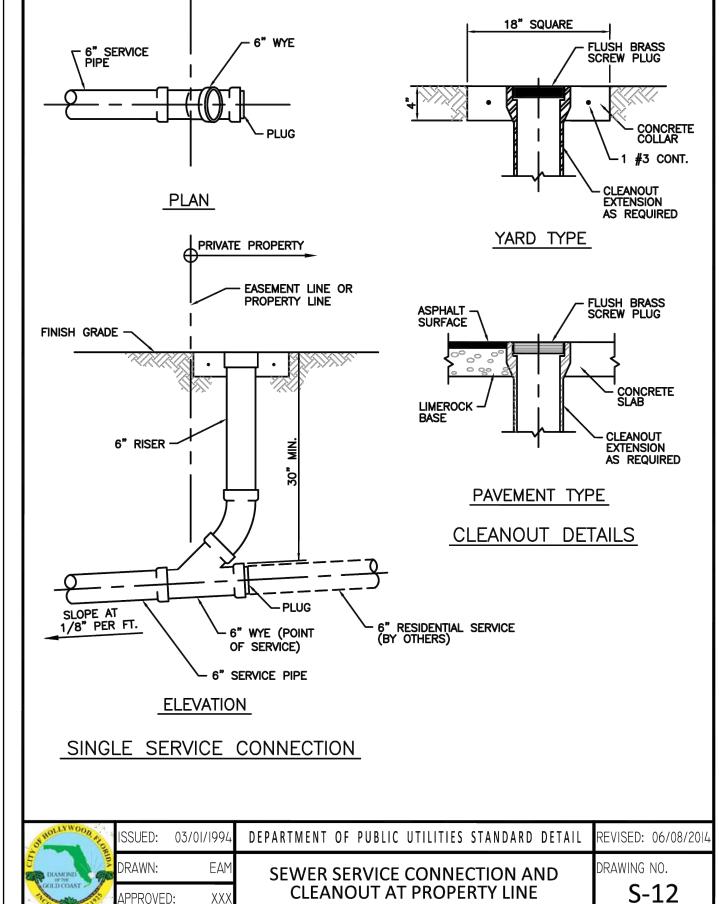


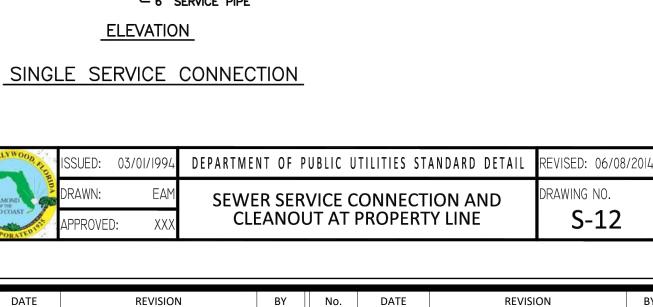

BY No.

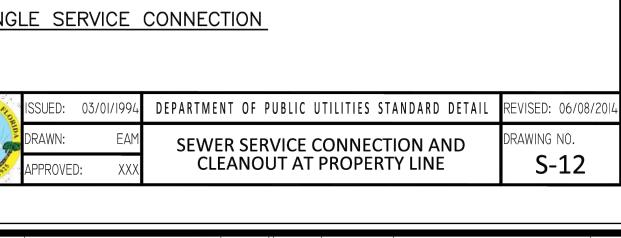

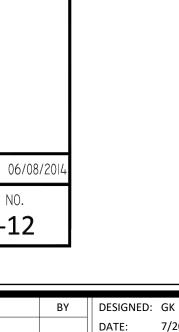

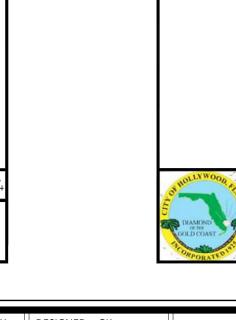

7/20/2022

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DATF:

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2. ALL BEDDING MATERIAL SHALL BE COMPACTED TO 95% OF MAXIMUM DENSITY BEFORE

DEPARTMENT OF PUBLIC UTILITIES STANDARD DETAIL

PIPE LAYING CONDITION TYPICAL

SECTION (P.V.C.)

ANY PIPE IS LAID. FOR ADDITIONAL MATERIAL SPECIFICATIONS REFER TO SPECIFICATION SECTION 02222, "EXCAVATION AND BACKFILL FOR UTILITIES".

4. BACKFILL TO COMPLY WITH FDOT DESIGN STANDARD 125-8.

DENSITY TESTING SHALL BE IN ACCORDANCE WITH AASHTO T-180 AND ASTM

1914-1920 PIERCE STREET HOLLYWOOD, FL. 33020


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G-03

RAWING NO.

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G-07

DEPARTMENT OF PUBLIC UTILITIES STANDARD DETAIL

TYPICAL GATE VALVE AND

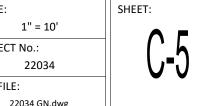VALVE BOX SETTING

—SAW-CUT AND MATCH

EXISTING PAVEMENT

-24"x24"x8" THICK

CONCRETE COLLAR

1" BELOW GRADE

ALL AROUND FOR

PAVED AREAS ONLY

- VALVE BOX (REFER TO

STANDARD DETAIL G-05)

-GATE VALVE (MECHANICAL JOINTS

TEES AND TAPPING SLEEVES										
RUN DIA. (INCHES)	BRANCH DIA. (INCHES)	MINIMUM RESTRAINED LENGTH ALONG	MINIMUM RESTRAINED LENGTH ALONG BRANCH (FT.)		RUN DIA. (INCHES)	BRANCH DIA. (INCHES)	MINIMUM RESTRAINED LENGTH ALONG	MINIMUM RESTRAINED LENGTH ALONG BRANCH (FT.)		
	(IIVCHES)	RUN (FT.)	PVC	*DIP		(IIVCHES)	RUN (FT.)	PVC	*DIP	
	24"					12"				
	16"				12"	8"				
24"	12"			•	12	6"	•		•	
24	8"			•		4"	•		•	
	6"					8"			•	
	4"				8"	6"				
	16"					4"				
	12"			•	6"	6"	•		•	
16"	8"			·	0	4"			•	
	6"				4"	4"				
	4"									

*ALL DIP JOINT-RESTRAINT CALCULATIONS ASSUME THE PIPE WILL BE WRAPPED IN POLYETHYLENE ENCASEMENT

OF HOLLYWOOD PAR	ISSUED:	03/01/19
DIAMOND OF THE	DRAWN:	E <i>l</i>
GOLD CHAST	APPROVED	: X

AL.	ISSUED:	03/01/1994	DEPARTMENT OF PUBLIC UTILITIES STANDARD DETAIL	REVISED: 06/08/2	10
TO VOL	DRAWN:	EAM	JOINT RESTRAINT DESIGN FOR PVC AND DIP	DRAWING NO.	
/.	APPROVE): XXX		G-11.1	

FLEXIBLE PAVEMENT RESTORATION NOTES:

- 1. THE ABOVE DETAILS APPLY ONLY TO ASPHALT PAVEMENT RESTORATION OVER UTILITY TRENCHES CUT WITHIN CITY OF HOLLYWOOD RIGHTS-OF-WAY. FOR PAVEMENT RESTORATION WITHIN BROWARD COUNTY OR FDOT RIGHTS-OF-WAY REFER TO THE CORRESPONDING DETAILS FOR THOSE AGENCIES.
- 2. LIMEROCK BASE MATERIAL SHALL HAVE A MINIMUM L.B.R. OF 100 AND A MINIMUM CARBONATE CONTENT OF 70%. REPLACED BASE MATERIAL OVER TRENCH SHALL BE A MINIMUM OF 12" THICK".
- 3. LIMEROCK BASE MATERIAL SHALL BE PLACED IN 12" MAXIMUM (LOOSE MEASUREMENT) THICKNESS LAYERS WITH EACH LAYER THOROUGHLY ROLLED OR TAMPED AND COMPACTED TO 100% OF MAXIMUM DENSITY, PER AASHTO T-180, PRIOR TO THE PLACEMENT OF THE SUCCEEDING LAYERS.
- 4. STABILIZED SUBGRADE MATERIAL SHALL BE GRANULAR AND SHALL HAVE A MINIMUM L.B.R. OF 40.
- 5. BACKFILL SHALL BE PLACED AND COMPACTED IN ACCORDANCE WITH THE PIPE LAYING CONDITION TYPICAL SECTIONS IN DETAILS G-02 AND G-03, AND THE SPECIFICATIONS, BUT TESTING WILL BEGIN 12" ABOVE THE INSTALLED FACILITY.
- 6. ALL EDGES AND JOINTS OF EXISTING ASPHALT PAVEMENT SHALL BE SAW CUT TO STRAIGHT LINES, PARALLEL TO OR PERPENDICULAR TO THE ROADWAY, PRIOR TO THE RESURFACING.
- 7. RESURFACING MATERIAL SHALL BE FDOT SUPERPAVE, AND SHALL BE APPLIED A MINIMUM OF TWO INCH IN THICKNESS.
- 8. MILL AND BUTT JOINT TO EXISTING PAVEMENT.
- 9. IF THE TRENCH IS FILLED TEMPORARILY, IT SHALL BE COVERED WITH A 2" ASPHALTIC CONCRETE PATCH TO KEEP THE FILL MATERIAL FROM RAVELING UNTIL REPLACED WITH A PERMANENT PATCH.
- 10. REFER TO SPECIFICATIONS FOR DETAILED PROCEDURES.
- 11. WHERE THE UTILITY TRENCH CROSSES EXISTING ASPHALT DRIVEWAYS, THE LIMEROCK BASE THICKNESS MAY BE A MINIMUM OF 6 INCHES THICK. REGARDLESS OF THE EXTENT OF IMPACT, THE ENTIRE DRIVEWAY SURFACE BETWEEN THE EDGE OF THE ROADWAY PAVEMENT AND PROPERTY LINE OR FRONT OF SIDEWALK SHALL BE OVERLAID USING 2-INCH THICK MINIMUM ASPHALTIC CONCRETE SURFACE COURSE WHERE INDICATED ON THE PLANS OR AS DIRECTED BY THE CITY/ENGINEER.

OF HOLLYWOOD ATO	ISSUED:	03/01/1994	DEPARTMENT OF PUBLIC UTILITIES STANDARD DETAIL	REVISED:	11/06/20
DIAMOND OF THE	DRAWN:	EAM	FLEXIBLE PAVEMENT RESTORATION	DRAWING	NO.
GOLD COAST	APPROVE	D: XXX	NOTES	G-	12

BY No. DATE BY DESIGNED: GK DATE: DRAWN: DATE: 7/20/2022 CHECKED: JFT



1914-1920 PIERCE STREET


HOLLYWOOD, FL. 33020

WATER AND SEWER DETAILS

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APPLICABLE CODES

- A. ALL CONSTRUCTION WITHIN THE LIMITS OF PUBLIC RIGHTS OF WAY THAT FALLS UNDER CITY OF HOLLYWOOD JURISDICTION SHALL CONFORM TO CITY OF HOLLYWOOD DESIGN GUIDELINES, LATEST EDITION.
- B. ALL CONSTRUCTION SHALL BE DONE IN A SAFE MANNER, SPECIFICALLY, THE RULES AND REGULATIONS OF THE OCCUPATIONAL SAFETY AND HEALTH ADMINISTRATION (OSHA) AND THE MANUAL OF UNIFORM TRAFFIC CONTROL
- DEVICES (M.U.T.C.D.) SHALL BE STRICTLY OBSERVED. C. ALL ELEVATIONS ON THE PLANS OR REFERENCED IN THE SPECIFICATIONS ARE BASED ON THE NORTH AMERICAN VERTICAL DATUM OF 1988 (NAVD 88).

2. PRE-CONSTRUCTION RESPONSIBILITY

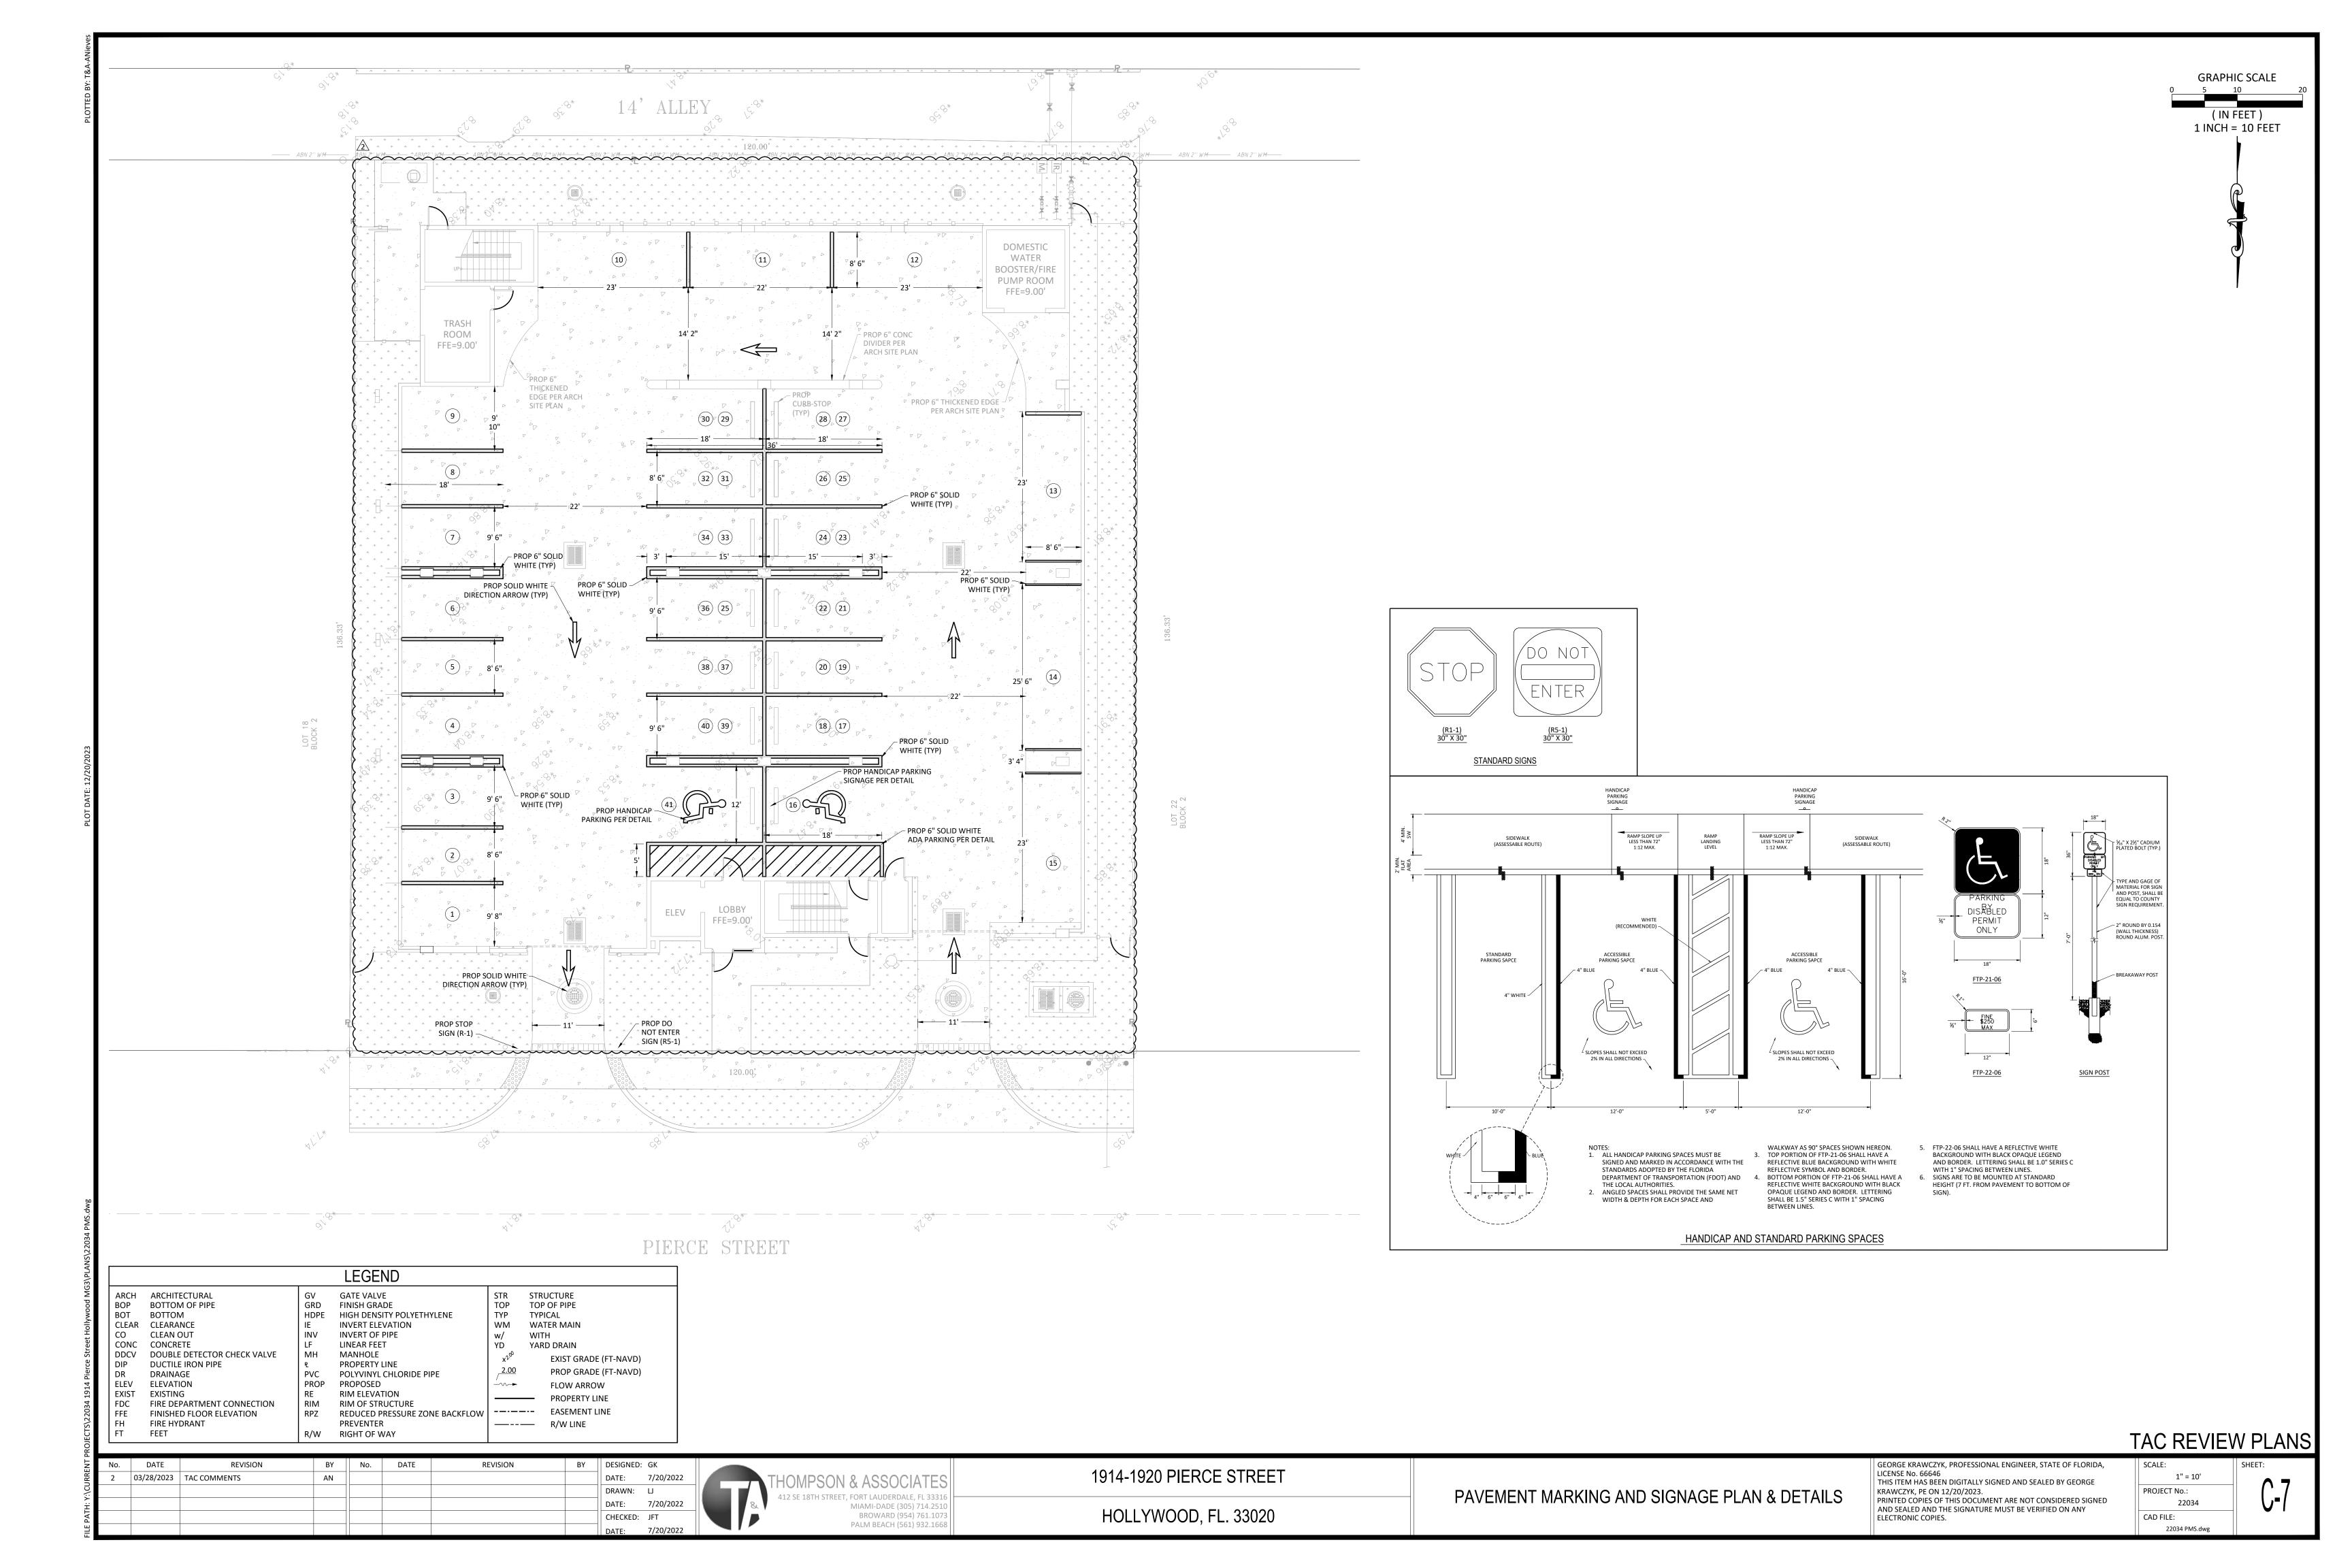THE ENGINEER OF RECORD AND ARRANGE A PRE-CONSTRUCTION CONFERENCE TO INCLUDE CITY OF HOLLYWOOD, UTILITY OWNERS, THE OWNER AND THE ENGINEER OF RECORD.

A. UPON THE RECEIPT OF THE "NOTICE TO PROCEED", PRIOR TO COMMENCING WORK, THE CONTRACTOR SHALL CONTACT

- B. THE CONTRACTOR SHALL OBTAIN A "SUNSHINE ONE CALL" CERTIFICATION NUMBER AT LEAST 2 WORKING DAYS PRIOR TO BEGINNING ANY EXCAVATION.
- C. ALL APPLICABLE PERMITS SHALL BE OBTAINED BY THE CONTRACTOR PRIOR TO START OF CONSTRUCTION. D. PRIOR TO BEGINNING CONSTRUCTION, THE CONTRACTOR SHALL VERIFY THE SIZE, LOCATION, ELEVATION, AND
- MATERIAL OF ALL EXISTING UTILITIES WITHIN THE AREA OF CONSTRUCTION. E. THE CONTRACTOR SHALL BE RESPONSIBLE FOR DAMAGE TO ANY EXISTING UTILITIES FOR WHICH THE CONTRACTOR FAILS
- TO REQUEST LOCATIONS FROM SUNSHINE ONE CALL. THE CONTRACTOR IS ALSO RESPONSIBLE FOR DAMAGE TO ANY EXISTING UTILITIES WHICH ARE PROPERLY LOCATED. IF UPON EXCAVATION, AN EXISTING UTILITY IS FOUND TO BE IN CONFLICT WITH THE PROPOSED CONSTRUCTION OR TO
- BE OF A SIZE OR MATERIAL DIFFERENT FROM THAT SHOWN ON THE PLANS, THE CONTRACTOR SHALL IMMEDIATELY NOTIFY THE ENGINEER OF RECORD, WHO WILL IN TURN NOTIFY THE APPROPRIATE UTILITY OWNER.
- G. THE CONTRACTOR WILL VERIFY THE RESTRAINT OF EXISTING UTILITY LINES, AND SHALL RESTRAIN AS NECESSARY TO PREVENT BLOWOUTS, PRIOR TO CONNECTING TO EXISTING UTILITIES.

INSPECTIONS

- THE CONTRACTOR SHALL NOTIFY CITY OF HOLLYWOOD AND THE ENGINEER OF RECORD AND ANY OTHER GOVERNMENTAL AGENCIES HAVING JURISDICTION AT LEAST 24 HOURS PRIOR TO BEGINNING CONSTRUCTION AND PRIOR TO THE INSPECTION OF THE FOLLOWING ITEMS, WHERE APPLICABLE.
- A. STORM DRAINAGE B. SANITARY SEWER
- WATER SYSTEM
- D. SUBGRADE: SUBMIT AND HAVE APPROVED DENSITIES PRIOR TO PLACEMENT OF ROCK
- . LIMEROCK BASE: SUBMIT AND HAVE APPROVED DENSITIES AND AS-BUILTS PRIOR TO THE PLACEMENT OF ANY ASPHALT F. ASPHALTIC CONCRETE
- G. CLEARING AND FILLING
- H. FINAL CLOSEOUT
- a. PRIOR TO ISSUANCE OF A CONSTRUCTION PERMIT, CONTRACTOR REVIEWED AND APPROVED SHOP DRAWINGS SHALL BE SUBMITTED TO AND REVIEWED BY THE ENGINEER OF RECORD AND CITY OF HOLLYWOOD FOR SANITARY MANHOLES, HYDRANTS, VALVES, PIPING, LIFT STATIONS AND OTHER ACCESSORIES. CATALOG LITERATURE SHALL BE
- SUBMITTED FOR WATER AND SEWER PIPES, FITTINGS AND APPURTENANCES. b. INDIVIDUAL SHOP DRAWINGS FOR ALL PRECAST STRUCTURES ARE REQUIRED. CATALOG LITERATURE WILL NOT BE ACCEPTED FOR PRECAST STRUCTURES.
- c. IT IS THE RESPONSIBILITY OF THE CONTRACTOR TO OBTAIN ALL OTHER AGENCY APPROVAL, IF REQUIRED.

SECTION 2: EARTHWORK AND COMPACTION NOTES:

- A. QUALITY, CONTROL TESTING FOR STABILIZATION, BASE, PAVEMENT, COMPACTION, AND MATERIALS SHALL BE IN ACCORDANCE WITH FLORIDA D.O.T. REQUIREMENTS, AND SHALL BE ARRANGED FOR AND PAID FOR BY THE CONTRACTOR, COPIES OF ALL TEST REPORTS SHALL BE PROVIDED TO THE ENGINEER OF RECORD AS THEY ARE RECEIVED.
- EXISTING ON-SITE BASE MATERIAL SHALL NOT BE REUSED FOR BASE CONSTRUCTION, BUT MAY BE USED FOR BACKFILL AROUND UTILITY AND DRAINAGE LINES, AND FOR SUBGRADE CONSTRUCTION, AND FOR GENERAL FILL IF NECESSARY. C. ALL SUBGRADE UNDER PAVED AREAS SHALL HAVE A MINIMUM L.B.R. VALUE OF 40 AND SHALL BE COMPACTED TO 100%
- OF THE MAXIMUM DENSITY AS DETERMINED BY AASHTO T-99-C. D. ALL SUBGRADE UNDER SIDEWALK AREAS SHALL HAVE A MINIMUM OF 6" COMPACTED SUBGRADE TO 98% OF THE MAXIMUM DENSITY AS DETERMINED BY AASHTO T-180.
- E. ALL FILL MATERIAL IN AREAS NOT TO BE PAVED SHALL BE COMPACTED TO 95% OF THE MAXIMUM DENSITY AS
- DETERMINED BY AASHTO T-99-C F. A 2" BLANKET OF TOP SOIL SHALL BE PLACED OVER ALL AREAS TO BE SODDED.
- G. SOD SHALL BE ST. AUGUSTINE, BITTER BLUE OR FLORATAM AND SHALL BE PLACED ON THE GRADED TOP SOIL AND WATERED TO ENSURE SATISFACTORY CONDITION UPON FINAL ACCEPTANCE OF THE PROJECT.
- H. WHEN WORKING IN AND AROUND EXISTING DRAINAGE CANALS OR LAKES, APPROPRIATE SILT BARRIERS SHALL BE
- NO MUCK BLANKET IS TO BE PLACED ON THE BOTTOM OF RETENTION AREAS OR SWALES.

ON-SITE

- A. ALL ORGANIC AND OTHER UNSUITABLE MATERIAL WITHIN THREE (3) FEET OF FINISHED GRADE AREAS TO BE PAVED SHALL BE REMOVED.
- B. SUITABLE BACKFILL SHALL BE MINIMUM L.B.R. 40 MATERIAL COMPACTED TO 95% OF THE MAXIMUM DENSITY AS
- DETERMINED BY AASHTO T-99-C FOR THREE (3) FEET BEYOND THE PERIMETER OF THE PAVING. C. EROSION CONTROL SHALL BE PROVIDED BY THE CONTRACTOR PER DETAILS ON THE PLANS.

SECTION 3: STORM DRAINAGE NOTES:

1. GENERAL:

- A. EXISTING STORM DRAINAGE GRATES, FRAMES, MANHOLE COVERS, AND RINGS THAT ARE TO BE REMOVED OR ADJUSTED, MAY BE REUSED ON THE SITE.
- B. THE EXISTING DRAINAGE SYSTEM SHALL BE CLEANED AND/OR GRADED TO ENSURE PROPER FLOW FUNCTION
- C. THE CONTRACTOR SHALL INSTALL FILTER FABRIC AT ALL CATCH BASIN GRATES UNTIL FINAL ACCEPTANCE OF THE STORM DRAINAGE SYSTEM.
- CONTRACTOR MAY UTILIZE ONE OF THE FOLLOWING MATERIALS, UNLESS OTHERWISE NOTED ON THE PLANS. A. HIGH DENSITY POLYETHYLENE PIPE (H.D.P.E.)
- a. PIPE SHALL BE CORRUGATED SMOOTH BORE POLYETHYLENE PIPE (N-12 PRO LINK ULTRA) OR APPROVED EQUAL,
- MANUFACTURED IN CONFORMANCE WITH ASTM M294. b. PIPE SHALL HAVE BUILT-IN BELL JOINT WITH RUBBER GASKET IN CONFORMANCE WITH ASTM F477.
- c. PIPE COUPLING BANDS IF NEEDED SHALL BE SPLIT/SPLIT PREMIUM REQUIRING MAXIMUM PULL-APART RESISTANCE B. POLYVINYL CHLORIDE PIPE (P.V.C.)
- a. PLASTIC PIPE SHALL CONFORM WITH ASTM D 3034, TYPE PSM, POLYVINYL CHLORIDE (PVC) MATERIAL; BELL AND SPIGOT STYLE SOLVENT SEALED EN JOINTS.
- ALUMINUM PIPE (C.A.P.) a. ALUMINUM PIPE SHALL CONFORM TO AASHTO M196 FOR CIRCULAR CORRUGATED PIPE OF AASHTO M211 FOR
- HELICALLY CORRUGATED PIPE, AND SECTION 945, AS PER FDOT STANDARD SPECIFICATIONS. b. MAKE FIELD JOINTS IN (CAP) WITH BANDS FABRICATED OF THE SAME ALLOY AS THE CULVERT PIPE AND
- CONFORMING TO THE REQUIREMENTS OF AASHTO M196. c. GASKET THE BANDED JOINTS WITH A NEOPRENE GASKET OF THE DESIGN INDICATED TO SECURE A SOIL-TIGHT OR
- D. REINFORCED CONCRETE PIPE (R.C.P.) a. CONCRETE PIPE FOR STORM SEWERS SHALL CONFORM TO ASTM C 76, CLASS III WITH WALL TYPE A; BAR
- REINFORCEMENT. b. ALL REINFORCEMENT CONCRETE PIPES SHALL HAVE BELL AND SPIGOT END JOINTS, AS MODIFIED BY SECTION 941,
- FDOT STANDARD SPECIFICATIONS. c. ALL REINFORCEMENT CONCRETE PIPES SHALL HAVE RUBBER COMPRESSION GASKET JOINTS, AS PER ASTM C443, UNLESS OTHERWISE SPECIFIED.

MISCELLANEOUS

WATERTIGHT JOINT.

- A. BEDDING AND INITIAL BACKFILL OVER DRAINAGE PIPES (EXCEPT FRENCH DRAINS) SHALL BE SAND WITH NO ROCKS LARGER THAN 2" DIAMETER.
- B. BACKFILL MATERIAL UNDER PAVED AREAS SHALL BE COMPACTED TO 100% OF THE MAXIMUM DENSITY AS DETERMINED BY AASHTO T-99-C.
- C. BACKFILL MATERIAL UNDER AREAS NOT TO BE PAVED SHALL BE COMPACTED TO 95% OF THE MAXIMUM DENSITY AS DETERMINED BY AASHTO T-99-C.
- D. CATCH BASINS SHALL BE PRECAST MINIMUM 3000 PSI CONCRETE WITH REINFORCED STEEL PER ASTM A615.

4. INSTALLATION

DATE

- A. PIPE SHALL BE PLACED ON STABLE GRANULAR MATERIAL FREE OF ROCK FORMATION OTHER FOREIGN FORMATIONS, AND CONSTRUCTED TO UNIFORM GRADE AND LINE
- B. BACKFILL MATERIAL SHALL BE WELL GRADED GRANULAR MATERIAL WELL TAMPED AND PLACED IN 6 INCH (MAXIMUM)

BY No.

C. PROVIDE A MINIMUM COVER OF 24 INCHES OVER STORM DRAINAGE. CROSSING BY HEAVY CONSTRUCTION VEHICLES. DURING CONSTRUCTION SHALL NOT BE ALLOWED WITH LESS THAN 24 INCHES OF COVER.

D. THE CONTRACTOR SHALL NOTIFY THE LOCAL WATER MANAGEMENT DISTRICT AT LEAST 24 HOURS PRIOR TO THE START OF THE CONSTRUCTION AND INSPECTION.

E. ALL DRAINAGE SYSTEMS SHALL BE PUMPED COMPLETELY DRY AND LAMPED AS A REQUIREMENT OF THE FINAL DRAINAGE INSPECTION.

5. STORM DRAINAGE PRE-TREATMENT/EXFILTRATION SYSTEM

- A. ANY CONFLICT WITH EXISTING OR PROPOSED UTILITIES SHALL IMMEDIATELY BE BROUGHT TO THE ATTENTION OF THE ENGINEER OF RECORD. ANY IMPERMEABLE MATERIAL ENCOUNTERED IN THE EXCAVATION FOR THE DRAIN FIELD SHALL BE REMOVED AS DIRECTED BY THE ENGINEER OF RECORD.
- B. THE TRENCH LINER SHALL BE TYPE D-3 PER F.D.O.T. INDEX 199, OR APPROVED EQUAL. IT SHALL BE USED ON THE SIDES AND TOP OF DRAIN FIELD TRENCH. THE TOP SECTION OF THE MATERIAL SHALL BE OVERLAPPED A MINIMUM OF 24 INCHES AND THE CONTRACTOR SHALL TAKE EXTREME CARE IN BACKFILLING TO AVOID BUNCHING OF THE FABRIC.
- C. PERFORATED PIPE WITHIN THE DRAIN FIELD SHALL HAVE 3/8 INCH PERFORATIONS 360° AROUND THE PIPE WITH APPROXIMATELY 120 PERFORATIONS PER FOOT.
- D. PERFORATED PIPE SHALL TERMINATE FIVE (5) FEET FROM THE DRAINAGE STRUCTURE. THE REMAINING FIVE (5) FEET SHALL BE NON-PERFORATED PIPE.
- E. PIPES SHALL TERMINATE TWO (2) FEET FROM THE END OF THE TRENCH OR CONNECT TO ADDITIONAL CATCH BASINS.

SECTION 5: SIGNING AND MARKING NOTES:

- A. ALL PAVEMENT MARKINGS AND SIGNING SHALL BE IN ACCORDANCE WITH CITY OF HOLLYWOOD, AND THE STANDARD
- SPECIFICATIONS OF THE FLORIDA DEPARTMENT OF TRANSPORTATION. B. ALL OFF-SITE MARKINGS TO BE THERMOPLASTIC PER FLORIDA DEPARTMENT OF TRANSPORTATION SPECIFICATIONS, AND ALL ON-SITE MARKINGS SHALL BE TRAFFIC PAINT PER CITY OF HOLLYWOOD SPECIFICATIONS, UNLESS OTHERWISE NOTED.
- C. INSTALL REFLECTIVE PAVEMENT MARKERS PER F.D.O.T. STANDARDS, OR AS SHOWN ON THE PLANS. D. ALL SIGNS SHALL BE HIGH-INTENSITY GRADE REFLECTIVE SHEETING, MOUNTED ON A BREAK AWAY POST ASSEMBLY PER
- E. CONTRACTOR SHALL BE RESPONSIBLE FOR THE REMOVAL OF ALL PAVEMENT MARKINGS AND SIGNS CONFLICTING WITH THE PROPOSED ROADWAY CONSTRUCTION. F. CONTRACTOR SHALL BE RESPONSIBLE FOR THE INSTALLATION OF ALL PAVEMENT MARKINGS AND SIGNS AS SHOWN IN
- THE PLANS AND APPLICABLE TRAFFIC DESIGN STANDARDS. G. CONTRACTOR SHALL BE RESPONSIBLE FOR MATCHING EXISTING PAVEMENT MARKINGS AT THE BEGINNING AND AT THE FND OF THE PROJECT.
- H. SIGN ASSEMBLY LOCATIONS SHOWN IN THE PLANS WHICH ARE IN CONFLICT WITH STREET LIGHTING UTILITIES, DRIVEWAYS, PEDESTRIAN RAMPS ETC. MAY BE ADJUSTED AS DIRECTED BY THE ENGINEER OF RECORD AND/OR APPROVAL AGENCIES' INSPECTOR.

SECTION 7: SANITARY SEWER SYSTEM

1. MATERIALS

A. GRAVITY SEWER PIPE AND FITTINGS

B.C.T.E.D. SPECIFICATIONS.

- a. PVC SEWER PIPE AND FITTINGS SHALL BE NON-PRESSURE POLYVINYL CHLORIDE PIPE CONFORMING TO ASTM
- D-3034, SDR 35, WITH PUSH-ON RUBBER GASKET JOINTS UNLESS OTHERWISE NOTED. b. THE INTERIOR OF THE DUCTILE IRON PIPE (DIP) SHALL BE EPOXY LINED CONFORMING TO ANSI/AWWA C104/A21.4 LATEST REVISION, OR POLYETHYLENE LINED CONFORMING TO ANSI/AWWA C105/A21.5, OR APPROVED EQUAL AND
- SHALL HAVE A COAL TAR EPOXY EXTERIOR COATING, MANUFACTURED IN ACCORDANCE TO ANSI/AWWA C151/A21.51 OR LATEST REVISION, MINIMUM WALL THICKNESS CLASS 350 (UNLESS OTHERWISE SPECIFIED). CLASS 52 SHALL BE USED IN PAVED AREAS.

ALL FITTINGS AND ACCESSORIES SHALL BE AS MANUFACTURED OR SUPPLIED BY THE PIPE MANUFACTURER.

2. INSTALLATION

- A. SERVICES
- a. MINIMUM SLOPE OF ALL SERVICE LINES SHALL BE AS INDICATED IN THE "FLORIDA BUILDING CODE". SERVICE LATERALS SHALL TERMINATE AT A DEPTH NOT TO EXCEED 30 INCHES BELOW FINISHED GRADE.
- EACH SERVICE CONNECTION SHALL BE PLUGGED WATERTIGHT WITH AN APPROVED PLUG. d. The end of each service connection shall be marked with 2 inch x 4 inch treated stake painted red,
- EXTENDING 18 INCHES (MINIMUM) ABOVE GRADE. IF HOUSE CONNECTION IS NOT MADE WITHIN THIRTY DAYS, A CLEAN-OUT INSIDE A VALVE BOX WITH AN ELECTRONIC MARKER MUST BE INSTALLED. e. CONTRACTOR SHALL ROUGH IN RISER TO 1 FOOT ABOVE FINISHED GRADE AND PLUG. AT PROJECT COMPLETION,
- CUT BACK TO FINISHED GRADE. CONNECTION OF SERVICES TO BUILDING'S PLUMBING SHALL BE COORDINATED WITH THE APPROPRIATE MUNICIPAL BUILDING DEPARTMENT, PLUMBING SECTION.

GENERAL NOTES (CONTINUED):

- 27. THE CONTRACTOR SHALL BE RESPONSIBLE FOR MAINTAINING THE INTEGRITY OF AND MAKING THE REPAIRS TO EXISTING PAVEMENT, SIDEWALKS, PIPES, CONDUITS, CURBS, CABLES, ETC., WHETHER OR NOT SHOWN ON THE PLANS DAMAGED AS A RESULT OF THE CONTRACTORS OPERATIONS AND/OR THOSE OF HIS SUBCONTRACTORS, AND SHALL RESTORE THEM PROMPTLY AT NO ADDITIONAL EXPENSE TO THE OWNER. CONTRACTOR SHALL REPORT ANY DAMAGE TO SIDEWALK, DRIVEWAY, ETC., PRIOR TO BEGINNING WORK IN ANY AREA.
- 28. WHERE NEW PAVEMENT MEETS EXISTING, CONNECTION SHALL BE MADE IN A NEAT STRAIGHT LINE AND FLUSH WITH EXISTING PAVEMENT TO MATCH EXISTING CONDITIONS.
- 29. UNDER NO CIRCUMSTANCES SHALL THE CONTRACTOR LEAVE EXCAVATED TRENCHES, OR PARTS OF, EXPOSED OR OPENED AT THE END OF THE WORKING DAY, WEEKENDS, HOLIDAYS OR OTHER TIMES, WHEN THE CONTRACTOR IS NOT WORKING, UNLESS OTHERWISE DIRECTED. ALL TRENCHES SHALL BE COVERED, FIRMLY SECURED AND MARKED ACCORDINGLY FOR PEDESTRIAN / VEHICULAR TRAFFIC.
- 30. ALL EXCAVATED MATERIAL REMOVED FROM THIS PROJECT SHALL BE DISPOSED OF OFF THE PROPERTY BY THE CONTRACTOR AT THE CONTRACTOR'S EXPENSE.
- 31. ALL DUCTILE IRON PRODUCTS SHALL BE DOMESTIC MADE HEAVY DUTY CLASSIFICATION SUITABLE FOR HIGHWAY TRAFFIC LOADS, OR 20,000 LB.
- 32. ALL GRASSED AREAS AFFECTED BY CONSTRUCTION SHALL BE RE-SODDED.
- 33. THE CONTRACTOR SHALL BE RESPONSIBLE FOR THE PROVISION, INSTALLATION AND MAINTENANCE OF ALL TRAFFIC CONTROL AND SAFETY DEVICES, IN ACCORDANCE WITH SPECIFICATIONS OF THE LATEST REVISION OF FDOT DESIGN STANDARDS. IN ADDITION, THE CONTRACTOR IS RESPONSIBLE FOR THE RESETTING OF ALL TRAFFIC CONTROL AND INFORMATION SIGNAGE REMOVED DURING THE CONSTRUCTION PERIOD.
- 34. EXCAVATED OR OTHER MATERIAL STORED ADJACENT TO OR PARTIALLY UPON A ROADWAY PAVEMENT SHALL BE ADEQUATELY MARKED FOR TRAFFIC SAFETY AT ALL TIMES.
- 35. TEMPORARY PATCH MATERIAL MUST BE ON THE JOB SITE WHENEVER PAVEMENT IS CUT, OR THE CITY'S INSPECTOR WILL SHUT THE JOB DOWN.
- 36. CONTRACTOR MUST PROVIDE FLASHER ARROW SIGNAL FOR ANY LANE THAT IS CLOSED OR DIVERTED.
- 37. CONTRACTOR SHALL NOTIFY LAW ENFORCEMENT AND FIRE PROTECTION SERVICES TWENTY-FOUR (24) HOURS IN ADVANCE OF TRAFFIC DETOUR IN ACCORDANCE WITH SECTION 336.07 OF FLORIDA STATUTES.
- 38. CONTRACTOR TO RESTORE PAVEMENT TO ORIGINAL CONDITION AS REQUIRED.
- 39. CONTRACTOR SHALL BE RESPONSIBLE FOR PROVIDING DEWATERING PER SPECIFICATION SECTION 02140

OFHOLLIWOOD,	ISSUED:	03/01/1994	DEPARTMENT OF PUBLIC UTILITIES STANDARD DETAIL	REVISED: 11/06/2017
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GENERAL NOTES:

- 1. THE INFORMATION PROVIDED IN THESE DRAWINGS IS SOLELY TO ASSIST THE CONTRACTOR IN ASSESSING THE NATURE AND EXTENT OF CONDITIONS WHICH WILL BE ENCOUNTERED DURING THE COURSE OF THE WORK. THE CONTRACTORS ARE DIRECTED, PRIOR TO BIDDING, TO CONDUCT WHATEVER INVESTIGATIONS THEY DEEM NECESSARY TO ARRIVE AT THEIR OWN CONCLUSION REGARDING THE ACTUAL CONDITIONS THAT WILL BE ENCOUNTERED, AND UPON WHICH BIDS WILL BE BASED.
- 2. ALL CONSTRUCTION AND MATERIALS SHALL CONFORM TO APPLICABLE STANDARDS AND SPECIFICATIONS OF THE CITY OF HOLLYWOOD DEPARTMENT OF PUBLIC UTILITIES, ENGINEERING AND CONSTRUCTION SERVICES DIVISION (ECSD), AND ALL OTHER LOCAL, STATE AND NATIONAL CODES, WHERE APPLICABLE.
- 3. LOCATIONS, ELEVATIONS, SIZES, MATERIALS, ALIGNMENTS, AND DIMENSIONS OF EXISTING FACILITIES, UTILITIES AND OTHER FEATURES ARE SHOWN ACCORDING TO THE BEST INFORMATION AVAILABLE AT THE TIME OF THE PREPARATION OF THESE PLANS; AND DO NOT PURPORT TO BE ABSOLUTELY CORRECT. ALSO, THERE MAY HAVE BEEN OTHER IMPROVEMENTS, UTILITIES, ETC., WITHIN THE PROJECT AREA WHICH WERE CONSTRUCTED AFTER THE PREPARATION OF THESE PLANS AND/OR THE ORIGINAL SITE SURVEY. THE CONTRACTOR SHALL VERIFY THE LOCATIONS, ELEVATIONS, AND OTHER FEATURES AFFECTING HIS/HER WORK PRIOR TO CONSTRUCTION, AND NOTIFY THE ENGINEER IMMEDIATELY WHEN CONFLICT BETWEEN DRAWINGS AND ACTUAL CONDITIONS ARE DISCOVERED. THE ENGINEER ASSUMES NO RESPONSIBILITY FOR ANY FACILITIES SHOWN OR NOT SHOWN ON THE PLANS. THE CONTRACTOR SHALL WORK AS NEEDED TO AVOID CONFLICT WITH EXISTING UTILITIES (NO ADDITIONAL COST SHALL BE PAID FOR THIS WORK). EXISTING UTILITIES SHALL BE MAINTAINED IN SERVICE DURING CONSTRUCTION UNLESS OTHERWISE APPROVED BY THE RESPECTIVE UTILITY OWNER.
- 4. THE CONTRACTOR SHALL COORDINATE WITH ALL UTILITIES TO ARRANGE FOR THE RELOCATION AND TEMPORARY SUPPORT OF UTILITY FEATURES, ETC. AS NECESSARY TO COMPLETE THE WORK.
- 5. IT SHALL BE THE CONTRACTOR'S RESPONSIBILITY TO LOCATE AND PROTECT ANY AND ALL EXISTING UTILITIES ON THIS PROJECT, AND TO ENSURE THAT EXISTING UTILITIES ARE MAINTAINED IN SERVICE DURING CONSTRUCTION UNLESS APPROVED OTHERWISE BY THE UTILITY OWNER.
- 6. CONTRACTOR SHALL ADJUST ALL EXISTING UTILITY CASTINGS INCLUDING VALVE BOXES, MANHOLES. HAND-HOLES, PULL-BOXES, STORMWATER INLETS, AND SIMILAR STRUCTURES IN CONSTRUCTION AREA TO BE OVERLAID WITH ASPHALT PAVEMENT.
- 7. THE CONTRACTOR IS REQUIRED TO OBTAIN ALL APPLICABLE CONSTRUCTION AND ENVIRONMENTAL PERMITS PRIOR TO THE START OF CONSTRUCTION.
- 8. THE CONTRACTOR SHALL NOTIFY ECSD AT LEAST 48 HOURS PRIOR TO BEGINNING CONSTRUCTION.
- 9. PRIOR TO THE COMMENCEMENT OF CONSTRUCTION AND INSTALLATION OF THE PROPOSED IMPROVEMENTS, SHOP DRAWINGS SHALL BE SUBMITTED TO ECSD IN ACCORDANCE WITH THE CONTRACT DOCUMENT'S REQUIREMENTS, FOR APPROVAL. IN ADDITION, IT IS THE CONTRACTOR'S RESPONSIBILITY TO OBTAIN ANY OTHER AGENCY SHOP DRAWING APPROVAL, IF REQUIRED.
- 10. THE CONTRACTOR SHALL NOTIFY ECSD IMMEDIATELY FOR ANY CONFLICT ARISING DURING CONSTRUCTION OF ANY IMPROVEMENTS SHOWN ON THESE DRAWINGS. THIS WORK BY THE CONTRACTOR SHALL BE CONSIDERED INCIDENTAL TO THE CONTRACT AND NO ADDITIONAL COMPENSATION SHALL BE ALLOWED.
- 11. ELEVATIONS SHOWN ARE IN FEET AND ARE REFERENCED TO THE NORTH AMERICAN VERTICAL DATUM OF 1988 (NAVD 88).

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GENERAL NOTES (CONTINUED):

40. THE CONTRACTOR SHALL GIVE AT LEAST 48 HOURS NOTICE TO UTILITY COMPANIES TO PROVIDE FOR THE LOCATION OF EXISTING UNDERGROUND UTILITIES IN ADVANCE OF CONSTRUCTION. CONTACT UTILITIES NOTIFICATION CENTER AT 811 OR 1-800-432-4770 (SUNSHINE ONE-CALL OF FLORIDA).



- 41. WHEN PVC PIPE IS USED, A METALLIZED MARKER TAPE SHALL BE INSTALLED CONTINUOUSLY 18" ABOVE THE PIPE. THE MARKER TAPE SHOULD BE IMPRINTED WITH A WARNING THAT THERE IS BURIED PIPE BELOW. THE TAPE SHALL BE MAGNA TEC, AS MANUFACTURED BY THOR ENTERPRISES INC. OR APPROVED EQUAL.
- 42. ALL CONNECTIONS TO EXISTING MAINS SHALL BE THE RESPONSIBILITY OF THE CONTRACTOR. WATER CONNECTIONS SHALL BE METERED, AND THE COST OF WATER AND TEMPORARY METER SHALL BE BORNE BY THE CONTRACTOR.
- 43. A COMPLETE AS-BUILT SURVEY SHALL BE ACCURATELY RECORDED OF THE UTILITY SYSTEM DURING CONSTRUCTION. AS-BUILT SURVEY SHALL BE SUBMITTED TO ECSD SIGNED AND SEALED BY A FLORIDA REGISTERED SURVEYOR PRIOR TO FINAL INSPECTION AND ACCEPTANCE OF PROJECT. THE COST OF SIGNED AND SEALED AS-BUILTS SHALL BE COVERED IN OVERALL BID. THE AS-BUILT SURVEY SHALL
- PLAN VIEW SHOWING THE HORIZONTAL LOCATIONS OF EACH MANHOLE, INLET, VALVE, FITTING, BEND AND HORIZONTAL PIPE DEFLECTIONS WITH COORDINATES AND IN REFERENCE TO A SURVEY BASELINE OR RIGHT-OF-WAY CENTERLINE.
- THE PLAN VIEW SHALL ALSO SHOW SPOT ELEVATIONS OF THE TOP OF THE MAIN (WATER MAIN AND FORCE MAIN) OR PIPE INVERTS (GRAVITY MAINS) AT INTERVALS NOT TO EXCEED 100 FEET AS MEASURED ALONG MAIN. THE PLAN VIEW SHALL ALSO INCLUDE SPOT ELEVATIONS AT EACH MANHOLE, INLET, VALVE, FITTING, BEND AND VERTICAL PIPE DEFLECTION.
- THE PLAN VIEW SHALL ALSO SHOW THE HORIZONTAL SEPARATION FROM UNDERGROUND UTILITIES IMMEDIATELY ADJACENT OR PARALLEL TO THE NEW MAIN.
- d. PROFILE VIEW WITH SPOT ELEVATIONS OF THE TOP OF THE MAIN (WATER MAIN AND FORCE MAIN) OR PIPE INVERT (GRAVITY MAIN) AND OF THE FINISHED GRADE OR MANHOLE RIM DIRECTLY ABOVE THE MAIN AT INTERVALS NOT TO EXCEED 100 FEET AS MEASURED ALONG THE MAIN. THE PROFILE VIEW SHALL ALSO INCLUDE SPOT ELEVATIONS AT EACH MANHOLE, INLET, VALVE, FITTING, BEND AND VERTICAL PIPE DEFLECTION.
- THE PROFILE VIEW SHALL SHOW ALL UNDERGROUND UTILITIES CROSSING THE NEW MAIN AND THE VERTICAL SEPARATION PROVIDED BETWEEN THAT UNDERGROUND UTILITY AND THE NEW MAIN.
- ALL CADD FILES MUST BE CREATED FOLLOWING THE CITY OF HOLLYWOOD "SURVEY / AS-BUILT CAD DRAWING STANDARDS"


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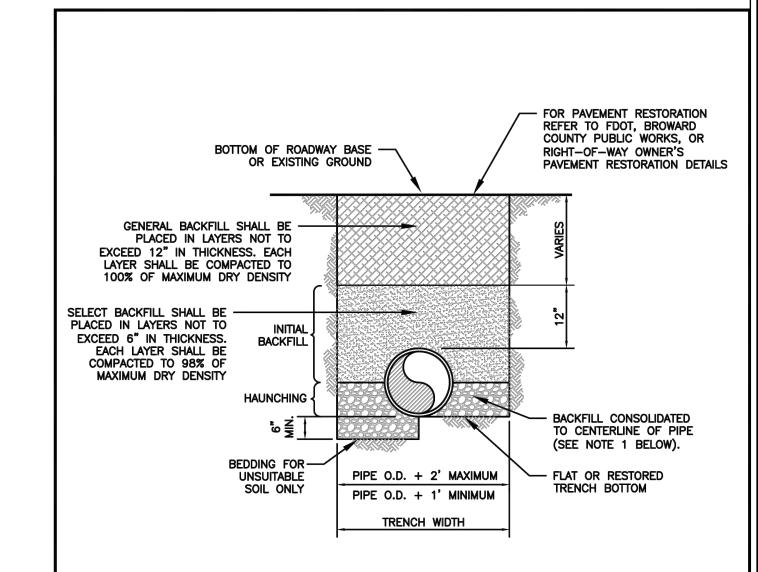
GENERAL NOTES (CONTINUED):

- 12. CITY OF HOLLYWOOD SHALL NOT PROVIDE STAGING / STORAGE AREA. CONTRACTOR SHALL SECURE STAGING / STORAGE AREA AS NECESSARY FOR CONSTRUCTION WORK.
- 13. CONTRACTOR SHALL HAUL AWAY EXCESSIVE STOCKPILE OF SOIL FOR DISPOSAL EVERY DAY. NO STOCKPILE SOIL IS ALLOWED TO BE LEFT ON THE CONSTRUCTION SITE OVER NIGHT.
- 14. CONTRACTOR SHALL CLEAN / SWEEP THE ROAD AT LEAST ONCE DAY OR AS REQUIRED BY THE ENGINEER.
- 15. CONTRACTOR SHALL PROTECT CATCH BASINS WITHIN / ADJACENT TO THE CONSTRUCTION SITE AS REQUIRED BY NPDES REGULATIONS.
- 16. THE CITY OF HOLLYWOOD HAS A NOISE ORDINANCE (CHAPTER 100) WHICH PROHIBITS EXCAVATION AND CONSTRUCTION BEFORE 8:00 A.M. AND AFTER 6:00 P.M., MONDAY THROUGH SATURDAY AND ALL DAY
- 17. SUITABLE EXCAVATED MATERIAL SHALL BE USED IN FILL AREAS. NO SEPARATE PAY ITEM FOR THIS WORK, INCLUDE COST IN OTHER ITEMS.
- 18. ALL ROAD CROSSINGS ARE OPEN CUT AS PER THE REQUIREMENTS OF THE ECSD UNLESS OTHERWISE NOTED ON THE DRAWINGS.
- 19. THE CONTRACTOR SHALL REPLACE ALL PAVING, STABILIZING EARTH, DRIVEWAYS, PARKING LOTS, SIDEWALKS, ETC. TO SATISFY THE INSTALLATION OF THE PROPOSED IMPROVEMENTS WITH THE SAME TYPE OF MATERIAL THAT WAS REMOVED DURING CONSTRUCTION OR AS DIRECTED BY ECSD FIELD
- 20. THE CONTRACTOR SHALL NOT ENCROACH INTO PRIVATE PROPERTY WITH PERSONNEL, MATERIAL OR EQUIPMENT. IN CASE WORK ON PRIVATE PROPERTY IS NEEDED, A CITY OF HOLLYWOOD "RIGHT OF ENTRY" FORM MUST BE SIGNED BY PROPERTY OWNER AND THE DIRECTOR OF PUBLIC UTILITIES. THE CONTRACTOR IS RESPONSIBLE TO MAINTAIN ACCESS AT ALL TIMES TO PRIVATE HOMES/BUSINESSES.
- 21. THE CONTRACTOR SHALL BE RESPONSIBLE FOR DAMAGE, REMOVAL OR MODIFICATION, CAUSED TO ANY IRRIGATION SYSTEM (PRIVATE OR PUBLIC) ACCIDENTALLY OR PURPOSELY. THE CONTRACTOR SHALL REPLACE ANY DAMAGED, REMOVED OR MODIFIED IRRIGATION PIPES, SPRINKLER HEADS OR OTHER PERTINENT APPURTENANCES TO MATCH OR EXCEED EXISTING CONDITIONS AT NO ADDITIONAL COST TO THE CITY.
- 22. MAIL BOXES, FENCES OR OTHER PRIVATE PROPERTY DAMAGED DURING THE CONSTRUCTION OF THE PROPOSED IMPROVEMENTS SHALL BE REPLACED TO MATCH OR EXCEED EXISTING CONDITION.
- 23. CONTRACTOR SHALL PROVIDE MAINTENANCE OF TRAFFIC IN ACCORDANCE WITH FDOT STANDARDS AND CITY OF HOLLYWOOD DEPARTMENT OF PUBLIC UTILITIES STANDARDS.
- 24. NO TREES ARE TO BE REMOVED OR RELOCATED WITHOUT PRIOR APPROVAL FROM THE ECSD FIELD
- 25. THE CONTRACTOR IS RESPONSIBLE FOR OBTAINING THE NECESSARY TREE REMOVAL OR RELOCATION PERMITS FROM THE CITY OF HOLLYWOOD BUILDING DEPARTMENT FOR TREES LOCATED IN THE PUBLIC RIGHT OF WAY.

26. IT IS THE INTENT OF THESE PLANS TO BE IN ACCORDANCE WITH APPLICABLE CODES AND AUTHORITIES

HAVING JURISDICTION. ANY DISCREPANCIES BETWEEN THESE PLANS AND APPLICABLE REGULATORY



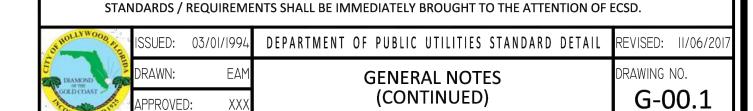

- WHEN PIPE INSTALLATION IS ABOVE THE GROUND WATER TABLE ELEVATION, OR WHENEVER BEDDING COPPER PIPE UNDER ANY CONDITION, BEDDING MATERIAL SHALL BE CLEAN SANDY SOIL IF AVAILABLE WITHIN THE LIMITS OF CONSTRUCTION, IMPORTED BEDDING SHALL BE WELL GRADED, WASHED CRUSHED STONE (OR DRAINFIELD LIMEROCK). CRUSHED STONE SHALL CONSIST OF HARD, DURABLE, SUB-ANGULAR PARTICLES OF PROPER SIZE AND GRADATION, AND SHALL BE FREE FROM ORGANIC MATERIAL, WOOD, TRASH, SAND, LOAM, CLAY, EXCESS FINES, AND OTHER DELETERIOUS
- 2. ALL BEDDING MATERIAL SHALL BE COMPACTED TO 95% OF MAXIMUM DENSITY BEFORE ANY PIPE IS LAID. FOR ADDITIONAL MATERIAL SPECIFICATIONS REFER TO SPECIFICATION SECTION 02222, "EXCAVATION AND BACKFILL FOR UTILITIES".

4. BACKFILL TO COMPLY WITH FDOT DESIGN STANDARDS 125-8.

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OLLYWOOD, ALE	ISSUED:	03/01/1994	DEPARTMENT OF PUBLIC UTILITIES STANDARD DETAIL	REVISED: 06/08/2

SECTION (D.I.P.)

DENSITY TESTING SHALL BE IN ACCORDANCE WITH AASHTO T-180 AND ASTM D-3017.

TAC REVIEW PLANS

DATE: 7/20/2022 DRAWN: DATF: 7/20/2022 CHECKED: JFT

DESIGNED: GK



1914-1920 PIERCE STREET


HOLLYWOOD, FL. 33020


GENERAL NOTES

GEORGE KRAWCZYK, PROFESSIONAL ENGINEER, STATE OF FLORIDA, LICENSE No. 66646 THIS ITEM HAS BEEN DIGITALLY SIGNED AND SEALED BY GEORGE KRAWCZYK, PE ON 12/20/2023. PRINTED COPIES OF THIS DOCUMENT ARE NOT CONSIDERED SIGNED AND SEALED AND THE SIGNATURE MUST BE VERIFIED ON ANY | ELECTRONIC COPIES

SCALE: 1" = 10' PROJECT No.: 22034 CAD FILE: 22034 GN.dwg

G-02

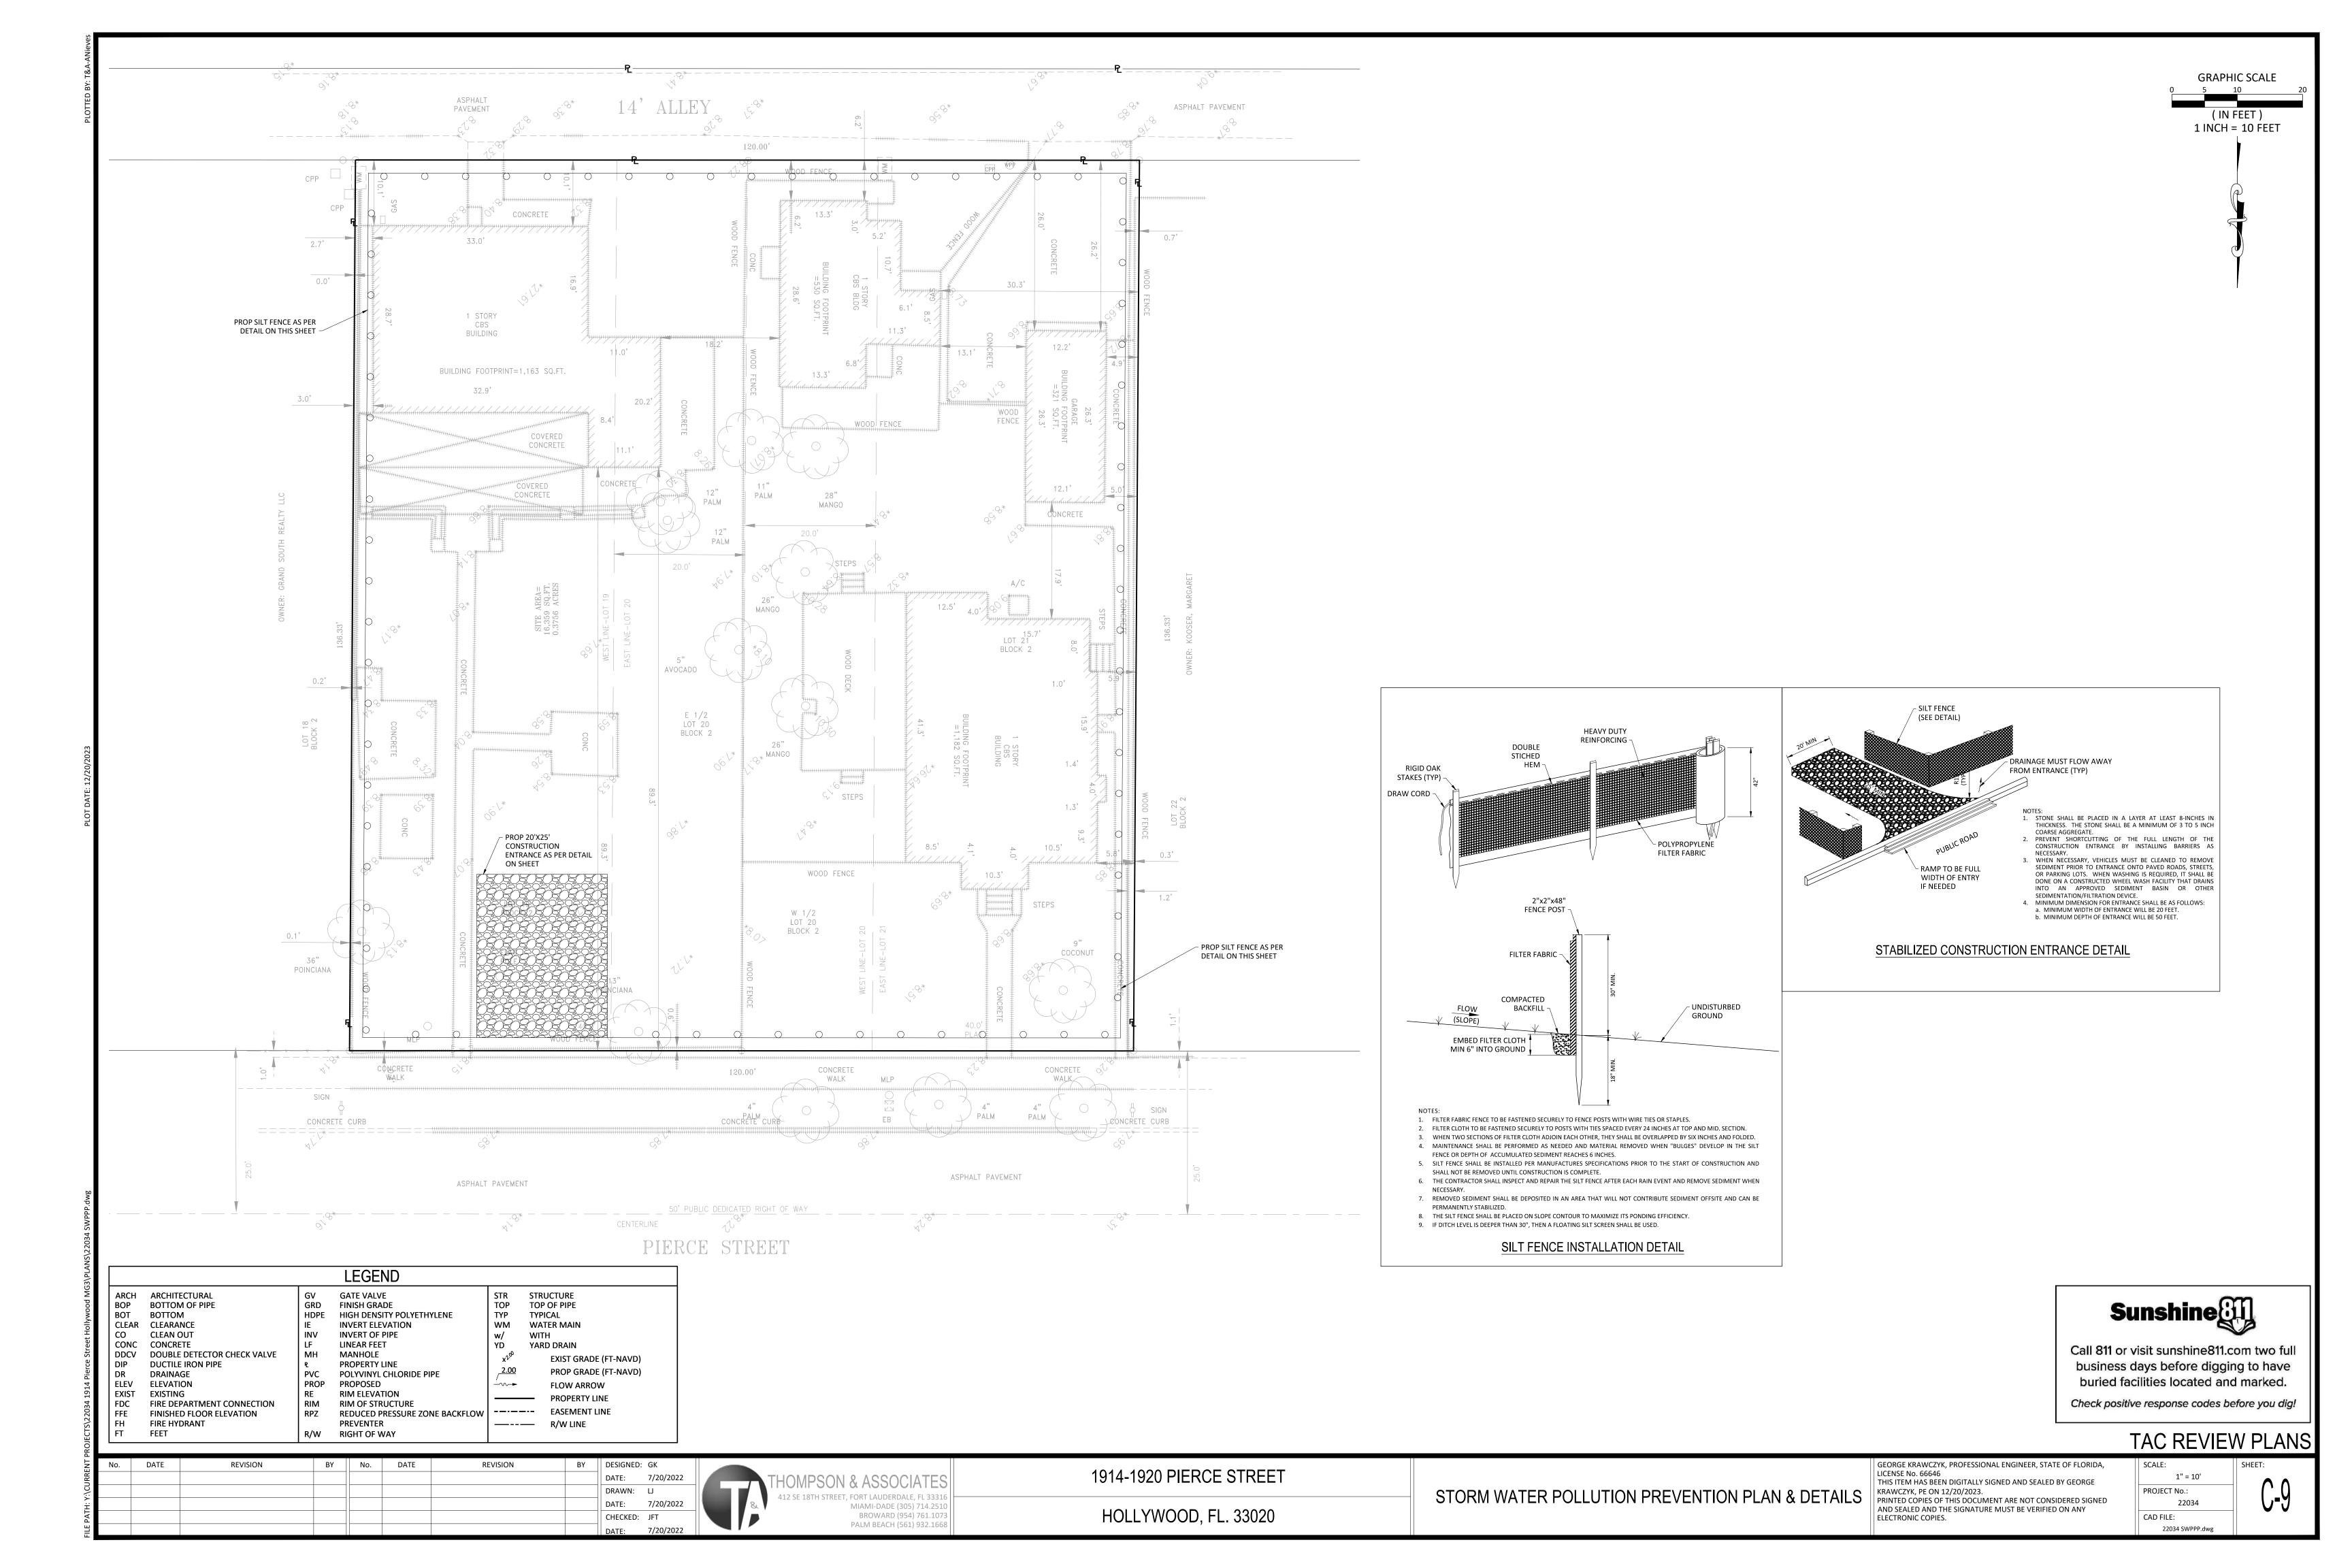


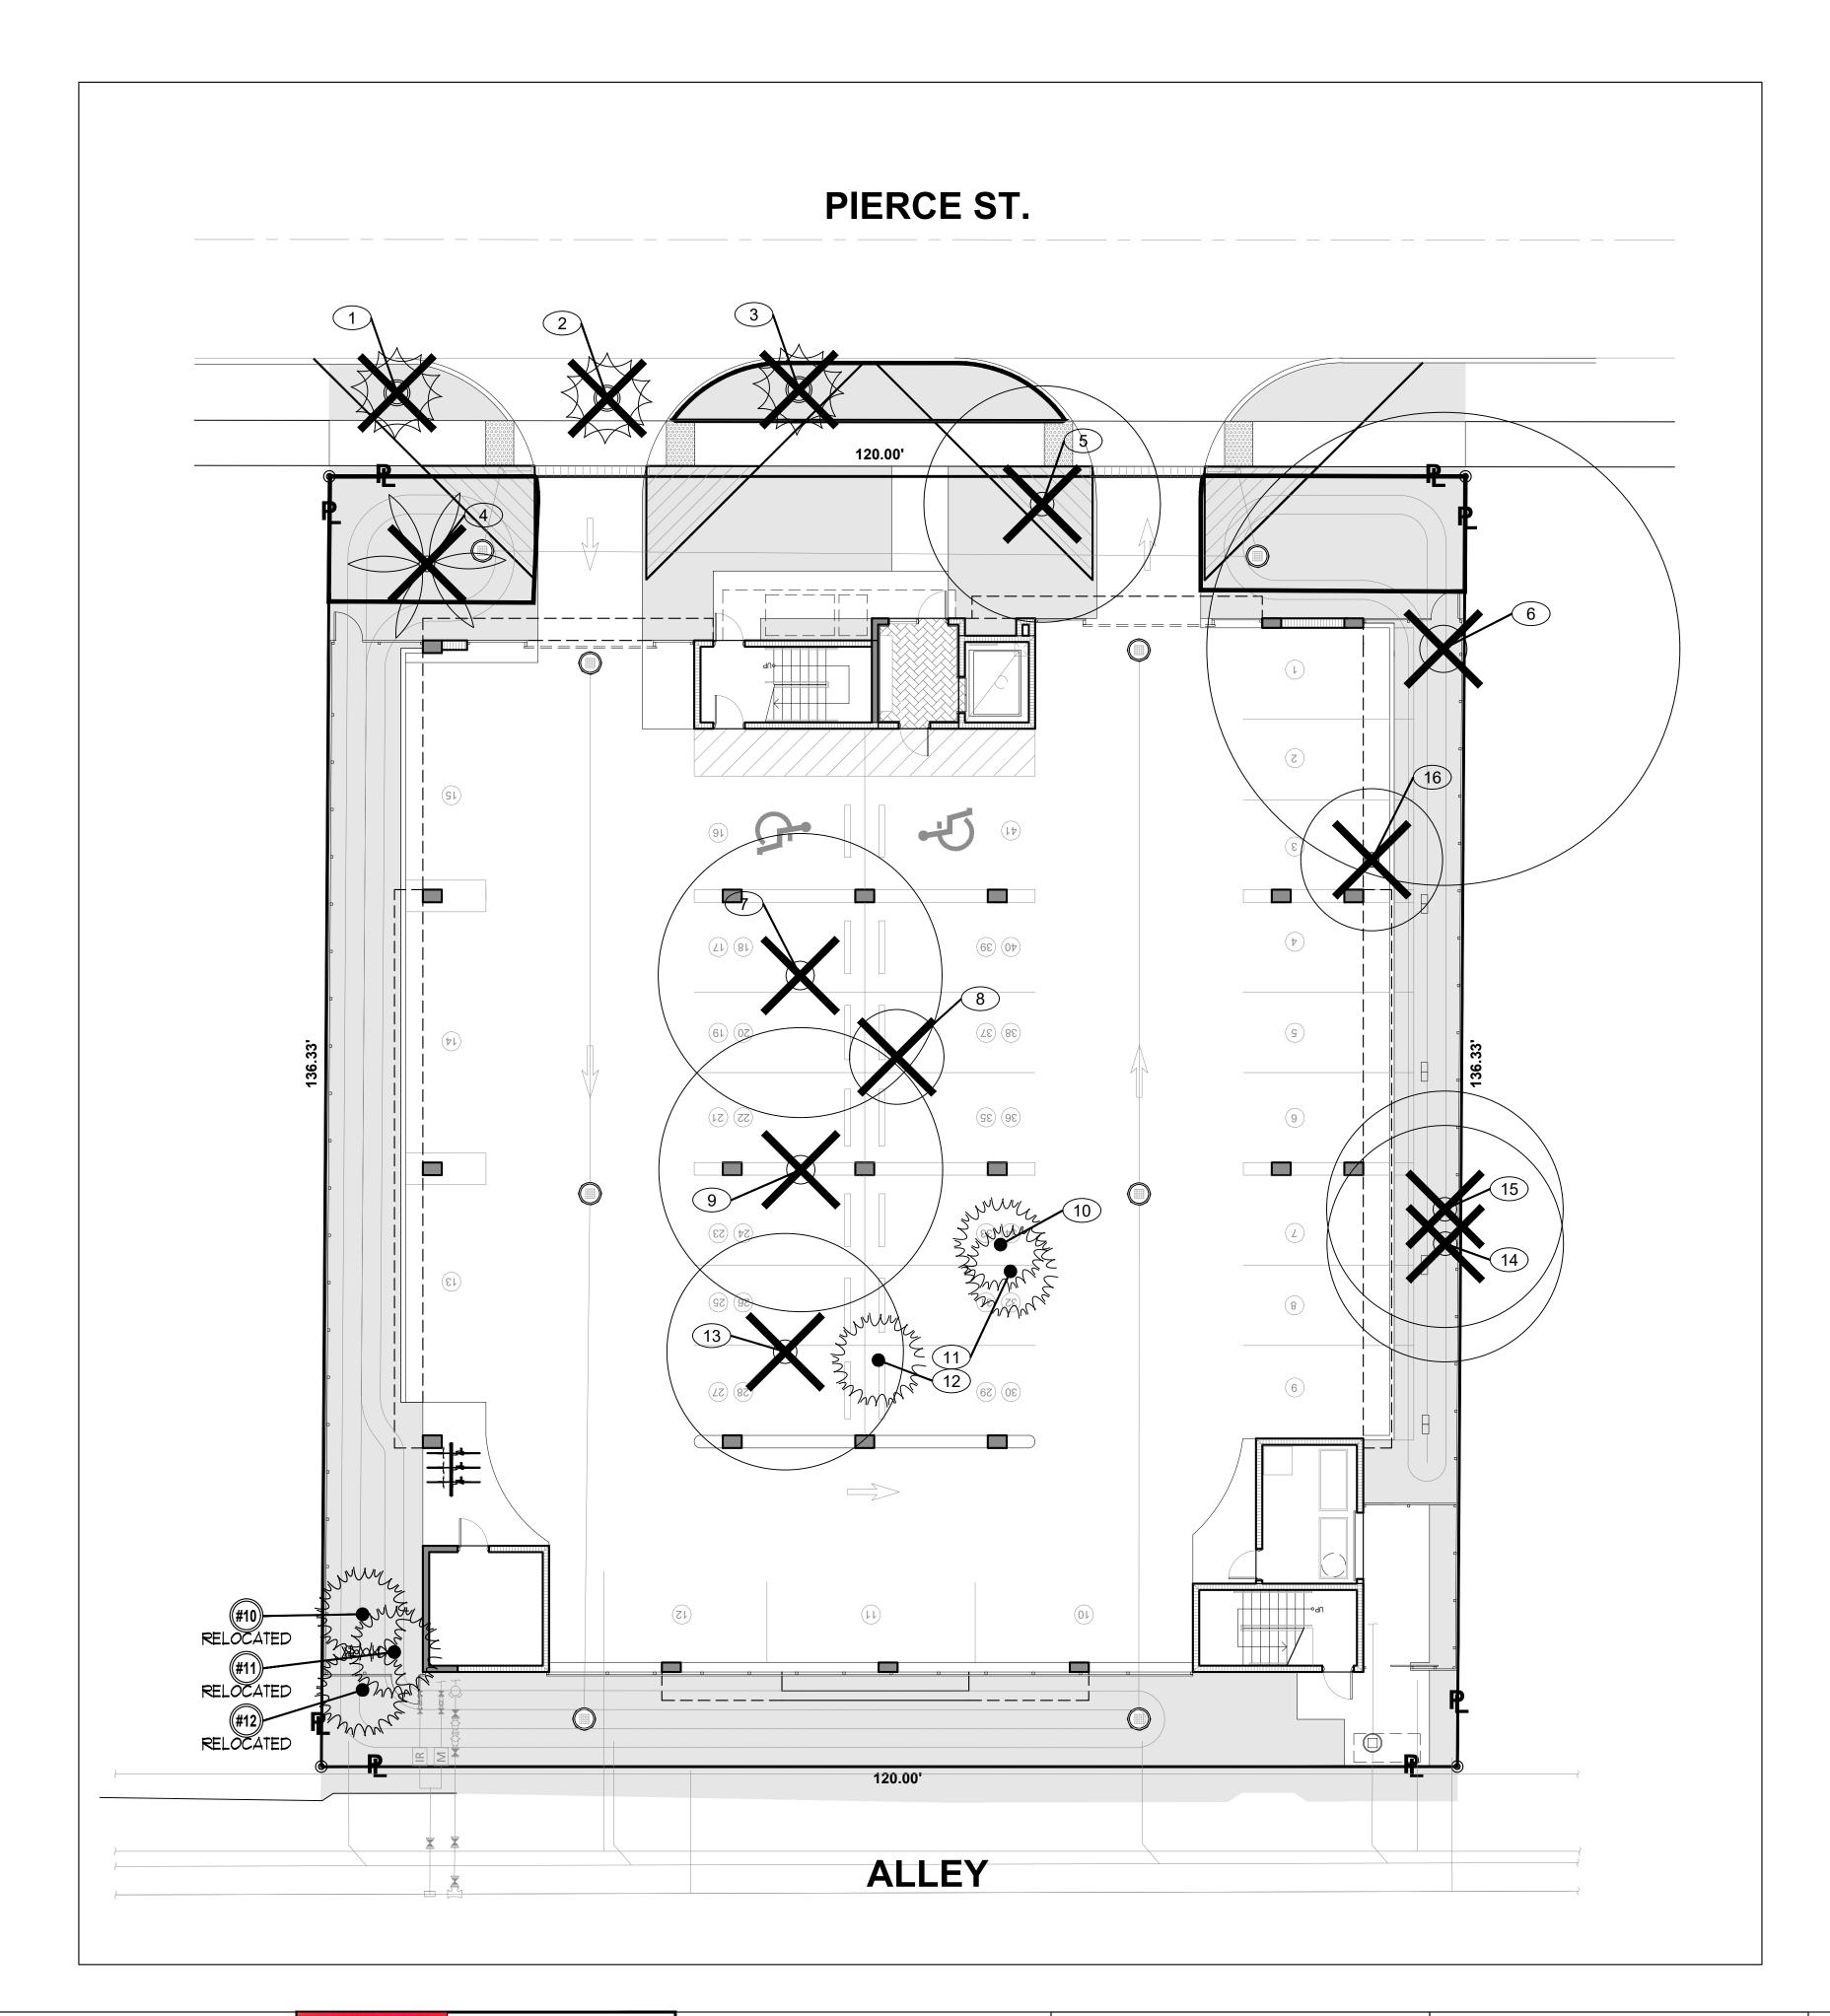



REE	~	COMMON NAME -	BOTANICAL NAME	→ HEIGH →	SPRE	DBH -	CONDITIC	CLEA -	STATUS -	DBH 🔻	PALM -	REMARKS
MUM	SYM					inches		TRUNK		LOSS	LOSS	
1	THF	FLORIDA THRINAX PALM	Thrinax radiata	10	10	4	GOOD	4'	REMOVE		1	IN SIGHT TRIANGLE
2		FLORIDA THRINAX PALM	Thrinax radiata	10	10	4	GOOD	4'	REMOVE		1	IN SIGHT TRIANGLE
3		FLORIDA THRINAX PALM	Thrinax radiata	10	10	4	GOOD	4'	REMOVE		1	IN SIGHT TRIANGLE
4		COCONUT PALM	Cocos nucifera	25	20	10	FAIR	14'	REMOVE		1	IN OIGHT TRIANGLE
5		ROYAL POINCIANA	Delonix regia	18	25	13	FAIR	10'	REMOVE	13	•	
6		ROYAL POINCIANA	Delonix regia	35	50	36	FAIR	12'	REMOVE	36		
7		MANGO	Mangifera indica	35	30	26	FAIR	10'	REMOVE	26		
8		AVOCADO	Persea americana	10	10	5	FAIR	4'	REMOVE	5		
9		MANGO	Mangifera indica	35	30	26	FAIR	12'	REMOVE	26		
10		SABAL PALM	Sabal palmetto	21	12	10	GOOD	15'	RELOCATE			
11		SABAL PALM	Sabal palmetto	18	12	10	GOOD	13'	RELOCATE			
12		SABAL PALM	Sabal palmetto	20	12	10	GOOD	14'	RELOCATE			
13		MANGO	Mangifera indica	25	25	28	FAIR	12'	REMOVE	28		
14		STRANGLER FIG	Ficus aurea	25	25	16	FAIR	12'	REMOVE	16		
15	FA	STRANGLER FIG	Ficus aurea	20	25	16	FAIR	12'	REMOVE	16		
16		LIVE OAK	Quercus virginiana	15	15	4	FAIR	8'	REMOVE	4		
		TOTALS								170	4	
		FIELD INVENTORY CONDUC	TED BY JFS DESIGN INC. C	N JULY 9,	2022							



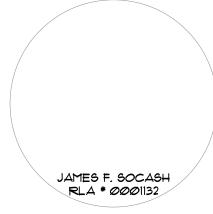

NEW 32 UNITS

DEVELOPMENT AT: DOWNTOWN HOLLYWOOD

1914 - 1920 PIERCE STREET

HOLLYWOOD, FL. 33020 DATE ISSUE DESCRIPTION

DRAWING INFORMATION:

DELIVERY DATE: DRAWN BY: CHECKED BY:


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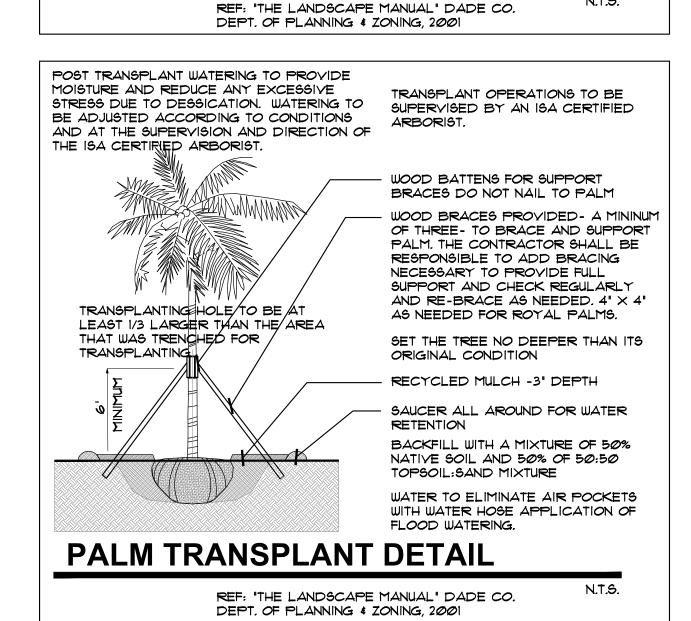
JFS Design Inc. LANDSCAPE ARCHITECTURE LC 000393 1833 N.W. 140th TERRACE PEMBROKE PINES, FL. 33028 jimmy@jfsdesignfl.com

A WRITTEN TREE REMOVAL PERMIT IS
REQUIRED FROM THE CITY OF
HOLLYWOOD PRIOR TO REMOVAL OF ANY
NON-EXEMPT TREE OR PALMS FROM THE
SITE.

SEE SHEETS L-I THROUGH L-4 FOR
GROUND LEVEL SITE LANDSCAPE PLANS.
AND UPPER LEVEL LANDSCAPE PLANS.



WORK TO BE SUPERVISED BY AN ISA CERTIFIED ARBORIST OR A COMPANY WITH A CERTIFIED ISA ARBORIST ON ROOT PRUNING MUST BE DONE A MINIMUM OF 8 WEEKS PRIOR TO TRANSPLANTING. WATERING MUST PROVIDE SUFFICIENT WATER TO MAINTAIN A MOIST CONDITION IN THE ROOTS. ONCE A WEEK OR MORE ACCORDING TO CONDITIONS. BRACE PALMS PER ISA CERTIFIED ARBORIST PRIOR TO RELOCATION. TAKE EXTRA CARE NOT TO DAMAGE THE TRUNK OR FRONDS. TRENCH TO BE LIGHTLY FILLED WITH FIBROUS MATERIAL SUCH AS LEAVES OR WOOD SHAYINGS. TRENCH SHALL USE SHARP INSTRUMENTS OR MACHINERY. RIPPING OR TEARING OF THE ROOTS IS STRICLY PROHIBITED. ALL TORN ROOTS MUST BE TRIMMED TO SOLID WOOD WITH CLEAN, SHARP DEPTH TO BE 18" MIN. TO 36" -VARIES WITH SIZE OF TREE **ROOT PRUNING DETAIL**

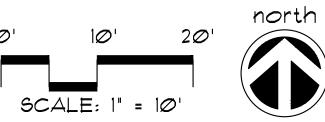

TREE DISPOSITION NOTES:

I. SEE LANDSCAPE PLANS FOR PROPOSED TREE AND PALM LOCATIONS.

2. THE CONTRACTOR SHALL REMOVE ALL TREES AND HEDGES AS PER PLANS AND AS APPROVED BY THE LOCAL GOVERNING AGENCIES (MIAMI-DADE CO. DRER). TREE. PALM AND HEDGE MATERIAL SHALL INCLUDE ALL TRUNKS, STUMPS AND ROOTS. ALL EXCESS DEBRIS SHALL BE REMOVED FROM THE SITE AND DISPOSED OF AT AN APPROVED SITE. ALL HOLES AND DEPRESSIONS SHALL BE BACKFILLED WITH CLEAN, APPROVED BACKFILL.

3. LOCATIONS SHOWN FOR THE EXISTING TREES AND PALMS ARE APPROXIMATE, EXACT LOCATIONS ARE TO BE FIELD YERIFIED BY A REGISTERED LAND SURVEYOR (RLS) PRIOR TO ANY PAVING OR ANY OTHER SUCH WORK WHICH WILL BE IMPACTED BY ANY TREES OR PALMS TO REMAIN.

4. ALL INVASIVE EXOTIC VEGETATION AND ANY ANY OTHER PLANTS LISTED AS CATEGORY I, ON THE FLORIDA EXOTIC PEST PLANT COUNCIL'S LIST OF FLORIDA'S MOST INVASIVE SPECIES SHALL BE REMOVED FROM THE SITE AND MAINTENANCE SHALL GUARANTEE CONTROL OF RE-INVASION.

5. ALL TREES AND PALMS TO BE RELOCATED SHALL BE ROOT PRUNED AND CANOPY PRUNED ACCORDING TO ALL ACCEPTED STANDARDS AS DEFINED BY THE NATIONAL ARBORIST ASSOCIATION, AND ALL PRE AND POST-TRANSPLANT OPERATIONS SHALL BE COORDINATED WITH UTMOST CARE TO MINIMIZE DAMAGE AND TRANSPLANT SHOCK. WATERING-IN AND WATERING SCHEDULES SHALL BE SUBMITTED TO THE PROJECT MANAGER FOR REVIEW AND APPROVAL PRIOR TO RELOCATION.

6. ALL TREES AND PALMS TO BE RELOCATED SHALL BE STAKED AND BRACED TO INSURE STABILITY AND MINIMIZE ROOT DAMAGE DURING THE PLANT ROOT RECUPERATION

1. CONTRACTOR SHALL VERIFY WITH THE PROJECT SUPERINTENDENT THE PROPOSED LANDSCAPE AREAS PRIOR TO TREE AND PALM RELOCATION TO INSURE PROPER RELOCATION AND MINIMIZE ANY FIELD DISCREPANCIES WITH RESPECT TO PROPOSED PAVING, BUILDINGS, AMENITIES, ABOVE AND BELOW GROUND UTILITIES AND LIMITS OF

8. CONTRACTOR SHALL ESTABLISH AN IRRIGATION SYSTEM TO PROVIDE FOR PRE AND POST-TRANSPLANT IRRIGATION SCHEDULING. TREE AND PALM FERTILIZATION SHALL BE ESTABLISHED CONCURRENTLY WITH IRRIGATION PRE AND POST-FERTILIZATION, THIS PROCEDURE SHALL BE CONDUCTED TO OPTIMIZE PLANT ESTABLISHMENT.

9. CONTRACTOR SHALL COORDINATE WITH THE PROJECT SUPERINTENDENT TO PLANT ALL RELOCATED TREES AND PALMS AT THE FINAL GRADE OF SITE.

10. SEE "ROOT PRUNING DETAIL" AND "TREE TRANSPLANT DETAIL AS SHOWN ON THE PLANS.

TREE TRANSPLANTING PROCEDURAL SPECIFICATION

PURPOSE: TO MAXIMIZE THE SUCCESS OF TREE TRANSPLANTING OPERATIONS.

ALL STANDARDS SHALL MEET OR EXCEED THE ANSI A300 (PART 6)-2005 (TRANSPLANTING) STANDARD PRACTICES AND ANY APPLICABLE LOCAL CODES.

CONTRACTOR SHALL EMPLOY AN ISA CERTIFIED ARBORIST WITH VERIFIABLE TREE TRANSPLANT EXPERIENCE AS THE "EXPERT ARBORIST OF RECORD' TO CARRY OUT THE FOLLOWING DUTIES:

SHALL PROVIDE A TREE RELOCATION PLAN FOR APPROVAL BY THE OWNER'S AGENT BEFORE ANY WORK CAN COMMENCE.


SHALL MAKE SITE VISITS PRIOR TO ANY RELOCATION WORK TO INSPECT THAT PROPER PREPARATION WORK IS PERFORMED TO THE TREE RELOCATION GUIDELINES.

SHALL MAKE SITE VISITS DURING RELOCATION WORK TO INSURE WORK IS BEING PERFORMED TO THE TREE RELOCATION GUIDELINES.

SHALL DOCUMENT ALL INSPECTIONS AND PROVIDE REPORT TO THE OWNER'S AGENT WITHIN 5 BUSINESS DAYS OF SITE VISIT.

SHALL SUBMIT PRIOR TO FINAL ACCEPTANCE BY OWNER'S AGENT, A POST-TRANSPLANT CARE GUIDE FOR UP TO THREE YEARS THAT INCLUDES WATERING, FERTILIZATION, PRUNING, PEST CONTROL, STAKING, ETC., FOR APPROVAL.



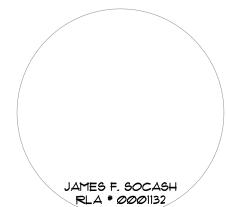

NEW 32 UNITS DEVELOPMENT AT:

DOWNTOWN HOLLYWOOD

1914 - 1920 PIERCE STREET HOLLYWOOD, FL. 33020

DATE ISSUE DESCRIPTION

DRAWING INFORMATION:

03.28.2023 DRAWN BY: J.B. CHECKED BY A.LL.

REF NUMBER:




JFS Design Inc. LANDSCAPE ARCHITECTURE


jimmy@jfsdesignfl.com


A WRITTEN TREE REMOVAL PERMIT IS REQUIRED FROM THE CITY OF HOLLYWOOD PRIOR TO REMOVAL OF ANY NON-EXEMPT TREE OR PALMS FROM THE PEMBROKE PINES, FL. 33028

SEE SHEETS L-1 THROUGH L-4 FOR GROUND LEVEL SITE LANDSCAPE PLAN, AND UPPER LEVEL LANDSCAPE PLANS.

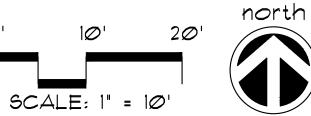

TREE DISPOSITION DETAILS, SPECIFICATIONS

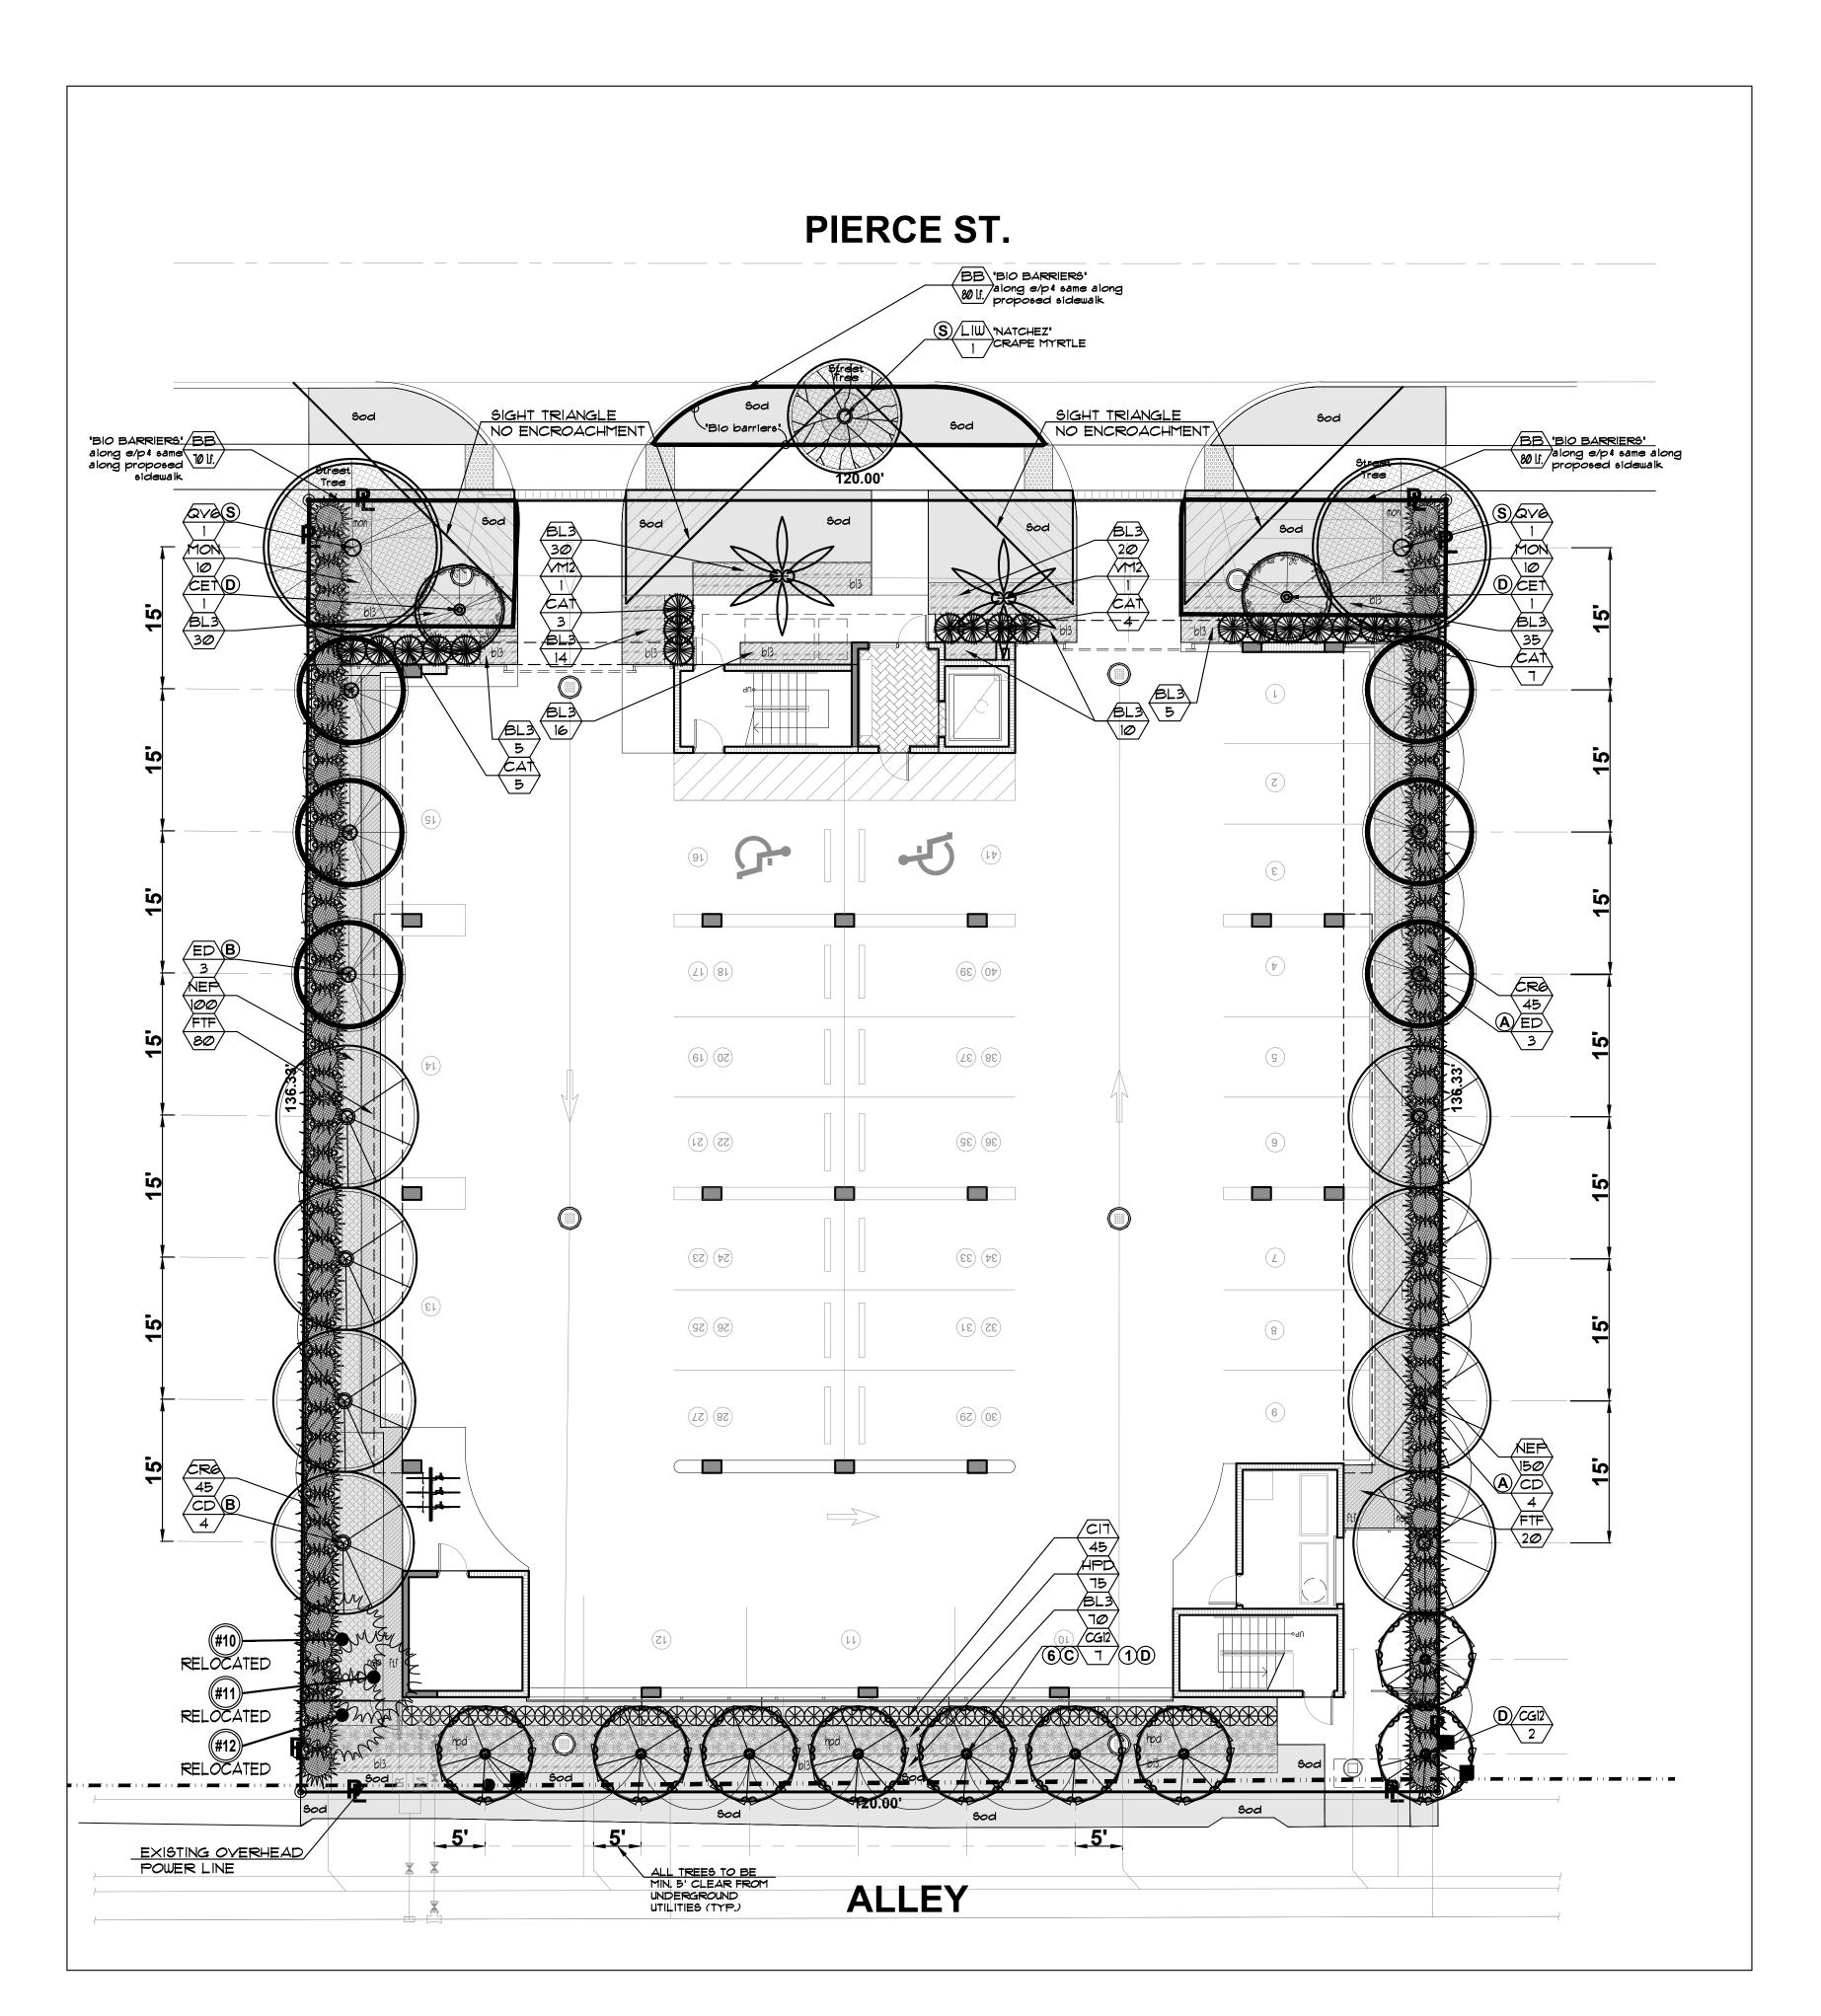

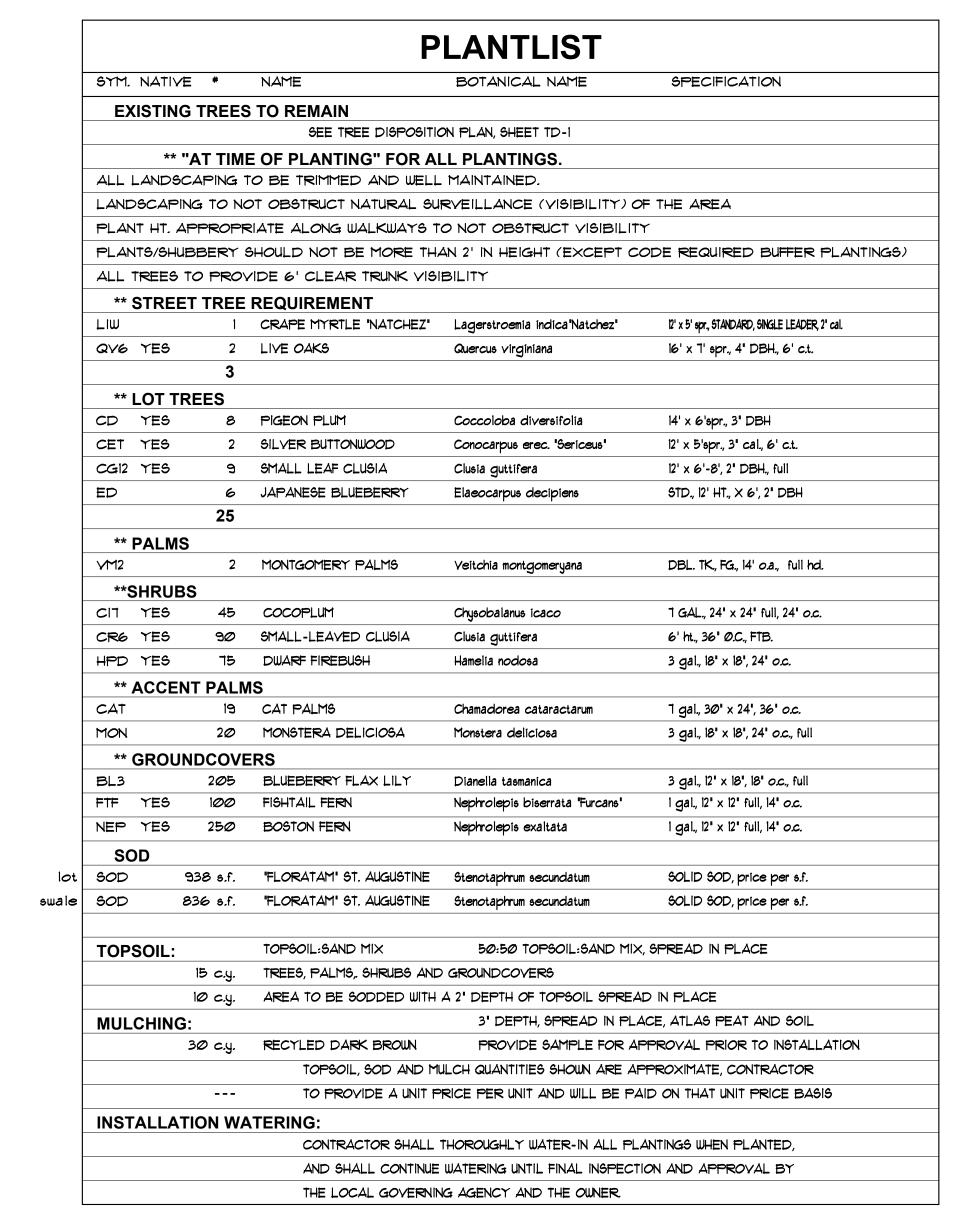

	LANDSCAPE SITE CALCULATIONS				
	7/27/2023				
TOTAL SITE AREA					
TO TALL OTTE ATTEN	GROSS SITE AREA	0.3755 AC	16,360 S.F.		
	NET SITE AREA	0.3755 AC	16,360 S.F.		
		0.00.000.00	,		
LAND	SCAPING COMPLIES WITH CITY OF HO	REQUIREMENTS LLYWOOD ZON NS, ARTICLE 9.		DEVELOPMENT	
	CTDEET TREES				
	STREET TREES 1 tree / 30 l.f.				
•	PIERCE ST	3		3	
ა.	88 l.f./ 30 l.f = 3 TREES	3		1 LIW+ 2 QV6	
	120' - 32' (DRIVEWAYS) = 88 L.F.			I LIVVT Z QVO	
	LE SE (BRIVE WITTO) = 30 E.T.				
	LANDSCAPE BUFFERS				
	1 tree / 20 l.f.				
Α.	EAST BUFFER	7		7	
	136.33 I.f./ 20 I.f.= 7 TREES	•		4 CD + 3 ED	
В.	WEST BUFFER	7		7	
	136.33 l.f./ 20 l.f.= 7 TREES			4 CD + 3 ED	
C.	SOUTH BUFFER	6		6	
	1 tree / 20 l.f. when abutting an alley			6 CG12	
	120 l.f./ 20 l.f.= 6 TREES				
	INTERIOR PARKING SPACE	N/A		N/A	
	1 tree / TERMINAL ISLAND				
	GARAGE PARKING-NO SURFACE PARKING SPACES				
D.	OPEN SPACE	4		5	
	1 tree /1,000 s.f. of pervious area of property			3 CG12 + 2 CET	
	3,963 S.F. @ 1/1000 s.f.				
	TOTAL	0.7		0.0	
	TOTAL	27		28	
NATIVE REQUIREME	ENT				
	TREES-60% NATIVE	17		21	
	28 REQUIRED TREES X 60% = 9 NATIVE TREES				
	SHRUBS-50% NATIVE	145		228	
	50% NATIVE SHRUBS				




JFS Design Inc.

LANDSCAPE ARCHITECTURE
LC 000393

1833 NW. 140th TERRACE
PEMBROKE PINES, FL. 33028
jimmy@jfsdesignfl.com

A WRITTEN TREE REMOVAL PERMIT IS REQUIRED FROM THE CITY OF HOLLYWOOD PRIOR TO REMOVAL OF ANY NON-EXEMPT TREE OR PALMS FROM THE SITE.

SEE SHEETS L-1 THROUGH L-4 FOR GROUND LEVEL SITE LANDSCAPE PLAN, AND UPPER LEVEL LANDSCAPE PLANS.

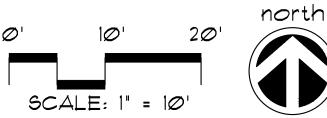






IN ASSOCIATION WITH:

AA-26002273

RROFESSIONAL SEAL.

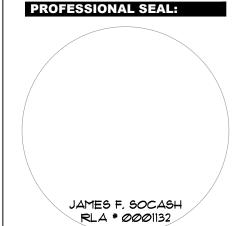

ROJECT:

NEW 32 UNITS DEVELOPMENT AT:

DOWNTOWN HOLLYWOOD

1914 - 1920 PIERCE STREET HOLLYWOOD, FL. 33020

DATE ISSUE DESCRIPTION

DRAWING INFORMATION:SHEET TITLE:

DELIVERY DATE: 03.28.2023

DRAWN BY: J.B.


J.B.

CHECKED BY:

A.LL.

REF NUMBER:



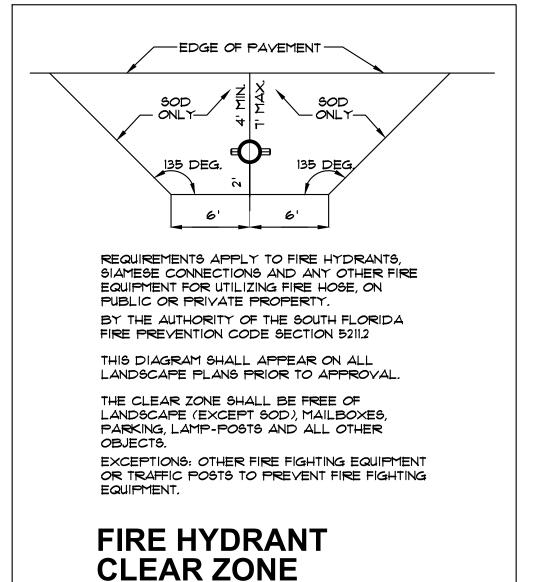

Bio barrier

BACKFILL \

3. SEE PLANTING DETAILS FOR MORE INFORMATION.

INSTALLATION TO BE COMPLETED IN ACCORDANCE WITH MANUFACTURER'S SPECIFICATIONS

5. FOR MAXIMUM PROTECTION IN HIGH ORGANIC SOILS (>10%), WITH AGGRESSIVE ROOT SPECIES

(ESPECIALLY A RETROFIT INSTALLATION) AND/OR IN CLOSE PROXIMITY TO OLEFIN PLASTICS. SPRAY

STAURATE TRENCH WALLS WITH LIQUID TRIFLURALIN. MIX OR FILL TRENCH WITH SAND OR GRAVEL.

7. CONTRACTORS NOTE: FOR PRODUCT AND PURCHASING INFORMATION VISIT www.CADdetails.com/info

ROOT CONTROL INSTALLATIONS

4. AN ARBORIST SHOULD BE CONTACTED BEFORE EXTENSIVE CUTTING OF ROOTS


6. REPORT ALL DISCREPANCIES TO CONSULTANT PRIOR TO INSTALLATION.

SIDEWALK

CONCRETE SIDEWALK

MAX. WIDTH 8' (2.4M).

PROTECTED BY COPYRIGHT - 09/30/05

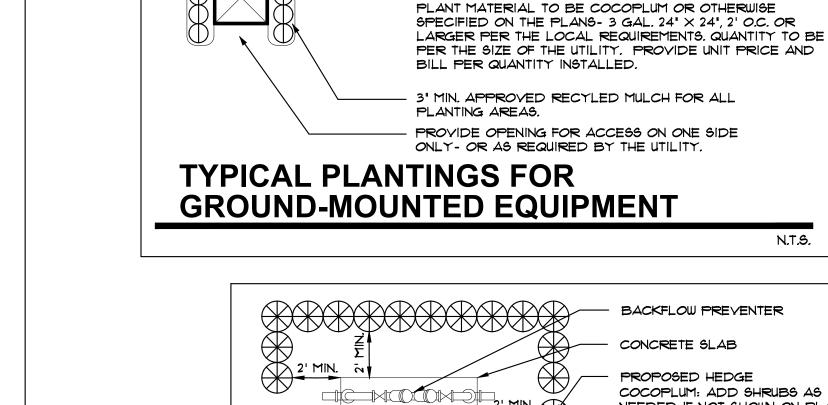

Bio Barrier

70 OLD HICKORY BLVD.

PHONE: (615) 847-7137

/ - MINIMUM DIAMETER LIMITED ONLY BY ROO BALL ON NEW INSTALLATIONS, PROVIDED 'W'

(- 10 FT (3M) RECOMMENDED OR CONTINUOUS

Z - 2 FT. (0.6M) MINIMUM, 4 FT. (1.2M) OR

IF PLANTINGS ARE < 20 FT. (6M) APART

BED ROCK, HARD PAN OR WATER EXISTS

Y - LIMITED ONLY WITH RETROFIT INSTALLATION ROOT

CONCRETE____19.5" (0.5M)

_BRING TOP OF

LEVEL

—ASPHALT

BASE

-GRANULAR

- NATIVE SOIL

(SEE NOTES)

BACKFILL

BRING TOP OF

LEVEL

GRANULAR

- NATIVE SOIL

BIOBARRIER TO

SURFACE GRADE

BIOBARRIER TO


SURFACE GRADE

FAX: (615) 847-7068 www.biobarrier.com

IS > 6 IN. (152MM)

OLD HICKORY, TN 37138-3651

TOLL FREE: 800-284-2780 ext. 7137

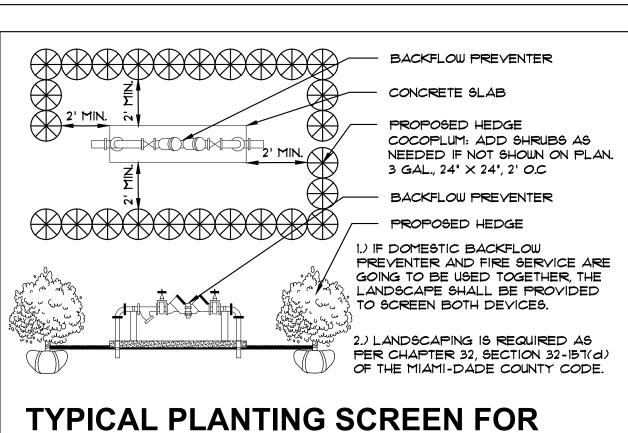

ABOVE-GROUND UTILITIES

PLANT HEDGE-TYPE MATERIAL AROUND ALL

OTHER ABOVE-GROUND UTILITY EQUIPMENT.

UN.C.L.E. - TEL: 1 (800) 432-4770

GROUND-MOUNTED EQUIPMENT - TYPICAL FOR ALL FPL


TRANSFORMER BOXES OR PADS, TELEPHONE AND CABLE


CLEARANCES FOR ANY AND ALL UNDERGROUND UTILITIES


N.T.S.


MUST BE COORDINATED WITH THE LOCAL GOVERNING


AGENCY AND/OR THE INDIVIDUAL UTILITIES AND/OR

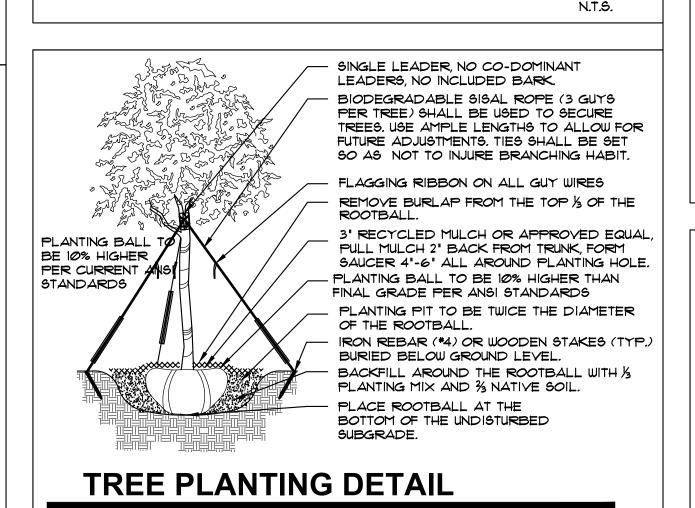


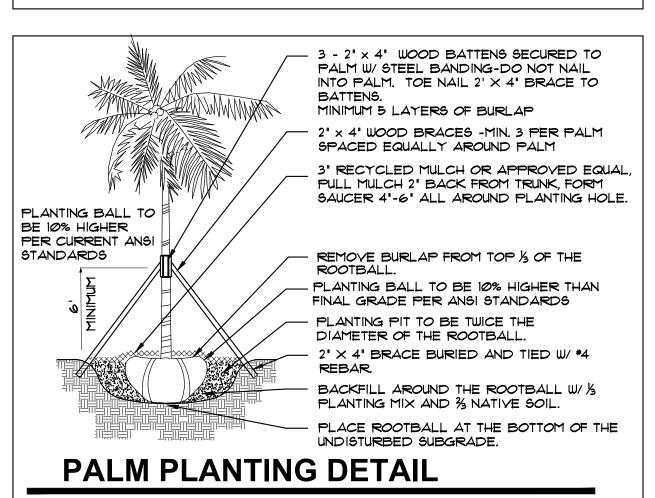

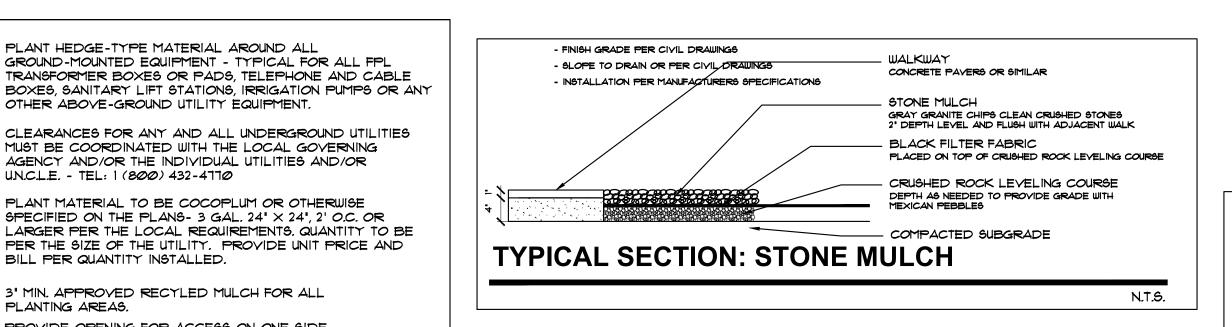


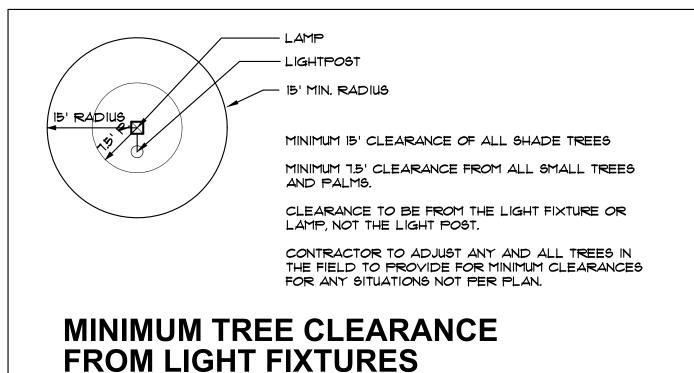

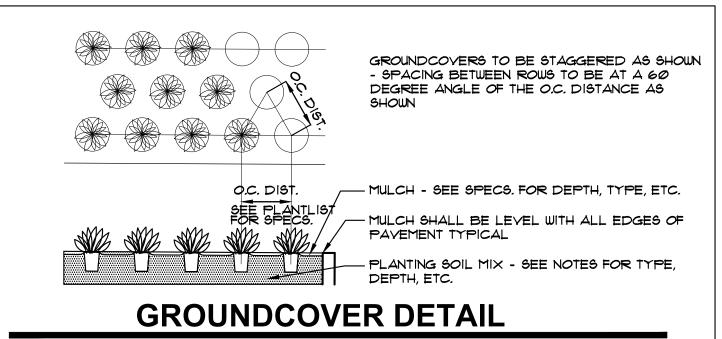

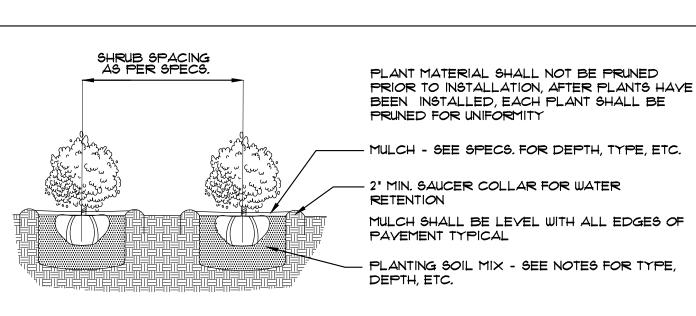

SHRUB PLANTING DETAIL

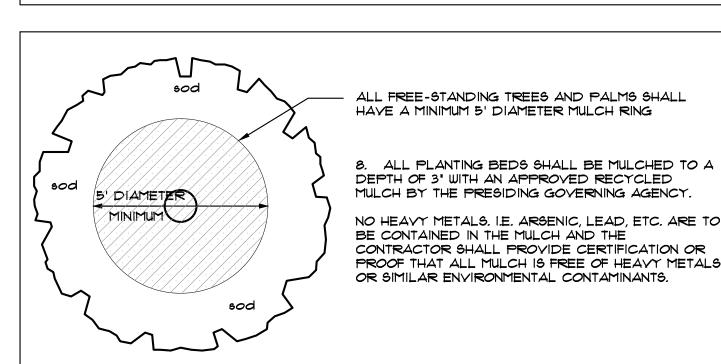

TYPICAL MULCH RING FOR FREE-STANDING TREES AND PALMS ■ ■ LANDSCAPE NOTES

36" FROM THE BUILDING BASE.

1. ALL PLANT MATERIAL SHALL BE FLORIDA NO. 1 GRADE OR BETTER. 2. CONTRACTOR SHALL FAMILIARIZE HIMSELF WITH THE LOCATION OF AND AVOID AND PROTECT UTILITY LINES, BURIED CABLES, AND OTHER UTILITIES.

3. TREE, PALM, ACCENT AND BED LINES ARE TO BE LOCATED IN THE FIELD AND APPROVED BY THE LANDSCAPE ARCHITECT PRIOR TO INSTALLATION.

4. ALL PLANTING SOIL SHALL BE 50:50 TOPSOIL:SAND MIX, FREE OF CLAY, STONES, ROCKS, OR OTHER FOREIGN MATTER. THIS SPECIFICATION INCLUDES ALL BACKFILL FOR BERMS AND OTHER LANDSCAPE AREAS.

SODDED-LAWN AREAS 2" DEPTH PLANTING SOIL SPREAD IN PLACE- THROUGHOUT. GROUND COVER PLANTING BEDS:

6' DEPTH PLANTING SOIL SPREAD IN PLACE- THROUGHOUT. SHRUB AND HEDGE PLANTING AREAS: 12" DEPTH PLANTING SOIL SPREAD IN PLACE- THROUGHOUT. TREES, PALMS, SPECIMEN PLANT MATERIAL:

24" DEPTH PLANTING SOIL SPREAD IN PLACE OR, TO THE DEPTH OF THE ROOTBALL OR CONTAINER WHICHEVER IS GREATEST. ANDSCAPE ISLANDS AND BUILDING FOUNDATIONS: EXCAVATE AND REMOVE ALL LIMEROCK, ROCKS, DEBRIS. ETC. TO A DEPTH OF 18" AND BACKFILL W/ 50:50 TOPSOIL:SAND MIX. BUILDING FOUNDATIONS SHALL BE THE SAME DEPTH TO A WIDTH OF

5. THE SITE CONTRACTOR SHALL BE RESPONSIBLE TO BRING ALL GRADES TO WITHIN 2" OF FINAL GRADES. THIS SHALL INCLUDE A 2" APPLICATION OF 50:50 TOPSOIL:SAND MIX FOR ALL LANDSCAPE AND AREAS TO BE SODDED.

6. THE LANDSCAPE CONTRACTOR SHALL CALCULATE AND SUBMIT AN ITEMIZED PRICE FOR THE 2" APPLICATION OF 50:50 MIX FOR ALL SOD AREAS AS A REFERENCE IN THE CASE THAT THERE WOULD BE A DISCREPANCY BETWEEN SITE AND LANDSCAPE CONTRACTORS AND NOTIFY THE SITE CONTRACTOR OR PROJECT SUPERINTENDENT AS TO THIS DISCREPANCY. IT WILL THEN BE DETERMINED WHICH PARTY WILL PROVIDE THIS 2" TOPSOIL: SAND APPLICATION AND SUBSEQUENT PAYMENT.

OTHER PLANTING SOIL MIXES TO BE ADDED, I.E. FOR TREES, PALMS, SPECIMEN PLANTS, SHRUBS AND GROUNDCOVERS SHALL BE THE RESPONSIBILITY OF THE LANDSCAPE CONTRACTOR AND BE INCLUSIVE WITH THE LANDSCAPE BID.

1. CONTRACTOR SHALL COORDINATE WITH THE IRRIGATION CONTRACTOR AND LEAVE PROVISIONS FOR ALL, INCLUDING UNDERGROUND UTILITY LINE LOCATIONS DIAL SII "NO CUTS" AS REQUIRED BY LAW.

8. ALL PLANTING BEDS SHALL BE MULCHED TO A DEPTH OF 3" WITH AN APPROVED RECYCLED MULCH BY THE PRESIDING GOVERNING AGENCY. NO HEAVY METALS. I.E. ARSENIC, LEAD, ETC. ARE TO BE CONTAINED IN THE MULCH AND THE CONTRACTOR SHALL PROVIDE CERTIFICATION OR PROOF THAT ALL MULCH IS FREE OF HEAVY METALS OR SIMILAR ENVIRONMENTAL CONTAMINANTS.

9. SOD SHALL BE ARGENTINE "BAHIA" OR ST. AUGUSTINE "FLORATAM" AS SHOWN ON THE PLANS, STRONGLY ROOTED, FREE FROM WEED, FUNGUS, INSECTS AND DISEASE. CONTRACTOR SHALL SOD ALL AREAS AS INDICATED ON THE PLAN OR AS DIRECTED. PAYMENT SHALL BE DETERMINED BY THE TOTAL MEASURED SODDED AREAS X THE UNIT PRICE SUBMITTED AND FIELD VERIFIED.

10. SOD SHALL BE INSTALLED IN ACCORDANCE WITH THE SPECIFICATIONS AS DEFINED BY FDOT. SOD SHALL CARRY A 5-MONTH WARRANTY.

ALL TREES, PALMS, SHRUBS AND GROUNDCOVERS SHALL CARRY ONE-YEAR WARRANTY FROM THE DATE OF FINAL ACCEPTANCE.

ALL TREES AND PALMS SHALL BE STAKED PER ACCEPTED STANDARDS BY THE FLORIDA NURSERYMEN & GROWERS LANDSCAPE ASSOCIATION (FNGLA). THERE SHALL BE ONE FINAL INSPECTION FOR APPROVAL BY THE PRESIDING GOVERNING AGENCY. CONTRACTOR SHALL INSURE THAT THE PLANS, DETAILS, SPECIFICATIONS AND NOTES HAVE BEEN ADHERED TO AND THAT THE LANDSCAPE AND IRRIGATION INSTALLATION IS COMPLIANT TO ALL ITEMS AS

DIRECTED ON THE PLANS PRIOR TO SCHEDULING OF THE FINAL INSPECTION.

THE PLANT LIST IS INTENDED ONLY AS AN AID TO BIDDING. ANY DISCREPANCIES FOUND BETWEEN THE QUANTITIES ON THE PLAN AND PLANT LIST, THE QUANTITIES ON THE PLAN SHALL BE HELD VALID.

14. IRRIGATION SHALL PROVIDE FOR A 100% COVERAGE WITH A 100% OVERLAP, AUTOMATIC SYSTEM W/ RAIN MOISTURE SENSOR ATTACHED TO CONTROLLER. ALL FLORIDA BUILDING CODE APPENDIX "F" IRRIGATION REQUIREMENTS SHALL BE STRICTLY ADHERED TO FOR INSTALLATION AND PREVAILING WATER MANAGEMENT DISTRICT RESTRICTIONS AND REGULATIONS SHALL BE IN COMPLIANCE FOR POST-INSTALLATION WATERING SCHEDULES.

15. EXISTING IRRIGATION SYSTEM (IF APPLICABLE) SHALL BE RETROFITTED TO COMPLY WITH THOSE SPECIFICATIONS AS OUTLINED ABOVE.

16. CONTRACTOR SHALL PROVIDE A WATER TRUCK DURING PLANTING TO INSURE PROPER WATERING-IN DURING INSTALLATION AND WILL BE RESPONSIBLE FOR CONTINUAL WATERING UNTIL FINAL ACCEPTANCE BY THE OWNER.

17. ALL EXISTING TREES, PALMS AND PLANT MATERIAL TO REMAIN SHALL BE PROTECTED DURING CONSTRUCTION. CONTRACTOR SHALL INSTALL PROTECTIVE BARRIERS SUCH AS "TENAX" PROTECTIVE FENCING OR AS SHOWN ON THE DETAILS TO BE INSTALLED AT THE BEGINNING OF THE PROJECT. BARRIERS SHALL BE LOCATED TO INCLUDE THE DRIPLINE OF THE TREES, PALMS AND PLANT MATERIAL WHERE POSSIBLE. THE CONTRACTOR SHALL TAKE EXTRA CAUTION TO PREVENT ANY DAMAGE TO THE TRUNK,, BRANCHES, ROOTS, ROOT ZONE AREAS AND ADJACENT GRADES.


18. EXISTING TREES AND PALMS TO REMAIN SHALL BE TRIMMED PER ANSI-300 STANDARDS. SUPERVISION OF THE TRIMMING SHALL BE PERFORMED BY AN ISA-CERTIFIED ARBORIST.

19. ALL EXISTING TREES AND PALMS SHALL BE "LIFTED AND THINNED" TO PROVIDE FOR AN 8' MINIMUM CLEARANCE FOR SIDEWALKS AND PEDESTRIAN WALKWAYS AND A 14' MINIMUM CLEARANCE FOR ROADWAYS, DRIVEWAYS, AND ALL VEHICULAR USE AREAS.

20. REMOVAL OF ANY TREES OR PALMS WILL REQUIRE A WRITTEN 'TREE REMOVAL PERMIT' FROM THE LOCAL GOVERNING AGENCY PRIOR TO REMOVAL.

21. ALL PLANTINGS IN NON-IRRIGATED AREAS, I.E. RIGHTS OF WAYS, SWALES, ETC. SHALL BE WATERED-IN THOROUGHLY AND CONTINUED TO BE WATERED THROUGHOUT UNTIL C.O. ACCEPTANCE. COORDINATE WITH OWNER AND PROJECT MANAGER TO PROVIDE POST C.O. WATERING TO INSURE PLANT ESTABLISHMENT FOR A MINIMUM OF ONE YEAR AFTER CERTIFICATE OF OCCUPANCY ACCEPTANCE.

22. THE LANDSCAPE CONTRACTOR SHALL SCHEDULE A PRE-CONSTRUCTION CONFERENCE WITH THE LOCAL GOVERNING AGENCY, GENERAL CONTRACTOR, LANDSCAPE ARCHITECT, AND IRRIGATION CONTRACTOR PRIOR TO COMMENCEMENT OF WORK.

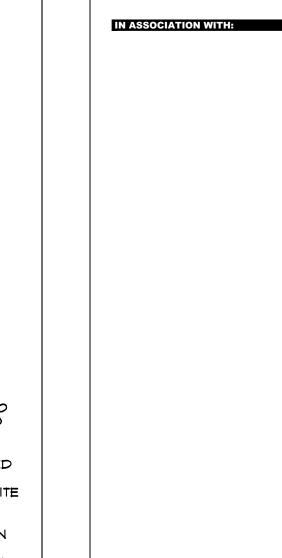


Llorente

Architects

13421 SOUTHWEST 23 STREET

MIAMI, FL. 33175 . (305) 525-2370

AA-26002273

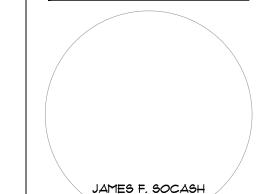

NEW 32 UNITS

RLA # 0001132

DEVELOPMENT AT: DOWNTOWN

HOLLYWOOD

1914 - 1920 PIERCE STREET

DATE ISSUE DESCRIPTION

HOLLYWOOD, FL. 33020

DRAWING INFORMATION:

03.28.2023 DRAWN BY J.B.

SHEET NO.

CHECKED BY

REF NUMBER



JFS Design Inc. LANDSCAPE ARCHITECTURE

'BIO BARRIER' SURROUND SYSTEM, 24' ROOT CONTROL WIDTH PER

BIO BARRIER ROOT CONTROL SYSTEM, HORT ENTERPRISES, P.O. BOX, 2448,

POMPANO BEACH, FL. 33060 CONTACT: MR. SAM CONSOLI, (954) 946-3850


1833 N.W. 140th TERRACE PEMBROKE PINES, FL. 33028 immy@jfsdesignfl.com

A WRITTEN TREE REMOVAL PERMIT IS REQUIRED FROM THE CITY OF HOLLYWOOD PRIOR TO REMOVAL OF ANY NON-EXEMPT TREE OR PALMS FROM THE


SEE SHEETS L-1 THROUGH L-4 FOR GROUND LEVEL SITE LANDSCAPE PLAN, AND UPPER LEVEL LANDSCAPE PLANS.

LANDSCAPE DETAILS, SPECIFICATIONS, ETC.

PIERCE ST.

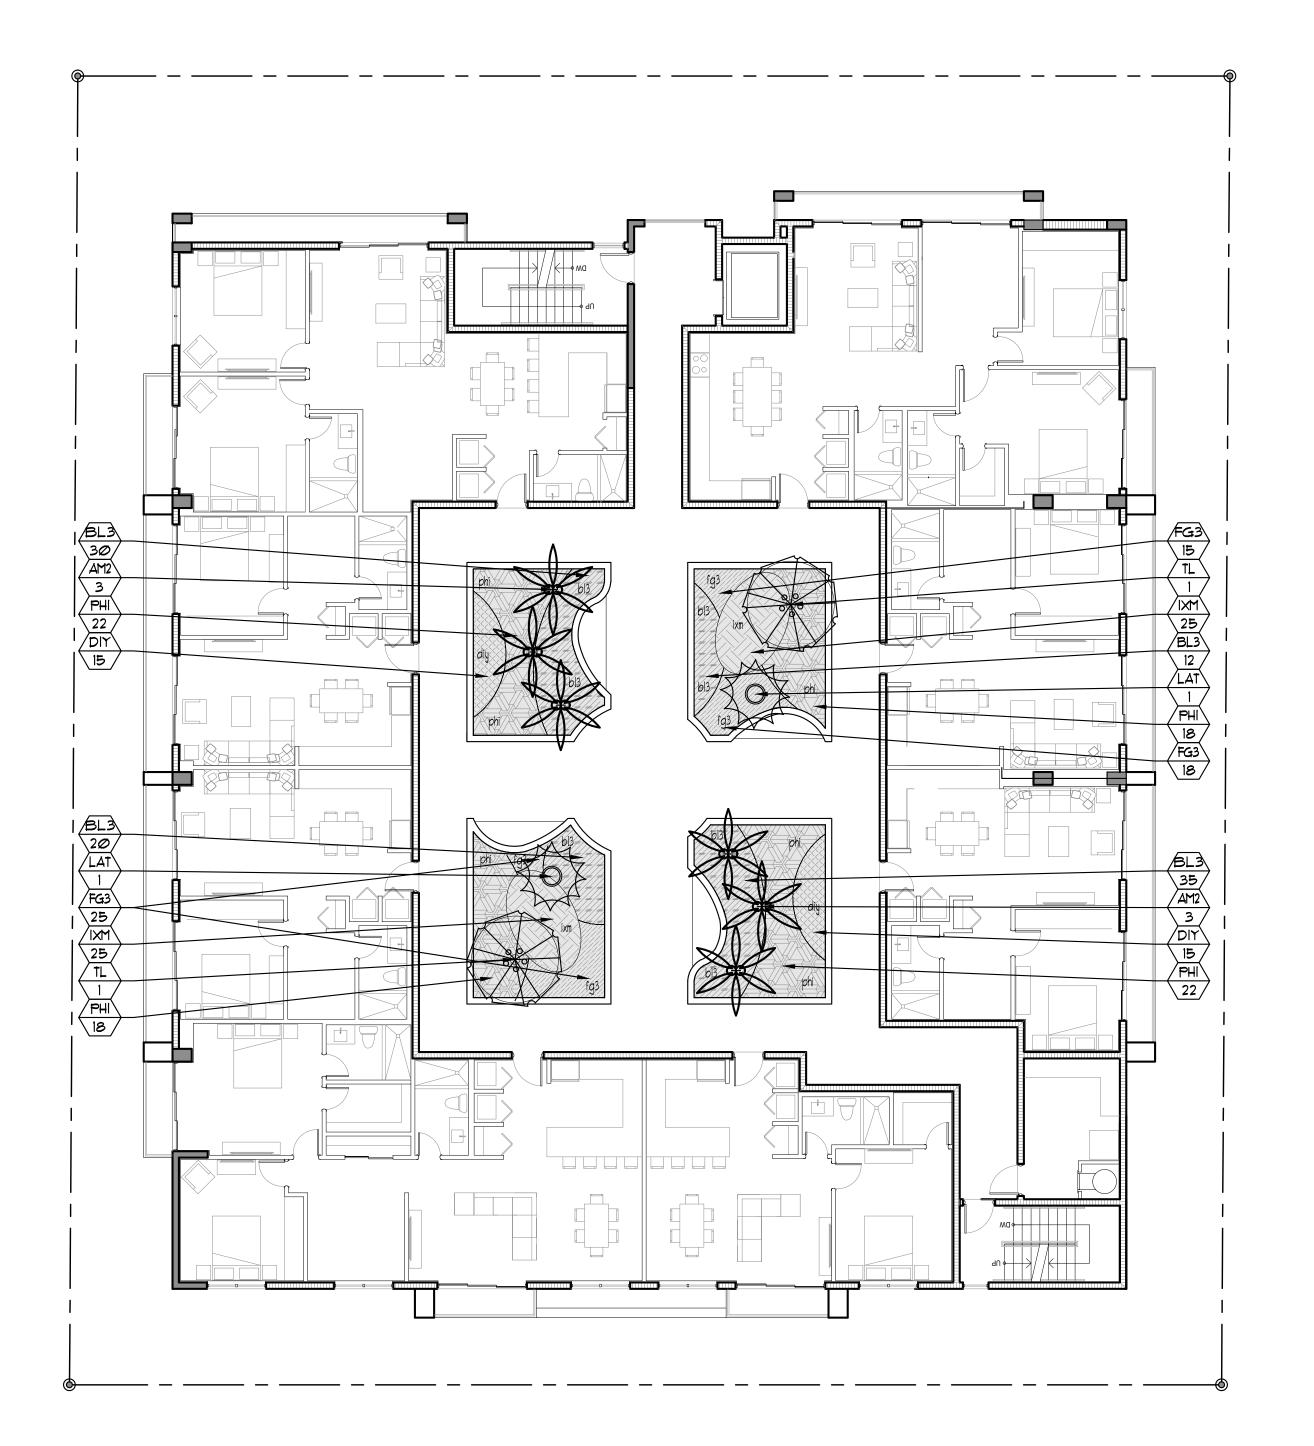

ALLEY

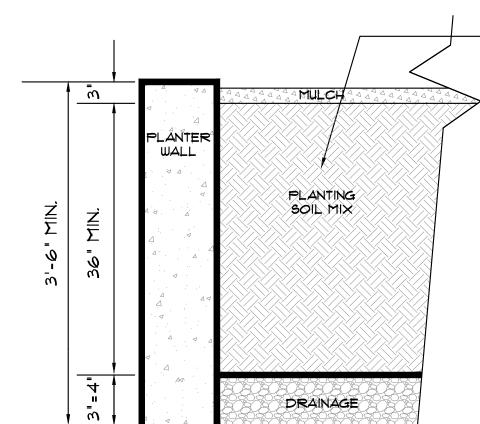

PLANTING SOIL:

SEE NOTE BELOW: PROVIDE SAMPLE TO LANDSCAPE ARCHITECT FOR APPROVAL PRIOR TO INSTALLATION.

TO BE INSTALLED BY GENERAL CONTRACTOR.

FILTER FABRIC BY "POLY FILTER" BY CARTHAGE MILLES INC., CINCINNATI, OH., OR APPROVED EQUAL

3"4" BALLAST ROCK OR APPROVED EQUAL 3"-4" DEPTH

PROTECT DRAINAGE PIPE AS INSTALLED BY CENERAL CONTRACTOR.

LANDSCAPE CONTRACTOR SHALL COORDINATE WITH THE PROJECT SUPERINTENDENT TO HAVE ALL DRAINAGE PIPE INSTALLED AND CONNECTED PRIOR TO BACKFILLING WITH BALLAST RODS, FILTER FABRIC, ETC. CONTRACTOR SHALL ALSO COORDINATE ALL IRRIGATION INSTALLATION TO INSURE COMPLETE OPERATION LOGISTICS REGARDING IRRIGATION AND DRAINAGE.

TYPICAL LANDSCAPE PLANTER

N.T.S.

Llorente **Architects**

13421 SOUTHWEST 23 STREET

IN ASSOCIATION WITH:

PROFESSIONAL SEAL:

JAMES F. SOCASH RLA # 0001132

NEW 32 UNITS DEVELOPMENT AT: DOWNTOWN

HOLLYWOOD

MIAMI, FL. 33175 . (305) 525-2370 AA-26002273

THE LANDSCAPE CONTRACTOR SHALL PROVIDE THE PLANTERS WITH AN APPROVED SOIL MIX.

CONTRACTOR SHALL SUBMIT TO THE LANDSCAPE ARCHITECT A SOIL SAMPLE AND A SOIL MATERIAL RATIO CHART FOR APPROVAL PRIOR TO INSTALLATION OF THE SOIL, SOIL MIX SHALL BE A SPECIAL MIX TO PROVIDE, POROSITY FOR DRAINAGE, AND CONTAIN AMENDMENTS (PERLITE OR SIMILAR) TO REDUCE SOIL DENSITY AND WEIGHT. SOIL MIX SHALL BE AS PER ATLAS PEAT AND SOIL OR TOM WATERS INC. SOIL MIX OR AN APPROVED EQUAL TO CONTAIN EQUAL OR FORMULATED RATIOS OF THE FOLLOWING:

- 1. SILICA SOIL
- 3. COMPOST
- 4. PERLITE
- 5. SHAYINGS

THE CONTRACTOR SHALL BE RESPONSIBLE TO FILL THE PLANTING MIX TO A DEPTH WHICH WILL BE 4" FROM THE TOP OF THE PLANTING WALL. SOIL & BALLAST ROCK QUANTITIES ARE APPROX. # WILL BE THE RESPONSIBILITY OF THE CONTRACTOR FOR FINAL GRADE AS PER THIS

WALL IMPERMEABILIZATION, DRAINS AND EYE HOOKS SHALL BE PREPARED & INSTALLED BY THE GENERAL CONTRACTOR.

THE LANDSCAPE AND IRRIGATION CONTRACTORS SHALL COORDINATE ALL WORK WITH THE PROJECT MANAGER AND ALL PERTINENT SUBCONTRACTORS TO INSURE A PROFESSIONAL EXPEDITIOUS PROCESS.

ALL PLANTING BEDS SHALL BE MULCHED WITH AN APPROVED RECYCLED MULCH, OR AN APPROYED EQUAL. SEE "LANDSCAPE NOTES".

THE CONTRACTOR SHALL SUBMIT PHOTOS FOR ALL SPECIMEN PLANT MATERIAL (ALL PALMS AND TREES) TO THE L.A. FOR APPROVAL PRIOR TO PLANTING.

SPECIFICATION

SECOND LEVEL COURTYARD PLANTLIST

** TREES				
TL	2	TREE LIGUSTRUM	Ligustrum japonicum	8' x 8' full crown
** PALMS				
AM2	6	CHRISTMAS PALM	Adonidia merrillii	FG., 10' o.a., DBL., full head
LAT	2	BLUE LATAN PALMS	Latania loddegesii	10' o.a., 6' C.T.

ACCENTS AND GROUNDCOVERS 3 gal., 12" x 18", 18" o.c., full 97 BLUEBERRY FLAX LILY Dianella tasmanica 3 gal., 12" x 18", 18" o.c., full Ficus 'Green Island 3 gal., 18" x 18", 18" o.c., full 3 gal., 18" x 18", 18" o.c., full 50 IXORA "MAUI" Ixora spp. "Maui" 3 gal., 24" x 24", 24" o.c., full 80 PHILODENDRON Philodendron bipinna. selloum

TOPSOIL: 102 c.y. "2100 MIX" FOR PLANTING-PER ATLAS PEAT AND SOIL FOR PLANTER BOXES BASED UPON 36" DEPTH, X 921 S.F. / 27 = 102 C.Y.

MULCHING:

DRK BRUN RECYCLED MULCH 3' DEPTH, SPREAD IN PLACE, ATLAS PEAT AND SOIL PROVIDE SAMPLE FOR APPROVAL PRIOR TO INSTALLATION TOPSOIL, SOD AND MULCH QUANTITIES SHOWN ARE APPROXIMATE, CONTRACTOR

TO PROVIDE A UNIT PRICE PER UNIT AND WILL BE PAID ON THAT UNIT PRICE BASIS UPON FINAL INSPECTION AND APPROVAL

INSTALLATION WATERING:

CONTRACTOR SHALL THOROUGHLY WATER-IN ALL PLANTINGS WHEN PLANTED, AND SHALL CONTINUE WATERING UNTIL FINAL INSPECTION AND APPROVAL BY THE LOCAL GOVERNING AGENCY AND THE OWNER

SECOND LEVEL COURTYARD

1914 - 1920 PIERCE STREET HOLLYWOOD, FL. 33020 DATE ISSUE DESCRIPTION **DRAWING INFORMATION:**

> DRAWN BY: CHECKED BY: REF NUMBER:

> > SHEET NO.




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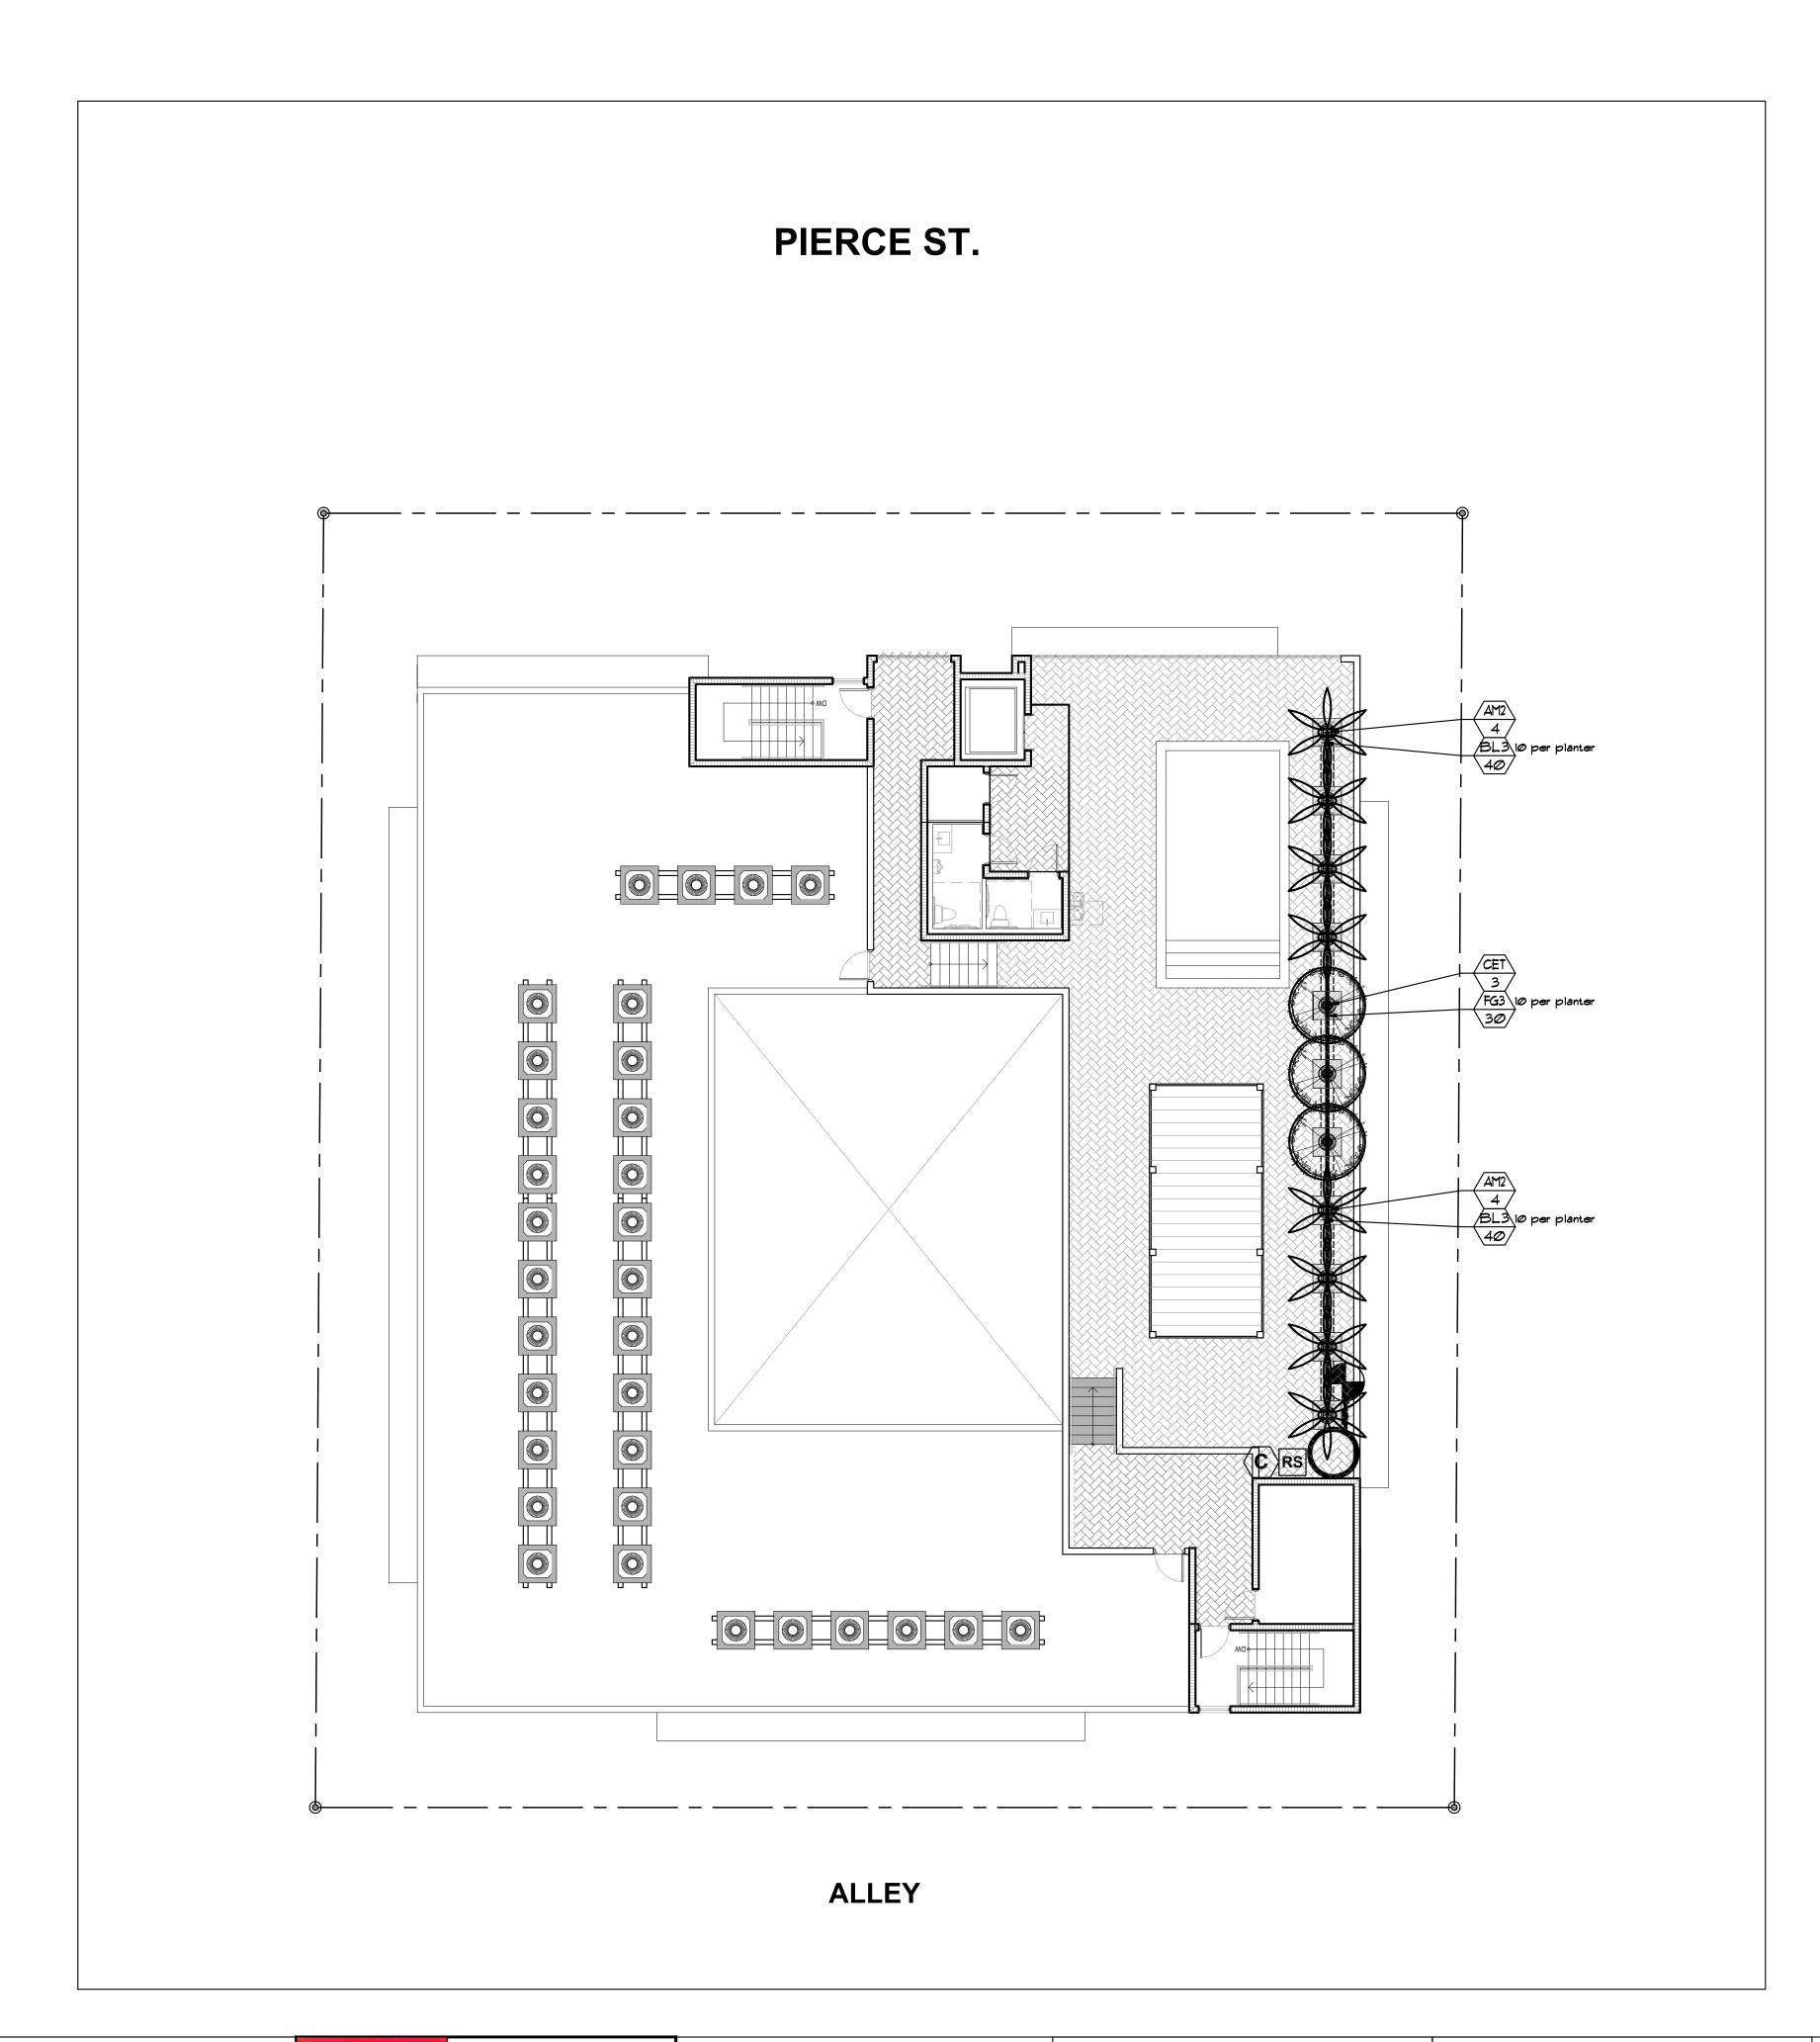
immy@jfsdesignfl.com


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SEE SHEETS L-1 THROUGH L-4 FOR GROUND LEVEL SITE LANDSCAPE PLAN, AND UPPER LEVEL LANDSCAPE PLANS.





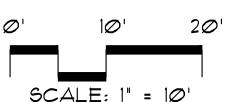

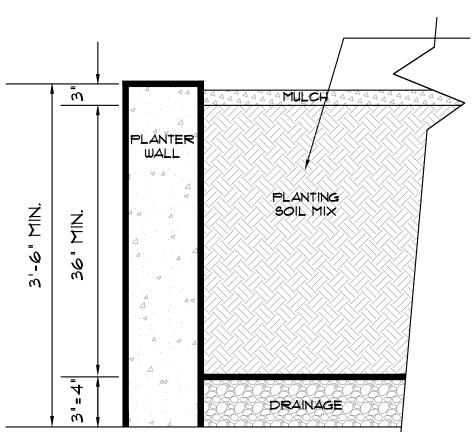

PLANTING SOIL:

SEE NOTE BELOW: PROVIDE SAMPLE TO LANDSCAPE ARCHITECT FOR APPROVAL PRIOR TO INSTALLATION.

FILTER FABRIC BY "POLY FILTER" BY CARTHAGE MILLES INC., CINCINNATI, OH., OR APPROVED EQUAL.

3"4" BALLAST ROCK OR APPROVED EQUAL 3"-4" DEPTH TO BE INSTALLED BY GENERAL CONTRACTOR.

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TYPICAL LANDSCAPE PLANTER

N.T.S.

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ROOF-POOL LEVEL PLANTLIST SYM. NATIVE BOTANICAL NAME ** TREES 10' x 6', STANDARD 3 SILVER BUTTONWOOD Conocarpus erec. 'Sericeus' ** PALMS 8 CHRISTMAS PALM Adonidia merrillii FG., 10' o.a., DBL., full head ** ACCENTS AND GROUNDCOVERS Dianella tasmanica 3 gal., 12" x 18", 18" o.c., full 30 'GREEN ISLAND' FICUS Ficus 'Green Island' 3 gal., 18' x 18', 18' o.c., full **TOPSOIL:** 11 c.y. '2100 MIX' FOR PLANTING-PER ATLAS PEAT AND SOIL FOR PLANTER BOXES BASED UPON 36" DEPTH, X 99 S.F. / 27 = 11 C.Y. **MULCHING:** DRK BRWN RECYCLED MULCH 3" DEPTH, SPREAD IN PLACE, ATLAS PEAT AND SOIL PROVIDE SAMPLE FOR APPROVAL PRIOR TO INSTALLATION TOPSOIL, SOD AND MULCH QUANTITIES SHOWN ARE APPROXIMATE, CONTRACTOR TO PROVIDE A UNIT PRICE PER UNIT AND WILL BE PAID ON THAT UNIT PRICE BASIS UPON FINAL INSPECTION AND APPROVAL **INSTALLATION WATERING:** CONTRACTOR SHALL THOROUGHLY WATER-IN ALL PLANTINGS WHEN PLANTED, AND SHALL CONTINUE WATERING UNTIL FINAL INSPECTION AND APPROVAL BY

THE LOCAL GOVERNING AGENCY AND THE OWNER



Llorente

Architects

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IN ASSOCIATION WITH:

JAMES F. SOCASH RLA # 0001132

NEW 32 UNITS

DEVELOPMENT AT: DOWNTOWN HOLLYWOOD

1914 - 1920 PIERCE STREET HOLLYWOOD, FL. 33020

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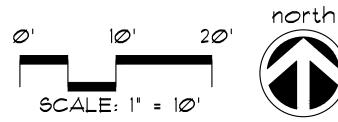


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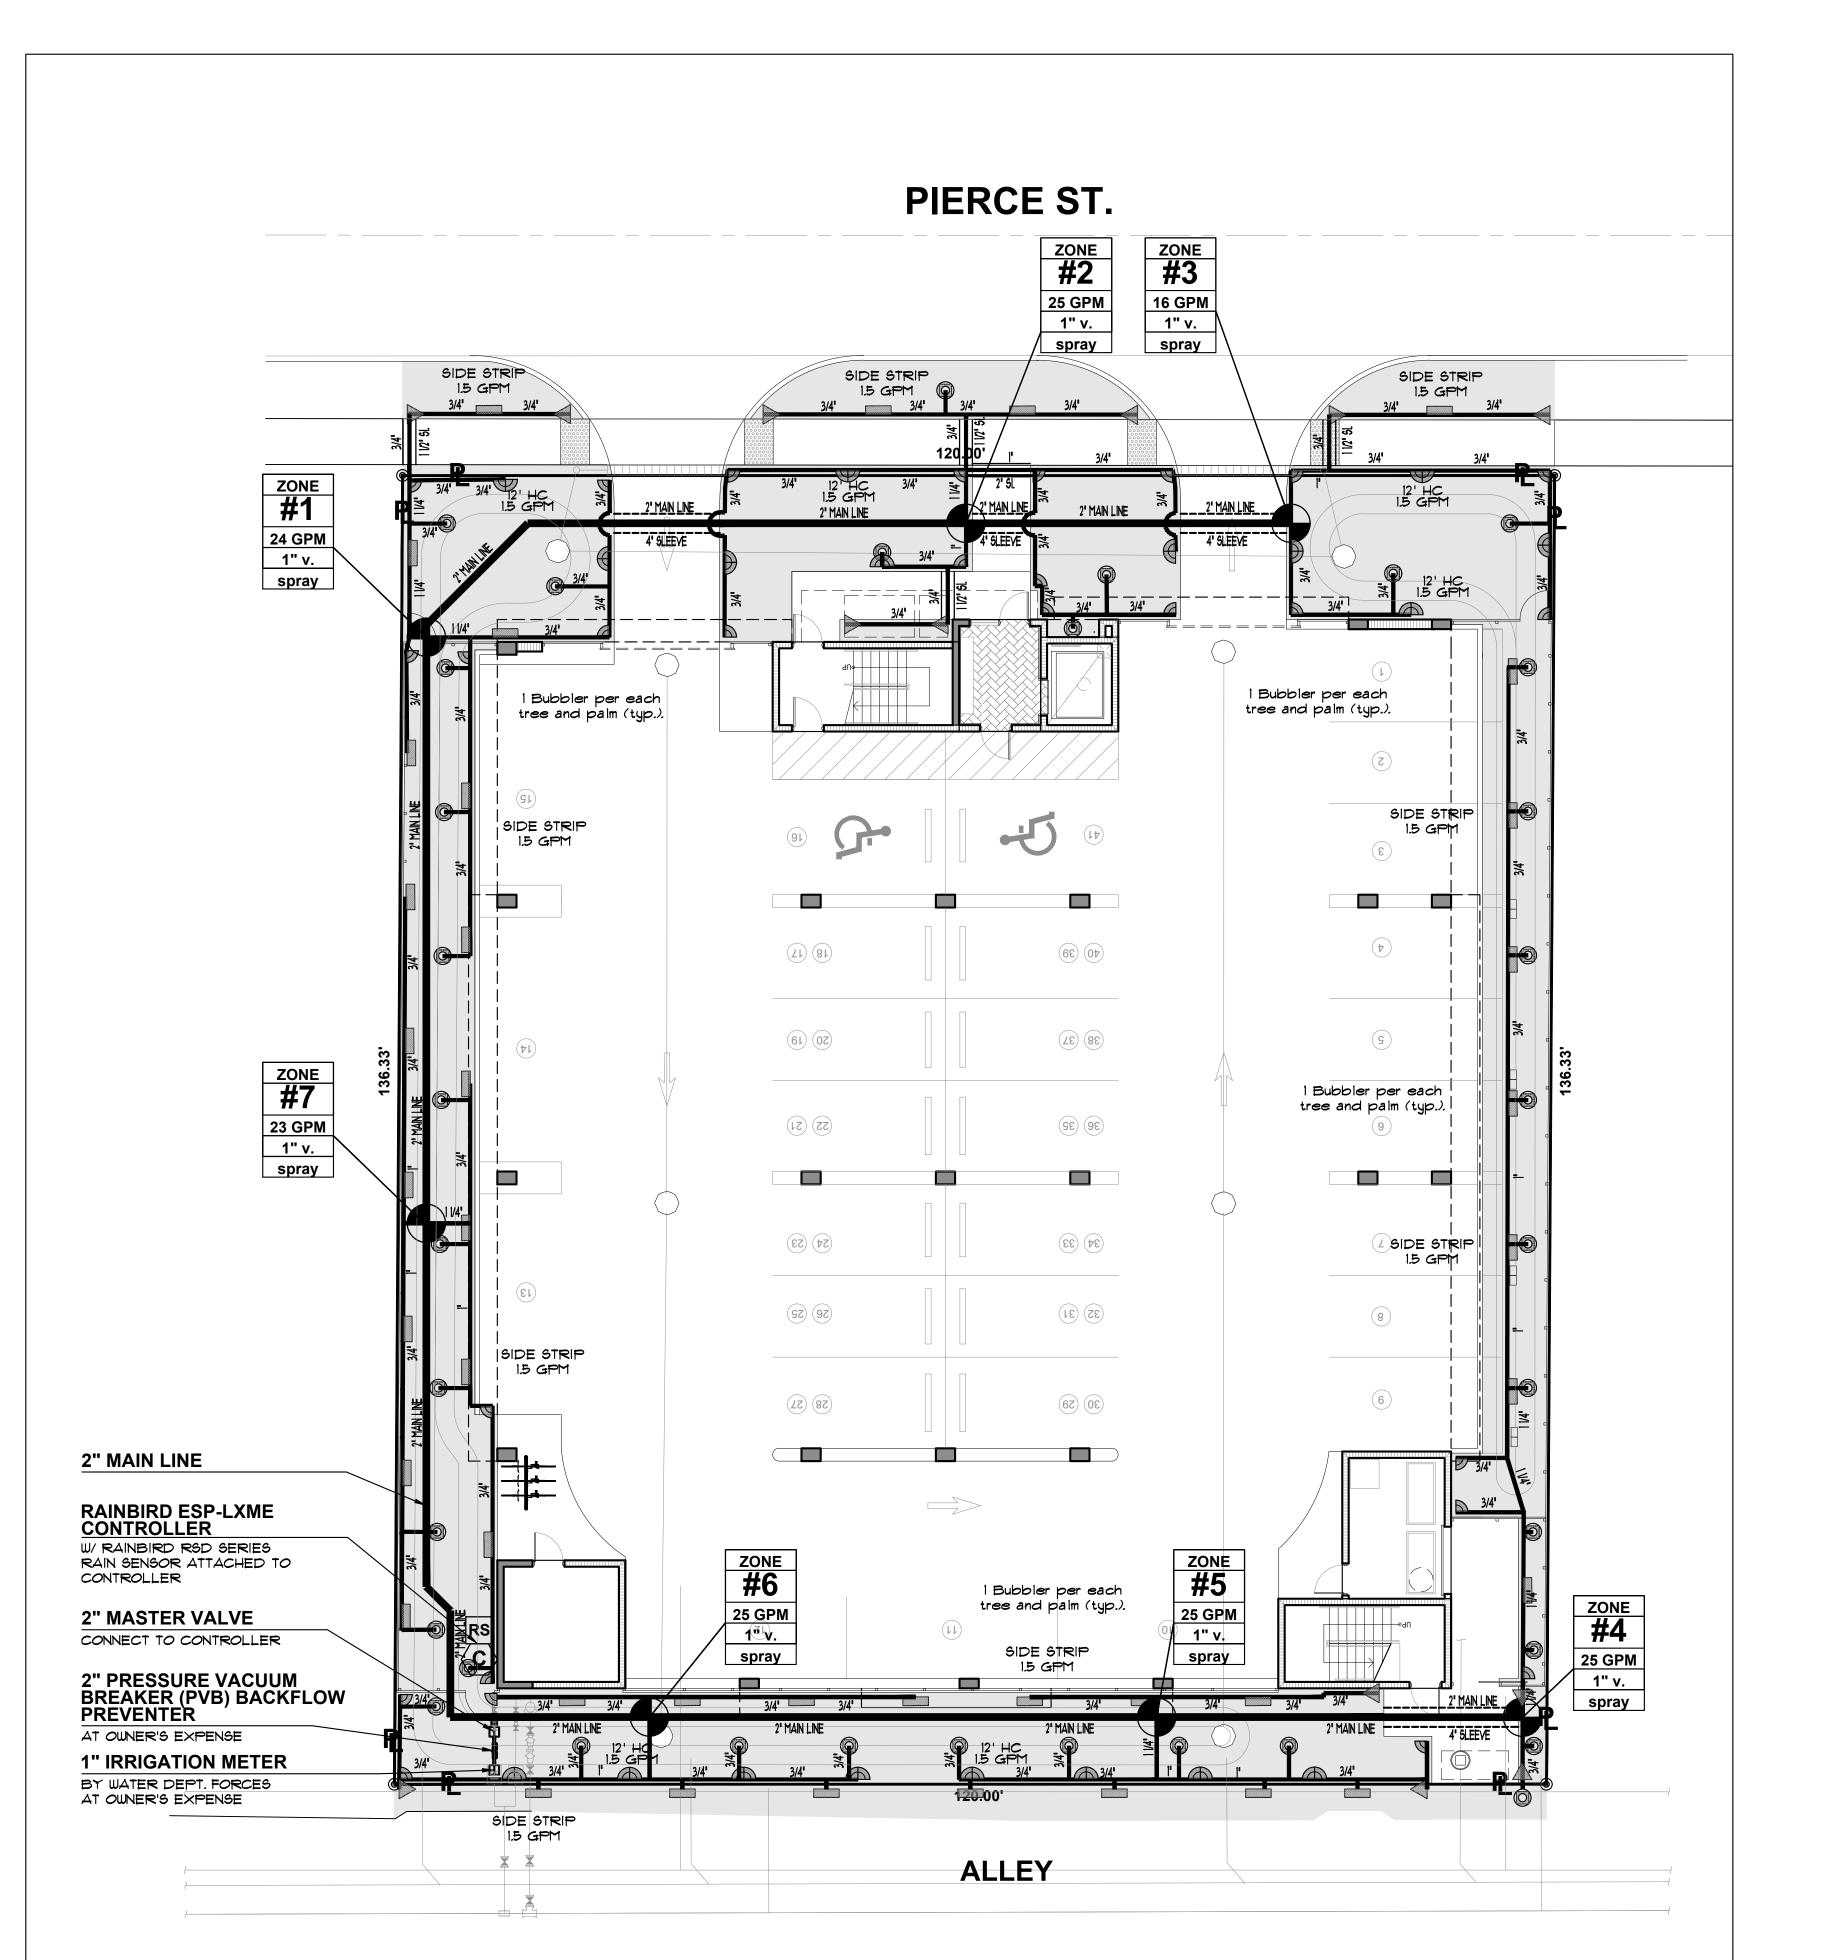
jimmy@jfsdesignfl.com

A WRITTEN TREE REMOVAL PERMIT IS REQUIRED FROM THE CITY OF HOLLYWOOD PRIOR TO REMOVAL OF ANY SPECIFICATIONS, ETC. NON-EXEMPT TREE OR PALMS FROM THE


SEE SHEETS L-1 AND L-2 FOR SECTOR LANDSCAPE PLAN, DETAILS, NOTES,









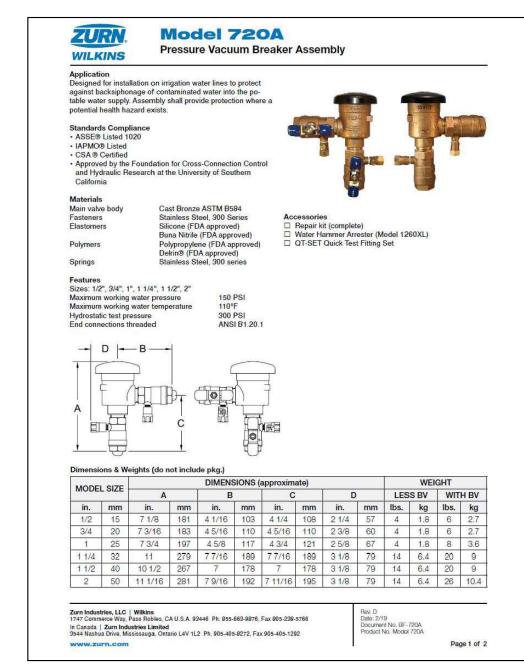

_	NG CODE- APPENDIX F RT V- A-6					
WATER PIPE SIZE	SLEEVE SIZE					
3/4"	1 1/2"					
1"	2"					
1 1/4"	2 1/2"					
1 1/2"	3'					
2"	4"					
3" 4"	6' 8'					
SLEEVES TO EXTEND A MIN. 3' BEYOND ALL PAVED AREAS, BACKFILL AND COMPACTION PER APPENDIX F.						
FLORIDA BUILDING CODE- APPENDIX F PIPE INSTALLATION-DEPTH OF COVER						
VEHICLE	TRAFFIC AREAS					
PIPE SIZE (INCHES)	DEPTH OF COVER (INCHES)					
1/2" TO 2 1/2"	18" TO 24"					
3" TO 5"	24" TO 3Ø"					
6" OR GREATER	30 TO 36'					
	30 TO 36'					
NON-TRAFFIC ANI	30 TO 36' D NON-CULTIVATED AREAS					
NON-TRAFFIC ANI	30 TO 36" DINON-CULTIVATED AREAS DEPTH OF COVER (INCHES)					
NON-TRAFFIC ANI PIPE SIZE (INCHES) 1/2" TO 1 1/4"	30 TO 36' D NON-CULTIVATED AREAS DEPTH OF COVER (INCHES) 12'					
NON-TRAFFIC ANI PIPE SIZE (INCHES) 1/2" TO 1 1/4" 1 1/2" TO 2"	30 TO 36' DINON-CULTIVATED AREAS DEPTH OF COVER (INCHES) 12' 12' TO 18"					

RAIN BIRD.

Utility which learns the normal flow rate of each sta-tion. Each time the station runs FloWatch compares

late the problem by turning off the affected station or master valve. FloWatch shall be compatible with both normally closed and open master valves. A Manual Master Valve Water Windows shall be provided to

The controller shall have an alarm indicator light on the front panel visible through the outer door with the door closed and locked. The alarm light shall

prompt the user to select the alarm softkey to review the alarm condition(s).

The controller shall be compatible with the ETC-LX E

Communication Cable). The IQ v2.0 Central Control

The controller shall offer an optional metal cabinet

The controller shall be as manufactured by Rain Bird

The Intelligent Use of Water*
www.rainbird.com

The ESP-LXME Controller shall be of a hybrid type that cuitry capable of fully automatic or manual operation. The controller shall be housed in a wall-mountable, weather-resistant plastic cabinet with a key-locking installation. The controller shall have the ability to The controller shall have a base station capacity of

of receiving station modules of 4, 8, or 12 stations to create a controller capacity of up to 48 stations. All stations shall have the capability of independently obeying or ignoring the weather sensor as well as using or not using the master valve. Station timing

shall have up to 8 start times per day for a total of 32 possible start times per day. The 4 programs shall be stations per program and total for the controller. breaker that shall sense a station with an electrical overload or short circuit and shall bypass that station and continue to operate all other stations.

The controller shall have a 365-day calendar with Permanent Day Off feature that allows a day(s) of the work to be to sensor input shall accept a direct input from a flow sensor input shall accept a direct input breaker that shall sense a station with an electrical

specified day(s) of the week. The controller shall also have a Calendar Day Off feature allowing the user to select up to 5 dates up to 35-days in the future when the controller shall not start programs. The controller shall incorporate a Rain Delay feature allowing the user to set the number of days the controller should The controller shall have Cycle+Soak water manage-ment software which is capable of operating each sta-tion for a maximum cycle time and a minimum soak time to reduce water run-off. The maximum cycle time shall not extended by Seasonal Adjustment.

feature providing real-time flow, power, and station management. FloManager shall manage the number water source capacity, station flow rate, number of using or not using the master valve. Station timing shall be from 0 minutes to 12 hours. The controller shall have a Seasonal Adjustment by program which adjusts the station run time from 0 to 300% in 1% increments. The controller shall also have a Monthly Seasonal Adjustment of 10 to 300% by month. Station timing with Seasonal Adjustment shall be from 1 second to 16 hours.

The controller shall have 4 separate and independent programs which can have different start times, start day cycles, and station run times. Each program shall have a post of the programs which can have different start times, start day cycles, and station run times. Each program shall have a post of the programs which can have different start times, start day cycles, and station run times. Each program shall be an experiment of the program of the station shall have a seasonal Adjustment shall be from 1 second to 16 hours. The controller shall have 4 separate and independent programs which can have different start times, start day cycles, and station run times. Each program allowed to overlap operation based on user defined settings which control the number of simultaneous programs. This function sets the allowed start and ler including the master valve/pump start circuit. The paused and watering automatically resumes when controller shall have an electronic, diagnostic circuit the Water Window opens the next time.

The controller shall have a 365-day calendar with Permanent Day Off feature that allows a day(s) of the week to be turned off on any user selected program Rain Bird Corporation 6991 E. Southpoint Road Tucson, AZ 85756 Phone: (520) 741-6100 Fax: (520) 741-6522

Rain Bird Technical Services (800) RAINBIRD (1-800-724-6247) (U.S. and Canada)

IRRIGATION LEGEND

Rain Bird Corporation

I' IRRIGATION METER BY WATER DEPT. FORCES AT OWNER'S EXPENSE

2" PRESSURE VACUUM BREAKER (PVB)

2" MASTER YALVE CONNECT TO CONTROLLER

BACKFLOW PREVENTER

PROPOSED 2" PVC Main Supply Line- SCHEDULE 40

IRRIGATION CONTROLLER RAINBIRD ESP-LX-ME MODULAR RAIN SENSOR- RAINBIRD RSD SERIES

ATTACHED TO CONTROLLER JUNCTION BOX

W/ WATERPROOF CONNECTORS EXISTING ELECTRIC VALVE

I" ELECTRIC VALVES, RAINBIRD PEB SERIES, OR APPROVED EQUAL IN 10" VALVE BOX

ZONE DESIGNATION 0 GPM 1" valve

LATERAL LINE

PIPE CONNECTION

PIPE CROSSING 15' rādīus 12' radius

RAINBIRD 1800 STRIP-TYPE 15 EST (END STRIP), 15 CST (CENTER STRIP)

PIPE IN SLEEVE (SEE SIZING CHART)

RAINBIRD 1800 "U SERIES" PRS, 4", 6", 12" POP-UP- QUARTER, HALF FULL 10', 12', 15' RADIUS AS SHOWN. 10' radius

> RAINBIRD -5 SERIES MPR STREAM BUBBLER, NOZZLES, 5' RADIUS, 1.0 GPM


SPECIAL NOTES:

6-1: A ROUGH INSPECTION IS REQUIRED BY THE CITY OF HOLLYWOOD PRIOR TO TRENCH BACKFILLING AND A FINAL INSPECTION SHALL BE REQUIRED PRIOR TO COMPLETION OF THE IRRIGATION WORK.

5-2: SOUTH FLORIDA WATER MANAGEMENT WATER RESTRICTIONS, PHASE II ARE IN EFFECT. NEW LANDSCAPE SHALL BE EXEMPT PER SFUMD FOR A PERIOD OF SIXTY DAYS AFTER INSTALLATION WITH CONTRACTOR AND/OR OWNER TO ASSUME RESPONSIBILITY AFTER THAT INITIAL

6-3: ALL NEW IRRIGATION TO BE DUG BY HAND WHEN INSTALLING CLOSE TO EXISTING TREES. ANY ROOTS THAT ARE DAMAGED WILL NEED TO BE PRUNDED BY AN ISA CERTIFIED ARBORIST.



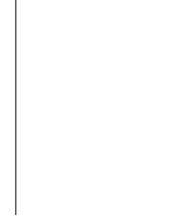

Llorente

Architects


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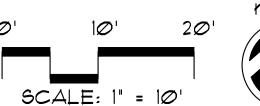



JFS Design Inc. LANDSCAPE ARCHITECTURE 1833 N.W. 140th TERRACE PEMBROKE PINES, FL. 33028

immy@jfsdesignfl.com


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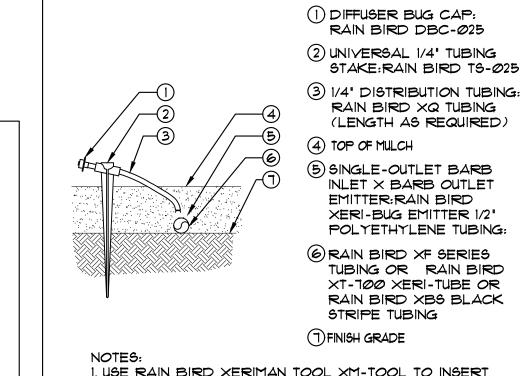
SEE SHEETS IRR-1 THROUGH IRR-4 FOR GROUND LEVEL SITE IRRIGATION PLAN, AND UPPER LEVEL IRRIGATION PLANS.



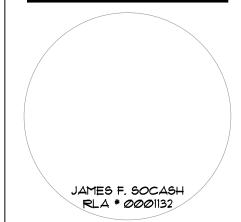

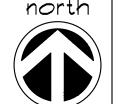12/15/2023



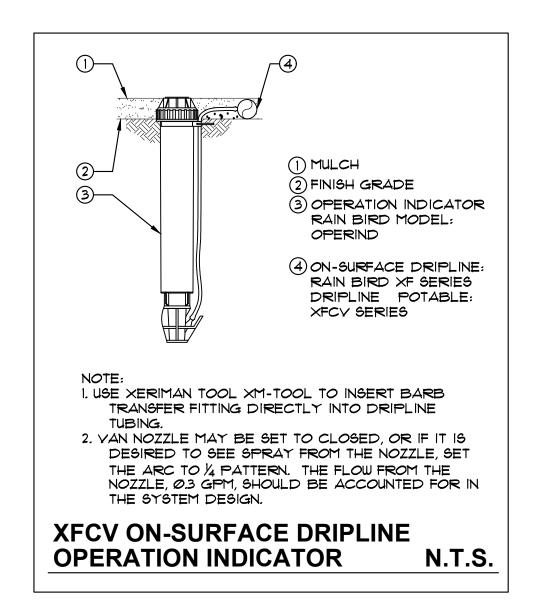


(2) PVC SCH 40 TEE OR EL (TYP.) (4) BARB X MALE FITTING: RAIN

> XT-700 XERI-TUBE OR RAIN BIRD XBS BLACK STRIPE TUBING (7) FINISH GRADE

1. USE RAIN BIRD XERIMAN TOOL XM-TOOL TO INSERT EMITTER DIRECTLY INTO 1/2" POLYETHYLENE TUBING. 2. RAIN BIRD XERI-BUG BARB X BARB EMITTERS ARE AVAILABLE IN THE FOLLOWING MODELS: XB-05PC 0.5 GPH

XERI-BUG INTO 1/2" TUBUNG W/ 1/4" TUBING, STAKE & BUG CAP N.T.S.

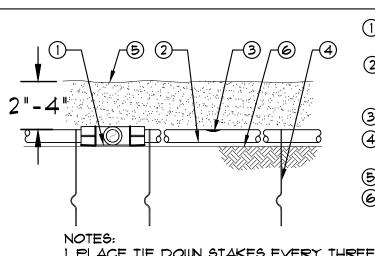


(1) EASY FIT COMPRESSION TEE: RAIN BIRD MDDFTEE (2) ON-SURFACE DRIPLINE: RAIN BIRD XF SERIES DRIPLINE POTABLE: XFCY DRIPLINE INLINE DRIP EMITTER OUTLET


TIE DOWN STAKE: RAIN BIRD TDS-050 WITH BEND (TYPICAL)


6 FINISH GRADE


1. PLACE TIE DOWN STAKES EVERY THREE FEET IN SAND, FØUR FEET IN LOAM, AND FIVE FEET IN CLAY. 2. AT FITTINGS WHERE THERE IS A CHANGE OF DIRECTION SUCH AS TEES OR ELBOWS, USE TIE-DOWN STAKES ON EACH LEG OF THE CHANGE OF DIRECTION.


XFCV ON-SURFACE N.T.S. **DRIPLINE AT GRADE**

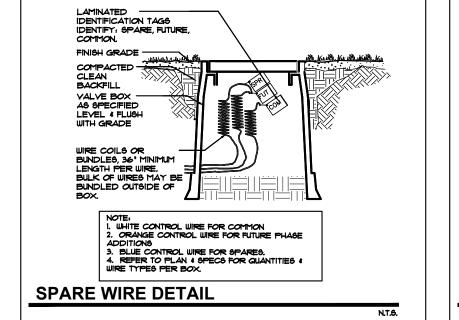

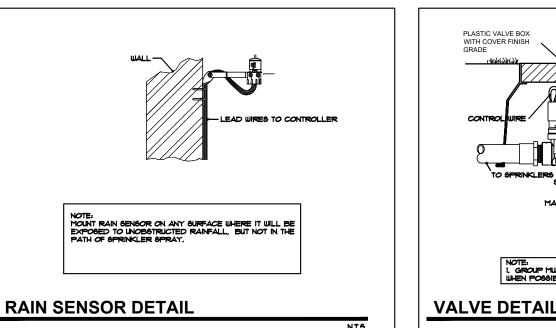

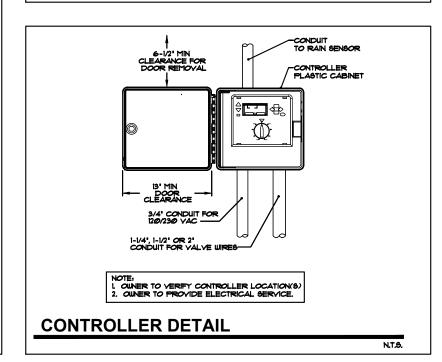

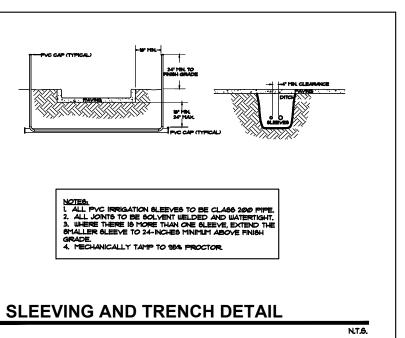

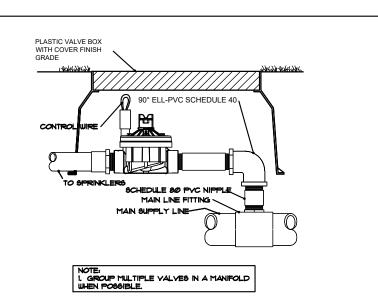

FLEXIBLE SWING JOINT OF FUNNY PIPE -AS NEEDED POP-UP SPRAY - ROTOR DETAIL

GENERAL IRRIGATION NOTES

- IRRIGATION CONTRACTOR SHALL PROVIDE, FURNISH AND INSTALL A FULLY AUTOMATIC IRRIGATION SYSTEM WHICH WILL COMPLY WITH ALL LOCAL CODE, STATE CODE & FLORIDA WATER MANAGEMENT DISTRICT (SFWMD) REQUIREMENTS.
- 2. THE IRRIGATION CONTRACTOR SHALL SCHEDULE AN ON-SITE PRE-CONSTRUCTION CONFERENCE WITH THE OWNER & THE OWNER'S AUTHORIZED REPRESENTATIVE PRIOR TO COMMENCEMENT OF INSTALLATION OF THE IRRIGATION SYSTEM.
- CONTRACTOR SHALL INSTALL A POP-UP TYPE HEADS. SPRAY TYPE SHALL BE ROTOR, IMPACT, SPRAY OR BUBBLER AND SHALL BE SO INSTALLED TO NOT CAUSE ANY OVERSPRAY ONTO ANY PAVED SURFACES, I.E. ROADS, SIDEWALKS, ETC. ALL FIXTURES SHALL BE "TORO", "RAINBIRD" OR AN APPROVED EQUAL. ALL WORK SHALL BE DONE IN A PROFESSIONAL MANNER AND AS PER THE MANUFACTURER'S SPECIFICATIONS. SPRAY HEADS SHALL BE 4" POP-UPS FOR SODDED AREAS, 6" FOR GROUNDCOVER PLANTINGS AND 12" POP-UPS FOR ALL PLANTING AND SHRUB BEDS. SPRAY HEADS ON RISERS SHALL ONLY BE PERMITTED PER THE LAND. ARCH.
- ALL MAIN SUPPLY LINE SHALL BE PVC SCHEDULE 40 PIPE. ALL PVC FITTINGS SHALL BE SCHEDULE 40. THE MAIN LINE IS SHOWN SCHEMATICALLY, LOCATE MAIN LINES IN LANDSCAPE AREAS WHERE POSSIBLE AND SLEEVE UNDER PAVEMENT WHERE NECESSARY. MAIN LINES SHALL BE IN THE SAME TRENCH WITH LATERAL LINES WHERE POSSIBLE.
- CONTRACTOR SHALL CONSTRUCT CONCRETE THRUST BLOCKS, 12" X 12" X 12" AT ALL "T"

INTERSECTIONS OR BENDS 45 DEGREES OR GREATER ON THE MAIN LINE.

- 6. MINIMUM PIPE SIZE SHALL BE 3/4" PIPE
- CONTRACTOR SHALL FAMILIARIZE HIMSELF WITH THE LOCATION OF AND AVOID & PROTECT ALL UTILITY LINES, DUCTS, BURIED CABLES AND OTHER UTILITIES IN THE AREA, CONTRACTOR WILL BE RESPONSIBLE FOR THE REPAIR, LIABILITY AND COSTS INCURRED IN THE DAMAGE OR DESTRUCTION OF SAID UTILITIES. CALL U.N.C.L.E. 1(800) 432-8770, 48 HOURS PRIOR TO COMMENCENT OF ANY WORK FOR PROPER UTILITY LOCATION AND CLEARANCES.
- THE CONTRACTOR SHALL SECURE ALL WORK WITH THE PROJECT MANAGER, LANDSCAPE CONTRACTOR AND ALL OTHER CONTRACTORS TO INSURE PROPER INSTALLATION, SCHEDULING
- THE CONTRACTOR SHALL COORDINATE WITH THE PROJECT MANAGER TO PROVIDE ELECTRICAL SUPPLY TO THE CONTROLLER, PUMP, ETC. AS NEEDED.
- THE CONTRACTOR SHALL BE RESPONSIBLE TO SECURE ALL PERMITS AS MAY BE DEEMED NECESSARY TO PERFORM THE WORK. ENTIRE SYSTEM SHALL BE INSTALLED IN COMPLIANCE WITH ALL LOCAL AND STATE CODES. THE OWNER IS RESPONSIBLE FOR ALL PERMIT FEES.
- 11. ALL SLEEVES UNDER PAVEMENT SHALL BE BURIED PER FL. BLDG CODE, APPENDIX "F". ALL LATERAL SLEEVES UNDER SIDEWALKS SHALL BE BURIED BELOW WALKWAYS AND SHALL BE SCHEDULE 40 PVC. ALL SLEEVING SHALL BE SCHEDULE 40 PVC PIPE & SHALL BE 2 TIMES THE
- MAIN OR LATERAL PIPE SIZE 12. THE CONTRACTOR SHALL CONNECT THE MASTER VALVE (WHEN APPLICABLE) & ALL ELECTRIC
- VALVES TO THE CONTROLLER & PROVIDE PROPER SYNCHRONIZATION. 13. ALL LOW-VOLTAGE ELECTRIC VALVES SHALL BE #14 DIRECT BURIAL. ALL WIRES UNDER ROADS TO BE PLACED IN A SEPARATE 1" SLEEVE. CONTRACTOR SHALL PROVIDE A MINIMUM OF 2 EXTRA
- WIRES FOR EMERGENCY POST-INSTALLATION WIRING. 14. ALL LINE LOCATIONS ARE APPROXIMATE. CONTRACTOR SHALL ADJUST TRENCHING AND LOCATION

OF SPRAY HEADS IN THE FIELD FOR EXISTING CONDITIONS, WALKS, UTILITIES, STRUCTURES &

15. CONTRACTOR SHALL PROVIDE A ONE-YEAR GUARANTEE ON ALL PARTS AND A 90-DAY GUARANTEE ON LABOR FROM THE DATE OF FINAL ACCEPTANCE

PLANTINGS TO PROVIDE AND INSURE 100% COVERAGE AND 100% OVERLAP.

- 16. THE IRRIGATION CONTRACTOR SHALL RECORD ALL CHANGES MADE TO THE IRRIGATION SYSTEM DURING INSTALLATION, & PROVIDE AN AS-BUILT DRAWING TO THE OWNER'S REPRESENTATIVE UPON COMPLETION AND ACCEPTANCE OF THE WORK
- 17. THE IRRIGATION CONTRACTOR SHALL INSTRUCT THE OWNER OR THE OWNER'S REPRESENTATIVE IN THE COMPLETE OPERATION & MAINTENANCE OF THE SYSTEM. THE CONTRACTOR SHALL FURNISH TWO (2) COPIES OF AN IRRIGATION SYSTEM MANAGEMENT MANUAL PREPARED BY THE MANUFACTURER & THE SYSTEM INSTALLER.
- 18. THE IRRIGATION CONTRACTOR SHALL CHECK AND ADJUST THE SYSTEM AT THE END OF THE 90-DAY PERIOD, FROM THE DATE OF FINAL ACCEPTANCE
- 19. ANY IRRIGATION PIPING WITHIN THE CONFINES OF ANY BUILDING SHALL BE CLEARLY MARKED "NON POTABLE WATER".
- 20. TREE AND PALM PLANTINGS IN RIGHTS OF WAYS SHALL HAVE ONE FLOOD BUBBLER PER TREE OR PALM. COORDINATE PIPING AND SEEVING AS NEEDED

XFCV ON-SURFACE

DRIPLINE LAYOUT

2-3"

MULCH/

DETAIL-A

DRIP MANIFOLD

BURIAL DEPTH

DETAIL-4

JFS Design Inc. LANDSCAPE ARCHITECTURE

) PVC EXHAUST HEADER

(3) FLUSH POINT (TYPICAL)

(5) PERIMETER OF AREA

BIRD XFF-MA FITTING

(6) BARB X BARB INSERT TEE OR

CROSS: RAIN BIRD XFF-TEE

OR RAIN BIRD XFD-CROSS

(1) PERIMETER DRIPLINE PIPE TO

(8) ON-SURFACE DRIPLINE: RAIN

BIRD XF SERIES DRIPLINE

(10) PVC SUPPLY PIPE FROM RAIN

(SIZED TO MEET LATERAL FLOW

DRIPLINE SHOULD NOT EXCEED

18" SPACING

NOMINAL FLOW (GPH)

637 529

N.T.S.

Ø.9

337

477

0.6

254

4Ø2

498

573

BIRD CONTROL ZONE KIT

(II) TOTAL LENGTH OF SELECTED

LENGTH SHOWN IN TABLE

(12) PVC SCH 40 RISER PIPE

XFCY DRIPLINE MAX. LATERAL LENGTHS

136

205

248

281

309

(13) AIR RELEASE VALVE

12" SPACING

PRESSURE | NOMINAL FLOW (GPH)

192

289

35Ø

436

100 LF. 67 LF.

20

(TYPICAL) POTABLE: XFCY

BE INSTALLED 2"-4" FROM


PERIMETER OF AREA

DEMAND)

1833 N.W. 140th TERRACE PEMBROKE PINES, FL. 33028 immy@jfsdesignfl.com


A WRITTEN TREE REMOVAL PERMIT IS REQUIRED FROM THE CITY OF HOLLYWOOD PRIOR TO REMOVAL OF ANY NON-EXEMPT TREE OR PALMS FROM THE

SEE SHEETS IRR-1 THROUGH IRR-4 FOR GROUND LEVEL SITE IRRIGATION PLAN, AND UPPER LEVEL IRRIGATION PLANS.

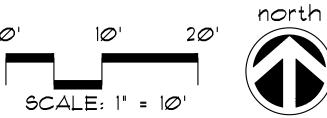

IRRIGATION DETAILS, SPECIFICATIONS, ETC.

PROFESSIONAL SEAL:

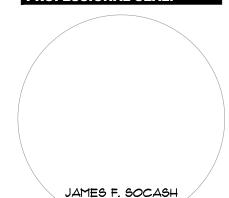

RLA * 0001132

NEW 32 UNITS

DEVELOPMENT AT: DOWNTOWN HOLLYWOOD

1914 - 1920 PIERCE STREET


DATE ISSUE DESCRIPTION


HOLLYWOOD, FL. 33020


DRAWING INFORMATION:

03.28.2023 DRAWN BY: J.B. CHECKED BY A.LL.

REF NUMBER

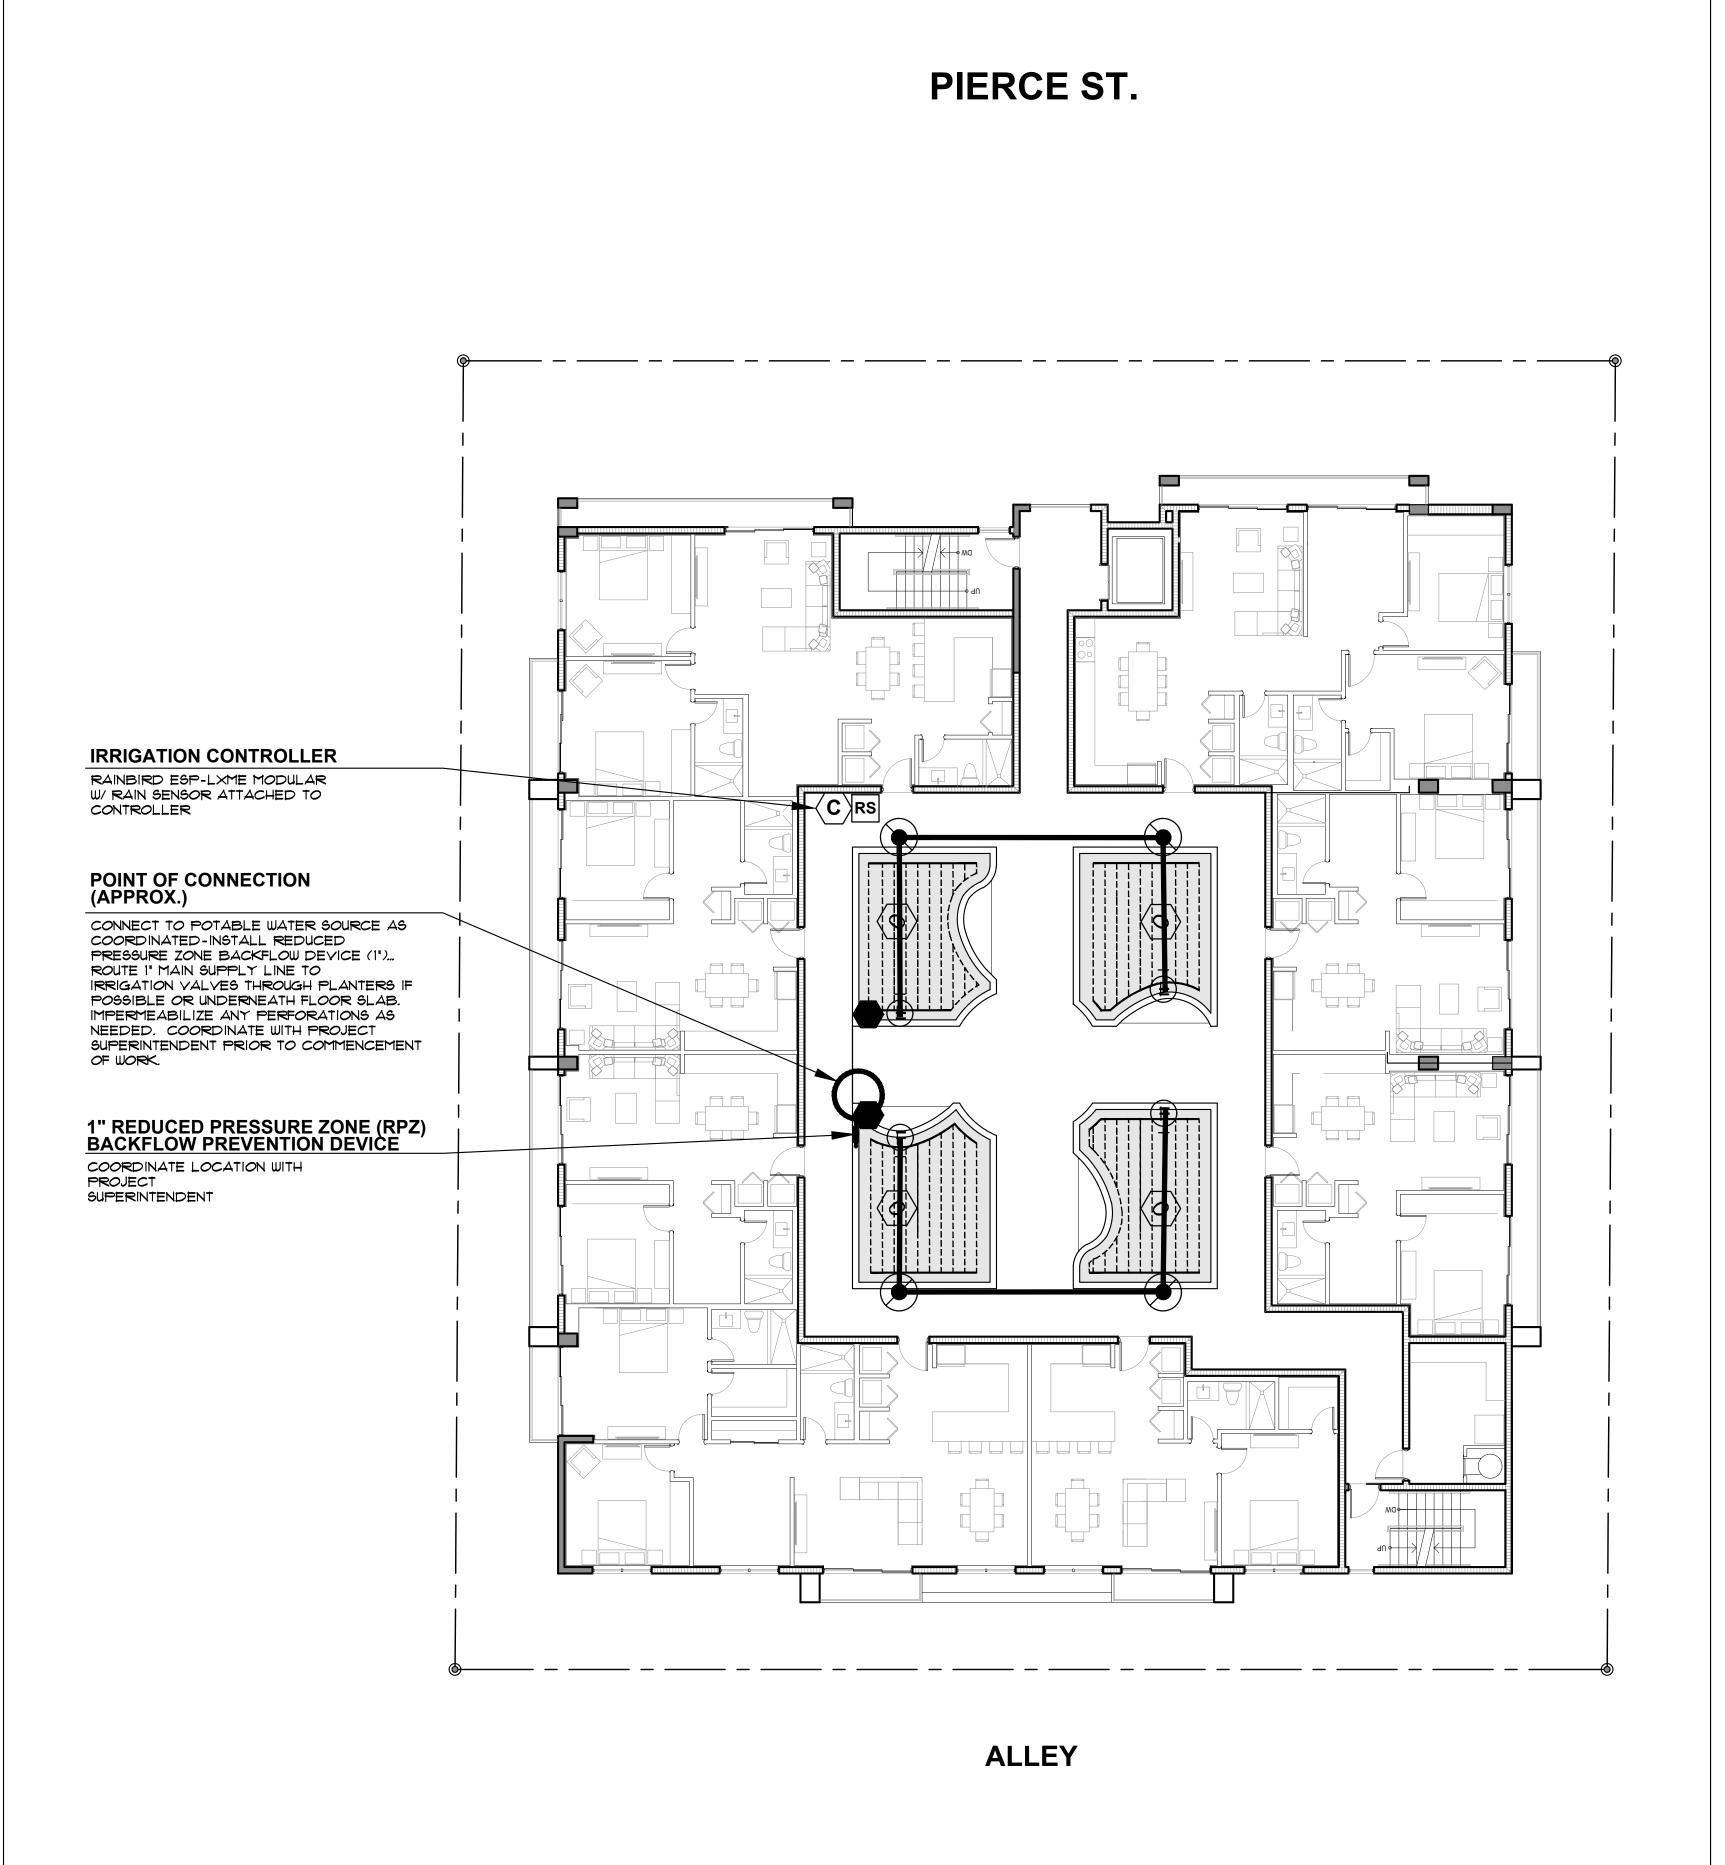

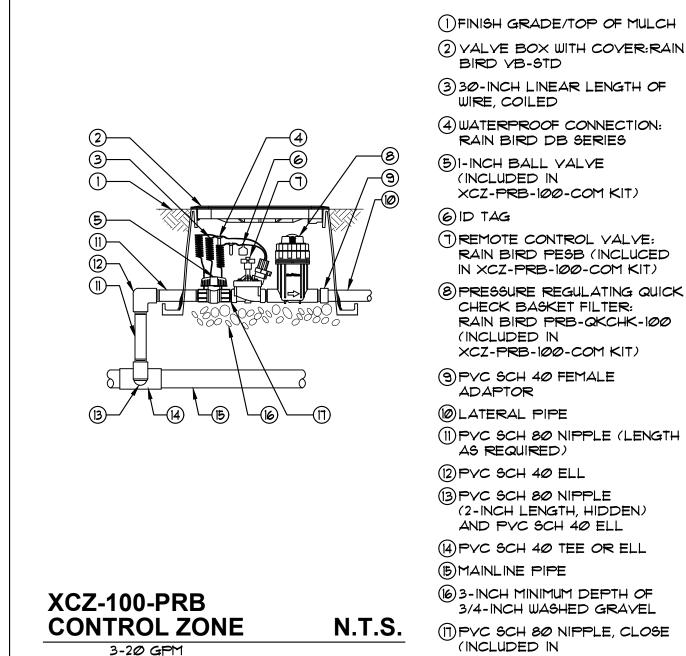


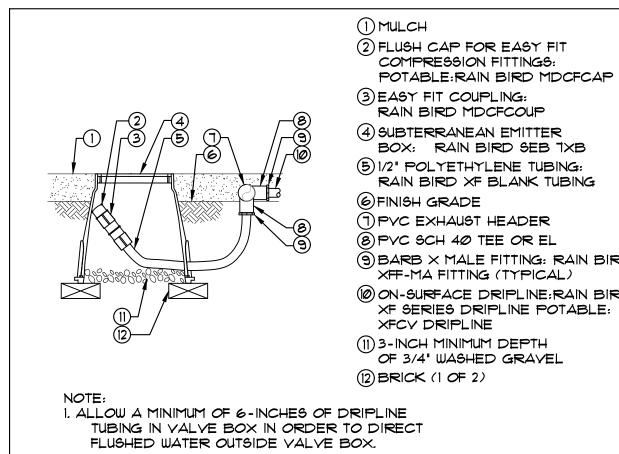

(4) SUBTERRANEAN EMITTER BOX: RAIN BIRD SEB TXB (5) 1/2" POLYETHYLENE TUBING: RAIN BIRD XF BLANK TUBING PVC EXHAUST HEADER B) PVC SCH 40 TEE OR EL (9) BARB X MALE FITTING: RAIN BIRD XFF-MA FITTING (TYPICAL) (10) ON-SURFACE DRIPLINE: RAIN BIRD XF SERIES DRIPLINE POTABLE: (1) 3-INCH MINIMUM DEPTH OF 3/4" WASHED GRAVEL

XCZ-PRB-100-COM KIT)

XFCV ON-SURFACE DRIPLINE FLUSH POINTE WITH EASY FIT COMPRESSION FITTINGS

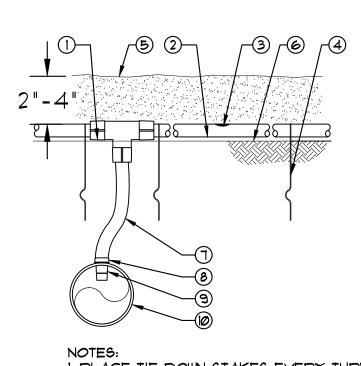

(1) EASY FIT COMPRESSION TEE: RAIN BIRD MODFTEE 2 ON-SURFACE DRIPLINE: RAIN BIRD XF SERIES DRIPLINE

POTABLE: XFCY DRIPLINE

(3) INLINE DRIP EMITTER OUTLET (4) TIE DOWN STAKE: RAIN BIRD TDS-050 WITH BEND (TYPICAL)

(7) 1/2" POLYETHYLENE TUBING: RAIN BIRD XF SERIES BLANK TUBING (8) RATCHET CLAMP (INCLUDED

WITH ADAPTER) (9) INSERT ADAPTER FOR PVC PIPE: RAIN BIRD XFD-INVPC (10) PVC LATERAL PIPE

6 FINISH GRADE

1. PLACE TIE DOWN STAKES EVERY THREE FEET IN SAND, FØUR FEET IN LOAM, AND FIVE FEET IN CLAY. 2. AT FITTINGS WHERE THERE IS A CHANGE OF DIRECTION SUCH AS TEES OR

ELBOWS, USE TIE-DOWN STAKES ON EACH LEG OF THE CHANGE OF

XFCV ON-SURFACE DRIPLINE INSERT ADAPTER

N.T.S.



IN ASSOCIATION WITH:

IRRIGATION LEGEND

POINT OF CONNECTION (APPROXIMATE) CONNECT TO POTABLE WATER SOURCE AS COORDINATED-INSTALL REDUCED PRESSURE ZONE BACKFLOW DEVICE (1")... ROUTE I" MAIN SUPPLY LINE TO IRRIGATION VALVES THROUGH PLANTERS IF POSSIBLE OR UNDERNEATH FLOOR

IMPERMEABILIZE ANY PERFORATIONS AS NEEDED. COORDINATE WITH PROJECT SUPERINTENDENT PRIOR TO COMMENCEMENT OF WORK.



I' REDUCED PRESSURE ZONE (RPZ) BACKFLOW PREVENTER

" PVC Main Supply Line- Sch 40

RAINBIRD ESP-LXME MODULAR SERIES

W/ RAINBIRD RAIN SENSOR RAINBIRD RSD SERIES RAIN SENSOR ATTACHED TO CONTROLLER

RAIN BIRD XCZ-100-PRB-COM HIGH FLOW CONTROL ZONE KIT, FOR LARGE COMMERCIAL DRIP ZONES. 1-1/2 PESB VALVE WITH TWO I' PRESSURE REGULATING (40PSI) QUICK-CHECK BASKET FILTERS. FLOW RANGE: 3-20GPM.

RAIN BIRD 5-LRC 1" BRASS QUICK-COUPLING VALVE, WITH CORROSION-RESISTANT STAINLESS STEEL SPRING, LOCKING THERMOPLASTIC RUBBER COVER, AND 1-PIECE BODY.

PIPE TRANSITION POINT ABOVE GRADE PIPE TRANSITION POINT FROM PVC LATERAL TO DRIP TUBING WITH RISER TO ABOVE GRADE


DRIPLINE FLUSH VALVE CAP IN COMPRESSION FITTING COUPLER.

RAIN BIRD OPERIND DRIP SYSTEM OPERATION INDICATOR, STEM RISES 6' FOR CLEAR VISIBILITY WHEN DRIP SYSTEM IS CHARGEDTO A MINIMUM OF 20PSI. INCLUDES 16" OF 1/4" DISTRIBUTION TUBING WITH CONNECTION FITTING PRE-INSTALLED.

RAIN BIRD PC SINGLE OUTLET, PC DRIP EMITTER SINGLE OUTLET, PRESSURE COMPENSATING DRIP EMITTERS WITH SELF-PIERCING BARB INLET.

AREA TO RECEIVE DRIPLINE RAIN BIRD XFD-09-12 (12) XFD ON-SURFACE PRESSURE COMPENSATING LANDSCAPE DRIPLINE. Ø.9GPH EMITTERS AT 12"O.C. DRIPLINE LATERALS SPACED AT 12"APART, WITH EMITTERS OFFSET FOR T TRIANGULAR PATTERN. UY RESISTANT.

- LATERAL LINE (Sch. 160)

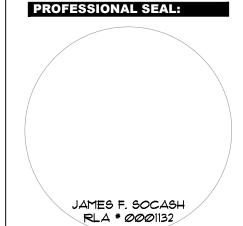

NEW 32 UNITS

DEVELOPMENT AT: DOWNTOWN HOLLYWOOD

1914 - 1920 PIERCE STREET HOLLYWOOD, FL. 33020

DATE ISSUE DESCRIPTION

DRAWING INFORMATION:

03.28.2023 DRAWN BY: CHECKED BY:

REF NUMBER:




JFS Design Inc. LANDSCAPE ARCHITECTURE


1833 N.W. 140th TERRACE PEMBROKE PINES, FL. 33028 immy@jfsdesignfl.com

A WRITTEN TREE REMOVAL PERMIT IS REQUIRED FROM THE CITY OF HOLLYWOOD PRIOR TO REMOVAL OF ANY NON-EXEMPT TREE OR PALMS FROM THE

SEE SHEETS IRR-1 THROUGH IRR-4 FOR GROUND LEVEL SITE IRRIGATION PLAN, AND UPPER LEVEL IRRIGATION PLANS.

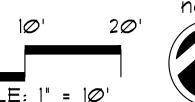



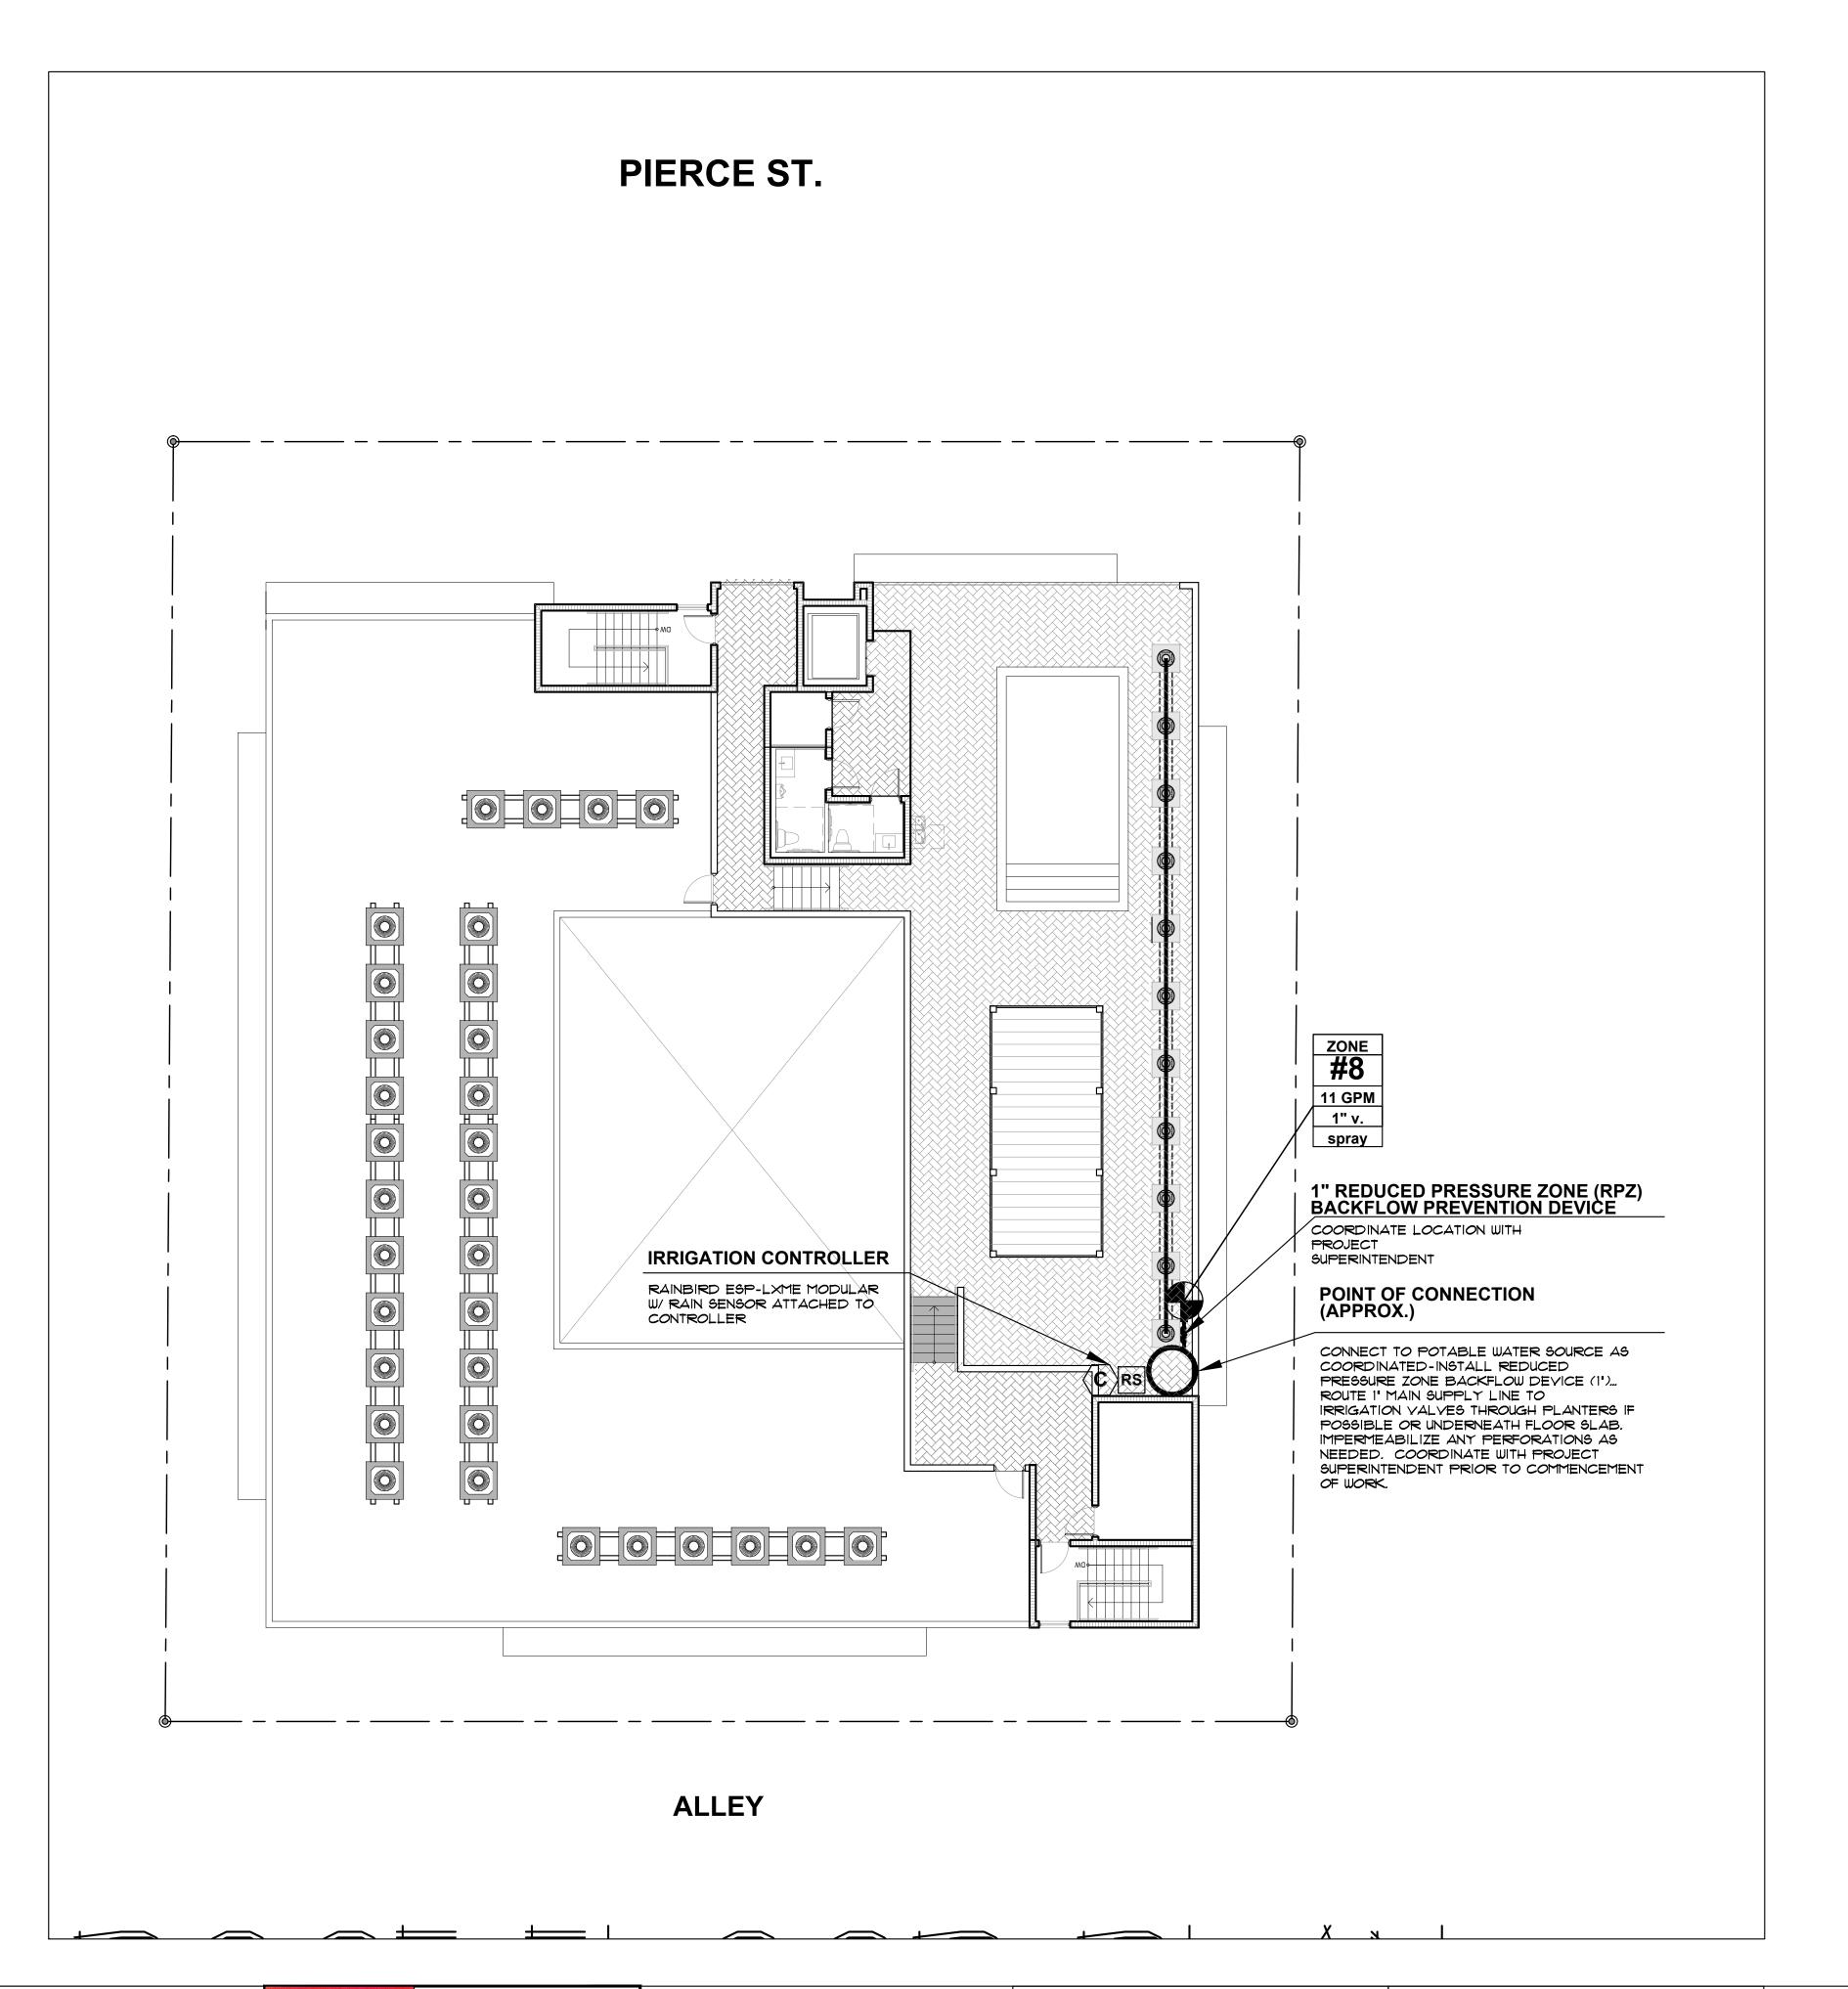



JAMES F. SOCASH RLA # 0001132

NEW 32 UNITS

DEVELOPMENT AT: DOWNTOWN HOLLYWOOD

1914 - 1920 PIERCE STREET HOLLYWOOD, FL. 33020

DATE ISSUE DESCRIPTION

DRAWING INFORMATION:

03.28.2023 DRAWN BY:

CHECKED BY: REF NUMBER:






JFS Design Inc. LANDSCAPE ARCHITECTURE LC 000393 1833 N.W. 140th TERRACE PEMBROKE PINES, FL. 33028

jimmy@jfsdesignfl.com


A WRITTEN TREE REMOVAL PERMIT IS REQUIRED FROM THE CITY OF HOLLYWOOD PRIOR TO REMOVAL OF ANY AND UPPER LEVEL IRRIGATION PLANS. NON-EXEMPT TREE OR PALMS FROM THE

SEE SHEETS IRR-1 THROUGH IRR-4 FOR GROUND LEVEL SITE IRRIGATION PLAN,

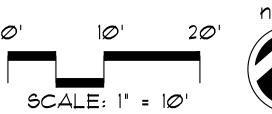





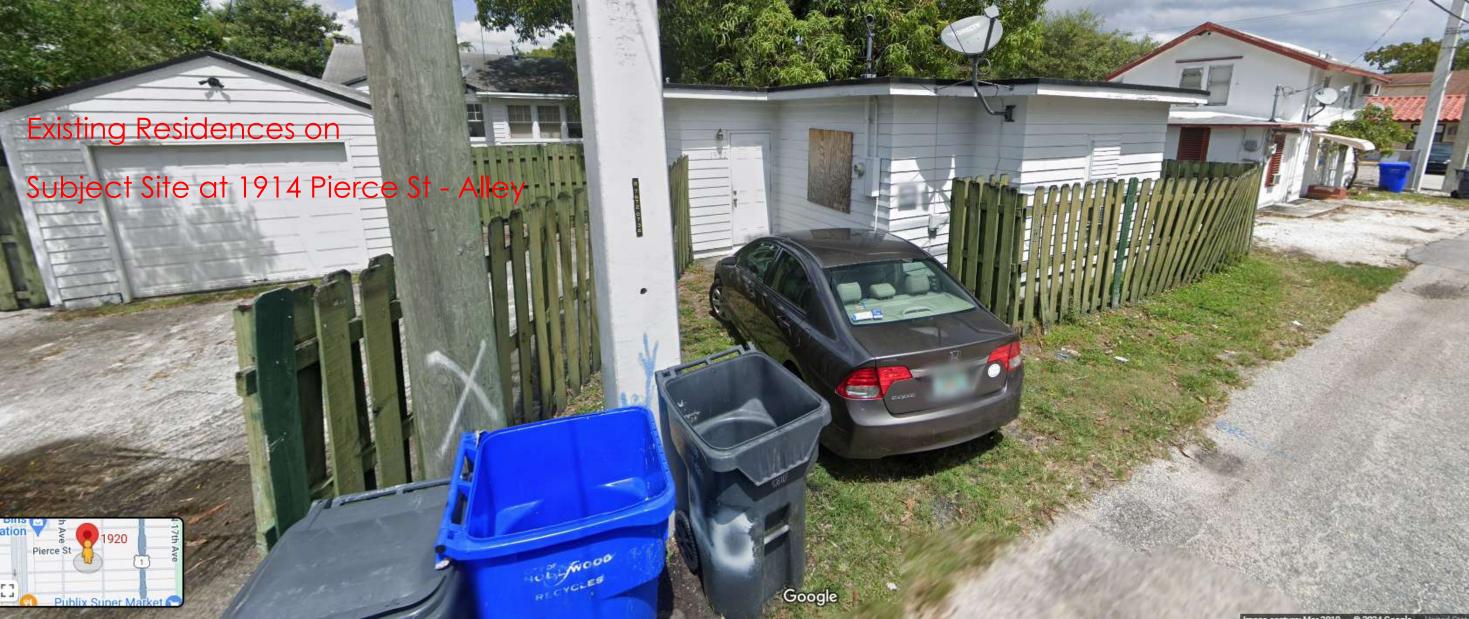













April 21, 2023

Pamela Butler, Senior Development Coordinator MG3 Group 2980 Northeast 207 Street, Suite 603 Aventura, Florida 33180 Via Email Only

Dear Ms. Butler:

Re: Platting requirements for a parcel legally described as Lots 19-21, Block 20, "Hollywood," according to the Plat thereof, as recorded in Plat Book 1, Page 21, of the Public Records of Broward County, Florida. This parcel is generally located on the south side of Pierce Street, between North 19 Avenue and North 20 Avenue, in the City of Hollywood.

This letter is in response to your correspondence regarding the Broward County Land Use Plan's platting requirements for a proposed multi-family residential development on the above referenced parcel.

Planning Council staff has determined that replatting <u>would not be required</u> by Policy 2.13.1 of the Broward County Land Use Plan (BCLUP) for the proposed development, subject to compliance with any applicable Broward County Trafficways Plan requirement.

As per the criteria of Policy 2.13.1, replatting is required for the issuance of building permits when constructing a non-residential or unified residential development, unless all of the following conditions are met:

- a. The lot or parcel is smaller than 10 acres and is unrelated to any adjacent development;
- b. The lot or parcel has been specifically delineated in a recorded plat;
- c. All land within the lot or parcel which is necessary to comply with the County Trafficways Plan has been conveyed to the public by deed or easement; and
- d. The proposed development is in compliance with the applicable land development regulations.

The subject parcel is less than 10 acres (approximately 0.38 acres) and meets the specifically delineated requirement. This platting interpretation is subject to the municipality finding that the proposed development is unrelated to any adjacent development, as noted in "a." above.

Pamela Butler April 21, 2023 Page Two

Some jurisdictions may be more restrictive and require platting in more situations than the BCLUP. The City of Hollywood's platting requirements should be investigated.

The contents of this letter are not a judgment as to whether this development proposal complies with State or local vehicular access provisions, the Broward County Trafficways Plan, permitted uses and densities, local zoning, the land development regulations of the municipality or the development review requirements of the BCLUP, including concurrency requirements.

If you have any additional questions concerning the BCLUP's platting requirements, please contact Dawn Teetsel at your convenience.

Respectfully,

Barbara Blake Boy Executive Director

BBB:DBT

cc/email: George Keller, City Manager

City of Hollywood


Shiv Newaldass, Director, Development Services

City of Hollywood



The School Board of Broward County, Florida PRELIMINARY SCHOOL CAPACITY AVAILABILITY DETERMINATION (SCAD)

SITE PLAN
SBBC-3683-2023
Municipality Number: 23-DP-20
Folio #: 514215013490 & 3500
Pierce Street Villas
November 1, 2023

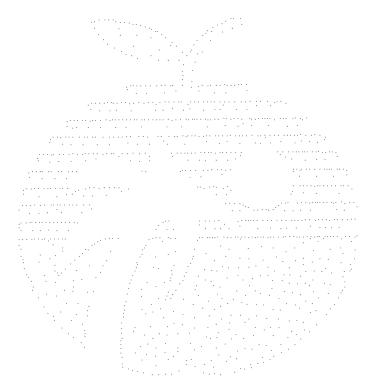

SCAD Expiration Date: April 29, 2024

Growth Management
Facility Planning and Real Estate Department
600 SE 3rd Avenue, 8th Floor
Fort Lauderdale, Florida 33301
Tel: (754) 321-2177 Fax: (754) 321-2179
www.browardschools.com

PRELIMINARY SCHOOL CAPACITY AVAILABILITY DETERMINATION SITE PLAN

PROJECT INFORMATION	NUMBER & TYPE OF PROPOSED UNITS	OTHER PROPOSED USES	STUDENT IMPACT	
Date: November 1, 2023	Single-Family:		Elementary:	0
Name: Pierce Street Villas	Townhouse:			_
SBBC Project Number: SBBC-3683-2023	Garden Apartments:		Middle:	0
County Project Number: N/A	Mid-Rise: 32			
Municipality Project Number: 23-DP-20	High-Rise:		High:	1
Owner/Developer: 1920 Pierce LLC	Mobile Home:			
Jurisdiction: Hollywood	Total: 32		Total:	1

SHORT RANGE - 5-YEAR IMPACT

Currently Assigned Schools	Gross Capacity	LOS * Capacity	Benchmark* Enrollment		Classroom Equivalent Needed to Meet LOS	% of LOS*** Capacity	Cumulative Reserved Seats
Dania Elementary	623	1,009	407	-219	-12	65.0%	9
Olsen	1,125	831	629	-609	-27	50.8%	55
South Broward High	2,297	2,026	2,407	-120	-4	95.3%	62

	Adjusted Over/Under LOS-Adj. %		% LOS Cap. Adj.		Proje	Projected Enrollment		
Currently Assigned Schools	Benchmark	Benchmark Enrollment	Benchmark	23/24	24/25	25/26	26/27	27/28
Dania Elementary	416	-210	66,5%	390	396	402	408	414
Olsen	684	-554	55.3%	645	628	616	604	592
South Broward High	2,469	-49	98.1%	2,417	2,403	2,413	2,419	2,424

Students generated are based on the student generation rates contained in the currently adopted Broward County Land Development Code. Information contained herein is current as of the date of review. A traditional cohort survival methodology is used to project school-by-school District traditional school enrollment out over the next five years, and a proportional share of charter school enrollment is used to project future charter school enrollment by school level Districtwide. For more information: https://www.browardschools.com/Page/34040. The annual benchmark enrollment is taken on the Monday following Labor Day and is used to apply individual charter school enrollment impacts against school facility review processes.

^{*}This number represents the higher of: 100% gross capacity or 110% permanent capacity. **The first Monday following Labor Day. ***Greater than 100% exceeds the adopted Level of Service (LOS).

CHARTER SCHOOL INFORMATION

	2022-23 Contract	2022-23 Benchmark Enrollment		Projected Enrollment		
Charter Schools within 2-mile radius	Permanent Capacity		Over/(Under)	23/24	24/25	25/26
Avant Garde Academy	750	1.116	366	1.116	1.116	1.116
Avant Garde K-8 Broward	1.050	1.015	-35	1.015	1.015	1.015
Ben Gamla Charter North Broward	900	289	-611	289	289	289
Hollywood Academy 6_8	450	478	28	478	478	478
Hollywood Academy K_5	1,100	1.130	30	1.130	1.130	1.130
International School Of Broward	675	87	-588	87	87	87
International Studies Academy High School	800	207	-593	207	207	207
International Studies Academy Middle School	594	252	-342	252	252	252
Paragon Academy Of Technology	500	135	-365	135	135	135
South Broward Montessori Charter School	348	166	-182	166	166	166
Sunshine Elementary	500	230	-270	230	230	230

PLANNED AND FUNDED CAPACITY ADDITIONS IN THE ADOPTED DISTRICT EDUCATIONAL FACILITIES PLAN

School(s)	Description of Improvements
Dania Elementary	There are no scheduled classroom additions in the Adopted DEFP that would increase the reflected FISH capacity of the school.
Olsen	There are no scheduled classroom additions in the current ADEFP that would increase the reflected FISH capacity of the school.
South Broward High	There are no scheduled classroom additions in the current ADEFP that would increase the reflected FISH capacity of the school.

Students generated are based on the student generation rates contained in the currently adopted Broward County Land Development Code. Information contained herein is current as of the date of review.

A traditional cohort survival methodology is used to project school-by-school District traditional school enrollment out over the next five years, and a proportional share of charter school enrollment is used to project future charter school enrollment by school level Districtwide. For more information: https://www.browardschools.com/Page/34040. The benchmark enrollment count taken on the first Monday following Labor Day is used to apply individual charter school enrollment impacts against school facility review processes.

Comments

The site plan application proposes 32 (20 one-bedroom or less and 12 two-bedroom or more) mid-rise units, which are anticipated to generate one high school student into Broward County Public Schools.

Please be advised that this application was reviewed utilizing 2022/23 school year data because the current school year (2023/24) data will not be available until updates are made utilizing the benchmark day enrollment count and the five-year student enrollment projections. The school Concurrency Service Areas (CSA) serving the project site in the 2022/23 school year include Dania Elementary, Olsen Middle, and South Broward High Schools. The schools will continue to serve the site for the academic year 2023/24. Based on the Public School Concurrency Document (PSCPD), all three schools are currently operating below the Level of Service Standard (LOS), which is established as the higher of 100% gross capacity or 110% permanent capacity. Incorporating the cumulative students anticipated from this project as well as approved and vested developments anticipated to be built within the next three years, these schools are expected to maintain their status through the coming school years. Additionally, the school capacity or Florida Inventory of School Houses (FISH) for the impacted schools reflects compliance with the class size constitutional amendment.

Charter schools located within a two-mile radius of the site in the 2022/23 school year are depicted above. Students returning, attending, or anticipated to attend charter schools are factored into the five-year student enrollment projections for District schools. Enrollment projections are adjusted for all elementary, middle, and high schools impacted by a charter school until the charter school reaches full enrollment status.

To ensure maximum utilization of the impacted CSA, the Board may utilize school boundary changes to accommodate students generated from developments in the County.

Capital Improvements scheduled in the currently Adopted District Educational Facilities Plan (DEFP), Fiscal Years 2023/24 to 2027/28 regarding pertinent impacted schools are depicted above.

Therefore, this application satisfies public school concurrency on the basis that there is adequate school capacity anticipated to be available to support the project as proposed. This preliminary determination shall be valid for either the end of the current school year or 180 days, whichever is greater for a maximum of 32 (20 onebedroom or less and 12 two-bedroom or more) mid-rise units and conditioned upon final approval by the applicable governmental body. As such, this Preliminary School Capacity Availability Determination (SCAD) Letter will expire on April 29, 2024. This preliminary school concurrency determination shall be deemed void unless prior to the referenced expiration of the preliminary SCAD, notification of final approval to the District has been provided, and/or an extension of this preliminary SCAD has been requested in writing and granted by the School District. Please be advised that the expiration of the SCAD will require the submission of a new application and fee for a new public school concurrency determination. Upon the District's receipt of sufficient evidence of final approval, which shall minimally specify the number, type, and bedroom mix for the approved residential units, the District will issue and provide a final SCAD letter for the approved units, which shall ratify and commence the vesting period for the approved residential project.

Please be advised that if a change is proposed to the development, which increases the number of students generated by the project, the additional students will not be considered vested for public school concurrency.

SBBC-3683-2023 Meets Public School Concurrency Requirements	X Yes □ No
	Reviewed By:
11/1/2023	Glennika D. Gordon
Date	Signature
	Glennika D. Gordon, AICP
	Name
	Planner
	Title

General criteria. All plans/architectural drawings shall be reviewed based upon the evaluation of compatibility with the City's Design Guidelines,
including the following elements:

(1) Architectural and design components. Architecture refers to the architectural elements of exterior building surfaces. Architectural details should be commensurate with the building mass. Design of the building(s) shall consider aesthetics and functionality, including the relationship of the pedestrian with the built environment. The design should consider architectural elements that

are characteristic of the surrounding neighborhood.

Response: Architectural Design Components have been added to the building including a Front Canopy to designate the entrance, Architectural Grilles at ground floor to visually hide the parking, New imitation porcelain tiles added to building exterior. The surrounding neighborhood is in the process of changing based on the new zoning changes to this area. The proposed building reflects a modern design which will be in compliance with future development in this area to meet the new zoning changes.

(2) Compatibility. The harmonious relationship between existing architectural language and composition and proposed construction, including how each building along the street relates to the whole and the pattern created with adjacent structures and the surrounding neighborhood, and with the established and adopted vision for the area.

Response: The surrounding neighborhood is in the process of changing based on the new zoning changes to this area. The proposed building reflects a modern design which will be in compliance with future development in this area to meet the new zoning changes.

(3) Scale/massing. Buildings shall be proportionate in scale, with a height which is consistent with the surrounding structures, and with the established and adopted vision of the area. Building geometries shall reflect a simple composition of basic architectural details in relation to its length, width, height lot coverage, and setting of the structure in context with adjacent buildings.

Response: The surrounding neighborhood is in the process of changing based on the new zoning changes to this area. The proposed building reflects a modern design which will be in compliance with future development in this area to meet the new zoning changes.

(4) Landscaping. Landscaped areas should contain a variety of native and other compatible plant types and forms, and be carefully integrated with existing buildings and paved areas. Existing mature trees and other significant plants on the site should be preserved.

Response: LANDSCAPE PLANTINGS CONSIST OF NATIVE TREES (4 species, Live Oak, Pigeon Plum, Silver Buttonwood and Pitch Apple) WITH ADDITIONAL NON-NATIVE "FLORIDA FRIENDLY" TREE SPECIES (Crape Myrtle and Japanese Blueberry), NATIVE SHRUBS (Cocoplum, Clusia, Hamelia) AND ADDITIONAL GROUNDCOVERS (Blueberry Flax Lily, Fishtail Ferns, Boston Ferns). PLANTING ARRANGEMENTS ARE LAYERED TO CREATE VERTICAL DIMENSION WITH TREES, SHRUBS AND GROUNDCOVERS PROVIDING A VEGETATIVE LAYERING ALONG THE STREET FRONTAGE, SIDES AND REAR. ALL THE LANDSCAPE PLANTINGS ARE "FLORIDA FRIENDLY" PER STATE OF FLORIDA MANDATE, AND WHICH WILL NOT REQUIRE SUPPLEMENTAL IRRIGATION ONCE THEY ARE ESTABLISHED. EXISTING NATIVE SABAL PALMS (3) ON-SITE WILL BE RELOCATED ON-SITE. PLEASE REFER TO LANDSCAPE PLANS, SHEETS TD-1, TD-2, L-1, L-2, L-3, L-4 FOR REFERENCE.