

ARCHITECT OF MR. ARCHITECT, LLC AA 26002308

MIGUEL RIONDA LIC. # AR 94189 15125 NE 9th CT NORTH MIAMI BEACH, FLORIDA 33162 o: 786.696.4276 info@mr-architect.com

measurements, standard industry practices in light of existing structural and other conditions, applicable building codes, and the like. These plans are and shall remain the property of MR. Architect, LLC and shall not be sold or reproduced without prior written consent. MR. Architect, LLC shall be notified of any changes required by a ctual conditions prior to execution of said changes for any phase for construction. 2022, MR. Architect, LLC

SIGN AND SEAL:

ADDRESS:

2300 Hollywood Blvd. Hollywood, FL 33020

PROJECT:

SYNAGOGUE

TENANT:

OHR HATORAH

SHEET TITLE:

LANDSCAPE PLAN

No.	Description	Date
1	Revision #1	01/02/2024
2	Revision #2	01/26/2024

3 Revision #3 01/31/2024 10 2022 Project Number:

07/31/23 Date


Author Drawn By:


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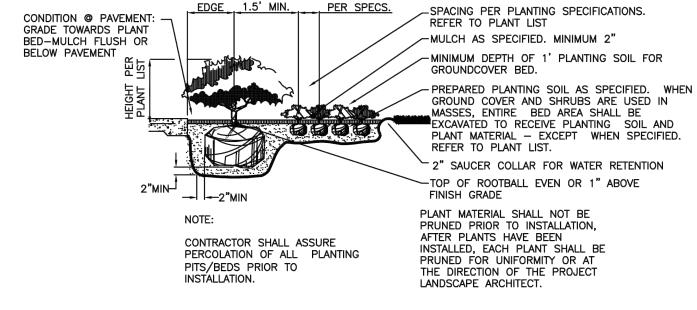
- 1. Before construction begins, the Landscape Contractor is responsible for locating all underground utilities and must avoid damaging any services during construction. If any damage occurs by fault of the Contractor, the necessary repairs must take place at the Landscape Contractor's expense and under the supervision of the Owner's representative.
- 2. All proposed trees and plant materials shall be graded as Nursery Grade Florida No. 1 or better as outlined by the Florida Department of Agriculture and Consumer Services, Division of Plant Industry "Grades and standards for Nursery Plants", most current edition. All planting shall be done in accordance with the Florida Nurserymen's and Grower's Association approved practices.
- In addition to these requirements the Landscape Contractor shall comply with all local landscape codes and requirements as part of this base bid and contract in order to satisfy the review and approval of the governing agency.
- 4. All screening hedges shall be planted and maintained in a way that they form a continuous visual screen. Screening hedges at VUA to be maintained at a minimum height of thirty (30) inches.
- 5. All planting beds shall be excavated to a minimum depth of twenty-four (24") inches and backfilled with a suitable soil. All plant material shall be planted in planting soil that is delivered to the site in a loose, clean and friable condition. The planting soil shall be the approximate proportions as follows: 50% sand and 50% organic material consisting of native peat, well-decomposed sawdust, leaf mold and top soil. It shall provide a good pliable and thoroughly mixed medium with adequate aeration, drainage and water-holding capacity. It shall also be free of all extraneous debris, such as roots, stones, weeds, etc.
- All trees/palms and shrubs shall be fertilized with "Agriform" 20-10-5 planting tablets as per the manufacturers specifications at the time of installation and prior completion of pit backfilling also in conjunction with note #5. Tablets to be placed uniformly around the root mass at a depth that is between the middle and bottom of root mass at an application rate of: One (1) - 21 gram tablet for 1 gal container, two (2)- tablets for 3 gal container, three (3)- tablets for 5 gal container, four (4)-tablets for 7 gal container, three (3)-tablets for each 1/2 inch of tree caliper, and seven (7) tablets for palms. Ground Cover areas shall receive fertilization with "Ozmocote" time release fertilizer as per manufacturer's specification.
- All plant beds shall receive a 3" layer of organic mulch, which is to be watered-in after installation. Mulch should be at least six (6) inches away from any portion of a structure or tree trunk and three (3) inches away from the base of shrubs. Only environmental friendly mulch shall be approved, Cypress mulch shall not be
- All plant material shall be thoroughly watered in at the time of planting and until landscape material is established. No dry material shall be permitted.
- 9. The plant material schedule is presented for the convenience of the Landscape Contractor. In the event of a discrepancy between the plan and the plant key, the plan shall prevail.
- 10. Plants shall meet size, container, and spacing specifications. Any material not meeting specifications shall be removed and replaced at the contractor's expense


11. All tree and shrub locations shall be approved by Landscape Architect prior to

- 12. The Landscape Contractor shall grade planting beds, as required, to provide positive drainage and promote optimum plant growth.
- 13. The Landscape Contractor shall be responsible for examining fully both the site and bid documents. Discrepancies in the documents or the actual site conditions shall be reported to the Landscape Architect in writing at the time of bidding or discovery. No account shall be made after contract completion for failure by the Landscape Contractor to report such condition or for errors on the part of the Landscape Contractor at the time of bidding.
- 14. The Landscape Contractor shall be responsible for securing all necessary applicable permits and licenses to perform the work set forth in this plan set and the specifications.
- 15. Plant material shall be bid as specified unless unavailable, at which time the Landscape Architect shall be notified in writing of intended changes.
- 16. All questions concerning the plan set and/or specifications shall be directed to the Landscape Architect.
- 17. There shall be no additions, deletions or substitutions without written approval of the Landscape Architect.
- 18. The Landscape Contractor shall guarantee, in writing, plant survivability. Trees and palms for twelve (12) months, shrubs and groundcovers for ninety (90) days and sod for sixty (60) days from final acceptance by the Owner or Owner's representative.
- 19. All dimensions to be field-checked by the Landscape Contractor prior to landscape material installation. Discrepancies shall be reported immediately to the Landscape Architect.
- 20. All materials must be as specified on the landscape plan. If materials or labor do not adhere to specifications, they will be rejected by the Landscape Architect with proper installation carried out by the Landscape Contractor at no additional cost.
- 21. Existing sod shall be removed as necessary to accommodate new plantings
- 22. All existing trees on site shall be protected from damage during construction See existing tree protection fence detail.
- 23. Any existing landscape and hardscape areas that are unnecessarily disturbed during the landscape installation shall be restored to original conditions by the Landscape Contractor.
- 24. The Landscape Contractor will be responsible for the collection, removal, and proper disposal of any and all debris generated during the installation of this project.
- 25. All landscape areas to have a positive drainage away from buildings and structures. Finished grade of landscape areas to be at or below the grade of adjacent sidewalks, slabs or VUA
- 26. All shade and medium trees installed within 5' of a public infrastructure shall utilize a root barrier system.



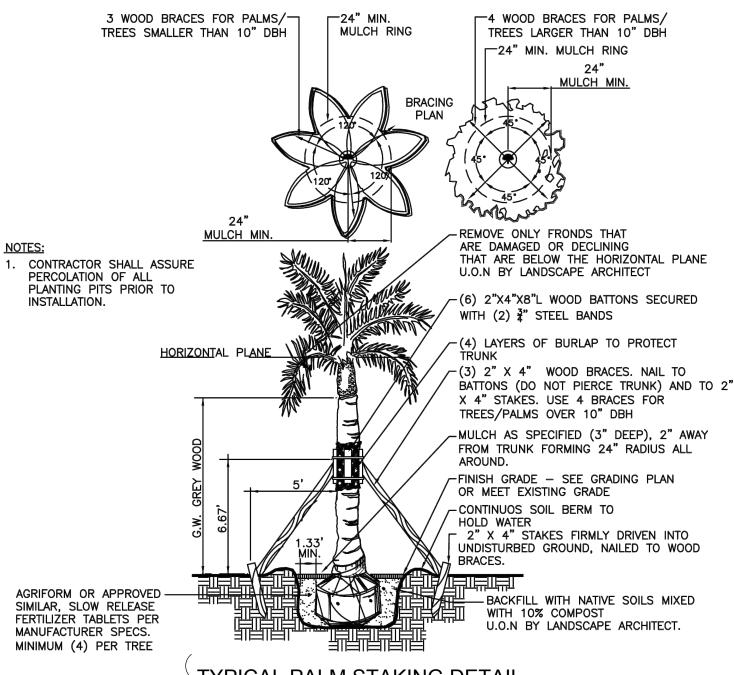


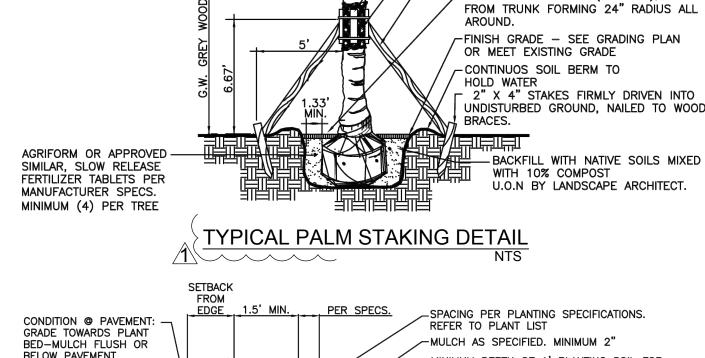

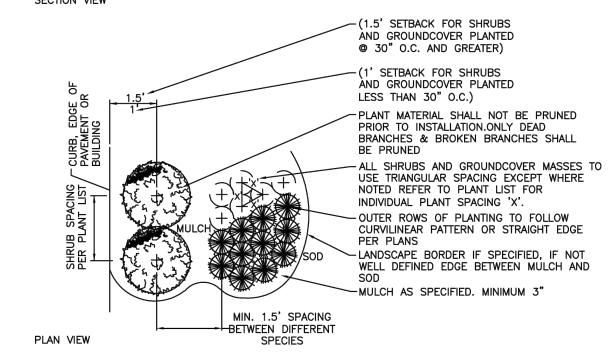

SPACING 'D' 6" OC 8" OC 10" OC	ROW 'A' 5.2" 6.93" 8.66"	# PLANTS 4.61 2.6 1.66	AREA UNIT	'A'	NOTES: 1. FOR USE ONLY WHEN PLANTS ARE SPACED EQUIDISTANT FROM EACH OTHER AS SHOWN. EACH OTHER AS SHOWN.
12" OC 15" OC 18" OC 24" OC 30" OC 36" OC	10.4" 13.0" 15.6" 20.8" 26.0" 30.0"	1.15 7.38 5.12 2.91 1.85 1.28	10 SQ. FT.	'D' 'D'	 ALL SHRUBS & GROUND COVER ARE TO BE INSTALLED WITH TRIANGULAR SPACING UNLESS OTHERWISE NOTED.
48" OC 60" OC 72" OC 96" OC 120" OC	3.46' 4.33' 5.2' 6.93' 8.66'	7.25 4.61 3.2 1.8 1.16	100 SQ. FT.	, , , , , , , , , , , , , , , , , , ,	

SHRUB AND GROUNCOVER DETAIL

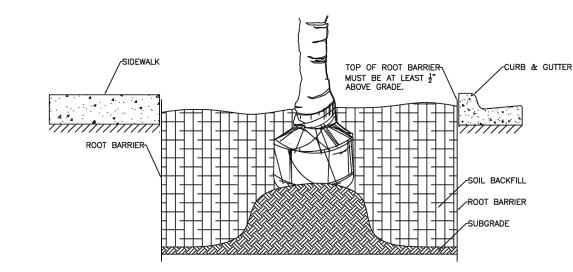


1. ROOT BARRIERS WHEN USED FOR SWALE TREES THAT ARE PLANTED WITHIN FIVE FEET OF A SIDEWALK OR 4. ROADWAY SHALL BE PLACED AGAINST THE EDGE OF THE SIDEWALK AND THE EDGE OF THE PAVEMENT, AND SHALL EXTEND FIVE FEET IN BOTH DIRECTIONS PARALLEL TO THE SIDEWALK AND ROADWAY.

1. ROOT BARRIERS SHALL BE INSTALLED AT ALL TREES/PALMS THAT ARE PLANTED WITHIN FIVE (5) FEET OF UNDERGROUND UTILITIES OR UTILITY EASEMENT. SEE DETAIL #4 ON SHEET L-03.

2. ALL LANDSCAPE AREAS SHALL BE PROVIDED WITH A FULLY AUTOMATICALLY OPERATED IRRIGATION SYSTEM. IRRIGATION SYSTEM SHALL PROVIDE COMPLETE COVERAGE OF ALL PLANT MATERIALS. THIS SYSTEM SHOULD HAVE RAIN SENSOR AND SHOULD AUTOMATICALLY SHUT OFF WHEN RAINING

3. WITHIN VISIBILITY TRIANGLES, LANDSCAPE SHALL BE MAINTAIN TO PROVIDE CLEAR VISIBILITY WITHOUT OBSTRUCTION FROM AN AREA BETWEEN TWO AND HALF (2 1/2) FEET AND SEVEN (7) FEET

TREE PROTECTION FENCE MIGHT BE TEMPORARILY ADJUSTED AT TREES #1 AND #2 TO ALLOW FOR THE CONSTRUCTION OF THE HARDCAPE AREAS AND THE BUILDING.

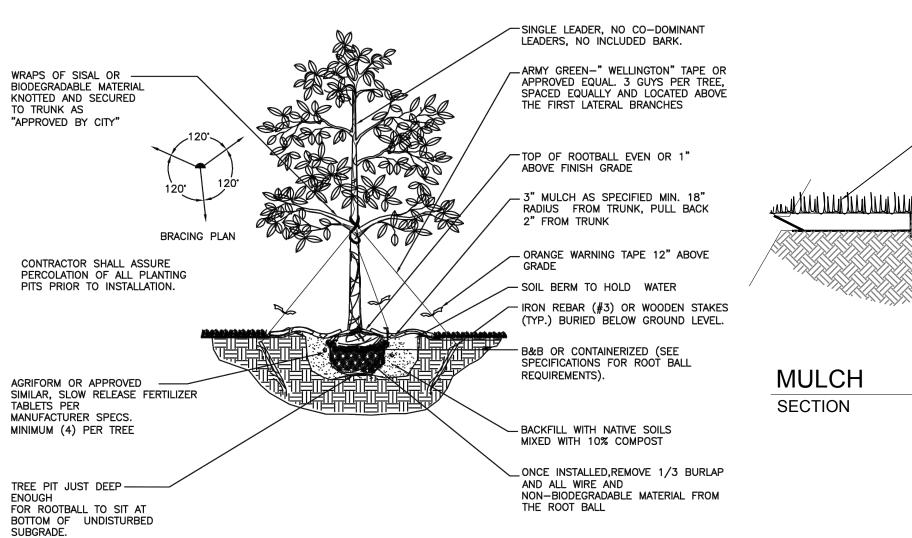

TREE PLANTING DETAIL



Plan Before You Plant

Choose suitable trees and palms for planting around your home, near powerlines, for courtyards, patios, lawns and streetscapes.


PROPER TREE SELECTION

Often, we take our utility service for granted because it has become a part of our daily lives. To enjoy the convenience of reliable electrical service, distribution systems are required to bring electricity to our homes.

The location of these utility lines should play a major role in your tree and planting site selection. The ultimate, mature height and width of a tree to be planted should not exceed the available over nead growing space. It's important to plant the right tree in the ight place. Proper tree selection will help to ensure trouble-free electrical service to your home for years to come.

The selection of trees to plant requires careful consideration. rees planted in the wrong place can cause serious problems such as clogged sewers, cracked sidewalks, and power service nterruptions. Planting the right tree in the right place can reduce naintenance expenses for homeowners as well as FPL, while nproving the appearance of the landscape.

Consult your tree care professional or garden center staff to help /ou select the right tree. this publication you will find a select list of trees and palms as well as recommendations for planting in relation to utility lines.

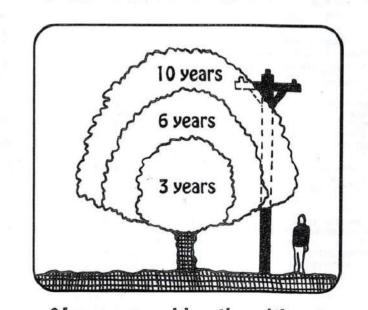

Always consider the ultimate mature size when planting

SMALL TREES

Less than 20' ht. at maturity

COMMON/BOTANICAL NAME	HEIGHT	COMMENTS
*SWEET ACACIA Acacia farnesiana	10'- 15'	fragrant yellow flowers
DWARF POINCIANA	10'- 15'	vallow arango flowers
Caesalpinia spp.	10 - 13	yellow-orange flowers large shrub, tropical
WEEPING BOTTLEBRUSH	15'- 20'	red, bottlebrush flowers
Callistemon viminalis	13 20	red, bettlebrush nowers
GLAUCUS CASSIA	15'- 20'	yellow flowers, tropical
Cassia surattensis	15 20	yenew novers, a opicar
CITRUS: LEMON, ORANGE, ETC.	15'- 20'	edible fruit, white flowers
Citrus spp.	.0 20	all, except Grapefruit
SILVER BUTTONWOOD	15'- 20'	attractive gray foliage
Conocarpus erectus var. 'sericeus'		cold tolerant
WHITE GEIGER/TEXAS OLIVE	10'- 15'	showy white flowers
Cordia boissieri		cold tolerant
ORANGE GEIGER	15'- 20'	brilliant orange flowers
Cordia sebestena		
LOQUAT	15'- 20'	edible orange fruit
Eriobotrya japonica		dark green foliage
STOPPERS	15'- 20'	understory trees
Eugenia spp.		good hedgerow screens
LIGNUM VITAE	15'- 20'	sky-blue flowers
Guaiacum sanctum		specimen tree
HIBISCUS "Standards"	10'- 15'	red, pink, yellow, or white
Hibiscus spp.		flowers, tropical
TREE JATROPHA	15'- 20'	crimson-red flowers,
Jatropha spp.		tropical
CREPE MYRTLE	15'- 20'	red, pink, coral, or white
Lagerstroemia indica		flowers
TREE LIGUSTRUM	15'- 20'	small white flowers,
Ligustrum spp.		dark green foliage
JABOTICABA	15 '- 20'	edible fruit,
Myrciaria caulifolia		attractive bark
CHALCAS/ ORANGE JASMINE	15'- 20'	fragrant white flowers,
Murraya paniculata		trained as a tree
*WAX MYRTLE	15'- 20'	tolerates wet soils,
Myrica cerifera	200 2002	aromatic leaves when crushed

15'-20' pink, coral, or white

tropical

flowers, very poisonous

attractive foliage

flowers, tropical

coral, yellow, or white

brilliant yellow flowers

lobster-red berries, poisonous,

_SOD (PROVIDE CLEAN, SMOOTH EDGE BETWEEN SOD AND MULCHED AREAS).

GÖMPLETELY REMOVE EXISTING SOD

PLANTING SOIL (FINE RAKED AND FREE C

WEEDS AND OTHER DELETERIOUS

ALL MULCH SHALL BE FREE

OF FIRE ANTS AND DEBRIS

SCALE: N.T.S

MATERIALS)

AS REQUIRED PRIOR TO PLACING

YELLOW ELDER Tecoma stans

OLEANDER "Standards"

Nerium oleander

Ochrosia elliptica

Plumeria rubra

FRANGIPANI

KOPSIA

SOUTH FLORIDA

*Asterisk denotes plants native to south Florida Heights are as per "Xeriscape Plant Guide II." This list is not all-inclusive. Check with local agencies for appropriateness of species in your area. 'LY' indicates susceptibility to lethal yellowing.

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ified of any changes required by actual conditions prior to execution of id changes for any phase for construction. 2022, MR. Architect, LLC

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SIGN AND SEAL:

2300 Hollywood Blvd.

Hollywood, FL 33020

PROJECT:

SYNAGOGUE

TENANT.

OHR HATORAH

SHEET TITLE: LANDSCAPE PLAN NOTES/DETAILS

lo. Description Date Revision #1 01/02/2024 2 Revision #2 01/26/2024 10 2022 Project Number: 07/31/23 Date Drawn By: Author Checker Checked By:

Scale:

ROOT BARRIER DETAIL

2. ALL CONSTRUCTION AND MATERIALS SHALL CONFORM TO APPLICABLE STANDARDS AND SPECIFICATIONS OF THE CITY OF HOLLYWOOD DEPARTMENT OF PUBLIC UTILITIES, ENGINEERING AND CONSTRUCTION SERVICES DIVISION (ECSD), AND ALL OTHER LOCAL, STATE AND NATIONAL CODES, WHERE APPLICABLE.

LOCATIONS, ELEVATIONS, SIZES, MATERIALS, ALIGNMENTS, AND DIMENSIONS OF EXISTING FACILITIES UTILITIES AND OTHER FEATURES ARE SHOWN ACCORDING TO THE BEST INFORMATION AVAILABLE AT THI TIME OF THE PREPARATION OF THESE PLANS: AND DO NOT PURPORT TO BE ABSOLUTELY CORRECT. ALSO THERE MAY HAVE BEEN OTHER IMPROVEMENTS, UTILITIES, ETC., WITHIN THE PROJECT AREA WHICH WERE CONSTRUCTED AFTER THE PREPARATION OF THESE PLANS AND/OR THE ORIGINALSITE SURVEY. THE CONTRACTOR SHALL VERIFY THE LOCATIONS, ELEVATIONS, AND OTHER FEATURES AFFECTING HIS/HEF WORK PRIOR TO CONSTRUCTION, AND NOTIFY THE ENGINEER IMMEDIATELY WHEN CONFLICT BETWEEN DRAWINGS AND ACTUAL CONDITIONS ARE DISCOVERED. THE ENGINEER ASSUMES NO RESPONSIBILITY FOR ANY FACILITIES SHOWN OR NOT SHOWN ON THE PLANS. THE CONTRACTOR SHALL WORK AS NEEDED TO AVOID CONFLICT WITH EXISTING UTILITIES (NO ADDITIONAL COST SHALL BE PAID FOR THIS WORK). EXISTING UTILITIES SHALL BE MAINTAINED IN SERVICE DURING CONSTRUCTION UNLESS OTHERWISE APPROVED BY THE RESPECTIVE UTILITY OWNER.

4. THE CONTRACTOR SHALL COORDINATE WITH ALL UTILITIES TO ARRANGE FOR THE RELOCATION AND TEMPORARY SUPPORT OF UTILITY FEATURES, ETC. AS NECESSARY TO COMPLETE THE WORK.

IT SHALL BE THE CONTRACTOR'S RESPONSIBILITY TO LOCATE AND PROTECT ANY AND ALL EXISTING UTILITIES ON THIS PROJECT. AND TO ENSURE THAT EXISTING UTILITIES ARE MAINTAINED IN SERVICE DURING CONSTRUCTION UNLESS APPROVED OTHERWISE BY THE UTILITY OWNER.

CONTRACTOR SHALL ADJUST ALL EXISTING UTILITY CASTINGS INCLUDING VALVE BOXES, MANHOLES HAND-HOLES, PULL-BOXES, STORMWATER INLETS, AND SIMILAR STRUCTURES IN CONSTRUCTION AREA TO BE OVERLAID WITH ASPHALT PAVEMENT.

7. THE CONTRACTOR IS REQUIRED TO OBTAIN ALL APPLICABLE CONSTRUCTION AND ENVIRONMENTAL PERMITS PRIOR TO THE START OF CONSTRUCTION.

8. THE CONTRACTOR SHALL NOTIFY ECSD AT LEAST 48 HOURS PRIOR TO BEGINNING CONSTRUCTION

9. PRIOR TO THE COMMENCEMENT OF CONSTRUCTION AND INSTALLATION OF THE PROPOSED IMPROVEMENTS, SHOP DRAWINGS SHALL BE SUBMITTED TO ECSD IN ACCORDANCE WITH THE CONTRACT DOCUMENT'S REQUIREMENTS, FOR APPROVAL. IN ADDITION, IT IS THE CONTRACTOR'S RESPONSIBILITY TO OBTAIN ANY OTHER AGENCY SHOP DRAWING APPROVAL, IF REQUIRED.

10. THE CONTRACTOR SHALL NOTIFY ECSD IMMEDIATELY FOR ANY CONFLICT ARISING DURING CONSTRUCTION OF ANY IMPROVEMENTS SHOWN ON THESE DRAWINGS. THIS WORK BY THE CONTRACTOR SHALL BE CONSIDERED INCIDENTAL TO THE CONTRACT AND NO ADDITIONAL COMPENSATION SHALL BE ALLOWED.

11. ELEVATIONS SHOWN ARE IN FEET AND ARE REFERENCED TO THE NORTH AMERICAN VERTICAL DATUM OF 1988 (NAVD 88).

OF HOLLYWOOD FEE	ISSUED: 03/	/01/1994	DEPARTMENT OF PUBLIC UTILITIES STANDARD DETAIL	REVISED: 06/08/2014
DIAMOND OF THE	DRAWN:	EAM	GENERAL NOTES	DRAWING NO.
GOLD COAST	APPROVED:	XXX	GLINLING I ES	G-00



LEGAL DESCRIPTION

THE WEST 1/2 OF LOT 6, LESS THE NORTH 7 1/2 FEET FOR ALLEY, BLOCK 6, HOLLYWOOD LITTLE RANCHES, ACCORDING TO THE PLAT THEREOF AS RECORDED IN PLAT BOOK 1, PAGE 26, OF THE PUBLIC RECORDS OF BROWARD COUNTY, FLORIDA.

LOT 7, LESS THE NORTH 7.5 FEET, BLOCK 6, HOLLYWOOD LITTLE RANCHES, ACCORDING TO THE PLAT THEREOF AS RECORDED IN PLAT BOOK 1, PAGE 26, OF THE PUBLIC RECORDS OF BROWARD COUNTY, FLORIDA.

LOT 16, AND THE WEST 1/2 OF LOT 17, BLOCK 6, HOLLYWOOD LITTLE RANCHES, ACCORDING TO THE PLAT THEREOF AS RECORDED IN PLAT BOOK 1, PAGE 26, OF THE PUBLIC RECORDS OF BROWARD COUNTY, FLORIDA, LESS THE FOLLOWING PORTION OF LOT 16 DEEDED TO THE CITY OF HOLLYWOOD, FLORIDA BY QUIT CLAIM DEED RECORDED IN OFFICIAL RECORDS BOOK 2295, PAGE 94, PUBLIC RECORDS OF BROWARD COUNTY, FLORIDA, DESCRIBED AS FOLLOWS:

THAT PORTION OF LOT SIXTEEN (16), BLOCK SIX (6), HOLLYWOOD LITTLE RANCHES AMENDED, ACCORDING TO THE PLAT THEREOF AS RECORDED IN PLAT BOOK 1, PAGE 26 OF THE PUBLIC RECORDS OF BROWARD COUNTY, FLORIDA, MORE PARTICULARLY DESCRIBED BY METES AND BOUNDS AS FOLLOWS: BEGINNING AT THE SOUTHWEST CORNER OF SAID LOT 16, BLOCK 6, THENCE RUN NORTHERLY ALONG THE WEST PROPERTY LINE FOR A DISTANCE OF SIX FEET TO A POINT; THENCE RUN EASTERLY PARALLEL TO THE SOUTH PROPERTY LINE A DISTANCE OF TWENTY-FIVE FEET TO A POINT; THENCE RUN NORTHEASTERLY FOR A DISTANCE OF TEN FEET ONE AND A. QUARTER INCHES MORE OR LESS, TO A POINT WHICH IS SEVEN AND ONE-HALF FEET NORTH OF THE SOUTH PROPERTY LINE OF SAID LOT 16; THENCE RUN EASTERLY ALONG A LINE PARALLEL TO THE SOUTH PROPERTY LINE A DISTANCE OF SIXTY-FIVE FEET MORE OR LESS, TO A POINT ON THE EAST PROPERTY LINE; THENCE RUN SOUTHERLY ALONG THE EAST PROPERTY LINE OF SAID LOT 16 A DISTANCE OF SEVEN AND ONE-HALF FEET TO THE SOUTH PROPERTY LINE; THENCE RUN WESTERLY ALONG THE SOUTH PROPERTY LINE OF SAID LOT 16, A DISTANCE OF ONE HUNDRED FEET TO THE POINT OF BEGINNING;

AND LESS THE FOLLOWING PORTION OF LOT 17 DEEDED TO THE CITY OF HOLLYWOOD, FLORIDA BY QUIT CLAIM DEED RECORDED IN OFFICIAL RECORDS BOOK 2295, PAGE 96, PUBLIC RECORDS OF BROWARD COUNTY, FLORIDA, DESCRIBED AS

THE SOUTH SEVEN AND ONE-HALF FEET OF THE WEST HALF OF LOT 17. BLOCK 6. HOLLYWOOD LITTLE RANCHES AMENDED. ACCORDING TO THE PLAT THEREOF AS RECORDED IN PLAT BOOK 1. PAGE 26 OF THE PUBLIC RECORDS OF BROWARD

GENERAL NOTES (CONTINUED):

27. THE CONTRACTOR SHALL BE RESPONSIBLE FOR MAINTAINING THE INTEGRITY OF AND MAKING THE REPAIRS TO EXISTING PAVEMENT, SIDEWALKS, PIPES, CONDUITS, CURBS, CABLES, ETC., WHETHER OR NOT SHOWN ON THE PLANS DAMAGED AS A RESULT OF THE CONTRACTORS OPERATIONS AND/OR THOSE OF HIS SUBCONTRACTORS, AND SHALL RESTORE THEM PROMPTLY AT NO ADDITIONAL EXPENSE TO THE OWNER, CONTRACTOR SHALL REPORT ANY DAMAGE TO SIDEWALK, DRIVEWAY, ETC., PRIOR TO **BEGINNING WORK IN ANY AREA.**

28. WHERE NEW PAVEMENT MEETS EXISTING, CONNECTION SHALL BE MADE IN A NEAT STRAIGHT LINE AND FLUSH WITH EXISTING PAVEMENT TO MATCH EXISTING CONDITIONS.

29. UNDER NO CIRCUMSTANCES SHALL THE CONTRACTOR LEAVE EXCAVATED TRENCHES, OR PARTS OF, EXPOSED OR OPENED AT THE END OF THE WORKING DAY, WEEKENDS, HOLIDAYS OR OTHER TIMES, WHEN THE CONTRACTOR IS NOT WORKING, UNLESS OTHERWISE DIRECTED, ALL TRENCHES SHALL BE COVERED, FIRMLY SECURED AND MARKED ACCORDINGLY FOR PEDESTRIAN / VEHICULAR TRAFFIC.

30. ALL EXCAVATED MATERIAL REMOVED FROM THIS PROJECT SHALL BE DISPOSED OF OFF THE PROPERTY BY THE CONTRACTOR AT THE CONTRACTOR'S EXPENSE.

31. ALL DUCTILE IRON PRODUCTS SHALL BE DOMESTIC MADE HEAVY DUTY CLASSIFICATION SUITABLE FOR HIGHWAY TRAFFIC LOADS, OR 20,000 LB.

32. ALL GRASSED AREAS AFFECTED BY CONSTRUCTION SHALL BE RE-SODDED.

33. THE CONTRACTOR SHALL BE RESPONSIBLE FOR THE PROVISION, INSTALLATION AND MAINTENANCE OF ALL TRAFFIC CONTROL AND SAFETY DEVICES, IN ACCORDANCE WITH SPECIFICATIONS OF THE LATEST REVISION OF FDOT DESIGN STANDARDS. IN ADDITION, THE CONTRACTOR IS RESPONSIBLE FOR THE RESETTING OF ALL TRAFFIC CONTROL AND INFORMATION SIGNAGE REMOVED DURING THE CONSTRUCTION PERIOD.

34. EXCAVATED OR OTHER MATERIAL STORED ADJACENT TO OR PARTIALLY UPON A ROADWAY PAVEMENT SHALL BE ADEQUATELY MARKED FOR TRAFFIC SAFETY AT ALL TIMES.

35. TEMPORARY PATCH MATERIAL MUST BE ON THE JOB SITE WHENEVER PAVEMENT IS CUT, OR THE CITY'S INSPECTOR WILL SHUT THE JOB DOWN.


36. CONTRACTOR MUST PROVIDE FLASHER ARROW SIGNAL FOR ANY LANE THAT IS CLOSED OR DIVERTED.

37. CONTRACTOR SHALL NOTIFY LAW ENFORCEMENT AND FIRE PROTECTION SERVICES TWENTY-FOUR (24)


HOURS IN ADVANCE OF TRAFFIC DETOUR IN ACCORDANCE WITH SECTION 336.07 OF FLORIDA STATUTES.

38. CONTRACTOR TO RESTORE PAVEMENT TO ORIGINAL CONDITION AS REQUIRED.

OF HOLLYWOOD PIC	ISSUED:	03/01/1994	DEPARTMENT OF PUBLIC UTILITIES STANDARD DETAIL	REVISED: 11/06/2017
DIAMOND DIAMOND	DRAWN:	: EAM	GENERAL NOTES	DRAWING NO.
GOLD COAST	APPROV	ED: XXX	(CONTINUED)	G-00.2

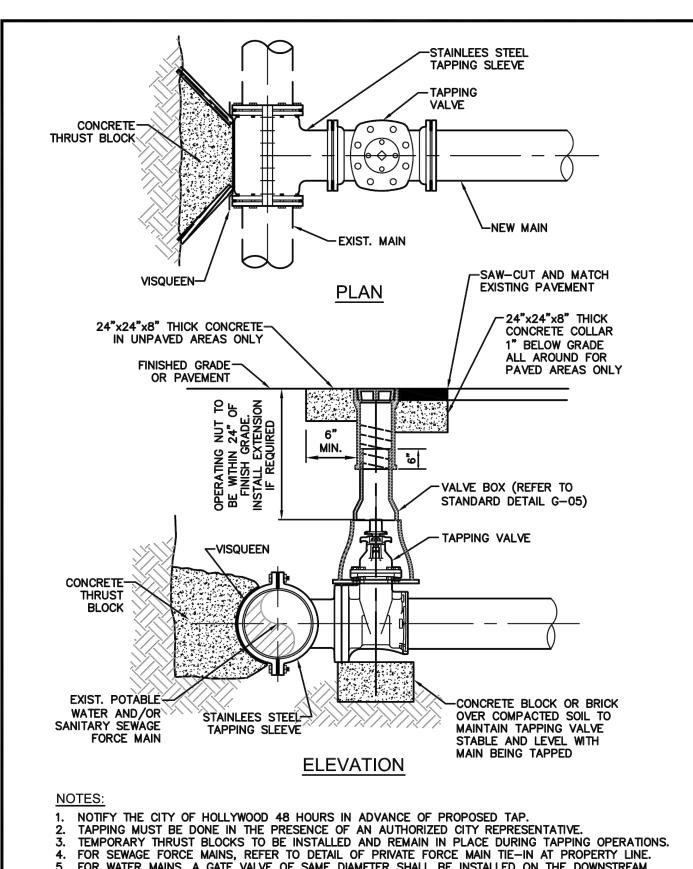

OF HOLLYWOOD THE	ISSUED:	03/01/1994	DEPARTMENT OF PUBLIC UTILITIES STANDARD DETAIL	REVISED: 06/08/2014
DIAMOND OF THE	DRAWN:	EAM	TYPICAL TAPPING SLEEVE	DRAWING NO.
GOLD COAST 2	APPROVE	D: XXX	AND VALVE SETTING	G-06

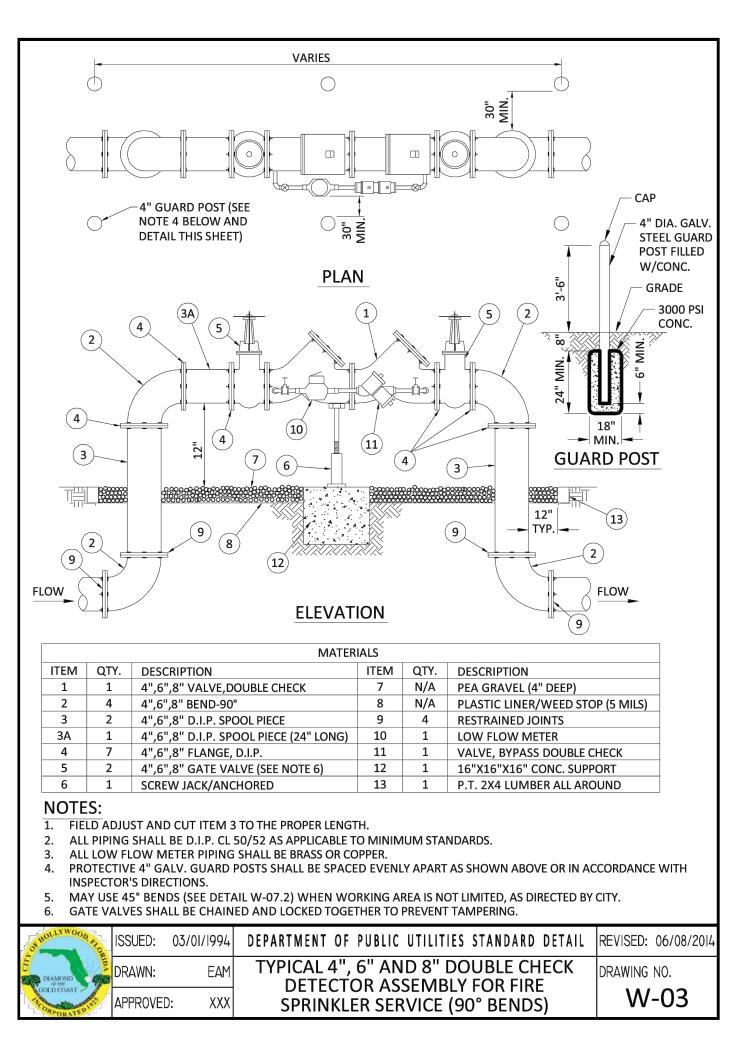

GENERAL NOTES (CONTINUED):

12. CITY OF HOLLYWOOD SHALL NOT PROVIDE STAGING / STORAGE AREA. CONTRACTOR SHALL SECURE STAGING / STORAGE AREA AS NECESSARY FOR CONSTRUCTION WORK.

13. CONTRACTOR SHALL HAUL AWAY EXCESSIVE STOCKPILE OF SOIL FOR DISPOSAL EVERY DAY. NO STOCKPILE SOIL IS ALLOWED TO BE LEFT ON THE CONSTRUCTION SITE OVER NIGHT.

14. CONTRACTOR SHALL CLEAN / SWEEP THE ROAD AT LEAST ONCE DAY OR AS REQUIRED BY THE ENGINEER.

15. CONTRACTOR SHALL PROTECT CATCH BASINS WITHIN / ADJACENT TO THE CONSTRUCTION SITE AS **REQUIRED BY NPDES REGULATIONS.**

16. THE CITY OF HOLLYWOOD HAS A NOISE ORDINANCE (CHAPTER 100) WHICH PROHIBITS EXCAVATION AND CONSTRUCTION BEFORE 8:00 A.M. AND AFTER 6:00 P.M., MONDAY THROUGH SATURDAY AND ALL DAY

17. SUITABLE EXCAVATED MATERIAL SHALL BE USED IN FILL AREAS. NO SEPARATE PAY ITEM FOR THIS WORK. INCLUDE COST IN OTHER ITEMS.

18. ALL ROAD CROSSINGS ARE OPEN CUT AS PER THE REQUIREMENTS OF THE ECSD UNLESS OTHERWISE NOTED ON THE DRAWINGS.

19. THE CONTRACTOR SHALL REPLACE ALL PAVING, STABILIZING EARTH, DRIVEWAYS, PARKING LOTS, SIDEWALKS, ETC. TO SATISFY THE INSTALLATION OF THE PROPOSED IMPROVEMENTS WITH THE SAME TYPE OF MATERIAL THAT WAS REMOVED DURING CONSTRUCTION OR AS DIRECTED BY ECSD FIELD

20. THE CONTRACTOR SHALL NOT ENCROACH INTO PRIVATE PROPERTY WITH PERSONNEL, MATERIAL OR EQUIPMENT. IN CASE WORK ON PRIVATE PROPERTY IS NEEDED. A CITY OF HOLLYWOOD "RIGHT OF ENTRY" FORM MUST BE SIGNED BY PROPERTY OWNER AND THE DIRECTOR OF PUBLIC UTILITIES. THE CONTRACTOR IS RESPONSIBLE TO MAINTAIN ACCESS AT ALL TIMES TO PRIVATE HOMES/BUSINESSES.

21. THE CONTRACTOR SHALL BE RESPONSIBLE FOR DAMAGE, REMOVAL OR MODIFICATION, CAUSED TO ANY IRRIGATION SYSTEM (PRIVATE OR PUBLIC) ACCIDENTALLY OR PURPOSELY. THE CONTRACTOR SHALL REPLACE ANY DAMAGED, REMOVED OR MODIFIED IRRIGATION PIPES, SPRINKLER HEADS OR OTHER PERTINENT APPURTENANCES TO MATCH OR EXCEED EXISTING CONDITIONS AT NO ADDITIONAL COST TO

22. MAIL BOXES, FENCES OR OTHER PRIVATE PROPERTY DAMAGED DURING THE CONSTRUCTION OF THE PROPOSED IMPROVEMENTS SHALL BE REPLACED TO MATCH OR EXCEED EXISTING CONDITION.

23. CONTRACTOR SHALL PROVIDE MAINTENANCE OF TRAFFIC IN ACCORDANCE WITH FDOT STANDARDS AND CITY OF HOLLYWOOD DEPARTMENT OF PUBLIC UTILITIES STANDARDS.

24. NO TREES ARE TO BE REMOVED OR RELOCATED WITHOUT PRIOR APPROVAL FROM THE ECSD FIELD ENGINEER.

25. THE CONTRACTOR IS RESPONSIBLE FOR OBTAINING THE NECESSARY TREE REMOVAL OR RELOCATION PERMITS FROM THE CITY OF HOLLYWOOD BUILDING DEPARTMENT FOR TREES LOCATED IN THE PUBLIC RIGHT OF WAY.

26. IT IS THE INTENT OF THESE PLANS TO BE IN ACCORDANCE WITH APPLICABLE CODES AND AUTHORITIES HAVING JURISDICTION. ANY DISCREPANCIES BETWEEN THESE PLANS AND APPLICABLE REGULATORY STANDARDS / REQUIREMENTS SHALL BE IMMEDIATELY BROUGHT TO THE ATTENTION OF ECSD.

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GENERAL NOTES (CONTINUED):

40. THE CONTRACTOR SHALL GIVE AT LEAST 48 HOURS NOTICE TO UTILITY COMPANIES TO PROVIDE FOR THE LOCATION OF EXISTING UNDERGROUND UTILITIES IN ADVANCE OF CONSTRUCTION. CONTACT UTILITIES NOTIFICATION CENTER AT 811 OR 1-800-432-4770 (SUNSHINE ONE-CALL OF FLORIDA).

Sunshine 811 Call 811 or visit sunshine811.com two full business days before digging to have buried facilities located and marked.

Check positive response codes before you dig!

41. WHEN PVC PIPE IS USED, A METALLIZED MARKER TAPE SHALL BE INSTALLED CONTINUOUSLY 18" ABOVE THE PIPE. THE MARKER TAPE SHOULD BE IMPRINTED WITH A WARNING THAT THERE IS BURIED PIPE BELOW. THE TAPE SHALL BE MAGNA TEC, AS MANUFACTURED BY THOR ENTERPRISES INC. OR APPROVED EQUAL.

42. ALL CONNECTIONS TO EXISTING MAINS SHALL BE THE RESPONSIBILITY OF THE CONTRACTOR. WATER CONNECTIONS SHALL BE METERED, AND THE COST OF WATER AND TEMPORARY METER SHALL BE BORNE BY THE CONTRACTOR.

43. A COMPLETE AS-BUILT SURVEY SHALL BE ACCURATELY RECORDED OF THE UTILITY SYSTEM DURING CONSTRUCTION. AS-BUILT SURVEY SHALL BE SUBMITTED TO ECSD SIGNED AND SEALED BY A FLORIDA REGISTERED SURVEYOR PRIOR TO FINAL INSPECTION AND ACCEPTANCE OF PROJECT. THE COST OF SIGNED AND SEALED AS-BUILTS SHALL BE COVERED IN OVERALL BID. THE AS-BUILT SURVEY SHALL INCLUDE:

a. PLAN VIEW SHOWING THE HORIZONTAL LOCATIONS OF EACH MANHOLE, INLET, VALVE, FITTING. BEND AND HORIZONTAL PIPE DEFLECTIONS WITH COORDINATES AND IN REFERENCE TO A SURVEY BASELINE OR RIGHT-OF-WAY CENTERLINE.

b. THE PLAN VIEW SHALL ALSO SHOW SPOT ELEVATIONS OF THE TOP OF THE MAIN (WATER MAIN AND FORCE MAIN) OR PIPE INVERTS (GRAVITY MAINS) AT INTERVALS NOT TO EXCEED 100 FEET AS MEASURED ALONG MAIN. THE PLAN VIEW SHALL ALSO INCLUDE SPOT ELEVATIONS AT EACH MANHOLE, INLET, VALVE, FITTING, BEND AND VERTICAL PIPE DEFLECTION.

c. THE PLAN VIEW SHALL ALSO SHOW THE HORIZONTAL SEPARATION FROM UNDERGROUND UTILITIES IMMEDIATELY ADJACENT OR PARALLEL TO THE NEW MAIN.

d. PROFILE VIEW WITH SPOT ELEVATIONS OF THE TOP OF THE MAIN (WATER MAIN AND FORCE MAIN) OR PIPE INVERT (GRAVITY MAIN) AND OF THE FINISHED GRADE OR MANHOLE RIM DIRECTLY ABOVE THE MAIN AT INTERVALS NOT TO EXCEED 100 FEET AS MEASURED ALONG THE MAIN. THE PROFILE VIEW SHALL ALSO INCLUDE SPOT ELEVATIONS AT EACH MANHOLE, INLET, VALVE, FITTING, BEND AND VERTICAL PIPE DEFLECTION.

e. THE PROFILE VIEW SHALL SHOW ALL UNDERGROUND UTILITIES CROSSING THE NEW MAIN AND THE VERTICAL SEPARATION PROVIDED BETWEEN THAT UNDERGROUND UTILITY AND THE NEW MAIN.

ALL CADD FILES MUST BE CREATED FOLLOWING THE CITY OF HOLLYWOOD "SURVEY / AS-BUILT CAD DRAWING STANDARDS"

OF HOLLY WOOD AT	ISSUED:	03/01/1994	DEPARTMENT OF PUBLIC UTILITIES STANDARD DETAIL	REVISED:	11/06/2017
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SCOPE OF WORK

PROPOSED 4" DIP FIRE LINE TO SERVE EXISTING

TWO-STORY COMMERCIAL BUILDING.

INDEX OF SHEETS:

W-1 CIVIL COVER SHEET AND NOTES W-2 PROPOSED FIRE LINE CONNECTION PLAN W-2



ICARLAB. INC ENGINEER AND PLANNERS CERTIFICATE OF AUTHORIZATION 641

8730 S.W. 25 STREET, MIAMI, FL 33165 TEL: 786 385.4093 | FAX: 305 226-0438 E-MAIL: SLABISTE@CARLABINC.COM

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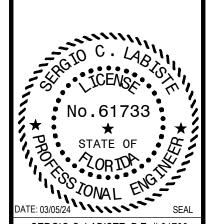
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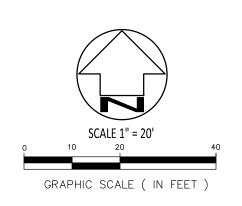
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SERGIO C. LABISTE P.E. #61733


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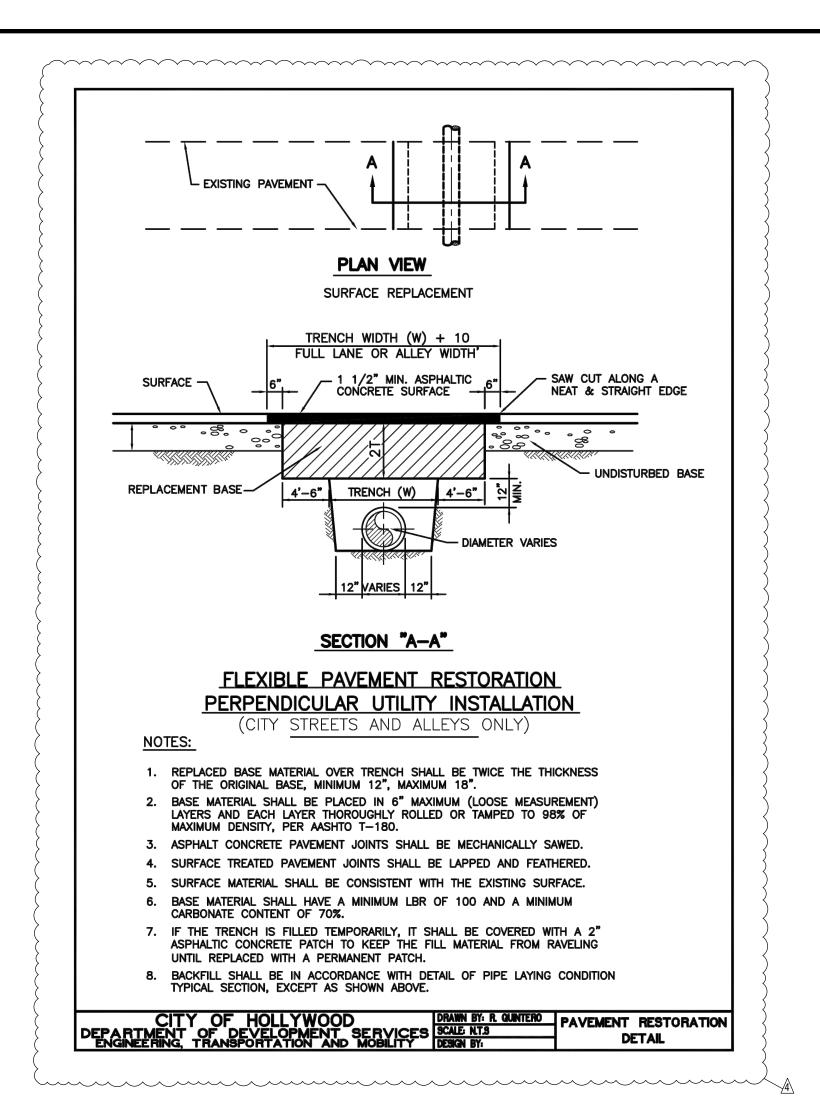
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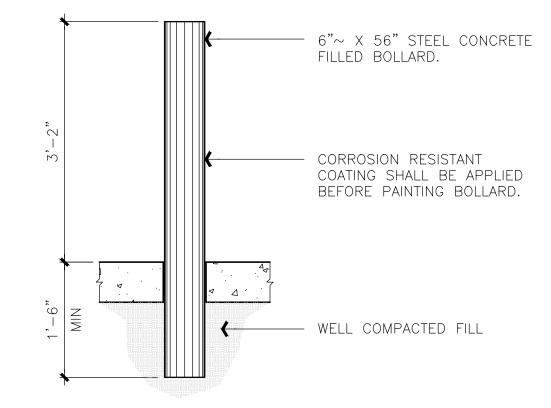
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DENOTES EXISTING	EXIST.
DENOTES SIDEWALK	SWK.
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TO BE FIELD VERIFIED	TBFV
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PROPOSED WATER METER	-0-
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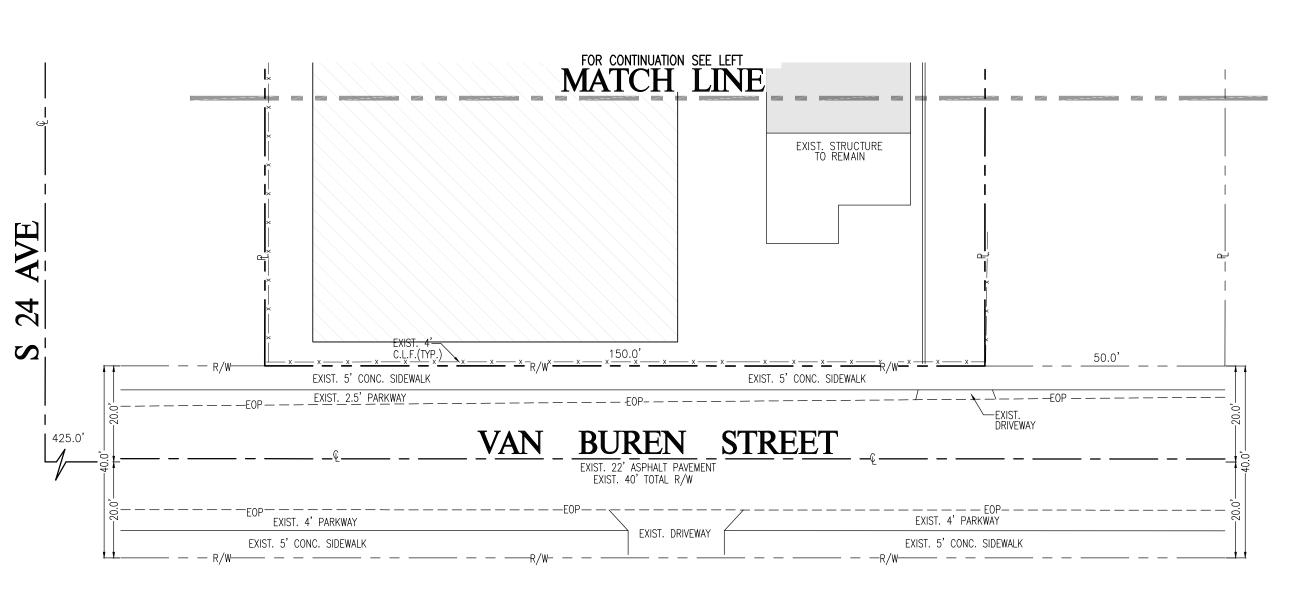


ENGINEER'S NOTES:

- 1. SURVEY OBTAINED FROM VIZCAYA SURVEYING AND MAPPING, INC (FLORIDA CERTIFICATE OF AUTHORIZATION # LB 8000)
- 2. ALL UNDERGROUND INFORMATION SHALL BE VERIFIED WITH THE DIFFERENT UTILITY COMPANIES BEFORE THE START OF ANY CONSTRUCTION OR EXCAVATION, NEITHER THE ENGINEER OR OWNER/DEVELOPER SHALL BE RESPONSIBLE FOR THIS ITEM. SHOULD FIELD DIFFER CONTACT ENGINEER IMMEDIATELY.
- 3. ALL WORK SHALL BE DONE IN ACCORDANCE WITH THE CITY OF HOLLYWOOD DEPARTMENT OF PUBLIC UTILITIES ENGINEERING AND CONSTRUCTION SERVICES STANDARDS AND
- 4. ALL UNDERGROUND INSTALLATIONS SHALL BE PROTECTED AT ALL TIMES DURING CONSTRUCTION AND EXCAVATION.
- 5. FOR PAVEMENT RESTORATION REFER TO CITY OF HOLLYWOOD AND BROWARD COUNTY PUBLIC WORKS STANDARDS AND SPECIFICATIONS (PER G-12 & G-12.1). CONTRACTOR TO RESTORE EXISTING PAVEMENT AND SWALE AREAS DISTURBED DURING CONSTRUCTION TO ORIGINAL CONDITIONS.
- 6. NO EXTERIOR WORK IS PROPOSED EXPECT FOR THE FIRE LINE.
- FOR MARKING AND SIGNAGE INFORMATION, SEE SHEET C-2



BOLLARD DETAIL 3/4"

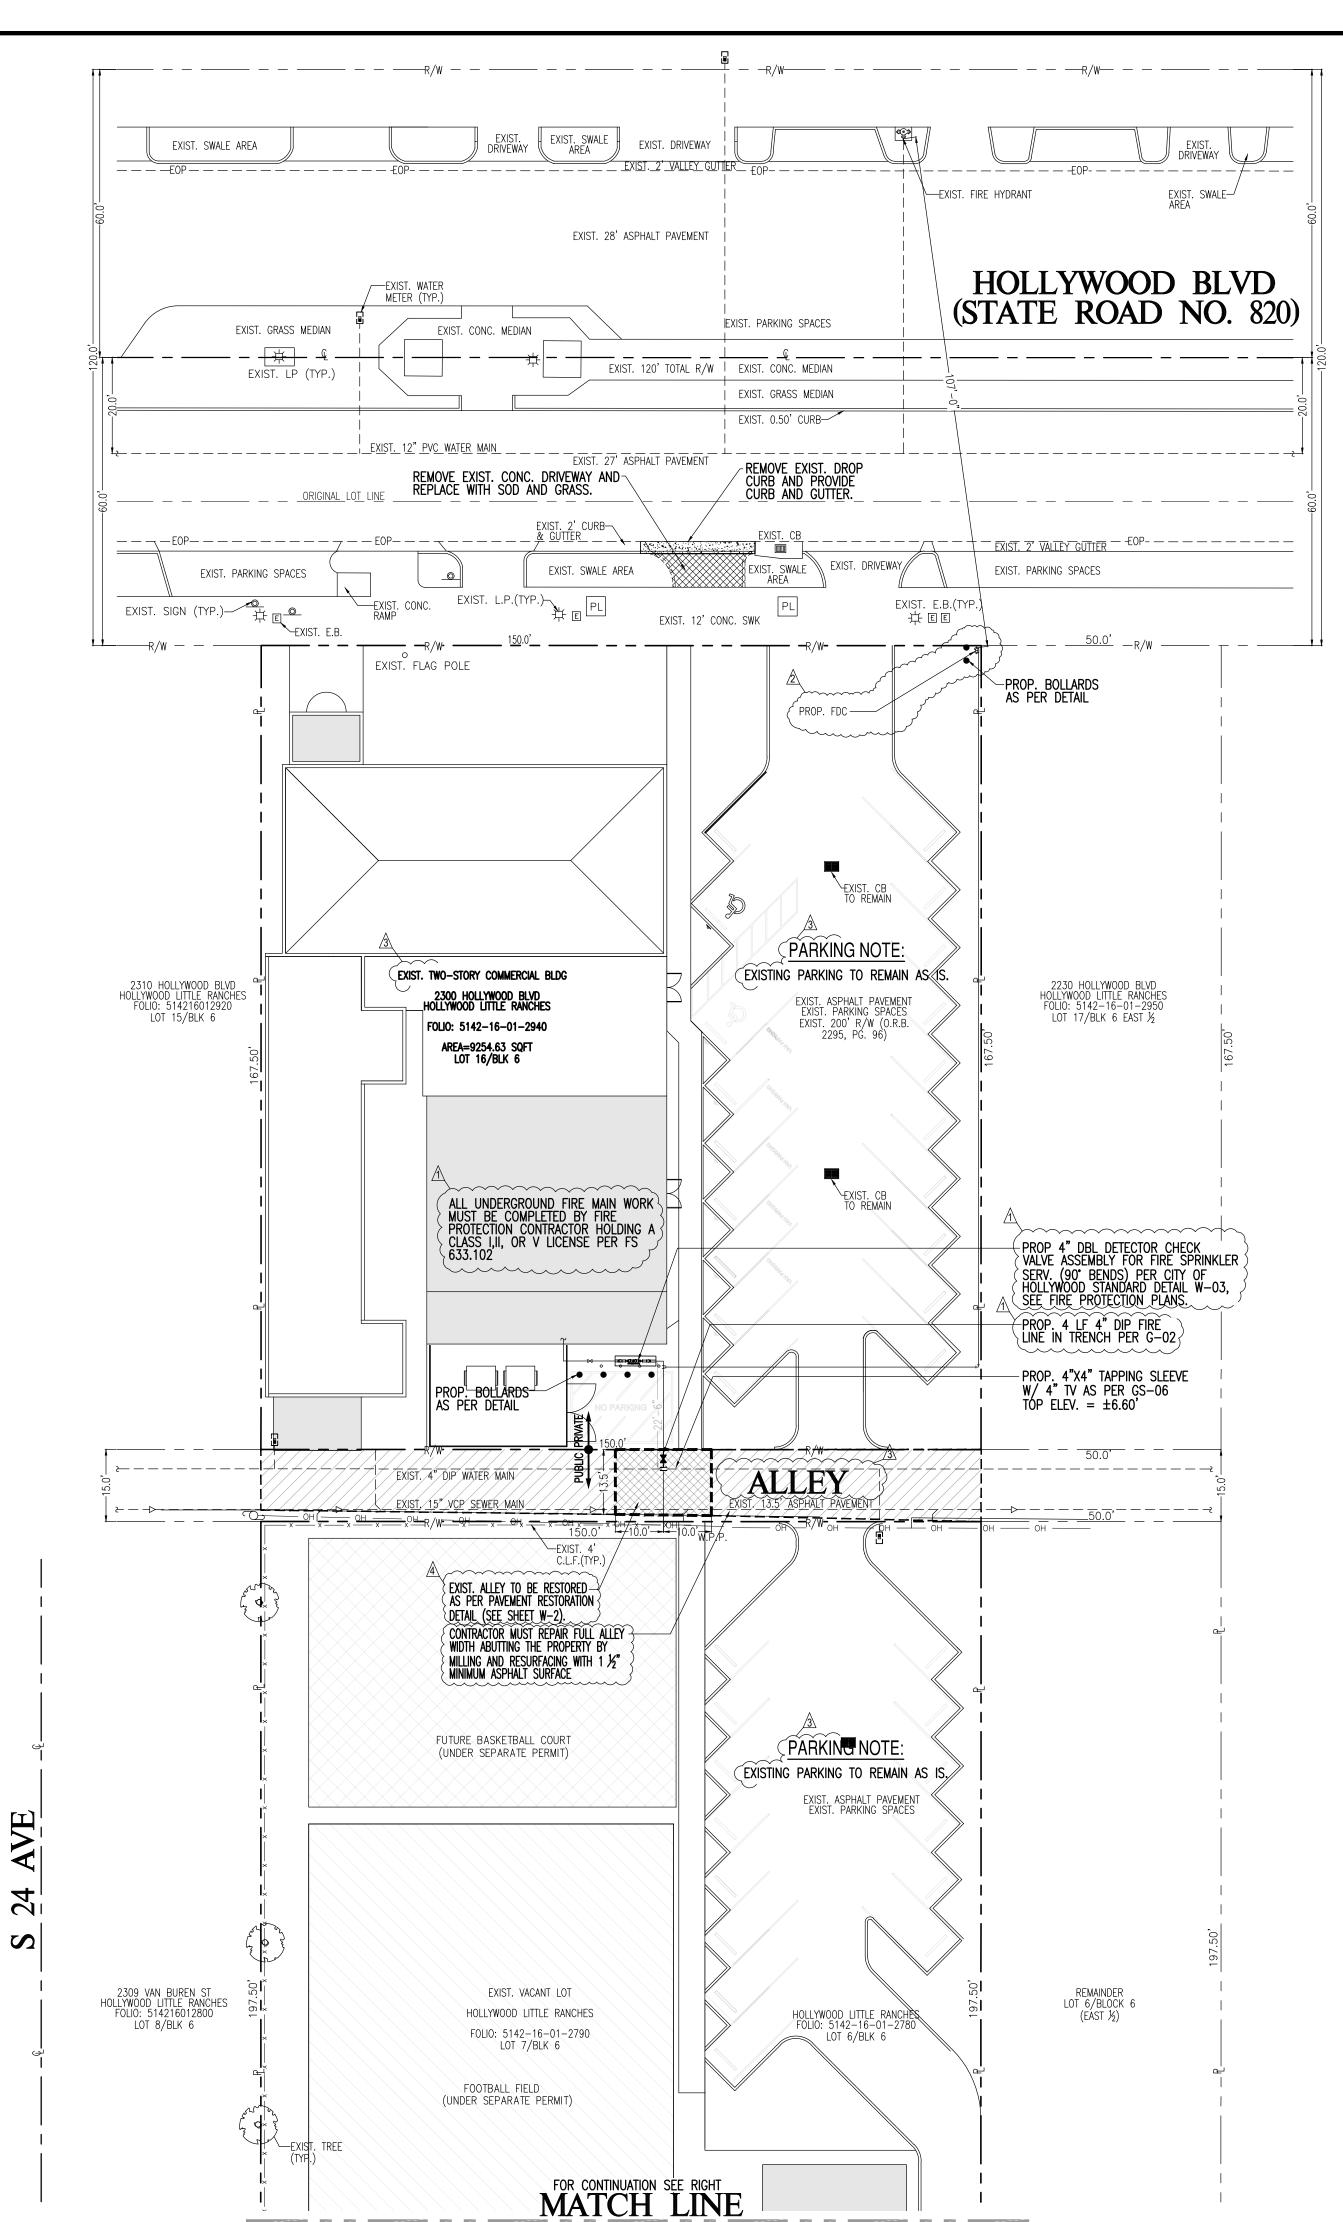



CARLAB, INC ENGINEER AND PLANNERS

CERTIFICATE OF AUTHORIZATION 6419 8730 S.W. 25 STREET, MIAMI, FL 33165 TEL: 786 385.4093 | FAX: 305 226-0438 E-MAIL: SLABISTE@CARLABINC.COM

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REVISIONS CITY OF HOLLYWOOD 01/10/23 A.M CITY OF HOLLYWOOD 03/14/23 R.M CITY OF HOLLYWOOD 06/09/23 R.M CITY OF HOLLYWOOD 01/30/24 A.M.C CARLAB, INC PROJECT NUMBE

22-1924 CHECKED DESIGNED A.M.G. AS SHOWN SCALE

THIS ITEM HAS BEEN DIGITALLY SIGNED AND SEALED BY SE C. LABISTE, P.E. ON THE DATE ADJACENT TO THE SEAL. PRINTED COPIES OF THIS DOCUMENT ARE NOT CONSIDERED SIGNED AND SEALED AND THE SIGNATURE MUST BE VERIFIED CANY ELECTRONIC COPIES.



SERGIO C. LABISTE P.E. # 61733

PROPOSED FIRE LINE CONNECTION PLAN

EET NUMBER W-2

Sunshine 811

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Check positive response codes before you dig!

GENERAL NOTES:


- THE INFORMATION PROVIDED IN THESE DRAWINGS IS SOLELY TO ASSIST THE CONTRACTOR IN ASSESSING THE NATURE AND EXTENT OF CONDITIONS WHICH WILL BE ENCOUNTERED DURING THE COURSE OF THE THE CONTRACTORS ARE DIRECTED, PRIOR TO BIDDING, TO CONDUCT WHATEVER INVESTIGATIONS THEY DEEM NECESSARY TO ARRIVE AT THEIR OWN CONCLUSION REGARDING THE ACTUAL CONDITIONS THAT WILL BE ENCOUNTERED, AND UPON WHICH BIDS WILL BE BASED.
- 2. ALL CONSTRUCTION AND MATERIALS SHALL CONFORM TO APPLICABLE STANDARDS AND SPECIFICATIONS OF THE CITY OF HOLLYWOOD DEPARTMENT OF PUBLIC UTILITIES, ENGINEERING AND CONSTRUCTION SERVICES DIVISION (ECSD), AND ALL OTHER LOCAL, STATE AND NATIONAL CODES, WHERE APPLICABLE.
- LOCATIONS, ELEVATIONS, SIZES, MATERIALS, ALIGNMENTS, AND DIMENSIONS OF EXISTING FACILITIES UTILITIES AND OTHER FEATURES ARE SHOWN ACCORDING TO THE BEST INFORMATION AVAILABLE AT THI TIME OF THE PREPARATION OF THESE PLANS: AND DO NOT PURPORT TO BE ABSOLUTELY CORRECT. ALSO THERE MAY HAVE BEEN OTHER IMPROVEMENTS. UTILITIES. ETC.. WITHIN THE PROJECT AREA WHICH WERE CONSTRUCTED AFTER THE PREPARATION OF THESE PLANS AND/OR THE ORIGINALSITE SURVEY. THE CONTRACTOR SHALL VERIFY THE LOCATIONS, ELEVATIONS, AND OTHER FEATURES AFFECTING HIS/HER WORK PRIOR TO CONSTRUCTION, AND NOTIFY THE ENGINEER IMMEDIATELY WHEN CONFLICT BETWEEN DRAWINGS AND ACTUAL CONDITIONS ARE DISCOVERED. THE ENGINEER ASSUMES NO RESPONSIBILITY FOR ANY FACILITIES SHOWN OR NOT SHOWN ON THE PLANS. THE CONTRACTOR SHALL WORK AS NEEDED TO AVOID CONFLICT WITH EXISTING UTILITIES (NO ADDITIONAL COST SHALL BE PAID FOR THIS WORK). EXISTING UTILITIES SHALL BE MAINTAINED IN SERVICE DURING CONSTRUCTION UNLESS OTHERWISE APPROVED BY THE RESPECTIVE UTILITY OWNER.
- 4. THE CONTRACTOR SHALL COORDINATE WITH ALL UTILITIES TO ARRANGE FOR THE RELOCATION AND TEMPORARY SUPPORT OF UTILITY FEATURES, ETC. AS NECESSARY TO COMPLETE THE WORK.
- IT SHALL BE THE CONTRACTOR'S RESPONSIBILITY TO LOCATE AND PROTECT ANY AND ALL EXISTING UTILITIES ON THIS PROJECT. AND TO ENSURE THAT EXISTING UTILITIES ARE MAINTAINED IN SERVICE DURING CONSTRUCTION UNLESS APPROVED OTHERWISE BY THE UTILITY OWNER.
- CONTRACTOR SHALL ADJUST ALL EXISTING UTILITY CASTINGS INCLUDING VALVE BOXES, MANHOLES HAND-HOLES, PULL-BOXES, STORMWATER INLETS, AND SIMILAR STRUCTURES IN CONSTRUCTION AREA TO BE OVERLAID WITH ASPHALT PAVEMENT.
- 7. THE CONTRACTOR IS REQUIRED TO OBTAIN ALL APPLICABLE CONSTRUCTION AND ENVIRONMENTAL PERMITS PRIOR TO THE START OF CONSTRUCTION.
- 8. THE CONTRACTOR SHALL NOTIFY ECSD AT LEAST 48 HOURS PRIOR TO BEGINNING CONSTRUCTION
- 9. PRIOR TO THE COMMENCEMENT OF CONSTRUCTION AND INSTALLATION OF THE PROPOSED IMPROVEMENTS, SHOP DRAWINGS SHALL BE SUBMITTED TO ECSD IN ACCORDANCE WITH THE CONTRACT DOCUMENT'S REQUIREMENTS, FOR APPROVAL. IN ADDITION, IT IS THE CONTRACTOR'S RESPONSIBILITY TO OBTAIN ANY OTHER AGENCY SHOP DRAWING APPROVAL, IF REQUIRED.
- 10. THE CONTRACTOR SHALL NOTIFY ECSD IMMEDIATELY FOR ANY CONFLICT ARISING DURING CONSTRUCTION OF ANY IMPROVEMENTS SHOWN ON THESE DRAWINGS. THIS WORK BY THE CONTRACTOR SHALL BE CONSIDERED INCIDENTAL TO THE CONTRACT AND NO ADDITIONAL COMPENSATION SHALL BE ALLOWED.
- 11. ELEVATIONS SHOWN ARE IN FEET AND ARE REFERENCED TO THE NORTH AMERICAN VERTICAL DATUM OF 1988 (NAVD 88).

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GENERAL NOTES (CONTINUED):

- 27. THE CONTRACTOR SHALL BE RESPONSIBLE FOR MAINTAINING THE INTEGRITY OF AND MAKING THE REPAIRS TO EXISTING PAVEMENT, SIDEWALKS, PIPES, CONDUITS, CURBS, CABLES, ETC., WHETHER OR NOT SHOWN ON THE PLANS DAMAGED AS A RESULT OF THE CONTRACTORS OPERATIONS AND/OR THOSE OF HIS SUBCONTRACTORS, AND SHALL RESTORE THEM PROMPTLY AT NO ADDITIONAL EXPENSE TO THE OWNER. CONTRACTOR SHALL REPORT ANY DAMAGE TO SIDEWALK, DRIVEWAY, ETC., PRIOR TO **BEGINNING WORK IN ANY AREA.**
- 28. WHERE NEW PAVEMENT MEETS EXISTING, CONNECTION SHALL BE MADE IN A NEAT STRAIGHT LINE AND FLUSH WITH EXISTING PAVEMENT TO MATCH EXISTING CONDITIONS.
- 29. UNDER NO CIRCUMSTANCES SHALL THE CONTRACTOR LEAVE EXCAVATED TRENCHES, OR PARTS OF, EXPOSED OR OPENED AT THE END OF THE WORKING DAY, WEEKENDS, HOLIDAYS OR OTHER TIMES, WHEN THE CONTRACTOR IS NOT WORKING, UNLESS OTHERWISE DIRECTED. ALL TRENCHES SHALL BE COVERED, FIRMLY SECURED AND MARKED ACCORDINGLY FOR PEDESTRIAN / VEHICULAR TRAFFIC.
- 30. ALL EXCAVATED MATERIAL REMOVED FROM THIS PROJECT SHALL BE DISPOSED OF OFF THE PROPERTY BY THE CONTRACTOR AT THE CONTRACTOR'S EXPENSE.
- 31. ALL DUCTILE IRON PRODUCTS SHALL BE DOMESTIC MADE HEAVY DUTY CLASSIFICATION SUITABLE FOR HIGHWAY TRAFFIC LOADS, OR 20,000 LB.
- 32. ALL GRASSED AREAS AFFECTED BY CONSTRUCTION SHALL BE RE-SODDED.
- 33. THE CONTRACTOR SHALL BE RESPONSIBLE FOR THE PROVISION, INSTALLATION AND MAINTENANCE OF ALL TRAFFIC CONTROL AND SAFETY DEVICES, IN ACCORDANCE WITH SPECIFICATIONS OF THE LATEST REVISION OF FDOT DESIGN STANDARDS. IN ADDITION, THE CONTRACTOR IS RESPONSIBLE FOR THE RESETTING OF ALL TRAFFIC CONTROL AND INFORMATION SIGNAGE REMOVED DURING THE CONSTRUCTION PERIOD.
- 34. EXCAVATED OR OTHER MATERIAL STORED ADJACENT TO OR PARTIALLY UPON A ROADWAY PAVEMENT SHALL BE ADEQUATELY MARKED FOR TRAFFIC SAFETY AT ALL TIMES.
- 35. TEMPORARY PATCH MATERIAL MUST BE ON THE JOB SITE WHENEVER PAVEMENT IS CUT, OR THE CITY'S INSPECTOR WILL SHUT THE JOB DOWN.
- 36. CONTRACTOR MUST PROVIDE FLASHER ARROW SIGNAL FOR ANY LANE THAT IS CLOSED OR DIVERTED.
- 37. CONTRACTOR SHALL NOTIFY LAW ENFORCEMENT AND FIRE PROTECTION SERVICES TWENTY-FOUR (24) HOURS IN ADVANCE OF TRAFFIC DETOUR IN ACCORDANCE WITH SECTION 336.07 OF FLORIDA STATUTES.
- 38. CONTRACTOR TO RESTORE PAVEMENT TO ORIGINAL CONDITION AS REQUIRED.

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LEGAL DESCRIPTION

THE WEST 1/2 OF LOT 6, LESS THE NORTH 7 1/2 FEET FOR ALLEY, BLOCK 6, HOLLYWOOD LITTLE RANCHES, ACCORDING TO THE PLAT THEREOF AS RECORDED IN PLAT BOOK 1, PAGE 26, OF THE PUBLIC RECORDS OF BROWARD COUNTY, FLORIDA.

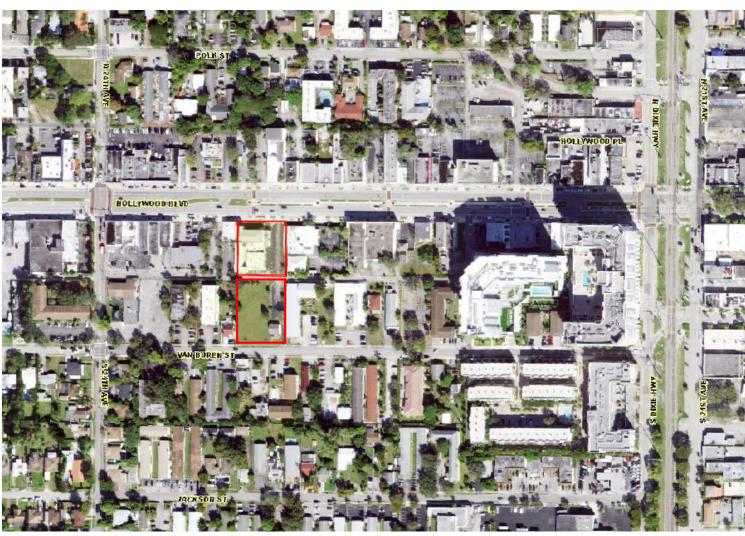LOT 7, LESS THE NORTH 7.5 FEET, BLOCK 6, HOLLYWOOD LITTLE RANCHES, ACCORDING TO THE PLAT THEREOF AS RECORDED IN PLAT BOOK 1, PAGE 26, OF THE PUBLIC RECORDS OF BROWARD COUNTY, FLORIDA.

LOT 16, AND THE WEST 1/2 OF LOT 17, BLOCK 6, HOLLYWOOD LITTLE RANCHES, ACCORDING TO THE PLAT THEREOF AS RECORDED IN PLAT BOOK 1, PAGE 26, OF THE PUBLIC RECORDS OF BROWARD COUNTY, FLORIDA, LESS THE FOLLOWING PORTION OF LOT 16 DEEDED TO THE CITY OF HOLLYWOOD, FLORIDA BY QUIT CLAIM DEED RECORDED IN OFFICIAL RECORDS BOOK 2295, PAGE 94, PUBLIC RECORDS OF BROWARD COUNTY, FLORIDA, DESCRIBED AS FOLLOWS: THAT PORTION OF LOT SIXTEEN (16), BLOCK SIX (6), HOLLYWOOD LITTLE RANCHES AMENDED, ACCORDING TO THE PLAT THEREOF AS RECORDED IN PLAT BOOK 1, PAGE 26 OF THE PUBLIC RECORDS OF BROWARD COUNTY, FLORIDA, MORE

PARTICULARLY DESCRIBED BY METES AND BOUNDS AS FOLLOWS: BEGINNING AT THE SOUTHWEST CORNER OF SAID LOT 16, BLOCK 6, THENCE RUN NORTHERLY ALONG THE WEST PROPERTY LINE FOR A DISTANCE OF SIX FEET TO A POINT; THENCE RUN EASTERLY PARALLEL TO THE SOUTH PROPERTY LINE A DISTANCE OF TWENTY-FIVE FEET TO A POINT; THENCE RUN NORTHEASTERLY FOR A DISTANCE OF TEN FEET ONE AND A. QUARTER INCHES MORE OR LESS, TO A POINT WHICH IS SEVEN AND ONE-HALF FEET NORTH OF THE SOUTH PROPERTY LINE OF SAID LOT 16; THENCE RUN EASTERLY ALONG A LINE PARALLEL TO THE SOUTH PROPERTY LINE A DISTANCE OF SIXTY-FIVE FEET MORE OR LESS, TO A POINT ON THE EAST PROPERTY LINE; THENCE RUN SOUTHERLY ALONG THE EAST PROPERTY LINE OF SAID LOT 16 A DISTANCE OF SEVEN AND ONE-HALF FEET TO THE SOUTH PROPERTY LINE; THENCE RUN WESTERLY ALONG THE SOUTH PROPERTY LINE OF SAID LOT 16, A DISTANCE OF ONE HUNDRED FEET TO THE POINT OF BEGINNING;

AND LESS THE FOLLOWING PORTION OF LOT 17 DEEDED TO THE CITY OF HOLLYWOOD, FLORIDA BY QUIT CLAIM DEED RECORDED IN OFFICIAL RECORDS BOOK 2295, PAGE 96, PUBLIC RECORDS OF BROWARD COUNTY, FLORIDA, DESCRIBED AS

THE SOUTH SEVEN AND ONE-HALF FEET OF THE WEST HALF OF LOT 17, BLOCK 6, HOLLYWOOD LITTLE RANCHES AMENDED, ACCORDING TO THE PLAT THEREOF AS RECORDED IN PLAT BOOK 1, PAGE 26 OF THE PUBLIC RECORDS OF BROWARD

GENERAL NOTES (CONTINUED):

- 12. CITY OF HOLLYWOOD SHALL NOT PROVIDE STAGING / STORAGE AREA. CONTRACTOR SHALL SECURE STAGING / STORAGE AREA AS NECESSARY FOR CONSTRUCTION WORK.
- 13. CONTRACTOR SHALL HAUL AWAY EXCESSIVE STOCKPILE OF SOIL FOR DISPOSAL EVERY DAY. NO STOCKPILE SOIL IS ALLOWED TO BE LEFT ON THE CONSTRUCTION SITE OVER NIGHT.
- 14. CONTRACTOR SHALL CLEAN / SWEEP THE ROAD AT LEAST ONCE DAY OR AS REQUIRED BY THE ENGINEER.
- 15. CONTRACTOR SHALL PROTECT CATCH BASINS WITHIN / ADJACENT TO THE CONSTRUCTION SITE AS **REQUIRED BY NPDES REGULATIONS.**
- 16. THE CITY OF HOLLYWOOD HAS A NOISE ORDINANCE (CHAPTER 100) WHICH PROHIBITS EXCAVATION AND CONSTRUCTION BEFORE 8:00 A.M. AND AFTER 6:00 P.M., MONDAY THROUGH SATURDAY AND ALL DAY
- 17. SUITABLE EXCAVATED MATERIAL SHALL BE USED IN FILL AREAS. NO SEPARATE PAY ITEM FOR THIS WORK. INCLUDE COST IN OTHER ITEMS.
- 18. ALL ROAD CROSSINGS ARE OPEN CUT AS PER THE REQUIREMENTS OF THE ECSD UNLESS OTHERWISE NOTED ON THE DRAWINGS.
- 19. THE CONTRACTOR SHALL REPLACE ALL PAVING, STABILIZING EARTH, DRIVEWAYS, PARKING LOTS, SIDEWALKS, ETC. TO SATISFY THE INSTALLATION OF THE PROPOSED IMPROVEMENTS WITH THE SAME TYPE OF MATERIAL THAT WAS REMOVED DURING CONSTRUCTION OR AS DIRECTED BY ECSD FIELD
- 20. THE CONTRACTOR SHALL NOT ENCROACH INTO PRIVATE PROPERTY WITH PERSONNEL, MATERIAL OR EQUIPMENT. IN CASE WORK ON PRIVATE PROPERTY IS NEEDED. A CITY OF HOLLYWOOD "RIGHT OF ENTRY" FORM MUST BE SIGNED BY PROPERTY OWNER AND THE DIRECTOR OF PUBLIC UTILITIES. THE CONTRACTOR IS RESPONSIBLE TO MAINTAIN ACCESS AT ALL TIMES TO PRIVATE HOMES/BUSINESSES.
- 21. THE CONTRACTOR SHALL BE RESPONSIBLE FOR DAMAGE, REMOVAL OR MODIFICATION, CAUSED TO ANY IRRIGATION SYSTEM (PRIVATE OR PUBLIC) ACCIDENTALLY OR PURPOSELY. THE CONTRACTOR SHALL REPLACE ANY DAMAGED, REMOVED OR MODIFIED IRRIGATION PIPES, SPRINKLER HEADS OR OTHER PERTINENT APPURTENANCES TO MATCH OR EXCEED EXISTING CONDITIONS AT NO ADDITIONAL COST TO
- 22. MAIL BOXES, FENCES OR OTHER PRIVATE PROPERTY DAMAGED DURING THE CONSTRUCTION OF THE PROPOSED IMPROVEMENTS SHALL BE REPLACED TO MATCH OR EXCEED EXISTING CONDITION.
- 23. CONTRACTOR SHALL PROVIDE MAINTENANCE OF TRAFFIC IN ACCORDANCE WITH FDOT STANDARDS AND CITY OF HOLLYWOOD DEPARTMENT OF PUBLIC UTILITIES STANDARDS.
- 24. NO TREES ARE TO BE REMOVED OR RELOCATED WITHOUT PRIOR APPROVAL FROM THE ECSD FIELD ENGINEER.
- 25. THE CONTRACTOR IS RESPONSIBLE FOR OBTAINING THE NECESSARY TREE REMOVAL OR RELOCATION PERMITS FROM THE CITY OF HOLLYWOOD BUILDING DEPARTMENT FOR TREES LOCATED IN THE PUBLIC RIGHT OF WAY.
- 26. IT IS THE INTENT OF THESE PLANS TO BE IN ACCORDANCE WITH APPLICABLE CODES AND AUTHORITIES HAVING JURISDICTION. ANY DISCREPANCIES BETWEEN THESE PLANS AND APPLICABLE REGULATORY STANDARDS / REQUIREMENTS SHALL BE IMMEDIATELY BROUGHT TO THE ATTENTION OF ECSD.

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GENERAL NOTES (CONTINUED):

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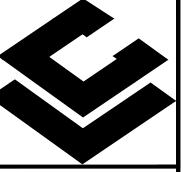
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- c. THE PLAN VIEW SHALL ALSO SHOW THE HORIZONTAL SEPARATION FROM UNDERGROUND UTILITIES IMMEDIATELY ADJACENT OR PARALLEL TO THE NEW MAIN.
- d. PROFILE VIEW WITH SPOT ELEVATIONS OF THE TOP OF THE MAIN (WATER MAIN AND FORCE MAIN) OR PIPE INVERT (GRAVITY MAIN) AND OF THE FINISHED GRADE OR MANHOLE RIM DIRECTLY ABOVE THE MAIN AT INTERVALS NOT TO EXCEED 100 FEET AS MEASURED ALONG THE MAIN. THE PROFILE VIEW SHALL ALSO INCLUDE SPOT ELEVATIONS AT EACH MANHOLE. INLET, VALVE, FITTING, BEND AND VERTICAL PIPE DEFLECTION.
- e. THE PROFILE VIEW SHALL SHOW ALL UNDERGROUND UTILITIES CROSSING THE NEW MAIN AND THE VERTICAL SEPARATION PROVIDED BETWEEN THAT UNDERGROUND UTILITY AND THE NEW MAIN.
- f. ALL CADD FILES MUST BE CREATED FOLLOWING THE CITY OF HOLLYWOOD "SURVEY / AS-BUILT CAD DRAWING STANDARDS"

of HOLLYWOOD P.	ISSUED:	03/01/1994	DEPARTMENT OF PUBLIC UTILITIES STANDARD DETAIL	REVISED: 11/06/2017
	DRAWN:	EAM	GENERAL NOTES	DRAWING NO.
TO DOMESTICATE OF THE PARTY OF	APPROVE	D: XXX	(CONTINUED)	G-00.3

INDEX OF SHEETS:

C-1 CIVIL COVER SHEET AND NOTES C-2 PROPOSED MARKING AND SIGNAGE PLAN

C-3 CIVIL DETAILS



ICARLAB. INC ENGINEER AND PLANNERS CERTIFICATE OF AUTHORIZATION 641 8730 S.W. 25 STREET, MIAMI, FL 33165

TEL: 786 385.4093 | FAX: 305 226-0438 E-MAIL: SLABISTE@CARLABINC.COM

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REVISIONS DATE B

CARLAB, INC PROJECT NUMBER 22-1924


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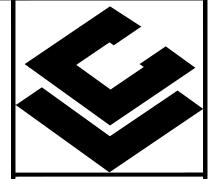
* STATE OF

E: 03/05/24 SERGIO C. LABISTE P.E. #61733

CIVIL COVER

IEET NUMBER



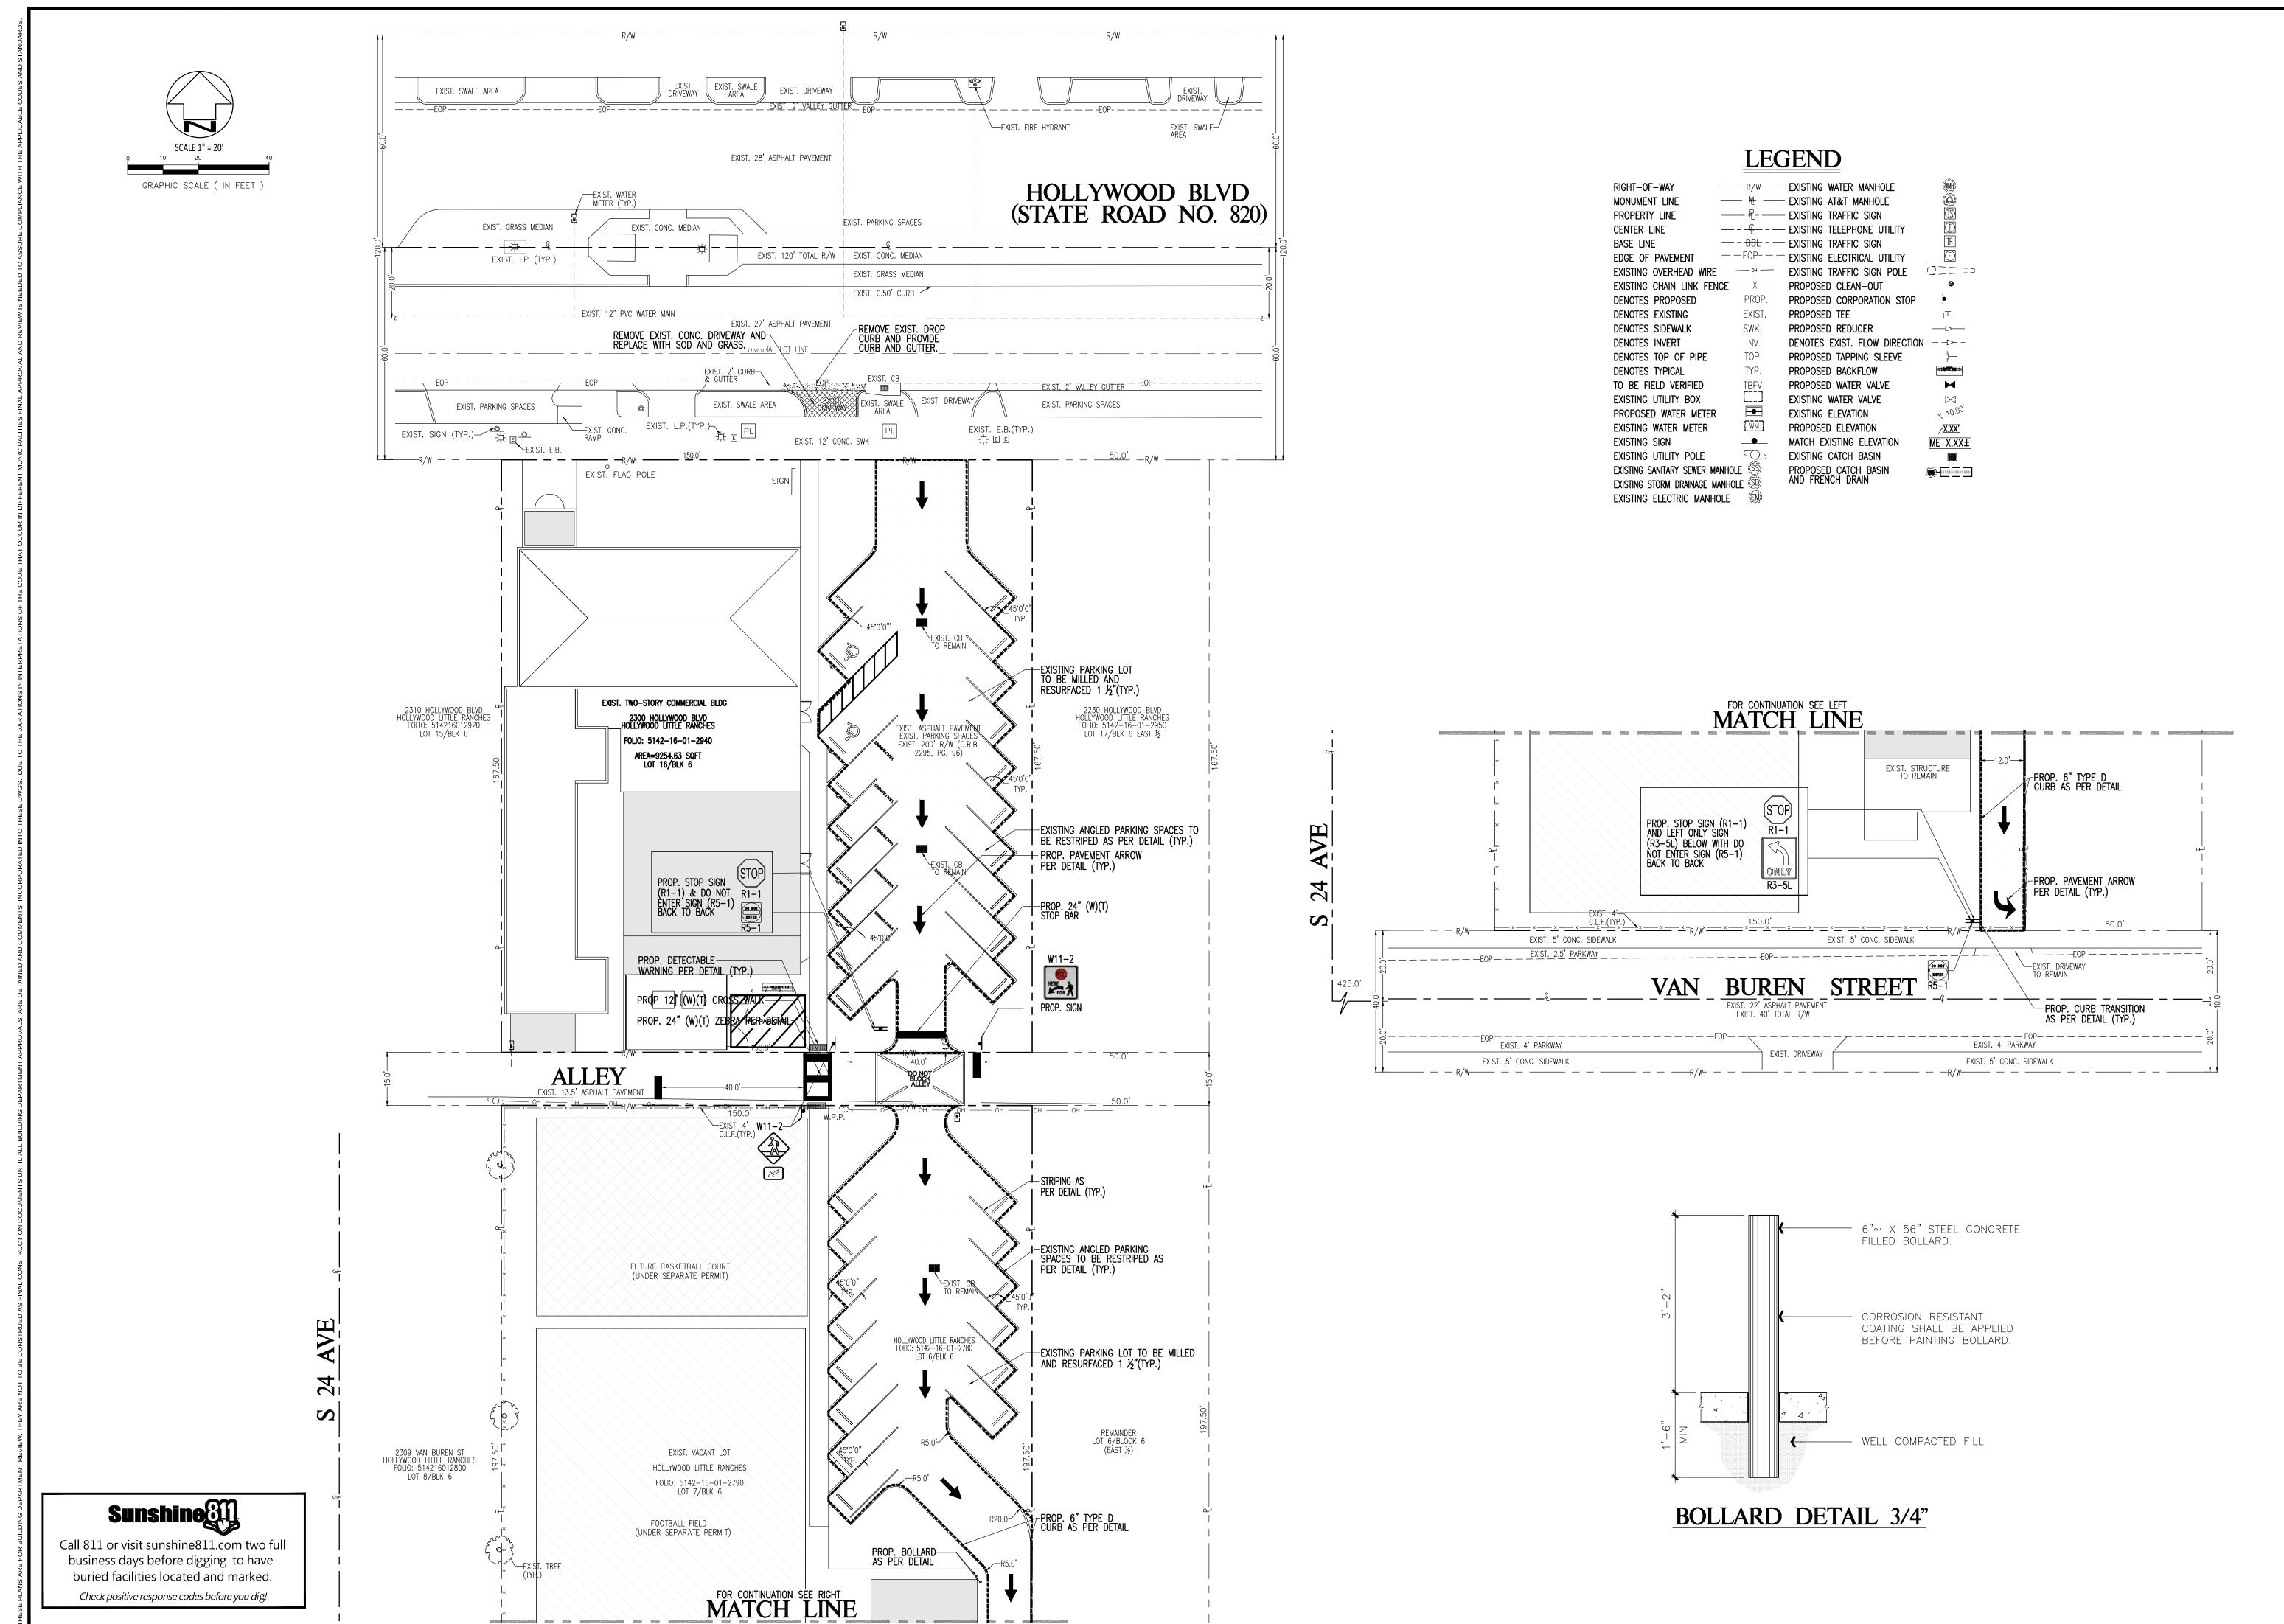

CARLAB, INC ENGINEER AND PLANNERS
CERTIFICATE OF AUTHORIZATION 6419 E-MAIL: SLABISTE@CARLABINC.COM

8730 S.W. 25 STREET, MIAMI, FL 33165 TEL: 786 385.4093 | FAX: 305 226-0438

EDUC/ AND WOOD BLVD, HOLLYWOO FOLIO NO: 514216012940 WORSHIP ELIGIOUS

DATE B' REVISIONS CARLAB, INC PROJECT NUMBER 22-1924


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SERGIO C. LABISTE P.E. # 61733

PROPOSED MARKING AND SIGNAGE PLAN


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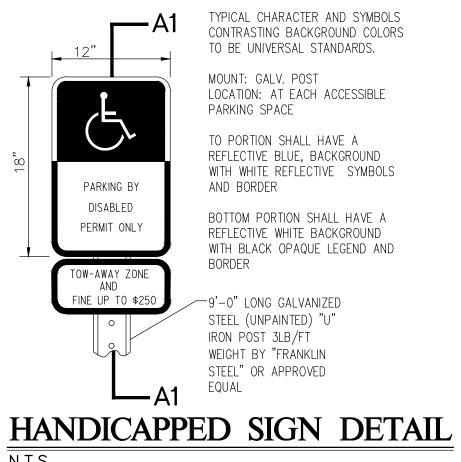



N.T.S.


DETAIL OF STANDARD CURB ENDING FOR 6" CURB

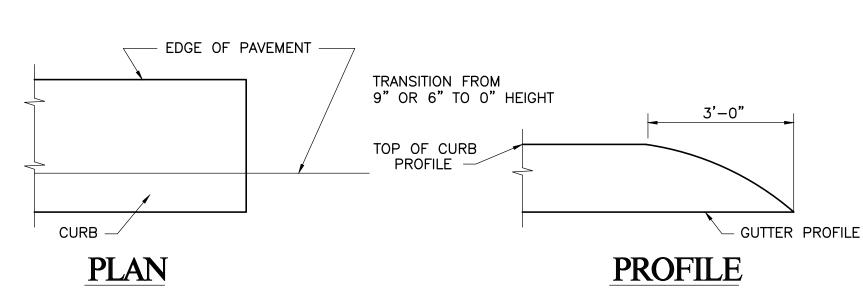





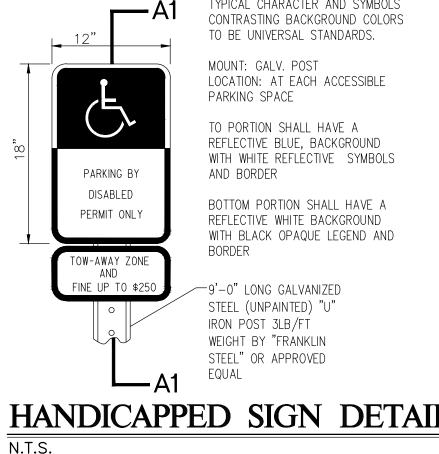

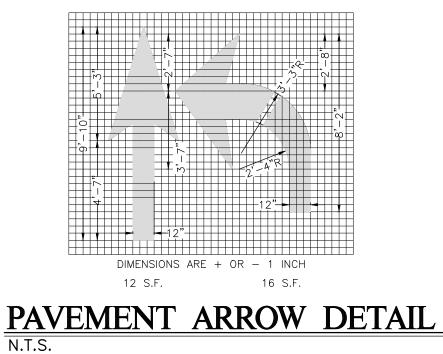


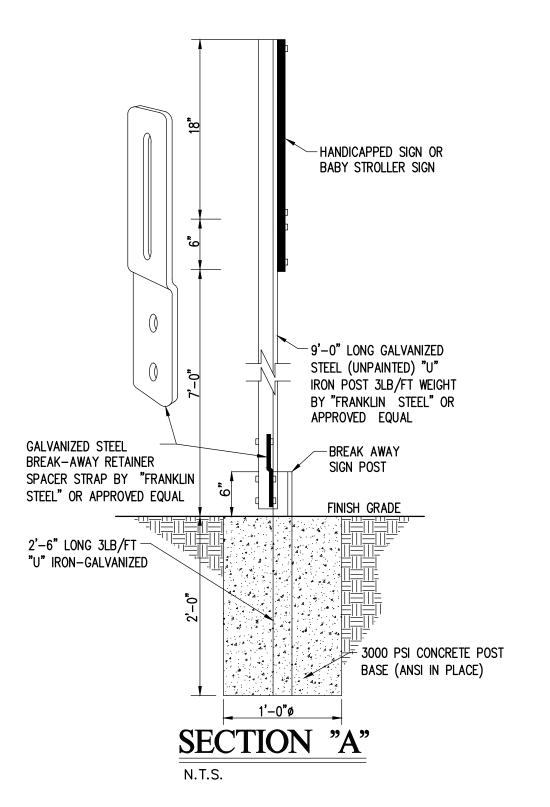

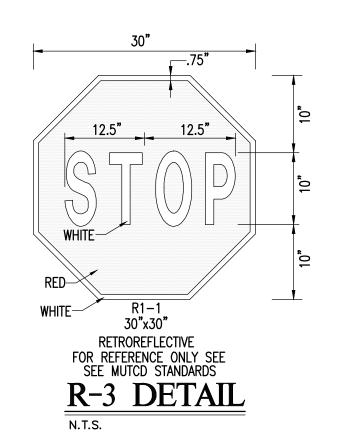

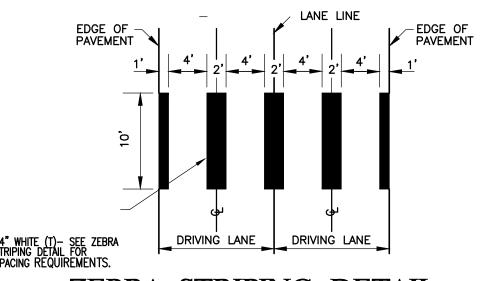


ZEBRA STRIPING DETAIL N.T.S.

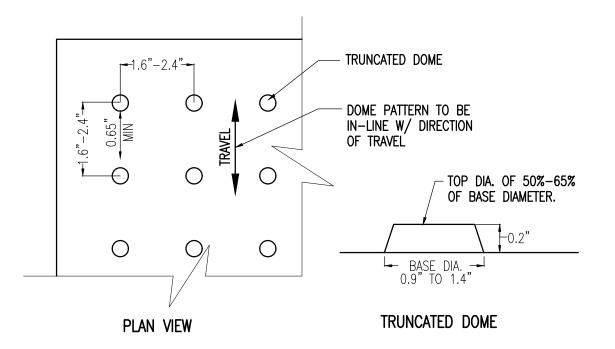


1. DETECTABLE WARNINGS TO BE POURED IN PLACE.

- 2. DETECTABLE WARNINGS SHALL CONSIST OF RAISED TRUNCATED DOMES WITH A NOMINAL DIAMETER OF 0.9" (23mm) MINIMUM TO 1.4" (36mm) MAXIMUM AT THE BASE. A TOP DIAMETER OF 50% TO 65% OF THE BASE DIAMETER. A NOMINAL HEIGHT OF 0.2" (5.1mm) AND ON CENTER SPACING OF
- 3. DETECTABLE WARNINGS SHALL EXTEND THE FULL WIDTH OF THE CURB RAMP (EXCLUSIVE OF FLARED SIDES) AND SHALL EXTEND EITHER THE FULL DEPTH OF THE CURB RAMP OR A MINIMUM OF 24" AS MEASURED FROM THE BACK OF THE CURB.
- 4. DETECTABLE WARNING ARE NOT TO BE INSTALLED ON TRANSITION SLOPES 5. DETECTABLE WARNING SHALL CONTRAST VISUALLY WITH ADJACENT WALKING SURFACES EITHER LIGHT-ON-DARK, OR DARK-ON-LIGHT

DETECTABLE WARNING SURFACE

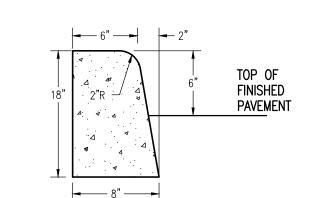

TYPE "D" CURB DETAIL

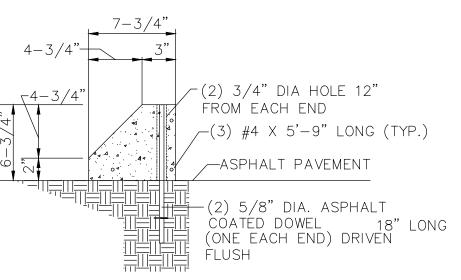

PRECAST CONCRETE WHEEL STOP N.T.S.

Sunshine 811

Call 811 or visit sunshine811.com two full business days before digging to have buried facilities located and marked. Check positive response codes before you dig!

CARLAB, INC ENGINEER AND PLANNERS
CERTIFICATE OF AUTHORIZATION 6419 8730 S.W. 25 STREET, MIAMI, FL 33165 TEL: 786 385.4093 | FAX: 305 226-0438 E-MAIL: SLABISTE@CARLABINC.COM

> EDUC/ AND WORSHIP

REVISIONS CARLAB, INC PROJECT NUMBER 22-1924 DESIGNED


AS SHOWN THIS ITEM HAS BEEN DIGITALLY SIGNED AND SEALED BY SERG C. LABISTE, P.E. ON THE DATE ADJACENT TO THE SEAL. PRINTED COPIES OF THIS DOCUMENT ARE NOT CONSIDERED SIGNED AND SEALED AND THE SIGNATURE MUST BE VERIFIED OI ANY ELECTRONIC COPIES.




CIVIL DETAILS

EET NUMBER

C-3

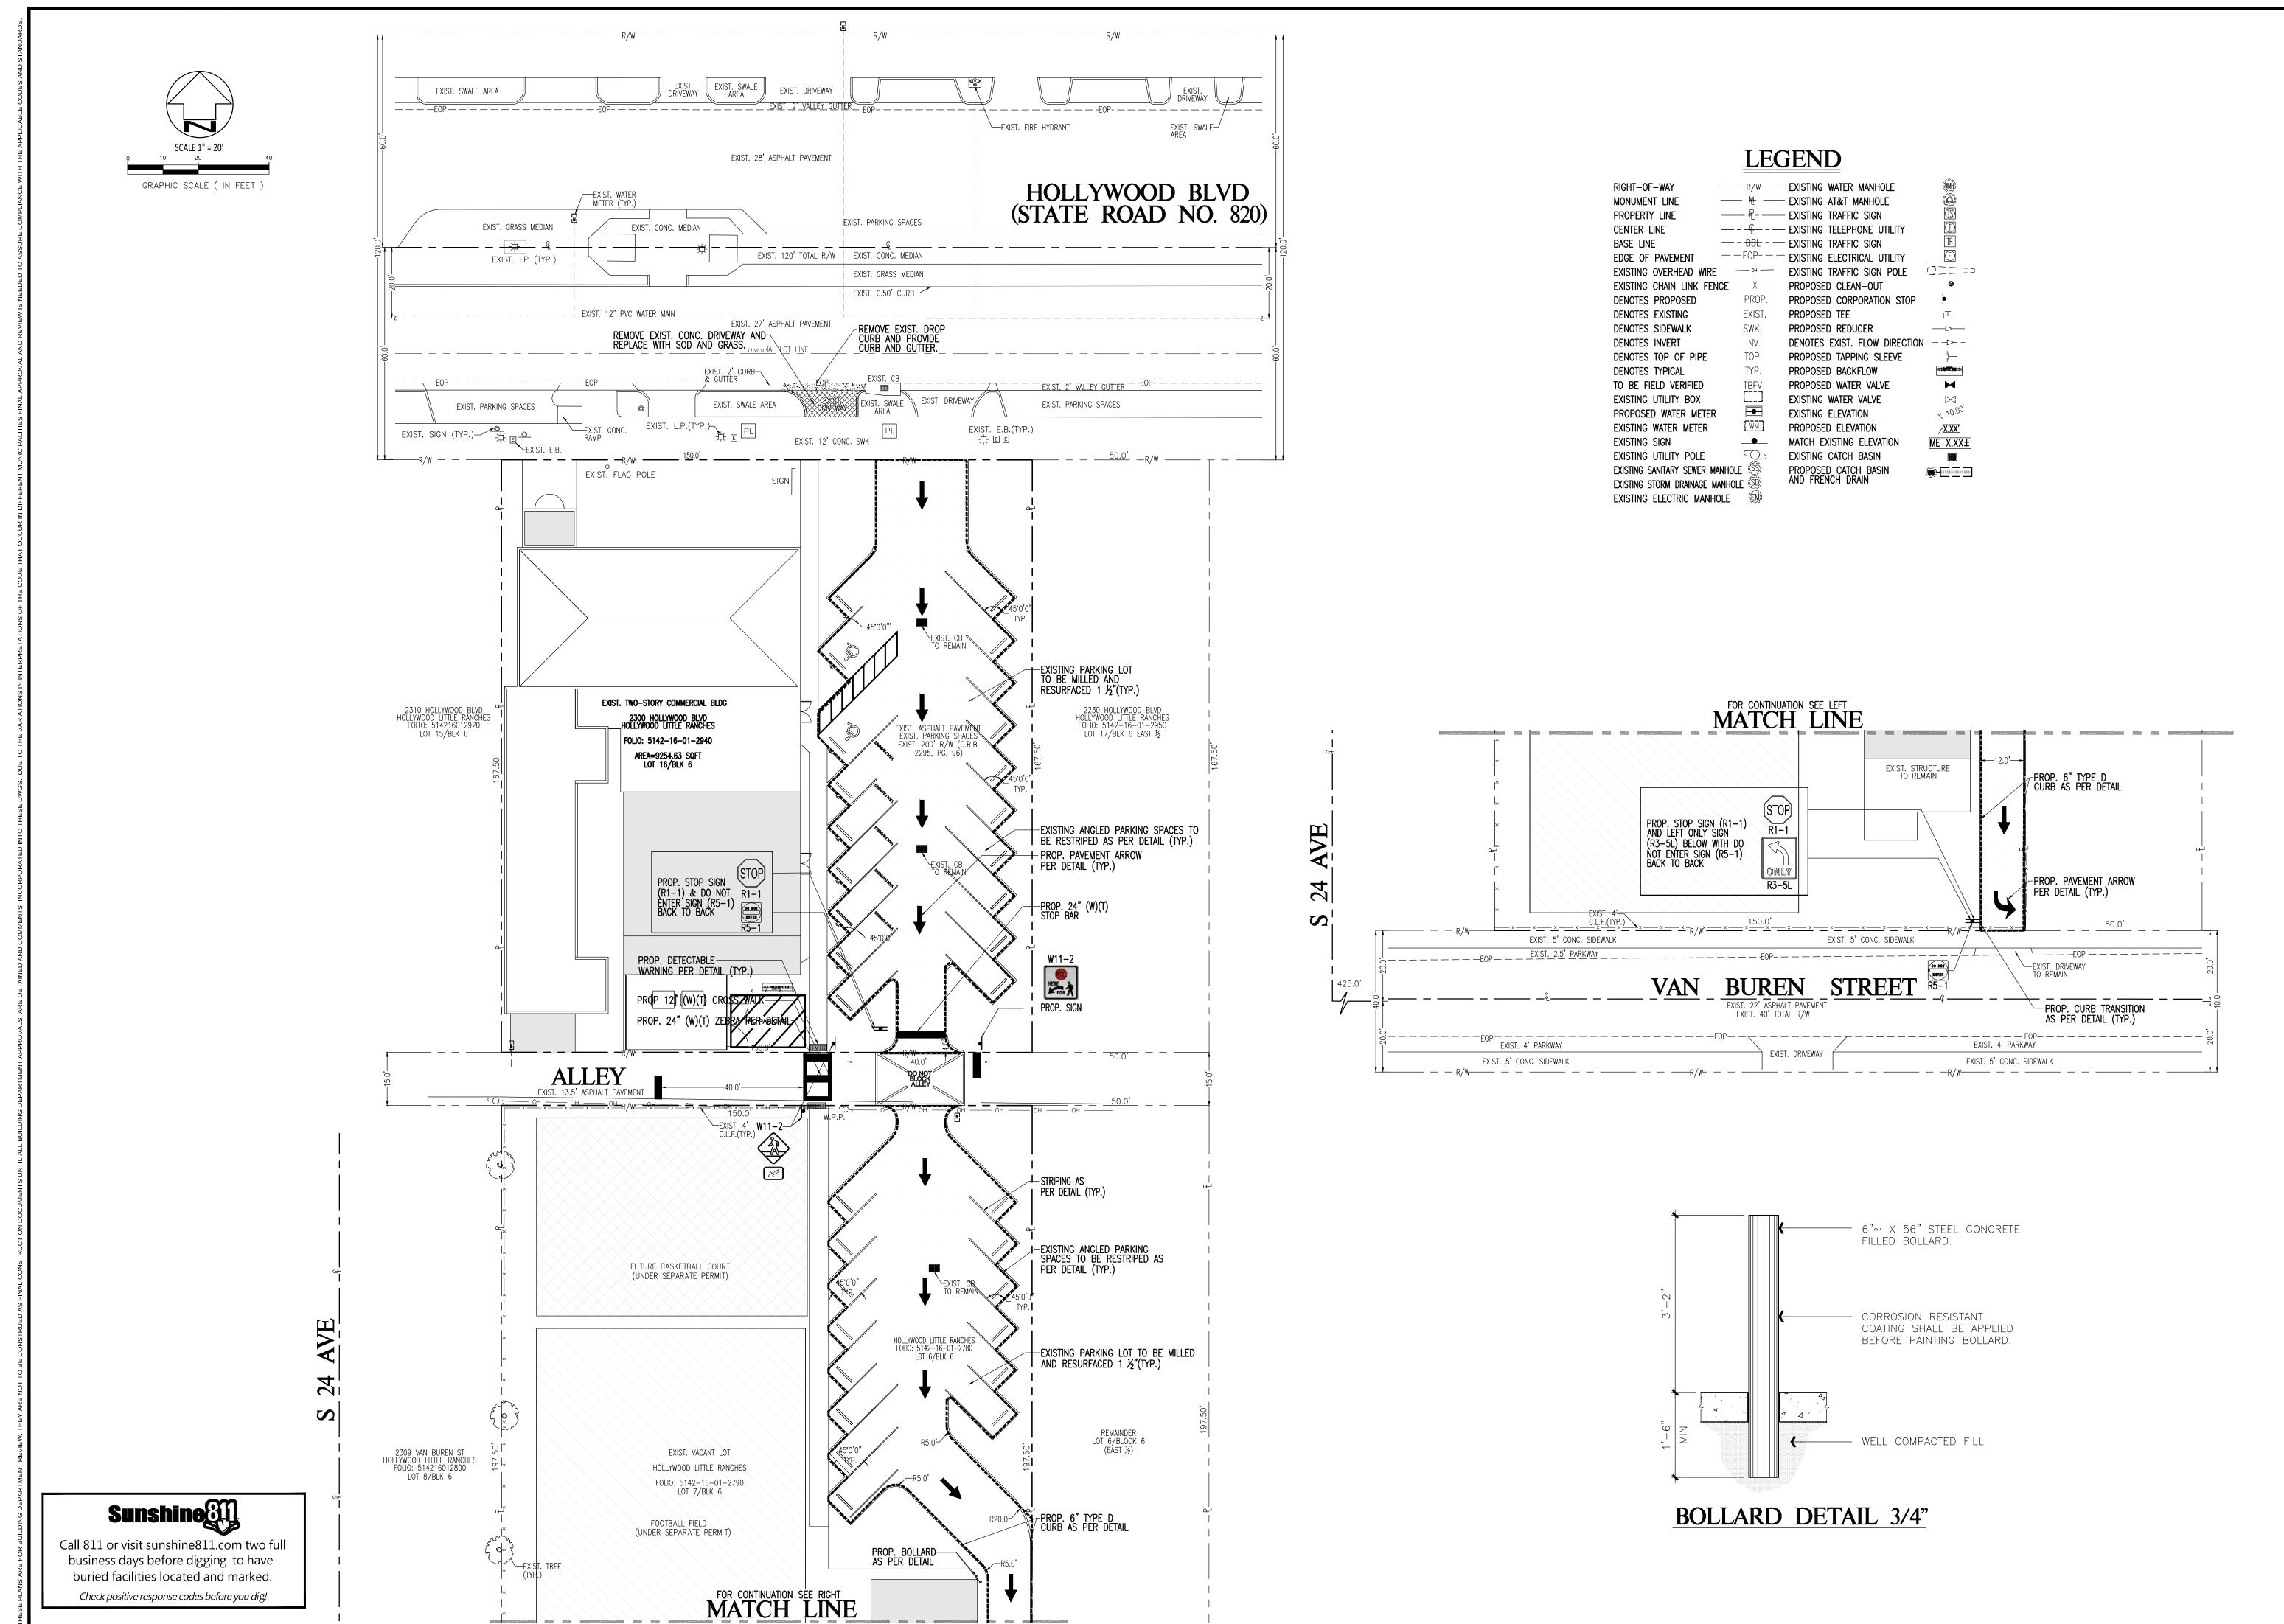

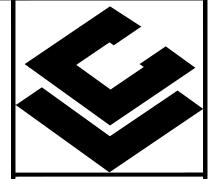

CARLAB, INC ENGINEER AND PLANNERS
CERTIFICATE OF AUTHORIZATION 6419 E-MAIL: SLABISTE@CARLABINC.COM

8730 S.W. 25 STREET, MIAMI, FL 33165 TEL: 786 385.4093 | FAX: 305 226-0438

EDUC/ AND WOOD BLVD, HOLLYWOO FOLIO NO: 514216012940 WORSHIP ELIGIOUS

DATE B' REVISIONS CARLAB, INC PROJECT NUMBER 22-1924


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SERGIO C. LABISTE P.E. # 61733


PROPOSED MARKING AND SIGNAGE PLAN


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LEGEND


RIGHT-OF-WAY -	— R/₩——
MONUMENT LINE -	— ₩ —
PROPERTY LINE —	
CENTER LINE —	
BASE LINE —	– – BBL – —
EDGE OF PAVEMENT —	-EOP
EXISTING OVERHEAD WIRE	—— он ——
EXISTING CHAIN LINK FENCE	X
DENOTES PROPOSED	PROP.
DENOTES EXISTING	EXIST.
DENOTES SIDEWALK	SWK.
DENOTES INVERT	INV.
DENOTES TOP OF PIPE	TOP
DENOTES TYPICAL	TYP.
TO BE FIELD VERIFIED	TBFV
EXISTING UTILITY BOX	
PROPOSED WATER METER	-0-
EXISTING WATER METER	
EXISTING SIGN	
EXISTING UTILITY POLE	
EXISTING SANITARY SEWER MANHOLE	(<u>(SS</u>))
EXISTING STORM DRAINAGE MANHOLE	(SD)
EXISTING ELECTRIC MANHOLE	ŒM)
EXISTING WATER MANHOLE	(WMH)
EXISTING AT&T MANHOLE	
EXISTING TRAFFIC SIGN	
EXISTING TELEPHONE UTILITY	
EXISTING TRAFFIC SIGN	TB
EXISTING ELECTRICAL UTILITY	(E)
EXISTING TRAFFIC SIGN POLE	\mathbb{Q}
PROPOSED CLEAN-OUT	⊗
PROPOSED CORPORATION STOP	—
PROPOSED TEE	凸
PROPOSED REDUCER	$\longrightarrow \!$
DENOTES EXIST. FLOW DIRECTION	V -→>-
PROPOSED TAPPING SLEEVE	¦ ⊢−
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EXISTING WATER VALVE	[×] .,
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PROPOSED CATCH BASIN	200200000000000000000000000000000000000
AND FRENCH DRAIN	_



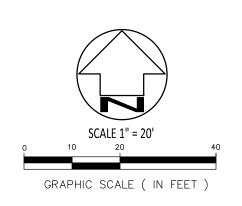


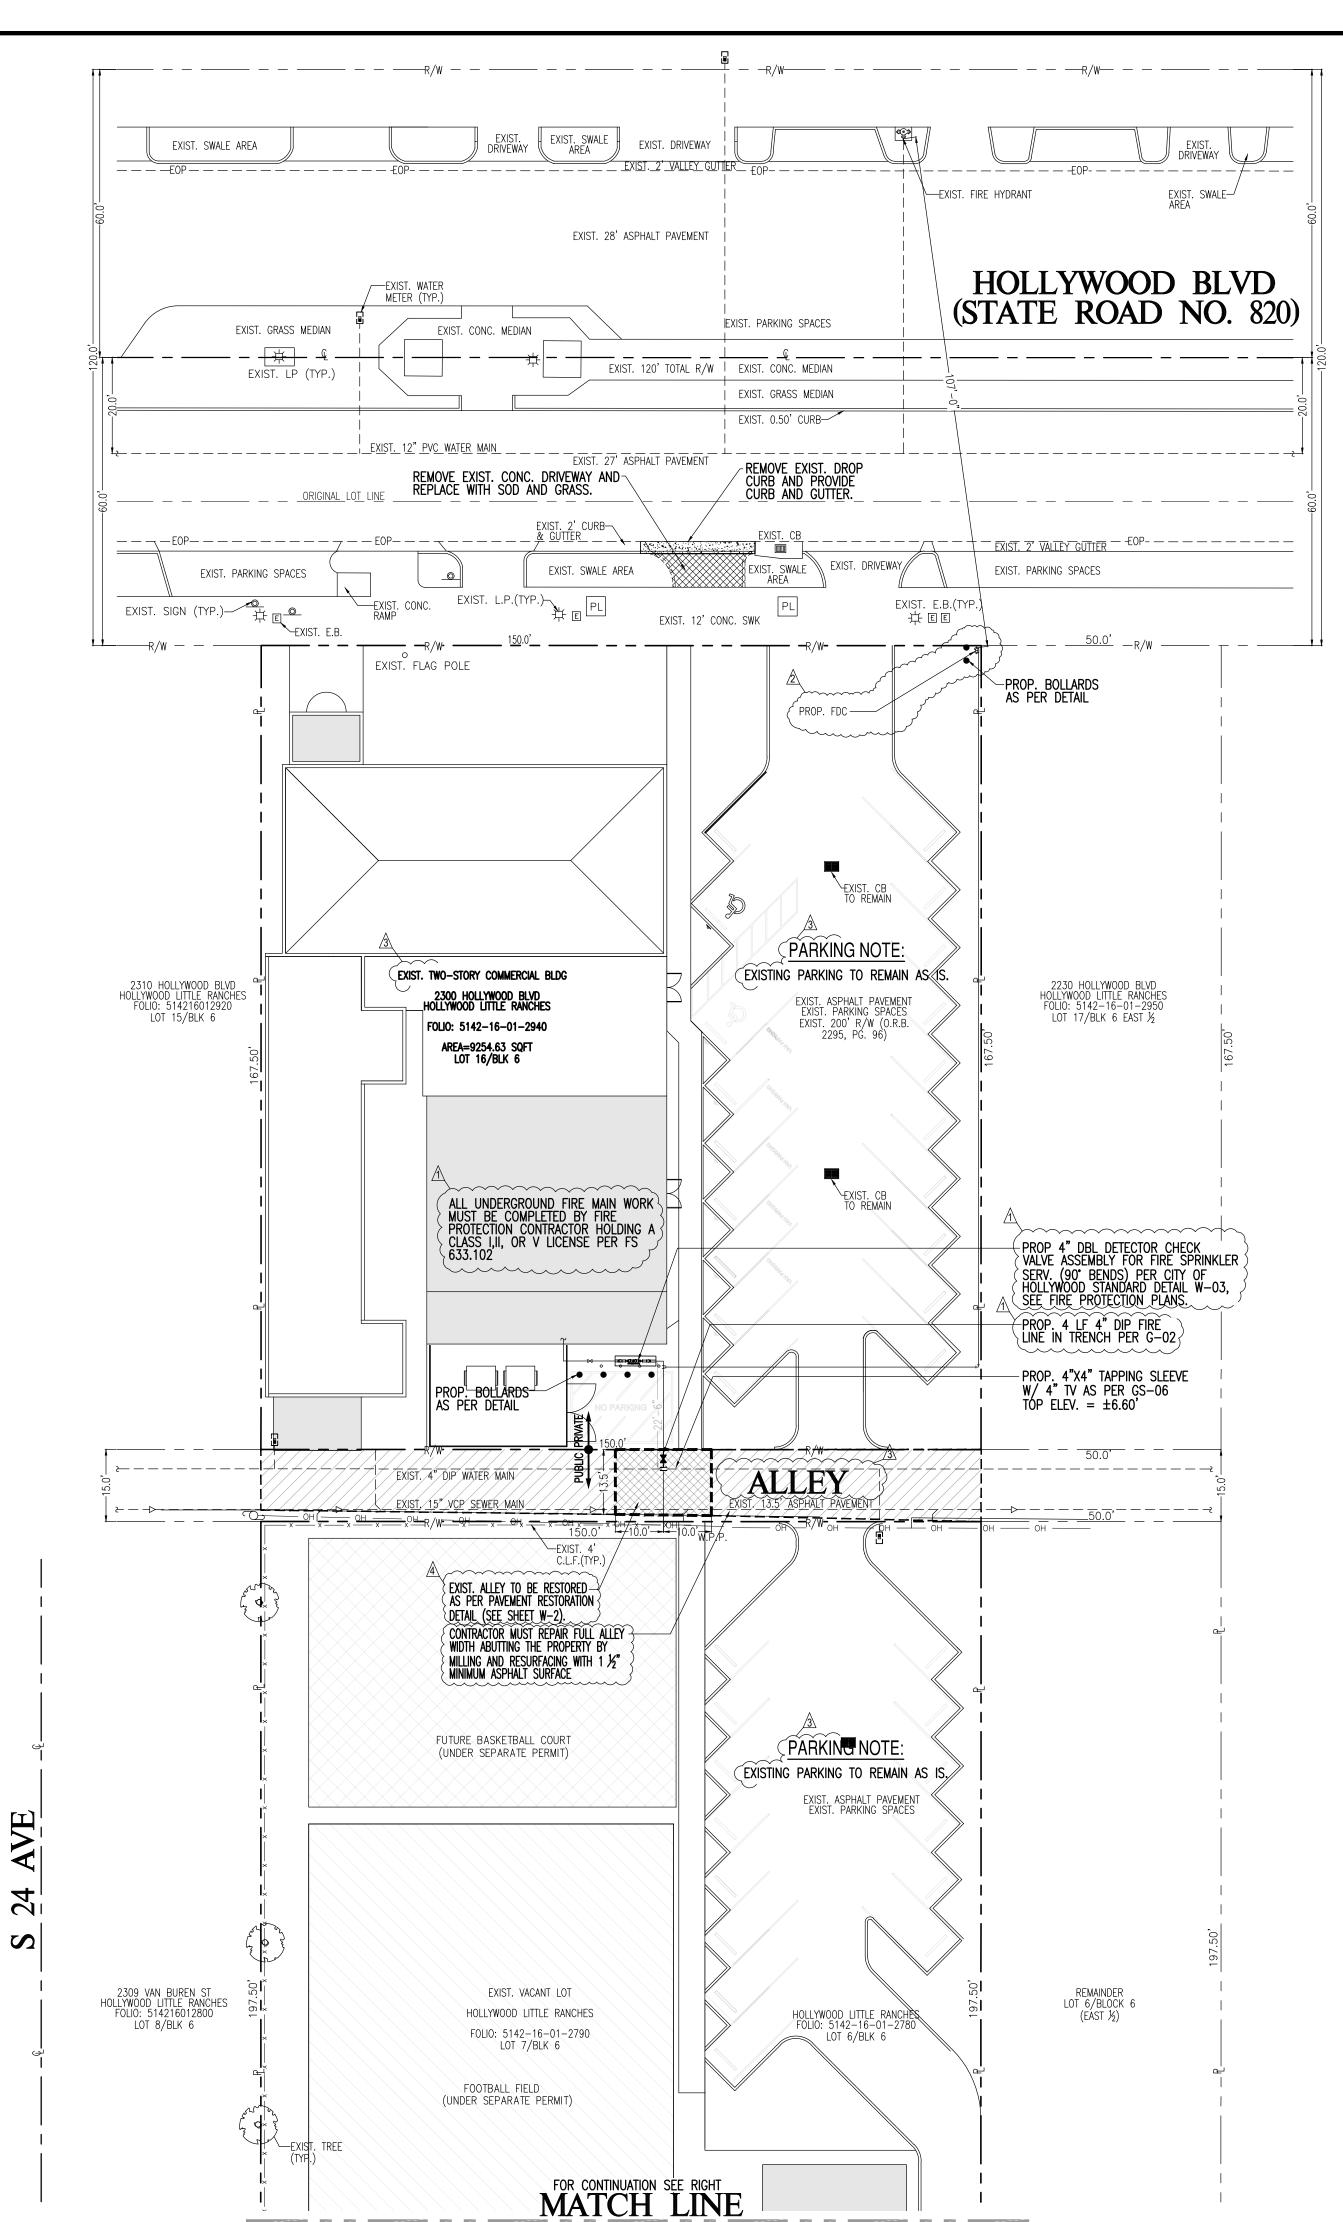ENGINEER'S NOTES:

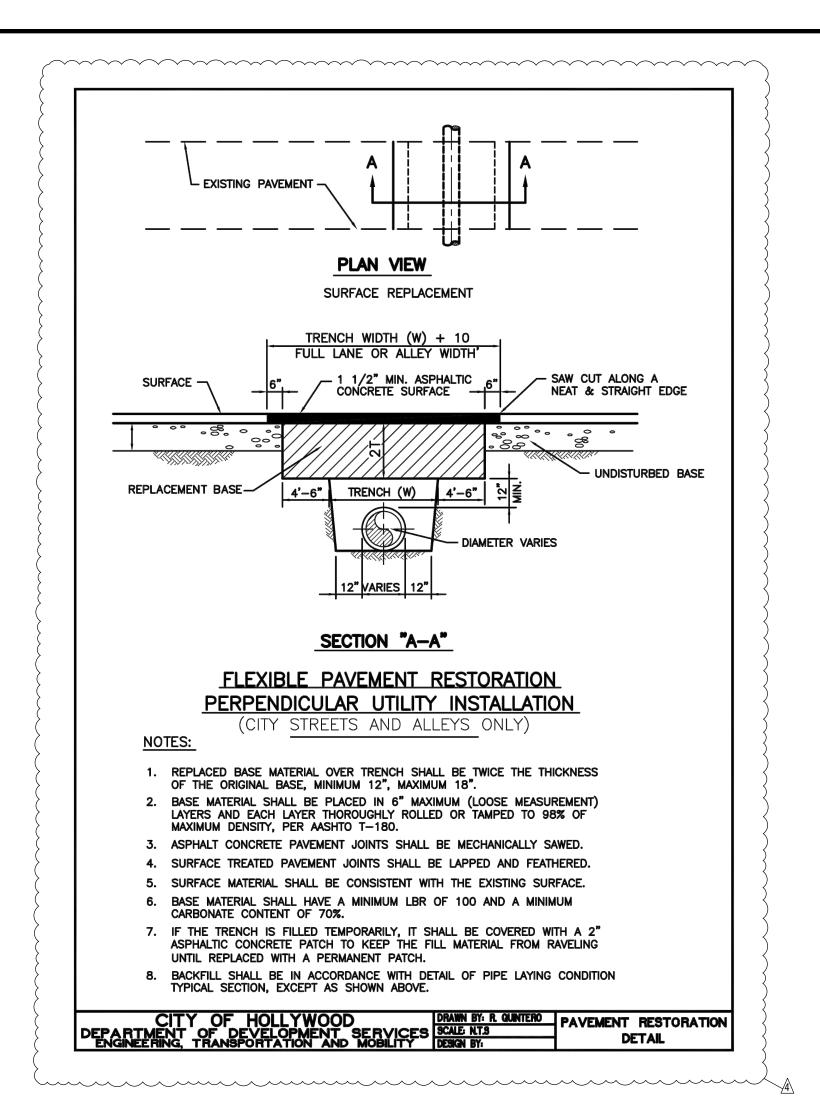- 1. SURVEY OBTAINED FROM VIZCAYA SURVEYING AND MAPPING, INC (FLORIDA CERTIFICATE OF AUTHORIZATION # LB 8000)
- 2. ALL UNDERGROUND INFORMATION SHALL BE VERIFIED WITH THE DIFFERENT UTILITY COMPANIES BEFORE THE START OF ANY CONSTRUCTION OR EXCAVATION, NEITHER THE ENGINEER OR OWNER/DEVELOPER SHALL BE RESPONSIBLE FOR THIS ITEM. SHOULD FIELD DIFFER CONTACT ENGINEER IMMEDIATELY.
- 3. ALL WORK SHALL BE DONE IN ACCORDANCE WITH THE CITY OF HOLLYWOOD DEPARTMENT OF PUBLIC UTILITIES ENGINEERING AND CONSTRUCTION SERVICES STANDARDS AND
- 4. ALL UNDERGROUND INSTALLATIONS SHALL BE PROTECTED AT ALL TIMES DURING CONSTRUCTION AND EXCAVATION.
- 5. FOR PAVEMENT RESTORATION REFER TO CITY OF HOLLYWOOD AND BROWARD COUNTY PUBLIC WORKS STANDARDS AND SPECIFICATIONS (PER G-12 & G-12.1). CONTRACTOR TO RESTORE EXISTING PAVEMENT AND SWALE AREAS DISTURBED DURING CONSTRUCTION TO ORIGINAL CONDITIONS.
- 6. NO EXTERIOR WORK IS PROPOSED EXPECT FOR THE FIRE LINE.
- FOR MARKING AND SIGNAGE INFORMATION, SEE SHEET C-2

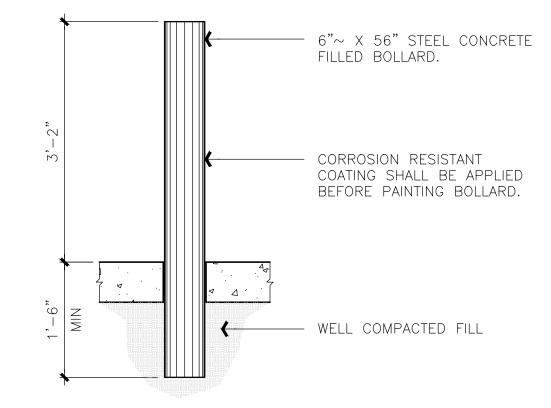

BOLLARD DETAIL 3/4"

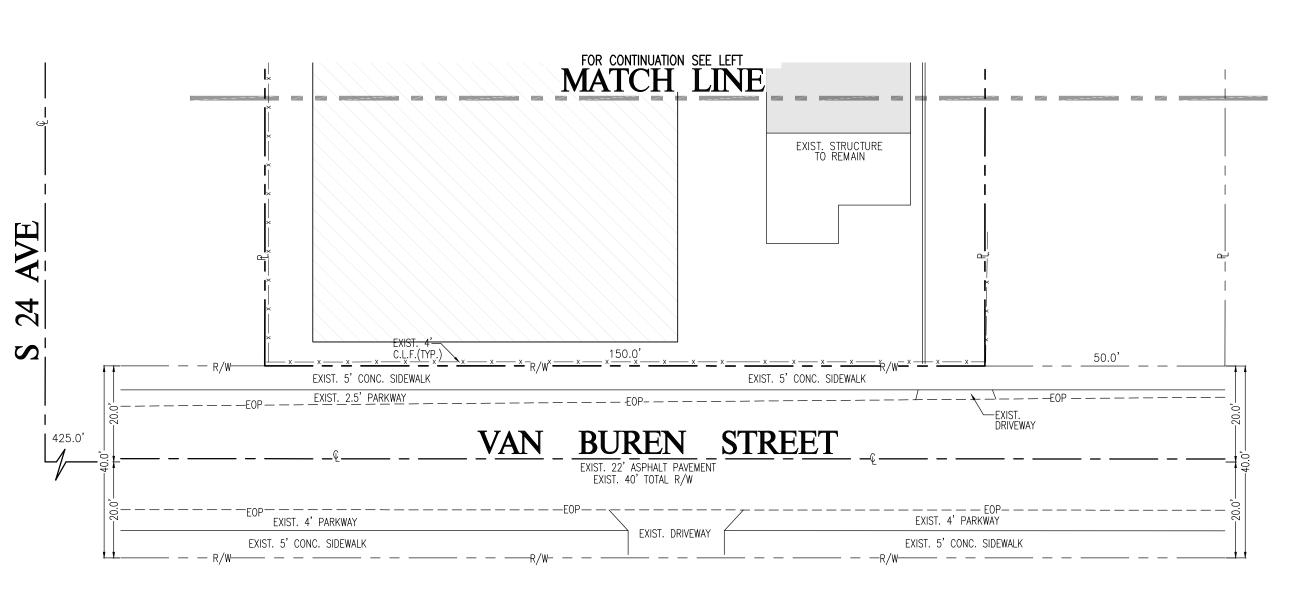



CARLAB, INC ENGINEER AND PLANNERS

CERTIFICATE OF AUTHORIZATION 6419 8730 S.W. 25 STREET, MIAMI, FL 33165 TEL: 786 385.4093 | FAX: 305 226-0438 E-MAIL: SLABISTE@CARLABINC.COM

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WORKSHIP ELIGIOU

REVISIONS CITY OF HOLLYWOOD 01/10/23 A.M CITY OF HOLLYWOOD 03/14/23 R.M CITY OF HOLLYWOOD 06/09/23 R.M CITY OF HOLLYWOOD 01/30/24 A.M.C CARLAB, INC PROJECT NUMBE

22-1924 CHECKED DESIGNED A.M.G. AS SHOWN SCALE

THIS ITEM HAS BEEN DIGITALLY SIGNED AND SEALED BY SE C. LABISTE, P.E. ON THE DATE ADJACENT TO THE SEAL. PRINTED COPIES OF THIS DOCUMENT ARE NOT CONSIDERED SIGNED AND SEALED AND THE SIGNATURE MUST BE VERIFIED CANY ELECTRONIC COPIES.



SERGIO C. LABISTE P.E. # 61733

PROPOSED FIRE LINE CONNECTION PLAN

EET NUMBER W-2

Sunshine 811

Call 811 or visit sunshine811.com two full business days before digging to have buried facilities located and marked.

Check positive response codes before you dig!

MR. ARCHITECT, LLC

AA 26002308

MIGUEL RIONDA, ARCHITECT AR 94189 15125 NE 9th CT

15125 NE 9th CT
North Miami Beach, FL 33162
305-527-8815
info@mr-architect.com

ARCHITECT

GENERAL OUTLINE SPECIFICATIONSPART 1.0 - GENERAL

THE FOLLOWING OUTLINE SPECIFICATIONS ARE INTENDED TO PROVIDE MATERIALS AND SYSTEMS TO COMPLY WITH ARCHITECT DESIGN INTENT. THESE SPECIFICATIONS ARE FOR GENERAL GUIDELINE PURPOSES FOR THE PROJECT AND BY NO MEANS ARE TO BE CONSIDERED COMPLETE SPECIFICATIONS FOR ALL REQUIRED MATERIALS FOR THIS PROJECT. THE ITEMS LISTED BELOW REPRESENT ONLY THE BASIC REQUIREMENTS AND THE MATERIALS THAT THE ARCHITECT HAS SELECTED. THE CONTRACTOR SHALL REVIEW THE REQUIREMENTS OF THE GUIDELINE AND PROVIDE MATERIALS AND ANY OTHER REQUIRED ACCESSORY OR SERVICE TO PROVIDE A COMPLETE SYSTEM OR PRODUCT FOR THE INTENDED USES. ALL MATERIAL AND WORKMANSHIP FOR EACH MATERIAL IN THIS PROJECT SHALL BE AS RECOMMENDED BY THE MANUFACTURE OF THE PRODUCT AND/OR ANY INDUSTRY CODE OR STANDARD THAT MAY APPLY.

UNLESS DIRECTED OTHERWISE BY THESE DRAWINGS, ALL OTHER ELEMENTS INCLUDING, COLUMNS, WALLS, EQUIPMENT, ELECTRICAL OUTLETS, MECHANICAL VENTS, AND FIXTURES ARE EXISTING TO REMAIN. UNIT COMPLIES WITH ALL CODE REQUIREMENTS, ALL NECESSARY LIFE SAFETY EQUIPMENT IS EXISTING AND FUNCTIONING. THESE ITEMS ARE BEING OMITTED FROM THESE DRAWINGS AND ARE NOT BEING AFFECTED BY THE SCOPE OF WORK IN THIS PROJECT. THESE ITEMS MAY BE ADDRESSED BY THE INSPECTORS AT THE TIME OF INSPECTIONS.

CONTRACTOR AGREES THAT HE WILL HOLD OWNER, ARCHITECT, ENGINEERS AND/OR ANY OF THEIR EMPLOYEES OR AGENTS, HARMLESS FROM ANY AND ALL DAMAGE AND CLAIMS WHICH MAY ARISE BY REASON OF ANY NEGLIGENCE ON THE PART OF THE CONTRACTOR, OR ANY OF HIS SUBCONTRACTORS, OR ANY MATERIAL AND EQUIPMENT SUPPLIERS, AND/OR ANY OF THEIR EMPLOYEES OR AGENTS, IN THE PERFORMANCE OF THIS CONTRACT.

IN CASE ANY ACTION IS BROUGHT AGAINST THE OWNER, OR ARCHITECT, OR ENGINEER, OR ANY OF THEIR EMPLOYEES OR AGENTS, CONTRACTOR SHALL ASSUME FULL RESPONSIBILITY FOR DEFENSE THEREOF, TO THE FULL SATISFACTION OF THE LATTER PARTY.

THE CONTRACTOR SHALL PERFORM THE WORK IN COMPLIANCE WITH THESE DOCUMENTS AND THE REQUIREMENTS SET FORTH IN ALL APPLICABLE CODES AND REGULATIONS.

THE CONTRACTOR SHALL EXAMINE ALL EXISTING CONDITIONS AND REVIEW THESE DRAWINGS AND ANY OTHER RELATED DOCUMENTS AND/OR SHOP DRAWINGS AND REPORT TO ARCHITECT ANY DISCREPANCIES PRIOR TO THE COMMENCEMENT OF THE WORK.

THE CONTRACTOR SHALL SUPPLY, LOCATE AND BUILD INTO WORK ALL INSERTS, ANCHORS, SLEEVES, OPENINGS, AND DEPRESSIONS AND PITCHES AS REQUIRED TO ACCOMMODATE WORK.

THE CONTRACTOR SHALL COORDINATE WITH THE OWNER ANY SPECIFIC ARRANGEMENTS AS NEEDED DURING DEMOLITION AND CONSTRUCTION.

ALL HARDWARE, BATHROOM & LIGHTING FIXTURES, CASEWORK, AND FINISH MATERIALS SPECIFICATIONS OMITTED IN THESE DRAWINGS ARE SUBJECT TO THE OWNER'S SELECTION.

THE CONTRACTOR SHALL MAKE AND HIGHLIGHT THE PROPER ALLOWANCES, AND COORDINATE WITH THE OWNER FOR PURCHASING AND DELIVERY.

THE CONTRACTOR MUST ENSURE TO PROTECT AND MAINTAIN ACTIVE ALL LIFE SAFETY FIXTURES AND APPLIANCES DURING AND AFTER CONSTRUCTION.

INTERIOR FINISHES

ALL INTERIOR WALL AND CEILING FINISHES SHALL BE CLASS 'A' OR 'B', FLAME SPREAD INDEX 0-25 FOR 'A' FINISHES, 26-75 FOR 'B' FINISHES, SMOKE DEVELOPED INDEX 0-450 AS PER NFPA ANNEX A 10.2.2.

ASSEMBLY AREAS: INTERIOR WALL AND CEILING FINISHES SHALL BE CLASS 'A', 'B', OR 'C' FOR 300 OR FEWER.

PROJECTION SCREENS MUST BE CLASS 'A' OR 'B'.

INTERIOR FLOOR FINISH IN EXIT ENCLOSURES AND EXIT ACCESS CORRIDORS SHALL NOT BE LESS THAN CLASS II.

INSULATION IN CONCEALED SPACES SHALL BEAR FLAME SPREAD RATING OF NOT MORE THAN 25 AND SMOKE DEVELOPED INDEX OF NOT MORE THAN 450. CELULOSE LOOSE-FILL INSULATION SHALL MEET ONLY SMOKE DEVELOPEDINDEX OF NOT MORE THAN 450.

ADDRESS

2300 HOLLYWOOD BOULEVARD HOLLYWOOD, FL 33020

LEGAL DESCRIPTION

HOLLYWOOD LITTLE RANCHES 1-26 B LOT 16 LESS ST & LESS ALLEY, LOT 17 W1/2 LESS ST & LESS ALLEYBLK 6

PRIOR OCCUPANCY:

LAST KNOWN: ASSEMBLY GROUP A-3
PLACE OF RELIGIOUS WORSHIP AND EDUCATION

OCCUPANCY:

ASSEMBLY GROUP A-3 WITH INCIDENTAL CLASSROOMS.

CERTIFICATE OF USE:

CERTIFICATE OF USE HAS BEEN FILED AND ISSUED AS 'PLACE OF WORSHIP' AND RELIGIOUS SUNDAY SCHOOL.

HAZARD CONTENTS CLASSIFICATION:

ORDINARY CONTENTS

SCOPE OF WORK

- BATHROOMS TO BE RECONFIGURED.
 BATHROOMS TO BE MADE ADA COMPLIAN
- SOME DEMOLITION OF INTERIOR WALLS. CLOSURE OF EXTERIOR WALLS.
- NEW ELECTRICAL AND LIGHTING.

 NEW MECHANICAL AC WORK
- NEW MECHANICAL AC WORK.
 PLUMBING WORK FOR REWORKED BATHROOM
- NEW ACOUSTICAL DROPPED CEILINGS.
- NEW LIFE SAFETY DEVICES

FIRE ALARM/FIRE SPRINKLER:

FIRE ALARM SYSTEM TO BE INSTALLED.
FIRE SPRINKLER SYSTEM TO BE INSTALLED.
SHOP DRAWINGS TO BE SUBMITTED AND APPROVED BY E.O.R. PRIOR TO INSTALLATION

APPLICABLE CODES:

FLORIDA BUILDING CODE EXISTING, 2020, 7th EDITION FLORIDA BUILDING CODE, 2020, 7th EDITION NFPA 70, NATIONAL ELECTRICAL CODE (NEC 2017) NFPA 1, FIRE CODE (2018) NFPA 101, NATIONAL LIFE SAFETY CODE (2018) FLORIDA FIRE PREVENTION CODE, 7th EDITION

ALTERATION LEVEL:

WORK TO BE PERFORMED IN EXISTING TO BE CLASSIFIED AS A LEVEL 2 ALTERATION AS DEFINED BY 2020 FBC(E) CHAPTER 5. LEVEL 2 ALTERATIONS SHALL COMPLY WITH THE PROVISIONS OF CHAPTER 8 FOR LEVEL 2.

DEMOLITION NOTES:

THE CONTRACTOR SHALL EXAMINE ALL EXISTING CONDITIONS AND REVIEW THESE DRAWINGS AND ANY OTHER RELATED DOCUMENTS AND/OR SHOP DRAWINGS AND REPORT TO ARCHITECT ANY DISCREPANCIES PRIOR TO THE COMMENCEMENT OF THE WORK

THE CONTRACTOR SHALL COORDINATE WITH THE OWNER ANY SPECIFIC ARRANGEMENTS AS NEEDED DURING DEMOLITION.

THE CONTRACTOR SHALL PROVIDE ALL OF THE NECESSARY RESOURCES INCLUDING LABOR, MATERIALS, EQUIPMENT, ETC. FOR THE COMPLETION OF ALL DEMOLITION WORK AS INDICATED OR IMPLIED BY THE DRAWINGS.

THE CONTRACTOR SHALL CONFIRM WITH THE OWNER TO DEMOLISH, REMOVE AND DISPOSE OF ALL ITEMS AND MATERIALS INDICATED OR IMPLIED BY THE DRAWINGS UNLESS OTHERWISE DIRECTED BY THE OWNER.

THE CONTRACTOR SHALL WORK IN A MANNER REQUIRED TO PROTECT EXISTING AREAS WHICH ARE NOT PART OF THE WORK. THE DEMOLITION CONTRACTOR SHALL COORDINATE ALL WORK WITH THE OWNER PRIOR TO COMMENCEMENT.

THE CONTRACTOR SHALL VERIFY THE LOCATION OF UTILITIES DURING THE DEMOLITION WORK AND SHALL INSURE THAT UTILITIES ARE PROTECTED FROM DAMAGE.

NO UTILITY SHALL BE DISCONNECTED WITHOUT CONSENT FROM THE OWNER OR ITS

AUTHORIZED REPRESENTATIVE OR THE BUILDING ASSOCIATION.

THE CONTRACTOR SHALL COMPLY WITH ALL PROTOCOLS AS DETERMINED BY THE AHJ.

CONDUCT REMOVAL OPERATIONS OF DEBRIS TO MAINTAIN TRAFFIC ALONG EXISTING HALLWAYS, WALKWAYS, AND PUBLIC AREAS. KEEP COMMON AREAS AND SIDEWALKS FREE OF DEBRIS. REMOVE MATERIAL AND OTHER MATTER TRACKED OR FALLEN ONTO TRAFFIC SURFACES IMMEDIATELY.

THE CONTRACTOR SHALL BE RESPONSIBLE FOR ALL MATERIALS, DEBRIS, AND DUST RESULTING FROM DEMOLITION. DISPOSE OF DEBRIS LEGALLY ON OR OFF SITE. USE APPROVED METHODS.

PROJECT: OHR HATORAH SYNAGOGUE

OPERATION SCHEDULE:

UNDER CURRENT SUNDAY SCHOOL CERTIFICATE OF USE, OPERATION OF BUILDING WILL BE: SUNDAYS: 9:00 AM - 1:00 PM.
TUESDAYS AND THURSDAY 4:00 PM - 7:00 PM.

RELIGIOUS SUNDAY SCHOOL CONFIRMATION CLASSES TUESDAYS AND THURSDAYS

BUILDING & LOT Address: 2300 Hollywood Blvd City: Hollywood Zip: 33020 County: Broward Parcel ID: 514216012940 Lot Area - Public Records: 25,163 ft² Existing Building Area: 13,195 ft² Year Built: 1967 Number of Buildings: Legal Description: HOLLYWOOD LITTLE RANCHES 126 B LOT 16 LESS ST & LESS ALLEY, LOT 17 W1/2 LESS ST & LESS ALLEY BLK 6

BASIC ZONING	
Municipal Future Land Use:	Regional Activity Center (RAC)
Zone:	RC-1
Existing Building Use:	Religious, Church, Worship (Synagogue, Temple, Parsonage)
Existing Land Use:	Civic
County Future Land Use:	Regional Activity Center
Allowed Use(s) - Primary:	Residential(2), Lodging(1), Office(1), Commercial(14), Civic(4), Educational(3), Industrial(3)
Allowed Use(s) - Accessory:	ilidastriai(o)

BUILDING INTENSITY N/A Maximum Lot Coverage: 75 ft Maximum Building Height: Maximum Height - Stories: 2.75 Floor Area Ratio: Maximum Built Area Allowed: 69,198 ft2 Maximum Building Footprint: 23,015 ft² Minimum Open Space: Maximum Residential Area Allowed: 69,198 ft² Estimated Residential Units Allowed: Unlimited 69,198 ft² Maximum Lodging Area Allowed: **Estimated Lodging Rooms Allowed:** Unlimited 69,198 ft² Maximum Commercial Area Allowed: 69,198 ft² Maximum Office Area Allowed:

SETBACKS AT GROUND LEVEL	
Minimum Primary Frontage Setback:	5.00 ft
Maximum Primary Frontage Setback:	25.00 ft
Minimum Secondary Frontage Setback:	10.00 ft
Minimum Side Setback:	0 ft
Minimum Rear Setback:	N/A
Minimum Water Setback:	N/A






Sheet List										
Sheet Number	Sheet Name	Sheet Issue Date	Drawn By	Checked By	Current Revision	Current Revision Description	Current Revision Date			
A0	Cover	05/04/22	MR	MR	5	Revision 5	3/14/23			
A0.0	Demolition Plan	05/04/22	MR	DZ	2	Revision 2	10/12/22			
A0.1	Area Plans	05/04/22	MR	MR	5	Revision 5	3/14/23			
A0.1.1	Gross Building Lot Coverage	10/13/22	MR	MR						
A0.2	Life Safety Plan	05/04/22	MR	MR	6	Revision 6	3/28/23			
A0.2.1	Fire Protection Plan	03/14/23	MRA	MR	6	Revision 6	3/28/23			
A0.3	Site Plan	05/24/22	MR	MR	1	Revision 1	9/7/22			
A0.3.1	Parking Details	09/06/22	MR	MR	1	Revision 1	9/7/22			
A1	Floor Plan	05/04/22	MR	DZ	6	Revision 6	3/28/23			
A1.1	Bathroom Details	05/04/22	MRA	MR	1	Revision 1	9/7/22			
A2	Reflected Ceiling Plan	05/04/22	MR	DZ						
A3	ADA Sheet	05/04/22	MR	MR						
A4	Wall Types Sheet	05/04/22	MRA	MR	4	Revision 4	02/23/23			
E-1.0	Electrical Floor Plan	05/04/22	PCE	MR						
E-2.0	Electrical Lighting Plan	05/04/22	PCE	MR						
E-3.0	Electrical Second Floor Plan	05/04/22	PCE	MR	4	Revision 4	02/23/23			
E-4.0	Electrical Roof Plan	05/04/22	PCE	MR						
E-5.0	Electrical Panels and Risers	05/04/22	PCE	MR						
E-6.0	Electrical Notes and Legend	05/04/22	PCE	MR	4	Revision 4	02/23/23			
M-0.0	Mechanical Notes	05/04/22	PCE	MR						
M-1.0	Mechanical Floor Plan	05/04/22	PCE	MR						
M-2.0	Mechanical Roof Plan	05/04/22	PCE	MR						
M-3.0	Mechanical Details	05/04/22	PCE	MR						
P-0.0	Plumbing Notes and Details	05/04/22	PCE	MR						
P-1.0	Plumbing Domestic Water	05/04/22	PCE	MR						
P-2.0	Plumbing Sanitary Sewer	05/04/22	PCE	MR						
FA-01	First Floor and Second Floor	9/19/22	R.S.	R.S.						
FA-02	Roof Level Riser Diagram	9/19/22	R.S.	R.S.						
FA-03	Battery Calculation	9/19/22	R.S.	R.S.						
FA-04	General Notes	9/19/22	R.S.	R.S.						
W-1	Civil Cover Sheet and Notes	11/14/22	D.C.	D.C.	2	Revision 2	03/14/23			
W-2	Fire Sprinkler Plans - 1st 2nd Floors	11/14/22	D.C.	D.C.	2	Revision 2	03/14/23			







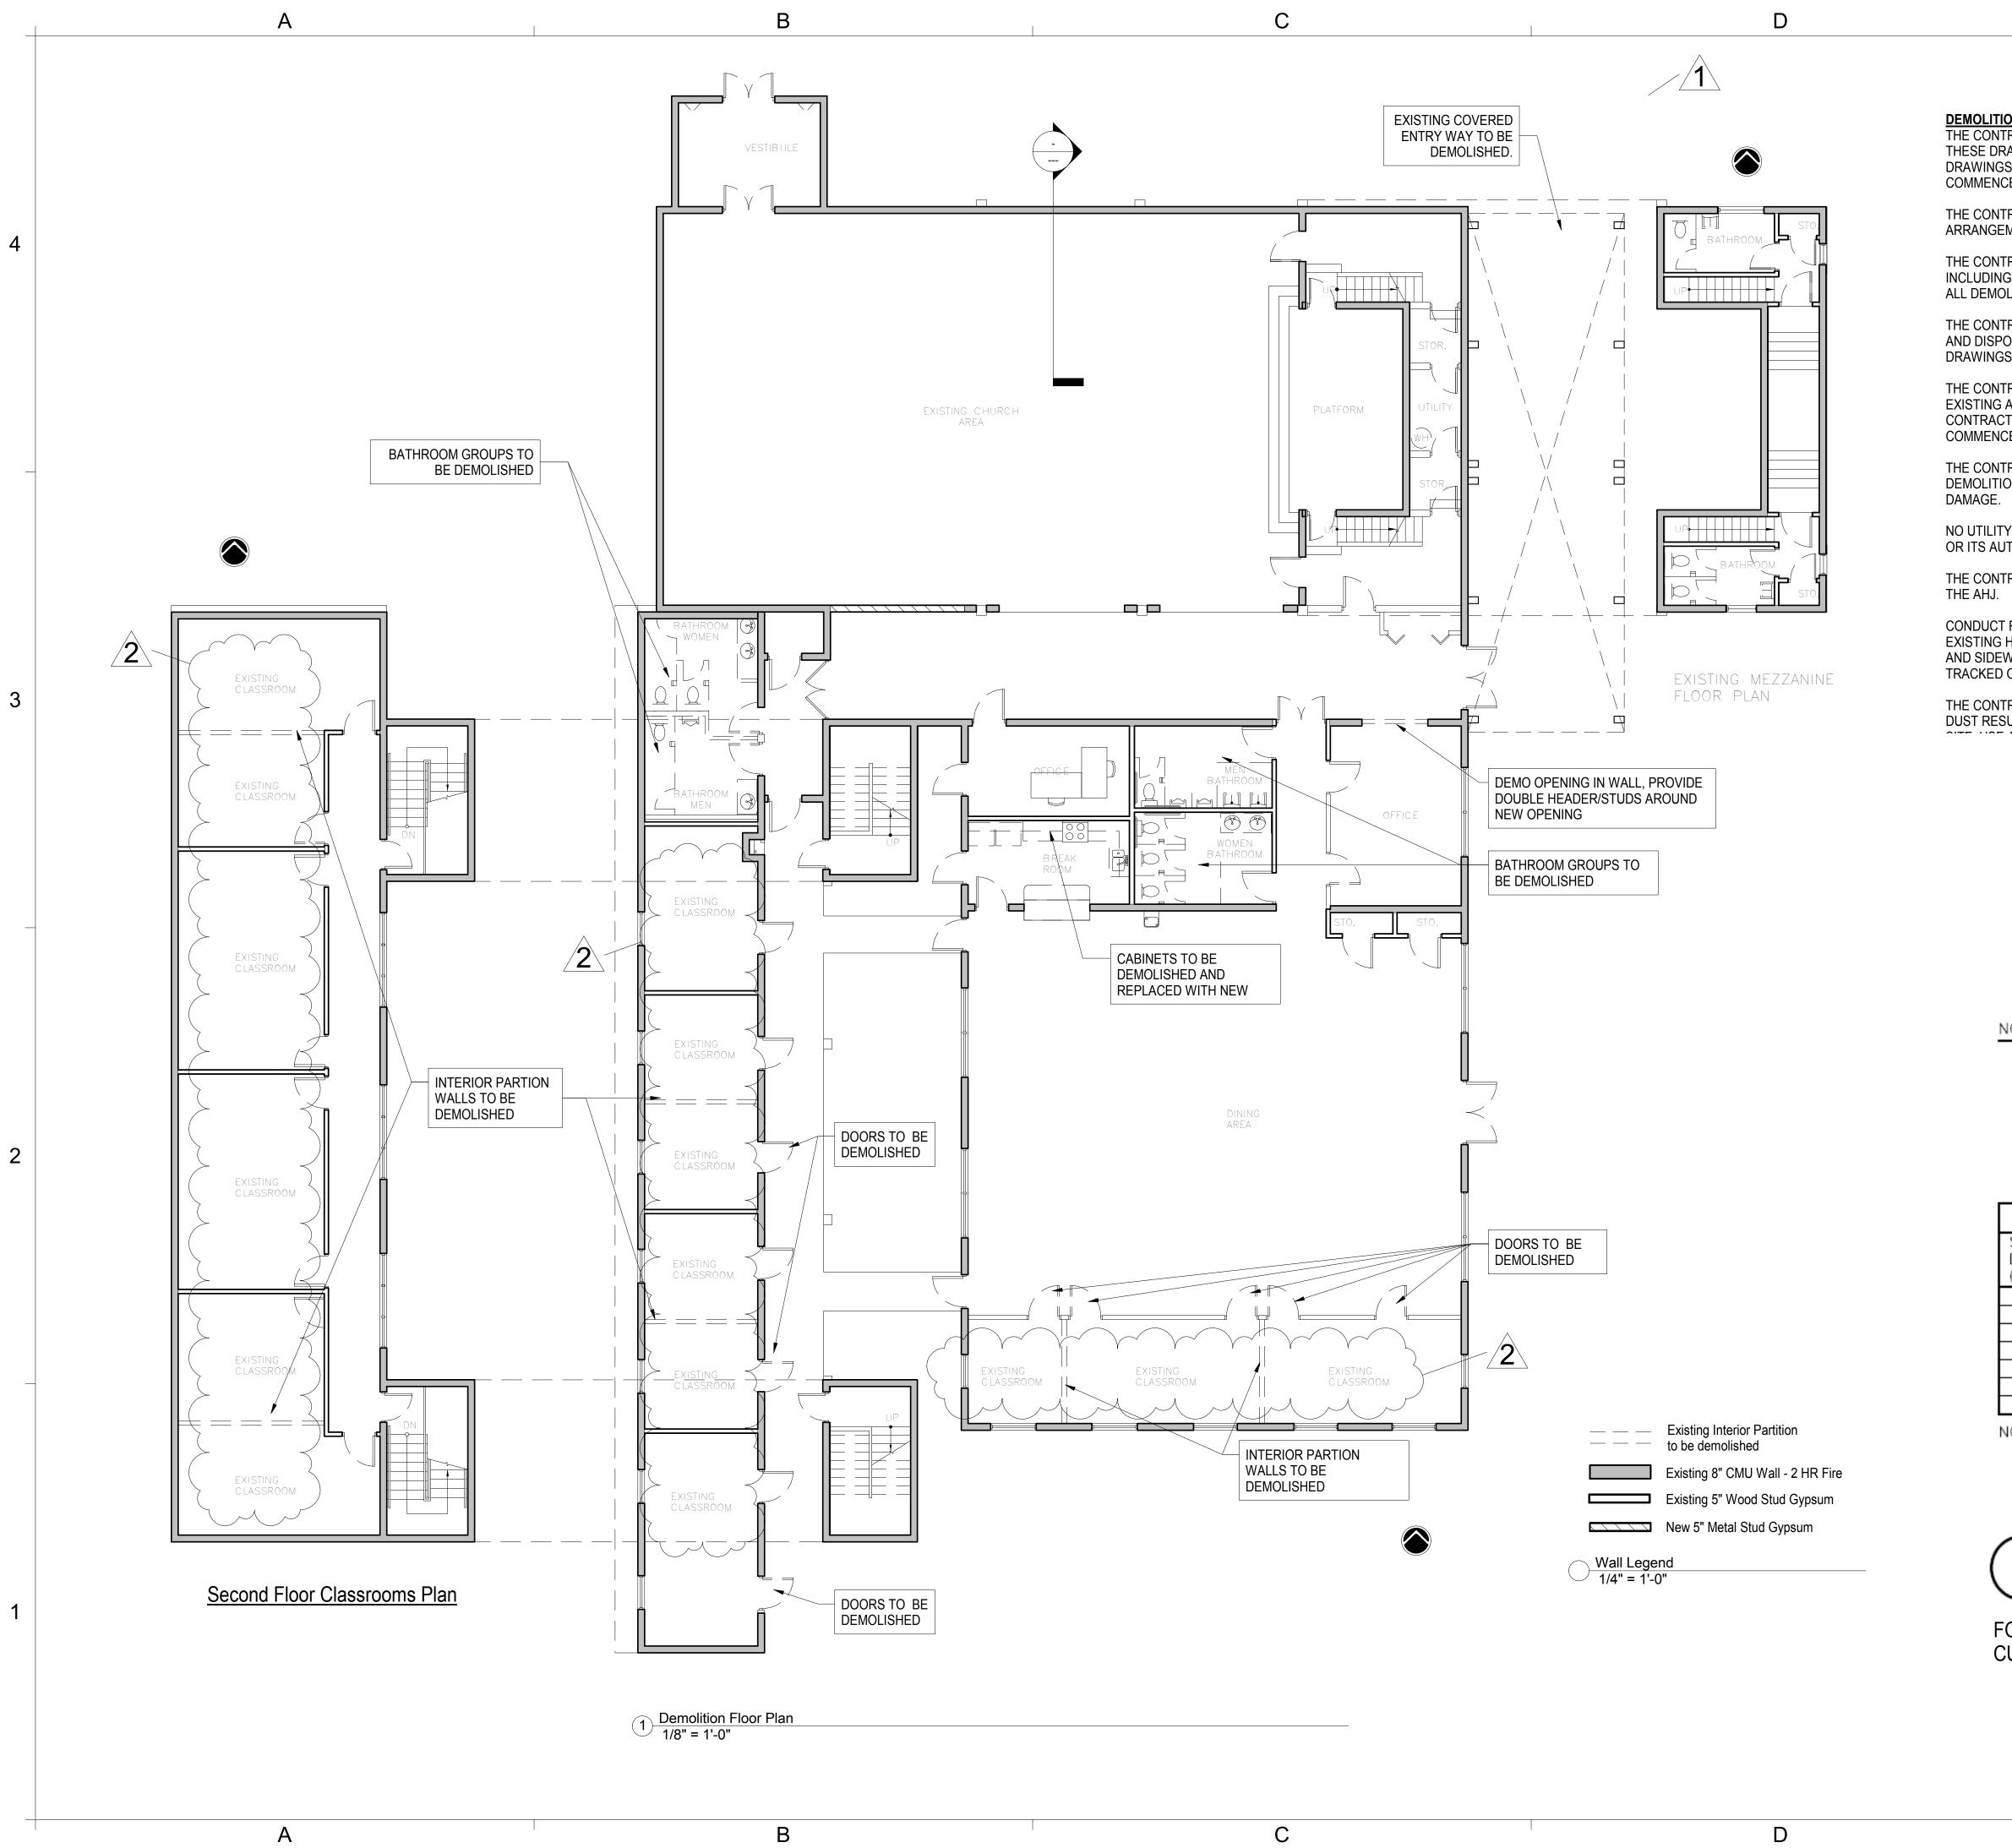

DEMOLITION NOTES:

THE CONTRACTOR SHALL EXAMINE ALL EXISTING CONDITIONS AND REVIEW THESE DRAWINGS AND ANY OTHER RELATED DOCUMENTS AND/OR SHOP DRAWINGS AND REPORT TO ARCHITECT ANY DISCREPANCIES PRIOR TO THE COMMENCEMENT OF THE WORK.

THE CONTRACTOR SHALL COORDINATE WITH THE OWNER ANY SPECIFIC ARRANGEMENTS AS NEEDED DURING DEMOLITION.

THE CONTRACTOR SHALL PROVIDE ALL OF THE NECESSARY RESOURCES INCLUDING LABOR, MATERIALS, EQUIPMENT, ETC. FOR THE COMPLETION OF ALL DEMOLITION WORK AS INDICATED OR IMPLIED BY THE DRAWINGS.

THE CONTRACTOR SHALL CONFIRM WITH THE OWNER TO DEMOLISH, REMOVE AND DISPOSE OF ALL ITEMS AND MATERIALS INDICATED OR IMPLIED BY THE DRAWINGS UNLESS OTHERWISE DIRECTED BY THE OWNER.

THE CONTRACTOR SHALL WORK IN A MANNER REQUIRED TO PROTECT EXISTING AREAS WHICH ARE NOT PART OF THE WORK. THE DEMOLITION CONTRACTOR SHALL COORDINATE ALL WORK WITH THE OWNER PRIOR TO COMMENCEMENT.


THE CONTRACTOR SHALL VERIFY THE LOCATION OF UTILITIES DURING THE DEMOLITION WORK AND SHALL INSURE THAT UTILITIES ARE PROTECTED FROM

NO UTILITY SHALL BE DISCONNECTED WITHOUT CONSENT FROM THE OWNER OR ITS AUTHORIZED REPRESENTATIVE OR THE BUILDING ASSOCIATION.

THE CONTRACTOR SHALL COMPLY WITH ALL PROTOCOLS AS DETERMINED BY

CONDUCT REMOVAL OPERATIONS OF DEBRIS TO MAINTAIN TRAFFIC ALONG EXISTING HALLWAYS, WALKWAYS, AND PUBLIC AREAS. KEEP COMMON AREAS AND SIDEWALKS FREE OF DEBRIS. REMOVE MATERIAL AND OTHER MATTER TRACKED OR FALLEN ONTO TRAFFIC SURFACES IMMEDIATELY.

THE CONTRACTOR SHALL BE RESPONSIBLE FOR ALL MATERIALS, DEBRIS, AND DUST RESULTING FROM DEMOLITION. DISPOSE OF DEBRIS LEGALLY ON OR OFF

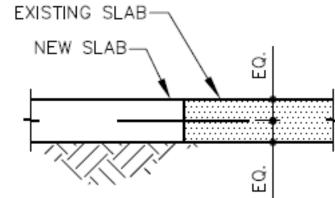

- 1. USE SIMPSON HIT HY 150 2-PART EPOXY, OR EQUIVALENT. FOR BAR SIZE AND SPACING SEE SCHEDULE BELOW.
- 2. USE SMOOTH DWL W/ PROJECTED END COATED TO PRÉVENT BOND.
- 3. SLAB REINF NOT SHOWN FOR CLARITY.

SMC	SMOOTH DOWEL SCHEDULE										
SLAB DEPTH (IN)	DIAMETER (IN)	TOTAL LENGTH (IN)	SPACING C TO C (IN)								
4	1/2	12	12								
5	5/8	12	12								
6	3/4	14	12								
7	7/8	14	12								
8	1	14	12								
9	11/8	16	12								
10	11/4	16	12								

NOTE: DWLS SHALL BE CUT TO LENGTH NOT SHEARED. GRIND ANY BURRS SMOOTH FROM PROJECTED END.

SLAB REPAIR (DOWELLED)



FOR REPAIRS TO CONCRETE SLAB AFTER CUTTING FOR PLUMBING SANITARY LINES



ARCHITECT OF MR. ARCHITECT, LLC AA 26002308 MIGUEL RIONDA LIC. # AR 94189 15125 NE 9th CT NORTH MIAMI BEACH, FLORIDA 33162 o: 786.696.4276 info@mr-architect.com

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SIGN AND

ADDRESS:

2300 Hollywood Blvd. Hollywood, FL 33020

PROJECT:

SYNAGOGUE

TENANT:

2

OHR HATORAH

SHEET TITLE:

Demolition Plan

No.	Description	Date
1	Revision 1	9/7/22
2	Revision 2	10/12/22


Project Number: 10_2022 05/04/22 Date

MR Drawn By: DΖ

Checked By: Scale:

As indicated

A0.0

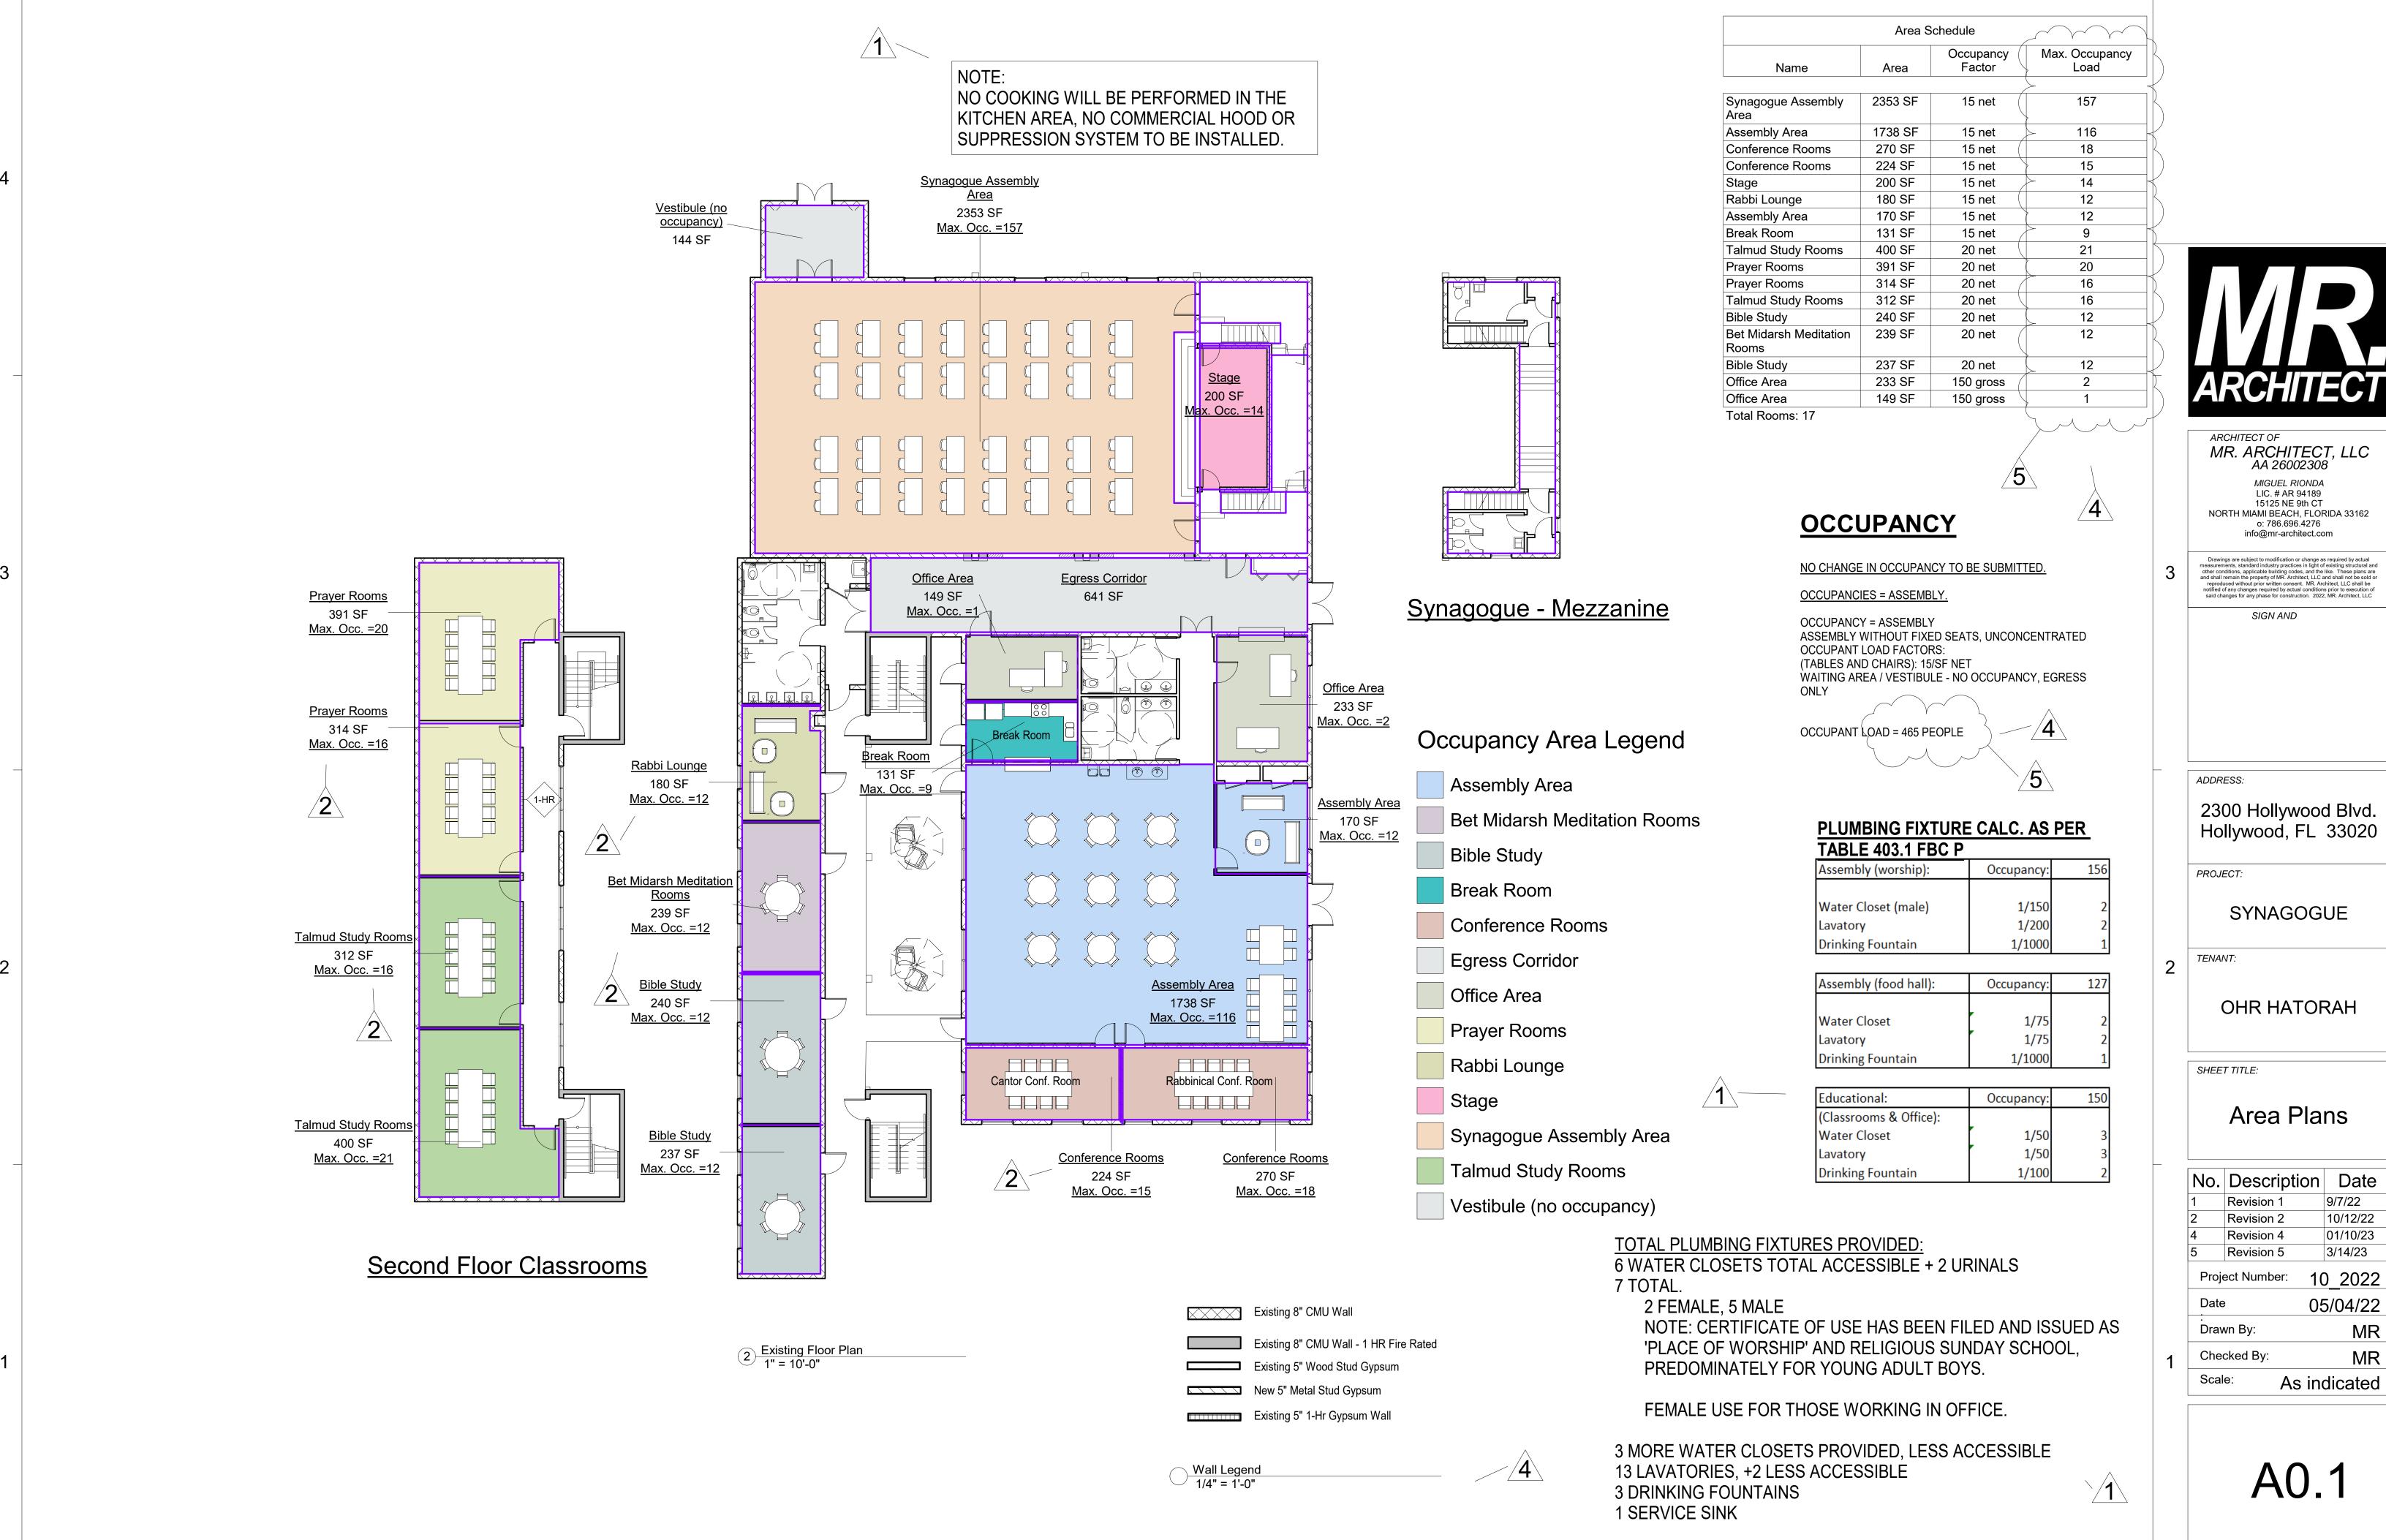


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2300 Hollywood Blvd. Hollywood, FL 33020

No.	Description	Date
1	Revision 1	9/7/22
2	Revision 2	10/12/22
4	Revision 4	01/10/23
5	Revision 5	3/14/23

10_2022 05/04/22 MR



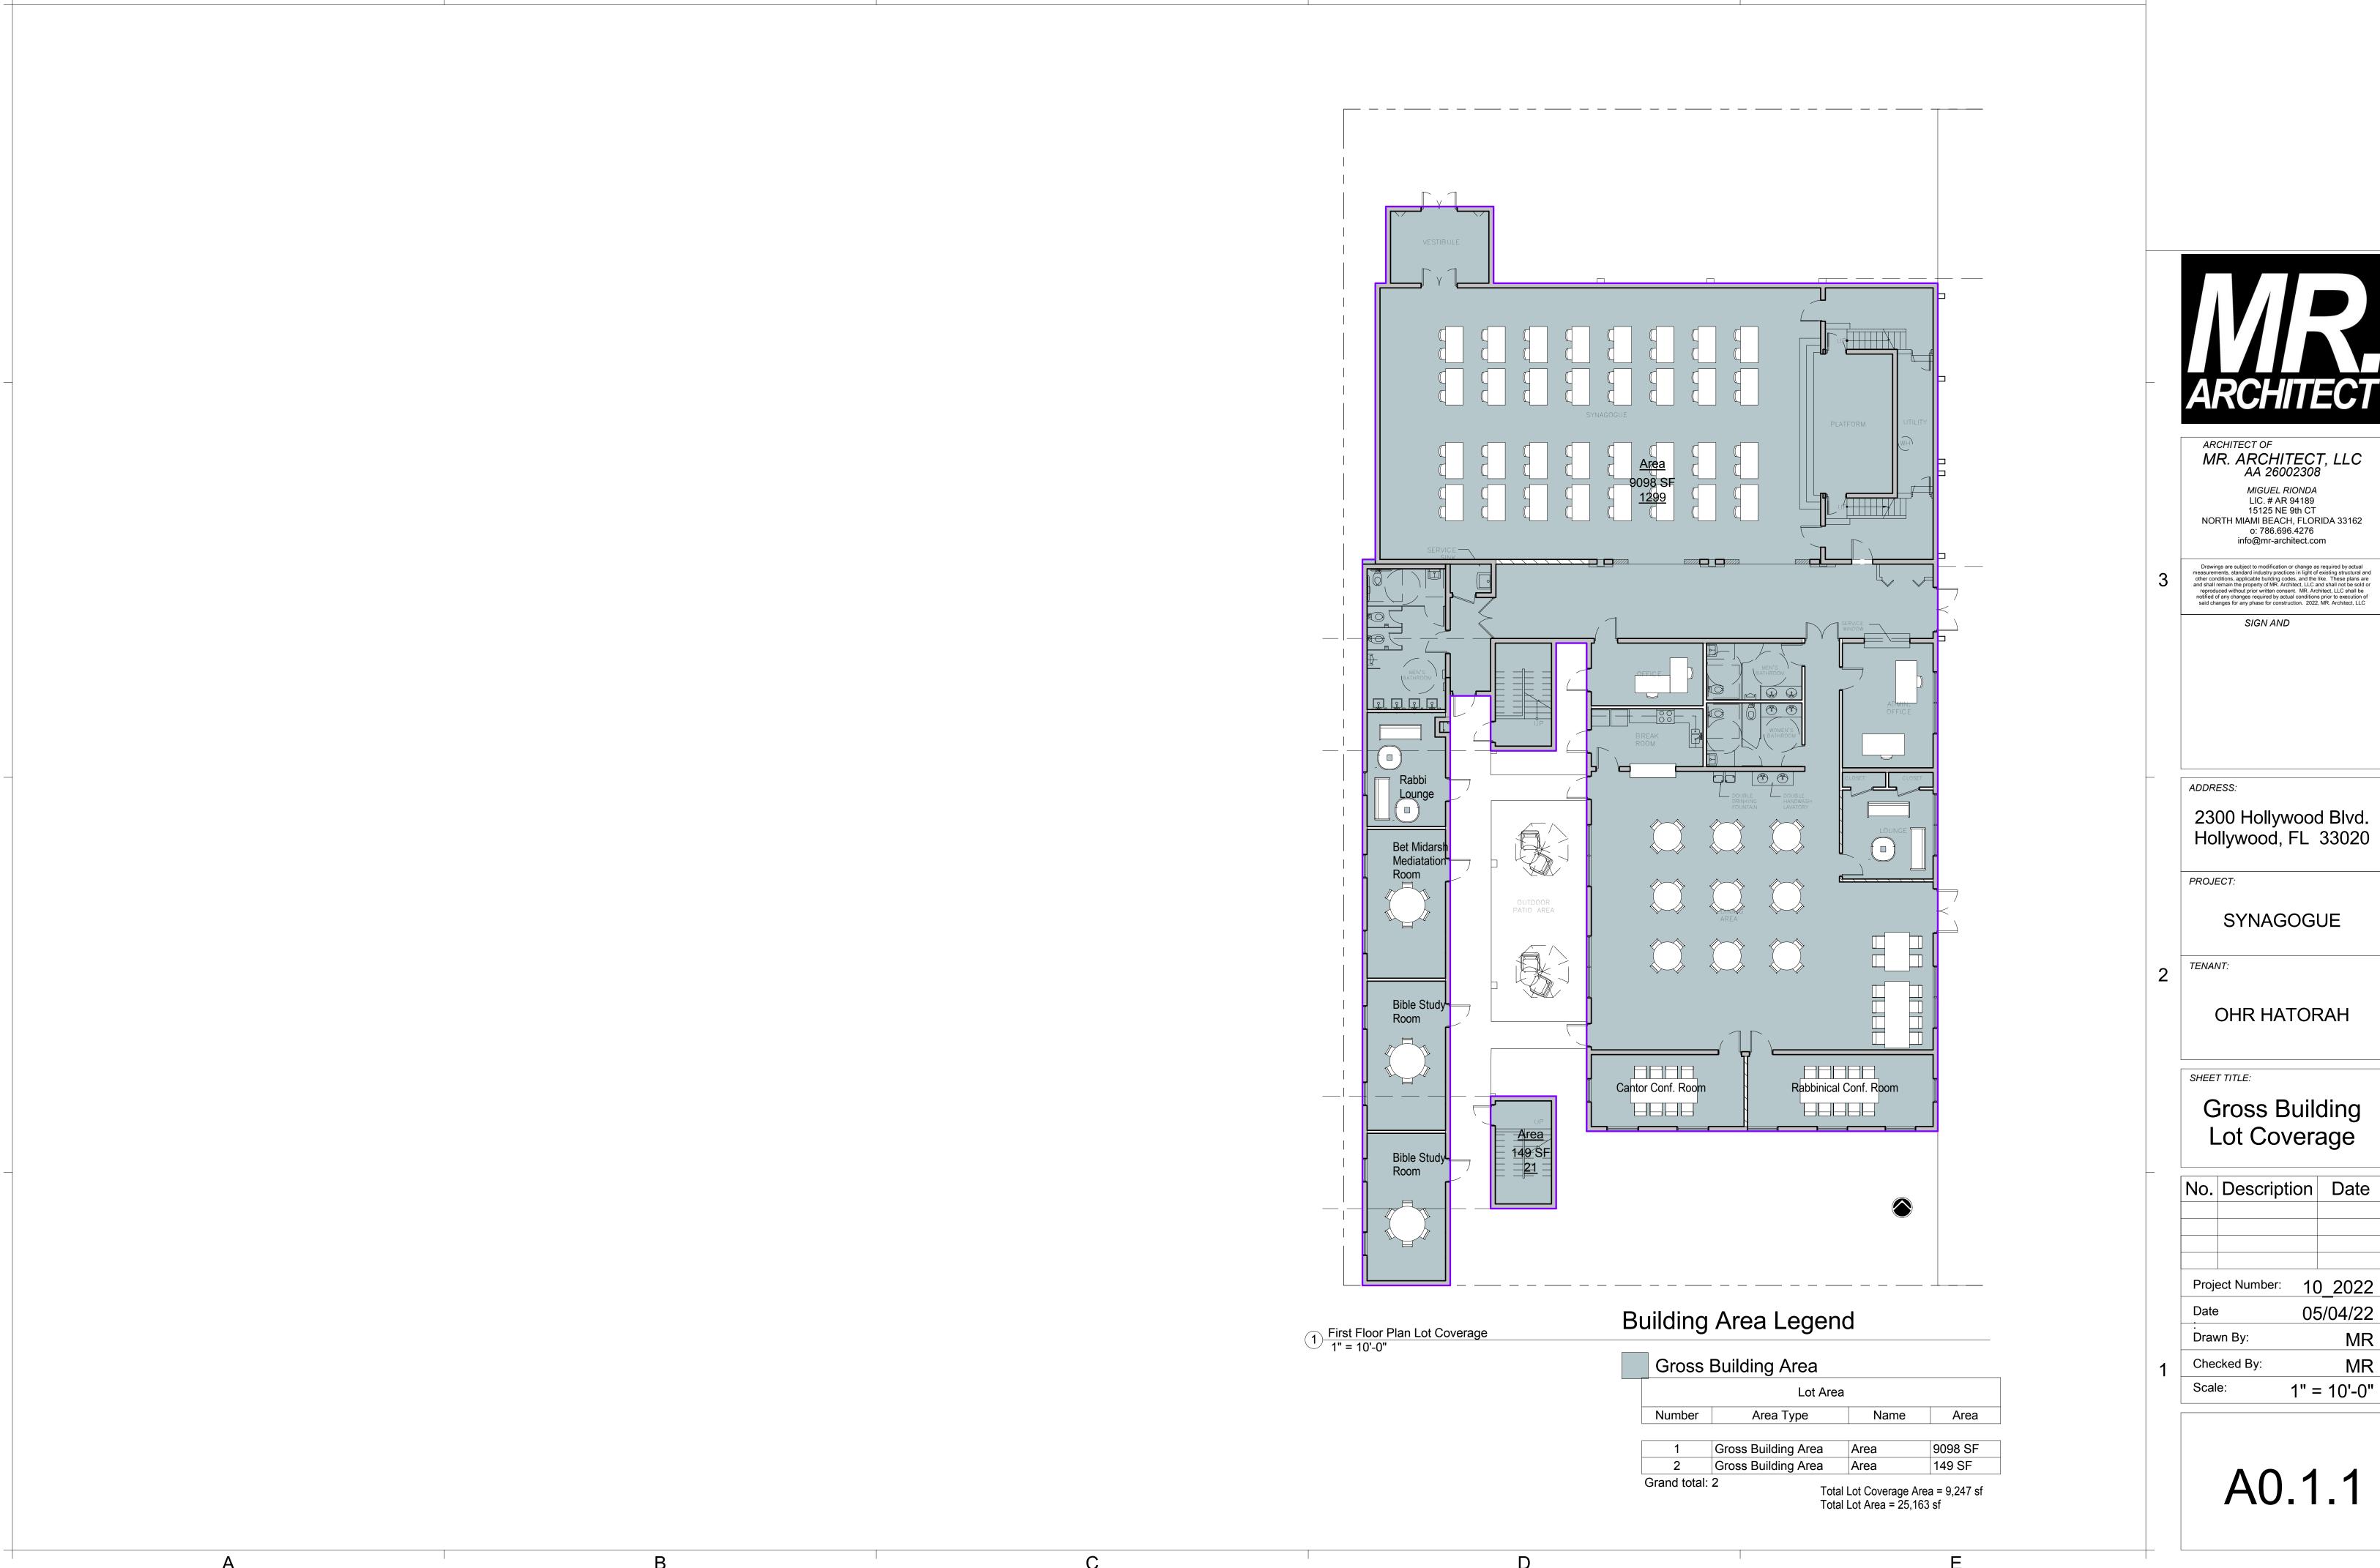

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SYNAGOGUE


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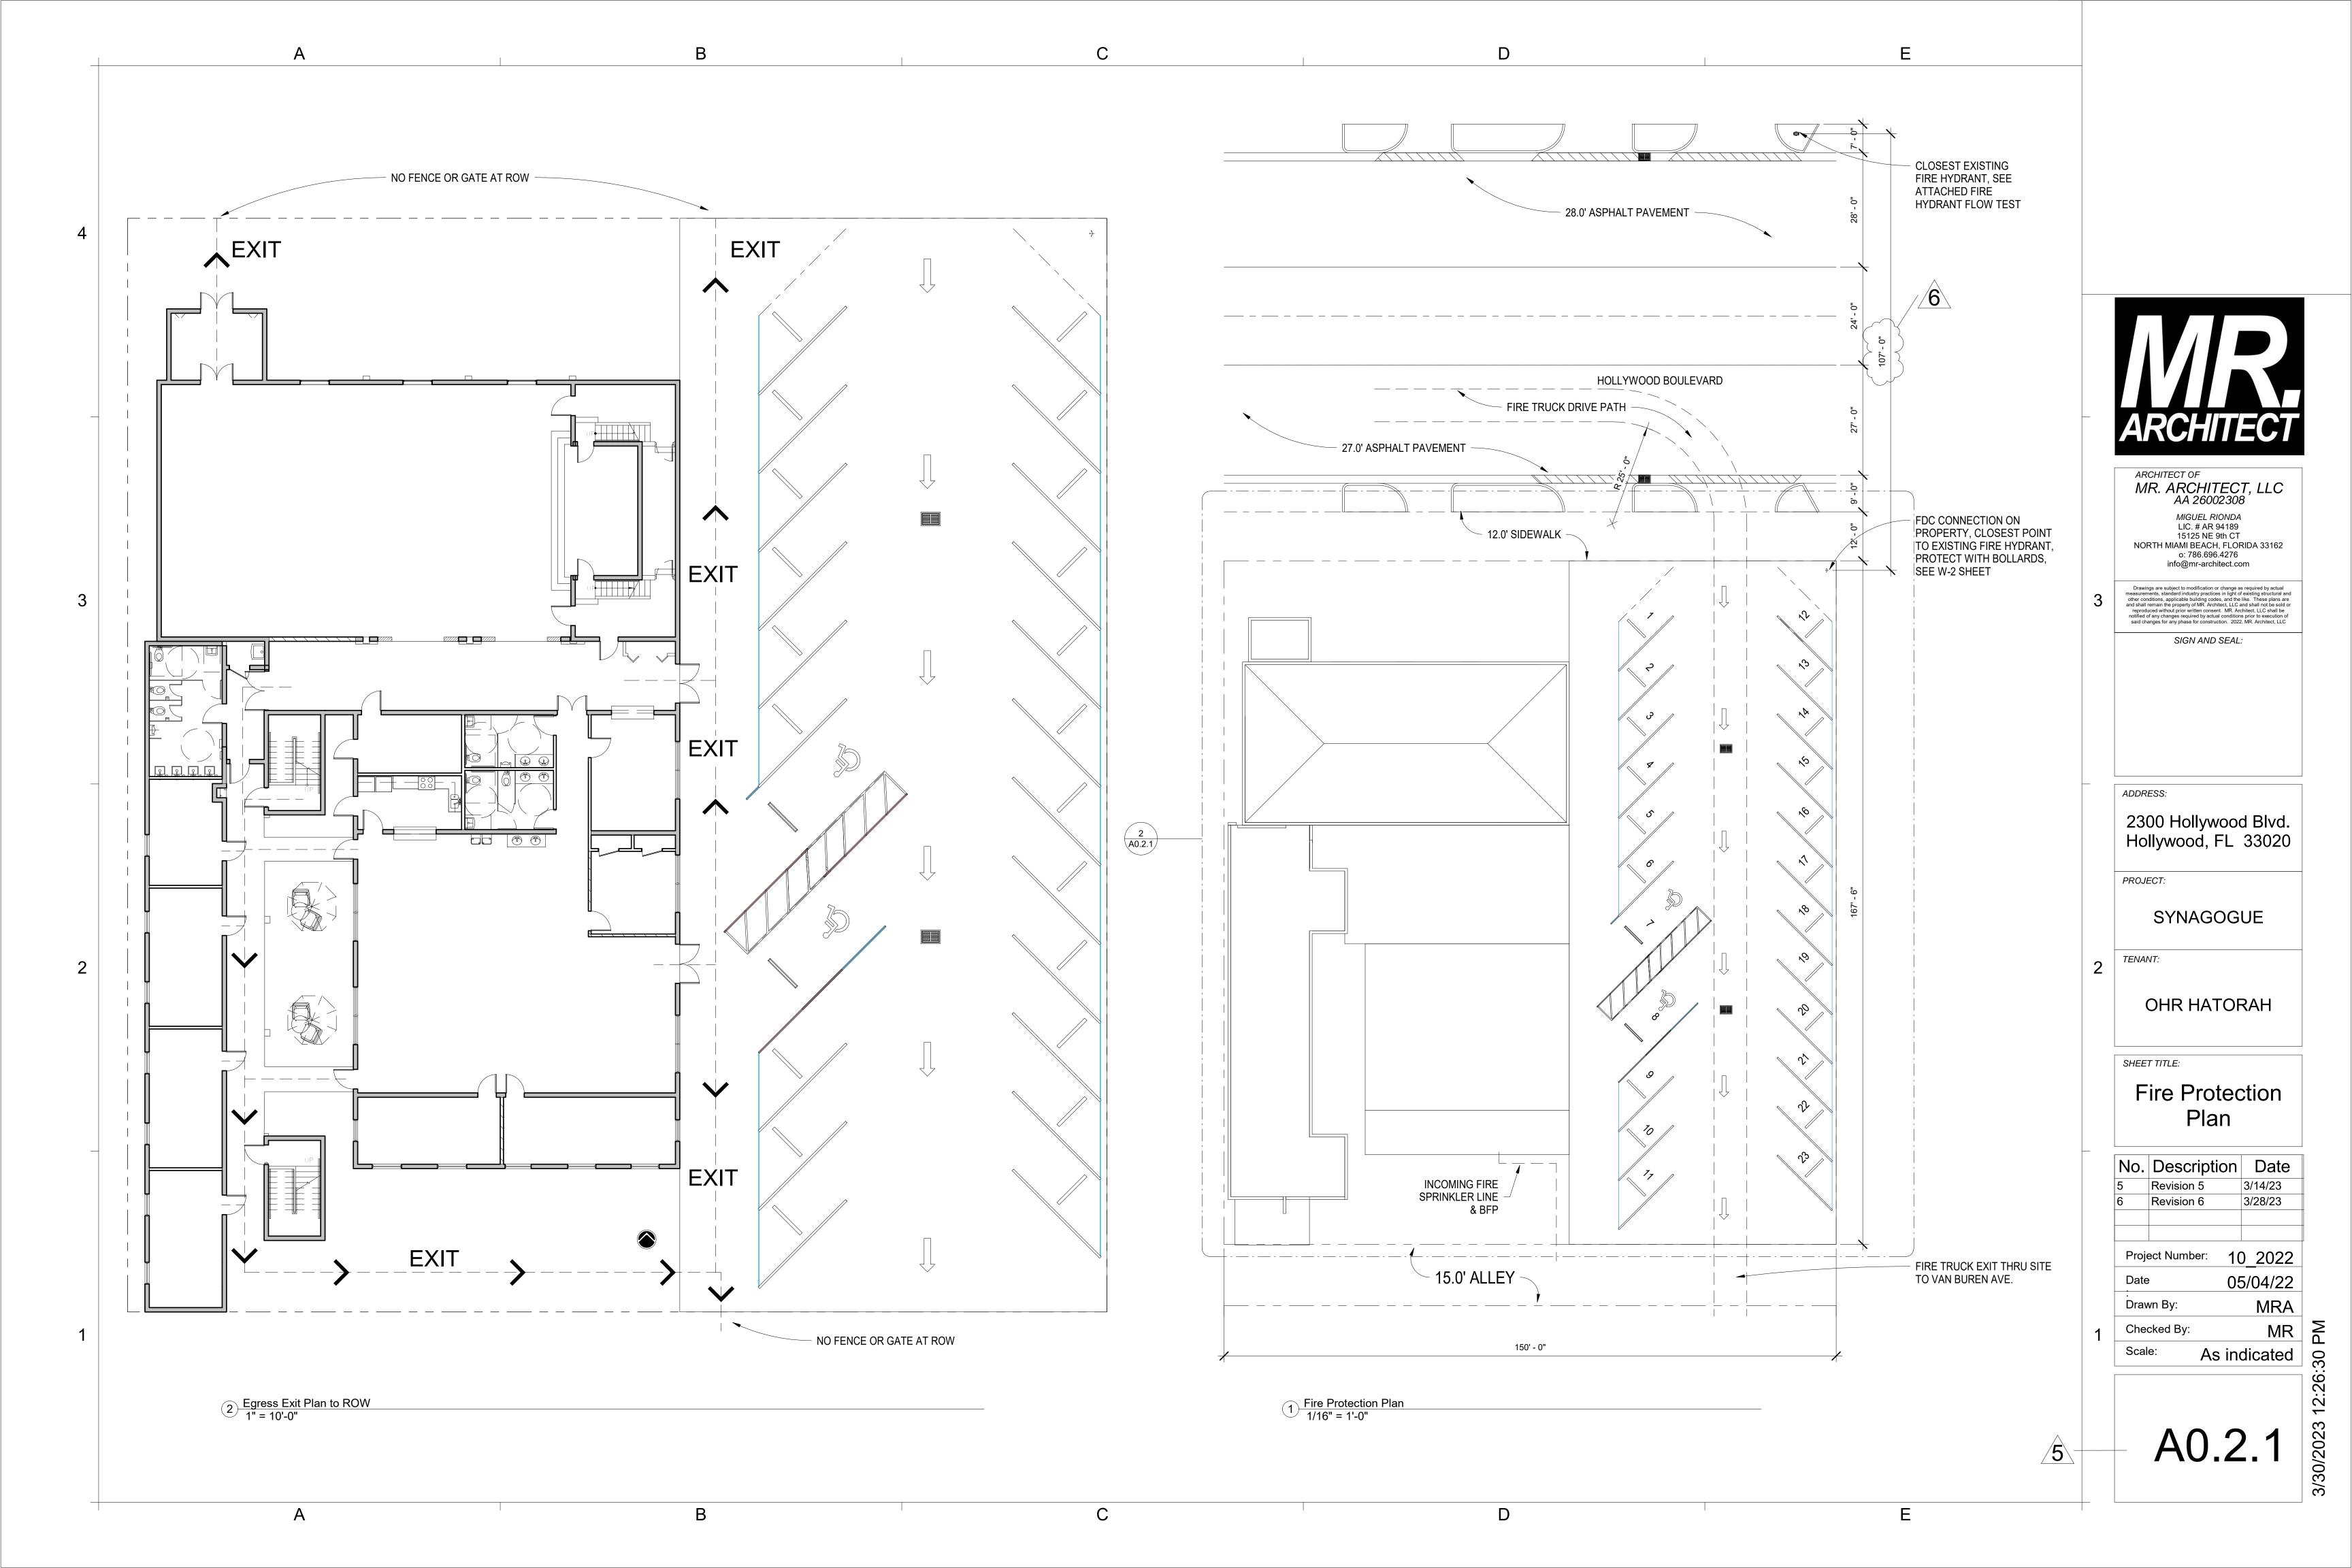
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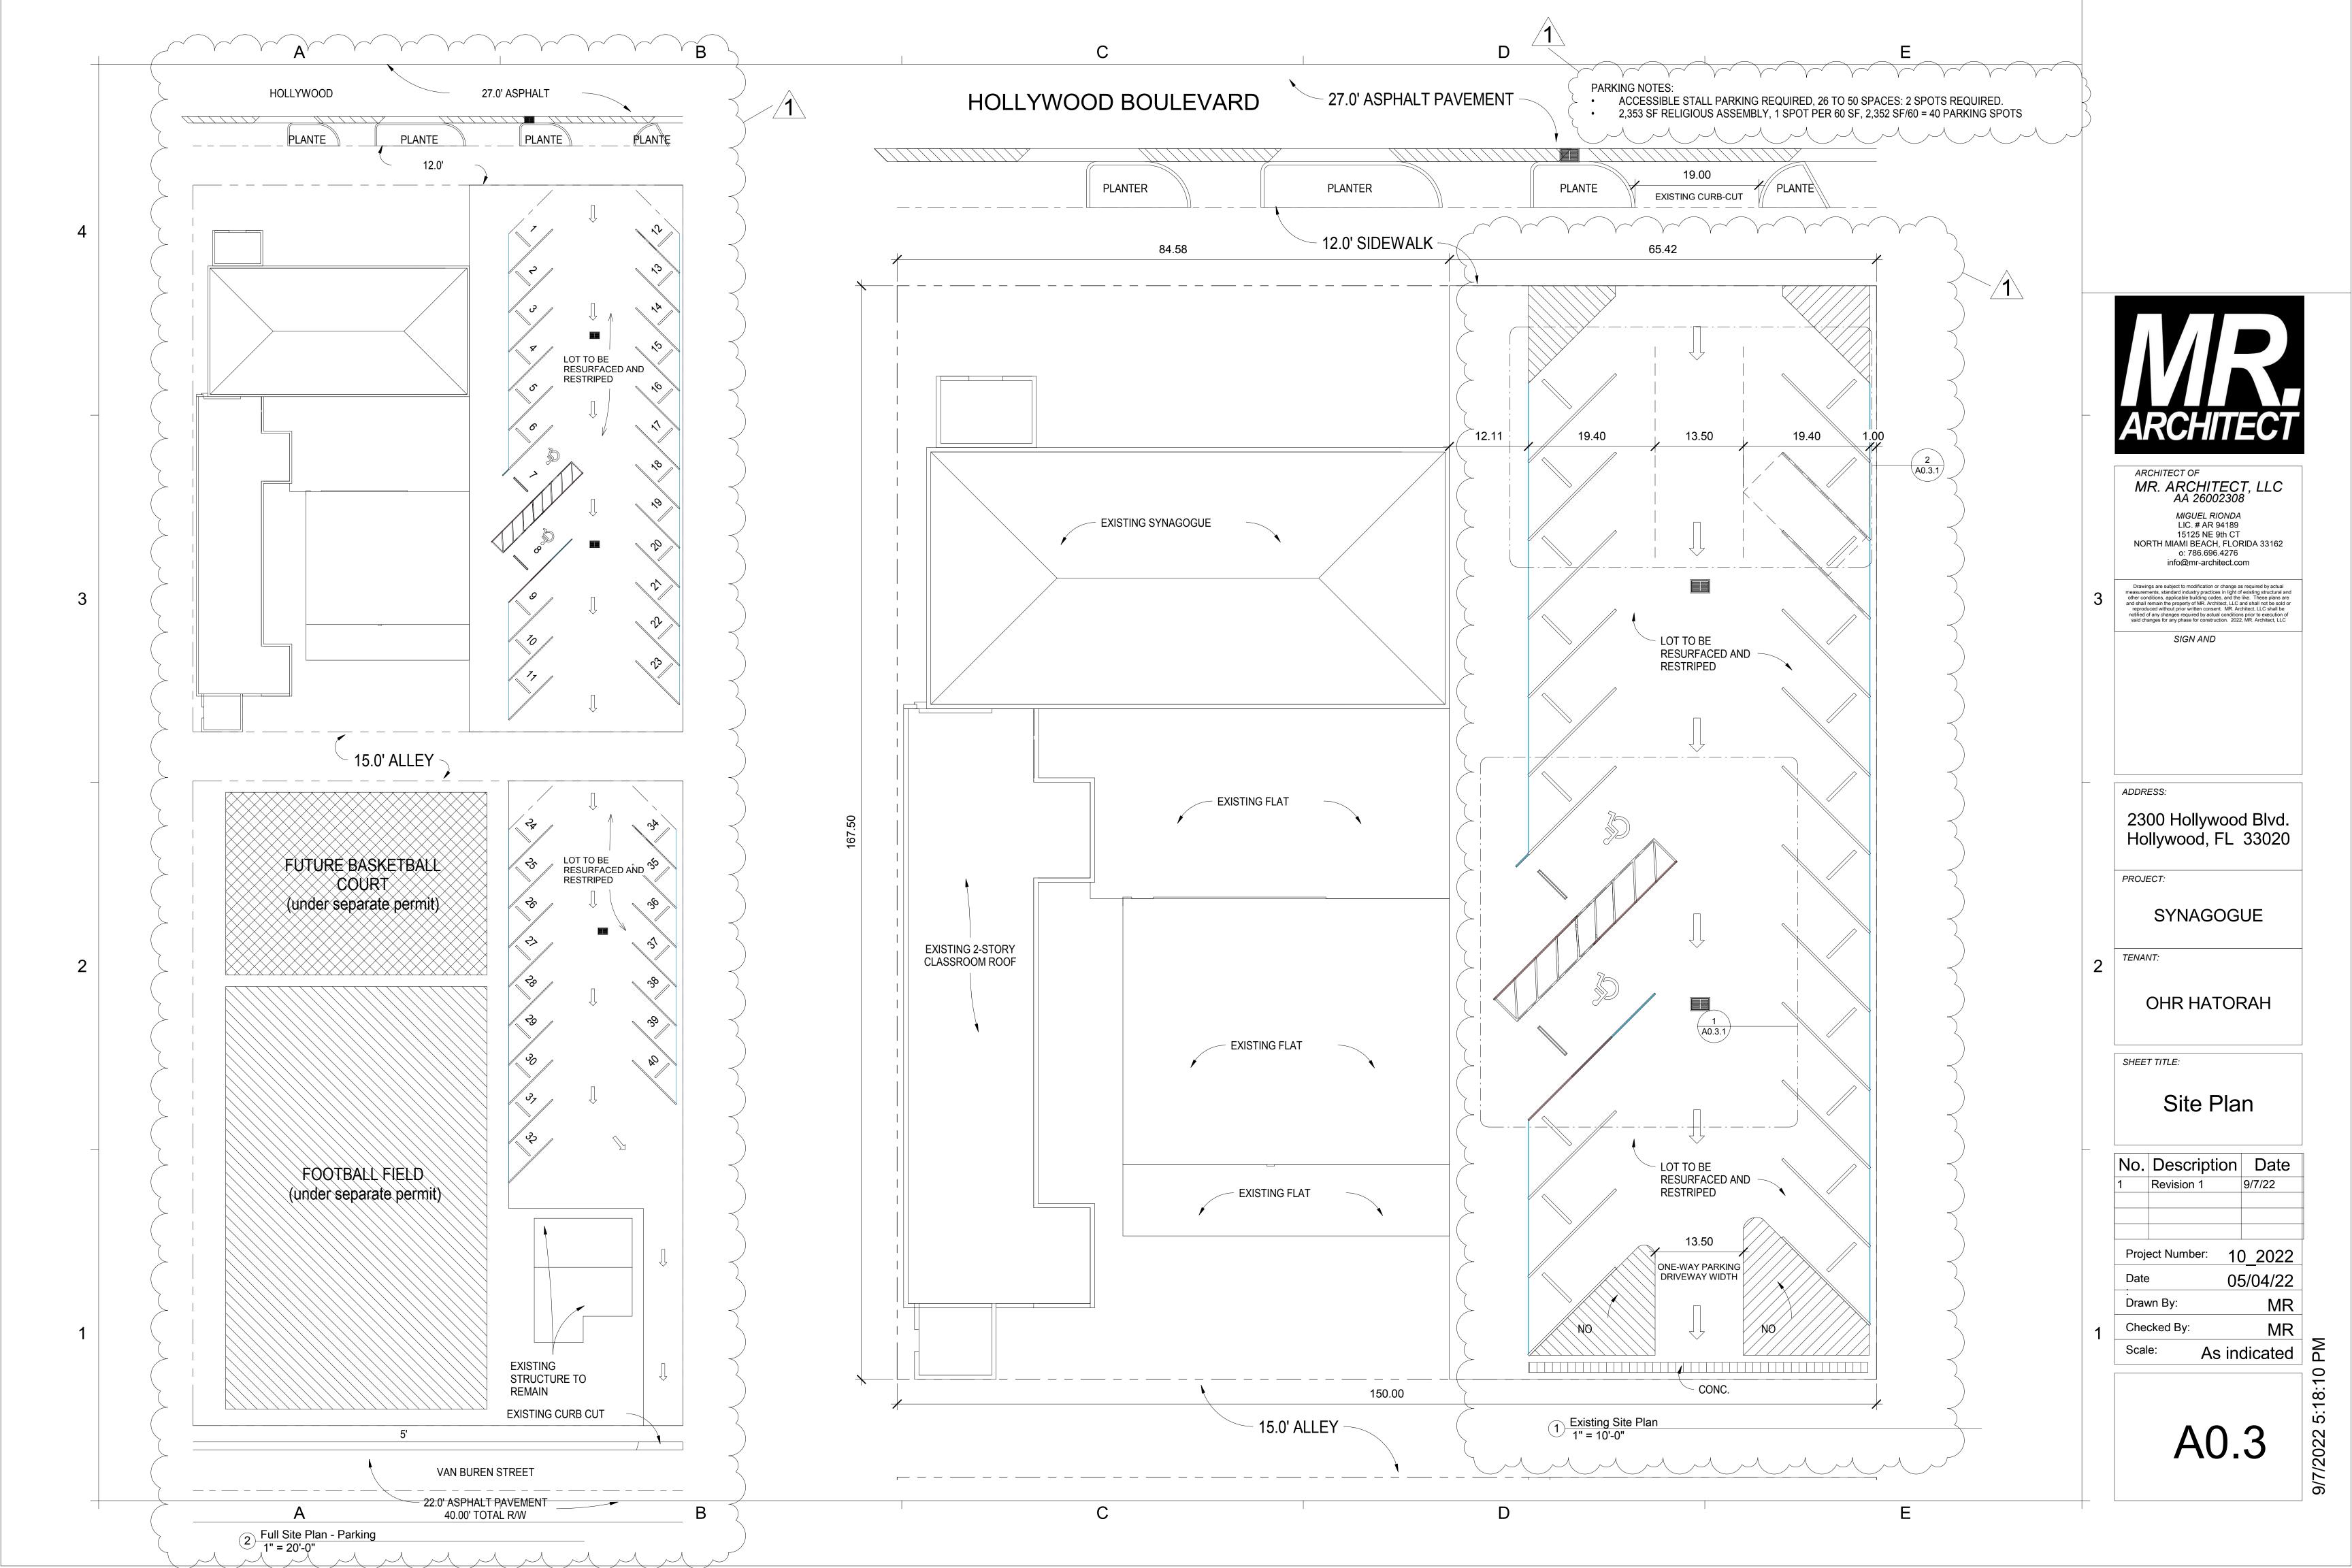
Gross Building Lot Coverage


	NO.	Descrip	tion	Date	
	Proje	ect Number:	1(2022	
	Date	;	05	5/04/22	
	: Drav	vn By:		MR	
1	Che	cked By:		MR	■ ■
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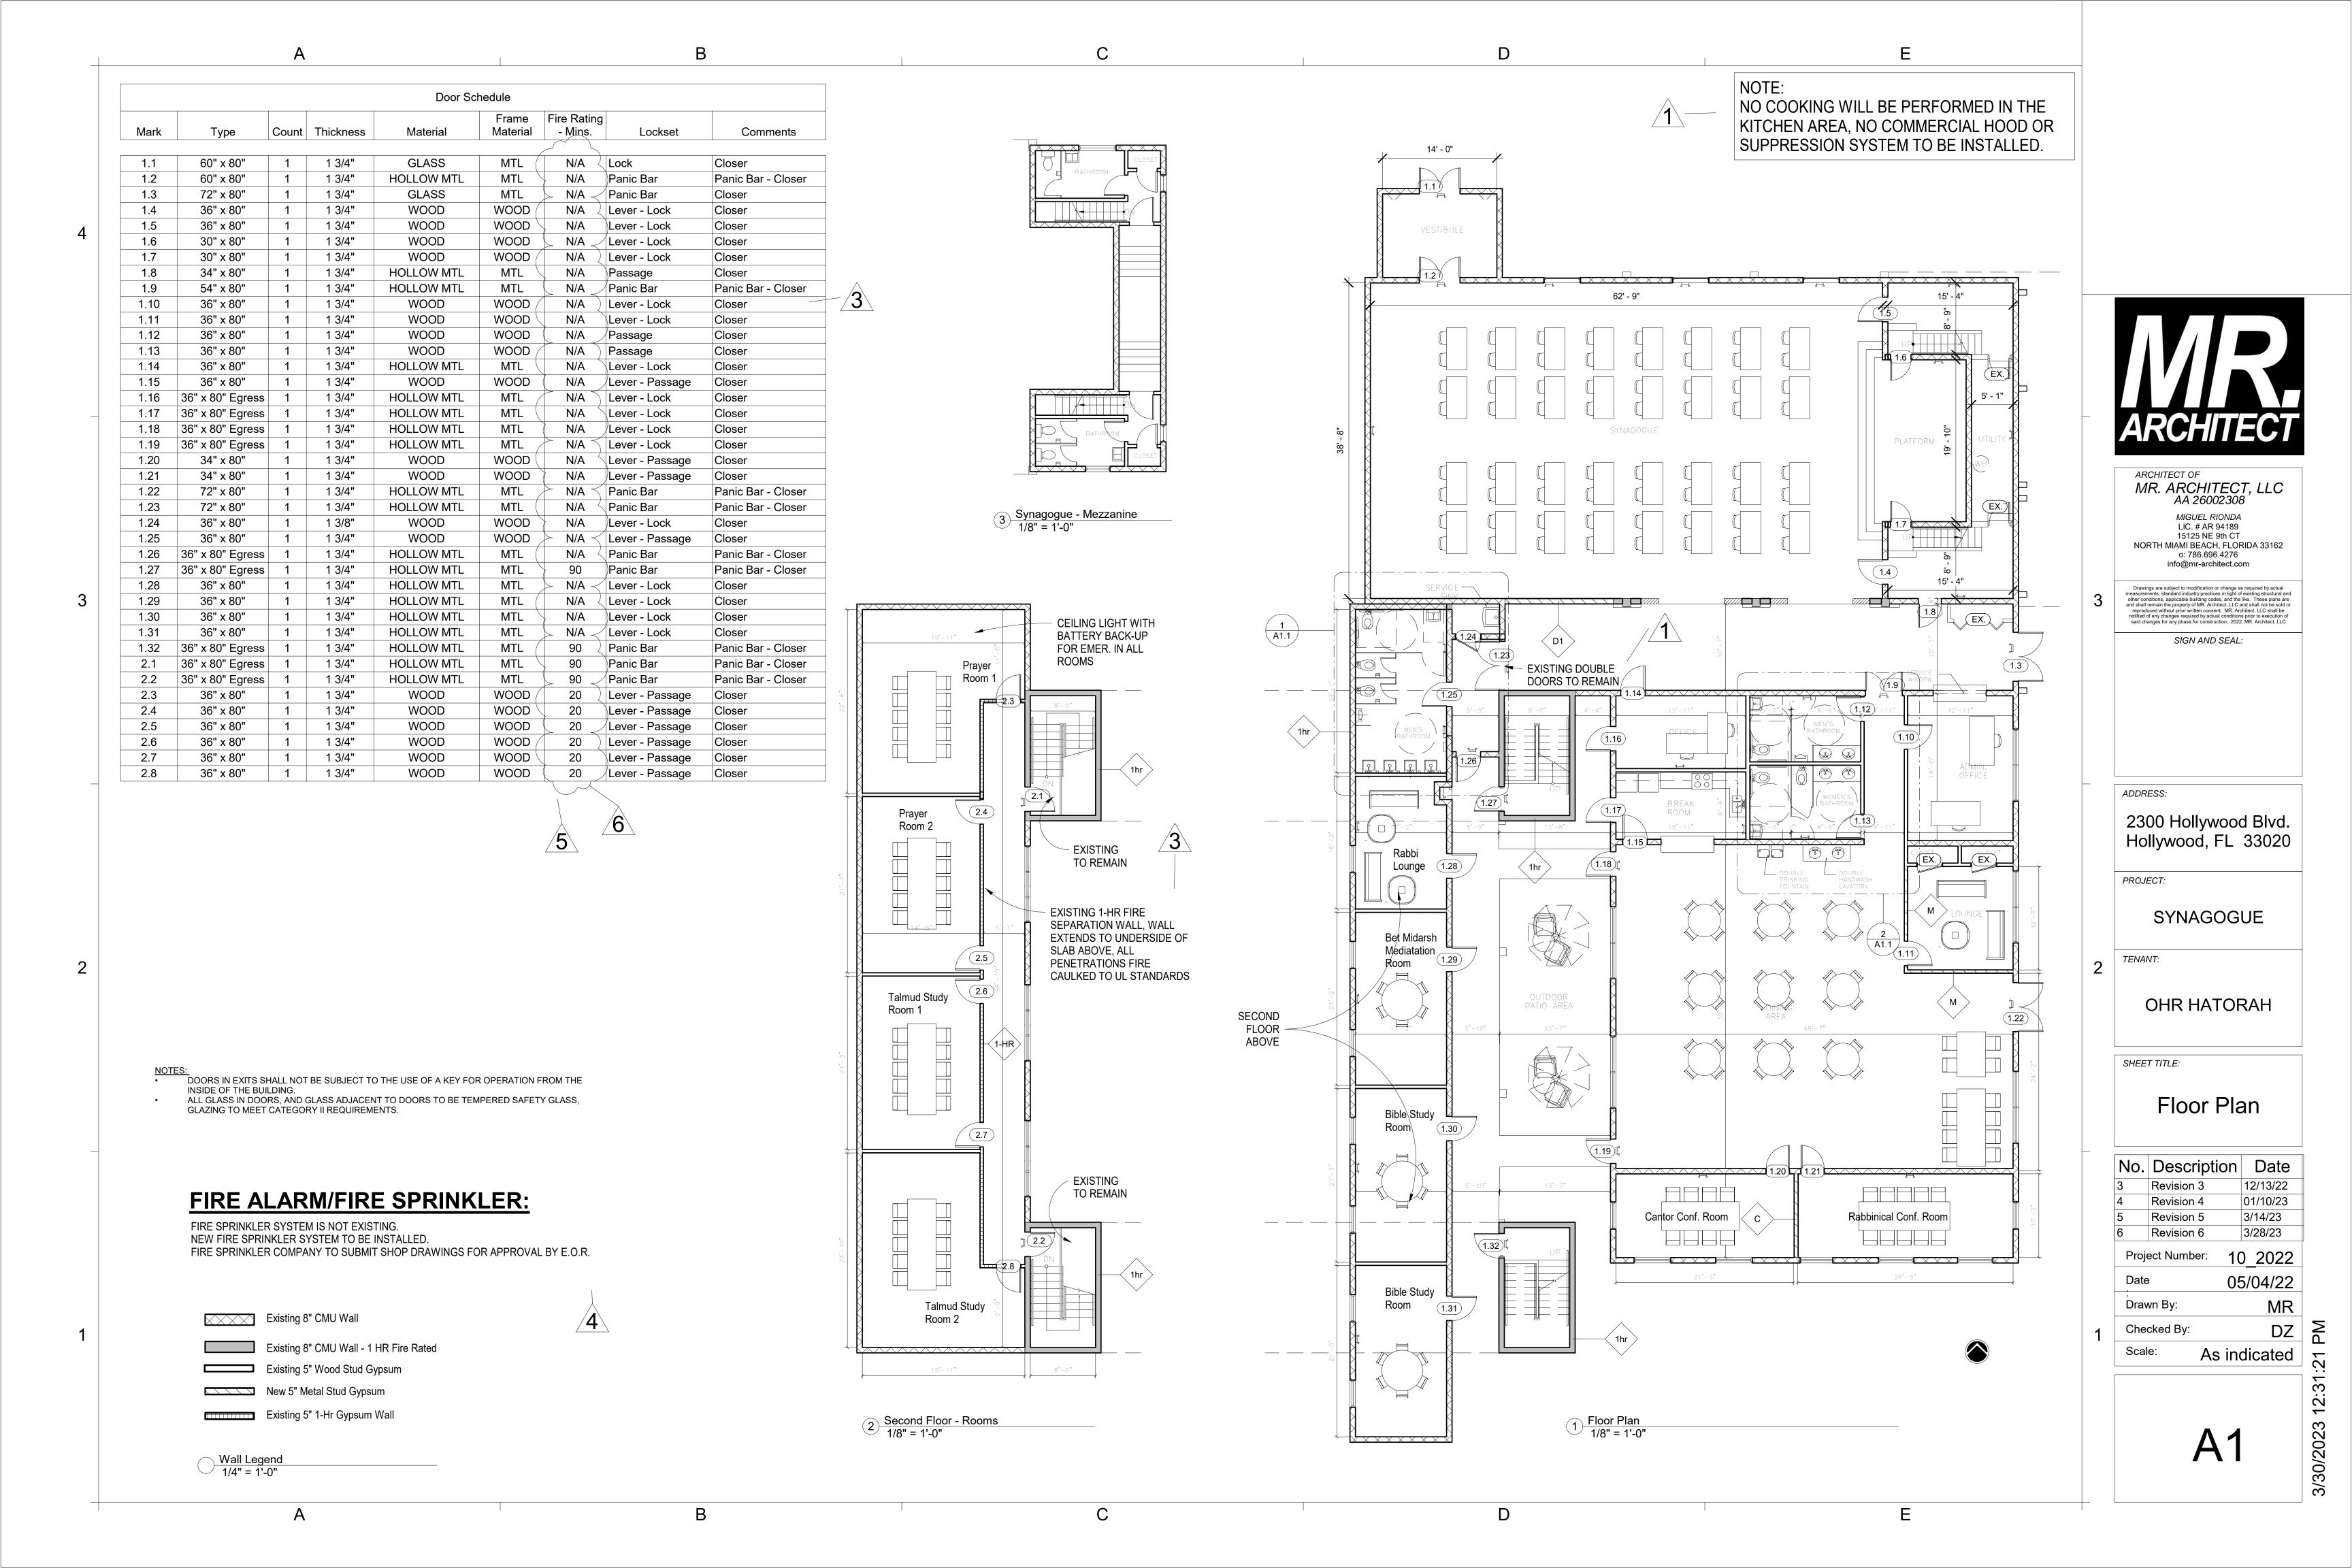
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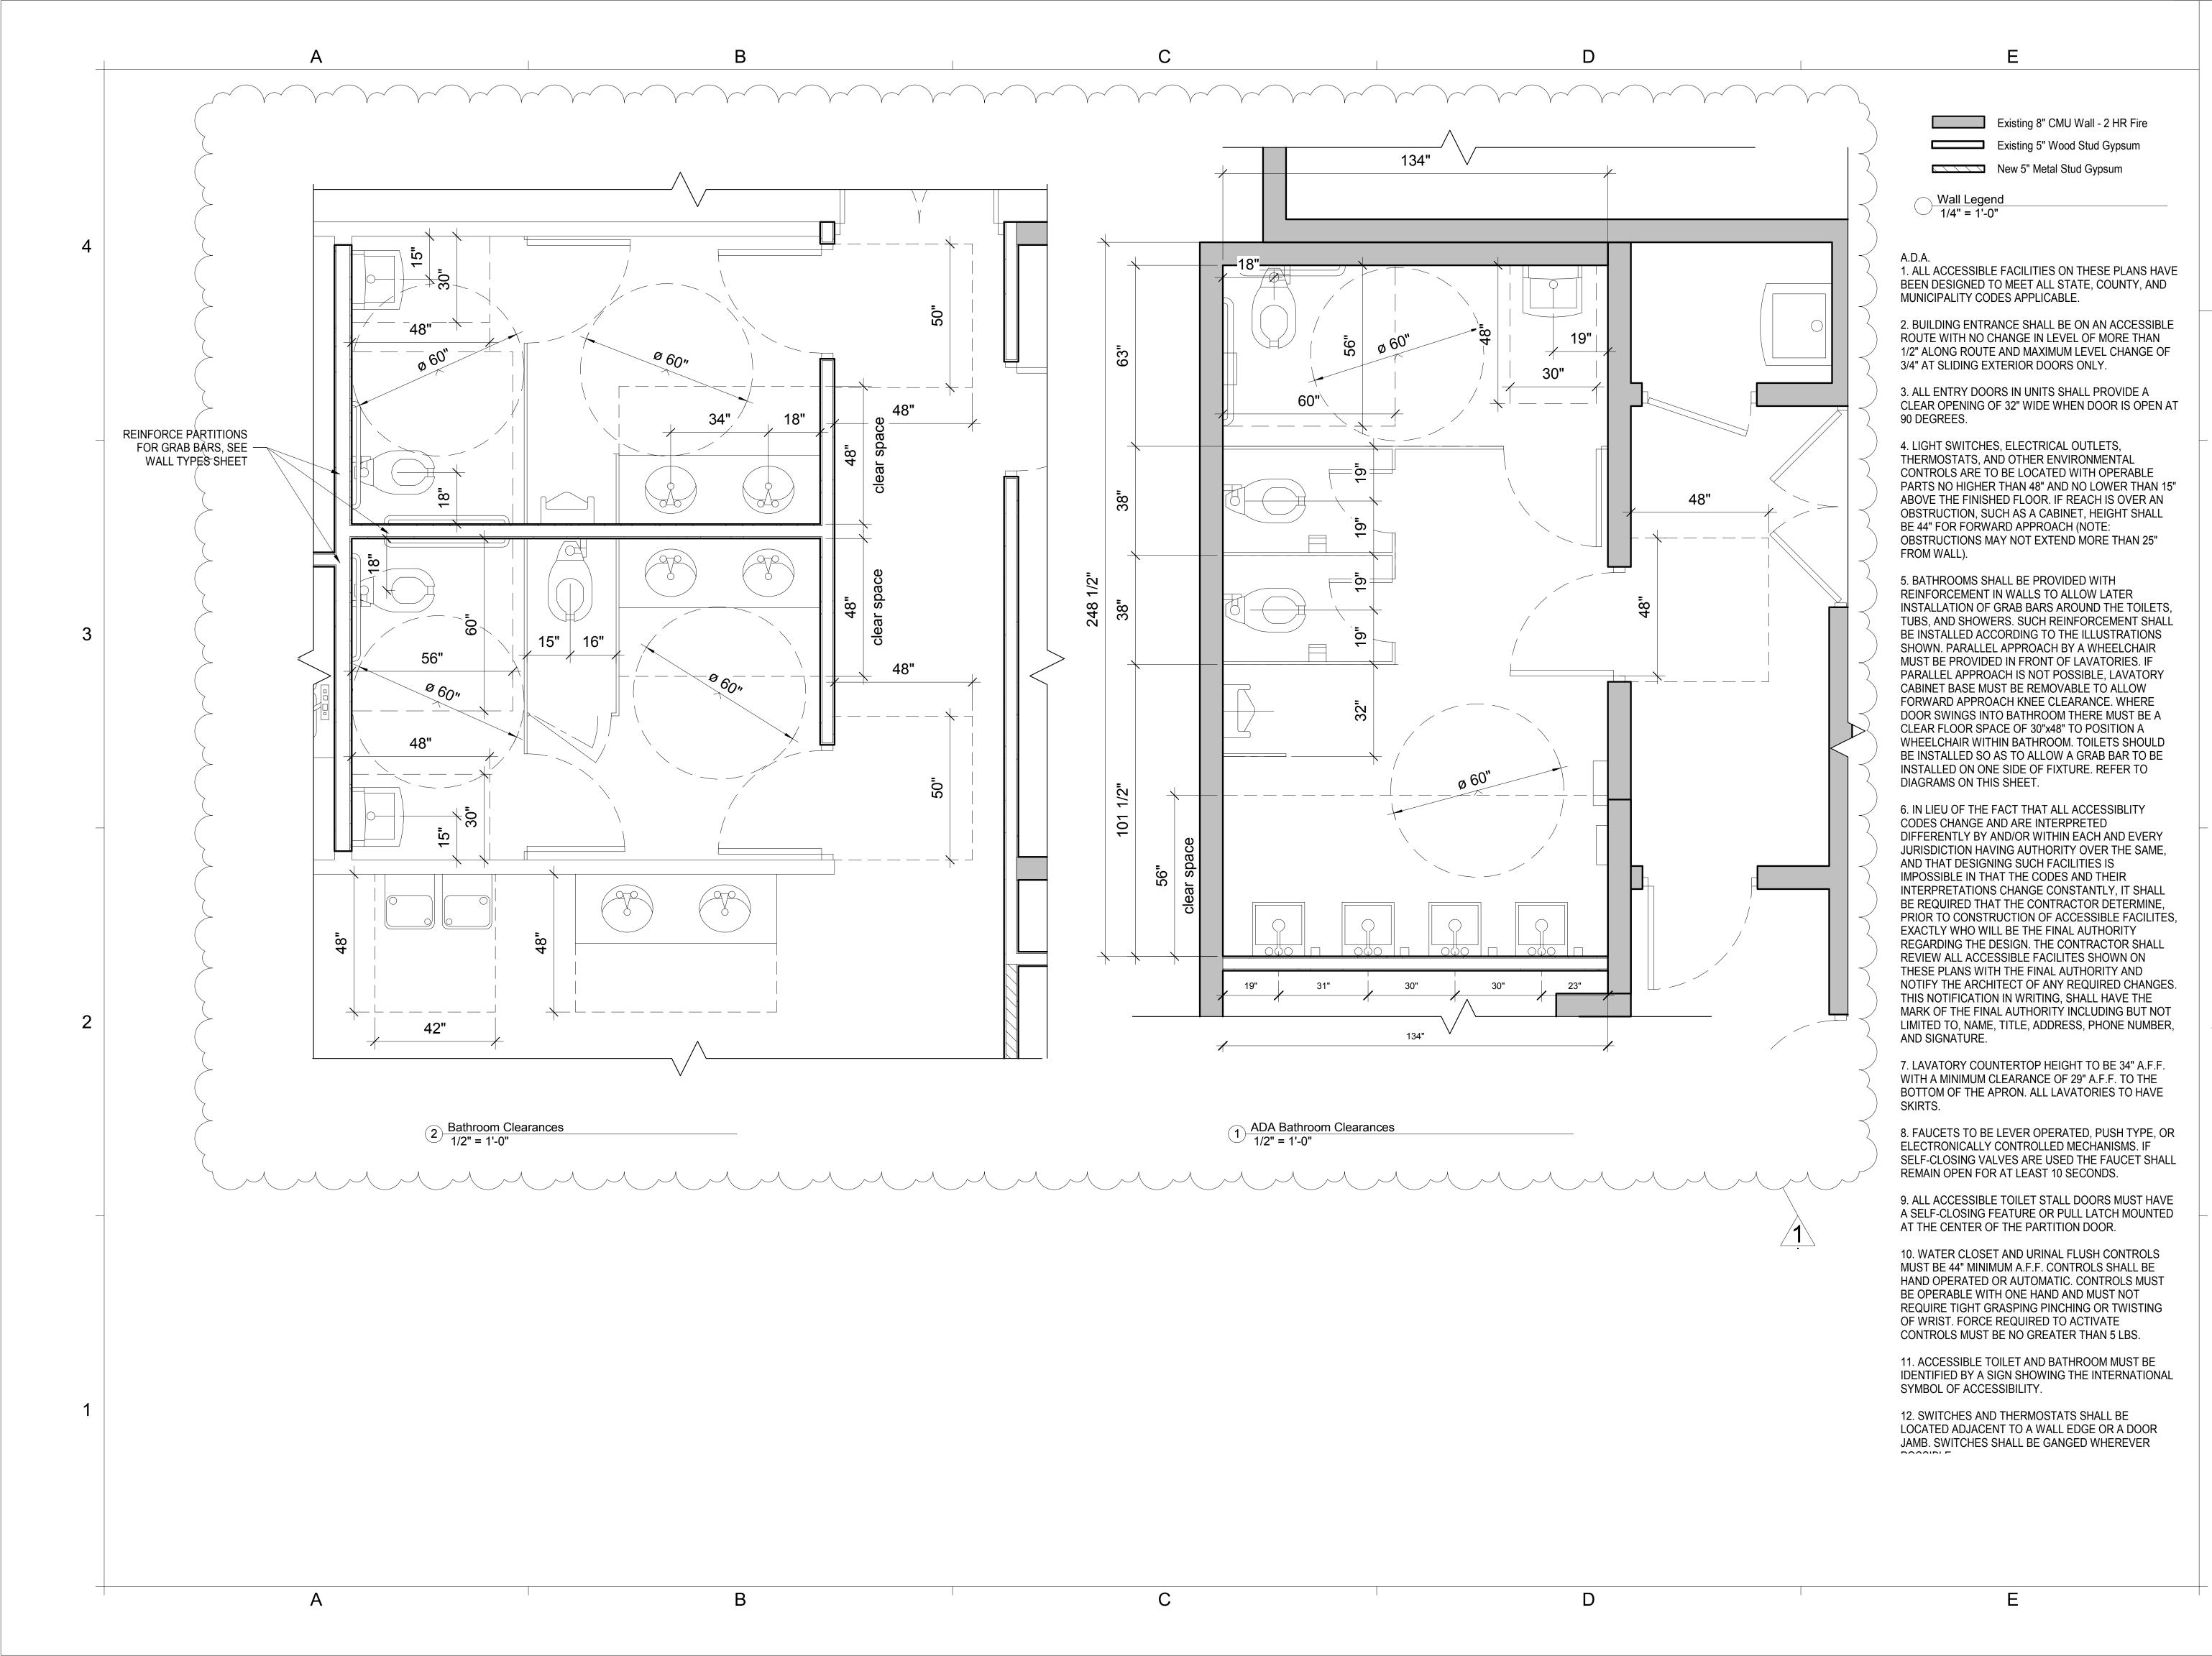








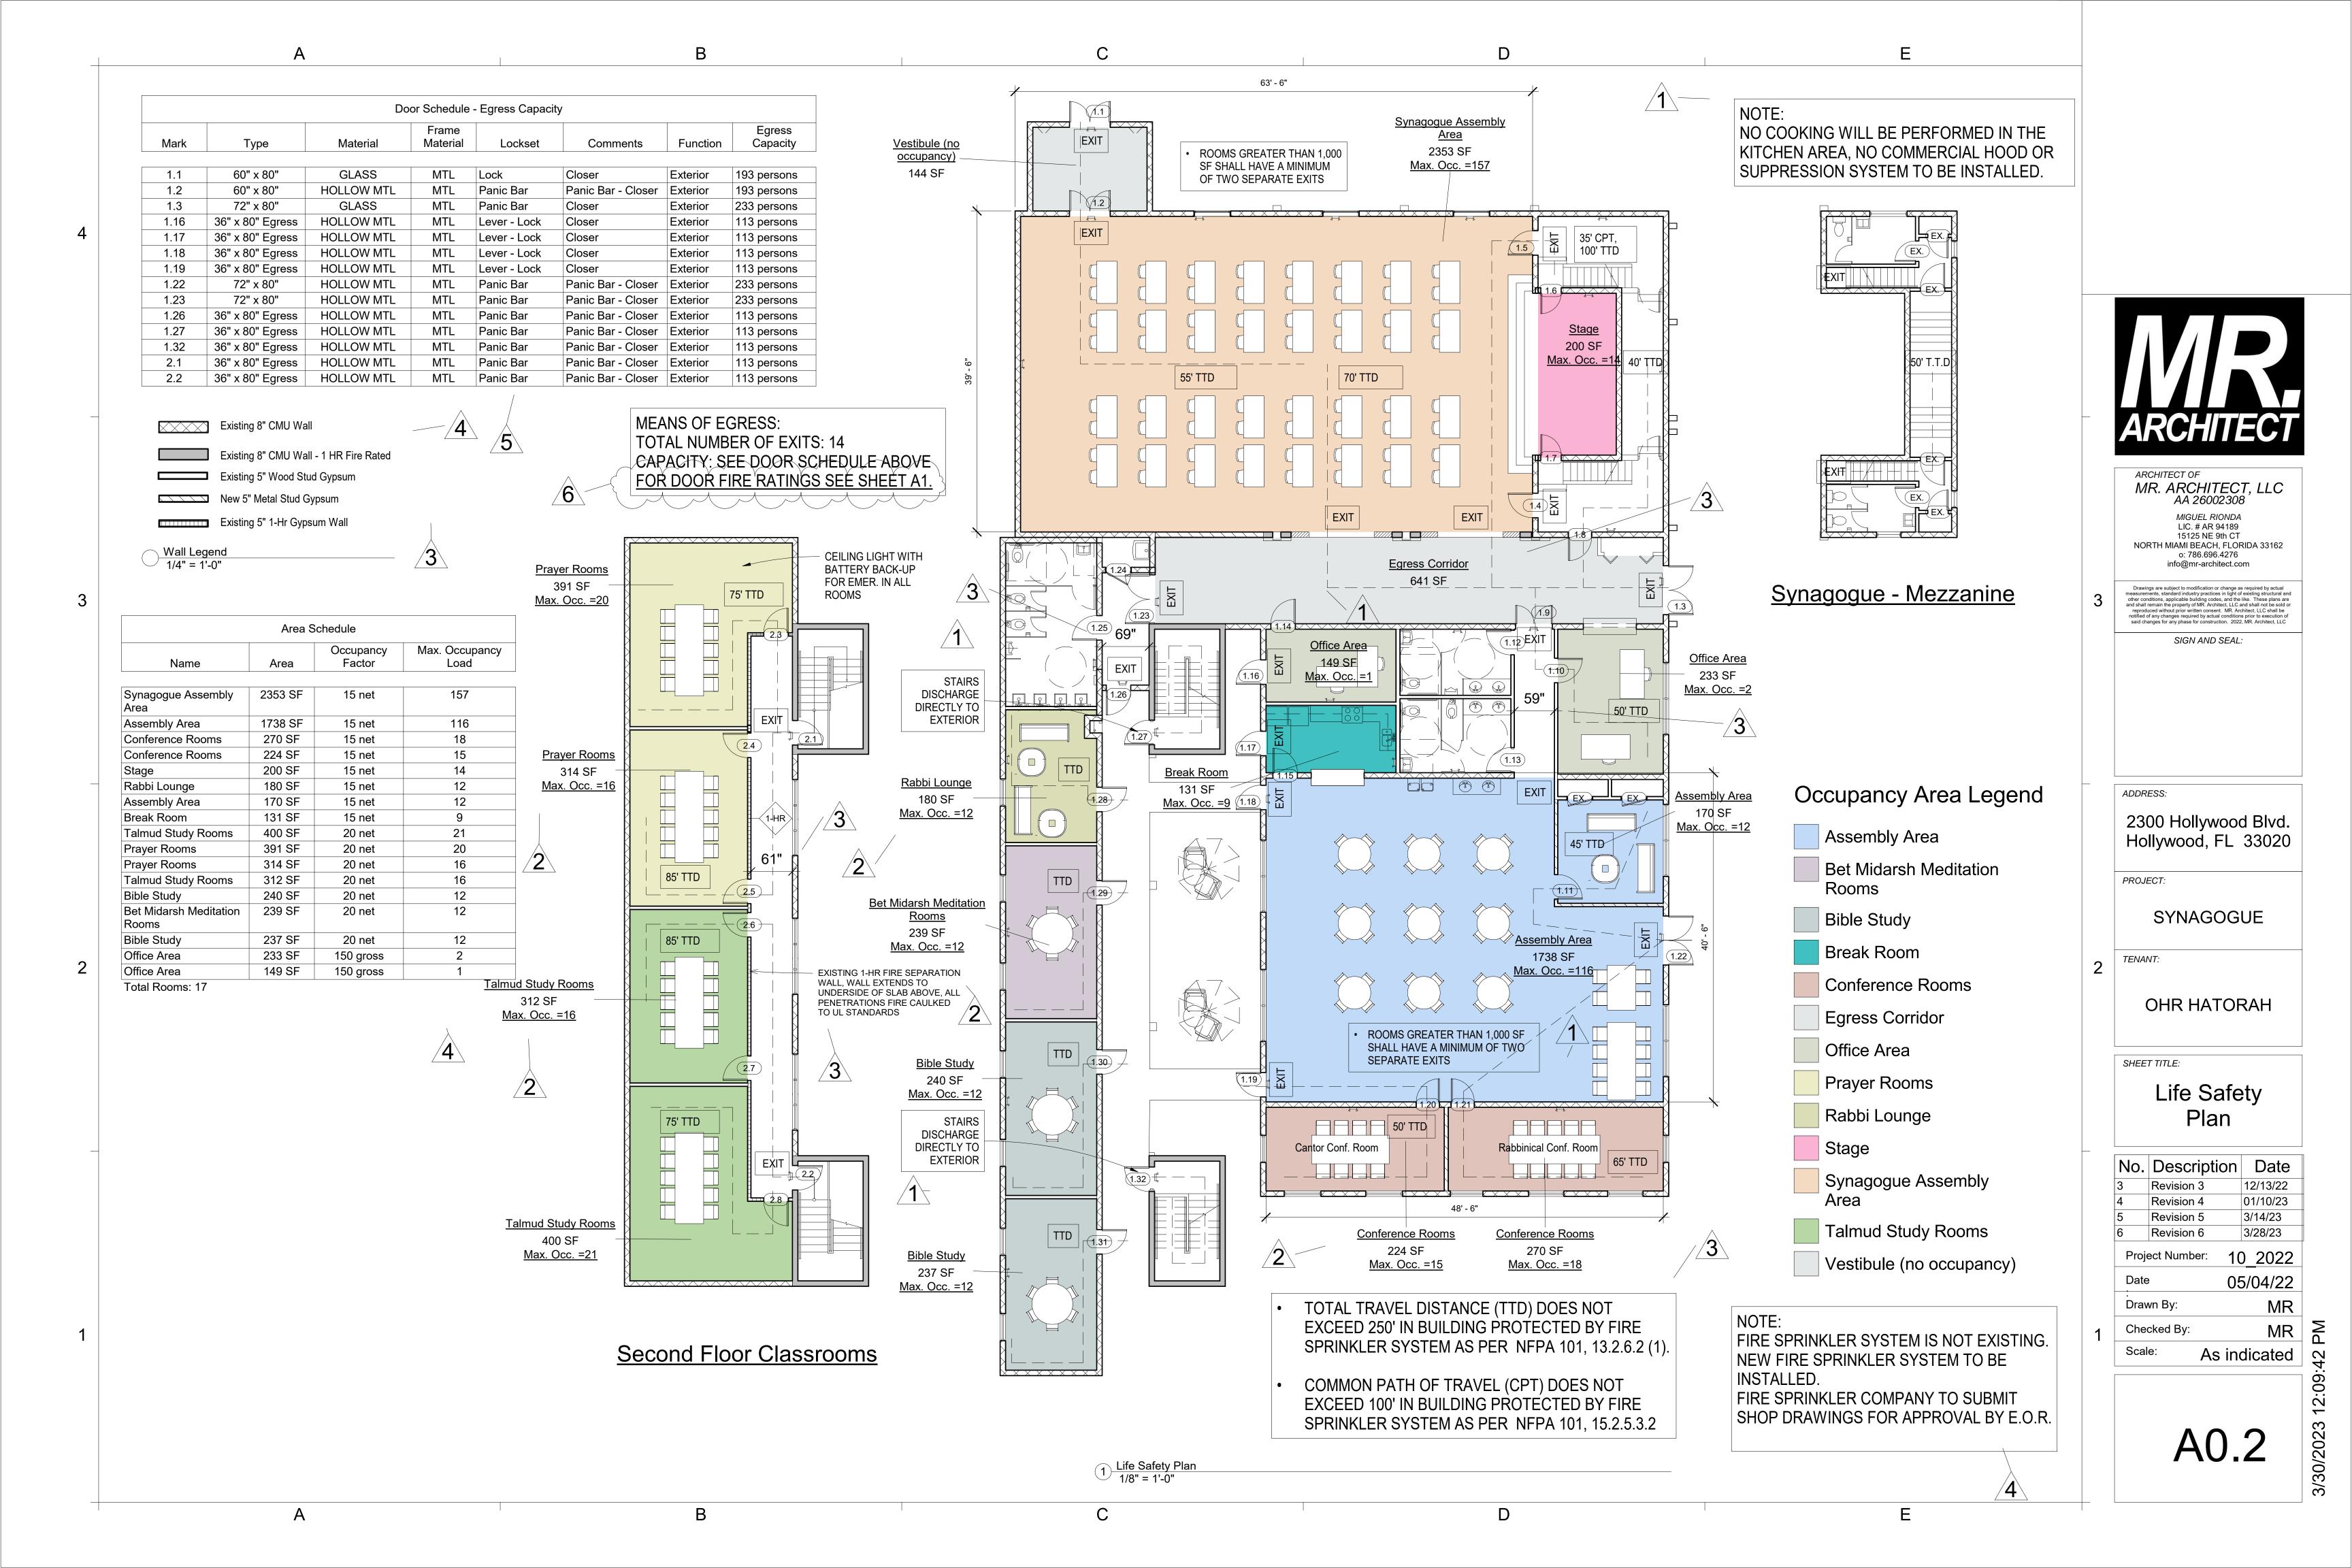

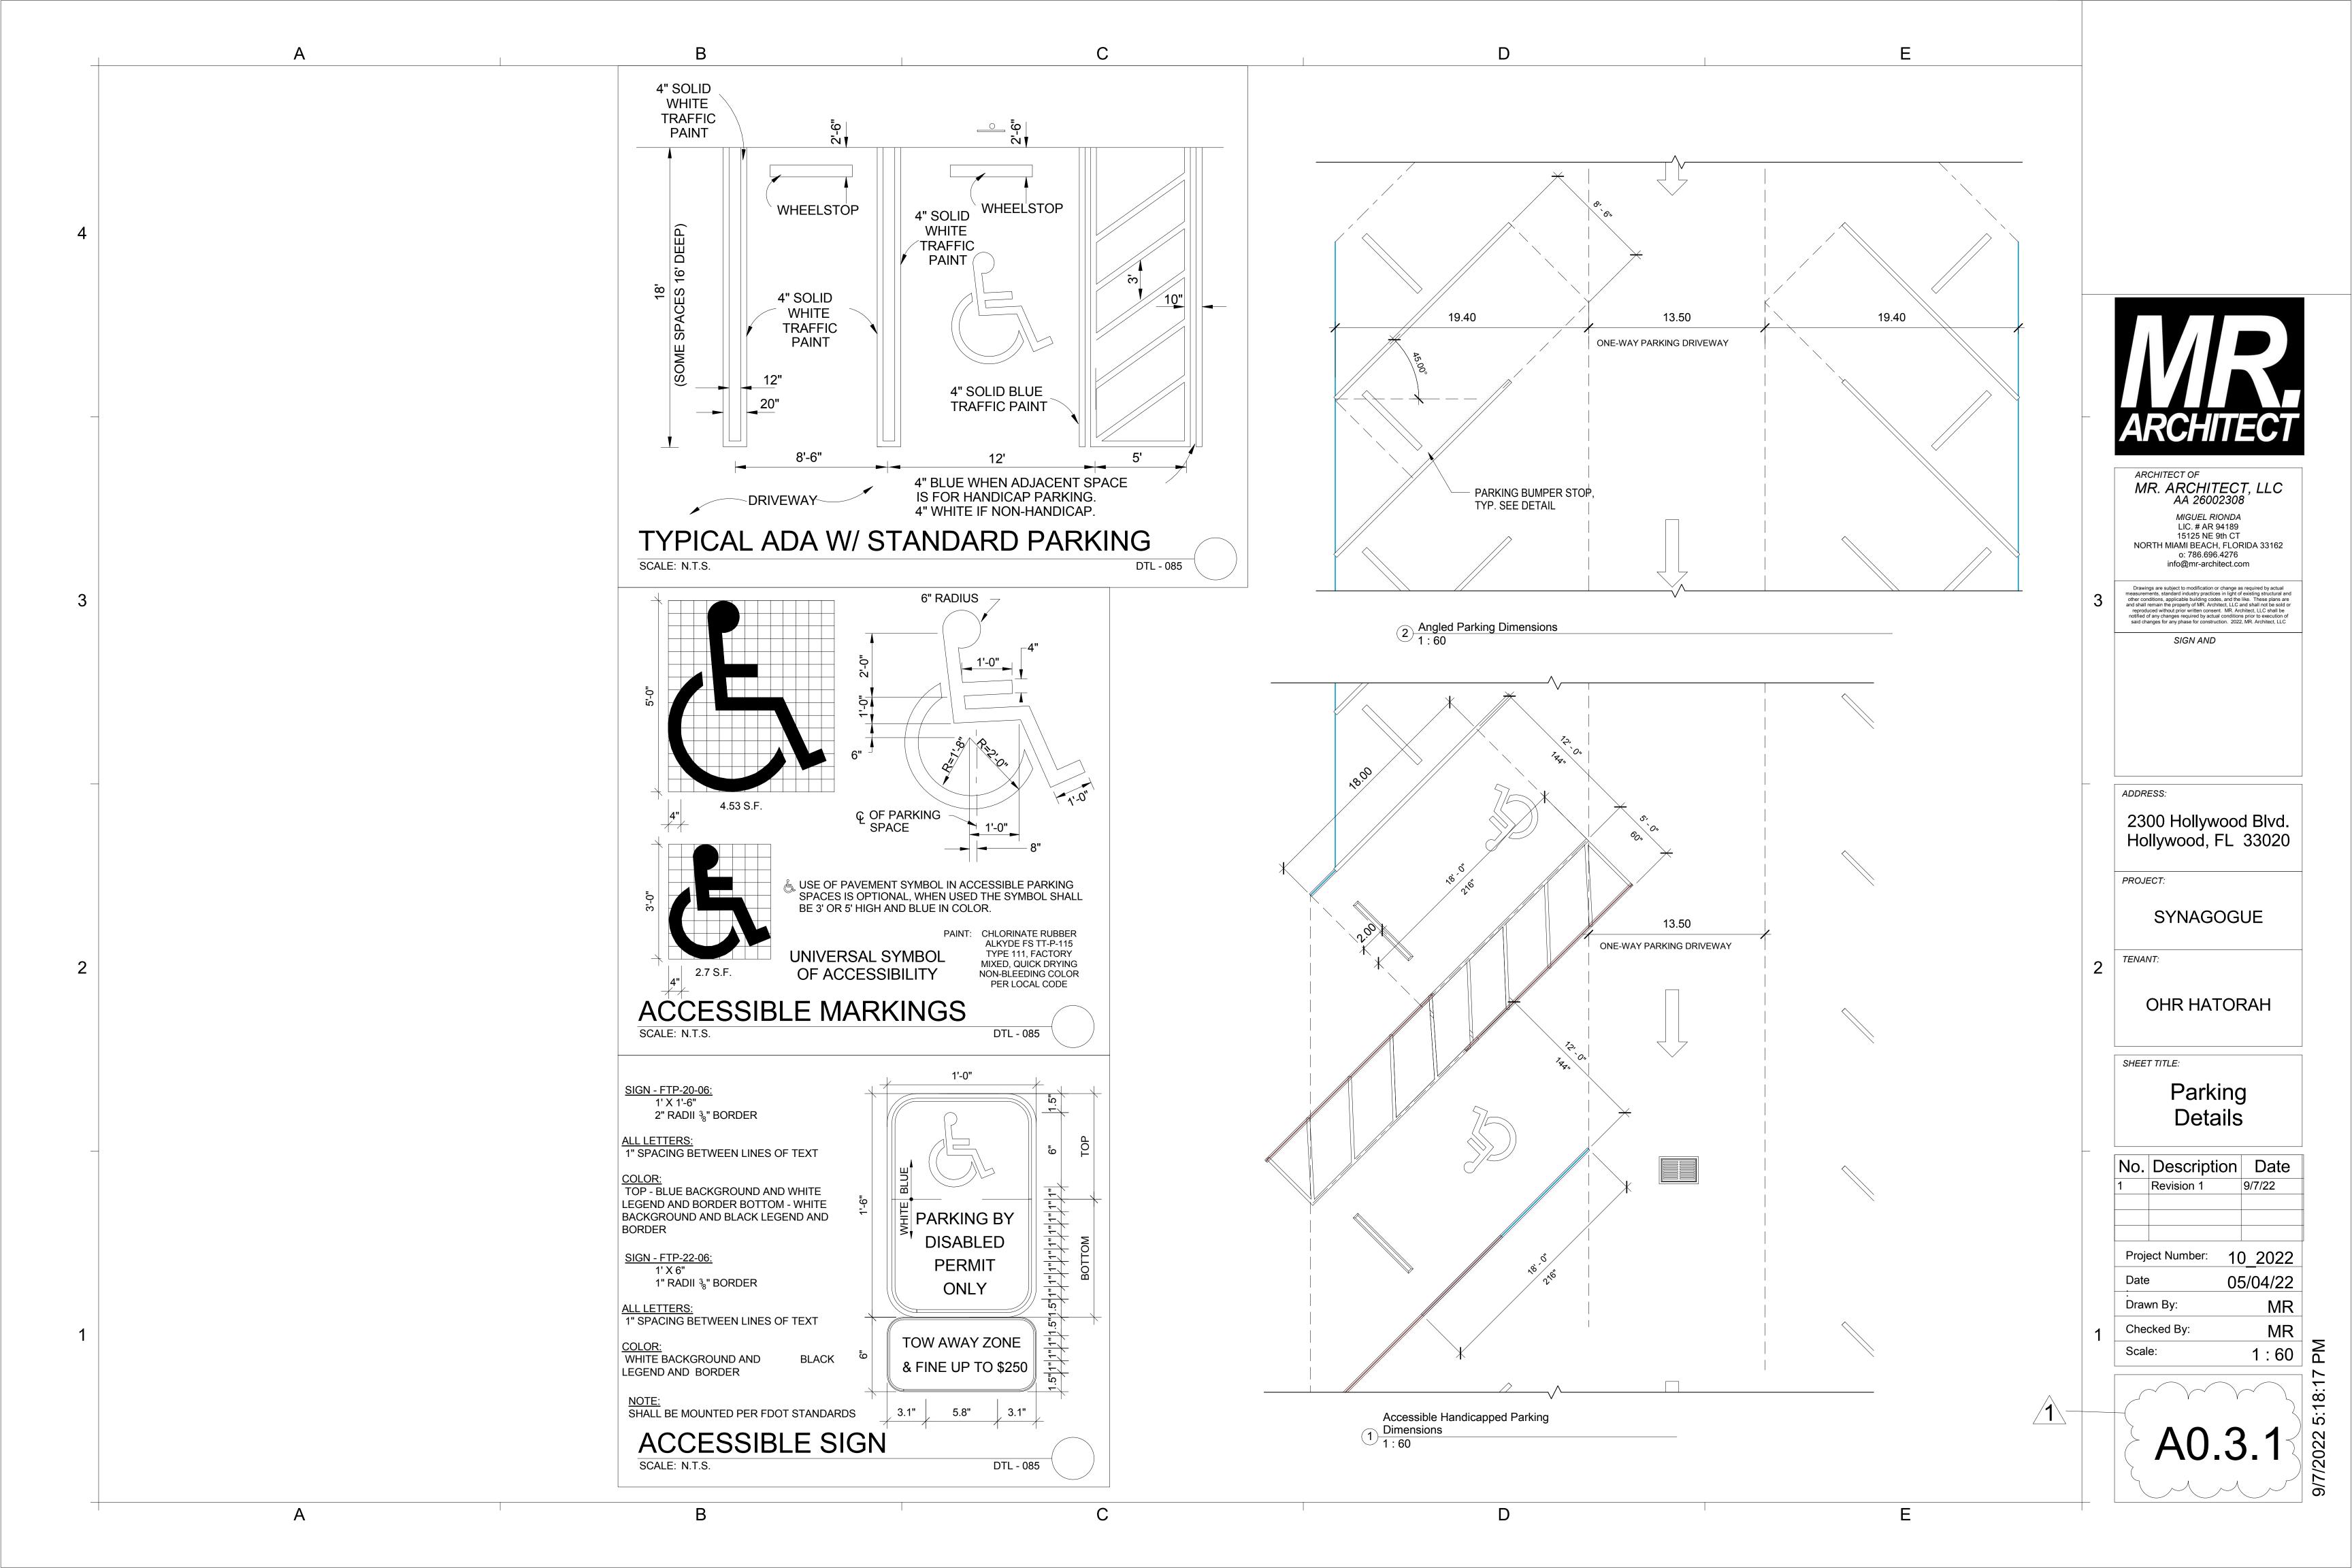



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SIGN AND

ADDRESS:

2300 Hollywood Blvd. Hollywood, FL 33020

PROJECT:

SYNAGOGUE

TENANT:

OHR HATORAH

SHEET TITLE:

Bathroom **Details**

No. Description Date

1	Revision 1	9/7/22
Proj	ect Number:	10_2022
Date)	05/04/22
Drav	vn By:	MRA

Drawn By:

Checked By:

MR Scale: As indicated





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ADDRESS:

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PROJECT:

SYNAGOGUE


OHR HATORAH


SHEET TITLE:

Reflected Ceiling Plan


No. Description Date Project Number: 10_2022 05/04/22 Date Drawn By: MR DZ

Checked By: 1/8" = 1'-0" Scale:

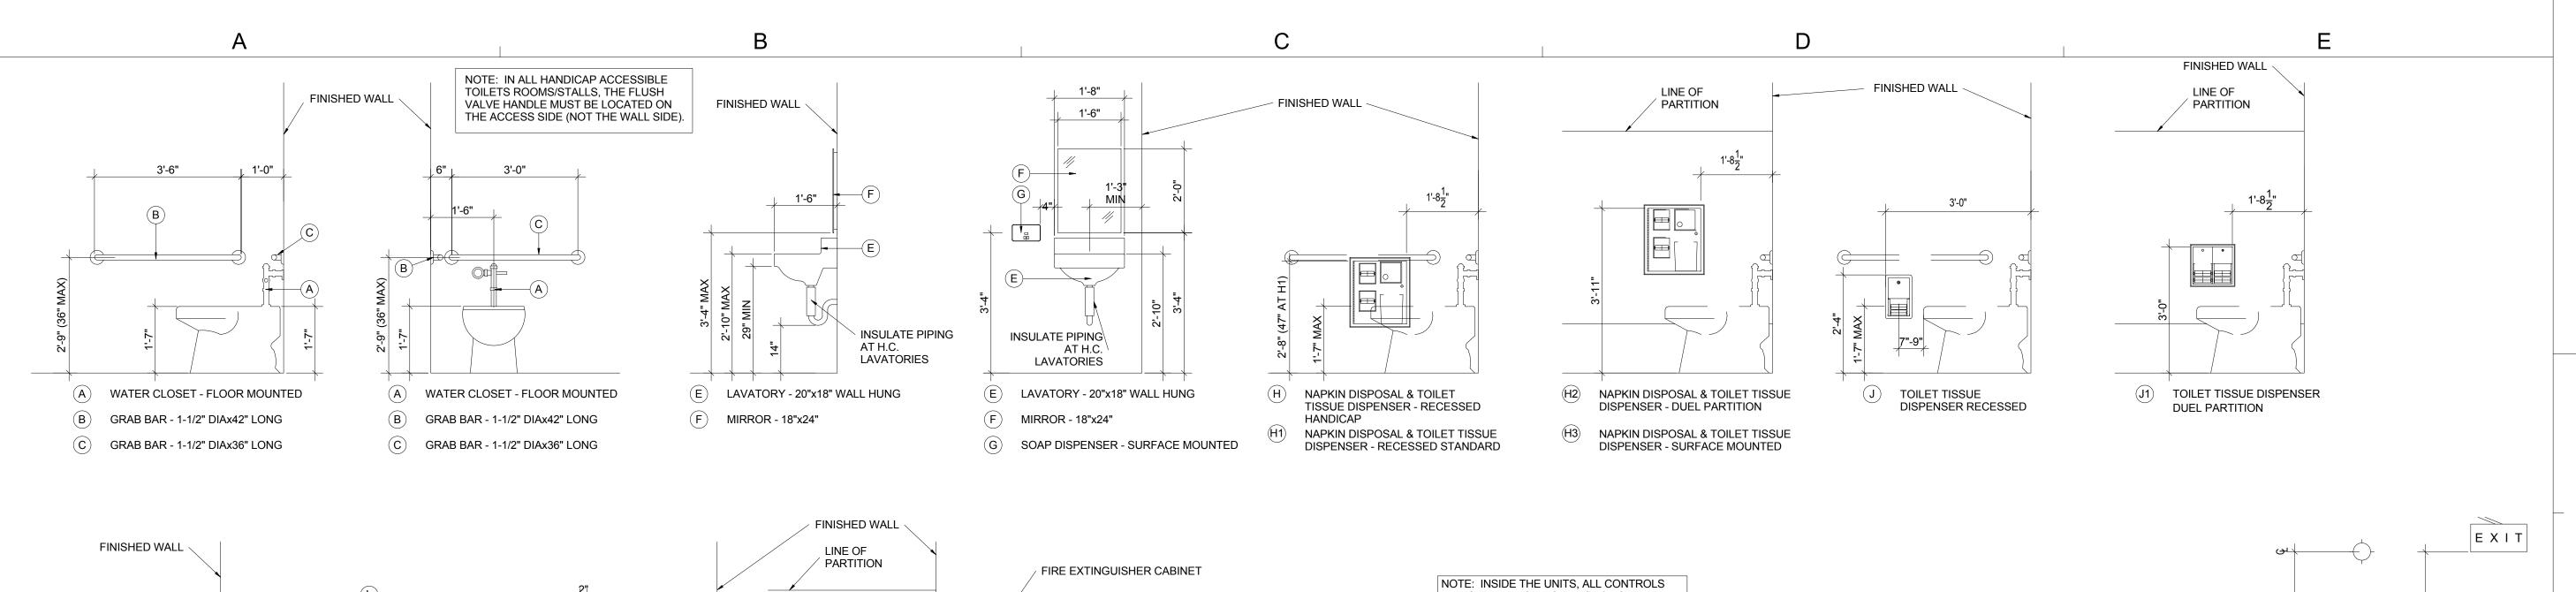

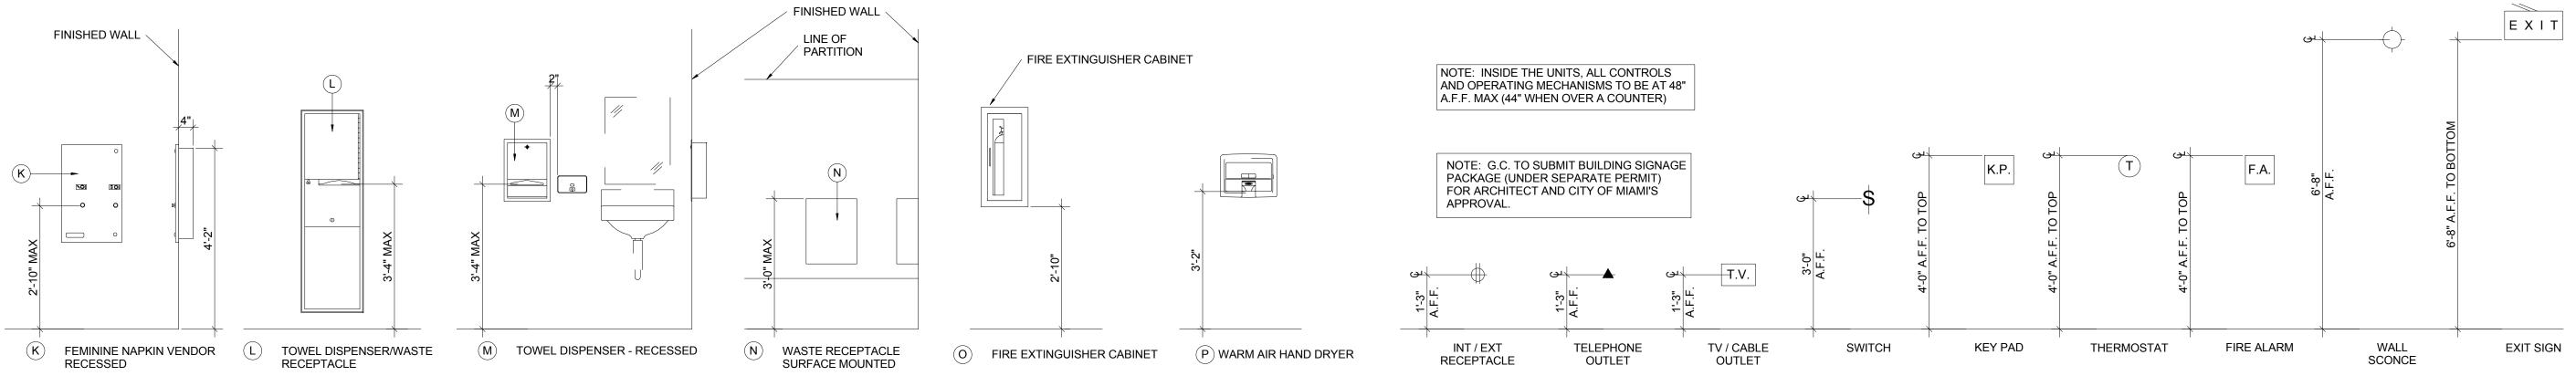

H.C. PLUMBING FIXTURE and ACCESSORY MOUNTING HEIGHTS

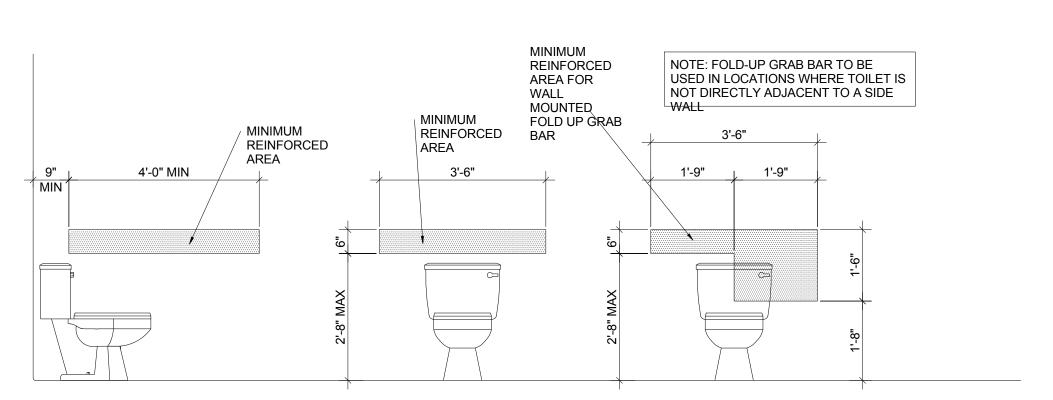

BLOCKING DIMENSIONS INSIDE WALLS FOR GRAB BARS

1. ALL ACCESSIBLE FACILITIES ON THESE PLANS HAVE BEEN DESIGNED TO MEET ALL STATE, COUNTY, AND MUNICIPALITY CODES APPLICABLE.

2. BUILDING ENTRANCE SHALL BE ON AN ACCESSIBLE ROUTE WITH NO CHANGE IN LEVEL OF MORE THAN 1/2" ALONG ROUTE AND MAXIMUM LEVEL CHANGE OF 3/4" AT SLIDING EXTERIOR DOORS ONLY.

3. ALL ENTRY DOORS IN UNITS SHALL PROVIDE A CLEAR OPENING OF 32" WIDE WHEN DOOR IS OPEN AT 90 DEGREES.

4. LIGHT SWITCHES, ELECTRICAL OUTLETS, THERMOSTATS, AND OTHER ENVIRONMENTAL CONTROLS ARE TO BE LOCATED WITH OPERABLE PARTS NO HIGHER THAN 48" AND NO LOWER THAN 15" ABOVE THE FINISHED FLOOR. IF REACH IS OVER AN OBSTRUCTION, SUCH AS A CABINET, HEIGHT SHALL BE 44" FOR FORWARD APPROACH (NOTE: OBSTRUCTIONS MAY NOT EXTEND MORE THAN 25" FROM WALL).

5. BATHROOMS SHALL BE PROVIDED WITH REINFORCEMENT IN WALLS TO ALLOW LATER INSTALLATION OF GRAB BARS AROUND THE TOILETS, TUBS, AND SHOWERS. SUCH REINFORCEMENT SHALL BE INSTALLED ACCORDING TO THE ILLUSTRATIONS SHOWN. PARALLEL APPROACH BY A WHEELCHAIR MUST BE PROVIDED IN FRONT OF LAVATORIES. IF PARALLEL APPROACH IS NOT POSSIBLE, LAVATORY CABINET BASE MUST BE REMOVABLE TO ALLOW FORWARD APPROACH KNEE CLEARANCE. WHERE DOOR SWINGS INTO BATHROOM THERE MUST BE A CLEAR FLOOR SPACE OF 30"x48" TO POSITION A WHEELCHAIR WITHIN BATHROOM. TOILETS SHOULD BE INSTALLED SO AS TO ALLOW A GRAB BAR TO BE INSTALLED ON ONE SIDE OF FIXTURE. REFER TO DIAGRAMS ON THIS SHEET.

6. LAVATORY COUNTERTOP HEIGHT TO BE 34" A.F.F. WITH A MINIMUM CLEARANCE OF 29" A.F.F. TO THE BOTTOM OF THE APRON. ALL LAVATORIES TO HAVE SKIRTS.

7. FAUCETS TO BE LEVER OPERATED, PUSH TYPE, OR ELECTRONICALLY CONTROLLED MECHANISMS. IF SELF-CLOSING VALVES ARE USED THE FAUCET SHALL REMAIN OPEN FOR AT LEAST 10 SECONDS.

8. WATER CLOSET AND URINAL FLUSH CONTROLS MUST BE 44" MINIMUM A.F.F. CONTROLS SHALL BE HAND OPERATED OR AUTOMATIC. CONTROLS MUST BE OPERABLE WITH ONE HAND AND MUST NOT REQUIRE TIGHT GRASPING PINCHING OR TWISTING OF WRIST. FORCE REQUIRED TO ACTIVATE CONTROLS MUST BE NO GREATER THAN 5 LBS.

9. ACCESSIBLE TOILET AND BATHROOM MUST BE IDENTIFIED BY A SIGN SHOWING THE INTERNATIONAL SYMBOL OF ACCESSIBILITY.

10. SWITCHES AND THERMOSTATS SHALL BE LOCATED ADJACENT TO A WALL EDGE OR A DOOR JAMB. SWITCHES SHALL BE GANGED WHEREVER POSSIBLE.

11. BACKING FOR GRAB BARS SHALL BE 12 GAUGE STEEL AND RESIST A MAXIMUM OF 500 LBS. OF FORCE IN ANY DIRECTION.

ELECTRICAL and ACCESSORY MOUNTING HEIGHTS



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SIGN AND

ADDRESS:

2300 Hollywood Blvd. Hollywood, FL 33020

PROJECT:

SYNAGOGUE

TENANT:

OHR HATORAH

SHEET TITLE:


ADA Sheet

No.	Descripti	on D	ate
Proje	ect Number:	10_2	022
Date	:	05/04	1/22

Drawn By:

Checked By:

Scale:

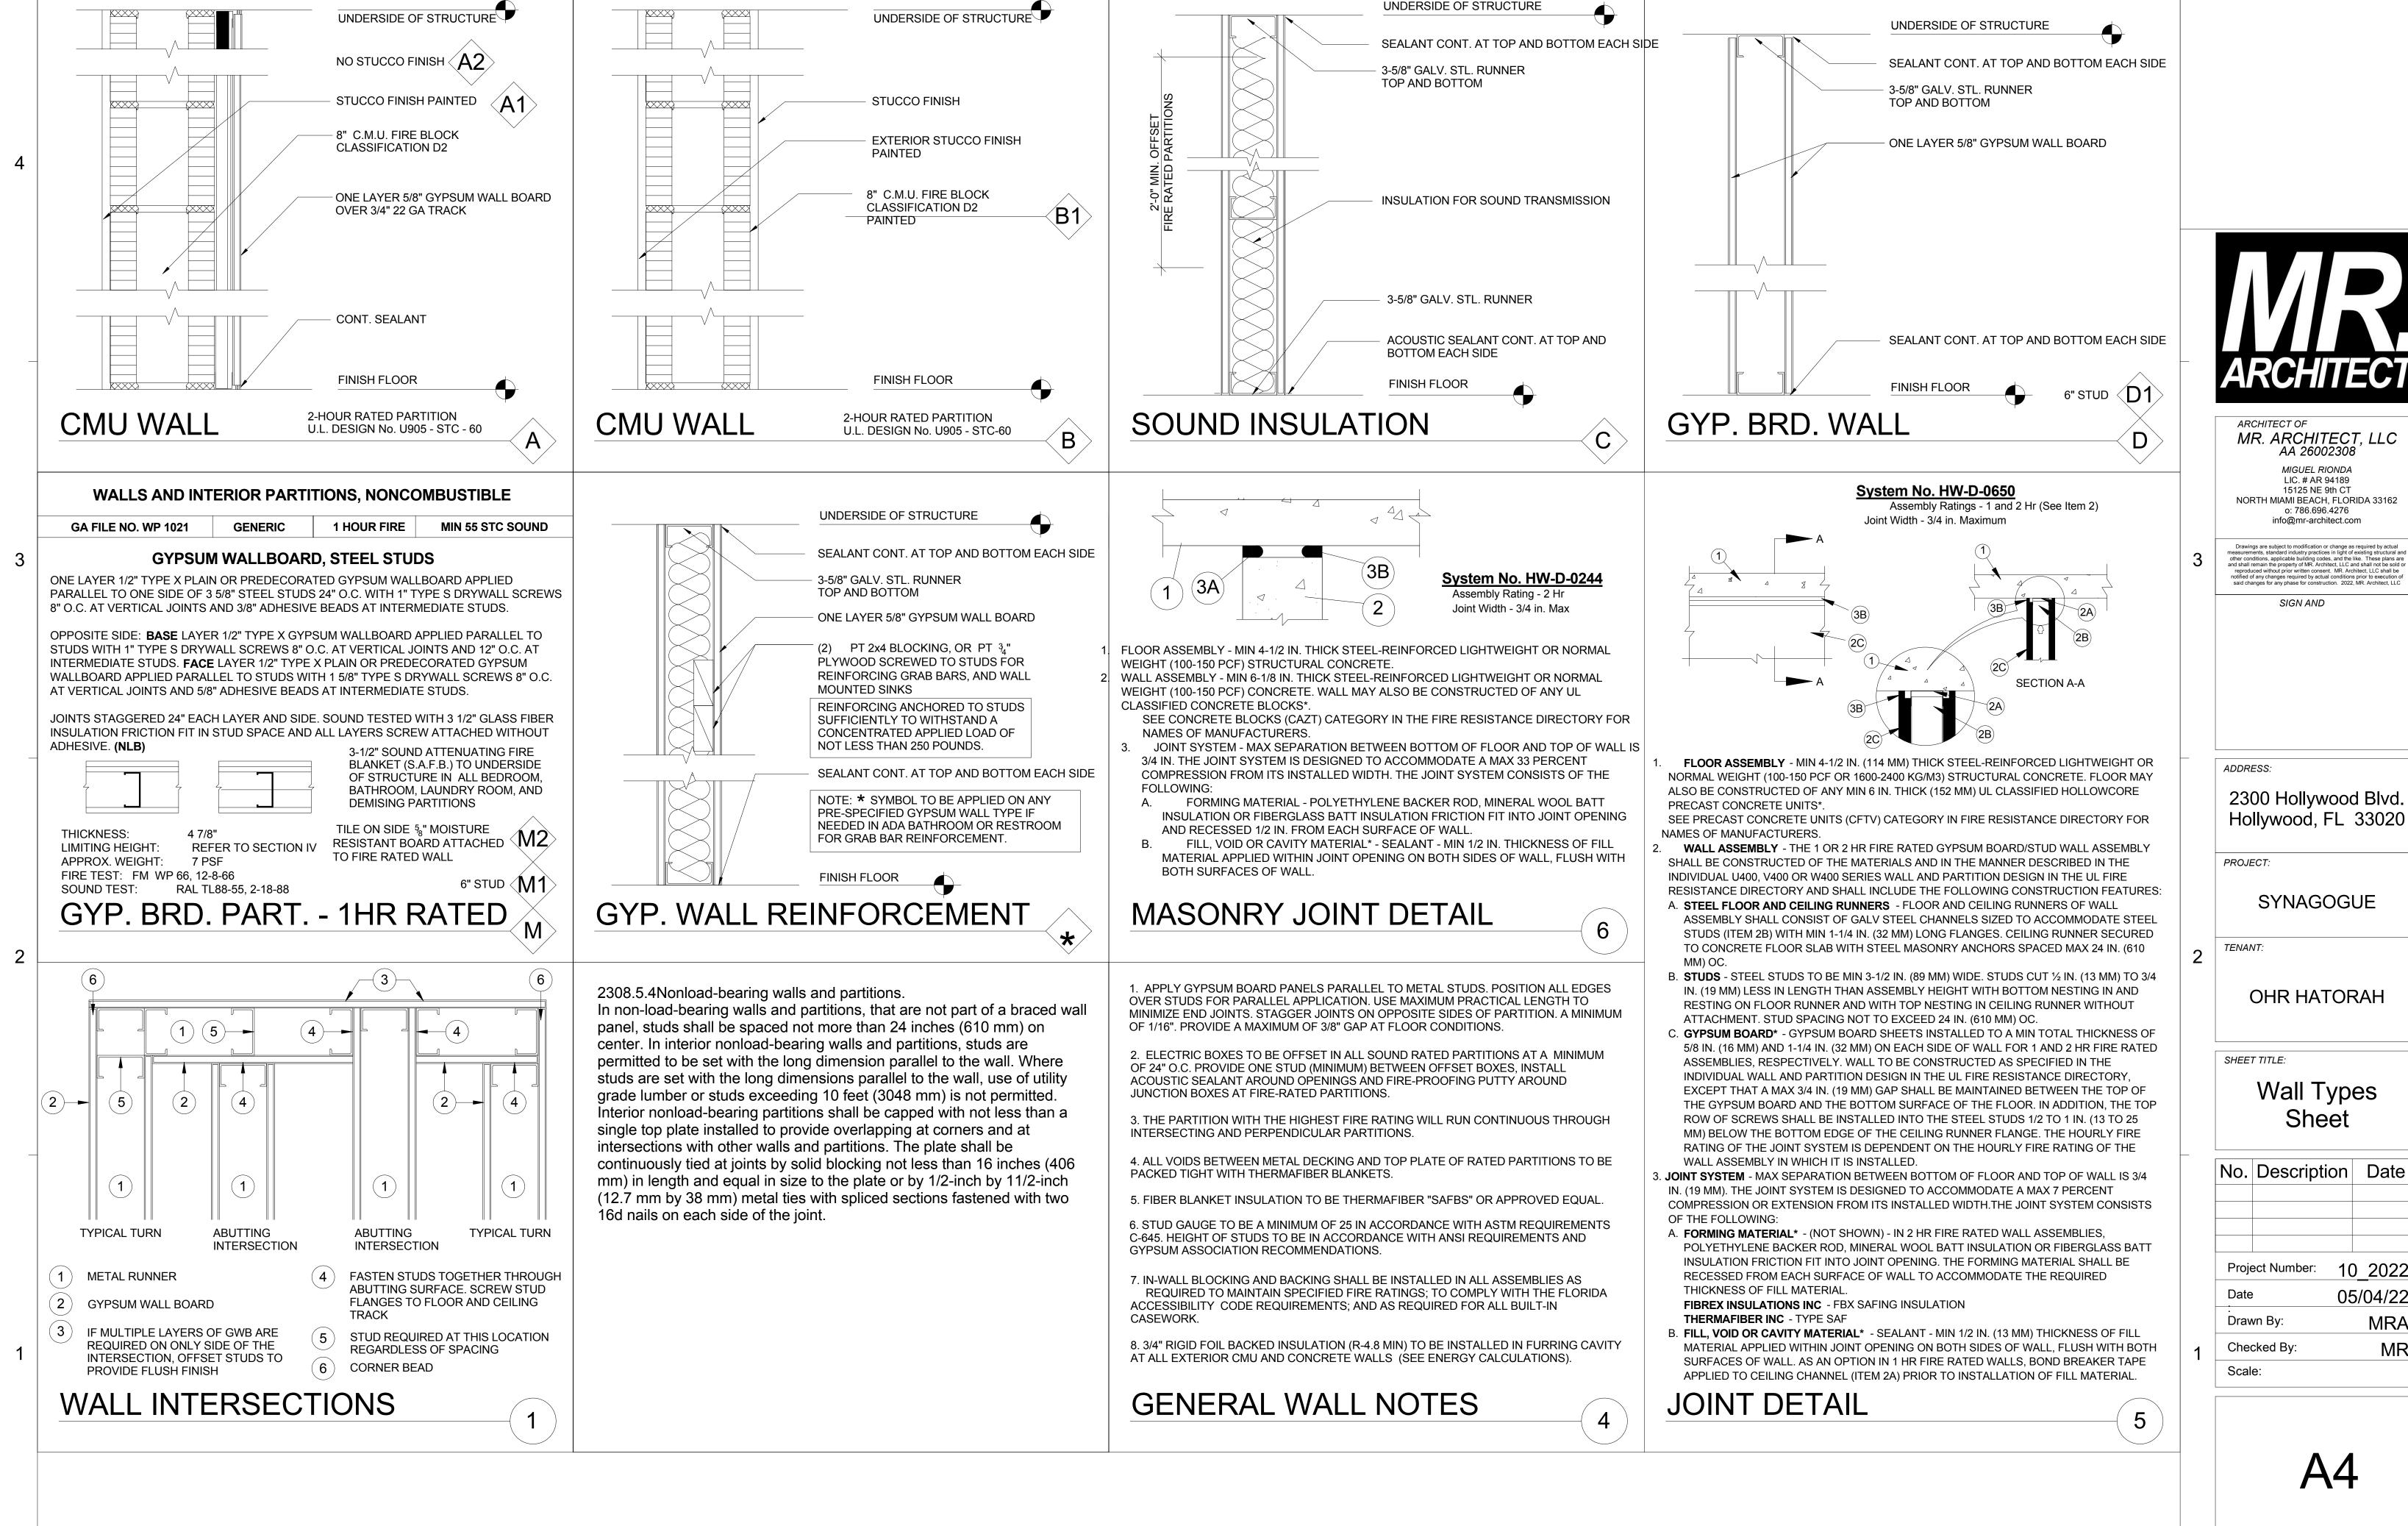


ARCHITECT

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Hollywood, FL 33020

10 2022

05/04/22 MRA MR

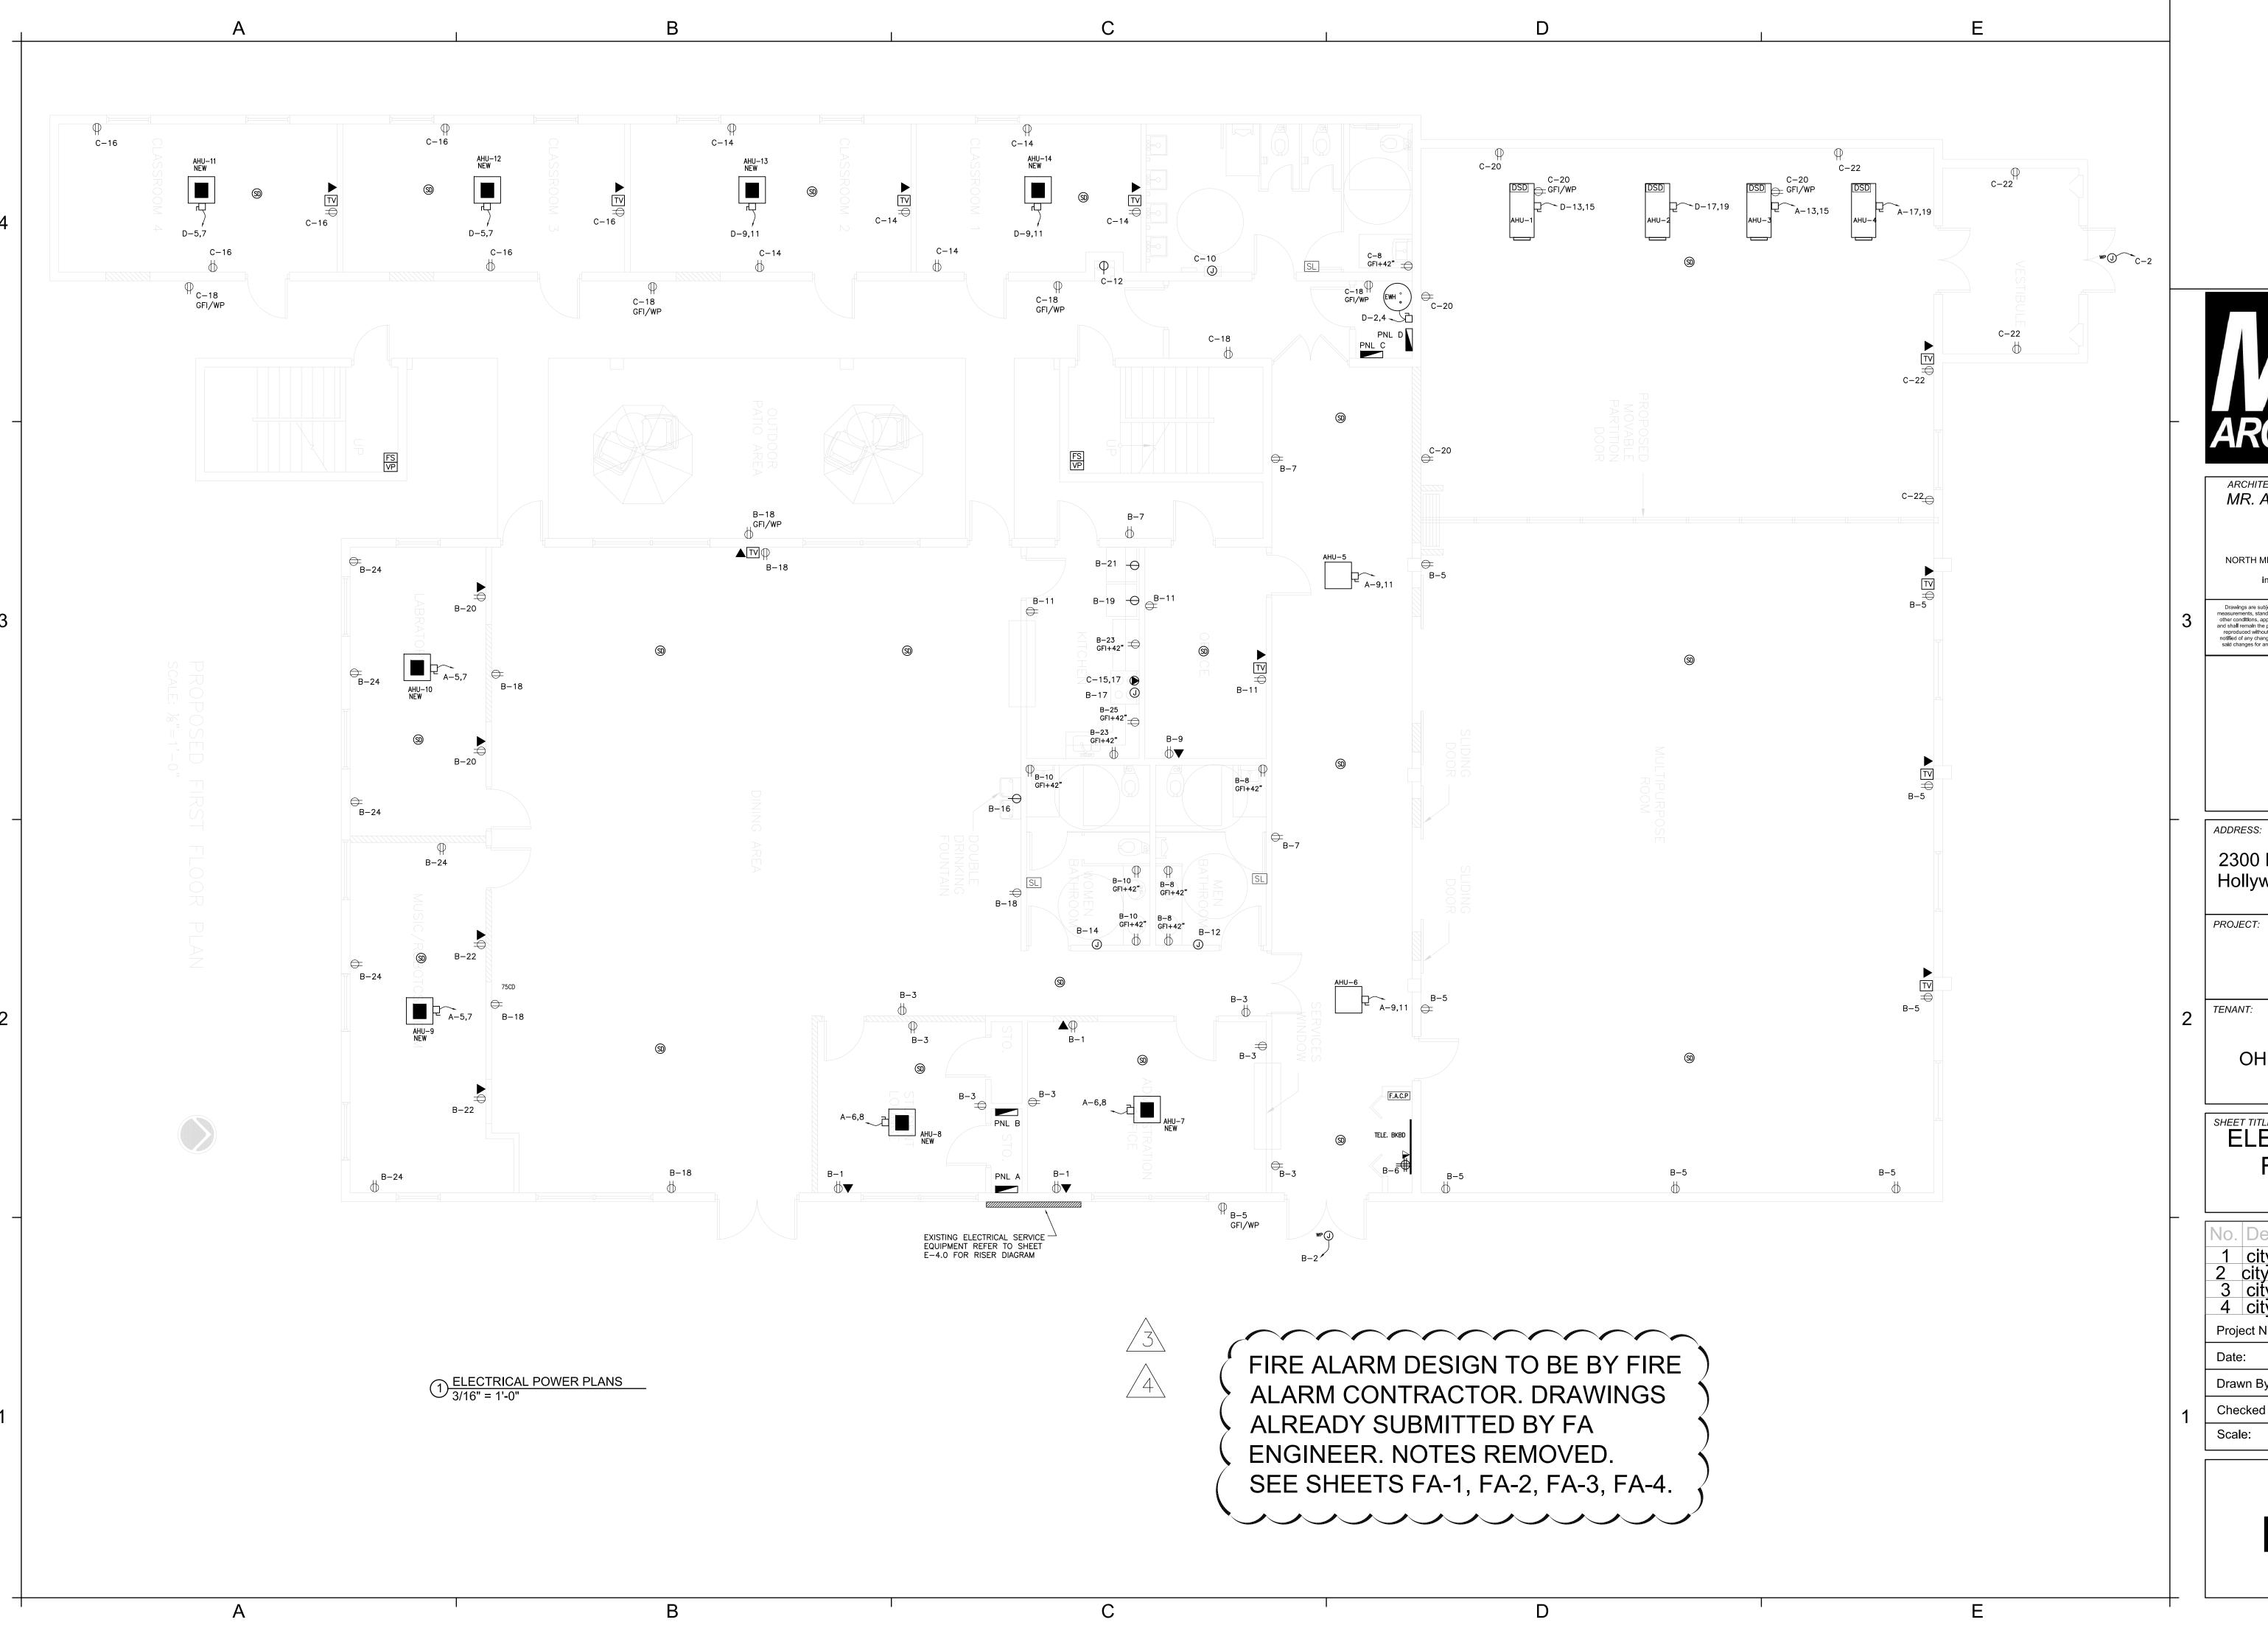

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SIGN AND SEAL:

2300 Hollywood Blvd. Hollywood, FL 33020

School

OHR HATORAH

SHEET TITLE:
ELECTRICAL **FLOOR** PLAN

No. Description Date 1 city comm 9/06/22 2 city comm 10/24/22 3 city comm 2/01/23 4 city comm 2/22/23

Project Number: 52 2021


10/5/21 Drawn By: MR


Checked By:

1/8" = 1'-0"

E-1.0

DΖ

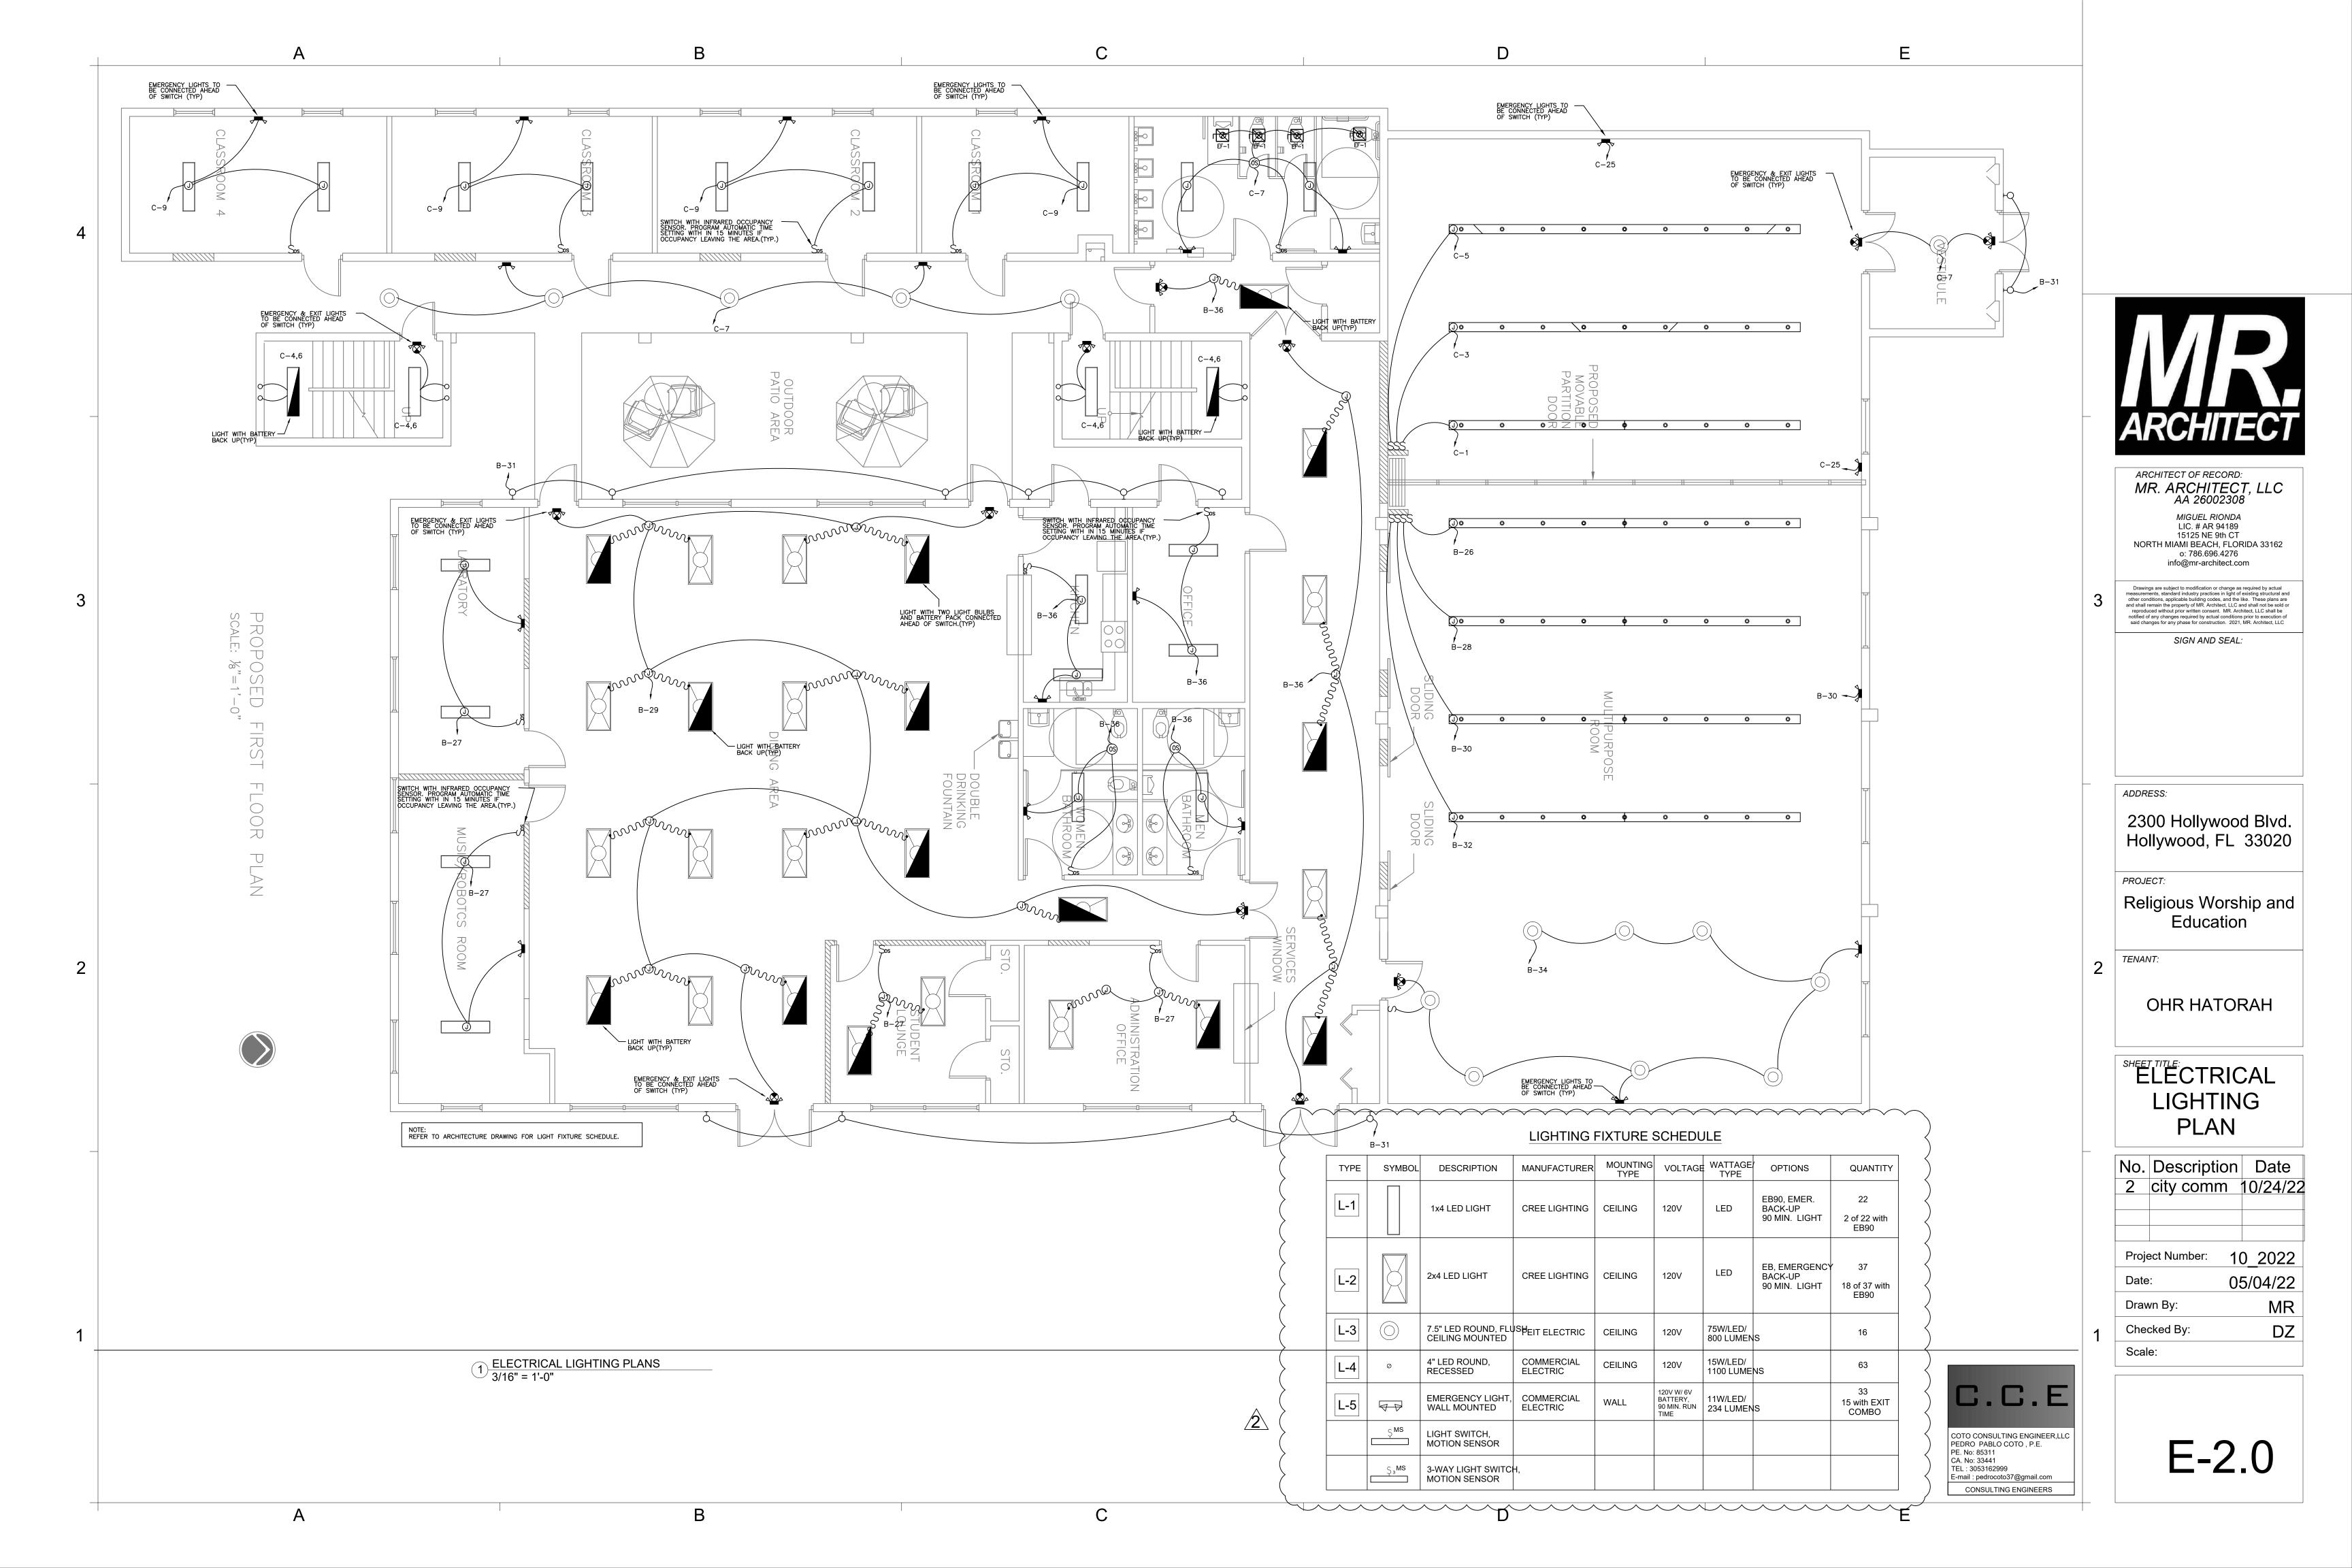

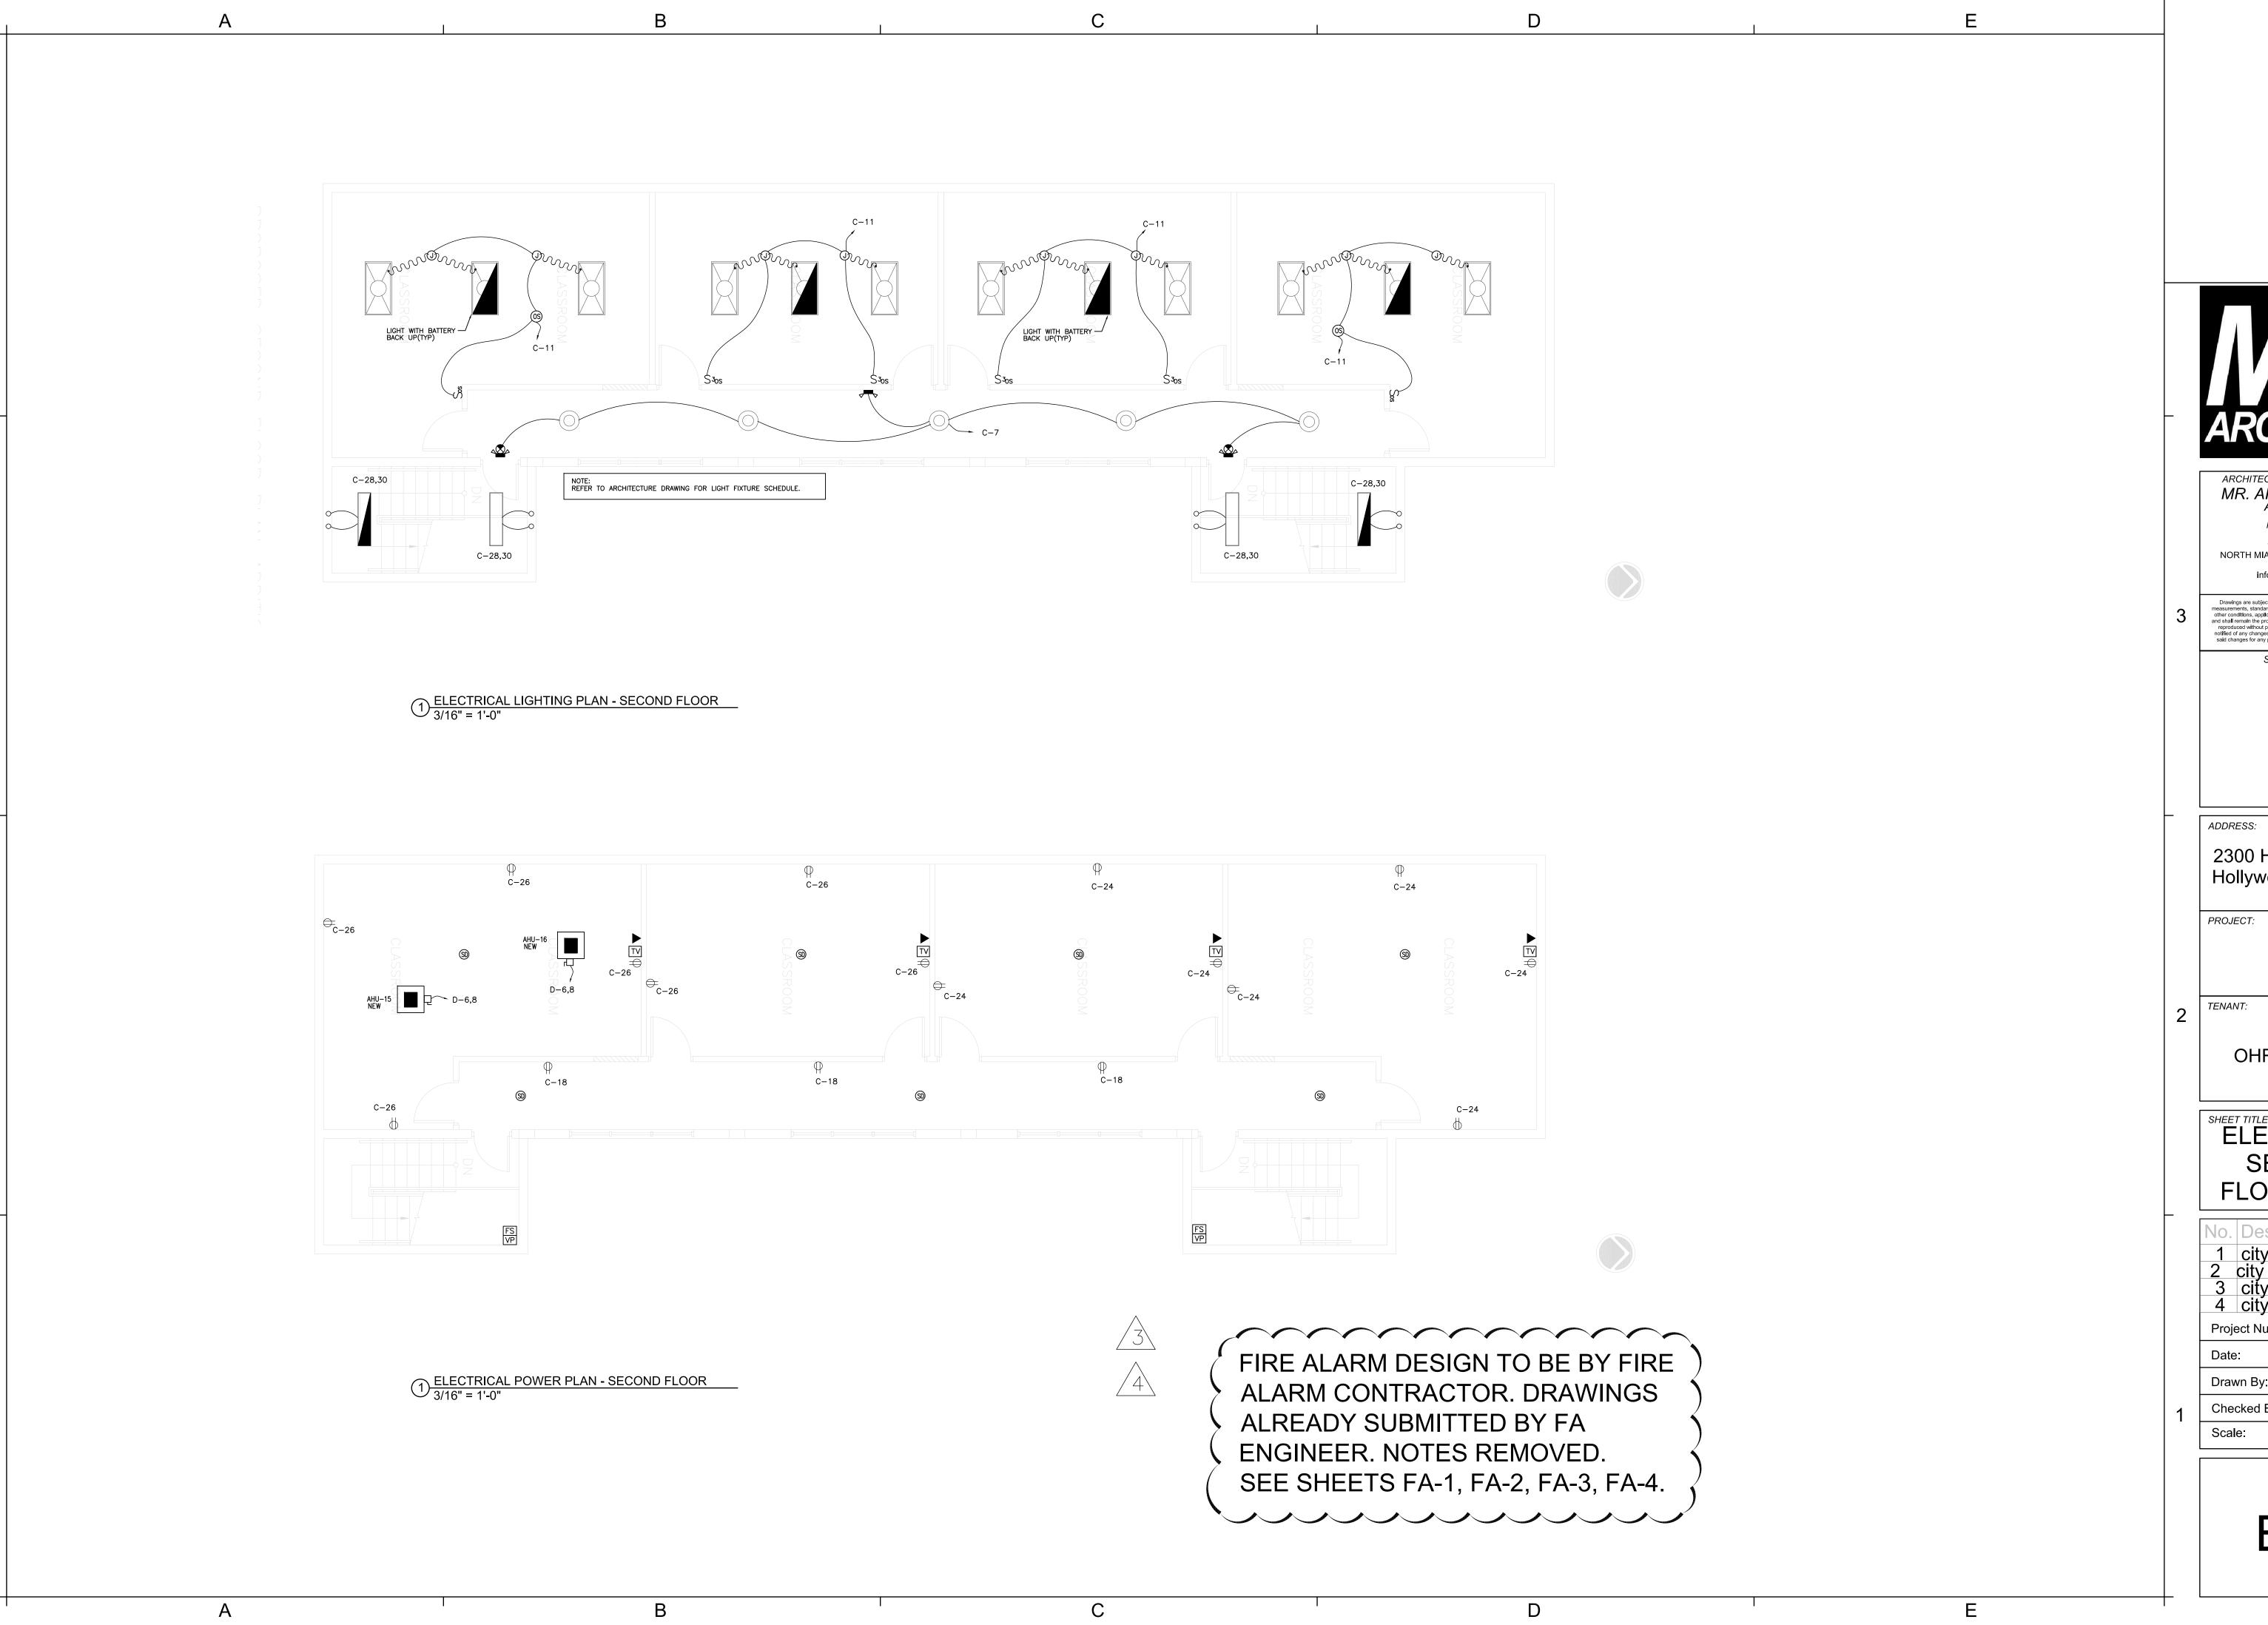

ARCHITECT OF RECORD: MR. ARCHITECT, LLC AA 26002308 MIGUEL RIONDA LIC. # AR 94189 15125 NE 9th CT NORTH MIAMI BEACH, FLORIDA 33162 o: 786.696.4276 info@mr-architect.com

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SIGN AND SEAL:

2300 Hollywood Blvd. Hollywood, FL 33020

School

OHR HATORAH

SHEET TITLE:
ELECTRICAL SECOND FLOOR PLAN

No. Description Date 1 city comm 9/06/22 2 city comm 10/24/22 3 city comm 2/01/23 4 city comm 2/22/23

Project Number: 52 2021


10/5/21 Drawn By: MR

Checked By:


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DΖ

E-3.0

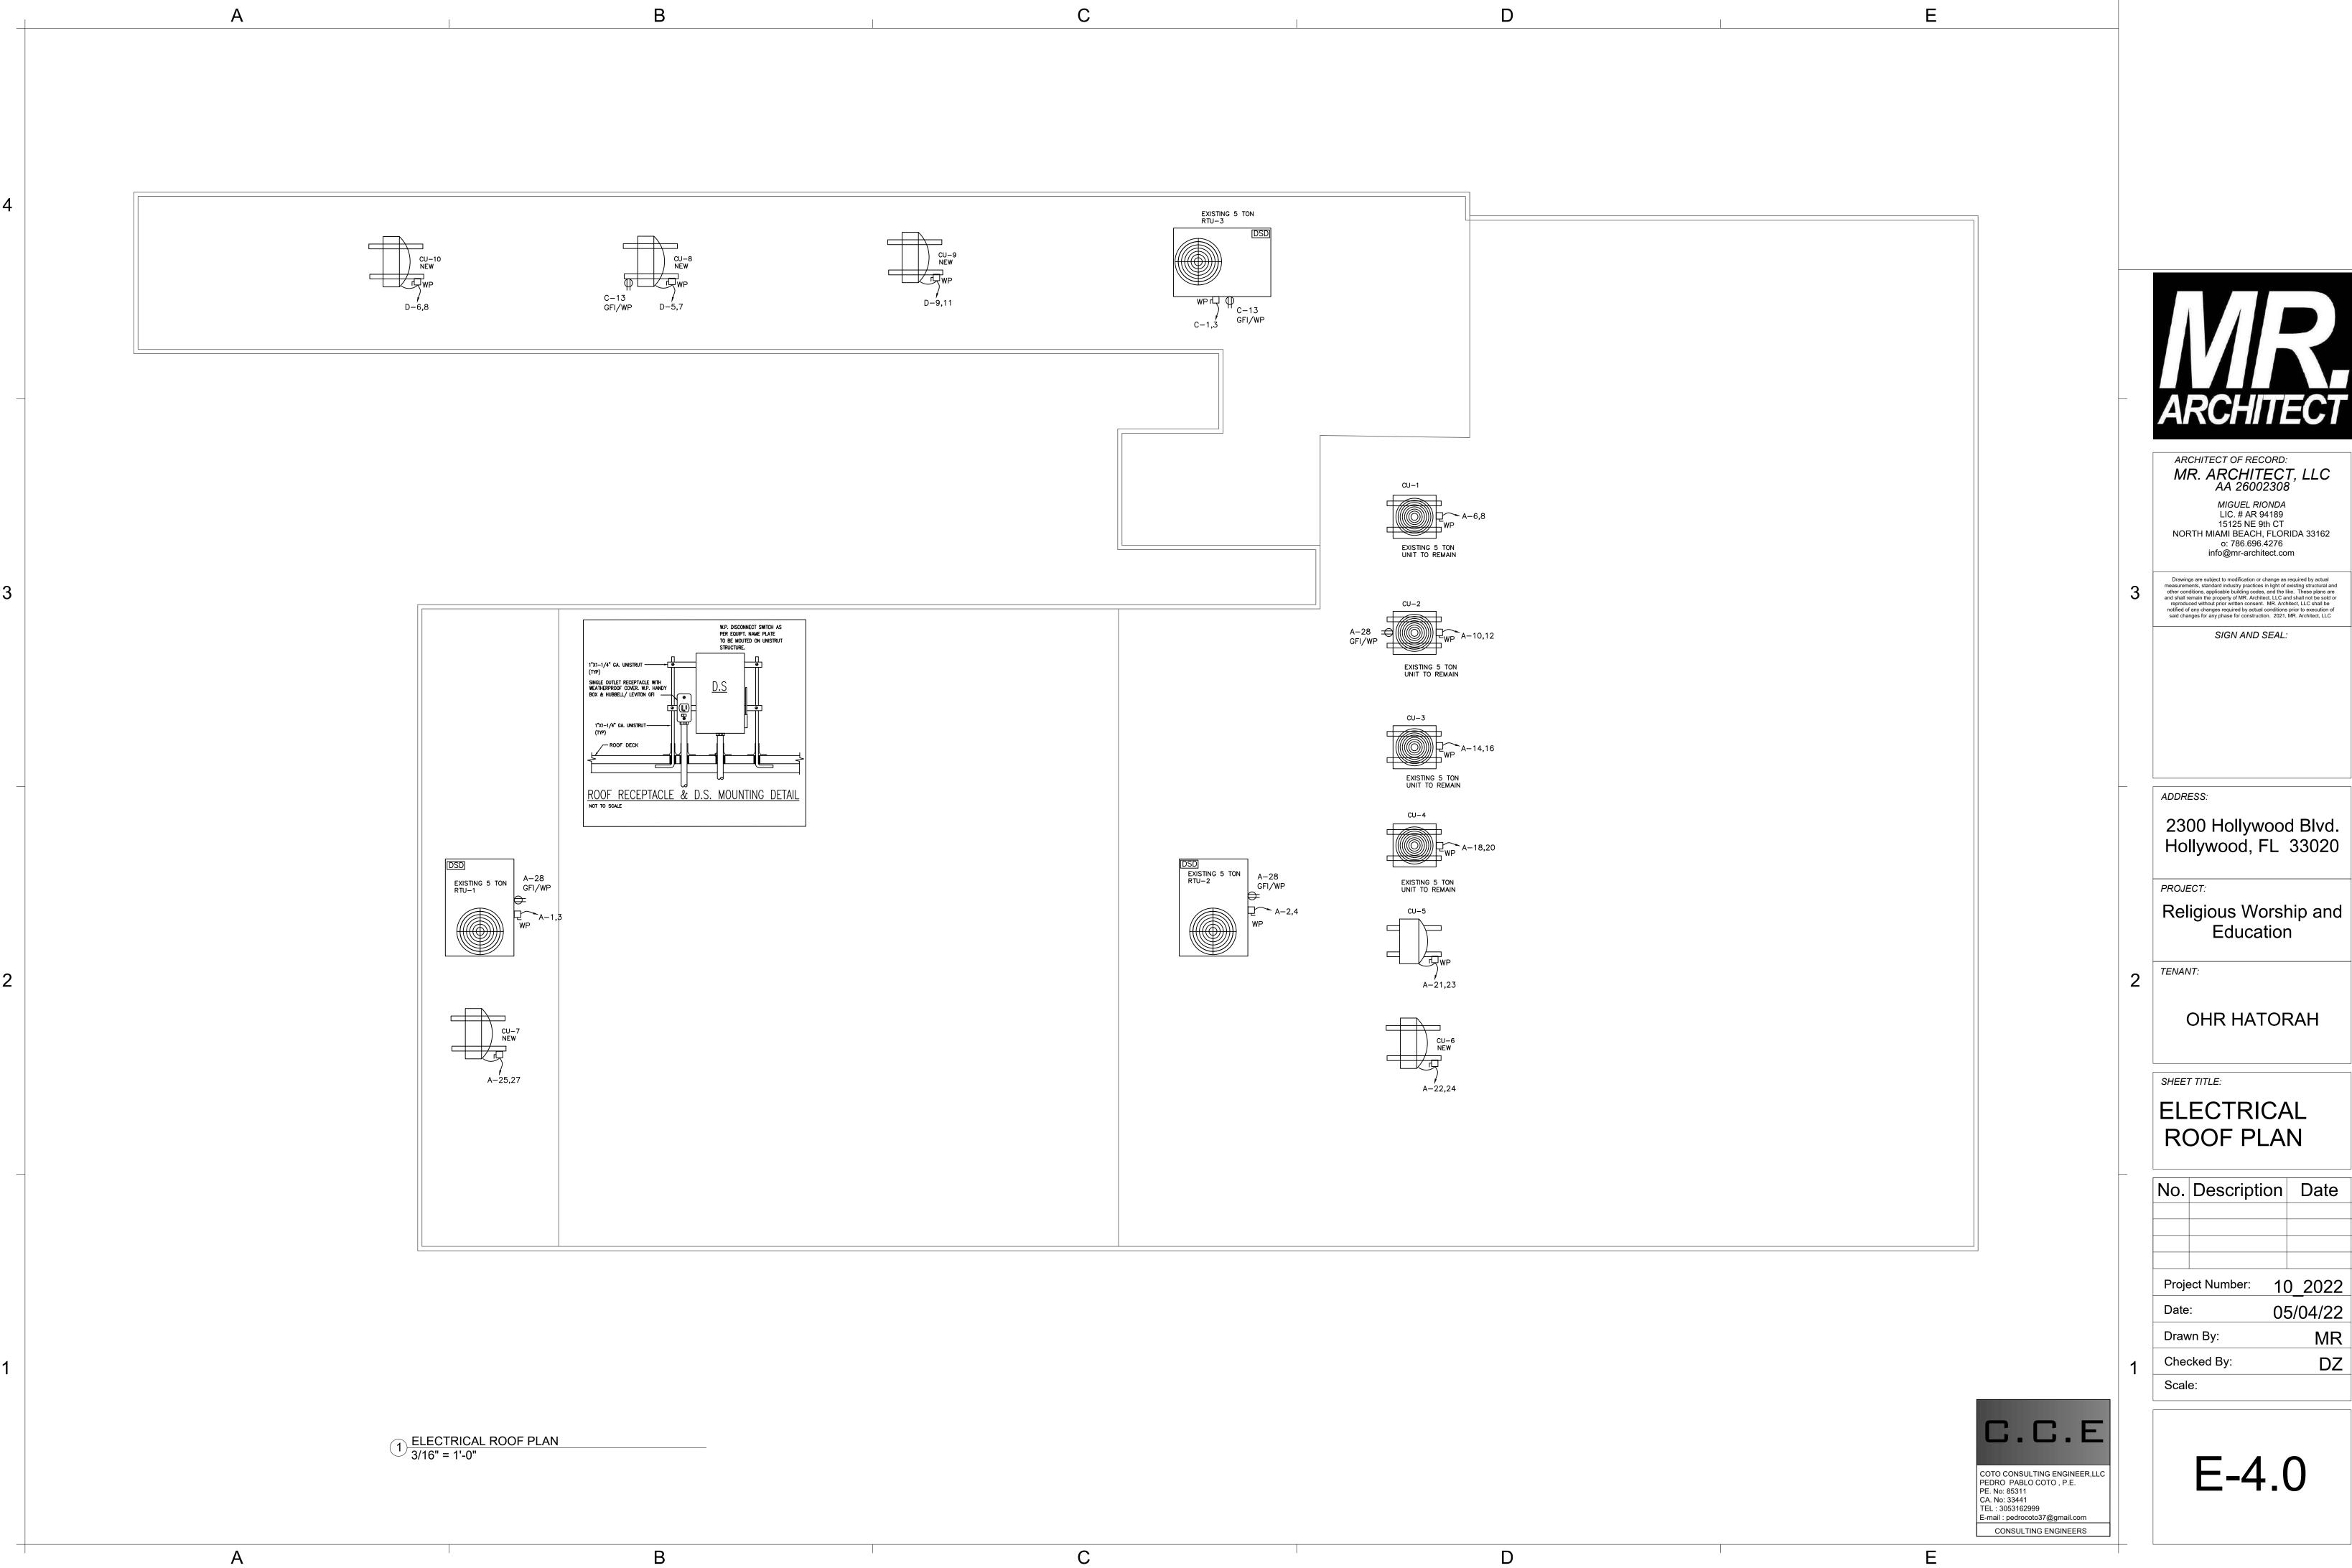

10_2022 05/04/22 MR DZ

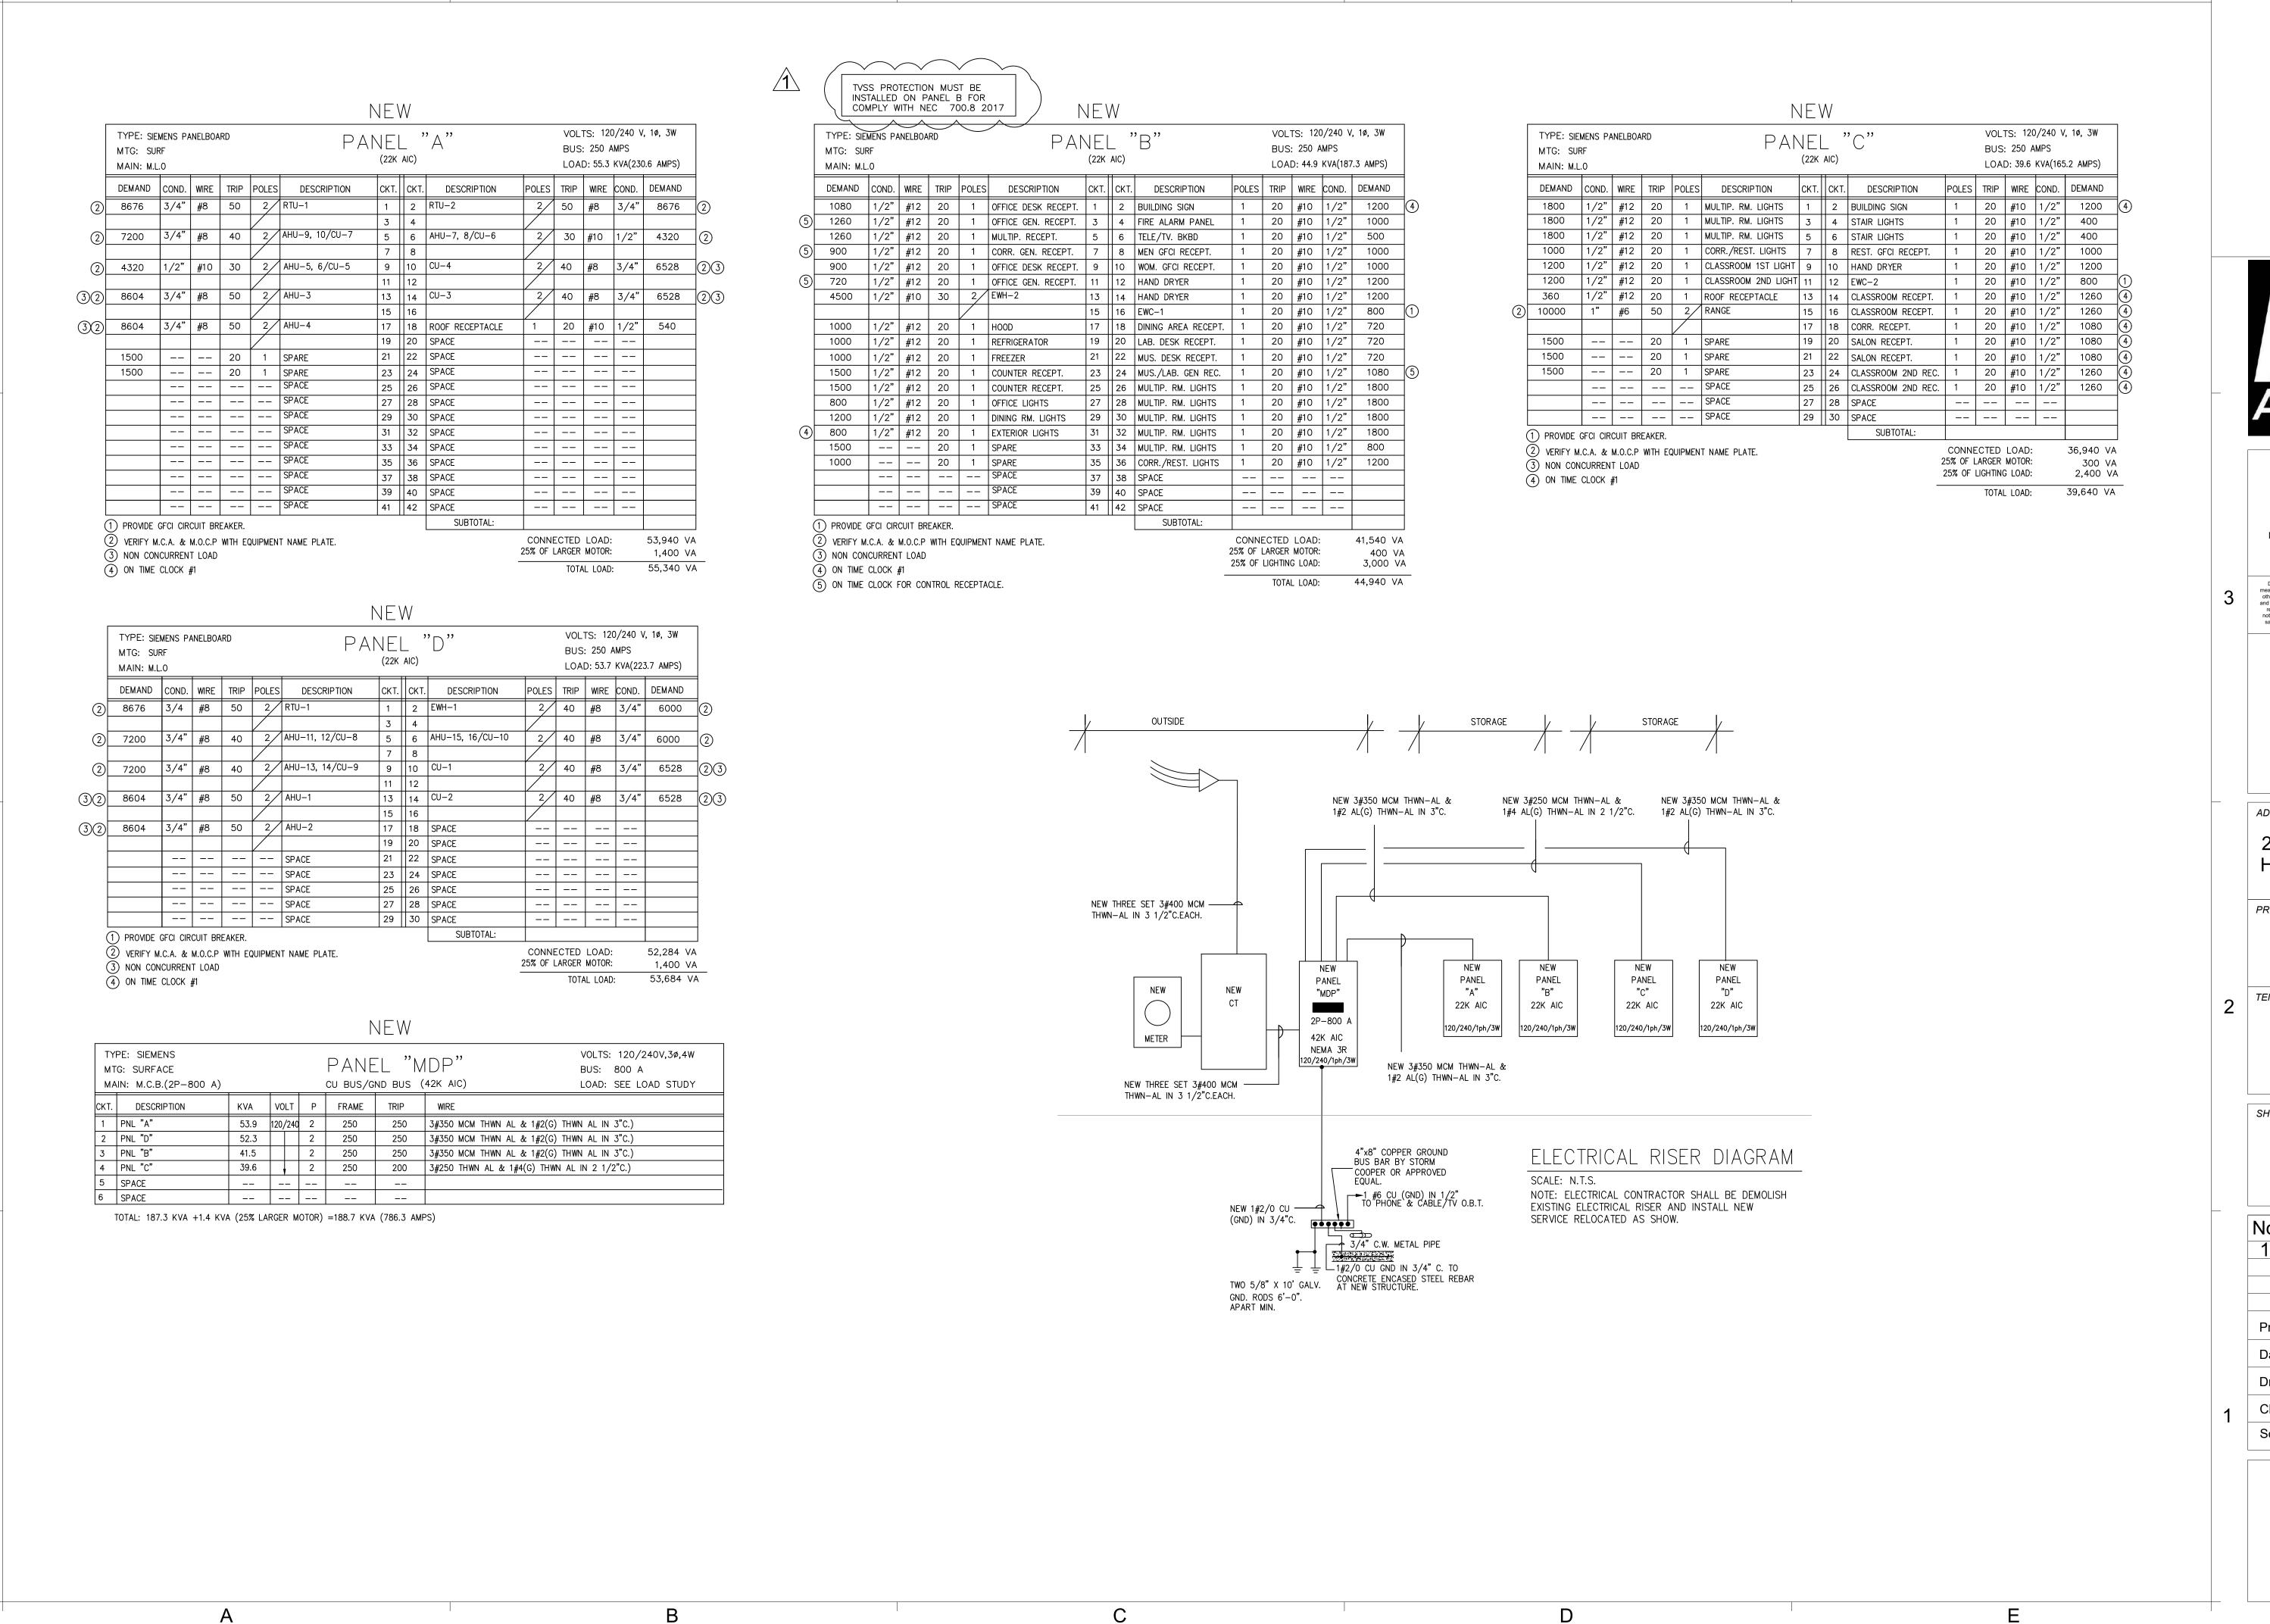

2

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ARCHITECT OF RECORD: MR. ARCHITECT, LLC AA 26002308 MIGUEL RIONDA LIC. # AR 94189 15125 NE 9th CT NORTH MIAMI BEACH, FLORIDA 33162 o: 786.696.4276 info@mr-architect.com

measurements, standard industry practices in light of existing structural and other conditions, applicable building codes, and the like. These plans are and shall remain the property of MR. Architect, LLC and shall not be sold or reproduced without prior written consent. MR. Architect, LLC shall be notified of any changes required by actual conditions prior to execution of said changes for any phase for construction. 2021, MR. Architect, LLC

SIGN AND SEAL:

ADDRESS: 2300 Hollywood Blvd. Hollywood, FL 33020

PROJECT:

School

TENANT:

OHR HATORAH

SHEET TITLE:
ELECTRICAL PANELS & **RISER**

No. Description Date 1 city comm 09/06/22 52 2021 Project Number: 10/5/21 Date: MR Drawn By:

Checked By: 1/8" = 1'-0"

E-5.0

DΖ

ARCHITECT OF RECORD: MR. ARCHITECT, LLC AA 26002308 MIGUEL RIONDA LIC. # AR 94189 15125 NE 9th CT NORTH MIAMI BEACH, FLORIDA 33162 o: 786.696.4276 info@mr-architect.com

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2300 Hollywood Blvd. Hollywood, FL 33020

School

OHR HATORAH

ELECTRICAL NOTES & **LEGENDS**

No. Description Date city comm | 9/06/22 city comm 10/24/22 city comm | 2/01/23 city comm | 2/22/23

52 2021 Project Number:


10/5/21 Drawn By: MR

Checked By:

E-6.

1/8" = 1'-0"

DΖ

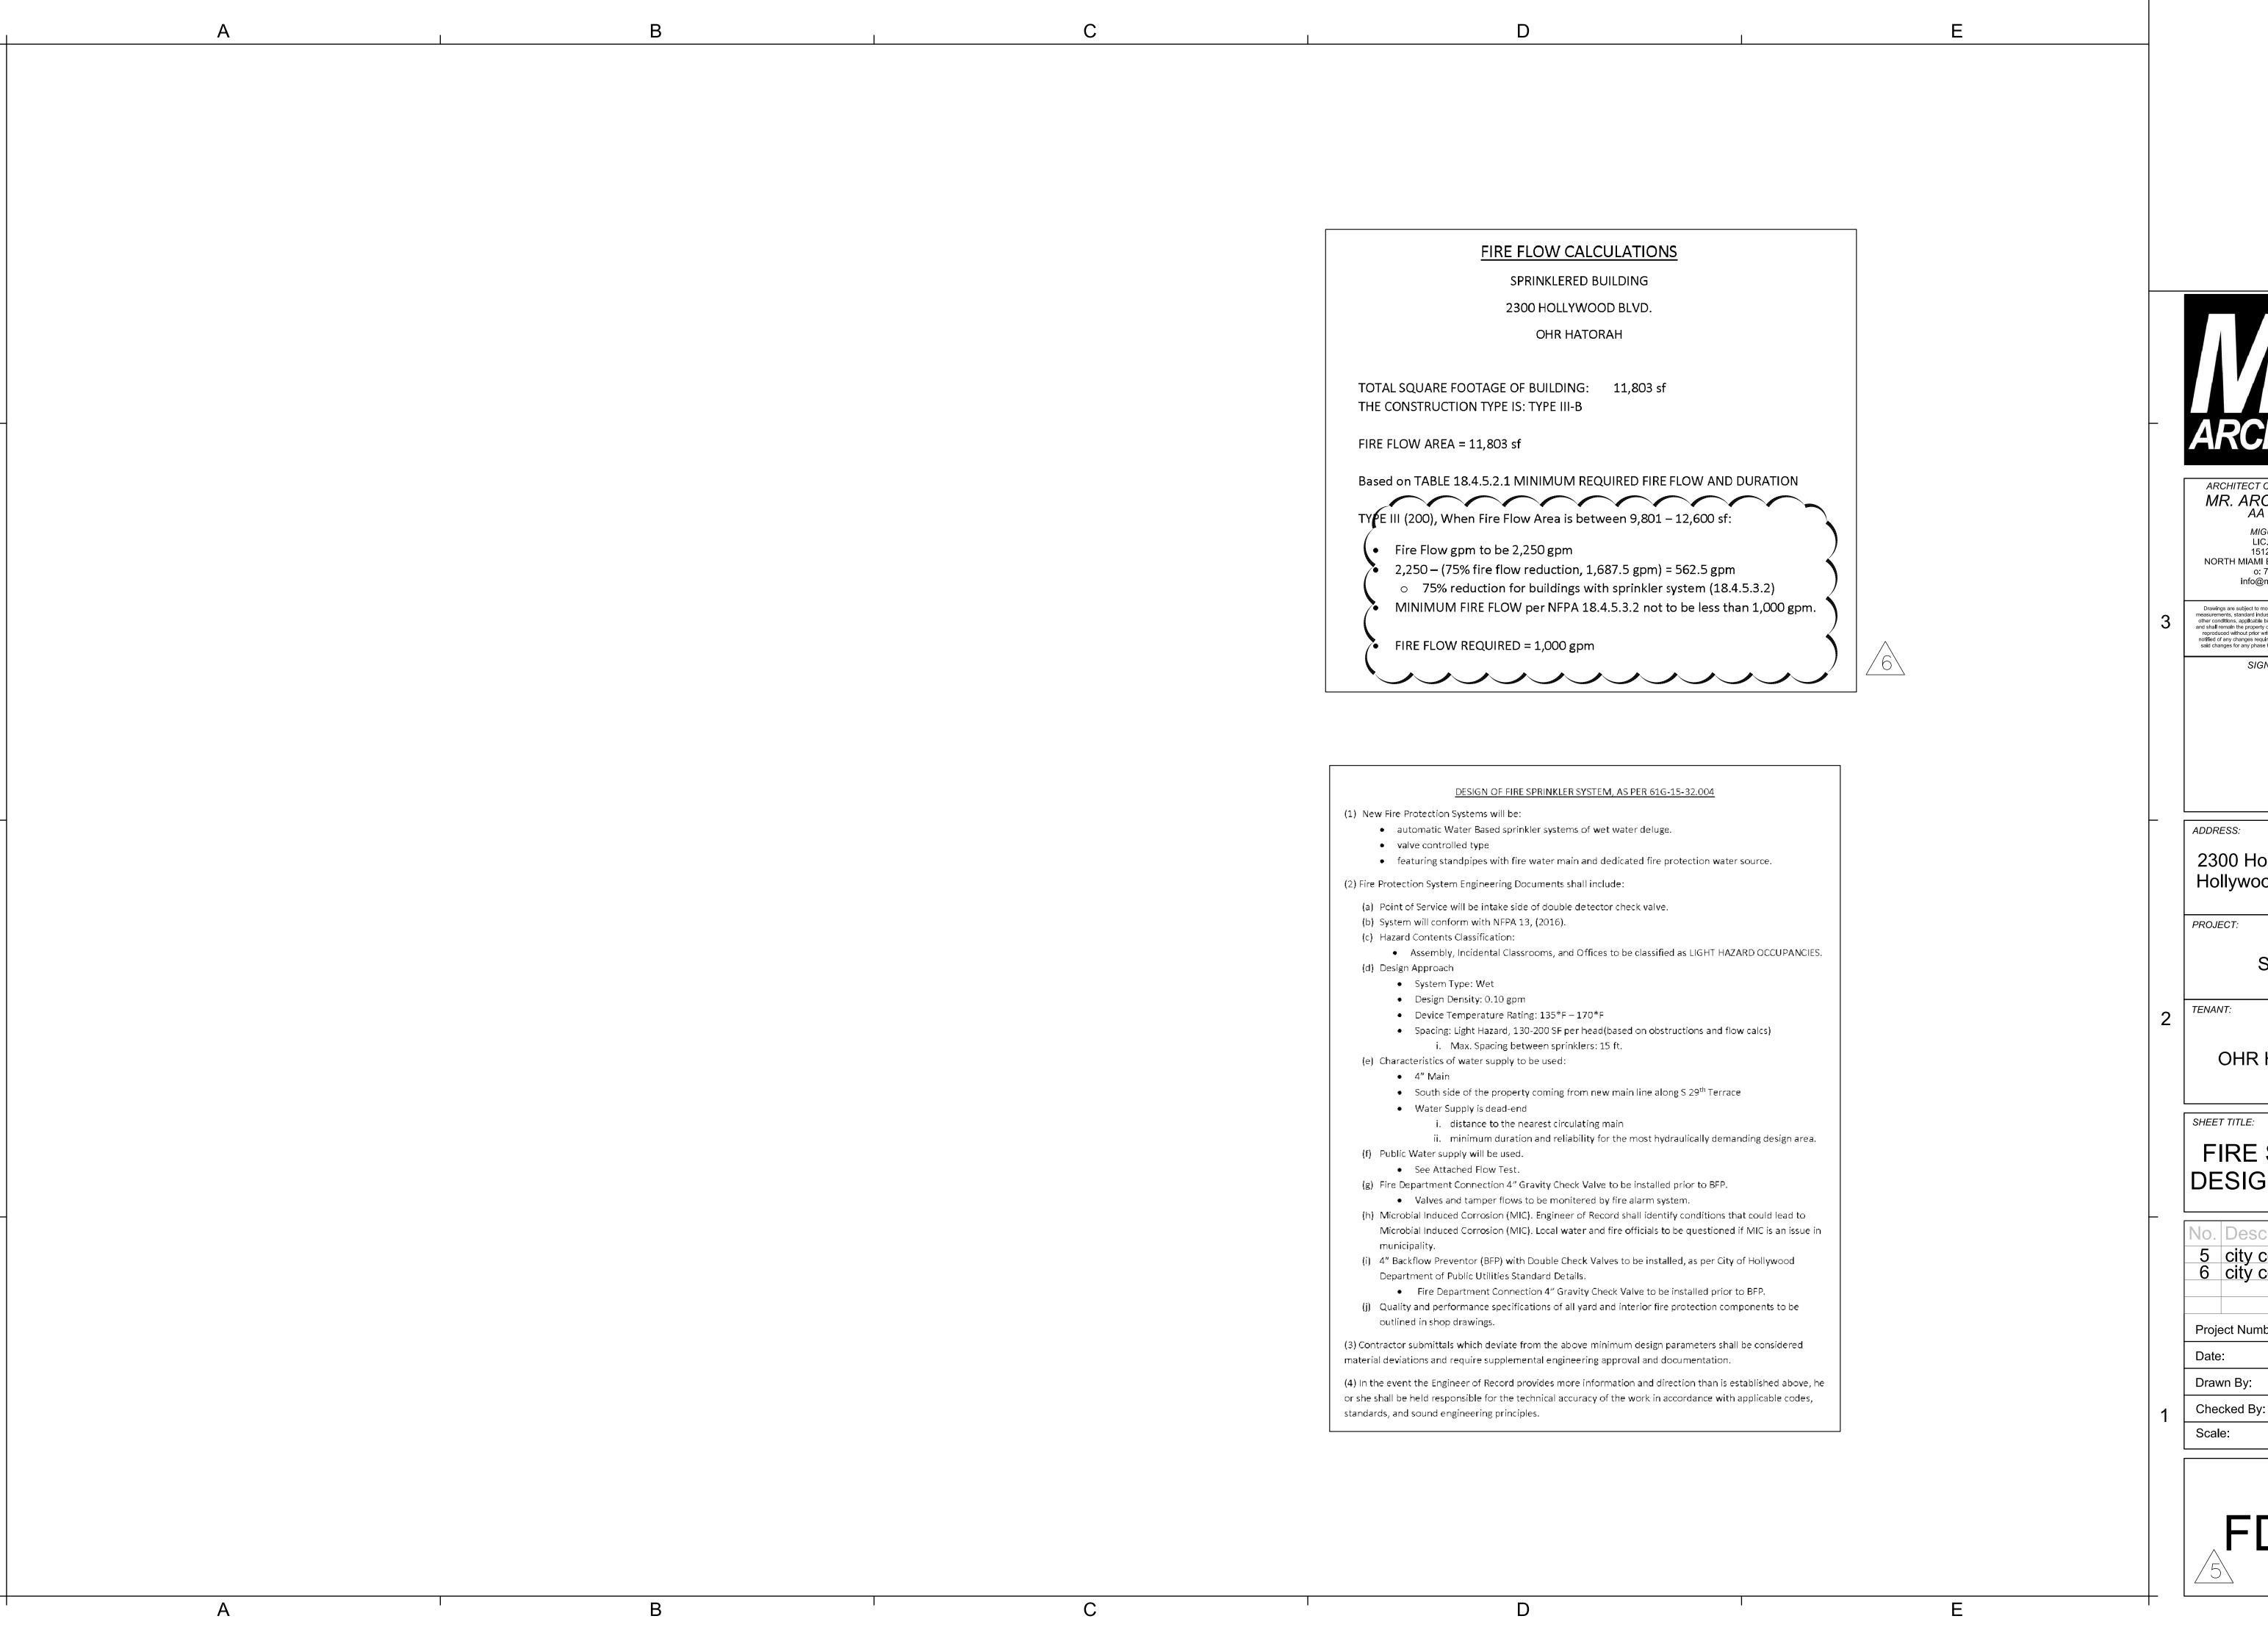

ARCHITECT OF RECORD: MR. ARCHITECT, LLC AA 26002308 MIGUEL RIONDA LIC. # AR 94189 15125 NE 9th CT NORTH MIAMI BEACH, FLORIDA 33162 o: 786.696.4276 info@mr-architect.com

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SIGN AND SEAL:

2300 Hollywood Blvd. Hollywood, FL 33020

School

OHR HATORAH

FIRE SAFETY **DESIGN SHEET**

No. Description Date 5 city comm 3/28/23 6 city comm 4/10/23 52 2021 Project Number: 10/5/21 MR Drawn By:

> DΖ 1/8" = 1'-0"

EXISTING ROOFTOP UNIT SCHEDULE TSC060 TSC060 MODEL AND MANUFACTURER AMERICAN STANDARD AMERICAN STANDARD AMERICAN STANDARD UNIT DESIGNATION RTU-3TOTAL COOLING LOAD, BTUH 59,500 59,500 59,500 SENSIBLE COOLING LOAD, BTUH 46,400 46,400 46,400 CFM 2000 EXTERNAL STATIC IN. WC 0.5 0.5 INDOOR FAN MOTOR, HP, FLA 3/4 HP 4.9 FLA 3/4 HP 4.9 FLA | 3/4 HP 4.9 FLA INTEGRAL ELECTRICAL HEATER, KW 7.5 7.5 7.5 UNIT MINIMUM CIRCUIT AMPS 27 27 27 UNIT MAXIMUM FUSE AMPS 40 40 40 NUMBER OF COMPRESSORS COMPRESSOR RLA 22.1 22.1 22.1 NUMBER OF CONDENSER FANS CONDENSER FAN MOTOR, HP,FLA 1/3HP,1.5FLA 1/3HP,1.5FLA 1/3HP,1.5FLA UNIT VOLTAGE / PHASE 240-1-60 240-1-60 OPERATING WEIGHT, LBS 676.0 676.0 676.0 SEER 14.0 14.0 14.0 80 / 67 80 / 67 COIL ENTERING CONDITIONS DB / WB (° F) 80 / 67 AMBIET AIR TEMP. DESIGN DB (° F) 95 95 DINING AREA AREA SERVED: DINING AREA DINING AREA

				ß	AIR H	ANDLE	UNIT	SCHE	EDULE	-				
UNIT NO (WEIGHT lbs)	MANUFACTURED	TOTAL CAPACITY	SENSIBLE CAPACITY	LATENT CAPACITY	OUTDOOR	EVAPORATOR	AIR FLOW	MCA/MOP	BLOWER	DIMENSIONS	REFRIGERANT PIPE SIZE	POWER SUPPLY VOLT	HEATING CAPACITY	DEEDIGEDANI
(SEER)	MODEL POSITION	(BTU/hr)	(BTU/h)	(BTU/h)	UNIT	CFM	SP	MCA/MOP	FLA	WXHXD	LIQUID (IN) GAS (IN)	PHASE FREQUENCY (Hz)	(BTU)	REFRIGERAN'
AHU-1 (151) (15)	RHEEM RH1T6024STAN VERTICAL	56,000	37,900	18,100	CU-1	1700	0.5	43/ 45	4.6	21"X57"X22"	3/8ø 7/8ø	230 1 60	34,120	R-410A
AHU-2 (151) (15)	RHEEM RH1T6024STAN VERTICAL	56,000	37,900	18,100	CU-2	1700	0.5	43/ 45	4.6	21"X57"X22"	3/8ø 7/8ø	230 1 60	34,120	R-410A
AHU-3 (151) (15)	RHEEM RH1T6024STAN VERTICAL	56,000	37,900	18,100	CU-3	1700	0.5	43/ 45	4.6	21"X57"X22"	3/8ø 7/8ø	230 1 60	34,120	R-410A
AHU-4 (151) (15)	RHEEM RH1T6024STAN VERTICAL	56,000	37,900	18,100	CU-4	1700	0.5	43/ 45	4.6	21"X57"X22"	3/8ø 7/8ø	230 1 60	34,120	R-410A
AHU-5,6 (38) (20)	PIONEER CB009GMFILCFHD CEILING CASSETTE	9000	6,750	2,250	CU-5	257-374		OUTDOOR	0.9000	24X10X24	1/4ø 3/8ø	230 1 60	10,000	R-410A
AHU-7,8 (38) (20)	PIONEER CB009GMFILCFHD CEILING CASSETTE	9000	6,750	2,250	CU-6	257-374		OUTDOOR	0.9000	24X10X24	1/4ø 3/8ø	230 1 60	10,000	R-410A
AHU-9,10 (38) (20)	PIONEER CB018GMFILCFHD CEILING CASSETTE	18000	6,750	11,250	CU-7	570-730		OUTDOOR	0.9000	23X11X23	1/4ø 1/2ø	230 1 60	10,000	R-410A
AHU-11,12 (38) (20)	PIONEER CB018GMFILCFHD CEILING CASSETTE	18000	6,750	11,250	CU-8	570-730		OUTDOOR	0.9000	23X11X23	1/4ø 1/2ø	230 1 60	10,000	R-410A
AHU-13,14 (38) (20)	PIONEER CB018GMFILCFHD CEILING CASSETTE	18000	6,750	11,250	CU-9	570-730		OUTDOOR	0.9000	23X11X23	1/4ø 1/2ø	230 1 60	10,000	R-410A
AHU-15,16 (38) (20)	PIONEER CB018GMFILCFHD CEILING CASSETTE	12000	9,000	3,000	CU-10	570-730		OUTDOOR	0.9000	23X11X23	1/4ø 1/2ø	230 1 60	10,000	R-410A
				INDO		R CONDITIONS S			%					

ITEM	MANUF./CAT NO.	TYPE	NECK	FRAME	FINISH
			0 - 125 CFM = 6"Ø 130 - 150 CFM = 6"Ø 160 - 275 CFM = 8"Ø 280 - 390 CFM = 10"Ø 400 - 500 CFM = 12"Ø	SEE PLANS	BAK. WHT. ENAMEL
A	TITUS SUPPLY CEILING GRILLE MODEL TMS	CG	SEE PLANS	SEE PLANS	BAK. WHT. ENAMEL
В	TITUS RETURN CEILING GRILLE MODEL PAR	RCG	SEE PLANS	SEE PLANS	BAK. WHT. ENAMEL
С	TITUS CEILING GRILLE MODEL 250CD	RCG	SEE PLANS	SEE PLANS	BAK. WHT. ENAMEL
D	TITUS LINEAR BAR DIFFUSER MODEL ML-38	RCG	SEE PLANS	SEE PLANS	BAK. WHT. ENAMEL
•	$ \begin{array}{ccc} \uparrow & \underline{DEVICE\ TYPE} \\ & \swarrow & CG = CEILIN \\ & \swarrow & RCG = CEILIN \\ & \underline{NOTES:} \end{array} $	NG GRILLE	SUPPLY	CFM — MOTORIZED VOLUME DA THERMO: DUCT SMOKE DE	stat (TS)
A B	BY ARCHITECT. 2. DEVICES SHALL BE PROBLEM OF THE P	OVIDED WIT 4-WAY T	PROPER FRAME STYLE TO MATCH OF THE FACTORY FINISH. THROW UNLESS NOTED OTHERWISE T FOR GRILLES AND DIFFUSERS. MODEL EG.) FOR DIFFUSERS TAP	OR SHOWN ON PL	ANS WITH DIRECTIONAL

BATHROOM EXHAUST FAN SPECS	HVAC DESIGN SCHED	ULE.		
	HVAC DESIGN REQUIRES:	YES	NO	REMARKS
EF-1: "NUTONE" MODEL QTXEN-50, 50 CFM AIR DELIVERY @ 1/10" SP, 115 VOLTS, 60 Hz, 0.3	DUCT SMOKE DETECTOR(S)	YES		
AMP. CEILING MOUNTED W/B.D.D. BUILT-IN.	FIRE DAMPER(S)		NO	
	SMOKE DAMPER(S)		NO	
	FIRE RATED ENCLOSURE		NO	
U.C. UNDERCUT DOOR 1" A.F.F.	FIRE RATED ROOF/FLOOR CEILING ASSEMBLY		NO	
FOR RETURN AIR.	FIRE STOPPING		NO	
CONDENSATION LINE	SMOKE CONTROL		NO	

6. WHERE 3-WAY THROW IS NOTED, INSTALL BAFFLES IN THE NECK OF DIFFUSERS.

PROVIDE OPPOSED BLADE DAMPER FOR REGISTERS.

UNIT NO (WEIGHT Ibs) (SEER)	MANUFACTUR ED MODEL POSITION	NOMINAL CAPACITY (BTU/hr)	MCA/MOP	FAN FLA	COMPRESSOR RLA/LRA	REFRIGERANT PIPE SIZE LIQUID (IN) GAS (IN)	POWER SUPP VOLT PHASE FREQUENCY(H
CU-1 (240) (15)	RHEEM RA1660AJ1	60,000	34 / 50	3.5	23.7/152.5	3/8ø 7/8ø	230 1 60
CU-2 (240) (15)	RHEEM RA1660AJ1	60,000	34 / 50	3.5	23.7/152.5	3/8ø 7/8ø	230 1 60
CU-3 (240) (15)	RHEEM RA1660AJ1	60,000	34 / 50	3.5	23.7/152.5	3/8ø 7/8ø	230 1 60
CU-4 (240) (15)	RHEEM RA1660AJ1	60,000	34 / 50	3.5	23.7/152.5	3/8ø 7/8ø	230 1 60
CU-5 (161) (20) HPSF(10)	PIONEER YN020GMFI22 M3D	18,000	18 /25	0.74	10	1/4ø (2) 3/8ø (2)	230 1 60
CU-6 (161) (20) HPSF(10) CU-7	PIONEER YN020GMFI22 M3D	18,000	18 /25	0.74	10	1/4ø (2) 3/8ø (2)	230 1 60
(161) (20) HPSF(10) CU-8	PIONEER YN040GMFI22 M4D	36,000	30 /45	1.3	22	1/4ø (4) 3/8ø (4)	230 1 60
(161) (20) HPSF(10)	PIONEER YN040GMFI22 M4D	36,000	30 /45	1.3	22	1/4ø (4) 3/8ø (4)	230 1 60
CU-9 (161) (20) HPSF(10)	PIONEER YN040GMFI22 M4D	36,000	30 /45	1.3	22	1/4ø (4) 3/8ø (4)	230 1 60
CU-10 (161) (20) HPSF(10)	PIONEER YN030GMFI22 M3D	36,000	25 /35	1.3	22	1/4ø (3) 3/8ø (3)	230 1 60

H.V.A.C. NOTES

- 1. ALL WORK SHALL BE AS PER 2020 7TH EDITION F.B.C. AND NFPA
- 2. ALL HEATING AND AIR CONDITIONING DUCT WORK SHALL BE FIBERGLASS, ENDURA GOLD TYPE, AS MANUFACTURED BY OWENS-CORNING, W/BACTERIAL / FUNGAL GROWTH RESISTANCE, TYPE 800 (1.5" THICK R-6). ALL BATHROOM AND DRYER EXHAUST DUCTS SHALL BE 30 GA. GALV. METAL WITHOUT INSULATION. HOOD EXHAUST DUCT SHALL BE 26 GA. GALV. METAL WITHOUT INSULATION AND W/WIRE MESH. PROVIDE A UV LIGHT IN EACH AIR HANDLING UNIT.
- 3. DUCT WORK SHALL BE FABRICATED AND INSTALLED IN ACCORDANCE WITH MANUFACTURER'S SPECIFICATIONS & ACCORDING TO ASHRAE & SMACNA STANDARDS AND IN COMPLIANCE WITH UL 181.
- 4. DUCT DIMENSIONS ARE IN INCHES AND CORRESPOND TO INSIDE DIMENSIONS WIDTH x HEIGHT. DUCT SYSTEM SHALL COMPLY WITH NFPA STD. NO. 90A AND/OR 90B. DUCTWORK AND MATERIALS SHALL BE CLASS 1 MATERIALS IN ACCORDANCE WITH U.L. 181 TESTS.
- 5. COORDINATE LOCATIONS, SIZES & OPENINGS W/OTHER TRADES ON THE JOB. A/C CONTRACTOR SHALL PROVIDE THE COMPLETE DUCT SYSTEM W/TURNING VANES AT ALL ELBOWS. SPLITTERS AND DAMPERS AS REQUIRED. A/C CONTRACTOR SHALL USE THE BEST PRACTICES OF THE TRADE IN THE FABRICATION AND INSTALLATION OF THE SYSTEM.

6. ALL SUPPLY AIR AND RETURN AIR GRILLES/DIFFUSERS SHALL BE NEW, AND SHALL BE LOCATED AND BALANCED IN ORDER THAT THEY DELIVER THE REQUIRED CFM TO THE ENTIRE ROOM EVENLY & DRAFT FREE TO MAINTAIN THE FOLLOWING DESIGN CONDITIONS:

inside OUTSIDE

MECHANICAL CLOSET.

ACHIEVE SUCH READINGS.

FAN SPEED SETTINGS WILL BE CHANGED.

COOLING - 76 DB HEATING - 72 DB

90 DB - 79 WB 50% TO 60%

7. ALL TEMPERATURE CONTROLS SHALL BE DIGITAL PROGRAMMABLE THERMOSTAT MOUNTED WHERE SHOWN ON PLANS, AT 5'-0" A.F.F.

RELATIVE HUMIDITY

- 8. ALL NEW GRILLES AND DIFFUSERS TO BE ALUMINUM CONSTRUCTION. DIFFUSERS SHALL HAVE HIDDEN OPPOSED BLADE DAMPERS. PROVIDE GASKETS ON ALL GRILLES & DIFFUSERS.
- 9. PROJECT ARCH. SHALL REVIEW AND APPROVE ALL DIFFUSER TYPES & FINISHES PRIOR TO PURCHASE AND INSTALLATION.
- 10. CONTRACTOR SHALL FIELD VERIFY/COORDINATE ALL CONDITIONS AND PARAMETERS W/OTHER TRADES INVOLVED W/THE PROJECT.
- 11. REFRIGERANT PIPING (SUCTION) SHALL BE INSULATED WITH MINIMUM 3/4" THICK ARMAFLEX INSULATION.
- 12. ALL AIR HANDLING UNITS SHALL BE INSTALLED WITH 4" CLEARANCE ALL AROUND INSIDE
- 13. PLACE ALL GRILLS MIN. 12" AWAY FROM WALLS TO ACCOMMODATE FOR DRYWALL AND MOLDINGS.
- 14. HVAC SYSTEMS SPECIFIED ON THIS PLAN AND INSTALLED AT THE PROJECT SITE WILL NOT BE USED AND IN OPERATION DURING WOOD FLOOR SANDING PROCESS.
- 15. UPON COMPLETION OF CONSTRUCTION, PRIOR TO THE DELIVERY OF THE HVAC SYSTEMS, ALL AIR HANDLING UNITS (COILS AND FAN SECTION) WILL BE CLEANED.
- 16. AT THE TIME OF INITIAL HVAC SYSTEM START-UP, THE FOLLOWING STEPS WILL BE FOLLOWED:
- A. COMPLETE HVAC SYSTEM WILL BE BALANCED AT EACH ZONE, WITHIN 5% OF
- SPECIFIED VALUES. B. FAN SPEED SETTING AT EACH AIR HANDLING UNIT WILL BE VERIFIED AGAINST
- THE TOTAL AIR FLOW AND SUPPLY AIR TEMP. AT AHU DISCHARGE. C. SUPPLY AIR TEMPERATURE READINGS WILL BE RECORDED AT AHU DISCHARGE
- AND AT THE REMOTEST SUPPLY AIR DIFFUSER / GRILLE. D. RETURN AIR TEMPERATURE READINGS WILL BE RECORDED AT EACH AHU ZONE.
- E. SUPPLY AND RETURN AIR DIFFERENTIAL IN THE RANGE OF 15 -20 DEG. WILL BE OBSERVED; OTHERWISE, FAN SPEED SETTINGS WILL BE MODIFIED INORDER TO
- F. SUPPLY AIR TEMPERATURE READING AT EACH AHU DISCHARGE POINT, (RECORDED BY PROBE TYPE INSTRUMENT INSERTED DIRECTLY INTO THE AIR STREAM) WILL NOT BE LOWER THAN 53 DEG. F. OR HIGHER THAN 58 DEG. F.; OTHERWISE
- G. ALL OF THE START-UP TESTS NOTED ABOVE WILL BE CARRIED OUT, AFTER THE SYSTEMS HAVE BEEN RUNNING FOR A PERIOD OF 24 HOURS.
- H. AT THE CONCLUSION OF THE START UP TESTING, ALL DUCT WORK WITHIN THE
- ATTIC SPACE WILL BE OBSERVED FOR SIGN OF CONDENSATION ON DUCT SURFACE, DAILY, FOR A PERIOD OF ONE WEEK.
- I. IN THE EVENT THAT TEMPERATURE READINGS AND / OR AIR FLOW QUANTITIES, ARE FOUND TO DIFFER FROM THE PARAMETERS NOTED ABOVE, AND / OR CONDENSATION IS OBSERVED ON THE DUCT SURFACE WITHIN THE ATTIC SPACE, PROJECT ARCHITECT AND ENGINEER WILL BE NOTIFIED FOR FURTHER EVALUATION AND IMPLEMENTATION OF CORRECTIVE MEASURES.

ARCHITECT OF RECORD: MR. ARCHITECT, LLC AA 26002308 MIGUEL RIONDA LIC. # AR 94189 15125 NE 9th CT NORTH MIAMI BEACH, FLORIDA 33162 o: 786.696.4276

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PROJECT:

Religious Worship and Education

TENANT:

OHR HATORAH

SHEET TITLE:

MECHANICAL NOTES

No. Description Date 10_2022 Project Number:

05/04/22 Date: MR Drawn By:

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Checked By:


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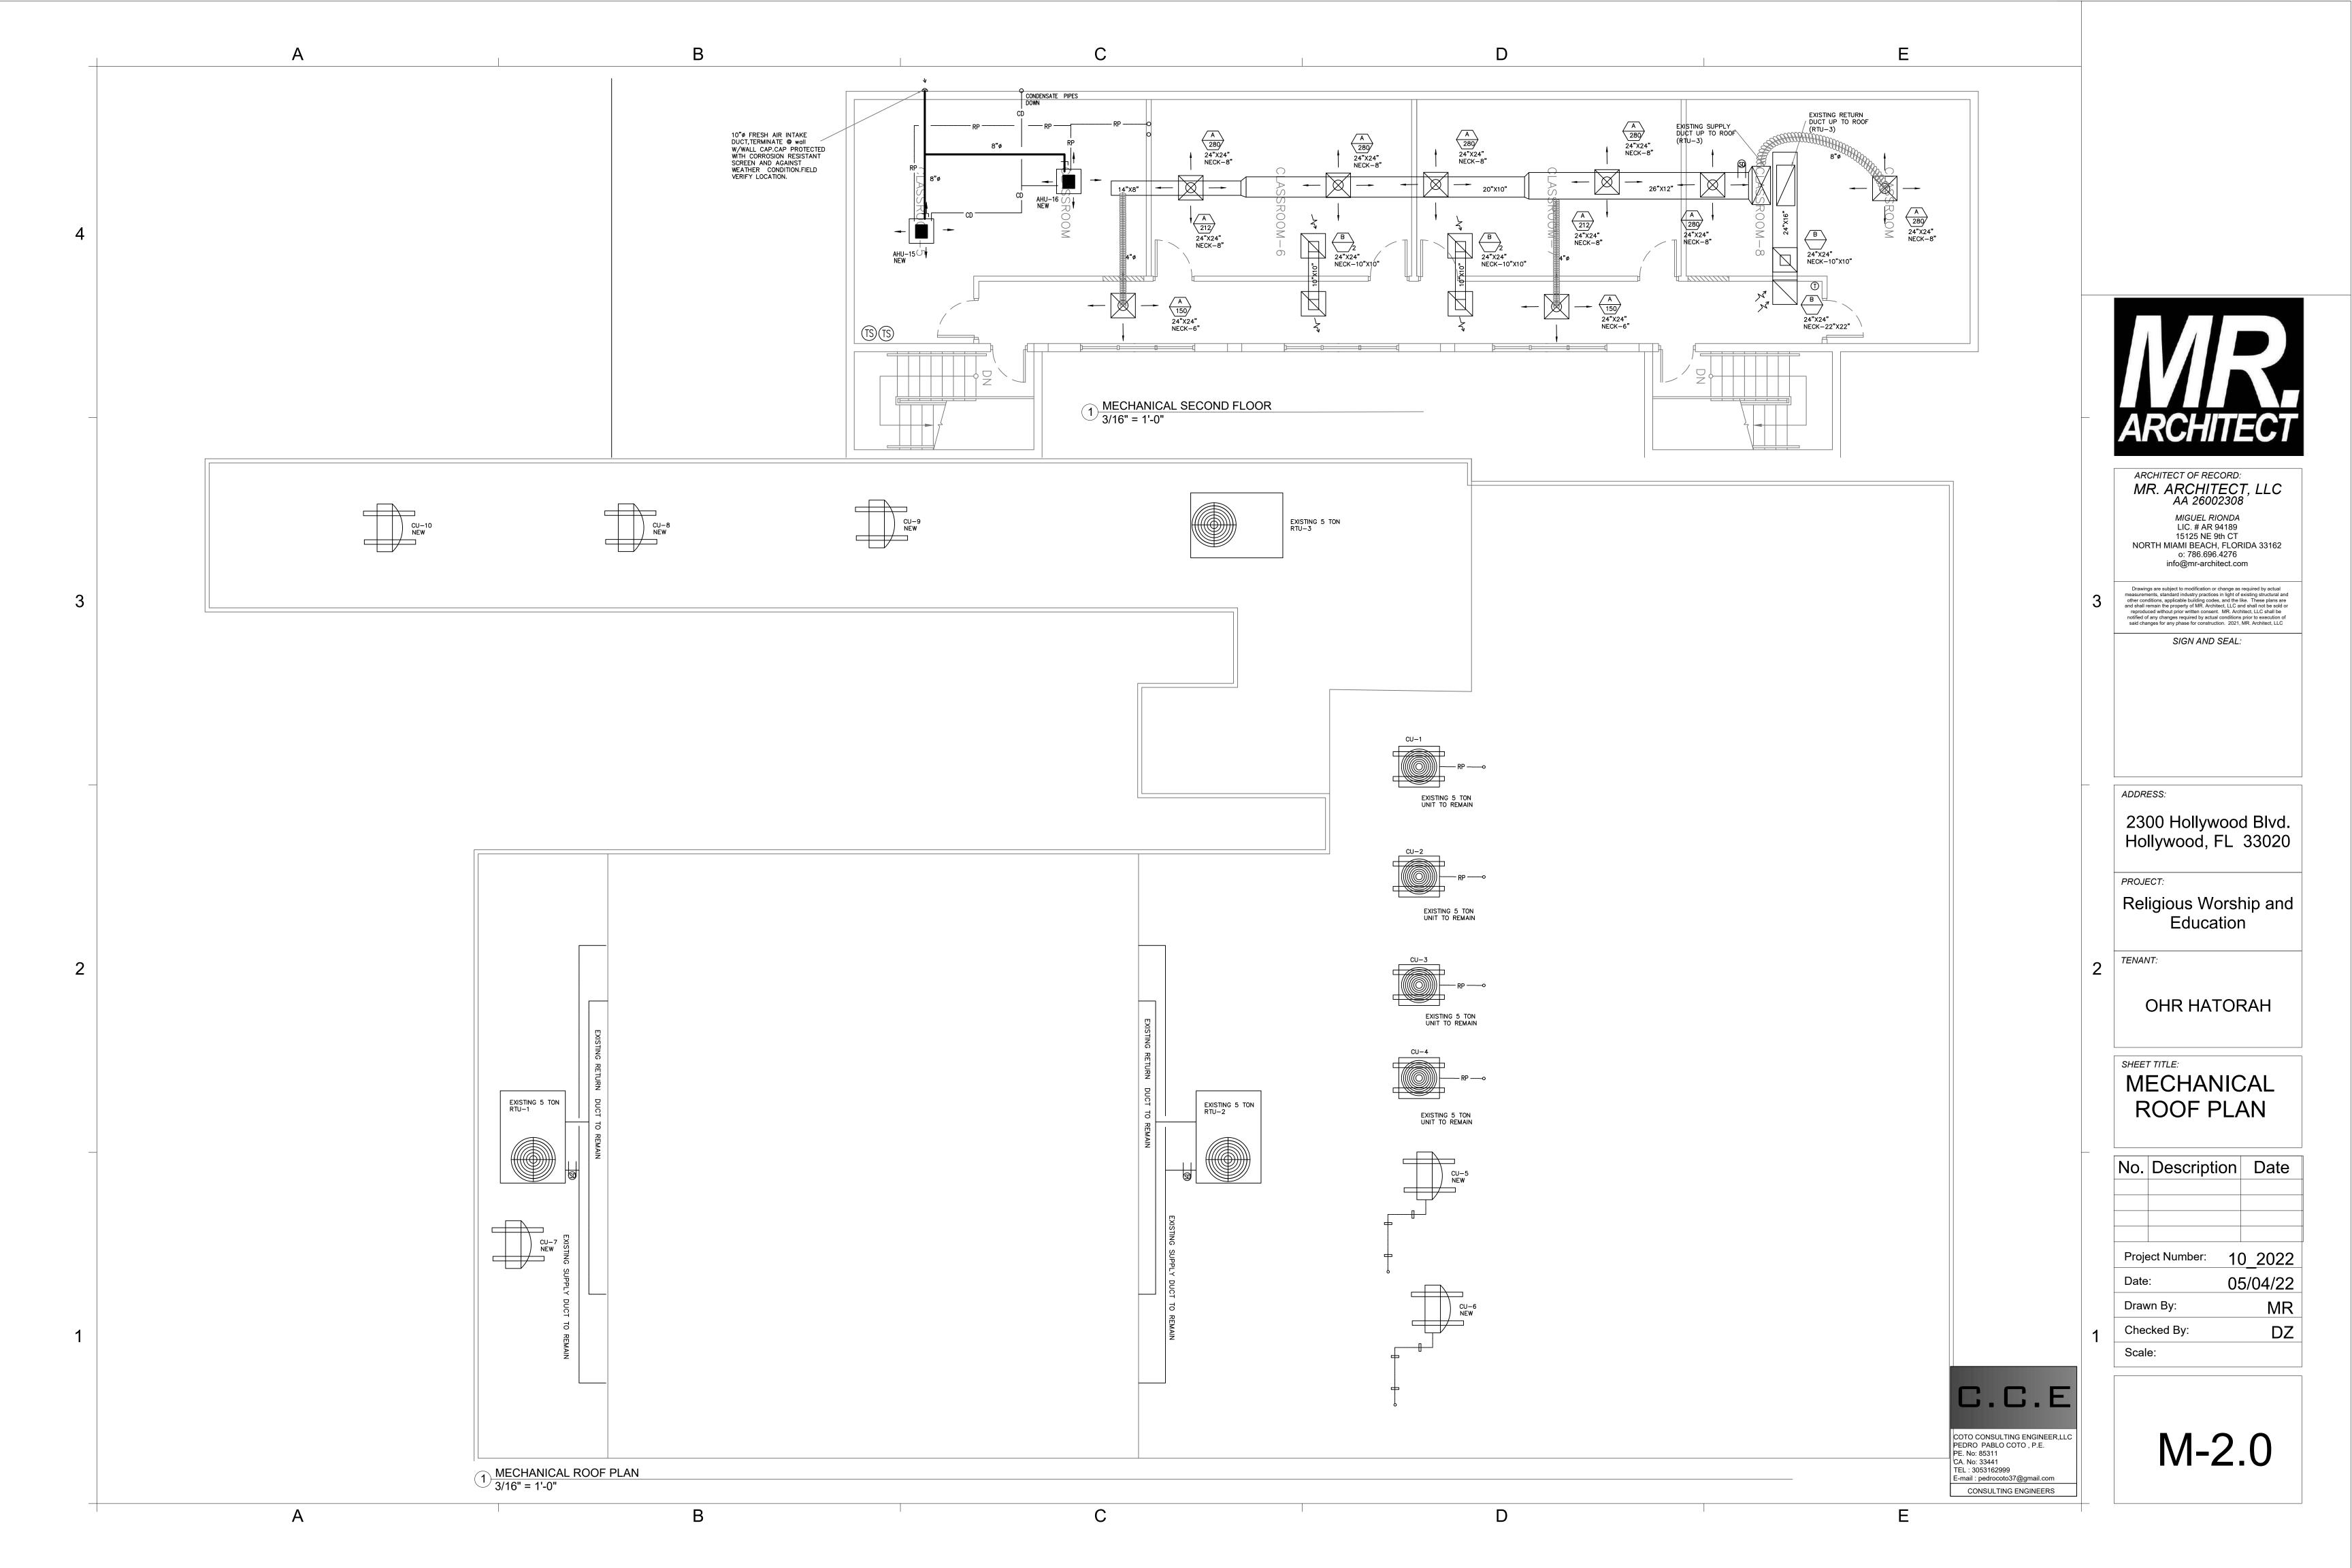
1 MECHANICAL NOTES NTS

PE. No: 85311 CA. No: 33441 TEL: 3053162999

COTO CONSULTING ENGINEER,LLC PEDRO PABLO COTO , P.E. E-mail : pedrocoto37@gmail.com CONSULTING ENGINEERS

C.C.E



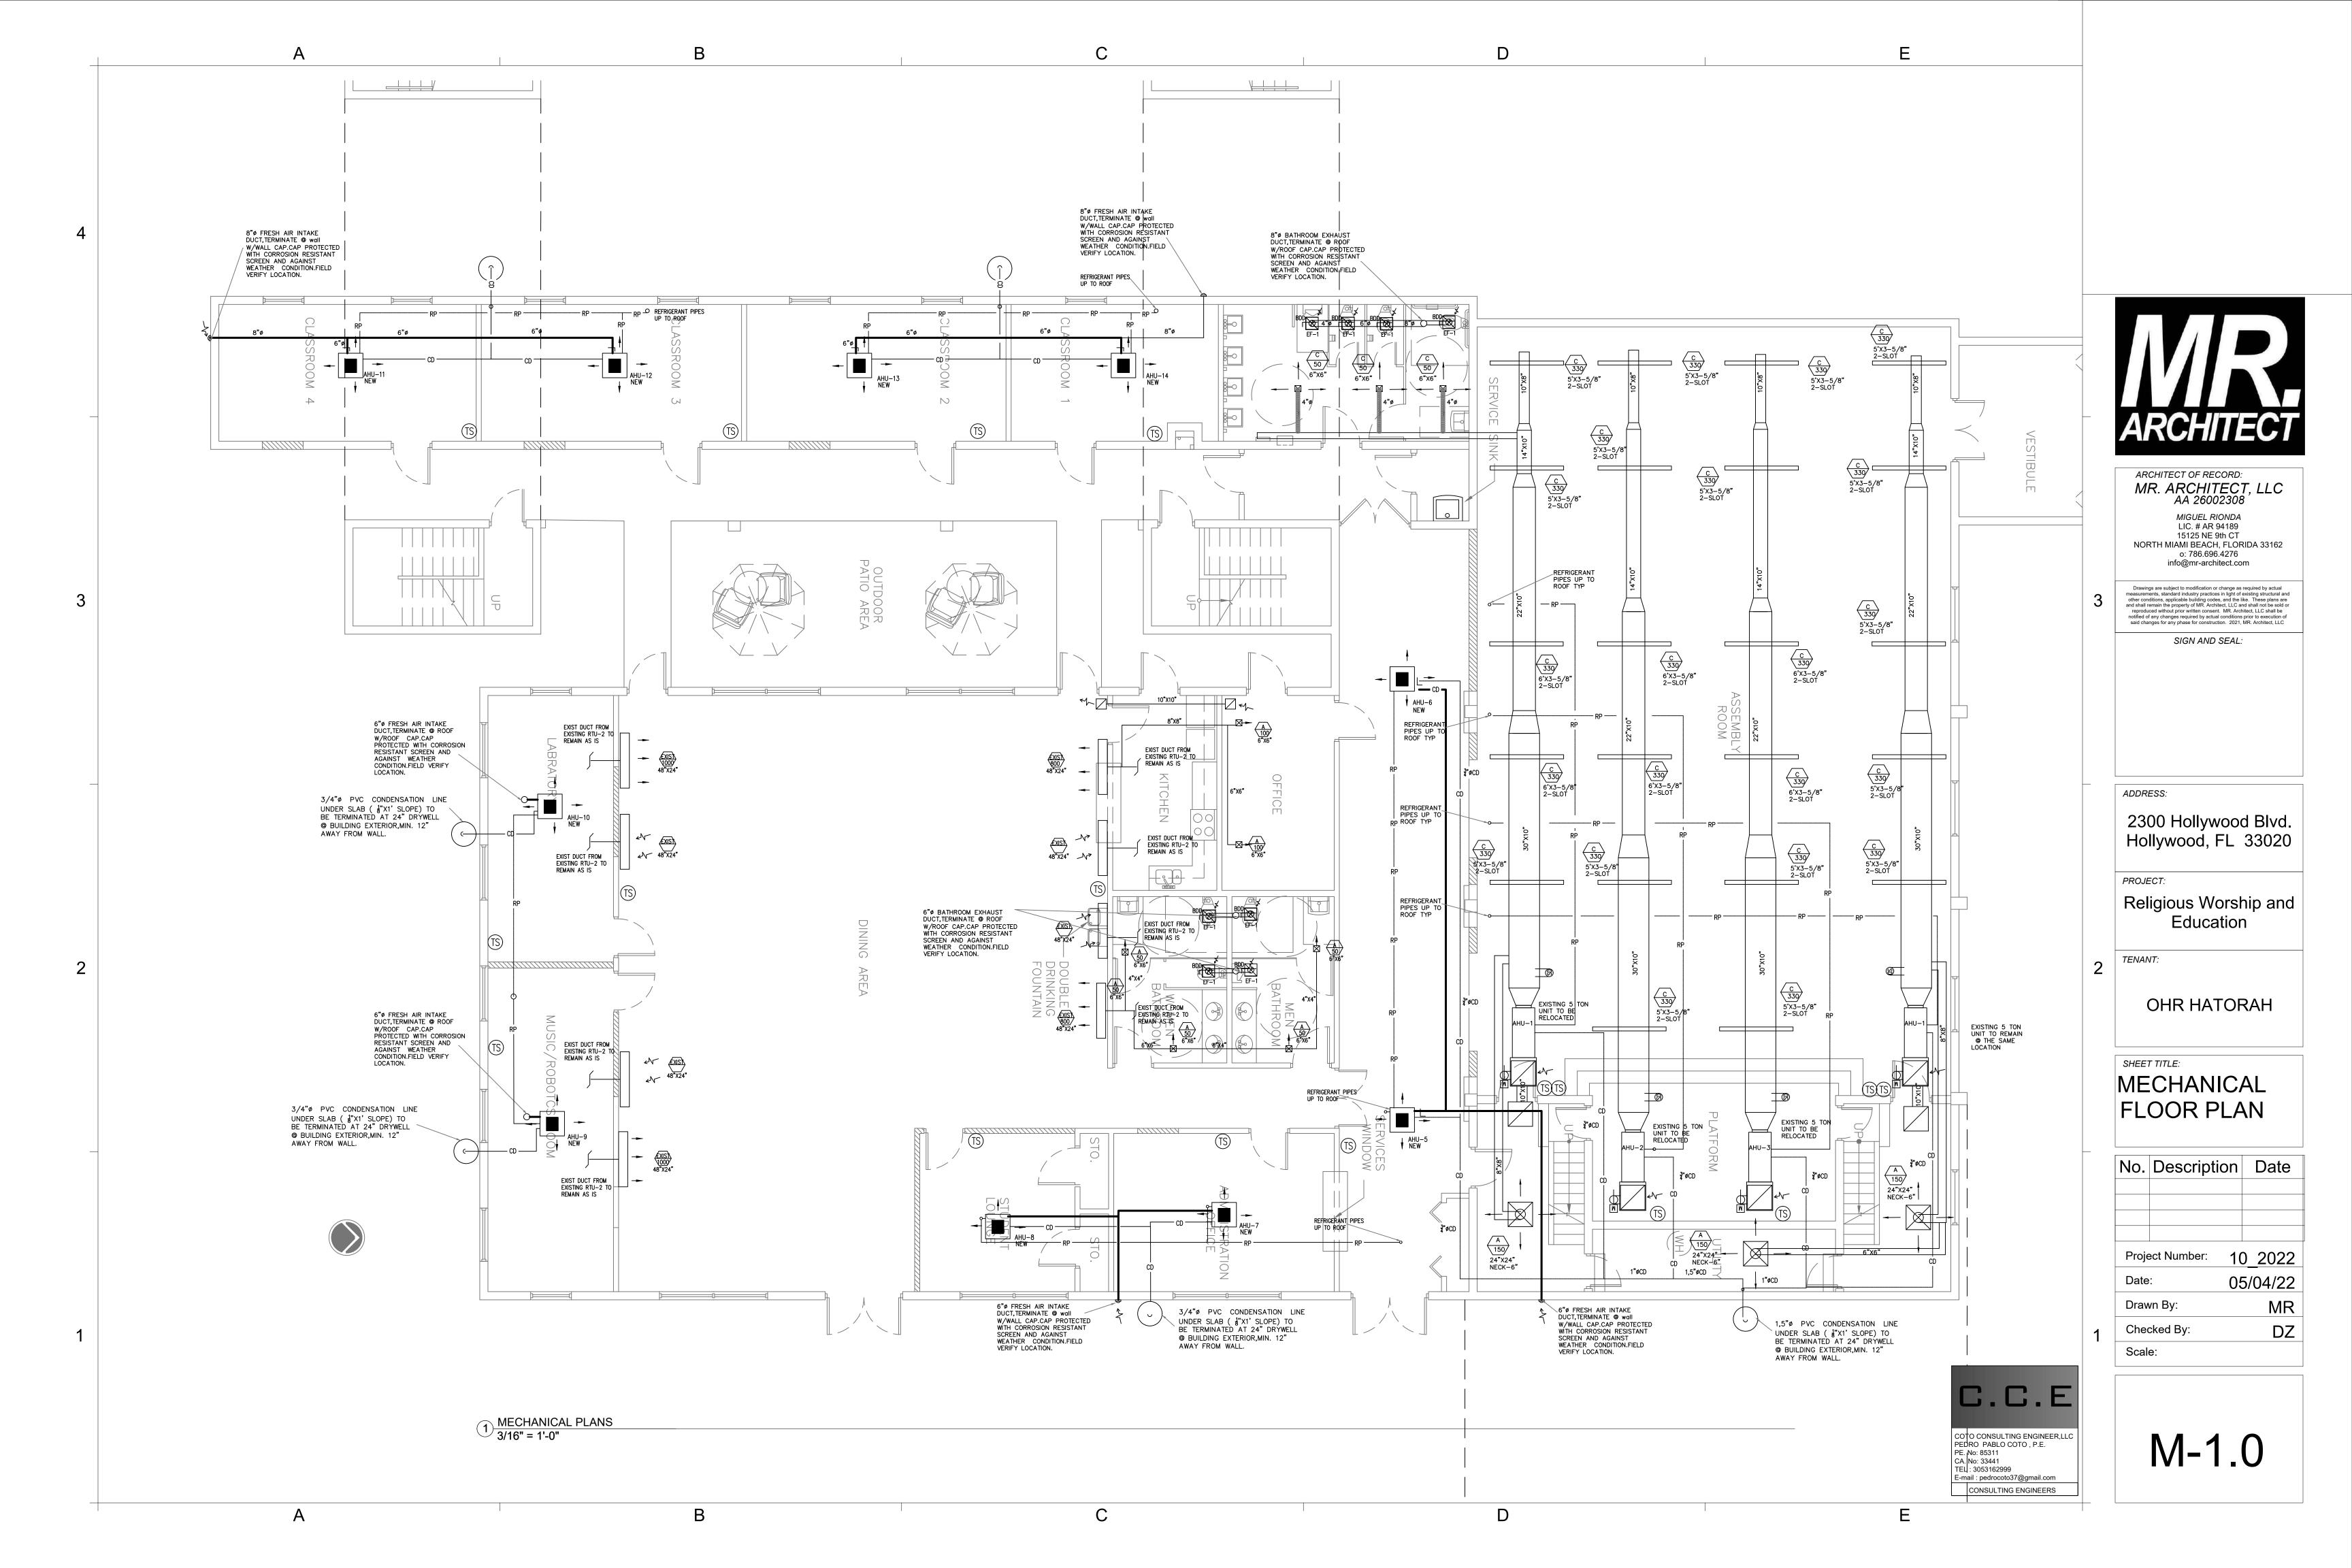

				AS		oz=[(Rp x Pz)+(CALCULATION				
			Rp	Pz	Vbzp	Ra	Az	Vbza	Vbz	Ez	Voz	Vot
	VENT. ZONE	UNIT#	O/A RATE PER PERSON	QTY. AIR RATE PEOPLE	VENT. BASED ON PEOPLE	O/A RATE BASED ON AREA	AREA	VENT. BESED ON AREA	TOTAL VENT. RATE	ZONE AIR DISTRIB. EEF	ZONE O/A =Vbz/Ez	PROVIDED CFM
	AUDITORIUM	AHU-1,2,3,4,5	5	156	780	0.06	3050	183	963	1	963	963
	DINING AREA	RTU-1,2	7.5	127	952.5	0.18	2353	423.54	1376.04	1	1376	1376
	CLASSROOM-1	AHU-11	12	12	144	0.12	187	22.44	166.44	1	166	166
	CLASSROOM-2	AHU-13	12	12	144	0.12	237	28.44	172.44	1	172	172
	CLASSROOM-3	AHU-12	12	12	144	0.12	237	28.44	172.44	1	172	172
	CLASSROOM-4	AHU-14	12	12	144	0.12	237	28.44	172.44	1	172	172
	CLASSROOM	AHU-9	12	12	144	0.12	269	32.28	176.28	1	176	176
	MUSIC ROBOTCS									200		
	LABORATORY	AHU-10	12	12	144	0.12	269	32.28	176.28	1	176	176
	CLASSROOM-5	AHU-15 AHU-16	12	20	240	0.12	397	47.64	287.64	1	288	288
	CLASSROOMS 6,7,8	RTU-3	12	52	624	0.12	1030	123.6	747.6	1	748	748
	LOUNGE AREA	AHU-8	5	20	100	0.05	198	9.9	109.9	1	110	110
	OFFICE	AHU-7	5	20	100	0.05	232	11.6	111.6	1	112	112
22 GAUGE SHEET METAL 1"x3" SCREW POP RIVET OR SPOT WELD TO EQUIPMENT FLANGI DUCT PLENUM SHALL BE SECURE TO TOP OF THE AHU W/ANGLES.	 E			SET SCRE' SPACER R ON INSUL/ DUCTS	EQ'D. ATED			1" GALV STRAP	FI	N. CLG.		
DUCT CONNECTION DETAILS N.T.S		FLEXIB	LE DUCT CONN. DETAIL (RES) N.T.		TYP. DETAIL OF 90 [^] I	DUCT TAP WITH DAMPER BLADE. N.T.	S		∕— 725.5 CFM O∕A INTAKE VI	ANGING DETAIL N.T.S.		<u>E</u>
TERMINATE EXH. W/RAIN CAP TERMINATE EXH. W/RAIN CAP ROOFING	LOW VELOCITY SUF AIR DUCT (SEE PL METAL ROUND FITTIN QUADRANT OPERTOR TO BE OUTSIDE INSU PROVIDE INSULATION GUARD WHERE NECES	AN VIEW) GATION.		WITHSTAND 2-16 G AIR FLOW DRAWN STRUCT	PRAMEWORK TO 150 MPH WINDS A. X 1 1/2" FLAT STRAPS TIGHT, BOLTED TO ROOF	ROOF	TOP AC UNIT (BUILT-IN 0/	0/A 'A)	BUILT-IN MOTORIZED DAMP RTU INTERCONNECTED W/ SENSOR		+	*
CALV. METAL TO (AS SIZED) UP SLEEVE ROOF CONSTRUCTION AS REQUIRED SLEEVE ROOF CONSTRUCTION AS REQUIRED AS REQUIRED AS REQUIRED AS REQUIRED CONSTRUCTION AS REQUIRED AS REQUIRED AS REQUIRED AS REQUIRED AS REQUIRED AS REQUIRED WITH BACKDRAFT AND CONSTRUCTED OF MINIMUM 30 GAGE METAL PIPE. TOTAL DE DUCT LENGTH TO AN EXTERIOR WALL CAP SHALL NOT EXCEED E OF ALL DEDUCTIONS (2.5 FT. FOR 45 DEG. BEND, AND 5 FT. F DEG. BEND) BATHROOM/DRYER EXH. THRU ROOF DETAIL.	RYER 25 FT. PROVIDE 1" FIBERGL	TO NECK	INSULATED FLEX (8'-0" MAXIMUM THERMOFIN OR I ONLY IN A NONI SPRINKLERED BL SEAL JOIN SEALER &) FQUAL E DG. ROOF (PRODUCT ROOF STRIJET					ANGLE SUPPORT			
ISHER SCRE	NING VANES W/S.M. EW FASTERNERS IN TS 8" O.C. OR LARGER DIFFUSER			4" X 4" F 2 H CHA 300 CF REQUIR	R FIRE RATED DUCT SE. TM OR MORE O/A E CO2 SENSOR ORIZED DAMPER NO PR CO	OTE: ROVIDE A FLOAT SWITCH IN SECO	HUT DOWN RTU, WHENEVER	D), INTERCONNECTED W/AH START WATER LEVEL IN DRAIN PAN RAIS	T/STOP			
DUCT CONNECTION DET	<u>"AILS.</u> NTS	FLEX. DUCT / DIFFUSE	R CONN. DETAIL N.T.S		•,		P UNIT DETAIL:	<u>S</u> N.T.S				<u>SPLITTER DAMPER.</u> N.
	1 MECHANICAL DETAILS NTS											
		В				C				D		

FLEXIBLE DUCT HANGER. N.T.S.

2

ASHRAE STANDARD 62.1-2004 OUTSIDE AIR CALCULATION



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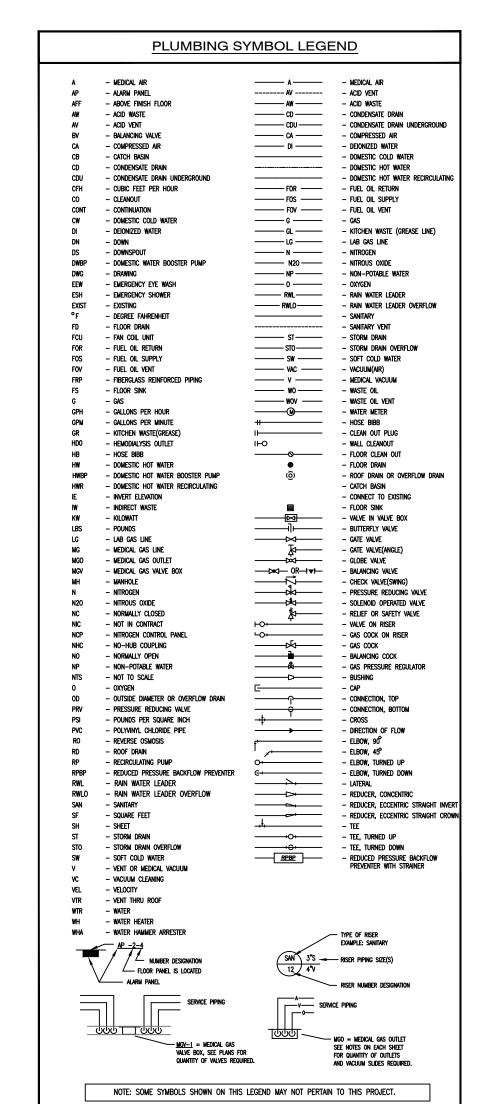
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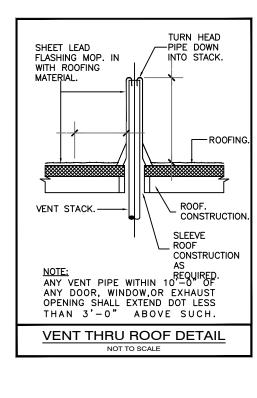
MECHANICAL **DETAILS AND** NOTES


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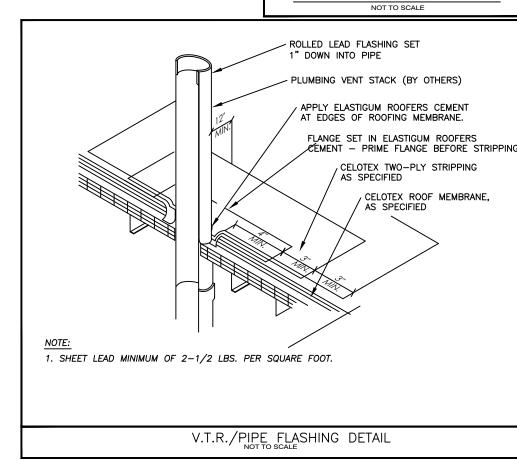
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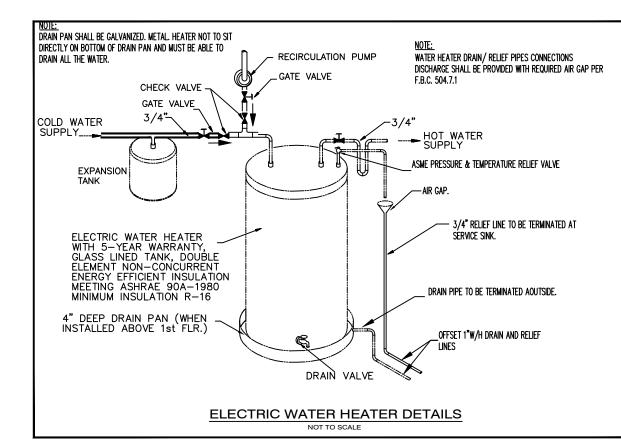


2







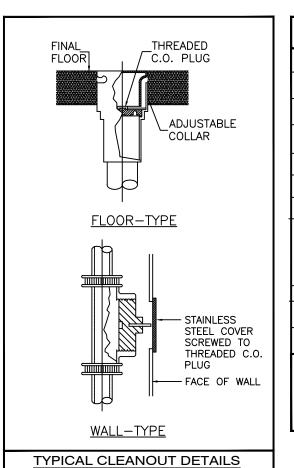

FIXTURE TYPE	TRAP SIZE	C.W.	H.W.	* FLOW RATE (gpm)	DESCRIPTION
WATER CLOSET	3"	1/2"	-	-	1.28 GALLONS PER FLUSHING CYCLE
LAVATORY	1-1/2"	1/2"	1/2"	1.5	
BATH TUB	2"	1/2"	1/2"	4	w/ ANTI-SCALD VALVES
SHOWER	2"	3/4"	3/4"	1.5	w/ ANTI-SCALD VALVES
BIDET	2*	1/2"	1/2"	2	w/ ANTI-SCALD VALVES
KITCHEN SINK	2"	1/2"	1/2"	1.5	w/ GARBAGE DISPOSAL UNIT
DISHWASHER	2"	-	1/2"	-	5.8 GALLONS PER LOAD (4GALLONS PER CYCL (ENERGY STAR/WATER SENSE CERTIFIED) DISCHARGE INTO GARBAGE DISPOSAL UNIT THROUGH AIR BREAK OR AIR GAP BRANCH WYI FITTING ACCORDING FBC PL 802.2.
SINK	1-1/2"	1/2"	1/2"	1.5	
WASHING MACHINE	2"	1/2"	1/2"	-	24 GALLONS PER LOAD (6 GALLONS PER CYCLE (ENERGY STAR/WATER SENSE CERTIFIED)
REFRIGERATOR	_	1/2"	-	_	PROVIDE S.O.V., IN-LINE FILTER &

NOTE: ALL DRAIN PIPING UNDER SLAB SHALL BE 2" MIN, 2" & LESS Ø DRAIN @ 1/4" DROP, 3" & 4" AND UP Ø DRAIN @ 1/8" DROP * ALL FLOW RATE SHALL BE PER F.B.C. TABLE 604.4 & AMENDMENTS BY MIAMI-DADE ORD. ON CHAPTER 8-31.

MBIN	IBING FIXTURE CONNECTION SCHEDULE							PIPI	NG MAT	TERIALS SCH	IEDL	<u>JLE</u>	
	TRAP Size	C.W.	H.W.	* FLOW RATE (gpm)	DESCRIPTION		SERVICE	SIZE	MATERIAL	SCHEDULE/TYPE		ILATION THICKNESS	REMARKS
	3"	1/2"	-	-	1.28 GALLONS PER FLUSHING CYCLE		COLD WATER	ALL		ASTM D 2846; ASTM F 441; ASTM F 442: CSA B137.6		1"	SEE NOTE 2
	1-1/2"	1/2"	1/2"	1.5			HOT WATER	ALL	CDVC	ASTM D 2846; ASTM F 441; ASTM F 442; CSA B137.6	FG	1"	SEE NOTE 2
	2"	1/"	1/2"	4	w/ ANTI-SCALD VALVES		SANITARY	ALL	C.I. OR P.V.C.	SERVICE WEIGHT	NONE	-	NO HUB
		/2	_	4	.,		VENT	ALL	C.I. OR P.V.C.	SCH. 40	NONE	-	SEE NOTE 1
	2"	34"	34"	1.5	w/ ANTI-SCALD VALVES		ST BELOW GRADE	ALL	C.I. OR P.V.C.	SERVICE WEIGHT	NONE	-	NO HUB
	2"	1/2"	1/2"	2	w/ anti-scald valves		ST ABOVE GRADE	ALL	C.I. OR P.V.C.	SERVICE WEIGHT	FG	1"	NO HUB
	2"	1/2"	1/2"	1.5	w/ garbage disposal unit		CONDENSATE	ALL	P.V.C.	SCH. 40	FG	1"	SEE NOTE 3
					5.8 GALLONS PER LOAD (4GALLONS PER CYCLE)		NOTES:						

 WASTES AND VENT PIPING IN PLENUM SPACE SHALL BE SERVICE WEIGHT CAST IRON, NO HUB. 2. FIBERGLASS PIPE INSULATION: MINERAL OR GLASS FIBERS BONDED WITH A THERMOSETTING RESIN. SEMIRIGID BOAR MATERIAL WITH FACTORY-APPLIED ASJ COMPLYING WITH ASTM C 1393, OR WITH PROPERTIES SIMILAR TO ASTM C 612. NOMINAL DENSITY IS 2.5 LB/CU. FT. OR MORE. THERMAL CONDUCTIVITY (K VALUE) AT 100°F (55°C) IS 0.29 BTU X IN. /H X SO.FT. X DEG. F (0.042 W/M X K) OR LESS. ALL SERVICE JACKET (ASJ): WHITE, KRAFT-PAPER. FIBERGLASS-REINFORCED SCRIM WITH ALLMINUM-FOIL BACKING; COMPLYING WITH ASTM C 1136, TYPE MANUFACTURERS; A. CERTAINEED CORP., B. JOHNS MANVILLE, C. KNAUF INSULATION, D. OWENS CORNING 3. HEAT TRACE FREEZE LINE. COORDINATE WITH KITCHEN EQUIPMENT PROVIDER AND FREEZER REQUIREMENTS.

WATER HAMMER ARRESTOR SCHEDULE.

INSTALLED ARRESTORS SHALL BE APPROVED DEVICE BY FLORIDA PLUMBING CODE. ALL SUPPLY PIPING SHALL HAVE ARRESTOR THE SAME SIZE AS CONNECTION SIZE UP TO 1" I.E. PROVIDE P.D.I. SIZE "C" FOR 1" OR LARGER WATER SUPPLY TO FIXTURES, P.D.I. SIZE "B" FOR 3/4" SUPPLY AND P.D.I. SIZE "A" FOR 1/2" SUPPLY.

* P.D.I. SIZE	Connection Size						
A (1–11 F.U.)	1/2"						
B (12–32 F.U.)	3/4"						
C (33–60 F.U.)	1*						
* P.D.I.= PLUMBING AND DRAINAGE INSTITUTE STANDARD WH-201							

VALVE TAG & SCHEDULE NOTES:

- VALVE TAGS: STAMPED OR ENGRAVED BRASS TAG WITH 1/4 INCH LETTERS FOR PIPING SYSTEM ABBREVIATION AND 1/2 INCH NUMBERS, WITH NUMBERING SCHEME. VALVE SCHEDULES: FOR EACH PIPING SYSTEM ON STANDARD SIZE BOND PAPER, TABULATE VALVE NUMBER, PIPING SYSTEM, SYSTEM ABBREVIATION (AS SHOWN ON VALVE TAG), LOCATION OF VALVE
- (ROOM OR SPACE), NORMAL-OPEATING POSITION (OPEN, CLOSED, MODULATING), AND VARIATIONS FOR IDENTIFICATION. MARK VALVES FOR EMERGENCY SHUTOFF AND SIMILAR SPECIAL ISSUES. A. VALVE SCHEDULE FRAMES: GLASS DISPLAY FRAME FOR REMOVABLE MOUNTING ON WALLS FOR EACH PAGE OF VALVES SCHEDULE. INCLUDE MOUNTING SCREWS.

NOTES

B. FRAME: EXTRUDED ALUMINUM.

- I. ALL WASTE PIPING JOINTS SHALL BE SOLDERED, OR SOLVENT CEMENTED SO AS TO FORM A SOLID CONNECTION PER F.B.C. 2017 6TH EDITION 405.8 CRITERIA, IF NO ACCESS IS PROVIDED FOR
- SUCH PIPE CONNECTIONS. A WATER-HAMMER ARRESTORS SHALL BE INSTALLED WHERE QUICK-CLOSING VALVES ARE UTILIZED, UNLESS OTHERWISE APPROVED. WATER-HAMMER ARRESTORS SHALL CONFORM TO ASSE
- 1010. ACCESS SHALL BE PROVIDED TO WATER-HAMMER ARRESTORS. 3. ALL STORM DRAINAGE RUN OFF FROM ROOF AND TERRACES SHALL TERMINATE AT GRASSY AREA, AND SHALL BE RETAINED WITHIN THE PROPERTY. SEE ARCHITECTURE PLAN.
- 4. AL AIR ADMITTANCE VALVES LOCATION SHALL BE PER F.B.C. 2020 7TH EDITION 917.3.1. 5. SEE ARCHITECTURAL PLANS FOR ALL OCCUPANCY LOADS OF COMMON AREAS. 6. ALL PLUMBING WATER DEVICE PROVIDE SHUTT-OFF VALVE.
- PLUMBING FIXTURES SHALL COMPLY WITH REFERENCED STANDARDS AS PER F.B.C. 7TH EDITION 2020 PLUMBING CHAPTER: 4.
- 3. ALL THE CIRCULATING PIPING INSULATION SHALL COMPLY BY F.B.C. 7TH EDITION 2020 SECTION

PLUMBING GENERAL NOTES CONTRACTOR SHALL COMPLY WITH ALL APPLICABLE CODES AND GOVERNING AUTHORITIES. I.E.: FLORIDA

HAVE 1/8" PER FOOT MINIMUM SLOPE UNLESS OTHERWISE INDICATED.

ALL SANITARY PIPING 2-1/2" OR LESS SHALL HAVE A 1/4" PER FOOT SLOPE. ALL SANITARY PIPING 3" OR LONGER SHALL HAVE A 1/8" PER FOOT SLOPE UNLESS OTHERWISE NOTED. ALL STORM WATER PIPING 2-1/ SHALL HAVE 1/4" PER FOOT MINIMUM HORIZONTAL SLOPE. ALL STORM WATER PIPING 3" OR LARGER SHALL

VALVES AND FITTINGS SHALL BE OF SAME SIZE OF LINE ON WHICH THEY ARE LOCATED, UNLESS OTHERWISE

INSTALL WATER HAMMER SHOCK ARRESTORS AT EACH FIXTURE OR BATTERY OF FIXTURES WHERE REQUIRED. ARRESTORS SHALL BE FACTORY FABRICATED. INSTALL ARRESTORS AND SIZE PER PLUMBING AND DRAINAGE INSTITUTE STANDARD P.D.I. WH-201. ACCEPTABLE MANUFACTURERS: JOSAM, WATTS AND SIOUX CHIEF. AIR CHAMBERS SHALL NOT BE CONSIDERED AN EQUAL TO WATER ARRESTORS AS SPECIFIED.

CONTRACTOR IS RESPONSIBLE FOR MAINTAINING FIRE RATING AND WEATHERPROOFING INTEGRITY OF ALL PIPING

ALL WATER SUPPLY AND SANITARY LINES SHALL RUN AS CLOSE TO PLANS AS POSSIBLE WITH NO CHANGES CONTRACTOR SHALL BE RESPONSIBLE FOR PROVIDING ALL NECESSARY SUPPORTING DEVICES FOR FIXTURES.

CHANGES IN THE DIRECTION OF SANITARY AND STORM DRAINAGE PIPING SHALL NOT BE MADE WITH FITTINGS WHICH WILL CAUSE EXCESSIVE REDUCTION IN THE VELOCITY OF FLOW OR CREATE ANY OTHER ADVERSE EFFE I.E.: USE SANITARY TEE IN HORIZONTAL CONNECTION, USE OF DOUBLE SANITARY TEE IN A VERTICAL STACK, USE OF SHORT RADIUS FITTINGS FOR BRANCH TO HOUSE DRAIN OR STACK CONNECTION.

CONTRACTOR SHALL GIVE 24 HOURS NOTICE TO APPLICABLE UTILITY COMPANY PRIOR TO PERFORMING WORK INVOLVING UTILITIES. ALL DRAINAGE PIPING SHALL BE MARKED WITH THE SEAL OF APPROVAL OF NATIONAL SANITATION FOUNDATION.

WHERE SANITARY SEWER LINES CROSS UNDERGROUND WATER SUPPLY LINES INSTALLATION SHALL COMPLY WITH THE 6TH EDITION 2017 OF FLORIDA PLUMBING CODE, ARTICLE 603.2 CONSTRUCTED OF DUCTILE IRON PIPE (10' EACH SIDE OF WATER MAIN) OR THE WATER LINES SHOULD BE MODIFIED TO PROVIDE 8" MINIMUM CLEARANCI

THE PLUMBING CONTRACTOR MAY BE REQUIRED TO DROP PIPE OUTSIDE OF THE BUILDING TO REQUIRED DEPTI TO PROVIDE CONNECTION TO AREA DEVELOPMENT UTILITY STUB. ALL DROPS IN DEPTH SHALL BE MADE WITH USE OF 45' FITTINGS.

ALL FLOOR DRAINS SHALL BE PROVIDED WITH A TRAP PRIMER VALVE AND FITTINGS UNLESS NOTED OTHERWIS

ROUTE ALL PIPING CONCEALED ABOVE CEILINGS, WITHIN WALLS, OR IN CHASES. EXPOSED PIPING SHALL BE SLOPED AND PAINTED TO MATCH ARCHITECTURAL FINISHES. PIPING IN MECHANICAL ROOMS MAY BE EXPOSE SLEEVE AND FIRE STOP ALL PENETRATIONS (IF ANY) OF RATED WALLS, FLOORS, CEILINGS, ETC., IN

ACCORDANCE WITH APPLICABLE U.L. STANDARDS AND LOCAL CODES TO MAINTAIN RATINGS. REFER TO SPECIFICATIONS AND ARCHITECTURAL DRAWINGS FOR RATED WALLS, CEILINGS AND FLOOR INFORMATION ALL WATER PIPING INSTALLED IN EXTERIOR WALLS BE PLACED ON THE INTERIOR SIDE WALL. THE WALL

Insulation shall be placed on the exterior side of the PIPE. SEE RISER DIAGRAMS FOR BRANCH PIPING DETAILS AND SIZES NOT SHOWN ON PLANS.

COLD AND HOT WATER PIPING SHALL BE COPPER WATER TUBE (ASTM B88) TYPE "L" WITH WROUGHT-COPPER (ANSI 16.22), OR CAST BRASS (ANSI B16.18), PRESSURE FITTINGS AND ALLOY GRADE (ANSI-ASTM B32) 95TA LEAD-FREE SOLDER JOINTS. DISINFECT WATER PIPING AFTER PRESSURE TEST (WITH CHLORINE SOLUTION 50 MG-L) FOR 24 HOURS. FLUSH LINES CLEAN AFTER COMPLETION.

SOIL, WASTE AND VENT PIPING SHALL BE P.V.C.: ASTM D2665 SCHEDULE 40. FITTINGS: P.V.C. DWV, JOINTS ASTM WELD. PROVIDE CAST IRON PIPE AND FITTINGS FOR SOIL, WASTE AND VENT PIPING LOCATED IN CEILING

PROVIDE CLEANOUTS AT BASE OF EACH VERTICAL STACK, AT EACH CHANGE OF DIRECTION OF HORIZONTAL RUNS AND AT 100 FOOT INTERVALS OF HORIZONTAL RUNS FOR SANITARY AND STORM PIPING. PROVIDE ACCESS PANELS TO ALL VALVES WITHIN CHASES OR ABOVE NON-ACCESSIBLE CEILINGS. REFER TO ARCHITECTURAL DRAWINGS FOR CEILINGS TYPES.

METERING AND SITE UTILITY CONNECTIONS SHALL BE PROVIDED ON SITE UTILITY DRAWINGS. ALL SERVICES SHOWN ON THIS SET OF PLANS TERMINATE 5'-0" FROM BUILDING, UNLESS SHOWN OTHERWISE ON DRAWINGS. PLUMBING CONTRACTOR SHALL MAKE FINAL CONNECTIONS TO SITE UTILITIES.

FURNISH AND INSTALL HOSE BIBBS AND/OR WALL HYDRANTS 24" ABOVE FINISH GRADE/FLOOR AND PROVIDE SEE ARCHITECTURAL DRAWINGS FOR EXACT LOCATIONS OF ROOF DRAINS, PLUMBING FIXTURE MOUNTING

CONTRACTOR SHALL VERIFY INVERT ELEVATIONS OF EXISTING SEWERS IN WHICH NEW SEWER LINES ARE TO BE CONNECTED PRIOR TO INSTALLATION.

26. CONTRACTOR SHALL INSTALL DIELECTRIC UNIONS AT CONNECTIONS OF DISSIMILAR METALS.

CONTRACTOR SHALL ROUGH-IN ALL WASTE AND SUPPLIES TO SPECIAL EQUIPMENT ACCORDING TO MANUFACTURERS SHOP DRAWNGS AND MAKE FINAL CONNECTIONS. ALL SUPPLIES SHALL BE VALVED. INSTALL VACUUM BREAKERS WHERE REQUIRED BY CODE.

. ALL BELOW GRADE/SLAB COPPER PIPE SHALL BE PLACED WITHIN COPPER SLEEVE (10 MIL) POLYETHYLENE

PLASTIC SLEEVING. EXTEND SLEEVING ABOVE GRADE/SLAB. CONTRACTOR SHALL REFER TO ARCHITECTURAL DRAWINGS FOR EXACT LOCATION OF FLOOR DRAINS (IF ANY)

PROVIDE REDUCED PRESSURE BACKFLOW PREVENTERS FOR DOMESTIC WATER SUPPLY CONNECTIONS AS

PRESSURE REDUCING VALVES SHALL BE INSTALLED ON BRANCH LINES SERVING FIXTURES AND/OR EQUIPMENT

WHEN THE PRESSURE IN THE LINE DISCHARGE INTO SANITARY SYSTEM COORDINATE EXACT LOCATION OF FLOOR DRAINS FOR HVAC EQUIPMENT WITH MECHANICAL CONTRACTOR. CONDENSATE PIPING SHALL NOT DISCHARGE INTO SANITARY SYSTEM.

ROUTE WATER LINES TIGHT TO STRUCTURE. COORDINATE ROUTING TO AVOID CONFLICTS WITH OTHERS

IF THE INTENT OF THE DRAWINGS AND/OR SPECIFICATIONS IS UNCLEAR OR HAS MORE THAN ONE INTERPRETATION, IT SHALL BE BROUGHT TO THE ATTENTION OF THE ARCHITECT/ENGINEER IN WRITING BEFORE THE SUBMISSION OF BIDS. THE ARCHITEC/ENGINEER SHALL MAKE CORRECTIONS AND/OR PROVIDE

 Plans and specifications are intended as a general description of the work to be performed. AI
ITEMS NOT SPECIFICALLY MENTIONED OR SHOWN, BUT NO NECESSARY FOR THE COMPLETION OF THE INSTALLATION, SHALL BE FURNISHED AND INSTALLED BY THIS CONTRACTOR. THE CONTRACTOR SHALL ACQUAINT HIMSELF WITH THE MECHANICAL, ARCHITECTURAL, STRUCTURAL AND ELECTRICAL PLANS PRIOR TO SUBMITTING HIS FINAL BID. NO ADDITIONAL COMPENSATION WILL BE ALLOWED DUE TO CONTRACTORS FAILURE TO FAMILIARIZE HIMSELF WITH THE PLANS.

6. THE CONTRACTOR SHALL BASE HIS PROPOSAL UPON THE EQUIPMENT AS SCHEDULED OR SPECIFIED, USING THE MANUFACTURERS AND EQUIPMENT SPECIFIED ON THE DRAWINGS. IF MORE THAN ONE MANUFACTURER IS SPECIFIED FOR ONE ITEM, ANY ONE OF THE MANUFACTURERS LISTED MAY BY USED IN THIS CONTRACTOR'S PROPOSAL IF THIS CONTRACTOR WISHES TO USE EQUIPMENT NOT SPECIFIED, HE MUST AT THE TIME OF BIDDIN SUBMIT SEPARATELY ON LETTERHEAD STATIONARY OF THE BIDDER, THE EQUIPMENT HE WOULD SUBSTITUTE AND THE COST TO BE ADDED OR TO BE DEDUCTED FROM HIS PROPOSAL.

THE CONTRACTOR IS EXPECTED TO ORDER ALL MATERIALS IN SUFFICIENT TIME TO AVOID DELAYING THE COMPLETION OF THE PROJECT. DELAY IN DELIVERY WILL NOT BE CONSIDERED A JUSTIFIABLE REASON FOR SUBMISSION OF SUBSTITUTE MATERIALS.

DO NOT PENETRATE WALL FOOTINGS WITH PIPING. COORDINATE WITH GENERAL CONTRACTOR TO DROP FOOTINGS AS REQUIRED TO CLEAR PLUMBING SERVICES WHERE ABSOLUTELY NECESSARY. ALL PIPING PENETRATING A BEARING WALL OR FOOTING MUST BE SLEEVED AND LOCATION APPROVED BY STRUCTURAL ENGINEER.

REFER TO PLANS FOR VENT THRU ROOF (V.T.R.) PIPES SIZES AND LOCATIONS. LOCATE V.T.R. A MIN. 10' HORIZONTAL FROM ANY BUILDING OPENING OR FRESH AIR INTAKE. EXTEND V.T.R. 12" ABOVE ROOF SURFACE. II 10' DISTANCE CANNOT BE ACHIEVED LOCATE V.T.R. 2' ABOVE ADJACENT TOP OF FRESH AIR INTAKE OR BUILDING OPENINGS. PROVIDE 1" FIBERGLASS INSULATION WITH ALL-SERVICE JACKET ON VENT PIPE INSIDE

BUILDING WITHIN 6' OF V.T.R. LOCATION. VERIFY FLASHING AND COUNTERFLASHING AND COORDINATE

ARCHITECT OF RECORD: MR. ARCHITECT, LLC AA 26002308 MIGUEL RIONDA LIC. # AR 94189 15125 NE 9th CT NORTH MIAMI BEACH, FLORIDA 33162 o: 786.696.4276 info@mr-architect.com

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SIGN AND SEAL:

ADDRESS:

2300 Hollywood Blvd. Hollywood, FL 33020

PROJECT:

Religious Worship and Education

TENANT:

OHR HATORAH

SHEET TITLE:

PLUMBING NOTES AND DETAILS

No. Description Date 10_2022 **Project Number:** 05/04/22 Date:

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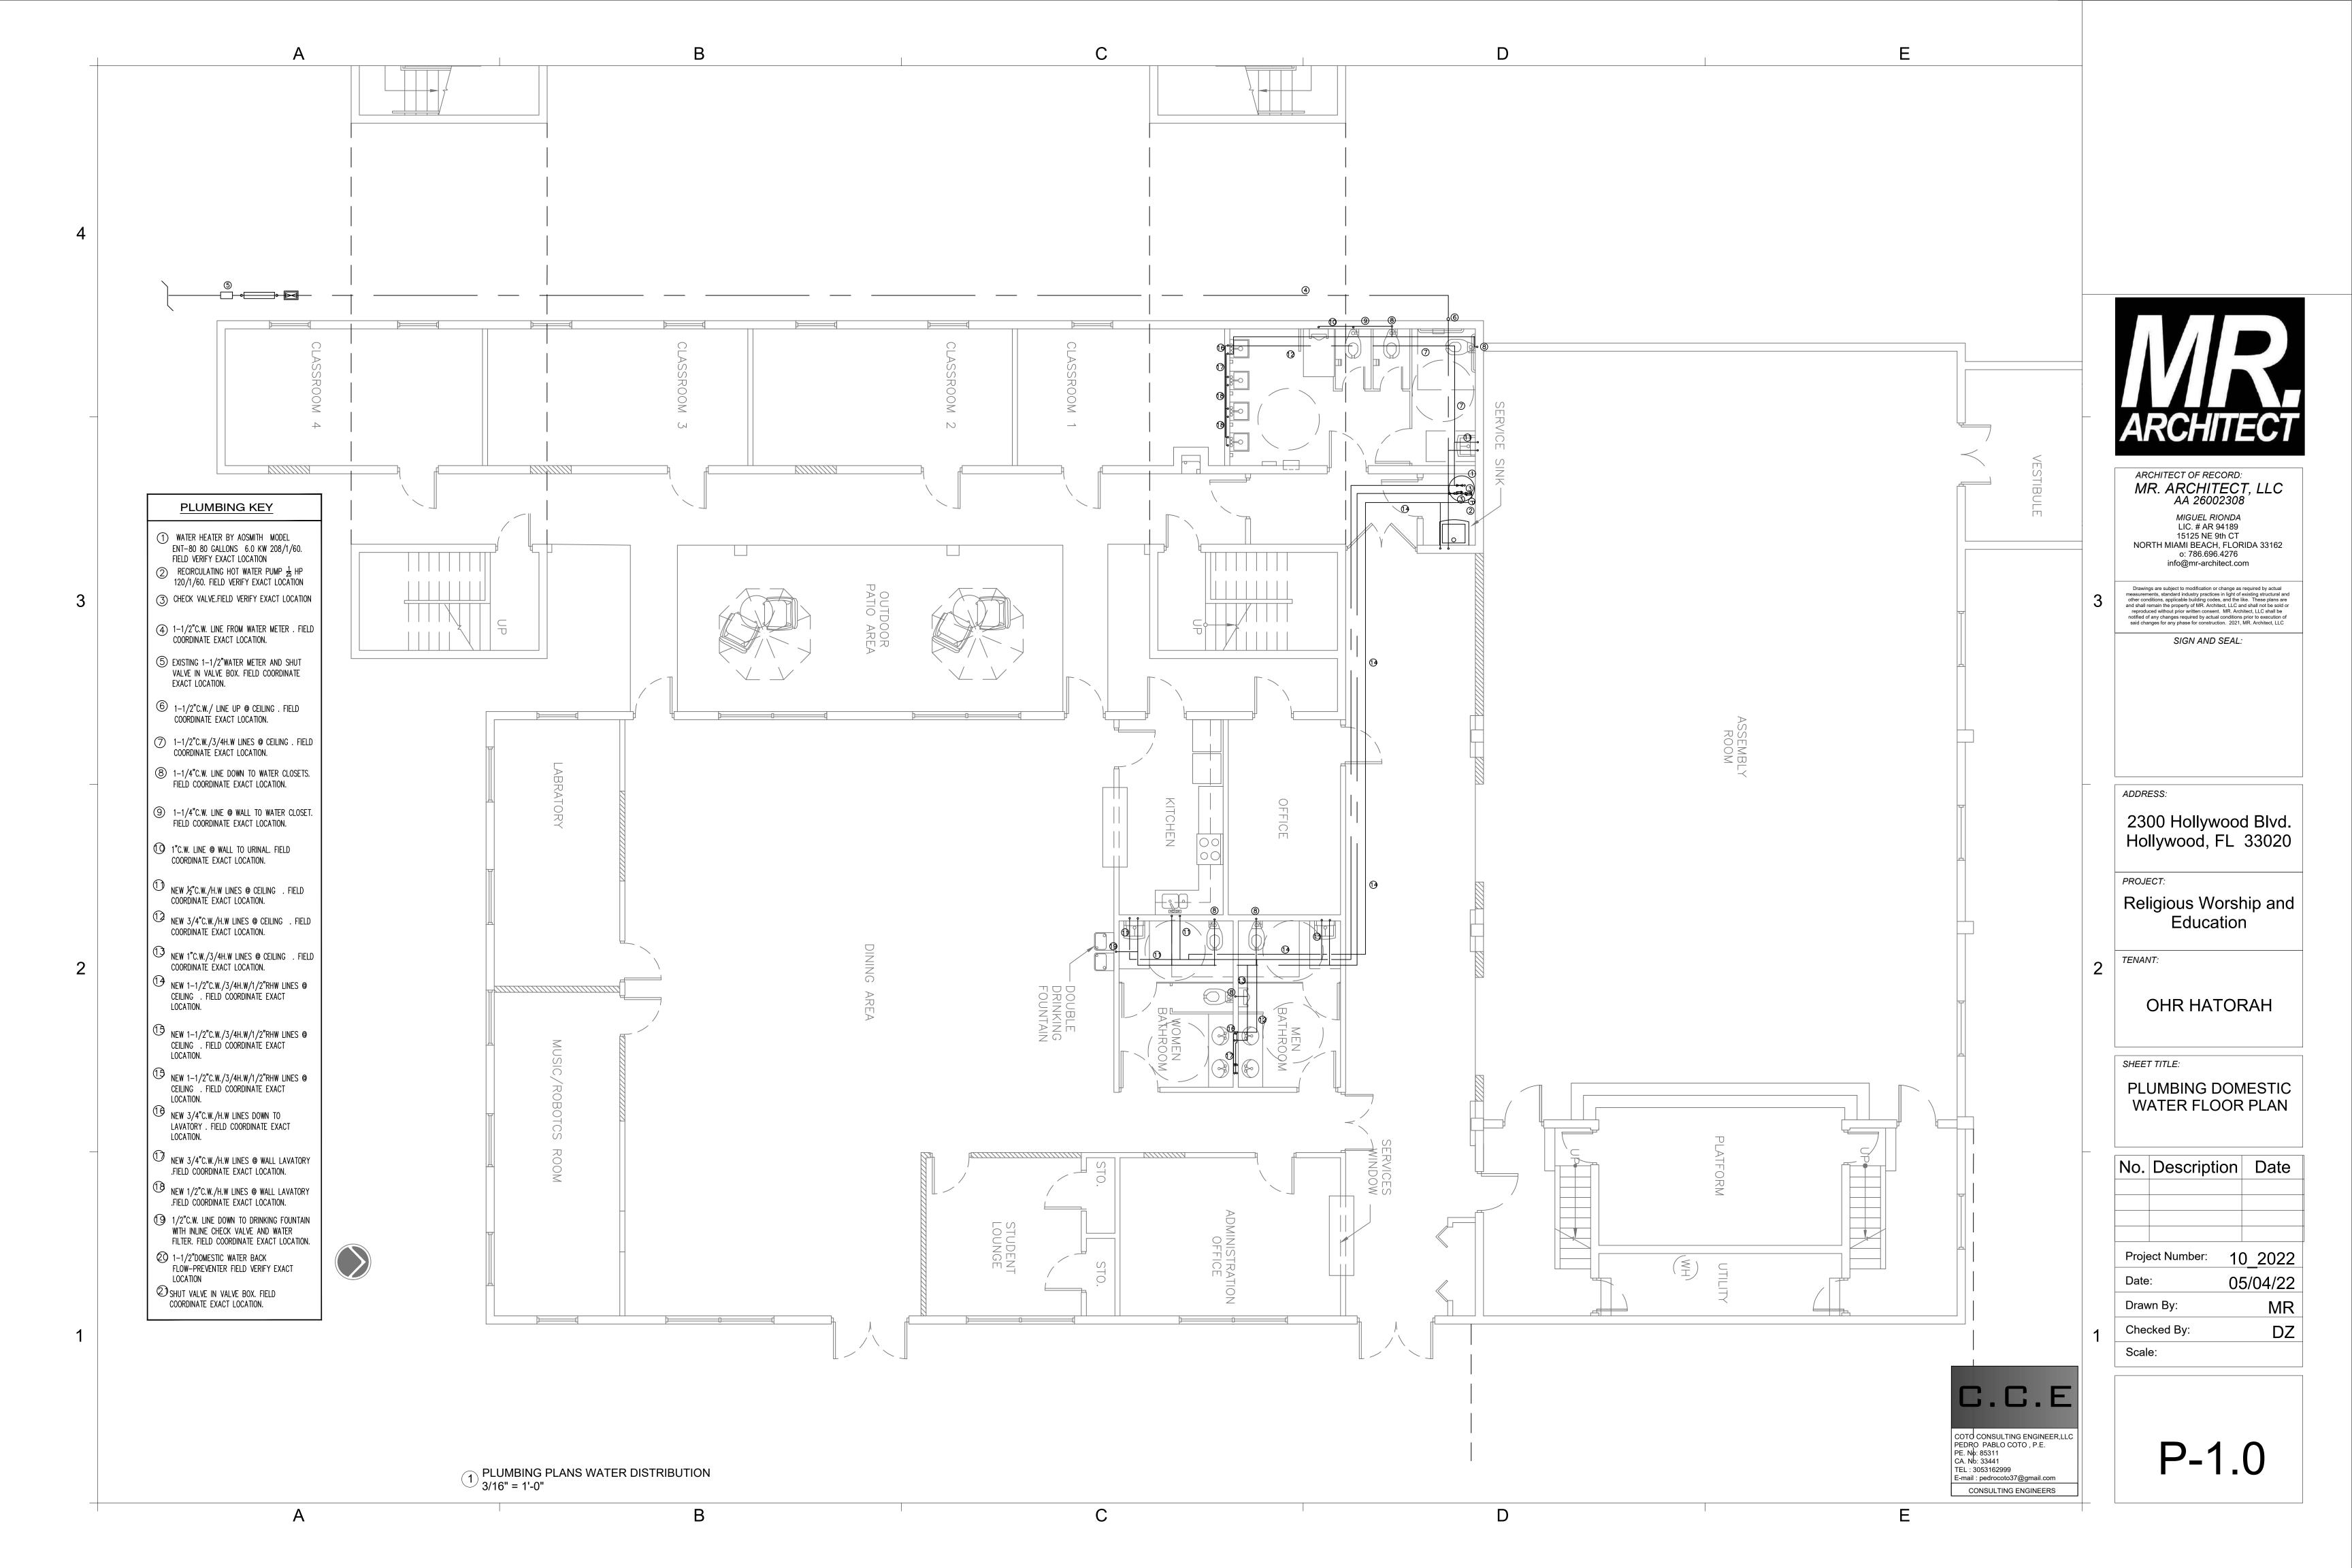
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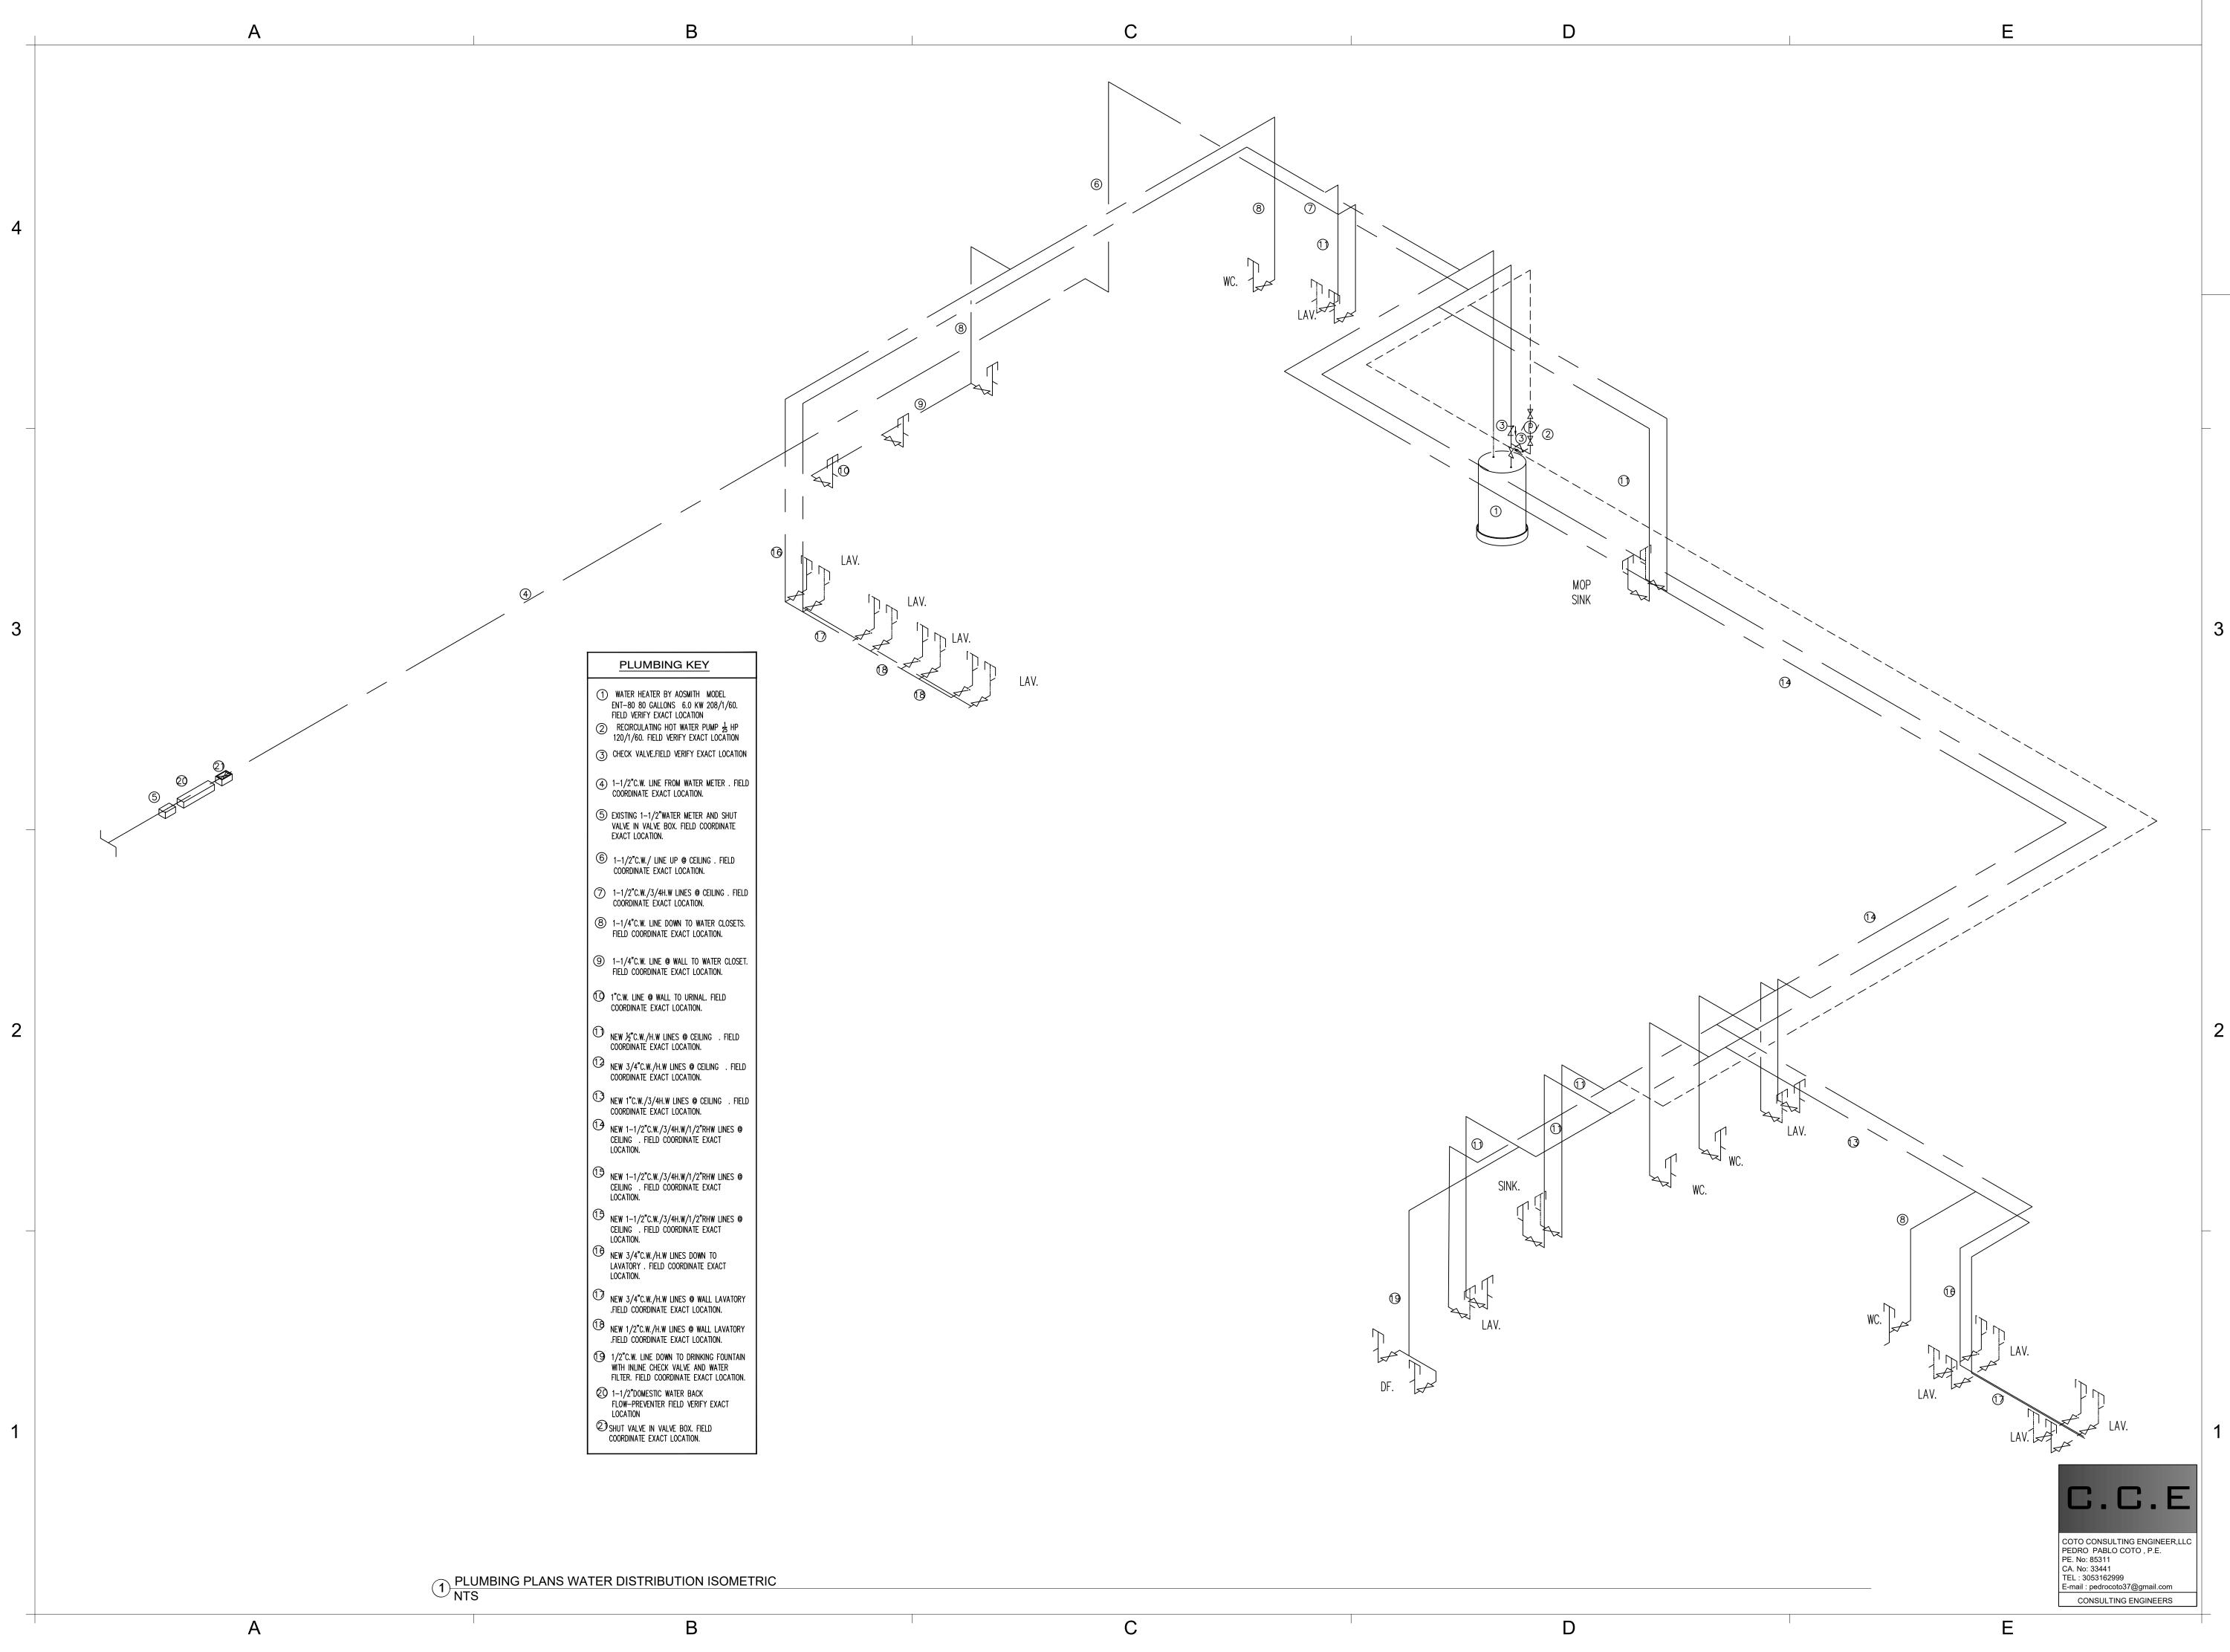
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1 PLUMBING NOTES AND DETAILS NTS

C.C.E COTO CONSULTING ENGINEER,LLC PEDRO PABLO COTO , P.E. PE. No: 85311 CA. No: 33441 TEL: 3053162999 E-mail : pedrocoto37@gmail.com CONSULTING ENGINEERS

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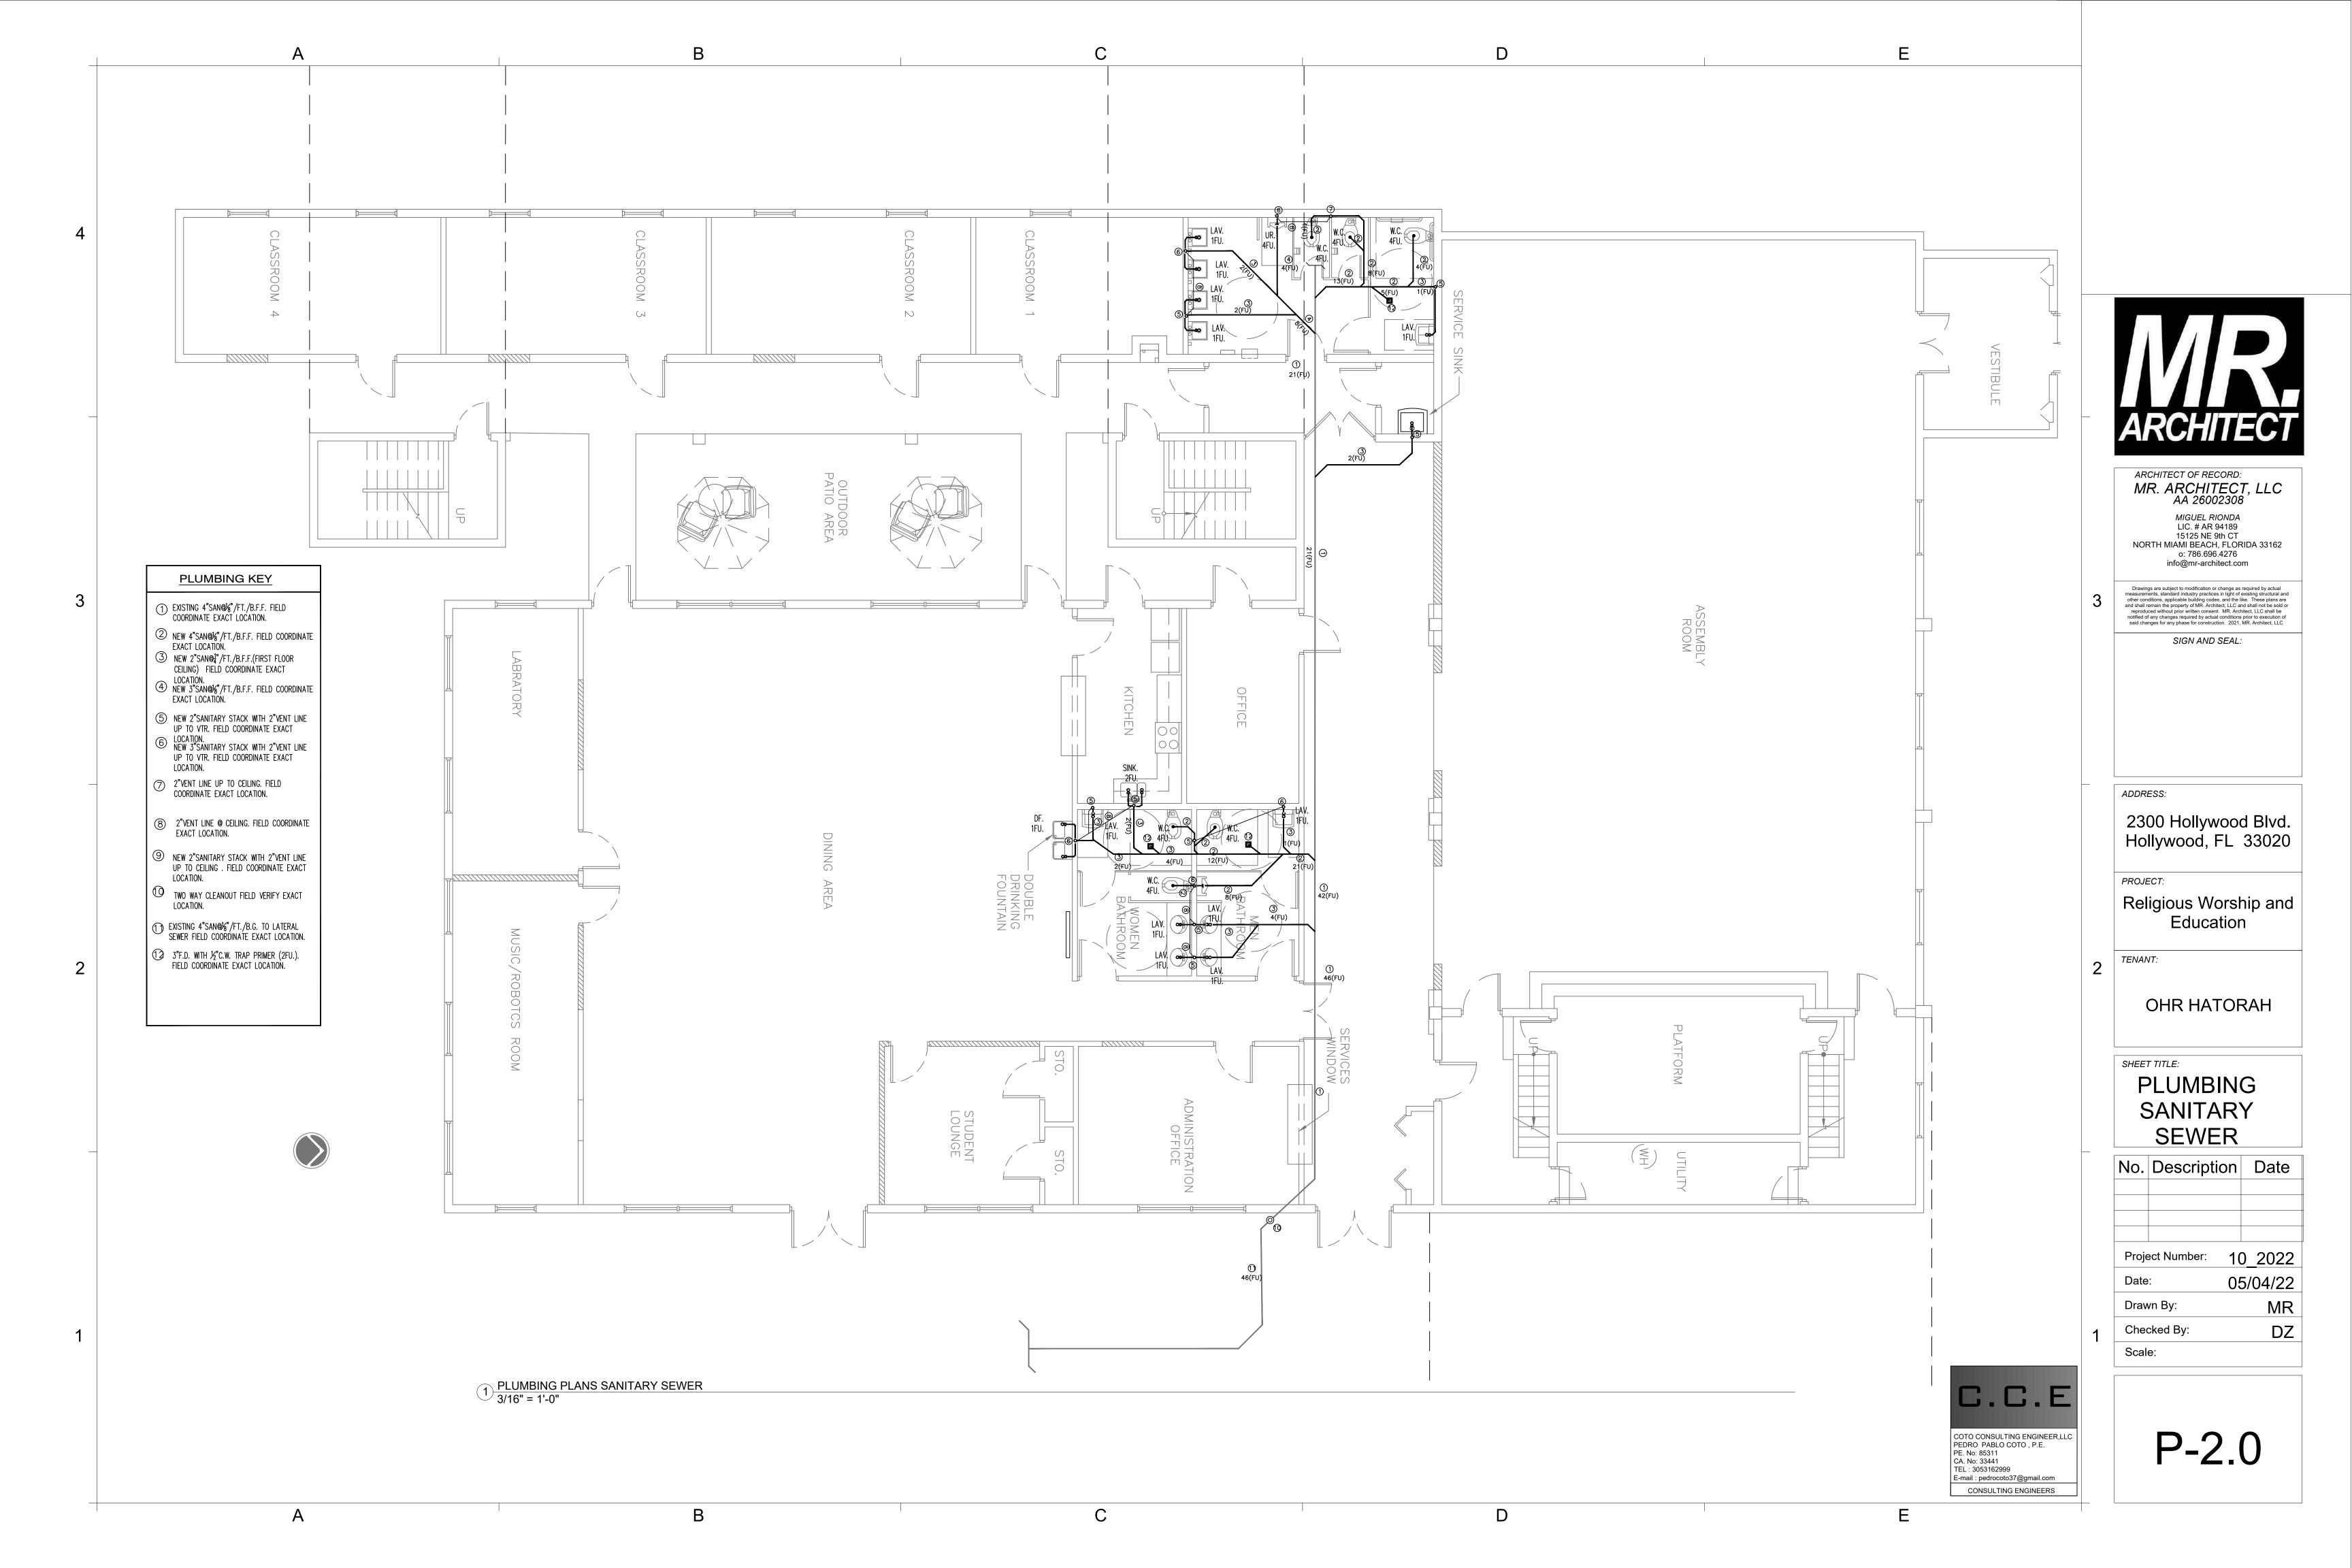
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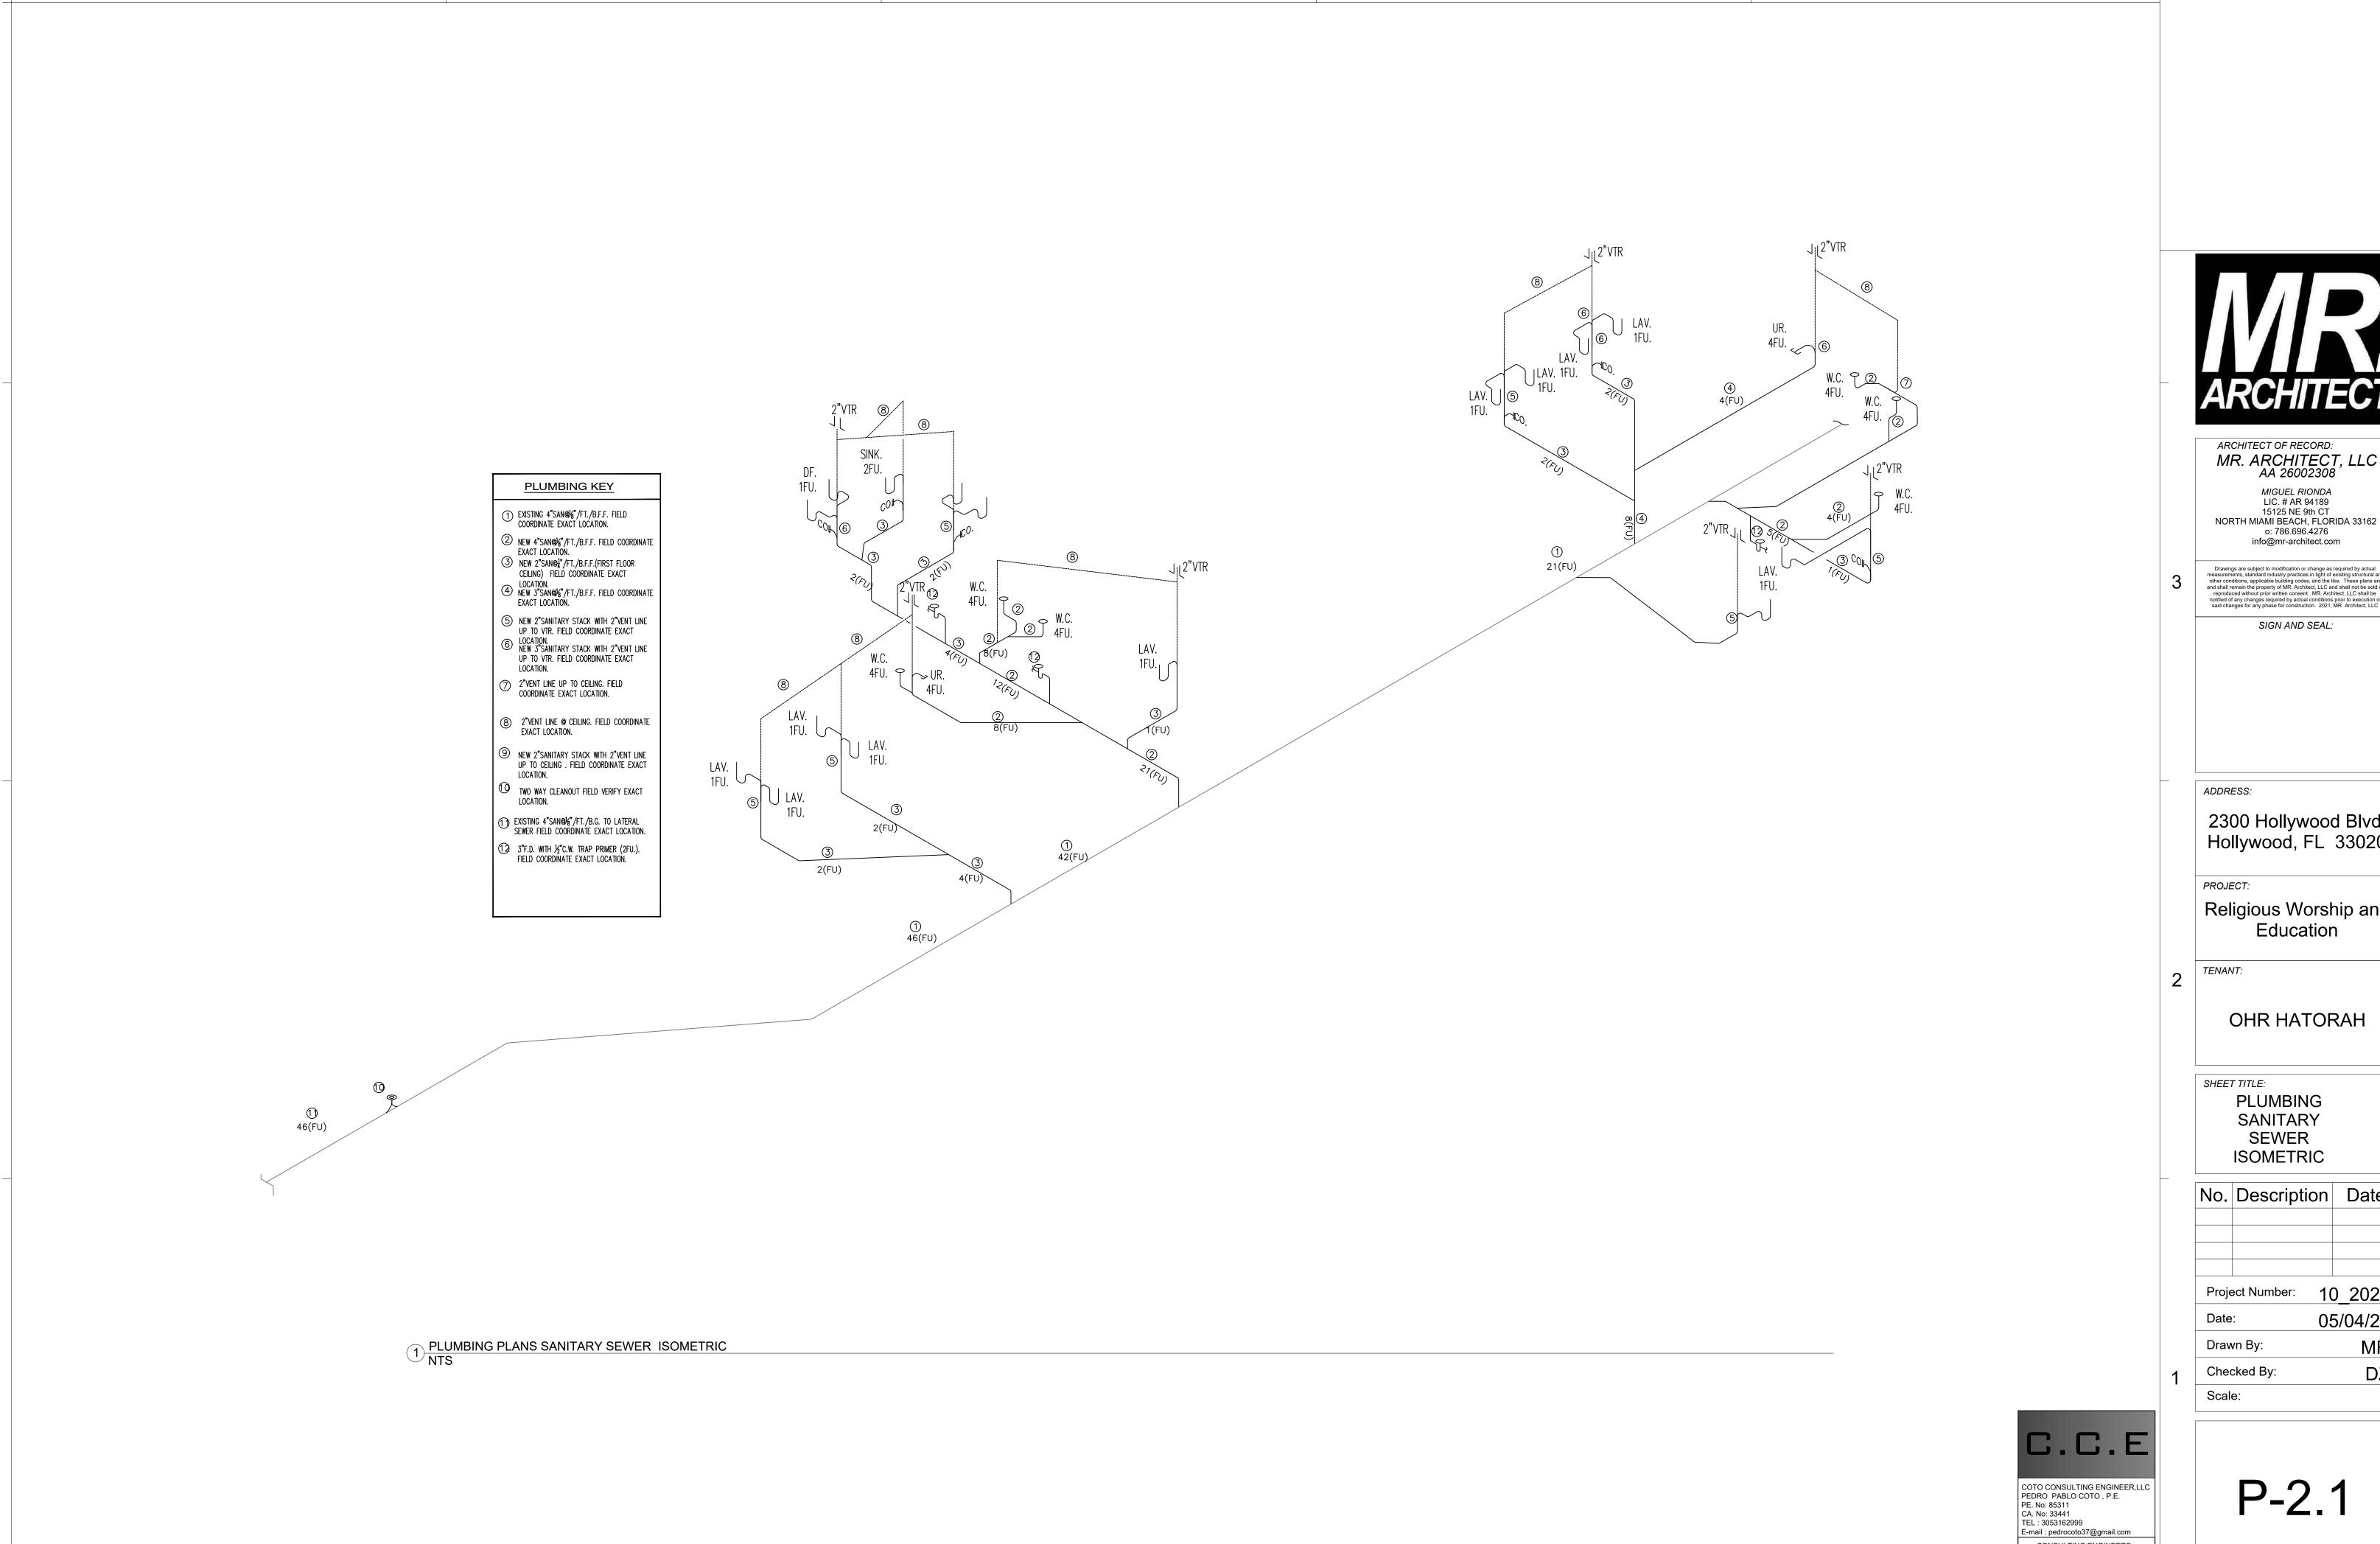
SHEET TITLE:

PLUMBING DOMESTIC WATER ISOMETRIC

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ARCHITECT OF RECORD: MR. ARCHITECT, LLC AA 26002308 MIGUEL RIONDA LIC. # AR 94189 15125 NE 9th CT NORTH MIAMI BEACH, FLORIDA 33162 o: 786.696.4276

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PLUMBING SANITARY SEWER ISOMETRIC

No.	Descripti	on	D	ate
Proje	ect Number:	<u> 10</u>	_2	2022
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CONSULTING ENGINEERS

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ALL CONSTRUCTION AND MATERIALS SHALL CONFORM TO APPLICABLE STANDARDS AND SPECIFICATIONS OF THE CITY OF HOLLYWOOD DEPARTMENT OF PUBLIC UTILITIES, ENGINEERING AND CONSTRUCTION SERVICES DIVISION (ECSD), AND ALL OTHER LOCAL, STATE AND NATIONAL CODES, WHERE APPLICABLE.

LOCATIONS, ELEVATIONS, SIZES, MATERIALS, ALIGNMENTS, AND DIMENSIONS OF EXISTING FACILITIES UTILITIES AND OTHER FEATURES ARE SHOWN ACCORDING TO THE BEST INFORMATION AVAILABLE AT THI TIME OF THE PREPARATION OF THESE PLANS: AND DO NOT PURPORT TO BE ABSOLUTELY CORRECT. ALSO THERE MAY HAVE BEEN OTHER IMPROVEMENTS, UTILITIES, ETC., WITHIN THE PROJECT AREA WHICH WER CONSTRUCTED AFTER THE PREPARATION OF THESE PLANS AND/OR THE ORIGINALSITE SURVEY. THE CONTRACTOR SHALL VERIFY THE LOCATIONS, ELEVATIONS, AND OTHER FEATURES AFFECTING HIS/HEF WORK PRIOR TO CONSTRUCTION, AND NOTIFY THE ENGINEER IMMEDIATELY WHEN CONFLICT BETWEEN DRAWINGS AND ACTUAL CONDITIONS ARE DISCOVERED. THE ENGINEER ASSUMES NO RESPONSIBILITY FOR ANY FACILITIES SHOWN OR NOT SHOWN ON THE PLANS. THE CONTRACTOR SHALL WORK AS NEEDED TO AVOID CONFLICT WITH EXISTING UTILITIES (NO ADDITIONAL COST SHALL BE PAID FOR THIS WORK). EXISTING UTILITIES SHALL BE MAINTAINED IN SERVICE DURING CONSTRUCTION UNLESS OTHERWISE APPROVED BY THE RESPECTIVE UTILITY OWNER.

4. THE CONTRACTOR SHALL COORDINATE WITH ALL UTILITIES TO ARRANGE FOR THE RELOCATION AND TEMPORARY SUPPORT OF UTILITY FEATURES, ETC. AS NECESSARY TO COMPLETE THE WORK.

IT SHALL BE THE CONTRACTOR'S RESPONSIBILITY TO LOCATE AND PROTECT ANY AND ALL EXISTING UTILITIES ON THIS PROJECT, AND TO ENSURE THAT EXISTING UTILITIES ARE MAINTAINED IN SERVICE DURING CONSTRUCTION UNLESS APPROVED OTHERWISE BY THE UTILITY OWNER.

CONTRACTOR SHALL ADJUST ALL EXISTING UTILITY CASTINGS INCLUDING VALVE BOXES, MANHOLES HAND-HOLES, PULL-BOXES, STORMWATER INLETS, AND SIMILAR STRUCTURES IN CONSTRUCTION AREA TO BE OVERLAID WITH ASPHALT PAVEMENT.


7. THE CONTRACTOR IS REQUIRED TO OBTAIN ALL APPLICABLE CONSTRUCTION AND ENVIRONMENTAL PERMITS PRIOR TO THE START OF CONSTRUCTION.

8. THE CONTRACTOR SHALL NOTIFY ECSD AT LEAST 48 HOURS PRIOR TO BEGINNING CONSTRUCTION

9. PRIOR TO THE COMMENCEMENT OF CONSTRUCTION AND INSTALLATION OF THE PROPOSED IMPROVEMENTS, SHOP DRAWINGS SHALL BE SUBMITTED TO ECSD IN ACCORDANCE WITH THE CONTRACT DOCUMENT'S REQUIREMENTS, FOR APPROVAL. IN ADDITION, IT IS THE CONTRACTOR'S RESPONSIBILITY TO OBTAIN ANY OTHER AGENCY SHOP DRAWING APPROVAL, IF REQUIRED.

10. THE CONTRACTOR SHALL NOTIFY ECSD IMMEDIATELY FOR ANY CONFLICT ARISING DURING CONSTRUCTION OF ANY IMPROVEMENTS SHOWN ON THESE DRAWINGS. THIS WORK BY THE CONTRACTOR SHALL BE CONSIDERED INCIDENTAL TO THE CONTRACT AND NO ADDITIONAL COMPENSATION SHALL BE ALLOWED.

11. ELEVATIONS SHOWN ARE IN FEET AND ARE REFERENCED TO THE NORTH AMERICAN VERTICAL DATUM OF 1988 (NAVD 88).

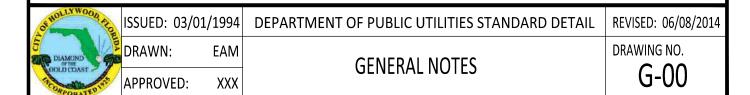

LOCATION MAP

LEGAL DESCRIPTION

THE WEST 1/2 OF LOT 6, LESS THE NORTH 7 1/2 FEET FOR ALLEY, BLOCK 6, HOLLYWOOD LITTLE RANCHES, ACCORDING TO THE PLAT THEREOF AS RECORDED IN PLAT BOOK 1, PAGE 26, OF THE PUBLIC RECORDS OF BROWARD COUNTY, FLORIDA.

LOT 7, LESS THE NORTH 7.5 FEET, BLOCK 6, HOLLYWOOD LITTLE RANCHES, ACCORDING TO THE PLAT THEREOF AS RECORDED IN PLAT BOOK 1, PAGE 26, OF THE PUBLIC RECORDS OF BROWARD COUNTY, FLORIDA.

LOT 16, AND THE WEST 1/2 OF LOT 17, BLOCK 6, HOLLYWOOD LITTLE RANCHES, ACCORDING TO THE PLAT THEREOF AS RECORDED IN PLAT BOOK 1, PAGE 26, OF THE PUBLIC RECORDS OF BROWARD COUNTY, FLORIDA, LESS THE FOLLOWING

PORTION OF LOT 16 DEEDED TO THE CITY OF HOLLYWOOD, FLORIDA BY QUIT CLAIM DEED RECORDED IN OFFICIAL RECORDS BOOK 2295, PAGE 94, PUBLIC RECORDS OF BROWARD COUNTY, FLORIDA, DESCRIBED AS FOLLOWS: THAT PORTION OF LOT SIXTEEN (16), BLOCK SIX (6), HOLLYWOOD LITTLE RANCHES AMENDED, ACCORDING TO THE PLAT THEREOF AS RECORDED IN PLAT BOOK 1, PAGE 26 OF THE PUBLIC RECORDS OF BROWARD COUNTY, FLORIDA, MORE PARTICULARLY DESCRIBED BY METES AND BOUNDS AS FOLLOWS: BEGINNING AT THE SOUTHWEST CORNER OF SAID LOT 16, BLOCK 6, THENCE RUN NORTHERLY ALONG THE WEST PROPERTY LINE FOR A DISTANCE OF SIX FEET TO A POINT; THENCE RUN EASTERLY PARALLEL TO THE SOUTH PROPERTY LINE A DISTANCE OF TWENTY-FIVE FEET TO A POINT; THENCE RUN NORTHEASTERLY FOR A DISTANCE OF TEN FEET ONE AND A. QUARTER INCHES MORE OR LESS, TO A POINT WHICH IS SEVEN AND ONE-HALF FEET NORTH OF THE SOUTH PROPERTY LINE OF SAID LOT 16; THENCE RUN EASTERLY ALONG A LINE PARALLEL TO THE SOUTH PROPERTY LINE A DISTANCE OF SIXTY-FIVE FEET MORE OR LESS, TO A POINT ON THE

AND LESS THE FOLLOWING PORTION OF LOT 17 DEEDED TO THE CITY OF HOLLYWOOD, FLORIDA BY QUIT CLAIM DEED RECORDED IN OFFICIAL RECORDS BOOK 2295, PAGE 96, PUBLIC RECORDS OF BROWARD COUNTY, FLORIDA, DESCRIBED AS

EAST PROPERTY LINE; THENCE RUN SOUTHERLY ALONG THE EAST PROPERTY LINE OF SAID LOT 16 A DISTANCE OF SEVEN AND ONE-HALF FEET TO THE SOUTH PROPERTY LINE; THENCE RUN WESTERLY ALONG THE SOUTH PROPERTY LINE OF

THE SOUTH SEVEN AND ONE-HALF FEET OF THE WEST HALF OF LOT 17, BLOCK 6, HOLLYWOOD LITTLE RANCHES AMENDED, ACCORDING TO THE PLAT THEREOF AS RECORDED IN PLAT BOOK 1, PAGE 26 OF THE PUBLIC RECORDS OF BROWARD

GENERAL NOTES (CONTINUED):

27. THE CONTRACTOR SHALL BE RESPONSIBLE FOR MAINTAINING THE INTEGRITY OF AND MAKING THE REPAIRS TO EXISTING PAVEMENT, SIDEWALKS, PIPES, CONDUITS, CURBS, CABLES, ETC., WHETHER OR NOT SHOWN ON THE PLANS DAMAGED AS A RESULT OF THE CONTRACTORS OPERATIONS AND/OR THOSE OF HIS SUBCONTRACTORS, AND SHALL RESTORE THEM PROMPTLY AT NO ADDITIONAL EXPENSE TO THE OWNER, CONTRACTOR SHALL REPORT ANY DAMAGE TO SIDEWALK, DRIVEWAY, ETC., PRIOR TO **BEGINNING WORK IN ANY AREA.**

28. WHERE NEW PAVEMENT MEETS EXISTING, CONNECTION SHALL BE MADE IN A NEAT STRAIGHT LINE AND FLUSH WITH EXISTING PAVEMENT TO MATCH EXISTING CONDITIONS.

29. UNDER NO CIRCUMSTANCES SHALL THE CONTRACTOR LEAVE EXCAVATED TRENCHES, OR PARTS OF, EXPOSED OR OPENED AT THE END OF THE WORKING DAY, WEEKENDS, HOLIDAYS OR OTHER TIMES, WHEN THE CONTRACTOR IS NOT WORKING, UNLESS OTHERWISE DIRECTED. ALL TRENCHES SHALL BE COVERED, FIRMLY SECURED AND MARKED ACCORDINGLY FOR PEDESTRIAN / VEHICULAR TRAFFIC.

30. ALL EXCAVATED MATERIAL REMOVED FROM THIS PROJECT SHALL BE DISPOSED OF OFF THE PROPERTY BY THE CONTRACTOR AT THE CONTRACTOR'S EXPENSE.

31. ALL DUCTILE IRON PRODUCTS SHALL BE DOMESTIC MADE HEAVY DUTY CLASSIFICATION SUITABLE FOR HIGHWAY TRAFFIC LOADS, OR 20,000 LB.

32. ALL GRASSED AREAS AFFECTED BY CONSTRUCTION SHALL BE RE-SODDED.

33. THE CONTRACTOR SHALL BE RESPONSIBLE FOR THE PROVISION, INSTALLATION AND MAINTENANCE OF ALL TRAFFIC CONTROL AND SAFETY DEVICES, IN ACCORDANCE WITH SPECIFICATIONS OF THE LATEST REVISION OF FDOT DESIGN STANDARDS. IN ADDITION, THE CONTRACTOR IS RESPONSIBLE FOR THE RESETTING OF ALL TRAFFIC CONTROL AND INFORMATION SIGNAGE REMOVED DURING THE CONSTRUCTION PERIOD.

34. EXCAVATED OR OTHER MATERIAL STORED ADJACENT TO OR PARTIALLY UPON A ROADWAY PAVEMENT SHALL BE ADEQUATELY MARKED FOR TRAFFIC SAFETY AT ALL TIMES.


35. TEMPORARY PATCH MATERIAL MUST BE ON THE JOB SITE WHENEVER PAVEMENT IS CUT, OR THE CITY'S INSPECTOR WILL SHUT THE JOB DOWN.

36. CONTRACTOR MUST PROVIDE FLASHER ARROW SIGNAL FOR ANY LANE THAT IS CLOSED OR DIVERTED.

37. CONTRACTOR SHALL NOTIFY LAW ENFORCEMENT AND FIRE PROTECTION SERVICES TWENTY-FOUR (24) HOURS IN ADVANCE OF TRAFFIC DETOUR IN ACCORDANCE WITH SECTION 336.07 OF FLORIDA STATUTES.


38. CONTRACTOR TO RESTORE PAVEMENT TO ORIGINAL CONDITION AS REQUIRED.

of HOLLYWOOD ATO	ISSUED: 03/01	1/1994	DEPARTMENT OF PUBLIC UTILITIES STANDARD DETAIL	REVISED: 11/06/2017
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SAID LOT 16, A DISTANCE OF ONE HUNDRED FEET TO THE POINT OF BEGINNING;

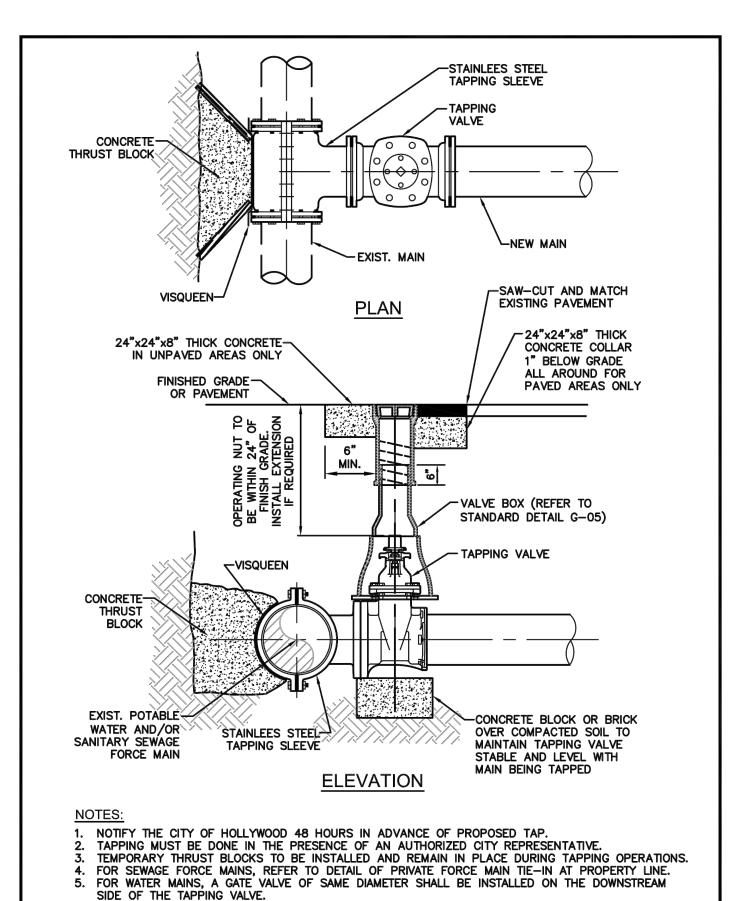OFHOLLYWOOD S	ISSUED:	03/01/1994	DEPARTMENT OF PUBLIC UTILITIES STANDARD DETAIL	REVISED: 06/08/2014	
DIAMOND or rue	DRAWN:	EAM	TYPICAL TAPPING SLEEVE	DRAWING NO.	
APPROVED:): XXX	AND VALVE SETTING	G-06	
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GENERAL NOTES (CONTINUED):

- 12. CITY OF HOLLYWOOD SHALL NOT PROVIDE STAGING / STORAGE AREA. CONTRACTOR SHALL SECURE STAGING / STORAGE AREA AS NECESSARY FOR CONSTRUCTION WORK.
- 13. CONTRACTOR SHALL HAUL AWAY EXCESSIVE STOCKPILE OF SOIL FOR DISPOSAL EVERY DAY. NO STOCKPILE
- SOIL IS ALLOWED TO BE LEFT ON THE CONSTRUCTION SITE OVER NIGHT. 14. CONTRACTOR SHALL CLEAN / SWEEP THE ROAD AT LEAST ONCE DAY OR AS REQUIRED BY THE ENGINEER.
- 15. CONTRACTOR SHALL PROTECT CATCH BASINS WITHIN / ADJACENT TO THE CONSTRUCTION SITE AS **REQUIRED BY NPDES REGULATIONS.**
- 16. THE CITY OF HOLLYWOOD HAS A NOISE ORDINANCE (CHAPTER 100) WHICH PROHIBITS EXCAVATION AND CONSTRUCTION BEFORE 8:00 A.M. AND AFTER 6:00 P.M., MONDAY THROUGH SATURDAY AND ALL DAY
- 17. SUITABLE EXCAVATED MATERIAL SHALL BE USED IN FILL AREAS. NO SEPARATE PAY ITEM FOR THIS WORK, INCLUDE COST IN OTHER ITEMS.
- 18. ALL ROAD CROSSINGS ARE OPEN CUT AS PER THE REQUIREMENTS OF THE ECSD UNLESS OTHERWISE NOTED ON THE DRAWINGS.
- 19. THE CONTRACTOR SHALL REPLACE ALL PAVING, STABILIZING EARTH, DRIVEWAYS, PARKING LOTS, SIDEWALKS, ETC. TO SATISFY THE INSTALLATION OF THE PROPOSED IMPROVEMENTS WITH THE SAME TYPE OF MATERIAL THAT WAS REMOVED DURING CONSTRUCTION OR AS DIRECTED BY ECSD FIELD
- 20. THE CONTRACTOR SHALL NOT ENCROACH INTO PRIVATE PROPERTY WITH PERSONNEL, MATERIAL OR EQUIPMENT. IN CASE WORK ON PRIVATE PROPERTY IS NEEDED, A CITY OF HOLLYWOOD "RIGHT OF ENTRY" FORM MUST BE SIGNED BY PROPERTY OWNER AND THE DIRECTOR OF PUBLIC UTILITIES. THE CONTRACTOR IS RESPONSIBLE TO MAINTAIN ACCESS AT ALL TIMES TO PRIVATE HOMES/BUSINESSES
- 21. THE CONTRACTOR SHALL BE RESPONSIBLE FOR DAMAGE, REMOVAL OR MODIFICATION, CAUSED TO ANY IRRIGATION SYSTEM (PRIVATE OR PUBLIC) ACCIDENTALLY OR PURPOSELY. THE CONTRACTOR SHALL REPLACE ANY DAMAGED, REMOVED OR MODIFIED IRRIGATION PIPES, SPRINKLER HEADS OR OTHER PERTINENT APPURTENANCES TO MATCH OR EXCEED EXISTING CONDITIONS AT NO ADDITIONAL COST TO
- 22. MAIL BOXES, FENCES OR OTHER PRIVATE PROPERTY DAMAGED DURING THE CONSTRUCTION OF THE PROPOSED IMPROVEMENTS SHALL BE REPLACED TO MATCH OR EXCEED EXISTING CONDITION.
- 23. CONTRACTOR SHALL PROVIDE MAINTENANCE OF TRAFFIC IN ACCORDANCE WITH FDOT STANDARDS AND CITY OF HOLLYWOOD DEPARTMENT OF PUBLIC UTILITIES STANDARDS.
- 24. NO TREES ARE TO BE REMOVED OR RELOCATED WITHOUT PRIOR APPROVAL FROM THE ECSD FIELD ENGINEER.
- 25. THE CONTRACTOR IS RESPONSIBLE FOR OBTAINING THE NECESSARY TREE REMOVAL OR RELOCATION PERMITS FROM THE CITY OF HOLLYWOOD BUILDING DEPARTMENT FOR TREES LOCATED IN THE PUBLIC RIGHT OF WAY.
- 26. IT IS THE INTENT OF THESE PLANS TO BE IN ACCORDANCE WITH APPLICABLE CODES AND AUTHORITIES HAVING JURISDICTION. ANY DISCREPANCIES BETWEEN THESE PLANS AND APPLICABLE REGULATORY STANDARDS / REQUIREMENTS SHALL BE IMMEDIATELY BROUGHT TO THE ATTENTION OF ECSD.

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GENERAL NOTES (CONTINUED):

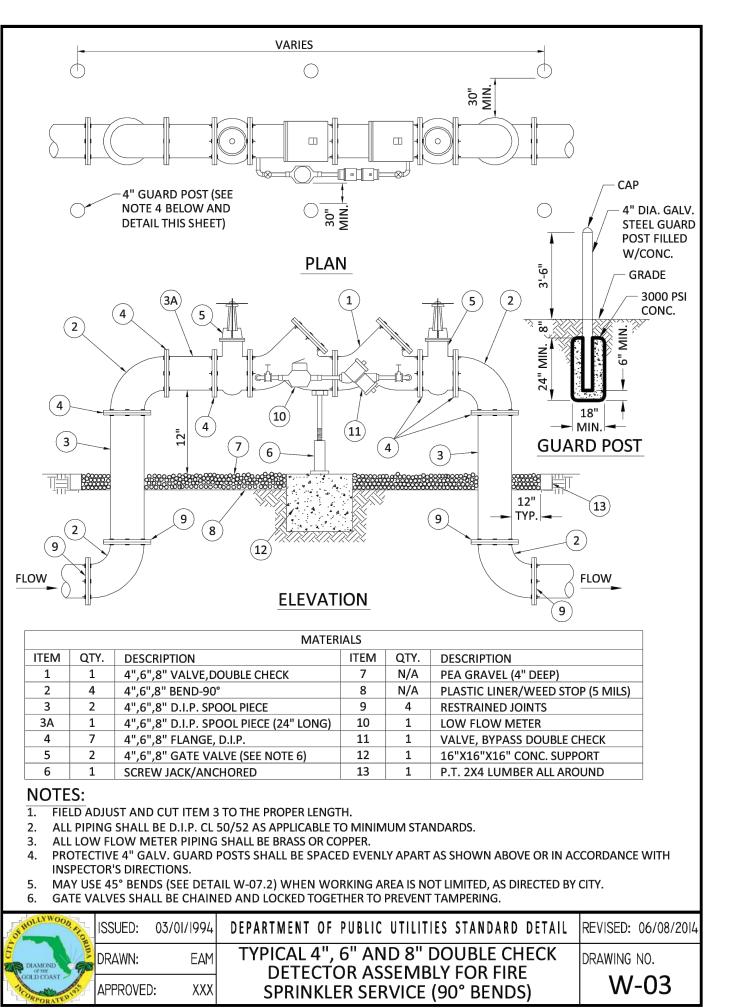40. THE CONTRACTOR SHALL GIVE AT LEAST 48 HOURS NOTICE TO UTILITY COMPANIES TO PROVIDE FOR THE LOCATION OF EXISTING UNDERGROUND UTILITIES IN ADVANCE OF CONSTRUCTION. CONTACT UTILITIES NOTIFICATION CENTER AT 811 OR 1-800-432-4770 (SUNSHINE ONE-CALL OF FLORIDA).

Sunshine 811 Call 811 or visit sunshine811.com two full business days before digging to have buried facilities located and marked.

Check positive response codes before you dig!

- 41. WHEN PVC PIPE IS USED, A METALLIZED MARKER TAPE SHALL BE INSTALLED CONTINUOUSLY 18" ABOVE THE PIPE. THE MARKER TAPE SHOULD BE IMPRINTED WITH A WARNING THAT THERE IS BURIED PIPE BELOW. THE TAPE SHALL BE MAGNA TEC, AS MANUFACTURED BY THOR ENTERPRISES INC. OR APPROVED EQUAL.
- 42. ALL CONNECTIONS TO EXISTING MAINS SHALL BE THE RESPONSIBILITY OF THE CONTRACTOR. WATER CONNECTIONS SHALL BE METERED, AND THE COST OF WATER AND TEMPORARY METER SHALL BE BORNE BY THE CONTRACTOR.
- 43. A COMPLETE AS-BUILT SURVEY SHALL BE ACCURATELY RECORDED OF THE UTILITY SYSTEM DURING CONSTRUCTION. AS-BUILT SURVEY SHALL BE SUBMITTED TO ECSD SIGNED AND SEALED BY A FLORIDA REGISTERED SURVEYOR PRIOR TO FINAL INSPECTION AND ACCEPTANCE OF PROJECT. THE COST OF SIGNED AND SEALED AS-BUILTS SHALL BE COVERED IN OVERALL BID. THE AS-BUILT SURVEY SHALL INCLUDE:
- a. PLAN VIEW SHOWING THE HORIZONTAL LOCATIONS OF EACH MANHOLE, INLET, VALVE, FITTING. BEND AND HORIZONTAL PIPE DEFLECTIONS WITH COORDINATES AND IN REFERENCE TO A SURVEY BASELINE OR RIGHT-OF-WAY CENTERLINE.
- b. THE PLAN VIEW SHALL ALSO SHOW SPOT ELEVATIONS OF THE TOP OF THE MAIN (WATER MAIN AND FORCE MAIN) OR PIPE INVERTS (GRAVITY MAINS) AT INTERVALS NOT TO EXCEED 100 FEET AS MEASURED ALONG MAIN. THE PLAN VIEW SHALL ALSO INCLUDE SPOT ELEVATIONS AT EACH MANHOLE, INLET, VALVE, FITTING, BEND AND VERTICAL PIPE DEFLECTION.
- c. THE PLAN VIEW SHALL ALSO SHOW THE HORIZONTAL SEPARATION FROM UNDERGROUND UTILITIES IMMEDIATELY ADJACENT OR PARALLEL TO THE NEW MAIN.
- d. PROFILE VIEW WITH SPOT ELEVATIONS OF THE TOP OF THE MAIN (WATER MAIN AND FORCE MAIN) OR PIPE INVERT (GRAVITY MAIN) AND OF THE FINISHED GRADE OR MANHOLE RIM DIRECTLY ABOVE THE MAIN AT INTERVALS NOT TO EXCEED 100 FEET AS MEASURED ALONG THE MAIN. THE PROFILE VIEW SHALL ALSO INCLUDE SPOT ELEVATIONS AT EACH MANHOLE, INLET, VALVE, FITTING, BEND AND VERTICAL PIPE DEFLECTION.
- e. THE PROFILE VIEW SHALL SHOW ALL UNDERGROUND UTILITIES CROSSING THE NEW MAIN AND THE VERTICAL SEPARATION PROVIDED BETWEEN THAT UNDERGROUND UTILITY AND THE NEW MAIN.
- ALL CADD FILES MUST BE CREATED FOLLOWING THE CITY OF HOLLYWOOD "SURVEY / AS-BUILT CAD DRAWING STANDARDS"

Obstance Of the Control of the Contr	ISSUED:	03/01/1994	DEPARTMENT OF PUBLIC UTILITIES STANDARD DETAIL	REVISED:	11/06/20
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	APPROVED): XXX	(CONTINUED)	G-0	10.3

SCOPE OF WORK

PROPOSED 4" DIP FIRE LINE TO SERVE

TWO-STORY COMMERCIAL BUILDING

INDEX OF SHEETS:

W-2 PROPOSED FIRE LINE CONNECTION PLAN

W-1 CIVIL COVER SHEET AND NOTES



ICARLAB. INC ENGINEER AND PLANNERS CERTIFICATE OF AUTHORIZATION 641 8730 S.W. 25 STREET, MIAMI, FL 33165 TEL: 786 385.4093 | FAX: 305 226-0438

E-MAIL: SLABISTE@CARLABINC.COM

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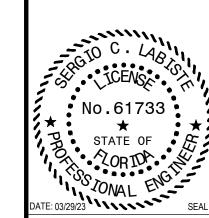
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REVISIONS DATE B CARLAB, INC PROJECT NUMBER 22-1924

HECKED DESIGNED A.M.G. SCALE AS SHOWN 11/14/22


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SERGIO C. LABISTE P.E. #61733

CIVIL COVER SHEET AND

ET NUMBER




LEGEND

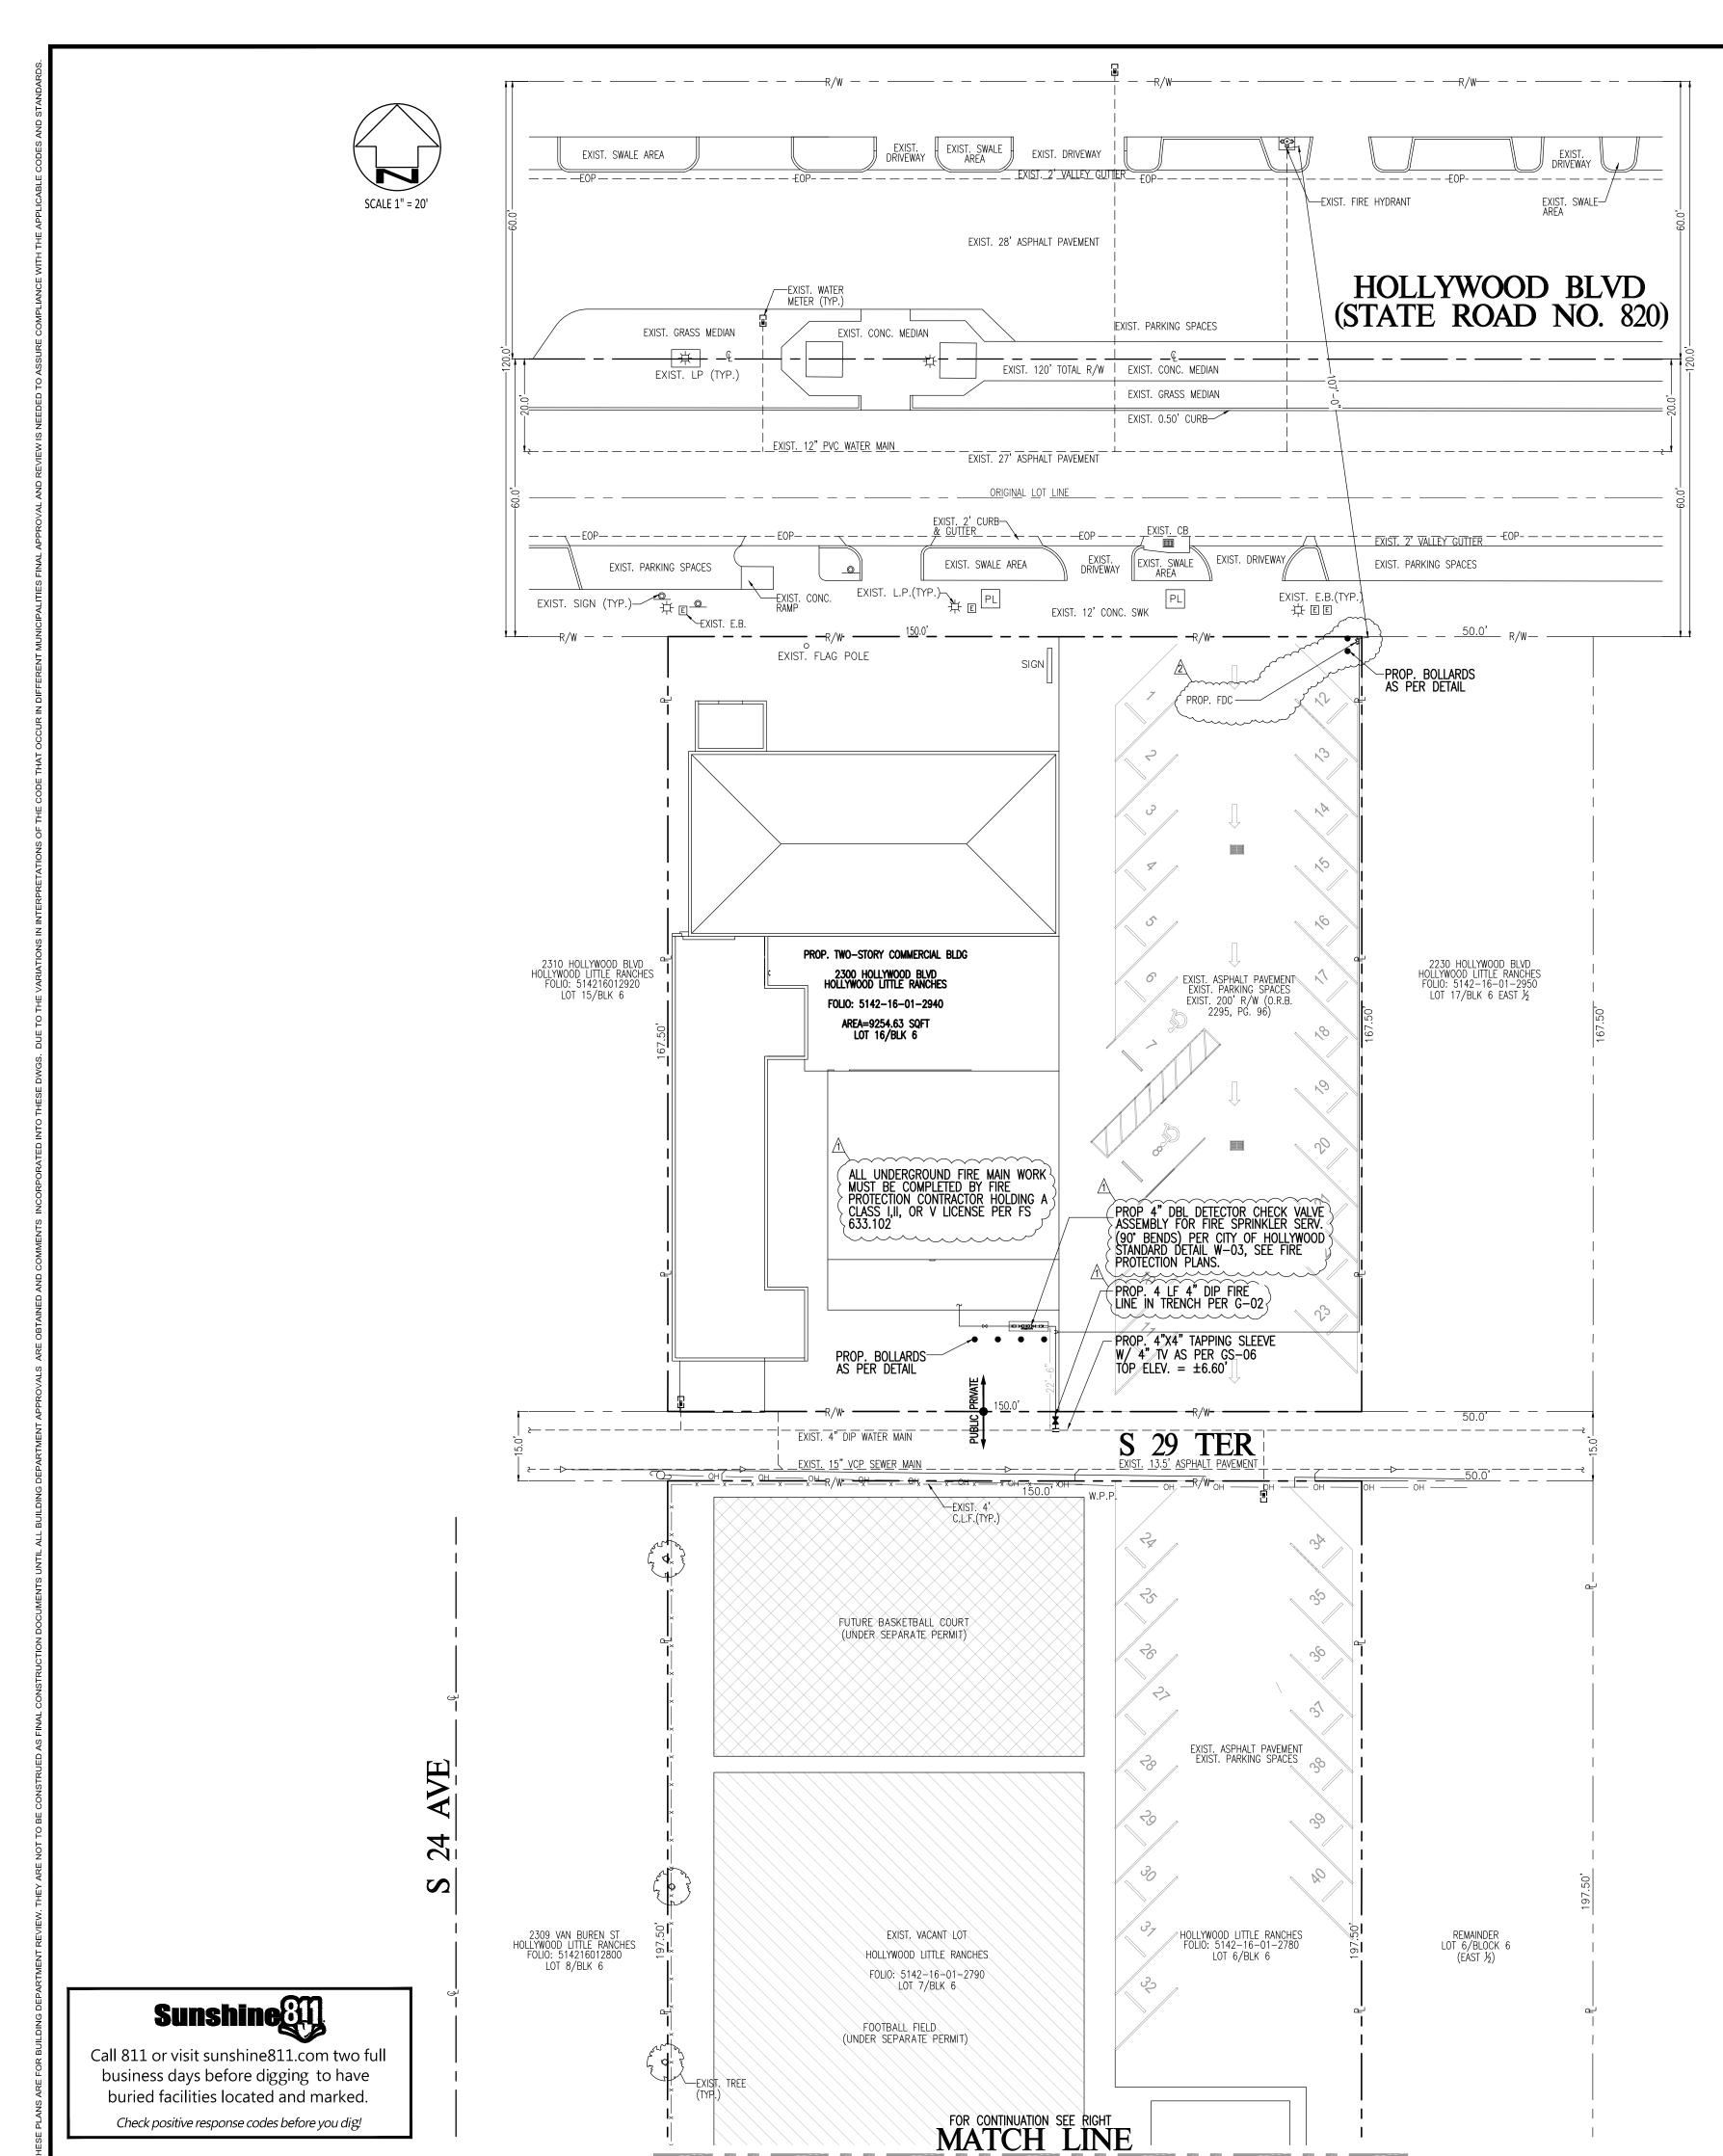GAS MAIN — SIZE	G Section line $$
TELEPHONE DUCT UNDERGROUND (U) — SIZE	RIGHT-OF-WAY —R/W —
OVERHEAD (0)	PROPERTY LINE —— €-——
TELEPHONE DUCT UNDERGROUND (U) — SIZE OVERHEAD (O)	T — CENTER LINE —————
ELECTRICAL PULL BOX — — ET	BASE LINE — B
STORM SEWER —— SIZE	SD MONUMENT LINE ——\frac{1}{2}
CATCH BASIN OR INLET	B. EDGE OF PAVEMENT ——EOP———
DENOTES EXISTING EXIST	EXISTING UTILITY POLE
DENOTES PROPOSED PROF	EXISTING CONCRETE POLE \square
DENOTES TYPICAL TYP.	EXISTING TREE
DENOTES VALLEY GUTTER VG	EXISTING PALM TREE 🤺
TO BE FIELD VERIFIED TBFV	EXISTING WOOD FENCE — // —
EXISTING OVERHEAD WIRE OH	EXISTING ELECTRICAL BOX
EXISTING CHAIN LINK FENCE — × –	_


	<u>EXISTING</u>	<u>PROPOSED</u>
FLUSHING VALVE OUTLET	Φ	•
WATER MAIN (W.M.)	_ø,(MATERIAL)_W.M.	ø,(MATERIAL) W.M
GATE AND PLUG VALVE		———
METER (SINGLE SERVICE)		
METER (DUAL SERVICE)		<u></u>
METER BOX		
REDUCER		
TEE, CROSS	$+^{T}++_{\pm}^{T}+-$	
FIRE HYDRANT	0 Ĉ1	
SANITARY SEWER (SAN)	ø,(MATERIAL) SAN. 	ø,(MATERIAL) SAN
SAN. MANHOLE	(MH)	
CLEAN-OUT	C	8

ENGINEER'S NOTES:

- 1. SURVEY OBTAINED FROM VIZCAYA SURVEYING AND MAPPING, INC (FLORIDA CERTIFICATE OF AUTHORIZATION # LB 8000)
- 2. ALL UNDERGROUND INFORMATION SHALL BE VERIFIED WITH THE DIFFERENT UTILITY COMPANIES BEFORE THE START OF ANY CONSTRUCTION OR EXCAVATION, NEITHER THE ENGINEER OR OWNER/DEVELOPER SHALL BE RESPONSIBLE FOR THIS ITEM. SHOULD FIELD DIFFER CONTACT ENGINEER IMMEDIATELY.
- 3. ALL WORK SHALL BE DONE IN ACCORDANCE WITH THE CITY OF HOLLYWOOD DEPARTMENT OF PUBLIC UTILITIES ENGINEERING AND CONSTRUCTION SERVICES STANDARDS AND
- 4. ALL UNDERGROUND INSTALLATIONS SHALL BE PROTECTED AT ALL TIMES DURING CONSTRUCTION AND EXCAVATION.
- 5. FOR PAVEMENT RESTORATION REFER TO CITY OF HOLLYWOOD AND BROWARD COUNTY PUBLIC WORKS STANDARDS AND SPECIFICATIONS (PER G-12 & G-12.1). CONTRACTOR TO RESTORE EXISTING PAVEMENT AND SWALE AREAS DISTURBED DURING CONSTRUCTION TO ORIGINAL CONDITIONS.

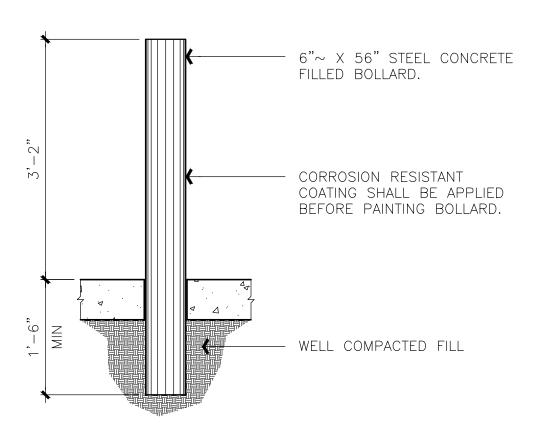

BOLLARD DETAIL 3/4"

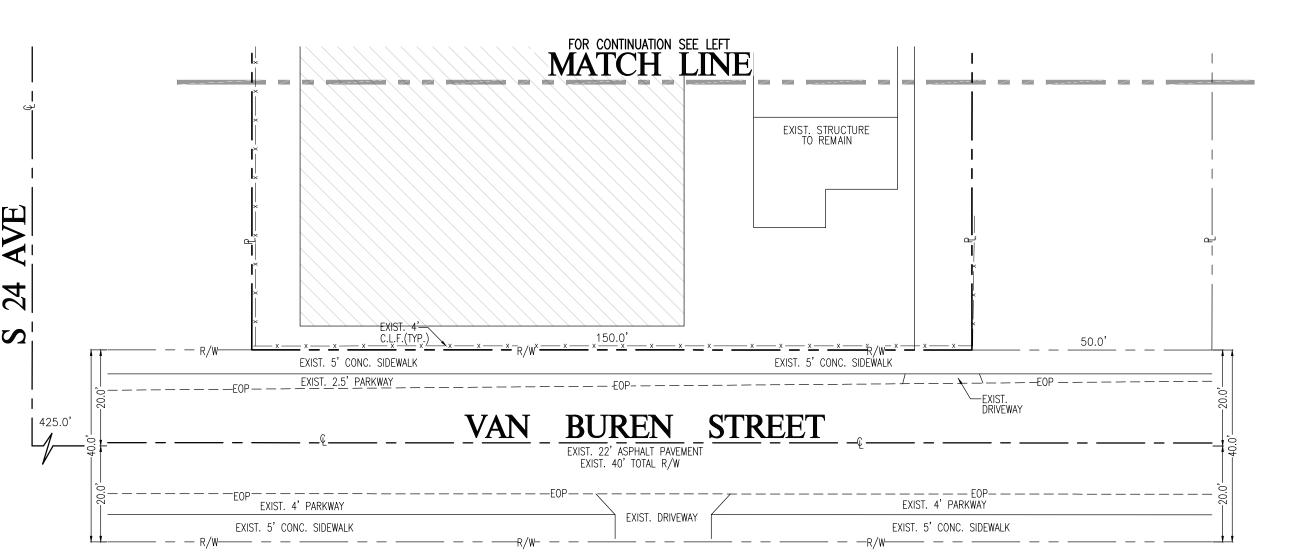

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EDUCATION AND WORKSHIP

RELIGIOUS

REVISIONS CITY OF HOLLYWOOD 01/10/23 A.M. CITY OF HOLLYWOOD 03/14/23 R.M CARLAB, INC PROJECT NUMBER 22-1924

DESIGNED AS SHOWN

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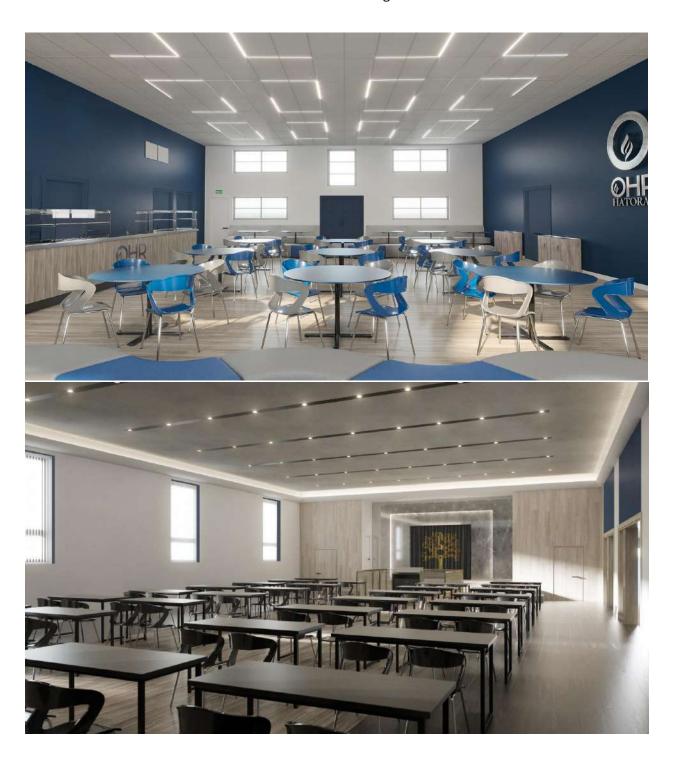
SERGIO C. LABISTE P.E. #61733

PROPOSED FIRE LINE CONNECTION PLAN

EET NUMBER

W-2

Interior Renderings



Interior Renderings





Interior Renderings

