




LShd


LIFT-SLIDINGSemi-Automated Parking System




SPEC SHEET

PARKPLUS LS LIFT-SLIDING

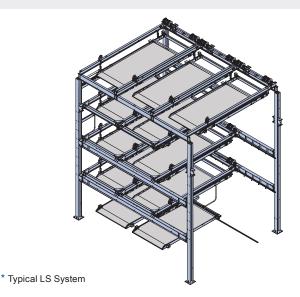

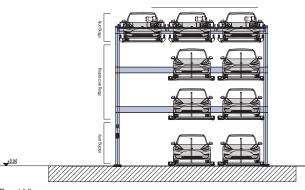

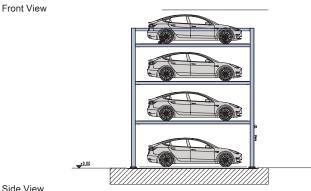

Applications

Lift-Sliding System can be installed in attended/valet applications and self-park applications:

- Multi-Family Residential Buildings
- Indoor & Outdoor Installations
- · Low & High Rise Buildings
- Commercial Buildings
- Surface Lots

The PARKPLUS Semi-Automated Lift-Sliding Parking System is a multi-level customizable vehicle storage and retrieval system for storing cars in vertical and horizontal arrays. The Lift-Slide uses Programmable Logic Control (PLC) software to move stacked cars on platforms to receive and present vehicles at grade, providing direct access to stacked vehicles without removing other vehicles from the system.

Entire assembly comes pre-welded and is assembled in the field. System is designed to be mounted on grade with an engineered foundation. System can be designed to stack up to 5 vehicles above grade and up to 2 vehicles below grade, with a maximum vertical stacking capacity of 7 vehicles in the space usually occupied by a single vehicle. There are no horizontal limitations to the system.

The PARKPLUS Lift-Sliding System is designed to be installed indoors and outdoors. System can be customized with external cladding/siding, garage doors and roof, per project specifications. Platform height is set at fixed height between 5'-2" min. and 7'-0" max. Each city may have minimum height requirements and different clear requirements for code required parking. Owner/Architect should review with local planning and building departments. MEP coordination with project team must meet code requirements and satisfy equipment clearances.

Suitable for

- · Standard passenger vehicles
- SUVs

*Custom Solutions Available

Specifications

Load per Platform: 5.200 lbs.

Weight of Unit: (Determined by Model)

19'-9" Length of Stall: Width of Stall: 8'-2 1/2"

(Determined by Model) **Height of Unit:** *Excluding column dimensions of structural framework

*Custom Dimensions Available

Operation: Flectric

Control Panel

Programmable Logic Control (PLC) Automatic with Manual Override

Control: **Push Button Control**

Key Fob

Remote Control (Optional) Mobile App (Optional)

Power

Lift Motor: 3 HP - 5 HP Traversing Motor: 0.55 HP

Electrical

1 Disconnect required per system module

3 PH 208V (100Amp)-480V (60Amp) / 60HZ All control wiring is a Class 2 Circuit 24V

Power & Electrical specifications vary per Product Model



- Cost-Effective, Multi-Layered Parking Solution
- In-house Design, Manufacturing, Installation & Service
- Minimal Moving Parts Reduced Maintenance
- Self Parking No Attendant Required



Operation

Each module requires an empty stack – allows for shifting of platforms. User will always park & retrieve car from same position on grade. Dedicated spaces/platforms can be assigned.

PARKING / STORAGE

- User requests platform by keypad/push-button control, key fob remote control and or mobile app.
- · System prepares platform and presents at grade level
- · Safety gate opens when platform is in position
- · Driver pulls vehicle onto platform
- · Driver engages parking brake, shuts off vehicle


- · Driver exits vehicle and completes storage command at keypad
- · Safety gate closes
- · Vehicle is transferred to specified storage position


RETRIEVAL


- · User requests retrieval at keypad
- · Process is followed in reverse
- · System presents vehicle at same position of loading
- · Driver enters vehicle, starts and drives away
- Safety gate closes
- System returns to neutral

A system of safety feature ensures normal operation of each cycle.


^{*} System shown at capacity

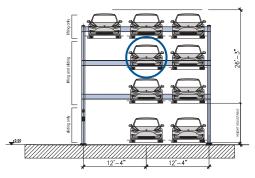

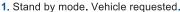

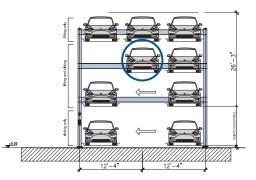

2. Slide-motion initiated.

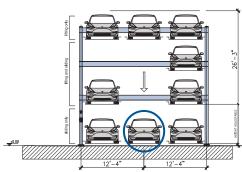

3. Vehicle presented at ground level.

ADDITIONAL INFORMATION

Safety

System is equipped with limit switches which limit motions to correct system levels and positions. Motion detectors and lasers detect obstructions within system and stop operation in emergency. System requires operator reset to check safety and obstruction removal. System is equipped with safety locking system. The safety hook system holds full weight of vehicle on platform in locked position. System is equipped with a secondary (anti-fall) safety system. System is equipped with Visual and Audible alarms and Emergency Stops. Safety Gates are required for Self Parking and In-ground units.

Fire Protection

In most metropolitan areas, car stacker systems are reviewed as similar to high piled storage and non-building structures. Fire rating of structural components is not required. Sprinklers may be required per following section. Each city may have fire department guidelines.

Fire Sprinklers

Outdoor: 1. Most cities do not require fire sprinklers. **2.** May need to conform to additional zoning regulations and building code requirements.

Indoor: 1. Installation shall be in a sprinklered garage. In tandem array, additional sprinkler requirements may apply. 2. Sprinkler Plans filed and approved by local municipality. 3. Sprinkler system designed as required by NFPA 13 and local building codes. 4. Clear building height within parking area must accommodate height of equipment plus additional requirements for adequate coverage of fire sprinklers.

Temperature

This device is designed to operate between 20° and 120° F.

Loading

Structural design and loading is provided on a project by project basis and is dependant on seismic zones, soil conditions and other environmental conditions.

Warranty

12-month Standard Manufacturer's Warranty on new equipment. Extended Warranty is available at time of purchase.

Service

At end of 12-month warranty period a service contract is available upon request.


Rental option includes Service & Maintenance for full term.

Approvals


- OTCR Certified, City of New York
- LAETL Approved, LARR#Pending, City of Los Angeles
- ISO Compliant
- California Seismic Code Compliant
- Miami Dade County Compliant
- · Approved in Multiple U.S. Cities

PRODUCT MODELS


MODEL LS2h0d

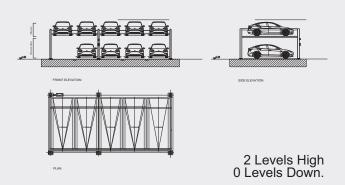


MODEL LS2h1d5w

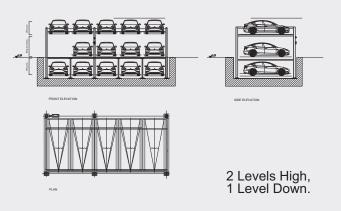


MODEL LS2h2d5w

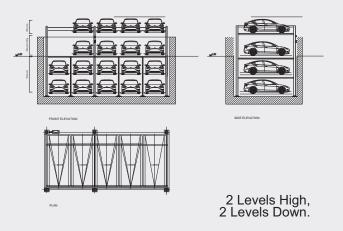


MODEL LS3h0d

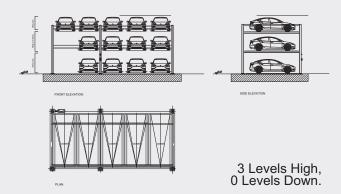

MODEL LS3h1d5w

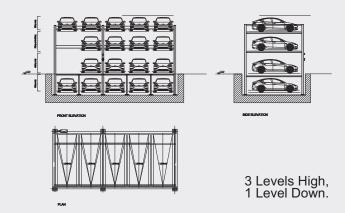

MODEL LS3h2d5w

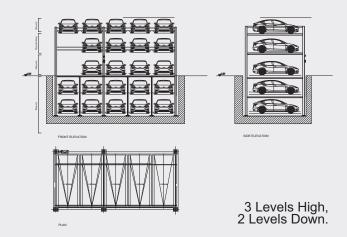


Layout

PARKPLUS LS Lift-Sliding System can be arranged in single or tandem arrays, with or without Pit, on either side of a drive aisle.

TYPE	Sedan	SUV
Pit Depth	7'-3"	9'-0"
On Grade	6'-8"	6'-8"
Above Grade	5'-2"	6'-8"


^{*}Custom dimensions available.

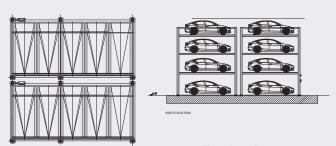


Tandem Layout

PRODUCT MODELS


MODEL LS4h0d5w

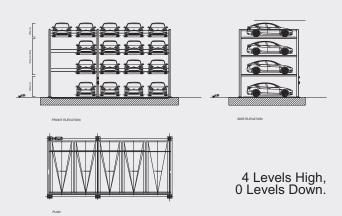


MODEL LS4h1d5w

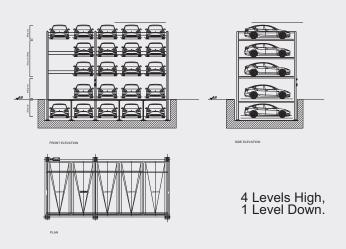


MODEL LS4h2d5w

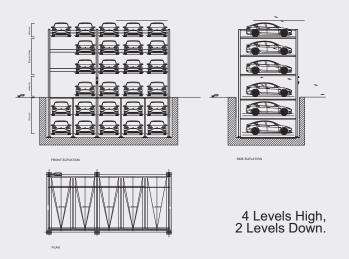


MODEL LS5h0d5w

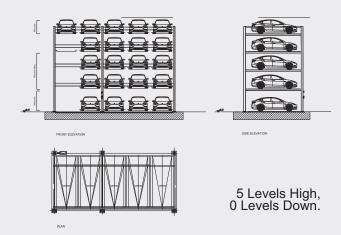

MODEL LS5h1d5w

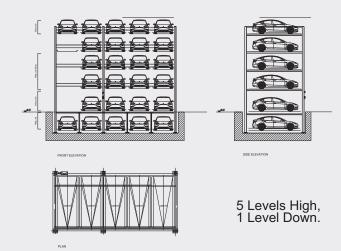


MODEL LS5h2d5w

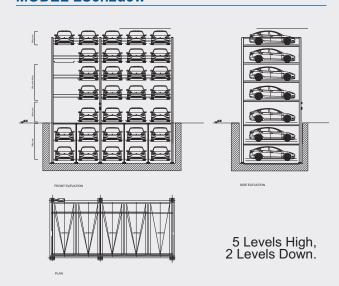



HIGH DENSITY PARKING SYSTEMS FOR 50 YEARS

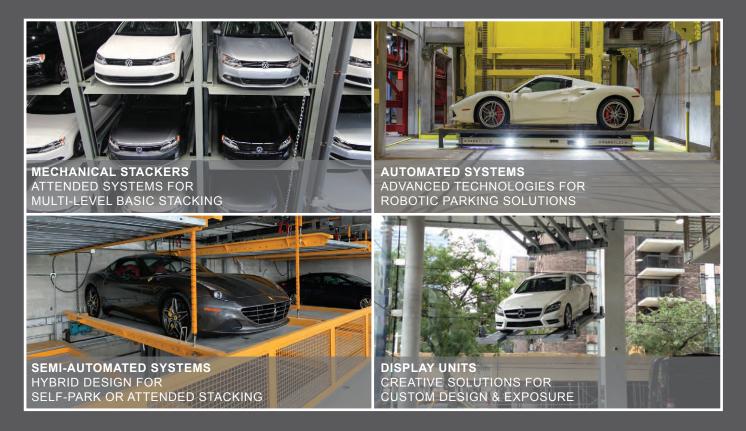


PARKPLUSINC.COM

INFO@PARKPLUSINC.COM





PARKPLUS, INC. HEADQUARTERS 83 BROAD AVENUE, SUITE 2 FAIRVIEW, NJ 07022 PARKPLUS CALIFORNIA 8640 TAMARACK AVENUE LOS ANGELES, CA 91352 CSLB# 1018794 PARKPLUS FLORIDA, INC. 1111 OLD GRIFFIN ROAD DANIA BEACH, FL 33004

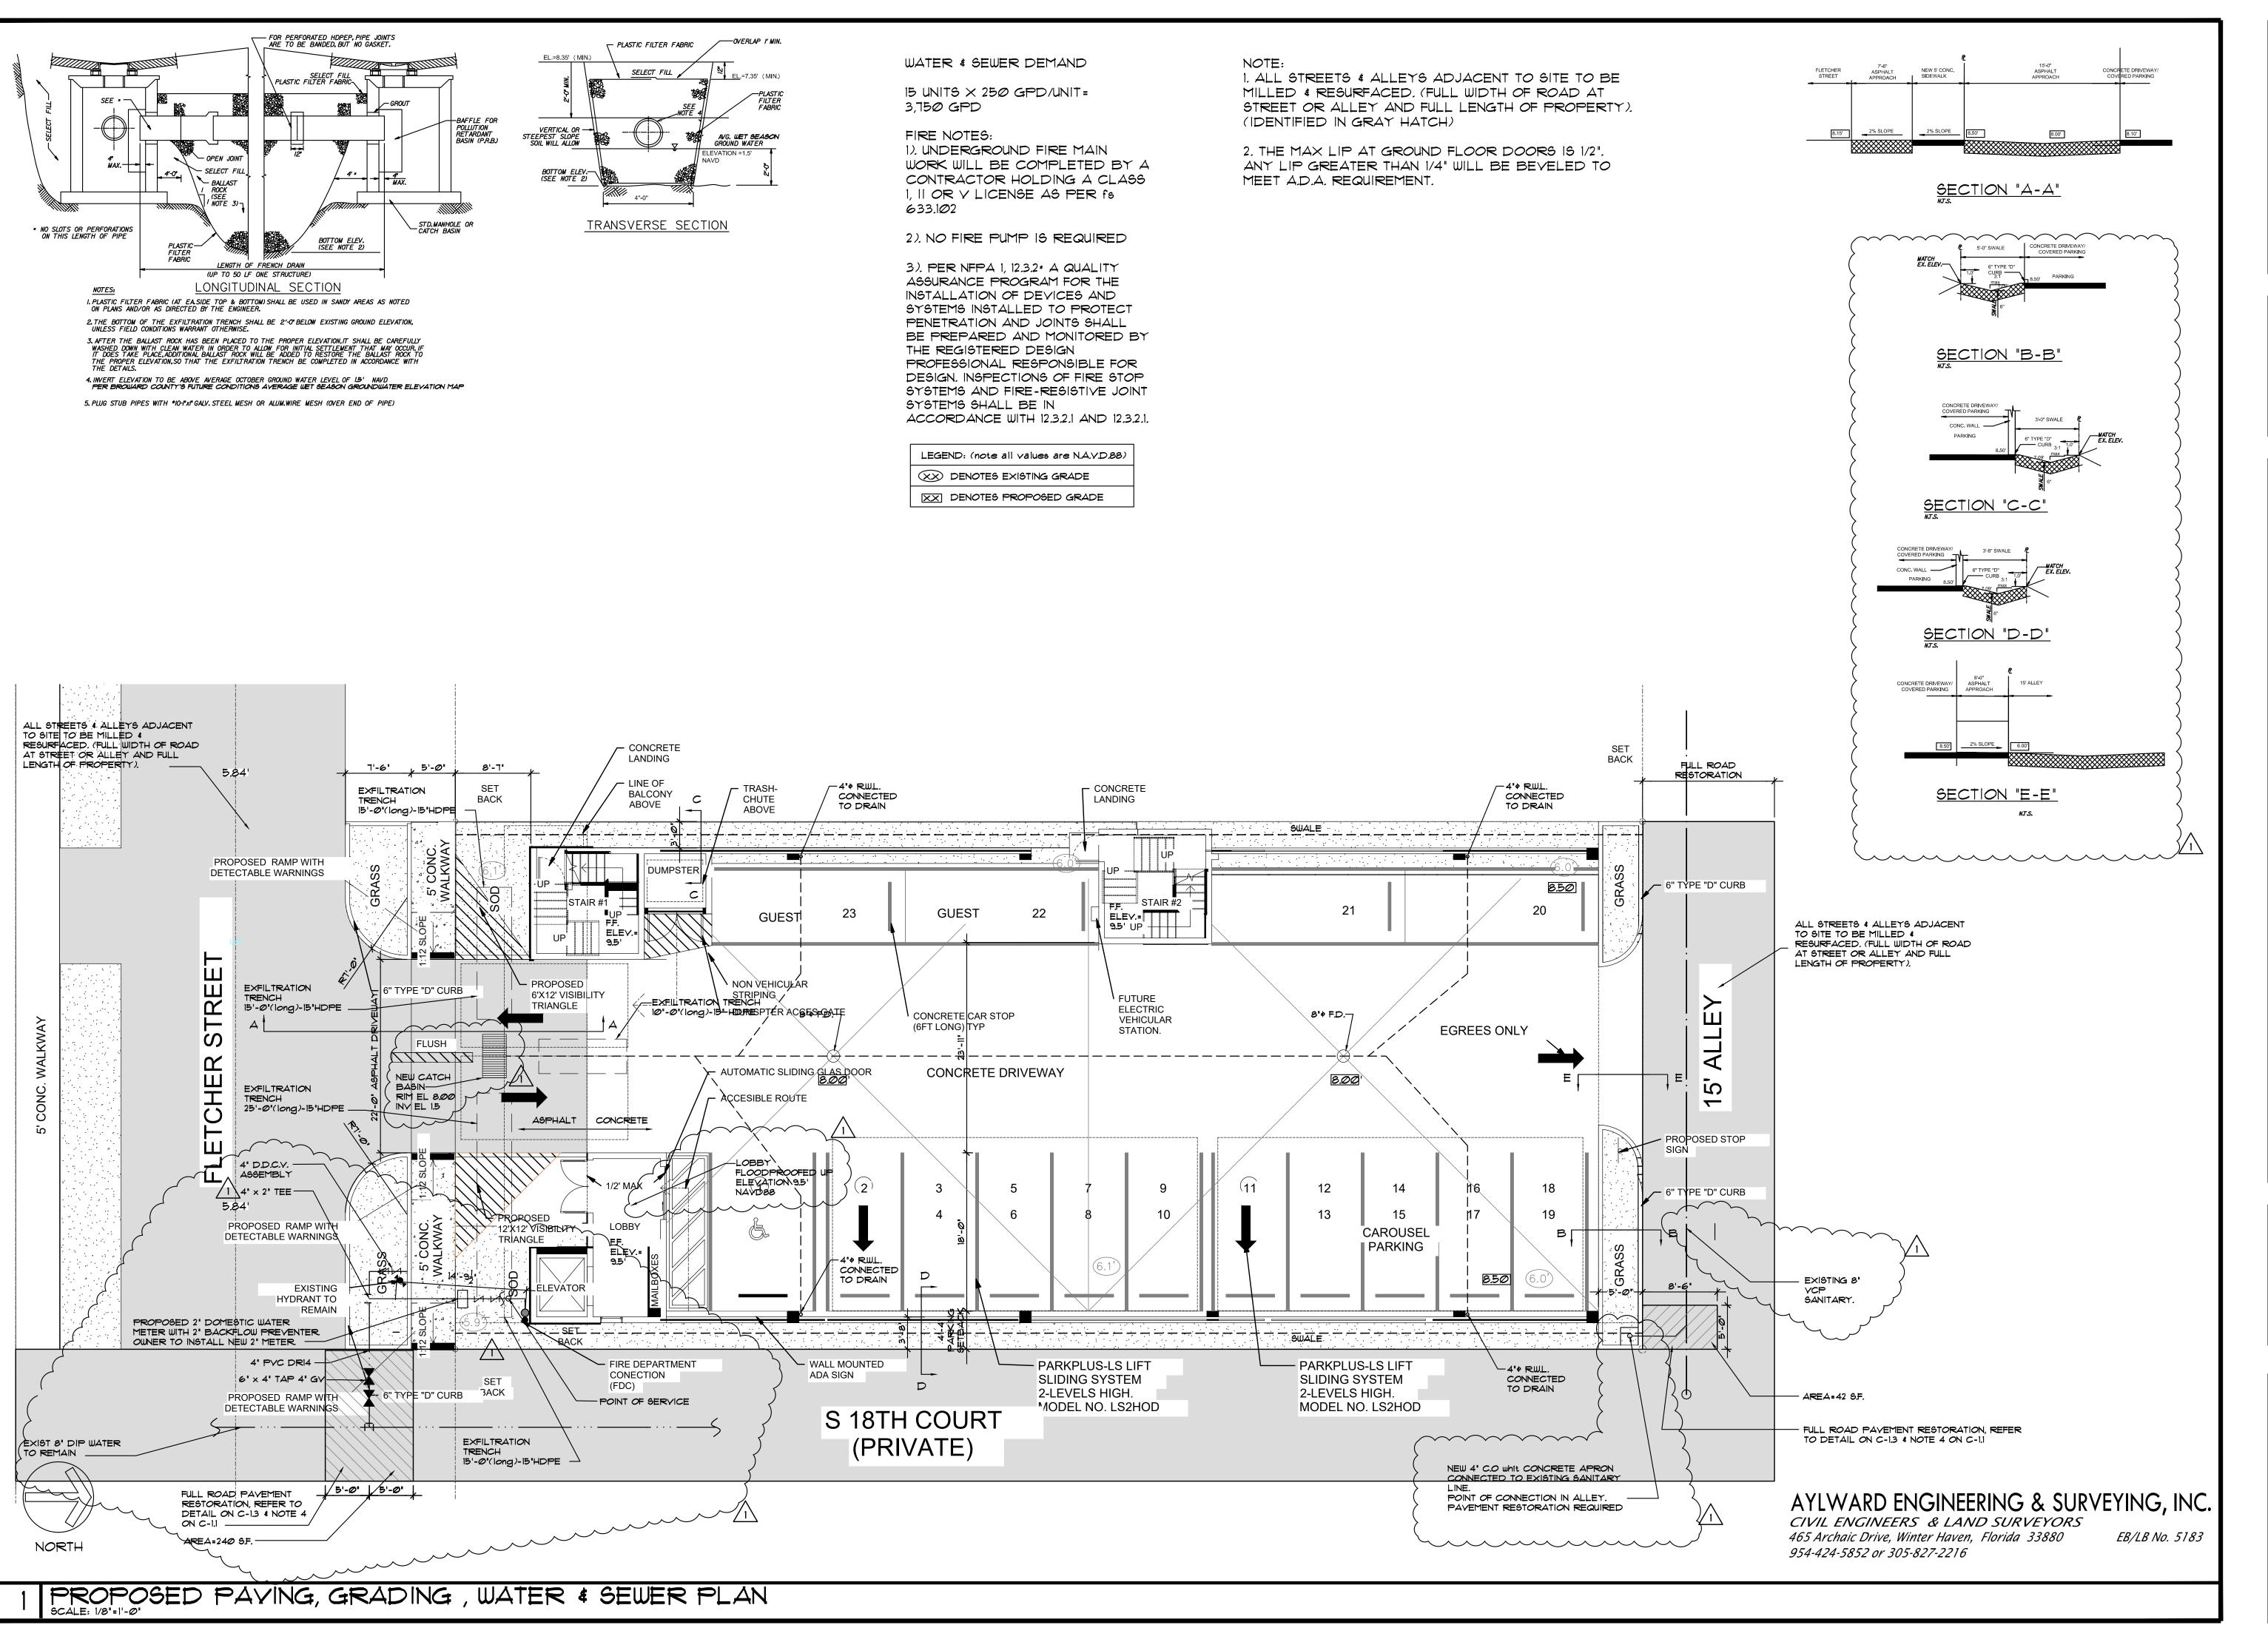



33024

(OFF.) - 305-403-7926
(CELL)- 786-543-0851
E-MAIL: LLAROSAGLAROSAARCHITECTCTS.COM
Lins LaRosa-Registered
Architect
AR#-0017852
AA#-26003693

REVISION:	BY:
01/29/2024 TAC 2	A.G.

PROPOSED 15-UNITS MULTI FAMILY DEVELOPMENT FOR 1835 FLETCHER STREET HOLLYWOOD, FLORIDA 33020

SEAL: AR 0017852 LUIS LA ROSA

C.C.

CHECKED

L.L.R.

DATE

10/3/2023

SCALE

AS NOTED

JOB. NO.

023-041

SHEET

C = 1,1

OF SHEETS

GENERAL NOTES:

- THE INFORMATION PROVIDED IN THESE DRAWINGS IS SOLELY TO ASSIST THE CONTRACTOR IN ASSESSING THE NATURE AND EXTENT OF CONDITIONS WHICH WILL BE ENCOUNTERED DURING THE COURSE OF THE WORK. THE CONTRACTORS ARE DIRECTED, PRIOR TO BIDDING, TO CONDUCT WHATEVER INVESTIGATIONS THEY DEEM NECESSARY TO ARRIVE AT THEIR OWN CONCLUSION REGARDING THE ACTUAL CONDITIONS THAT WILL BE ENCOUNTERED, AND UPON WHICH BIDS WILL BE BASED.
- ALL CONSTRUCTION AND MATERIALS SHALL CONFORM TO APPLICABLE STANDARDS AND SPECIFICATIONS OF THE CITY OF HOLLYWOOD DEPARTMENT OF PUBLIC UTILITIES, ENGINEERING AND CONSTRUCTION SERVICES DIVISION (ECSD), AND ALL OTHER LOCAL, STATE AND NATIONAL CODES, WHERE APPLICABLE.
- LOCATIONS, ELEVATIONS, SIZES, MATERIALS, ALIGNMENTS, AND DIMENSIONS OF EXISTING FACILITIES. UTILITIES AND OTHER FEATURES ARE SHOWN ACCORDING TO THE BEST INFORMATION AVAILABLE AT THE TIME OF THE PREPARATION OF THESE PLANS; AND DO NOT PURPORT TO BE ABSOLUTELY CORRECT. ALSO, THERE MAY HAVE BEEN OTHER IMPROVEMENTS, UTILITIES, ETC., WITHIN THE PROJECT AREA WHICH WERE CONSTRUCTED AFTER THE PREPARATION OF THESE PLANS AND/OR THE ORIGINAL SITE SURVEY. THE CONTRACTOR SHALL VERIFY THE LOCATIONS, ELEVATIONS, AND OTHER FEATURES AFFECTING HIS/HER WORK PRIOR TO CONSTRUCTION, AND NOTIFY THE ENGINEER IMMEDIATELY WHEN CONFLICT BETWEEN DRAWINGS AND ACTUAL CONDITIONS ARE DISCOVERED. THE ENGINEER ASSUMES NO RESPONSIBILITY FOR ANY FACILITIES SHOWN OR NOT SHOWN ON THE PLANS. THE CONTRACTOR SHALL WORK AS NEEDED TO AVOID CONFLICT WITH EXISTING UTILITIES (NO ADDITIONAL COST SHALL BE PAID FOR THIS WORK). EXISTING UTILITIES SHALL BE MAINTAINED IN SERVICE DURING CONSTRUCTION UNLESS OTHERWISE APPROVED BY THE RESPECTIVE UTILITY OWNER.
- 4. THE CONTRACTOR SHALL COORDINATE WITH ALL UTILITIES TO ARRANGE FOR THE RELOCATION AND TEMPORARY SUPPORT OF UTILITY FEATURES, ETC. AS NECESSARY TO COMPLETE THE WORK.
- IT SHALL BE THE CONTRACTOR'S RESPONSIBILITY TO LOCATE AND PROTECT ANY AND ALL EXISTING UTILITIES ON THIS PROJECT, AND TO ENSURE THAT EXISTING UTILITIES ARE MAINTAINED IN SERVICE DURING CONSTRUCTION UNLESS APPROVED OTHERWISE BY THE UTILITY OWNER.
- CONTRACTOR SHALL ADJUST ALL EXISTING UTILITY CASTINGS INCLUDING VALVE BOXES. MANHOLES. HAND-HOLES, PULL-BOXES, STORMWATER INLETS, AND SIMILAR STRUCTURES IN CONSTRUCTION AREA TO BE OVERLAID WITH ASPHALT PAVEMENT.
- THE CONTRACTOR IS REQUIRED TO OBTAIN ALL APPLICABLE CONSTRUCTION AND ENVIRONMENTAL PERMITS PRIOR TO THE START OF CONSTRUCTION.
- THE CONTRACTOR SHALL NOTIFY ECSD AT LEAST 48 HOURS PRIOR TO BEGINNING CONSTRUCTION.
- PRIOR TO THE COMMENCEMENT OF CONSTRUCTION AND INSTALLATION OF THE PROPOSED IMPROVEMENTS, SHOP DRAWINGS SHALL BE SUBMITTED TO ECSD IN ACCORDANCE WITH THE CONTRACT DOCUMENT'S REQUIREMENTS, FOR APPROVAL. IN ADDITION, IT IS THE CONTRACTOR'S RESPONSIBILITY TO OBTAIN ANY OTHER AGENCY SHOP DRAWING APPROVAL, IF REQUIRED.
- 10. THE CONTRACTOR SHALL NOTIFY ECSD IMMEDIATELY FOR ANY CONFLICT ARISING DURING CONSTRUCTION OF ANY IMPROVEMENTS SHOWN ON THESE DRAWINGS, THIS WORK BY THE CONTRACTOR SHALL BE CONSIDERED INCIDENTAL TO THE CONTRACT AND NO ADDITIONAL COMPENSATION SHALL BE ALLOWED.
- 11. ELEVATIONS SHOWN ARE IN FEET AND ARE REFERENCED TO THE NORTH AMERICAN VERTICAL DATUM OF 1988 (NAVD 88).

WOOD R.O.	ISSUED:	03/01/1994	DEPARTMENT OF PUBLIC UTILITIES STANDARD DETAIL	REVISED: 06/08/2014
DRA	DRAWN:	EAM	GENERAL NOTES	DRAWING NO.
RATEDIATE	APPROVED:	: XXX	GENERAL NOTES	G-00

WATER MAIN SEPARATION IN ACCORDANCE WITH F.A.C. RULE 62-555.314

OTHER PIPE	HORIZONTAL SEPARATION	CROSSING (1), (4)	JOINT SPACING @ CROSSING (FULL JOINT CENTERED) (8)
STORM SEWER, STORM WATER FORCE MAIN, RECLAIMED WATER (2)	3 ft minimum	12 inches is the minimum except for storm sewer, then 6 inches is the minimum and 12 inched is preferred	Alternate 3 ft minimum Columbia Label L
GRAVITY SANITARY SEWER, (3) SANITARY SEWER FORCE MAIN, RECLAIMED WATER	WATER MAIN 10 ft prefered 6 ft minimum	WATER MAIN 12 inches is the minimum except for gravity sewer, then 6 inches is the minimum and 12 inched is preferred	Alternate 6 ft minimum
ON-SITE SEWAGE TREATMENT & DISPOSAL SYSTEM	10 ft minimum		

- WATER MAIN SHOULD CROSS ABOVE OTHER PIPE, WHEN WATER MAIN MUST BE BELOW OTHER PIPE, THE MINIMUM
- SEPARATION IS 12 INCHES. RECLAIMED WATER REGULATED UNDER PART III OF CHAPTER 62-610, F.A.C.
- 3 FT. FOR GRAVITY SANITARY SEWER WHERE THE BOTTOM OF THE WATER MAIN IS LAID AT LEAST 6 INCHES ABOVE THE TOP OF THE GRAVITY SANITARY SEWER. 18" VERTICAL MINIMUM SEPARATION REQUIRED BY CITY OF HOLLYWOOD, UNLESS OTHERWISE APPROVED.
- A MINIMUM 6 FOOT HORIZONTAL SEPARATION SHALL BE MAINTAINED BETWEEN ANY TYPE OF SEWER AND WATER MAIN
- IN PARALLEL INSTALLATIONS WHENEVER POSSIBLE.
- IN CASES WHERE IT IS NOT POSSIBLE TO MAINTAIN A 10 FOOT HORIZONTAL SEPARATION, THE WATER MAIN MUST BE LAID IN A SEPARATE TRENCH OR ON AN UNDISTURBED EARTH SHELF LOCATED ON ONE SIDE OF THE SEWER OR FORCE MAIN AT SUCH AN ELEVATION THAT THE BOTTOM OF THE WATER MAIN IS AT LEAST 18 INCHES ABOVE THE TOP OF THE SEWER. WHERE IT IS NOT POSSIBLE TO MAINTAIN A VERTICAL DISTANCE OF 18 INCHES IN A PARALLEL INSTALLATIONS, THE WATER MAIN SHALL BE CONSTRUCTED OF DIP AND THE SANITARY SEWER OR FORCE MAIN SHALL BE CONSTRUCTED OF DIP WITH A MINIMUM VERTICAL DISTANCE OF 6 INCHES, THE WATER MAIN SHOULD ALWAYS BE ABOVE THE SEWER, JOINTS ON THE WATER MAIN SHALL BE LOCATED AS FAR APART AS POSSIBLE FROM JOINTS ON THE SEWER OR FORCE MAIN (STAGGERED
- ALL JOINTS ON THE WATER MAIN WITHIN 20 FEET OF THE CROSSING MUST BE MECHANICALY RESTRAINED.

(UASSESSO)	DRAWN:	EAM	SEPARATION REQUIREMENTS OF	DRAWING N	
HOLLYWOOD	ISSUED:	03/01/1994	DEPARTMENT OF PUBLIC UTILITIES STANDARD DETAIL	REVISED:	11/06/2017

GENERAL NOTES (CONTINUED):

- 12. CITY OF HOLLYWOOD SHALL NOT PROVIDE STAGING / STORAGE AREA. CONTRACTOR SHALL SECURE STAGING / STORAGE AREA AS NECESSARY FOR CONSTRUCTION WORK.
- 13. CONTRACTOR SHALL HAUL AWAY EXCESSIVE STOCKPILE OF SOIL FOR DISPOSAL EVERY DAY. NO STOCKPILE SOIL IS ALLOWED TO BE LEFT ON THE CONSTRUCTION SITE OVER NIGHT.
- 14. CONTRACTOR SHALL CLEAN / SWEEP THE ROAD AT LEAST ONCE DAY OR AS REQUIRED BY THE ENGINEER.
- 15. CONTRACTOR SHALL PROTECT CATCH BASINS WITHIN / ADJACENT TO THE CONSTRUCTION SITE AS REQUIRED BY NPDES REGULATIONS.
- 16. THE CITY OF HOLLYWOOD HAS A NOISE ORDINANCE (CHAPTER 100) WHICH PROHIBITS EXCAVATION AND CONSTRUCTION BEFORE 8:00 A.M. AND AFTER 6:00 P.M., MONDAY THROUGH SATURDAY AND ALL DAY
- 17. SUITABLE EXCAVATED MATERIAL SHALL BE USED IN FILL AREAS. NO SEPARATE PAY ITEM FOR THIS WORK, INCLUDE COST IN OTHER ITEMS.
- 18. ALL ROAD CROSSINGS ARE OPEN CUT AS PER THE REQUIREMENTS OF THE ECSD UNLESS OTHERWISE NOTED ON THE DRAWINGS.
- 19. THE CONTRACTOR SHALL REPLACE ALL PAVING, STABILIZING EARTH, DRIVEWAYS, PARKING LOTS, SIDEWALKS, ETC. TO SATISFY THE INSTALLATION OF THE PROPOSED IMPROVEMENTS WITH THE SAME TYPE OF MATERIAL THAT WAS REMOVED DURING CONSTRUCTION OR AS DIRECTED BY ECSD FIELD
- 20. THE CONTRACTOR SHALL NOT ENCROACH INTO PRIVATE PROPERTY WITH PERSONNEL, MATERIAL OR FOUIPMENT IN CASE WORK ON PRIVATE PROPERTY IS NEEDED. A CITY OF HOLLYWOOD "RIGHT OF ENTRY" FORM MUST BE SIGNED BY PROPERTY OWNER AND THE DIRECTOR OF PUBLIC UTILITIES. THE CONTRACTOR IS RESPONSIBLE TO MAINTAIN ACCESS AT ALL TIMES TO PRIVATE HOMES/BUSINESSES.
- 21. THE CONTRACTOR SHALL BE RESPONSIBLE FOR DAMAGE, REMOVAL OR MODIFICATION, CAUSED TO ANY IRRIGATION SYSTEM (PRIVATE OR PUBLIC) ACCIDENTALLY OR PURPOSELY. THE CONTRACTOR SHALL REPLACE ANY DAMAGED, REMOVED OR MODIFIED IRRIGATION PIPES, SPRINKLER HEADS OR OTHER PERTINENT APPURTENANCES TO MATCH OR EXCEED EXISTING CONDITIONS AT NO ADDITIONAL COST TO
- 22. MAIL BOXES, FENCES OR OTHER PRIVATE PROPERTY DAMAGED DURING THE CONSTRUCTION OF THE PROPOSED IMPROVEMENTS SHALL BE REPLACED TO MATCH OR EXCEED EXISTING CONDITION.
- 23. CONTRACTOR SHALL PROVIDE MAINTENANCE OF TRAFFIC IN ACCORDANCE WITH FDOT STANDARDS AND CITY OF HOLLYWOOD DEPARTMENT OF PUBLIC UTILITIES STANDARDS.
- 24. NO TREES ARE TO BE REMOVED OR RELOCATED WITHOUT PRIOR APPROVAL FROM THE ECSD FIELD
- 25. THE CONTRACTOR IS RESPONSIBLE FOR OBTAINING THE NECESSARY TREE REMOVAL OR RELOCATION PERMITS FROM THE CITY OF HOLLYWOOD BUILDING DEPARTMENT FOR TREES LOCATED IN THE PUBLIC
- 26. IT IS THE INTENT OF THESE PLANS TO BE IN ACCORDANCE WITH APPLICABLE CODES AND AUTHORITIES HAVING JURISDICTION. ANY DISCREPANCIES BETWEEN THESE PLANS AND APPLICABLE REGULATORY STANDARDS / REQUIREMENTS SHALL BE IMMEDIATELY BROUGHT TO THE ATTENTION OF ECSD.

INTERNATION AND AND ADDRESS OF THE PARTY OF	ISSUED:	03/01/1994	DEPARTMENT OF PUBLIC UTILITIES STANDARD DETAIL	REVISED:	11/06/2
man de	DRAWN:	EAM	GENERAL NOTES	DRAWING 1	NO.
ORFORDS STATE OF	APPROVE	D: XXX	(CONTINUED)	G-C	0.1

PIPE O.D. + 2' MAXIMUM

PIPE O.D. + 1' MINIMUM

TRENCH WIDTH

1. WHEN PIPE INSTALLATION IS ABOVE THE GROUND WATER TABLE ELEVATION, OR

SECTION 02222, "EXCAVATION AND BACKFILL FOR UTILITIES".

4. BACKFILL TO COMPLY WITH FDOT DESIGN STANDARDS 125-8.

BEDDING SHALL BE WELL GRADED, WASHED CRUSHED STONE (OR DRAINFIELD

LIMEROCK), CRUSHED STONE SHALL CONSIST OF HARD, DURABLE, SUB-ANGULAR PARTICLES OF PROPER SIZE AND GRADATION, AND SHALL BE FREE FROM ORGANIC

WHENEVER BEDDING COPPER PIPE UNDER ANY CONDITION, BEDDING MATERIAL SHALL

BE CLEAN SANDY SOIL IF AVAILABLE WITHIN THE LIMITS OF CONSTRUCTION, IMPORTED

MATERIAL, WOOD, TRASH, SAND, LOAM, CLAY, EXCESS FINES, AND OTHER DELETERIOUS

ANY PIPE IS LAID. FOR ADDITIONAL MATERIAL SPECIFICATIONS REFER TO SPECIFICATION

DENSITY TESTING SHALL BE IN ACCORDANCE WITH AASHTO T-180 AND ASTM D-3017.

ISSUED: 03/01/1994| DEPARTMENT OF PUBLIC UTILITIES STANDARD DETAIL |REVISED: 06/08/201

PIPE LAYING CONDITION TYPICAL

SECTION (D.I.P.)

2. ALL BEDDING MATERIAL SHALL BE COMPACTED TO 95% OF MAXIMUM DENSITY BEFORE

BOTTOM OF ROADWAY BASE -

HAUNCHING

BEDDING FOR

UNSUITABLE

SOIL ONLY

GENERAL BACKFILL SHALL BE

EXCEED 12" IN THICKNESS, EACH

LAYER SHALL BE COMPACTED TO

100% OF MAXIMUM DRY DENSITY

MATERIALS

APPROVED:

SELECT BACKFILL SHALL BE PLACED IN LAYERS NOT TO

FXCFFD 6" IN THICKNESS. EACH LAYER SHALL BE COMPACTED TO 98% OF MAXIMUM DRY DENSITY

PLACED IN LAYERS NOT TO

OR EXISTING GROUND

- FOR PAVEMENT RESTORATION REFER TO FDOT, BROWARD

COUNTY PUBLIC WORKS, OR

PAVEMENT RESTORATION DETAILS

RIGHT-OF-WAY OWNER'S

- BACKFILL CONSOLIDATED

TO CENTERLINE OF PIPE

G-02

(SEE NOTE 1 BELOW).

- FLAT OR RESTORED

TRENCH BOTTOM

GENERAL NOTES (CONTINUED):

- 27. THE CONTRACTOR SHALL BE RESPONSIBLE FOR MAINTAINING THE INTEGRITY OF AND MAKING THE REPAIRS TO EXISTING PAVEMENT, SIDEWALKS, PIPES, CONDUITS, CURBS, CABLES, ETC., WHETHER OR NOT SHOWN ON THE PLANS DAMAGED AS A RESULT OF THE CONTRACTORS OPERATIONS AND/OR THOSE OF HIS SUBCONTRACTORS, AND SHALL RESTORE THEM PROMPTLY AT NO ADDITIONAL EXPENSE TO THE OWNER. CONTRACTOR SHALL REPORT ANY DAMAGE TO SIDEWALK, DRIVEWAY, ETC., PRIOR TO BEGINNING WORK IN ANY AREA.
- 28. WHERE NEW PAVEMENT MEETS EXISTING, CONNECTION SHALL BE MADE IN A NEAT STRAIGHT LINE AND FLUSH WITH EXISTING PAVEMENT TO MATCH EXISTING CONDITIONS.
- 29. UNDER NO CIRCUMSTANCES SHALL THE CONTRACTOR LEAVE EXCAVATED TRENCHES, OR PARTS OF, EXPOSED OR OPENED AT THE END OF THE WORKING DAY, WEEKENDS, HOLIDAYS OR OTHER TIMES, WHEN THE CONTRACTOR IS NOT WORKING, UNLESS OTHERWISE DIRECTED. ALL TRENCHES SHALL BE COVERED, FIRMLY SECURED AND MARKED ACCORDINGLY FOR PEDESTRIAN / VEHICULAR TRAFFIC.
- 30. ALL EXCAVATED MATERIAL REMOVED FROM THIS PROJECT SHALL BE DISPOSED OF OFF THE PROPERTY BY THE CONTRACTOR AT THE CONTRACTOR'S EXPENSE.
- 31. ALL DUCTILE IRON PRODUCTS SHALL BE DOMESTIC MADE HEAVY DUTY CLASSIFICATION SUITABLE FOR HIGHWAY TRAFFIC LOADS, OR 20,000 LB.
- 32. ALL GRASSED AREAS AFFECTED BY CONSTRUCTION SHALL BE RE-SODDED.
- 33. THE CONTRACTOR SHALL BE RESPONSIBLE FOR THE PROVISION, INSTALLATION AND MAINTENANCE OF ALL TRAFFIC CONTROL AND SAFETY DEVICES, IN ACCORDANCE WITH SPECIFICATIONS OF THE LATEST REVISION OF FDOT DESIGN STANDARDS. IN ADDITION, THE CONTRACTOR IS RESPONSIBLE FOR THE RESETTING OF ALL TRAFFIC CONTROL AND INFORMATION SIGNAGE REMOVED DURING THE CONSTRUCTION PERIOD.
- 34. EXCAVATED OR OTHER MATERIAL STORED ADJACENT TO OR PARTIALLY UPON A ROADWAY PAVEMENT SHALL BE ADEQUATELY MARKED FOR TRAFFIC SAFETY AT ALL TIMES.
- 35. TEMPORARY PATCH MATERIAL MUST BE ON THE JOB SITE WHENEVER PAVEMENT IS CUT, OR THE CITY'S INSPECTOR WILL SHUT THE JOB DOWN.

HOURS IN ADVANCE OF TRAFFIC DETOUR IN ACCORDANCE WITH SECTION 336.07 OF FLORIDA STATUTES.

- 36. CONTRACTOR MUST PROVIDE FLASHER ARROW SIGNAL FOR ANY LANE THAT IS CLOSED OR DIVERTED. 37. CONTRACTOR SHALL NOTIFY LAW ENFORCEMENT AND FIRE PROTECTION SERVICES TWENTY-FOUR (24)
- 38. CONTRACTOR TO RESTORE PAVEMENT TO ORIGINAL CONDITION AS REQUIRED.
- 39. CONTRACTOR SHALL BE RESPONSIBLE FOR PROVIDING DEWATERING PER SPECIFICATION SECTION 02140 DEWATERING.


OLI OLI WOOD A	ISSUED:	03/01/1994	DEPARTMENT OF PUBLIC UTILITIES STANDARD DETAIL	REVISED:	11/06/2
	DRAWN:	EAM	GENERAL NOTES	DRAWING I	
TO OF CHATTURE	APPROVED): XXX	(CONTINUED)	G-0	0.2


GENERAL NOTES (CONTINUED):


40. THE CONTRACTOR SHALL GIVE AT LEAST 48 HOURS NOTICE TO UTILITY COMPANIES TO PROVIDE FOR THE LOCATION OF EXISTING UNDERGROUND UTILITIES IN ADVANCE OF CONSTRUCTION. CONTACT UTILITIES NOTIFICATION CENTER AT 811 OR 1-800-432-4770 (SUNSHINE ONE-CALL OF FLORIDA).




- 41. WHEN PVC PIPE IS USED, A METALLIZED MARKER TAPE SHALL BE INSTALLED CONTINUOUSLY 18" ABOVE THE PIPE. THE MARKER TAPE SHOULD BE IMPRINTED WITH A WARNING THAT THERE IS BURIED PIPE BELOW. THE TAPE SHALL BE MAGNA TEC, AS MANUFACTURED BY THOR ENTERPRISES INC. OR APPROVED EQUAL.
- 42. ALL CONNECTIONS TO EXISTING MAINS SHALL BE THE RESPONSIBILITY OF THE CONTRACTOR. WATER CONNECTIONS SHALL BE METERED, AND THE COST OF WATER AND TEMPORARY METER SHALL BE BORNE BY THE CONTRACTOR.
- 43. A COMPLETE AS-BUILT SURVEY SHALL BE ACCURATELY RECORDED OF THE UTILITY SYSTEM DURING CONSTRUCTION. AS-BUILT SURVEY SHALL BE SUBMITTED TO ECSD SIGNED AND SEALED BY A FLORIDA REGISTERED SURVEYOR PRIOR TO FINAL INSPECTION AND ACCEPTANCE OF PROJECT. THE COST OF SIGNED AND SEALED AS-BUILTS SHALL BE COVERED IN OVERALL BID. THE AS-BUILT SURVEY SHALL
- PLAN VIEW SHOWING THE HORIZONTAL LOCATIONS OF EACH MANHOLE, INLET, VALVE, FITTING, BEND AND HORIZONTAL PIPE DEFLECTIONS WITH COORDINATES AND IN REFERENCE TO A SURVEY BASELINE OR RIGHT-OF-WAY CENTERLINE.
- THE PLAN VIEW SHALL ALSO SHOW SPOT ELEVATIONS OF THE TOP OF THE MAIN (WATER MAIN AND FORCE MAIN) OR PIPE INVERTS (GRAVITY MAINS) AT INTERVALS NOT TO EXCEED 100 FEET AS MEASURED ALONG MAIN. THE PLAN VIEW SHALL ALSO INCLUDE SPOT ELEVATIONS AT EACH MANHOLE, INLET, VALVE, FITTING, BEND AND VERTICAL PIPE
- THE PLAN VIEW SHALL ALSO SHOW THE HORIZONTAL SEPARATION FROM UNDERGROUND UTILITIES IMMEDIATELY ADJACENT OR PARALLEL TO THE NEW MAIN.
- PROFILE VIEW WITH SPOT ELEVATIONS OF THE TOP OF THE MAIN (WATER MAIN AND FORCE MAIN) OR PIPE INVERT (GRAVITY MAIN) AND OF THE FINISHED GRADE OR MANHOLE RIM DIRECTLY ABOVE THE MAIN AT INTERVALS NOT TO EXCEED 100 FEET AS MEASURED ALONG THE MAIN. THE PROFILE VIEW SHALL ALSO INCLUDE SPOT ELEVATIONS AT EACH MANHOLE, INLET, VALVE, FITTING, BEND AND VERTICAL PIPE DEFLECTION.
- THE PROFILE VIEW SHALL SHOW ALL UNDERGROUND UTILITIES CROSSING THE NEW MAIN AND THE VERTICAL SEPARATION PROVIDED BETWEEN THAT UNDERGROUND UTILITY AND THE
- ALL CADD FILES MUST BE CREATED FOLLOWING THE CITY OF HOLLYWOOD "SURVEY / AS-BUILT CAD DRAWING STANDARDS"

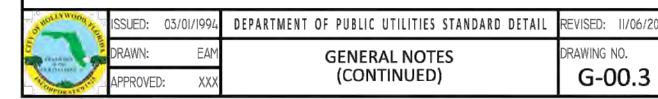

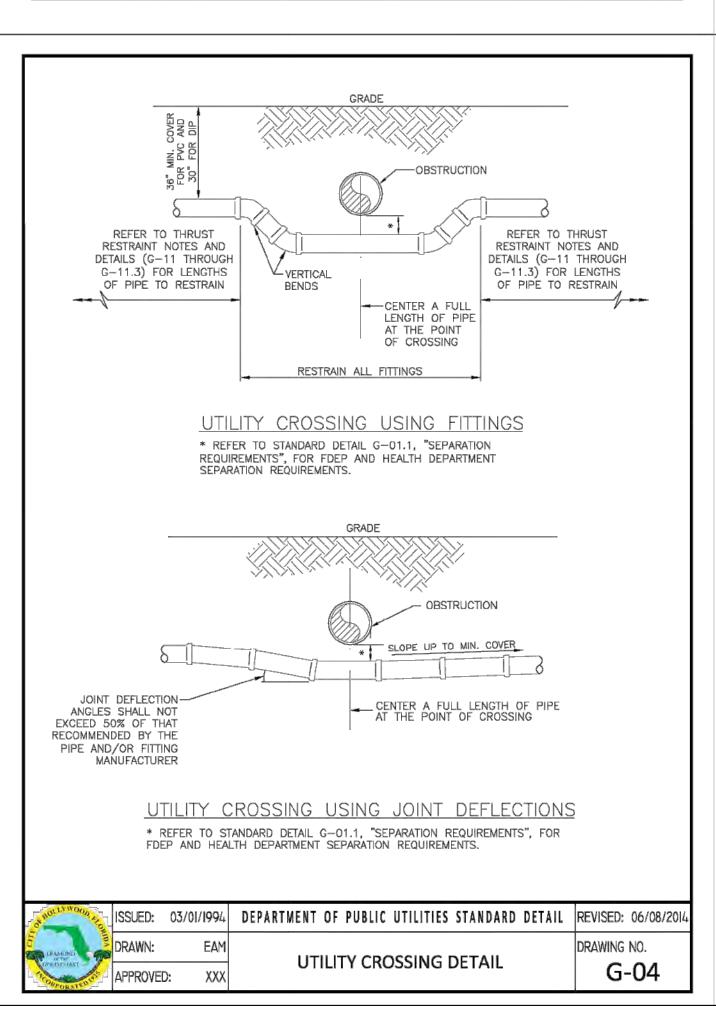

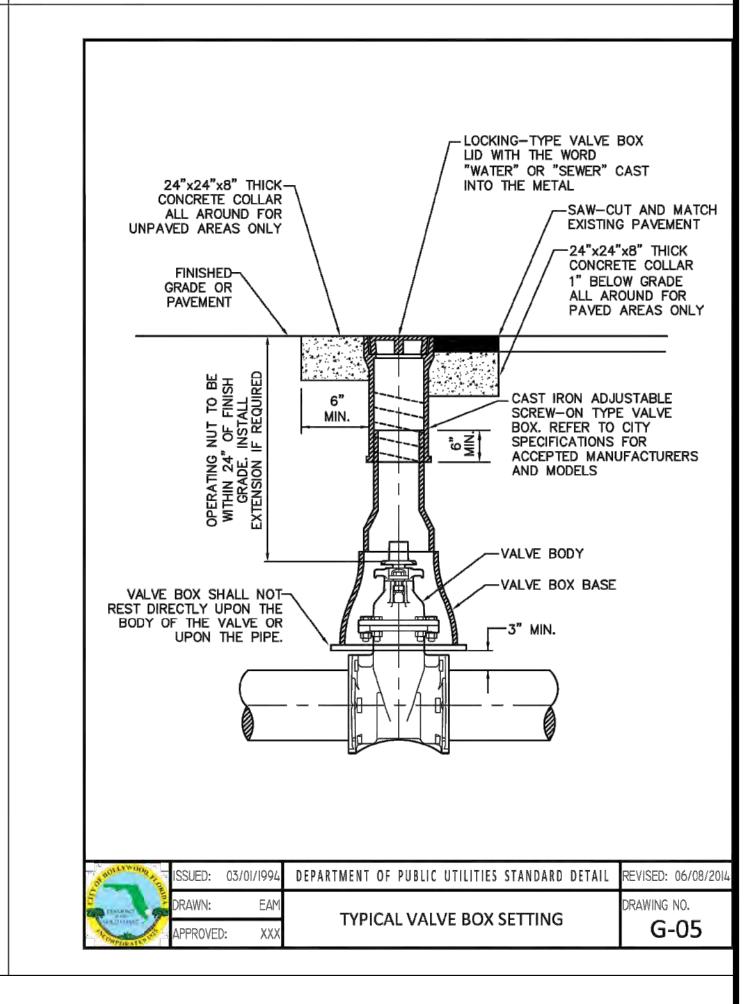


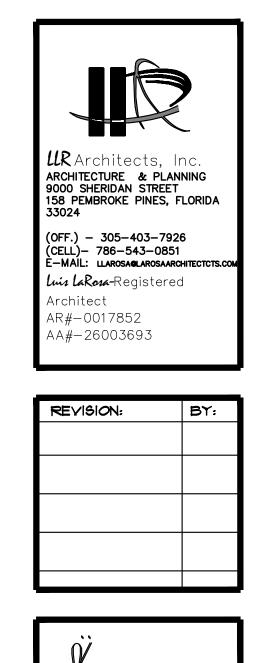


 \exists

SEAL: AR 0017852 LUIS LA ROSA

C.C. CHECKED 10/3/2023 AS NOTED *@*23-*@*41

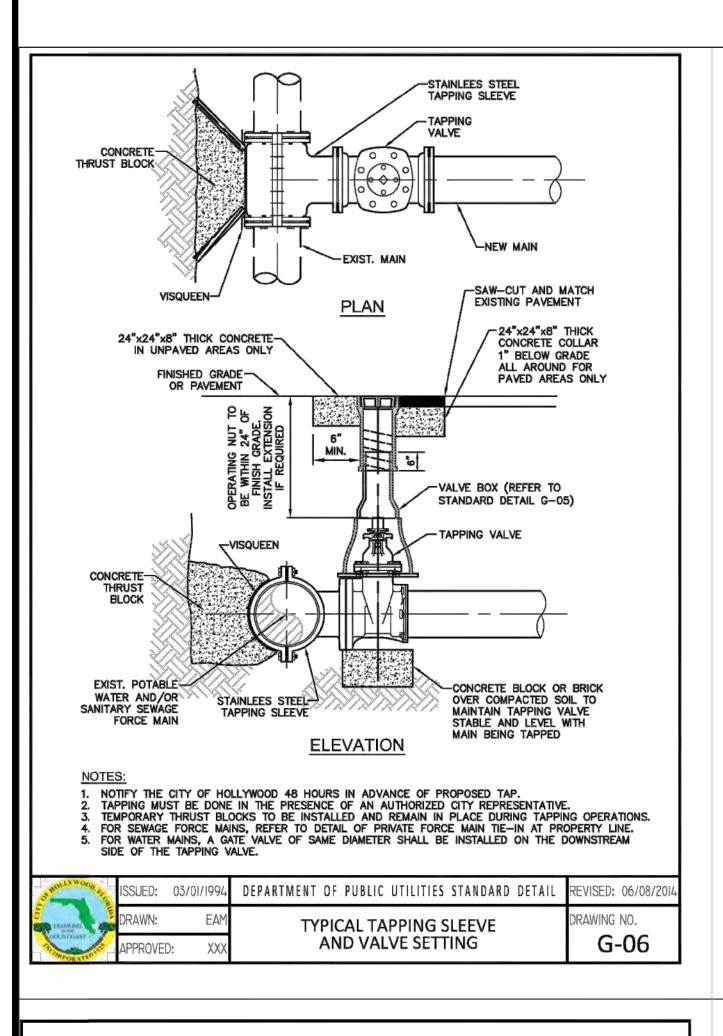

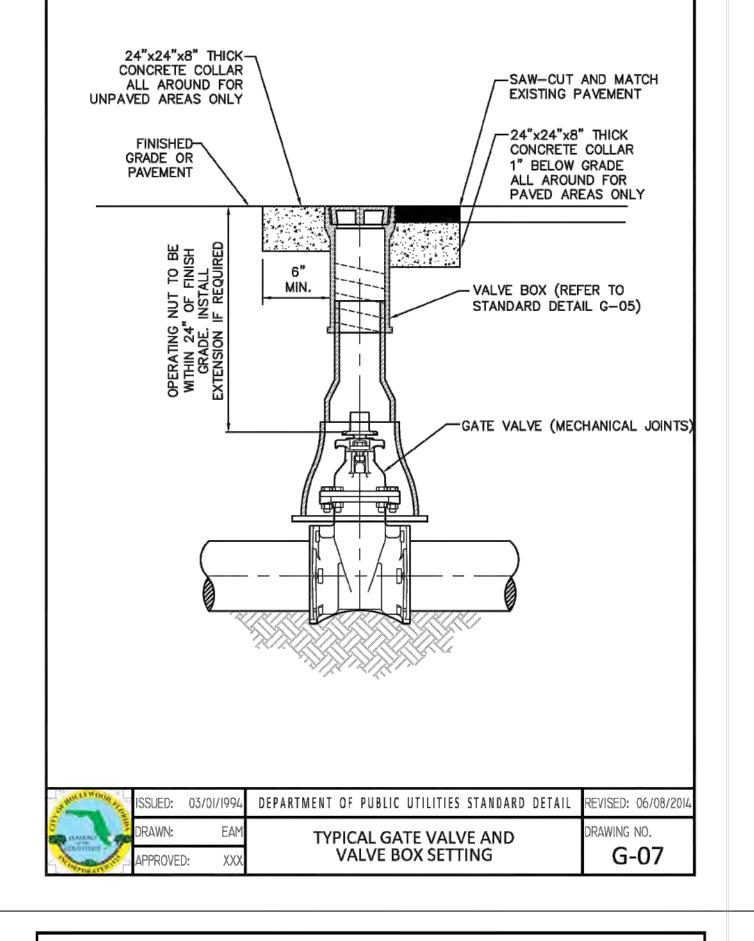


THE AROVE DETAILS APPLY ONLY TO ASPHALT PAVEMENT RESTORATION

- THE ABOVE DETAILS APPLY ONLY TO ASPHALT PAVEMENT RESTORATION OVER UTILITY TRENCHES CUT WITHIN CITY OF HOLLYWOOD RIGHTS-OF-WAY. FOR PAVEMENT RESTORATION WITHIN BROWARD COUNTY OR FDOT RIGHTS-OF-WAY REFER TO THE CORRESPONDING DETAILS FOR THOSE AGENCIES.
- LIMEROCK BASE MATERIAL SHALL HAVE A MINIMUM L.B.R. OF 100 AND A MINIMUM CARBONATE CONTENT OF 70%. REPLACED BASE MATERIAL OVER TRENCH SHALL BE A MINIMUM OF 12" THICK".
- LIMEROCK BASE MATERIAL SHALL BE PLACED IN 12" MAXIMUM (LOOSE MEASUREMENT) THICKNESS LAYERS WITH EACH LAYER THOROUGHLY ROLLED OR TAMPED AND COMPACTED TO 100% OF
- MAXIMUM DENSITY, PER AASHTO T-180, PRIOR TO THE PLACEMENT OF THE SUCCEEDING LAYERS.

 4. STABILIZED SUBGRADE MATERIAL SHALL BE GRANULAR AND SHALL HAVE A MINIMUM L.B.R. OF 40.
- 5. BACKFILL SHALL BE PLACED AND COMPACTED IN ACCORDANCE WITH THE PIPE LAYING CONDITION TYPICAL SECTIONS IN DETAILS G-02 AND G-03, AND THE SPECIFICATIONS, BUT TESTING WILL BEGIN 12" ABOVE THE INSTALLED FACILITY.
- 6. ALL EDGES AND JOINTS OF EXISTING ASPHALT PAVEMENT SHALL BE SAW CUT TO STRAIGHT LINES, PARALLEL TO OR PERPENDICULAR TO THE ROADWAY, PRIOR TO THE RESURFACING.
- RESURFACING MATERIAL SHALL BE FDOT SUPERPAVE, AND SHALL BE APPLIED A MINIMUM OF TWO INCH IN THICKNESS.
- 8. MILL AND BUTT JOINT TO EXISTING PAVEMENT.
- IF THE TRENCH IS FILLED TEMPORARILY, IT SHALL BE COVERED WITH A 2" ASPHALTIC CONCRETE PATCH
 TO KEEP THE FILL MATERIAL FROM RAVELING UNTIL REPLACED WITH A PERMANENT PATCH.
- 10. REFER TO SPECIFICATIONS FOR DETAILED PROCEDURES.
- 11. WHERE THE UTILITY TRENCH CROSSES EXISTING ASPHALT DRIVEWAYS, THE LIMEROCK BASE THICKNESS MAY BE A MINIMUM OF 6 INCHES THICK. REGARDLESS OF THE EXTENT OF IMPACT, THE ENTIRE DRIVEWAY SURFACE BETWEEN THE EDGE OF THE ROADWAY PAVEMENT AND PROPERTY LINE OR FRONT OF SIDEWALK SHALL BE OVERLAID USING 2-INCH THICK MINIMUM ASPHALTIC CONCRETE SURFACE COURSE WHERE INDICATED ON THE PLANS OR AS DIRECTED BY THE CITY/ENGINEER.

Gradier Hoos	ISSUED:	03/01/1994	DEPARTMENT OF PUBLIC UTILITIES STANDARD DETAIL	REVISED: 11/06/2017
5 nuesco	DRAWN:	EAM	FLEXIBLE PAVEMENT RESTORATION	DRAWING NO.
A CONTRACTOR OF THE PARTY OF TH	APPROVED): XXX	NOTES	G-12

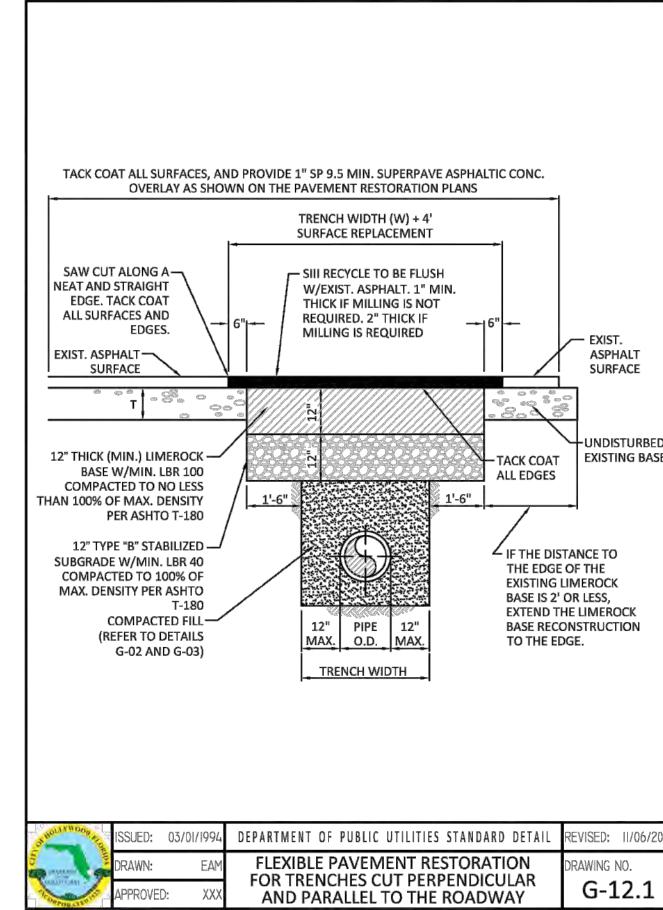

ISSUED: 03/01/1994 DEPARTMENT OF PUBLIC UTILITIES STANDARD DETAIL REVISED: 11/06/2017 DRAWN: EAM FLEXIBLE PAVEMENT RESTORATION FOR TRENCHES CUT PERPENDICULAR AND PARALLEL TO THE ROADWAY HDPE TO MIP COMPRESSION FITTING C CURB STOP (TYP) C OUTLET METER COUPLING

SINGLE SERVICE PLAN

(PROVIDED BY CITY)

PVC INSIDE PROPERTY TO BE SAME

DIAMETER AS METER OR 1" MIN WHICH EVER IS LARGER (TYP)

I" x 3/4" DUAL CHECK VALVE FOR

1" x 3/4" DUAL CHECK VALVE FOR

RAWING NO.

3/4" AND SMALLER DIAMETER

3/4" AND SMALLER DIAMETER

METERS (TYP)

METERS (TYP)

1" MIN HOPE PIPE FOR

2" MIN HDPE PIPE FO

WATER METER

(PROVIDED BY CITY)

1 1/2" & 2" METER

U BRANCH" PIECE W/ TWIN 3/4"

MIP OUTLETS (FORD METER

CO. OR APPROVED EQUAL)



- NEW OR RELOCATED UNDERGROUND WATER MAINS INCLUDED IN THIS PROJECT THAT WILL CROSS ANY
 EXISTING OR PROPOSED GRAVITY OR VACUUM-TYPE SANITARY SEWER OR STORM SEWER WILL BE LAID SO
 THE OUTSIDE OF THE WATER MAIN IS AT LEAST SIX INCHES ABOVE THE OTHER PIPELINE OR AT LEAST 12
 INCHES BELOW THE OTHER PIPELINE.
- NEW OR RELOCATED UNDERGROUND WATER MAINS INCLUDED IN THIS PROJECT THAT WILL CROSS ANY EXISTING OR PROPOSED PRESSURE-TYPE SANITARY SEWER, WASTEWATER OR STORM WATER FORCE MAIN, OR PIPELINE CONVEYING RECLAIMED WATER WILL BE LAID SO THE OUTSIDE OF THE WATER MAIN IS AT LEAST 12 INCHES ABOVE OR BELOW THE OTHER PIPELINE. [FAC 62-555.314(2); EXCEPTIONS ALLOWED UNDER FAC 62-555.314(5)].
- AT ALL UTILITY CROSSINGS DESCRIBED ABOVE, ONE FULL LENGTH OF WATER MAIN PIPE WILL BE CENTERED ABOVE OR BELOW THE OTHER PIPELINE SO THE WATER MAIN JOINTS WILL BE AS FAR AS POSSIBLE FROM THE OTHER PIPELINE, OR THE PIPES WILL BE ARRANGED SO THAT ALL WATER MAIN JOINTS ARE AT LEAST THREE FEET FROM ALL JOINTS IN VACUUM-TYPE SANITARY SEWERS, STORM SEWERS, STORM WATER FORCE MAINS, OR PIPELINES CONVEYING RECLAIMED WATER REGULATED UNDER PART III OF CHAPTER 62-610, F.A.C., AND AT LEAST SIX FEET FROM ALL JOINTS IN GRAVITY OR PRESSURE-TYPE SANITARY SEWERS, WASTEWATER FORCE MAINS, OR PIPELINES CONVEYING RECLAIMED WATER NOT REGULATED UNDER PART III OF CHAPTER 62-610, F.A.C. [FAC 62-555.314(2); EXCEPTIONS ALLOWED UNDER FAC 62-555.314(5)].
- NEW UNDERGROUND WATER MAINS INCLUDED IN THIS PROJECT TO BE DUCTILE IRON PIPE (D.I.P.) WHEN CROSSING BELOW SANITARY SEWER MAINS.
- 5. POLYETHYLENE ENCASEMENT MATERIAL SHALL BE USED TO ENCASE ALL BURIED DUCTILE IRON PIPE, FITTINGS, VALVES, RODS, AND APPURTENANCES IN ACCORDANCE WITH AWWA C105, METHOD A. THE POLYETHYLENE TUBING SHALL BE CUT TWO FEET LONGER THAN THE PIPE SECTION AND SHALL OVERLAP THE ENDS OF THE PIPE BY ONE FOOT. THE POLYETHYLENE TUBING SHALL BE GATHERED AND LAPPED TO PROVIDE A SNUG FIT AND SHALL BE SECURED AT QUARTER POINTS WITH POLYETHYLENE TAPE. EACH END OF THE POLYETHYLENE TUBING SHALL BE SECURED WITH A WRAP OF POLYETHYLENE TAPE.
- 6. THE POLYETHYLENE TUBING SHALL PREVENT CONTACT BETWEEN THE PIPE AND BEDDING MATERIAL, BUT IS NOT INTENDED TO BE A COMPLETELY AIRTIGHT AND WATERTIGHT ENCLOSURE. DAMAGED POLYETHYLENE TUBING SHALL BE REPAIRED IN A WORKMANLIKE MANNER USING POLYETHYLENE TAPE, OR THE DAMAGED SECTION SHALL BE REPLACED. POLY WRAP WILL NOT BE PAID FOR AS A SEPARATE BID ITEM. IT SHALL BE CONSIDERED TO BE A PART OF THE PRICE BID FOR WATER MAINS.
- FIRE HYDRANT BARRELS SHALL BE ENCASED IN POLY WRAP UP TO THE GROUND SURFACE AND THE WEEP
 HOLES SHALL NOT BE COVERED BY THE POLY WRAP.
- GATE VALVES FOR USE WITH PIPE LESS THAN THREE INCHES (3") IN DIAMETER SHALL BE RATED FOR TWO HUNDRED (200) PSI WORKING PRESSURE, NON-SHOCK, BLOCK PATTERN, SCREWED BONNET, NON-RISING STEM, BRASS BODY, AND SOLID WEDGE. THEY SHALL BE STANDARD THREADED FOR PVC PIPE AND HAVE A MALLEABLE IRON HANDWHEEL. GATE VALVES 3" THROUGH 16" IN DIAMETER SHALL BE RESILIENT SEAT AND BIDIRECTIONAL FLOW ONLY. VALVES FOR SPECIAL APPLICATIONS WILL REQUIRE CITY UTILITY APPROVAL.
- O. VALVE BOXES AND COVERS FOR ALL SIZE VALVES SHALL BE OF CAST IRON CONSTRUCTION AND ADJUSTABLE SCREW-ON TYPE. THE LID SHALL HAVE CAST IN THE METAL THE WORD "WATER" FOR THE WATER LINES. ALL VALVE BOXES SHALL BE SIX INCH (6") NOMINAL DIAMETER AND SHALL BE SUITABLE FOR DEPTHS OF THE PARTICULAR VALVE. THE STEM OF THE BURIED VALVE SHALL BE WITHIN TWENTY-FOUR INCHES (24") OF THE FINISHED GRADE UNLESS OTHERWISE APPROVED BY THE CITY.
- ALL WATER MAIN INSTALLATIONS SHALL COMPLY WITH THE COLOR CODING REQUIREMENTS OF CHAPTER 62-555.320 F.A.C.

OF HOLLY WOOD AT	ISSUED:	03/01/1994	DEPARTMENT OF PUBLIC UTILITIES STANDARD DETAIL	REVISED: 06/08/2014
DIAMOND S	DRAWN:	EAM	WATER SYSTEM NOTES	DRAWING NO.
OK DITAN	APPROVED	: XXX	WATER SYSTEM NOTES	W-01

WATER SYSTEM NOTES (CONTINUED):


- ALL WATER MAIN INSTALLATIONS SHALL COMPLY WITH THE COLOR CODING REQUIREMENTS OF CHAPTER 62-555.320 F.A.C.
- 12. ALL PVC PIPE SHALL CONFORM TO THE REQUIREMENTS OF ANSI/AWWA C900 LATEST REVISION AND CLASS DR 18. ALL DIP WATER MAINS SHALL BE DUCTILE IRON PRESSURE CLASS 350, WITH WALL THICKNESS COMPLYING WITH CLASS 52. ALL DUCTILE IRON PIPE SHALL CONFORM TO THE REQUIREMENTS OF ANSI/AWWA C151/A21.51-02 AND BE CEMENT LINED AND SEAL COATED PER ANSI/AWWA C104/A21.4-03.
- 13. FITTINGS SHALL BE DUCTILE IRON, MEETING ANSI/AWWA C153/A21.53-00 SPECIFICATIONS, WITH 350 PSI MINIMUM WORKING PRESSURE. FITTINGS MUST BE CEMENT LINED AND SEAL COATED PER ANSI/AWWA C104/A21.4-03. ALL DUCTILE IRON PIPE AND FITTINGS MUST BE MANUFACTURED IN THE UNITED STATES OF AMERICA.
- ALL DUCTILE IRON PIPE TO BE MECHANICAL JOINTS, WRAPPED IN POLY. ADEQUATE PROTECTIVE MEASURES
 AGAINST CORROSION SHALL BE USED AS DETERMINED BY DESIGN.
- 15. PAVEMENT RESTORATION SHALL BE CARRIED OUT IN ACCORDANCE WITH THE REQUIREMENTS OF THE CITY.
- ALL TRENCHING, PIPE LAYING, BACKFILL, PRESSURE TESTING, AND DISINFECTING MUST COMPLY WITH THE CITY OF HOLLYWOOD SPECIFICATIONS.
- 17. THE MINIMUM DEPTH OF COVER OVER WATER MAINS IS 30" (DIP) OR 36" (PVC).
- 18. MINIMUM HORIZONTAL SEPARATION BETWEEN STORM STRUCTURES AND WATER MAINS SHALL BE 3'.


19. MAXIMUM DEFLECTION PER EACH JOINT SHALL BE 50% OF MANUFACTURES RECOMMENDATION

- (MAXIMUM) WHERE DEFLECTION IS REQUIRED.

 20. CONTRACTOR SHALL BE RESPONSIBLE FOR IDENTIFYING CONFLICTS WITH WATER MAINS PLACED AT
- MINIMUM COVER. IN CASE OF CONFLICT, WATER MAIN SHALL BE LOWERED TO PASS UNDER CONFLICTS WITH 18" MINIMUM VERTICAL SEPARATION. NO ADDITIONAL PAYMENT SHALL BE DUE TO CONTRACTOR FOR LOWERING THE MAIN OR THE ADDITIONAL FITTINGS USED THEREON.
- 21. PIPE JOINT RESTRAINT SHALL BE PROVIDED BY THE USE OF DUCTILE IRON FOLLOWER GLANDS MANUFACTURED TO ASTM A 536-80. TWIST-OFF NUTS SHALL BE USED TO ENSURE PROPER ACTUATING OF THE RESTRAINING DEVICES. THE MECHANICAL JOINT RESTRAINING DEVICES SHALL HAVE A WORKING PRESSURE OF 250 PSI MINIMUM, WITH A MINIMUM SAFETY FACTOR OF 2:1, AND SHALL BE EBAA IRON INC., MEGALUG OR APPROVED EQUAL. JOINT RESTRAINTS SHALL BE PROVIDED AT A MINIMUM OF THREE JOINTS (60 FEET) FROM ANY FITTING.
- 22. WHENEVER IT IS NECESSARY, IN THE INTEREST OF SAFETY, TO BRACE THE SIDES OF A TRENCH, THE CONTRACTOR SHALL FURNISH, PUT IN PLACE AND MAINTAIN SUCH SHEETING OR BRACING AS MAY BE NECESSARY TO SUPPORT THE SIDES OF THE EXCAVATION TO ENSURE PERSONNEL SAFETY, AND TO PREVENT MOVEMENT WHICH CAN IN ANY WAY DAMAGE THE WORK OR ENDANGER ADJACENT STRUCTURES. THE CONTRACTOR SHALL BE SOLELY RESPONSIBLE FOR THE SEQUENCE, METHODS AND MEANS OF CONSTRUCTION, AND FOR THE IMPLEMENTATION OF ALL OSHA AND OTHER SAFETY REQUIREMENTS.


O'HOLLYWOWN ARE	ISSUED:	03/01/1994	DEPARTMENT OF PUBLIC UTILITIES STANDARD DETAIL	REVISED: 06/08/2014
S DAMUNI	DRAWN:	EAM		DRAWING NO.
LIM D COAST	APPROVED	: XXX	WATER SYSTEM NOTES	W-02

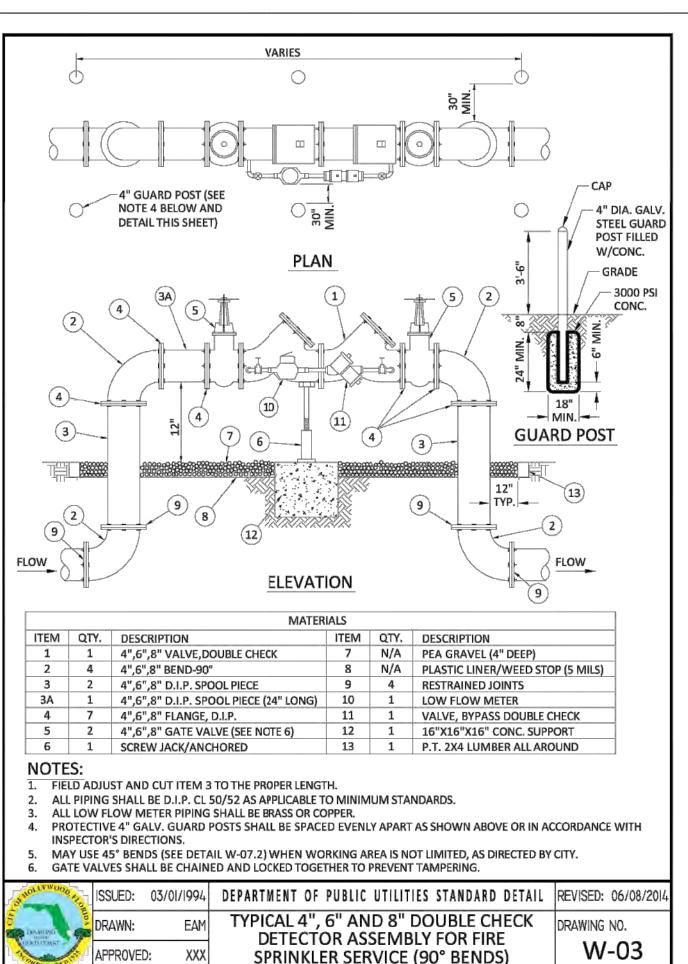

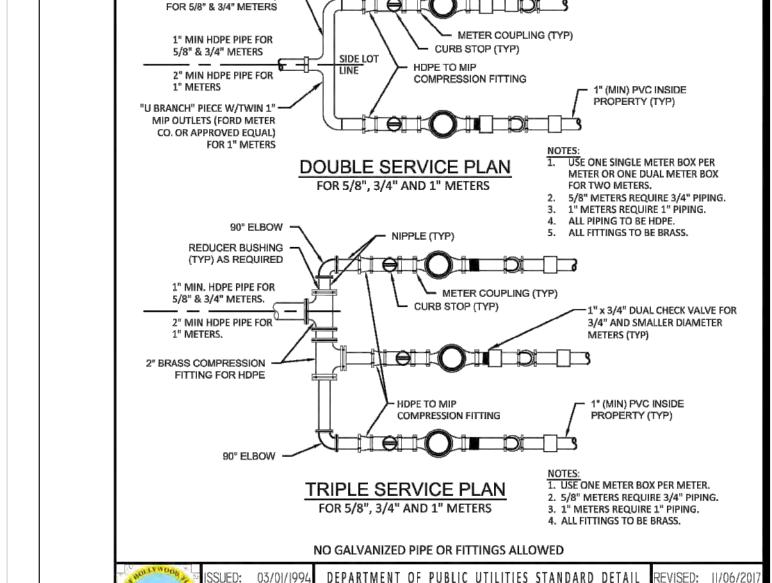

TYPICAL 5/8", 1", 1-1/2" AND

2" METER INSTALLATION

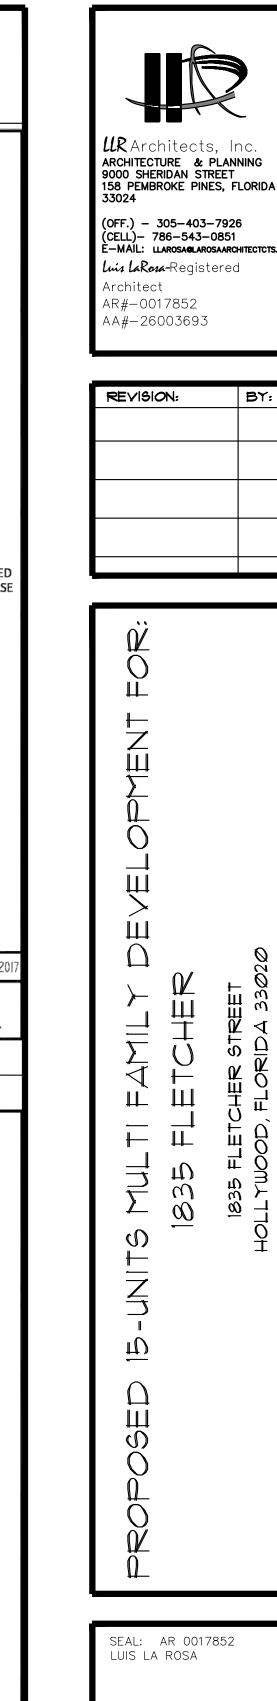



C.C.

CHECKED

L.L.R.

DATE

10/3/2023


SCALE


AS NOTED


JOB. NO.

023-041

SHEET

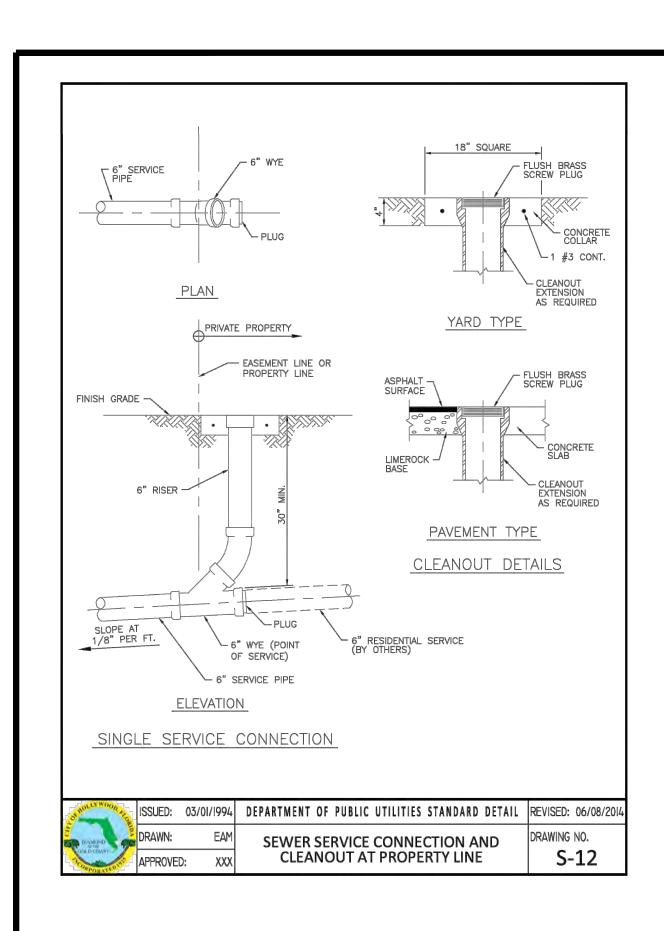

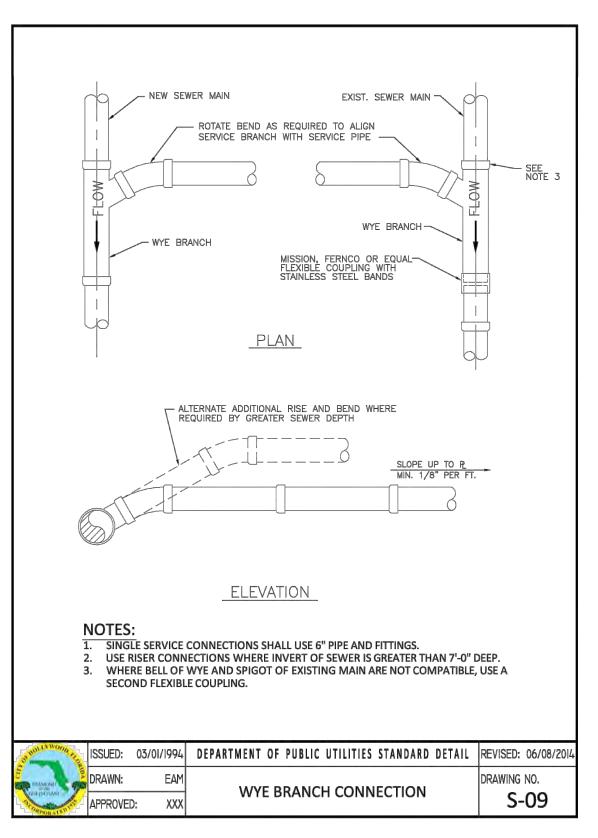

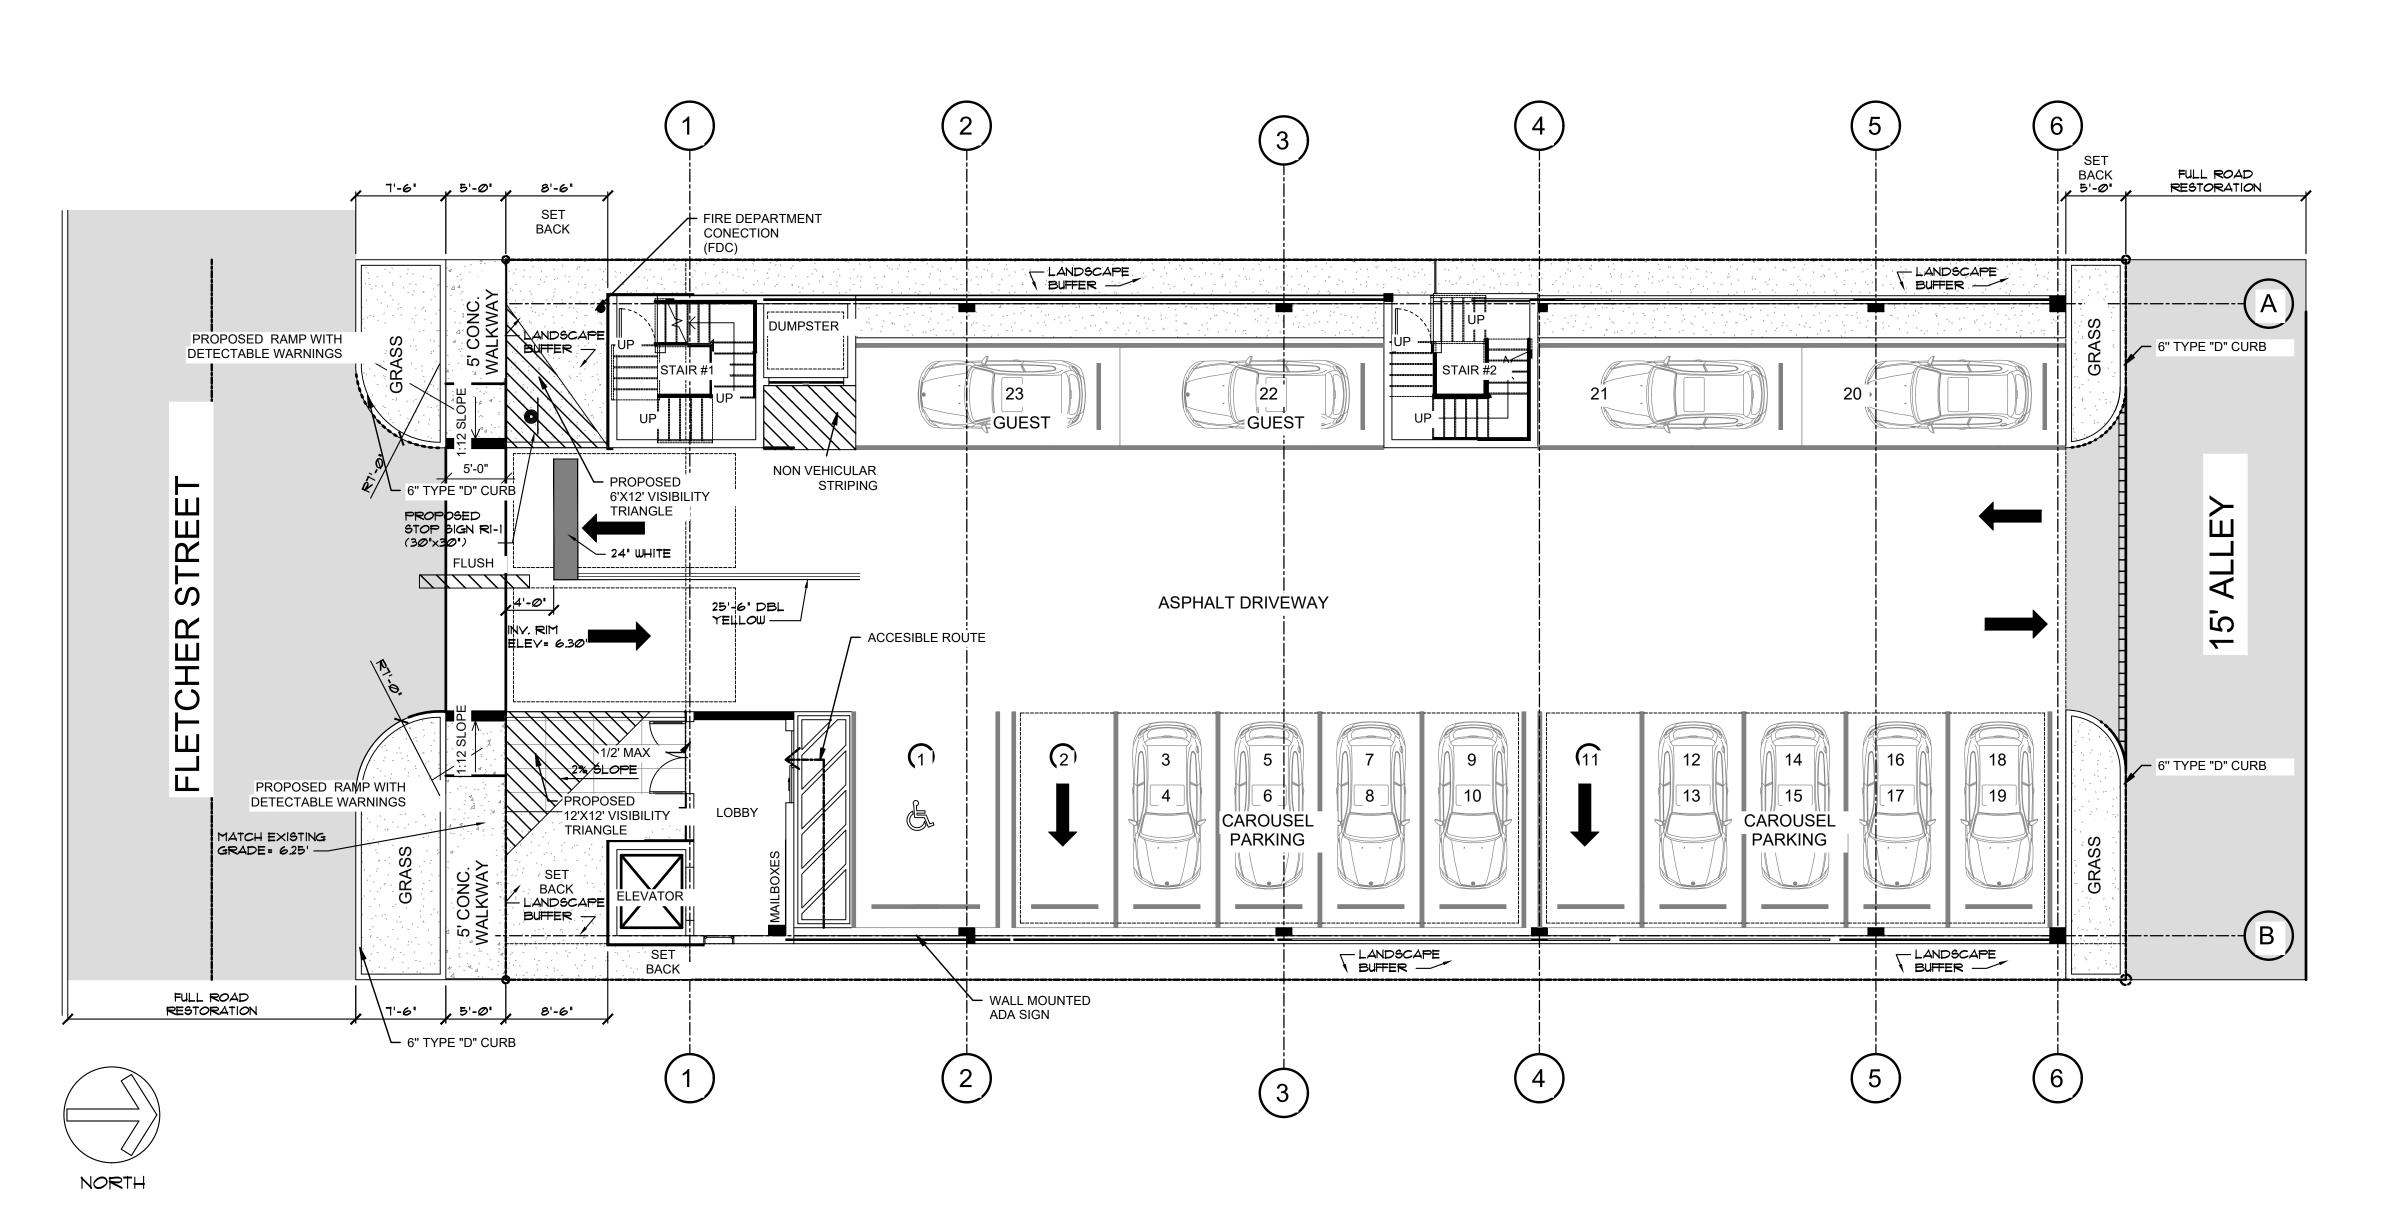




REVISION:	BY:	

PROPOSED 15-UNITS MULTI FAMILY DEVELOPMENT FOR 1835 FLETCHER STREET HOLLYWOOD, FLORIDA 33020


SEAL: AR 0017852 LUIS LA ROSA


DRAV	VN
	C.C.
CHEC	
D A TE	L.L.R.
DATE	1 <i>0</i> /3/2 <i>0</i> 23
SCAL	
	AS NOTED
JOB.	NO. @23-@41
SHEE	ΪΤ
]=1,4


SHEETS

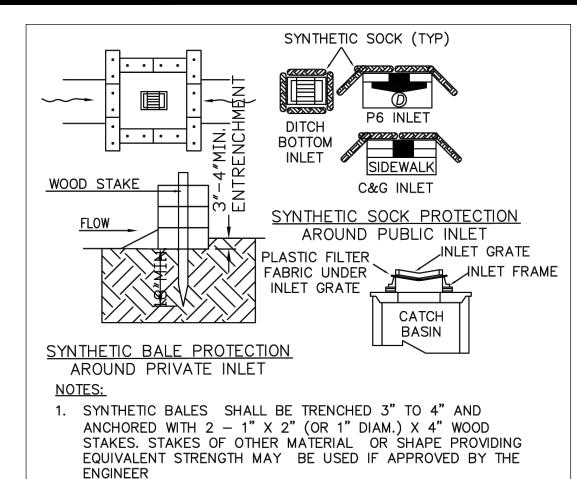


- ENGINEER
- 2. ADJACENT SYNTHETIC BALES SHALL BE BUTTED FIRMLY TOGETHER. UNAVOIDABLE GAPS SHALL BE PLUGGED WITH HAY OR STRAW TO PREVENT SILT FROM PASSING
- 3. SYNTHETIC BALES SHALL BE INSTALLED AT ALL NEW INLETS ON PRIVATE PROPERTY AND SYNTHETIC "SOCKS" ON EXISTING INLETS IN THE PUBLIC RIGHT O WAY DURING CONSTRUCTION
- 4. CONTRACTOR TO INSTALL PLASTIC FILTER FABRIC UNDER INLET GRATE ON ALL NEW INLETS AND IT SHALL REMAIN THERE FOR THE DURATION OF THE CONSTRUCTION

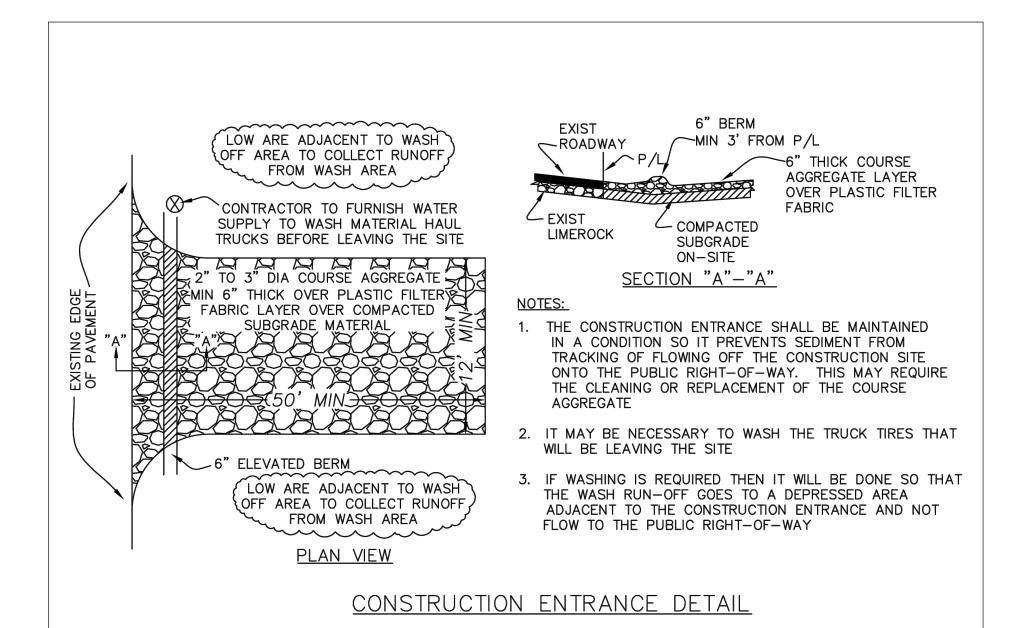

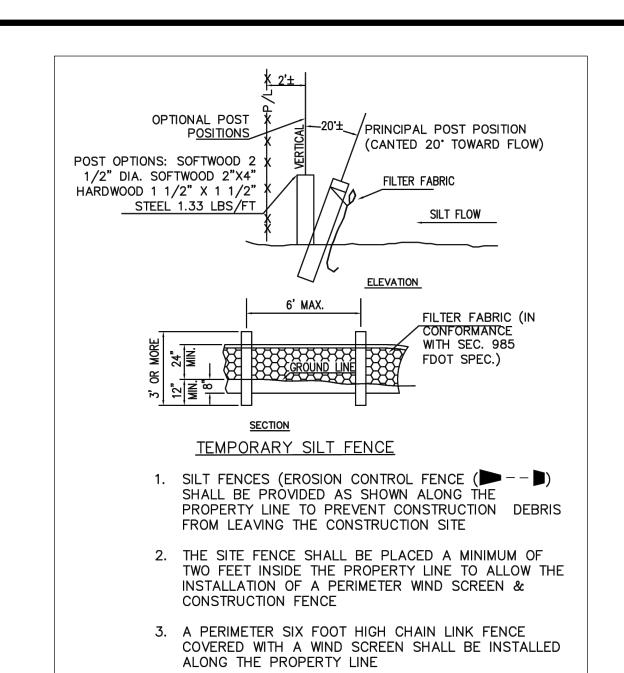

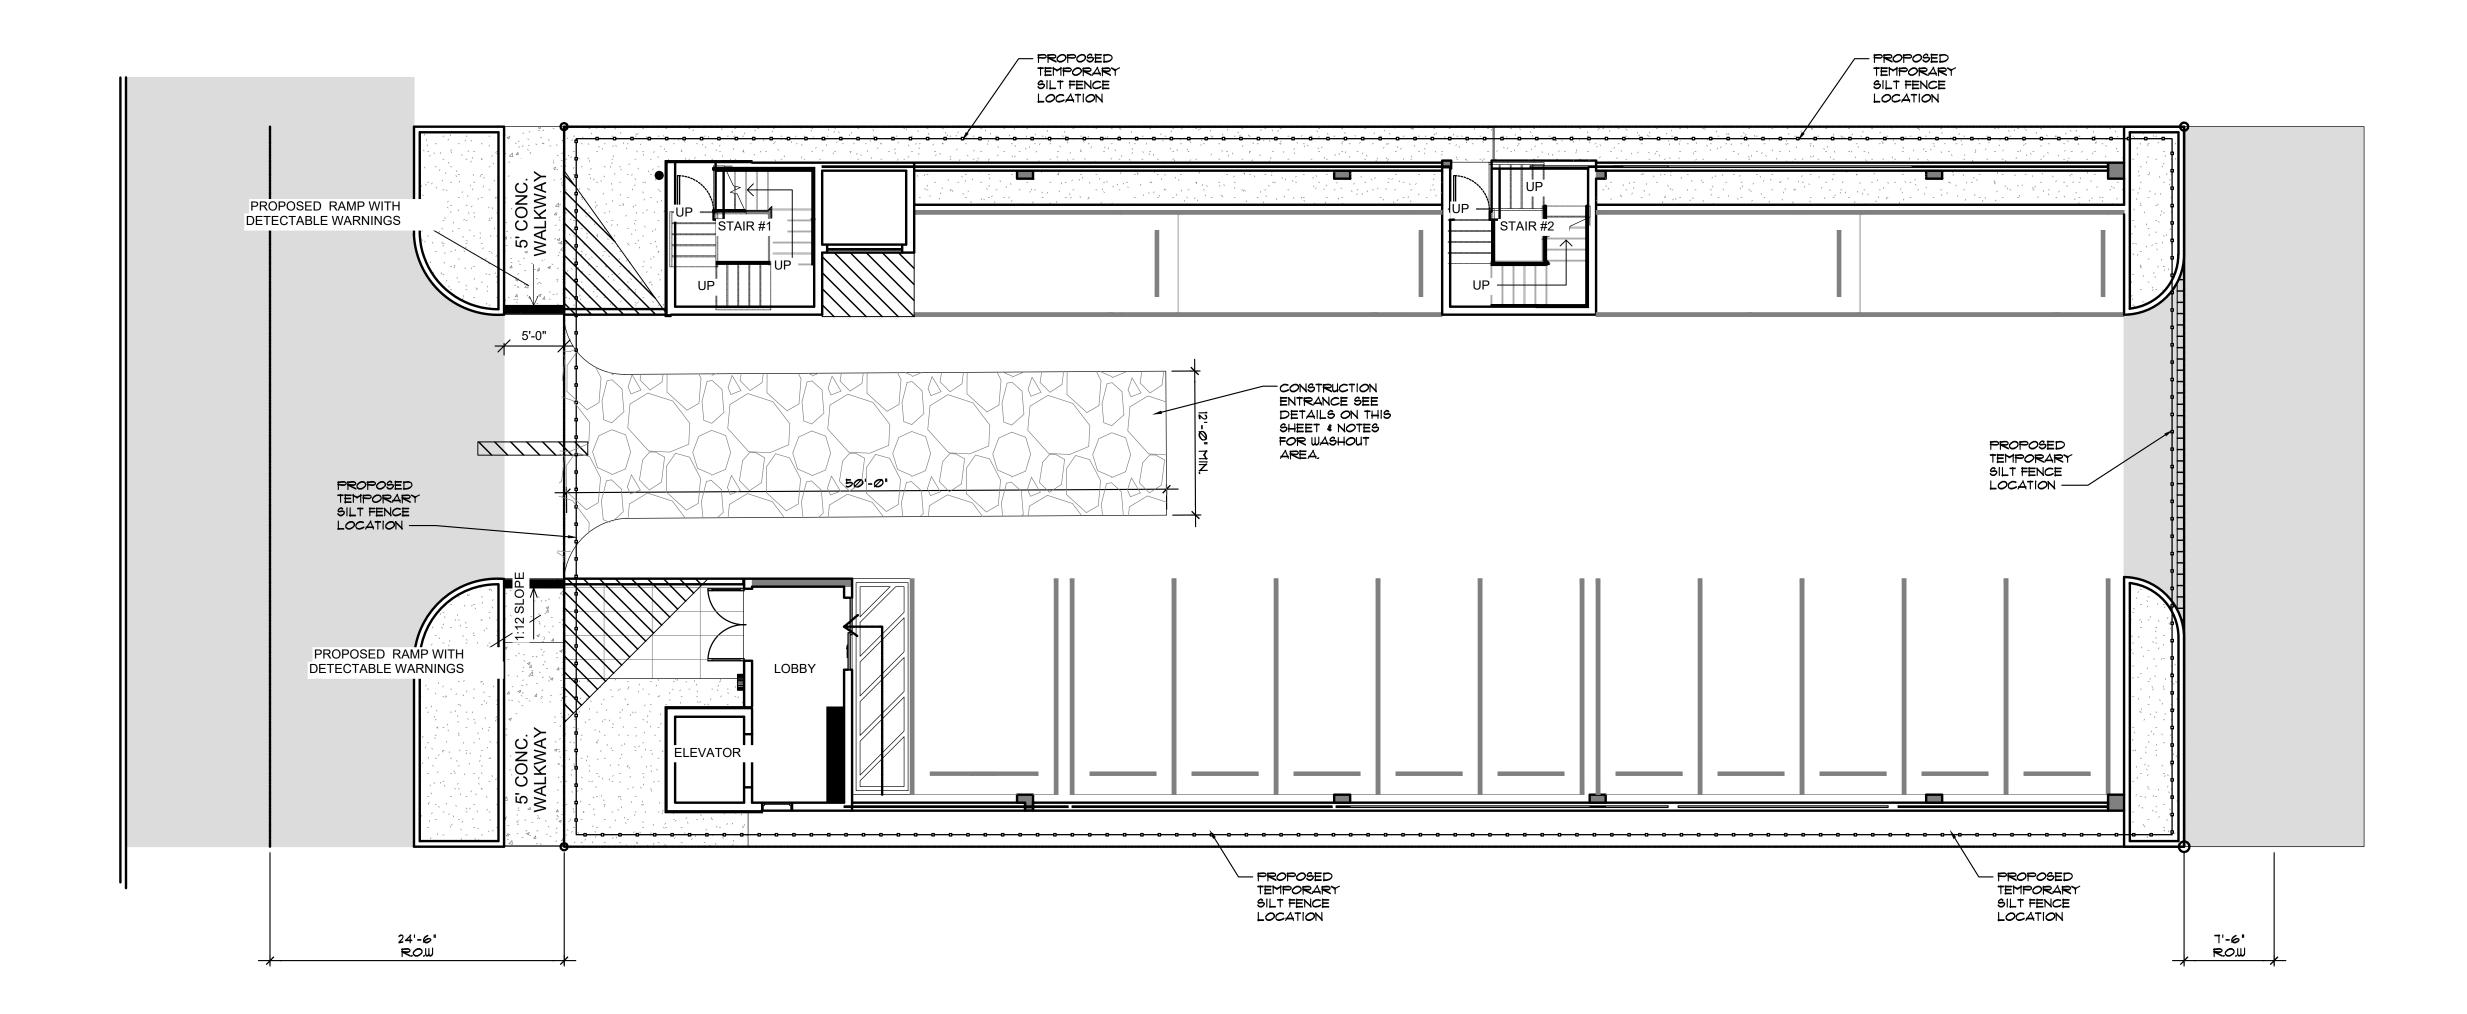

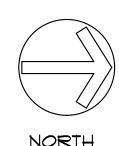

URArchitects, Inc. ARCHITECTURE & PLANNING 9000 SHERIDAN STREET 158 PEMBROKE PINES, FLORIDA


(OFF.) - 305-403-7926

(CELL)- 786-543-0851 E-MAIL: LLAROSA@LAROSAARCHITECTCTS.C Luis La Rosa-Registered Architect AR#-0017852 AA#-26003693

_		
	REVISION:	BY:

SEAL: AR 0017852 LUIS LA ROSA

DRAWN
C.C.
CHECKED
L.L.R.
DATE
10/3/2023
SCALE
AS NOTED
JOB. NO.
<i>@</i> 23- <i>@</i> 41
SHEET

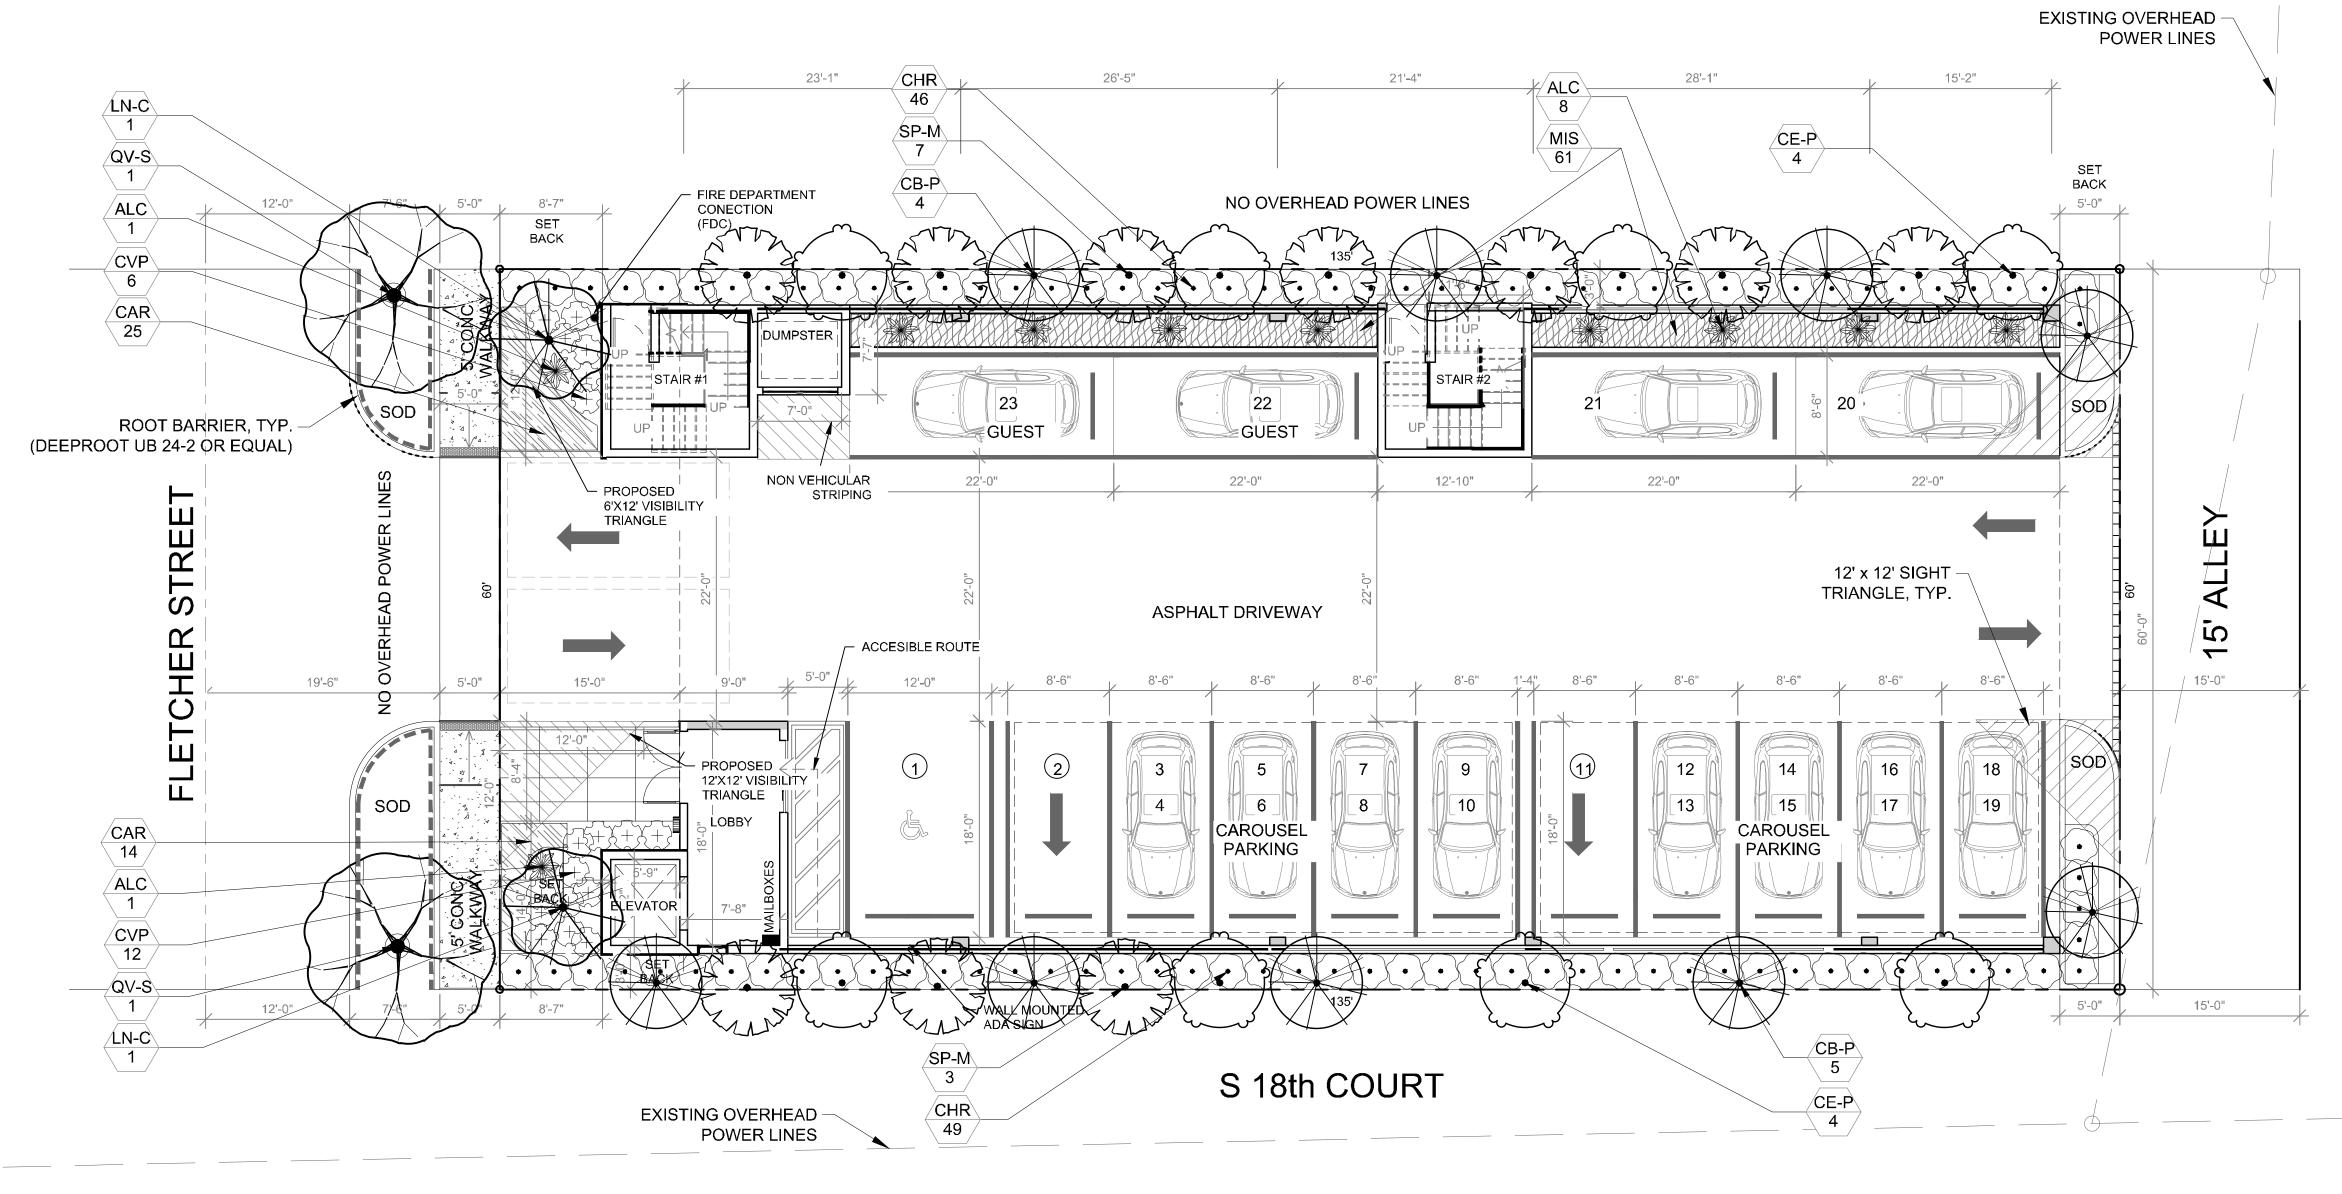

Disclaimer: Trees and Palms shall not be removed without first obtaining an approved Tree Removal Permit from the City of Hollywood. Note: Proposed landscaping along perimeter will not interfere with proposed grass swales function.

Landscape Data:


RAC Zoning - FH-2 (Federal Highway Medium-High Intensity Mixed-Use District)	Required	Provided
Perimeter Landscape One 12' street tree per 30 linear feet or portion thereof, of street frontage of property wherein said improvements are proposed.	2 Trees (60'/30)	2 Trees (See Schedule)
Residential Uses shall provide a five (5) foot landscape buffer within required setback areas with one (1) tree for every 20 linear feet of required buffer area.	17 Trees (330'/20)	17 Trees (See Schedule)
Minimum Open Space All pervious areas must be landscaped with grass, ground cover, and/or shrubbery. Minimum of one tree per 1,000 sq. ft. of pervious area. Ground Floor: 1,229 sf	2 Trees	2 Trees (See Schedule)
Total Required:	2 Trees (1,229 SF)	2 Trees (See Schedule)
Minimum Tree Sizes Shade trees:2" DBH/ 12' height. Palm trees: 8' of GW or CT. (One Palm = 1 Tree Credit)		
Native Requirements A minimum of 60% of required trees and 50% of required shrubs must be native species.	14 Trees 55 Shrubs	19 Trees 95 Shrubs

Landscape Notes:

- Alternative plant species for required landscape may be permitted subject to review and approval by the City of Hollywood Planning Department prior to installation.
- All prohibited exotic or invasive species shall be removed from the entire site prior to the issuance of a Certificate of Occupancy.
- All required landscaping shall be installed prior to the issuance of a Certificate of Occupancy.
- No Cypress Mulch is to be used on site. Eucalyptus or Melaleuca Mulch is to be used in a 3" consistent layer in all
- planting beds.
 Enhanced landscaping beyond minimum requirements will conform to all applicable sections of the City of Hollywood
- Landscape Manual.
- This plan has been designed to meet the tree planting requirements contained within the FPL document entitled 'Plant the Right Tree in the Right Place' and City of Hollywood Landscape Manual.
- For existing or proposed utilities, no tree shall be planted where it could, at mature height conflict with overhead power lines
- Tree species shall be selected as to minimize conflicts with existing or proposed utilities.
- See engineer's plans for all underground & overhead utilities and field locate all prior to installation; contact Landscape Designer/Owner regarding any conflicts.
- All site drainage by others.
- Landscape adjacent to vehicular traffic to be maintained to preserve site line visibility.
- Tree Relocation Note: Do not relocate without obtaining permit from the City of Hollywood. Existing tree(s) to be relocated require root pruning by a qualified professional prior to relocation. If the tree(s) does not survive after relocation and is dead or in poor health at time of final inspection, mitigation will be required through payment into the tree preservation
- fund, equal to \$350 per every 2" tree mitigation owed.
- Irrigation Note: Per Article 9: 9.4(4): Irrigation. All landscaped areas shall receive 100% coverage by means of an automatic sprinkler system designed and constructed in accordance with the City of Hollywood Code of Ordinances, the Florida Building Code, State Law, and the regulations of the South Florida Water Management District. Failure to maintain or disconnection of the irrigation system shall be a violation of these regulations.

Plant Schedule:

CODE	QTY	BOTANICAL NAME	COMMON NAME	SIZE	NATIVE	
MITIGAT	ION TR	EES				
SP-M	10	Sabal palmetto	Sabal Palm	FG, 8`-12- CT, HVY C, SP	Yes	
PERIME	TER TR	EES				
CE-P	8	Conocarpus erectus 'sericeus'	Silver Buttonwood	FG, 12` HT, 2" DBH MIN, STD, SP	Yes	
CB-P	9	Cordia sebestena	Orange Geiger Tree	FG, 12` HT, 2" DBH MIN, STD, SP	Yes	
CODE T	REES					
LN-C	2	Lagerstroemia indica `Natchez`	Natchez Crape Myrtle	FG, 12` HT, 2" DBH MIN, STD, SP	No	
STREET	TREES	8				
QV-S	2	Quercus virginiana	Southern Live Oak	FG, 12` HT, 2" DBH MIN, STD, SP	Yes	
SHRUBS	3					
ALC	10	Alcantarea odorata	Giant Silver Bromeliad	17" POT, 36" OA, SP	No	
CHR	95	Chrysobalanus icaco `Redtip`	Red Tip Cocoplum	3G, 24" OA, F,	Yes	
CVP	18	Codiaeum variegatum `Petra`	Bravo Croton	3G, 24" OA, F,	No	
CODE	QTY	BOTANICAL NAME	COMMON NAME	SIZE	NATIVE	SPACING
GROUND COVERS						
CAR	39	Carissa macrocarpa `Emerald Blanket`	Emerald Blanket Carissa	3G, 12" OA, F, @	No	18" o.c.
MIS	61	Microsorum scolopendrum	Wart Fern	1G, 12" OA, F,	No	24" o.c.
SOD		Stenotaphrum secundatum	St. Augustine Grass	Sod, Free of Weeds, Pests, & Debris	No	

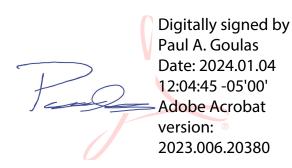





(CELL)- 786-543-0851


ĹE-MAIĹ: llarosa@larosaarchitectcts.com


PROPOSED MULTIFMAILY DEVELOPMENT FOR:


2022 MAYO LLC


1835 Fletcher Street, Hollywood, FL 33020

Landscape Plan

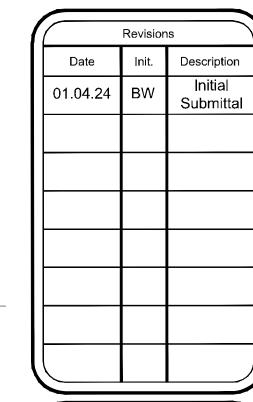

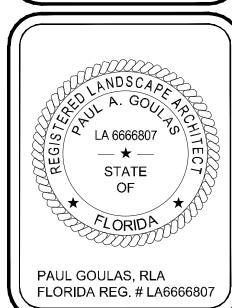

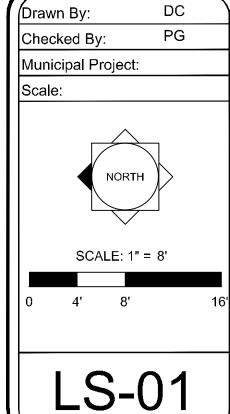

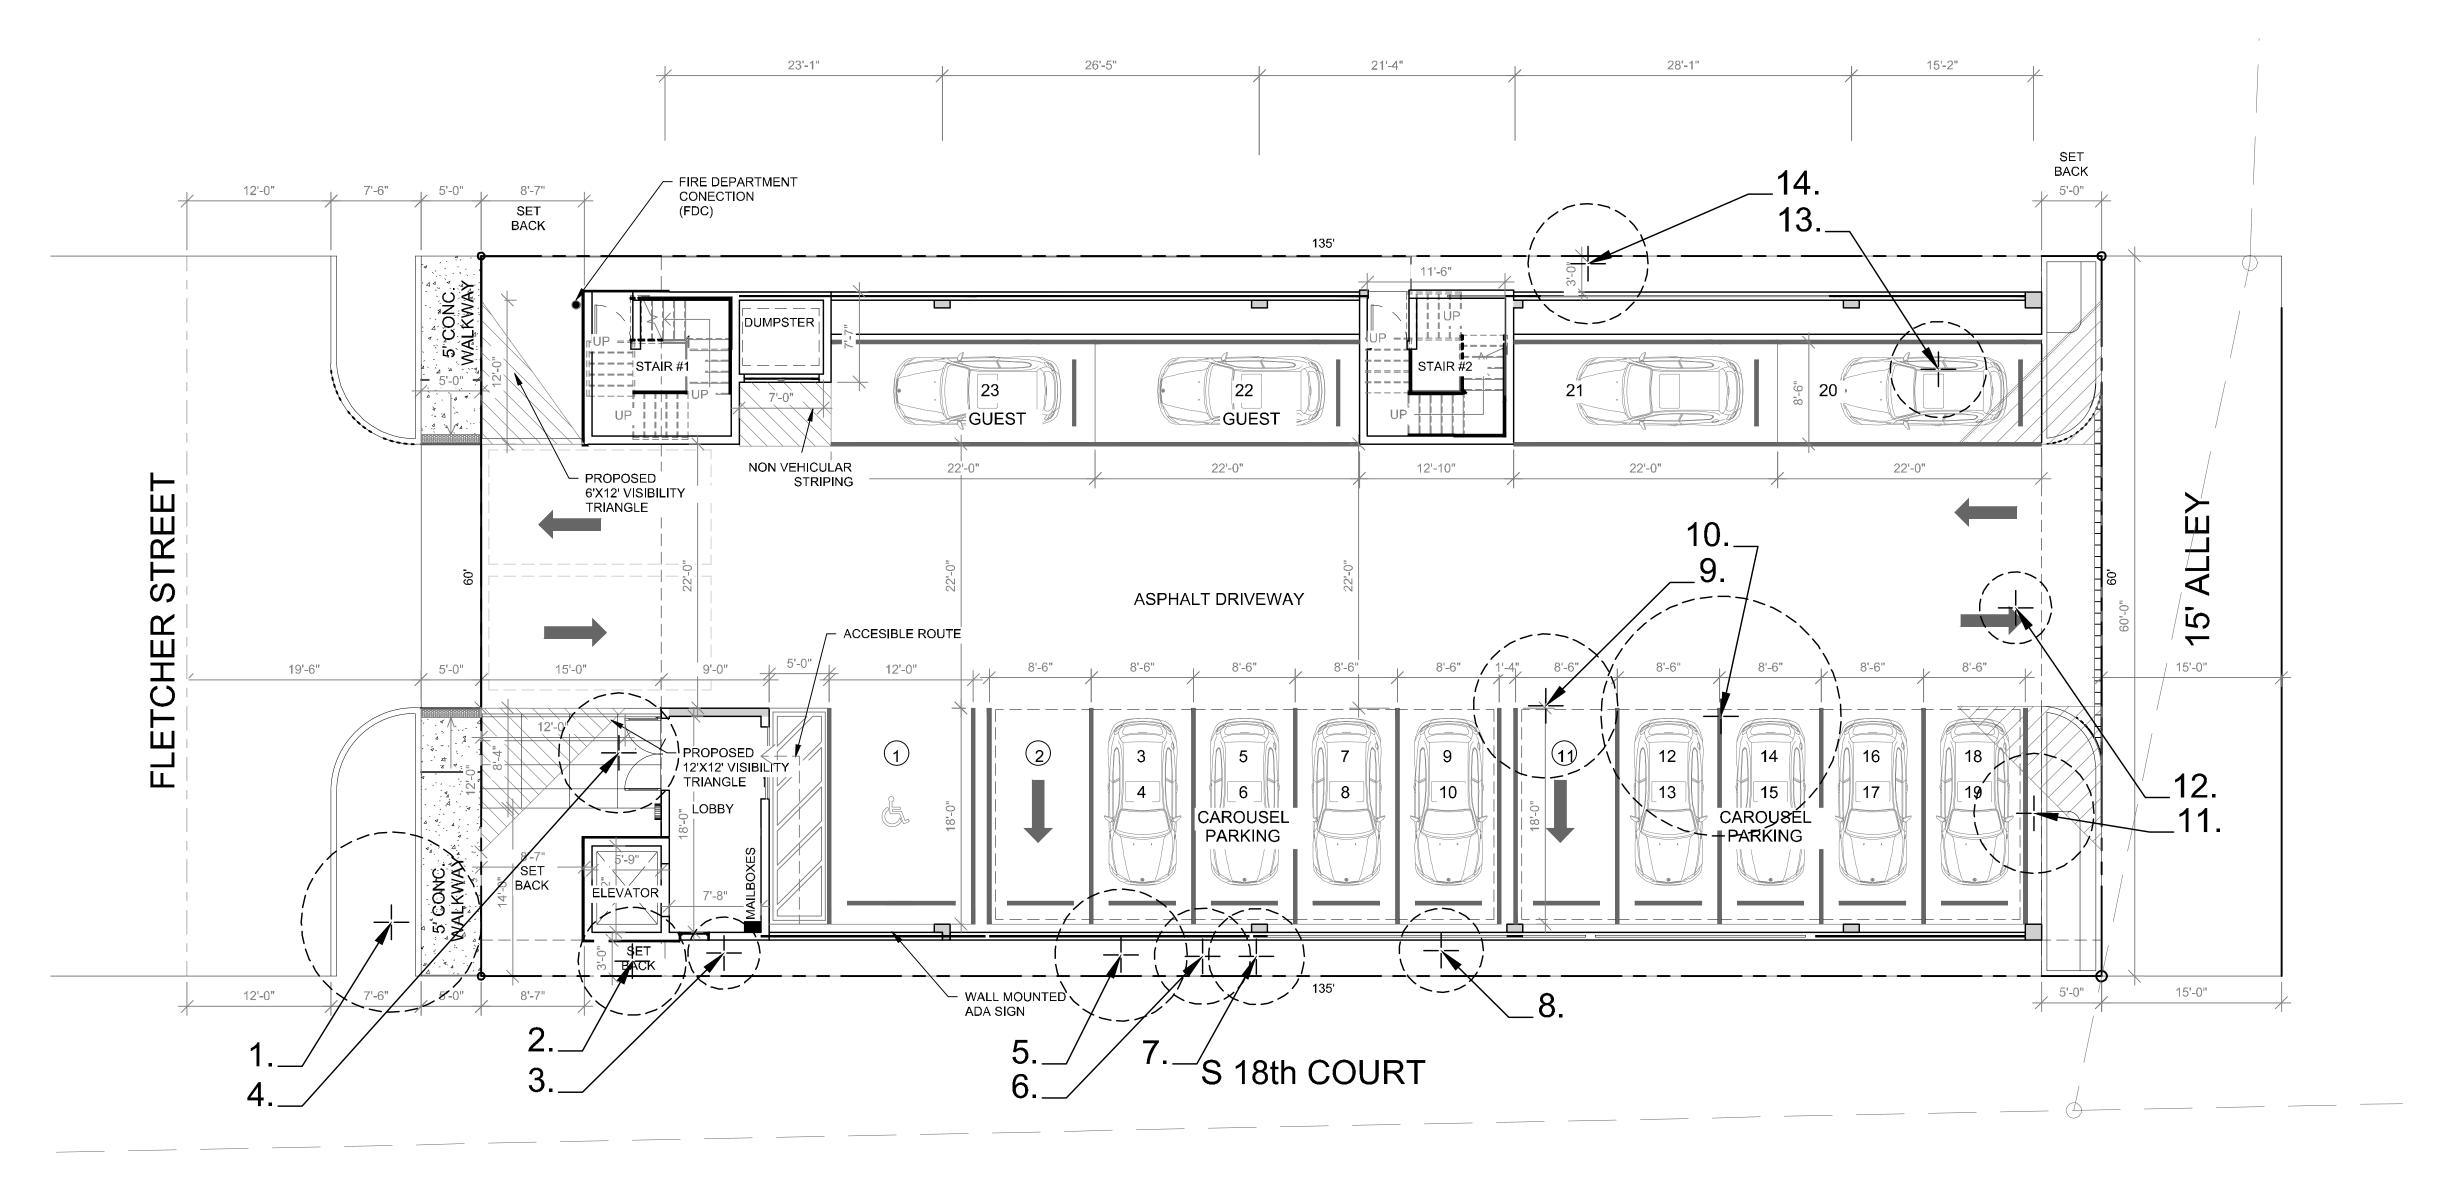

NOTE: Trees and Palms shall not be removed without first obtaining an approved Tree Removal Permit from the City of Hollywood.

Existing Trees to be Removed:

	TREE CHART					
Tree #	Common Name	Scientific Name	Trunk Diameter at Breast Height DBH(in) (+/-)	Approximate	Approximate Canopy (ft)(+/-)	
1	Palm	Unknown	8	12	15	
2	Palm	Unknown	7	11	9	
3	Palm	Unknown	7	11	6	
4	Unknown	Unknown	15	32	10	
5	Palm	Unknown	7	8	11	
6	Palm	Unknown	7	11	8	
7	Palm	Unknown	7	11	8	
8	Palm	Unknown	8	13	7	
9	Unknown	Unknown	5	15	12	
10	Mango Tree	Mangifera Indica	15	25	20	
11	Coconut Palm	Cocos nucifera	12	25	10	
12	Coconut Palm	Cocos nucifera	6	12	6	
13	Palm	Unknown	5	12	8	
14	Unknown	Unknown	12	15	10	

Landscape Tree Mitigation Data:

Trees F	Replacement Provided	Trees Removed
14. <i>Unknown, Ur</i> 15' Height <i>,</i> 10'	1 Palm Tree (Sabal Palm)	1. <i>Palm, Unknown,</i> 8" DBH, 12' Height, 15' Canopy Spread
Total r Ten (10) Total	1 Palm Tree (Sabal Palm)	2. <i>Palm, Unknown,</i> 7" DBH, 11' Height, 9' Canopy Spread
Remaining	1 Palm Tree (Sabal Palm)	3. <i>Palm, Unknown,</i> 7" DBH, 11' Height, 6' Canopy Spread
*Mitigation Tree Requiren	\$2,625 Payment Contribution (\$350 / 2" DBH @ 15")	4. <i>Unknown, Unknown,</i> 15" DBH, 32' Height, 10' Canopy Spread
minimum 8' clear trunk.	1 Palm Tree (Sabal Palm)	5. <i>Palm, Unknown,</i> 7" DBH, 8' Height, 11' Canopy Spread
	1 Palm Tree (Sabal Palm)	6. <i>Palm, Unknown,</i> 7" DBH, 11' Height, 8' Canopy Spread
	1 Palm Tree (Sabal Palm)	7. <i>Palm, Unknown,</i> 7" DBH, 11' Height, 8' Canopy Spread
	1 Palm Tree (Sabal Palm)	8. <i>Palm, Unknown,</i> 8" DBH, 13' Height, 7' Canopy Spread
	\$875 Payment Contribution (\$350 / 2" DBH @ 5")	9. <i>Unknown, Unknown,</i> 5" DBH, 15' Height, 12' Canopy Spread
	\$2,625 Payment Contribution (\$350 / 2" DBH @ 15")	10. Mango Tree, Mangifera inidica, 15" DBH, 25' Height, 20' Canopy Spread
	1 Palm Tree (Sabal Palm)	11. Coconut Palm, Cocos nucifera, 12" DBH, 25' Height, 10' Canopy Spread
	1 Palm Tree (Sabal Palm)	12. Coconut Palm, Cocos nucifera, 6" DBH, 12' Height, 6' Canopy Spread
	1 Palm Tree (Sabal Palm)	13. <i>Palm, Unknown,</i> 5" DBH, 12' Height, 8' Canopy Spread

Remaining (47") of mitigation to be provided by payment to City Tree Fund:
\$8,225 Total Payment Required.

*Mitigation Tree Requirements: All replacement trees minimum of twelve (12) feet in height when planted on private property and twelve (12) feet when planted on swales and commercial properties. Palms

Total mitigation planted on site to satisfy required tree replacement: Ten (10) Total Palms. See 'Mitigation Trees' listed in the plant schedule, Sheet LS-01.

Replacement Provided

\$2,100 Payment Contribution (\$350 / 2" DBH @ 12")

Trees Removed

14. Unknown, Unknown, 12" DBH,

15' Height, 10' Canopy Spread

Project Team

Landscape Architect:

LANDSCAPE
ARCHITECTURAL
SERVICES, LLC

1708 SE Joy Haven Street
Port St. Lucie, Fl. 34983

772) 834-1357 | brandon@las-fl.cor


LLR Architects, Inc.
ARCHITECTURE & PLANNING
12980 S.W. 52 STREET
MIRAMAR, FLORIDA 33027

(OFF.) - 305-403-7926 (CELL)- 786-543-0851 E-MAIL: LLAROSA@LAROSAARCHITECTCTS.COM

AYO LLC
Hollywood, FL 33020

2022 MAYO LLC
1835 Fletcher Street, Hollywoo
Tree Disposition

	Revisions		
Date	Init.	Description	
01.04.24	BW	Initial Submitta	

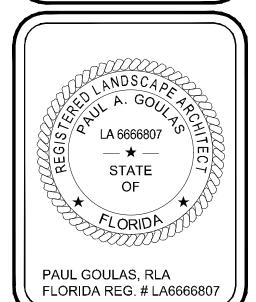

Drawn By:	DC
Checked B	y: PG
Municipal F	Project:
Scale:	
	NORTH ALE: 1" = 8'
	ALL. I - 0
0 4'	8' 16

Landscape Specifications

PART 1: GENERAL CONDITIONS

1.01 SCOPE:

A. The landscape contract includes the supplying and planting of all trees, shrubs, vines, and ground cover together with all necessary labor, equipment, tools and materials needed for the successful completion, execution and maintenance of the landscape plans.

1.02 AGENCY STANDARDS:

A. Grades and standards of plant materials to be used shall be true to name, size, condition and graded Florida #1 or better as stated in: Grades and Standards of Florida Plant Materials published by the State of Florida Department of Agriculture, Tallahassee, Florida.

1.03 SITE EXAMINATION:

A. The Landscape Contractor shall personally examine the site and fully acquaint him/herself with all of the existing conditions in order that no mis-understanding may afterwards arise as to the character or extent of the work to be performed, and additionally, in order to acquaint him/herself with all precautions to be taken in order to avoid injury to property or persons. No additional compensation will be granted because of any unusual difficulties which may be encountered in the execution or maintenance of any portion of the work.

1.04 ERRORS AND OMISSIONS:

A. The plant list is a part of the drawings and is furnished as a convenience. The plant list indicates the name, size and quantities of specific plant materials as called for and is located on the drawings. The Landscape Contractor is responsible for his/her own quantity count, and any discrepancy between drawings and plant list shall be considered as correct on the drawings.

B. The Landscape Contractor shall not take advantage of errors or omissions in the specifications or contract drawings. Full instruction will be given if such errors are discovered. Upon the discovery of any discrepancies in, or omissions from the drawings or documents, or should the Landscape Contractor be in doubt as to their meaning, the Landscape Architect shall be notified and will determine the actions necessary to each query.

C. If plans and specifications are found to disagree after the contract is awarded, the

Landscape Architect shall be the judge as to which was intended. 1.05 EXECUTION OF THE WORK:

A. The Landscape Contractor shall have his labor crews controlled and directed by a Foreman well versed in plant materials, planting methods, reading blueprints, and coordination between job and nursery in order to execute installation correctly and in a timely manner.

B. The Landscape Contractor shall provide a competent English-speaking Foreman on the project at all times, who shall be fully authorized as the Contractor's agent on the work. The Superintendent shall be capable of reading and thoroughly understanding the Plans, Specifications and other Contract Documents. If the Superintendent is deemed incompetent by the Landscape Architect, he (the superintendent) shall be immediately replaced.

C. The Landscape Contractor shall be available for any meetings with the Owner and/or Landscape Architect during implementation of the job. Any additional work or changes required as a result of failure to communicate with the Owner or Landscape Architect during implementation will be the responsibility of the Landscape Contractor.

1.06 PROTECTION OF PUBLIC AND PROPERTY:

A. The Landscape Contractor shall protect all materials and work against injury from any cause and shall provide and maintain all necessary safeguards for the protection of the public. He shall be held responsible for any damage or injury to persons or property which may occur as a result of his fault or negligence in the execution of the work, i.e. damage to underground pipes or cables.

1.07 CHANGES AND EXTRAS:

A. The Contractor shall not start work on any changes or "extras" in the project until a written agreement setting forth the adjusted prices has been executed by the Owner and the Contractor. Any work performed on changes or "extras" prior to execution of a written agreement may or may not be compensated for by the Owner at his discretion.

1.08 GUARANTEE:

A. The Landscape Contractor shall furnish a written guarantee warranting all materials, workmanship and plant materials, except sod, for a period of ONE (1) YEAR from the time of completion and acceptance by the Landscape Architect and Owner. Sod shall be guaranteed to 90 calendar days after acceptance by the Landscape Architect and Owner. All plant material shall be alive and in satisfactory condition and growth for each specific kind of plant at the end of the guarantee period. The guranteeing of plant material shall be construed to mean complete and immediate replacement with plant material of the same variety, type, size, quality and grade as that of the originally specified material. During the guarantee period it shall be the Landscape Contractor's responsibility to immediately replace any dead or unhealthy material as determined by the Landscape Architect. The guarantee will be null and void if plant material is damaged by lightning, hurricane force winds, or any other acts of God, as well as vandalism or lack of proper maintenance.

B. At the end of the specified guarantee period, any plant required under this contract that is dead or not in satisfactory condition, as determined by the Landscape Architect, shall be replaced. The Landscape Contractor shall be responsible for the full replacement cost of plant materials for the first replacement and share subsequent replacement (s) costs equally with the Owner, should the replacement plant fail to survive.

1.09 CARE AND MAINTENANCE:

 The Landscape Contractor shall be responsible for the care and maintenance of all plant materials and irrigation when applicable until final acceptance by the Owner or Landscape Architect.

B. The Owner agrees to execute the instructions for such care and maintenance.

1.10 SAFETY: A. It shall be the responsibility of the Landscape Contractor to protect all persons from injury and to avoid property damage. Adequate warning devices shall be placed and maintained during the progress of the work

B. It shall be the contractor's responsibility to conform to all local, state, and federal safety laws and codes including the Federal Occupational Safety And Health Act (O.S.H.A.)

1.11 CONTRACTOR QUALIFICATION: A. The Owner may require the apparent contractor (s) to qualify him/herself to be a responsible entity by furnishing any or all of the following documentary data: A financial statement showing assets and liabilities of the company current to date. A listing of not less than (3) completed projects of similar scope and nature.

Permanent name and address of place of business. 4. The number of regular employees of the organization and length of time the organization has been in business under the present name.

1.12 INSURANCE AND BONDING:

A. The contractor (s) shall submit proof of insurance for this job for the time period that the work is done. The minimum amount of insurance shall be \$300,000.00 per person and \$300,000.00 per aggregate or as required by owner and agreed to in the contract. The successful bidder shall be required to have this coverage in effect before beginning work on the site.

The Owner shall have the right to require the Contractor to furnish bonds covering faithful performance of the Contract and payment obligations arising thereunder as stipulated in bidding requirements or specifically required in the Contract Documents on the date of execution of the Contract.

1.13 PERMITS AND CERTIFICATES: A. All contractors shall secure and pay for all permits and certificates required for his/her

PART 2: MATERIALS

2.01 PLANT MATERIALS: A. A complete list of plants is shown on the drawings, including a schedule of quantities, sizes, and such other requirements deemed necessary. In the event discrepancies occur, the specifications on the drawings shall govern.

B. Substitutions: Substitutions of plant materials or changes in size or spacing of materials will be permitted ONLY upon written authorization by the Owner or the Landscape Architect. If plant material is not of sufficient size to meet applicable codes, a letter of variance from the appropriate agency must be obtained by the Contractor prior to issuance of any change order. If material of smaller size is to be accepted, the quantity of material shall be increased, at no additional cost to the Owner, to meet the intent of the drawings.

C. All plant materials shall have a habit of growth that is normal for the species and shall be healthy, vigorous and equal to or exceed the measurements specified in the plant list, which are the minimum acceptable sizes. Plants shall be measured before pruning with branches in normal position. Any necessary pruning shall be done at the time of planting.

D. All plant materials shall be nursery grown, unless otherwise noted, Florida #1 or better and shall comply with all required inspections, grading standards and plant regulations as set forth by the Florida Department of Agriculture's Grades and Standards for Nursery Plants, most current addition and Grades and Standards for Nursery Plants, most current addition.

Plants that do not have the normal balance of height and spread typical for the respective plant shall not be acceptable.

F. The Landscape Contractor shall install each plant to display its best side. Adjustments may be required if plants are not installed properly and/or approved by the Landscape Architect at no additional cost to owner.

A. The Landscape Architect and Owner may inspect trees and shrubs at place of growth or at site before planting, for compliance with requirements for genus, species, variety, size and quality. The Landscape Architect and Owner retain the right to further inspect trees and shrubs for size and condition of balls and root systems, insects, injuries and latent defects, and to reject unsatisfactory or defective material at any time during progress of work. Rejected plant materials shall be immediately removed from project site.

2.03 PROTECTION OF PLANT MATERIALS:

Balled and burlapped plants (B & B) shall be dug with firm natural balls of earth of sufficient diameter and depth to encompass the fibrous and feeding root system necessary for full recovery of the plant. Balls shall be firmly wrapped with burlap similar materials and bound with cord, rope, or wire mesh. All collected plants shall be balled and burlapped.

B. Plants with broken, damaged or insufficient rootballs will be rejected.

C. All plant material shall be protected from possible bark injury or breakage of branches. All plants transported by open trucks shall be adequately covered to prevent windburn, drying or

D. Plants which cannot be planted immediately on delivery to the site shall be covered with moist soil, mulch or other protection from the drying of wind and sun. All plants shall be watered as necessary by the Landscape Contractor until planted.

2.04 STORAGE: All plant materials shall be stored on the site in designated areas, specified by the

Landscape Architect or Owner's agent

B. No plant material shall be stored longer than seventy-two (72) hours unless approved by by Landscape Architect and/or owner.

C. The Landscape Architect reserves the right to reject any plant materials not in conformance with these specifications.

D. All rejected material shall be immediately removed from the site and replaced with acceptable material at no cost to the Owner.

2.05 PROTECTION DURING PLANTING:

A. Trees moved by winch or crane shall be thoroughly protected from chain marks, girdling or bark slippage by means of burlap, wood battens or other approved methods. Battens shall NOT be attached to the tree with nails.

2.06 PLANTING SOIL:

A. Planting soil for all plantings shall consist of existing native soil and shall be free of debris, roots. clay, stones, plants or other foreign materials which might be a hindrance to planting operations or

be detrimental to good growth.

2.07 FERTILIZER: A. Commercial fertilizer shall comply with the state fertilizer laws. Nitrogen shall not be less than 40% from organic source. Inorganic chemical nitrogen shall not be derived from the sodium form of nitrate. Fertilizers shall be delivered to the site in unopened original containers, each bearing the manufacturer's guaranteed analysis. Any fertilizer that becomes caked or otherwise damaged shall be rejected.

to each cubic yard of planting soil.

B. Thoroughly mixed 3 lbs. of commercial fertilizer

C. Tabletized fertilizer shall be Agriform planting tablets 20-10-5 formula, 21 gram or equal. All trees and shrubs shall be fertilized with tabletized fertilizer as follows. While backfilling plant holes, fertilizer tablets shall be equally spaced and placed adjacent to the ball mid-way in depth in accordance with the following rates:

> 1 gallon container 1 tablet 3 gallon container 2 tablets 5 gallon container 3 tablets 7 gallon 5 tablets

Large tubs, wire baskets, grow bags, and balled and burlapped material shall have 1 tablet for each 1/2 inch of trunk diameter (measured 3 feet from ground) or for each foot of height or spread of larger shrub material

The Landscape Architect reserves the right to inspect and review the application of fertilizer.

2.08 MULCH:

A. Mulch material shall be clean, dry, free of weeds, seeds and pests, moistened at the time of application to prevent wind displacement. Cypress &/or Red mulch is prohibited.

B. All trees and shrub beds shall receive 3" mulch immediately after planting and Apply 2" max on tree & palm rootballs, keep away from tree & palm trunks thoroughly watered. or as required by local jusidiction.

PART 3: EXECUTION 3 01 DIGGING:

A. The Landscape Contractor shall exercise care in digging and other work so as not to damage existing work, including overhead wires, underground pipes and cables and the pipes and hydrants of watering systems. Should such overhead or underground obstructions be encountered which interfere with planting, the Owner shall be consulted and contractor will adjust the location of plants to clear such obstruction. The Contractor shall be responsible for the immediate repair of any damage caused by his work.

3.02 GRADING: A. Grading for drainage, swales, etc. to within 4 inches of the finished grade to be

B. It shall be the responsibility of the Landscape Contractor to provide the final grading during the course of landscape installation so as to bring sod and planting areas to their proper elevations in relation to walks, paving, drain structures, and other site conditions. The site grading plan must be checked prior to installation of sod to insure that drainage and other conditions will NOT be modified.

provided by others.

A. Planting shall take place during favorable weather conditions.

B. The Contractor shall call for utility locates and ascertain the location of all utilities and easements so proper precautions can be taken not to damage or encroach on them.

C. Tree Planting shall be located where it is shown on the plan. No planting holes shall be dug until the proposed locations have been staked on the ground by the Contractor.

D. Excavation of holes shall extend to the required subgrades as specified on the planting diagrams located in the planting plans. Plant pits shall be circular in outline and shall have a profile which conforms to the aforementioned "Tree and Shrub Planting Diagrams".

E. A representative number of planting pits (a minimum of one in every 25 feet throughout the entire site) shall be tested for proper drainage. See Landscape Plan for complete testing methods

F. Planting pits shall be excavated to the following dimensions and refilled with a mixture of (1/2) planting soil (1/2) existing native soil]; 1 Gallon material (1 gal.): 12" x 12" x 12" min.

3 Gallon material (3 gal.): 20" x 20" x 18" min. Lerio material (7 gal.): 30" x 30" x 24" min.

Field grown material and trees: 1-1/2 times width of ball and depth of ball plus 12" min. G. No planting or laying of sod shall be initiated until the area has been cleaned of existing sod or other plant materials, rough grass, weeds, debris, stones etc. and the ground has been brought to an even grade, with positive drainage away from buildings and towards drain inlets and swales

and approved by Landscape Architect or owner's rep. H. Each plant shall be planted in an individual hole as specified for trees, shrubs, and vines. I. All plants shall be set to ultimate finished grade. No filling will be permitted around trunks or

stems. All ropes, wire, stakes, etc., shall be removed from sides and top of the ball and removed

J. All flagging ribbon shall be removed from trees and shrubs before planting.

K. Excess excavation (fill) from all holes shall be removed from the site, at no additional expense to

L. All palms shall be backfilled with sand, thoroughly washed in during planting operations and with a shallow saucer depression left at the soil line for future waterings. Saucer areas shall be topdressed two (2") inches deep with topsoil raked and left in a neat, clean manner.

3.04 PRUNING:

from hole before filling in.

D. Remove all trimmings from site.

A. Remove dead and broken branches from all plant material. Prune to retain typical growth habit of individual plants with as much height and spread as possible in a manner which will preserve the plant's natural character

B. Make all cuts with sharp instruments flush with trunk or adjacent branch, in such a manner as to insure elimination of stubs. Cuts made at right angles to line of growth will not be permitted. C. Trees shall not be poled or topped.

> TOP OF ROOT BARRIER 1" ABOVE FINISHED GRADE 21 FINISHED GRADE BELOW ADJACENT PAVEMENT 24" MIN DEPTH TOPSOIL ROOT BARRIER. (SEE SPEC.) TAMP SOIL ADJACENT TO ROOT BARRIERS TO STABILIZE SO THAT IRRIGATION FLOWS DIRECTLY THROUGH THE ROOT BALL. EXISTING SOIL - 29" MIN DEPTH. ROOT BARRIER

SPECIAL APPLICATIONS ROOT BARRIER DETAIL <u>NOTES.</u> 1- ROOT BARRIER SHALL BE DEEPROOT UB24-2 24" DEPTH OR APPROVED EQUAL. 2- ROOT BARRIER SHALL BE INSTALLED PER MANUFACTURER'S SPECIFICATIONS AND RECOMMENDATIONS 3.05 GUYING:

A. All trees over six (6') feet in height shall, immediately after setting to proper grade, be guyed with three sets of two strands. No. 12 gauge malleable galvanized iron, in tripod fashion. See Detail

B. Wires shall not come in direct contact with the tree but shall be covered with an approved protection device at all contact points. Wires shall be fastened in such a manner as to avoid pulling crotches apart.

D. Stake & Brace all treess larger than 12' oa. See detail. Stakes shall be 2" x 2" lumber of sufficient length to satisfactorily support each tree.

E. Turnbuckles for guying trees shall be galvanized or cadmium plated and shall be of adequate size and strength to properly maintain tight guy wires.

A. Each plant or tree shall be thoroughly watered in after planting. Watering of all newly installed plant materials shall be the responsibility of the Landscape Contractor until final acceptance by the

B. See General Notes of Landscape Plan for water source

3.07 SOD:

A. The Landscape Contractor shall sod all areas indicated on the drawings.

B. It shall be the responsibility of the Landscape Contractor to fine grade all landscape areas, eliminating all bumps, depressions, sticks, stones, and other debris.

C. The sod shall be firm, tough texture, having a compacted growth of grass with good root development. It shall contain no noxious weeds, or any other objectionable vegetation fungus, insects, or disease. The soil embedded in the sod shall be good clean earth, free from stones and debris.

Before being cut and lifted, the sod shall have been mowed at least three times with a lawn mower, with the final mowing not more than seven days before the sod is cut. The sod shall be carefully cut into uniform dimensions.

E. 6-6-6 fertilizer with all trace elements is to be applied at the rate of 40 lbs. per 1,000 sq. ft. prior

F. Solid sod shall be laid with closely abutting, staggered joints with a tamped or rolled, even surface. G. The finished level of all sod areas after settlement shall be one (1") inch below the top of abutting walks, paving and wood borders to allow for building turf.

H. If in the opinion of the Landscape Architect, top dressing is necessary after rolling, clean yellow sand will be evenly applied over the entire surface and thoroughly washed in.

The Landscape Contractor shall remove all vegetation and rocks larger than (1") in diameter from areas to be seeded, scarify the area, then apply fertilizer at a rate of 500 lbs. per acre.

Application: Argentine Bahia Grass seed - 200 Pounds per acre mixed with common hulled Bermuda seed - 30 lbs. per acre. All other seed mixtures shall be applied per the manufacturer's instructions

C. Roll immediately after seeding with a minimum 500 pound roller, then apply straw mulch at the rate of 2,500 pounds per acre. D. Apply fertilizer at the rate of 150 lbs. per acre 45-60 days after seeding.

3.09 CLEANING UP:

A. The contractor shall at all times keep the premises free from accumulations of waste materials or rubbish caused by his employees or work. He shall leave all paved areas "broom clean" when completed with his work

3.10 MAINTENANCE:

Maintenance shall begin immediately after each plant is installed and shall continue until all planting has been accepted by the Owner or Landscape Architect. Maintenance shall include watering, weeding, removal of dead materials, resetting plants to proper grades or upright positions, spraying, restoration of planting saucer and/or any other necessary

B. Proper protection to lawn areas shall be provided and any damage resulting from planting operations shall be repaired promptly

Replacement of plants during the maintenance period shall be the responsibility of the Contractor, excluding vandalism or damage on the part of others, lighting, or hurricane force winds, until final

D. In the event that weeds or other undesirable vegetation become prevalent, it shall be the Contractor's responsibility to remove them.

E. Trees or other plant material which fall or are blown over during the maintenance period will be reset by the Contractor at no additional expense to the Owner, the only exception being hurricane force winds.

A. Completion of the work shall mean the full and exact compliance and conformity with the provisions expressed or implied in the Drawings and in the Specifications, including the complete removal of all trash, debris, soil or other waste created by the Landscape Contractor. B. Inspection of work to determine completion of contract, exclusive of the possible

replacement of plants, will be made by the Owner and/or Landscape Architect at the conclusion of

all planting and at the request of the Landscape Contractor. C. All plant material shall be alive and in good growing condition for each specified kind of plant at the time of acceptance. The rating of each plant according to Florida Grades and Standards shall be equal to or better than that called for on the plans and in these Specifications at the time of final

D. After inspection, the Landscape Contractor will be notified by the Owner of the acceptance of all plant material and workmanship, exclusive of the possible replacement of plants subject to

DRAINAGE TESTING/DRAINAGE CHANNEL REQUIREMENTS

3.11 COMPLETION, INSPECTION AND ACCEPTANCE:

inspection and acceptance.

PRIOR TO PLANTING ALL PLANTING PITS SELECTED FOR TESTING SHALL BE TESTED IN THE FOLLOWING MANNER

A. DIG EACH PLANTING PIT TO THE MINIMUM SPECIFIED SIZE.

PLANTING PIT AND DRAINAGE CHANNEL.

(5) 2x4x16" WOOD BATTENS

BATTENS IN PLACE DURING

SECURE BATTENS W/ (2) 3/4" HIGH

PLANTING PROJECT. DO NOT NAIL

BATTENS TO TRUNK, HEIGHT OF

RELATION TO THE HEIGHT OF THE

BATTENS SHALL BE LOCATED IN

TREE FOR ADEQUATE BRACING.

STEEL BANDS

BRACING DETAIL

CARBON STEEL BANDS TO HOLD

B. FILL PLANTING PIT WITH TWELVE INCHES (12") OF WATER. IF THE WATER LEVEL DROPS FOUR (4") OR MORE WITHIN FOUR (4) HOURS, THE DRAINAGE IS SUFFICIENT AND A DRAINAGE CHANNEL IS NOT REQUIRED IF THE WATER LEVEL DROPS LESS THAN FOUR INCHES (4") WITHIN THE FOUR (4) HOUR PERIOD, A DRAINAGE CHANNEL IS REQUIRED.

C. WHERE REQUIRED, THE DRAINAGE CHANNEL MUST EXTEND DOWN THROUGH THE NON POROUS SOIL AND INTO POROUS SOIL. (SEE DETAIL)

TAKEN TO KEEP THE CONSISTENCY OF THE SOIL MIX THE SAME THROUGHOUT THE

- (5) LAYERS OF BURLAP

D. ALL MATERIAL REMOVED FROM THE DRAINAGE CHANNEL SHALL BE DISCARDED.

E. WHEN BACKFILLING PLANTING PITS WITH PLANTING MIXTURE, CARE MUST BE


TOPSOIL ROOTBALL 6" DIA. DRAINAGE DETAI DRAINAGE TESTING DETAIL


SECTION


BARRICADE CIRCLE TO BE CENTERED ON TREE TRUNK(S). FOR GROUPS OF TREES, PLACE BARRICADES BETWEEN TREES AND CONSTRUCTION ACTIVITY.


TREE PROTECTION BARRICADES SHALL BE LOCATED TO PROTECT EXISTING, RELOCATED AND NEW TREES II CONSTRUCTION AREAS. THE PROTECTIVE BARRIES SHALL BE PLACED AROUND THE TREE ALT A DISTANCE CHEET FROM THE TREE TRUNK OF AT THE CAMOPY DIND LINE, WHICHEVER IS GREATER OR AS SHOWN ON

TREE PROTECTION DETAIL

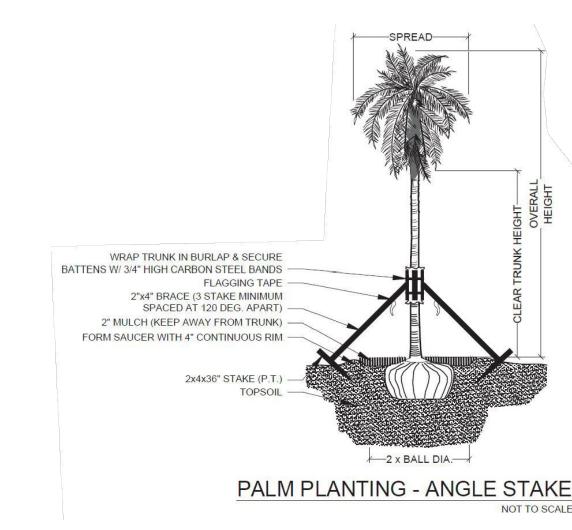


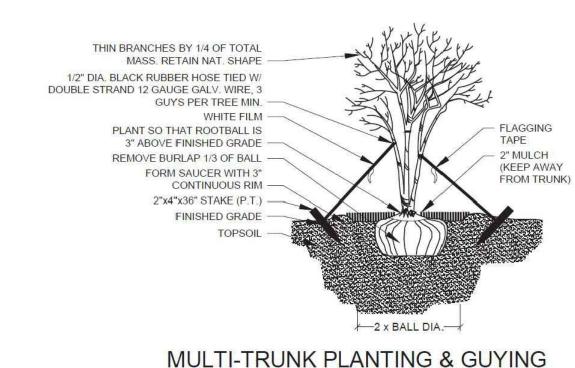

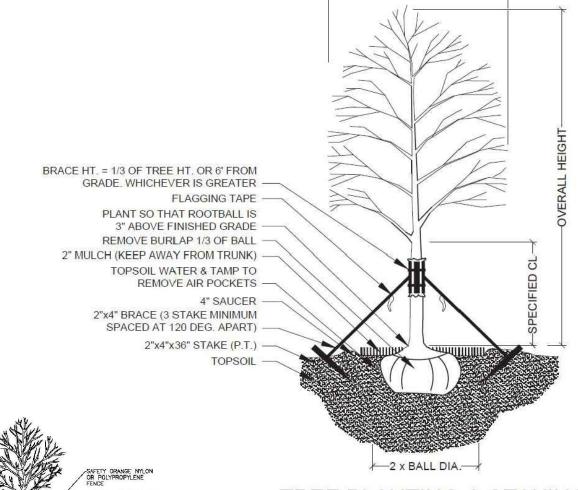

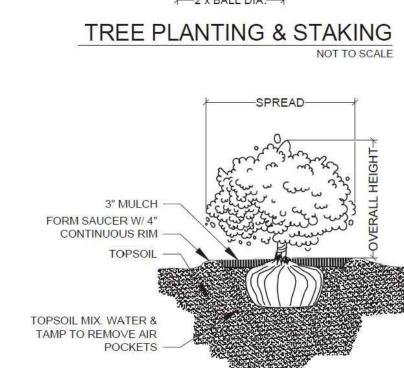



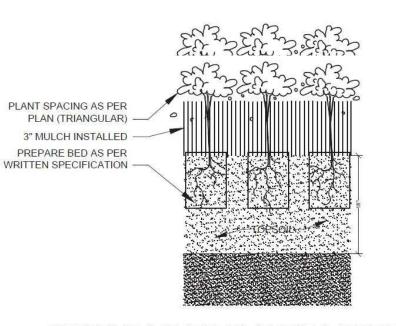

GROUNDCOVER PLANTING DETAIL


Landscape Architect: LANDSCAPE ARCHITECTURAL SERVICES, LLC 1708 SE Joy Haven Street Port St. Lucie, Fl. 34983 772) 834-1357 | brandon@las-fl.co Architect:

LLR Architects, Inc. ARCHITECTURE & PLANNING 12980 S.W. 52 STREET **MIRAMAR, FLORIDA 33027** (OFF.) - 305-403-7926 (CELL)- 786-543-0851 E-MAIL: LLAROSA@LAROSAARCHITECTCTS.COM

C cation cifi

Q ∞ et 2 0 B Q 2 pu

Revisions Description Initial 01.04.24 BW Submittal

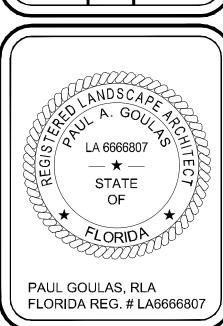

DC Drawn By: PG Checked By: Municipal Project Scale: NORTH SCALE: 1" = N.T.S.