	ABBREVIATION LEGEND	LINE TYPE LEGEND	PROPOSED SYMBOL LEGEND	EXISTING SYMBOL LEGEND
ARV	AIR RELEASE VALVE	LOT LINE	AIR RELEASE VALVE	EXISTING SPOT ELEVATION (FT)
BE	BURIED ELECTRIC	SECTION LINE	●B.S.P. No. BACTERIOLOGICAL SAMPLE POINT	GUY ANCHOR
BFP BFV	BACKFLOW PREVENTER BUTTERFLY VALVE		WATER METER	(FPL) FPL MANHOLE
ВМ	BENCHMARK	CENTERLINE	FIRE HYDRANT	<>-CLP CONC. LIGHT POLE
ВОР	BOTTOM OF PIPE		FIRE DEPARTMENT CONNECTION	<>- CONC. UTILITY POLE
BSP	BACTERIOLOGICAL SAMPLING POINT	——————————————————————————————————————	→ SINGLE WATER SERVICE	<>CSP CONC. SIGNAL POLE
CAP	CORRUGATED ALUMINUM PIPE	GUARDRAIL —O—O—O—PROPOSED CHAIN LINK FENCE	DOUBLE WATER SERVICE	COMMUNICATION MH
CB CI	CATCH BASIN CURB INLET	EXISTING WOOD FENCE	BACKFLOW PREVENTER	COMMUNICATION RISER
CIP	CAST IRON PIPE	EXISTING PICKET FENCE		CABLE TV MANHOLE
CLF	CHAIN LINK FENCE	EXISTING SANITARY SEWER (8")	DOUBLE DETECTOR CHECK VALVE	
CMP	CORRUGATED METAL PIPE		■ BLOWOFF	© CABLE TV RISER Z EHH ELEC. HANDHOLE
CMU	CONCRETE MASONRY UNIT	×6FM EXISTING FORCE MAIN (6")	REDUCER	
CO CONC	CLEANOUT CONCRETE	——————————————————————————————————————	GATE VALVE	FPL TRANSFORMER
DE	DRAINAGE EASEMENT		90°, 45°, 22.5° & 11.25° BENDS	ELECTRICAL METER
DIP	DUCTILE IRON PIPE	— xIRR — xIRR — EXISTING IRRIGATION — xmedgas — xmedgas — EXISTING MEDICAL GAS	├ └ ┤ TEE ┬	GAS METER
E	EAST	xoxy EXISTING OXYGEN	CROSS	LIGHT POLE
EL	ELEVATION EDGE OF WATER	xfpl EXISTING UNDERGROUND POWER	[PLUG	TRAFFIC CONTROL BOX
EOW EXIST	EDGE OF WATER EXISTING		● [BLOWOFF	-O-WPP WOOD POWER POLE
EXFILT	EXFILTRATION	xCD EXISTING CONDENSATION		GAS VALVE
FF EL	FINISHED FLOOR ELEVATION		SEWER MANHOLE	SEWER VALVE
FH	FIRE HYDRANT	xch EXISTING CHILLER	SANITARY FLOW DIRECTION	WV WATER VALVE
FM	FORCE MAIN	EXISTING AT&T UNDERGROUND	SINGLE SANITARY LATERAL	GATE VALVE
GALV GV	GALVANIZED GATE VALVE		DOUBLE SANITARY LATERAL	© CLEANOUT
HORZ	HORIZONTAL			FIRE HYDRANT
H.P.	HIGH POINT	xukn EXISTING UNKNOWN UTILITY	CONFLICT ID	REDUCER
INV	INVERT		SUE POTHOLE ID	
JB	JUNCTION BOX	— /// ×UGE — /// DEMOLISH UNDERGROUND ELECTRIC — /// ×WM — /// DEMOLISH WATER	DRAINAGE FLOW	IRRIGATION VALVE
LF MAX	LINEAR FEET MAXIMUM	EXISTING UTILITY TO BE GROUTED AND ABANDONED IN PLACE	O.OO SPOT GRADE	S SEWER MANHOLE
M.E.G.	MATCH EXISTING GRADE	**************************************	SIGN	STORM MANHOLE
МН	MANHOLE	->>>>>>>>>>>>>>>>>>>>>>>>>>>>>>>>>>>>>	CATCH BASIN	FIRE DEPARTMENT
MIN	MINIMUM		STORM MANHOLE	CATCH BASIN
MJ	MECHANICAL JOINT		© CLEANOUT	CURB INLET
n Navd	NORTH NORTH AMERICAN VERTICAL DATUM		SLOTTED DRAIN	GROUND/LANDSCAPING LIGHTING
NIC	NOT INCLUDED		STORM YARD DRAIN	ʊ SIGN
NTS	NOT TO SCALE		P5 STORM INLET	SIGN TO BE REMOVED
NGVD	NATIONAL GEODETIC VERTICAL DATUM		P6 STORM INLET	WATER METER
OE DCAD	OVERHEAD ELECTRIC	HATCHING LEGEND	EXFILTRATION TRENCH	EXFILTRATION TRENCH
PCAP PRB	PERFORATED CORRUGATED ALUMINUM PIPE POLLUTION RETARDANT BAFFLE	EXISTING DECOMMISSIONED BURIED MASTER LIFT STATION TO BE REMOVED	HEADWALL	TREE TO BE REMOVED
PROP	PROPOSED	EVICTING BUILDING TO DEMAIN		TREE TO BE REMOVED
PSI	POUNDS PER SQUARE INCH			
PV	PLUG VALVE	EXISTING BUILDING TO BE DEMOLISHED EXISTING PEDESTRIAN BRIDGE CANOPY WITH SIDEWALK TO BE REMOVED	MITERED END — HDPE	
PVC	POLYVINYL CHLORIDE	WITH SIDEWALK TO BE REMOVED EXISTING ASPHALT PAVEMENT TO BE REMOVED	HAY BALES	
R RCP	RADIUS REINFORCED CONCRETE PIPE		ROCK BAGS W/ HAY BALES	
RCW	RECLAIMED WATER	EXISTING ASPHALT PAVEMENT TO BE REMOVED 30" MIN. DEPTH BELOW SURFACE		
RED	REDUCER	EXISTING CONCRETE TO BE REMOVED		
R/W	RIGHT-OF-WAY	EXISTING PAVERS TO BE REMOVED		
S	SOUTH	EXISTING STRIPING/MARKINGS TO BE REMOVED		
SAN	SANITARY SOIL BORING	EXISTING LANDSCAPING TO BE REMOVED		
SB STA	SOIL BORING STATION	PROPOSED BUILDING		
TOB	TOP OF BANK	DETECTABLE WARNING SURFACES		
TOP	TOP OF PIPE	PROPOSED MILLING AND RESURFACING		
TYP	TYPICAL	PROPOSED FULL DEPTH RECONSTRUCTION		
UE VEDT	UTILITY EASEMENT	PROPOSED CONCRETE SIDEWALK		
VERT W	VERTICAL WEST			
WM	WATER MAIN			
				1

PERMITTING AGENCIES	DATE SUBMITTED	CGA INITIALS	DATE APPROVED	PERMIT NUMBER
CITY OF HOLLYWOOD PUBLIC WORKS AND ENGINEERING	_	-	_	_
CITY OF HOLLYWOOD BUILDING DEPARTMENT	-	_	_	_
BROWARD COUNTY ENVIRONMENTAL SERVICES — SWM PERMIT	06/05/24	SRS	_	L-2024-151
BROWARD COUNTY ENVIRONMENTAL PROTECTION AND GROWTH MANAGEMENT DEPARTMENT - WASTEWATER MAIN EXTENSION PERMIT	_	_	_	_
FDEP CONSTRUCTION GENERIC PERMIT (BY CONTRACTOR)	_	_	_	_
SOUTH FLORIDA WATER MANAGEMENT DISTRICT DEWATERING PERMIT (BY CONTRACTOR)	_	_	_	_

- 1. CONTRACTOR SHALL BE RESPONSIBLE FOR PROCURING, INSTALLING, AND MAINTAINING ALL UTILITY BYPASS SYSTEMS FOR THE DURATION OF THE TEMPORARY SERVICES AND CONSTRUCTION ACTIVITIES. BYPASS SYSTEMS SHALL BE APPROVED BY OWNER AND HAVE ONE PRIMARY ELECTRIC PUMP AND ONE BACKUP DIESEL PUMP. PUMPS SHALL BE "HOSPITAL GRADE" AND SHALL NOT EXCEED 55dB(A) AT THE RIGHT-OF-WAY BOUNDARY.
- 2. THE CONTRACTOR SHALL BE GOVERNED BY THE APPLICABLE PORTIONS OF THE FLORIDA DEPARTMENT AND SUPPLEMENTS THERETO IF NOTED IN THE SPECIAL PROVISIONS FOR THIS PROJECT.
- TO COORDINATE FIELD VISITS WITH UTILITY REPRESENTATIVE DURING CONSTRUCTION.
- 4. ANY DAMAGE BY THE CONTRACTOR TO PUBLIC OR PRIVATE PROPERTY SHALL BE RESTORED TO

- 7. PRE-CONSTRUCTION VIDEO OF EXISTING CONDITIONS SHALL BE TAKEN BY THE CONTRACTOR PRIOR TO START OF CONSTRUCTION AND SUBMITTED TO THE ENGINEER AND OWNER FOR REVIEW.
- 8. THE CONTRACTOR SHALL COORDINATE SELECTION AND REVIEW OF ANY PROPOSED STAGING AREA WITH THE OWNER AT LEAST 72 HOURS PRIOR TO USE. THE STAGING AREA SHALL BE RESTORED TO ITS ORIGINAL CONDITION OR BETTER AT NO ADDITIONAL COST TO THE OWNER.

- 553.851 FOR THE PROTECTION OF UNDERGROUND GAS PIPELINES. 14. MAINTENANCE OF TRAFFIC SHALL BE IN ACCORDANCE WITH CURRENT FDOT DESIGN STANDARDS AND
- PROPOSED CLOSURES OR DETOUR ROUTES SHALL REQUIRE CITY (PUBLIC RIGHT-OF-WAY) OR OWNER (HOSPITAL CAMPUS) APPROVAL.
- DEVELOPMENT EQUAL TO OR GREATER THAN EXISTING TO PREVENT WATER MAIN SEPARATION.
- ELEVATION, UNLESS OTHERWISE NOTED.
- 17. THE CONTRACTOR SHALL EMPLOY QUALIFIED ARBORIST TO REMOVE BRANCHES, AND TREAT ANY CUTS.
- 20. THE CONTRACTOR IS RESPONSIBLE FOR RESTORATION OF ALL EXISTING UTILITIES, IRRIGATION, CABLES,
- FROM OUTSIDE OF PIPE TO OUTSIDE OF PIPE OR STRUCTURE.
- ON NORTH AMERICAN VERTICAL DATUM OF 1988 (NAVD88).
- 24. CONTRACTOR TO FIELD ADJUST LOCATION OF THE PROPOSED WORK TO MEET THE MINIMUM SEPARATION REQUIREMENTS.

26. FOLLOWING CONSTRUCTION AND PRIOR TO SUBSTANTIAL COMPLETION, CONTRACTOR SHALL REMOVE

- 25. CONTRACTOR TO VERIFY LOCATIONS OF UTILITIES VIA SOFT DIG.
- SEDIMENT WITHIN EXISTING DRAINAGE SYSTEM PIPING AND STRUCTURES BY PRESSURIZED

OF TRANSPORTATION DESIGN STANDARDS, DATED 2023/2024, AND THE FLORIDA DEPARTMENT OF TRANSPORTATION STANDARD SPECIFICATIONS FOR ROAD AND BRIDGE CONSTRUCTION DATED 2023-24,

- 3. THE CONTRACTOR SHALL NOTIFY THE APPROPRIATE UTILITY COMPANY AND GOVERNMENT AGENCY A MINIMUM OF TWO BUSINESS DAYS IN ADVANCE OF ANY EXCAVATION INVOLVING ITS UTILITIES AND IS
- PRE-EXISTING CONDITIONS OR BETTER AT NO EXPENSE TO THE OWNER.
- 5. THE LOCATIONS OF ALL UTILITIES SHOWN IN THE PLANS ARE BASED ON LIMITED INVESTIGATION TECHNIQUES AND SHOULD BE CONSIDERED APPROXIMATE ONLY AND FIELD VERIFIED BY THE
- 6. THE CONTRACTOR SHALL VERIFY IF OTHER UTILITIES NOT SHOWN IN THE PLANS EXIST WITHIN THE AREA OF CONSTRUCTION. SHOULD UTILITY CONFLICTS ARISE, THE CONTRACTOR SHALL INFORM THE ENGINEER AND CORRESPONDING UTILITY COMPANY OF THE CONFLICT.

- 9. ALL CONSTRUCTION DEBRIS SHALL BE PROPERLY DISPOSED OF OFFSITE.
- 10. THE CONTRACTOR SHALL UTILIZE BEST MANAGEMENT PRACTICES, AS ESTABLISHED BY THE SOUTH FLORIDA WATER MANAGEMENT DISTRICT, FOR ALL WORK.
- 11. THE CONTRACTOR SHALL OBTAIN ALL PERMITS AND COMPLY WITH THE PERMIT REQUIREMENTS BEFORE AND DURING CONSTRUCTION.
- 12. ALL QUESTIONS CONCERNING MATERIALS OR CONSTRUCTION METHODS SHALL BE DIRECTED TO THE OWNER OR THE ENGINEER.
- 13. PRIOR TO THE START OF CONSTRUCTION, THE CONTRACTOR SHALL COMPLY WITH FLORIDA STATUTE
- THE MANUAL ON UNIFORM TRAFFIC CONTROL DEVICES AND SHALL BE THE RESPONSIBILITY OF THE CONTRACTOR. DRIVEWAYS AND TRAVEL LANES SHALL REMAIN OPEN AT ALL TIMES. ANY AND ALL
- 15. CONTRACTOR MUST PROVIDE LATERAL SUPPORT FOR ALL EXISTING WATER MAINS AND MAINTAIN SOIL
- 16. ALL EXISTING UTILITIES MANHOLE COVERS, ELECTRICAL BOXES, VALVE BOXES, METER BOXES, DRAINAGE STRUCTURES, ETC. WITHIN PROPOSED AREAS OF IMPROVEMENTS SHALL BE ADJUSTED TO GRADE
- 18. CONTRACTOR SHALL USE SPECIAL CARE WHEN WORKING NEAR EXISTING CLAY SANITARY SEWER LINE.
- 19. CONTRACTOR TO AVOID DAMAGING EXISTING SEWER LATERALS. IF DAMAGE OCCURS TO EXISTING SEWER LATERALS, CONTRACTOR SHALL REPLACE AT NO ADDITIONAL COST TO THE OWNER.
- ETC., DISTURBED DURING CONSTRUCTION OF PROPOSED IMPROVEMENTS.
- 21. EXISTING SURFACE GRADES SHOWN IN PROFILE VIEWS ARE AT THE ALIGNMENT CENTERLINE.
- 22. MINIMUM HORIZONTAL AND VERTICAL SEPARATIONS SHOWN ON THE PLANS ARE TO BE MEASURED
- 23. SURVEY DATA: ALL ELEVATIONS ON THE PLANS OR REFERENCED IN THE SPECIFICATIONS ARE BASED
- HYDRO-JETTING FOR COMPLETE REMOVAL OF DISPLACED SEDIMENT AND DEBRIS DURING

ARCHITECT

2020 SALZEDO STREET, 4TH FLOOR CORAL GABLES, FL 33134

HKS ARCHITECTS, INC.

INTERIOR DESIGNER

HKS ARCHITECTS 225 EAST ROBINSON ST. SUITE #405 ORLANDO, FL 32801

CIVIL & LANDSCAPE CALVIN, GIORDANO & ASSOCIATES

1800 ELLER DRIVE, SUITE 600 FORT LAUDERDALE, FL 33316

STRUCTURAL ENGINEER GMG STRUCTURAL ENGINEERS 14335 COMMERCE WAY

MIAMI LAKES, FL 33016 MEP & FIRE PROTECTION

TLC ENGINEERING SOLUTIONS, INC. 800 FAIRWAY DRIVE DEERFIELD BEACH, FL 33441

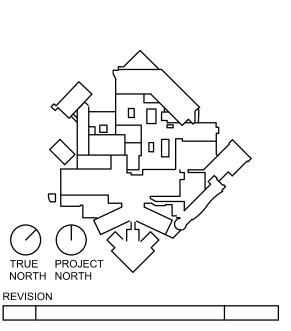
TELECOM & EQUIPMENT SMITH SECKMAN REID, INC. 2995 SIDCO DRIVE

NASHVILLE, TN 37204 OWNER MEMORIAL HEALTHCARE SYSTEM

3501 JOHNSON STREET HOLLYWOOD, FL 33021



INTERIM REVIEW ONLY These documents are incomplete, and are released for interim review only and are not intended for regulatory approval, permit, or construction purposes. Engineer: James D. Messick P.E. License No.: 70870



JAMES D. MESSICK, STATE OF FLORIDA, PROFESSIONAL ENGINEER, LICENSE NO. 70870. THIS ITEM HAS BEEN DIGITALLY SIGNED AND SEALED BY JAMES D. MESSICK ON THE DATE INDICATED HERE. PRINTED COPIES OF THIS DOCUMENT ARE NOT CONSIDERED SIGNED AND SEALED AND THE SIGNATURE MUST BE VERIFIED ON ANY ELECTRONIC COPIES.

HKS PROJECT NUMBER 23459.000 **AUGUST 19, 2024**

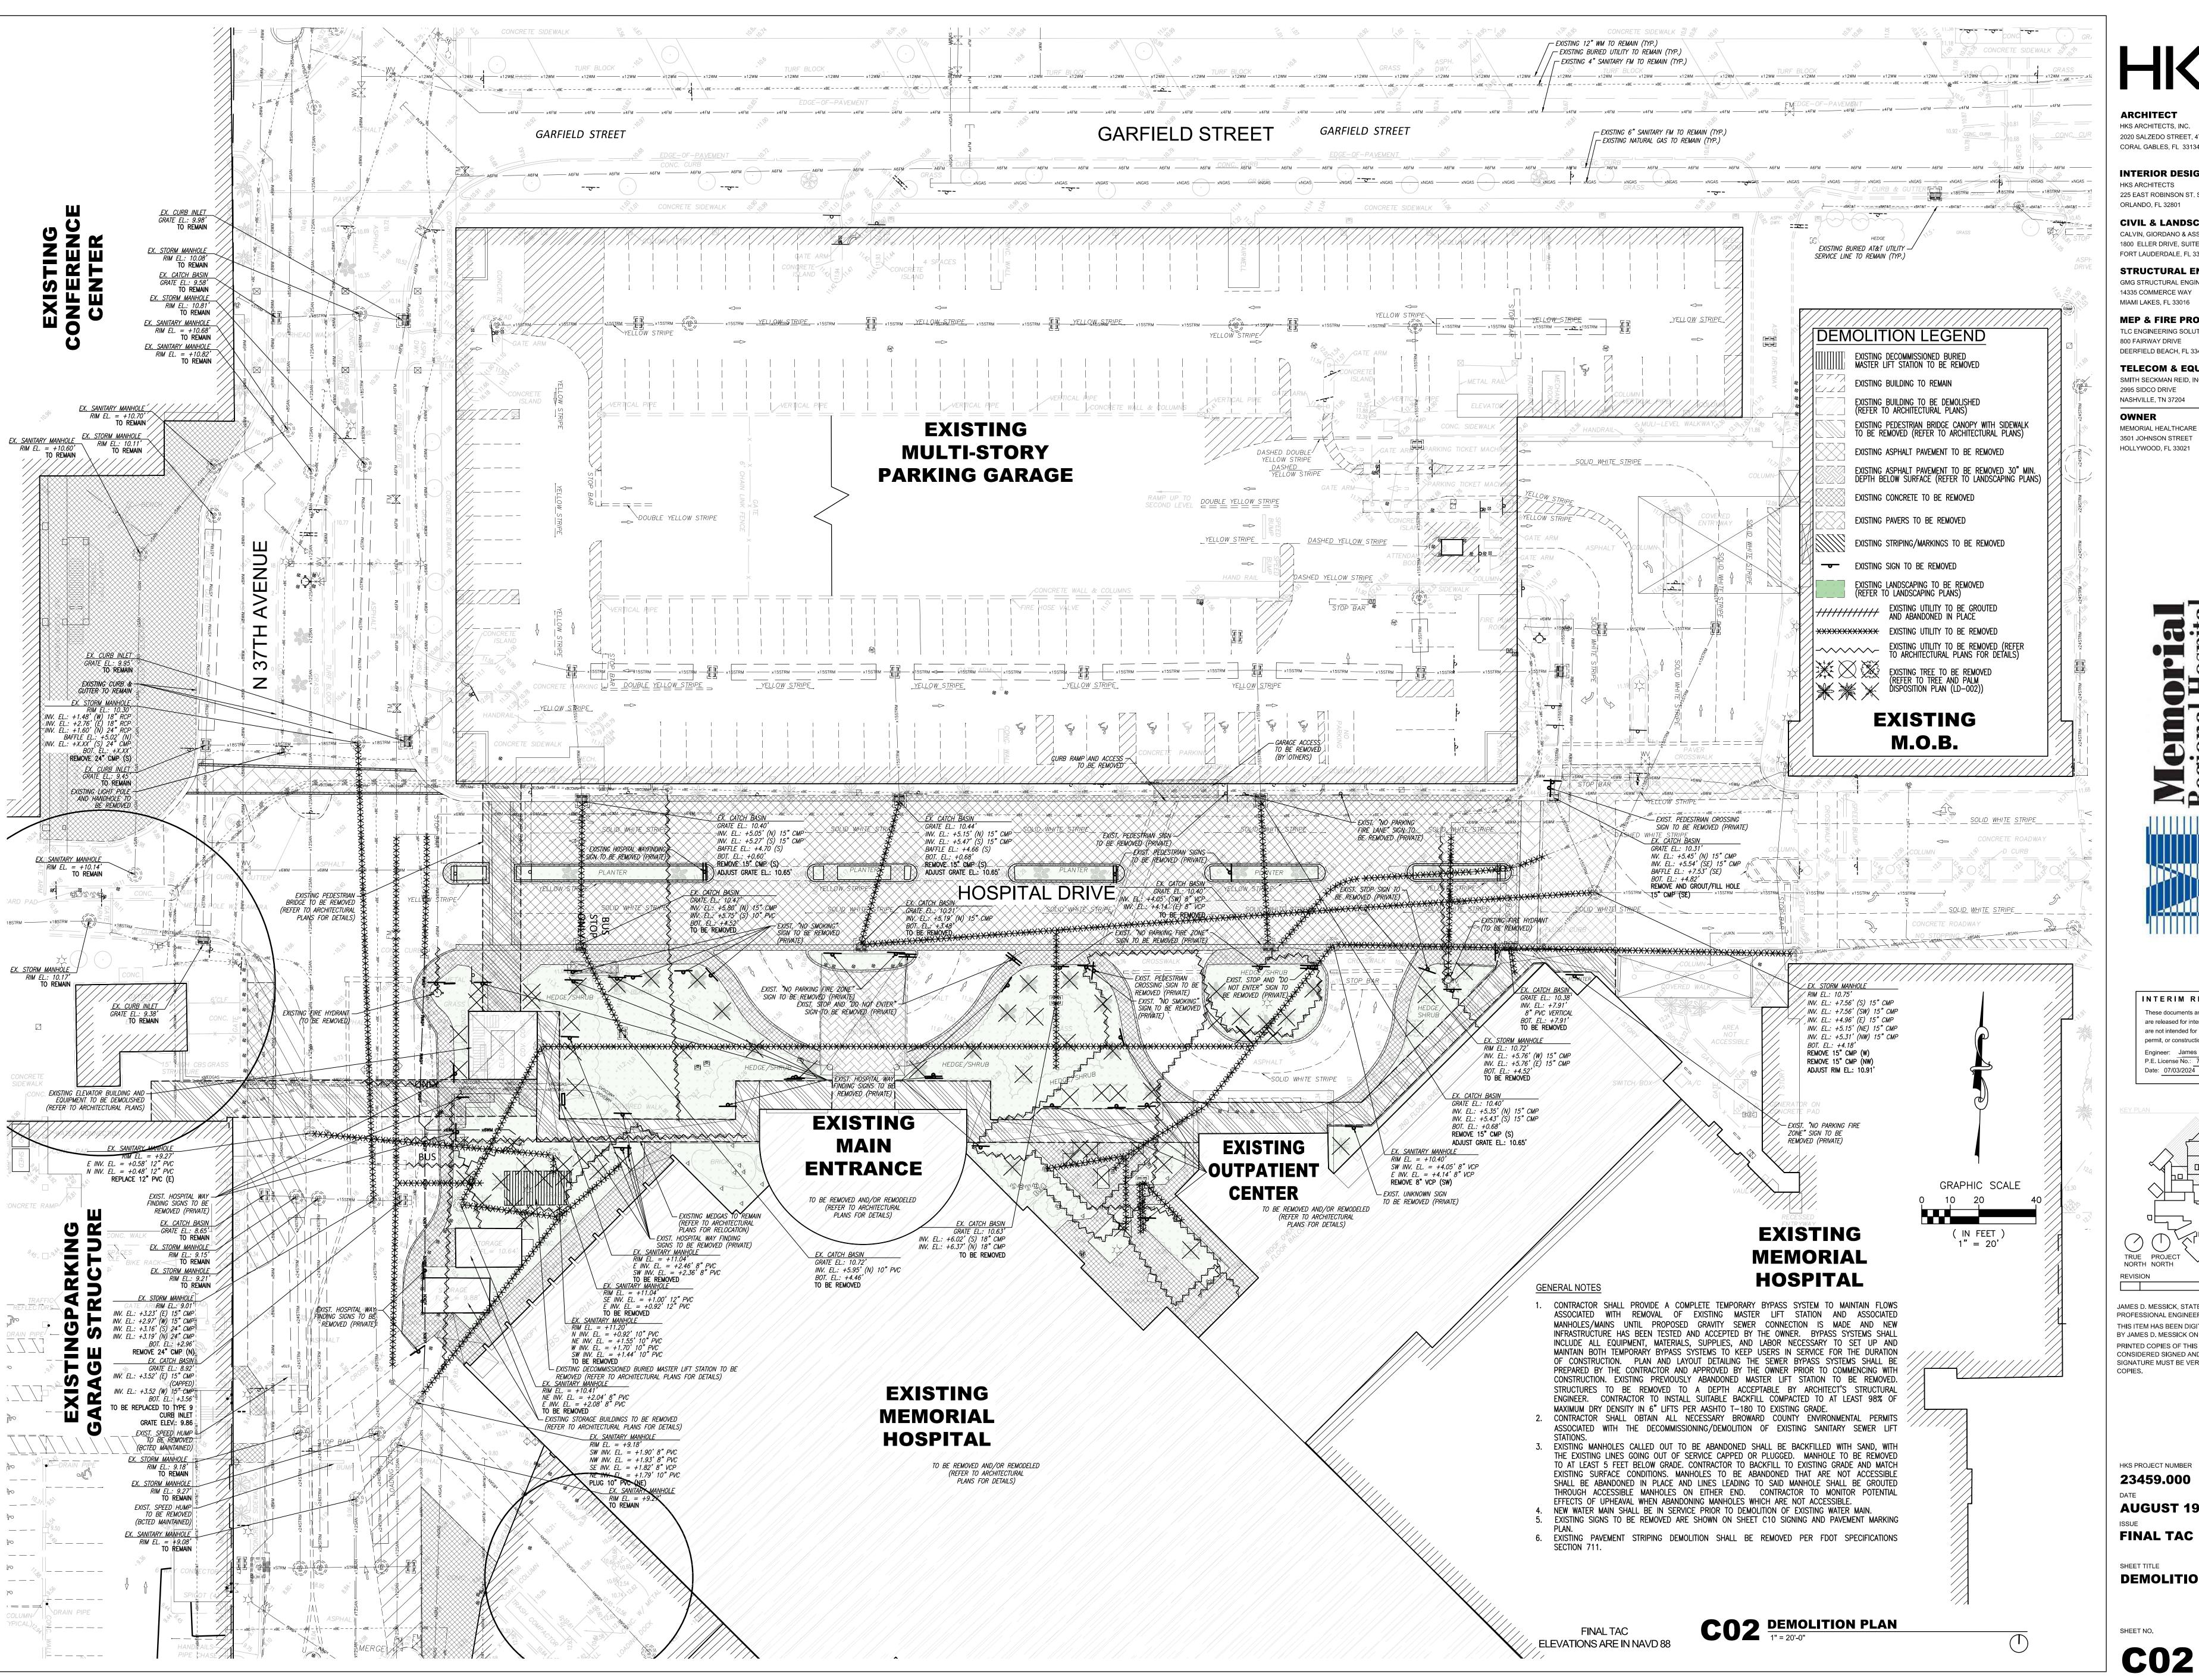
FINAL TAC

LEGENDS, ABBREVIATIONS AND GENERAL NOTES

SHEET NO. **C01**

CO1 LEGENDS, ABBREVIATIONS AND GENERAL NOTES
NOT TO SCALE

FINAL TAC ELEVATIONS ARE IN NAVD 88



ARCHITECT HKS ARCHITECTS, INC. 2020 SALZEDO STREET, 4TH FLOOR

CORAL GABLES, FL 33134

INTERIOR DESIGNER HKS ARCHITECTS 225 EAST ROBINSON ST. SUITE #405

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1800 ELLER DRIVE, SUITE 600 FORT LAUDERDALE, FL 33316

STRUCTURAL ENGINEER GMG STRUCTURAL ENGINEERS 14335 COMMERCE WAY

MIAMI LAKES, FL 33016

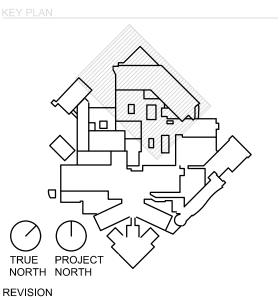
MEP & FIRE PROTECTION TLC ENGINEERING SOLUTIONS, INC. 800 FAIRWAY DRIVE

DEERFIELD BEACH, FL 33441 **TELECOM & EQUIPMENT**

SMITH SECKMAN REID, INC. 2995 SIDCO DRIVE NASHVILLE, TN 37204

OWNER MEMORIAL HEALTHCARE SYSTEM 3501 JOHNSON STREET HOLLYWOOD, FL 33021

INTERIM REVIEW ONLY are not intended for regulatory approval, permit, or construction purposes. Engineer: James D. Messick P.E. License No.: 70870 Date: 07/03/2024




JAMES D. MESSICK, STATE OF FLORIDA, BY JAMES D. MESSICK ON THE DATE INDICATED HERE CONSIDERED SIGNED AND SEALED AND THE SIGNATURE MUST BE VERIFIED ON ANY ELECTRONIC

HKS PROJECT NUMBER 23459.000 **AUGUST 19, 2024**

DEMOLITION PLAN

SHEET NO.

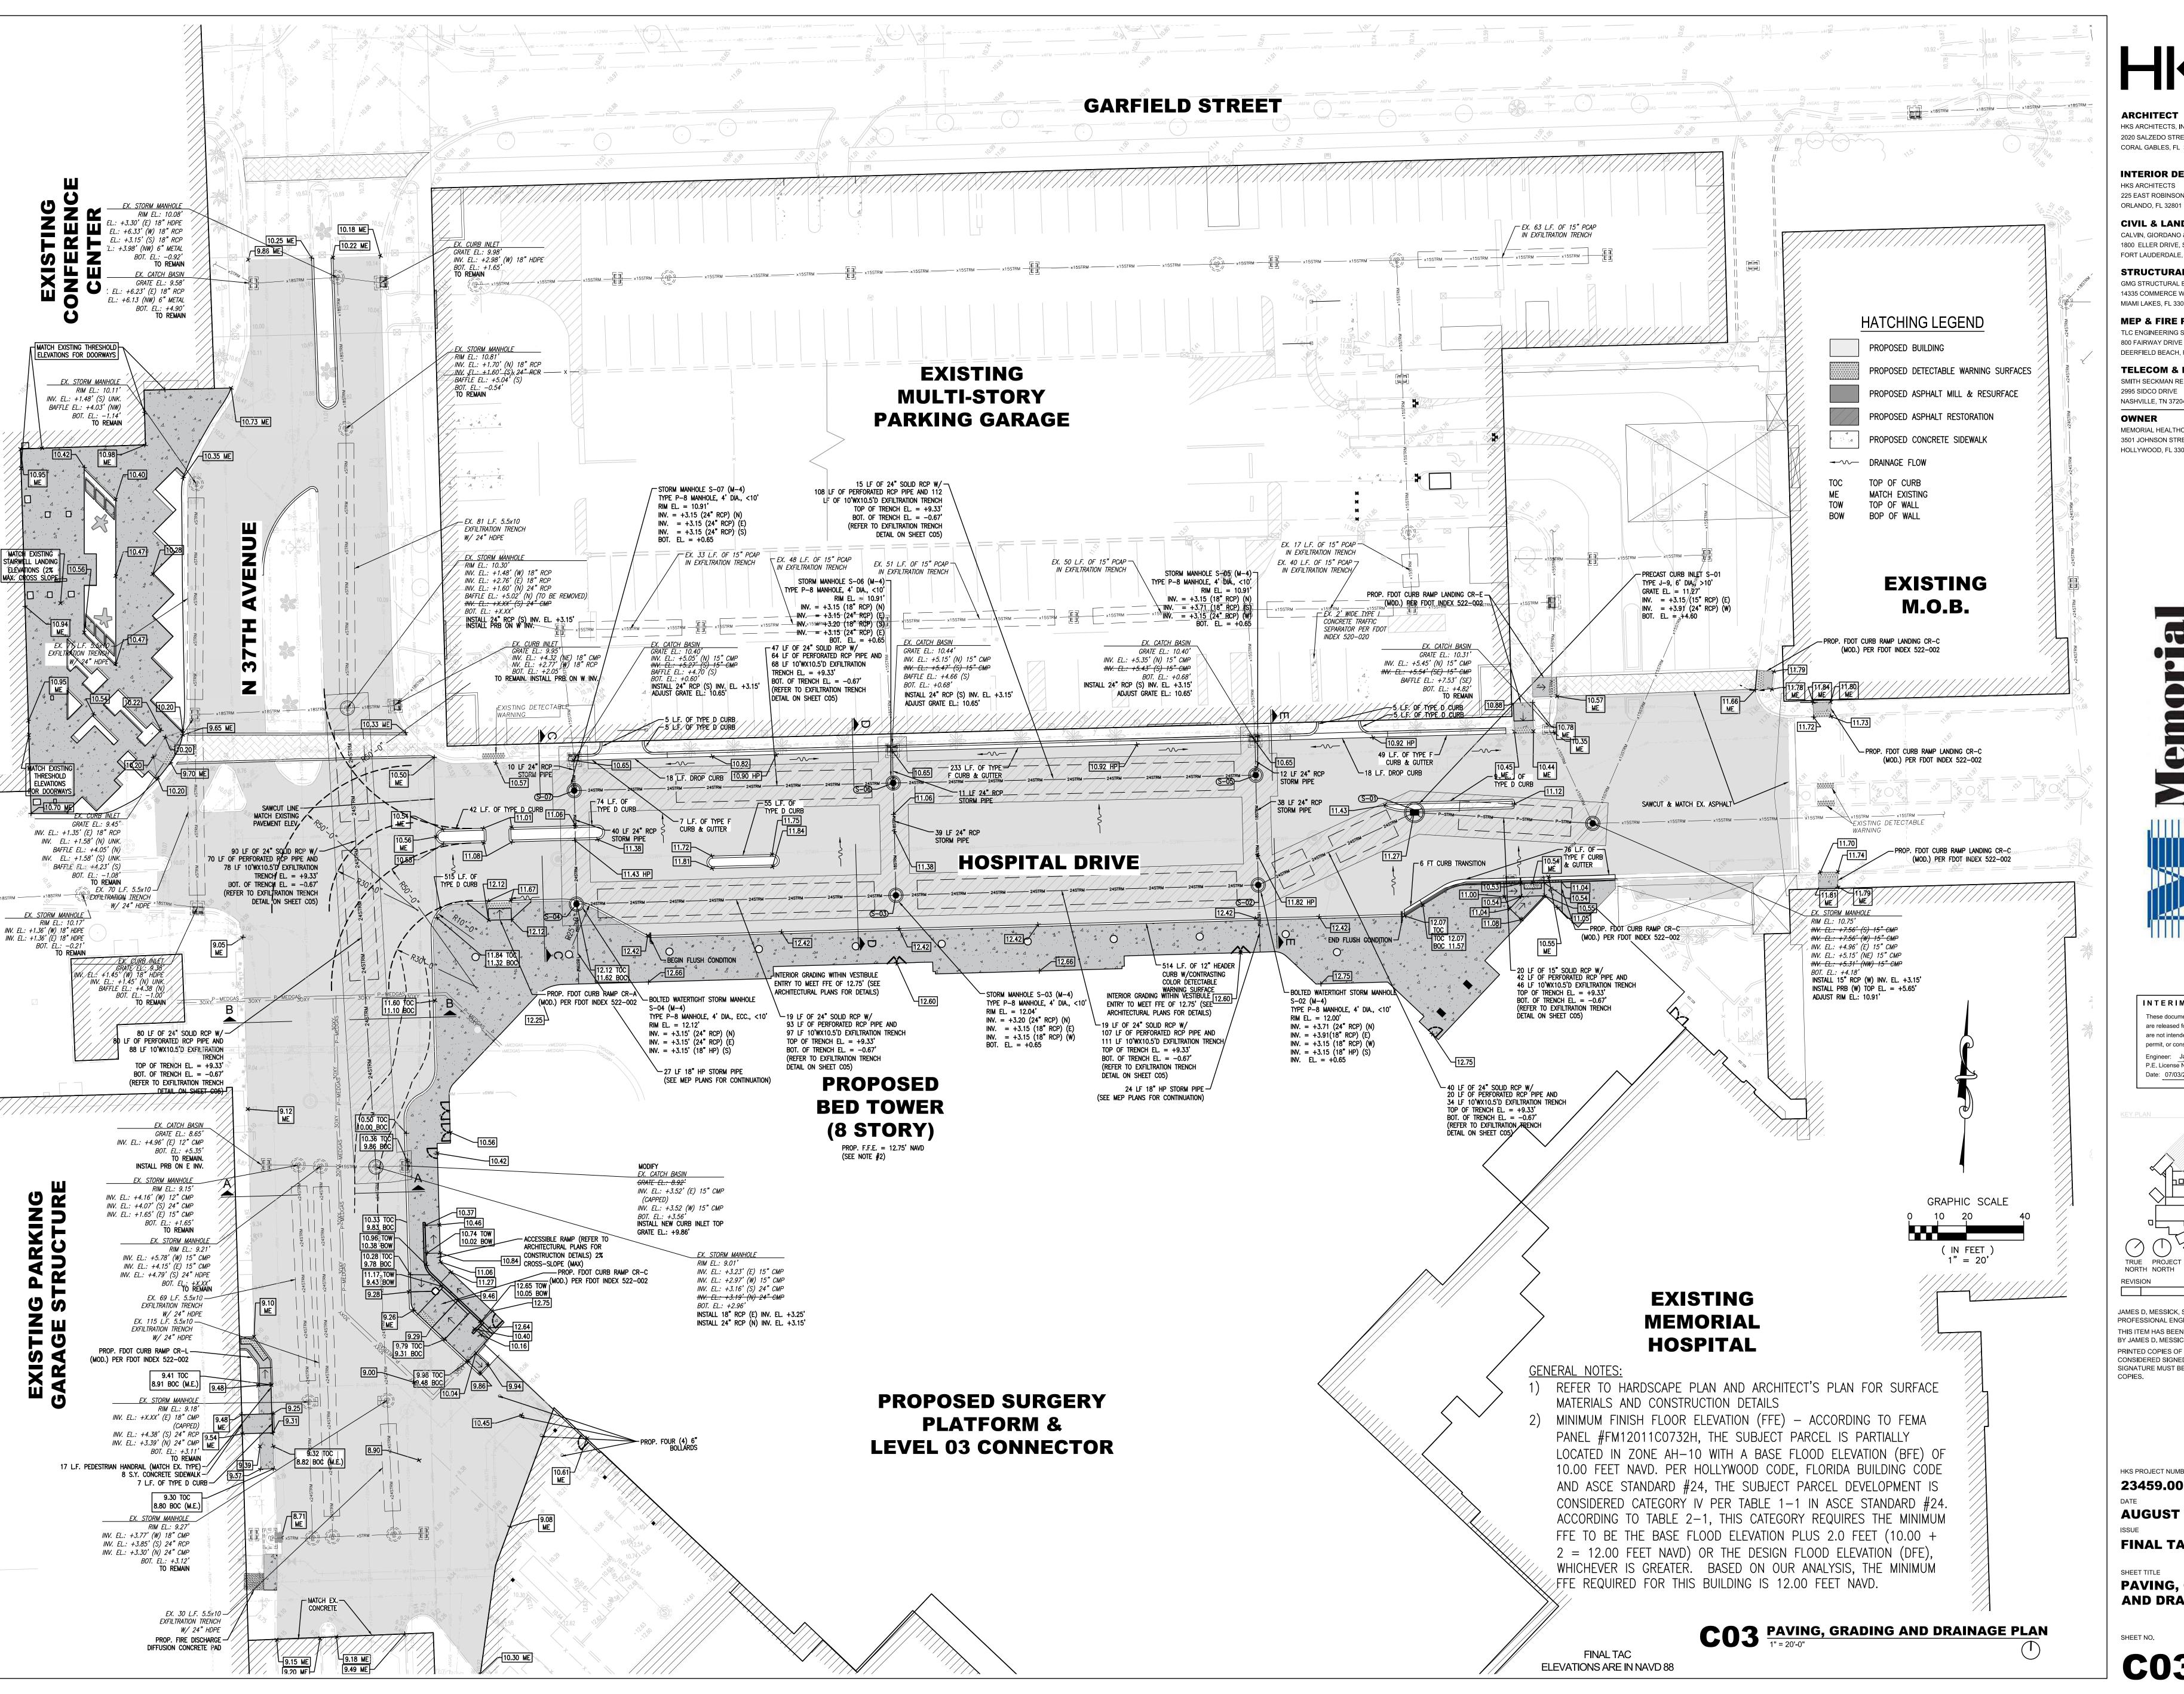C02



ARCHITECT HKS ARCHITECTS, INC. 2020 SALZEDO STREET, 4TH FLOOR CORAL GABLES, FL 33134

INTERIOR DESIGNER

HKS ARCHITECTS 225 EAST ROBINSON ST. SUITE #405

CIVIL & LANDSCAPE CALVIN, GIORDANO & ASSOCIATES 1800 ELLER DRIVE, SUITE 600

FORT LAUDERDALE, FL 33316 STRUCTURAL ENGINEER

GMG STRUCTURAL ENGINEERS 14335 COMMERCE WAY

MIAMI LAKES, FL 33016 **MEP & FIRE PROTECTION**

TLC ENGINEERING SOLUTIONS, INC. 800 FAIRWAY DRIVE

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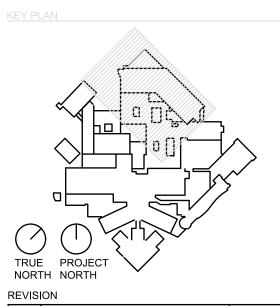
NASHVILLE, TN 37204

OWNER MEMORIAL HEALTHCARE SYSTEM

3501 JOHNSON STREET HOLLYWOOD, FL 33021

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Date: 07/03/2024



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HKS PROJECT NUMBER 23459.000

AUGUST 19, 2024

FINAL TAC

PAVING, GRADING AND DRAINAGE PLAN

SHEET NO.

CO3

GENERAL NOTES:

- THE INFORMATION PROVIDED IN THESE DRAWINGS IS SOLELY TO ASSIST THE CONTRACTOR IN ASSESSING THE NATURE AND EXTENT OF CONDITIONS WHICH WILL BE ENCOUNTERED DURING THE COURSE OF THE WORK. THE CONTRACTORS ARE DIRECTED, PRIOR TO BIDDING, TO CONDUCT WHATEVER INVESTIGATIONS THEY DEEM NECESSARY TO ARRIVE AT THEIR OWN CONCLUSION REGARDING THE ACTUAL CONDITIONS THAT WILL BE ENCOUNTERED, AND UPON WHICH BIDS WILL BE BASED.
- ALL CONSTRUCTION AND MATERIALS SHALL CONFORM TO APPLICABLE STANDARDS AND SPECIFICATIONS OF THE CITY OF HOLLYWOOD DEPARTMENT OF PUBLIC UTILITIES, ENGINEERING AND CONSTRUCTION SERVICES DIVISION (ECSD), AND ALL OTHER LOCAL, STATE AND NATIONAL CODES, WHERE APPLICABLE.
- 3. LOCATIONS, ELEVATIONS, SIZES, MATERIALS, ALIGNMENTS, AND DIMENSIONS OF EXISTING FACILITIES, UTILITIES AND OTHER FEATURES ARE SHOWN ACCORDING TO THE BEST INFORMATION AVAILABLE AT THE TIME OF THE PREPARATION OF THESE PLANS; AND DO NOT PURPORT TO BE ABSOLUTELY CORRECT. ALSO, THERE MAY HAVE BEEN OTHER IMPROVEMENTS, UTILITIES, ETC., WITHIN THE PROJECT AREA WHICH WERE CONSTRUCTED AFTER THE PREPARATION OF THESE PLANS AND/OR THE ORIGINAL SITE SURVEY. THE CONTRACTOR SHALL VERIFY THE LOCATIONS, ELEVATIONS, AND OTHER FEATURES AFFECTING HIS/HER WORK PRIOR TO CONSTRUCTION, AND NOTIFY THE ENGINEER IMMEDIATELY WHEN CONFLICT BETWEEN DRAWINGS AND ACTUAL CONDITIONS ARE DISCOVERED. THE ENGINEER ASSUMES NO RESPONSIBILITY FOR ANY FACILITIES SHOWN OR NOT SHOWN ON THE PLANS. THE CONTRACTOR SHALL WORK AS NEEDED TO AVOID CONFLICT WITH EXISTING UTILITIES (NO ADDITIONAL COST SHALL BE PAID FOR THIS WORK). EXISTING UTILITIES SHALL BE MAINTAINED IN SERVICE DURING CONSTRUCTION UNLESS OTHERWISE APPROVED BY THE RESPECTIVE UTILITY OWNER.
- 4. THE CONTRACTOR SHALL COORDINATE WITH ALL UTILITIES TO ARRANGE FOR THE RELOCATION AND TEMPORARY SUPPORT OF UTILITY FEATURES, ETC. AS NECESSARY TO COMPLETE THE WORK.
- 5. IT SHALL BE THE CONTRACTOR'S RESPONSIBILITY TO LOCATE AND PROTECT ANY AND ALL EXISTING UTILITIES ON THIS PROJECT, AND TO ENSURE THAT EXISTING UTILITIES ARE MAINTAINED IN SERVICE

DURING CONSTRUCTION UNLESS APPROVED OTHERWISE BY THE UTILITY OWNER.

- CONTRACTOR SHALL ADJUST ALL EXISTING UTILITY CASTINGS INCLUDING VALVE BOXES, MANHOLES, HAND-HOLES, PULL-BOXES, STORMWATER INLETS, AND SIMILAR STRUCTURES IN CONSTRUCTION AREA TO BE OVERLAID WITH ASPHALT PAVEMENT.
- 7. THE CONTRACTOR IS REQUIRED TO OBTAIN ALL APPLICABLE CONSTRUCTION AND ENVIRONMENTAL PERMITS PRIOR TO THE START OF CONSTRUCTION.
- 8. THE CONTRACTOR SHALL NOTIFY ECSD AT LEAST 48 HOURS PRIOR TO BEGINNING CONSTRUCTION.
- 9. PRIOR TO THE COMMENCEMENT OF CONSTRUCTION AND INSTALLATION OF THE PROPOSED IMPROVEMENTS, SHOP DRAWINGS SHALL BE SUBMITTED TO ECSD IN ACCORDANCE WITH THE CONTRACT DOCUMENT'S REQUIREMENTS, FOR APPROVAL. IN ADDITION, IT IS THE CONTRACTOR'S RESPONSIBILITY TO OBTAIN ANY OTHER AGENCY SHOP DRAWING APPROVAL, IF REQUIRED.
- 10. THE CONTRACTOR SHALL NOTIFY ECSD IMMEDIATELY FOR ANY CONFLICT ARISING DURING CONSTRUCTION OF ANY IMPROVEMENTS SHOWN ON THESE DRAWINGS. THIS WORK BY THE CONTRACTOR SHALL BE CONSIDERED INCIDENTAL TO THE CONTRACT AND NO ADDITIONAL COMPENSATION SHALL BE ALLOWED.
- 11. ELEVATIONS SHOWN ARE IN FEET AND ARE REFERENCED TO THE NORTH AMERICAN VERTICAL DATUM OF 1988 (NAVD 88).

DIAMOND OF THE GOLD COAST	ISSUE	D: 03/01/199	DEPARTMENT OF PUBLIC UTILITIES STANDARD DETAIL	REVISED: 06/
DIAMOND OF THE	DRAWI	N: EAI		DRAWING NO.
GOLD COAST	APPROVI	VED: XX	GENERAL NOTES	G-0

GENERAL NOTES (CONTINUED):

RIGHT OF WAY.

- 12. CITY OF HOLLYWOOD SHALL NOT PROVIDE STAGING / STORAGE AREA. CONTRACTOR SHALL SECURE STAGING / STORAGE AREA AS NECESSARY FOR CONSTRUCTION WORK.
- 13. CONTRACTOR SHALL HAUL AWAY EXCESSIVE STOCKPILE OF SOIL FOR DISPOSAL EVERY DAY. NO STOCKPILE SOIL IS ALLOWED TO BE LEFT ON THE CONSTRUCTION SITE OVER NIGHT.
- 14. CONTRACTOR SHALL CLEAN / SWEEP THE ROAD AT LEAST ONCE DAY OR AS REQUIRED BY THE ENGINEER.
- 15. CONTRACTOR SHALL PROTECT CATCH BASINS WITHIN / ADJACENT TO THE CONSTRUCTION SITE AS REQUIRED BY NPDES REGULATIONS.
- 16. THE CITY OF HOLLYWOOD HAS A NOISE ORDINANCE (CHAPTER 100) WHICH PROHIBITS EXCAVATION AND CONSTRUCTION BEFORE 8:00 A.M. AND AFTER 6:00 P.M., MONDAY THROUGH SATURDAY AND ALL DAY
- 17. SUITABLE EXCAVATED MATERIAL SHALL BE USED IN FILL AREAS. NO SEPARATE PAY ITEM FOR THIS WORK, INCLUDE COST IN OTHER ITEMS.
- 18. ALL ROAD CROSSINGS ARE OPEN CUT AS PER THE REQUIREMENTS OF THE ECSD UNLESS OTHERWISE NOTED ON THE DRAWINGS.
- 19. THE CONTRACTOR SHALL REPLACE ALL PAVING, STABILIZING EARTH, DRIVEWAYS, PARKING LOTS, SIDEWALKS, ETC. TO SATISFY THE INSTALLATION OF THE PROPOSED IMPROVEMENTS WITH THE SAME TYPE OF MATERIAL THAT WAS REMOVED DURING CONSTRUCTION OR AS DIRECTED BY ECSD FIELD ENGINEER.
- 20. THE CONTRACTOR SHALL NOT ENCROACH INTO PRIVATE PROPERTY WITH PERSONNEL, MATERIAL OR EQUIPMENT. IN CASE WORK ON PRIVATE PROPERTY IS NEEDED, A CITY OF HOLLYWOOD "RIGHT OF ENTRY" FORM MUST BE SIGNED BY PROPERTY OWNER AND THE DIRECTOR OF PUBLIC UTILITIES. THE CONTRACTOR IS RESPONSIBLE TO MAINTAIN ACCESS AT ALL TIMES TO PRIVATE HOMES/BUSINESSES.
- 21. THE CONTRACTOR SHALL BE RESPONSIBLE FOR DAMAGE, REMOVAL OR MODIFICATION, CAUSED TO ANY IRRIGATION SYSTEM (PRIVATE OR PUBLIC) ACCIDENTALLY OR PURPOSELY. THE CONTRACTOR SHALL REPLACE ANY DAMAGED, REMOVED OR MODIFIED IRRIGATION PIPES, SPRINKLER HEADS OR OTHER PERTINENT APPURTENANCES TO MATCH OR EXCEED EXISTING CONDITIONS AT NO ADDITIONAL COST TO
- 22. MAIL BOXES, FENCES OR OTHER PRIVATE PROPERTY DAMAGED DURING THE CONSTRUCTION OF THE

PROPOSED IMPROVEMENTS SHALL BE REPLACED TO MATCH OR EXCEED EXISTING CONDITION.

- 23. CONTRACTOR SHALL PROVIDE MAINTENANCE OF TRAFFIC IN ACCORDANCE WITH FDOT STANDARDS AND CITY OF HOLLYWOOD DEPARTMENT OF PUBLIC UTILITIES STANDARDS.
- 24. NO TREES ARE TO BE REMOVED OR RELOCATED WITHOUT PRIOR APPROVAL FROM THE ECSD FIELD
- 25. THE CONTRACTOR IS RESPONSIBLE FOR OBTAINING THE NECESSARY TREE REMOVAL OR RELOCATION PERMITS FROM THE CITY OF HOLLYWOOD BUILDING DEPARTMENT FOR TREES LOCATED IN THE PUBLIC
- 26. IT IS THE INTENT OF THESE PLANS TO BE IN ACCORDANCE WITH APPLICABLE CODES AND AUTHORITIES HAVING JURISDICTION. ANY DISCREPANCIES BETWEEN THESE PLANS AND APPLICABLE REGULATORY STANDARDS / REQUIREMENTS SHALL BE IMMEDIATELY BROUGHT TO THE ATTENTION OF ECSD.

HOLLYWOOD A	ISSUED:	03/01/1994	DEPARTMENT OF PUBLIC UTILITIES STANDARD DETAIL	REVISED:	11/06/2
DIAMOND	DRAWN:	EAM	GENERAL NOTES	DRAWING I	٧٥.
GOLD COAST	APPROVE	D: XXX	(CONTINUED)	G-0	0.1

GENERAL NOTES (CONTINUED):

- 27. THE CONTRACTOR SHALL BE RESPONSIBLE FOR MAINTAINING THE INTEGRITY OF AND MAKING THE REPAIRS TO EXISTING PAVEMENT, SIDEWALKS, PIPES, CONDUITS, CURBS, CABLES, ETC., WHETHER OR NOT SHOWN ON THE PLANS DAMAGED AS A RESULT OF THE CONTRACTORS OPERATIONS AND/OR THOSE OF HIS SUBCONTRACTORS, AND SHALL RESTORE THEM PROMPTLY AT NO ADDITIONAL EXPENSE TO THE OWNER. CONTRACTOR SHALL REPORT ANY DAMAGE TO SIDEWALK, DRIVEWAY, ETC., PRIOR TO BEGINNING WORK IN ANY AREA.
- 28. WHERE NEW PAVEMENT MEETS EXISTING, CONNECTION SHALL BE MADE IN A NEAT STRAIGHT LINE AND FLUSH WITH EXISTING PAVEMENT TO MATCH EXISTING CONDITIONS.
- 29. UNDER NO CIRCUMSTANCES SHALL THE CONTRACTOR LEAVE EXCAVATED TRENCHES, OR PARTS OF, EXPOSED OR OPENED AT THE END OF THE WORKING DAY, WEEKENDS, HOLIDAYS OR OTHER TIMES, WHEN THE CONTRACTOR IS NOT WORKING, UNLESS OTHERWISE DIRECTED. ALL TRENCHES SHALL BE COVERED, FIRMLY SECURED AND MARKED ACCORDINGLY FOR PEDESTRIAN / VEHICULAR TRAFFIC.
- 30. ALL EXCAVATED MATERIAL REMOVED FROM THIS PROJECT SHALL BE DISPOSED OF OFF THE PROPERTY BY THE CONTRACTOR AT THE CONTRACTOR'S EXPENSE.
- 31. ALL DUCTILE IRON PRODUCTS SHALL BE DOMESTIC MADE HEAVY DUTY CLASSIFICATION SUITABLE FOR HIGHWAY TRAFFIC LOADS, OR 20,000 LB.
- 32. ALL GRASSED AREAS AFFECTED BY CONSTRUCTION SHALL BE RE-SODDED.
- 33. THE CONTRACTOR SHALL BE RESPONSIBLE FOR THE PROVISION, INSTALLATION AND MAINTENANCE OF ALL TRAFFIC CONTROL AND SAFETY DEVICES, IN ACCORDANCE WITH SPECIFICATIONS OF THE LATEST REVISION OF FDOT DESIGN STANDARDS. IN ADDITION, THE CONTRACTOR IS RESPONSIBLE FOR THE RESETTING OF ALL TRAFFIC CONTROL AND INFORMATION SIGNAGE REMOVED DURING THE CONSTRUCTION PERIOD.
- 34. EXCAVATED OR OTHER MATERIAL STORED ADJACENT TO OR PARTIALLY UPON A ROADWAY PAVEMENT SHALL BE ADEQUATELY MARKED FOR TRAFFIC SAFETY AT ALL TIMES.
- 35. TEMPORARY PATCH MATERIAL MUST BE ON THE JOB SITE WHENEVER PAVEMENT IS CUT, OR THE CITY'S INSPECTOR WILL SHUT THE JOB DOWN.
- 36. CONTRACTOR MUST PROVIDE FLASHER ARROW SIGNAL FOR ANY LANE THAT IS CLOSED OR DIVERTED.
- 37. CONTRACTOR SHALL NOTIFY LAW ENFORCEMENT AND FIRE PROTECTION SERVICES TWENTY-FOUR (24) HOURS IN ADVANCE OF TRAFFIC DETOUR IN ACCORDANCE WITH SECTION 336.07 OF FLORIDA STATUTES.
- 38. CONTRACTOR TO RESTORE PAVEMENT TO ORIGINAL CONDITION AS REQUIRED.
- 39. CONTRACTOR SHALL BE RESPONSIBLE FOR PROVIDING DEWATERING PER SPECIFICATION SECTION 02140 DEWATERING.

DIAMOND OF THE PROPERTY OF THE	ISSUED:	03/01/1994	DEPARTMENT OF PUBLIC UTILITIES STANDARD DETAIL	REVISED: 11/06/2017
	DRAWN:	EAM	GENERAL NOTES	DRAWING NO.
GOLD COAST	APPROVED): XXX	(CONTINUED)	G-00.2


GENERAL NOTES (CONTINUED):


40. THE CONTRACTOR SHALL GIVE AT LEAST 48 HOURS NOTICE TO UTILITY COMPANIES TO PROVIDE FOR THE LOCATION OF EXISTING UNDERGROUND UTILITIES IN ADVANCE OF CONSTRUCTION. CONTACT UTILITIES NOTIFICATION CENTER AT 811 OR 1-800-432-4770 (SUNSHINE ONE-CALL OF FLORIDA).





- 41. WHEN PVC PIPE IS USED, A METALLIZED MARKER TAPE SHALL BE INSTALLED CONTINUOUSLY 18" ABOVE THE PIPE. THE MARKER TAPE SHOULD BE IMPRINTED WITH A WARNING THAT THERE IS BURIED PIPE BELOW. THE TAPE SHALL BE MAGNA TEC, AS MANUFACTURED BY THOR ENTERPRISES INC. OR APPROVED EQUAL.
- 42. ALL CONNECTIONS TO EXISTING MAINS SHALL BE THE RESPONSIBILITY OF THE CONTRACTOR. WATER CONNECTIONS SHALL BE METERED, AND THE COST OF WATER AND TEMPORARY METER SHALL BE BORNE BY THE CONTRACTOR.
- 43. A COMPLETE AS-BUILT SURVEY SHALL BE ACCURATELY RECORDED OF THE UTILITY SYSTEM DURING CONSTRUCTION. AS-BUILT SURVEY SHALL BE SUBMITTED TO ECSD SIGNED AND SEALED BY A FLORIDA REGISTERED SURVEYOR PRIOR TO FINAL INSPECTION AND ACCEPTANCE OF PROJECT. THE COST OF SIGNED AND SEALED AS-BUILTS SHALL BE COVERED IN OVERALL BID. THE AS-BUILT SURVEY SHALL INCLUDE:
- PLAN VIEW SHOWING THE HORIZONTAL LOCATIONS OF EACH MANHOLE, INLET, VALVE, FITTING, BEND AND HORIZONTAL PIPE DEFLECTIONS WITH COORDINATES AND IN REFERENCE TO A SURVEY BASELINE OR RIGHT-OF-WAY CENTERLINE.
- b. THE PLAN VIEW SHALL ALSO SHOW SPOT ELEVATIONS OF THE TOP OF THE MAIN (WATER MAIN AND FORCE MAIN) OR PIPE INVERTS (GRAVITY MAINS) AT INTERVALS NOT TO EXCEED 100 FEET AS MEASURED ALONG MAIN. THE PLAN VIEW SHALL ALSO INCLUDE SPOT ELEVATIONS AT EACH MANHOLE, INLET, VALVE, FITTING, BEND AND VERTICAL PIPE
- c. THE PLAN VIEW SHALL ALSO SHOW THE HORIZONTAL SEPARATION FROM UNDERGROUND UTILITIES IMMEDIATELY ADJACENT OR PARALLEL TO THE NEW MAIN.
- d. PROFILE VIEW WITH SPOT ELEVATIONS OF THE TOP OF THE MAIN (WATER MAIN AND FORCE MAIN) OR PIPE INVERT (GRAVITY MAIN) AND OF THE FINISHED GRADE OR MANHOLE RIM DIRECTLY ABOVE THE MAIN AT INTERVALS NOT TO EXCEED 100 FEET AS MEASURED ALONG THE MAIN. THE PROFILE VIEW SHALL ALSO INCLUDE SPOT ELEVATIONS AT EACH MANHOLE, INLET, VALVE, FITTING, BEND AND VERTICAL PIPE DEFLECTION.
- e. THE PROFILE VIEW SHALL SHOW ALL UNDERGROUND UTILITIES CROSSING THE NEW MAIN AND THE VERTICAL SEPARATION PROVIDED BETWEEN THAT UNDERGROUND UTILITY AND THE
- f. ALL CADD FILES MUST BE CREATED FOLLOWING THE CITY OF HOLLYWOOD "SURVEY / AS-BUILT CAD DRAWING STANDARDS"

	, to 2012.				
GOLD COAST	ISSUED:	03/01/1994	DEPARTMENT OF PUBLIC UTILITIES STANDARD DETAIL	REVISED: 11/06/20	17
	DRAWN:	EAM	GENERAL NOTES	DRAWING NO.	1
	APPROVED): XXX	(CONTINUED)	G-00.3	

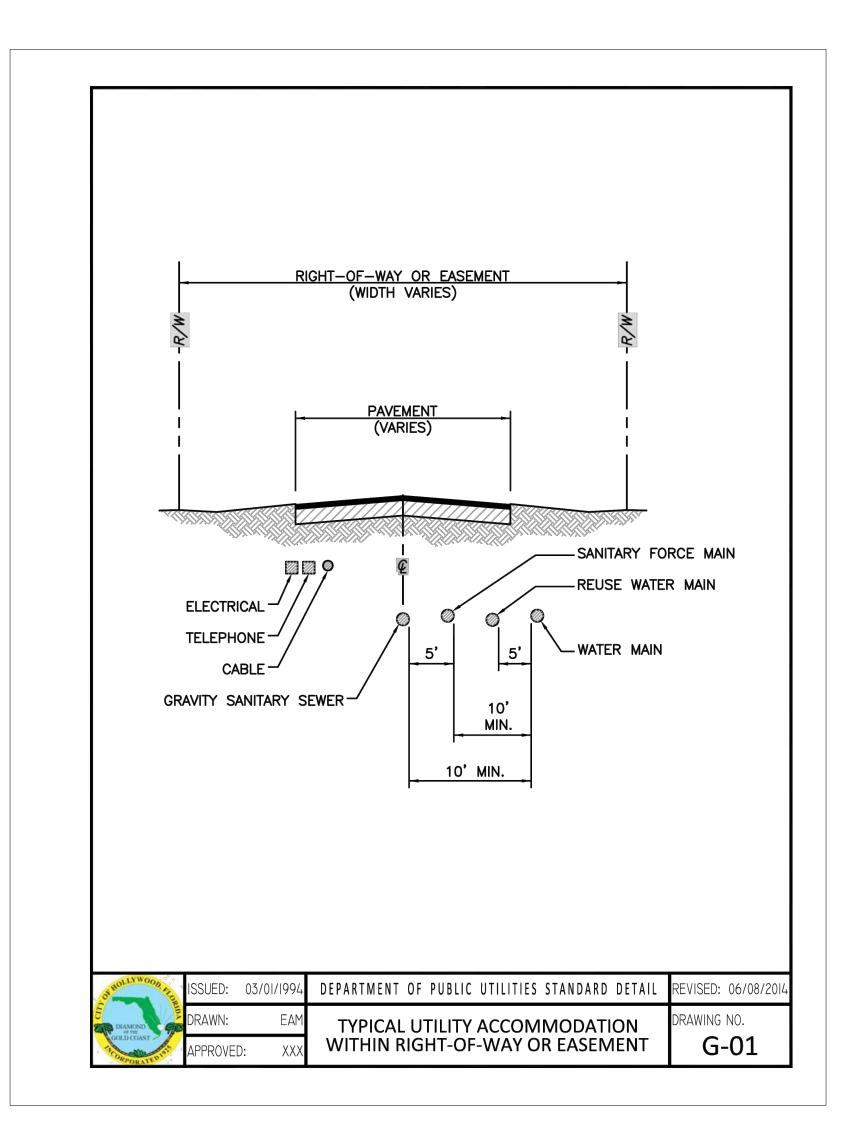

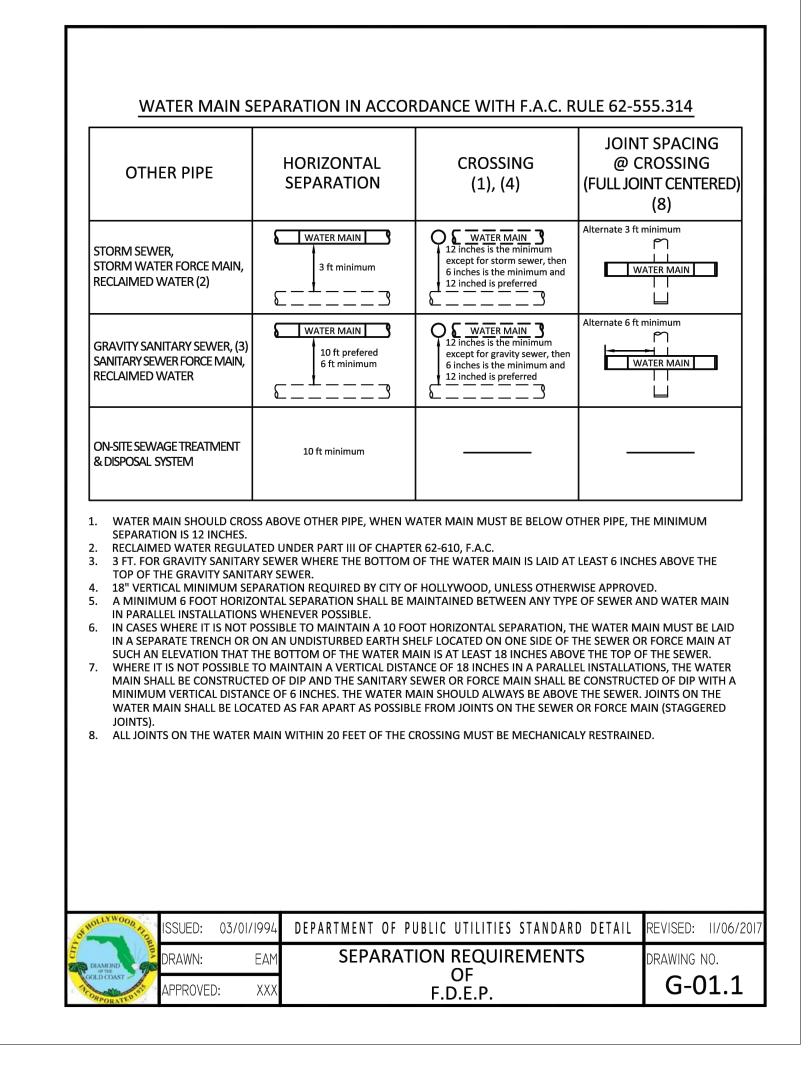

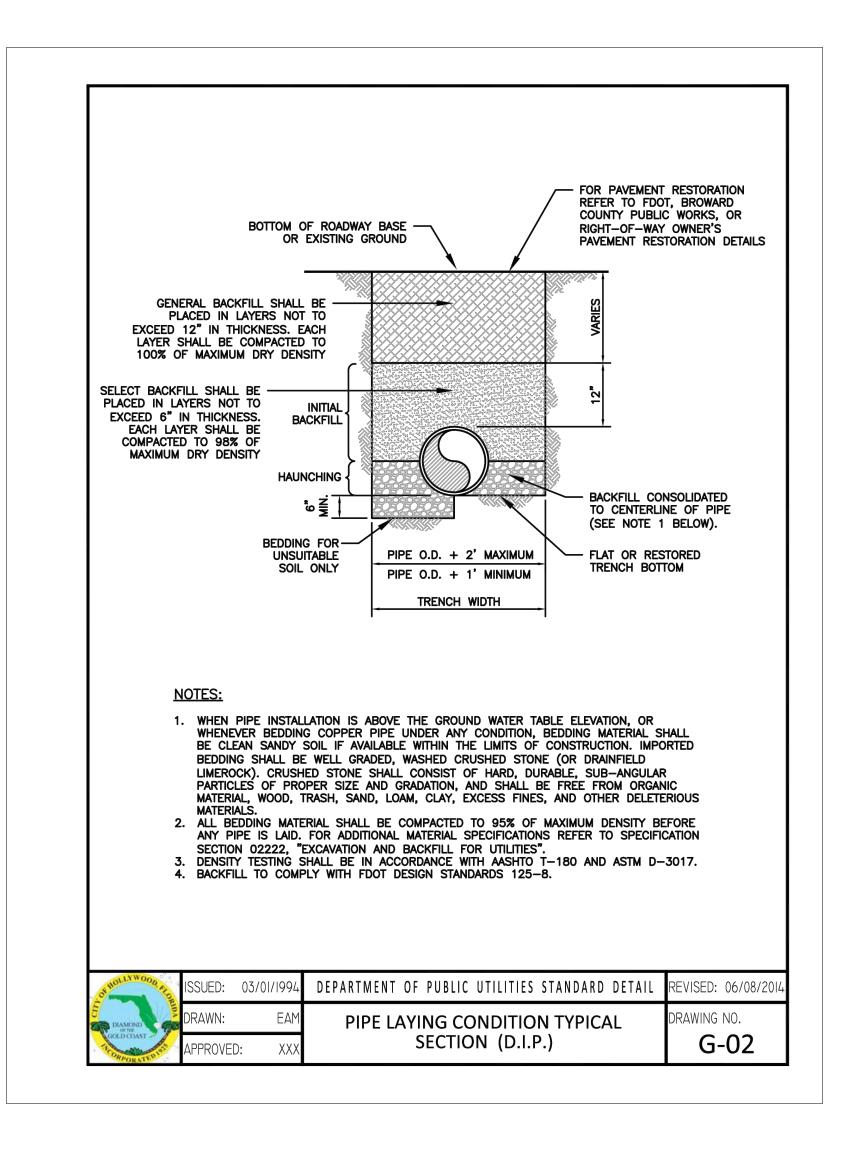

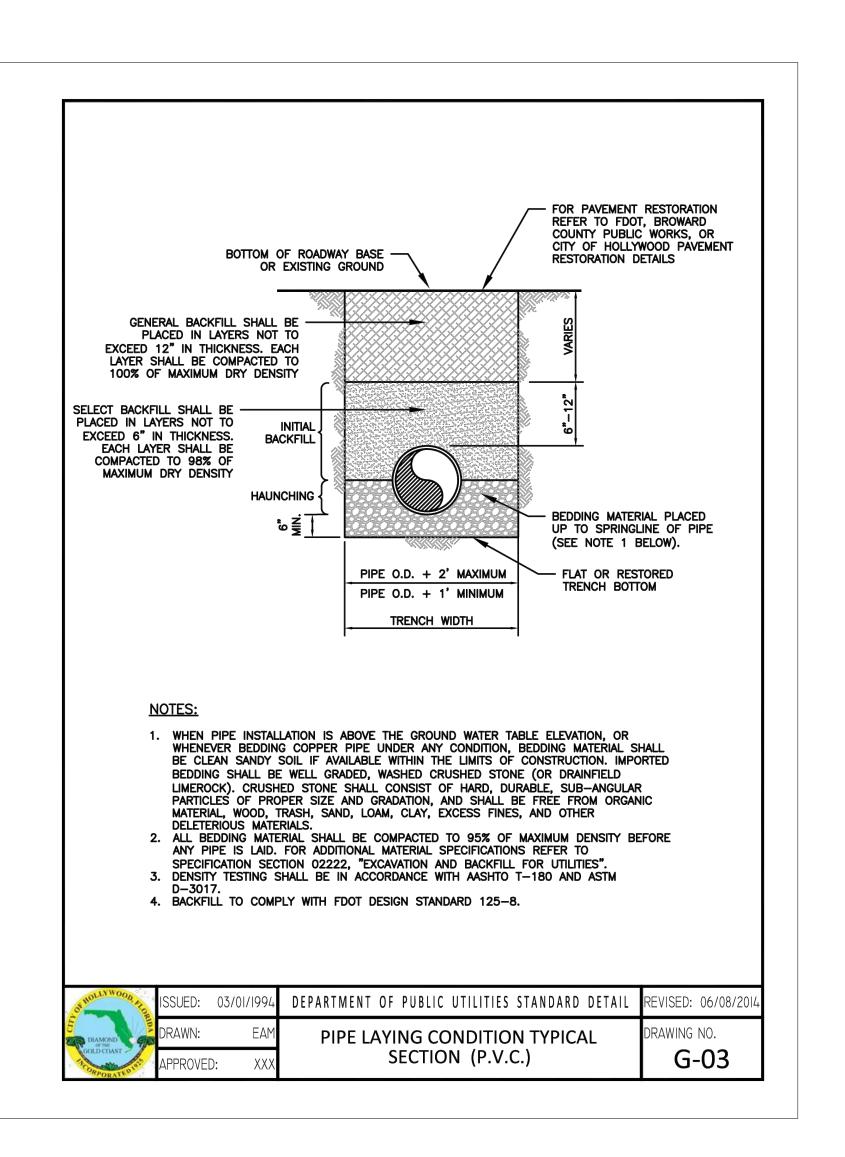

FINAL TAC ELEVATIONS ARE IN NAVD 88

CO4 PAVING, GRADING AND DRAINAGE DETAILS

NOT TO SCALE

ARCHITECT HKS ARCHITECTS, INC. 2020 SALZEDO STREET, 4TH FLOOR

CORAL GABLES, FL 33134

INTERIOR DESIGNER HKS ARCHITECTS 225 EAST ROBINSON ST. SUITE #405

ORLANDO, FL 32801

CIVIL & LANDSCAPE CALVIN, GIORDANO & ASSOCIATES 1800 ELLER DRIVE, SUITE 600

FORT LAUDERDALE, FL 33316 STRUCTURAL ENGINEER

GMG STRUCTURAL ENGINEERS 14335 COMMERCE WAY

MIAMI LAKES, FL 33016

MEP & FIRE PROTECTION TLC ENGINEERING SOLUTIONS, INC. 800 FAIRWAY DRIVE


DEERFIELD BEACH, FL 33441 **TELECOM & EQUIPMENT** SMITH SECKMAN REID, INC.

2995 SIDCO DRIVE NASHVILLE, TN 37204

MEMORIAL HEALTHCARE SYSTEM 3501 JOHNSON STREET HOLLYWOOD, FL 33021



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HKS PROJECT NUMBER 23459.000

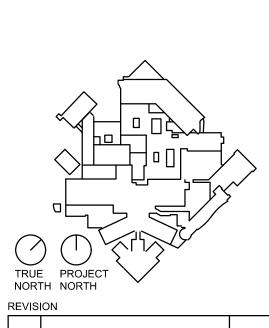
FINAL TAC

AUGUST 19, 2024

PAVING, GRADING AND DRAINAGE DETAILS

SHEET NO.

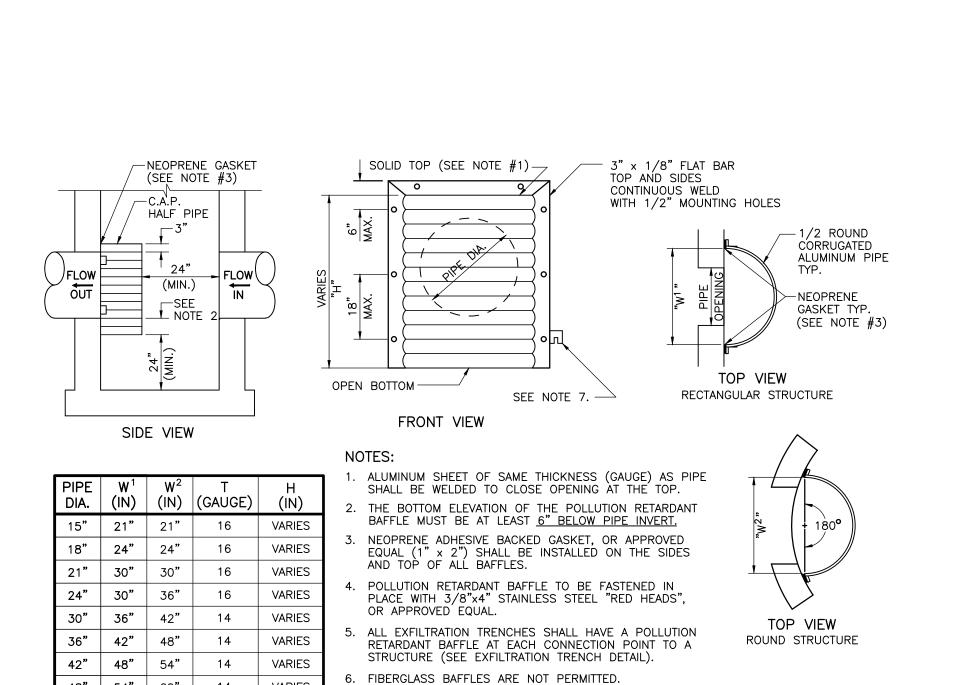C04




MOUNTING BRACKETS MAY BE ADDED TO FLAT BARS TO

EASE INSTALLATION IN ROUND STRUCTURES. SPACING TO

POLLUTION RETARDANT BAFFLE DETAIL SCALE: N.T.S.

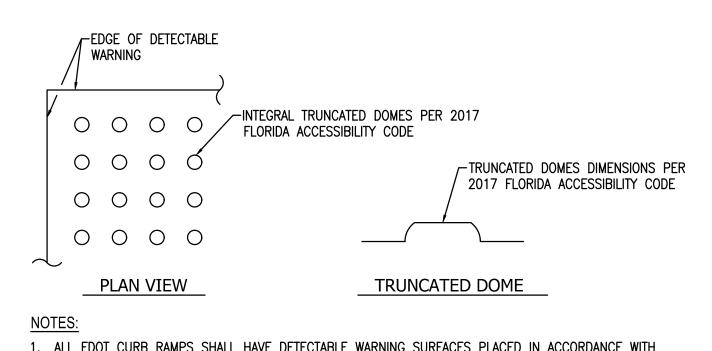MATCH HOLES IN FLAT BARS.



1. ALL FDOT CURB RAMPS SHALL HAVE DETECTABLE WARNING SURFACES PLACED IN ACCORDANCE WITH FDOT STANDARD PLANS INDEX 522


48" | 54" | 60" | 14 | VARIES

14 VARIFS

54" | 60" | 66" |


- 2. ROWS OF TRUNCATED DOMES IN A DETECTABLE WARNING SURFACE SHALL BE ALIGNED TO BE PERPENDICULAR OR RADIAL TO THE STREET, ROADWAY, OR DRIVEWAY IN ACCORDANCE WITH FDOT STANDARD PLANS INDEX 522.
- 3. SIDEWALKS ABUTTING ROADWAYS SHALL BE INSTALLED WITH A DETECTABLE WARNING SURFACE IN ACCORDANCE WITH FDOT STANDARD PLANS INDEX 522.
- 4. ALL DETECTABLE WARNINGS SHALL BE IN COMPLIANCE WITH FDOT SPECIFICATION SECTION 527. 5. ALL DETECTABLE WARNINGS SHALL BE PRE-FORMED CAST-IN-PLACE TYPE BY ACO OR EPOXY SYSTEM PRODUCTS APPROVED BY FDOT IN THE APPROVED PRODUCTS LIST (APL). STAMPED, MECHANICAL FASTENED, GLUED OR TORCH APPLIED WILL NOT BE ACCEPTED. SÚBMIT SHOP DRAWINGS FOR APPROVAL.
- 6. COLOR SHALL BE SAFETY YELLOW PER FDOT SPECIFICATION SECTION 527.

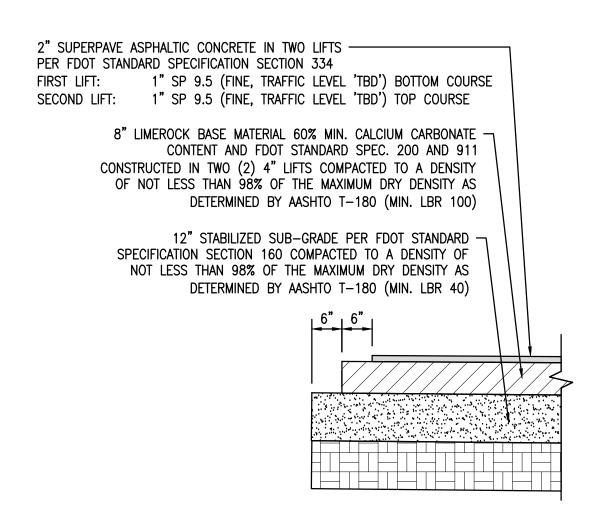DETECTABLE WARNING SURFACE SCALE: N.T.S.



- 1. TACK AND PRIME COATS ARE REQUIRED AND SHALL BE IN ACCORDANCE WITH FDOT STANDARD SPECIFICATION SECTION 300.
- 2. ASPHALT INSTALLATION SHALL BE PERFORMED IN ACCORDANCE WITH FDOT STANDARD SPECIFICATION SECTION 334.

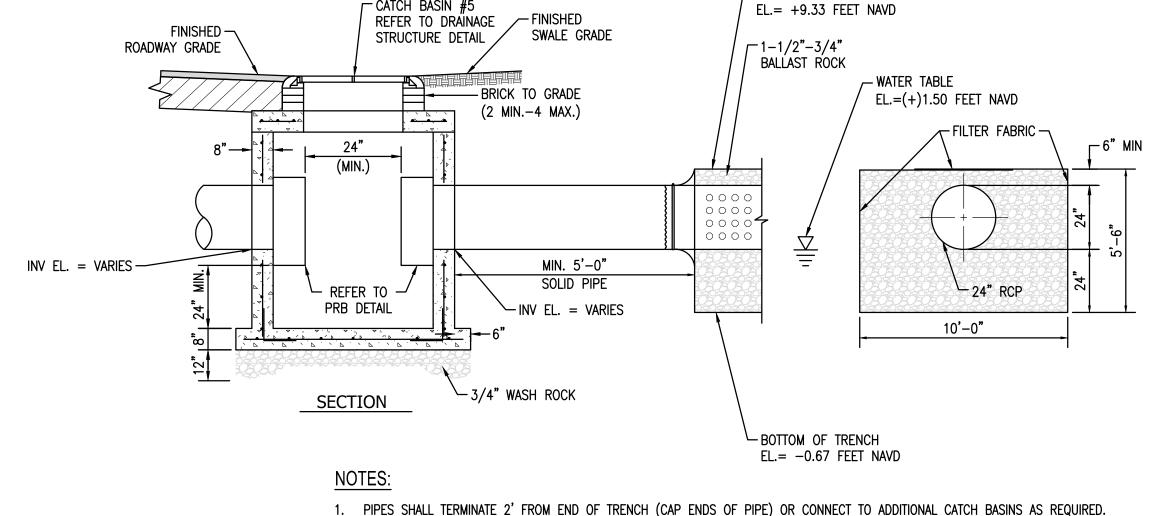ASPHALT ROADWAYDETAIL SCALE: N.T.S.



CATCH BASIN #5

2. SIDES AND TOP OF TRENCH ONLY TO BE LINED WITH FILTER FABRIC. OVERLAP LINER A MINIMUM OF 2' AT THE TOP OF THE TRENCH.

TOP OF TRENCH

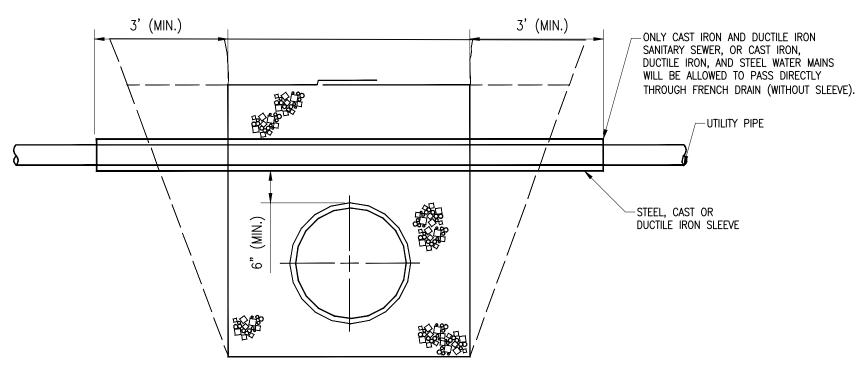
BALLAST ROCK SHALL BE FROM FRESH WATER, WASHED AND FREE OF DELETERIOUS MATTER. 4. ALL EXFILTRATION TRENCHES SHALL HAVE A POLLUTION RETARDANT BAFFLE AT EACH CONNECTION POINT TO A STRUCTURE. (SEE

CURRENT


- POLLUTION RETARDANT BAFFLE (PRB) DETAIL) 6. GASKETS SHALL BE USED WITH HP IN EXFILTRATION TRENCH.
- 6. EXFILTRATION TRENCH SHALL BE CONSTRUCTED IN COMPLIANCE WITH FDOT SPECIFICATIONS SECTION 443.


SCALE: N.T.S.

EXFILTRATION TRENCH



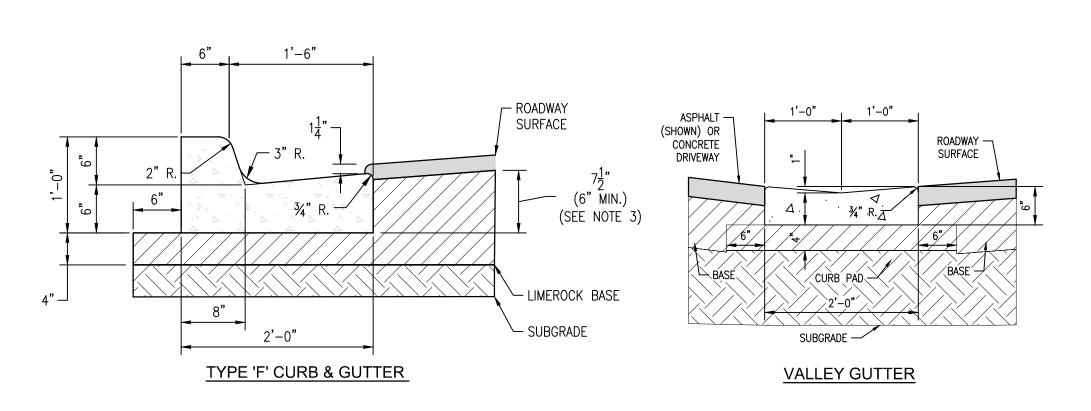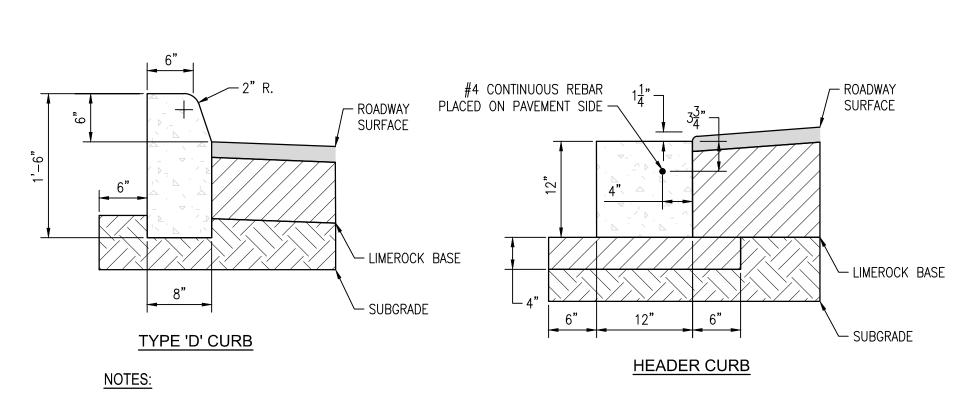UTILITY PIPES THROUGH TRENCH DRAIN FDOT INDEX NO. 285






1. ALL CURBS, GUTTERS AND CURB AND GUTTER SHALL BE CONSTRUCTED IN ACCORDANCE WITH FDOT STANDARD PLANS INDEX 520-001 AND SPECIFICATION 520.

STRENGTH OF 3,000 PSI.

- 2. CONCRETE SHALL BE IN ACCORDANCE WITH FDOT SPECIFICATION 346 HAVING A MINIMUM 28-DAY COMPRESSIVE
- 3. WHEN USED ON HIGH SIDE OF ROADWAYS, CROSS SLOPE OF THE GUTTER SHALL MATCH THE CROSS SLOPE OF THE ADJACENT PAVEMENT. THE EDGE OF PAVEMENT SHALL MATCH THE LIP OF CURB ELEVATION. THE MINIMUM THICKNESS OF THE LIP SHALL BE 6".
- 4. REFER TO FLEXIBLE PAVEMENT RESTORATION DETAIL G-12.1 FOR BASE AND SUBGRADE MATERIAL AND INSTALLATION SPECIFICATIONS.
- 5. BACKFILL BEHIND CURBS TO 2" BELOW TOP OF CURB TO ALLOW FOR SOD OR AS SPECIFIED IN LANDSCAPE PLANS AND SPECIFICATIONS.


CURB AND CURB & GUTTER DETAILS

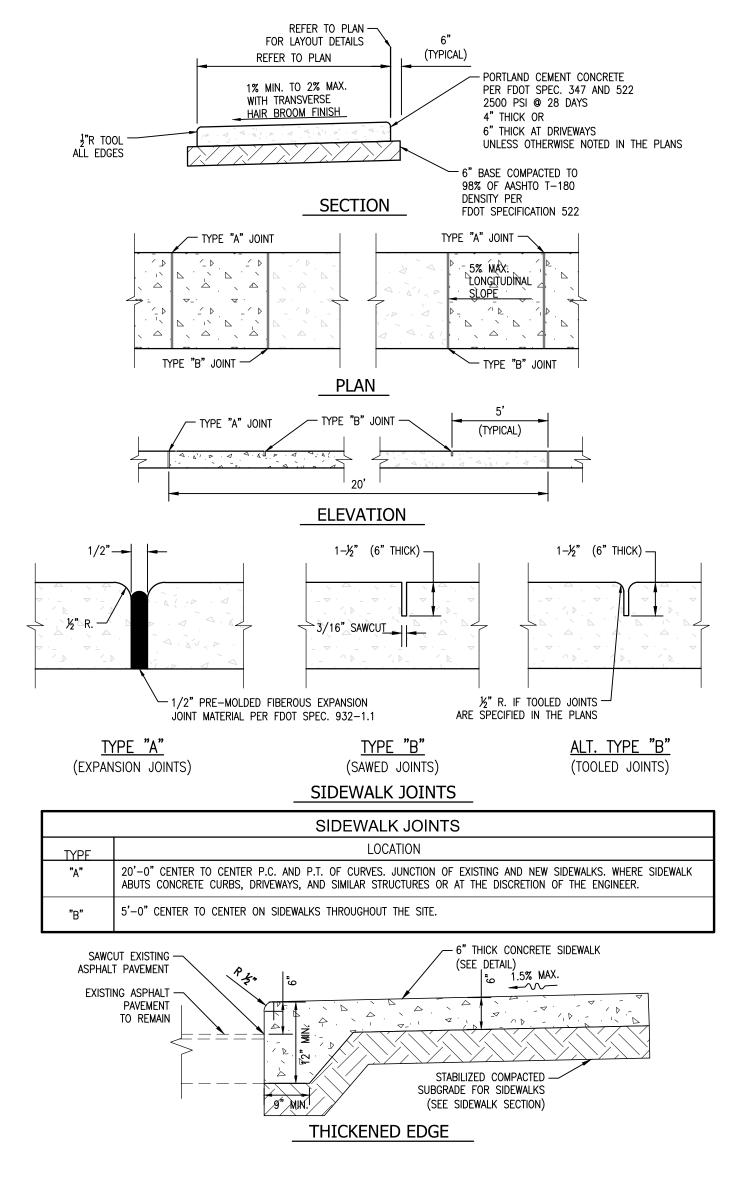SCALE: N.T.S.






Scale: NTS

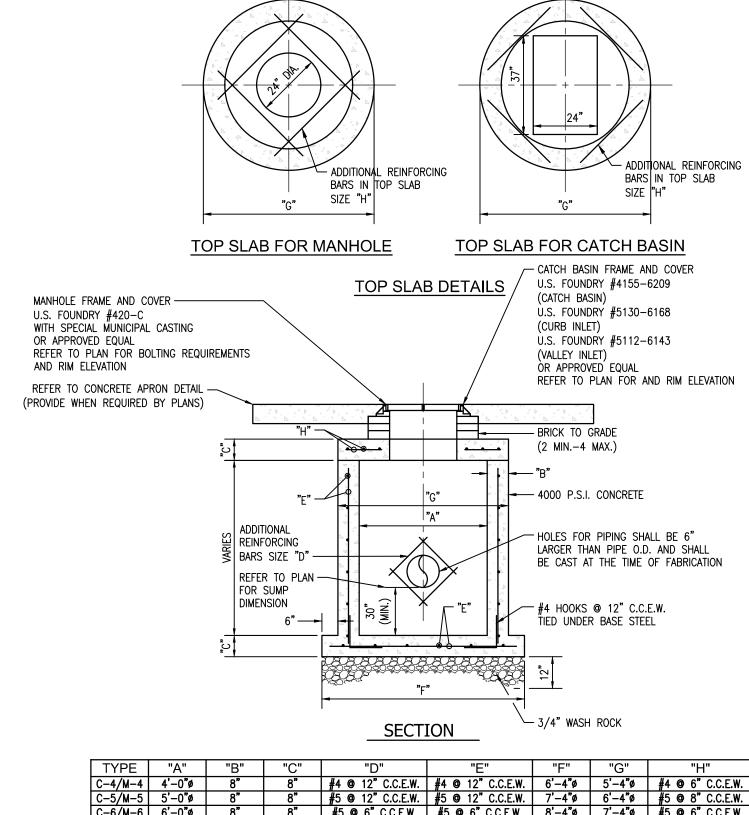


* STEEL DESIGN SHOWN HERE IS A MINIMUM, ALL STEEL DESIGN SHALL MEET OR EXCEED ASTM C478. ALL REBAR SHALL BE 60 KSI.

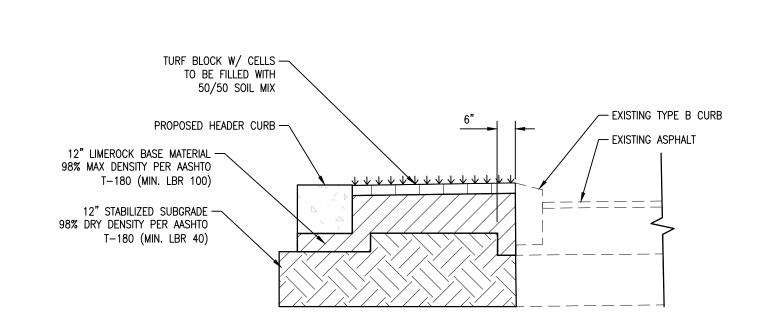PRECAST CIRCULAR MANHOLE SCALE: N.T.S.



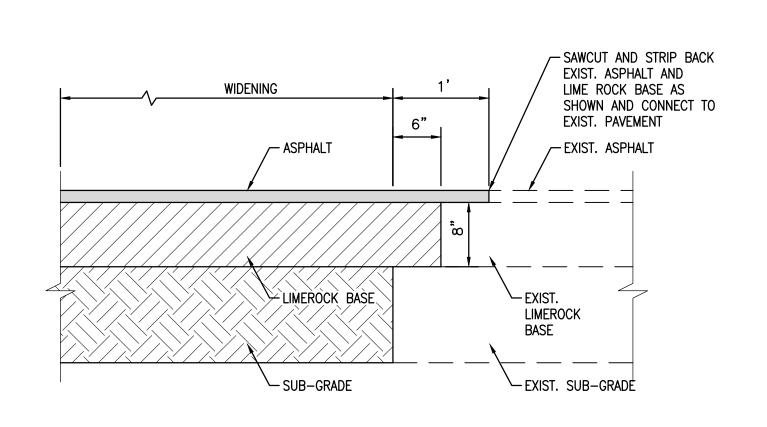TYPICAL TURF BLOCK AND HEADER CURB RESTORATION DETAIL SCALE: N.T.S.



CONNECTION WITH EXISTING PAVEMENT

FINAL TAC **ELEVATIONS ARE IN NAVD 88**

C05 PAVING, GRADING AND DRAINAGE DETAILS

NOT TO SCALE

ARCHITECT HKS ARCHITECTS, INC.

2020 SALZEDO STREET, 4TH FLOOR CORAL GABLES, FL 33134

INTERIOR DESIGNER HKS ARCHITECTS 225 EAST ROBINSON ST. SUITE #405

ORLANDO, FL 32801 CIVIL & LANDSCAPE CALVIN, GIORDANO & ASSOCIATES

1800 ELLER DRIVE, SUITE 600 FORT LAUDERDALE, FL 33316 STRUCTURAL ENGINEER

GMG STRUCTURAL ENGINEERS 14335 COMMERCE WAY

MIAMI LAKES, FL 33016 **MEP & FIRE PROTECTION** TLC ENGINEERING SOLUTIONS, INC.

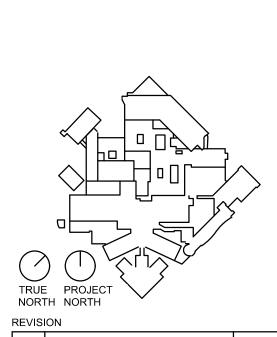
800 FAIRWAY DRIVE DEERFIELD BEACH, FL 33441 **TELECOM & EQUIPMENT** SMITH SECKMAN REID, INC.

2995 SIDCO DRIVE NASHVILLE, TN 37204

OWNER MEMORIAL HEALTHCARE SYSTEM 3501 JOHNSON STREET HOLLYWOOD, FL 33021



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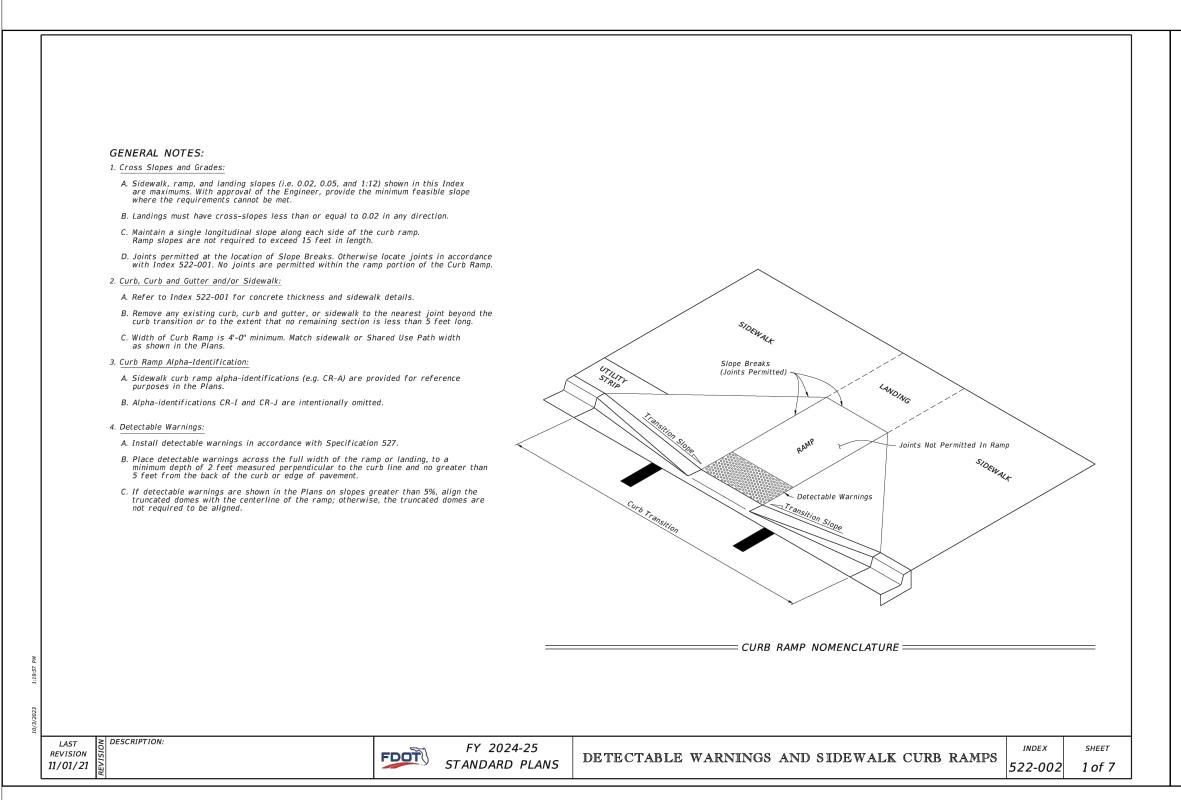
HKS PROJECT NUMBER 23459.000 **AUGUST 19, 2024**


FINAL TAC

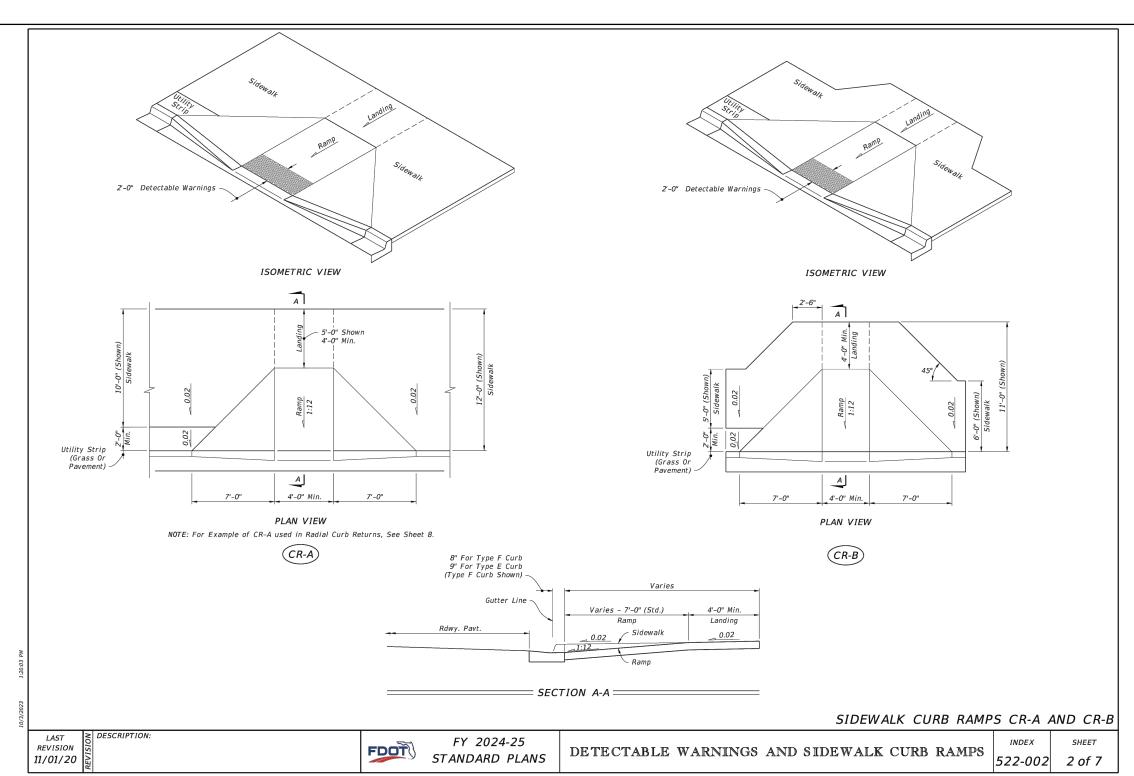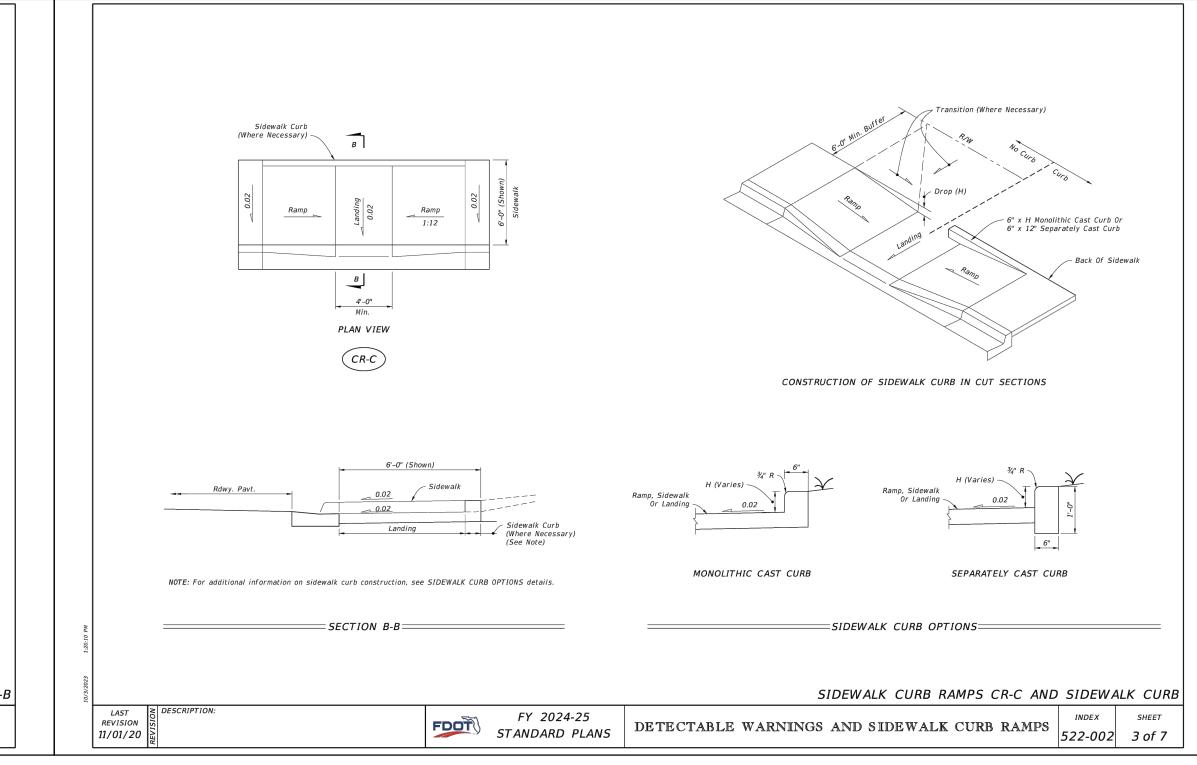
PAVING, GRADING AND DRAINAGE DETAILS

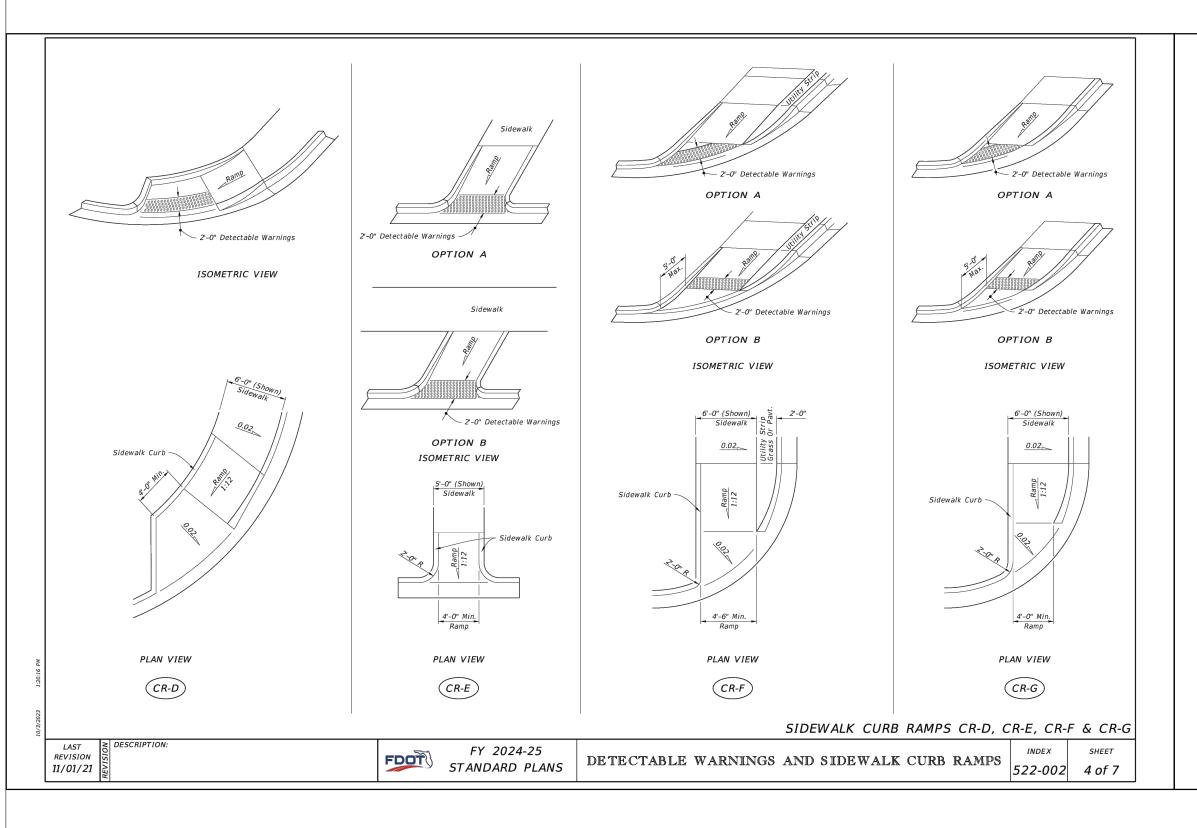
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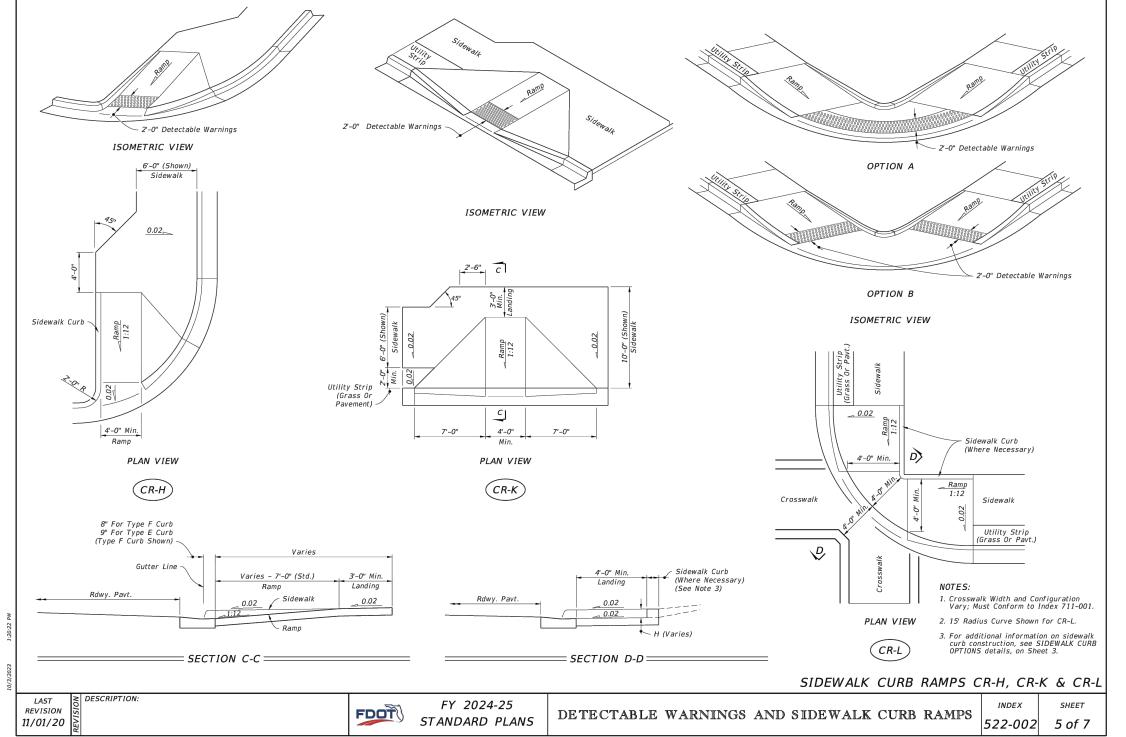
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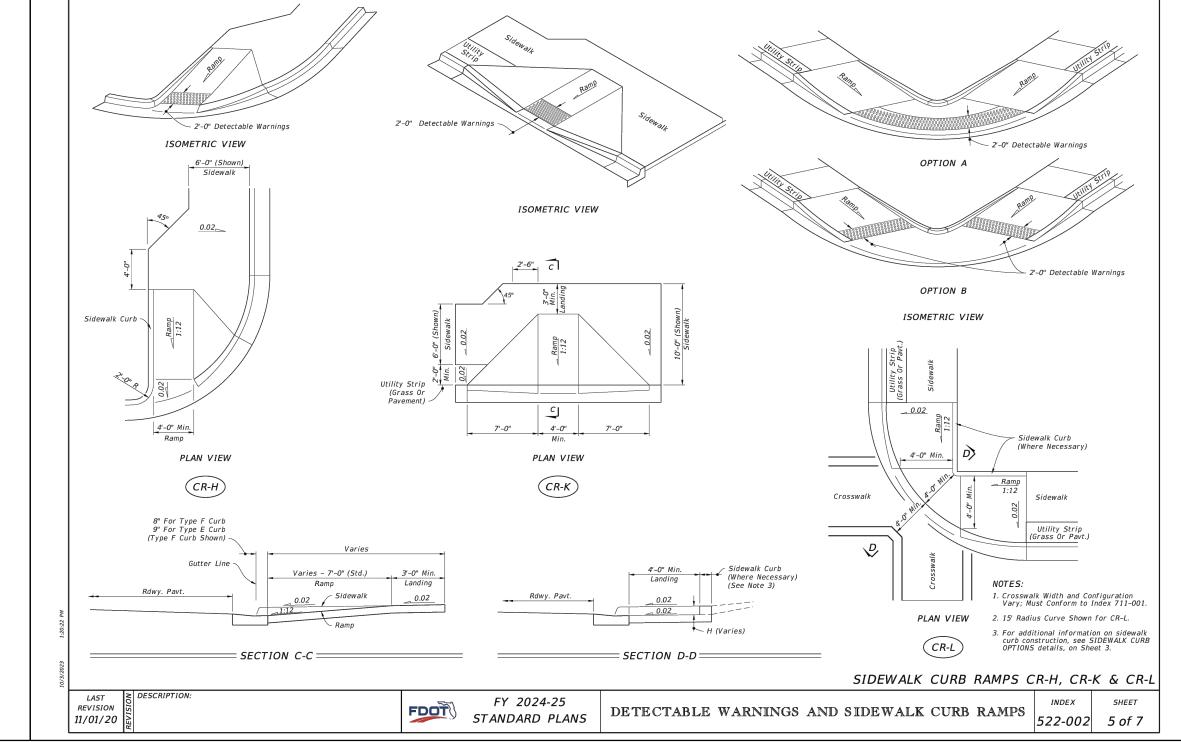


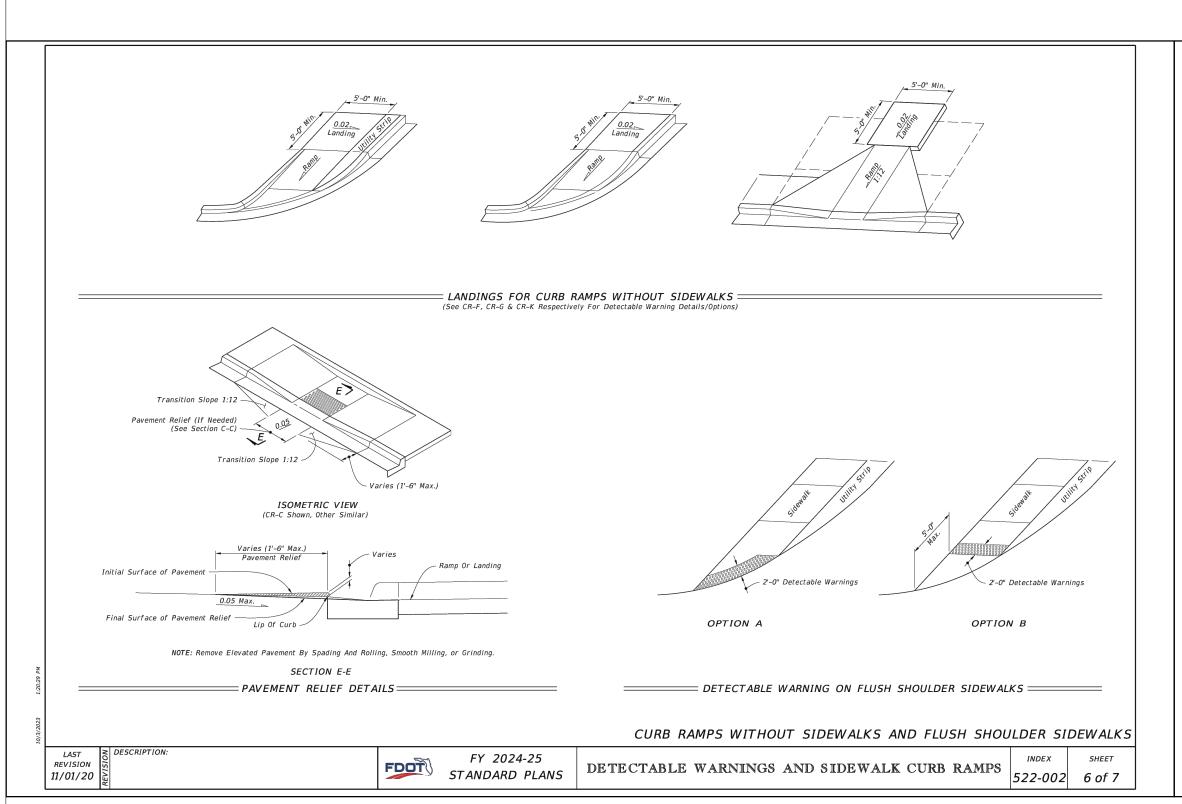


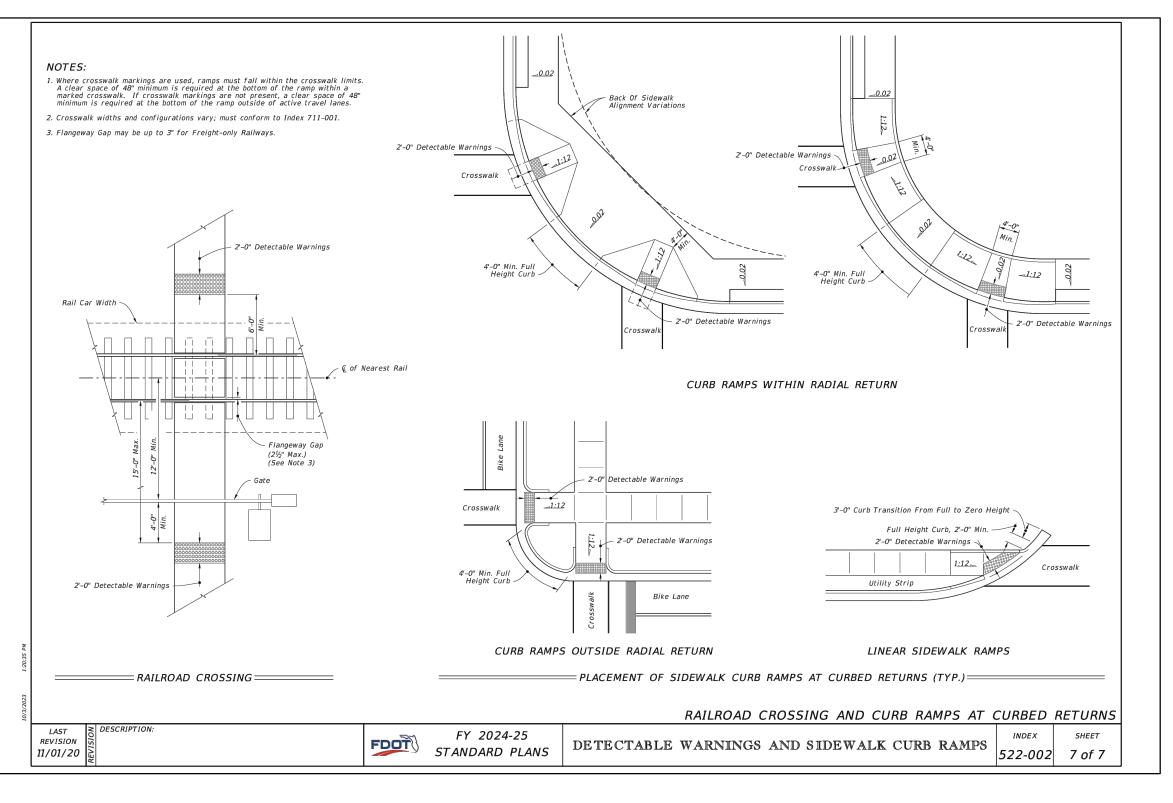












FINAL TAC ELEVATIONS ARE IN NAVD 88

CO5A PAVING, GRADING AND DRAINAGE DETAILS

NOT TO SCALE

2020 SALZEDO STREET, 4TH FLOOR CORAL GABLES, FL 33134

ARCHITECT HKS ARCHITECTS, INC.

INTERIOR DESIGNER HKS ARCHITECTS

225 EAST ROBINSON ST. SUITE #405 ORLANDO, FL 32801

CIVIL & LANDSCAPE CALVIN, GIORDANO & ASSOCIATES 1800 ELLER DRIVE, SUITE 600

FORT LAUDERDALE, FL 33316 STRUCTURAL ENGINEER

GMG STRUCTURAL ENGINEERS 14335 COMMERCE WAY

MIAMI LAKES, FL 33016 **MEP & FIRE PROTECTION** TLC ENGINEERING SOLUTIONS, INC.

800 FAIRWAY DRIVE DEERFIELD BEACH, FL 33441 **TELECOM & EQUIPMENT**


SMITH SECKMAN REID, INC. 2995 SIDCO DRIVE

NASHVILLE, TN 37204 **OWNER** MEMORIAL HEALTHCARE SYSTEM

3501 JOHNSON STREET HOLLYWOOD, FL 33021



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HKS PROJECT NUMBER 23459.000 **AUGUST 19, 2024**

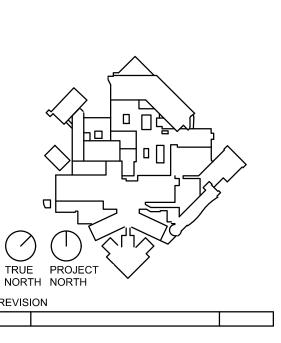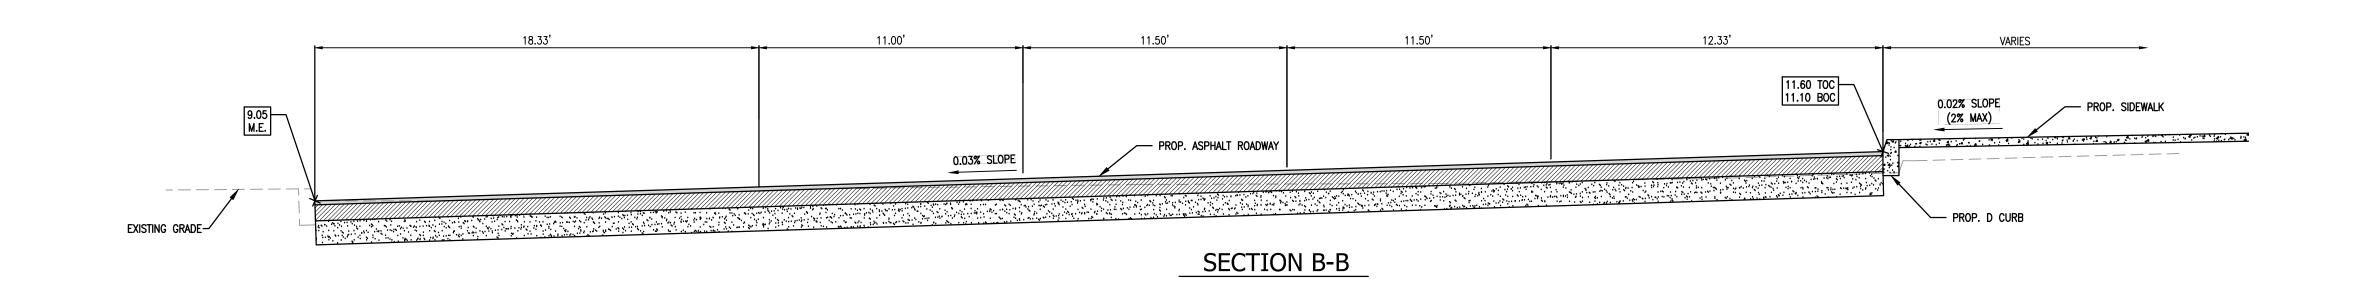
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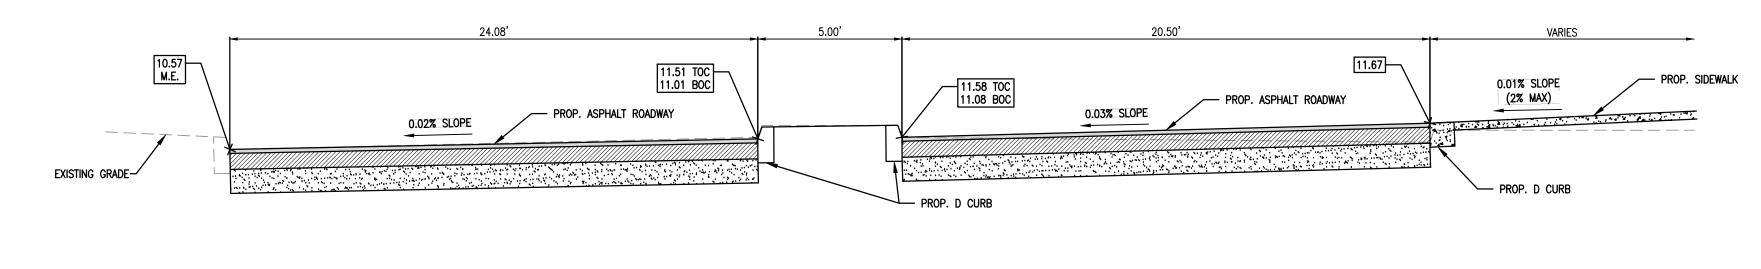
PAVING, GRADING AND **DRAINAGE DETAILS**

C05A


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SECTION A-A






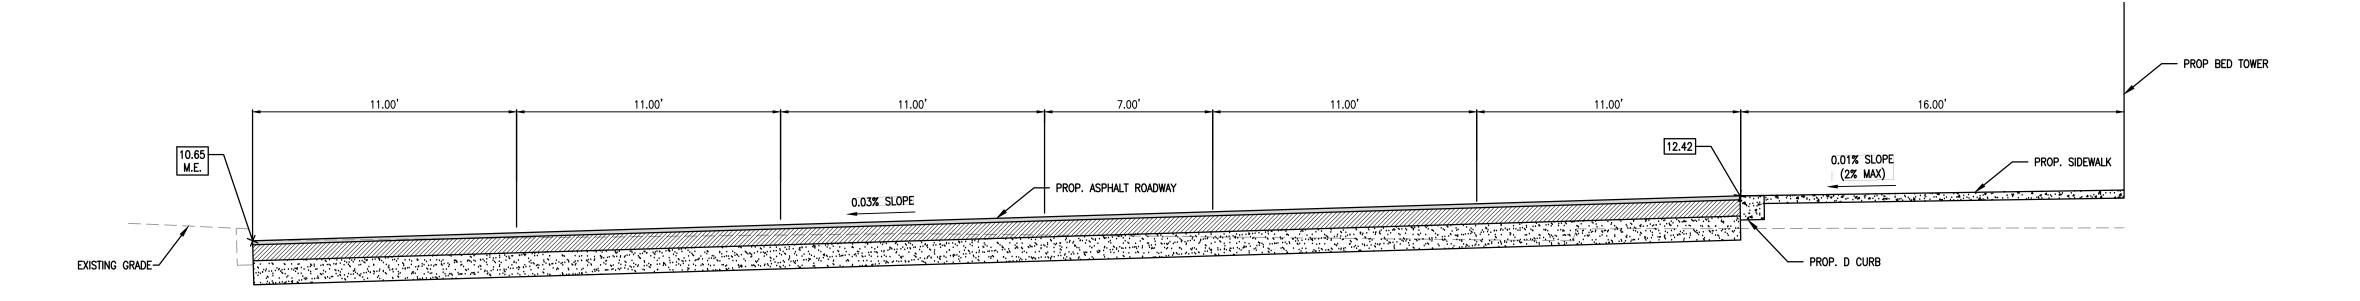SECTION C-C



SECTION D-D

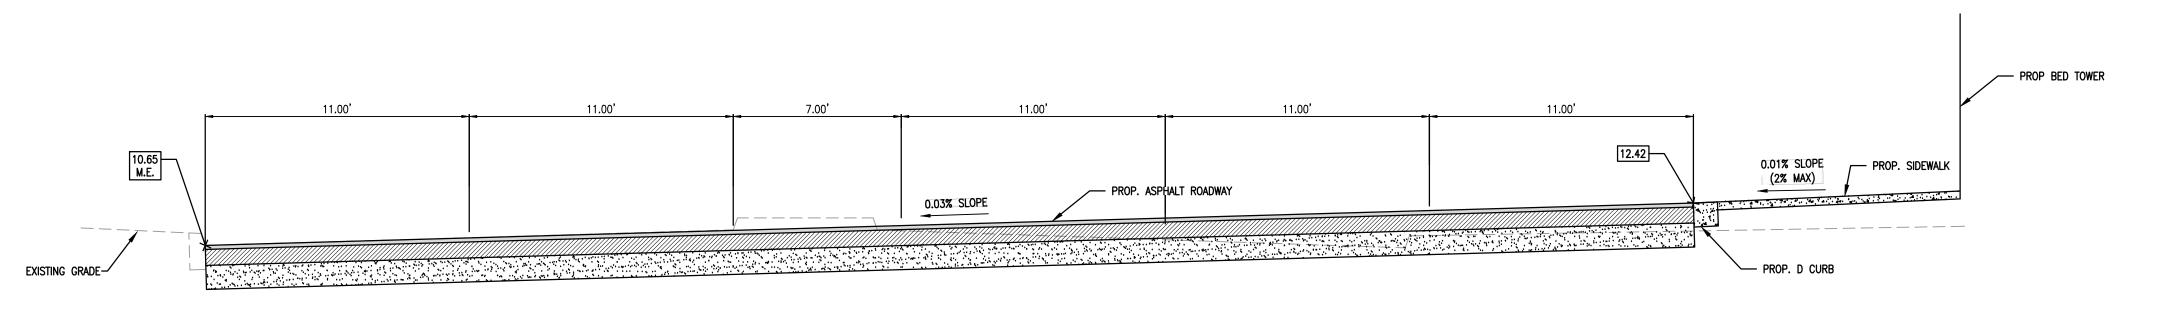

SECTION E-E

FINAL TAC ELEVATIONS ARE IN NAVD 88

CO5B PAVING, GRADING AND DRAINAGE DETAILS

H: 3" = 1'-0" V: 3" = 1'-0"

ARCHITECT

HKS ARCHITECTS, INC. 2020 SALZEDO STREET, 4TH FLOOR CORAL GABLES, FL 33134

INTERIOR DESIGNER

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ORLANDO, FL 32801

CIVIL & LANDSCAPE CALVIN, GIORDANO & ASSOCIATES

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STRUCTURAL ENGINEER GMG STRUCTURAL ENGINEERS

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800 FAIRWAY DRIVE DEERFIELD BEACH, FL 33441


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OWNER

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FINAL TAC PAVING, GRADING AND DRAINAGE DETAILS

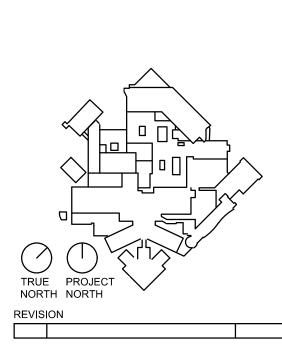SHEET NO.

C05B