



# CRITERIA STATEMENT For the Historic Preservation Board

June 30, 2025

City of Hollywood Planning and Zoning Board 2600 Hollywood Boulevard Hollywood Fl. 33022

Reference: Pothos Bryan House - Historic Home

4220 North 58th Avenue Hollywood, Florida

Architect's Project #24329

#### **Integrity of Location**

The existing 2-story Historical home built in the 1920's is to be carefully restored and repurposed as a library/meeting area for the residential development. This Historical Gem allows visual views from all sides of the surrounding Buildings

#### Design

A partial demolition of external stairs, floor slabs, walls and roof of a more recent addition in the first floor of the building in the areas area and the demolition of the internal stair and second level floor slab with architectural features such as walls, doors, plumbing fixtures, lighting and carpentry (existing windows to remain on facades). We envision a two-story volume internal building ceiling height with a sunroom in the front.

June 30, 2025 Criteria Statement Page Two

#### Setting

The current Historical Building is presently centrally located on the 4.25+/- Acre Site located at 4220 North 58 Avenue. The integration of the House placed in the central courtyard of the development which will provide a Historical Charm and serve as a small amenities building at the core and in the consolidated location of the Site.

#### Materials

The restoration will focus on key architectural features, such as windows with wood shutters, building wood corner guards, roof with wood structural elements, white wood siding for facades and fireplace while making necessary updates to accommodate the needs of a library. This will include areas for reading, study, community events, restrooms, water filing station, A/C and janitor's room. The restoration plan also integrates materials that closely resemble the original materials in appearance but offer greater durability and improved longevity.

#### Workmanship

The proportion of form, space and functionality are simple but sophisticated at the same time. The style is characterized by straight lines, volumes that make a strong imprint of architecture. The workforce must be very careful in order to achieve the necessary quality standards and achieve an energy efficient product and at the same time an environment filled with light, preserving its Historic Charm while ensuring it meets all the updated standards for accessibility, safety and functionality.

#### Association

The Historical residence is located and is incorporated in a perfect manner to the surrounding environment, not only from the existing frontage facing the multi-family buildings.

This home allows visual from all sides to both its residents and neighbors.

Should you have any questions or need anything further, please feel free to contact this office.

Sincerely,

Kaller Architecture

seph B. Kaller, AIA, LEED AP BD+C

President



June 30, 2025

City of Hollywood Department of Planning & Zoning 2600 Hollywood Boulevard Hollywood, Florida 33020

Re:

Pothos Bryan - Historic Home 4220 North 58th Avenue Hollywood, Florida

Architect's Project #24329

### CERTIFICATE OF APPROPRIATENESS FOR PARTIAL DEMOLITION FOR AN EXISTING PORTION OF THE STRUCTURE

The Zoning and Land Development Regulations Section 5.5.F.4.e states the Historic Preservation Board shall consider the following Criteria in evaluating an Application for Certificate of Appropriateness for "partial" Demolition of the rear addition portion of the Home and the main portion of the house will be carefully restored and repurposed to serve as a library for the residential development preserving its Historic Charm while ensuring it meets modern code standards for accessibility, safety and functionality.

CRITERION 1:

The building, structure, improvement, or site is designated on either a National, State or Local level as a Historic Preservation District or an Architectural Landmark or Site.

ANALYSIS: The existing 1920's Pothos Bryan Home is a Historic Residential Landmark to be preserved and retained in the interior courtyard of a Proposed New Multi-Family Development Site.

**CRITERION 2:** 

The building, structure, improvement, or site is of such design, craftsmanship, or material that it could be reproduced only with great difficulty or expense.

June 30, 2025
Partial Demolition
Certificate of Appropriateness.
Page 2

ANALYSIS: The small rear (west) portion of the building that is proposed to be demolished is not original to the building itself. It is an addition that was poorly constructed of wood framing, with low ceilings and no insulation. There is no air conditioning, finished ceilings or floors in the area. The removal of the addition would be done in order to meet the simplicity of the original design of the building, and giving the Historical Structure the presence that it so highly deserves.

#### **CRITERION 3:**

The building, structure, improvement, or site is one of the last remaining examples of its kind in the neighborhood, the county, or the region

ANALYSIS: The existing 2-Story building structure is characterized by the 1920's Southern, craftsman/colonial revival style, and is currently surrounded by others similar in age and varying styles, and varying samples of this particular style exist in the area.

#### **CRITERION 4:**

The building, structure, improvement, or site contributes significantly to the Historic Character of a Historically Designated District.

ANALYSIS: The Historical Building is not located in a Historically significant District, but its adaptive re-use as a library would significantly be seen as a Historic Jewel in the center of the proposed new multi-family development Site.

#### **CRITERION 5:**

Retention of the building, structure, improvement or site promotes the general welfare of the City by providing an opportunity for study of local history, architecture and design or by developing an understanding of the importance and value of a particular culture and heritage.

ANALYSIS: The restoration and renovation of the existing Two-Story Historic Building in its original Site location promotes the general welfare of the City by providing an opportunity for the study of local Florida History, Architecture and Design and understanding the importance and value of Historic Architecture within our Community.

June 30, 2025
Partial Demolition
Certificate of Appropriateness.
Page 3

**CRITERION 6:** 

There are definite plans for reuse of the property if the proposed demolition is carried out, and those plans will adversely affect the historic character of the Historic District.

ANALYSIS: Since the existing Historic Building will be retained, restored and re-purpose, it will enhance the immediate area and yet preserve the structures Historical Charm.

**CRITERION 7:** 

The Unsafe Structures Board has ordered the demolition of a structure or the feasibility study determines that the retention of the building would deny the Owner of all economically viable uses of the Property.

ANALYSIS: This has not been reviewed by the Unsafe Structures Board.

**CRITERION 8:** 

The information listed in the Historic Properties Database (a listing of historic and non-historic properties), as a guideline in determining whether a certification of Appropriateness for Demolition should be issued.

ANALYSIS: The information listed in the Historic Properties database, reflects this structure to be considered as a Historic Home that was built in the early 1900's, and therefore the Certificate of Appropriateness for "partial" demolition should be considered.

Should you have any questions, please feel free to contact our office at any time.

Sincerely,

Kaller Architecture

Joseph B. Kaller, AIA, LEED AP BD+C

President

# **ARCHITECT**

JOSEPH KALLER KALLER ARCHITECTURE AA#26001212 2417 Hollywood Blvd. Hollywood Florida 33020 954.920.5746 joseph@kallerarchitects.com www.kallerarchitects.com

**CIVIL ENGINEER** 

STRUCTURAL ENGINEER

LANDSCAPE ARCHITECT

**MEP ENGINEERS** 



www.kallerarchitects.com

Kaller Architecture

2417 Hollywood Blvd. Hollywood Florida 33020

# HISTORICAL HOUSE

4220 N 58TH AVENUE., HOLLYWOOD, FL.

# **SCOPE OF WORK**

The building will be partially demolished, carefully restored and repurposed to serve as a library for the residential development in the lot area, preserving its historical charm while ensuring it meets modern standards for accessibility, safety, and functionality.

A partial demolition of external stairs, floors slabs, walls and roof of a more recent addition in the first floor of the building in the rear area and the demolition of the internal stair and second level floor slab with architectural features such as walls, door, plumbing fixtures, lighting and carpentry (existing windows to remain on facades). We envision a two-story building height with a sunroom in

The restoration will focus on key architectural features, such as windows with wood shutters, building wood corners guards, roof with wood structural elements, white wood siding for facades and fireplace while making necessary updates to accommodate the needs of a library. This will include areas for reading, study, community events, restrooms, water filling station, A/C and janitor's room. The restoration plan also integrate materials that closely resemble the original materials in appearance but offer greater durability and improved longevity.

- A. Architectural Review and Restoration: evaluating and restoring the building's historical features, including the façades, original windows, and unique external and internal architectural
- B. Structural Reinforcement: The building's structural integrity will be reinforced as per civil specifications as the second and third floor slab will be removed.
- C. Material Conservation: Where possible, original building materials will be preserved. In cases of deterioration, we will use historically appropriate materials to ensure consistency with the building's original design.
- D. Adaptive Reuse: The library's design will adapt the space for modern use while minimizing disruptions to the building's original layout. Key historical elements will remain prominent, and any upgrades (e.g., electrical systems, HVAC) will be carefully integrated to avoid impacting the building's character.

# **PROJECT + ZONING INFORMATION**

# **ZONING INFORMATION**

**BUILDING INFORMATION** 

REAR SETBACK

ADDRESS: 4220 N 58TH AVENUE., HOLLYWOOD, FL. 33021 FOLIO NUMBER(S): LAND USE: TRANSIT ORIENTED CORRIDOR **ZONING DISTRICT:** JURISDICTION: CITY OF HOLLYWOOD + BROWARD COUNTY + FLORIDA 7' NAVD88 BASE FLOOD ELEVATION: LOT AREA: 184,748 S.F. (BCPA)

BUILDING HEIGHT	65'	25' 10"
OCCUPANCY CLASSIFICATION	<u>R-1</u>	<u>A-3</u>
SETBACKS	ALLOWED	PROPOSED
PRIMARY FRONT SETBACK	15'-0"	Existing to remain
SIDE SETBACK (NORTH)	15'-0"	Existing to remain
SIDE SETBACK (SOUTH)	15'-0"	Existing to remain

**ALLOWED** 

# PROJECT FLOOD ZONE INFORMATION

AH, X 0.2 Percent Annual FLOOD ZONE Chance Flood Hazard

# **DESIGN FLOOD ELEVATION:**

FEMA BASE FLOOD ELEVATION: 7.00' NAVD88 CROWN OF ROAD ELEVATION 13.14' NAVD88 PROPOSED FINISH FLOOR ELEVATION (F.F.E) 14.32' NAVD




	SHELLIVAME		DAIL
T-0.00	COVER SHEET	3	6-31-25
	1. SITE		
SHEET NO.	SHEET NAME	REV#	LAST REVISION DATE
SP-1.00	PROPOSED SITE PLAN	3	6-31-25
SP-2.00	CONSTRUCTION PROTECTION PLAN		
	3. ARCHITECTURE (EXISTING & DEMOLITION)		
SHEET NO.	SHEET NAME	REV#	LAST REVISION DATE
D-1.00	DEMOLITION -FIRST LEVEL PLAN	3	6-31-25
D-1.01	DEMOLITION - SECOND LEVEL PLAN	3	6-31-25
D-1.02	DEMOLITION ROOF PLAN	3	6-31-25
D-3.00	DEMOLITION EAST & WEST BUILDING ELEVATIONS	3	6-31-25
D-3.01	DEMOLITION NORTH & SOUTH BUILDING ELEVATIONS	3	6-31-25
	3. ARCHITECTURE (PROPOSED)		
SHEET NO.	SHEET NAME	REV#	LAST REVISION DATE
A-1.00	EXISTING AND PROPOSED FIRST LEVEL FLOOR PLAN	3	6-31-25
A-1.01	EXISTING AND PROPOSED ROOF PLAN	3	6-31-25
A-3.00	EXISTING AND PROPOSED - EAST BUILDING ELEVATIONS	3	6-31-25
A-3.01	EXISTING AND PROPOSED - WEST BUILDING ELEVATIONS	3	6-31-25
A-3.02	EXISTING AND PROPOSED NORTH BUILDING ELEVATIONS	3	6-31-25
A-3.03	EXISTING AND PROPOSED SOUTH BUILDING ELEVATIONS	3	6-31-25
A-3.10	COLORED EAST & WEST ELEVATIONS	2	4-1-25
A-3.11	COLORED NORTH & SOUTH BUILDING ELEVATIONS	2	4-1-25
A-4.01	EAST & NORTH BUILDING SECTIONS		
A-4.02	DETAILS	2	4-1-25
A-5.00	3D PERSPECTIVES		
710.00			
A-5.01	3D PERSPECTIVES CONT.		
	3D PERSPECTIVES CONT.  RENDERING 1		

SHEET NAME

SHEET NO.

**PROPOSED** 


Existing to remain

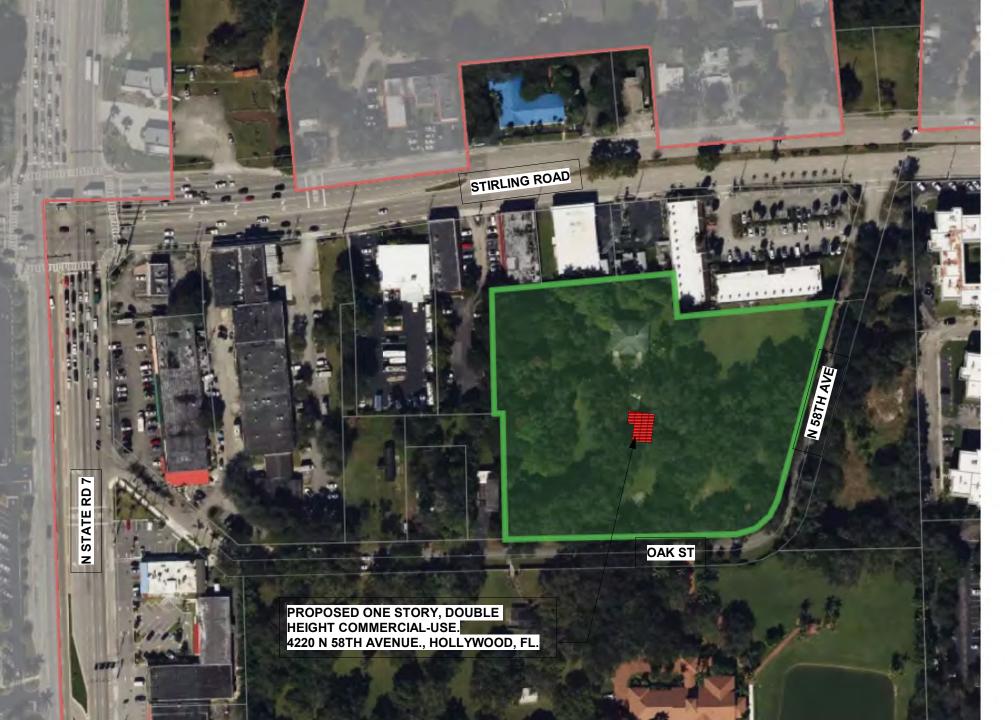

**DRAWINGS INDEX** 

REV# LAST REVISION

**PROPERTY MAP** 

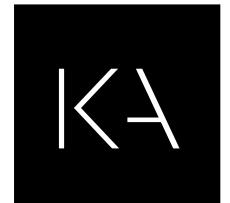

Kaller Architecture

2417 Hollywood Blvd. Hollywood Florida 33020 954.920.5746 joseph@kallerarchitects.com

www.kallerarchitects.com

JOSEPH B. KALLER

HOUSE


**REVISIONS** 

3 REV 3 - TAC COMM. 6-31-25

This drawing, as an instrument of service, is and shall remain the property of the Architect and shall not be reproduced, published or

PROJECT No.:

DRAWN BY: CHECKED BY:

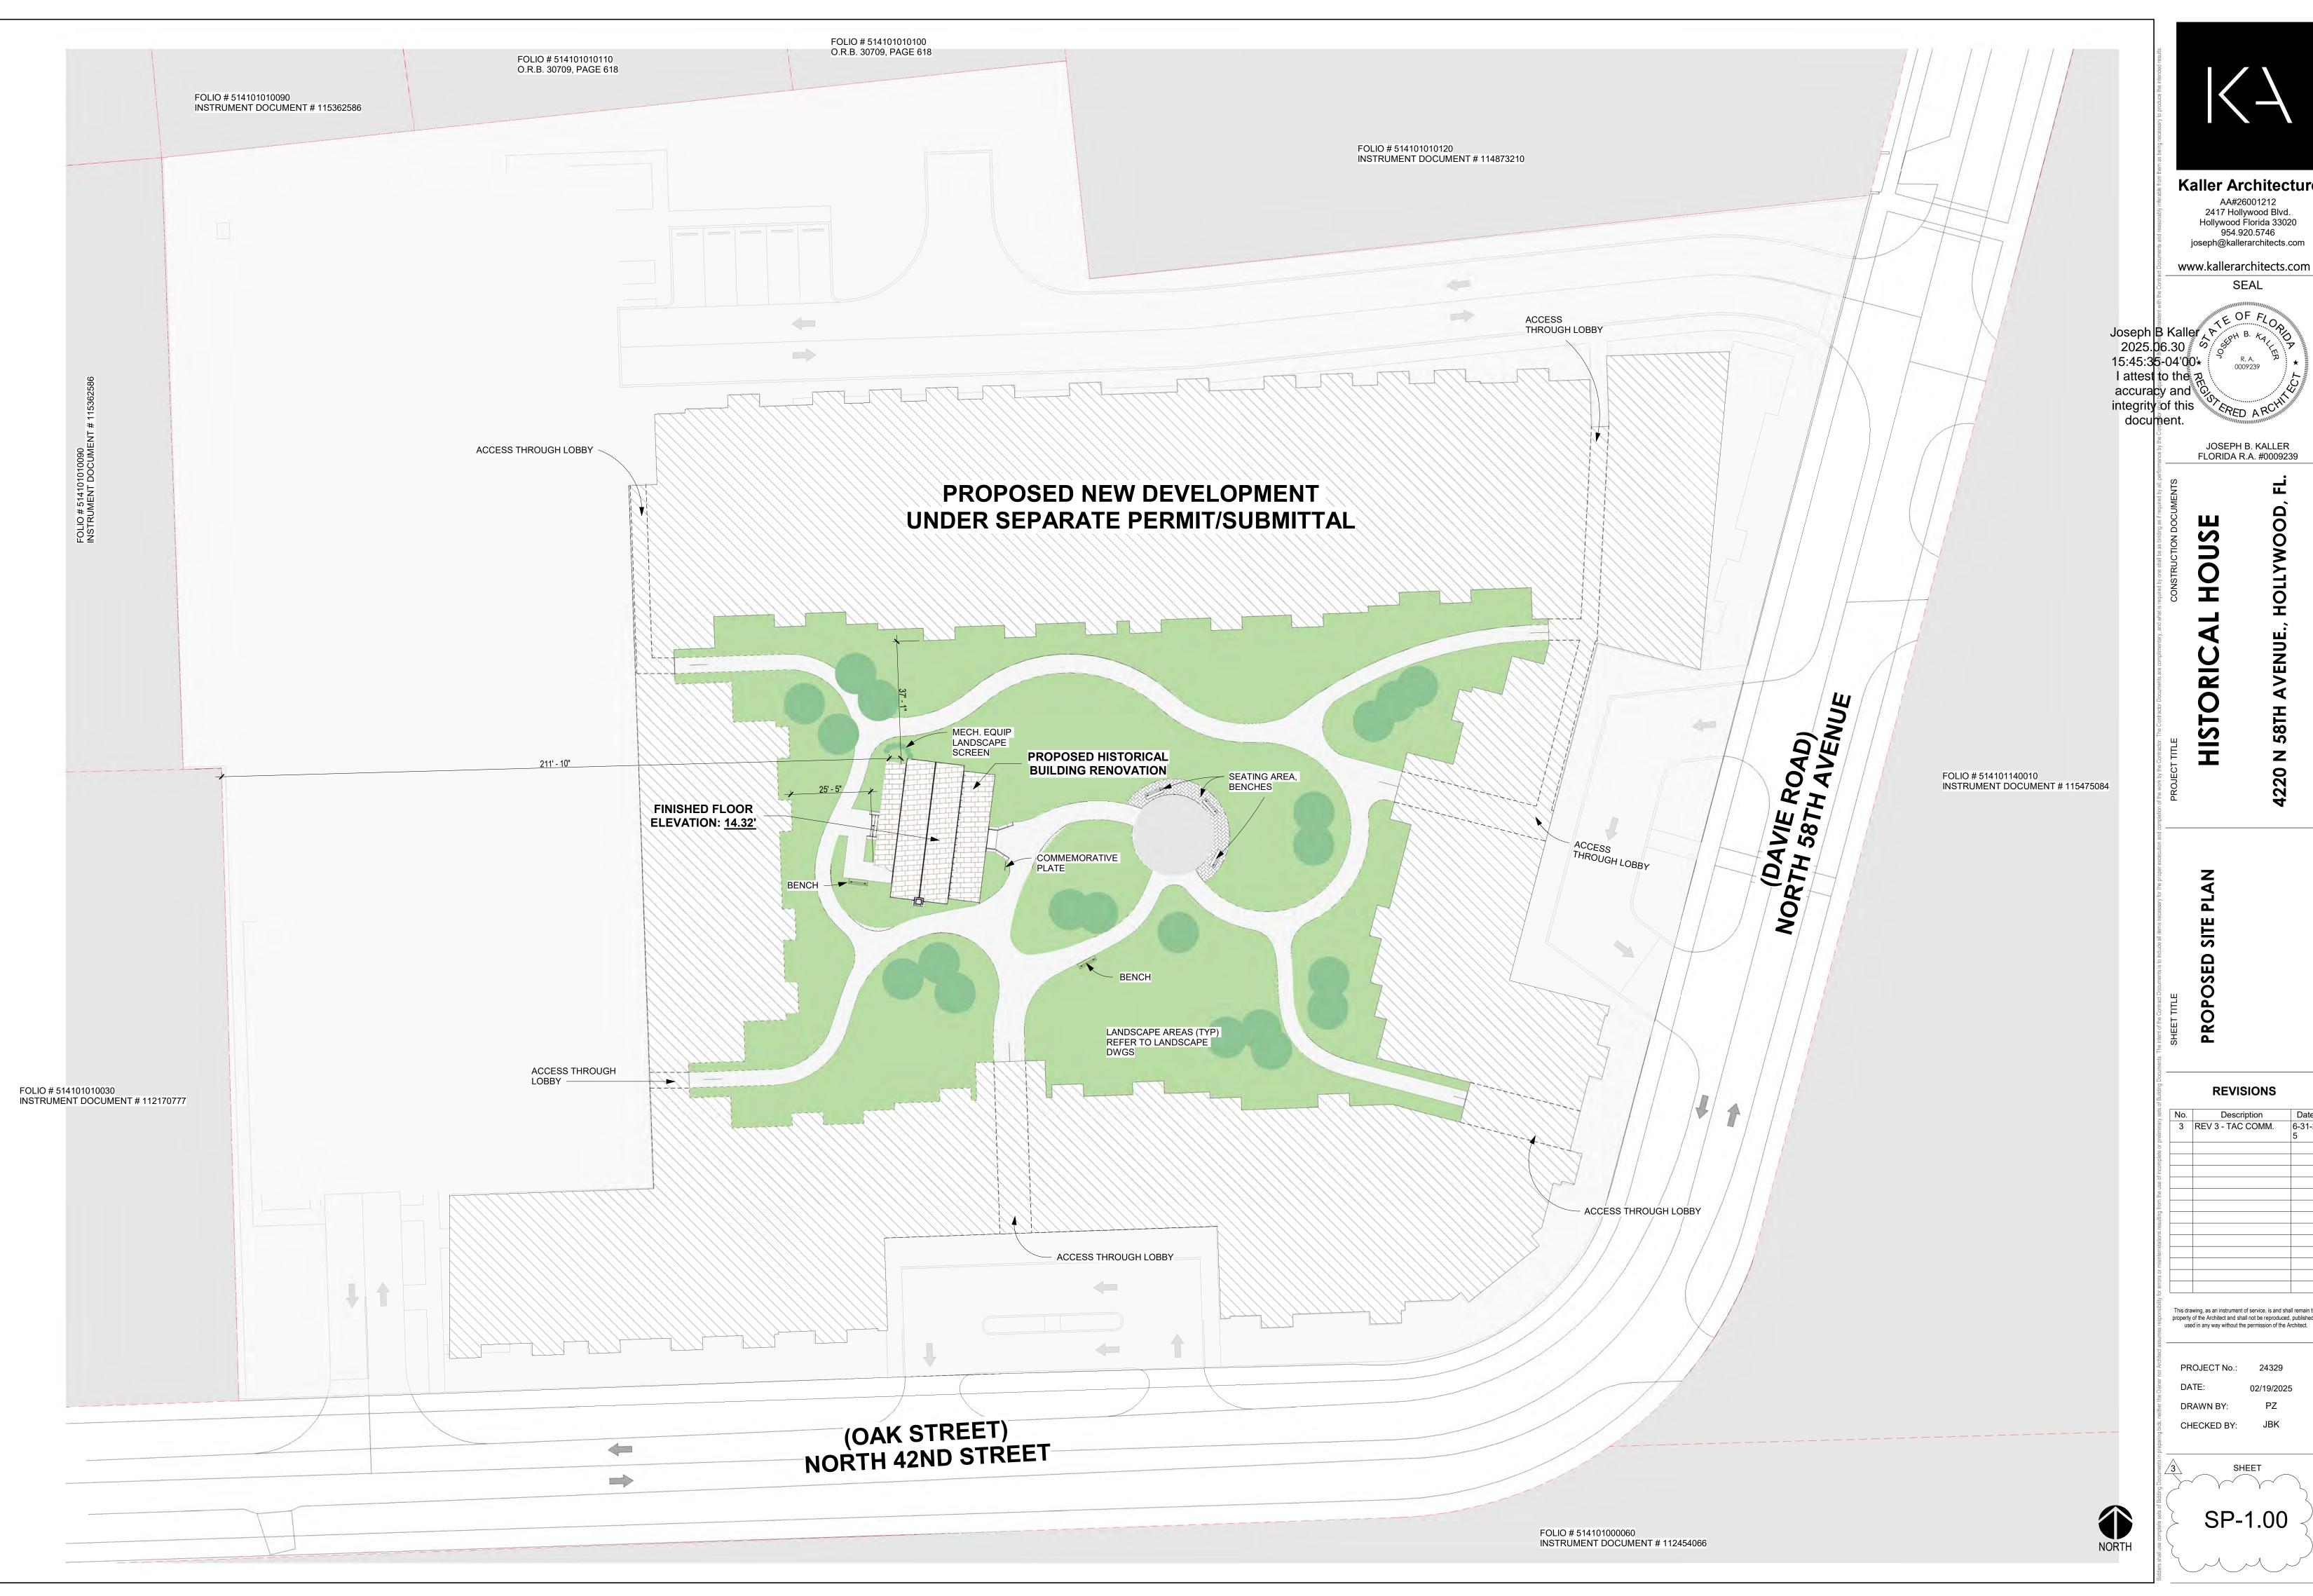



JOSEPH B. KALLER FLORIDA R.A. #0009239

**REVISIONS** 

3 REV 3 - TAC COMM.

This drawing, as an instrument of service, is and shall remain the property of the Architect and shall not be reproduced, published or used in any way without the permission of the Architect.

CHECKED BY:



Kaller Architecture

AA#26001212
2417 Hollywood Blvd.

AA#26001212 2417 Hollywood Blvd. Hollywood Florida 33020 954.920.5746 joseph@kallerarchitects.com

www.kallerarchitects.com

JOSEPH B. KALLER FLORIDA R.A. #0009239

FLORIDA R.A. #0009239

Ö, Fi.

CAL HOUSE

HISTORIC

CONSTRUCTION ROTECTION PLAN

No.	Description	Da

This drawing, as an instrument of service, is and shall remain the property of the Architect and shall not be reproduced, published or used in any way without the permission of the Architect.

PROJECT No.: 24329

DATE: 02/19/202


DRAWN BY: PZ

CHECKED BY: JBK

SHEET

SP-2.00

CONSTRUCTION PROTECTION PLAN

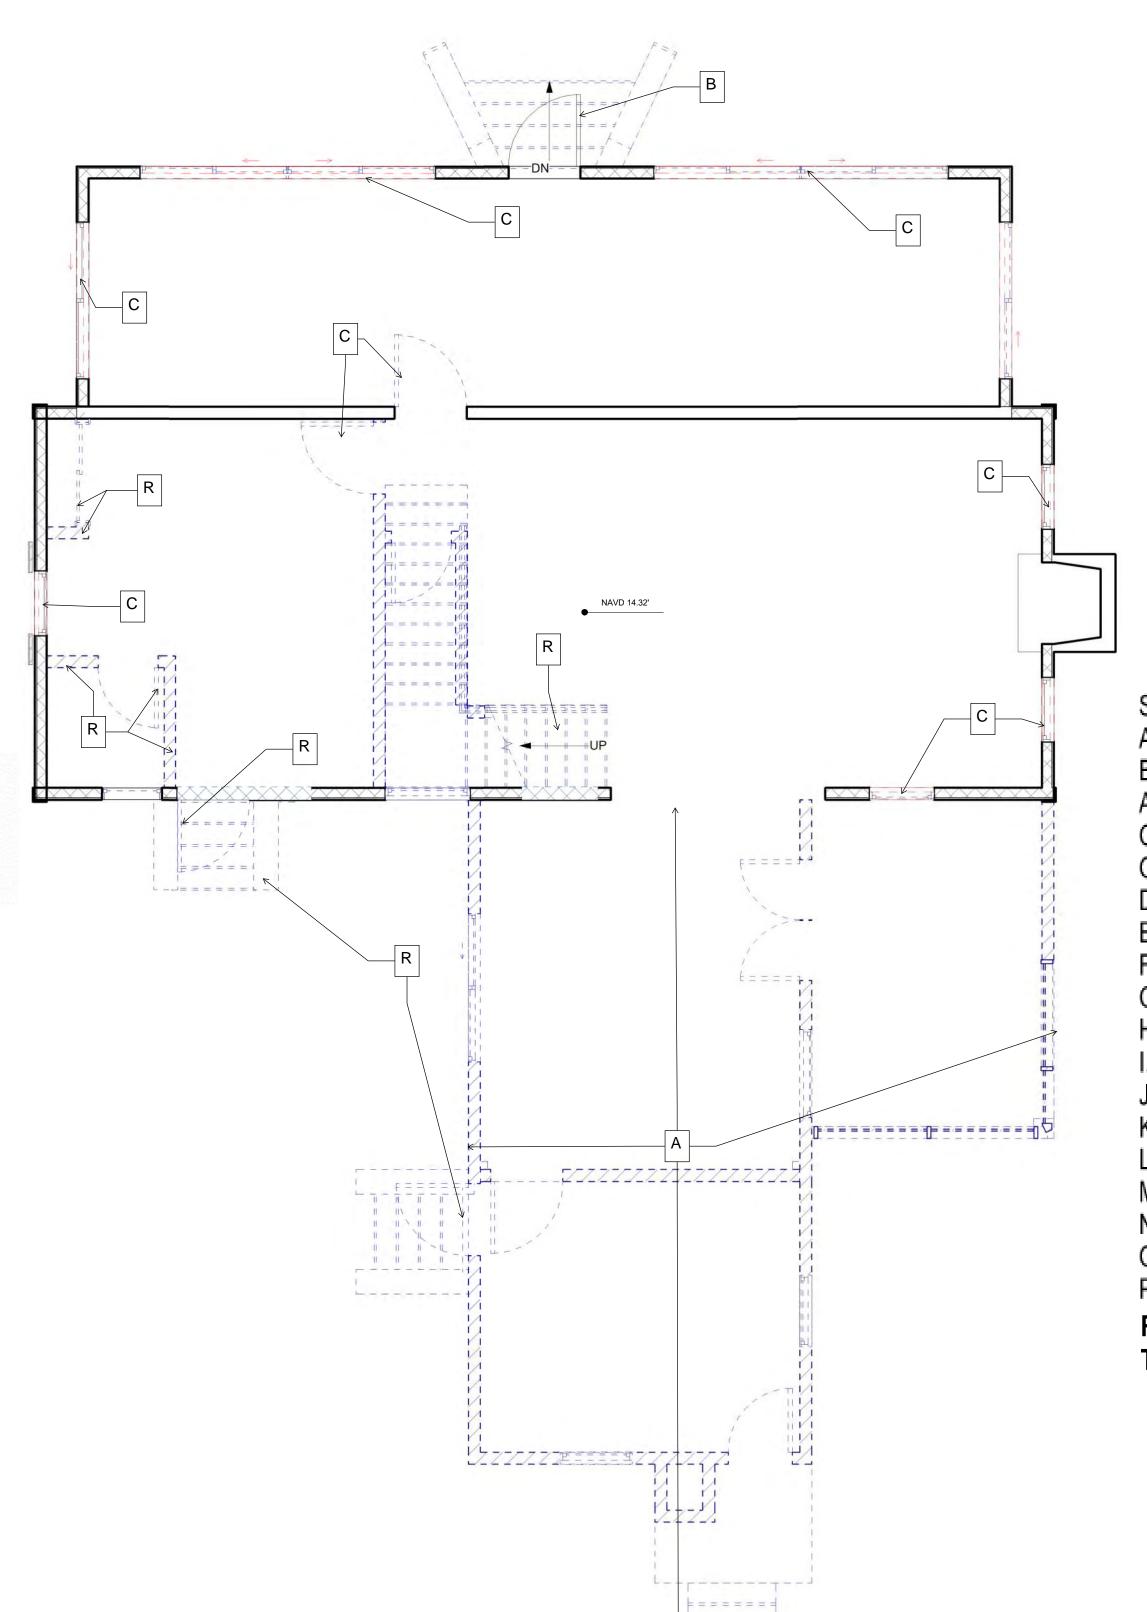

A. DEMOLITION OF WEST ADDITION PRESERVING THE REST OF BUILDING

B. DEMOLITION OF EXISTING ENTRANCE STAIR, BUILDING A NEW ENTRANCE STAIR TO BE SIMILAR IN DESIGN IN COMPLIANCE WITH FBC AND FLORIDA

C. REPLACING ALL DOORS AND WINDOWS TO MATCH EXISTING STYLE, DIMENSIONS WITH IMPACT RESISTANT TYPE, IN COMPLIANCE WITH FBC AND OTHER APPLICABLE CODES.

D. REPLACING ROOF SHINGLES AND BUILDING AN ADDITION WEST SIDE OF THE BUILDING.

E. NEW WEST STAIR AND RAILING

F. ADA VERTICAL LIFT

G. REPLACE ALL DAMAGED WOOD SIDING TO MATCH STYLE AND DIMENSIONS.

H. NEW PAINT ALL EXTERIOR SIDING

I. REPAIR, REFURBISH ALL EXTERIOR SHUTTERS

J. BUILD TWO NEW ADA BATHROOMS TO COMPLY WITH FBC AND FLORIDA ACCESSIBILITY CODE.

K. REMOVING SECOND FLOOR TO CREATE A CATHEDRAL SPACE (DOUBLE HEIGHT) IN LIBRARY ROOM.

L. ADDING AN AC UNIT WITHIN A CLOSET AND EXTERIOR CONDENSER.

M. ADDING DRINKING FOUNTAIN WITH BOTTLE FILLER

N. PAINTING ALL INTERIOR SPACES AFTER REPARING INTERIOR EXISTING WALLS

O. NEW LIGHTING FIXTURES

P. REPAIRING EXTERIOR ARCHITECTURAL ELEMENTS (EDGE OF RAFTERS, BANDING, MOLDING)

R. REMOVE INTERIOR WALLS, STAIRS, DOORS AND WINDOWS (INTERIOR AND EXTERIOR). PATCH AND REPAIR WALLS TO REMAIN. PREPARE THE WALLS FOR PAINT. REFER TO COLOR SCHEME FOR PAINT.

EXISTING TO REMAIN

**LINE TYPES LEGEND** 

---- DEMOLISH EXISTING ROOF/ WALLS / STAIRS / DOORS / WINDOWS

ALL EXISTING WINDOWS TO BE REPLACED BY IMPACT GLASS WINDOWS WITH THE SAME SIZE OPENING AS EXISTING

**Kaller Architecture** 2417 Hollywood Blvd. Hollywood Florida 33020 954.920.5746

www.kallerarchitects.com

joseph@kallerarchitects.com

JOSEPH B. KALLER FLORIDA R.A. #0009239

**REVISIONS** 

No.	Description	Date
2	TAC COMM.	4-1-2
3	REV 3 TAC COMM.	6.31.2

This drawing, as an instrument of service, is and shall remain the property of the Architect and shall not be reproduced, published o


PROJECT No.: DRAWN BY:

CHECKED BY:

D-1.00

www.

DEMOLITION FIRST LEVEL PLAN

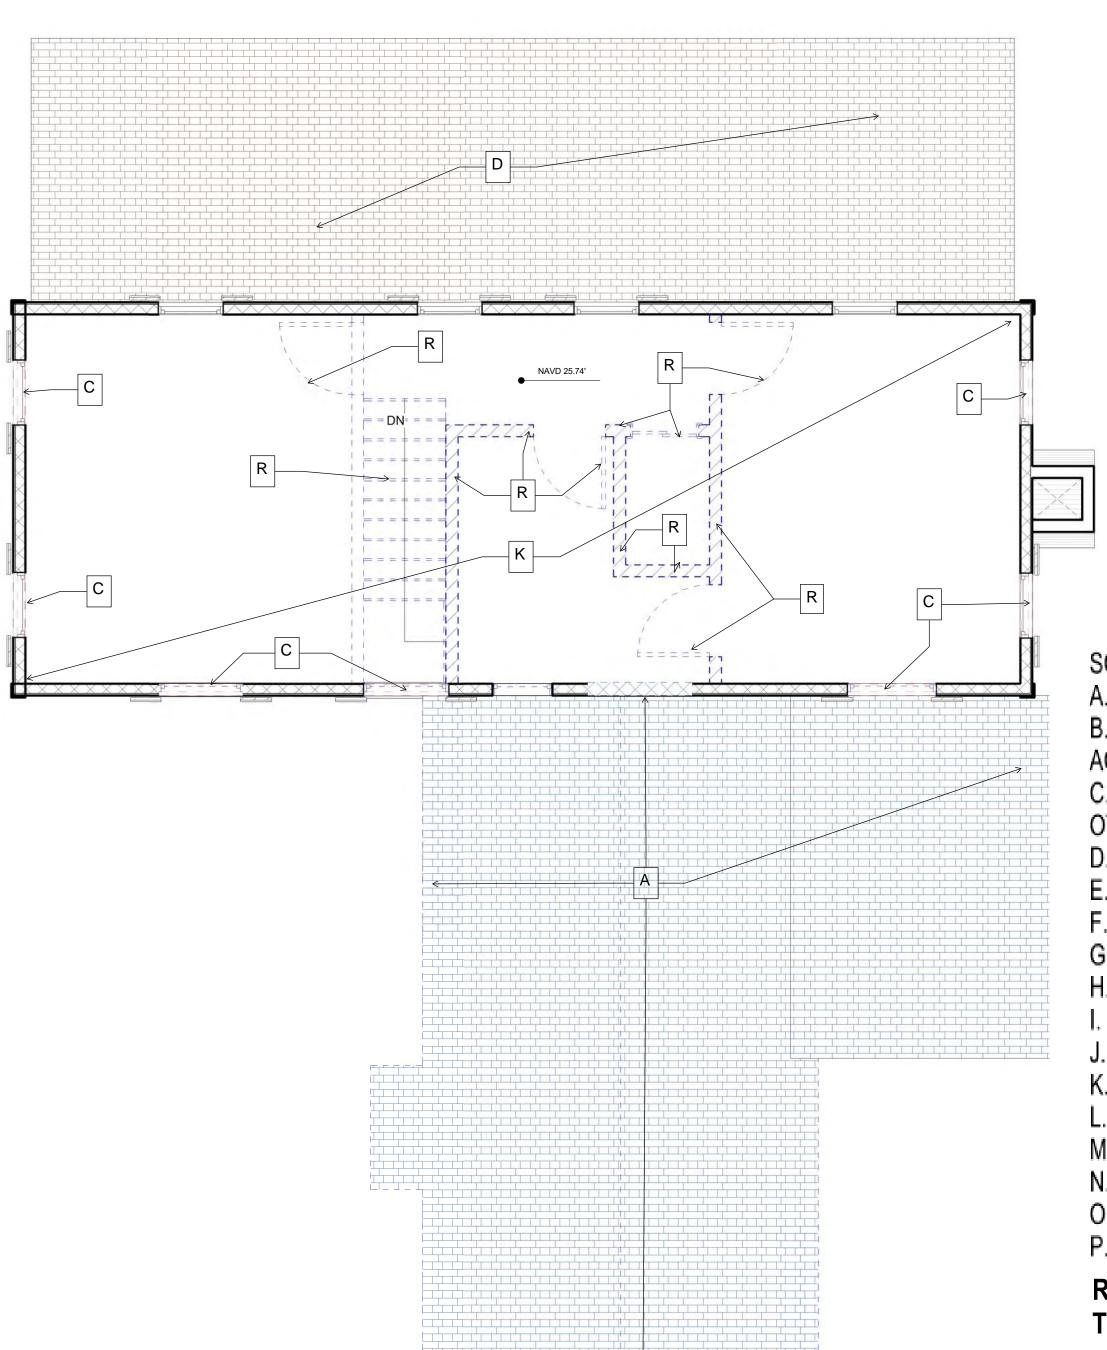

A. DEMOLITION OF WEST ADDITION PRESERVING THE REST OF BUILDING

B. DEMOLITION OF EXISTING ENTRANCE STAIR, BUILDING A NEW ENTRANCE STAIR TO BE SIMILAR IN DESIGN IN COMPLIANCE WITH FBC AND FLORIDA ACCESSIBILITY CODE

C. REPLACING ALL DOORS AND WINDOWS TO MATCH EXISTING STYLE, DIMENSIONS WITH IMPACT RESISTANT TYPE, IN COMPLIANCE WITH FBC AND OTHER APPLICABLE CODES.

D. REPLACING ROOF SHINGLES AND BUILDING AN ADDITION WEST SIDE OF THE BUILDING.

E. NEW WEST STAIR AND RAILING

F. ADA VERTICAL LIFT

G. REPLACE ALL DAMAGED WOOD SIDING TO MATCH STYLE AND DIMENSIONS.

H. NEW PAINT ALL EXTERIOR SIDING

I. REPAIR, REFURBISH ALL EXTERIOR SHUTTERS

J. BUILD TWO NEW ADA BATHROOMS TO COMPLY WITH FBC AND FLORIDA ACCESSIBILITY CODE.

K. REMOVING SECOND FLOOR TO CREATE A CATHEDRAL SPACE (DOUBLE HEIGHT) IN LIBRARY ROOM.

L. ADDING AN AC UNIT WITHIN A CLOSET AND EXTERIOR CONDENSER.

M. ADDING DRINKING FOUNTAIN WITH BOTTLE FILLER

N. PAINTING ALL INTERIOR SPACES AFTER REPARING INTERIOR EXISTING WALLS

O. NEW LIGHTING FIXTURES

P. REPAIRING EXTERIOR ARCHITECTURAL ELEMENTS (EDGE OF RAFTERS, BANDING, MOLDING)

R. REMOVE INTERIOR WALLS, STAIRS. PATCH AND REPAIR WALLS TO REMAIN. PREPARE THE WALLS FOR PAINT. REFER TO COLOR SCHEME FOR PAINT.

# **LINE TYPES LEGEND**

EXISTING TO REMAIN

---- DEMOLISH EXISTING ROOF/ WALLS / STAIRS / DOORS / WINDOWS

ALL EXISTING WINDOWS TO BE REPLACED BY IMPACT GLASS WINDOWS WITH THE SAME SIZE OPENING AS EXISTING

Kaller Architecture AA#26001212 2417 Hollywood Blvd. Hollywood Florida 33020 954.920.5746

www.kallerarchitects.com

joseph@kallerarchitects.com

JOSEPH B. KALLER

FLORIDA R.A. #0009239

SE

DEMOLITION SECOND LEVEL PLAN

**REVISIONS** 

No.	Description	Date
2	TAC COMM.	4-1-2
3	REV 3 TAC COMM.	6.31.2

This drawing, as an instrument of service, is and shall remain the property of the Architect and shall not be reproduced, published or

PROJECT No.:

CHECKED BY:

D-1.01

www

DEMOLITION SECOND LEVEL PLAN

======

SCOPE OF WORK:

A. DEMOLITION OF WEST ADDITION PRESERVING THE REST OF BUILDING

B. DEMOLITION OF EXISTING ENTRANCE STAIR, BUILDING A NEW ENTRANCE STAIR TO BE SIMILAR IN DESIGN IN COMPLIANCE WITH FBC AND FLORIDA ACCESSIBILITY CODE

C. REPLACING ALL DOORS AND WINDOWS TO MATCH EXISTING STYLE, DIMENSIONS WITH IMPACT RESISTANT TYPE, IN COMPLIANCE WITH FBC AND OTHER APPLICABLE CODES.

D. REPLACING ROOF SHINGLES AND BUILDING AN ADDITION WEST SIDE OF THE BUILDING.

E. NEW WEST STAIR AND RAILING

F. ADA VERTICAL LIFT

G. REPLACE ALL DAMAGED WOOD SIDING TO MATCH STYLE AND DIMENSIONS.

H. NEW PAINT ALL EXTERIOR SIDING

I. REPAIR, REFURBISH ALL EXTERIOR SHUTTERS

J. BUILD TWO NEW ADA BATHROOMS TO COMPLY WITH FBC AND FLORIDA ACCESSIBILITY CODE.

K. REMOVING SECOND FLOOR TO CREATE A CATHEDRAL SPACE (DOUBLE HEIGHT) IN LIBRARY ROOM.

L. ADDING AN AC UNIT WITHIN A CLOSET AND EXTERIOR CONDENSER.

M. ADDING DRINKING FOUNTAIN WITH BOTTLE FILLER

N. PAINTING ALL INTERIOR SPACES AFTER REPARING INTERIOR EXISTING WALLS

O. NEW LIGHTING FIXTURES

P. REPAIRING EXTERIOR ARCHITECTURAL ELEMENTS (EDGE OF RAFTERS, BANDING, MOLDING)

R. REMOVE INTERIOR WALLS, STAIRS. PATCH AND REPAIR WALLS TO REMAIN. PREPARE THE WALLS FOR PAINT. REFER TO COLOR SCHEME FOR PAINT.

**LINE TYPES LEGEND** 

EXISTING TO REMAIN

---- DEMOLISH EXISTING ROOF/ WALLS / STAIRS / DOORS / WINDOWS

ALL EXISTING WINDOWS TO BE REPLACED BY IMPACT GLASS WINDOWS WITH THE SAME SIZE OPENING AS EXISTING

**Kaller Architecture** AA#26001212 2417 Hollywood Blvd. Hollywood Florida 33020 954.920.5746

joseph@kallerarchitects.com www.kallerarchitects.com

JOSEPH B. KALLER

FLORIDA R.A. #0009239

SE HOU HISTORIC

DEMOI

	REVISIONS	
No.	Description	Date
2	TAC COMM.	4-1-25
3	REV 3 TAC COMM.	6.31.25

property of the Architect and shall not be reproduced, published o

PROJECT No.:

CHECKED BY:

D-1.02

1/4" = 1'-0"

# SCOPE OF WORK:

A. DEMOLITION OF WEST ADDITION PRESERVING THE REST OF BUILDING

B. DEMOLITION OF EXISTING ENTRANCE STAIR, BUILDING A NEW ENTRANCE STAIR TO BE SIMILAR IN DESIGN IN COMPLIANCE WITH FBC AND FLORIDA ACCESSIBILITY CODE

C. REPLACING ALL DOORS AND WINDOWS TO MATCH EXISTING STYLE, DIMENSIONS WITH IMPACT RESISTANT TYPE, IN COMPLIANCE WITH FBC AND OTHER APPLICABLE CODES.

D. REPLACING ROOF SHINGLES AND BUILDING AN ADDITION WEST SIDE OF THE BUILDING.

E. NEW WEST STAIR AND RAILING

F. ADA VERTICAL LIFT

G. REPLACE ALL DAMAGED WOOD SIDING TO MATCH STYLE AND DIMENSIONS.

H. NEW PAINT ALL EXTERIOR SIDING

I. REPAIR, REFURBISH ALL EXTERIOR SHUTTERS

J. BUILD TWO NEW ADA BATHROOMS TO COMPLY WITH FBC AND FLORIDA ACCESSIBILITY CODE.

K. REMOVING SECOND FLOOR TO CREATE A CATHEDRAL SPACE (DOUBLE HEIGHT) IN LIBRARY ROOM.

L. ADDING AN AC UNIT WITHIN A CLOSET AND EXTERIOR CONDENSER.

M. ADDING DRINKING FOUNTAIN WITH BOTTLE FILLER

N. PAINTING ALL INTERIOR SPACES AFTER REPAIRING INTERIOR EXISTING WALLS

O. NEW LIGHTING FIXTURES

P. REPAIRING EXTERIOR ARCHITECTURAL ELEMENTS (EDGE OF RAFTERS, BANDING, MOLDING).

R. REMOVE INTERIOR WALLS, STAIRS. PATCH AND REPAIR WALLS TO REMAIN. PREPARE THE WALLS FOR PAINT. REFER TO COLOR SCHEME FOR PAINT.



Kaller Architecture AA#26001212

2417 Hollywood Blvd. Hollywood Florida 33020 954.920.5746 joseph@kallerarchitects.com

www.kallerarchitects.com

TE OF FL Joseph B Kaller 2025.06.30 15:45:54-04'00'\ R. A. 0009239 I attest to the ス accuracy and co integrity of this ERED / document.

JOSEPH B. KALLER FLORIDA R.A. #0009239

SE 0

ISTORIC,

DEMOLITION EAST & WEST BUILDING ELEVATIONS

**REVISIONS** 


No.	Description	Date
2	TAC COMM.	4-1-25
3	REV 3 TAC COMM.	6.31.25

This drawing, as an instrument of service, is and shall remain the property of the Architect and shall not be reproduced, published or used in any way without the permission of the Architect.

PROJECT No.: DRAWN BY:

CHECKED BY:

D-3.00

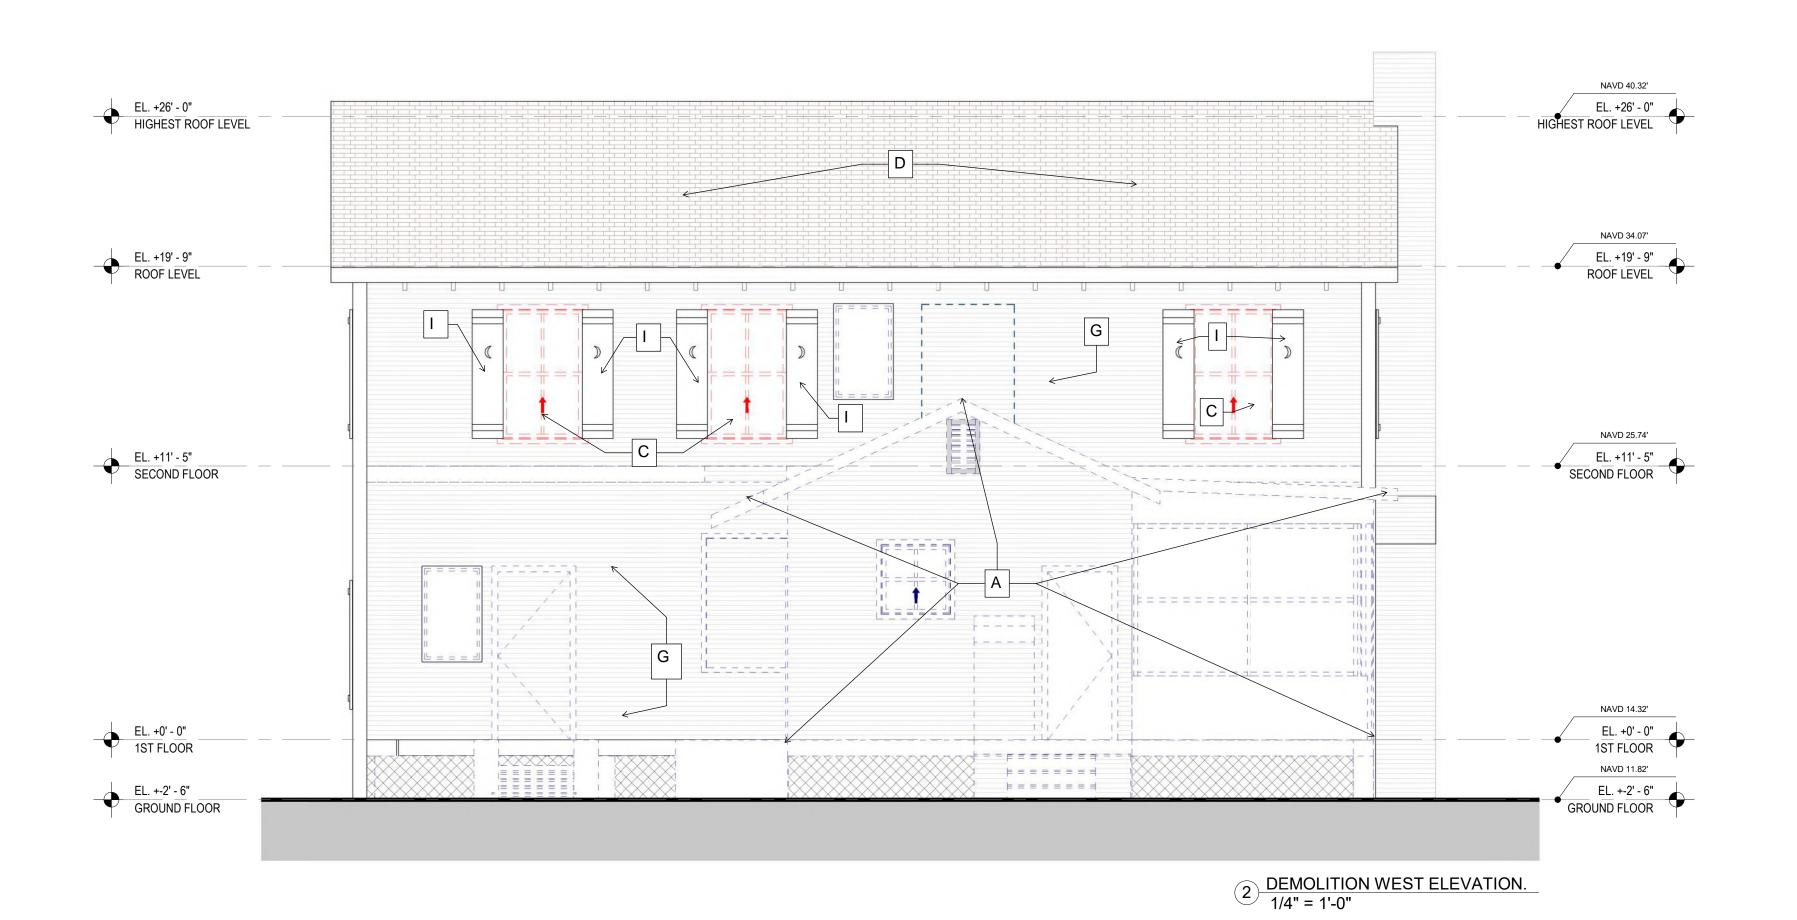



**LINE TYPES LEGEND** 

EXISTING TO REMAIN

---- DEMOLISH EXISTING ROOF/ WALLS / STAIRS / DOORS / WINDOWS

ALL EXISTING WINDOWS TO BE REPLACED BY IMPACT GLASS WINDOWS WITH THE SAME SIZE OPENING AS EXISTING

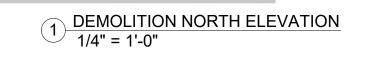

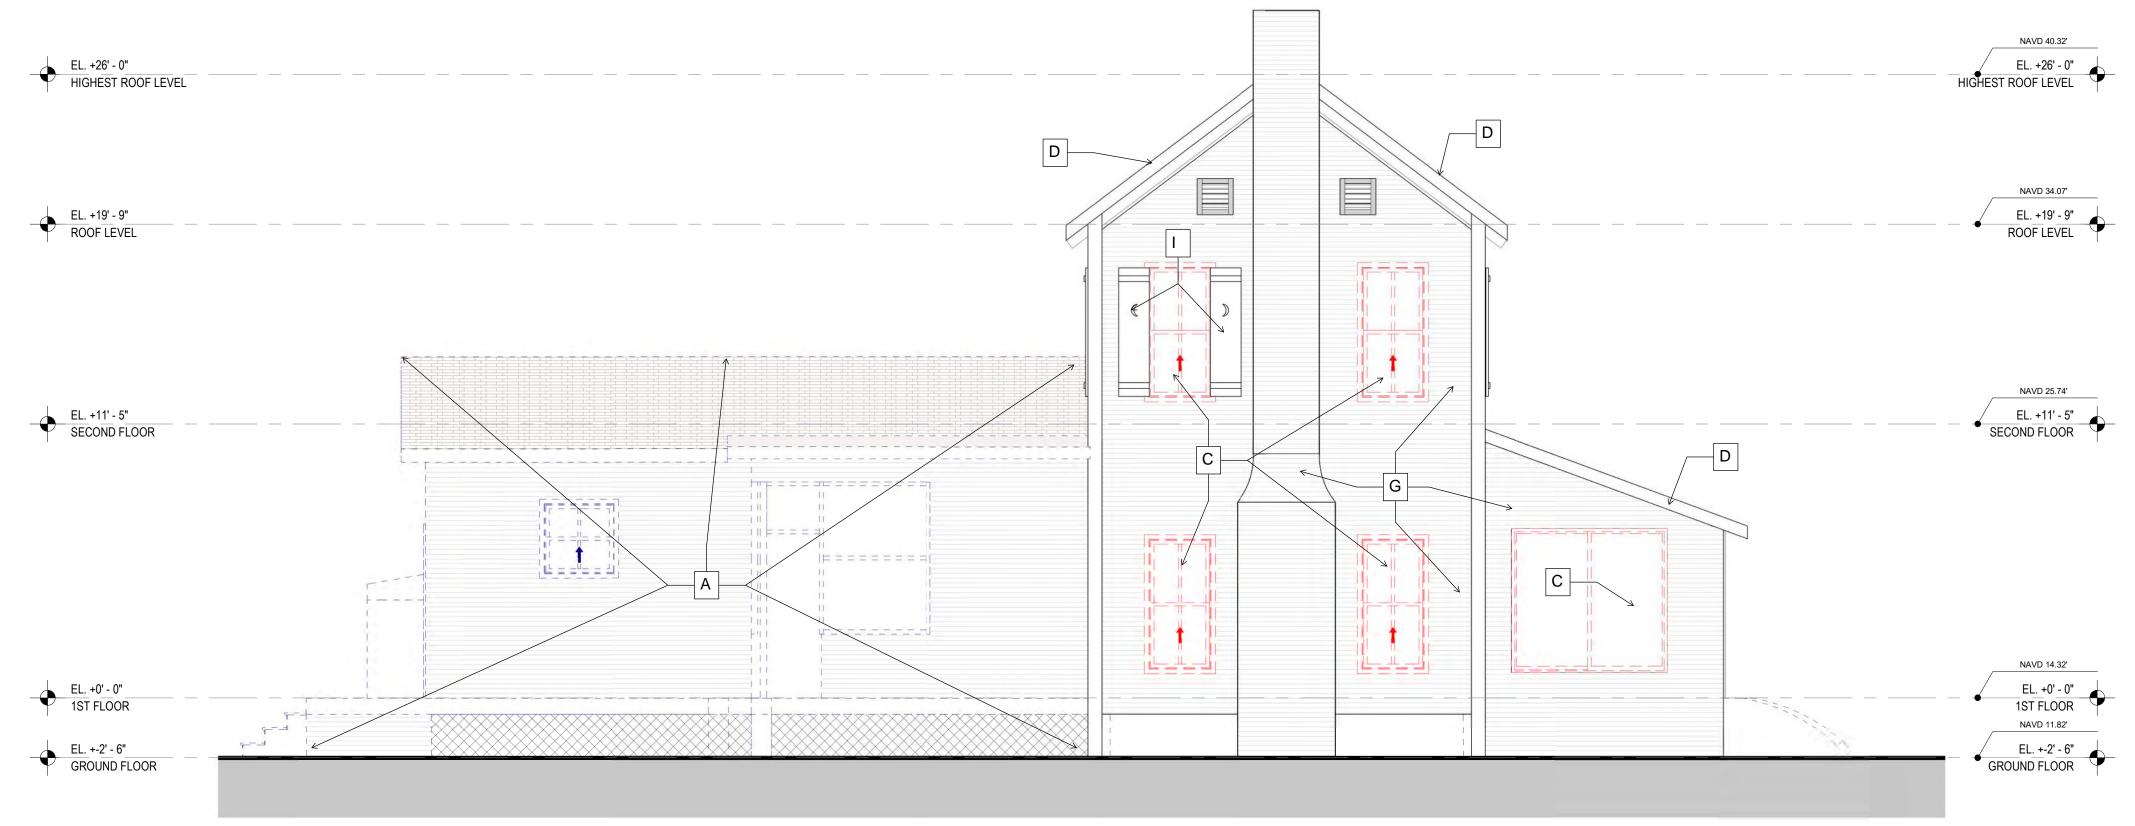

2 DEMOLITION SOUTH ELEVATION. 1/4" = 1'-0"

A. DEMOLITION OF WEST ADDITION PRESERVING THE REST OF BUILDING

B. DEMOLITION OF EXISTING ENTRANCE STAIR, BUILDING A NEW ENTRANCE STAIR TO BE SIMILAR IN DESIGN IN COMPLIANCE WITH FBC AND FLORIDA ACCESSIBILITY CODE

C. REPLACING ALL DOORS AND WINDOWS TO MATCH EXISTING STYLE, DIMENSIONS WITH IMPACT RESISTANT TYPE, IN COMPLIANCE WITH FBC AND OTHER APPLICABLE CODES.

D. REPLACING ROOF SHINGLES AND BUILDING AN ADDITION WEST SIDE OF THE BUILDING.

G. REPLACE ALL DAMAGED WOOD SIDING TO MATCH STYLE AND

I. REPAIR, REFURBISH ALL EXTERIOR SHUTTERS

J. BUILD TWO NEW ADA BATHROOMS TO COMPLY WITH FBC AND FLORIDA ACCESSIBILITY CODE.

K. REMOVING SECOND FLOOR TO CREATE A CATHEDRAL SPACE

O. NEW LIGHTING FIXTURES

P. REPAIRING EXTERIOR ARCHITECTURAL ELEMENTS (EDGE OF RAFTERS, BANDING, MOLDING).

R. REMOVE INTERIOR WALLS, STAIRS. PATCH AND REPAIR WALLS TO REMAIN. PREPARE THE

SCOPE OF WORK:

E. NEW WEST STAIR AND RAILING

F. ADA VERTICAL LIFT

DIMENSIONS.

H. NEW PAINT ALL EXTERIOR SIDING

(DOUBLE HEIGHT) IN LIBRARY ROOM.

L. ADDING AN AC UNIT WITHIN A CLOSET AND EXTERIOR CONDENSER.

M. ADDING DRINKING FOUNTAIN WITH BOTTLE FILLER

N. PAINTING ALL INTERIOR SPACES AFTER REPAIRING INTERIOR EXISTING WALLS

WALLS FOR PAINT. REFER TO COLOR SCHEME FOR PAINT.

**LINE TYPES LEGEND** 

EXISTING TO REMAIN

---- DEMOLISH EXISTING ROOF/ WALLS / STAIRS / DOORS / WINDOWS

ALL EXISTING WINDOWS TO BE REPLACED BY IMPACT GLASS WINDOWS WITH THE SAME SIZE OPENING AS EXISTING

Kaller Architecture AA#26001212 2417 Hollywood Blvd.

> 954.920.5746 joseph@kallerarchitects.com

www.kallerarchitects.com

Hollywood Florida 33020

15:45:58-04'00' R. A. I attest to the 双 accura gy and ho integrity of this document.

JOSEPH B. KALLER

FLORIDA R.A. #0009239

SE 0

STORIC

DEMOLITION
NORTH & SOUT
BUILDING
ELEVATIONS

**REVISIONS** 


No.	Description	Date
2	TAC COMM.	4-1-25
3	REV 3 TAC COMM.	6.31.25


This drawing, as an instrument of service, is and shall remain the property of the Architect and shall not be reproduced, published or used in any way without the permission of the Architect.

PROJECT No.: DRAWN BY:

CHECKED BY:

D-3.01

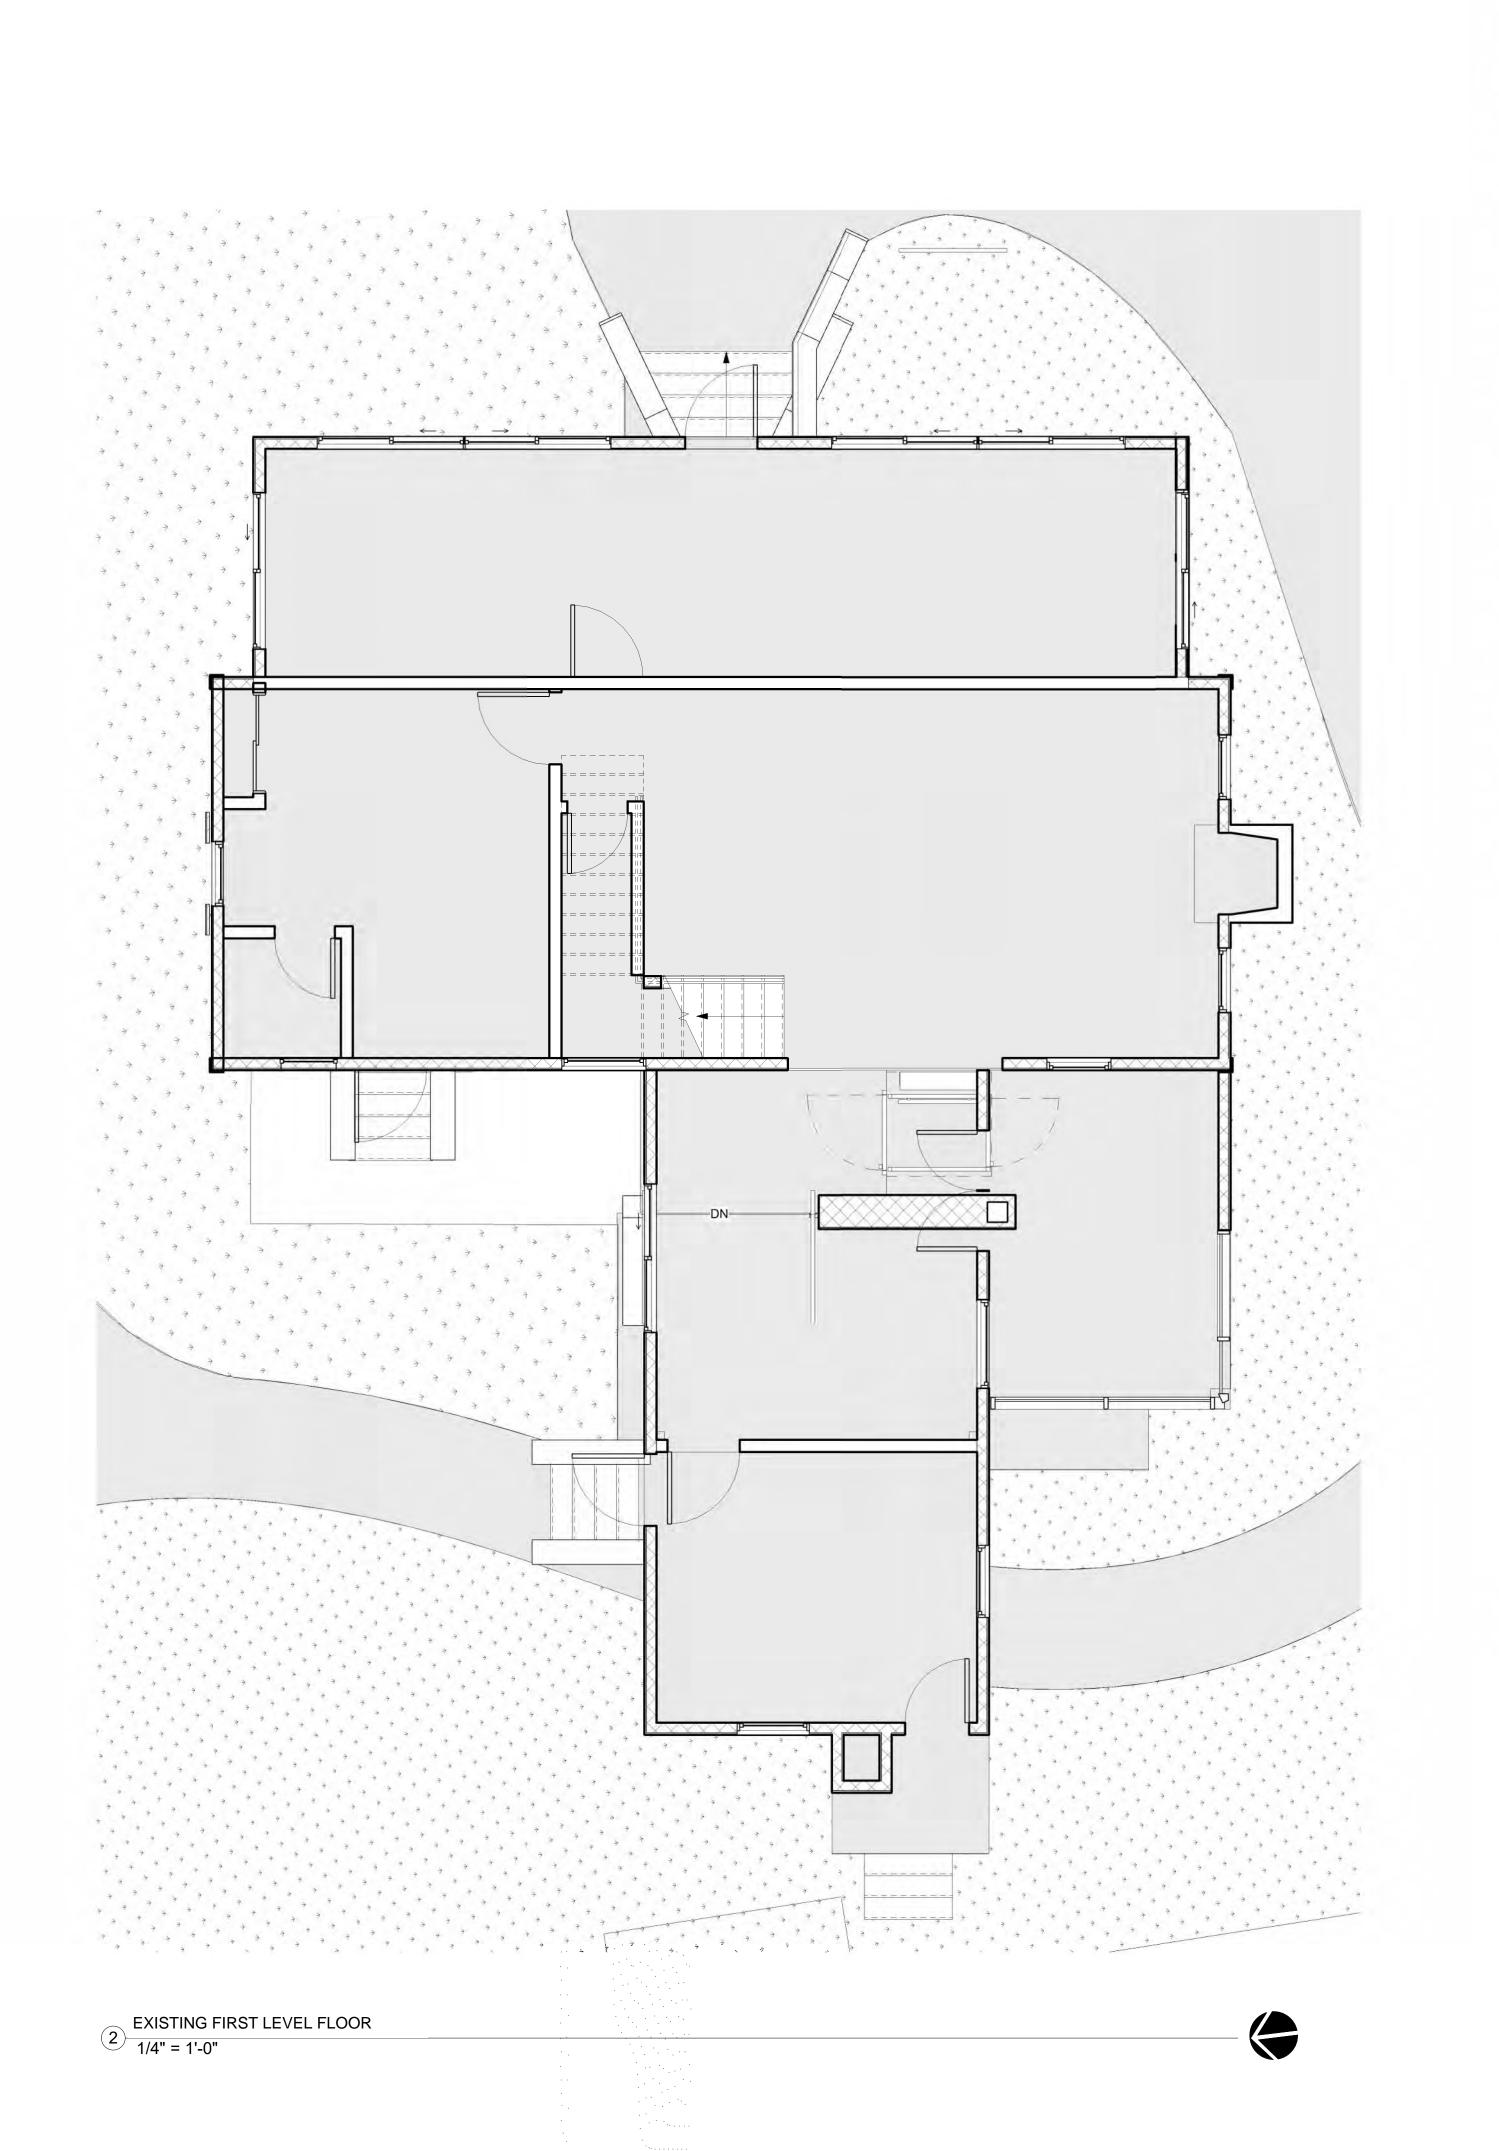

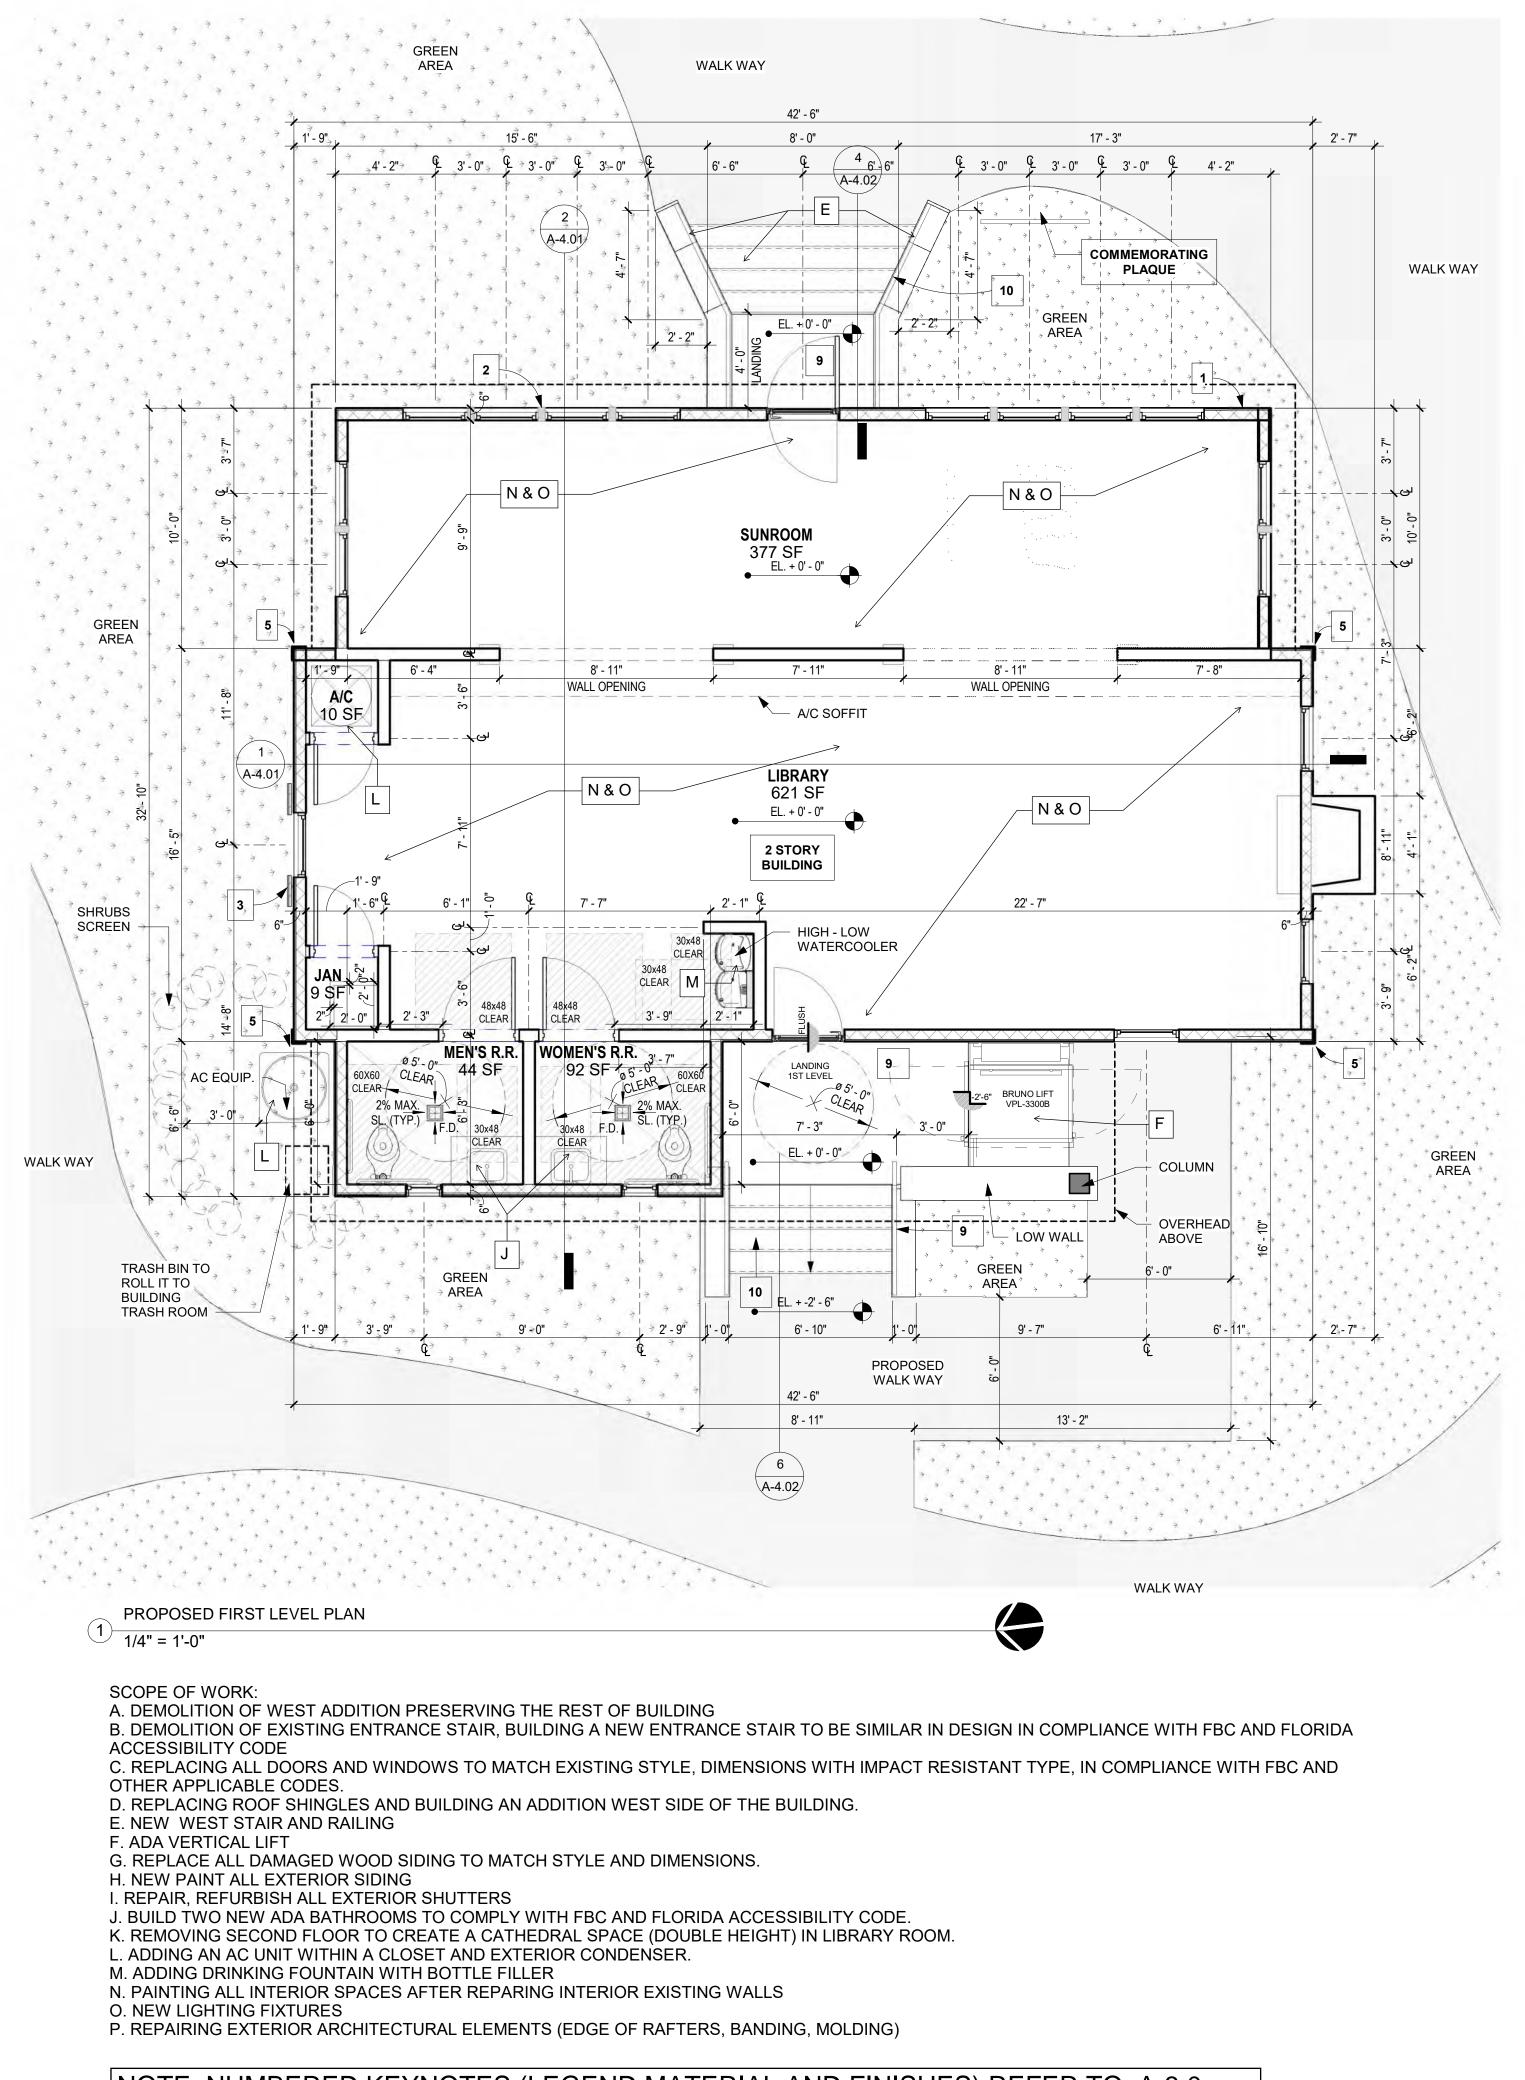

Kaller Architecture AA#26001212
2417 Hollywood Blvd.
Hollywood Florida 33020
954.920.5746

joseph@kallerarchitects.com www.kallerarchitects.com

integrity of this RED document.

JOSEPH B. KALLER FLORIDA R.A. #0009239

**REVISIONS** 


2 TAC COMM. REV 3 TAC COMM.

This drawing, as an instrument of service, is and shall remain the property of the Architect and shall not be reproduced, published or used in any way without the permission of the Architect.

PROJECT No.: 24329

DRAWN BY: CHECKED BY:

NOTE: NUMBERED KEYNOTES (LEGEND MATERIAL AND FINISHES) REFER TO A-3.0

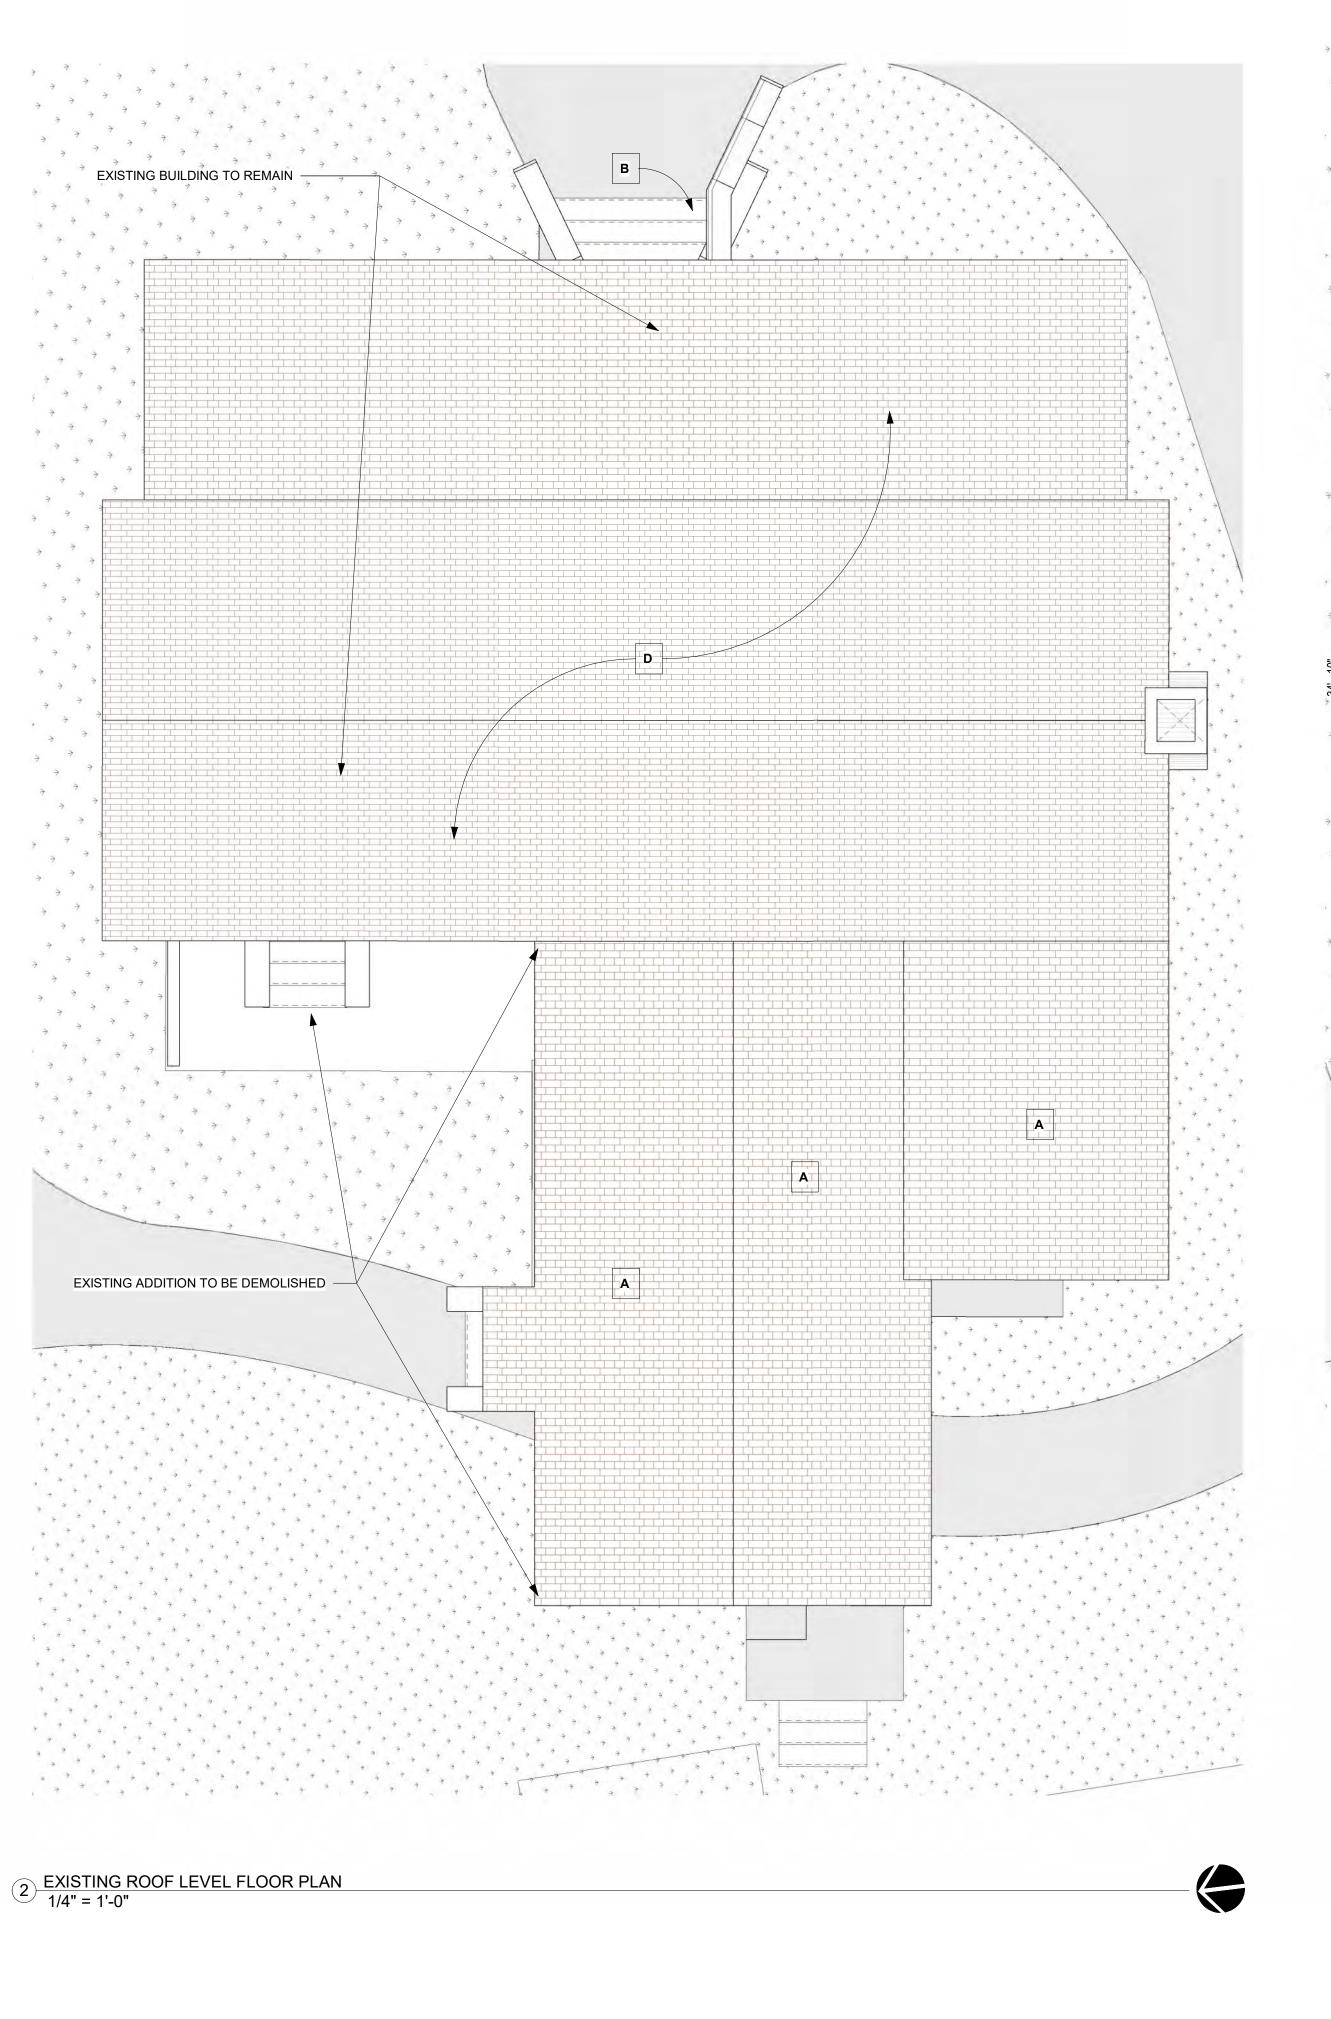

F. ADA VERTICAL LIFT

E. NEW WEST STAIR AND RAILING

D. REPLACING ROOF SHINGLES AND BUILDING AN ADDITION WEST SIDE OF THE BUILDING.


B. DEMOLITION OF EXISTING ENTRANCE STAIR, BUILDING A NEW ENTRANCE STAIR TO BE SIMILAR IN DESIGN IN COMPLIANCE WITH FBC AND FLORIDA ACCESSIBILITY CODE C. REPLACING ALL DOORS AND WINDOWS TO MATCH EXISTING STYLE, DIMENSIONS WITH IMPACT RESISTANT TYPE, IN COMPLIANCE WITH FBC AND OTHER APPLICABLE CODES.

SCOPE OF WORK: A. DEMOLITION OF WEST ADDITION PRESERVING THE REST OF BUILDING

PROPOSED MATERIALS AND FINISHES ✓ 3/8" = 1'-0"

Roof shingles: BARKWOOD Timberline HDZ®



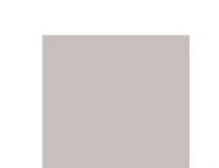

Exterior concrete wall and stair paint in #CABFBE - 10YR 55/037 PELICAN BLUFF Dulux CP5 CP4

NEW ROOF TO MATCH
EXISTING SHINGLES
F: ADA VERTICAL LIFT

E: NEW STAIRS AND

RAILING

NEW ROOF SHINGLES TO MATCH EXISTING STYLE AND COLOR

1) PROPOSED ROOF LEVEL FLOOR PLAN 1/4" = 1'-0"

NEW ROOF AREA

(ADDITION ABOVE ADA BATHROOMS & ADA LIFT)

10

44' - 6"

Exterior stair handrail in steel and color Pure Black Hi-Gloss Enamel Exterior/Interior Paint #86200 (Behr Fandeck)

✓ 6 \ A-4.02

**REVISIONS** Description

EXISTING AND PROPOSED ROC

Kaller Architecture

AA#26001212
2417 Hollywood Blvd.
Hollywood Florida 33020
954.920.5746

joseph@kallerarchitects.com

JOSEPH B. KALLER FLORIDA R.A. #0009239

www.kallerarchitects.com

integrity of this creen document.

HOUSE


HISTORIC

3 REV 3 TAC COMM.

This drawing, as an instrument of service, is and shall remain the property of the Architect and shall not be reproduced, published or used in any way without the permission of the Architect.

PROJECT No.: 24329

DRAWN BY: CHECKED BY: JBK

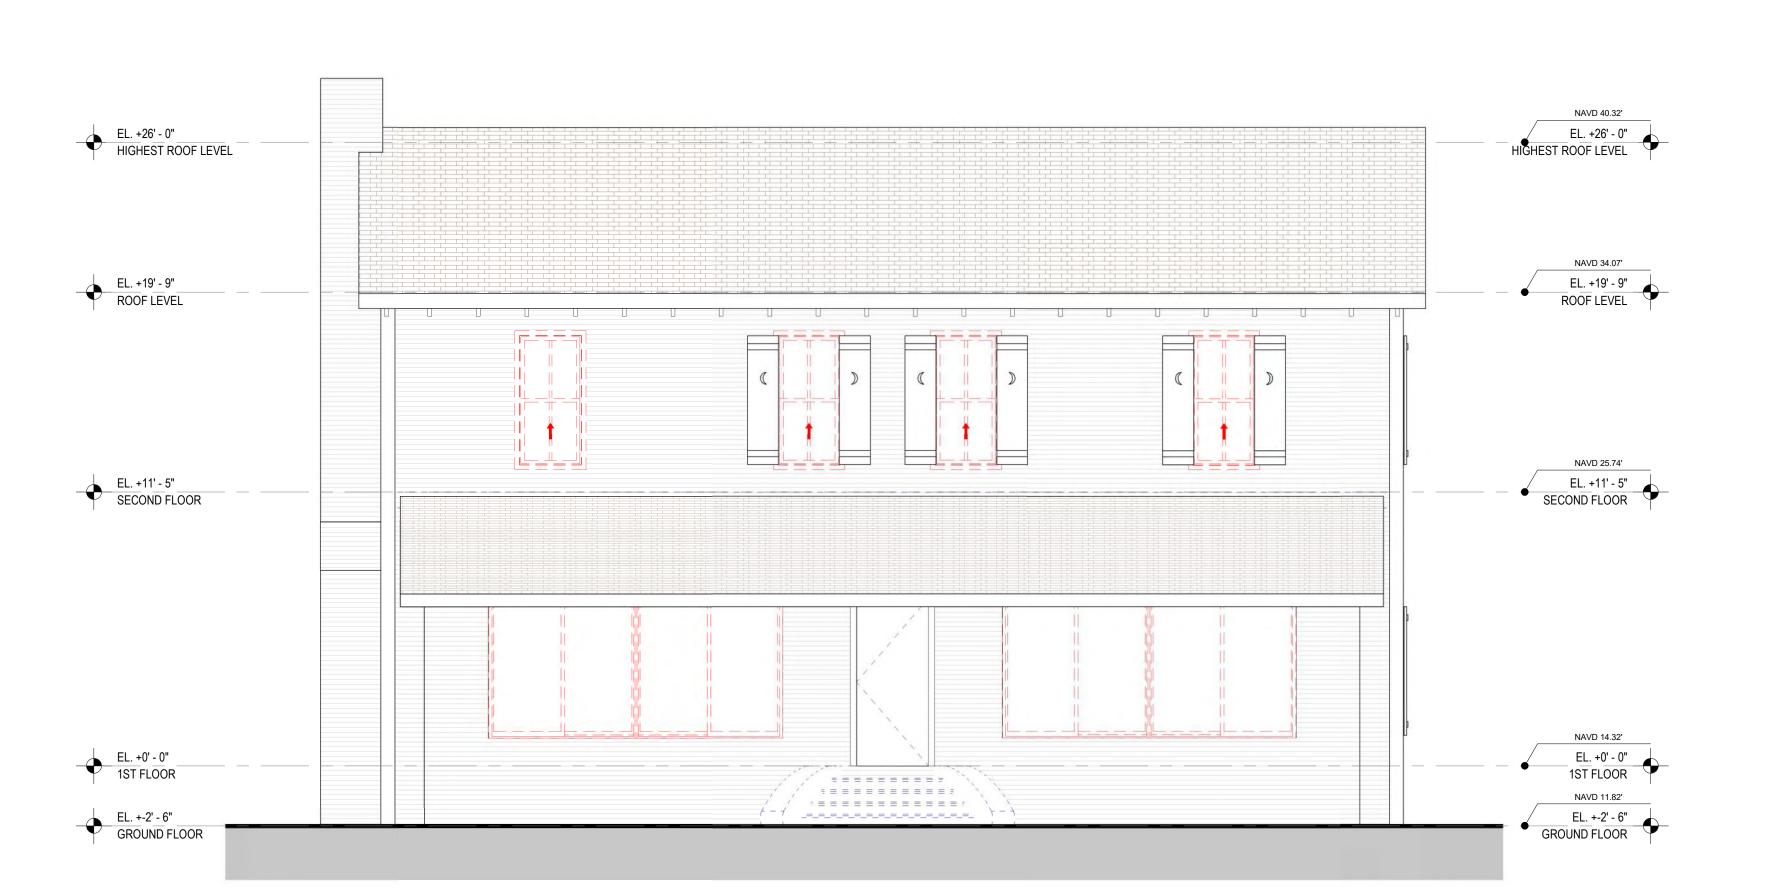

## **SCOPE OF WORK:**

A. DEMOLITION OF WEST ADDITION PRESERVING THE REST OF BUILDING

B. DEMOLITION OF EXISTING ENTRANCE STAIR, BUILDING A NEW ENTRANCE STAIR TO BE SIMILAR IN DESIGN IN COMPLIANCE WITH FBC

C. REPLACING ALL DOORS AND WINDOWS TO MATCH EXISTING STYLE, DIMENSIONS WITH IMPACT RESISTANT TYPE, IN COMPLIANCE WITH FBC AND OTHER APPLICABLE CODES.

D. REPLACING ROOF SHINGLES AND BUILDING AN ADDITION WEST SIDE OF THE BUILDING.

E. NEW WEST STAIR AND RAILING

F. ADA VERTICAL LIFT

DIMENSIONS.

H. NEW PAINT ALL EXTERIOR SIDING

I. REPAIR, REFURBISH ALL EXTERIOR SHUTTERS

FLORIDA ACCESSIBILITY CODE.

K. REMOVING SECOND FLOOR TO CREATE A CATHEDRAL SPACE

L. ADDING AN AC UNIT WITHIN A CLOSET AND EXTERIOR CONDENSER.

O. NEW LIGHTING FIXTURES

P. REPAIRING EXTERIOR ARCHITECTURAL ELEMENTS (EDGE OF

AND FLORIDA ACCESSIBILITY CODE

G. REPLACE ALL DAMAGED WOOD SIDING TO MATCH STYLE AND

J. BUILD TWO NEW ADA BATHROOMS TO COMPLY WITH FBC AND

(DOUBLE HEIGHT) IN LIBRARY ROOM.

M. ADDING DRINKING FOUNTAIN WITH BOTTLE FILLER

N. PAINTING ALL INTERIOR SPACES AFTER REPAIRING INTERIOR EXISTING WALLS

RAFTERS, BANDING, MOLDING).



Kaller Architecture AA#26001212 2417 Hollywood Blvd. Hollywood Florida 33020 954.920.5746

joseph@kallerarchitects.com www.kallerarchitects.com

15:46:10-04'00' R. A. integrity of this RED / ddcument.

JOSEPH B. KALLER FLORIDA R.A. #0009239

SE

0

RC

STO

EXISTING AND PROPOSED - EAST BUILDING ELEVATIONS

**REVISIONS** 

Description

REV 3 TAC COMM.

Windows Shutters: #829CB3 - 278-4 GENTLE BLUE (Valspar Color system)

Exterior wall Siding size is 6" high please NOA No-23-1012.05 we will be using fiber-cement siding -

paint in ULTRA PURE WHITE (Behr Fandeck)

Windows and louvers: #F7F8F4 - ULTRA PURE

WHITE (Behr Fandeck)

Roof shingles: BARKWOOD Timberline HDZ® Shingles or similar



MATERIALS AND FINISHES

TYPE # DESCRIPTION

Column and Roof beam system: #F7F8F4 - ULTRA PURE WHITE (Behr Fandeck)




Wood Corner Guards Size 4.5": #829CB3 painted in -



Exterior Doors Frame: #F7F8F4 - ULTRA PURE WHITE (Behr Fandeck)



Wood Paneling and Trim: #F7F8F4 - ULTRA PURE WHITE (Behr Fandeck)

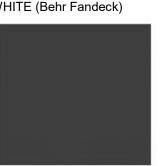

Exterior stair handrail in steel and color Pure Black Hi-Gloss Enamel Exterior/Interior Paint #86200 (Behr Fandeck)



Exterior concrete wall and stair paint in #CABFBE -10YR 55/037 PELICAN BLUFF Dulux CP5 CP4



Heavy duty fencing galvanized steel - 1/2" Hardware Cloth

PROJECT No.: 24329 DRAWN BY: CHECKED BY: JBK

A-3.00

This drawing, as an instrument of service, is and shall remain the property of the Architect and shall not be reproduced, published or used in any way without the permission of the Architect.

1 PROPOSED EAST ELEVATION 1/4" = 1'-0"

2 EXISTING EAST ELEVATION
1/4" = 1'-0"

1 PROPOSED WEST ELEVATION 1/4" = 1'-0"



**SCOPE OF WORK:** 

A. DEMOLITION OF WEST ADDITION PRESERVING THE REST OF BUILDING

B. DEMOLITION OF EXISTING ENTRANCE STAIR, BUILDING A NEW ENTRANCE STAIR TO BE SIMILAR IN DESIGN IN COMPLIANCE WITH FBC AND FLORIDA ACCESSIBILITY CODE

C. REPLACING ALL DOORS AND WINDOWS TO MATCH EXISTING STYLE, DIMENSIONS WITH IMPACT RESISTANT TYPE, IN COMPLIANCE WITH FBC AND OTHER APPLICABLE CODES.

D. REPLACING ROOF SHINGLES AND BUILDING AN ADDITION WEST SIDE OF THE BUILDING.

E. NEW WEST STAIR AND RAILING

F. ADA VERTICAL LIFT

G. REPLACE ALL DAMAGED WOOD SIDING TO MATCH STYLE AND DIMENSIONS.

H. NEW PAINT ALL EXTERIOR SIDING

I. REPAIR, REFURBISH ALL EXTERIOR SHUTTERS

J. BUILD TWO NEW ADA BATHROOMS TO COMPLY WITH FBC AND

K. REMOVING SECOND FLOOR TO CREATE A CATHEDRAL SPACE (DOUBLE HEIGHT) IN LIBRARY ROOM.

L. ADDING AN AC UNIT WITHIN A CLOSET AND EXTERIOR CONDENSER.

INTERIOR EXISTING WALLS

O. NEW LIGHTING FIXTURES

FLORIDA ACCESSIBILITY CODE.

M. ADDING DRINKING FOUNTAIN WITH BOTTLE FILLER

N. PAINTING ALL INTERIOR SPACES AFTER REPAIRING

P. REPAIRING EXTERIOR ARCHITECTURAL ELEMENTS (EDGE OF RAFTERS, BANDING, MOLDING).

MATERIALS AND FINISHES

TYPE # DESCRIPTION

Exterior wall Siding size is 6" high please NOA No-23-1012.05 we will be using fiber-cement siding paint in ULTRA PURE WHITE (Behr Fandeck)



Windows and louvers: #F7F8F4 - ULTRA PURE WHITE (Behr Fandeck)



Windows Shutters: #829CB3 - 278-4 GENTLE BLUE (Valspar Color system)



Roof shingles: BARKWOOD Timberline HDZ® Shingles or similar



Column and Roof beam system: #F7F8F4 - ULTRA PURE WHITE (Behr Fandeck)




Wood Corner Guards Size 4.5": #829CB3 painted in -



Exterior Doors Frame: #F7F8F4 - ULTRA PURE WHITE (Behr Fandeck)



Wood Paneling and Trim: #F7F8F4 - ULTRA PURE WHITE (Behr Fandeck)

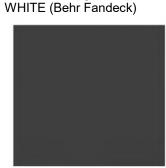

Exterior stair handrail in steel and color Pure Black Hi-Gloss Enamel Exterior/Interior Paint #86200 (Behr Fandeck)



Exterior concrete wall and stair paint in #CABFBE -10YR 55/037 PELICAN BLUFF Dulux CP5 CP4



Heavy duty fencing galvanized steel - 1/2" Hardware Cloth

Kaller Architecture AA#26001212 2417 Hollywood Blvd. Hollywood Florida 33020 954.920.5746

joseph@kallerarchitects.com www.kallerarchitects.com

Joseph B Kaller, v 15:46:15-04'00' R. A. integrity of this RED

JOSEPH B. KALLER FLORIDA R.A. #0009239

SE

0 RC STO

EXISTING AND PROPOSED - WEST BUILDING ELEVATIONS

**REVISIONS** 

Description 3 REV 3 - TAC COMM.

This drawing, as an instrument of service, is and shall remain the property of the Architect and shall not be reproduced, published or used in any way without the permission of the Architect.

PROJECT No.: 24329 DRAWN BY:

CHECKED BY:

A-3.01

2 EXISTING WEST ELEVATION 1/4" = 1'-0"

1) PKUr UL\_ 1/4" = 1'-0"

PROPOSED NORTH ELEVATION

# **SCOPE OF WORK:**

- A. DEMOLITION OF WEST ADDITION PRESERVING THE REST OF BUILDING
- B. DEMOLITION OF EXISTING ENTRANCE STAIR, BUILDING A NEW ENTRANCE STAIR TO BE SIMILAR IN DESIGN IN COMPLIANCE WITH FBC AND FLORIDA ACCESSIBILITY CODE
- C. REPLACING ALL DOORS AND WINDOWS TO MATCH EXISTING STYLE, DIMENSIONS WITH IMPACT RESISTANT TYPE, IN COMPLIANCE WITH FBC AND OTHER APPLICABLE CODES.
- D. REPLACING ROOF SHINGLES AND BUILDING AN ADDITION WEST SIDE OF THE BUILDING.
- E. NEW WEST STAIR AND RAILING
- F. ADA VERTICAL LIFT
- G. REPLACE ALL DAMAGED WOOD SIDING TO MATCH STYLE AND DIMENSIONS.
- H. NEW PAINT ALL EXTERIOR SIDING
- I. REPAIR, REFURBISH ALL EXTERIOR SHUTTERS
- J. BUILD TWO NEW ADA BATHROOMS TO COMPLY WITH FBC AND FLORIDA ACCESSIBILITY CODE.
- K. REMOVING SECOND FLOOR TO CREATE A CATHEDRAL SPACE (DOUBLE HEIGHT) IN LIBRARY ROOM.
- L. ADDING AN AC UNIT WITHIN A CLOSET AND EXTERIOR CONDENSER.
- M. ADDING DRINKING FOUNTAIN WITH BOTTLE FILLER
- N. PAINTING ALL INTERIOR SPACES AFTER REPAIRING INTERIOR EXISTING WALLS
- O. NEW LIGHTING FIXTURES
- P. REPAIRING EXTERIOR ARCHITECTURAL ELEMENTS (EDGE OF RAFTERS, BANDING, MOLDING).





Exterior Doors Frame: #F7F8F4 - ULTRA PURE WHITE (Behr Fandeck)



Wood Paneling and Trim: #F7F8F4 - ULTRA PURE



Exterior stair handrail in steel and color Pure Black Hi-Gloss Enamel Exterior/Interior Paint #86200 (Behr Fandeck)



Exterior concrete wall and stair paint in #CABFBE -10YR 55/037 PELICAN BLUFF Dulux CP5 CP4



Heavy duty fencing galvanized steel - 1/2" Hardware Cloth

Kaller Architecture AA#26001212 2417 Hollywood Blvd. Hollywood Florida 33020 954.920.5746 joseph@kallerarchitects.com www.kallerarchitects.com

JOSEPH B. KALLER FLORIDA R.A. #0009239

R. A.

15:46 19-04 QO

integrity of this RED

SE 0

RC STO

**REVISIONS** Description REV 3 TAC COMM.

This drawing, as an instrument of service, is and shall remain the property of the Architect and shall not be reproduced, published or used in any way without the permission of the Architect.

PROJECT No.: DRAWN BY: CHECKED BY:

A-3.02





A. DEMOLITION OF WEST ADDITION PRESERVING THE REST OF BUILDING

B. DEMOLITION OF EXISTING ENTRANCE STAIR, BUILDING A NEW ENTRANCE STAIR TO BE SIMILAR IN DESIGN IN COMPLIANCE WITH FBC AND FLORIDA ACCESSIBILITY CODE

C. REPLACING ALL DOORS AND WINDOWS TO MATCH EXISTING STYLE, DIMENSIONS WITH IMPACT RESISTANT TYPE, IN COMPLIANCE WITH FBC AND OTHER APPLICABLE CODES.

D. REPLACING ROOF SHINGLES AND BUILDING AN ADDITION WEST SIDE OF THE BUILDING.

E. NEW WEST STAIR AND RAILING

F. ADA VERTICAL LIFT

G. REPLACE ALL DAMAGED WOOD SIDING TO MATCH STYLE AND DIMENSIONS.

H. NEW PAINT ALL EXTERIOR SIDING

I. REPAIR, REFURBISH ALL EXTERIOR SHUTTERS

J. BUILD TWO NEW ADA BATHROOMS TO COMPLY WITH FBC AND FLORIDA ACCESSIBILITY CODE.

K. REMOVING SECOND FLOOR TO CREATE A CATHEDRAL SPACE (DOUBLE HEIGHT) IN LIBRARY ROOM.


L. ADDING AN AC UNIT WITHIN A CLOSET AND EXTERIOR CONDENSER.

M. ADDING DRINKING FOUNTAIN WITH BOTTLE FILLER

N. PAINTING ALL INTERIOR SPACES AFTER REPAIRING INTERIOR EXISTING WALLS

O. NEW LIGHTING FIXTURES

P. REPAIRING EXTERIOR ARCHITECTURAL ELEMENTS (EDGE OF RAFTERS, BANDING, MOLDING).

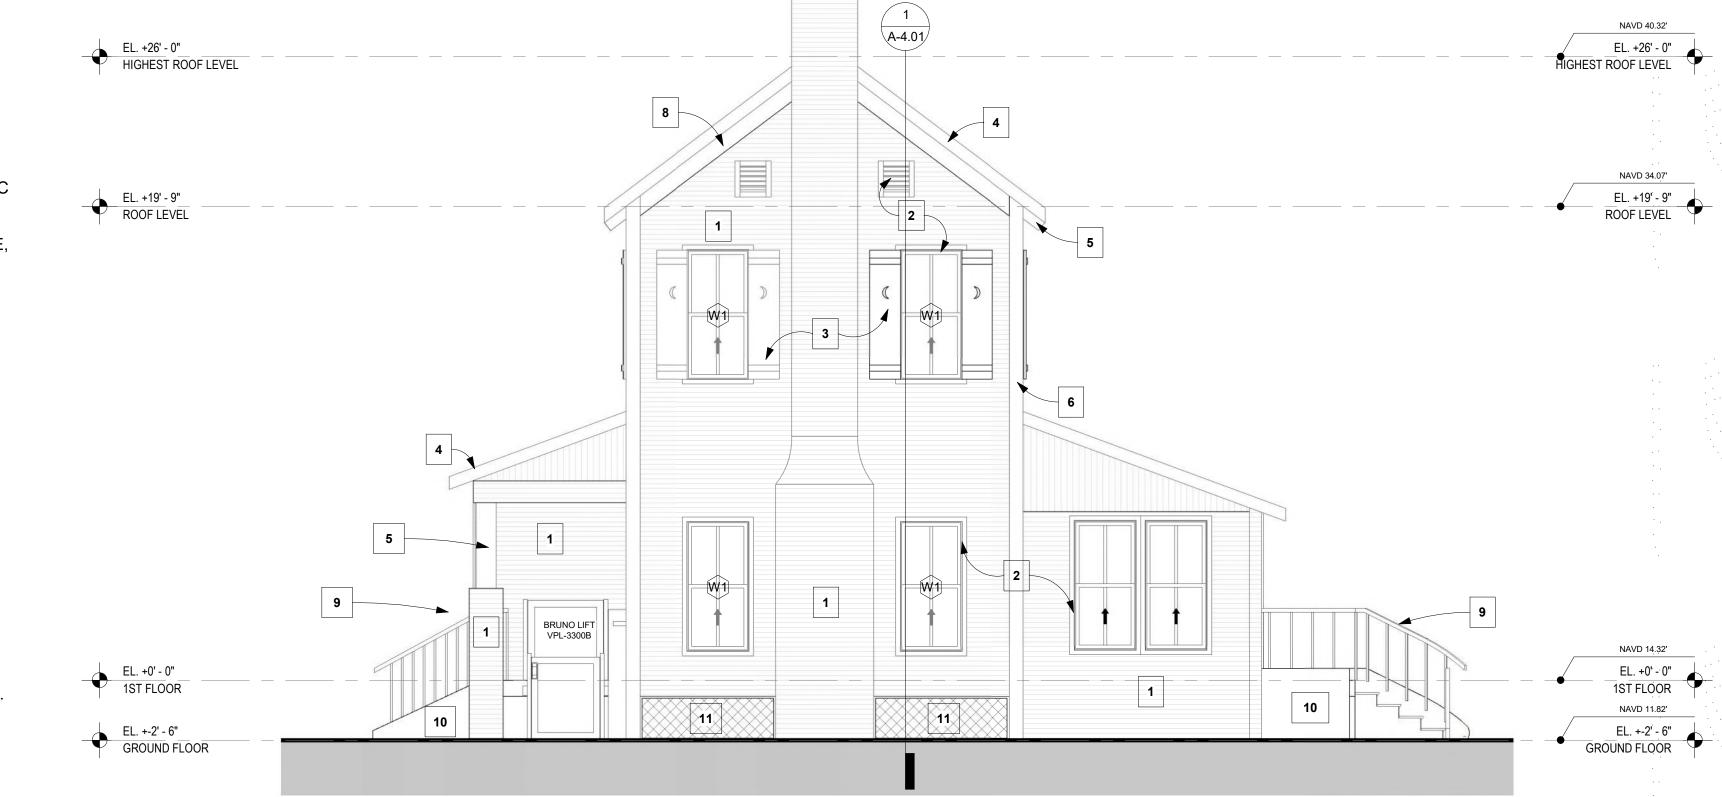



PROPOSED SOUTH ELEVATION

1 PROF 5522 1/4" = 1'-0"





Kaller Architecture AA#26001212 2417 Hollywood Blvd.

Hollywood Florida 33020 954.920.5746 joseph@kallerarchitects.com

www.kallerarchitects.com

FLORIDA R.A. #0009239

SE

0

RC

STO

15:46 23-04 00 R. A. integrity of this RED JOSEPH B. KALLER

Heavy duty fencing galvanized steel - 1/2" Hardware Cloth

SHEET A-3.03

This drawing, as an instrument of service, is and shall remain the property of the Architect and shall not be reproduced, published or used in any way without the permission of the Architect.

PROJECT No.:

DRAWN BY:

CHECKED BY:

**REVISIONS** 

Description


6.31.25

2 TAC COMM.

3 REV 3 TAC COMM.





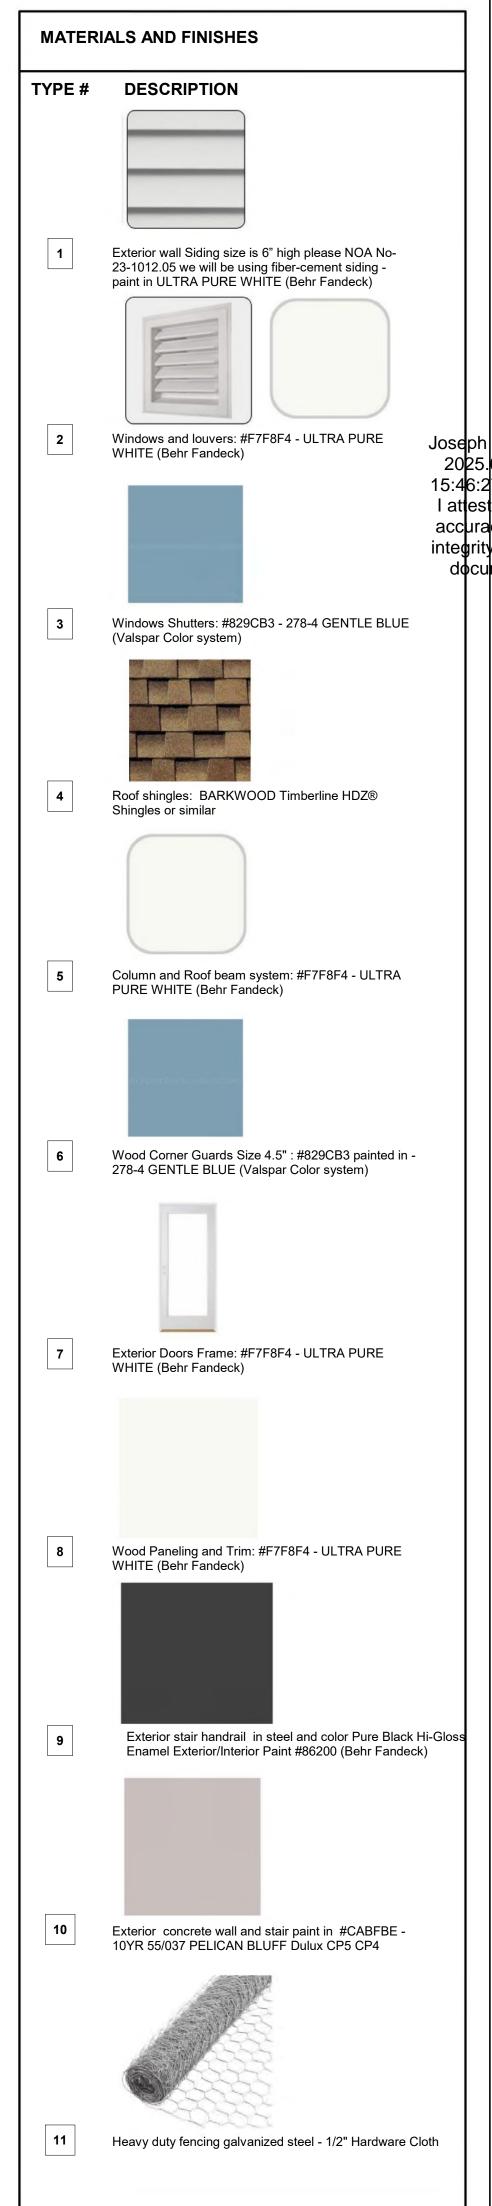

poemig necessary to produce me intended results.

Kaller Architecture

AA#26001212
2417 Hollywood Blvd.
Hollywood Florida 33020
954.920.5746
joseph@kallerarchitects.com

www.kallerarchitects.com

JOSEPH B. KALLER FLORIDA R.A. #0009239

Joseph B Kaller F RA B. Ky B.

HOUSE

HISTORICAL

COLORED EAST & VELEVATIONS

**REVISIONS** 

Description

This drawing, as an instrument of service, is and shall remain the property of the Architect and shall not be reproduced, published or used in any way without the permission of the Architect.

02/19/2025

PROJECT No.: 24329

CHECKED BY: JBK

SHEET

DRAWN BY:


2 TAC COMM.

A-3.10

ALLER ARCHITECTURE, ALL RIGHTS RESER





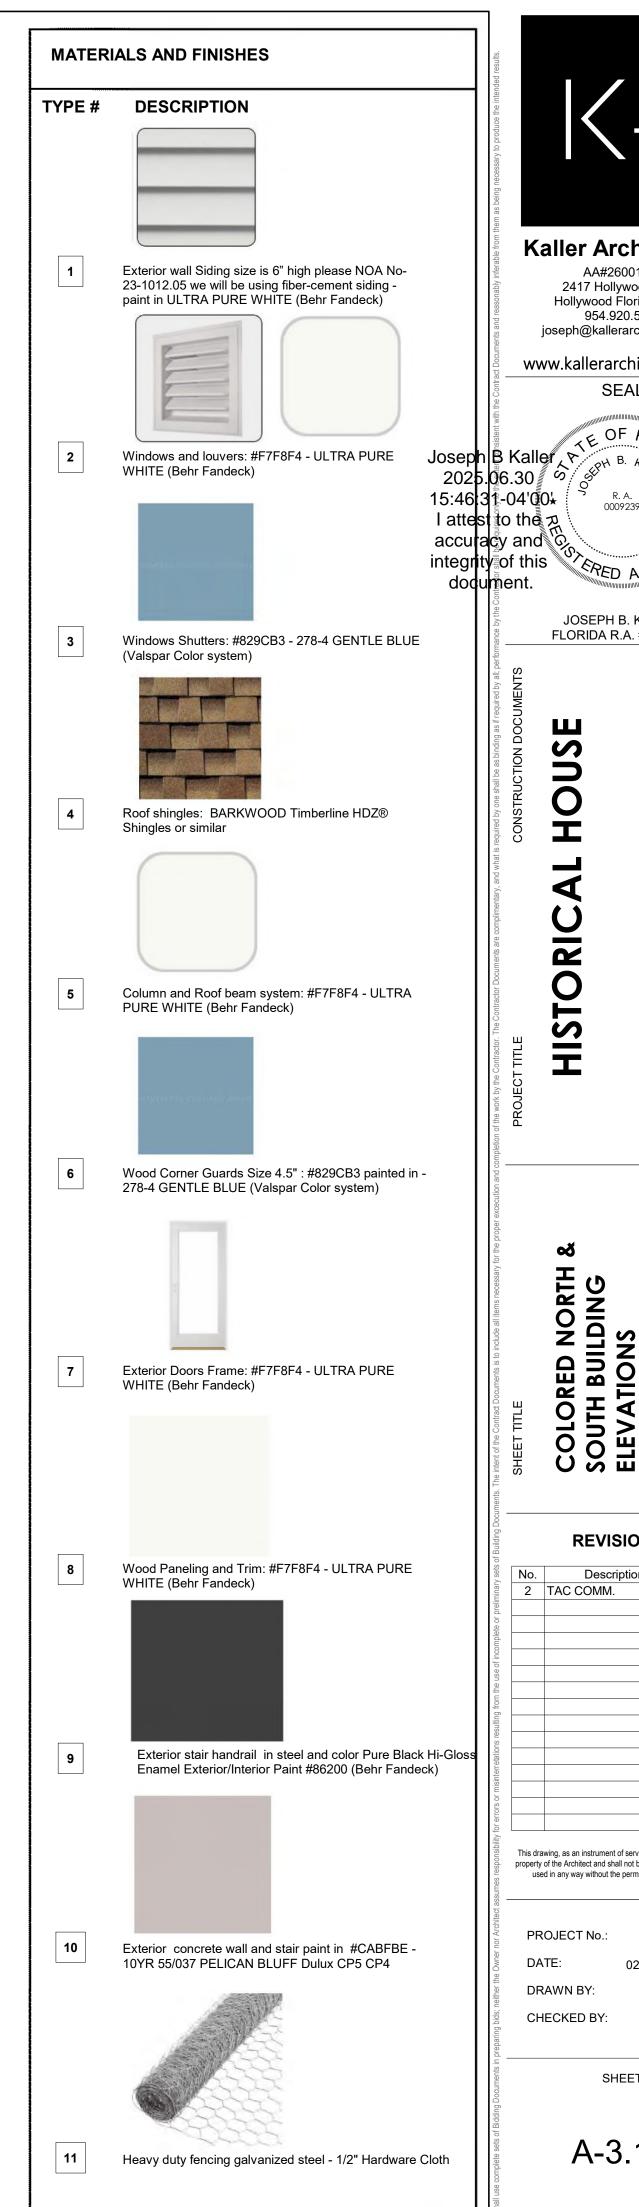



**Kaller Architecture** AA#26001212 2417 Hollywood Blvd. Hollywood Florida 33020

954.920.5746 joseph@kallerarchitects.com

www.kallerarchitects.com

TE OF FLO

R. A. 0009239

JOSEPH B. KALLER FLORIDA R.A. #0009239

HOUSE

AL

HISTORIC

This drawing, as an instrument of service, is and shall remain the property of the Architect and shall not be reproduced, published or used in any way without the permission of the Architect.

COLORED NORTH SOUTH BUILDING ELEVATIONS

**REVISIONS** 


Description

2 TAC COMM.

PROJECT No.: 24329

DRAWN BY: CHECKED BY: JBK SHEET

A-3.11

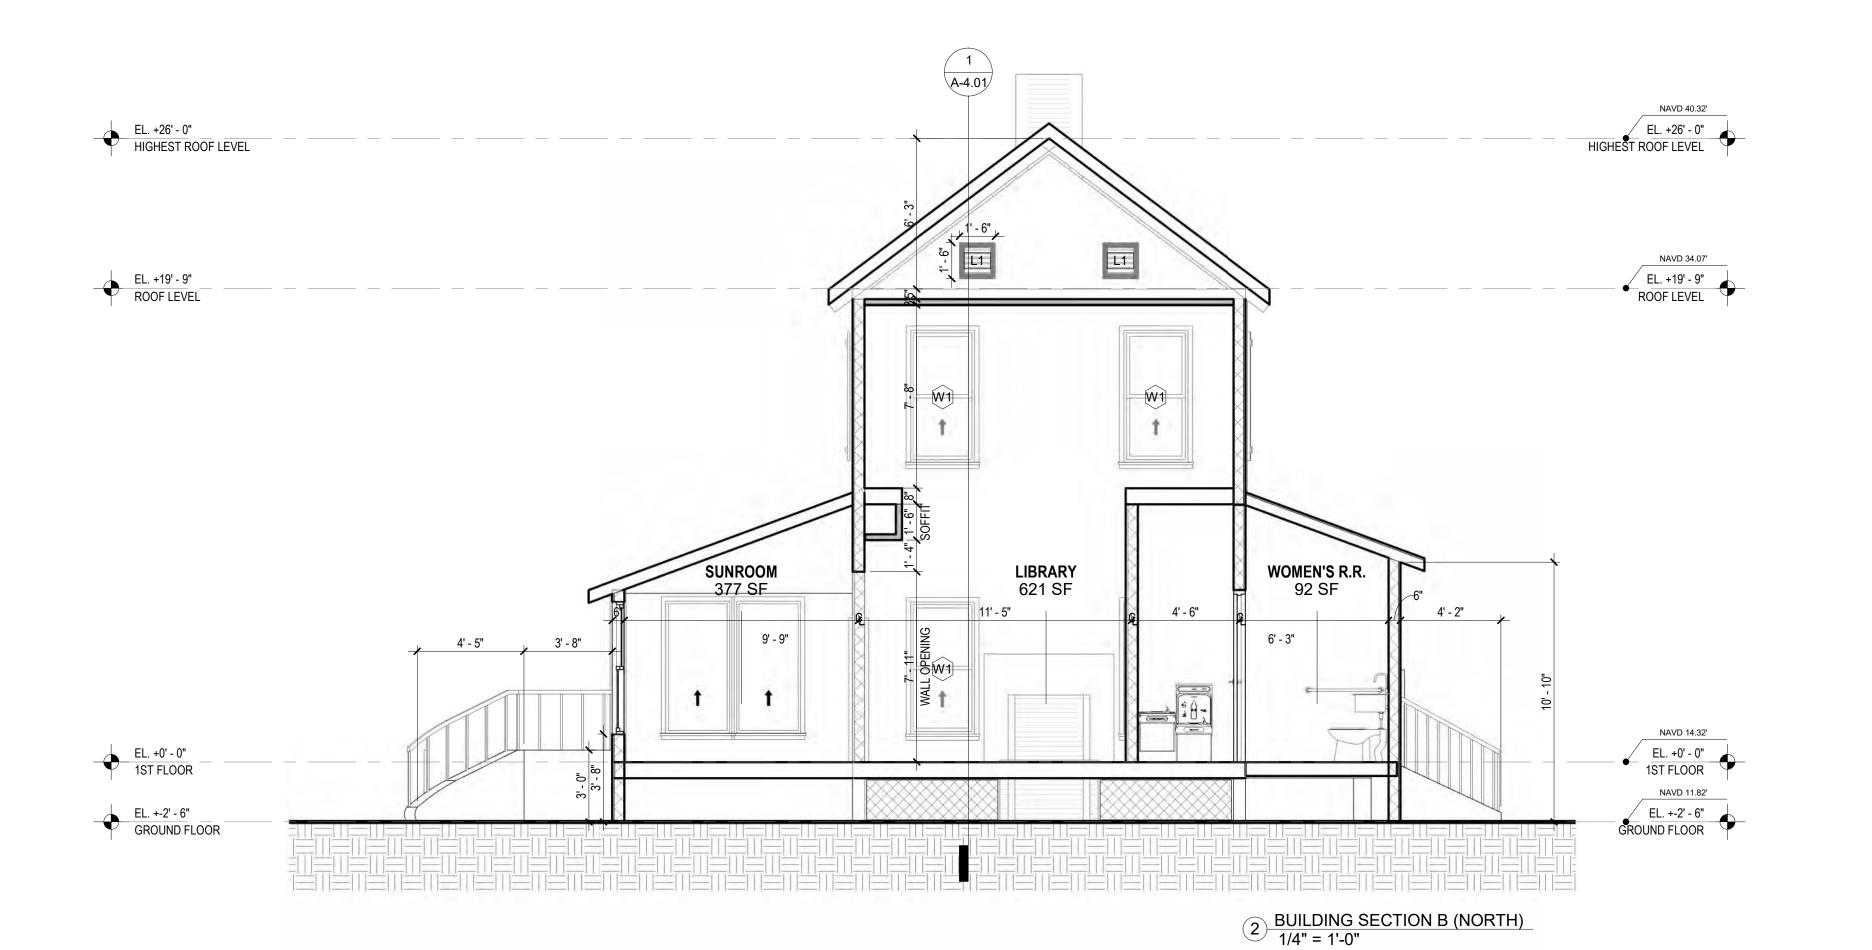

www.kallerarchitects.com

SEAL

Joseph B Kaller R B 2025.06.30 B 15:46:36-04'00' RA 000923' I attest to the accuracy and integrity of this document.

JOSEPH B. KALLER FLORIDA R.A. #0009239

HOUSE

HISTORICAL

EAST & NORTH BUILDING SECTIONS

**REVISIONS** Description


This drawing, as an instrument of service, is and shall remain the property of the Architect and shall not be reproduced, published or used in any way without the permission of the Architect.

PROJECT No.: 24329 DRAWN BY: CHECKED BY: JBK


SHEET


A-4.01



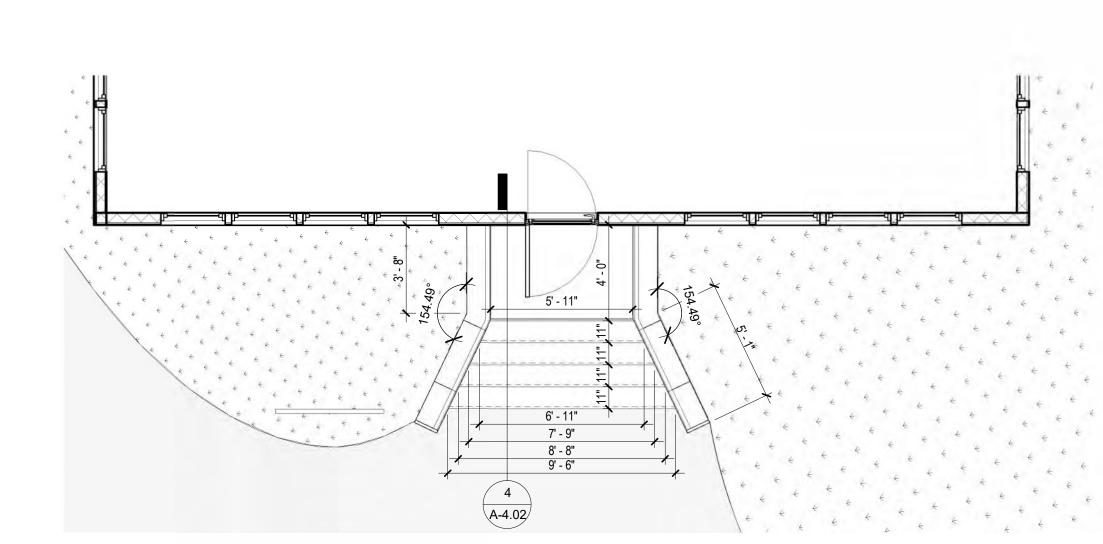


3 FIRST LEVEL PLAN - FRONT STAIR PLAN 1/4" = 1'-0"

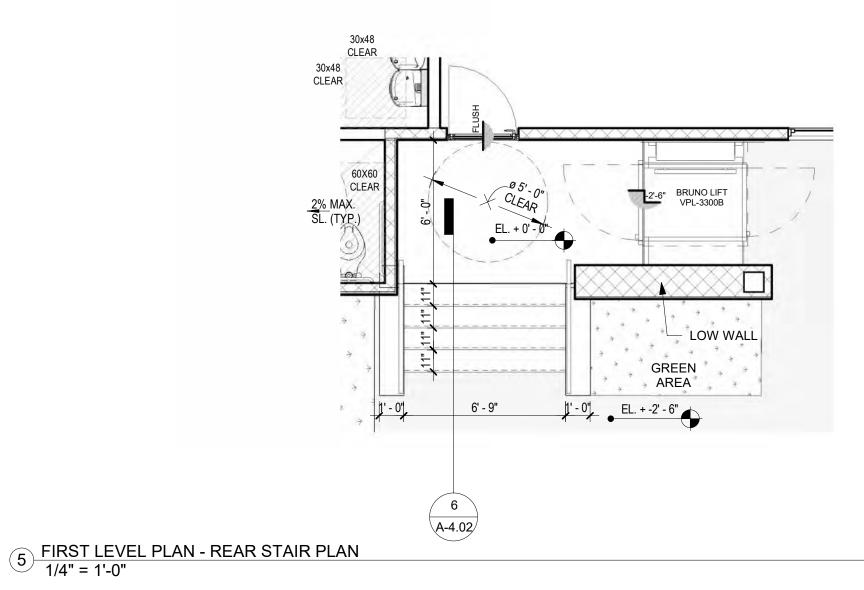


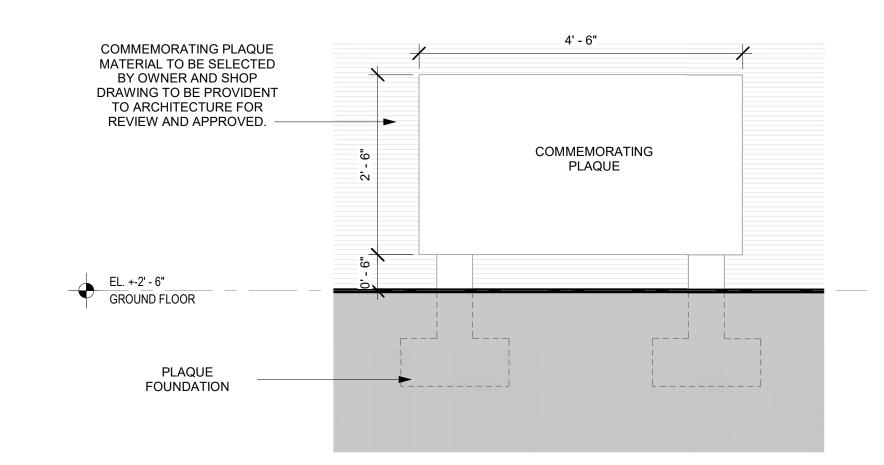

2 COMMEMORATING PLAQUE ELEVATION 3/4" = 1'-0"

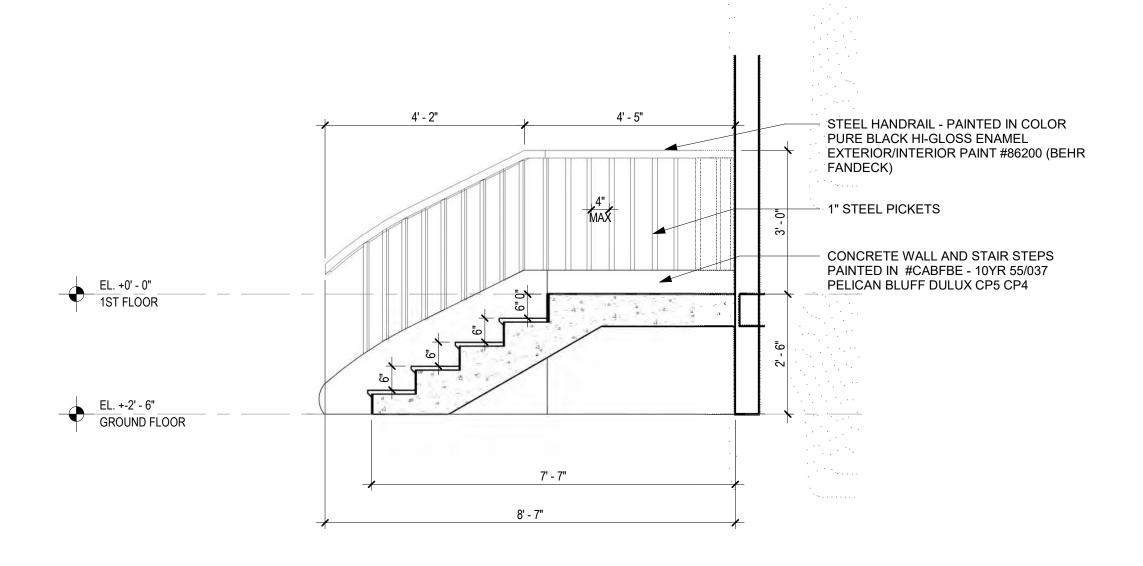

4 SECTION - FRONT STAIR
1/2" = 1'-0"

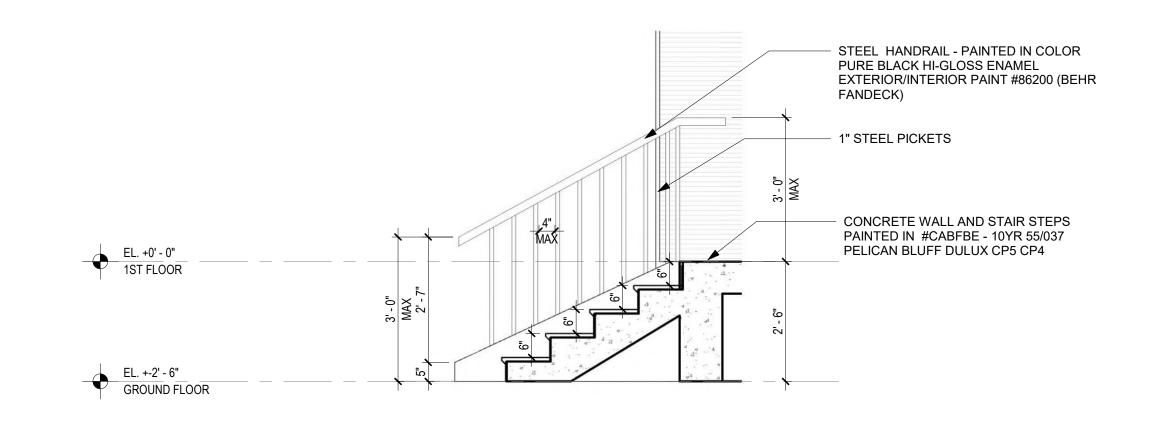

6 SECTION - REAR STAIR 1/2" = 1'-0"



Kaller Architecture

AA#26001212 2417 Hollywood Blvd. Hollywood Florida 33020 954.920.5746 joseph@kallerarchitects.com

www.kallerarchitects.com

15:46:40-04'00\*

I attest to the accuracy and integrity of this document.

JOSEPH B. KALLER FLORIDA R.A. #0009239

HOUSE

HISTORIC

**DETAILS** 

**REVISIONS** 


No.	Description	Date
2	TAC COMM.	4-1-2

This drawing, as an instrument of service, is and shall remain the property of the Architect and shall not be reproduced, published or used in any way without the permission of the Architect.

PROJECT No.: 24329 DATE: 02/19/2025 DRAWN BY: CHECKED BY: JBK

SHEET

A-4.02

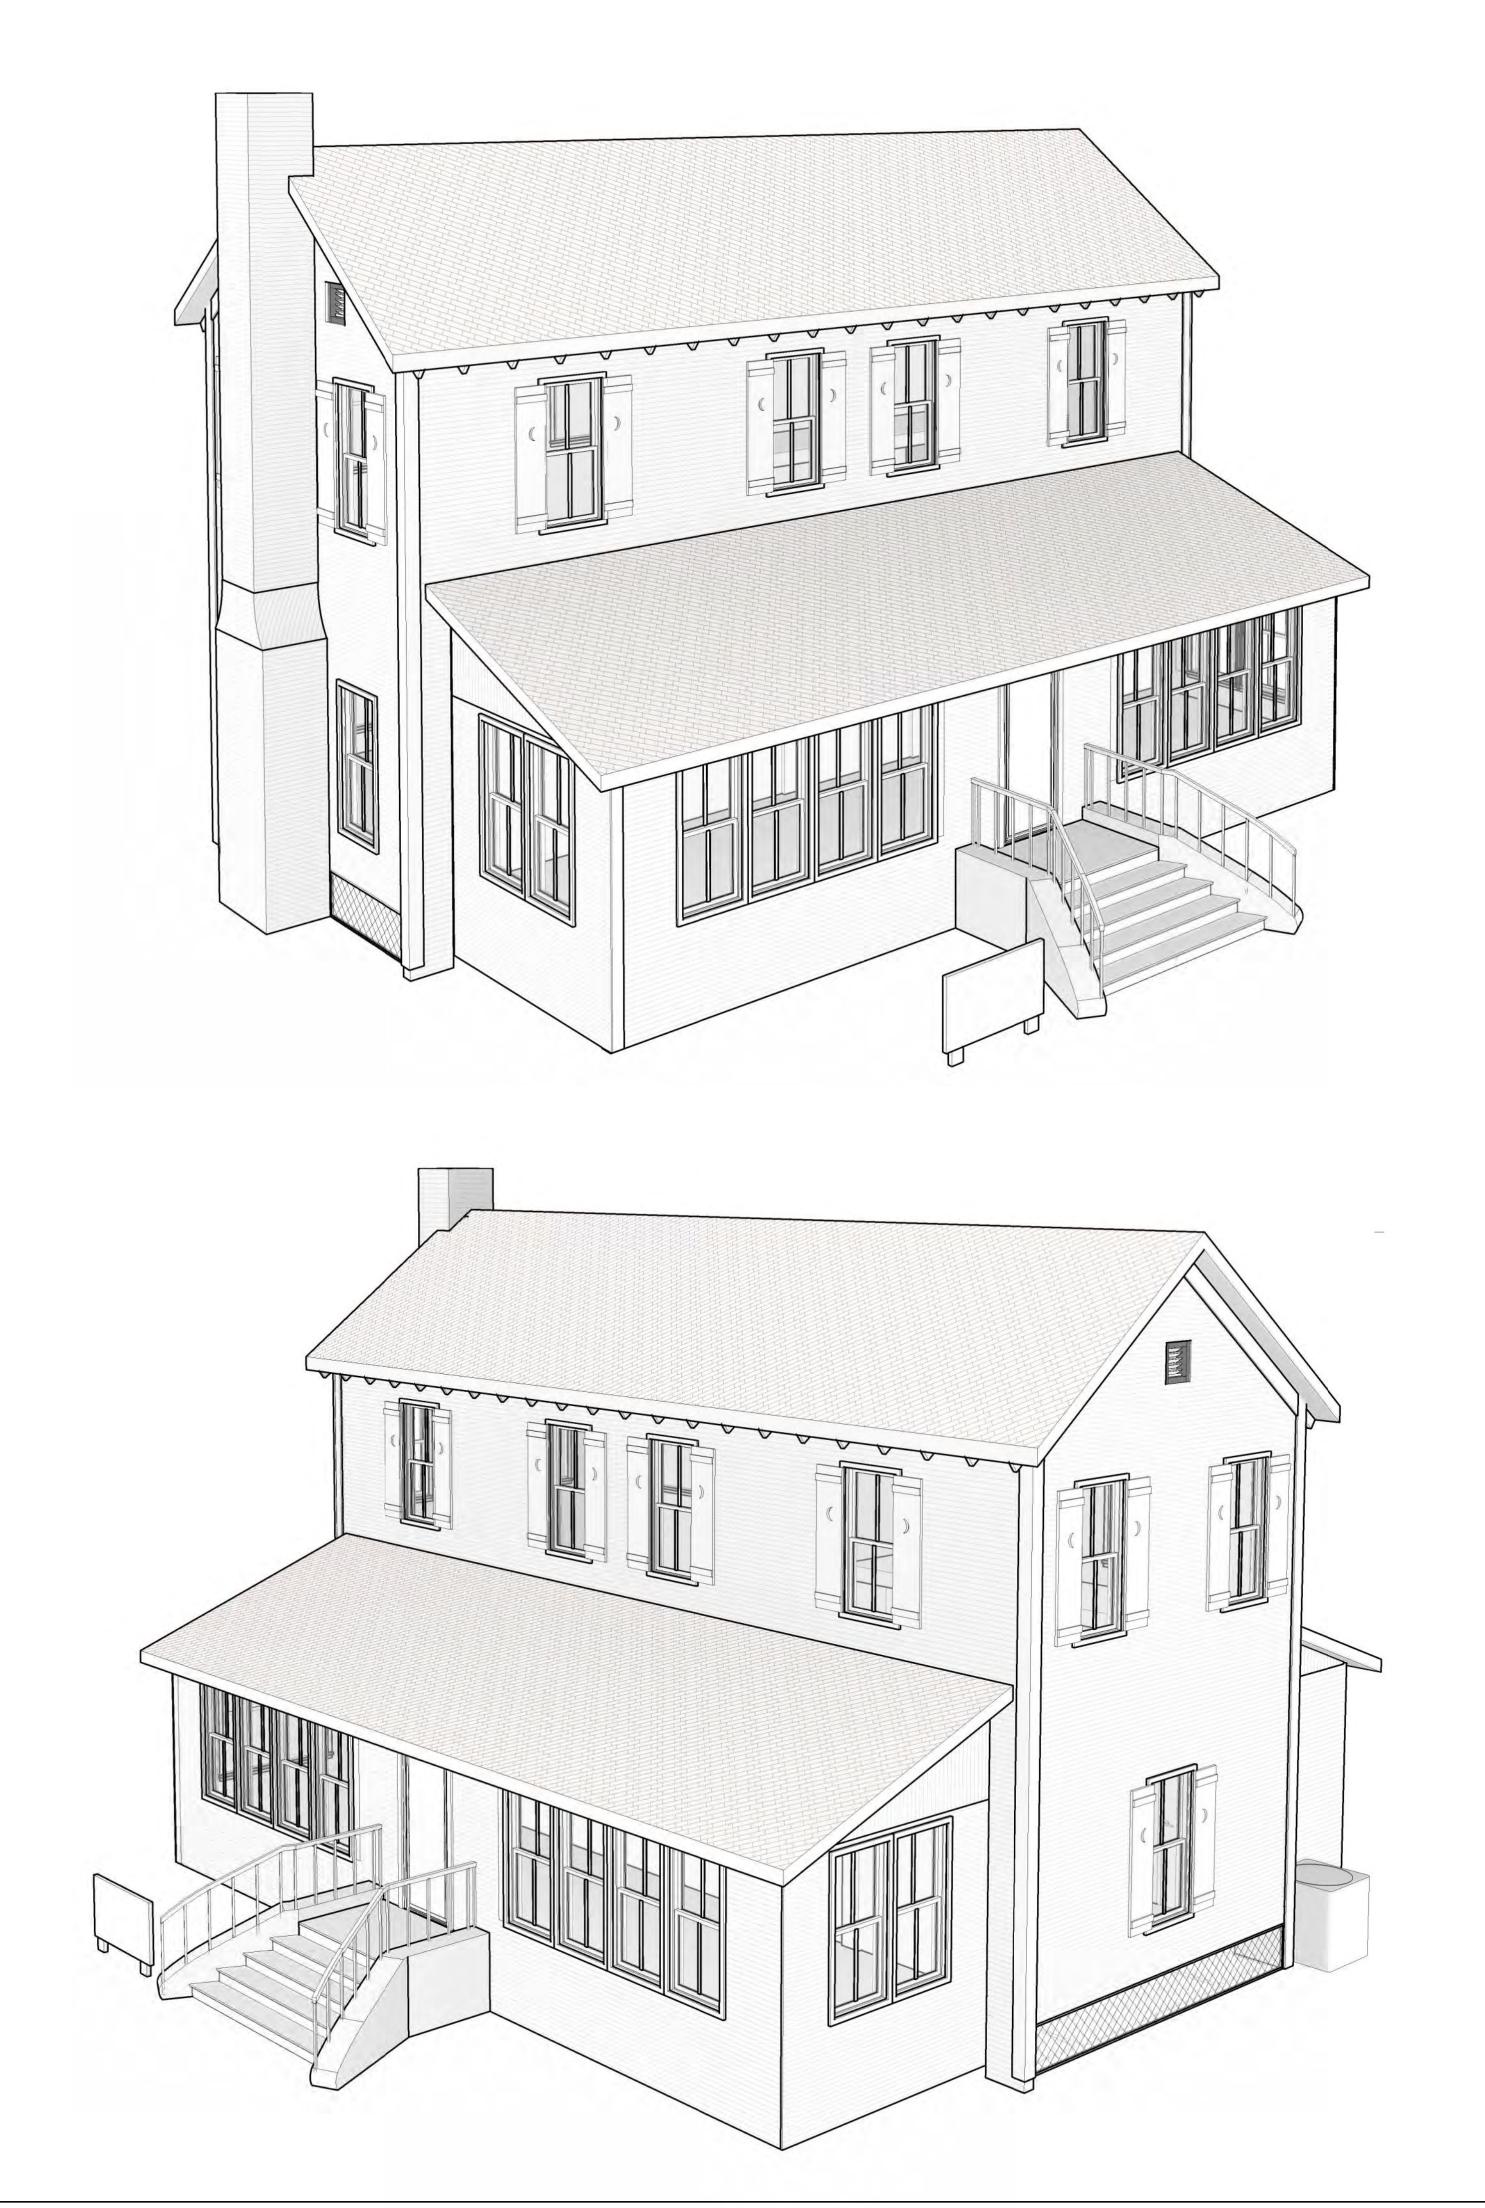



www.kallerarchitects.com

integrity of this document.

JOSEPH B. KALLER FLORIDA R.A. #0009239

HOUSE

HISTORIC


REVISIONS

REVISIONS			
No.	Description	Date	

This drawing, as an instrument of service, is and shall remain the property of the Architect and shall not be reproduced, published or used in any way without the permission of the Architect.

PROJECT No.: 24329 DRAWN BY: CHECKED BY: JBK

SHEET

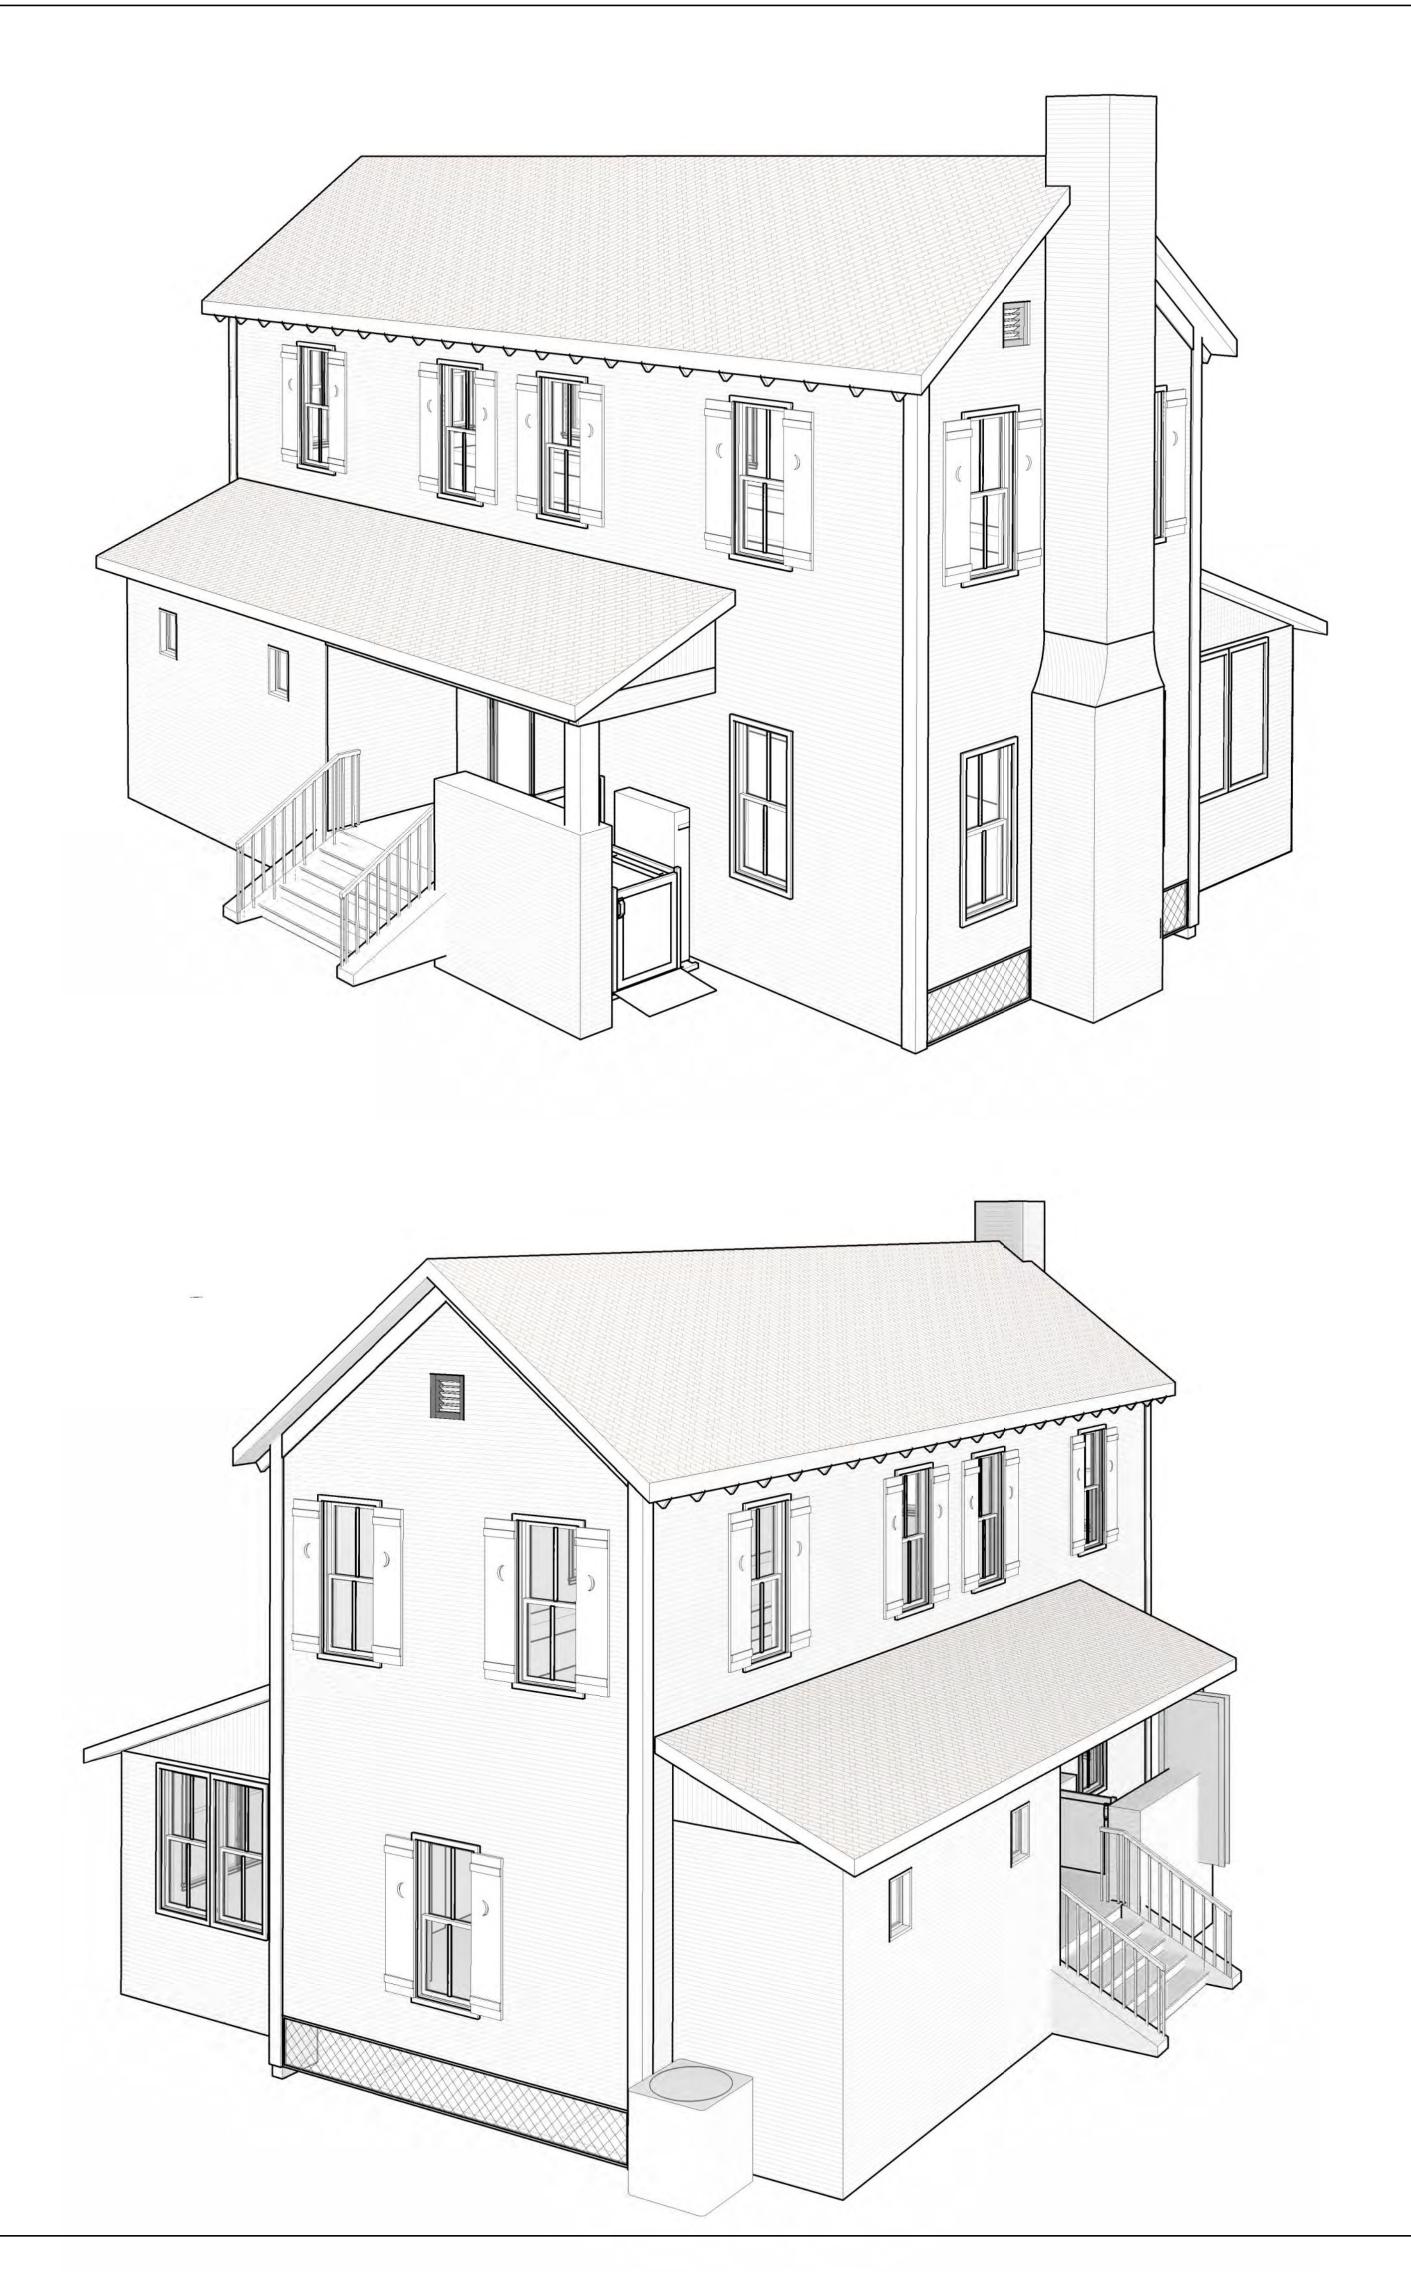



joseph@kallerarchitects.com
www.kallerarchitects.com

JOSEPH B. KALLER FLORIDA R.A. #0009239

FLORIDA R.A. #000923

щ

ICAL HOUSE

HISTORIC

PERSPECTIVES CONT.

3D PERSP

No.	Description	Date

property of the Architect and shall not be reproduced, published or used in any way without the permission of the Architect.

PROJECT No.: 24329

DATE: 02/19/2025

DRAWN BY: PZ

CHECKED BY: JBK

SHEET





www.kallerarchitects.com

JOSEPH B. KALLER FLORIDA R.A. #0009239

HOUSE

HISTORIC

RENDERING

**REVISIONS** 

This drawing, as an instrument of service, is and shall remain the property of the Architect and shall not be reproduced, published or used in any way without the permission of the Architect.

DRAWN BY: CHECKED BY: JBK

SHEET





www.kallerarchitects.com

integrity of this CRED ARCY document.

JOSEPH B. KALLER FLORIDA R.A. #0009239

HISTORIC


RENDERING

REVISIONS			
lo.	Description	Date	


This drawing, as an instrument of service, is and shall remain the property of the Architect and shall not be reproduced, published or used in any way without the permission of the Architect.


DRAWN BY: CHECKED BY: JBK


SHEET

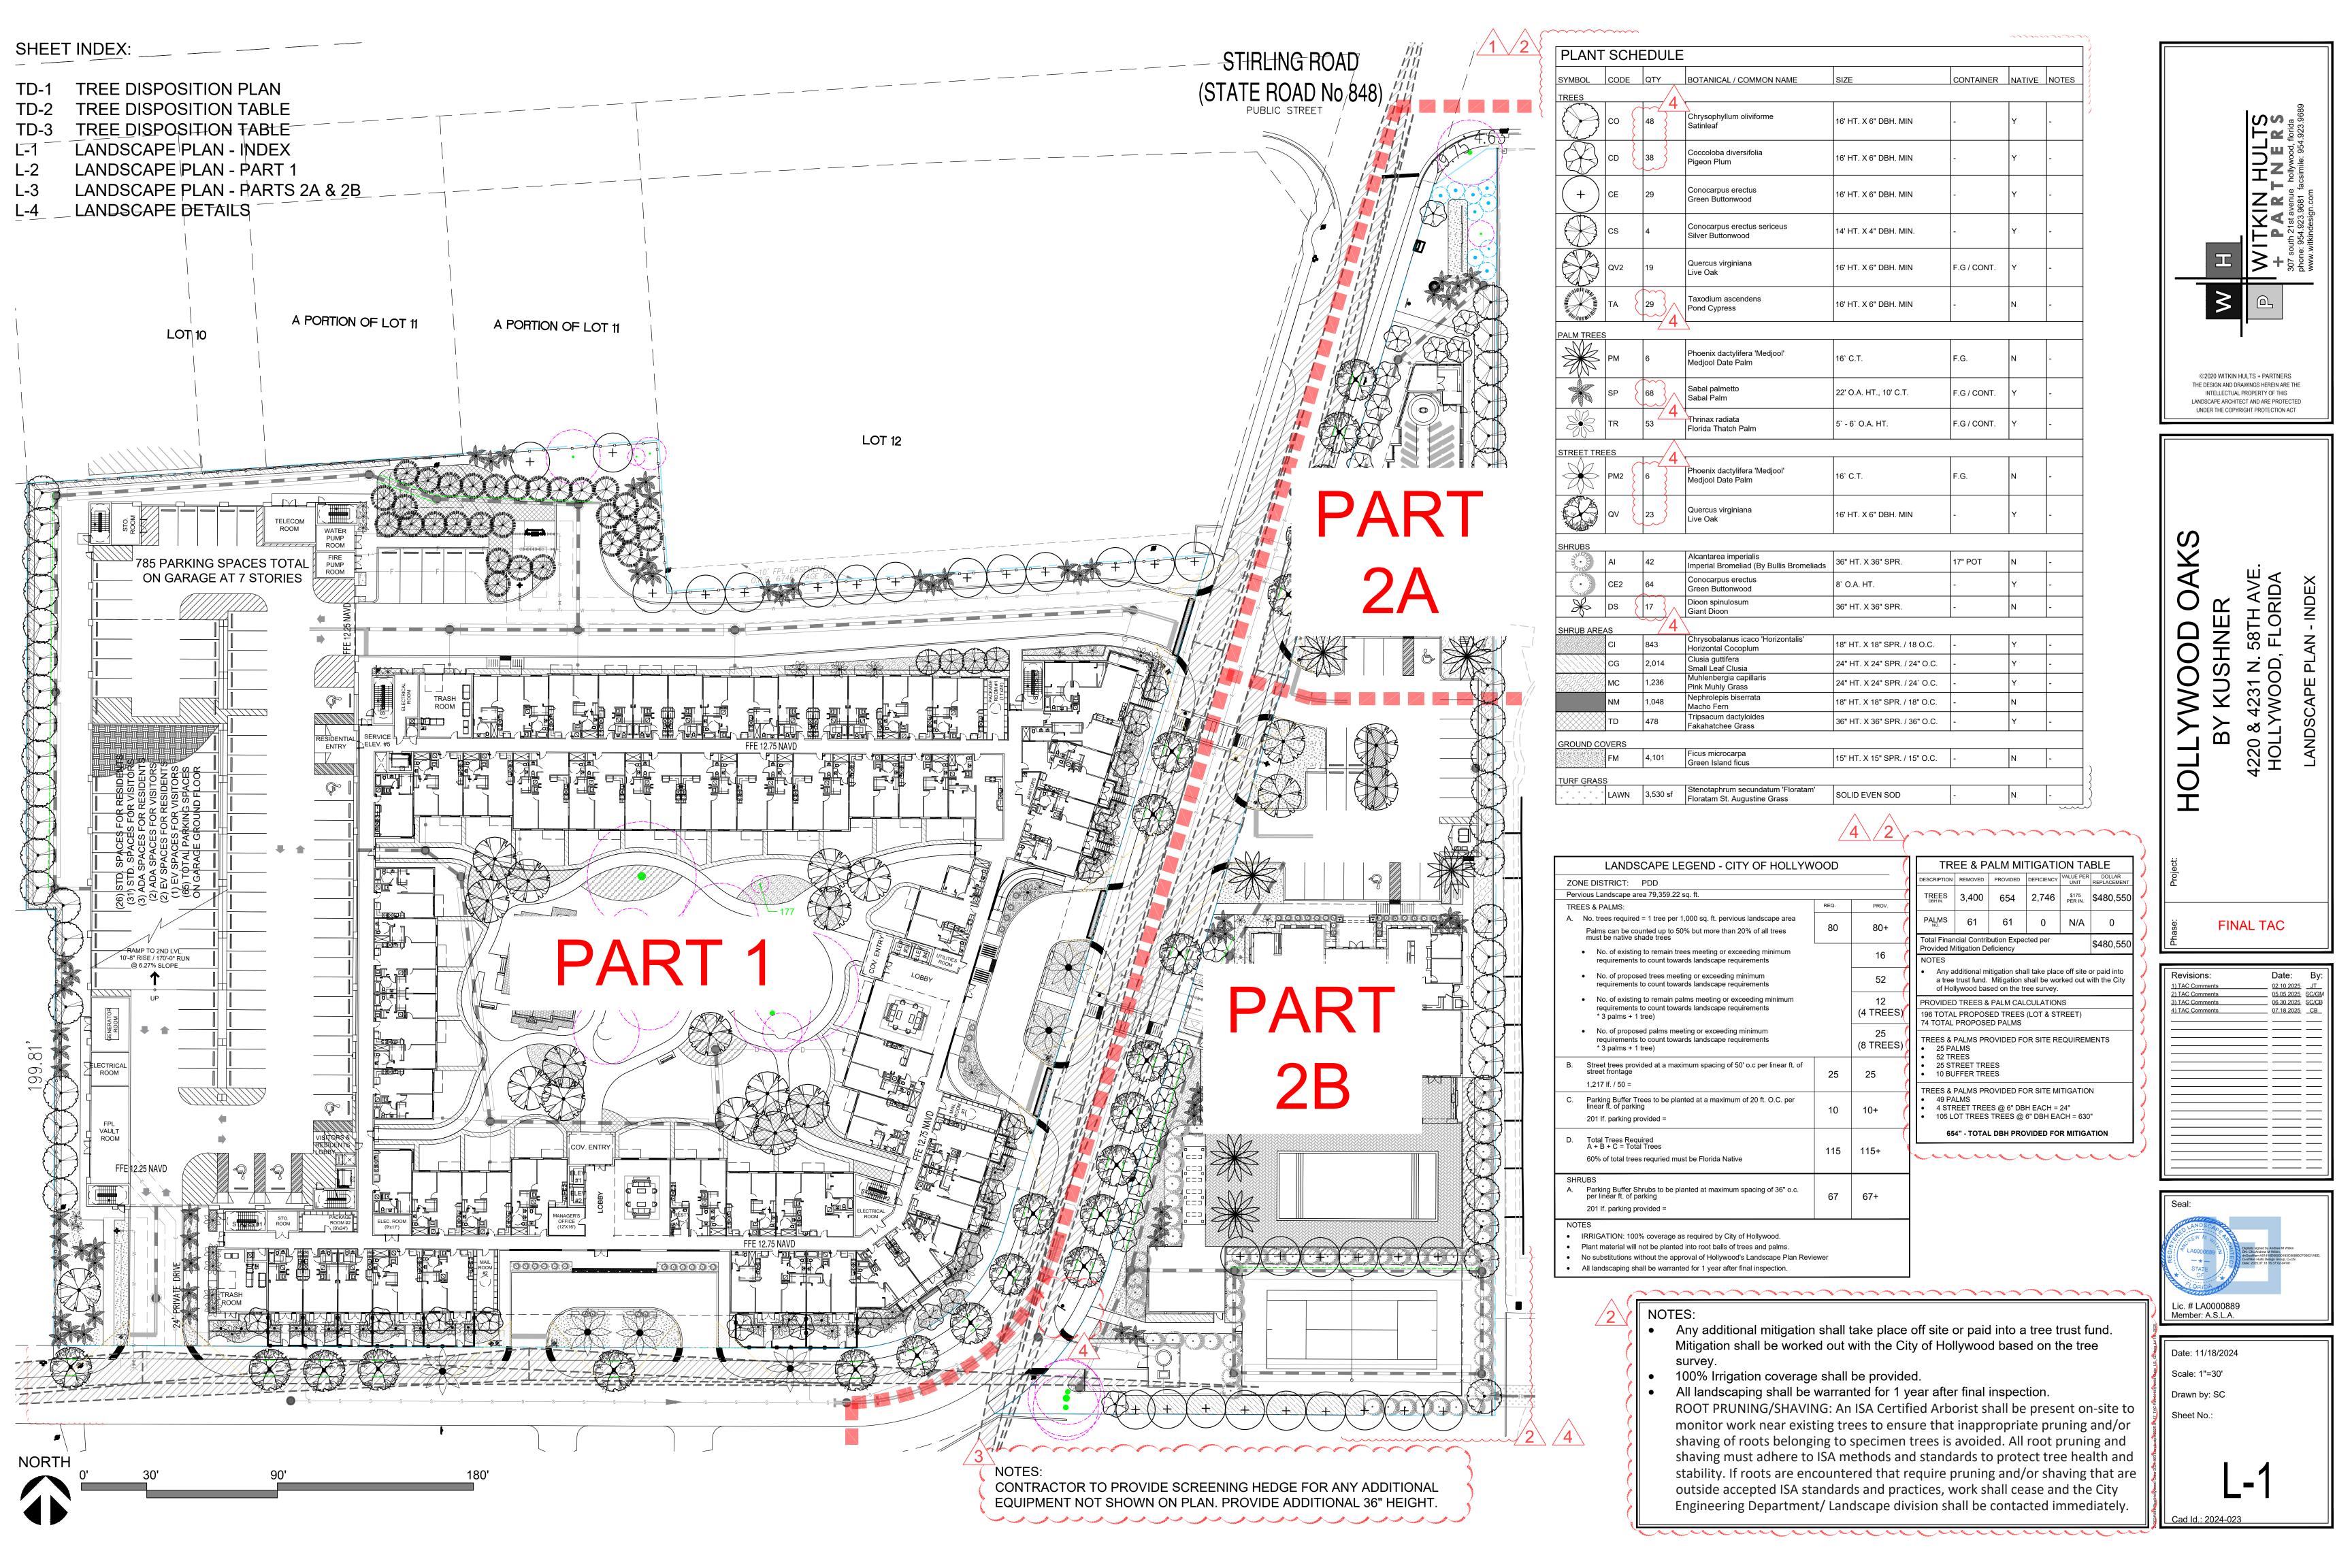





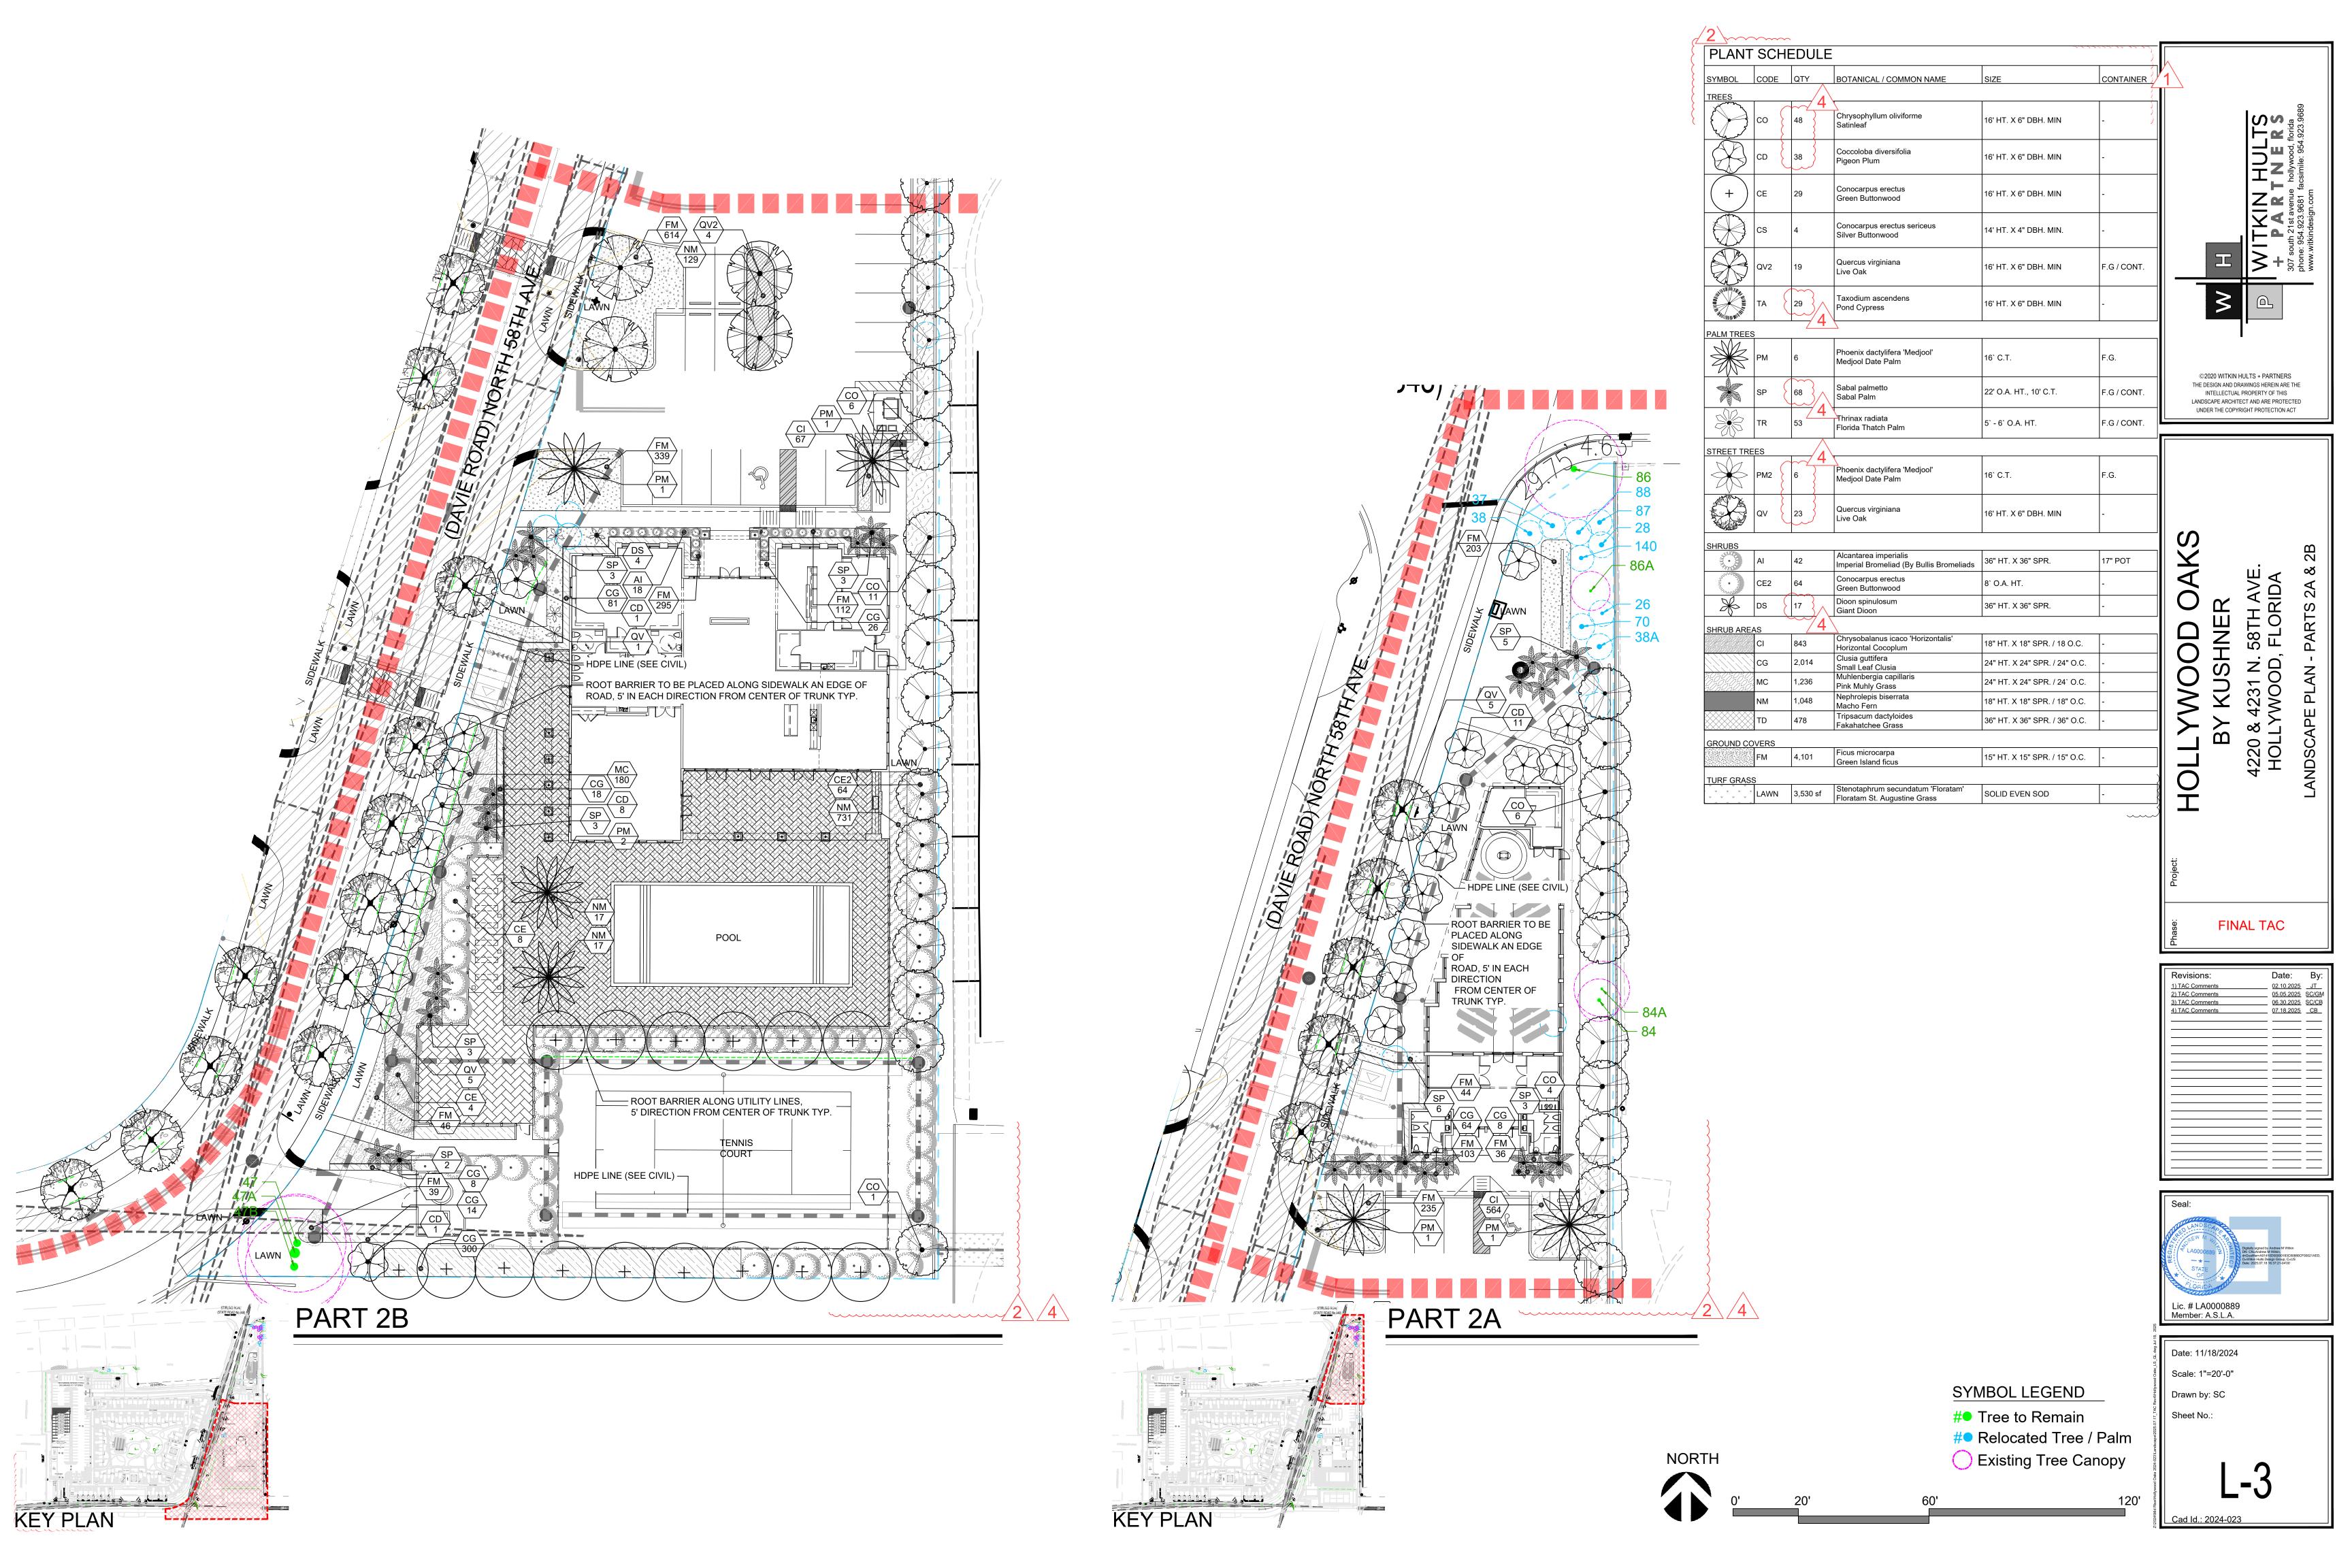

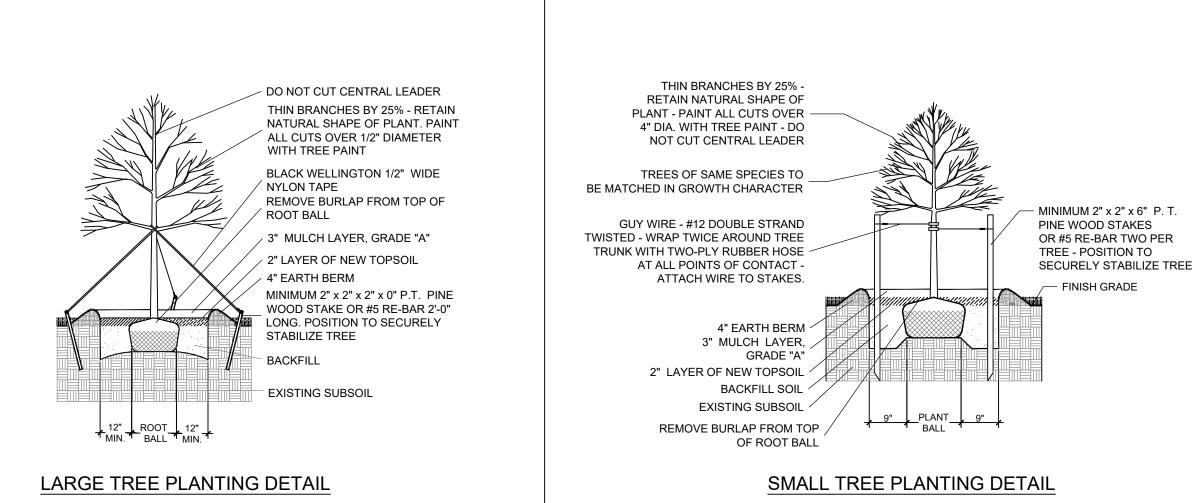


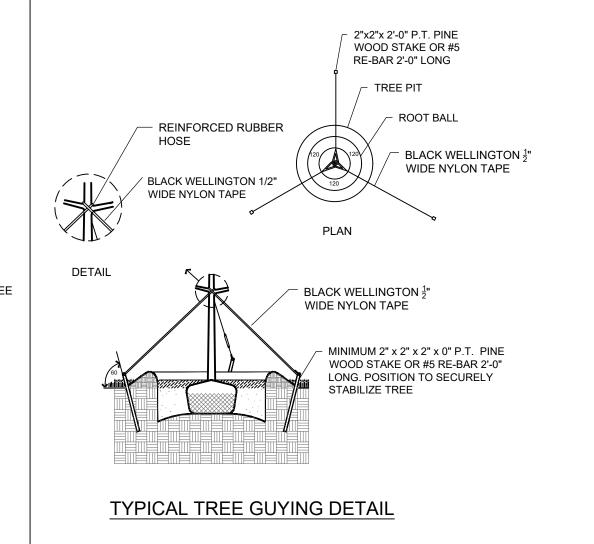


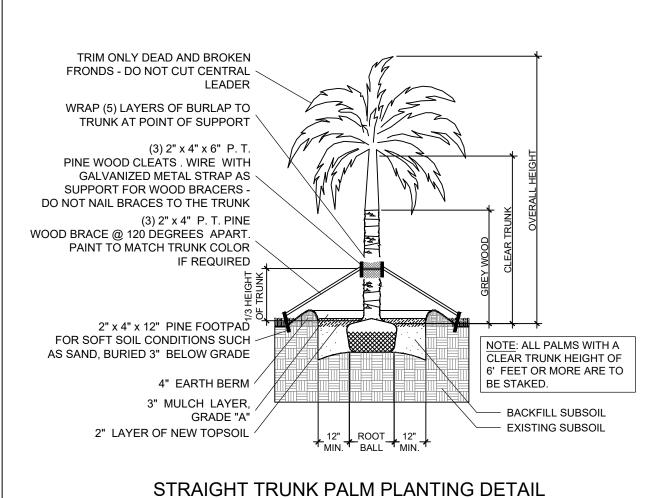


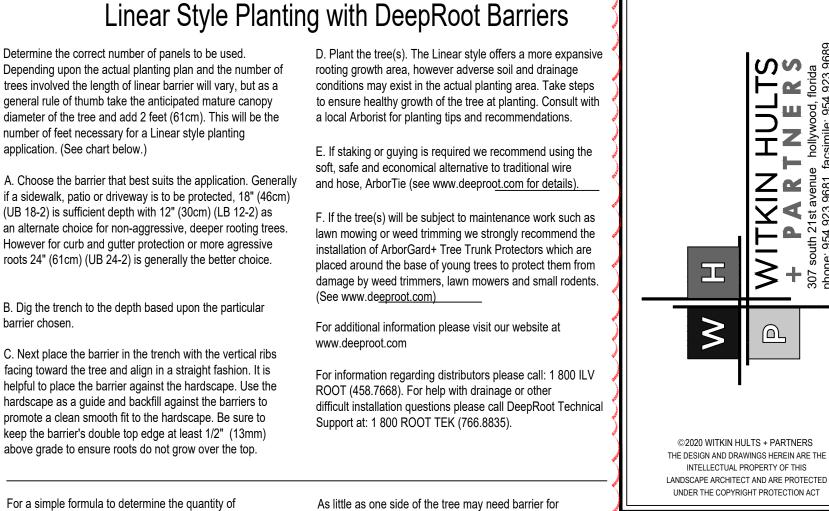


root direction as there may be no hardscape

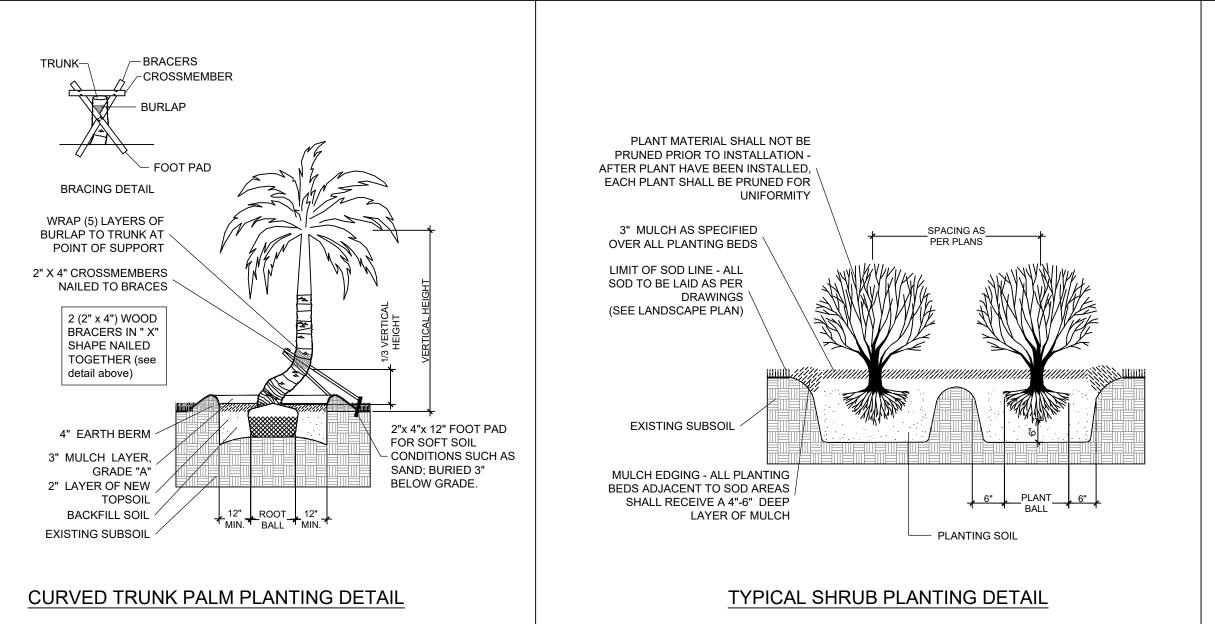

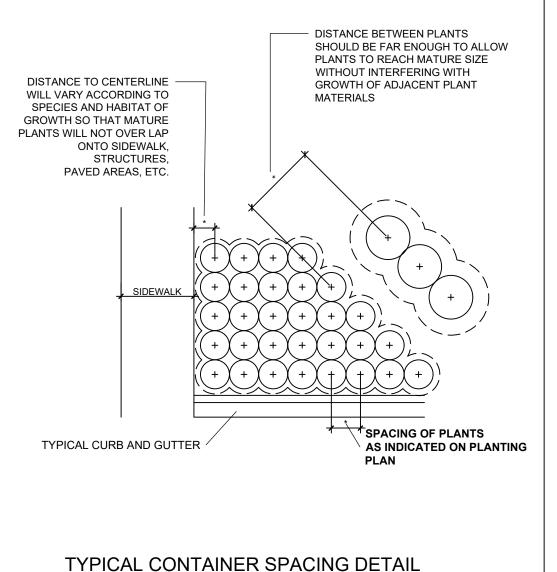

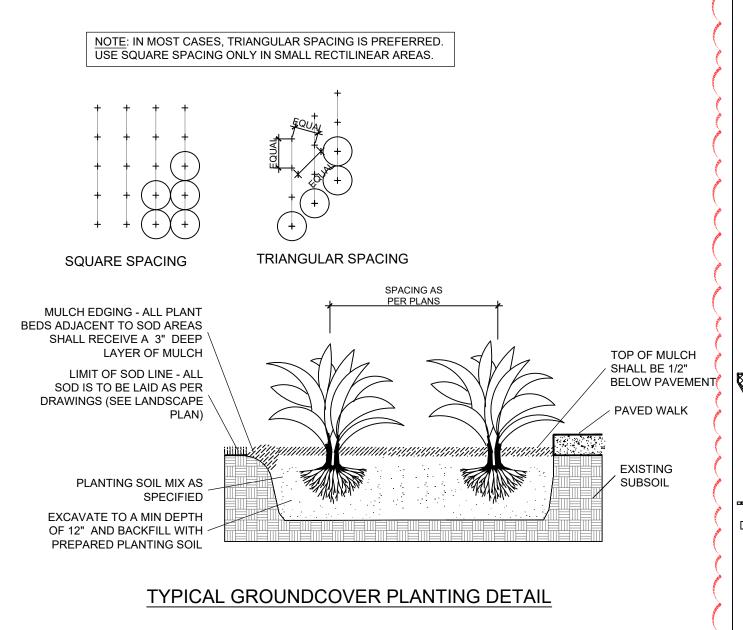

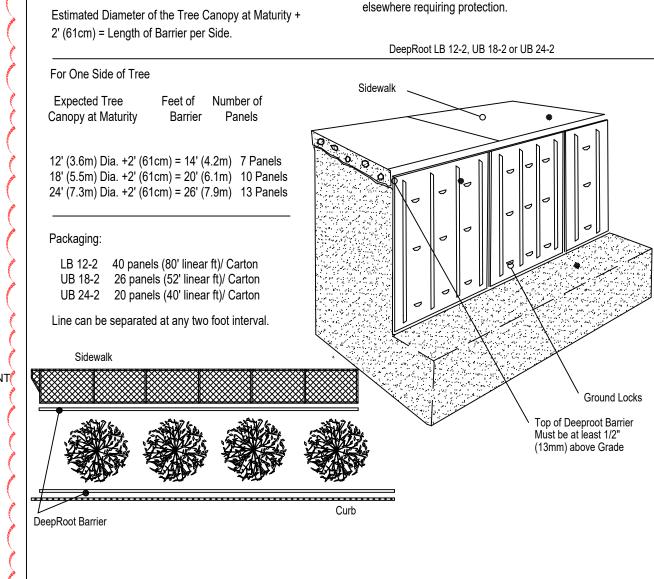

panels required for a Linear application use:

DEEPROOT-ROOT BARRIER DETAIL

# PLANTING NOTES:


- -All plant material is to be Florida Number 1 or better pursuant to the Florida Department of Agriculture's Grades and Standards for Nursery Plants.
- -All plants are to be top dressed with a minimum 3" layer of Melaleuca mulch, Eucalyptus mulch or equal.
- -Planting plans shall take precedence over plant list in case of discrepancies.
- -No changes are to be made without the prior consent of the Landscape Architect and Owner. Additions and or deletions to the plant material must be approved by the project engineer.
- -Landscape Contractor is responsible for providing their own square footage takeoffs and field verification for 100% sod coverage for all areas specified.
- All landscape areas are to be provided with automatic sprinkler system which provide 100% coverage, and 50% overlap.
- All trees in lawn areas are to receive a 24" diameter mulched saucer at the base of the trunk.
- Trees are to be planted within parking islands after soil is brought up to grade. Deeply set root balls are not acceptable.
- Planting soil for topsoil and backfill shall be 50/50 mix, nematode free. Planting soil for annual beds to be comprised of 50% Canadian peat moss, 25% salt free coarse sand and 25% Aerolite.
- Tree and shrub pits will be supplemented with "Agriform Pells", 21 gram size with a 20-10-5 analysis, or substitute application accepted by Landscape Architect. Deliver in manufacturer's standard containers showing weight, analysis and name of manufacturer.

# **SOD NOTES:**

- -Sod is to be grade "A" weed free.
- -All areas marked "LAWN" shall be solid sodded with St. Augustine 'Floratam' solid sod. See limit on plan. All areas marked 'Bahia Grass' shall be solid sodded with Paspalum.
- -Provide a 2" deep blanket of planting soil as described in planting notes this sheet. Prior to planting, remove stones, sticks, etc. from the sub soil surface. Excavate existing non-conforming soil as required so that the finish grade of sod is flush with adjacent pavement or top of curb as well as adjacent sod in the case of sod patching.
- -Place sod on moistened soil, with edges tightly butted, in staggered rows at right angles to slopes.
- -Keep edge of sod bed a minimum of 18" away from groundcover beds and 24" away from edge of shrub beds and 36" away from trees, measured from center of plant.
- -Sod Shall be watered immediatley after installation to uniformily wet the soil to at least 2" below the bottom of the sod strips.
- -Excavate and remove excess soil so top of sod is flush with top of curb or adjacent pavement or adjacent existing sod.


# **GENERAL NOTES:**


- -The Landscape Contractor is to locate and verify all underground and overhead utilities prior to beginning work. Contact proper utility companies and / or General Contractor prior to digging for field verification. The Owner and the Landscape Architect shall not be responsible for any damages to utility or irrigation lines (see Roadway Plans for more utility notes).
- -Landscape Contractor is to verify all current drawings and check for discrepancies and bring to the attention of the Landscape Architect prior to commencing with the work.
- -All unattended and unplanted tree pits are to be properly barricaded and flagged during installation.
- -All planting plans are issued as directives for site layout. Any deviations, site changes, etcetera are to be brought to the attention of the Landscape Architect for clarification prior to installation.

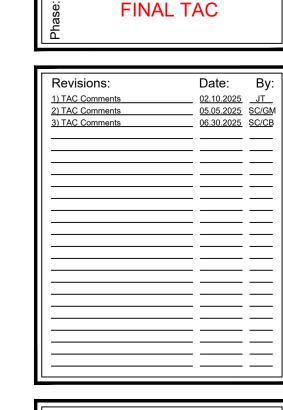

H




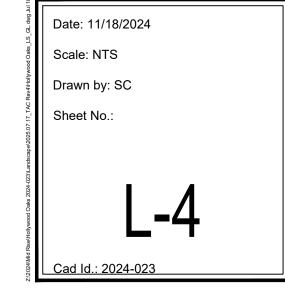

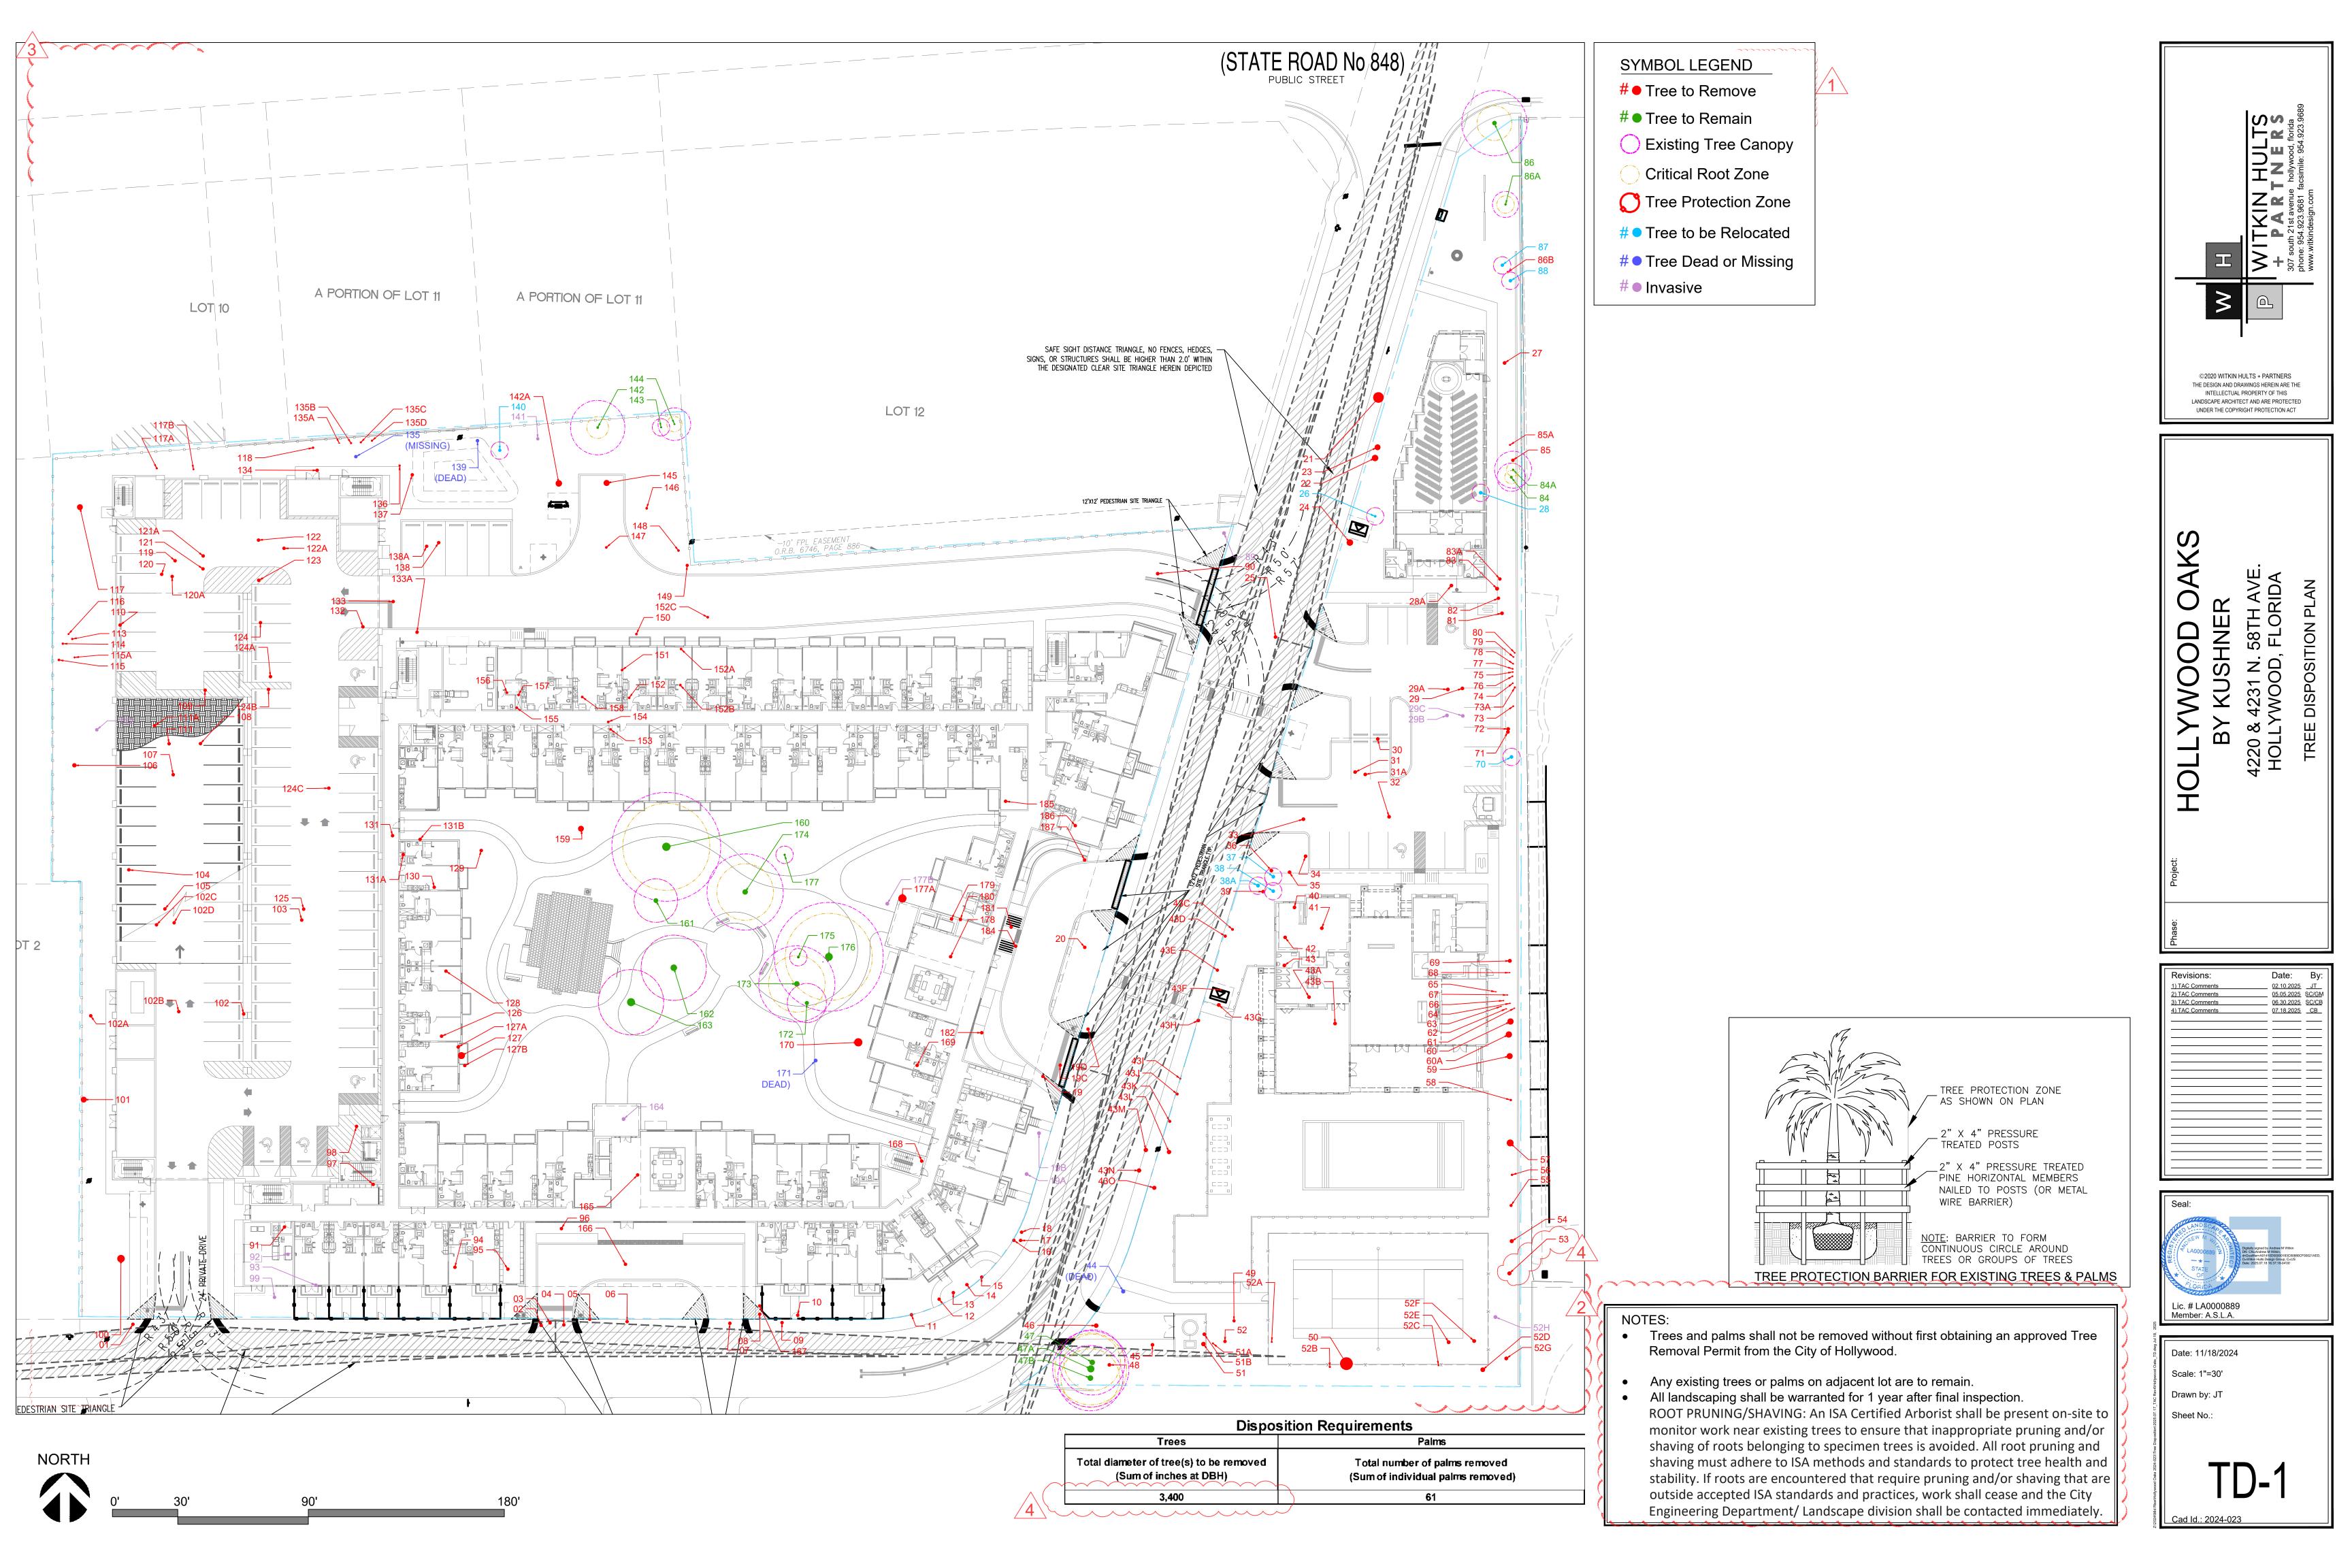

TREE#	COMMON NAME	BOTANICAL NAME	HEIGHT (ft)	WIDTH (ft)	DBH (in)	CLEAR TRUNK	HEALTH CONDITION	HEALTH CONDITION		TREE PROTECTION	SPECIMEN	UNDERSIZED	MITIGATION REQURIED	DISPOSITION	RELOCATION CANDIDATE	NOTES
1	Live Oak	Quercus virginiana	27.7	50	25.50	(ft)	Fair	% 47%	(CRZ)* 12.20	25.00	Y	N	YES	Remove	(Y/N) N	
2	Live Oak	Quercus virginiana	20	12	12.50		Fair	45%	6.00	6.00	N	N	YES	Remove	N	
3	Live Oak	Quercus virginiana	21.3	12	10.50		Fair	45%	5.00	6.00	N	N	YES	Remove	Ŋ	
4	Live Oak	Quercus virginiana	26.7	15	14.00		Fair	45%	7.00	7.50	N	N	YES	Remove	N	
5	Live Oak	Quercus virginiana	24.8	15	15.25		Fair	45%	7.50	7.50	N	N	YES	Remove	N	
6	Live Oak	Quercus virginiana	32.3	35	20.00		Fair	47%	10.00	17.50	Υ	N	YES	Remove	N	
7	Live Oak	Quercus virginiana	26.9	55	40.00		Fair	47%	20.00	27.50	Υ	N	YES	Remove	N	
8	Live Oak	Quercus virginiana	33.4	18	14.25		Fair	47%	7.00	9.00	N	N	YES	Remove	N	
9	Live Oak	Quercus virginiana	17.1	14	13.00		Fair	46%	6.50	7.00	N	N	YES	Remove	N	
10	Live Oak	Quercus virginiana	45.1	26	19.75		Fair	49%	10.00	13.00	Y	N	YES	Remove	N	
11	Live Oak	Quercus virginiana	51.8	46	33.00		Fair	51%	16.20	23.00	Y	N	YES	Remove	N	
12	Live Oak	Quercus virginiana	21.3	13	18.00		Poor	40%	6.50	6.50	Υ	N	YES	Remove	N	
13	Live Oak	Quercus virginiana	44.3	22	15.00		Fair	52%	7.50	11.00	N	N	YES	Remove	N	
14	Live Oak	Quercus virginiana	48.4	40	20.50		Fair	52%	10.00	20.00	Y	N	YES	Remove	N	
15	7. 7	Quercus virginiana	44.4	55	20.00		Fair	51%	10.00	22.00	Y	N	YES	Remove	N	
16		Quercus virginiana	26.4	42	23.00		Fair	48%	11.50	13.00	Y	N	YES	Remove	N	
17		Quercus virginiana	44.7	34	18.00		Fair	51%	9.00	17.00	Y	N	YES	Remove	Ŋ	
18	Live Oak	Quercus virginiana	42.7	34	17.50		Fair	50%	8.50	17.00	N	N	YES	Remove	N	
19	No. of the last of	Quercus virginiana	39.9	36	28.00		Fair	47%	14.00	18.00	Y	N	YES	Remove	N	Florida Invasive Species
19A		Schefflera actinophylla	20.5	15	9.00		Fair	49%	4.50	7.50	N	N	NO	Remove	N	Council Category I Invasive Florida Invasive Species
19B	Lancas and the same of the sam	Scheffiera actinophylla	24.5	15	13.00	126.5	Fair	49%	6.50	7.50	N	N.	NO NEC	Remove	N	Council Category I Invasive
19C		Ptychosperma elegans	24.5	6	4.50	20.5	Fair	52%	2.00	3.00	N	N	YES	Remove	N	
19D		Celtis laevigata	16.8	26	16.00		Fair	46%	8.00	13.00	N	N	YES	Remove	N	
20		Quercus virginiana	51.9	32	39.50		Fair	47%	16.00	16.00	Y	N	YES	Remove	N	
21		Quercus virginiana	40.6	52	54.50		Fair	56%	16.00	26.00	Y	N.	YES	Remove	N	
22	Secretary Secretary	Quercus virginiana	37.6	42	31.50		Fair	52%	10.00	21.00	Y	N	YES	Remove	N	
23		Quercus virginiana	37.6	32	28.25		Fair	54%	10.00	16.00	Y	N	YES	Remove	N	
24		Quercus virginiana	44.8 36.2	38 66	32.00 35.00		Fair Fair	55% 56%	16 <sub>-</sub> 00	19.00 33.00	Y	N N	YES	Remove	N N	
25		Quercus virginiana			-	24.0			1					Remove		_
26		Sabal palmetto	35.9	8	10.75	31.9	Fair	58%	4.00	4.00	N	N	YES	RELOCATE	Y	
27		Sabal palmetto	32.1	8	16.50	28.1	Good	65%	4.00	4.00	N	N	YES	Remove	N	
28		Sabal palmetto	21.2	8	15.00	17.2	Good	65%	4.00	4.00	N	N	YES	RELOCATE	Y	
28A		Bursera simaruba	24.6	35	17.75		Good	64%	9.00	17.50	N	N	YES	Remove	Y	
29		Quercus virginiana	50	34	31.00		Fair	54%	15.50	17.00	Y	N	YES	Remove	N	
29A		Quercus virginiana	21.9	27	21.00		Fair	50%	10.50	13.50	Y	N	YES	Remove	N	Florida Invasive Species
29B		Schinus terebinthifolia	15	15	6.00		Fair	29%			N	N	NO	Remove	N N	Council Category I Invasive Florida Invasive Species
29C		Schinus terebinthifolia	15	18	7.00		Fair	29%	***		N	N	NO	Remove	N	Council Category I Invasive
30	Live Oak	Quercus virginiana	45.5	56	45.00		Poor	37%	22.50	28.00	Y	N	YES	Remove	N	
31		Quercus virginiana	26.4	28	21.50		Poor	40%	11.00	14.00	Y	N	YES	Remove	N	
31A		Quercus virginiana	51.6	30	23.00		Very poor	15%	11.50	15.00	Y	N	YES	Remove	N	
32	7 h h h h	Quercus virginiana	36.1	32	23.00		Fair	52%	11.50	16.00	Y	N	YES	Remove	N N	
33		Quercus virginiana  Quercus virginiana	38.8	26	22.50		Poor	40%	10.00	10.00	Y	N	YES	Remove	N	
35		Quercus virginiana	38.8	15	15.25		Poor	40%	7.50	7.50	N	N	YES	Remove	N	
36	a com	Quercus virginiana	27.3	25	19.00		Poor	41%	9.50	12.50	Y	N	YES	Remove	N	
37		Sabal palmetto	17.1	8	15.50	13.1	Good	65%	4.00	4.00	N	N	YES	RELOCATE	Y	
38		Sabal palmetto	24.1	8	15.50	20.1	Good	65%	4.00	4.00	N	N	YES	RELOCATE	Y	
38A		Sabal palmetto	14	8	17.00	10	Good	65%	4.00	4.00	N	N	YES	RELOCATE	Y	
39		Quercus virginiana	50.6	65	34.50		Fair	47%	17.00	33.00	Y	N	YES	Remove	N	
40	4 To 2 A - 2	Quercus virginiana	41	44	25.00		Fair	48%	12.50	22.00	Y	N	YES	Remove	N	
41	DO 1800 100 1	Delonix regia	19.9	20	6.50		Fair	54%	3.00	10.00	N	N	YES	Remove	N	
42		Roystonea Regia	33.9	16	16.75	24.9	Good	65%	4.00	8.00	N	N	YES	Remove	Y	
43		Roystonea Regia	40.6	16	16.00	32.6	Good	65%	4.00	8.00	N	N	YES	Remove	Y	
43A		Delonix regia	23	12	6.50		Fair	54%	3.00	6.00	N	N	YES	Remove	Y	
43B		Adonidia merrillii	22	6	7.00	19	Fair	53%	3.00	3.00	N	N	YES	Remove	N	
43C		Quercus virginiana	26.4	25	11.50		Fair	48%	10.50	12.50	N	N	YES	Remove	N	
43D	N 8- W- C -	Quercus virginiana	34.2	30	14.00		Fair	50%	7.00	15.00	N	N	YES	Remove	N	
43E	Royal Poinciana	Delonix regia	28.4	30	26.00		Fair	52%	13.00	15.00	Y	N	YES	Remove	N	
43F	Royal Poinciana	Delonix regia	21.1	15	6.50		Fair	54%	3.00	7.50	N	N	YES	Remove	N	
43G		Dypsis lutescens	14.5	15	17.00	11.5	Fair	54%	4.00	7.50	N	N	YES	Remove	N	
43H	Royal Poinciana	Delonix regia	31.5	16	16.50		Fair	54%	8.00	8.00	N	N	YES	Remove	N	
431	Royal Poinciana	Delonix regia	33.3	20	7.00		Fair	52%	3.50	10.00	N	N	YES	Remove	N	
43J	Royal Poinciana	Delonix regia	33.3	22	12.00		Fair	52%	6.00	11.00	N	N	YES	Remove	N	
43K	Royal Poinciana	Delonix regia	36.5	20	12.50	1	Fair	53%	6.00	10.00	N	N	YES	Remove	N	
43L	Royal Poinciana	Delonix regia	28.7	28	20.00		Fair	53%	10.00	14.00	Y	N	YES	Remove	N	
43M	Live Oak	Quercus virginiana	34	30	27.50		Fair	51%	13.50	15.00	Y	N	YES	Remove	N	
43N	Live Oak	Quercus virginiana	30.6	24	19.00		Fair	46%	9.50	12.00	Y	N	YES	Remove	N	
430	Avocado	Persea Americana	20.4	12	13.75		Fair	47%	6.00	6.00	N	N	YES	Remove	N	Non-Native Fruit Tree
44	Live Oak	Quercus virginiana					Dead	0%			N	Y	NO	Remove	N	
45		Cocos nucifera	35	16	7.50	27	Good	65%	4.00	8.00	N	N	YES	Remove	Y	
46	Live Oak	Quercus virginiana	25.4	30	21.00		Fair	47%	10.00	15.00	Y	N	YES	Remove	N	
			-				1	51%	13.00	15.00	Y	N	NO	Remain	N	

REE#	COMMON NAME	BOTANICAL NAME	HEIGHT	WIDTH	DBH (in)	CLEAR	HEALTH	HEALTH CONDITION	CRITICAL ROOT ZONE	TREE PROTECTION	SPECIMEN	UNDERSIZED	MITIGATION	DISPOSITION	RELOCATION CANDIDATE	NOTES
KEE#	COMMON NAME	BO TANICAL NAME	(ft)	(ft)	DBH (III)	(ft)	CONDITION	%	(CRZ)*	ZONE (TPZ)**	SPECIMEN	UNDERSIZED	REQURIED	DISPOSITION	(Y/N)	NOTES
47A	Live Oak	Quercus virginiana	21.3	30	35.00		Fair	51%	16 50	15.00	Y	N	NO	Remain	N	
47B	Live Oak	Quercus virginiana	21.3	30	27.00		Fair	51%	13.50	15.00	Y	N	NO	Remain	N	
48	Coconut Palm	Cocos nucifera	43.7	16	13 75	35.7	Good	65%	4.00	8.00	N	N	YES	Remove	Y	
49	Mango	Mangifera indica	29.6	30	13,50		Fair	55%	6.50	15.00	Ν	N	YES	Remove	N	Non-Native Fruit Tree
50	Live Oak	Quercus virginiana	36.5	56	66.00		Fair	53%	28 00	28.00	Y	N	YES	Remove	N	
51	Royal Poinciana	Delonix regia	41.5	55	20.50		Fair	54%	10.00	26.50	Y	N	YES	Remove	N	
51A	Mango	Mangifera indica	24	15	6.50		Fair	52%	3.00	7.50	Ν	N	YES	Remove	N	Non-Native Fruit Tree
51B	Queen Palm	Syagrus romanzoffiana	30	7	7.50	23	Fair	52%	3.00	7.00	Ν	N	YES	Remove	N	
52	Mango	Mangifera indica	28.1	27	14.50		Fair	53%	7.00	13.50	N	N	YES	Remove	N	Non-Native Fruit Tree
52A	Mango	Mangifera indica	26.7	15	6.00		Fair	53%	3.00	7.50	N	N	YES	Remove	N	Non-Native Fruit Tree
52B	Mango	Mangifera indica	32.6	17	7.50		Fair	48%	3.00	8.50	N	N	YES	Remove	N	Non-Native Fruit Tree
52C	Live Oak	Quercus virginiana	33.8	28	5.50		Fair	45%	3.00	14.00	N	N	YES	Remove	N	
52D	Live Oak	Quercus virginiana	39.3	35	22.00		Fair	53%	11.00	17.50	Y	N	YES	Remove	N	
52E	Areca Palm	Dypsis lutescens	17.6	15	17.00		Fair	53%	4.00	7.50	N	N	YES	Remove	N	
52F	Areca Palm	Dypsis lutescens	17.6	15	17.00		Fair	53%	4.00	7.50	N	N	YES	Remove	N	
52G	Areca Palm	Dypsis lutescens	17.6	15	17.00		Fair	53%	4.00	7.50	N	N	YES	Remove	N	
									4.00	7.50					^	Florida Invasive Species
52H	Umbrella Tree	Schefflera actinophylla	35.9	23	16.50		Fair	53%			N	N	NO	Remove	4	Council Category I Invasive
53	Live Oak	Quercus virginiana	49	50	45.00		Fair	54%	16.00	25.00	Y	N	NO	Remove	N	
54	Live Oak	Quercus virginiana	22	22	18.25		Fair	54%	6.00	11.00	Y	N	YES	Remove	N	
55	Solitaire Palm	Ptychosperma elegans	45,5	6	13.00	37.5	Fair	53%	3.00	3.00	N	N	YES	Remove	N	
56	Solitaire Palm	Ptychosperma elegans	22.5	6	9.00	19.5	Fair	53%	3.00	3.00	N	N	YES	Remove	N	
57	Live Oak	Quercus virginiana	44.8	55	34.00		Fair	54%	11.00	27.50	Y	N	YE\$	Remove	N	
58	Solitaire Palm	Ptychosperma elegans	34.2	8	9.00	31.2	Fair	53%	3.00	3.00	N	N	YES	Remove	N	
59	Live Oak	Quercus virginiana	35.4	25	29.00		Fair	49%	11.00	12.50	Y	N	YES	Remove	N	
60	Live Oak	Quercus virginiana	45.7	55	30.50		Fair	50%	11.00	27.50	Y	N	YES	Remove	N	
60A	Live Qak	Quercus virginiana	38.9	40	31.00		Fair	53%	11.00	20.00	Y	N	YES	Remove	N	
61	Solitaire Palm	Ptychosperma elegans	25	6	3.50	22	Fair	53%	3.00	3.00	N	N	YES	Remove	N	
62	Solitaire Palm	Ptychosperma elegans	25	6	3.50	22	Fair	53%	3.00	3.00	N	N	YES	Remove	N	
63	Solitaire Palm	Ptychosperma elegans	25	6	3.50	22	Fair	53%	3.00	3.00	N	N	YES	Remove	N	
64	Solitaire Palm	Ptychosperma elegans	25	6	3.50	22	Fair	53%	3.00	3.00	N	N	YES	Remove	N	
65	Solitaire Palm	Ptychosperma elegans	25	6	3.50	22	Fair	53%	3.00	3.00	N	N	YES	Remove	N	
66	Solitaire Palm	Ptychosperma elegans	25	6	3.50	22	Fair	53%	3.00	3.00	N	N	YES	Remove	N	
67	Solitaire Palm	Ptychosperma elegans	25	6	3.50	22	Fair	53%	3.00	3.00	N	N	YES	Remove	N	
68	Solitaire Palm	Ptychosperma elegans	25	6	3.50	22	Fair	53%	3.00	3.00	N	N	YES	Remove	N	
69	Live Oak	Quercus virginiana	27.9	22	17.50		Fair	52%	6.00	11.00	N	N	YES	Remove	N	
70	Sabal Palm	Sabal palmetto	24	8	17.00	20	Good	65%	4.00	4.00	N	N	YES	RELOCATE	Y	
	Solitaire Palm	Ptychosperma elegans	25	6	3.00	22	Fair	53%	3.00	3.00	N N	Υ	NO	Remove	N	
	Solitaire Palm	Ptychosperma elegans	25	£	3.00	22	Fair	53%	3.00	3.00	N	Υ	NO	Remove	N N	
				0												
73	Solitaire Palm	Ptychosperma elegans	25	6	4.00	22	Fair	53%	3.00	3.00	N	N	YES	Remove	N	
73A	Gumbo Límbo	Bursera Simaruba	18	12	8.25		Fair	51%	4.00	6.00	N	N	YES	Remove	N	
74	Solitaire Palm	Ptychosperma elegans	23	6	5.00	20	Fair	53%	3.00	3.00	N	N	YES	Remove	N	
75	Solitaire Palm	Ptychosperma elegans	23	6	5.00	20	Fair	53%	3.00	3.00	N	N	YES	Remove	N	
76	Solitaire Palm	Ptychosperma elegans	23	6	5,00	20	Fair	53%	3.00	3.00	N	N	YES	Remove	N	
77	Solitaire Palm	Ptychosperma elegans	23	6	5.00	20	Fair	53%	3.00	3.00	N	N	YES	Remove	N	
78	Solitaire Palm	Ptychosperma elegans	23	6	5.00	20	Fair	53%	3.00	3.00	Ν	N	YES	Remove	N	
79	Solitaire Palm	Ptychosperma elegans	23	6	5.00	20	Fair	53%	3.00	3.00	Ν	N	YES	Remove	N	
80	Solitaire Palm	Ptychosperma elegans	23	6	5.00	20	Fair	53%	3.00	3.00	Ν	N	YES	Remove	N	
81	Live Oak	Quercus virginiana	20.5	12	6.00		Fair	52%	3.00	6.00	N	N	YES	Remove	N	
82	Live Oak	Quercus virginiana	21.4	17	8.00		Fair	52%	4.00	8.50	N	N	YES	Remove	N	
83	Live Oak	Quercus virginiana	37	35	17.00		Fair	54%	6.00	17.50	Ν	N	YES	Remove	N	
ЗА	Live Qak	Quercus virginiana	27.6	23	14.50		Fair	52%	4.00	11.50	N	N	YES	Remove	N	
34	Gumbo Limbo	Bursera Simaruba	13.5	13	11.75		Fair	57%	3.00	6.50	N	N	NO	Remain	N	
4A	Live Oak	Quercus virginiana	24.4	17	7.50		Fair	53%	3.00	8.50	N	N	NO	Remain	N	
85	Sabal Palm	Sabal palmetto	22.5	8	15.00	18.5	Fair	57%	4.00	4.00	N	N	YES	Remove	N	
85A	Live Oak	Quercus virginiana	23	15	7,00		Fair	54%	3.00	7.50	N	N	YES	Remove	N	
86	Black Olive	Bucida buceras	27.9	30	21.00		Fair	55%	8.00	15.00	Y	N	NO	Remain	N N	
36A	Live Oak	Quercus virginiana	22	12	8.50		Fair	55%	4.00	6.00	N	N	YES	Remain	N	
36B	Live Oak	Quercus virginiana	22.7	17	8.00		Fair	53%	4.00	8.50	N	N N	YES	Remove	N	
		•				A.E.									N Y	
97 	Sabal Palm	Sabal palmetto	19	8	15 00	15	Good	65%	4.00	4.00	N	N	YES	RELOCATE		
88	Sabal Palm	Sabal palmetto	19	8	15.00	15	Good	65%	4.00	4.00	N	N	YES	RELOCATE	Y	Florida Invasive Species
89	Carrotwood	Cupaniopsis anacardioides	25	15	12 25		Poor	37%			N	N	YES	Remove		Council Category I Invasive
	Strangler Fig	Ficus aurea	36.5	25	17.75		Fair	55%	9.00	12.50	N	N	YES	Remove	N	
<del>]</del> 1	Live Oak	Quercus virginiana	45.7	<b>7</b> 5	39.75		Fair	53%	20.00	37.50	Y	N	YES	Remove	N	Clevide lawers C
92	Umbrella Tree	Schefflera actinophylla	28	8	6.00		Fair	50%			N	N	NO	Remove	N	Florida Invasive Species Council Category I Invasive
93	Brazilian Pepper	Schinus terebinthifolia	22	17	15.00		Fair	47%			N	N	NO	Remove	N	Florida Invasive Species Council Category I Invasive
94	Queen Palm	Syagrus romanzoffiana	20.9	13	8.00	14.9	Fair	52%	4.00	4.00	N	N	YES	Remove	N	
95	Queen Palm	Syagrus romanzoffiana	20.9	13	8.00	14.9	Fair	52%	4.00	4.00	N	N	YES	Remove	N	
96	Queen Palm	Syagrus romanzoffiana	20.9	13	8.00	14.9	Fair	52%	4.00	4.00	N	N	YES	Remove	N	
97	Live Qak	Quercus virginiana	41.7	65	38,50		Fair	53%	19.00	33.00	Y	N	YES	Remove	N	
98	Queen Palm	Syagrus romanzoffiana	34.8	13	10.00	28.8	Fair	52%	4.00	4.00	Ν	N	YES	Remove	N	
99	Carrotwood	Cupaniopsis anacardioides	23	17	10 00		Fair	<b>4</b> 7%			Z	N	02		N	Florida Invasive Species Council Category I Invasive
				<u> </u>												Country Category . mitdente

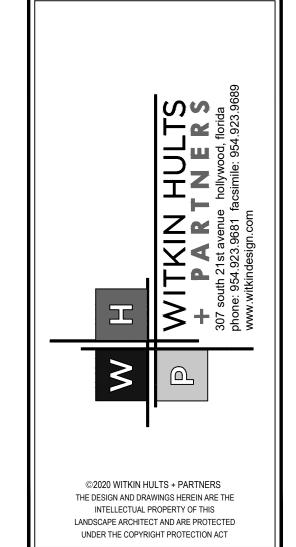

HOLLYWOOD OAKS

BY KUSHNER


4220 & 4231 N. 58TH AVE.
HOLLYWOOD, FLORIDA

TREE DISPOSITION TABLE

FINAL TAC

<u>ц</u>		
Revisions:	Date:	Ву:
1) TAC Comments	02.10.2025	_JT_
4) TAC Comments	07.18.2025	СВ
		= $ $
	•	



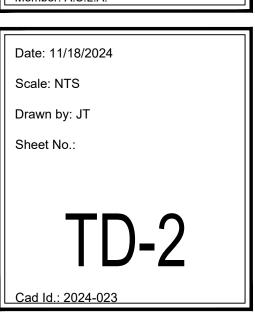

TREE #	COMMON NAME	BOTANICAL NAME	HEIGHT (ft)	WIDTH (ft)	DBH (in)	CLEAR TRUNK (ft)	HEALTH CONDITION	HEALTH CONDITION %	CRITICAL ROOT ZONE (CRZ)*	TREE PROTECTION ZONE (TPZ)**	SPECIMEN	UNDERSIZED	MITIGATION REQURIED	DISPOSITION	RELOCATION CANDIDATE (Y/N)	NOTES
101	Avocado	Persea americana	30.5	28	28.00		Fair	50%	14.00	14.00	Y	N	YES	Remove	N	Non-Native Fruit Tree
102	Live Oak	Quercus virginiana	39.8	54	34.00		Fair	55%	17.00	20.00	Y	N	YES	Remove	N	
102A	Strangler Fig	Ficus aurea	31.9	35	21.50	-	Fair	54%	11.00	17.50	Y	N	YES	Remove	N	
102B	Live Oak	Quercus virginiana	30.9	40	23.00		Fair	50%	11.50	20.00	Y	N	YES	Remove	N	
102C	Royal Poinciana  Queen Palm	Delonix regia Syagrus romanzoffiana	42.8	15	8.00	22.1	Fair Fair	50%	5.00	7.50	N	N N	YES	Remove	N	
103	Live Oak	Quercus virginiana	37	38	27.00	22.1	Fair	45%	13.50	19.00	Y	N	YES	Remove	N	
104	Mango	Mangifera indica	38.7	28	25.00		Fair	53%	12.50	14.00	Y	N	YES	Remove	N	Non-Native Fruit Tree
105		Mangifera indica	53.2	60	37.00		Fair	55%	18.50	30.00	Y	N	YES	Remove	N	Non-Native Fruit Tree
106	Live Oak	Quercus virginiana	39.4	30	16.50		Fair	52%	8.00	15.00	N	N	YES	Remove	N	
107	Mango	Mangifera indica	34.2	37	19.00		Fair	55%	9.50	18.50	Y	N	YES	Remove	N	Non-Native Fruit Tree
108	Mango	Mangifera indica	31.4	22	19.25		Fair	46%	10.00	11.00	Y	N	YES	Remove	N	Non-Native Fruit Tree
109	Mango	Mangifera indica	40.5	27	19.50		Fair	55%	10.00	13.50	Y	N	YES	Remove	N	Non-Native Fruit Tree
110	Weeping Fig	Ficus benjamina	42	36	49.50		Fair	49%	18.00	18.00	Y	N	YES	Remove	N	Non-Native Fruit Tree
111	Live Oak	Quercus virginiana	40.4	30	22.50		Fair	46%	11.00	15.00	Y	N	YES	Remove	N	
111A	Coconut Palm	Cocos nucifera	36.7	16	8.25	28.7	Good	6%	8.00	8.00	N	N	YES	Remove	Y	
112	Brazilian Pepper	Schinus terebinthifolia	27.8	30	22.00		Fair	48%			N	N	NO	Remove	N	Florida Invasive Species Council Category I Invasive
113	Royal Poinciana	Delonix regia	44	15	8.50		Fair	53%	4.00	7.50	N	N	YES	Remove	N	
114	Royal Poinciana	Delonix regia	44	15	8.50		Fair	53%	4.00	7.50	N	N	YES	Remove	N	
115	Royal Poinciana	Delonix regia	44	15	10.75		Fair	53%	5.00	7.50	N	N	YES	Remove	N	
115A	Royal Poinciana	Delonix regia	44	7.5	6.50		Fair	53%	3.00	3.50	N	N	YES	Remove	N	
116	Royal Poinciana	Delonix regia	44	15	7.00		Fair	53%	3.50	7.50	N	N	YES	Remove	N	
117	A CONTRACT OF STATE O	Quercus virginiana	42.4	55	29.50		Fair	54%	15.00	27.50	Y	N	YES	Remove	N	
117A	Royal Poinciana	Delonix regia	20.5	15	8.00		Fair	55%	4.00	7.50	N	N	YES	Remove	N	
117B	Royal Poinciana	Delonix regia	24.1	12	6.50		Fair	55%	3.00	6.00	N	N	YES	Remove	N	
	Queen Palm	Syagrus romanzoffiana	38	13	8.50	32	Fair	53%	4.00	4.00	N	N	YES	Remove	N	
119	Royal Poinciana	Delonix regia	44	36	28.50		Fair	46%	14.00	18.00	Y	N	YES	Remove	N	
	Royal Poinciana	Delonix regia	42.8	52	53.50		Fair	51%	21.00	21.00	Y	N	YES	Remove	N	
	Royal Poinciana	Delonix regia	33.6	25	16.00		Fair	50%	8.00	12.50	N	N	YES	Remove	N	
		Mangifera indica	36.4	26	16.50		Fair	54%	8.00	13.00	N	N	YES	Remove	N	Non-Native Fruit Tree
121A	22	Mangifera indica	17.7	17	6.75		Fair	52%	3.00	8.50	N	N	YES	Remove	N	Non-Native Fruit Tree
TOWN AND AND AND AND AND AND AND AND AND AN		Mangifera indica	32.4	30	18.50		Fair	54%	9.00	15.00	Y	N	YES	Remove	N	Non-Native Fruit Tree
122A	Avocado	Persea americana	32.8	20	26.50		Poor	25%	10.00	10.00	Y	N	YES	Remove	N	Non-Native Fruit Tree
123	Mango	Mangifera indica	30.7	25	17.50		Fair	53%	8.50	12.50	N	N	YES	Remove	N	Non-Native Fruit Tree
124	Avocado	Persea americana	31.1	18	18.50		Poor	37%	9.00	9.00	Y	N	YES	Remove	N	Non-Native Fruit Tree
124A	Mango	Mangifera indica	28.8	15	8.25		Fair	53%	4.00	7.50	N	N	YES	Remove	N	Non-Native Fruit Tree
124B		Mangifera indica	30	20	13.00		Fair	53% 64%	7.50 4.00	10.00	N	N	YES	Remove	N	Non-Native Fruit Tree
124C 125	Laurel Oak Live Oak	Quercus laurifolia	34 42.6	30 40	15.25 33.50		Good	46%	16.50	15.00 20.00	N Y	N N	YES YES	Remove	N N	
126		Quercus virginiana	47.6	52	43.00		Fair	51%	21.50	36.00	Y	N	YES	Remove	N	
127	Live Oak	Quercus virginiana  Quercus virginiana	33.9	34	34.50		Fair	49%	17.00	17.00	Y	N	YES	Remove	N	
100.00	Queen Palm	Syagrus romanzoffiana	30	13	6.00	24	Fair	53%	4.00	4.00	N	N N	YES	Remove	N N	
127B		Syagrus romanzoffiana	30	13	8.00	24	Fair	53%	4.00	4.00	N	N	YES	Remove	N	
128		Quercus virginiana	48.8	18	30.50		Fair	44%	9.00	9.00	Y	N N	YES	Remove	N	
129	Live Oak	Quercus virginiana	51.6	25	39.00		Poor	28%	12.50	12.50	Y	N	YES	Remove	N	
130	Live Oak	Quercus virginiana	40.1	30	27.00		Fair	47%	13.50	25.00	Y	N	YES	Remove	N	
131		Quercus virginiana	40.9	45	50.00		Poor	32%	22.50	22.50	Y	N	YES	Remove	N	
131A		Syagrus romanzoffiana	30	13	8.00	24	Fair	53%	4.00	4.00	N	N	YES	Remove	N	
131B	Live Oak	Quercus virginiana	34.4	15	29.00		Poor	27%	7.50	7.50	Y	N	YES	Remove	N	
132	Avocado	Persea americana	29.8	30	15.00		Fair	54%	7.50	15.00	N	N	YES	Remove	N	Non-Native Fruit Tree
133	Mango	Mangifera indica	32	26	17.00		Fair	52%	8.50	13.00	N	N	YES	Remove	N	
133A	Frangi Pani	Plumeria sp.	18.8	15	8.50		Fair	54%	4.00	7.50	N	N	YES	Remove	N	
134	Mango	Mangifera indica	35.3	43	36.00		Fair	53%	18.00	21.50	Y	N	YES	Remove	N	Non-Native Fruit Tree
135	Missing						Missing	0%			N/A	N/A	N/A	N/A	N	
135a	Queen Palm	Syagrus romanzoffiana	30.1	8	4.00	24	Fair	53%	4.00	4.00	N	N	YES	Remove	N	
135b	Queen Palm	Syagrus romanzoffiana	30.1	13	8.00	24.1	Fair	53%	4.00	4.00	N	N	YES	Remove	N	
135c	Queen Palm	Syagrus romanzoffiana	30.1	13	8.00	24.1	Fair	53%	4.00	4.00	N	N	YES	Remove	N	
135d	Queen Palm	Syagrus romanzoffiana	30.1	13	8.00	24.1	Fair	53%	4.00	4.00	N	N	YES	Remove	N	
136	Sabal Palm	Sabal palmetto	30.1	13	8.00	24.1	Good	65%	4.00	4.00	N	N	YES	Remove	N	
137	Mango	Mangifera indica	30.4	20	19.25		Fair	51%	10.00	10.00	Y	N	YES	Remove	N	Non-Native Fruit Tree
138	Sabal Palm	Sabal palmetto	31.8	8	12.00	27.8	Good	65%	4.00	4.00	N	N	YES	Remove	N	
138A	Silk Cotton Tree	Ceiba pentandra	29.2	35	31.50		Fair	56%	15.50	17.50	Y	N	YES	Remove	N	
139	Queen Palm	Syagrus romanzoffiana					Dead	0%			N/A	N/A	NO	Remove	N	
140	Sabal Palm	Sabal palmetto	22.9	8	13.50	18.9	Good	65%	4.00	4.00	N	N	YES	RELOCATE	Y	
141	Queen Palm	Syagrus romanzoffiana	25	13	8.00	19	Good	65%	4.00	4.00	N	N	NO	Remove	Y	Florida Invasive Species Council Category I Invasive
142	Royal Poinciana	Delonix regia	27	25	10.50		Good	65%	5.00	12.50	N	N	NO	Remain	N	
	Mango	Mangifera indica	35.6	32	31.50		Fair	51%	15.50	16.00	Υ	N	YES	Remove	N	Non-Native Fruit Tree
142A		400000000000000000000000000000000000000	26.8	8	6.00	20.8	Fair	46%	4.00	4.00	N	N	NO	Remain	N	
4	Queen Palm	Syagrus romanzoffiana	20.0					, h		-		<del></del>				
4.00	Queen Palm Frangi Pani	Syagrus romanzoftiana Plumeria sp.	16.7	15	7.00		Fair	53%	3.50	7.50	N	N	NO	Remain	N	

TREE #	COMMON NAME	BOTANICAL NAME	HEIGHT (ft)	WIDTH (ft)	DBH (in)	CLEAR TRUNK (ft)	HEALTH CONDITION	HEALTH CONDITION %	CRITICAL ROOT ZONE (CRZ)*	TREE PROTECTION ZONE (TPZ)**	SPECIMEN	UNDERSIZED	MITIGATION REQURIED	DISPOSITION	RELOCATION CANDIDATE (Y/N)	NOTES
147	Mango	Mangifera indica	29.5	33	20.00		Fair	54%	10.00	16.50	Y	N	YES	Remove	N	Non-Native Fruit Tree
148	Sabal Palm	Sabal palmetto	28	8	10.00	24	Good	65%	4.00	4.00	N	N	YES	Remove	N	
149	Sabal Palm	Sabal palmetto	25	8	14.00	21	Good	65%	4.00	4.00	N	N	YES	Remove	N	
150	Foxtail Palm	Wodyetia bifurcata	23	8	12.00	19	Fair	59%	4.00	4.00	N	N	YES	Remove	Υ	
151	Coconut Palm	Cocos nucifera	24	14	10.00	18	Good	65%	7.00	7.00	N	N	YES	Remove	Υ	
152	Foxtail Palm	Wodyetia bifurcata	14	6	7.00	8	Fair	58%	4.00	4.00	N	N	YES	Remove	Y	
152a	Japanese Blueberry	Elaeocarpus decipiens	19.7	15	9.00		Fair	53%	4.50	7.50	N	N	YES	Remove	N	
152b	Japanese Blueberry	Elaeocarpus decipiens	10	8	7.00		Fair	50%	3.50	4.00	N	N	YES	Remove	N	
152c	Mango	Mangifera indica	42.6	40	27.00		Fair	49%	13.50	20.00	Y	N	YES	Remove	N	Non-Native Fruit Tree
153	Foxtail Palm	Wodyetia bifurcata	20	8	7.00	16	Good	65%	4.00	4.00	N	N	YES	Remove	Y	
154	Foxtail Palm	Wodyetia bifurcata	20	8	7.00	16	Good	65%	4.00	4.00	N	N	YES	Remove	Y	
155	Foxtail Palm	Wodyetia bifurcata	18.5	8	7.00	14.5	Fair	53%	4.00	4.00	N	N	YES	Remove	N	
156	Triangle Palm		18.5	12	11.50	10.5	Fair	53%	4.00	4.00	N	N N	YES	Remove	N	
157	Triangle Palm	Dypsis decaryi	18.5	12	11.50	10.5	Fair	53%	4.00	4.00	N		YES	Remove		
157	Foxtail Palm	Dypsis decaryi	19.7	8	6.00	10.5	Good	65%	4.00	4.00	N	N N	YES	Remove	N Y	
		Wodyetia bifurcata				14.7					***					
159	Tropical Almond	Terminalia muelleri	44.9	44	28.25		Fair	55%	14.00	22.00	Y	N	YES	Remove	N	
160	Live Oak	Quercus virginiana	49.8	50	41.50		Poor	17%	20.00	25.00	Y	N	NO	Remain	N	
161	Live Oak	Quercus virginiana	40.4	20	22.75		Poor	33%	10.00	10.00	Y	N	NO	Remain	N	
162	Live Oak	Quercus virginiana	57.5	30	32.00		Fair	49%	15.00	15.00	Y	N	NO	Remain	N	
163	Live Oak	Quercus virginiana	53.2	30	40.00		Fair	44%	15.00	15.00	Υ	N	NO	Remain	N	
164	Queen Palm	Syagrus romanzoffiana	24.8	14	8.00	16.8	Good	62%	4.00	4.00	N	N	NO	Remove	Y	Florida Invasive Species Council Category I Invasive
165	Lychee	Litchi chinensis	29.3	40	26.75		Good	64%	13.00	20.00	Y	N	YES	Remove	Y	
166	Live Oak	Quercus virginiana	30.2	52	29.00		Fair	55%	15.00	26.00	Υ	N	YES	Remove	N	
167	Live Oak	Quercus virginiana	35.5	22	14.25		Fair	50%	7.00	11.00	N	N	YES	Remove	N	
168	Sapote	Pouteria sapota	34.5	30	27.00		Fair	55%	13.50	15.00	Y	N	YES	Remove	N	
169	Live Oak	Quercus virginiana	23.7	15	17.50		Poor	28%	7.50	7.50	N	N	YES	Remove	N	
170	Live Oak	Quercus virginiana	33.9	35	41.50		Poor	35%	17.50	17.50	Υ	N	YES	Remove	N	
171	Live Oak	Quercus virginiana			17.00		Dead	0%			N/A	N/A	NO	Remove	N	
172	Live Oak	Quercus virginiana	33.7	18	19.00		Poor	40%	9.00	9.00	Y	N	NO	Remain	N	
173	Live Oak	Quercus virginiana	53.6	38	36.75		Poor	24%	18.00	19.00	Y	N	NO	Remain	N	
174	Live Oak	Quercus virginiana	54.2	35	26.00		Poor	23%	13.00	17.50	Υ	N	NO	Remain	N	
175	Sabal Palm	Sabal palmetto	29.2	8	10.00	25.2	Good	65%	4.00	4.00	N	N	NO	Remain	Y	
176	Live Oak	Quercus virginiana	49.5	50	39.00		Fair	47%	20.00	25.00	Y	N	NO	Remain	N	
177	Sabal Palm	Sabal palmetto	36.5	8	8.00	32.5	Good	65%	4.00	4.00	N	N	NO	Remain	Y	
177A	Live Oak	Quercus virginiana	39.3	35	41.00		Poor	40%	17.50	17.50	Y	N	YES	Remove	N	
177B	Queen Palm	Syagrus romanzoffiana	39	13	7.00		Fair	55%	4.00	4.00	N	N	YES	Remove	N	
178	Live Oak	Quercus virginiana	37	30	30.00		Poor	40%	15.00	15.00	Y	N	YES	Remove	N	
179	Mango	Mangifera indica	31.7	12	8.75		Fair	47%	4.00	6.00	N	N	YES	Remove	N	Non-Native Fruit Tree
180	Queen Palm	Syagrus romanzoffiana	30	13	10.00	24	Good	65%	4.00	4.00	N	N	YES	Remove	Y	
181	Live Oak			25	23.00	24		40%	11.50	12.50	Y		YES			
		Quercus virginiana	39.7	- 2			Poor	10.000		7		N		Remove	N	
182	Live Oak	Quercus virginiana	41.9	32	32.00		Poor	40%	16.00	16.00	Y	N	YES	Remove	N	
184	Live Oak	Quercus virginiana	31.6	20	22.50		Poor	37%	10.00	10.00	Υ	N	YES	Remove	N	
185	Live Oak	Quercus virginiana	34.1	50	34.00		Fair	49%	17.00	25.00	Y	N	YES	Remove	N	
186	Live Oak	Quercus virginiana	49.7	60	82.00		Fair	53%	30.00	30.00	Y	N	YES	Remove	N	

7.50

9.00


YES

187 Frangi Pani Plumeria sp. 27 18 15.00 Fair 53%

\* Critical Root Zone radius average in feet\*

\*\* Tree Protection Zone radius average in feet, note Arborist Report and survey for recommended placement\*



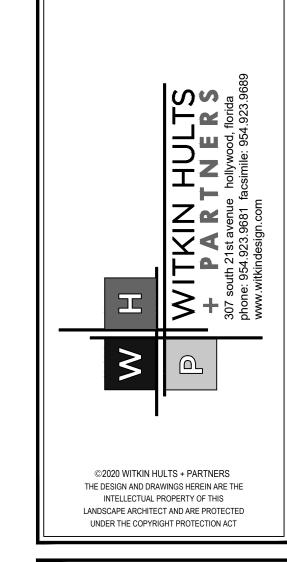

# HOLLYWOOD OAKS BY KUSHNER 4220 & 4231 N. 58TH AVE. HOLLYWOOD, FLORIDA TREE DISPOSITION TABLE

FINAL TAC



