



GENERAL APPLICATION

APPLICATION DATE:		
2600 Hollywood Blvd Room 315 Hollywood, FL 33022	APPLICATION TYPE (CHECK ON Technical Advisory Committee Planning and Development Board City Commission	Historic Preservation Board Special Exception Administrative Approval
Tel: (954) 921-3471 Email: Development@ Hollywoodfl.org SUBMISSION REQUIREMENTS:	PROPERTY INFORMATION Location Address: 402 Lot(s): 8 Blo Folio Number(s): 514214	ock(s): 63 Subdivision: HOLLYCOMO LAVES Sob
 One set of signed & sealed plans (i.e. Architect or Engineer) One electronic combined PDF submission (max. 25mb) Completed Application Checklist 	Zoning Classification: Existing Property Use: Is the request the result of a violation Has this property been presented to Number(s) and Resolution(s):	
Application fee	IN ORDER to BUILDA	Hing Approval to demoush Existing NOW TWO STOPY Single FAMILY HOME. er of Phases: Proposal
NOTE:	Units/rooms (# of units)	Duelling Unit (Area: 3,000 S.F.)
This application must be completed in full and submitted with all documents to be placed on a Board or Committee's agenda.	Proposed Non-Residential Uses Open Space (% and SQ.FT.) Parking (# of spaces) Height (# of stories) Gross Floor Area (SQ. FT)	N/A S.F. 41.9% (Area: 2207 S.F.) (4) TOTAL: (3) SURFACE (Area: 898 S.F.) 2- Story (23 FT.)
 The applicant is responsible for obtaining the appropriate checklist for each type of application. Applicant(s) or their 	Name of Current Property Owner:	
authorized legal agent	Email Address:	Consultant Representative Tenant (circle one) WY S. 121 Ft. 33025 Telephone: 954-592-2841 p.11 South. Next
<u>CLICK HERE FOR</u> FORMS, CHECKLISTS, &	If Yes, Attach Copy of the Contract. Noticing Agent (FTAC & Board sub	Is there an option to purchase the Property? Yes () No ()



GENERAL APPLICATION

CERTIFICATION OF COMPLIANCE WITH APPLICABLE REGULATIONS

The applicant/owner(s) signature certifies that he/she has been made aware of the criteria, regulations and guidelines applicable to the request. This information can be obtained in Room 315 of City Hall or on our website at www.hollywoodfl.org. The owner(s) further certifies that when required by applicable law, including but not limited to the City's Zoning and Land Development Regulations, they will post the site with a sign provided by the Office of Planning and Development Services. The owner(s) will photograph the sign the day of posting and submit photographs to the Office of Planning and Development Services as required by applicable law. Failure to post the sign will result in violation of State and Municipal Notification Requirements and Laws.


(I)(We) certify that (I) (we) understand and will comply with the provisions and regulations of the City's Zoning and Land Development Regulations, Design Guidelines, Design Guidelines for Historic Properties and City's Comprehensive Plan as they apply to this project. (I)(We) further certify that the above statements and drawings made on any paper or plans submitted herewith are true to the best of (my)(our) knowledge. (I)(We) understand that the application and attachments become part of the official public records of the City and are not returnable.

Signature of Current Owner:	Date: 7/8/702 y
PRINT NAME: Izhar Cohen - Manger	Date:
Signature of Consultant Representative:	Date: 7/9/202 4
PRINT NAME: RALPH TAIT, ARCHITECT	Date:
Signature of Tenant:	Date:
PRINT NAME:	Date:
Current Owner Power of Attorney	
I am the current owner of the described real property and that I am aware of the above development proposal to my property, which is hereby my legal representative before the Committee) relative to all matters concerning this application.	ade by me or I am hereby authorizing
Sworn to and subscribed before me	2
this day of	Signature of Current Owner
MY COMMISSION # HH 278412 EXPIRES: October 12, 2026 Notary Public	Izhar Cohen - Manger Print Name
State of Florida My Commission Expires: Local Check One)Personally known to me; ORPersonally known to me; ORPer	roduced Identification Divers \ CCL

DESCRIPTION:

LOT 18, BLOCK 63, OF HOLLYWOOD LAKES SECTION, A SUBDIVISION OF SECTION 14, AND PART OF SECTION 13, LYING WEST OF THE FLORIDA COAST LINE CANAL AND TRANSPORTION COMPANY'S CANAL IN TOWNSHIP 51 SOUTH, RANGE 42 EAST, ACCORDING TO THE PLAT THEREOF AS RECORDED IN PLAT BOOK 1, PAGE 32, OF THE PUBLIC RECORDS OF BROWARD COUNTY, FLORIDA. SAID LAND SITUATED IN THE CITY OF HOLLYWOOD, BROWARD COUNTY, FLORIDA

HOLLYWOOD BROWARD COUNTY, FLORIDA 125113 **ZONE AE BASE FLOOD ELEVATION=5** PANEL No. 12011 C0 588 H FIRM DATE- 08/18/2014

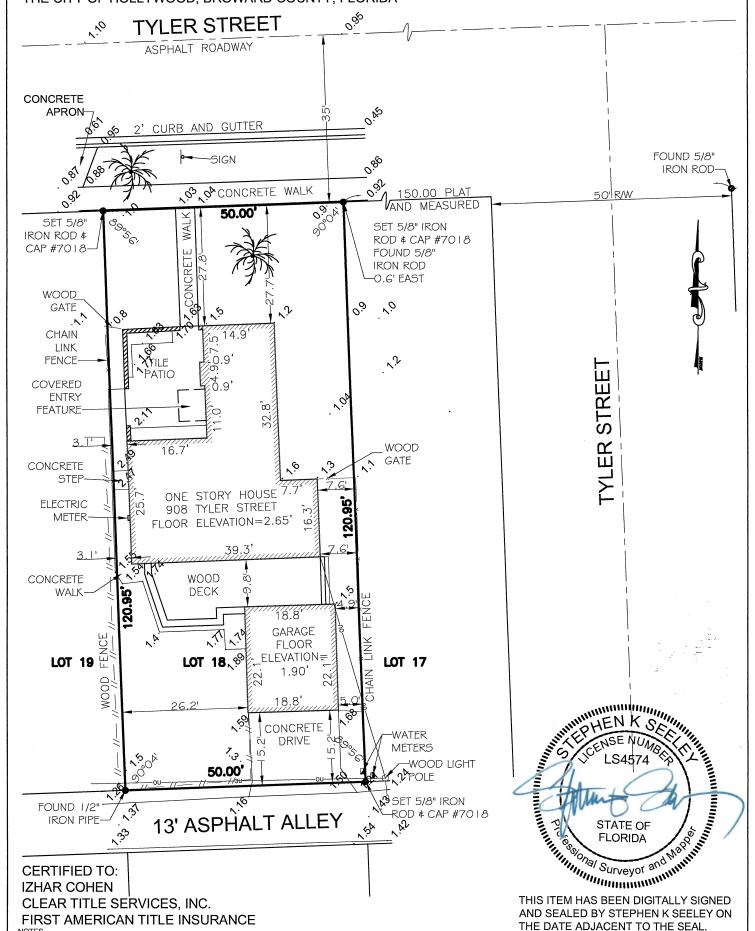

THE LAND DESCRIPTION SHOWN HEREON WAS PROVIDED BY THE CLIENT. EASEMENTS AND RIGHTS-OF-WAY PER
RECORD PLAT HAVE BEEN SHOWN HEREON. NO FURTHER SEARCH FOR MATTERS OF RECORD HAS BEEN MADE BY THIS

FIRM.
THIS SURVEY IS PREPARED FOR THE SOLE AND EXCLUSIVE USE OF THE PARTIES AS SURVEYED FOR AND AS CERTIFIED TO AND SHALL NOT BE RELIED UPON BY ANY OTHER ENTITY OR INDIVIDUAL.
ELEVATIONS SHOWN HEREON ARE BASED ON NORTH AMERICAN VERTICAL DATUM OF 1988 (NAVD 88).
BENCHMARK REFERENCE- NGS MONUMENT DESIGNATION B 311 - PID AD2430 - ELEVATION= 1.68 (NAVD88) NORTH ARROW RELATIVE TO ASSUMED EAST ALONG THE CENTERLINE OF TYLER STREET STREET.
ADDITIONS OR DELETIONS TO SURVEY MAPS OR REPORTS BY OTHER THAN THE SIGNING PARTY OR PARTIES IS PROHIBITED WITHOUT WRITTEN CONSENT OF THE SIGNING PARTY OR PARTIES.

SKETCH OF BOUNDARY SURVEY

LAND SURVEYORS

2131 HOLLYWOOD BOULEVARD, SUIT

PRINTED COPIES OF THIS DOCUMENT ARE NOT CONSIDERED SIGNED AND SEALED AND THE SIGNATURE MUST BE VERIFIED ON ANY ELECTRONIC COPIES

STEPHEN K. SEELEY, FOR THE FIRM PROFESSIONAL SURVEYOR & MAPPER FLORIDA REGISTRATION NO. 4574

Legal Description & Project Information:

Legal Description:

LOT 18, BLOCK 63, "HOLLYWOOD LAKES SECTION", ACCORDING TO PLAT THEREOF AS RECORDED IN PLAT BOOK 1, PAGE 32, OF THE PUBLIC RECORDS OF BROWARD COUNTY, FLORIDA. SAID LAND SITUATED IN THE CITY OF HOLLYWOOD, BROWARD COUNTY, FLORIDA

BUILDING DATA

FIRST FLOOR A/C SPACE: 1,294 SQ. FT. SECOND FLOOR A/C SPACE: 1,510 SQ. FT. GARAGE (NON A/C SPACE) 365 SQ. FT. TOTAL AREA A/C SPACE: 2,804 SQ. FT. TOTAL BUILDING AREA:3,169 SQ, FT,

ZONING DATA

RS-6	REQUIRED	PROVIDED
LOT AREA	6,000 SQ. FT. MIN.	6,047.5 SQ. FT.
LOT WIDTH	60 FT MIN.	50 FT.
LOT COVERAGE	N/A	2,207 /6,047.5 SQ FT.OR 36.4 % OF S.A.
GREEN SPACE	N/A	2,528.5 SQ. FT. OR 41.9% OF S.A.
POOLS /POOL DECK	N/A	626 SQ. FT. / 6,047.5 SQ. FT. = 10.4% OF S.A.
VUA + PEDESTRIAN WALKS	N/A	686 SQ. FT. OR 11.3% OF SITE AREA
DENSITY	N/A	1 SINGLE FAMILY RESIDENCE
BUILDING SETBACK		
PRINCIPAL FRONT	25FT MIN.	25 FT
SECONDARY FRONT	N/A	N/A
	7'-6"FT MIN.	
SIDE	25% LOT WIDTH TOTAL MIN = 12'-6""	7'-6"
REAR	15% OF LOT DEPTH 18'-1" MIN.	30'-0" TO GARAGE
BUILDING HEIGHT		
PRINCIPAL BUILDING	30 FT OR 2 STORY	23'-0" TOP OF FLAT ROOF DECK
PARKING	4 PARKING SPACES	4 PARKING SPACES GARAGE & SURFACE

FRONT YARD REQD. GREEN SPACE:

50 FT. x 25 FT. = 1,250 SQ. FT. (.20) = 250 SQ. FT. MIN. LANDSCAPE PERVIOUS OPEN SPACES REQD.

1,067 SQ. FT. OR 85.3% PERVIOUS OPEN SPACE PROVIDED





October 21, 2024

City Of Hollywood Planning Division 2600 Hollywood Blvd. Hollywood, Fl. 33020

Re: Proposed Single Family Residence for: GNY USA LLC 908 Tyler Street Hollywood, Fl. 33019

Criteria Statement on Certificate of Appropriateness for Design/Demolition

Dear Board Members,

This firm represents GNY USA LLC, owners of the property situated at 908 Tyler Street. We are submitting this letter of intent in support of the application for a certificate of appropriateness regarding the design of a new two-story single-family residence for the aforementioned property.

1. Retention and Preservation of Historic Character:

The structure will maintain its historic character by remaining a single-family residence and incorporating design elements similar to the original structure, like the sloping roof with barrel tiles and flat roof. Automobile access and parking will also follow the original pattern by being located at the rear of the property.

2. Rationale for Removal of Historic Materials:

The removal of historic materials is unavoidable due to the house being in severe disrepair. Since it cannot be occupied in its current state, demolition is necessary.

3. Retention of Historically Significant Changes:

Items of historic significance, such as the main entry door, will be preserved when possible. The property owners have agreed to donate the entry door to the local historical society as per their request.

4. Preservation of Historic Materials during New Construction:

Efforts will be made to prevent the destruction of historic materials. Similar to the previous point, the entry door will be preserved and donated.

5. Compatibility and Differentiation of New Work:

The new construction will differentiate from the old while maintaining compatibility with the surrounding neighborhood. This will be achieved by incorporating certain design elements similar to the original structure such as, the roof style and massing, ensuring that the new work respects the scale and architectural features of the neighborhood, which consists of one- and two-story single-family homes.

This approach demonstrates a balance between preserving historical elements and making necessary updates for safety and functionality.

Sincerely,

Ralph E Tait, R.A. AR95832 President Ralph Tait Architect, Inc.



City of Hollywood Division of Planning 2600 Hollywood Blvd, Room 315 Hollywood, FL 33022

RE: 908 Tyler Street Hollywood, FL 33019

Subject: Structural Assessment

Upon the request of Mr. Rafi Soltz, we have inspected the residence listed above for the purpose of evaluating the existing conditions of the structure. The construction system of the house is wood floor framing supported on masonry stem and spread footings. Residence envelope is masonry walls. The roof structure is wood framing.

The exterior of the house shows signs of age and moisture deterioration. Wood members around the house: doorways, windows, window frames exhibit significant wood rotting and decay. Wood member joints around the doors and windows have shifted, expanded and/or separated so they are no longer tight and no longer prevent water intrusion. The roof structure has collapsed at South East bedroom, bathroom and corridor of the house. The rest of roof structure is progressing to total collapse. House structure is not safe.

Residence finished floor is below FEMA flood elevation. The floor structure has been experiencing cycles of wet and dry causing extreme decay of wood members. The floor structure has large deformation due to the displacement of the foundation supports. The floor inclines heavily in areas toward the corners and supporting walls. Therefore floor structure is unsafe to walk on. Doors cannot open or close properly because of jamming due to the floor deformations. The kitchen floor is also deformed and has rotting issues as well.

In addition to the continuous water exposure damage, the wood structure is infested with termites, which are the ones responsible of the roof wood frame damage and progressive collapse. The roof of the Detached garage located experience same damage and failure.

Because of the damages explained above and the finished floor elevation of house below flood elevation requirement, repair of existing structure is not feasible. Our office recommendation is to demolish and rebuilt new structure in accordance with current Florida Building Code.



LIMITATIONS OF LIABILITY

We warrant that the services performed by Unison Structural Design LLC are conducted in a manner consistent with the level and skill ordinarily exercised by members of the profession currently practicing under similar conditions. No other warranties expressed or implied are made.

Recommendations and conclusions are based primarily on visual observation and record plans, when available. Concealed conditions may exist and may not become evident without destructive testing or destructive exposure. No destructive testing or exposure was conducted unless specifically noted herein. We are not responsible for any concealed conditions. If conditions are found that are inconsistent with or vary from visible portions of the building, the engineer should be contacted so that field conditions can be examined and recommendations revised, if necessary.

The contents of this report are for the exclusive use of the client, the client's design and construction team and governmental authorities. Information conveyed in this report shall not be used or relied upon by other parties or for other projects without the expressed written consent of Unison Structural Design LLC. This report discusses structural considerations for this site based upon observed conditions and our understanding of construction and foundation support. Environmental issues including (but not limited to) asbestos, soil and/or groundwater contamination are beyond our scope of service.

Should you have any questions or require additional information regarding the above, please feel free to contact me.

Sincerely,

Unison Structural Design LLC



Kervin Ventura, P.E. #74146



908 Tyler Street, Hollywood, FL 33019














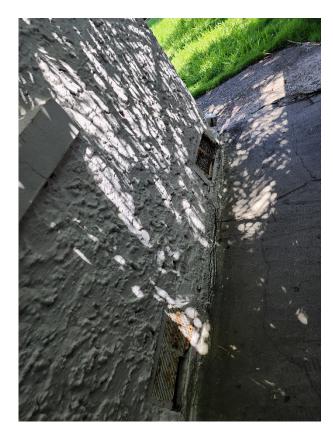















































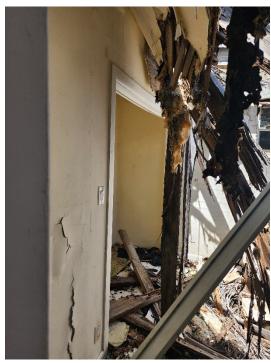






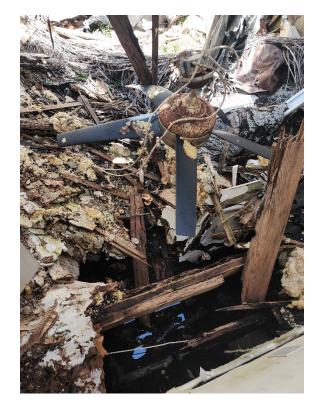







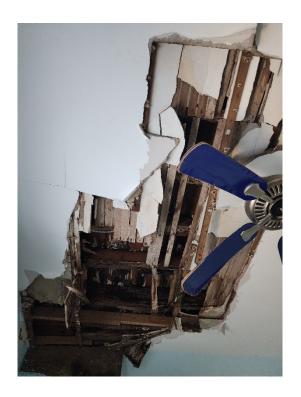



















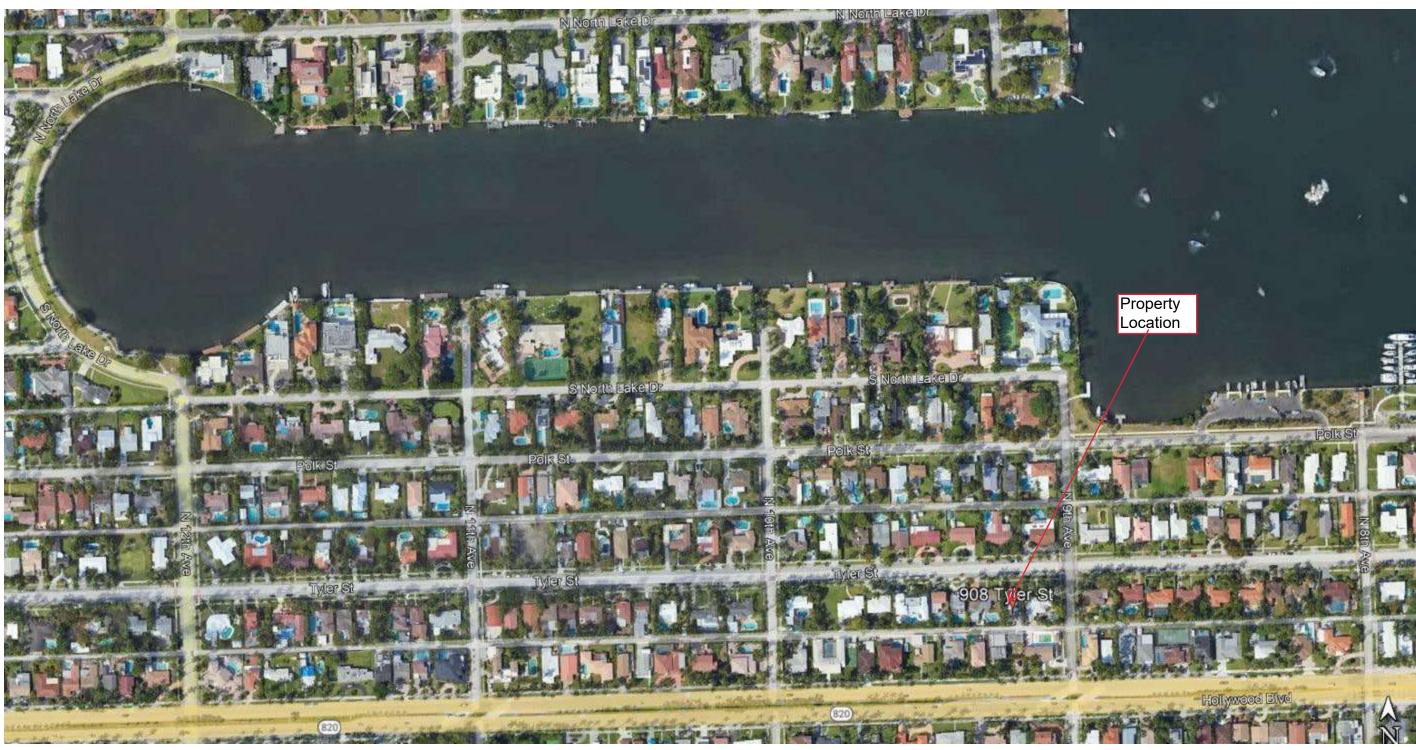

Existing Site Photos For: 908 Tyler Street: Demolition and Proposed Two Story Single Family Residence for: GNY USA LLC

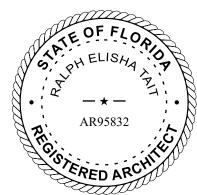















Main House Main Entry/ Courtyard





PROPOSED RESIDENCE for:

GNY USA LLC 908 TYLER STREET HOLLYWOOD, FL 33019

SHEET NUMBER	SHEET NAME	ISSUE DATE	REV
1-GENERAL		'	
T-001	COVER SHEET / SHEET INDEX	07/09/24	
AS-101	ARCHITECTURAL SITE PLAN	07/09/24	3
C-01	CIVIL - EROSION CONTROL PLAN	07/09/24	
C-02	CIVIL PLAN	07/09/24	
C-03	CIVIL PLAN DETAIL	07/09/24	
EX-1	DEMOLITION PLAN	07/09/24	
EX-2	DEMOLITION PLAN - EXISTING BUILDING	07/09/24	
2-ARCHITECT	URE	·	
A-101	FLOOR PLANS AND NOTES	07/09/24	2
A-102	ROOF PLAN AND NOTES	07/09/24	1
A-201	BUILDING ELEVATIONS	07/09/24	3
A-202	BUILDING ELEVATIONS	07/09/24	3
A-204	STREET PROFILE ELEVATION	07/09/24	1
A-303	BUILDING SECTIONS	07/09/24	3
A-304	BUILDING SECTIONS	07/09/24	3
3-LANDSCAPE			
L102	PROPOSED LANDSCAPE PLAN	07/09/24	
Grand total: 15			






1 EXISTING VIEW SCALE:NTS



ARCHITECT OF RECORD

11820 Miramar Parkway, Suite 121 Miramar, Florida, 33025 (P) 954-592-2841 (Fax) 954-392-7502 Email: rtait@bellsouth.net www.rtarchitectinc.com

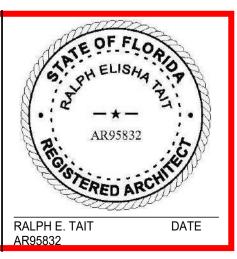

ENGINEER OF RECORD

PROPOSED RESIDENCE for:

GNY USA LLC

2 PROPOSED VIEW SCALE:NTS


908 TYLER STREET, HOLLYWOOD, FLORIDA 33019 CLIENT: GNY USA LLC

REV DATE	DESCRIPTION	DESIGN Histo DELIVERABLE: Subm		s
		PROJECT NUMBER: 24		
		DRAWN BY: JJ CHECKED BY: RET Copyright (c) by RALPH TAIT AF	RCHITECT INC.	s

COVER SHEET /
SHEET INDEX

SHEET NUMBER:

TYLER STREET

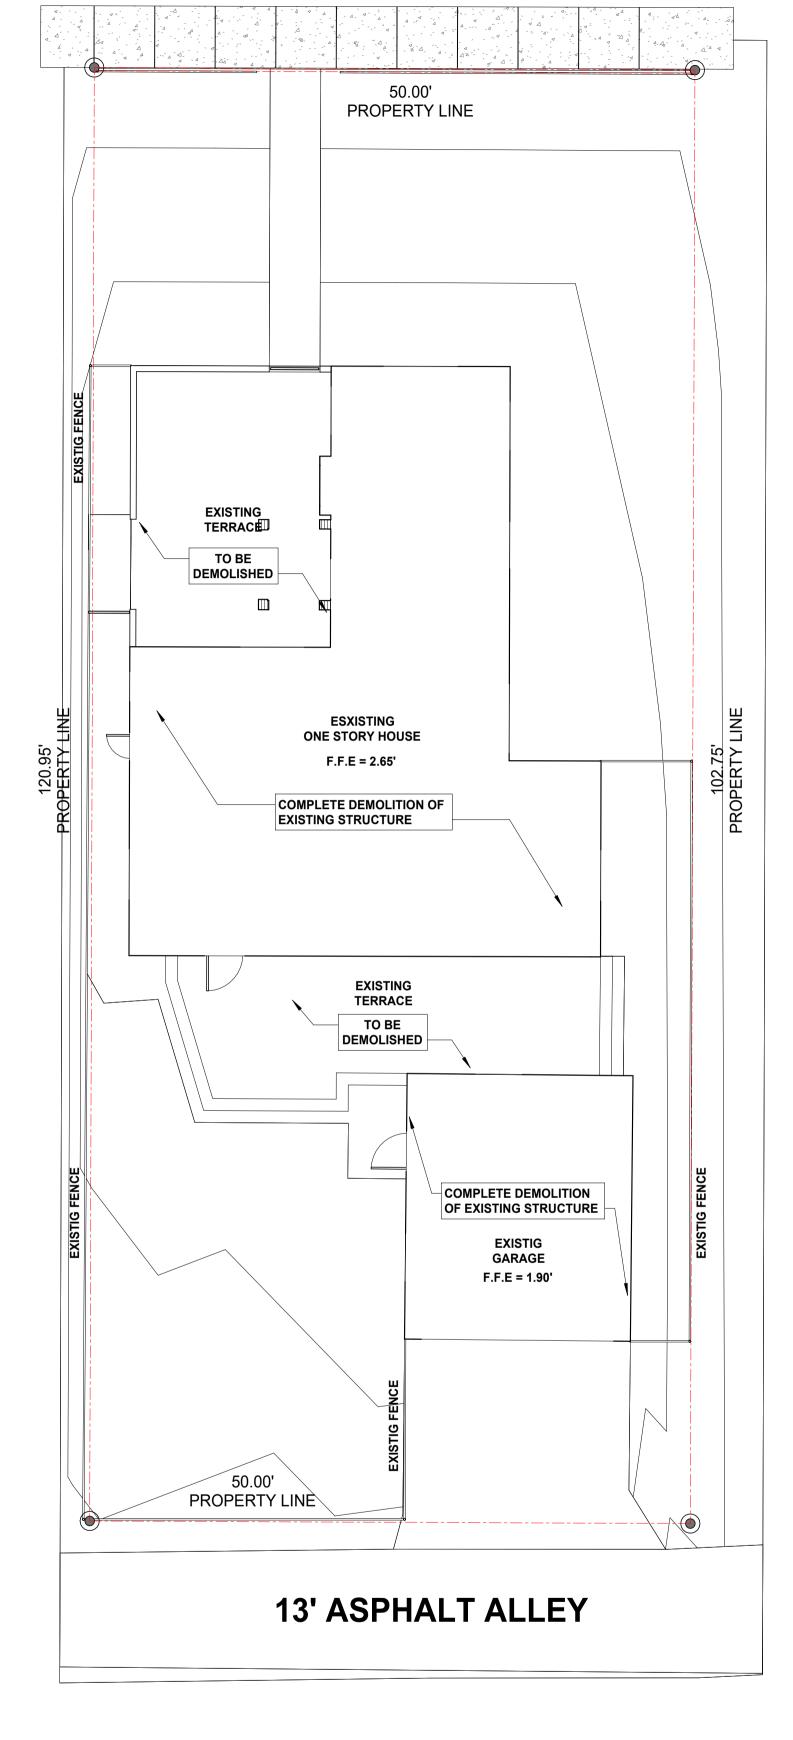

1 DEMOLITION PLAN SCALE: 1/8" = 1'-0"



HOLLYWOOD, FLORIDA 33019

DESIGN Historical Board DELIVERABLE: Submittal ISSUE DATE: 07/09/24 PROJECT NUMBER: 24-010 DRAWN BY: JS CHECKED BY: RET

SHEET TITLE: **DEMOLITION PLAN**

PROJECT LOCATION

3 LOCATION MAP. SCALE: N.T.S.

1) THE WORK SHALL INCLUDE THE FURNISHING OF ALL MATERIALS, CUTTING, EXTENDING, CONNECTING, REPAIRING, ADAPTING, AND OTHER WORK COINCIDENTAL HERETO. TOGETHER WITH SUCH TEMPORARY INSTALLATIONS AS MAY BE NECESSARY TO SATISFY THE DEMOLITION PROGRAM. APPROVAL SHALL BE SECURED FROM THE OWNER/ PRIOR TO CUTTING/DRILLING OF ANY STRUCTURAL SUPPORT. 2) ALL BUILDING CONSTRUCTION AFFECTED BY THE REMOVAL, RELOCATION,

INSTALLATION OF ANY PIECE OF EQUIPMENT SHALL BE REPAIRED AND FINISHED AS REQUIRED TO MATCH EXISTING CONDITION OR AS DIRECTED BY THE ARCHITECTURAL DRAWINGS, SPECIFICATIONS, OR OWNER'S REPRESENTATIVE. 3)CONTRACTOR SHALL DEMOLISH ANY INTERIOR FINISHES TO COMPLETE THE

INTERIOR DESIGN DRAWINGS, SPECIFICATIONS, OR BY OWNER REPRESENTATIVES. 4) EXISTING FIXTURES, EQUIPMENT, AND ALL DEBRIS WHICH ARE REQUIRED TO BE REMOVED SHALL BE REMOVED BY THE CONTRACTOR. CONTRACTOR TO COORDINATE

NÉCESSARY AND PROPOSED WORK AS DIRECTED BY THE ARCHITECTURAL DRAWINGS

WITH OWNER REPRESENTATIVES PRIOR TO REMOVAL OF SUCH. 5) ALL ELECTRICAL AND PLUMBING LINES WHICH REQUIRE REMOVAL OR ALTERATION ARE TO BE DONE SO BY THE CONTRACTOR. LINES TO BE CAPPED AND PREPARED FOR

REMOVAL OR REROUTING AS SPECIFIED ON THE PLANS. 6) REMOVE ALL UTILITIES IN DEMOLITION AREAS AND CONSTRUCTION AREAS IN A MANNER, AND IN THE TIME, SATISFACTORY TO THE UTILITY COMPANY DESIRED TO

7) COVER ITEMS AS SPECIFIED BY OWNER REPRESENTATIVE TO PROTECT FROM DUST

EFFECT THE REMOVAL OF THE MATERIALS, THEY SHALL BE PERMITTED TO DO SO.

8) SALVAGED MATERIALS SHALL BE REMOVED, CLEANED, AND PREPARED FOR RE-INSTALLATION. OWNER MAINTAINS OWNERSHIP OF ALL MATERIALS UNLESS OTHERWISE

9) WHERE EXISTING WALLS, CEILINGS, AND FIXTURES HAVE BEEN REMOVED, AREAS SHALL BE PATCHED TO MATCH EXISTING FINISHES, OR FINISHES TO BE ADDED AS PER PLANS, OR AS PER OWNER'S REP.

10) WHERE EXISTING WORK IS DAMAGED IN THE EXECUTION OF THIS CONTRACT, OR WHERE OPENINGS ARE LEFT DUE TO THE REMOVAL OF PIPES, EQUIPMENT OR APPARATUS, THE SAME SHALL BE REPAIRED OR CLOSED UP TO CORRESPOND IN MATERIAL, QUALITY, SHAPE AND FINISH WITH THAT OF SIMILAR AND ADJOINING WORK, UNLESS OTHERWISE CALLED FOR. WHERE DAMAGE IS UNREPAIRABLE, NEW ITEMS OR EQUIPMENT SHALL BE PROVIDED. CONTRACTOR SHALL PROVIDE ALL NECESSARY WATERPROOFING, FIRE STOPPING AND SEALING OF PENETRATIONS LEFT FROM REMOVED EQUIPMENT OR PRODUCED BY THIS WORK.

11) INTERRUPTION OF EXISTING SERVICES AND/OR OPERATION OF FACILITIES SHALL BE KEPT TO A MINIMUM. CONTRACTOR SHALL FURNISH ALL MATERIALS REQUIRED WHENEVER TEMPORARY CONNECTIONS ARE NECESSARY TO MAINTAIN CONTINUITY OF SERVICE. INTERRUPTION OF EXISTING SERVICES, THE INSTALLATION OF TEMPORARY FACILITIES, AND THE WORK OF MAKING FINAL CONNECTIONS TO THE NEW WORK SHALL BE DONE ONLY AT SUCH TIMES PERMITTED AND SCHEDULED IN ADVANCE BY THE ARCHITECT/OWNER WITHOUT ADDITIONAL COST. CARE MUST BE USED IN REMOVING SERVICES TO AREAS BEING DEMOLISHED SO THAT SERVICES TO OTHER AREAS WHICH

12) ALL EXIST. GAS LINES WHICH REQUIRE REMOVAL OR ALTERATION SHALL BE PÉRFORMED BY A QUALIFIED CONTRACTOR LICENSED BY THE STATE OF FLORIDA TO PERFORM SUCH WORK.

MIGHT BE SERVED THROUGH THESE AREAS WILL NOT BE INTERRUPTED.

2 GENERAL DEMO NOTE SCALE: 1/4" = 1'-0"

ARCHITECT OF RECORD

1820 Miramar Parkway, Suite 121 Miramar, Florida, 33025 (P) 954-592-2841 (Fax) 954-392-7502 Email: rtait@bellsouth.net


RALPH E. TAIT AR95832 www.rtarchitectinc.com


AR95832 DATE ENGINEER OF RECORD

GNY USA LLC

908 TYLER STREET,


CLIENT: GNY USA LLC

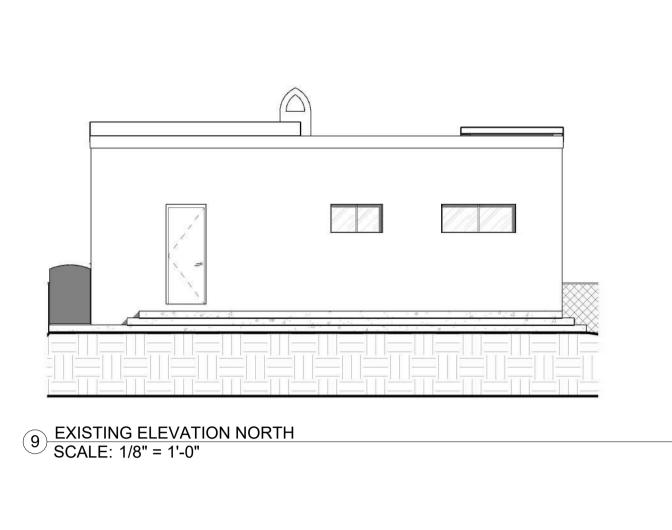


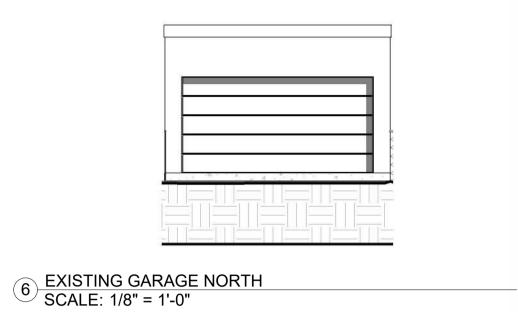







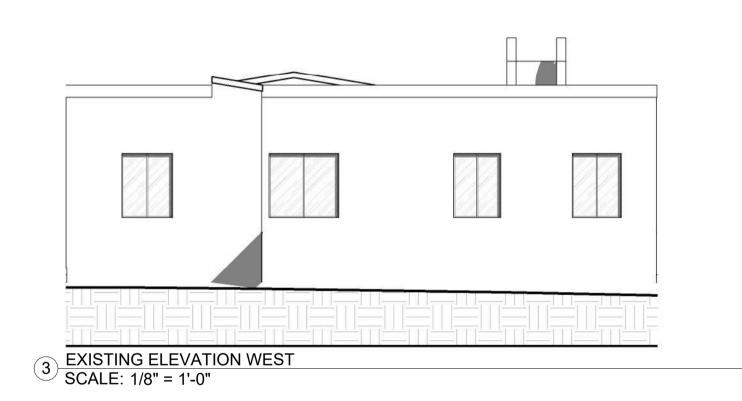


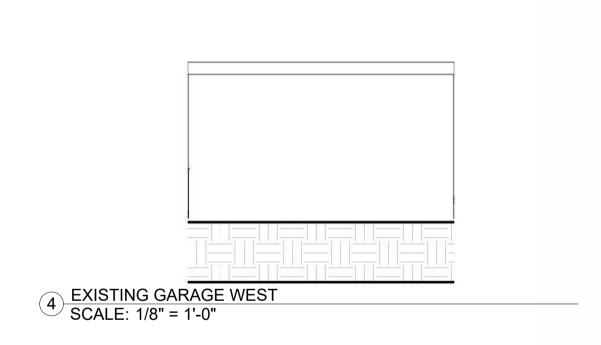



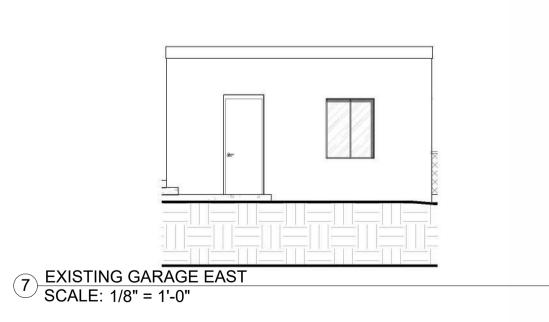

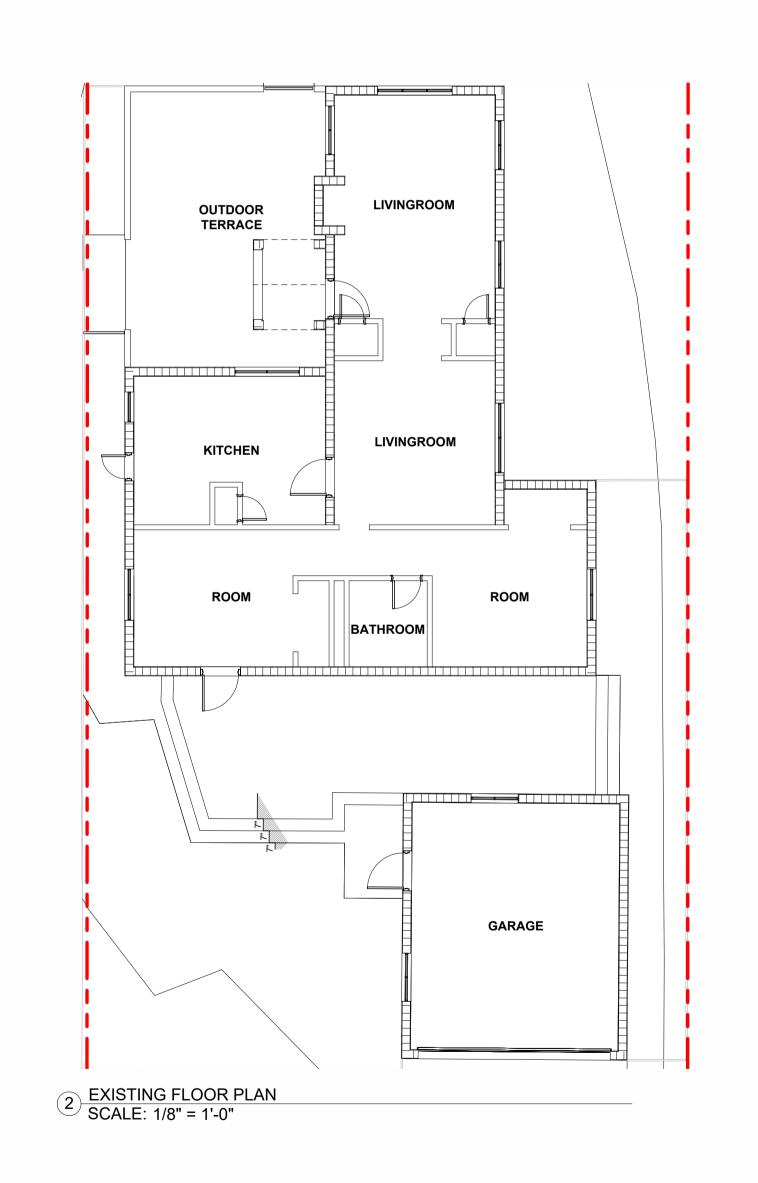

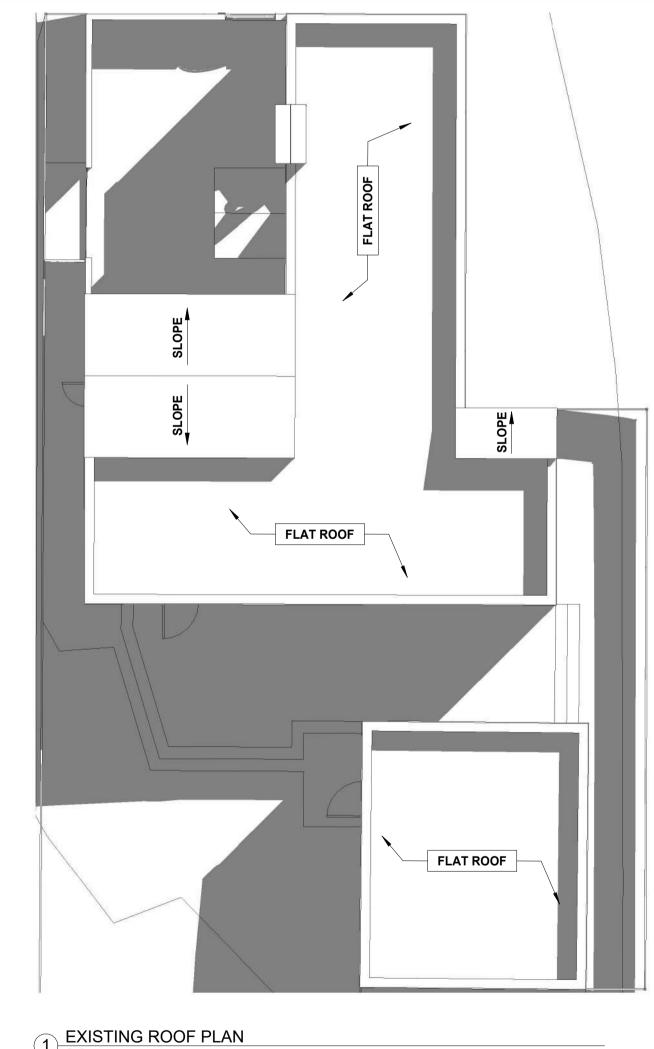






ARCHITECT OF RECORD

11820 Miramar Parkway, Suite 121 Miramar, Florida, 33025 (P) 954-592-2841 (Fax) 954-392-7502 Email: rtait@bellsouth.net www.rtarchitectinc.com

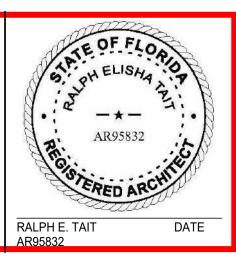

ENGINEER OF RECORD


PROPOSED RESIDENCE for:


GNY USA LLC 908 TYLER STREET, **HOLLYWOOD, FLORIDA 33019 CLIENT:** GNY USA LLC


REV	DATE	DESCRIPTION	DESIGN Historical Board DELIVERABLE: Submittal
			ISSUE DATE: 07/09/24
			PROJECT NUMBER: 24-010
			DRAWN BY: JS
			CHECKED BY: RET
			Copyright (c) by RALPH TAIT ARCHITECT, INC. All Rights Reserved

SHEET TITLE: **DEMOLITION** PLAN -**EXISTING BUILDING**

EX-2

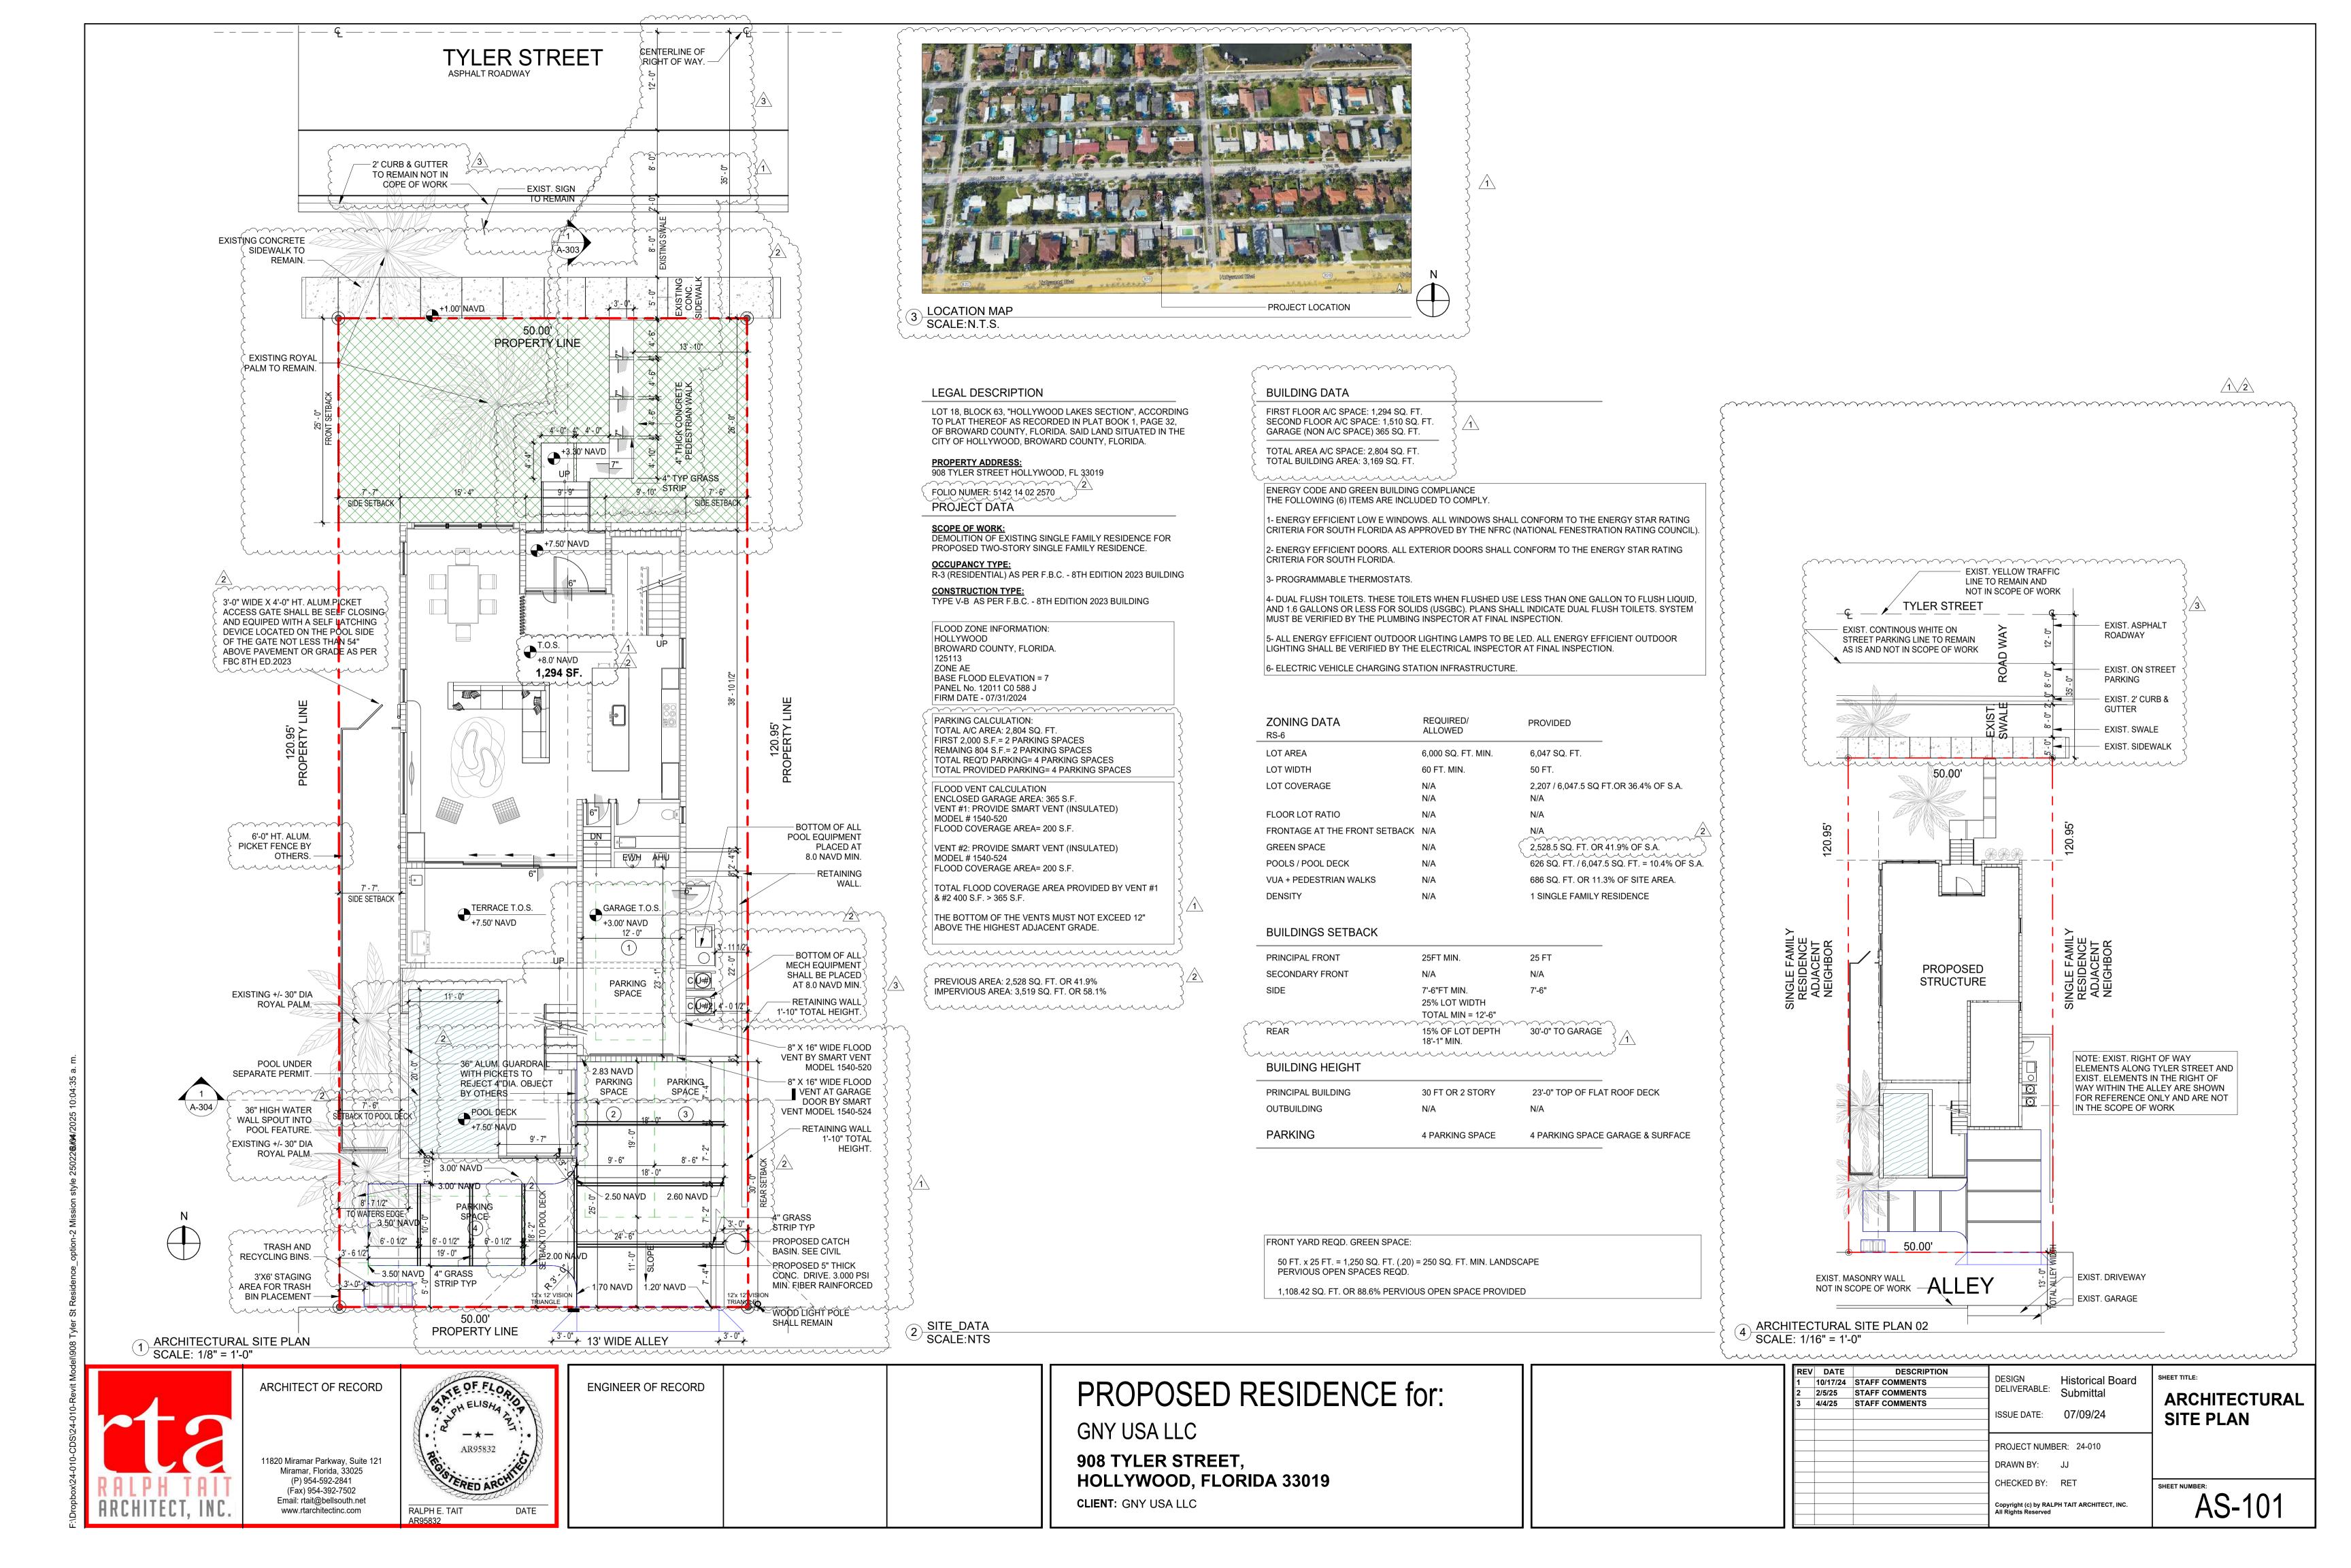

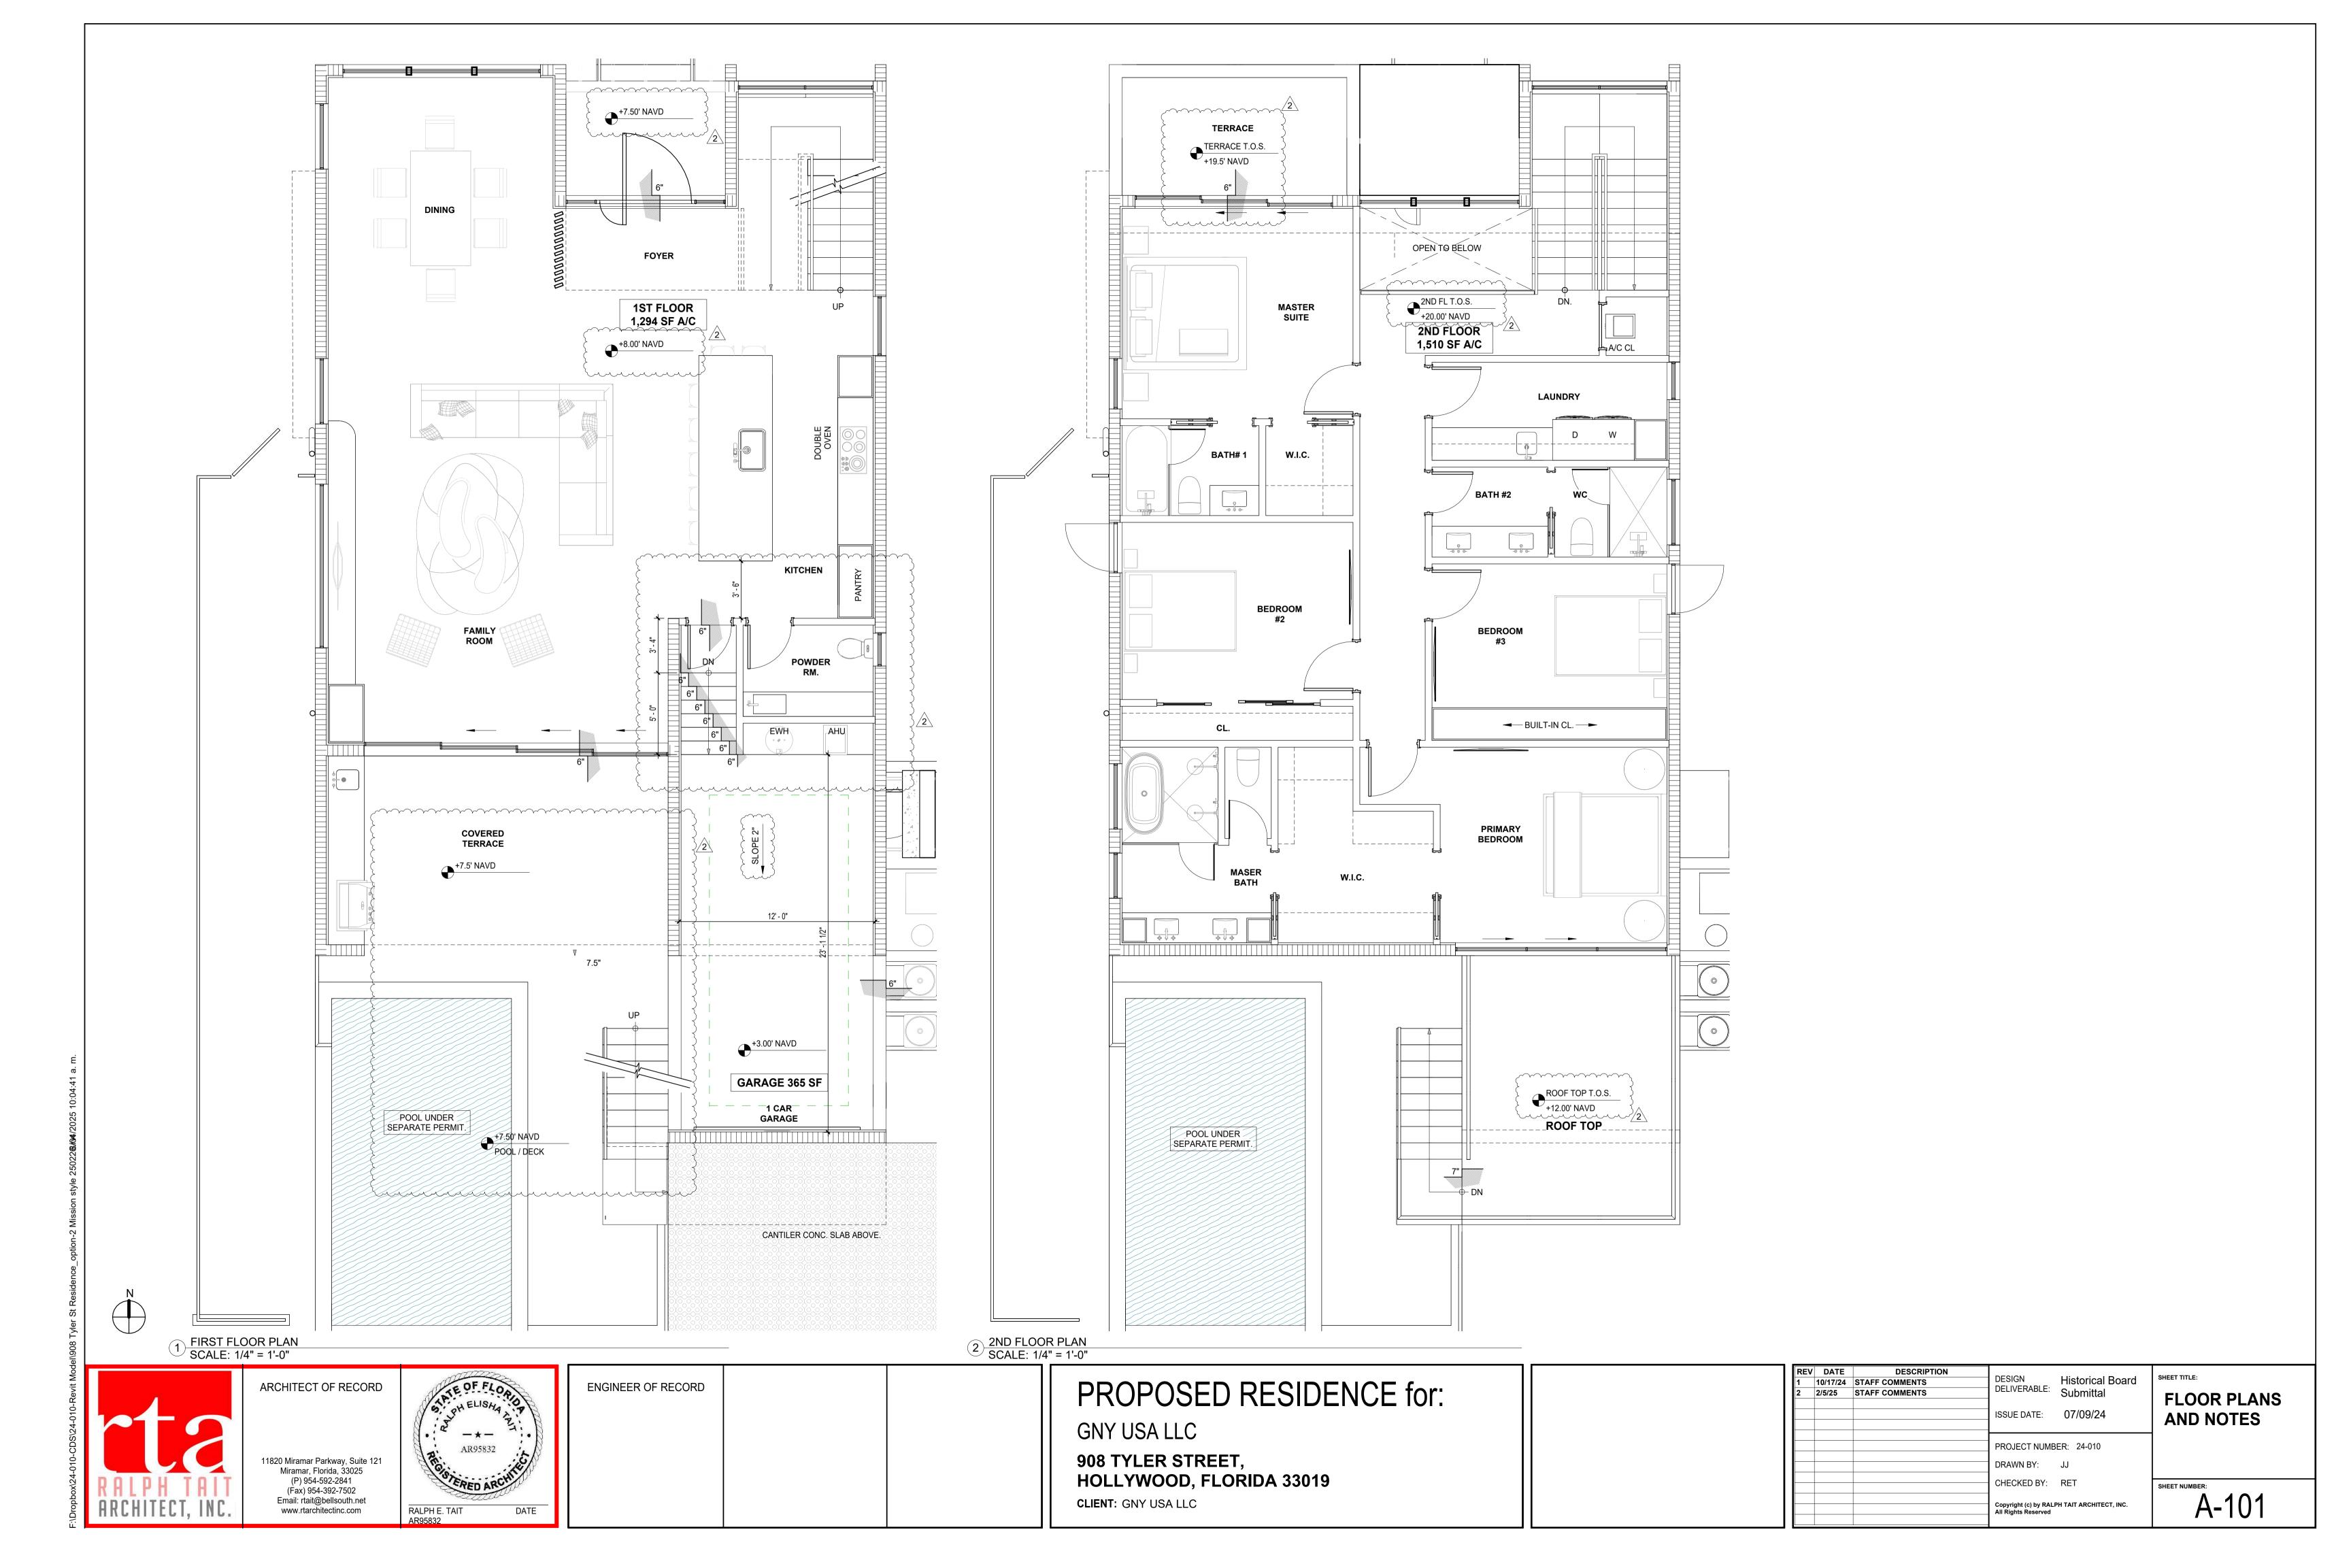

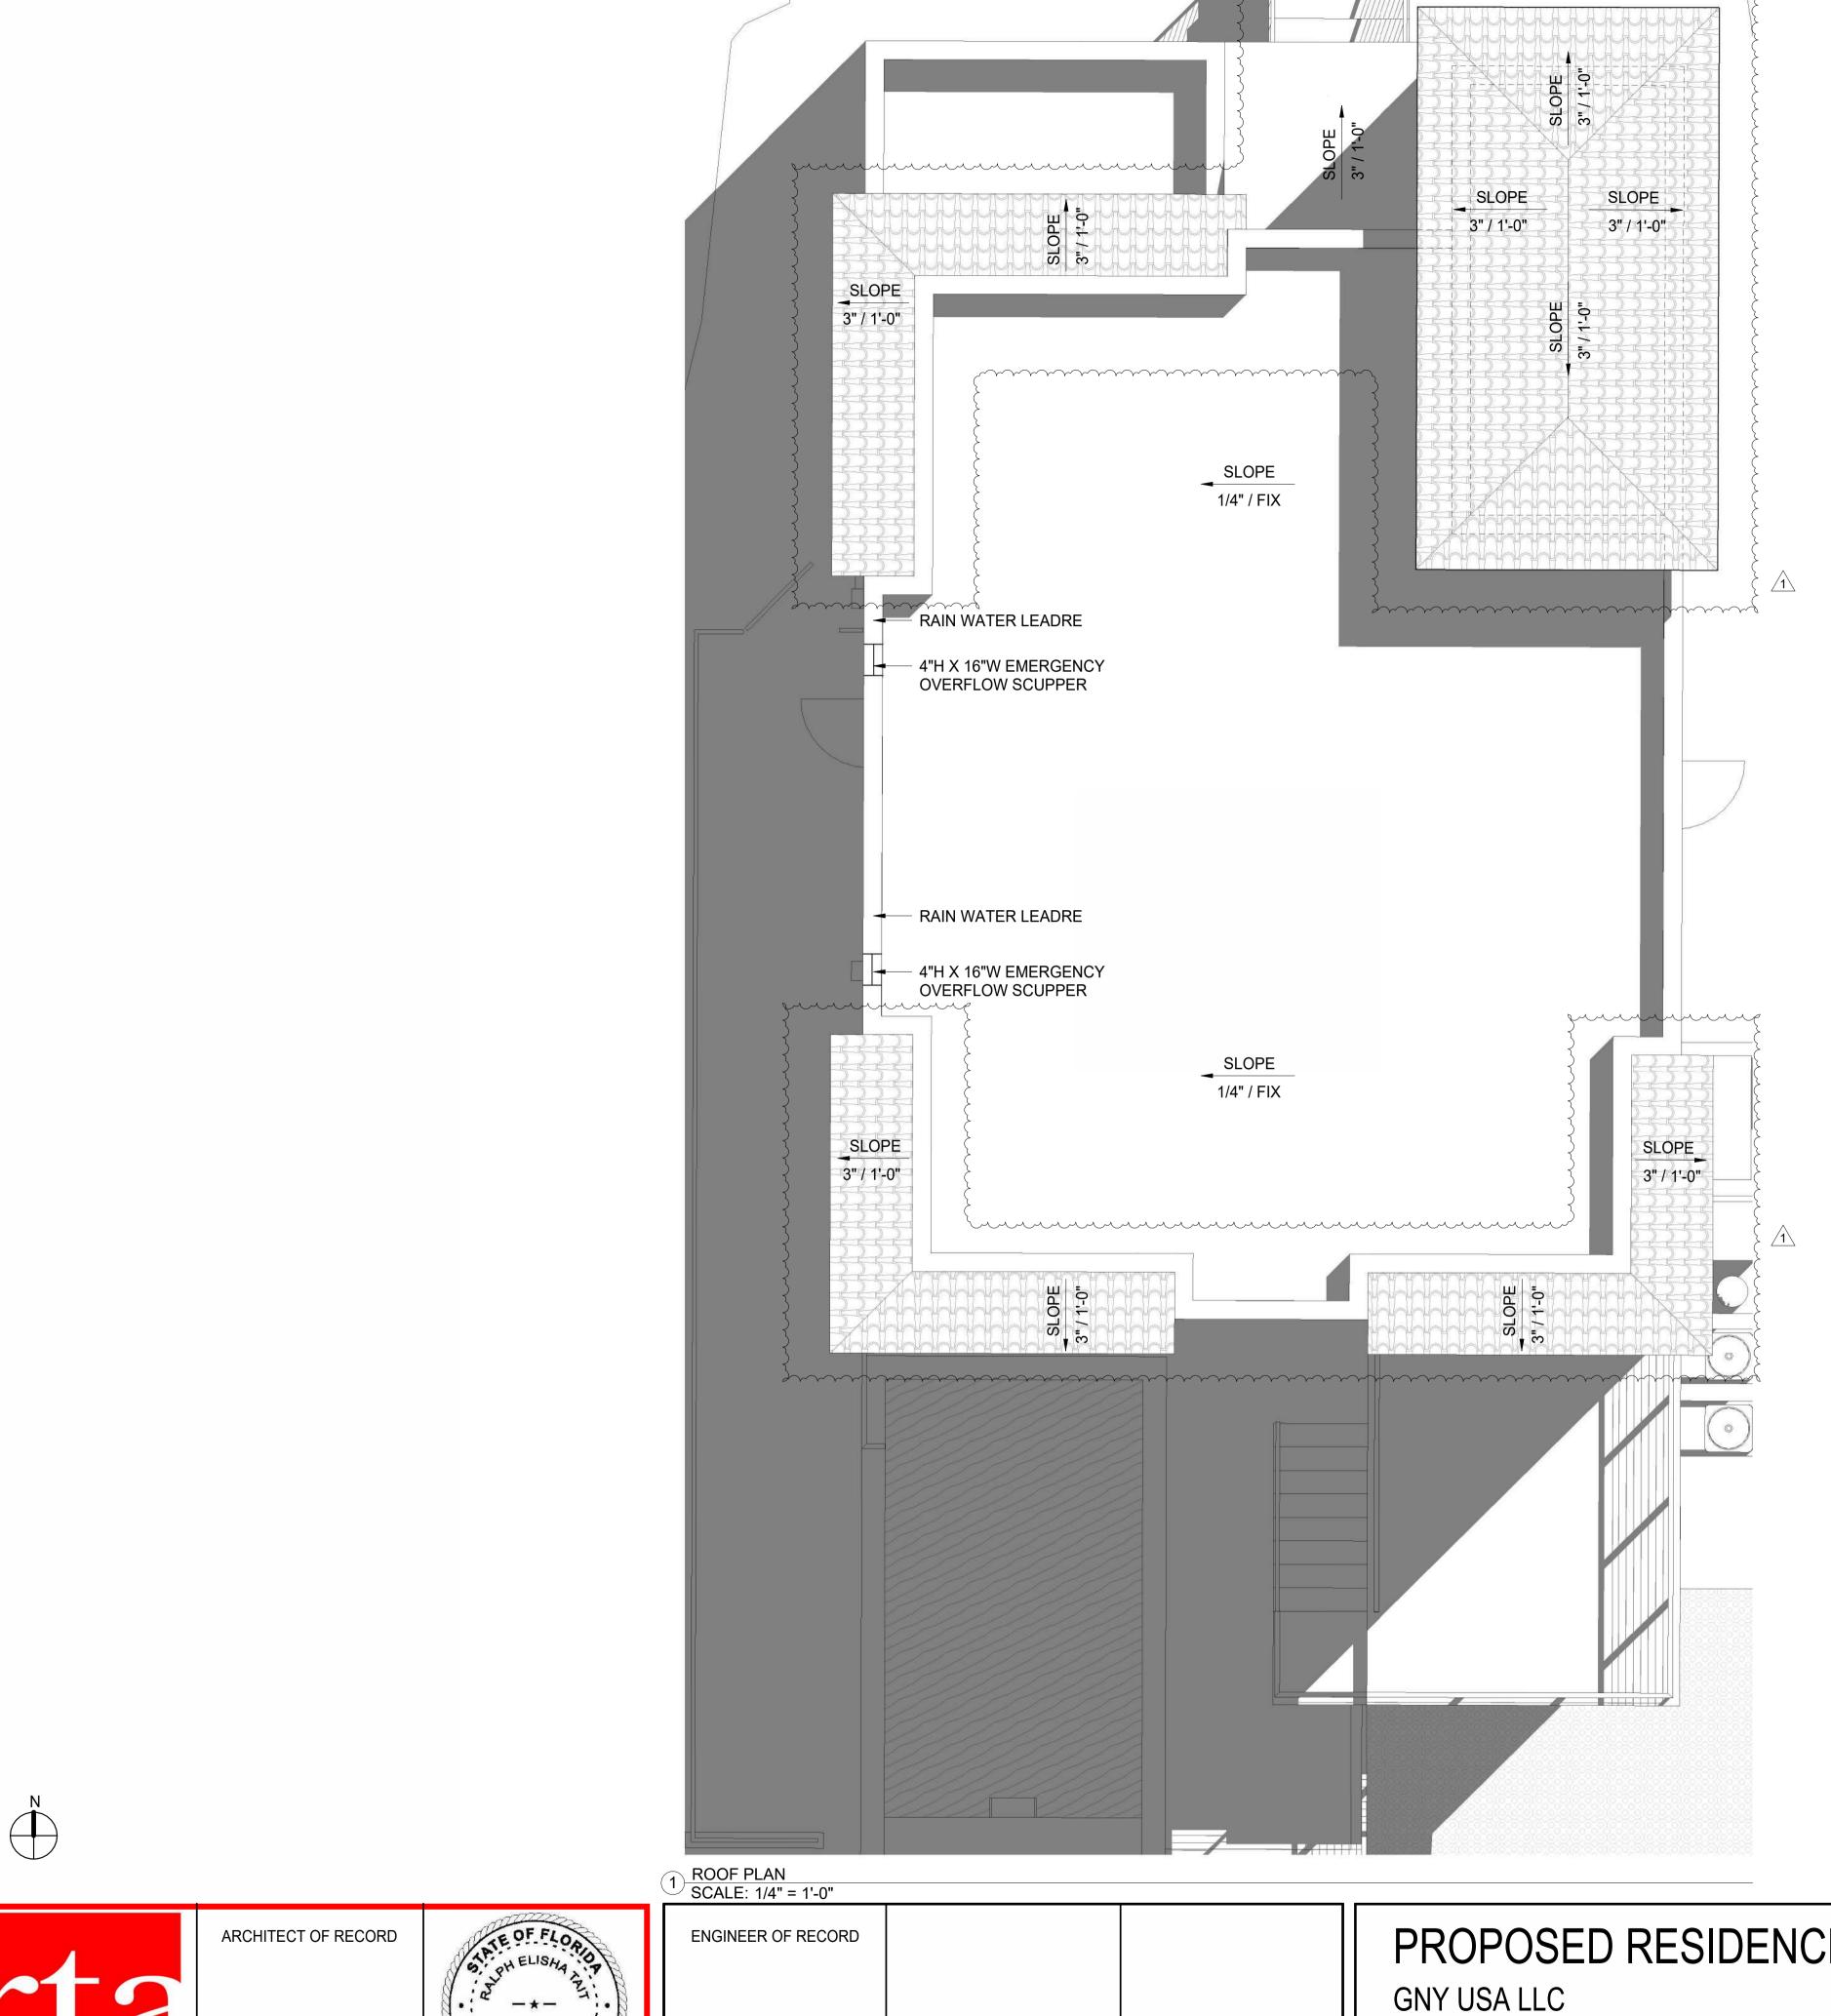



11820 Miramar Parkway, Suite 121 Miramar, Florida, 33025 (P) 954-592-2841 (Fax) 954-392-7502 Email: rtait@bellsouth.net www.rtarchitectinc.com

RALPH E. TAIT AR95832

PROPOSED RESIDENCE for:

908 TYLER STREET, **HOLLYWOOD, FLORIDA 33019 CLIENT:** GNY USA LLC

REV	DATE	DESCRIPTION	DEGLON	
1	10/17/24	STAFF COMMENTS	DESIGN DELIVERABLE:	Historical Bo Submittal
			ISSUE DATE:	07/09/24
			PROJECT NUME	BER: 24-010
			DRAWN BY:	JJ
			CHECKED BY:	RET
			Copyright (c) by RAL All Rights Reserved	PH TAIT ARCHITECT, IN

ROOF PLAN AND NOTES

A-102




<u>MARK</u>	MODEL	MANUFACTURER	FINISH	LOCATION	<u>REMARKS</u>
А	SW7004 SNOWBOUND	SHERWIN WILLIAMS	EXTERIOR SATIN	ALL SMOOTH STUCCO SURFACES	
В	SW7043 WORLDY GRAY	SHERWIN WILLIAMS	EXTERIOR SATIN	ALL SMOOTH STUCCO SURFACES	
С	CUMARU HARDWOOD W/ IPE OIL TO SEAL	TBD	MATTE FINISH	UNDERSIDE OF ROOF OVERHANG	CUMARU
D	ENTRY DOOR	TBD	WOODLIKE ROYAL WALNUT	ENTRY PIVOT DOOR	
E	WINDOWS / DOORS	TBD	BLACK FRAME / CLEAR GLASS	ALL WINDOWS AND DOORS EXCEPT ENTRY DOOR	ESM/MOCWWA 0.m.dex 0.edorr/
F	TILE ROOF	TBD		PITCHED ROOF	
G	ALUMINUM RAILING	сиѕтом	FINISH TO MATCH WINDOW FRAMES BLACK		
Н	CUMARU HARDWOOD W/ IPE OIL TO SEAL	TBD	MATTE FINISH	DECORATIVE WOOD RAFTERS	CUMARU
I	ALUM. RAIN GUTTERS & DOWNSPOUT	сиѕтом	BLACK PAINT		

MARK	KEYNOTE TEXT		
1	5/8" SMOOTH STUCCO ON 8" CMU. FINISH TO BE SELECTED BY OWNER.		
2	IMPACT RESISTANT WINDOWS / DOORS (TYP).		
4	ALUMINUM RAILING BY OTHERS. BLACK FINISH		
5	1X T&G WOOD SOFFIT STAINED.		
6	5/8" SMOOTH STUCCO ON 8" CMU. W/1/2" HORIZONTAL STUCCO REVEAL SPACED EQUALLY @ \pm 1-6.00" O.C BY PLASTIC COMPONENTS OR APPROVED EQUAL.		
41	RETAINING WALL 1'-10" TOTAL HEIGHT.		

2 NORTH ELEVATION
SCALE: 1/4" = 1'-0"

FINISH SCHEDULE.
SCALE:NTS

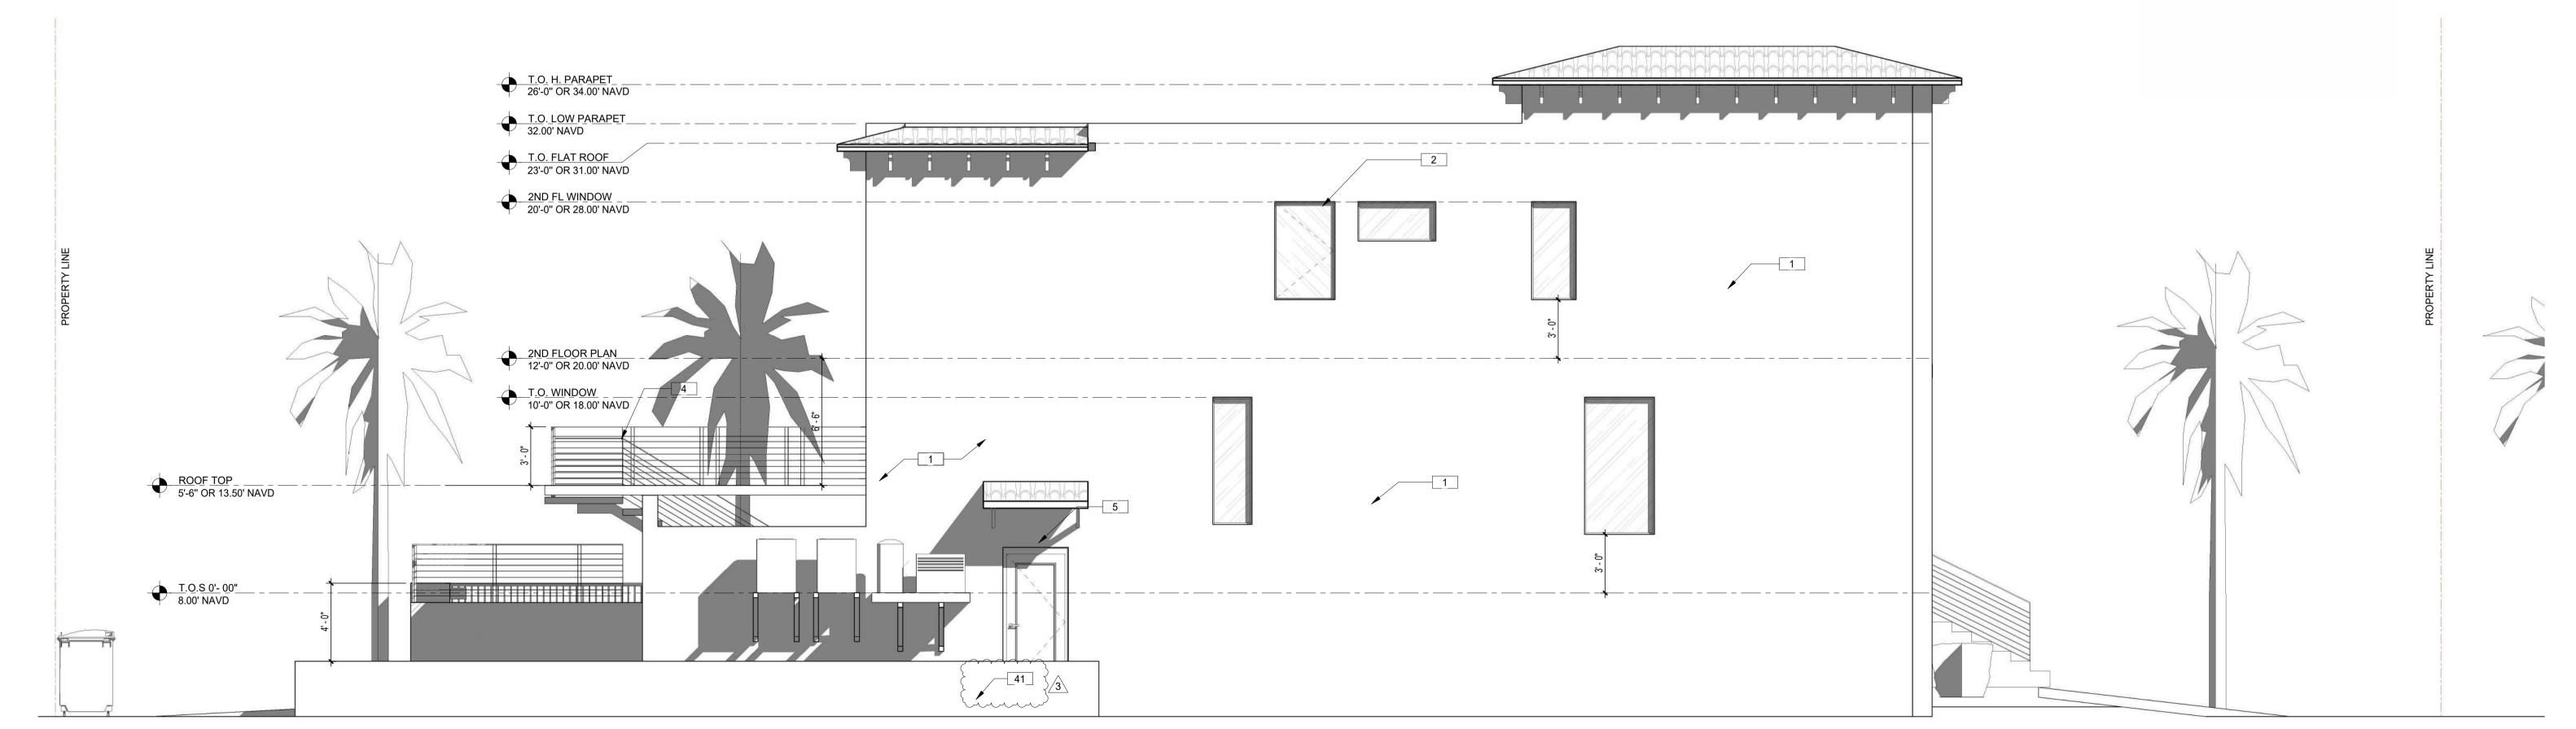

1 EAST ELEVATION SCALE: 1/4" = 1'-0"



ARCHITECT OF RECORD

RALPH E. TAIT DATE
AR95832

ENGINEER OF RECORD

PROPOSED RESIDENCE for:

GNY USA LLC

908 TYLER STREET, HOLLYWOOD, FLORIDA 33019 CLIENT: GNY USA LLC

DATE	REV
10/17/24	1
2/5/25	2
4/4/25	3

DESCRIPTION	550.00	
STAFF COMMENTS	_	Historical Board
STAFF COMMENTS	DELIVERABLE:	Submittal
STAFF COMMENTS		
	ISSUE DATE:	07/09/24
	PROJECT NUMB	ER: 24-010
	DRAWN BY:	JJ
	STAFF COMMENTS STAFF COMMENTS	STAFF COMMENTS STAFF COMMENTS STAFF COMMENTS ISSUE DATE:

CHECKED BY: RET

Copyright (c) by RALPH TAIT ARCHITECT, INC.
All Rights Reserved

BUILDING ELEVATIONS

A-201

SHEET TITLE:



MARK	MODEL	MANUFACTURER	FINISH	LOCATION	<u>REMARKS</u>
А	SW7004 SNOWBOUND	SHERWIN WILLIAMS	EXTERIOR SATIN	ALL SMOOTH STUCCO SURFACES	
В	SW7043 WORLDY GRAY	SHERWIN WILLIAMS	EXTERIOR SATIN	ALL SMOOTH STUCCO SURFACES	
С	CUMARU HARDWOOD W/ IPE OIL TO SEAL	TBD	MATTE FINISH	UNDERSIDE OF ROOF OVERHANG	CUMARIU
D	ENTRY DOOR	TBD	WOODLIKE ROYAL WALNUT	ENTRY PIVOT DOOR	
Е	WINDOWS / DOORS	TBD	BLACK FRAME / CLEAR GLASS	ALL WINDOWS AND DOORS EXCEPT ENTRY DOOR	ESWinduration D. St. Alex UK-66177
F	TILE ROOF	TBD		PITCHED ROOF	
G	ALUMINUM RAILING	CUSTOM	FINISH TO MATCH WINDOW FRAMES BLACK		
н	CUMARU HARDWOOD W/ IPE OIL TO SEAL	TBD	MATTE FINISH	DECORATIVE WOOD RAFTERS	CUMARU
ı	ALUM. RAIN GUTTERS & DOWNSPOUT	CUSTOM	BLACK PAINT		

MARK	KEYNOTE TEXT
1	5/8" SMOOTH STUCCO ON 8" CMU. FINISH TO BE SELECTED BY OWNER.
2	IMPACT RESISTANT WINDOWS / DOORS (TYP).
3	IMPACT RESISTANT STEEL GARAGE DOOR. TO MATCH BUILDING COLOR. SNOWBOUND COLOR.
4	ALUMINUM RAILING BY OTHERS. BLACK FINISH
41	RETAINING WALL 1'-10" TOTAL HEIGHT.

10.000 pp. 10.000 pp.


3 FINISH SCHEDULE SCALE:NTS

7

WEST ELEVATION
SCALE: 1/4" = 1'-0"

ARCHITECT OF RECORD

11820 Miramar Parkway, Suite 121 Miramar, Florida, 33025 (P) 954-592-2841 (Fax) 954-392-7502 Email: rtait@bellsouth.net www.rtarchitectinc.com

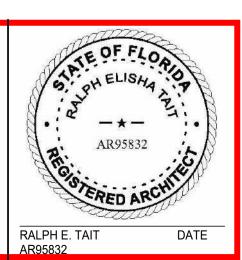

ENGINEER OF RECORD

PROPOSED RESIDENCE for:

GNY USA LLC


908 TYLER STREET, HOLLYWOOD, FLORIDA 33019 CLIENT: GNY USA LLC

ΕV	DATE	DESCRIPTION	5=0.0	
	10/17/24	STAFF COMMENTS	DESIGN	Historical Board
	2/5/25	STAFF COMMENTS	DELIVERABLE:	Submittal
	4/4/25	STAFF COMMENTS		
			ISSUE DATE:	07/09/24
			PROJECT NUMB	ER: 24-010
			D D A \ A \ A \ D \ \	
			DRAWN BY:	JJ
			CHECKED BY:	RET
			OHLONED DT.	INLI
	I			

Copyright (c) by RALPH TAIT ARCHITECT, INC.
All Rights Reserved

BUILDING ELEVATIONS

A-202

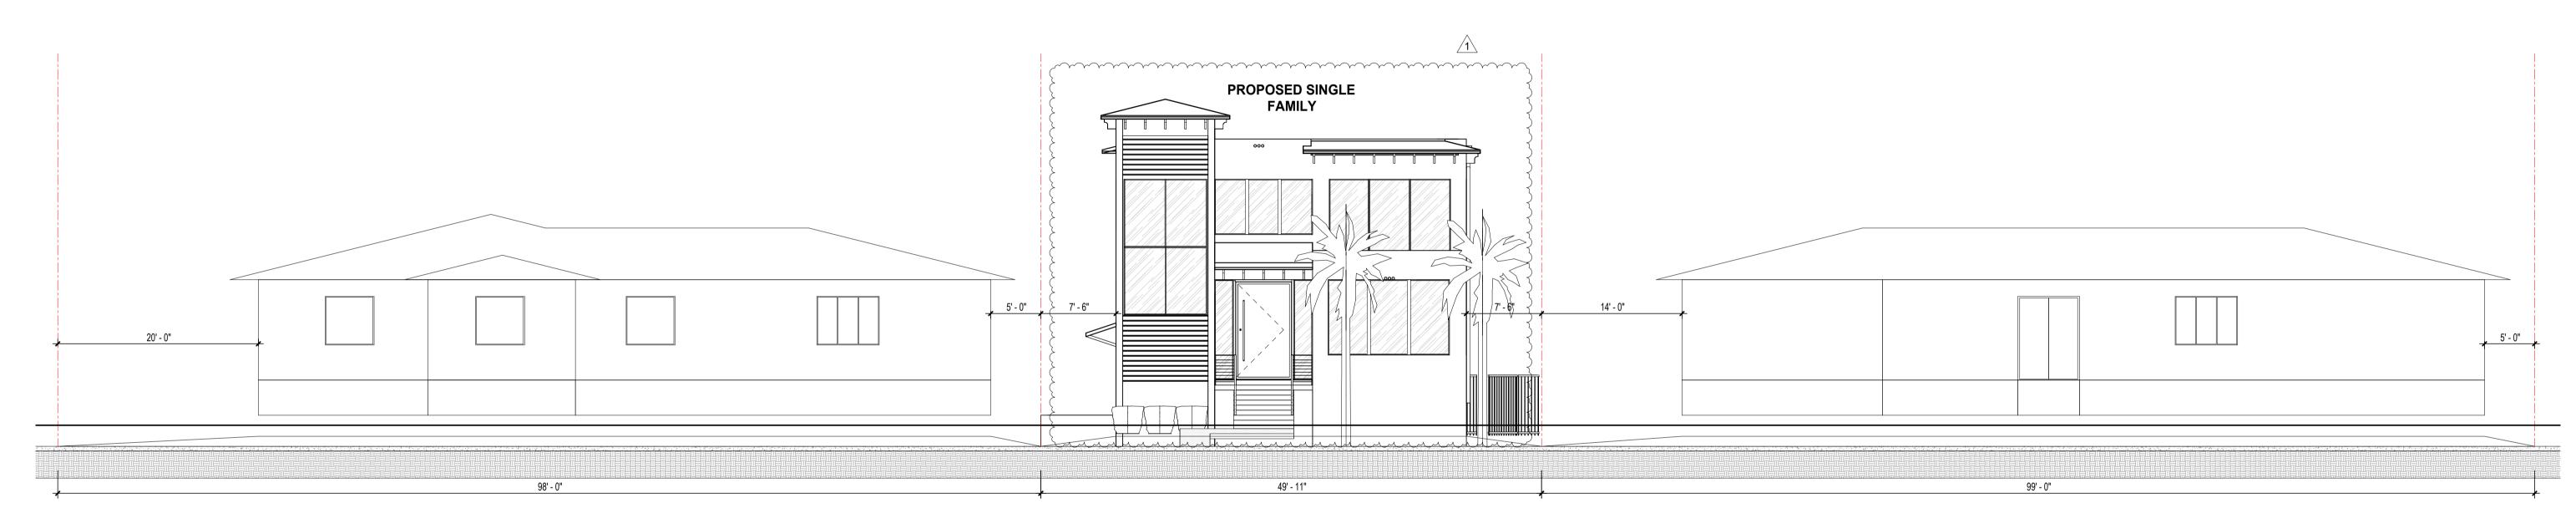


1 STREET PROFILE ELEVATION SCALE: 1/8" = 1'-0"



ARCHITECT OF RECORD

11820 Miramar Parkway, Suite 121 Miramar, Florida, 33025 (P) 954-592-2841 (Fax) 954-392-7502 Email: rtait@bellsouth.net www.rtarchitectinc.com

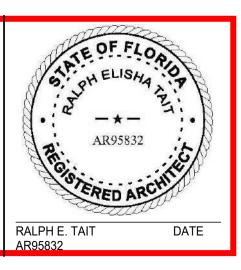

ENGINEER OF RECORD

PROPOSED RESIDENCE for:

GNY USA LLC

908 TYLER STREET, HOLLYWOOD, FLORIDA 33019 CLIENT: GNY USA LLC


REV 1	DATE 10/17/24	DESCRIPTION STAFF COMMENTS	DESIGN DELIVERABLE:	Historical Board Submittal
			ISSUE DATE:	07/09/24
			PROJECT NUME	BER: 24-010
			CHECKED BY:	RET
			Copyright (c) by RAL All Rights Reserved	PH TAIT ARCHITECT, INC.

Historical Board Submittal

07/09/24

MBER: 24-010


A-204

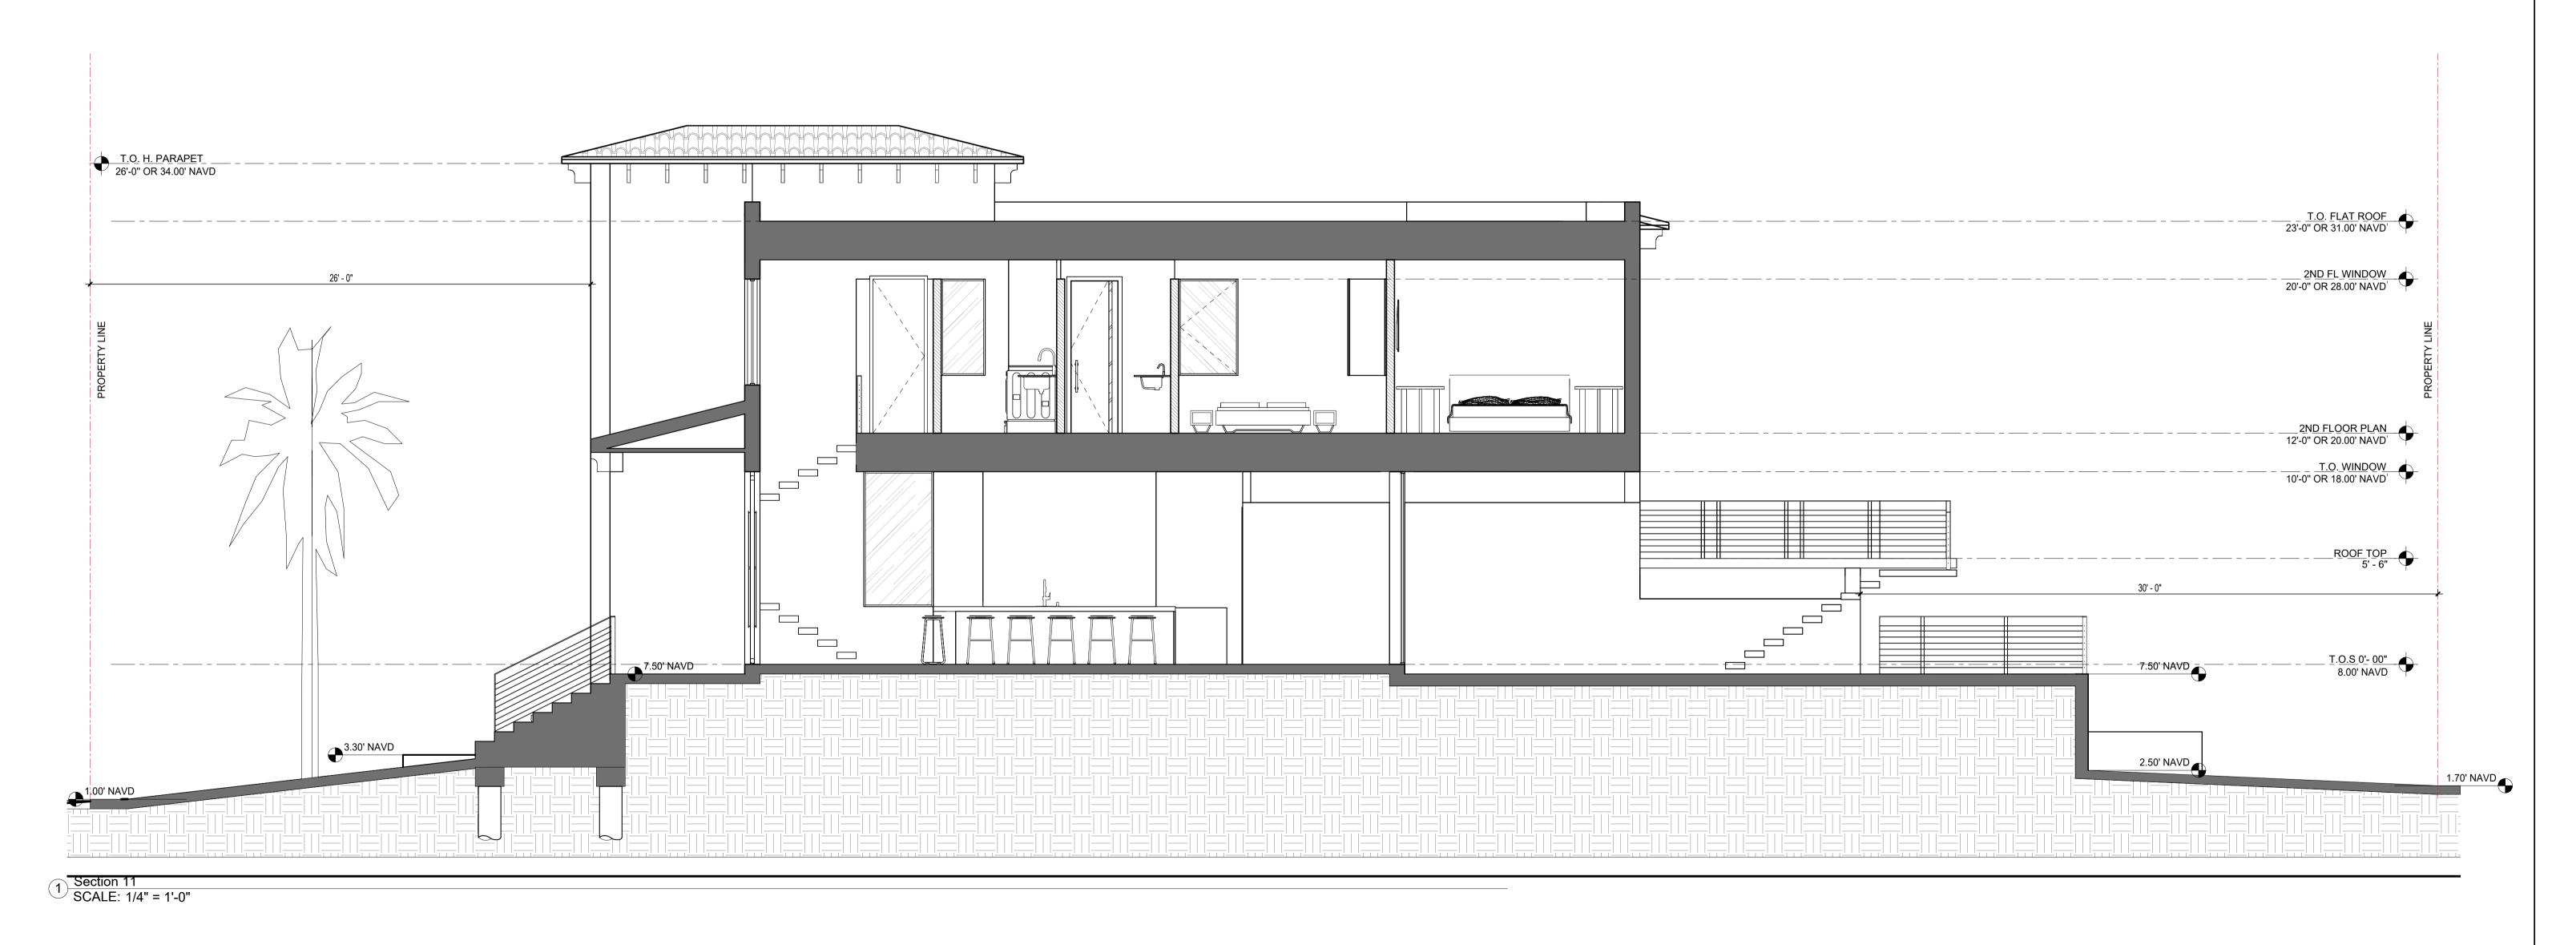

RALPH TAIT ARCHITECT, INC.

ARCHITECT OF RECORD

11820 Miramar Parkway, Suite 121 Miramar, Florida, 33025 (P) 954-592-2841 (Fax) 954-392-7502 Email: rtait@bellsouth.net www.rtarchitectinc.com

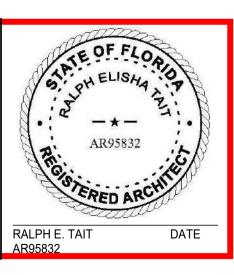


ENGINEER OF RECORD


PROPOSED RESIDENCE for:

GNY USA LLC

908 TYLER STREET,
HOLLYWOOD, FLORIDA 33019
CLIENT: GNY USA LLC

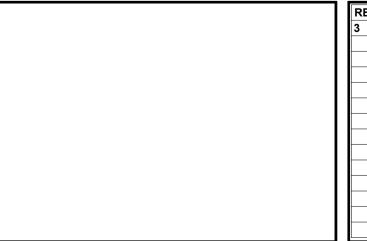

EV	DATE 4/4/25	DESCRIPTION STAFF COMMENTS	DESIGN DELIVERABLE: ISSUE DATE:	Historical Board Submittal 07/09/24	BUILDING SECTIONS
			PROJECT NUME DRAWN BY:	BER: 24-010 Author	
			CHECKED BY: Copyright (c) by RAL: All Rights Reserved	Checker PH TAIT ARCHITECT, INC.	SHEET NUMBER: A-303

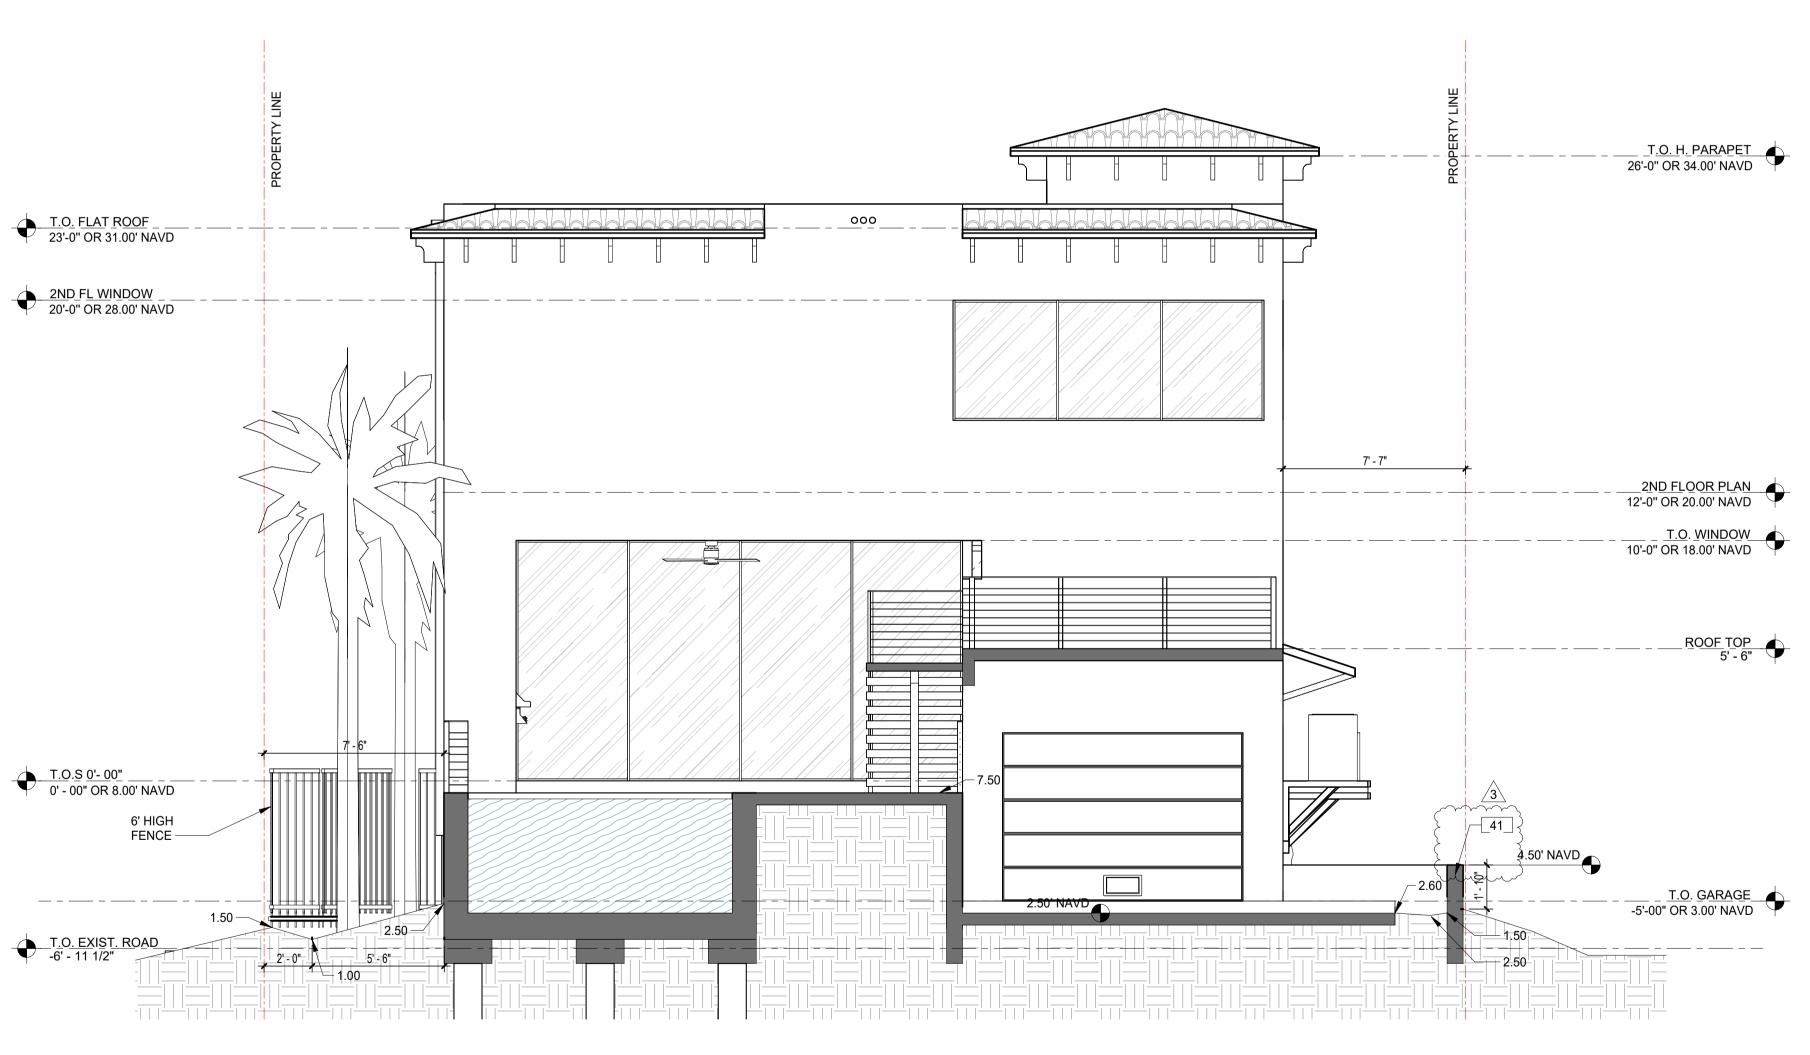

1 Section 13 SCALE: 1/4" = 1'-0"



ARCHITECT OF RECORD

11820 Miramar Parkway, Suite 121 Miramar, Florida, 33025 (P) 954-592-2841 (Fax) 954-392-7502 Email: rtait@bellsouth.net www.rtarchitectinc.com

RALPH E. TAIT DATE AR95832

ENGINEER OF RECORD

PROPOSED RESIDENCE for:

GNY USA LLC

908 TYLER STREET,
HOLLYWOOD, FLORIDA 33019
CLIENT: GNY USA LLC

REV 3	DATE 4/4/25	DESCRIPTION STAFF COMMENTS	DESIGN Historical Bo
			ISSUE DATE: 07/09/24
			PROJECT NUMBER: 24-010 DRAWN BY: Author
			CHECKED BY: Checker
			Copyright (c) by RALPH TAIT ARCHITECT, IN All Rights Reserved

BUILDING SECTIONS

A-304





ARCHITECT OF RECORD

11820 Miramar Parkway, Suite 121 Miramar, Florida, 33025 (P) 954-592-2841 (Fax) 954-392-7502 Email: rtait@bellsouth.net www.rtarchitectinc.com

ENGINEER OF RECORD

PROPOSED RESIDENCE for:

GNY USA LLC

908 TYLER STREET, **HOLLYWOOD, FLORIDA 33019**


REV 1	DATE 10/17/24	DESCRIPTION STAFF COMMENTS	DESIGN Historical Board DELIVERABLE: Submittal ISSUE DATE: 07/09/24
			PROJECT NUMBER: 24-010 DRAWN BY: Author CHECKED BY: Checker
			Copyright (c) by RALPH TAIT ARCHITECT, INC. All Rights Reserved

FRONT VIEW

SHEET TITLE:

SHEET NUMBER:

CLIENT: GNY USA LLC

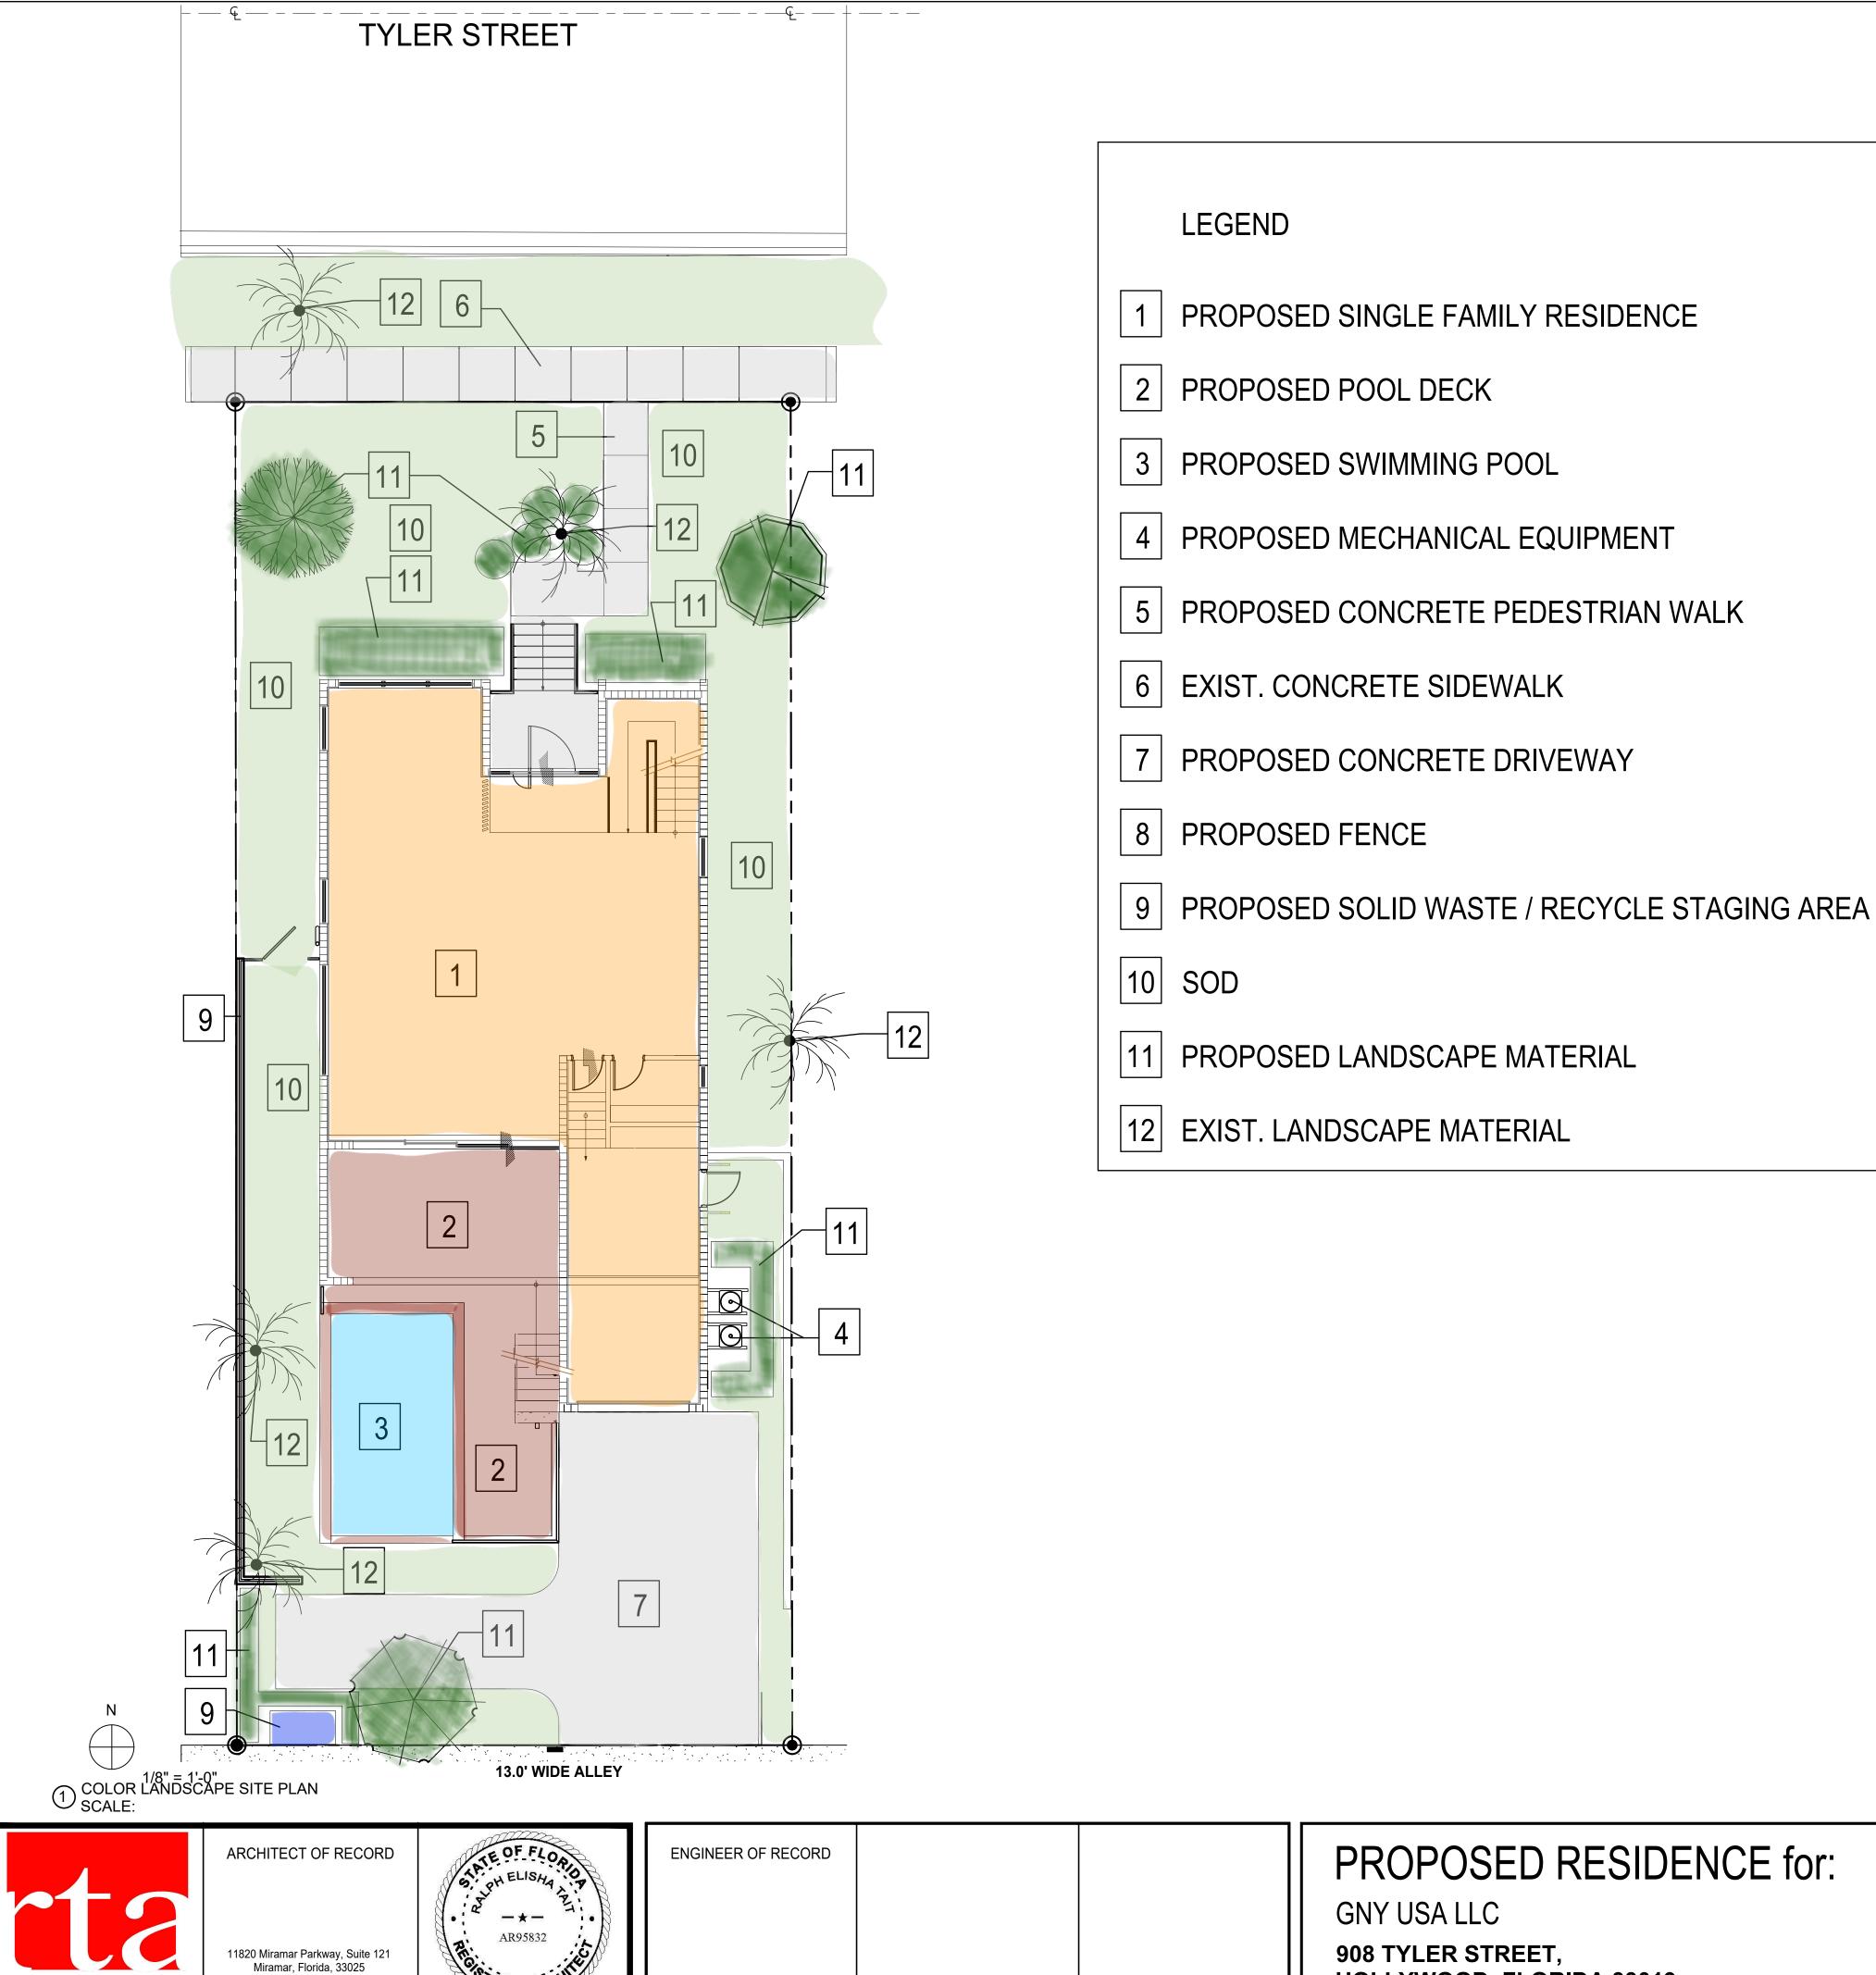

(P) 954-592-2841 (Fax) 954-392-7502 Email: rtait@bellsouth.net www.rtarchitectinc.com

RALPH E. TAIT

PROPOSED RESIDENCE for:

HOLLYWOOD, FLORIDA 33019 CLIENT: GNY USA LLC

REV	DATE	DESCRIPTION	DESIGN	Historical Board	SHEET TITLE:
			DELIVERABLE:	Submittal	
			ISSUE DATE:	07/09/24	
					1
			PROJECT NUME	BER: 24-010	
			DRAWN BY:	JJ	
			CHECKED BY:	RET	SHEET NUMBER:
					I S-101
			All Rights Reserved	PH TAIT ARCHITECT, INC.	LO-101

The plan takes precedence over the plant list.

2 Full business days before digging, call toll free 1-800-432-4770 Sunshine State One Call of Florida, Inc. Notification Center. Contractors are responsible for coordinating with the owners and appropriate public agencies to assist in locating and verifying all underground utilities prior to excavation. All existing utilities shown on the plans are to be considered approximate and should be verified by the contractor prior to the start of work operations.

General site and berm grading to +/- 1 inch (1") shall be provided by the general contractor. All finished site grading and final decorative berm shaping shall be provided by the landscape contractor.

All sizes shown for plant material on the plans are to be considered Minimum. All plant material must meet or exceed these minimum requirements for both height and spread. Any other requirements for specific shape or effect as noted on the plan(s) will also be required for final acceptance.

All plant material furnished by the landscape contractor shall be Florida #1 or better as established by Grades and Standards for Florida Nursery Trees and

All trees designated as single trunk shall have a single, relatively straight, dominant leader, proper structural branching and even branch distribution. Trees with bark inclusion, tipped branches, and co—dominant trunks will not be accepted. Trees with girdling, circling and/or plunging roots will be rejected.

All planting beds shall be free of all rocks $\frac{1}{2}$ " or larger, sticks, and objectionable material including weeds, weed seeds. All limerock shall be removed/cleaned down to the native soils. Planting soil 50/50 sand/topsoil mix shall be delivered to the site in a clean loose and friable condition and is required around the root ball of all trees and palms, the top 6" of all shrubs and ground cover beds. This soil can be tilled into the existing soil after the existing soil has been cleaned of all rocks, limestone and sticks. Recycled compost is encouraged as a soil amendment alternative. Sod 1.5-2" topsoil comes furnished.

All burlap, string, cords, wire baskets, plastic or metal containers shall be removed from the rootballs before planting. Remove all bamboo and metal nursery stakes. Remove all tagging tape.

All trees/palms shall be planted so the top of the root ball, root flair are slightly above final grade. Shrub material shall be planted such that the top of the plant ball is flush with the surrounding grade. It is the sole responsibility of the landscape contractor to insure that all new plantings receive adequate water during the installation and during all plant warranty periods. Deep watering of all new trees and palms and any supplemental watering that may be required to augment natural rainfall and site irrigation is mandatory to insure proper plant development and shall be provided as a part of this contract.

All trees/palms shall be staked using biodegradable material. No wire, black strapping, or other synthetic material shall be used. Nailing into trees and palms for any reason is prohibited and the material will be rejected. Please refer to the planting details

All landscape areas shall be irrigated by a fully automatic sprinkler system with a minimum 100% coverage with all heads adjusted to 50% overlap. Each system shall be installed with an operational rain sensor and rust

No fertilizers are required.

All landscape areas shall be covered with Pine Straw, Pine Bark, Eucalyptus or sterilized seed free Melaleuca mulch to a minimum depth of two inches (2") of cover when settled. Spread mulch to 1" thickness 3" away from the trunks/stems of all plant material. All trees in sodded areas shall have a clean cut 4' diameter mulch ring. The 5-6" height water ring shall be made from mulch, not soil. Certain areas may receive a thicker mulch cover where noted on plans. Cypress, red, gold and green mulch is prohibited.


Please refer to the planting details for a graphic representation of the above notes.

All plant material as included herein shall be warranted by the landscape


contractor for a minimum period of 12 months after final inspection approval.

No landscape substitutions shall be made without the City of Hollywood

No tree removal or planting allowed until sub permits are fully approved by city.

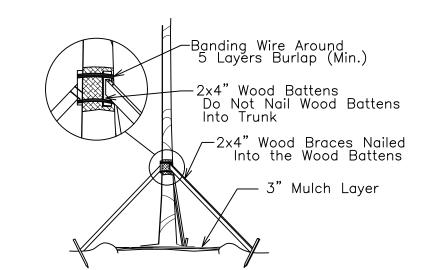


TREE/PALM BRACING DETAIL

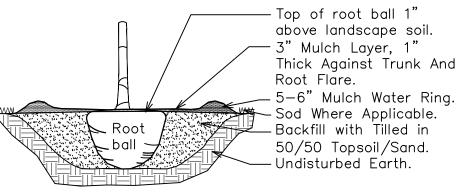

TREE/PALM PLANTING DETAIL


TYLER STREET

ASPHALT ROADWAY

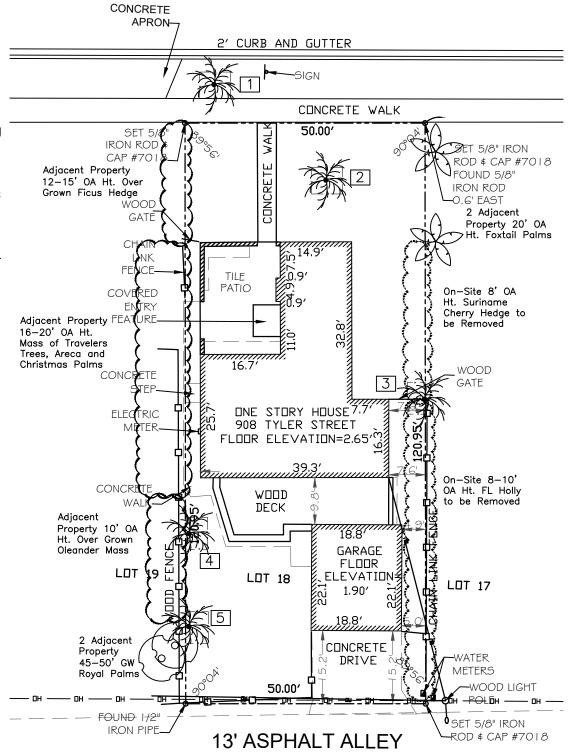


TREE SURVEY


SCALE: 1"=20"

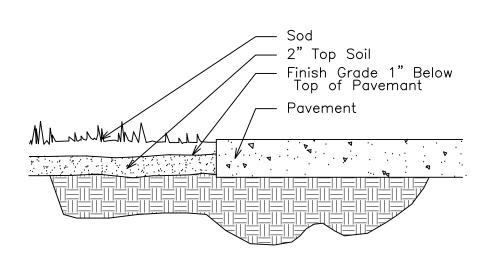

SOD INSTALLATION DETAIL

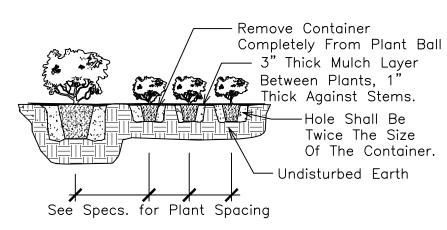


SHRUB PLANTING DETAIL

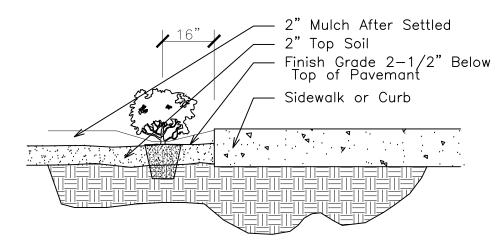


SHRUB INSTALLATION DETAIL



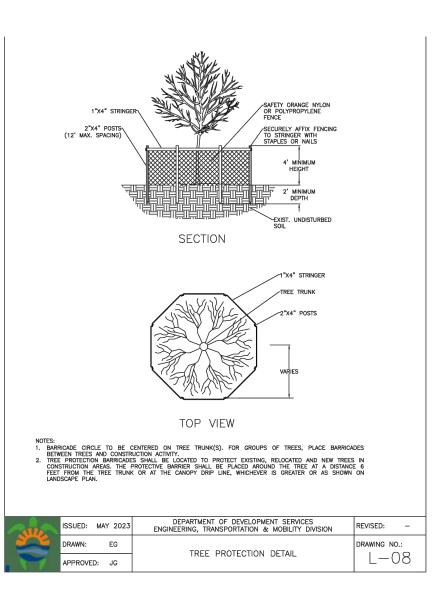

Before Construction Begins,
Contractor to Install and
Maintain Tree Protection
Fencing Around Existing Trees
As Shown. See Existing Tree
Protection Detail This Sheet


Existing Pa	alm List						
Address:	908 Tyler Street, Hollywood, FL						
Date:	10/16/2024						
Appraiser:	Thomas White, ASLA-ISA.						
	Landscape Atchitect FL #LA1100						
	ISA Arborist FL-5248A						
Palm	Botanical Name / Common Name	Ht.	GW	DBH	Condition	Replacement	Disposition
#		(Feet)	(Feet)	(Inches)		Palms	
1	Roystonea elata / Cuban-Florida Royal Palm	40	30	10	Fair-Good	0	Remain
2	Roystonea elata / Cuban-Florida Royal Palm	50	40	16	Good	0	Remain
3	Roystonea elata / Cuban-Florida Royal Palm	30	20	14	Good	0	Remain
4	Roystonea elata / Cuban-Florida Royal Palm	50	40	16	Good	0	Remain
5	Roystonea elata / Cuban-Florida Royal Palm	50	40	16	Good	0	Remain
			Replacement Palms Required		0		

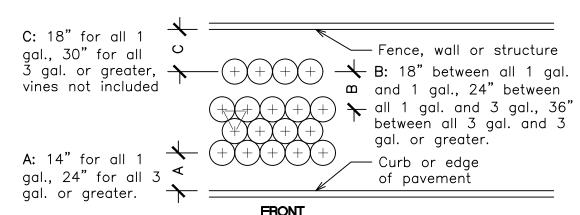

TYPICAL SHRUB SPACING DETAIL

Code		Drought	QTY.		Botanical Name / Common Name	Specifications per Sec.
						3.3 Landscape Manuel
EXISTI	NG P	ALMS				
ERE	(N)	V	5		Existing Roystonea elata / Cuban-Florida Royal Palm	30-50 OA Ht.
PROP	OSED	TREES				
CS	(N)	V	1		Cordia sebestena / Orange Geiger	12'x4-5', 2" Cal. DBH, Sng. Trunk
IC	(N)	V	1		Ilex cassine / Dahoon Holly	12'x4-5', 2" Cal. DBH, Sng. Trunk
LL	(N)	V	1		Lysiloma latisiliquum / Tamarind	12'x4-5', 2" Cal. DBH, Sng. Trunk
			5		Total Site Trees (2 ERE Counted)	
			5		Native Trees	
			100%		Native Trees	
PROP	OSED	SHRUBS				
CIR	(N)	V	24		Chrysobalanus icaco / 'Red Tip' Cocoplum	3 Gal., 24"x 24", 24" OC
CRS	(N)	V	10		Clusia rosea / Small Leaf Clusia	7/10Gal., 48"x 24", 36" OC
TDF	(N)	V	5		Tripsacum dactyloides / Fakahatchee Grass	3 Gal., 24"x 24", 42-48" OC
			39		Total Shrubs	
			39		Native Shrubs	
			100%		Native Shrubs	
SOD						
Sod		M	By GC	S.F.	Stenotaphrum secundatum / St. Augustine 'Palmetto'	Solid application - no gaps between seams
			М		Moderate Drought Tolerance	
			V		Very Drought Tolerant	
			(N)		Florida Native Species	

LANDSCAPI	Required	Provided		
Sec. 2.1:1	Street	Tree Requirement: One 12' Tree at 50' OC		
	50	Feet of Tyler Street	1	1
Sec. 2.1	SFR: T	ree and Shrub Requirement - Single Family Residence		
	3	Trees Front Half of Plot	3	3
	15	Shrubs Front Half of Plot	15	17
	1	Tree Rear Half of Plot	1	1
	10	Shrubs Rear Half of Plot	10	10
		Total Trees:	5	5
		Total Shrubs:	25	39

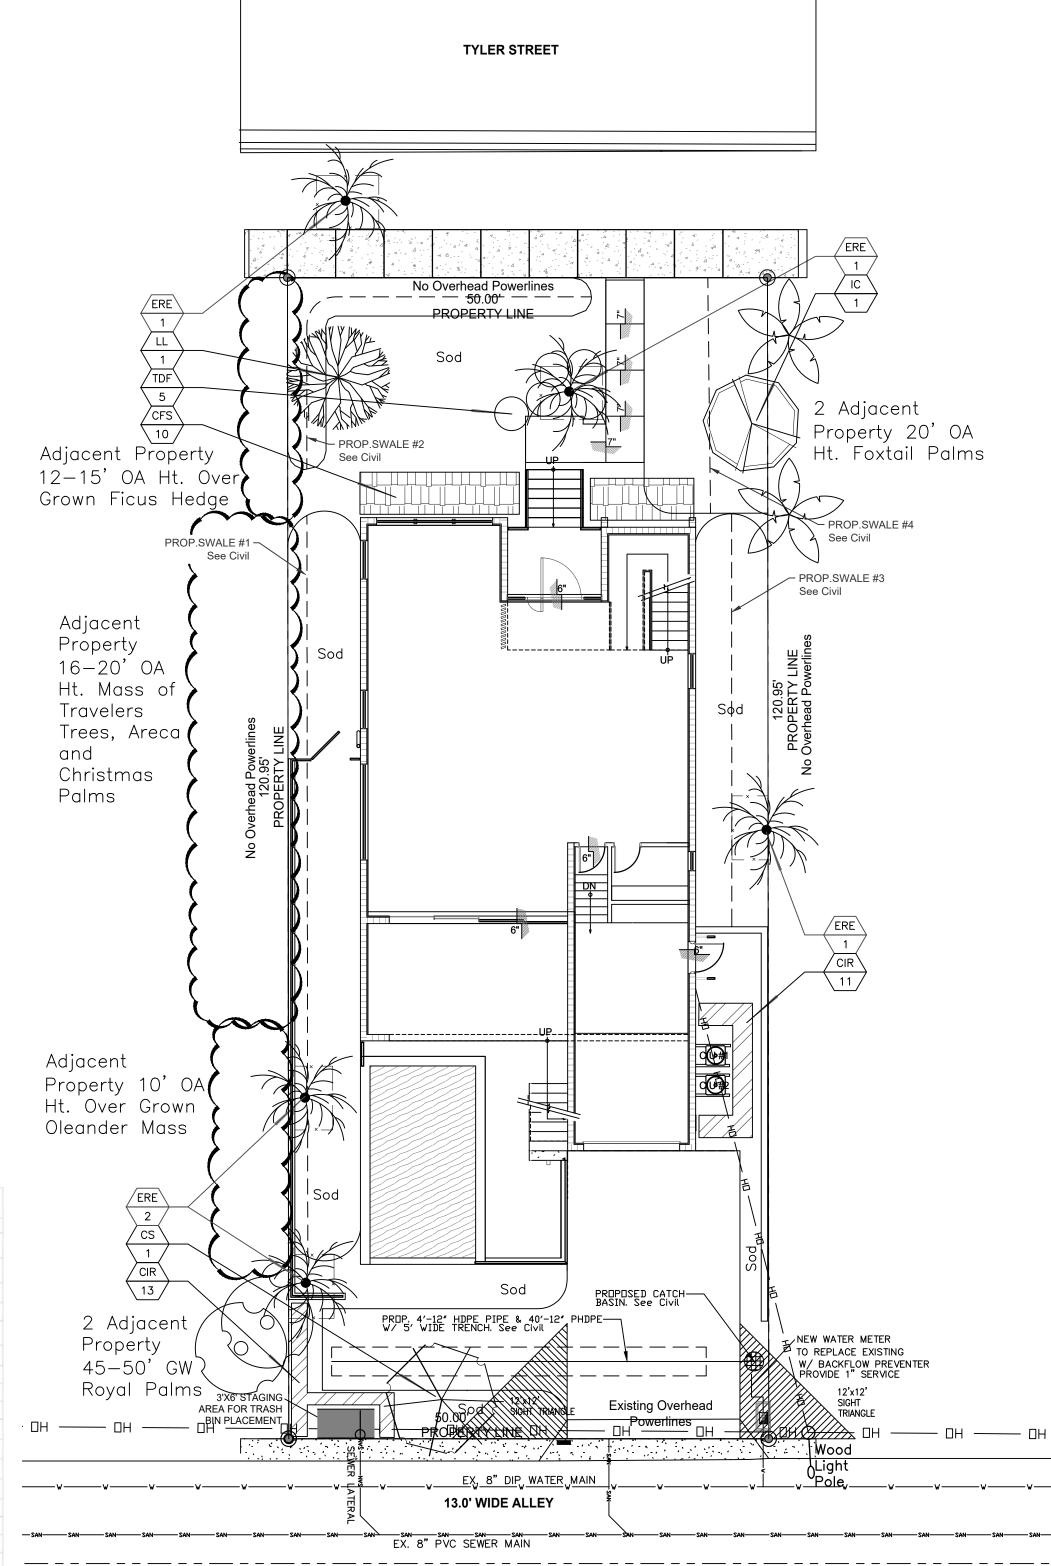

TYLER STREET

LANDSCAPE PLAN SCALE: 1"=10"

CITY OF HOLLYWOOD SITE PLAN INFORMATION Future Land Use: SF Residential Property Zoning: RS-6 Existing Land Use: SFR 6,047.5 Sq. Feet = 13.9% Acres 2,207 Sq. Feet = 36.5% Building Area: Driveway / Pads: 686 Sq. Feet = 11.3% 626 Sq. Feet Pool / Deck: = 10.4% 3,519 Sq. Feet = 58.2% Total Impervious Areas: Landscape Area: 2,528.5 Sq. Feet = 41.8%

2,528.5 Sq. Feet

= 41.8%

Total Pervious Areas:

Sunshine


Call 811 or www.sunshine811.com two full business days before digging to have utilities located and marked.

Check positive response codes before you dig!



DRAWN:
TW
CHECKED:
TW
DATE:
10-17-2024
SCALE: As Shown



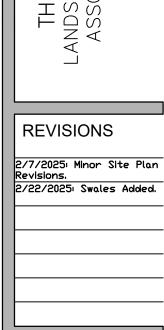

Tree Survey / Landscape Permit Plan

dence for GNY USA, LL

908 Tvler Street

1" MAIN LINE

LATERAL ZONE LINES.

CONTROLLER - Intermatic Electric 4 station

Mini Clik automatic rain sensor shutoff switch

ZONE VALVES - Hunter PGV Series with

SCV-100-VALVE-B Smart Valve Battery Controller.

mounted outside on top of wall...

Sch. 40, 2 Sizes Larger. NOTE - Pipe Size Shown is the Lateral Size, NOT the Sleeve Size

6″ P□P-UP SPRAY -Hunter MP Rotator Series: Nozzles as Required.

NOTE - All of the below may not be used

Radius Radius Radius 120 T 180 H 240 TT 270 TQ


∞ 6" P□P-UP STREAM BUBBLER - Hunter 5-CST-B 5'R.

△ RCS-515 5 × 15′ □ SS-530 5 × 30′

■ ES-515 5 × 15′

/ 0.0 \ GPM

ZONE # VALVE SIZE

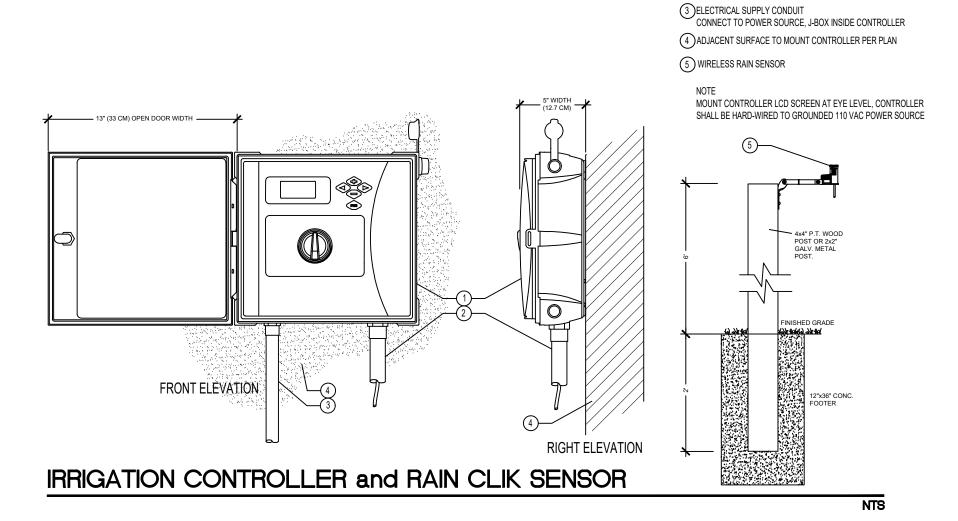

IRRIGATION NOTES:

Main Lines: PVC SCH 40 Solvent Weld. Zone Lines: PVC SCH 40 Solvent Weld. 1/2 in. is not used. All pipe is 3/4 inch. Sleeves and suction Line: PVC SCH 40.

Fittings: SCH 40 PVC

Fabrication: To manufacturers specifications. Use blue or grey PVC cement, square cut, clean and prime all joints.

Allow all main lines to cure for 24 hours before pressuring.

All pipe, fittings, and solvents to conform to latest ASTM specs.

Depth of Lines: Main Line and wiring = 18 in. depth, min. Sleeving under pavement = 24 in. depth, min. Suction Line = 24 in. depth, nominal.

Zone Lines 1-1/2 in. and smaller = 15 in. depth, min.

Control Wires: AWG 14 for all hot wires and AWG 12 for common. Solid copper type UF UL listed for direct burial. Run wires under main.

Run spares, two min. Splice wires only in a valve box. All splices shall be moisture proof using Snap tite or DBY UL connectors.


Common shall be white, hot shall be red or color coded Spare shall be black. Run all wires in Grey Electrical SCH 40 conduit...

Backfill all trenches free of debris, compact to original density, flush all lines, use screens in all heads, adjust heads for proper coverage avoiding excess water on walls, walks, etc.

All details are graphically shown only. All quantities shall be verified by the contractor prior to installation. It shall be the contractors responsibility to assure complete overlapping coverage. Any discrepancies shall be reported to the owner and landscape architect before proceeding. Codes and local regulations shall take precedence over these plans, it is the contractors responsibility to comply. The landscape architect reserves the right to make minor field changes, the contractor may field adjust spray nozzle selection to provide for proper 100% min, coverage.

Provide owner with an accurate as installed plan(s) at completion showing main lines, wiring, valves, crossings, etc. using dimensions from fixed datums.


Contractor shall verify all underground utilities prior to commencement of work.

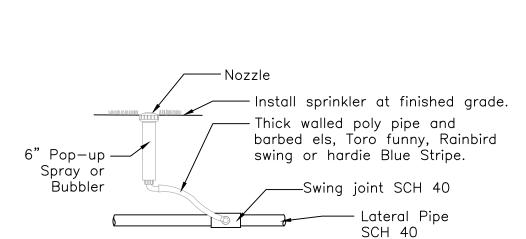


6" Pop-up Spray / Bubbler Detail

1)IRRIGATION CONTROLLER

2 IRRIGATION CONTROL WIRE IN CONDUIT SIZE AND TYPE PER LOCAL CODES

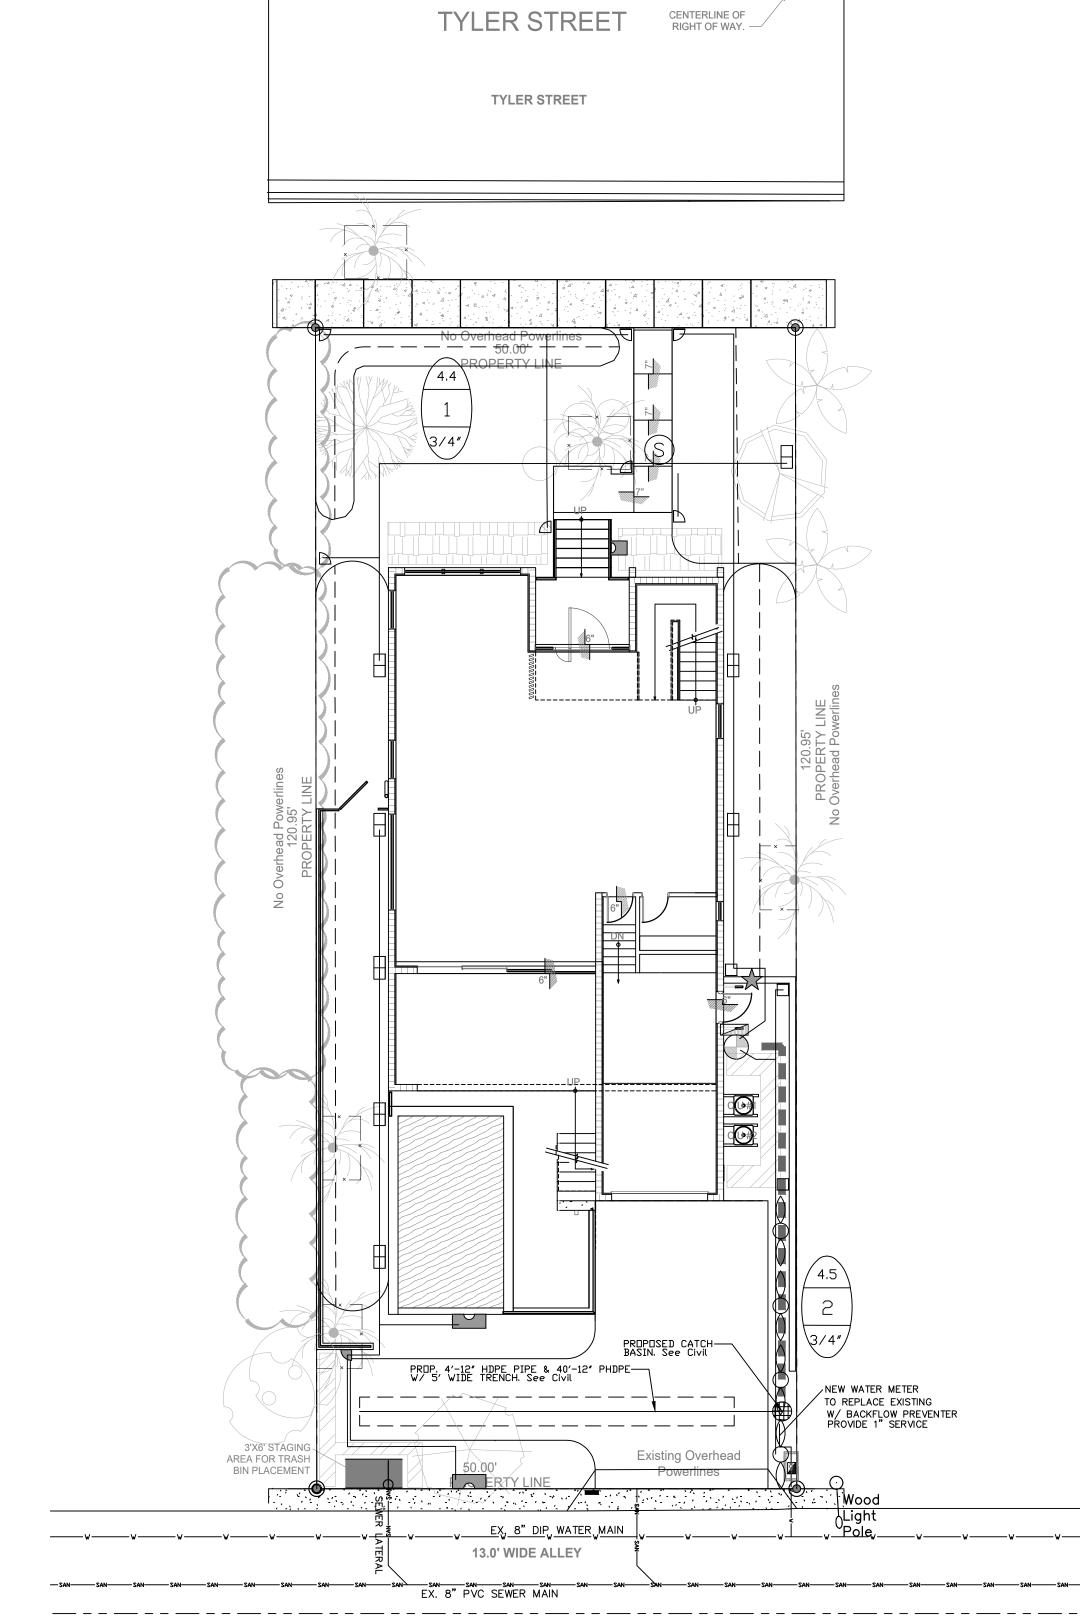

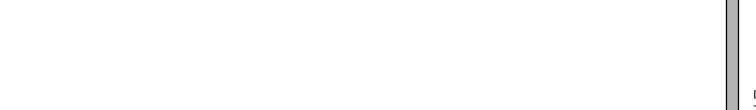

Call 811 or www.sunshine811.com two full business days before digging to have utilities located and marked. Check positive response codes before you dig!

Sunshine@[[]




esid

REVISIONS

CHECKED: DATE: 10-17-2024 SCALE: As Shown

GNY USA LLC. NEW SINGLE FAMILY HOME

908 TYLER STREET HOLLYWOOD, FLORIDA 33019

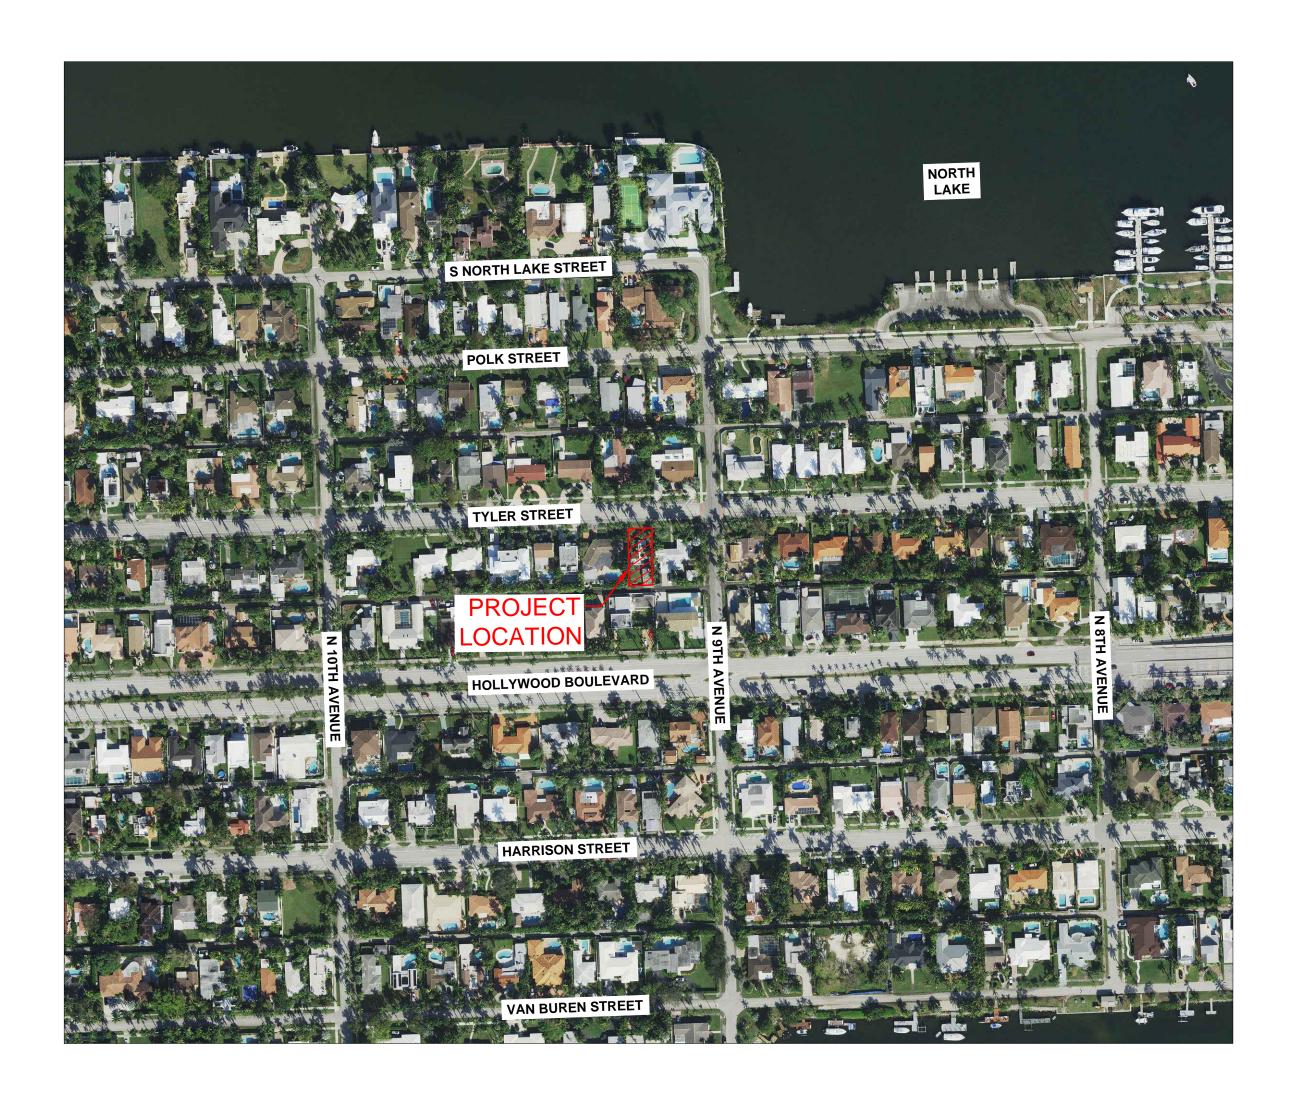



INDEX OF SHEETS:

03-1	COVER .	SHEET			
PD-1	PAVING,	GRADING	&	DRAINAGE	PLA
PD-2	PAVING,	GRADING	&	DRAINAGE	DET

SWPP-1 STORMWATER POLLUTION PREVENTION PLAN & EROSION CONTROL DETAILS

WS-1 WATER & SEWER PLAN

WS-2 DEPARTMENT OF PUBLIC UTILITIES STANDARD DETAILS

WS-2A WATER & SEWER DETAILS



& SUAREZ ENGINEERING
& SURVEYING, INC
13350 SW 131ST STREE
SUITE 103
MIAMI, FL 33186
Tel: 305.596.1799

CERTIFICATE OF AUTHORIZATION
LIC. NO.: 34996

08 TYLER STREET

CLIENT:
RALPH TAIT ARCHITECT, INC.

PROJECT NAME: NEW SINGLE FAMILY HOME

PROJECT ADDRESS: 908 TYLER STREET, HOLLYWOOD, FLORIDA 33019

PROJECT NUMBER:

REVISIONS
E BY DESCRIPTION

LICENSE No. 74556

STATE OF FLORIDA

STATE OF FLORIDA

STATE OF FLORIDA

STATE OF FLORIDA

The seal to the seal of the seal of

JESUS J. SUAREZ, P.E.
LICENSE NO. – 74556

DATE: 4/7/2025

SCALE: AS SHOWN

DESIGNED BY: J.S.

DRAWN BY: J.S.S.

CHECKED BY: J.S.

FILE:

LOB. No. 25-63-02

0.122.110.

CS-1

LOCATION MAP

1"=200"

FOLIO: 5142-14-02-2570

CIVIL ENGINEERING PLANS



Call 811 or visit sunshine811.com two full business days before digging to have buried facilities located and marked.

Check positive response codes before you dig!

SITE CALCULATIONS:

BUILDING FOOTPRINT 2,207.00 SQ FT 36.49% 686.00 SQ FT 11.34% DRIVEWAY & PADS POOL AND DECK 626.00 SQ FT 10.35% LANDSCAPING 2,528.50 SQ FT 41.82% TOTAL AREA 6,047.50 SQ FT 100.00% TOTAL PERVIOUS AREA 2,528.50 SQ FT 41.82% TOTAL IMPERVIOUS AREA 3,519.00 SQ FT 58.18%

DRAINAGE CALCULATIONS:

SITE SHALL RETAIN 1" RUNOFF OVER ENTIRE SITE OR 2 1/2" OVER IMPERVIOUS AREAS (WHICHEVER IS GREATER),

6,047.50 SQ. FT. X 0.0833 FT = 503.76 CU. FT. (N/A) 3,519.00 SQ. FT. X 0.2083 FT = 733.01 CU. FT. (REQUIRED)

SWALE #1 = 144 CU. FT.

SWALE #2 = 47 CU. FT. SWALE #3 = 79 CU. FT.

SWALE #4 = 80 CU. FT.

TOTAL VOLUME PROVIDED IN SWALES = 350 CU. FT.

EXFILTRATION TRENCH:

BALANCE OF VOLUME REQUIRED: 471.45 CU. FT. / (43,560 AC / FT X 12 IN/FT) = 0.13 AC-IN Computation of Trench Volume

endi volume

V = L / (K(H2W + 2H2Du - Du2 + 2H2Ds) + (1.39 x 10-4)(WDu))

L = Length of trench required (feet)
V = Volume to be exfiltrated (Ac-In)

W = Trench width (feet)

K = Hydraulic Conductivity (cfs/ft2-ft. head)

H2 = Depth to water table (feet)

Du = Non-saturated trench depth (feet)

Ds = Saturated trench depth (feet)

L = 40 LF W = 5.00 ft

K = 1.50 x 10-4 (Assumed)


H2 = 1.50 ft Du = 0.50 ft

Ds = 5.50 ft

TOTAL VOLUME PROVIDED: = 350 + 438 = 788 CU. FT. > 733.01 CU. FT. (REQUIRED)

 $V = 40/[(1.00 \times 10^{-4})(1.50 \times 5) + [(2(1.50 \times 0.50)) - (0.50)(0.50) + 2(1.50)(5.50))]$

+ 1.39x10-4(5.00)(0.50) = 438 CU. FT.

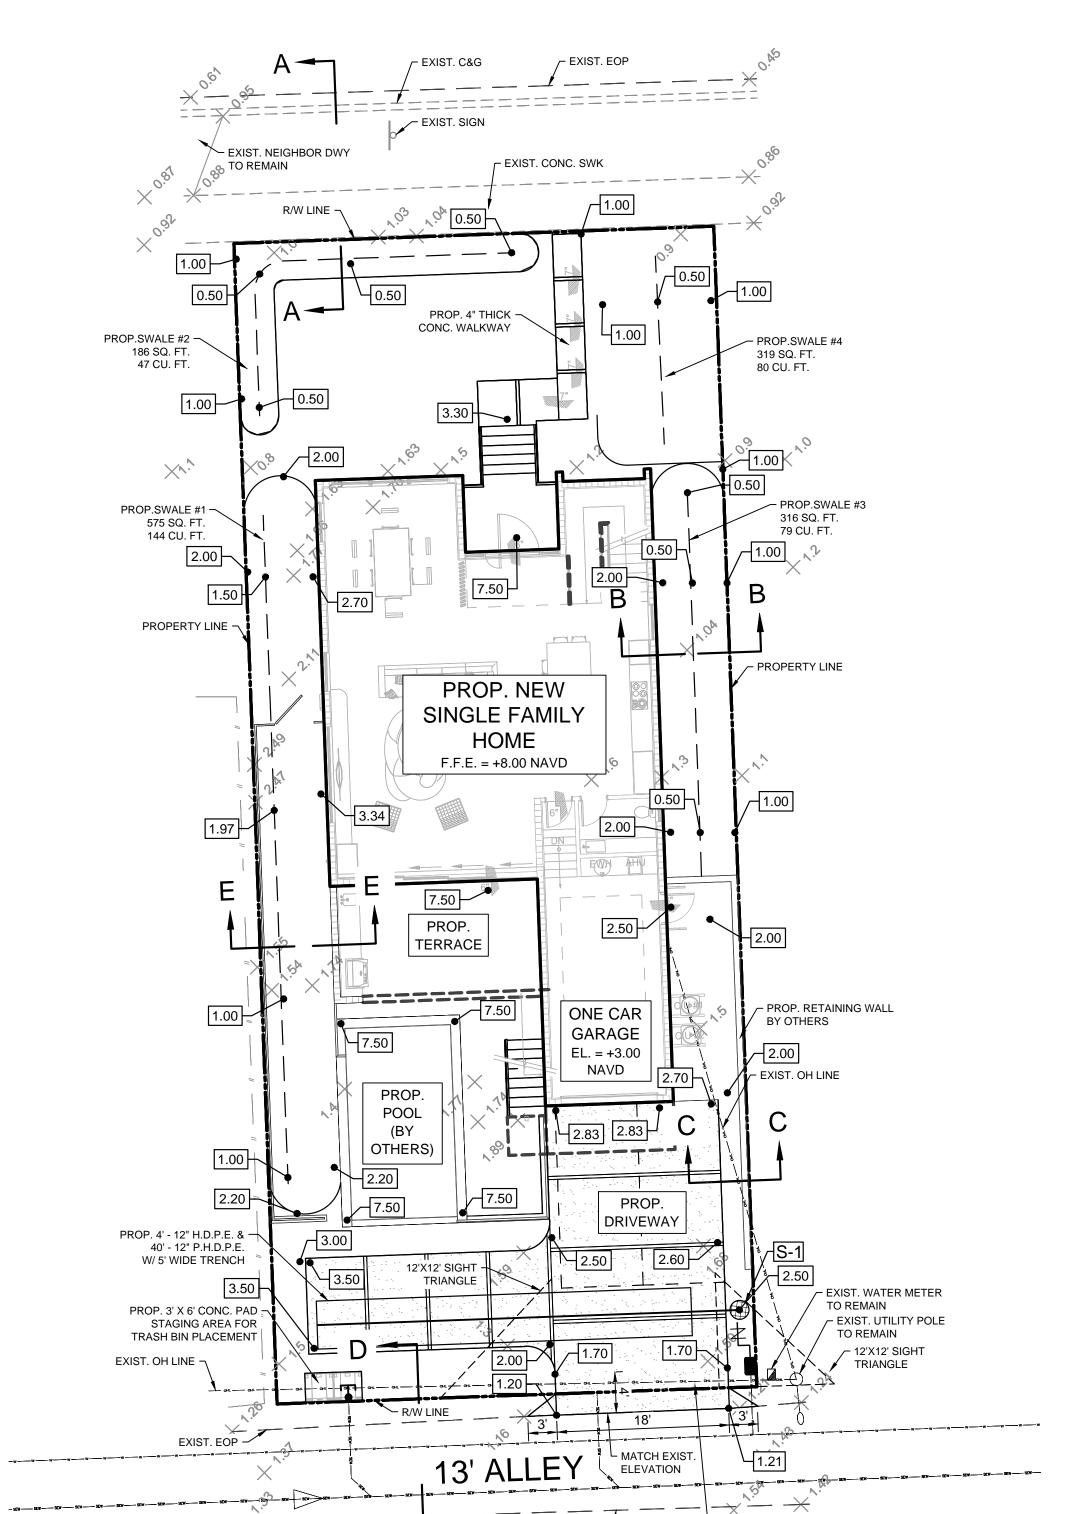

EXIST. EOP -

PROP. CONC. DRIVEWAY

LEGEND:



DRAINAGE STRUCTURE SCHEDULE

INLET NO.	TYPE	RIM	INVERT
S-1	12" YARD DRAIN	2.50	0.83

NOT

EXISTING ELECTRICAL OVERHEAD WIRES SHALL BE ROUTED UNDERGROUND FOR THE PROPOSED RESIDENCE.

SUAREZ ENGINEERING
& SURVEYING, INC
13350 SW 131ST STREET
SUITE 103
MIAMI, FL 33186
Tel: 305.596.1799

CERTIFICATE OF AUTHORIZATION LIC. NO.: 34996

908 TYLER STREET PAVING, GRADING

CLIENT: RALPH TAIT ARCHITECT, INC.


PROJECT NAME: NEW SINGLE FAMILY HOME

PROJECT ADDRESS: 908 TYLER STREET, HOLLYWOOD, FLORIDA 33019

PROJECT NUMBER: 25-63-02

REVISIONS

DATE BY DESCRIPTION

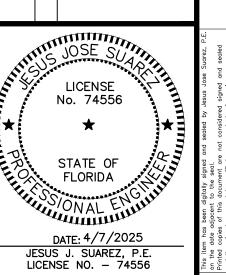



DATE: 4/7/2025
SCALE: AS SHOWN
DESIGNED BY: J.S.
DRAWN BY: J.S.S.
CHECKED BY: J.S.
FILE:
JOB No. 25-63-02

DD_1


SHEET NO.

Z:\Engineering\Projects\2025\63-Ralph Tait\256302—Tyler Street\CIVIL\CADD\PlanSheets\256302—PD-1_PDPLN.dwg Apr 07, 2025 — 11:09a

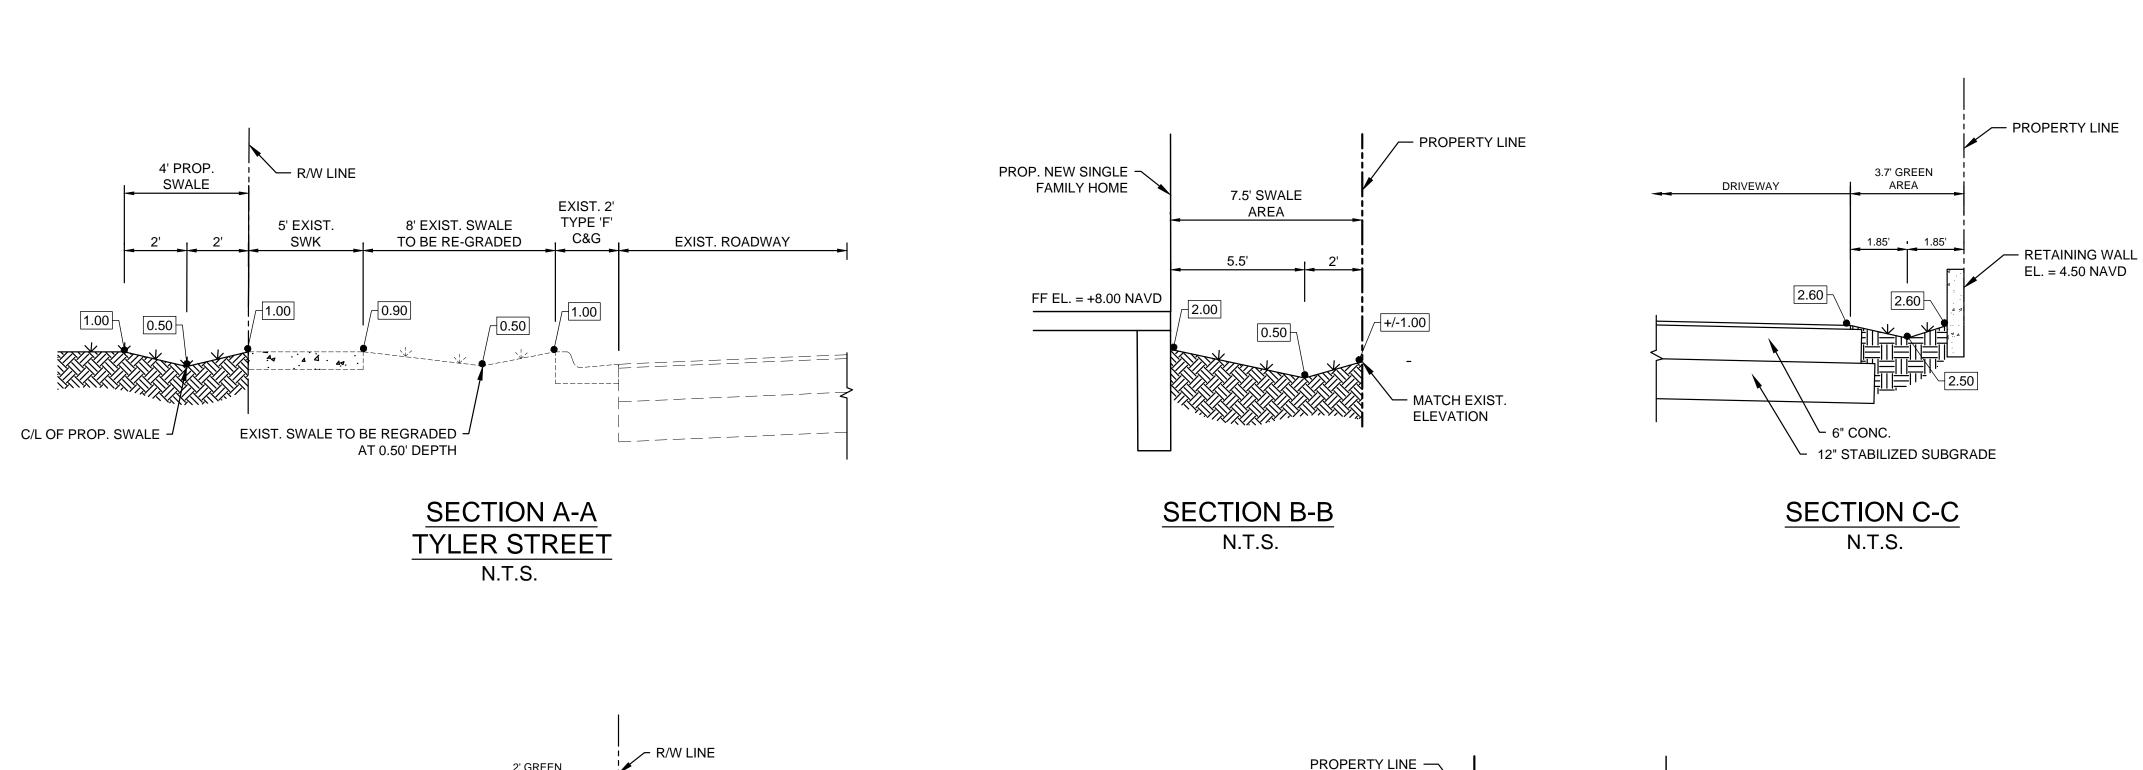


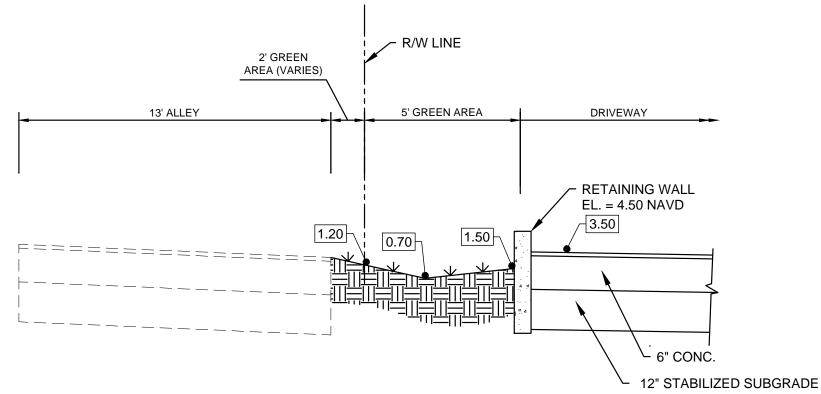


 $\frac{\text{SECTION D-D}}{\text{N.T.S.}}$

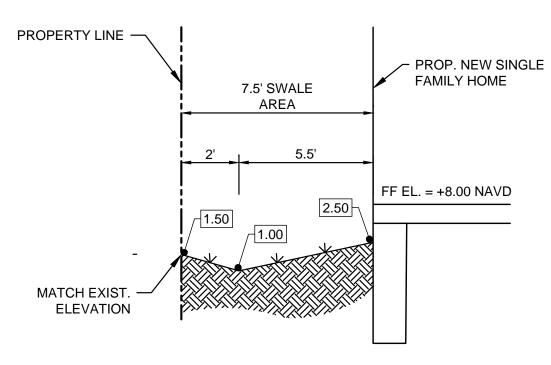

SECTION E-E

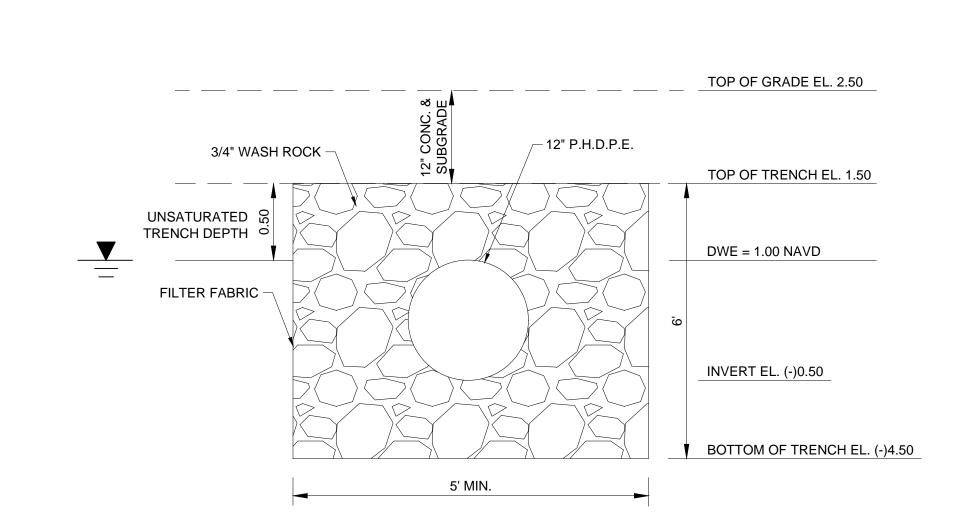

EXFILTRATION TRENCH DETAIL N.T.S.

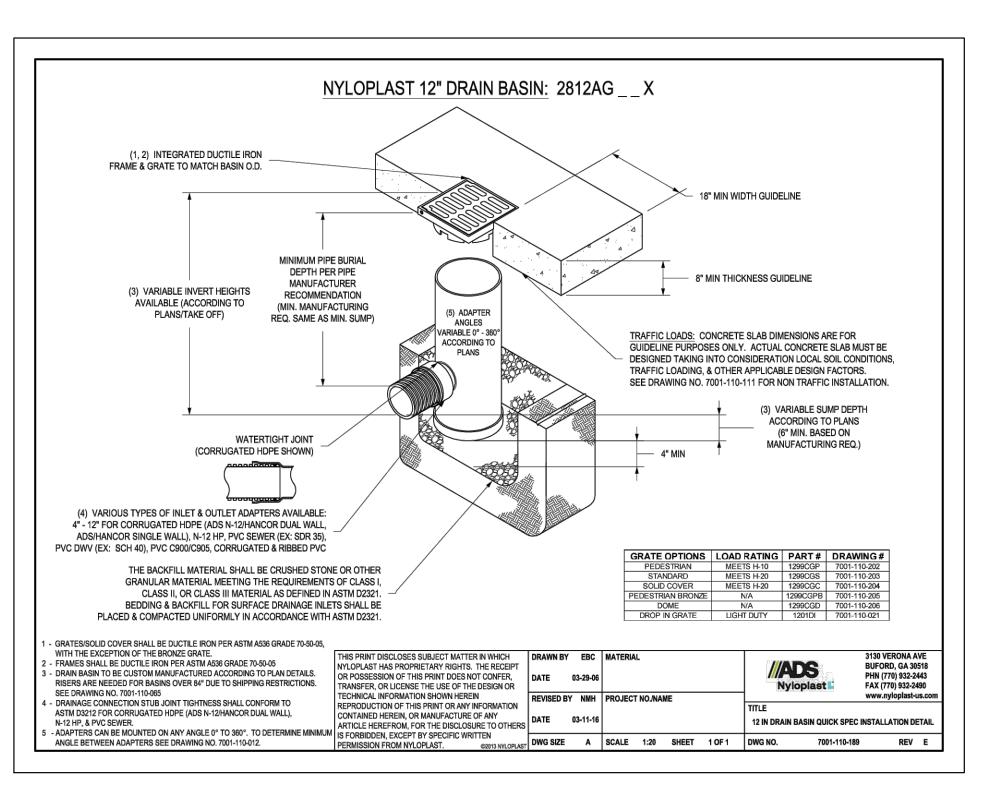

YARD DRAIN DETAIL

N.T.S.



& SURVEYING, INC
13350 SW 131ST STREET
SUITE 103
MIAMI, FL 33186
Tel: 305.596.1799
CERTIFICATE OF AUTHORIZATION
LIC. NO.: 34996

908 TYLER STREET
PAVING, GRADING & DRAINAGE


CLIENT:
RALPH TAIT ARCHITECT, INC.

PROJECT NAME:
NEW SINGLE FAMILY HOME

PROJECT ADDRESS: 908 TYLER STREET, HOLLYWOOD, FLORIDA 33019

PROJECT NUMBER: 25-63-02

REVISIONS					
BY	DESCRIPTION				

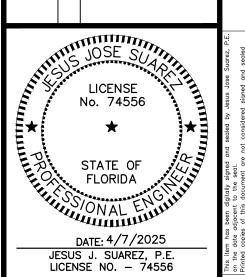

DATE: 4/7/2025
SCALE: AS SHOWN
DESIGNED BY: J.S.
DRAWN BY: J.S.S.
CHECKED BY: J.S.
FILE:
JOB No. 25-63-02

SHEET NO.


PD-2

POST & FILTER FABRIC INSTALLATION DETAIL


N.T.S.

SILT FENCE & POST INSTALLATION NOTES


- 1. THE HEIGHT OF THE SILT FENCE SHALL BE INSTALLED AT A MINIMUM OF 24 INCHES BUT SHALL NOT EXCEED 36 INCHES.
- 2. THE FILTER FABRIC MATERIAL SHALL BE PURCHASED IN A CONTINUOUS ROLL IN ORDER TO BE ABLE TO CUT THE ENTIRE REQUIRED LENGTH IN ONE PIECE AND AVOID THE USE OF JOINTS.
- 3. WHEN STANDARD STRENGTH FILTER FABRIC MATERIAL IS USED, A WELDED WIRE MESH SUPPORT SHALL BE FASTENED SECURELY TO THE UP SLOPE SIDE OF THE FENCE POSTS BY USING EITHER HEAVY DUTY WIRE STAPLES AT LEAST 1 INCH LONG, TIE WIRES OR HOG RINGS. THE WIRE SHALL EXTEND INTO THE TRENCH A MINIMUM OF 2 INCHES AND SHALL NOT EXTEND MORE THAN 36 INCHES ABOVE THE ORIGINAL GROUND SURFACE.
- 4. THE FILTER FABRIC MATERIAL SHALL BE EITHER STAPLED OR WIRED TO THE FENCE POSTS AND 12 INCHES OF THE FABRIC SHALL BE EXTENDED AT THE BOTTOM INTO THE TRENCH. THE FABRIC SHALL NOT EXTEND MORE THAN 36 INCHES ABOVE THE GROUND SURFACE.
- 5. A 6"X6" TRENCH SHALL BE CONSTRUED ALONG THE BOTTOM OF THE ENTIRE LINE OF FENCE POSTS AND UP SLOPE FROM THE BARRIER IN ORDER TO BURY THE BOTTOM 12 INCHES OF THE FILTER FABRIC MATERIAL. THE TRENCH SHALL BE BACK FILLED AND THE SOIL COMPACTED OVER THE FILTER FABRIC.
- 6. THE FENCE POSTS SHALL BE INSTALLED AT A MAXIMUM OF 10 FEET APART AND DRIVEN SECURELY INTO THE GROUND FOR A MINIMUM OF 12 INCHES WHEN THE FILTER FABRIC IS USED WITHOUT WIRE MESH SUPPORT. IF WIRE SUPPORT IS USED THEN THE FENCE POSTS SHALL BE SPACED AT A MAXIMUM OF 6 FEET APART.
- 7. WHEN INSTALLING TWO SILT FENCES AROUND THE PERIMETER, PLACE THE POSTS OF THE SECOND FENCE INSIDE THE POSTS OF THE FIRST FENCE. ROTATE BOTH FENCE POSTS AT A CLOCKWISE DIRECTION IN ORDER TO CREATE A TIGHT SEAL. FOLLOW ALL OTHER STANDARD INSTALLATION REQUIREMENTS.

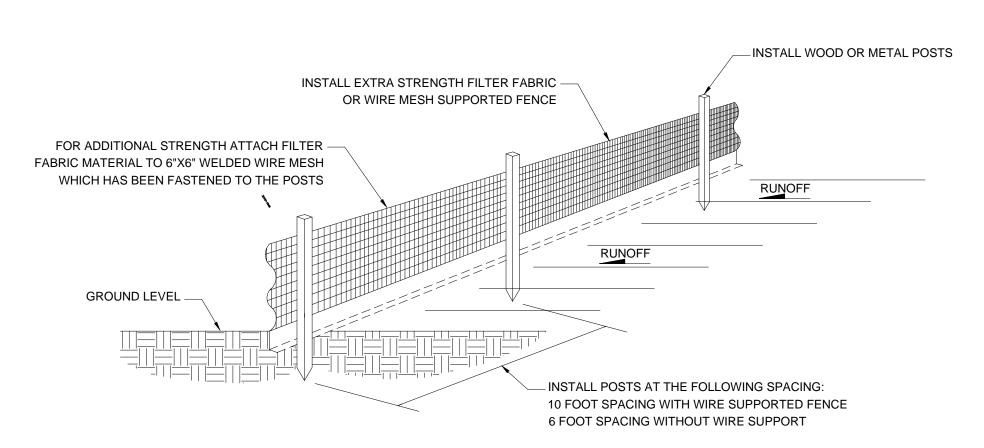

SILT FENCE INSTALLATION DETAIL

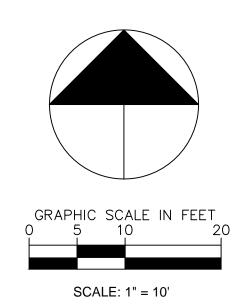


TYLER STREET

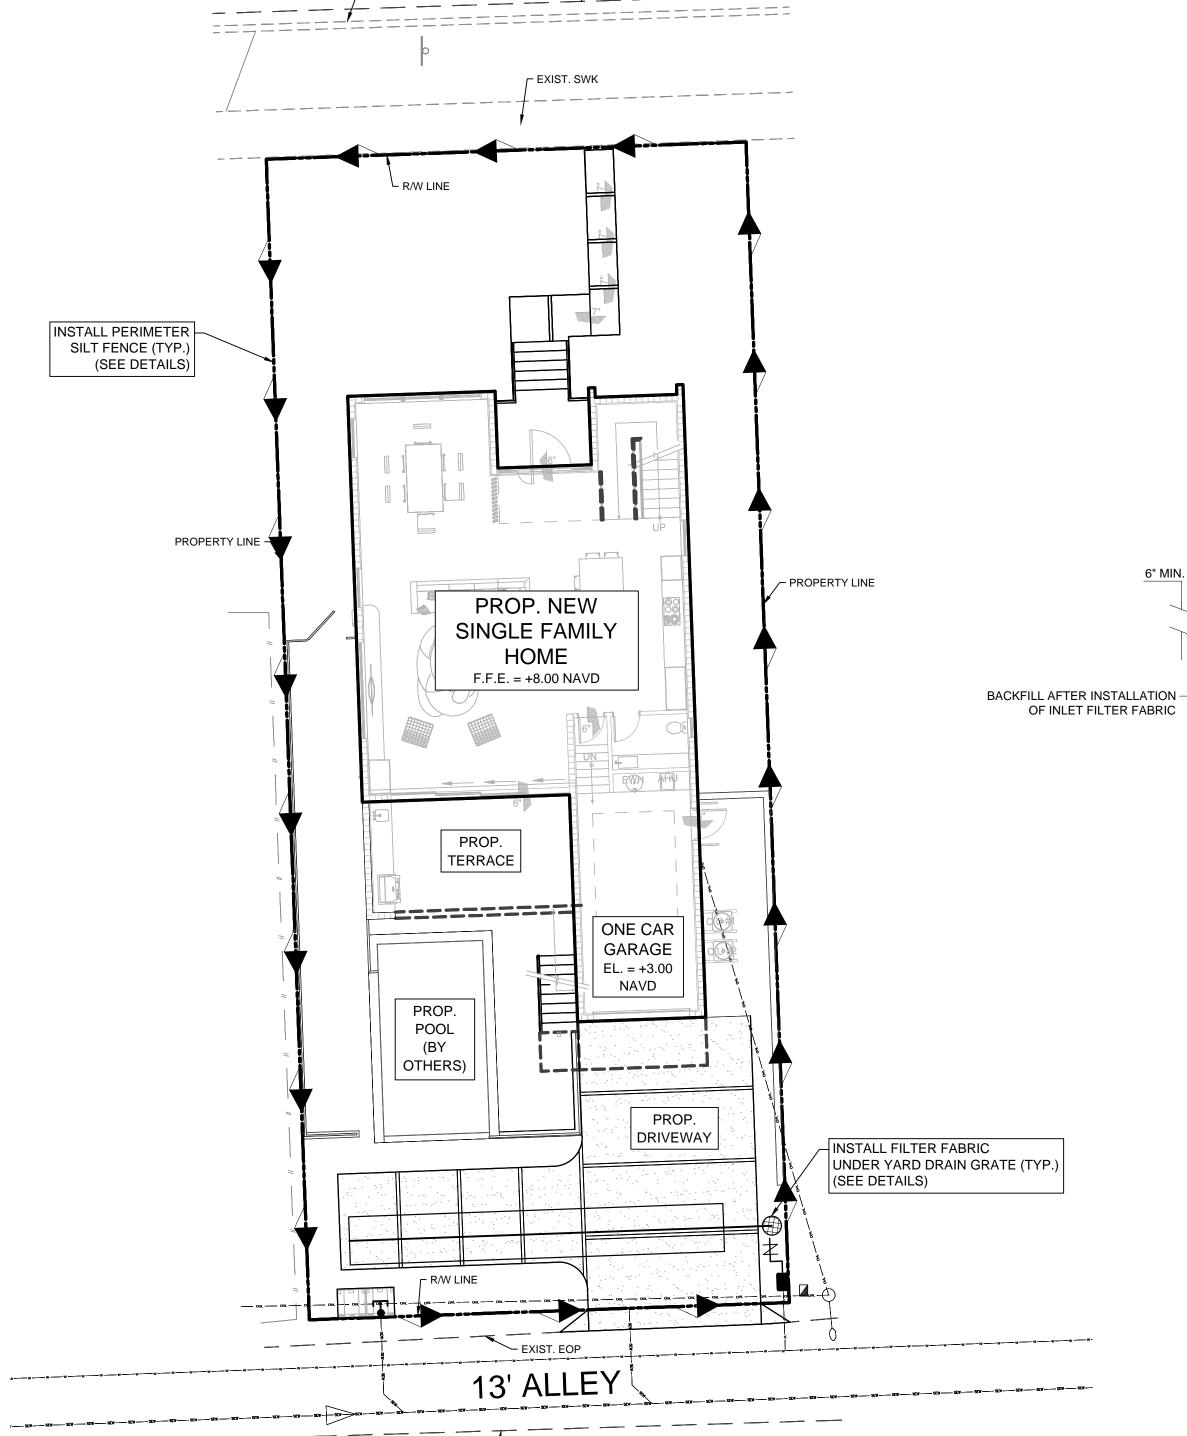

EXIST. EOP -

GENERAL EROSION AND TURBIDITY CONTROL NOTES

- ALL EROSION AND TURBIDITY CONTROL DEVICES AND TEMPORARY BARRIERS SHALL BE INSTALLED WITHIN THE LIMITS OF THE CONSTRUCTION AREA PRIOR TO ANY CONSTRUCTION ACTIVITIES COMMENCING.
- 2. A TEMPORARY BARRIER SHALL BE INSTALLED AROUND ALL WETLAND AND/OR NATURAL PRESERVATION AREAS PRIOR TO ANY CONSTRUCTION ACTIVITIES COMMENCING. NO CONSTRUCTION VEHICLES SHALL ENCROACH WITHIN THESE AREAS.
- 3. CONTRACTOR SHALL HAVE ALL EXISTING UNDERGROUND UTILITIES LOCATED BY APPROPRIATE AGENCIES PRIOR TO INSTALLATION OF ANY EROSION AND TURBIDITY CONTROL DEVICES AND BARRIERS.
- 4. DURING CONSTRUCTION ACTIVITIES, EXISTING PERIMETER NATIVE VEGETATION SHALL REMAIN IN ORDER TO ACT AS A BUFFER BETWEEN ADJACENT PROPERTIES, AND TO MINIMIZE NUISANCE DUST, NOISE, AND/OR AIR POLLUTION.
- 5. PRACTICES SUCH AS SEEDING, MULCHING AND WETTING WHICH MINIMIZE AIRBORNE DUST AND PARTICULATE EMISSIONS GENERATED DURING CONSTRUCTION ACTIVITIES SHALL BE USED AS DIRECTED BY BOTH THE ENGINEER-OF-RECORD AND/OR APPLICABLE GOVERNMENTAL AGENCIES.
- 6. ALL AREAS DISTRIBUTED DURING CONSTRUCTION ACTIVITIES, WHICH ARE NOT GOING TO BE PAVED OR LANDSCAPED, SHALL BE SEEDED AND MULCHED.

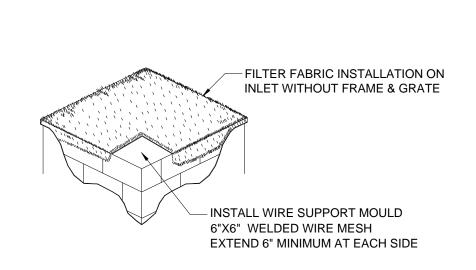

FILTER FABRIC INSTALLATION DETAIL

N.T.S

FILTER FABRIC INSTALLATION NOTES

SECURE FILTER FABRIC

TO FRAME & GRATE

- CONTRACTOR SHALL CLEAN OUT DRAINAGE INLET AND FILTER FABRIC AFTER EVERY STORM EVENT OR AS NEEDED.
- 2. CONTRACTOR SHALL REPAIR AND/OR REPLACE ALL DAMAGED FILTER FABRIC WITHIN INLETS DURING CONSTRUCTION OPERATIONS.
- CONTRACTOR SHALL REMOVE FILTER FABRIC FROM DRAINAGE INLETS PRIOR TO STARTING FINAL PAVING OPERATIONS.

SUAREZ ENGINEERING & SURVEYING, INC 13350 SW 131ST STREET SUITE 103 MIAMI, FL 33186 Tel: 305.596.1799

CERTIFICATE OF AUTHORIZATION LIC. NO.: 34996

308 TYLER STREET STORMWATER POLLUTION PREVENTION PLAN &


CLIENT: RALPH TAIT ARCHITECT, INC.

PROJECT NAME:
NEW SINGLE FAMILY HOME

PROJECT ADDRESS: 908 TYLER STREET, HOLLYWOOD, FLORIDA 33019

PROJECT NUMBER:

REVISIONS					
DATE	BY	DESCRIPTION			

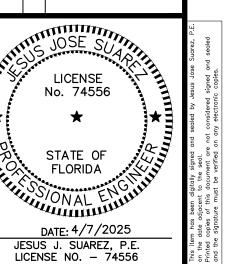


DATE: 4/7/2025
SCALE: AS SHOWN
DESIGNED BY: J.S.
DRAWN BY: J.S.S.
CHECKED BY: J.S.
FILE:
JOB No. 25-63-02


SWPP-1

SHEET NO.

Z:\Engineering\Projects\2025\63-Ralph Tait\256302—Tyler Street\CIVIL\CADD\PlanSheets\256302—SWPP—1_SWPPP.dwg Apr 07, 2025

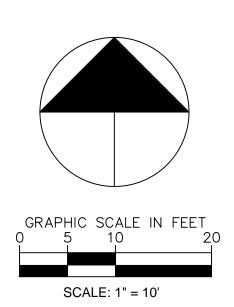



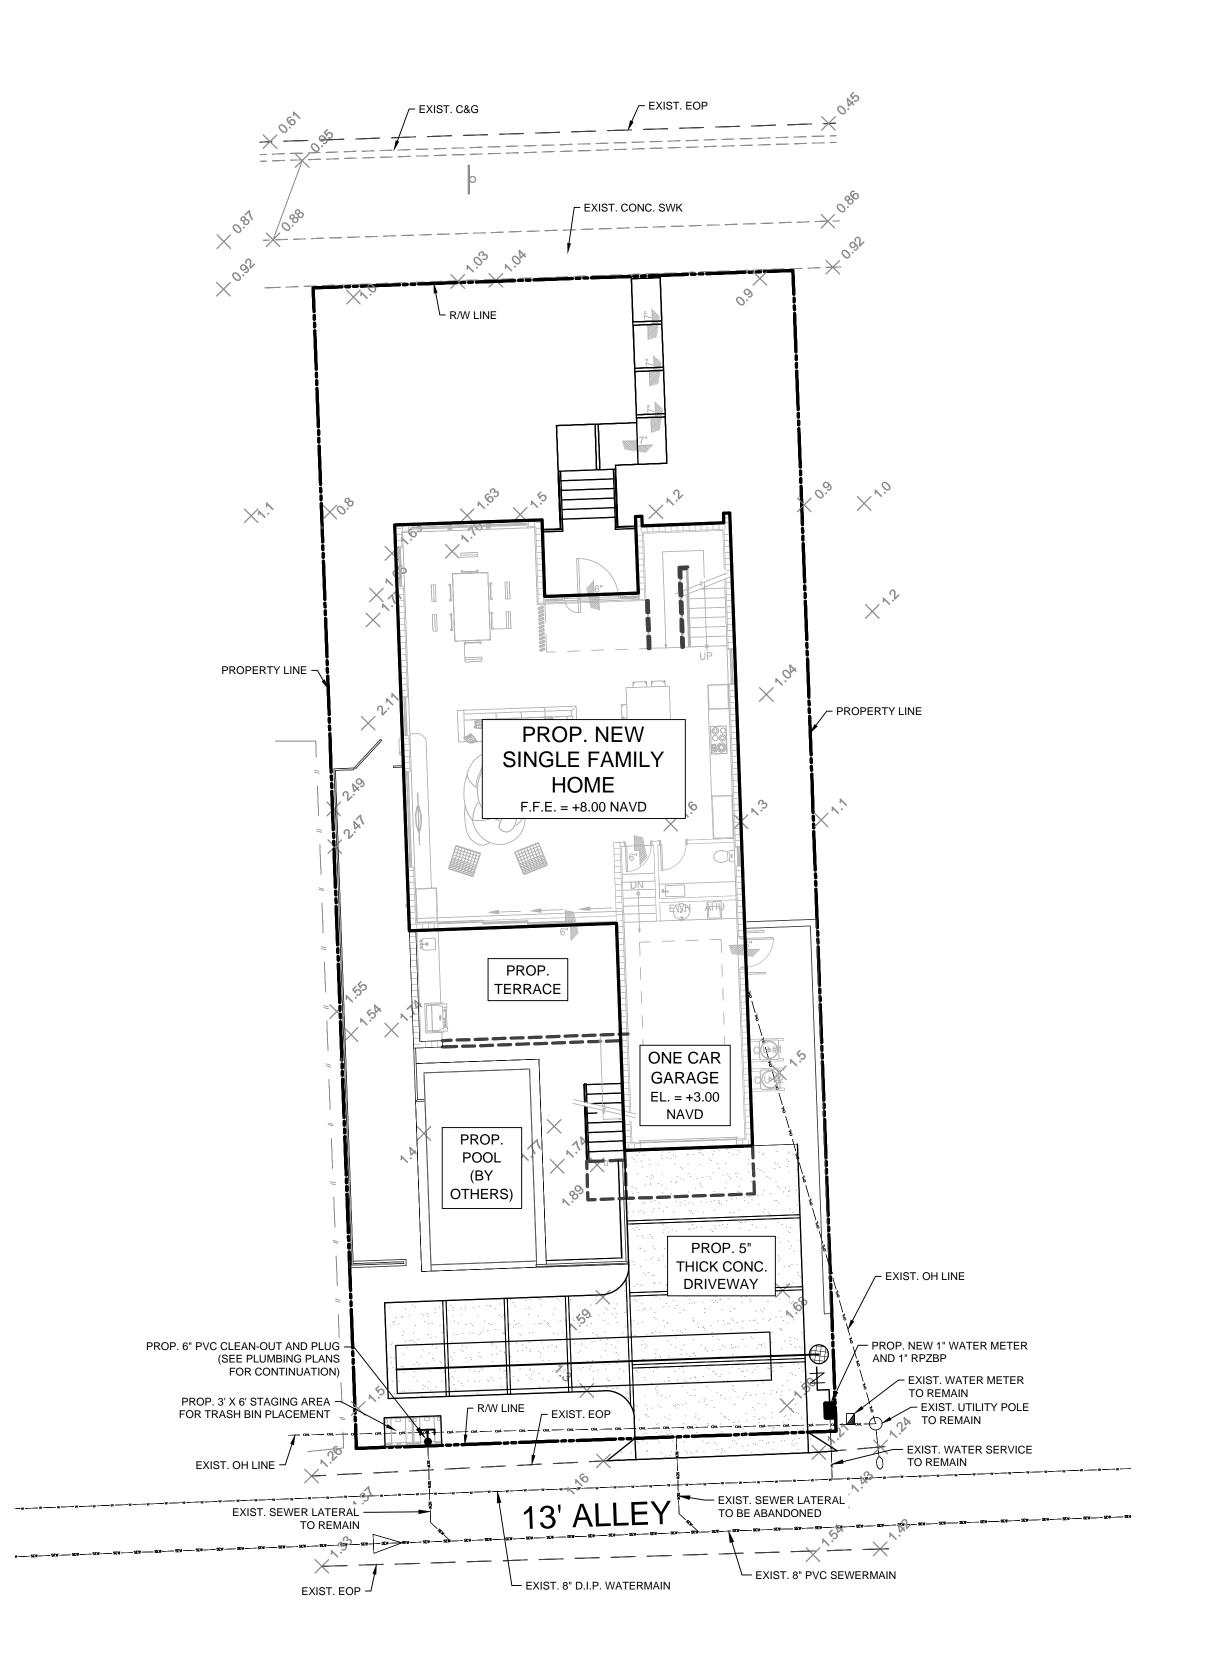

NOTE: EXISTING ELECTRICAL OVERHEAD WIRES SHALL BE ROUTED UNDERGROUND FOR THE PROPOSED RESIDENCE. SUAREZ ENGINEERING & SURVEYING, INC 13350 SW 131ST STREET SUITE 103 MIAMI, FL 33186

Tel: 305.596.1799 CERTIFICATE OF AUTHORIZATION LIC. NO.: 34996

> TRE SEWER 806


<u>CLIENT:</u> RALPH TAIT ARCHITECT, INC.

PROJECT NAME: NEW SINGLE FAMILY HOME

PROJECT ADDRESS: 908 TYLER STREET, HOLLYWOOD, FLORIDA 33019

PROJECT NUMBER: 25-63-02

REVISIONS						
DATE	BY	DESCRIPTION				

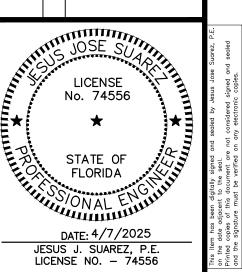

DATE: 4/7/2025 SCALE: AS SHOWN DESIGNED BY: J.S. DRAWN BY: J.S.S. CHECKED BY: J.S. JOB No. 25-63-02

SHEET NO.

GENERAL NOTES:

- THE INFORMATION PROVIDED IN THESE DRAWINGS IS SOLELY TO ASSIST THE CONTRACTOR IN ASSESSING
 THE NATURE AND EXTENT OF CONDITIONS WHICH WILL BE ENCOUNTERED DURING THE COURSE OF THE
 WORK. THE CONTRACTORS ARE DIRECTED, PRIOR TO BIDDING, TO CONDUCT WHATEVER INVESTIGATIONS
 THEY DEEM NECESSARY TO ARRIVE AT THEIR OWN CONCLUSION REGARDING THE ACTUAL CONDITIONS
 THAT WILL BE ENCOUNTERED, AND UPON WHICH BIDS WILL BE BASED.
- ALL CONSTRUCTION AND MATERIALS SHALL CONFORM TO APPLICABLE STANDARDS AND SPECIFICATIONS
 OF THE CITY OF HOLLYWOOD DEPARTMENT OF PUBLIC UTILITIES, ENGINEERING AND CONSTRUCTION
 SERVICES DIVISION (ECSD), AND ALL OTHER LOCAL, STATE AND NATIONAL CODES, WHERE APPLICABLE.
- LOCATIONS, ELEVATIONS, SIZES, MATERIALS, ALIGNMENTS, AND DIMENSIONS OF EXISTING FACILITIES, UTILITIES AND OTHER FEATURES ARE SHOWN ACCORDING TO THE BEST INFORMATION AVAILABLE AT THE TIME OF THE PREPARATION OF THESE PLANS; AND DO NOT PURPORT TO BE ABSOLUTELY CORRECT. ALSO, THERE MAY HAVE BEEN OTHER IMPROVEMENTS, UTILITIES, ETC., WITHIN THE PROJECT AREA WHICH WERE CONSTRUCTED AFTER THE PREPARATION OF THESE PLANS AND/OR THE ORIGINAL SITE SURVEY. THE CONTRACTOR SHALL VERIFY THE LOCATIONS, ELEVATIONS, AND OTHER FEATURES AFFECTING HIS/HER WORK PRIOR TO CONSTRUCTION, AND NOTIFY THE ENGINEER IMMEDIATELY WHEN CONFLICT BETWEEN DRAWINGS AND ACTUAL CONDITIONS ARE DISCOVERED. THE ENGINEER ASSUMES NO RESPONSIBILITY FOR ANY FACILITIES SHOWN OR NOT SHOWN ON THE PLANS. THE CONTRACTOR SHALL WORK AS NEEDED TO AVOID CONFLICT WITH EXISTING UTILITIES (NO ADDITIONAL COST SHALL BE PAID FOR THIS WORK). EXISTING UTILITIES SHALL BE MAINTAINED IN SERVICE DURING CONSTRUCTION UNLESS OTHERWISE APPROVED BY THE RESPECTIVE UTILITY OWNER.
- 4. THE CONTRACTOR SHALL COORDINATE WITH ALL UTILITIES TO ARRANGE FOR THE RELOCATION AND TEMPORARY SUPPORT OF UTILITY FEATURES, ETC. AS NECESSARY TO COMPLETE THE WORK.
- IT SHALL BE THE CONTRACTOR'S RESPONSIBILITY TO LOCATE AND PROTECT ANY AND ALL EXISTING
 UTILITIES ON THIS PROJECT, AND TO ENSURE THAT EXISTING UTILITIES ARE MAINTAINED IN SERVICE
 DURING CONSTRUCTION UNLESS APPROVED OTHERWISE BY THE UTILITY OWNER.
- 6. CONTRACTOR SHALL ADJUST ALL EXISTING UTILITY CASTINGS INCLUDING VALVE BOXES, MANHOLES, HAND-HOLES, PULL-BOXES, STORMWATER INLETS, AND SIMILAR STRUCTURES IN CONSTRUCTION AREA TO BE OVERLAID WITH ASPHALT PAVEMENT.
- THE CONTRACTOR IS REQUIRED TO OBTAIN ALL APPLICABLE CONSTRUCTION AND ENVIRONMENTAL PERMITS PRIOR TO THE START OF CONSTRUCTION.
- 8. THE CONTRACTOR SHALL NOTIFY ECSD AT LEAST 48 HOURS PRIOR TO BEGINNING CONSTRUCTION.
- 9. PRIOR TO THE COMMENCEMENT OF CONSTRUCTION AND INSTALLATION OF THE PROPOSED IMPROVEMENTS, SHOP DRAWINGS SHALL BE SUBMITTED TO ECSD IN ACCORDANCE WITH THE CONTRACT DOCUMENT'S REQUIREMENTS, FOR APPROVAL. IN ADDITION, IT IS THE CONTRACTOR'S RESPONSIBILITY TO OBTAIN ANY OTHER AGENCY SHOP DRAWING APPROVAL, IF REQUIRED.
- 10. THE CONTRACTOR SHALL NOTIFY ECSD IMMEDIATELY FOR ANY CONFLICT ARISING DURING CONSTRUCTION OF ANY IMPROVEMENTS SHOWN ON THESE DRAWINGS. THIS WORK BY THE CONTRACTOR SHALL BE CONSIDERED INCIDENTAL TO THE CONTRACT AND NO ADDITIONAL COMPENSATION SHALL BE ALLOWED.
- 11. ELEVATIONS SHOWN ARE IN FEET AND ARE REFERENCED TO THE NORTH AMERICAN VERTICAL DATUM OF 1988 (NAVD 88).

ISSUED: 0	03/01/1994	DEPARTMENT OF PUBLIC UTILITIES STANDARD DETAIL	REVISED: 06/08/2014	
	DRAWN:	EAM	CENEDAL NOTES	DRAWING NO.
GOLD COAST	APPROVE	D: XXX	GENERAL NOTES	G-00

GENERAL NOTES (CONTINUED):

- 12. CITY OF HOLLYWOOD SHALL NOT PROVIDE STAGING / STORAGE AREA. CONTRACTOR SHALL SECURE STAGING / STORAGE AREA AS NECESSARY FOR CONSTRUCTION WORK.
- 13. CONTRACTOR SHALL HAUL AWAY EXCESSIVE STOCKPILE OF SOIL FOR DISPOSAL EVERY DAY. NO STOCKPILE SOIL IS ALLOWED TO BE LEFT ON THE CONSTRUCTION SITE OVER NIGHT.
- 14. CONTRACTOR SHALL CLEAN / SWEEP THE ROAD AT LEAST ONCE DAY OR AS REQUIRED BY THE ENGINEER.
- 15. CONTRACTOR SHALL PROTECT CATCH BASINS WITHIN / ADJACENT TO THE CONSTRUCTION SITE AS REQUIRED BY NPDES REGULATIONS.
- 16. THE CITY OF HOLLYWOOD HAS A NOISE ORDINANCE (CHAPTER 100) WHICH PROHIBITS EXCAVATION AND CONSTRUCTION BEFORE 8:00 A.M. AND AFTER 6:00 P.M., MONDAY THROUGH SATURDAY AND ALL DAY SUNDAY.
- 17. SUITABLE EXCAVATED MATERIAL SHALL BE USED IN FILL AREAS. NO SEPARATE PAY ITEM FOR THIS WORK, INCLUDE COST IN OTHER ITEMS.
- 18. ALL ROAD CROSSINGS ARE OPEN CUT AS PER THE REQUIREMENTS OF THE ECSD UNLESS OTHERWISE NOTED ON THE DRAWINGS.
- 19. THE CONTRACTOR SHALL REPLACE ALL PAVING, STABILIZING EARTH, DRIVEWAYS, PARKING LOTS, SIDEWALKS, ETC. TO SATISFY THE INSTALLATION OF THE PROPOSED IMPROVEMENTS WITH THE SAME TYPE OF MATERIAL THAT WAS REMOVED DURING CONSTRUCTION OR AS DIRECTED BY ECSD FIELD
- 20. THE CONTRACTOR SHALL NOT ENCROACH INTO PRIVATE PROPERTY WITH PERSONNEL, MATERIAL OR EQUIPMENT. IN CASE WORK ON PRIVATE PROPERTY IS NEEDED, A CITY OF HOLLYWOOD "RIGHT OF ENTRY" FORM MUST BE SIGNED BY PROPERTY OWNER AND THE DIRECTOR OF PUBLIC UTILITIES. THE CONTRACTOR IS RESPONSIBLE TO MAINTAIN ACCESS AT ALL TIMES TO PRIVATE HOMES/BUSINESSES.
- 21. THE CONTRACTOR SHALL BE RESPONSIBLE FOR DAMAGE, REMOVAL OR MODIFICATION, CAUSED TO ANY IRRIGATION SYSTEM (PRIVATE OR PUBLIC) ACCIDENTALLY OR PURPOSELY. THE CONTRACTOR SHALL REPLACE ANY DAMAGED, REMOVED OR MODIFIED IRRIGATION PIPES, SPRINKLER HEADS OR OTHER PERTINENT APPURTENANCES TO MATCH OR EXCEED EXISTING CONDITIONS AT NO ADDITIONAL COST TO
- 22. MAIL BOXES, FENCES OR OTHER PRIVATE PROPERTY DAMAGED DURING THE CONSTRUCTION OF THE PROPOSED IMPROVEMENTS SHALL BE REPLACED TO MATCH OR EXCEED EXISTING CONDITION.
- 23. CONTRACTOR SHALL PROVIDE MAINTENANCE OF TRAFFIC IN ACCORDANCE WITH FDOT STANDARDS AND CITY OF HOLLYWOOD DEPARTMENT OF PUBLIC UTILITIES STANDARDS.
- 24. NO TREES ARE TO BE REMOVED OR RELOCATED WITHOUT PRIOR APPROVAL FROM THE ECSD FIELD ENGINEER.
- 25. THE CONTRACTOR IS RESPONSIBLE FOR OBTAINING THE NECESSARY TREE REMOVAL OR RELOCATION PERMITS FROM THE CITY OF HOLLYWOOD BUILDING DEPARTMENT FOR TREES LOCATED IN THE PUBLIC PLOT WAY.
- 26. IT IS THE INTENT OF THESE PLANS TO BE IN ACCORDANCE WITH APPLICABLE CODES AND AUTHORITIES HAVING JURISDICTION. ANY DISCREPANCIES BETWEEN THESE PLANS AND APPLICABLE REGULATORY STANDARDS / REQUIREMENTS SHALL BE IMMEDIATELY BROUGHT TO THE ATTENTION OF ECSD.

OS/01/19	94	DEPARTMENT OF PUBLIC UTILITIES STANDARD DETAIL	REVISED: 11/06/2017
DRAWN: E	ΔM	GENERAL NOTES	DRAWING NO.
APPROVED: X	XX	(CONTINUED)	G-00.1

GENERAL NOTES (CONTINUED):

- 27. THE CONTRACTOR SHALL BE RESPONSIBLE FOR MAINTAINING THE INTEGRITY OF AND MAKING THE REPAIRS TO EXISTING PAVEMENT, SIDEWALKS, PIPES, CONDUITS, CURBS, CABLES, ETC., WHETHER OR NOT SHOWN ON THE PLANS DAMAGED AS A RESULT OF THE CONTRACTORS OPERATIONS AND/OR THOSE OF HIS SUBCONTRACTORS, AND SHALL RESTORE THEM PROMPTLY AT NO ADDITIONAL EXPENSE TO THE OWNER. CONTRACTOR SHALL REPORT ANY DAMAGE TO SIDEWALK, DRIVEWAY, ETC., PRIOR TO BEGINNING WORK IN ANY AREA.
- 28. WHERE NEW PAVEMENT MEETS EXISTING, CONNECTION SHALL BE MADE IN A NEAT STRAIGHT LINE AND FLUSH WITH EXISTING PAVEMENT TO MATCH EXISTING CONDITIONS.
- 29. UNDER NO CIRCUMSTANCES SHALL THE CONTRACTOR LEAVE EXCAVATED TRENCHES, OR PARTS OF, EXPOSED OR OPENED AT THE END OF THE WORKING DAY, WEEKENDS, HOLIDAYS OR OTHER TIMES, WHEN THE CONTRACTOR IS NOT WORKING, UNLESS OTHERWISE DIRECTED. ALL TRENCHES SHALL BE COVERED, FIRMLY SECURED AND MARKED ACCORDINGLY FOR PEDESTRIAN / VEHICULAR TRAFFIC.
- THE CONTRACTOR AT THE CONTRACTOR'S EXPENSE.

30. ALL EXCAVATED MATERIAL REMOVED FROM THIS PROJECT SHALL BE DISPOSED OF OFF THE PROPERTY BY

- 31. ALL DUCTILE IRON PRODUCTS SHALL BE DOMESTIC MADE HEAVY DUTY CLASSIFICATION SUITABLE FOR HIGHWAY TRAFFIC LOADS, OR 20,000 LB.
- 32. ALL GRASSED AREAS AFFECTED BY CONSTRUCTION SHALL BE RE-SODDED.
- 33. THE CONTRACTOR SHALL BE RESPONSIBLE FOR THE PROVISION, INSTALLATION AND MAINTENANCE OF ALL TRAFFIC CONTROL AND SAFETY DEVICES, IN ACCORDANCE WITH SPECIFICATIONS OF THE LATEST REVISION OF FDOT DESIGN STANDARDS. IN ADDITION, THE CONTRACTOR IS RESPONSIBLE FOR THE RESETTING OF ALL TRAFFIC CONTROL AND INFORMATION SIGNAGE REMOVED DURING THE CONSTRUCTION PERIOD.
- 34. EXCAVATED OR OTHER MATERIAL STORED ADJACENT TO OR PARTIALLY UPON A ROADWAY PAVEMENT SHALL BE ADEQUATELY MARKED FOR TRAFFIC SAFETY AT ALL TIMES.
- 35. TEMPORARY PATCH MATERIAL MUST BE ON THE JOB SITE WHENEVER PAVEMENT IS CUT, OR THE CITY'S INSPECTOR WILL SHUT THE JOB DOWN.
- 36. CONTRACTOR MUST PROVIDE FLASHER ARROW SIGNAL FOR ANY LANE THAT IS CLOSED OR DIVERTED.
- CONTRACTOR SHALL NOTIFY LAW ENFORCEMENT AND FIRE PROTECTION SERVICES TWENTY-FOUR (24)
 HOURS IN ADVANCE OF TRAFFIC DETOUR IN ACCORDANCE WITH SECTION 336.07 OF FLORIDA STATUTES.
- 38. CONTRACTOR TO RESTORE PAVEMENT TO ORIGINAL CONDITION AS REQUIRED.
- CONTRACTOR SHALL BE RESPONSIBLE FOR PROVIDING DEWATERING PER SPECIFICATION SECTION 02140 DEWATERING.

OF HOLLYWOOD ATO	ISSUED:	03/01/1994	DEPARTMENT OF PUBLIC UTILITIES STANDARD DETAIL	REVISED:	11/06/2017
P DIAMOND SPINI	DRAWN:	EAM	GLINLKAL NOTES	DRAWING N	
GOLD COAST	APPROVED): XXX	(CONTINUED)	G-0	0.2

GENERAL NOTES (CONTINUED):

40. THE CONTRACTOR SHALL GIVE AT LEAST 48 HOURS NOTICE TO UTILITY COMPANIES TO PROVIDE FOR THE LOCATION OF EXISTING UNDERGROUND UTILITIES IN ADVANCE OF CONSTRUCTION. CONTACT UTILITIES NOTIFICATION CENTER AT 811 OR 1-800-432-4770 (SUNSHINE ONE-CALL OF FLORIDA).



- 41. WHEN PVC PIPE IS USED, A METALLIZED MARKER TAPE SHALL BE INSTALLED CONTINUOUSLY 18"
 ABOVE THE PIPE. THE MARKER TAPE SHOULD BE IMPRINTED WITH A WARNING THAT THERE IS
 BURIED PIPE BELOW. THE TAPE SHALL BE MAGNA TEC, AS MANUFACTURED BY THOR ENTERPRISES
 INC. OR APPROVED EQUAL.
- 42. ALL CONNECTIONS TO EXISTING MAINS SHALL BE THE RESPONSIBILITY OF THE CONTRACTOR. WATER CONNECTIONS SHALL BE METERED, AND THE COST OF WATER AND TEMPORARY METER SHALL BE BORNE BY THE CONTRACTOR.
- 43. A COMPLETE AS-BUILT SURVEY SHALL BE ACCURATELY RECORDED OF THE UTILITY SYSTEM DURING CONSTRUCTION. AS-BUILT SURVEY SHALL BE SUBMITTED TO ECSD SIGNED AND SEALED BY A FLORIDA REGISTERED SURVEYOR PRIOR TO FINAL INSPECTION AND ACCEPTANCE OF PROJECT. THE COST OF SIGNED AND SEALED AS-BUILTS SHALL BE COVERED IN OVERALL BID. THE AS-BUILT SURVEY SHALL INCLUDE:
- a. PLAN VIEW SHOWING THE HORIZONTAL LOCATIONS OF EACH MANHOLE, INLET, VALVE, FITTING, BEND AND HORIZONTAL PIPE DEFLECTIONS WITH COORDINATES AND IN REFERENCE TO A SURVEY BASELINE OR RIGHT-OF-WAY CENTERLINE.
- b. THE PLAN VIEW SHALL ALSO SHOW SPOT ELEVATIONS OF THE TOP OF THE MAIN (WATER MAIN AND FORCE MAIN) OR PIPE INVERTS (GRAVITY MAINS) AT INTERVALS NOT TO EXCEED 100 FEET AS MEASURED ALONG MAIN. THE PLAN VIEW SHALL ALSO INCLUDE SPOT ELEVATIONS AT EACH MANHOLE, INLET, VALVE, FITTING, BEND AND VERTICAL PIPE DEFLECTION.
- c. THE PLAN VIEW SHALL ALSO SHOW THE HORIZONTAL SEPARATION FROM UNDERGROUND UTILITIES IMMEDIATELY ADJACENT OR PARALLEL TO THE NEW MAIN.
- d. PROFILE VIEW WITH SPOT ELEVATIONS OF THE TOP OF THE MAIN (WATER MAIN AND FORCE MAIN) OR PIPE INVERT (GRAVITY MAIN) AND OF THE FINISHED GRADE OR MANHOLE RIM DIRECTLY ABOVE THE MAIN AT INTERVALS NOT TO EXCEED 100 FEET AS MEASURED ALONG THE MAIN. THE PROFILE VIEW SHALL ALSO INCLUDE SPOT ELEVATIONS AT EACH MANHOLE, INLET, VALVE, FITTING, BEND AND VERTICAL PIPE DEFLECTION.
- e. THE PROFILE VIEW SHALL SHOW ALL UNDERGROUND UTILITIES CROSSING THE NEW MAIN AND THE VERTICAL SEPARATION PROVIDED BETWEEN THAT UNDERGROUND UTILITY AND THE NEW MAIN.
- f. ALL CADD FILES MUST BE CREATED FOLLOWING THE CITY OF HOLLYWOOD "SURVEY / AS-BUILT CAD DRAWING STANDARDS"

	DIAMOND DIAMOND	ISSUED:	03/01/1994	DEPARTMENT OF PUBLIC UTILITIES STANDARD DETAIL	REVISED:	11/06/201
		DRAWN:	EAM	GENERAL NOTES	DRAWING	
	TACORPORATEURS	APPROVE	D: XXX	(CONTINUED)	G-0	00.3



SUAREZ ENGINEERING & SURVEYING, INC 13350 SW 131ST STREET SUITE 103 MIAMI, FL 33186 Tel: 305.596.1799

CERTIFICATE OF AUTHORIZATION LIC. NO.: 34996

WATER & SEWER

CLIENT: RALPH TAIT ARCHITECT, INC.


PROJECT NAME:
NEW SINGLE FAMILY HOME

PROJECT ADDRESS: 908 TYLER STREET, HOLLYWOOD, FLORIDA 33019

PROJECT NUMBER:

REVISIONS

DATE BY DESCRIPTION

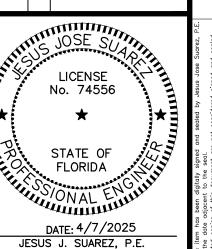

DATE: 4/7/2025
SCALE: AS SHOWN
DESIGNED BY: J.S.
DRAWN BY: J.S.S.
CHECKED BY: J.S.
FILE:
JOB No. 25-63-02


SHEET NO.


WS-2


FLEXIBLE PAVEMENT RESTORATION NOTES:


- THE ABOVE DETAILS APPLY ONLY TO ASPHALT PAVEMENT RESTORATION OVER UTILITY TRENCHES CUT WITHIN CITY OF HOLLYWOOD RIGHTS-OF-WAY. FOR PAVEMENT RESTORATION WITHIN BROWARD COUNTY OR FDOT RIGHTS-OF-WAY REFER TO THE CORRESPONDING DETAILS FOR THOSE AGENCIES.
- LIMEROCK BASE MATERIAL SHALL HAVE A MINIMUM L.B.R. OF 100 AND A MINIMUM CARBONATE CONTENT OF 70%. REPLACED BASE MATERIAL OVER TRENCH SHALL BE A MINIMUM OF 12" THICK".
- 3. LIMEROCK BASE MATERIAL SHALL BE PLACED IN 12" MAXIMUM (LOOSE MEASUREMENT) THICKNESS LAYERS WITH EACH LAYER THOROUGHLY ROLLED OR TAMPED AND COMPACTED TO 100% OF MAXIMUM DENSITY, PER AASHTO T-180, PRIOR TO THE PLACEMENT OF THE SUCCEEDING LAYERS.
- 4. STABILIZED SUBGRADE MATERIAL SHALL BE GRANULAR AND SHALL HAVE A MINIMUM L.B.R. OF 40.
- 5. BACKFILL SHALL BE PLACED AND COMPACTED IN ACCORDANCE WITH THE PIPE LAYING CONDITION TYPICAL SECTIONS IN DETAILS G-02 AND G-03, AND THE SPECIFICATIONS, BUT TESTING WILL BEGIN 12" ABOVE THE INSTALLED FACILITY.
- 6. ALL EDGES AND JOINTS OF EXISTING ASPHALT PAVEMENT SHALL BE SAW CUT TO STRAIGHT LINES, PARALLEL TO OR PERPENDICULAR TO THE ROADWAY, PRIOR TO THE RESURFACING.
- 7. RESURFACING MATERIAL SHALL BE FDOT SUPERPAVE, AND SHALL BE APPLIED A MINIMUM OF TWO INCH IN THICKNESS.
- 8. MILL AND BUTT JOINT TO EXISTING PAVEMENT.
- 9. IF THE TRENCH IS FILLED TEMPORARILY, IT SHALL BE COVERED WITH A 2" ASPHALTIC CONCRETE PATCH TO KEEP THE FILL MATERIAL FROM RAVELING UNTIL REPLACED WITH A PERMANENT PATCH.
- 10. REFER TO SPECIFICATIONS FOR DETAILED PROCEDURES.
- 11. WHERE THE UTILITY TRENCH CROSSES EXISTING ASPHALT DRIVEWAYS, THE LIMEROCK BASE THICKNESS MAY BE A MINIMUM OF 6 INCHES THICK. REGARDLESS OF THE EXTENT OF IMPACT, THE ENTIRE DRIVEWAY SURFACE BETWEEN THE EDGE OF THE ROADWAY PAVEMENT AND PROPERTY LINE OR FRONT OF SIDEWALK SHALL BE OVERLAID USING 2-INCH THICK MINIMUM ASPHALTIC CONCRETE SURFACE COURSE WHERE INDICATED ON THE PLANS OR AS DIRECTED BY THE CITY/ENGINEER.

	DIAMOND OF THE PARTY OF THE PAR	ISSUED:	03/01/1994	DEPARTMENT OF PUBLIC UTILITIES STANDARD DETAIL	REVISED:	11/06/2017
		DRAWN:	EAM	FLEXIBLE PAVEMENT RESTORATION		DRAWING NO.
	GOLD COAPORATED 1955	APPROVED): XXX	NOTES	G-	12

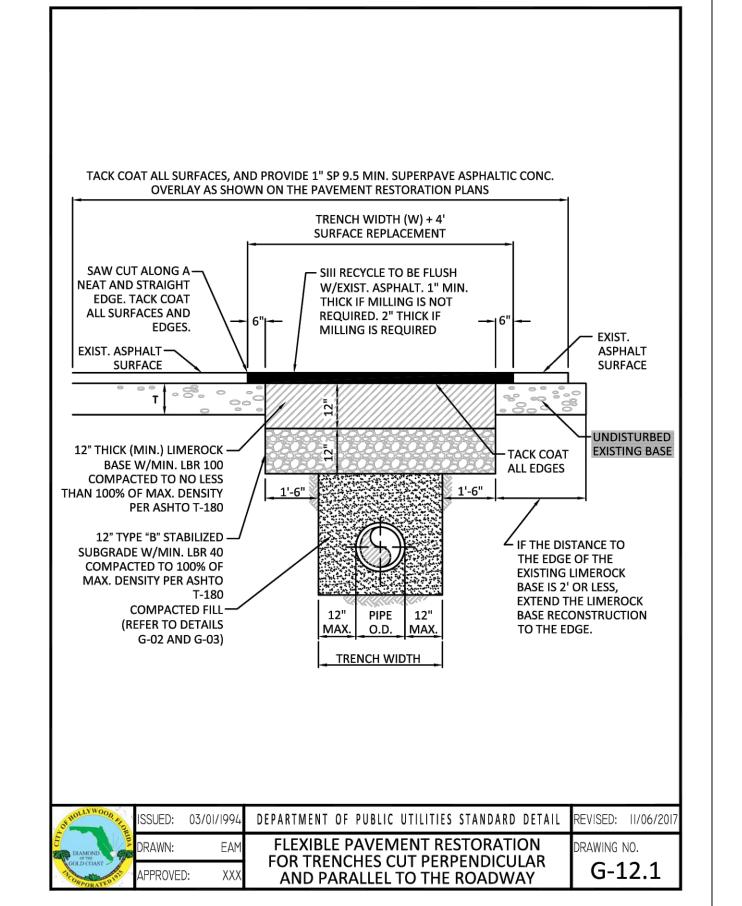

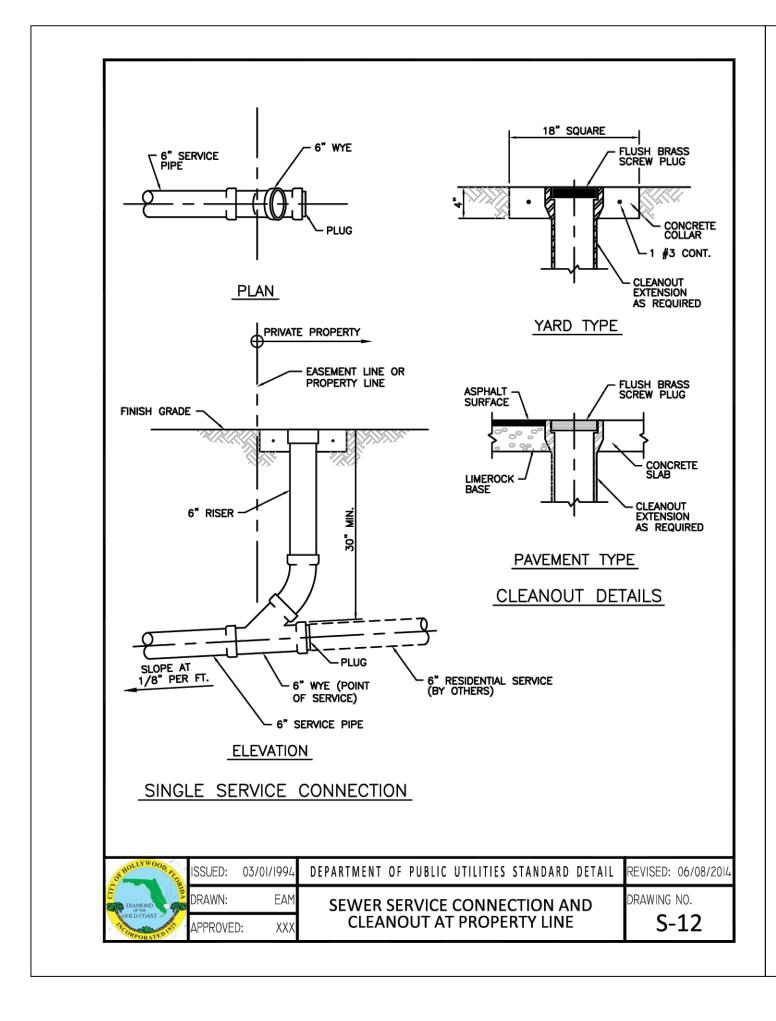

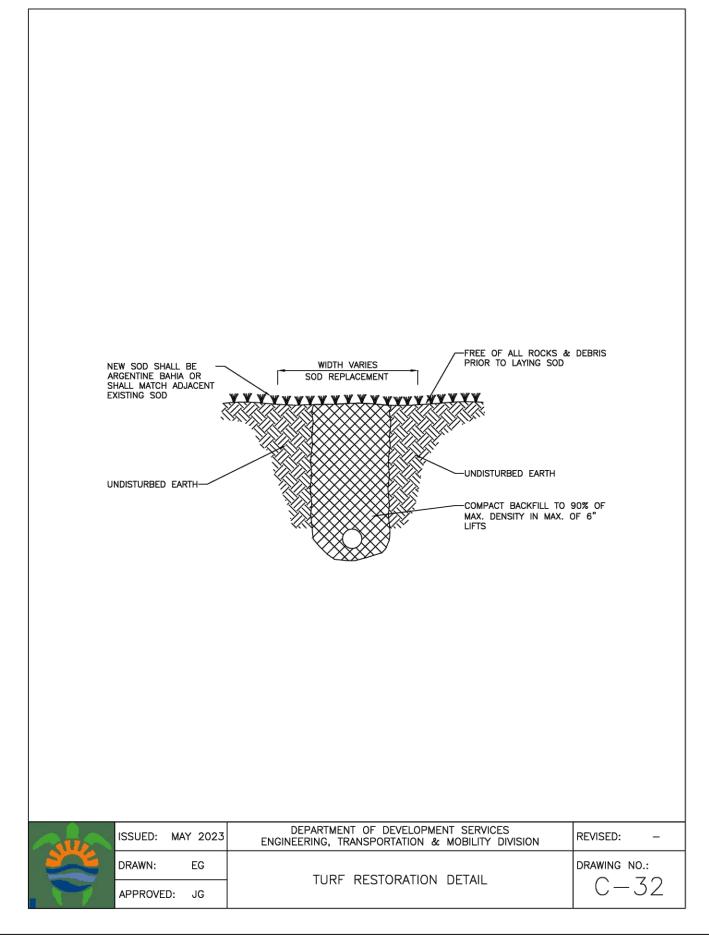


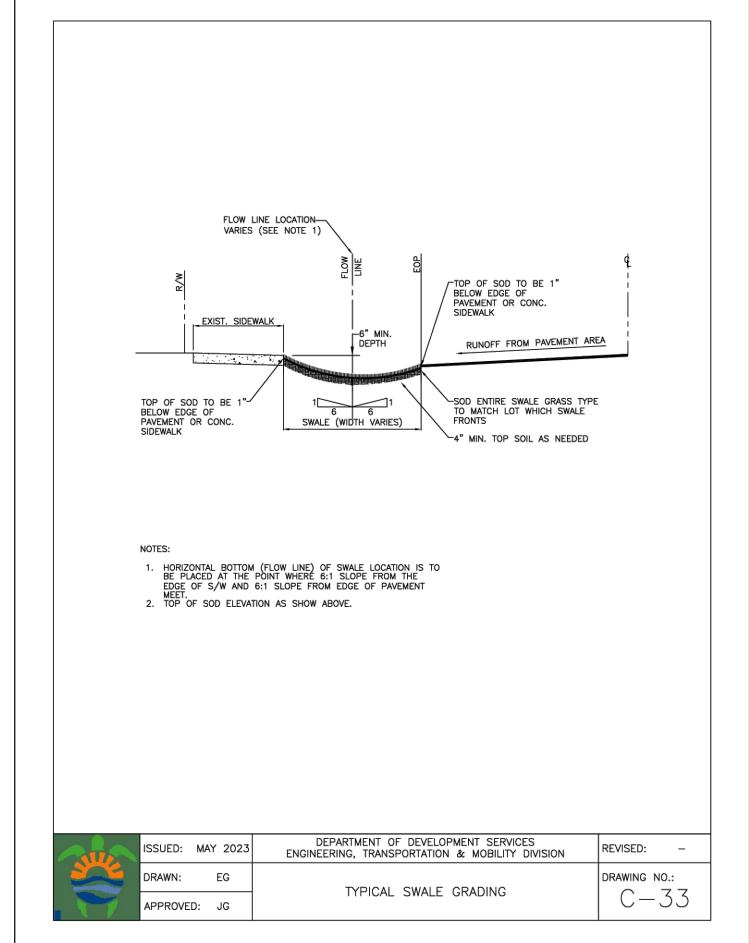




- 1. SUCCESSIVE TAPS INTO THE WATER MAIN SHALL BE SPACED NOT LESS THAN 18" ON CENTER.
- 2. P.E. TUBING SHALL BE IN ACCORDANCE WITH THE LATEST EDITION OF AWWA STANDARD C901, "POLYETHYLENE (PE) PRESSURE PIPE AND TUBING, 1/2 IN. (13mm) THROUGH 3 IN. (76 mm), FOR WATER SERVICE".
- 3. MINIMUM SERVICE PIPE DIAMETER SHALL BE 1" FOR SINGLE OR DUAL ¾" OR SINGLE 1" DIAMETER METERS.
- 4. MINIMUM SERVICE PIPE DIAMETER SHALL BE 2" FOR SINGLE OR DUAL 1-½" OR SINGLE 2" DIAMETER METERS.
- 5. FOR METER DIAMETERS LARGER THAN 2", THE MINIMUM SERVICE PIPE DIAMETER SHALL BE THE SAME AS THE METER DIAMETER.
- 6. APPROVED COPPER TUBING MAY BE USED AT THE CITY'S DISCRETION.
- FOR NEW METER INSTALLATIONS, ALL SADDLES, VALVES, PIPING, FITTINGS, CURB STOPS, METER VALVES, METER COUPLINGS, METER VAULTS AND COVERS SHALL BE FURNISHED AND INSTALLED BY THE CONTRACTOR. THE WATER METERS WILL BE PROVIDED AND INSTALLED BY THE CITY OF HOLLYWOOD (NEW ACCOUNTS).
- 8. FOR METER RELOCATIONS, ALL SADDLES, VALVES, PIPING, FITTINGS, CURB STOPS, METER VALVES, METER COUPLINGS, METER VAULTS AND COVERS SHALL BE FURNISHED AND INSTALLED BY THE CONTRACTOR. THE EXISTING WATER METER TO BE RELOCATED AND INSTALLED BY CONTRACTOR.
- FOR EXISTING METERS ABUTTING THE RIGHT-OF-WAY THAT ARE BEING DISCONNECTED FROM EXISTING MAINS AND RECONNECTED TO NEW MAINS, THE CONTRACTOR SHALL:
- a. CUT AND PLUG THE EXISTING SERVICE LINE AT THE MAIN AND AT THE METER, AND REMOVE THE EXISTING BALL VALVE CURB STOP.
- FURNISH AND INSTALL SERVICE SADDLE, CORPORATION STOP OR SERVICE VALVE AND VALVE BOX, PIPING AND FITTINGS UP TO AND INCLUDING THE BALL VALVE CURB STOP.
- 12. THE ELEVATION AT THE TOP OF THE METER BOX SHALL MATCH THE ELEVATION OF THE BACK OF SIDEWALK, WHENEVER PRACTICAL.
- 13. AS PART OF THE SERVICE INSTALLATION, THE CONTRACTOR SHALL RESTORE THE RIGHT-OF-WAY TO MATCH EXISTING CONDITIONS, INCLUDING ROADWAY PAVEMENT, PAVEMENT MARKINGS AND RPMs, CONCRETE CURBS, SIDEWALKS, RAMPS (INCLUDING DETECTABLE WARNING SURFACE), SODDING, AND ALL OTHER IMPROVEMENTS REMOVED OR DAMAGED DURING THE SERVICE INSTALLATION.
- 14. FOR UNPAVED AREAS, THE MINIMUM GROUND COVER ACCEPTED BY THE CITY IS SODDING.

TOT HOLL WOOD WILDER	ISSUED:	03/01/1994	DETAILMENT OF TODER OFFICERS STANDARD DETAIL	REVISED:	11/06/2017
DIAMOND OF THE GOLD COAST	APPROVE	EAM D: XXX	WATER METER SERVICE NOTES FOR 5/8" THROUGH 2" METERS	DRAWING I	- 07

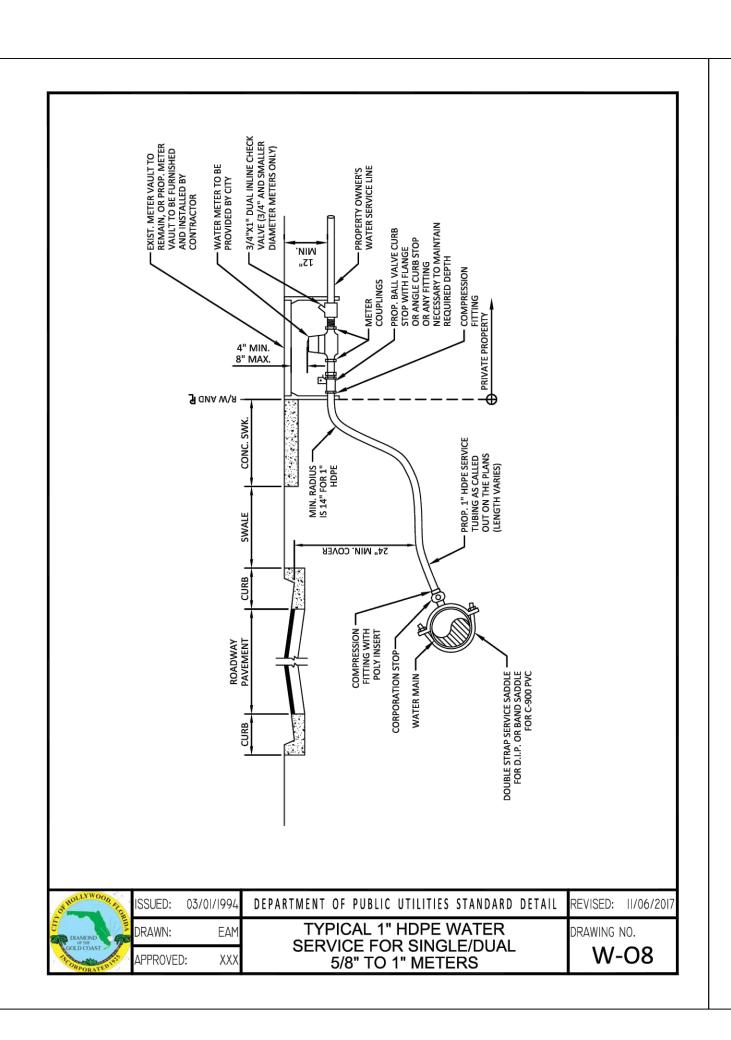

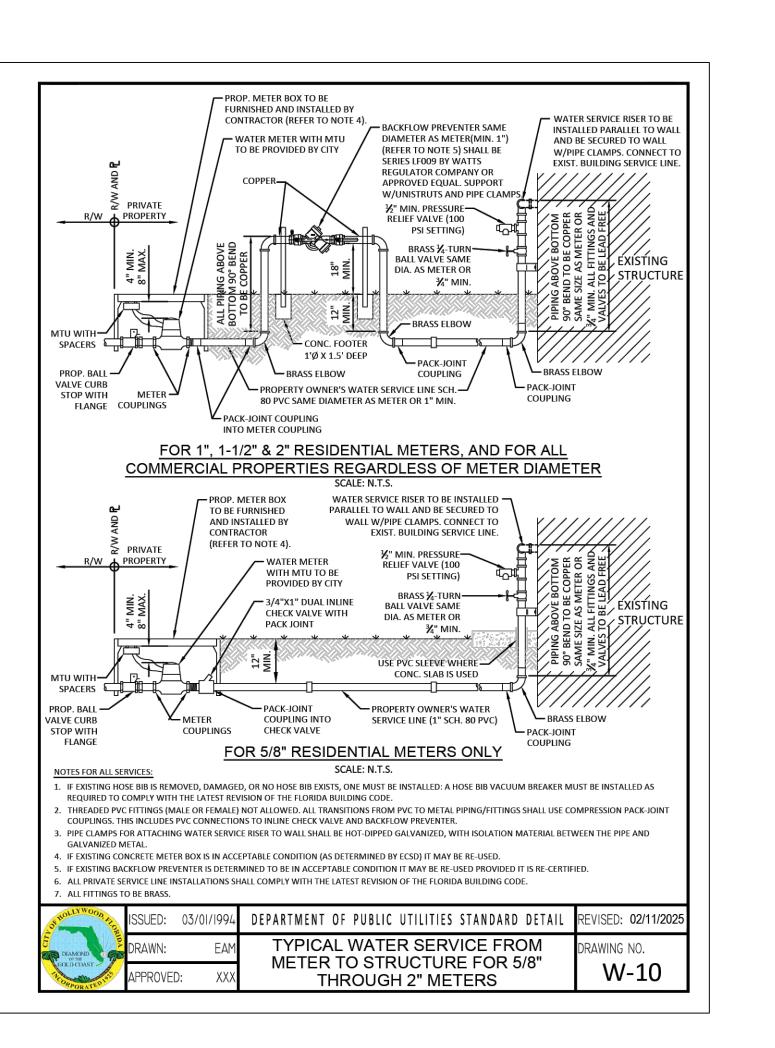



SUAREZ ENGINEERING & SURVEYING, INC 13350 SW 131ST STREET SUITE 103 MIAMI, FL 33186 Tel: 305.596.1799

CERTIFICATE OF AUTHORIZATION LIC. NO.: 34996

308 TYLER STREE WATER & SEWER DETAILS


<u>CLIENT:</u> RALPH TAIT ARCHITECT, INC.

PROJECT NAME:
NEW SINGLE FAMILY HOME

PROJECT ADDRESS: 908 TYLER STREET, HOLLYWOOD, FLORIDA 33019

PROJECT NUMB

	REVISIONS					
DATE	BY	DESCRIPTION				

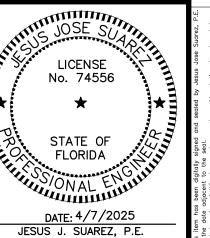

DATE: 4/7/2025
SCALE: AS SHOWN
DESIGNED BY: J.S.
DRAWN BY: J.S.S.
CHECKED BY: J.S.
FILE:
JOB No. 25-63-02

LICENSE NO. - 74556

WS-2A

SHEET NO.