

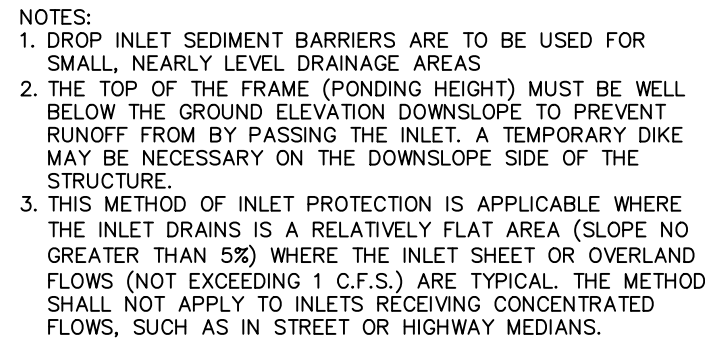
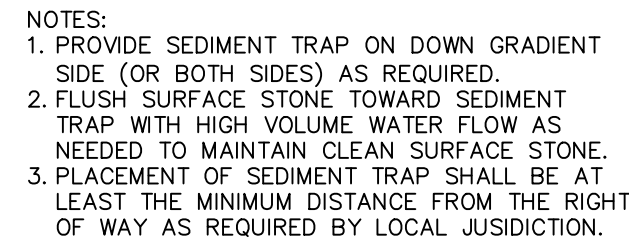


1. SEDIMENT BASINS AND TRAPS, PERIMETER DIKES, SEDIMENT BARRIERS AND OTHER MEASURES INTENDED TO TRAP SEDIMENT SHALL BE CONSTRUCTED AS A FIRST STEP IN ANY LAND DISTURBING ACTIVITY AND SHALL BE MADE FUNCTIONAL BEFORE UP-SLOPE LAND DISTURBANCE TAKES PLACE.
2. ALL SEDIMENT CONTROL MEASURES ARE TO BE ADJUSTED TO MEET FIELD CONDITIONS AT THE TIME OF CONSTRUCTION AND BE CONSTRUCTED PRIOR TO ANY GRADING OR DISTURBANCE OF EXISTING SURFACE MATERIAL ON BALANCE OF SITE. PERIMETER SEDIMENT BARRIERS SHALL BE CONSTRUCTED TO PREVENT SEDIMENT OR TRASH FROM FLOWING OR FLOATING ON TO ADJACENT PROPERTIES.
3. PERMANENT OR TEMPORARY SOIL STABILIZATION SHALL BE APPLIED TO DENUDED AREAS WITHIN SEVEN (7) DAYS AFTER FINAL GRADE IS REACHED. ANY EROSION OR SOIL STABILIZATION SHALL BE APPLIED WITHIN SEVEN (7) DAYS TO DENUDED AREAS THAT MAY NOT BE AT FINAL GRADE BUT WILL REMAIN UNDISTURBED FOR LONGER THAN 30 DAYS. PERMANENT STABILIZATION SHALL BE APPLIED TO AREAS THAT ARE TO BE LEFT UNDISTURBED FOR MORE THAN ONE YEAR.
4. DURING CONSTRUCTION OF THE PROJECT, SOIL STOCK PILES SHALL BE STABILIZED, COVERED OR CONTAINED WITH SEDIMENT TRAPPING MEASURES. THE APPLICANT IS RESPONSIBLE FOR THE TEMPORARY PROTECTION AND PERMANENT STABILIZATION OF ALL SOIL STOCKPILES ON SITE AS WELL AS SOIL, INTENTIONALLY TRANSPORTED FROM THE PROJECT SITE.
5. A PERMANENT VEGETATIVE COVER SHALL BE ESTABLISHED ON DENUDED AREAS NOT OTHERWISE PERMANENTLY STABILIZED.
6. AFTER ANY SIGNIFICANT RAINFALL, SEDIMENT CONTROL STRUCTURES WILL BE INSPECTED FOR INTEGRITY. ANY DAMAGED DEVICES SHALL BE CORRECTED IMMEDIATELY.
7. CONCENTRATED RUNOFF SHALL NOT FLOW DOWN CUT OR FILL SLOPES UNLESS CONTAINED WITHIN AN ADEQUATE TEMPORARY OR PERMANENT CHANNEL, FLUME, SLOPE DRAIN STRUCTURE OR APPROVED CONTROL.
8. SEDIMENT WILL BE PREVENTED FROM ENTERING ANY STORM WATER SYSTEM, DITCH OR CHANNEL. ALL STORM WATER INLETS THAT ARE MADE OPERABLE OR REQUIRED TO BE MADE OPERABLE MUST BE PROTECTED SO THAT ANY DITCH OR CHANNEL WATER CANNOT ENTER THE CONVEYANCE SYSTEM WITHOUT FIRST BEING FILTERED OR OTHERWISE TREATED TO REMOVE SEDIMENT.
9. WHEN WORK IN A LIVE WATERCOURSE IS PERFORMED, PRECAUTIONS SHALL BE TAKEN TO MINIMIZE ENCROACHMENT, CONTROL SEDIMENT TRANSPORT AND STABILIZE THE WORK AREA TO THE GREATEST EXTENT POSSIBLE DURING CONSTRUCTION.
10. PERIODIC INSPECTION AND MAINTENANCE OF ALL SEDIMENT CONTROL STRUCTURES MUST BE PROVIDED TO ENSURE INTENDED PURPOSE IS ACCOMPLISHED. THE DEVELOPER, OWNER AND/OR CONTRACTOR SHALL BE CONTINUALLY RESPONSIBLE FOR ALL SEDIMENT CONTROL STRUCTURES. SEDIMENT CONTROL MEASURES SHALL BE IN WORKING CONDITION AT THE END OF EACH WORKING DAY.
11. WHERE CONSTRUCTION VEHICLE ACCESS ROUTES INTERSECT PAVED PUBLIC ROADS, PROVISIONS SHALL BE MADE TO MINIMIZE THE TRANSPORT OF SEDIMENT BY TRACKING ONTO THE PAVED SURFACE. WHERE SEDIMENT IS TRANSPORTED ONTO A PUBLIC ROAD SURFACE WITH CURBS AND GUTTERS, THE ROAD SHALL BE CLEANED THOROUGHLY AT THE END OF EACH DAY. SEDIMENT SHALL BE REMOVED FROM THE ROADS BY SWEELING OR SCRAPING AND TRANSPORTED TO SEDIMENT CONTROL DISPOSAL AREA. STREET WASHING SHALL BE ALLOWED ONLY AFTER SEDIMENT IS REMOVED IN THIS MANNER. THIS PROVISION SHALL APPLY TO INDIVIDUAL SUBDIVISION LOTS AS WELL AS TO LARGER LAND DISTURBING ACTIVITIES.
12. ALL TEMPORARY EROSION AND SEDIMENT CONTROL MEASURES SHALL BE REMOVED WITHIN 30 DAYS AFTER FINAL SITE STABILIZATION OR AFTER THE TEMPORARY MEASURES ARE NO LONGER NEEDED.
13. PROPERTIES AND WATERWAYS DOWNSTREAM FROM CONSTRUCTION SITES SHALL BE PROTECTED FROM SEDIMENT DEPOSITION AND EROSION AT ALL TIMES DURING CONSTRUCTION.
14. EROSION CONTROL DESIGN AND CONSTRUCTION SHALL FOLLOW THE REQUIREMENTS IN THE "FLORIDA EROSION AND SEDIMENT CONTROL MANUAL" AND COUNTY PERMITS.
15. CONTRACTOR IS RESPONSIBLE FOR ALL SURFACE WATER DISCHARGES, RAINFALL RUN OFF OR DEWATERING ACTIVITIES.
16. CONTRACTOR MUST INCORPORATE ALL BMP'S NECESSARY TO MEET OR EXCEED STATE WATER QUALITY AND SWPPP REQUIREMENTS.
17. THE POLLUTION PREVENTION PLAN IS A MINIMUM GUIDELINE ONLY. ADDITIONAL BMP'S MAY BE NECESSARY AT CONTRACTOR'S EXPENSE.
18. NOI TO BE POSTED ON SITE.

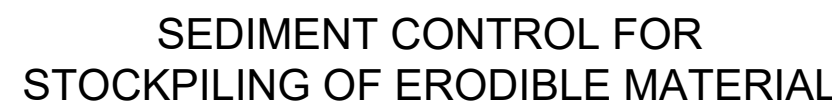

- NOTES:
1. "SWPPP INFORMATION" MUST BE DISPLAYED PROMINENTLY ACROSS THE TOP OF THE SIGN, AS SHOWN IN THE DETAIL.
2. SIGN TO BE CONSTRUCTED OF A RIGID MATERIAL, SUCH AS PLYWOOD OR OUTDOOR SIGN BOARD. SIGN MUST BE CONSTRUCTED IN A MANNER TO PROTECT DOCUMENTS FROM DAMAGE DUE TO WEATHER (WIND, SUN, MOISTURE, ETC.).
3. THE SWPPP INFORMATION SIGN MUST BE LOCATED NEAR THE ENTRANCE/EXIT OF THE SITE, SUCH THAT IT IS ACCESSIBLE/VISIBLE BY THE GENERAL PUBLIC, BUT NOT OBSTRUCTING VIEWS AS TO CAUSE A SAFETY HAZARD.
4. ALL POSTED DOCUMENTS MUST BE MAINTAINED IN A CLEARLY READABLE CONDITION AT ALL TIMES THROUGHOUT CONSTRUCTION AND UNTIL THE NOTICE-OF-TERMINATION (NOT) IS FILED FOR THE PERMIT.
5. CONTRACTOR SHALL POST OTHER WATER WAD/AND/OR EROSION AND SEDIMENT CONTROL RELATED PERMITS ON THE SIGN AS REQUIRED BY THE LOCAL AGENCY.
6. SIGN SHALL BE LOCATED OUTSIDE OF PUBLIC RIGHT-OF-WAY AND EASEMENTS UNLESS APPROVED BY THE AGENCY.
7. CONTRACTOR IS RESPONSIBLE FOR ENSURING STABILITY OF THIS SWPPP INFORMATION SIGN.

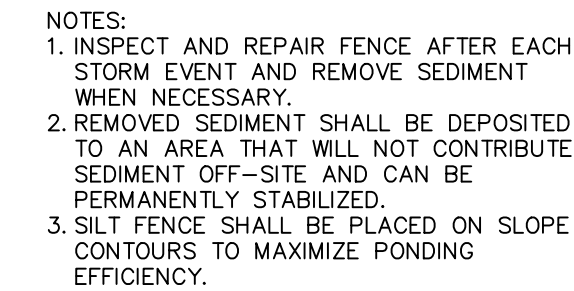


| LOW TO MODERATE FLOW GEOTEXTILE FABRIC SPECIFICATION TABLE | | |
|---|-------------|-------------------|
| PROPERTIES | TEST METHOD | UNITS |
| GRAB TENSILE STRENGTH | ASTM D-4632 | 300 LBS |
| GRAB TENSILE ELONGATION | ASTM D-4632 | 20 % |
| PUNCTURE | ASTM D-4633 | 120 LBS |
| MULLEN BURST | ASTM D-3786 | 800 PSI |
| TRAPEZOID TEAR | ASTM D-4533 | 120 LBS |
| UV RESISTANCE | ASTM D-4355 | 80 % |
| APPARENT OPENING SIZE | ASTM D-4751 | 40 US SIEVE |
| FLOW RATE | ASTM D-4491 | 200 GAL/MIN/SQ FT |
| PERMITTIVITY | ASTM D-4491 | 0.55 SEC -1 |
| MODERATE TO HIGH FLOW GEOTEXTILE FABRIC SPECIFICATION TABLE | | |
| PROPERTIES | TEST METHOD | UNITS |
| GRAB TENSILE STRENGTH | ASTM D-4632 | 265 LBS |
| GRAB TENSILE ELONGATION | ASTM D-4632 | 20 % |
| PUNCTURE | ASTM D-4633 | 135 LBS |
| MULLEN BURST | ASTM D-3786 | 820 PSI |
| TRAPEZOID TEAR | ASTM D-4533 | 45 LBS |
| UV RESISTANCE | ASTM D-4355 | 90 % |
| APPARENT OPENING SIZE | ASTM D-4751 | 20 US SIEVE |
| FLOW RATE | ASTM D-4491 | 200 GAL/MIN/SQ FT |
| PERMITTIVITY | ASTM D-4491 | 1.5 SEC -1 |

- NOTES:
1. FOR TEMPORARY USE TO CAPTURE LARGER DIAMETER SEDIMENTS. NOT TO BE UTILIZED AS THE ONLY SEDIMENT CONTAINMENT SYSTEM.
 2. GEOTEXTILE WILL BE A WOVEN POLYPROPYLENE FABRIC THAT MEETS OR EXCEEDS REQUIREMENTS IN THE SPECIFICATIONS TABLE.
 3. AN OIL ADSORBENT PAD OR PILLOW CAN BE PURCHASED WHEN OIL SPILLS ARE A CONCERN.
 4. INSPECT PER REGULATORY REQUIREMENTS.

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CAUTION:
EXISTING PYLON
SIGN TO REMAIN

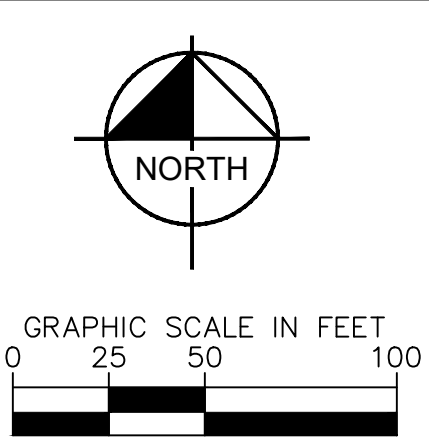

UTILITY LEGEND

| | |
|-----|--|
| --- | PROPERTY LINE |
| --- | UTILITY EASEMENT |
| --- | WATER MAIN (WM) |
| --- | SANITARY MAIN |
| --- | ELECTRIC |
| --- | GAS |
| --- | EXISTING STORM PIPE |
| --- | PROPOSED CONSTRUCTION FENCE WITH FABRIC |
| --- | FDC |
| --- | GATE VALVE |
| --- | 90° BEND |
| --- | 45° BEND |
| --- | 22.5° BEND |
| --- | 11.25° BEND |
| --- | TEE |
| --- | TRANSFORMER |
| --- | EXISTING SEWER MANHOLE |
| --- | CONSTRUCTION GATE |
| --- | PARKING LOT AREA TO BE DEMOLISHED AND CLEARED. DEMOLITION INCLUDES BUT IS NOT LIMITED TO PAVEMENT, SUBBASE, UTILITIES, STORM DRAINAGE, CONDUIT, LIGHT POLES, AND TREES UNLESS OTHERWISE SPECIFIED. |
| --- | MILLING AND RESURFACING |


- DEMOLITION NOTES:**
1. THE INTENT OF THE DEMOLITION PLAN IS TO DEPICT ALL EXISTING FEATURES THAT ENCUMBER THE PROPOSED CONSTRUCTION AREA AND ARE SCHEDULED FOR REMOVAL. SOME INCIDENTAL ITEMS MAY HAVE BEEN INADVERTENTLY OMITTED FROM THE PLAN. THE CONTRACTOR IS ENCOURAGED TO THOROUGHLY INSPECT THE SITE AS WELL AS REVIEW THE PLANS AND SPECIFICATIONS PRIOR TO SUBMITTING PRICING. CONTRACTOR WILL NOT RECEIVE ADDITIONAL COMPENSATION FOR INCIDENTAL ITEMS NOT SHOWN ON THIS DEMOLITION PLAN.
 2. THIS DEMOLITION PLAN IS BASED ON AVAILABLE UTILITY INFORMATION AND MAY OR MAY NOT BE ALL INCLUSIVE FOR THIS SITE. ANY UTILITIES ENCOUNTERED DURING DEMOLITION THAT ARE NOT DEPICTED/ADDRESSED ON THIS DRAWING SHOULD BE BROUGHT TO THE ATTENTION OF THE PROJECT ENGINEER IMMEDIATELY.
 3. CONTRACTOR IS REQUIRED TO OBTAIN ALL DEMOLITION PERMITS.
 4. ALL FEATURES IDENTIFIED ON THIS PLAN WHICH ARE LISTED TO BE DEMOLISHED ARE TO BE REMOVED FROM THE SITE. AFTER DEMOLITION IS COMPLETE THE SITE SHALL BE DELIVERED IN A CONDITION SUITABLE FOR DEVELOPMENT.
 5. CONTRACTOR SHALL LIMIT ALL DEMOLITION ACTIVITIES TO THOSE AREAS DELINEATED ON THE CONSTRUCTION DRAWINGS UNLESS OTHERWISE DIRECTED BY THE DEVELOPER OR AS REQUIRED FOR CONSTRUCTION OF IMPROVEMENTS.
 6. CONTRACTOR TO COORDINATE WITH ALL UTILITY OWNERS PRIOR TO DEMOLITION TO ENSURE SERVICES HAVE BEEN DISCONNECTED.
 7. CONTRACTOR IS RESPONSIBLE FOR CONTROLLING AIRBORNE DUST AND POLLUTANTS BY USING WATER SPRINKLING OR OTHER SUITABLE MEANS OF CONTROL.
 8. CONTRACTOR TO USE CARE IN HANDLING DEBRIS FROM SITE TO ENSURE THE SAFETY OF THE PUBLIC. HAUL ROUTE TO BE CLOSELY MONITORED FOR DEBRIS OR MATERIALS TRACKED ONTO ADJOINING ROADWAYS, SIDEWALKS, ETC. ROADWAYS AND WALKWAYS TO BE CLEARED DAILY OR AS NECESSARY TO MAINTAIN PUBLIC SAFETY.
 9. DE-WATERING SHOULD BE ANTICIPATED AND INCLUDED.
 10. ALL ASPHALT TO BE REMOVED SHALL BE SAW CUT ADJACENT TO REMAINING IMPROVEMENTS.
 11. WHERE REMAINING, INLETS, MANHOLE COVERS, AND VALVE COVERS TO BE PROTECTED IN PAVEMENT REMOVAL AREAS.
 12. SEE SITE AND IMPROVEMENTS PLANS FOR LIMITS AND GRADING OF RESURFACED DRIVEWAYS AND ENTRANCES.
 13. SEE LANDSCAPE PLAN FOR TREE REMOVAL/RELOCATION AND TREE PROTECTION.
 14. SEE EROSION CONTROL PLAN FOR REMAINING INLET PROTECTION AND EROSION PREVENTION.
- (ALTERNATE NOTES)**
15. INGRESS AND EGRESS, AS WELL AS SUFFICIENT PARKING SHALL BE MAINTAINED, TWENTY-FOUR HOURS A DAY, SEVEN DAYS A WEEK, THROUGHOUT ALL PHASES OF CONSTRUCTION.
 16. THE CONTRACTOR IS RESPONSIBLE FOR LOCATING ALL EXISTING SITE LIGHTING AND CONDUIT ROUTINGS AND FOR ASSURING THAT THE CIRCUITRY OF THE SITE LIGHTING TO REMAIN IS MAINTAINED AND THAT DEMOLITION DOES NOT IMPACT SITE LIGHTING OF THE REMAINDER OF THE DEVELOPMENT.
 17. THE CONTRACTOR IS RESPONSIBLE FOR LOCATING AND DEMOLISHING ALL EXISTING IRRIGATION. THE CONTRACTOR SHALL ASSURE THAT THE INTEGRITY OF THE IRRIGATION SYSTEM FOR THE REMAINING DEVELOPMENT IS MAINTAINED.

GREGORY D WILFONG

Digitally signed by GREGORY D WILFONG, DN: cn=GREGORY D WILFONG, o=KIMLEY-HORN AND ASSOCIATES, INC., email=gwilfong@kimley-horn.com, c=US, Date: 2024.09.03 14:50:13 -0400


| | | | | | |
|--|--|--|--|--|--|
| OAKWOOD SOUTH RETAIL SHOPPING CENTER | | CITY OF HOLLYWOOD | | FL | |
| SHEET NUMBER C-150 | | DEMOLITION PLAN | | THIS ITEM HAS BEEN DIGITALLY SIGNED AND SEALED BY GREGORY D. WILFONG, P.E. ON THE DATE ADJACENT TO THE SEAL. PRINTED THIS DOCUMENT ARE NOT CONSIDERED SIGNED AND SEALED AND THE DIGITAL SIGNATURE MUST BE VERIFIED ON ANY ELECTRONIC COPIES. | |
| KHA PROJECT 147507131 | | DATE 9/3/2024 | | SCALE AS SHOWN | |
| DESIGNED BY SHB | | DRAWN BY SHB | | CHECKED BY CDW | |
| Kimley-Horn and Associates, Inc. 445 24TH STREET, SUITE 200, VERO BEACH, FL 32960 PHONE: 772-794-4100 WWW.KIMLEY-HORN.COM | | GREGORY D. WILFONG P.E. No. 63166 FLORIDA PROFESSIONAL ENGINEER | | Kimley-Horn and Associates, Inc. 445 24TH STREET, SUITE 200, VERO BEACH, FL 32960 PHONE: 772-794-4100 WWW.KIMLEY-HORN.COM | |
| REVISIONS | | DATE | | BY | |

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SITE LEGEND

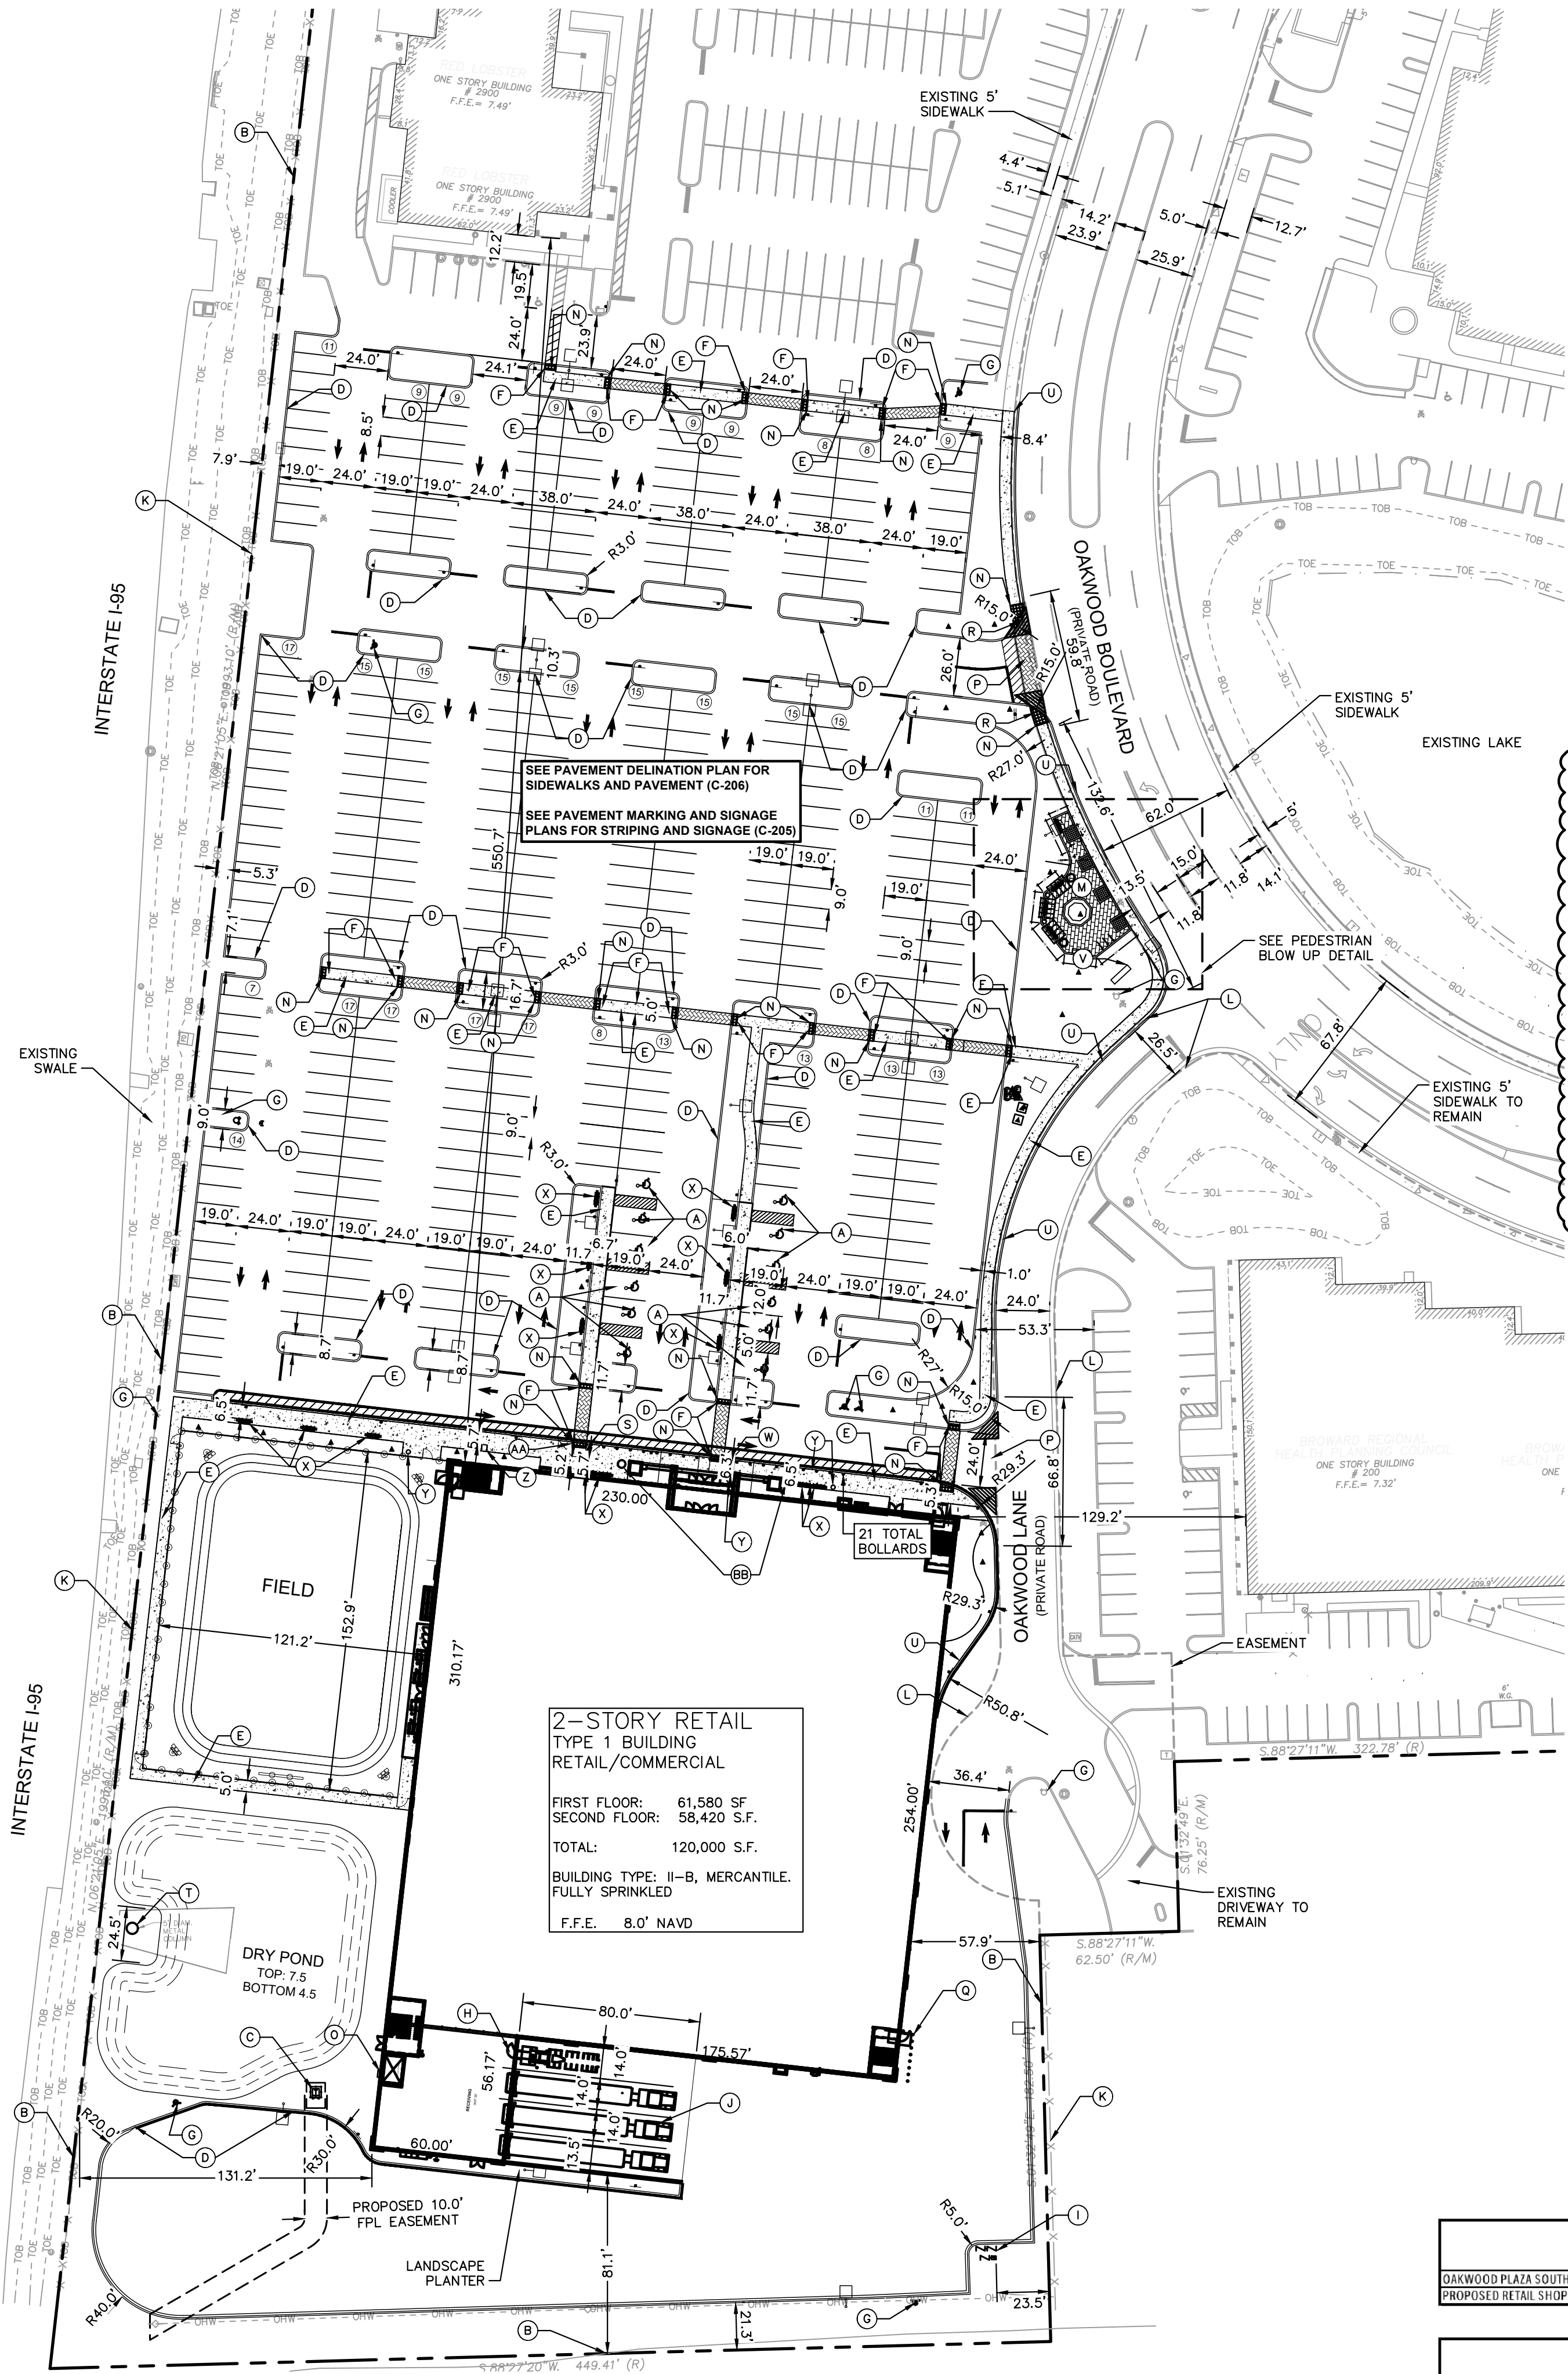- (A) ACCESSIBLE PARKING SPACE (TYP.) (SEE SHEET C-201 FOR DETAIL, WITH ADA SIGN)
- (B) PROPERTY LINE
- (C) CONCRETE TRANSFORMER PAD AND TRANSFORMER. CONTRACTOR TO COORDINATE WITH LOCAL POWER COMPANY FOR DETAILS.
- (D) 6" TYPE 'D' CURB (SEE SHEET C-202 AND SHEET C-206)
- (E) STANDARD DUTY CONCRETE SIDEWALK (5' MIN) (SEE SHEET C-202 AND SHEET C-206)
- (F) FDOT CURB RAMP TYPE CR-E INDEX 522-002 (SEE SHEET C-201 FOR DETAIL AND SHEET C-206)
- (G) PROPOSED OR EXISTING FIRE HYDRANTS
- (H) COMPACTOR (SEE SHEET C-201)
- (I) WATER/ FIRE EQUIPMENT
- (J) LOADING DOCK (SEE ARCH PLANS)
- (K) EXISTING FENCE TO REMAIN
- (L) EXISTING ACCESS EASEMENT
- (M) PEDESTRIAN PLAZA (SEE SHEET L-301 AND BLOW UP BELOW)
- (N) DETECTABLE WARNING PER FDOT INDEX 522-002 (SEE SHEET C-201)
- (O) GAS METER (SEE ARCH. PLANS)
- (P) ASPHALT DRIVEWAY (SEE SHEET C-350 AND DETAIL C-20 ON SHEET C-202)
- (Q) PROPOSED BOLLARDS (SEE SHEET C-201)
- (R) FDOT CURB RAMP TYPE CR-F INDEX 522-002 (SEE SHEET C-201 FOR DETAIL AND SHEET C-206)
- (S) FDOT CURB RAMP TYPE CR-A INDEX 522-002 (SEE SHEET C-201 FOR DETAIL AND SHEET C-206)
- (T) EXISTING FREEWAY SIGN TO REMAIN (LONG TERM LEASE WITH OWNERSIGN COMPANY)
- (U) 6" TYPE 'F' CURB AND GUTTER (SEE DETAIL C-26 ON SHEET C-202)
- (V) PROPOSED MONUMENT SIGN (SIGN WILL BE UP TO MAXIMUM ALLOWED BY CODE. DESIGN WILL BE SUBMITTED WITH PERMIT APPLICATION)
- (W) FDOT CURB RAMP TYPE CR-C INDEX 522-002 (SEE SHEET C-201 FOR DETAIL)



- (X) BENCH (SEE LANDSCAPING PLANS)
- (Y) TRASH BIN (SEE LANDSCAPING PLANS)
- (Z) BIKE RACK (SEE LANDSCAPING PLANS)
- (AA) BOLLARD (SEE LANDSCAPING PLANS)
- (BB) LARGE PLANTER (SEE LANDSCAPING PLANS)

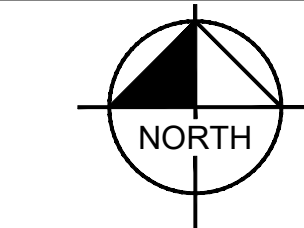MAIL DELIVERY NOTE

MAIL DELIVERY WILL BE INSIDE STORE

SITE LIGHTING CONFORMANCE NOTE

THE SIGN LIGHTING OF THE SITE SHALL CONFORM TO THE SITE LIGHTING CRITERIA ESTABLISHED BY THE CITY OF HOLLYWOOD. THIS CONSISTS OF WELL DIRECTED LED LIGHTING WITH MAX FOOT CANDLE LEVEL AT ALL PROPERTY LINES = 0.5 (ADJACENT TO RESIDENTIAL).

GREEN ORDINANCE NOTE

FLORIDA GREEN BUILDING COALITION (FGBC) COMMERCIAL CERTIFICATION WILL BE PURSUED FOR THIS PROJECT.

MECHANICAL EQUIPMENT NOTE

ALL MECHANICAL EQUIPMENT SHALL BE PROPERLY SCREENED FROM PUBLIC VIEW.

PHASING INFORMATION

SITE WILL BE CONSTRUCTED WITH PAD FOR BUILDING. BUILDING WILL BE CONSTRUCTED AFTER SITE IS CLOSE TO COMPLETE AND SIGNED OFF.

SITE PLAN APPROVAL NOTE

CHANGES TO THE DESIGN OF THE SITE PLAN WILL REQUIRE PLANNING REVIEW AND MAY BE SUBJECT TO BOARD APPROVAL.

ADA NOTE

ANY LIP FROM 1/4" BUT NOT GREATER THAN 1/2" WILL BE BEVELED TO MEET ADA REQUIREMENTS ALONG ALL SIDEWALKS AND ADA PATHS

NOTES:
ALL CURB RADII ARE '9" ON ALL LANDSCAPING ISLANDS UNLESS OTHERWISE NOTED.

SIGNAGE NOTE:
ALL SIGNAGE SHALL BE IN COMPLIANCE WITH THE OAKWOOD SIGN REGULATIONS

LEGAL DISCRIPTION

(LUPA SOUTH):

A PARCEL OF LAND BEING A PORTION OF TRACT "E", OAKWOOD HILLS, ACCORDING TO THE PLAT THEREOF RECORDED IN PLAT BOOK 120, PAGE 45, OF THE PUBLIC RECORDS OF BROWARD COUNTY, FLORIDA. SAID PARCEL BEING MORE PARTICULARLY DESCRIBED AS FOLLOWS:

COMMENCE AT THE SOUTHEAST CORNER OF SAID TRACT "E", SAID POINT ALSO BEING A POINT ON THE WEST RIGHT-OF-WAY LINE OF THE C-10 CANAL; THENCE S.88°27'20"W, ALONG THE SOUTH LINE OF SAID TRACT "E", A DISTANCE OF 325.00 FEET TO THE POINT OF BEGINNING OF THE HEREIN DESCRIBED PARCEL OF LAND; THENCE CONTINUE S.88°27'20"W, ALONG SAID SOUTH LINE, A DISTANCE OF 449.41 FEET TO THE SOUTHWEST CORNER OF SAID TRACT "E", SAID POINT ALSO BEING A POINT ON THE EAST RIGHT-OF-WAY LINE OF INTERSTATE I-95; THENCE N.06°21'05"E, ALONG THE WEST LINE OF SAID TRACT "E" AND THE EAST RIGHT-OF-WAY LINE OF SAID INTERSTATE I-95, A DISTANCE OF 1993.10 FEET TO THE NORTHWEST CORNER OF SAID TRACT "E", SAID POINT ALSO BEING A POINT OF THE SOUTH RIGHT-OF-WAY LINE OF THE C-10 SPUR CANAL; THENCE N.88°32'24"E, ALONG THE NORTH LINE OF SAID TRACT "E", AND THE SOUTH RIGHT-OF-WAY LINE OF THE SAID C-10 SPUR CANAL, A DISTANCE OF 960.10 FEET TO THE NORTHEAST CORNER OF SAID TRACT "E", SAID POINT ALSO BEING A POINT ON THE WEST RIGHT-OF-WAY LINE OF THE SAID C-10 CANAL; THENCE S.11°34'01"W, ALONG SAID EAST LINE OF SAID TRACT "E" AND THE WEST RIGHT-OF-WAY LINE OF THE SAID C-10 CANAL, A DISTANCE OF 1759.90 FEET; THENCE S.88°27'11"W, A DISTANCE OF 322.78 FEET; THENCE S.01°32'49"E, A DISTANCE OF 76.25 FEET; THENCE S.88°27'11"W, A DISTANCE OF 62.50 FEET; THENCE S.01°32'49"E, A DISTANCE OF 182.50 FEET TO THE POINT OF BEGINNING.

SITE DATA (WORK AREA)

PROJECT DESCRIPTION:

PARCEL ID: 514204120620 & 514204120627

LOCATION: HOLLYWOOD, FL

ADDRESS: 2800 OAKWOOD BLVD HOLLYWOOD FL 33020

LAND USE: OAKWOOD ACTIVITY CENTER

ZONING DISTRICT: OAKWOOD PLAZA PD

FLOOD ZONE: ZONE AE AND ZONE X

SITE AREA:

| SITE COVERAGE: | PROVIDED | |
|------------------|-----------|--------------|
| BUILDING AREA: | 1.71 A.C. | |
| OPEN SPACE: | 1.54 A.C. | |
| IMPERVIOUS AREA: | 5.06 A.C. | |
| TOTAL: | 8.20 A.C. | 357,100 S.F. |

BUILDING SETBACKS:

| | REQUIRED | PROVIDED |
|--------|----------|----------------------------|
| EAST: | 0 | 57.9' |
| SOUTH: | 0 | 81.1' |
| WEST: | 0 | 131.2' |
| NORTH: | 0 | N/A (INTERNAL PARCEL LINE) |

LANDSCAPE BUFFERS:

| | REQUIRED | PROVIDED |
|----------------|----------|----------|
| NORTH (FRONT): | 0 | 0 |
| EAST (SIDE): | 0 | 1.0' |
| SOUTH (REAR): | 0 | 21.3' |
| WEST (SIDE): | 0 | 5.3' |

BUILDING HEIGHT:

| | MAXIMUM | PROVIDED |
|--|---------|----------|
| | 300' | 64' |

BUILDING STORIES:

PARKING SUMMARY:

| | SQUARE FOOTAGE | PARKING (STALLS) | EXISTING PARKING RATION PER 1000 S.F. | REQUIRED PARKING RATIO WITH 3.5/1000 | PARKING REMOVED WITH DEMOLITION (STALLS) | PARKING SURPLUS (STALLS) | TOTAL ADA REQUIRED (STALLS) | TOTAL ADA PROPOSED (STALLS) |
|---------------------------------|----------------|------------------|---------------------------------------|--------------------------------------|--|--------------------------|-----------------------------|-----------------------------|
| OAKWOOD PLAZA SOUTH (CURRENT) | 317,972 | 2,024 | 6.37 | 1,113 | N/A | 911 | | |
| PROPOSED RETAIL SHOPPING CENTER | 120,000 | 388 | N/A | 420 | 667 | | 9 | 13 |

| | SQUARE FOOTAGE | PARKING (STALLS) | EXISTING PARKING RATION PER 1000 S.F. | REQUIRED PARKING RATIO WITH 3.5/1000 | PARKING SURPLUS (STALLS) |
|---|----------------|------------------|---------------------------------------|--------------------------------------|--------------------------|
| OAKWOOD PLAZA SOUTH AT PROJECT COMPLETION | 437,972 | 1,735 | 4.01 | 1,533 | 222 |

NOTE: OAKWOOD PLAZA PD GUIDELINES ALLOWS SHARED PARKING IN SHOPPING CENTER

LEGEND


- PROPERTY LINE
- == PROPOSED CURB
- - - EXISTING EASEMENTS
- == PROPOSED CURB AND GUTTER
- STANDARD DUTY PAVEMENT
- ▨ HEAVY DUTY ASPHALT
- ▽ VISIBILITY TRIANGLE (12X12)
- ADA DETECTABLE WARNING
- PROPOSED LIGHT POLES (SEE SHEET SL200)
- EXISTING SIDEWALK
- PROPOSED SIDEWALK (STANDARD GREY CONCRETE WITH BROOM FINISH)
- ▨ 6X9, 3 1/8" CROSSWALK VEHICULAR PAVERS FROM BELGARD PATTERN: HERRINGBONE
- ▨ 12X6, 2 3/8" PEDESTRIAN PAVERS FROM BELGARD PATTERN 1/2 RUNNING BOND

PARCEL 2:



ADA PATH
1" = 100'

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| | |
|-------------|-----------|
| KHA PROJECT | 147507131 |
| DATE | 9/3/2024 |
| SCALE | AS SHOWN |
| DESIGNED BY | SHB |
| DRAWN BY | SHB |
| CHECKED BY | CDW |

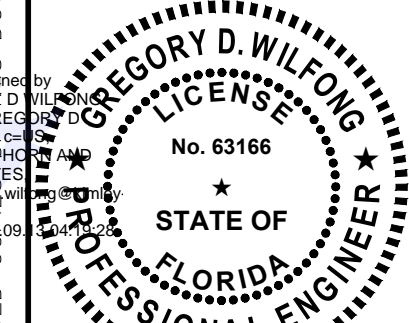SITE PLAN

OAKWOOD SOUTH RETAIL SHOPPING CENTER

SHEET NUMBER
C-200

CITY OF HOLLYWOOD FL

Kimley»Horn

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445 24TH STREET, SUITE 200, VERO BEACH, FL 32960
PHONE: 772-794-4100
WWW.KIMLEY-HORN.COM

REGISTRY NO. 35106

CITY OF HOLLYWOOD PLANNING REVISIONS

DATE








BY

REVISIONS








9/3/2024

SHB


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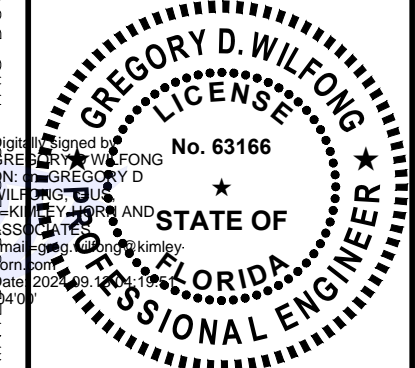
FDOT ADA RAMPS
N.T.S.

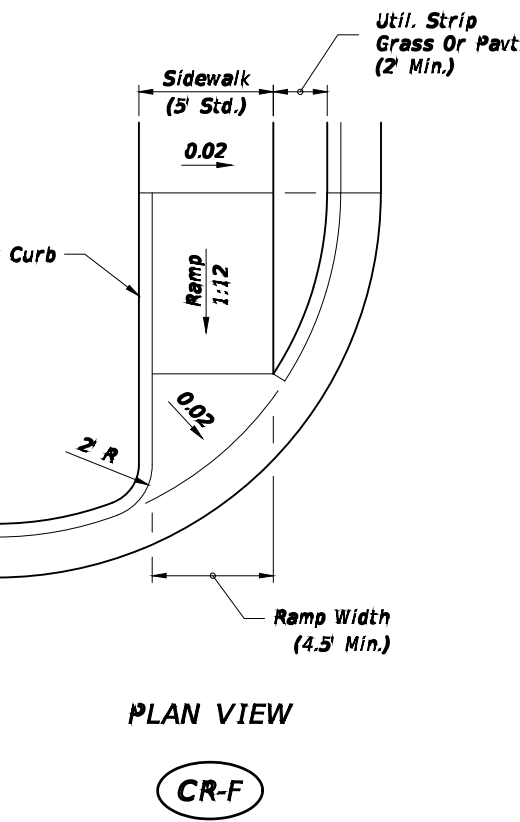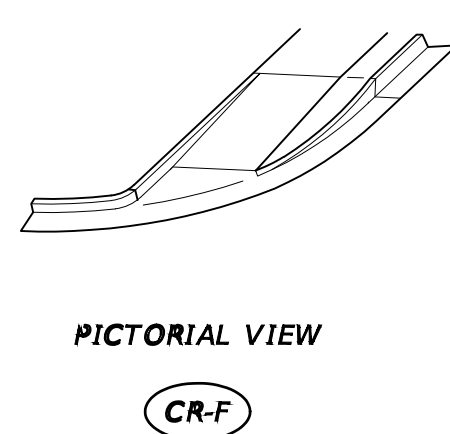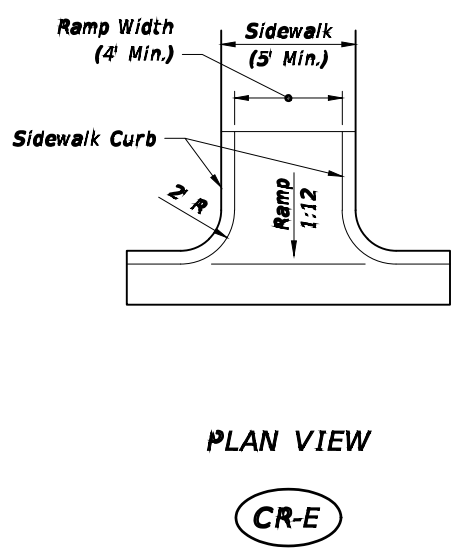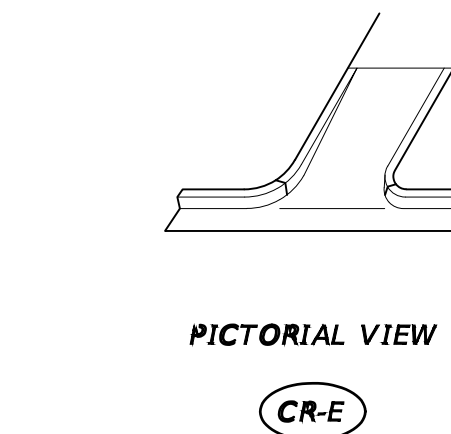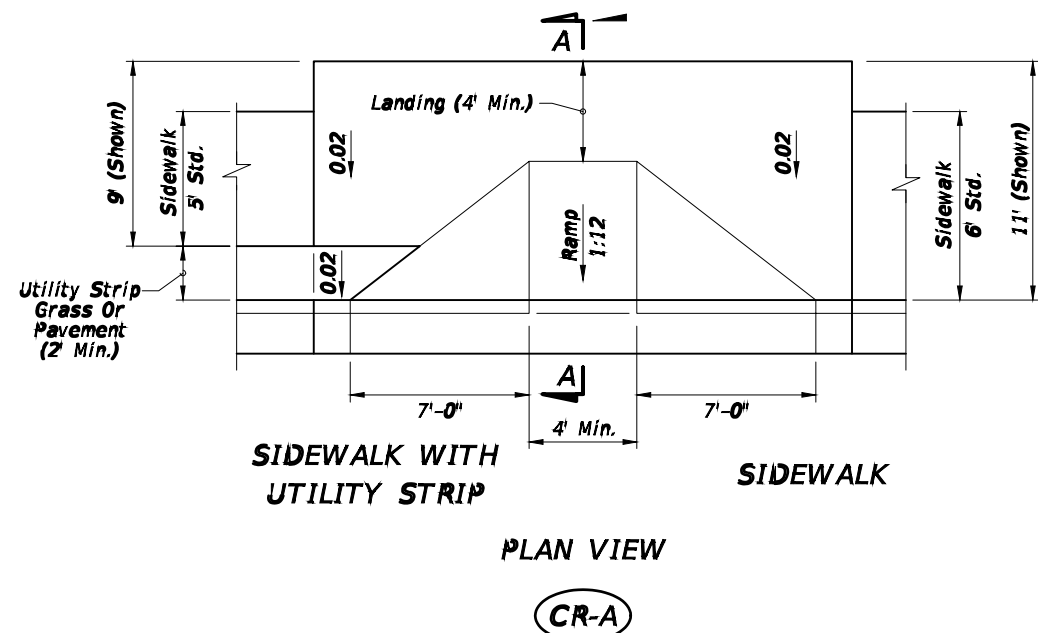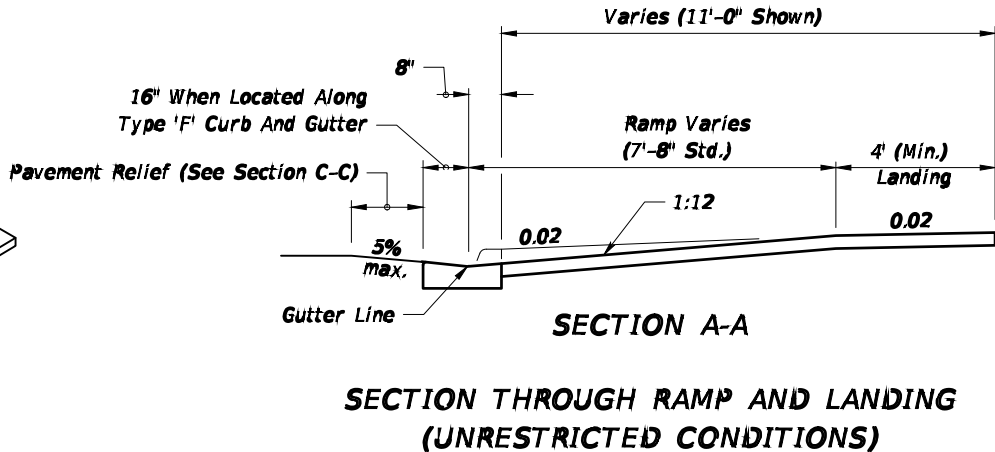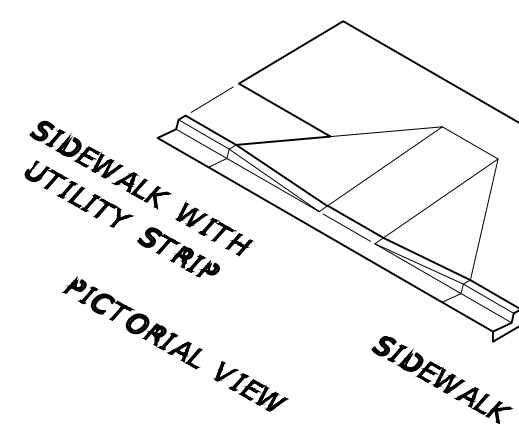

FDOT DETECTABLE WARNINGS
N.T.S.

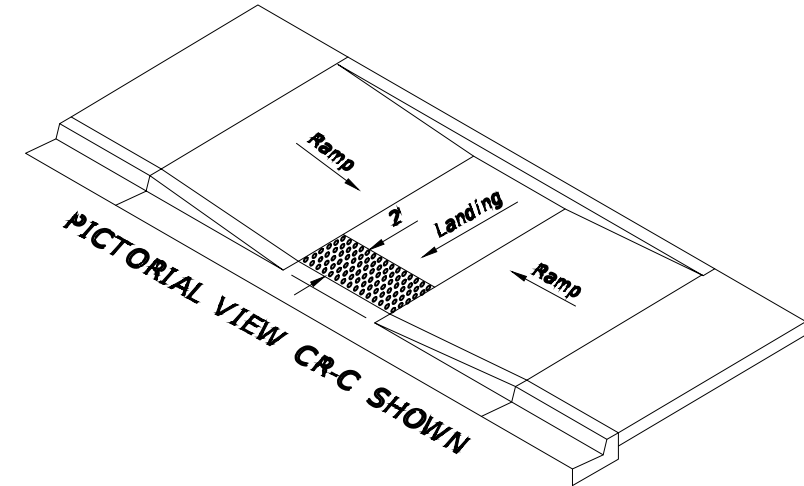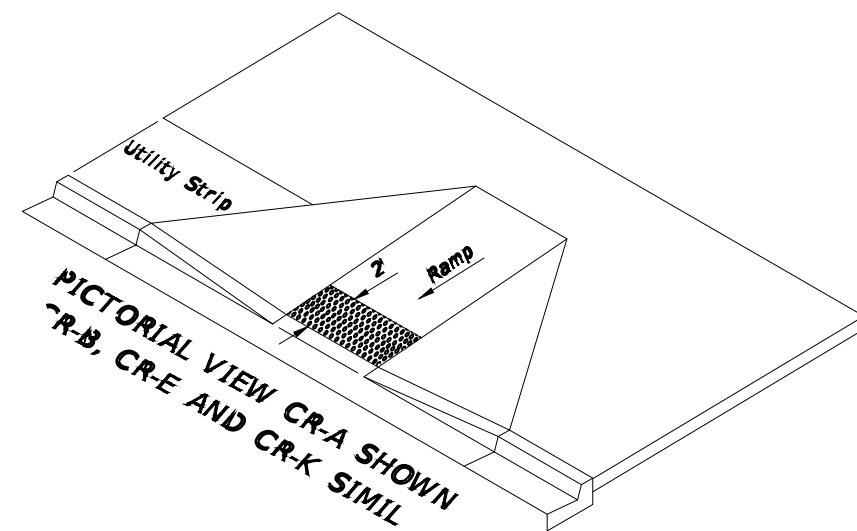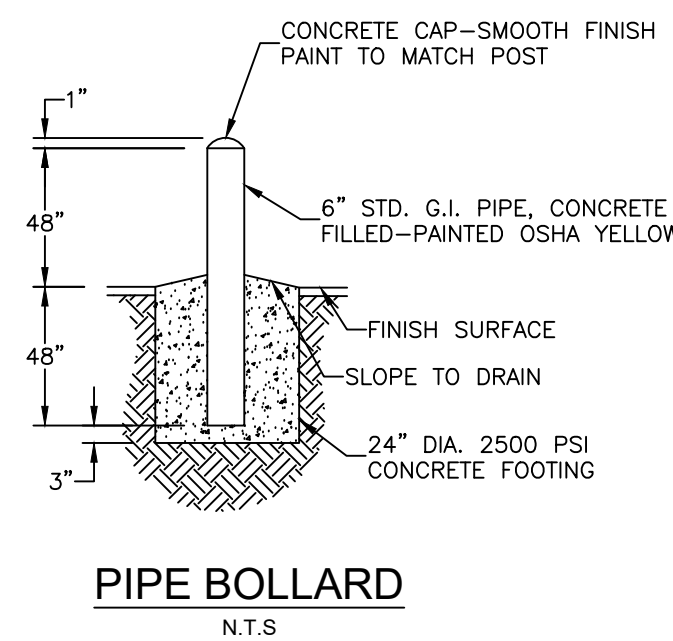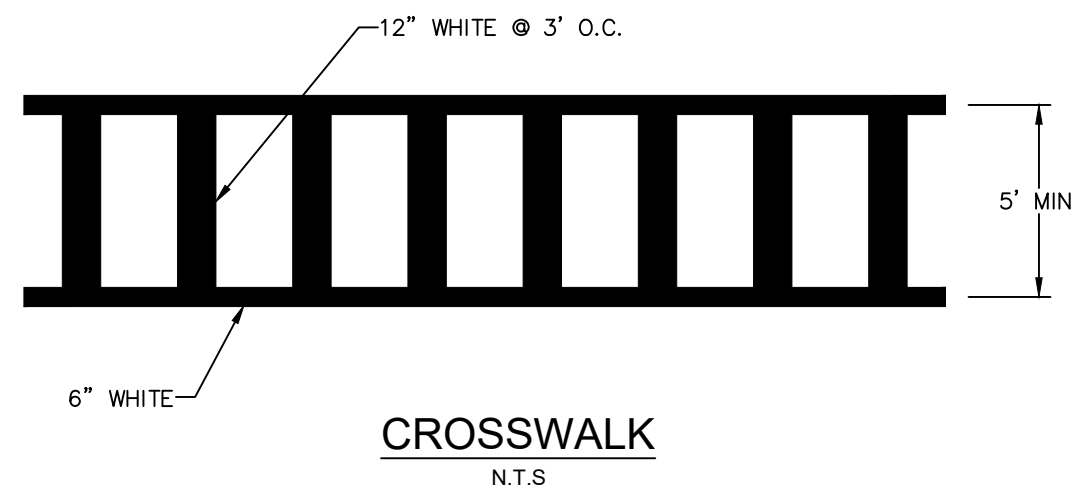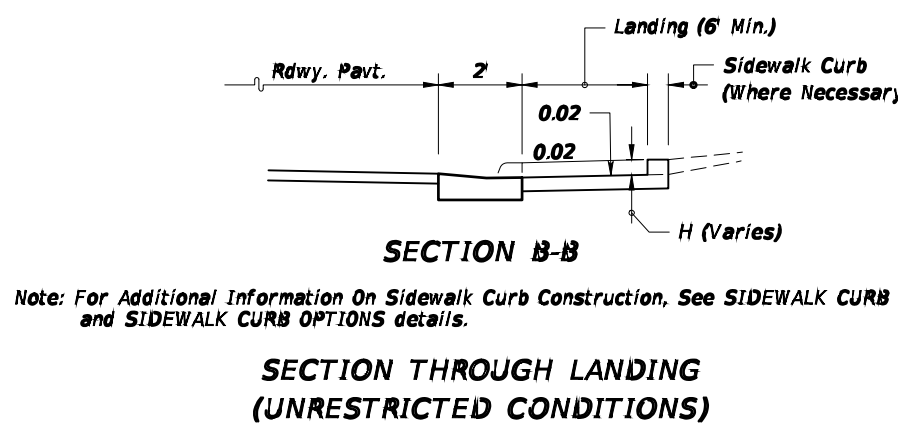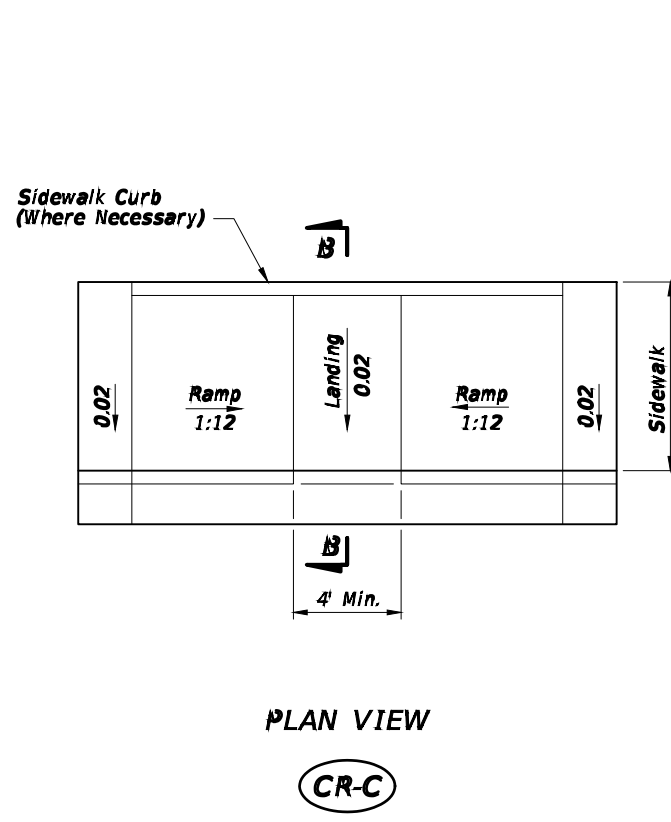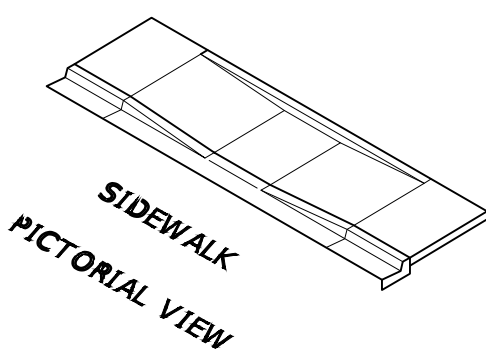

GREGORY D WILFONG

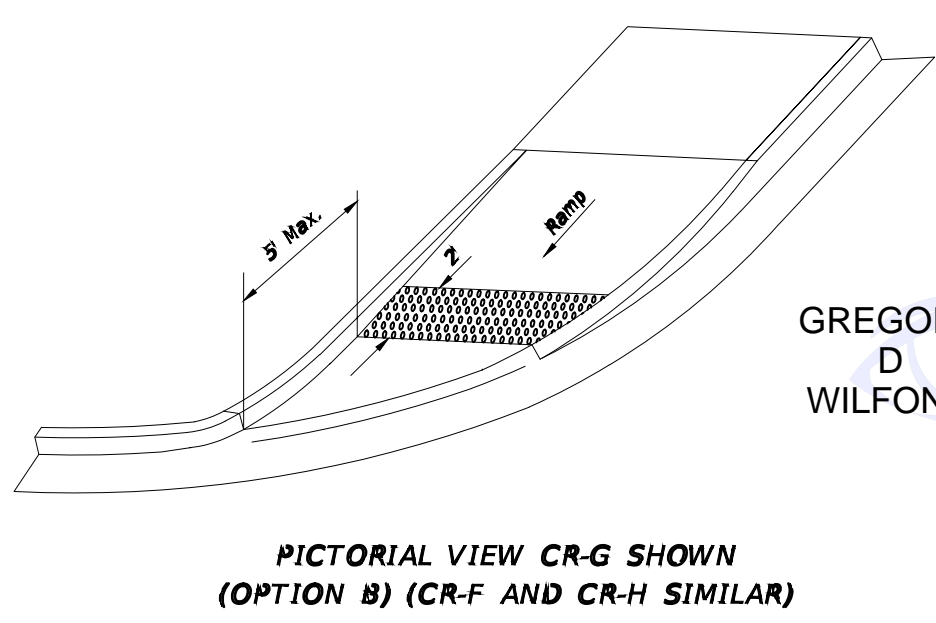

| | |
|-------------|-----------|
| KHA PROJECT | 147507131 |
| DATE | 9/3/2024 |
| SCALE | AS SHOWN |
| DESIGNED BY | SHB |
| DRAWN BY | SHB |
| CHECKED BY | GDW |

SITE DETAILS

OAKWOOD SOUTH
RETAIL SHOPPING
CENTER
CITY OF HOLLYWOOD

SHEET NUMBER
C-201

THIS ITEM HAS BEEN DIGITALLY SIGNED AND SEALED BY GREGORY D. WILFONG, P.E. ON THE DATE ADJACENT TO THE SEAL. PRINTED HEREIN FOR THE PROJECT. THIS DOCUMENT ARE NOT CONSIDERED SIGNED AND SEALED AND THE DIGITAL SIGNATURE MUST BE VERIFIED ON ANY ELECTRONIC COPIES.



TP-2000SP

Tram-Pak
Stationary Compactor


- * Retailers * Hospitals * Hotels * Distribution Centers *
- * Manufacturing Centers * Recycling Centers * Home Centers *

Our TP-2000SP (Short Profile) compactor was our response to customers battling space constrictions and those who could not accommodate a long chute. We managed to construct a twin cylinder machine with high compaction forces and an overall length of 78 inches. All components are built using heavy-duty structural steel components and welded by AWS certified technicians. This unit has total U.L. approval, standard 3 button controls, (On/Off key switch, mushroom stop, auto reverse) and a 13' Sealtite.







| Specifications | | Electrical Equipment | |
|-----------------------------|------------|----------------------------|-------------------------|
| Charge Box Capacity | 2 Cu Yd | Electrical Motor | 208 / 230 / 460 3 Phase |
| Clear Top Opening (L x W) | 40" x 60" | Electrical Control Voltage | 120 VAC |
| Capacity Per Hour | 58.7 cy/hr | | |
| Performance Characteristics | | Hydraulic Equipment | |
| Cycle Time | 31 sec | Hydraulic Pump Capacity | 10.5 gpm |
| Total Normal Force | 43,000 lbs | Normal Pressure | 2000 psi |
| Total Maximum Force | 51,600 lbs | Maximum Pressure | 2400 psi |
| Normal Ram Face Pressure | 23 psi | Hydraulic Cylinder | 4" Bore |
| Maximum Ram Face Pressure | 29 psi | Hydraulic Cylinder | 2.5" Rod |
| | | Weight | 4,500 lbs |




BAILER AND COMPACTOR
(SUBJECT TO CHANGE BY OWNER)
N.T.S.

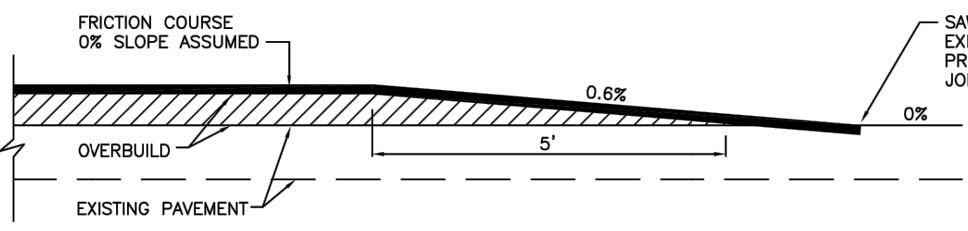


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| ISSUED: MAY 2023 | DEPARTMENT OF DEVELOPMENT SERVICES ENGINEERING, TRANSPORTATION & MOBILITY DIVISION | REVISED: - |
| DRAWN: EG | FEATHERING DETAIL | DRAWING NO.: C-29 |
| APPROVED: JG | | |

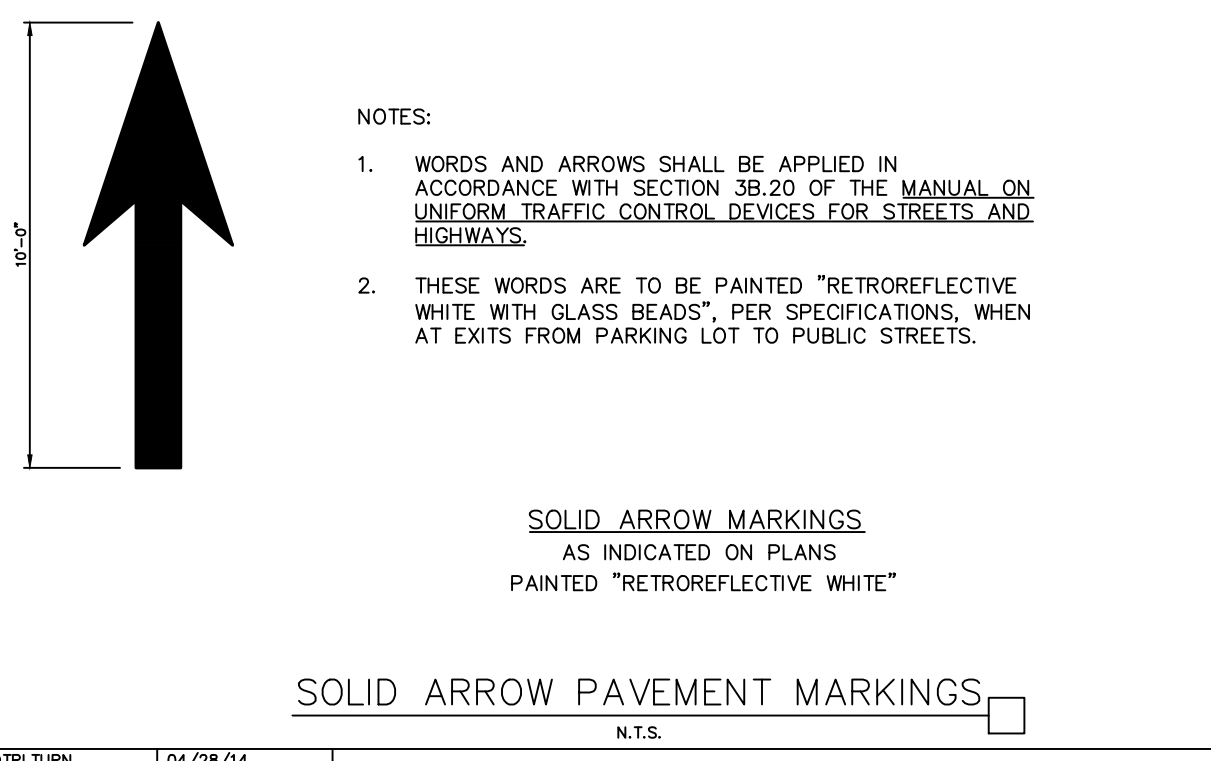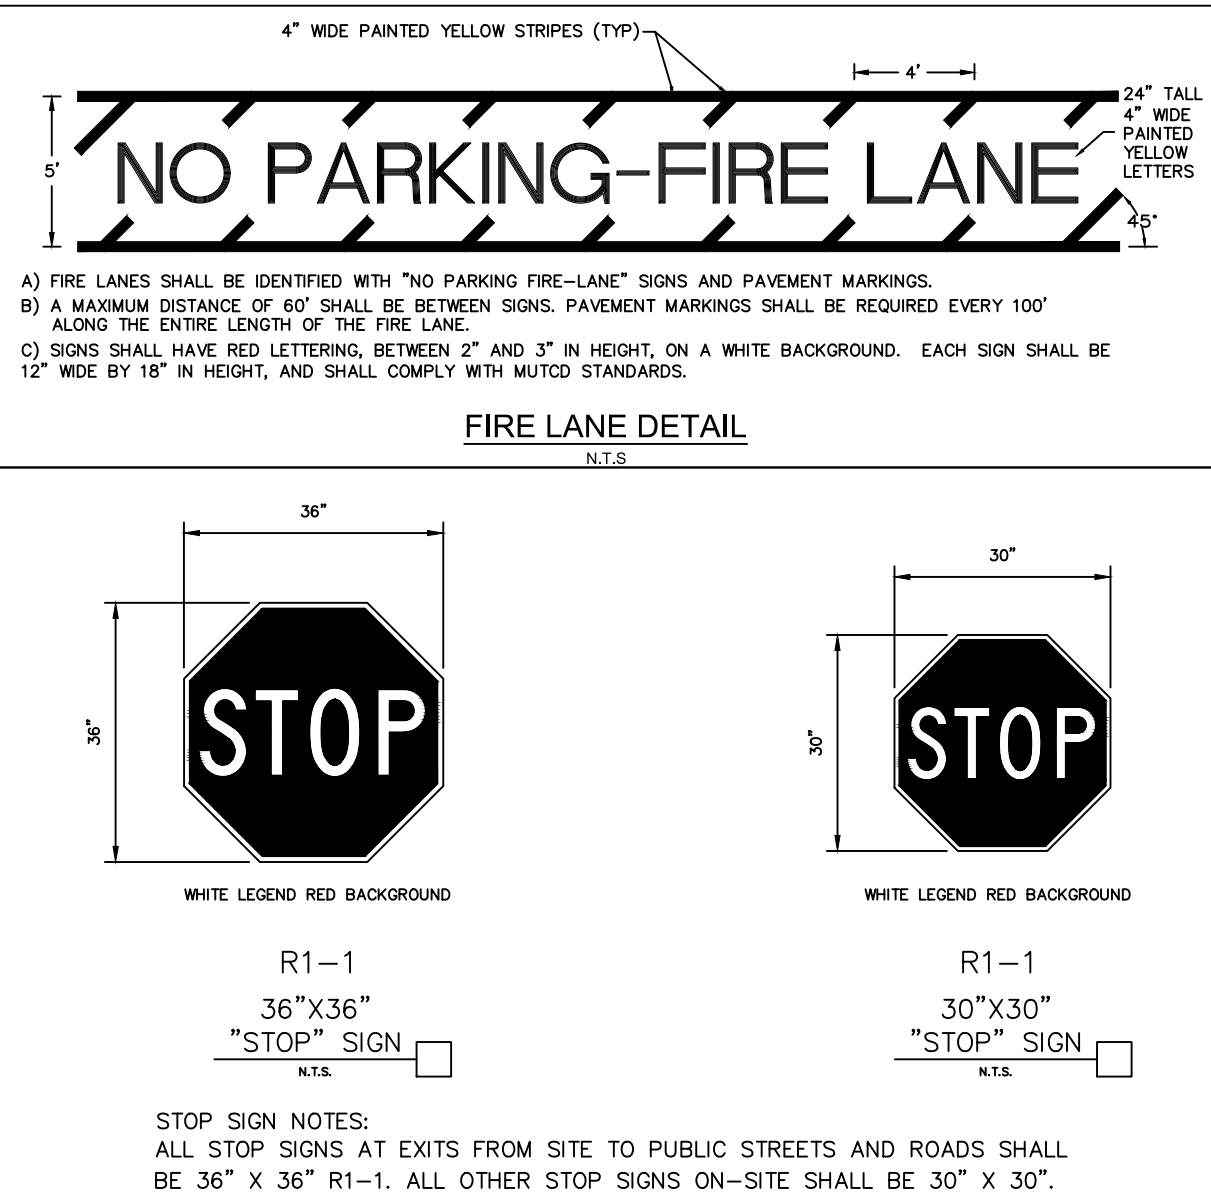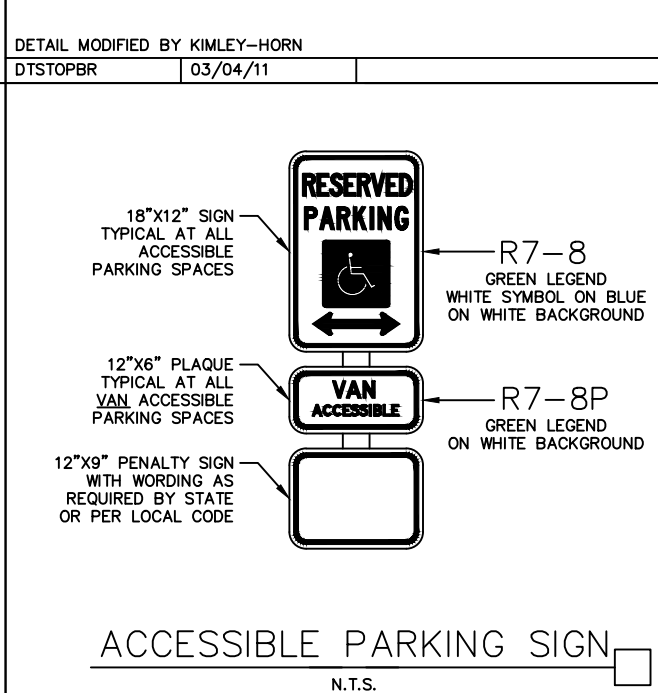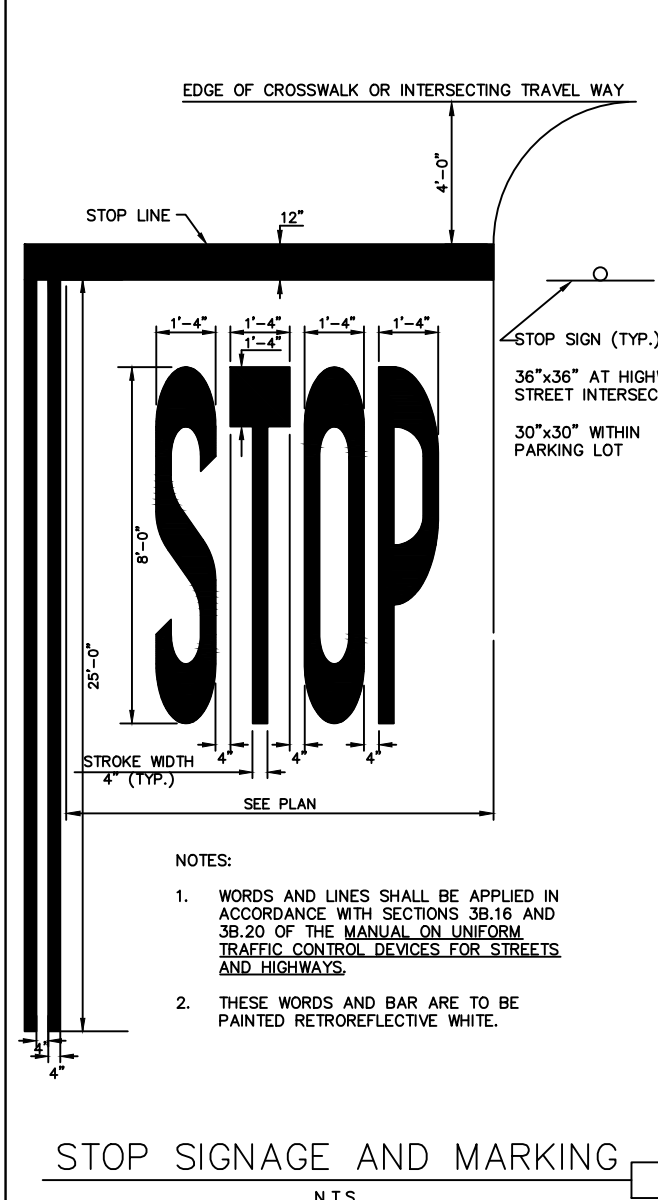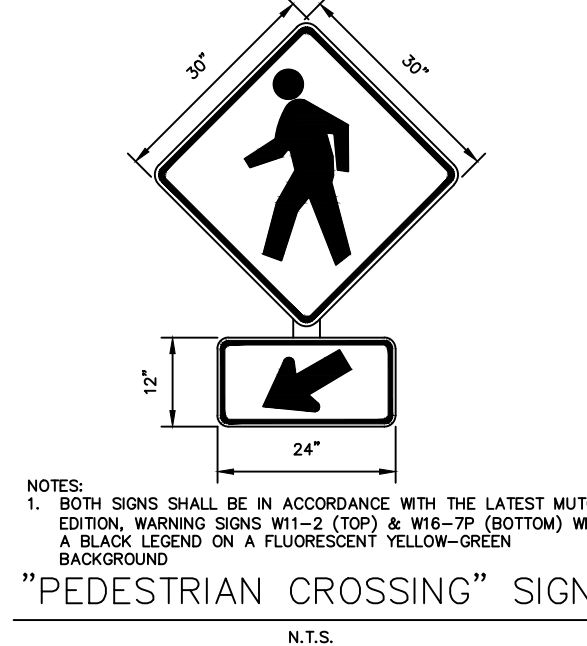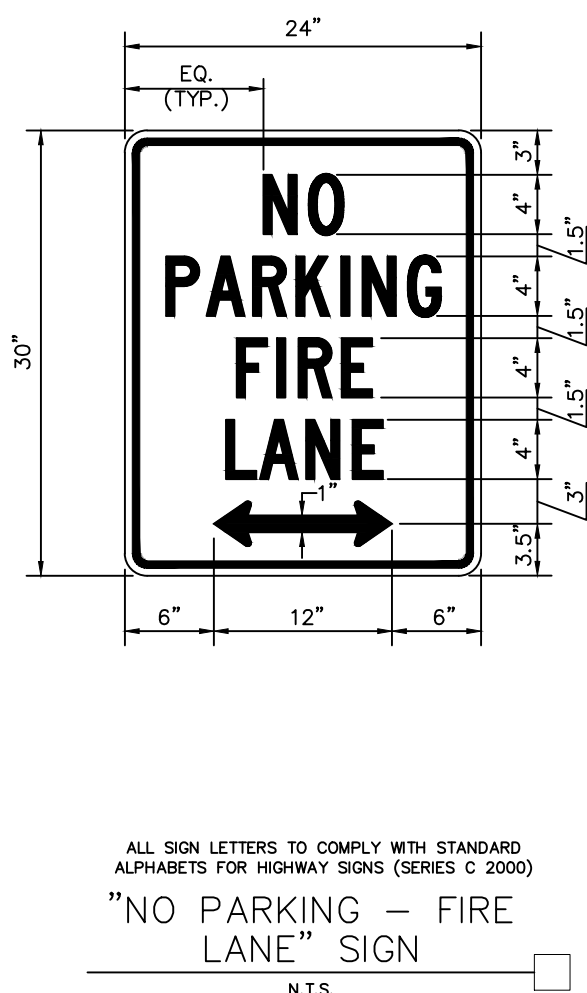


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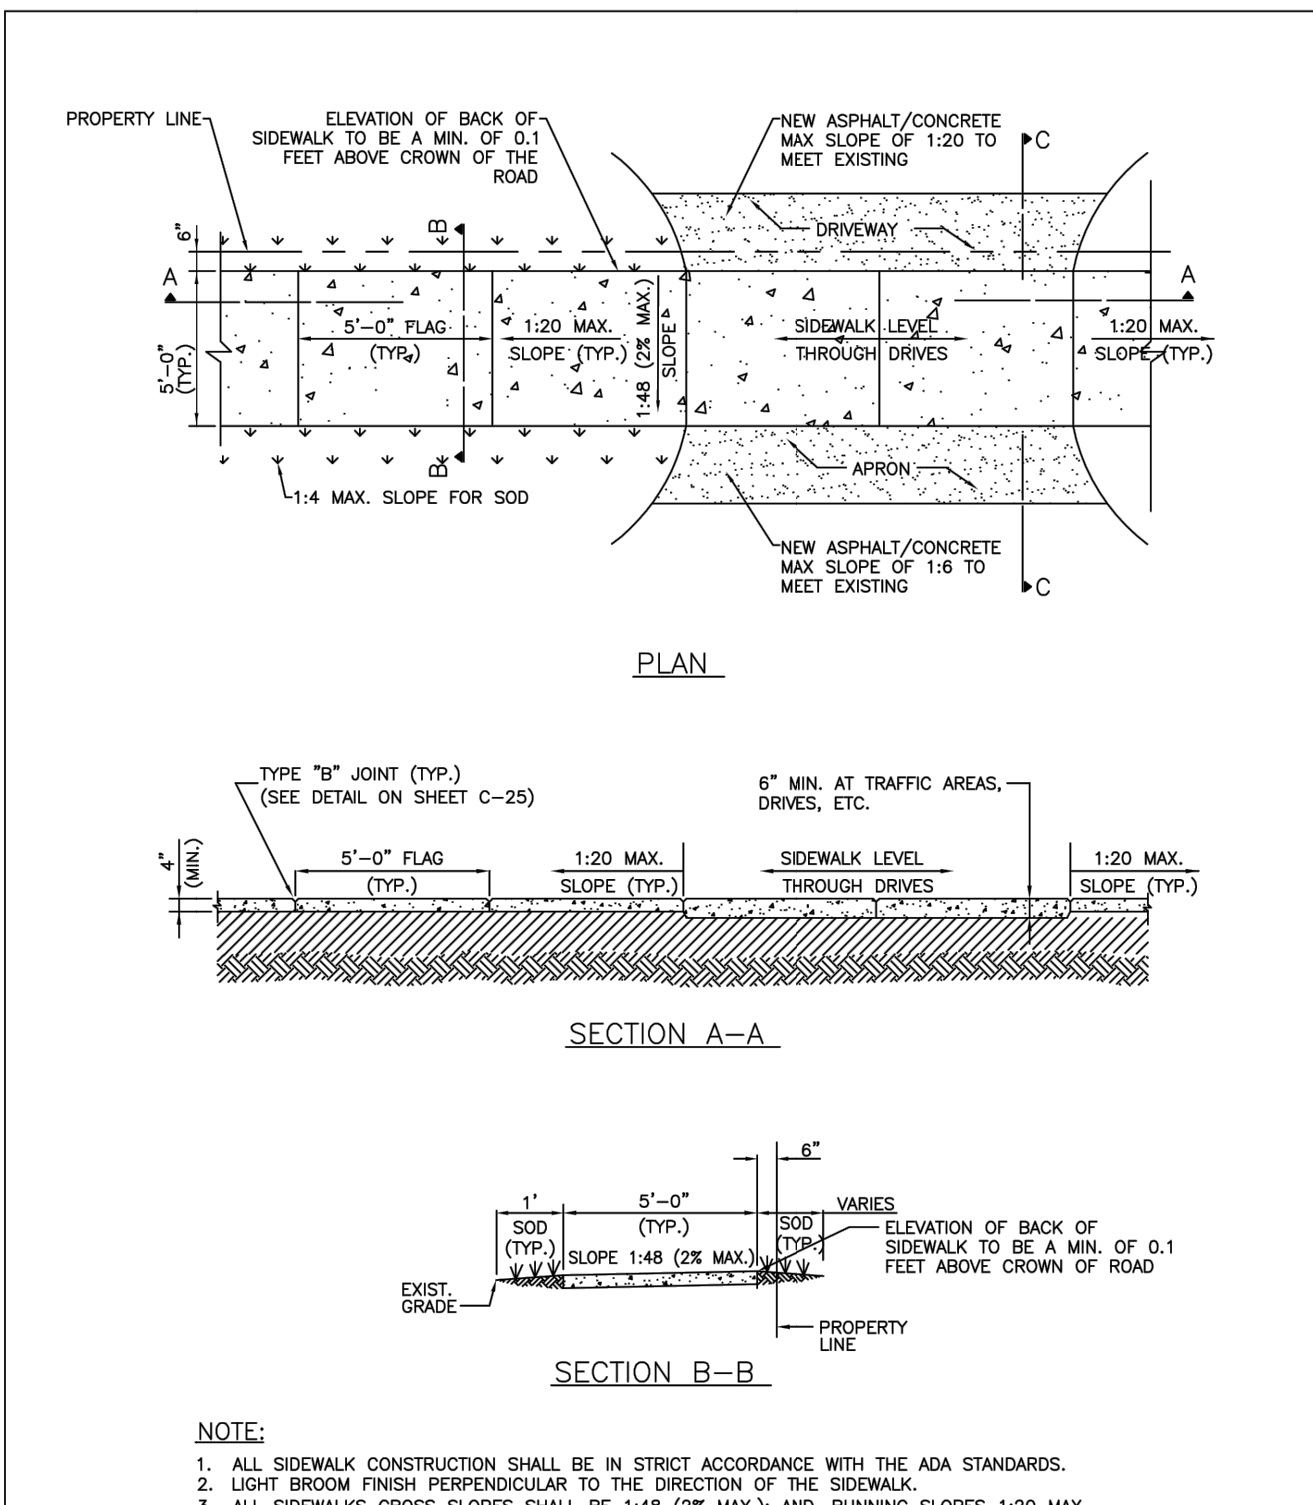
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| ISSUED: MAY 2023 | DEPARTMENT OF DEVELOPMENT SERVICES ENGINEERING, TRANSPORTATION & MOBILITY DIVISION | REVISED: - |
| DRAWN: EG | PARKING LOT EXIT-ENTRANCE DETAIL | DRAWING NO.: |
| APPROVED: JG | | C-20 |

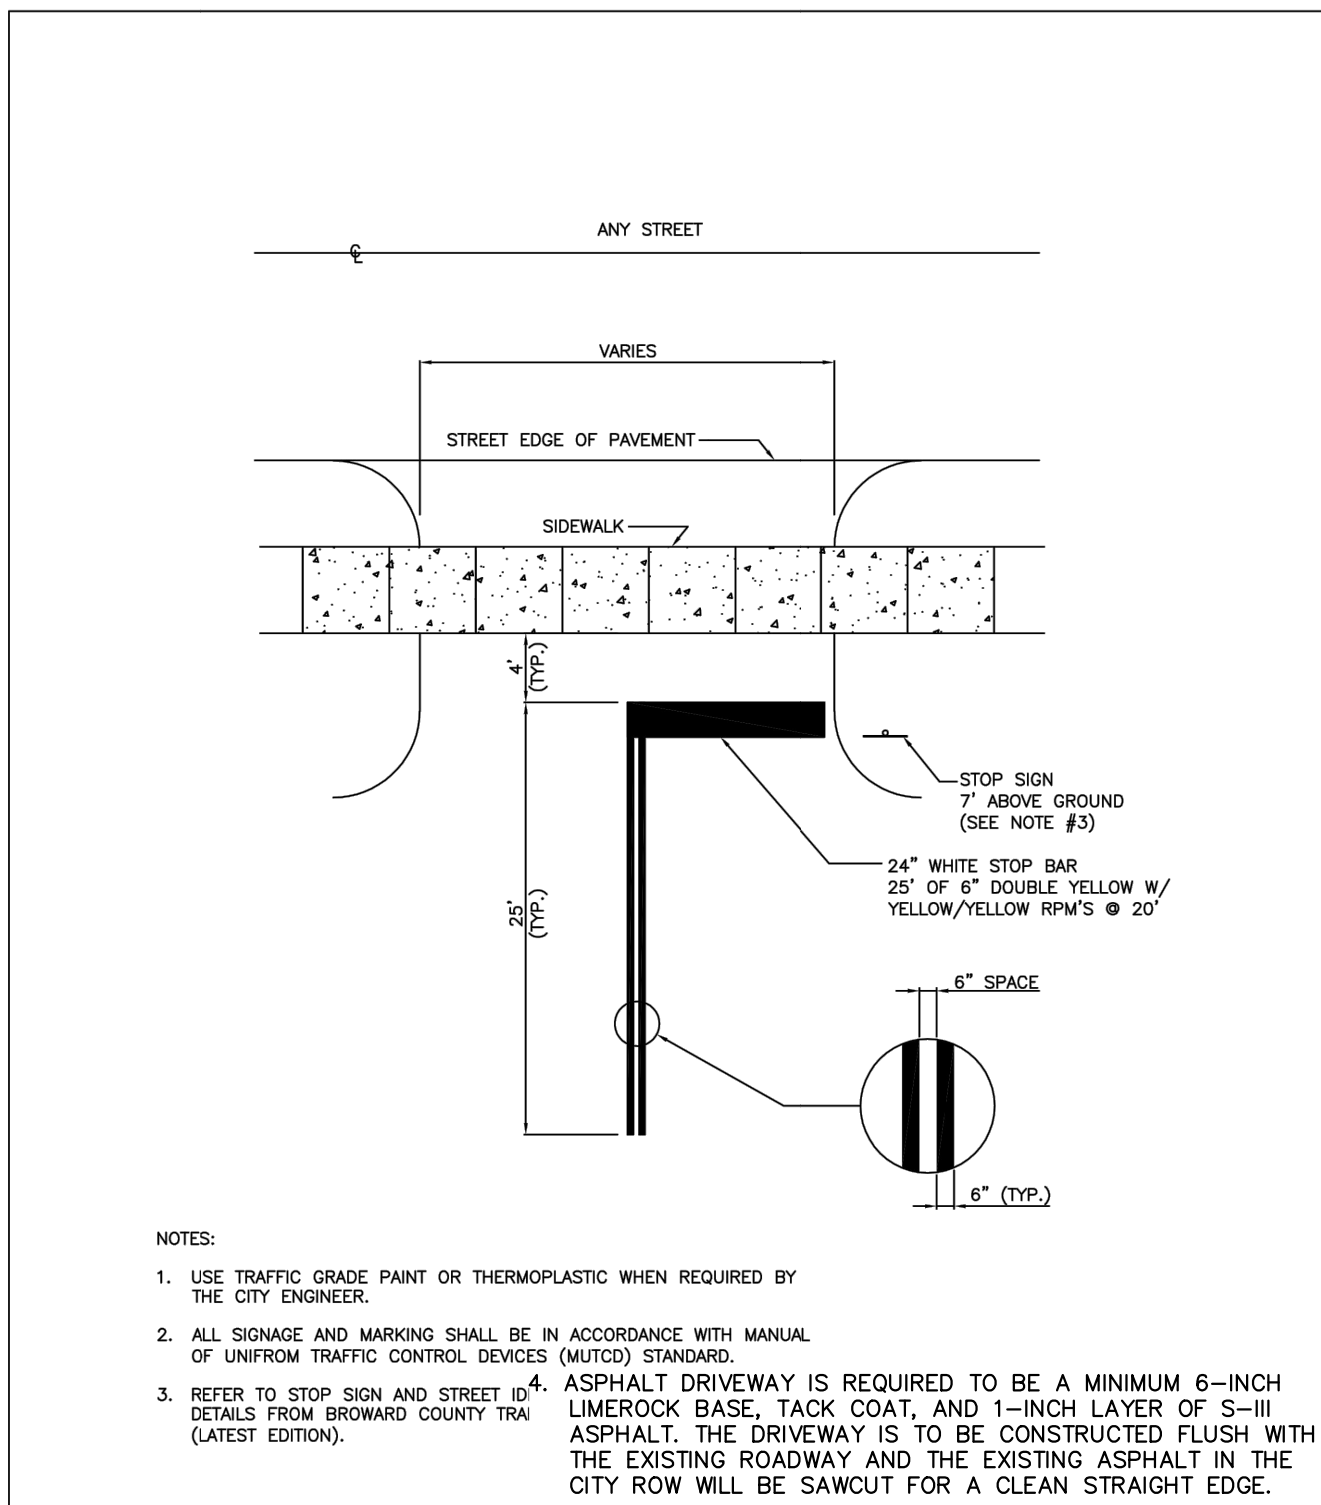


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| ISSUED: MAY 2023 | DEPARTMENT OF DEVELOPMENT SERVICES ENGINEERING, TRANSPORTATION & MOBILITY DIVISION | REVISED: - |
| DRAWN: EG | ACCESSIBLE PARKING SPACE DETAILS (1 OF 2) | DRAWING NO.: |
| APPROVED: JG | | C-21A |

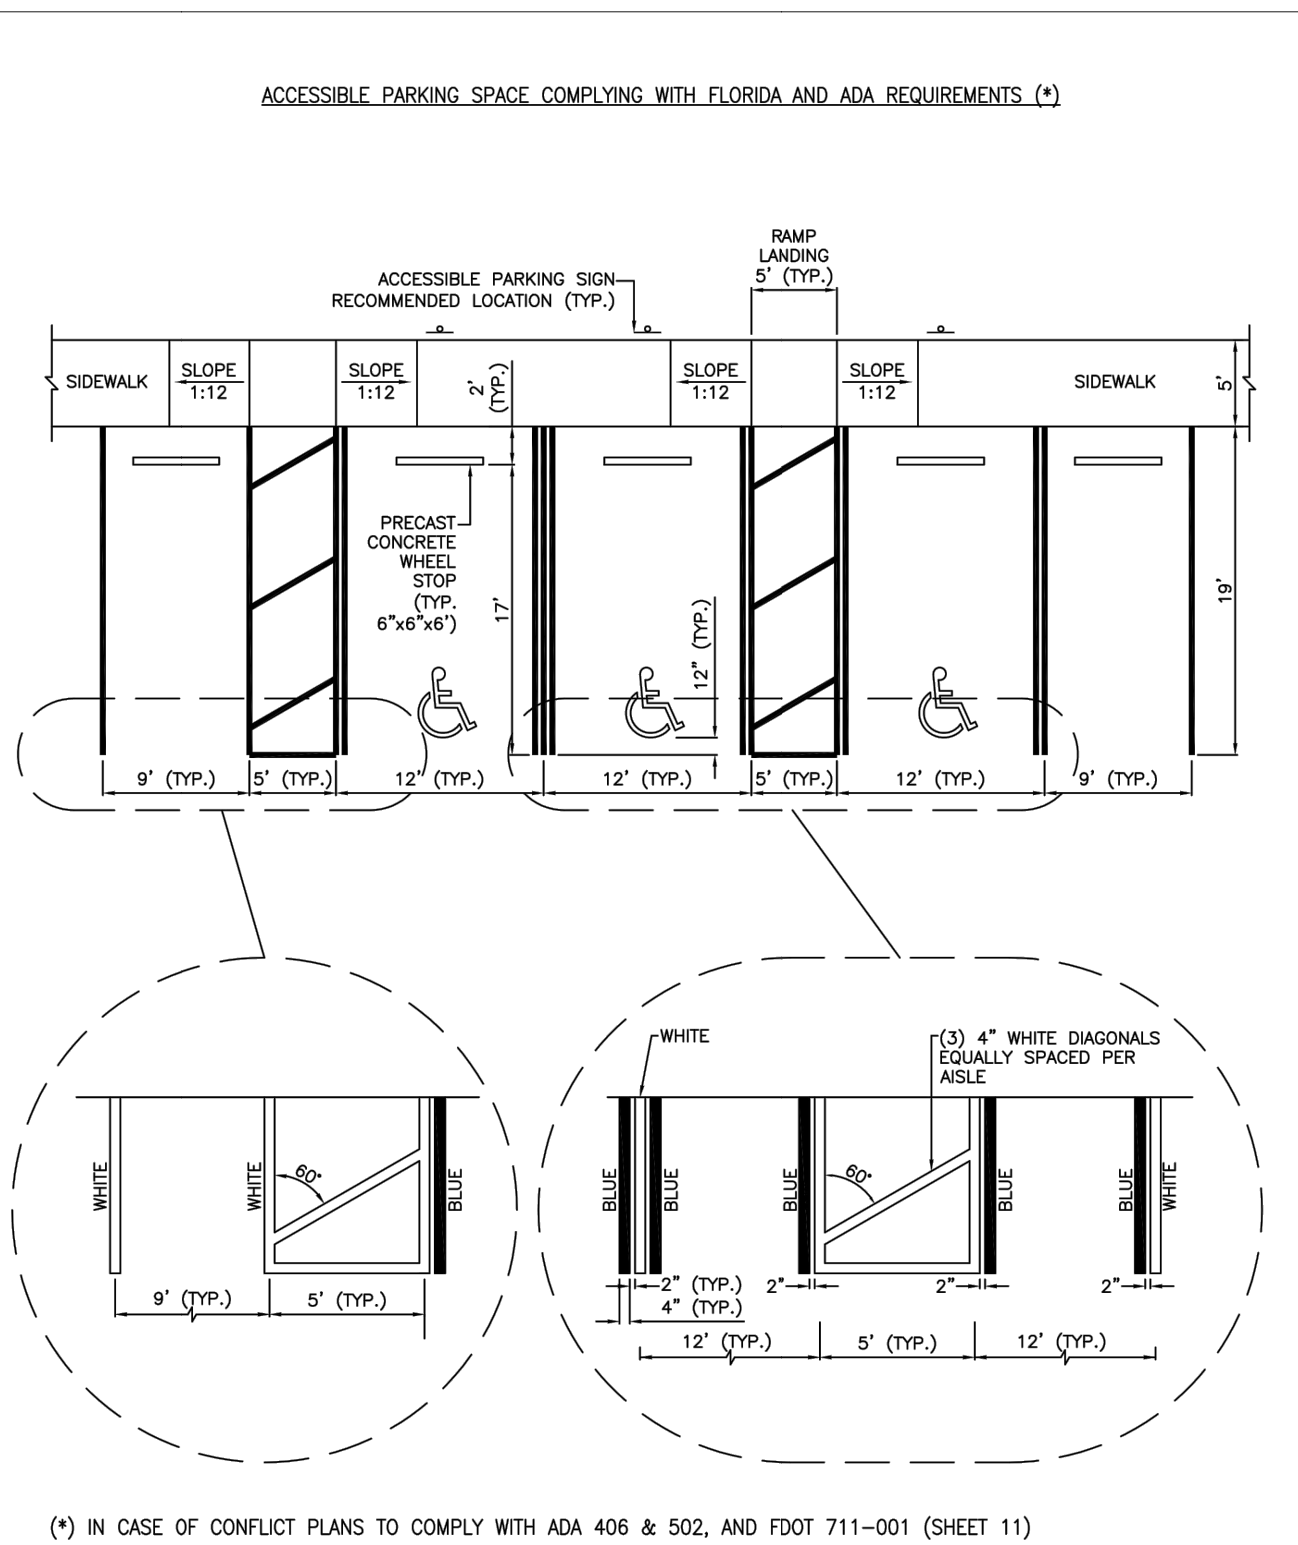


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| ISSUED: MAY 2023 | DEPARTMENT OF DEVELOPMENT SERVICES ENGINEERING, TRANSPORTATION & MOBILITY DIVISION | REVISED: - |
| DRAWN: EG | ACCESSIBLE PARKING SPACE DETAILS (2 OF 2) | DRAWING NO.: |
| APPROVED: JG | | C-21B |

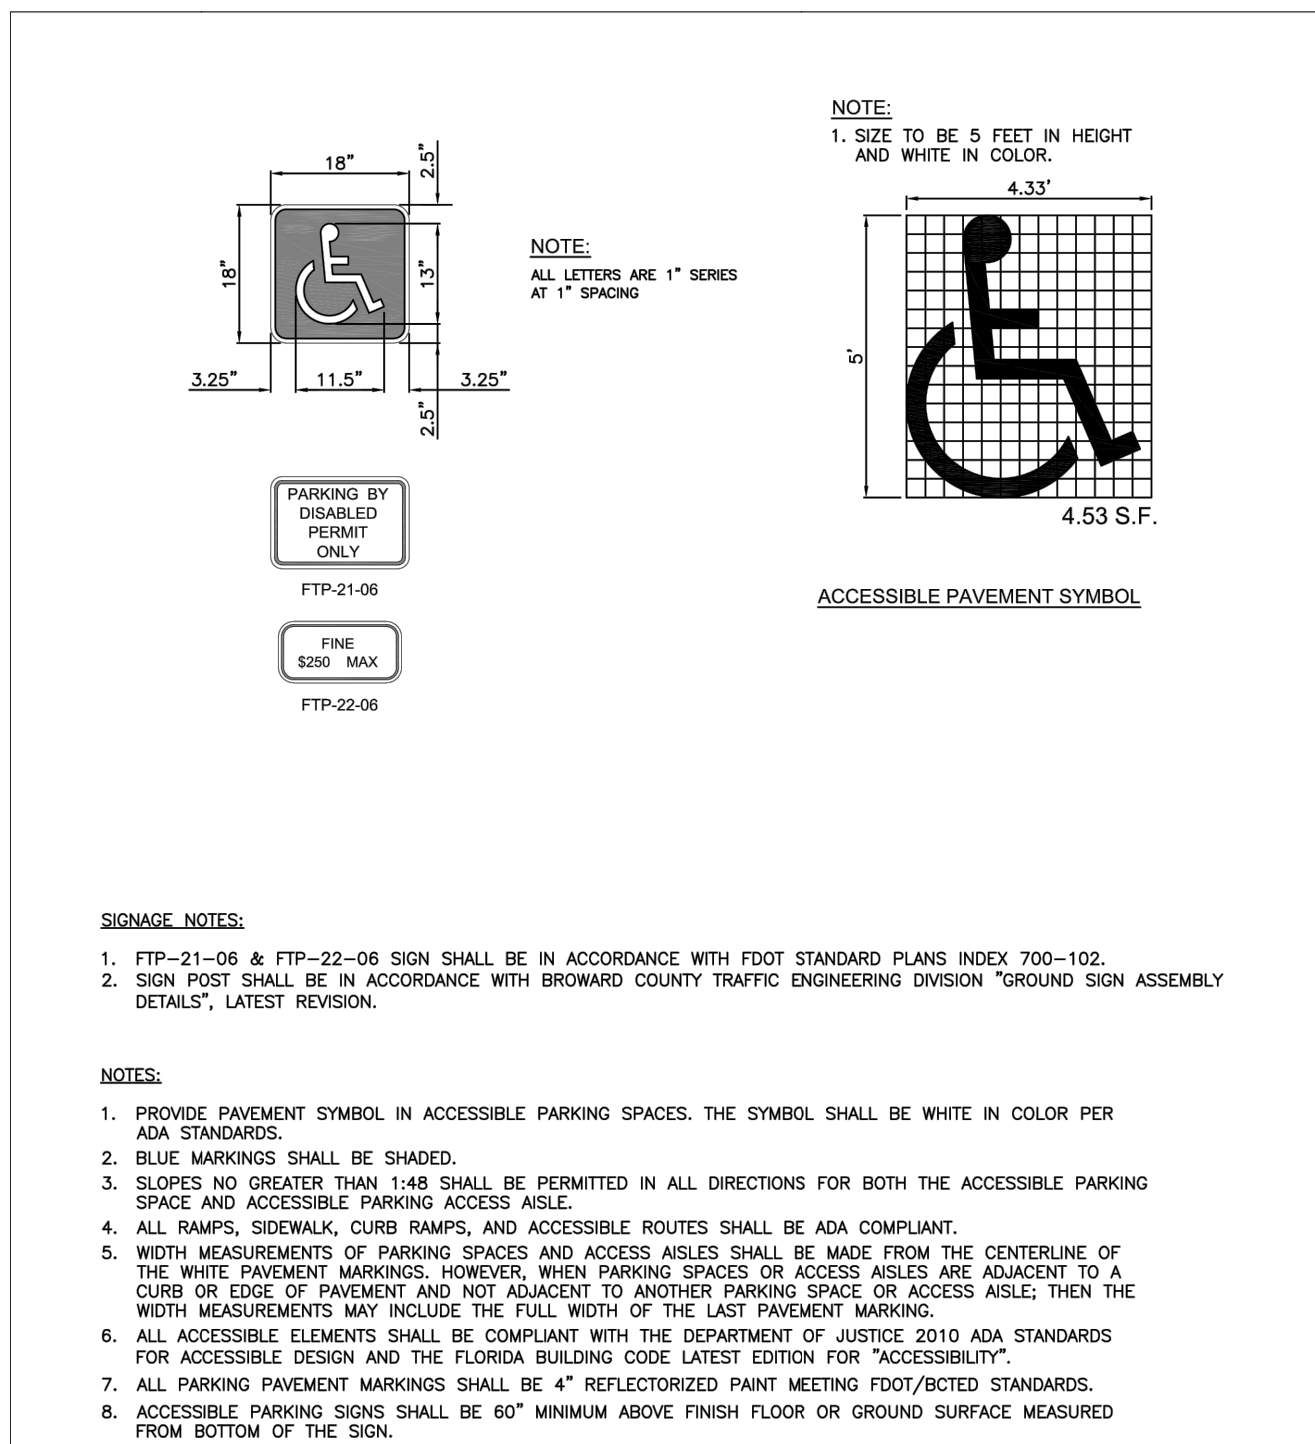


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| ISSUED: MAY 2023 | DEPARTMENT OF DEVELOPMENT SERVICES ENGINEERING, TRANSPORTATION & MOBILITY DIVISION | REVISED: - |
| DRAWN: EG | SIDEWALK CONSTRUCTION DETAILS (1 OF 3) | DRAWING NO.: |
| APPROVED: JG | | C-23 |

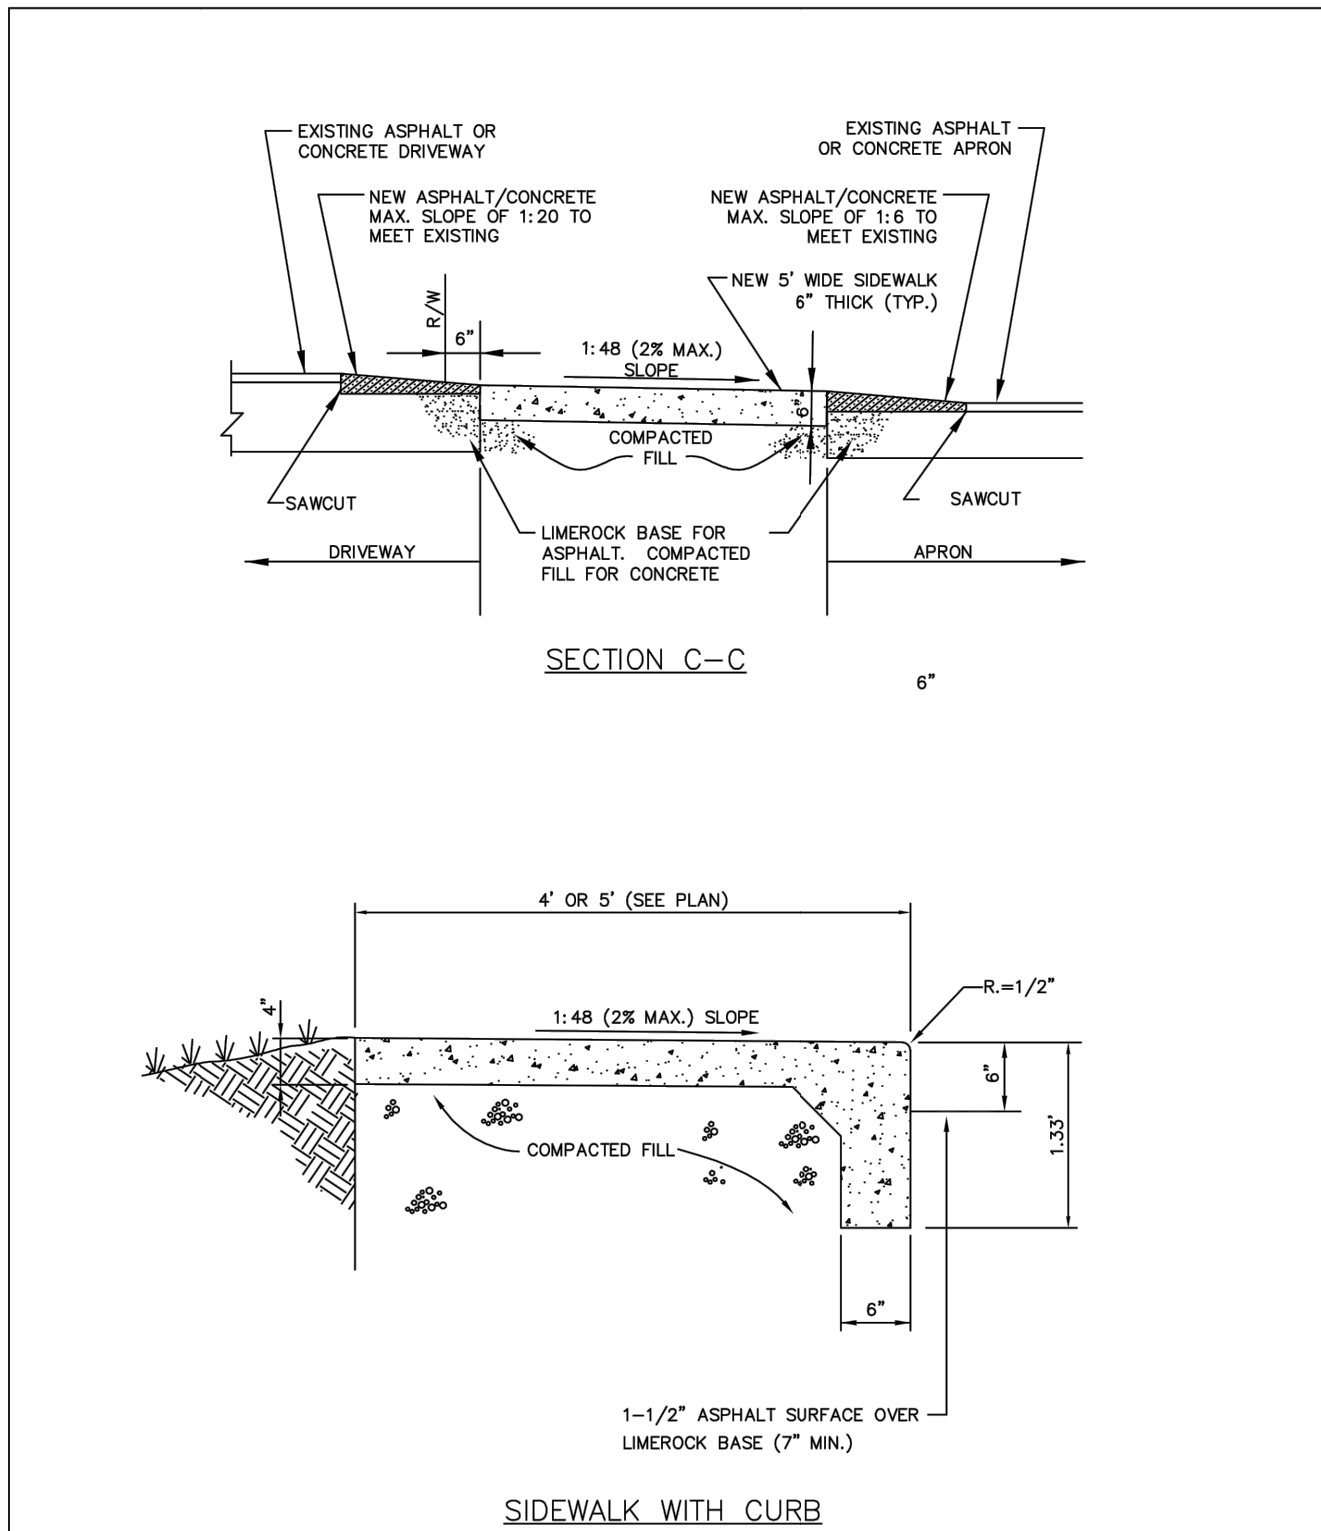


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| DRAWN: EG | SIDEWALK CONSTRUCTION DETAILS (2 OF 3) | DRAWING NO.: |
| APPROVED: JG | | C-24 |

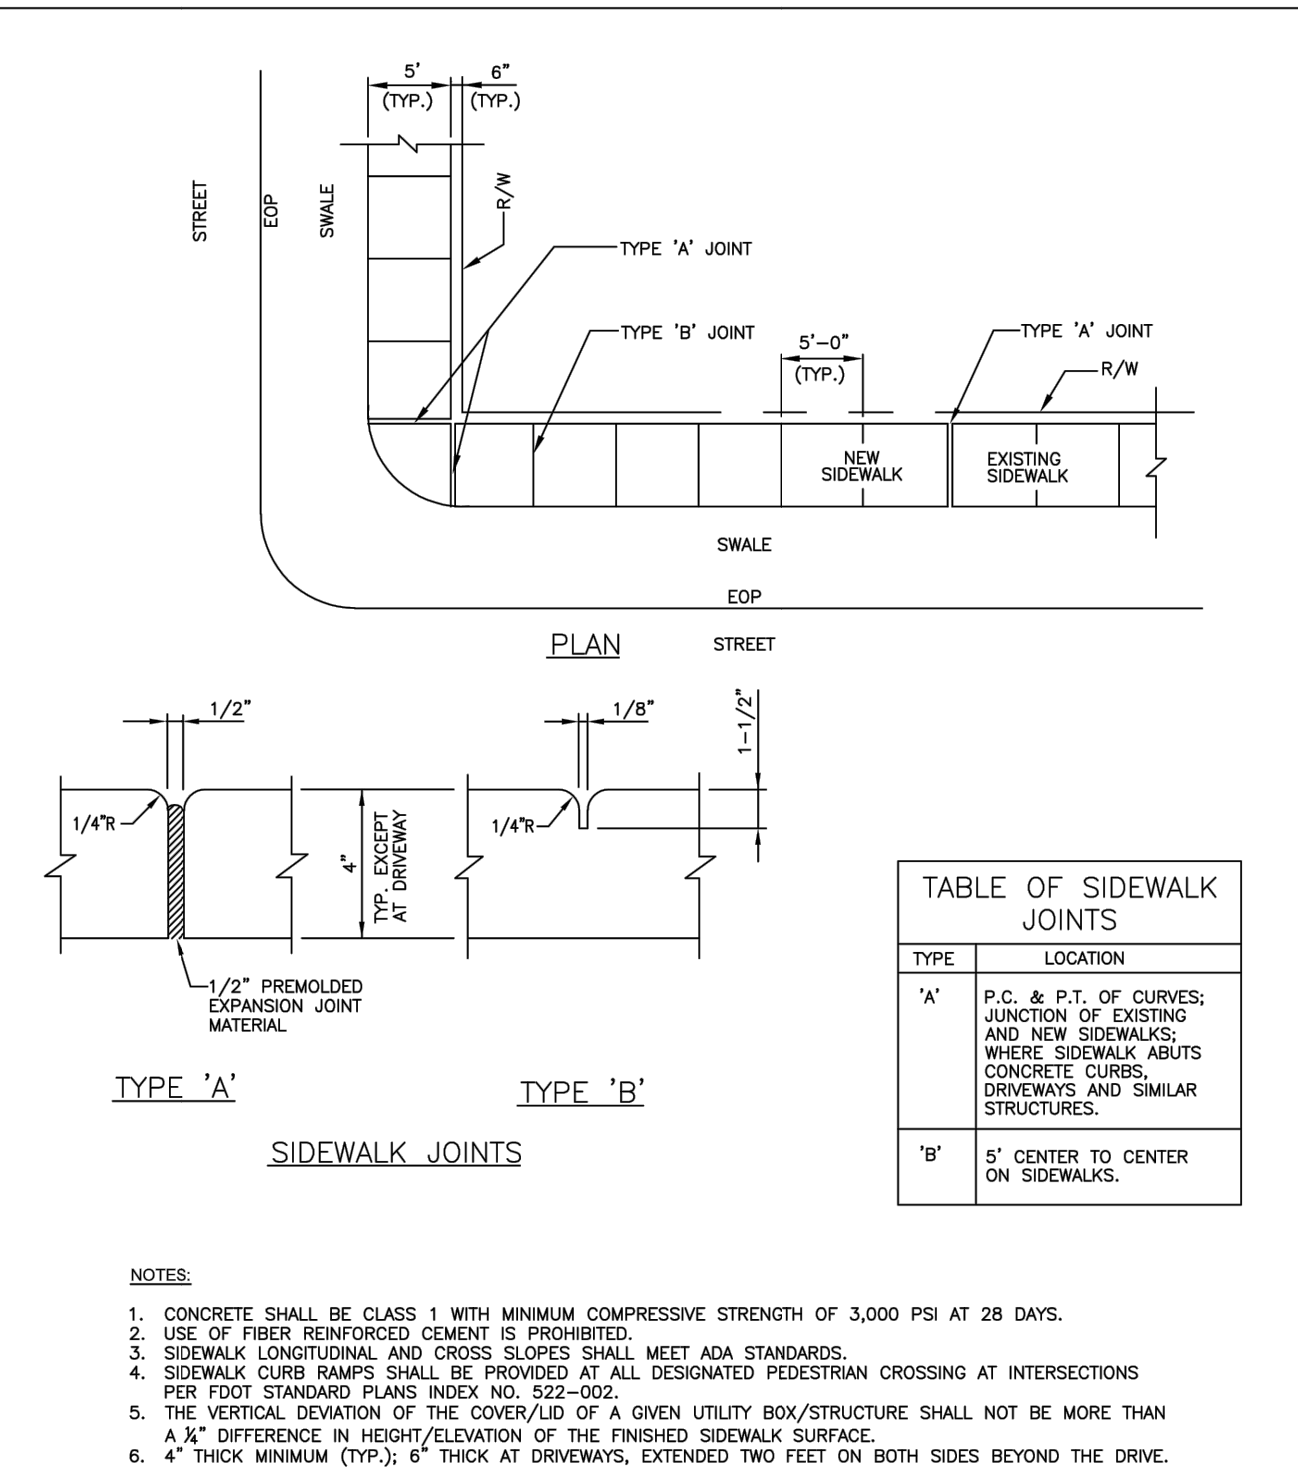

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| ISSUED: MAY 2023 | DEPARTMENT OF DEVELOPMENT SERVICES ENGINEERING, TRANSPORTATION & MOBILITY DIVISION | REVISED: - |
| DRAWN: EG | SIDEWALK CONSTRUCTION DETAILS (3 OF 3) | DRAWING NO.: |
| APPROVED: JG | | C-25 |

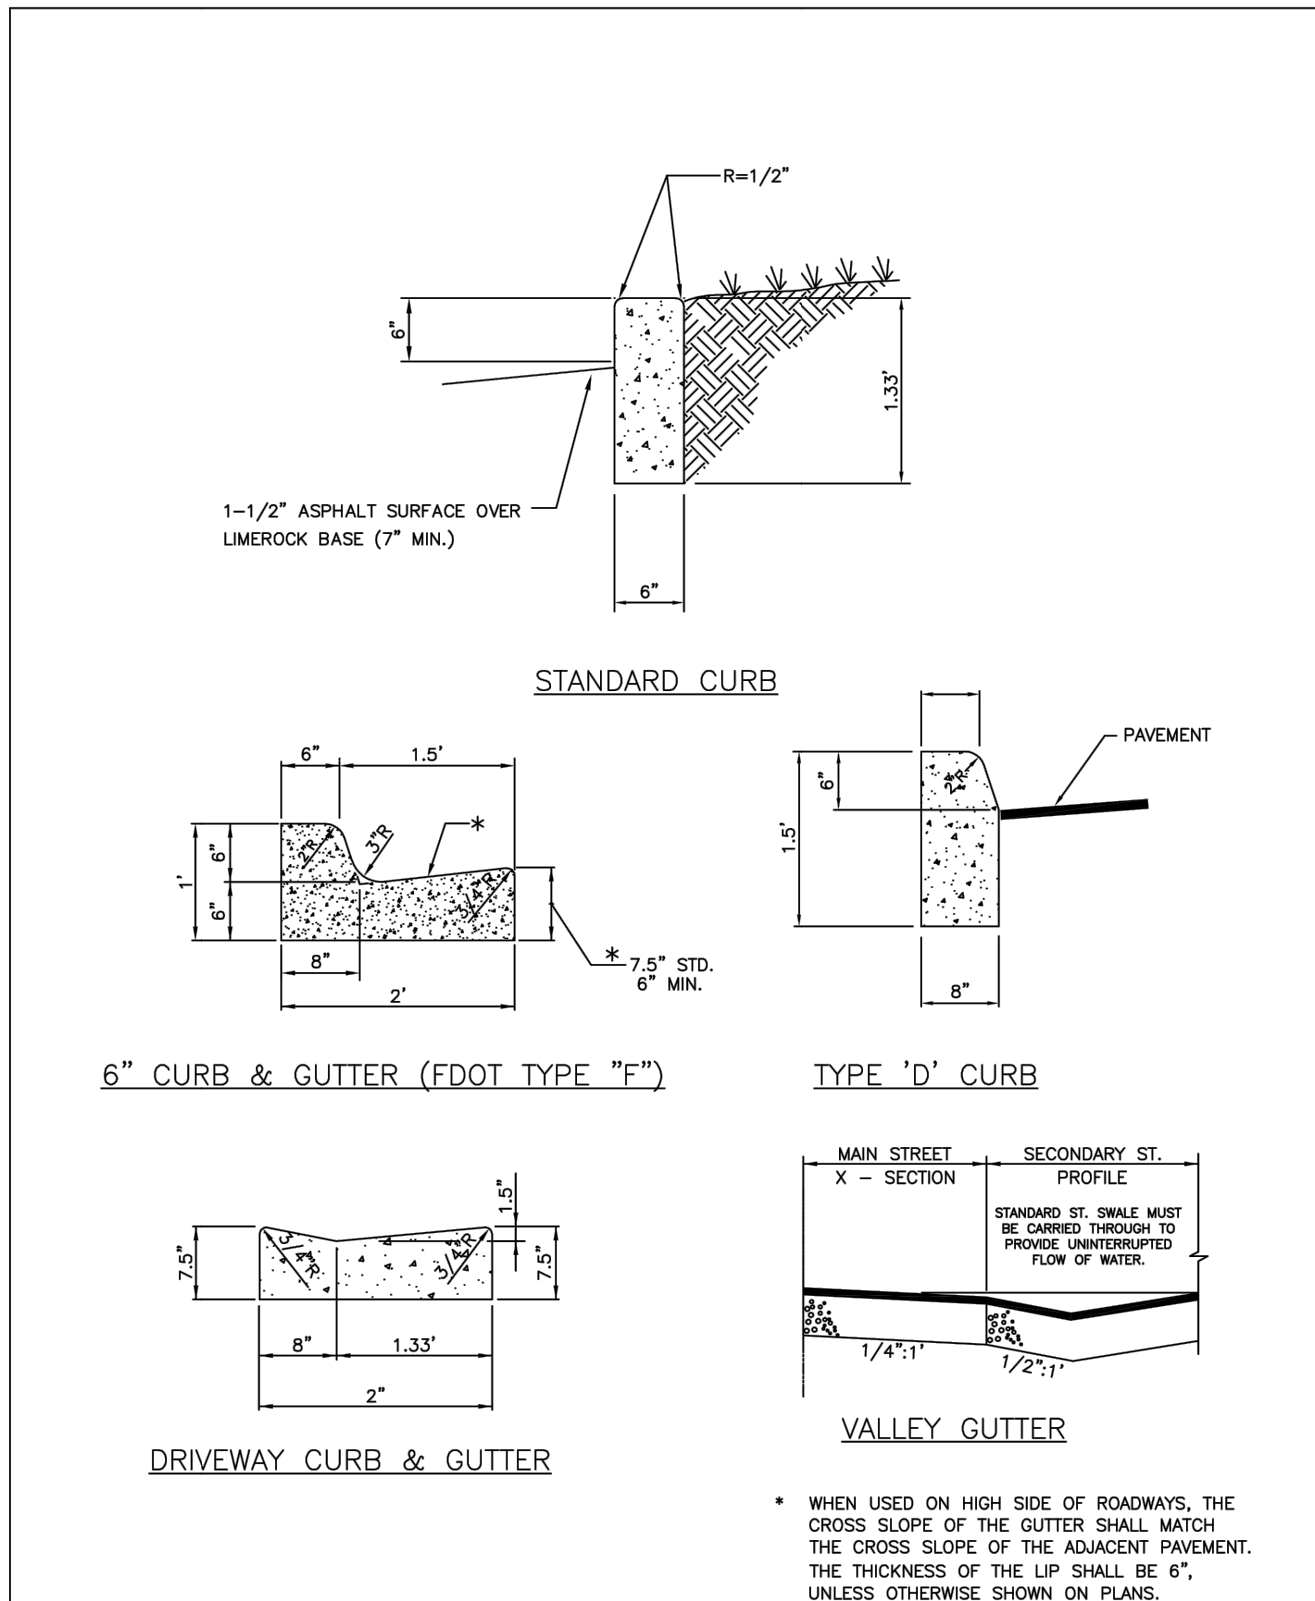

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|------------------|---|--------------|
| ISSUED: MAY 2023 | DEPARTMENT OF DEVELOPMENT SERVICES ENGINEERING, TRANSPORTATION & MOBILITY DIVISION | REVISED: - |
| DRAWN: EG | CURB AND GUTTER DETAILS | DRAWING NO.: |
| APPROVED: JG | | C-26 |

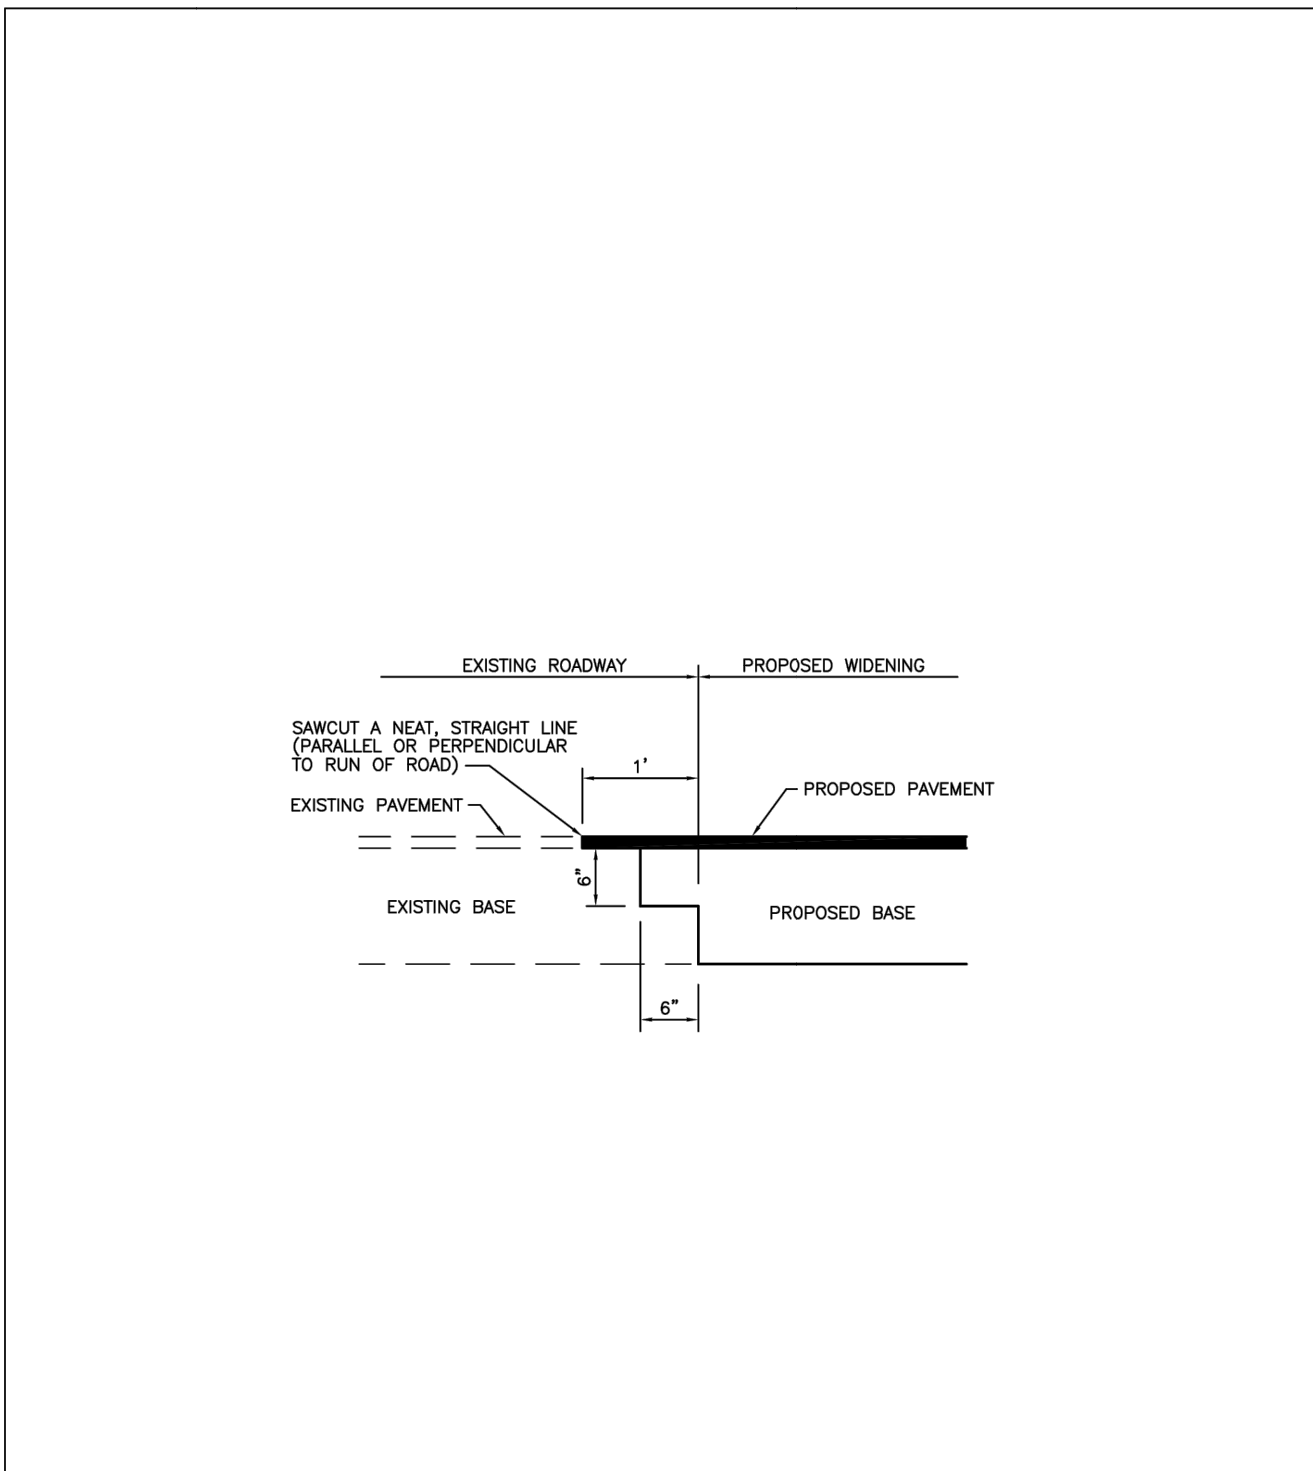

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| ISSUED: MAY 2023 | DEPARTMENT OF DEVELOPMENT SERVICES ENGINEERING, TRANSPORTATION & MOBILITY DIVISION | REVISED: - |
| DRAWN: EG | SAWCUT DETAIL | DRAWING NO.: |
| APPROVED: JG | | C-28 |

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| No. | REVISIONS | DATE | BY |
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445 24TH STREET, SUITE 200, VERO BEACH, FL 32960
PHONE: 772-794-4100
WWW.KIMLEY-HORN.COM REGISTRY NO. 35106

Digitally signed by
GREGORY D. WILFONG
DN: cn=GREGORY D.
WILFONG, o=KIMLEY-HORN
ASSOCIATES, email=greg.wilfong@kimley-horn.com, c=US
Date: 2024.05.04 14:00:44-0400


GREGORY D. WILFONG
FLORIDA PROFESSIONAL ENGINEER
No. 63166

| | | | | | |
|--------------------------|------------------|-------------------|--------------------|-----------------|-------------------|
| KHA PROJECT 147507131 | DATE 9/3/2024 | SCALE AS SHOWN | DESIGNED BY SHB | DRAWN BY SHB | CHECKED BY GDW |
|--------------------------|------------------|-------------------|--------------------|-----------------|-------------------|


**OAKWOOD SOUTH
RETAIL SHOPPING
CENTER**

CITY OF HOLLYWOOD

SITE DETAILS

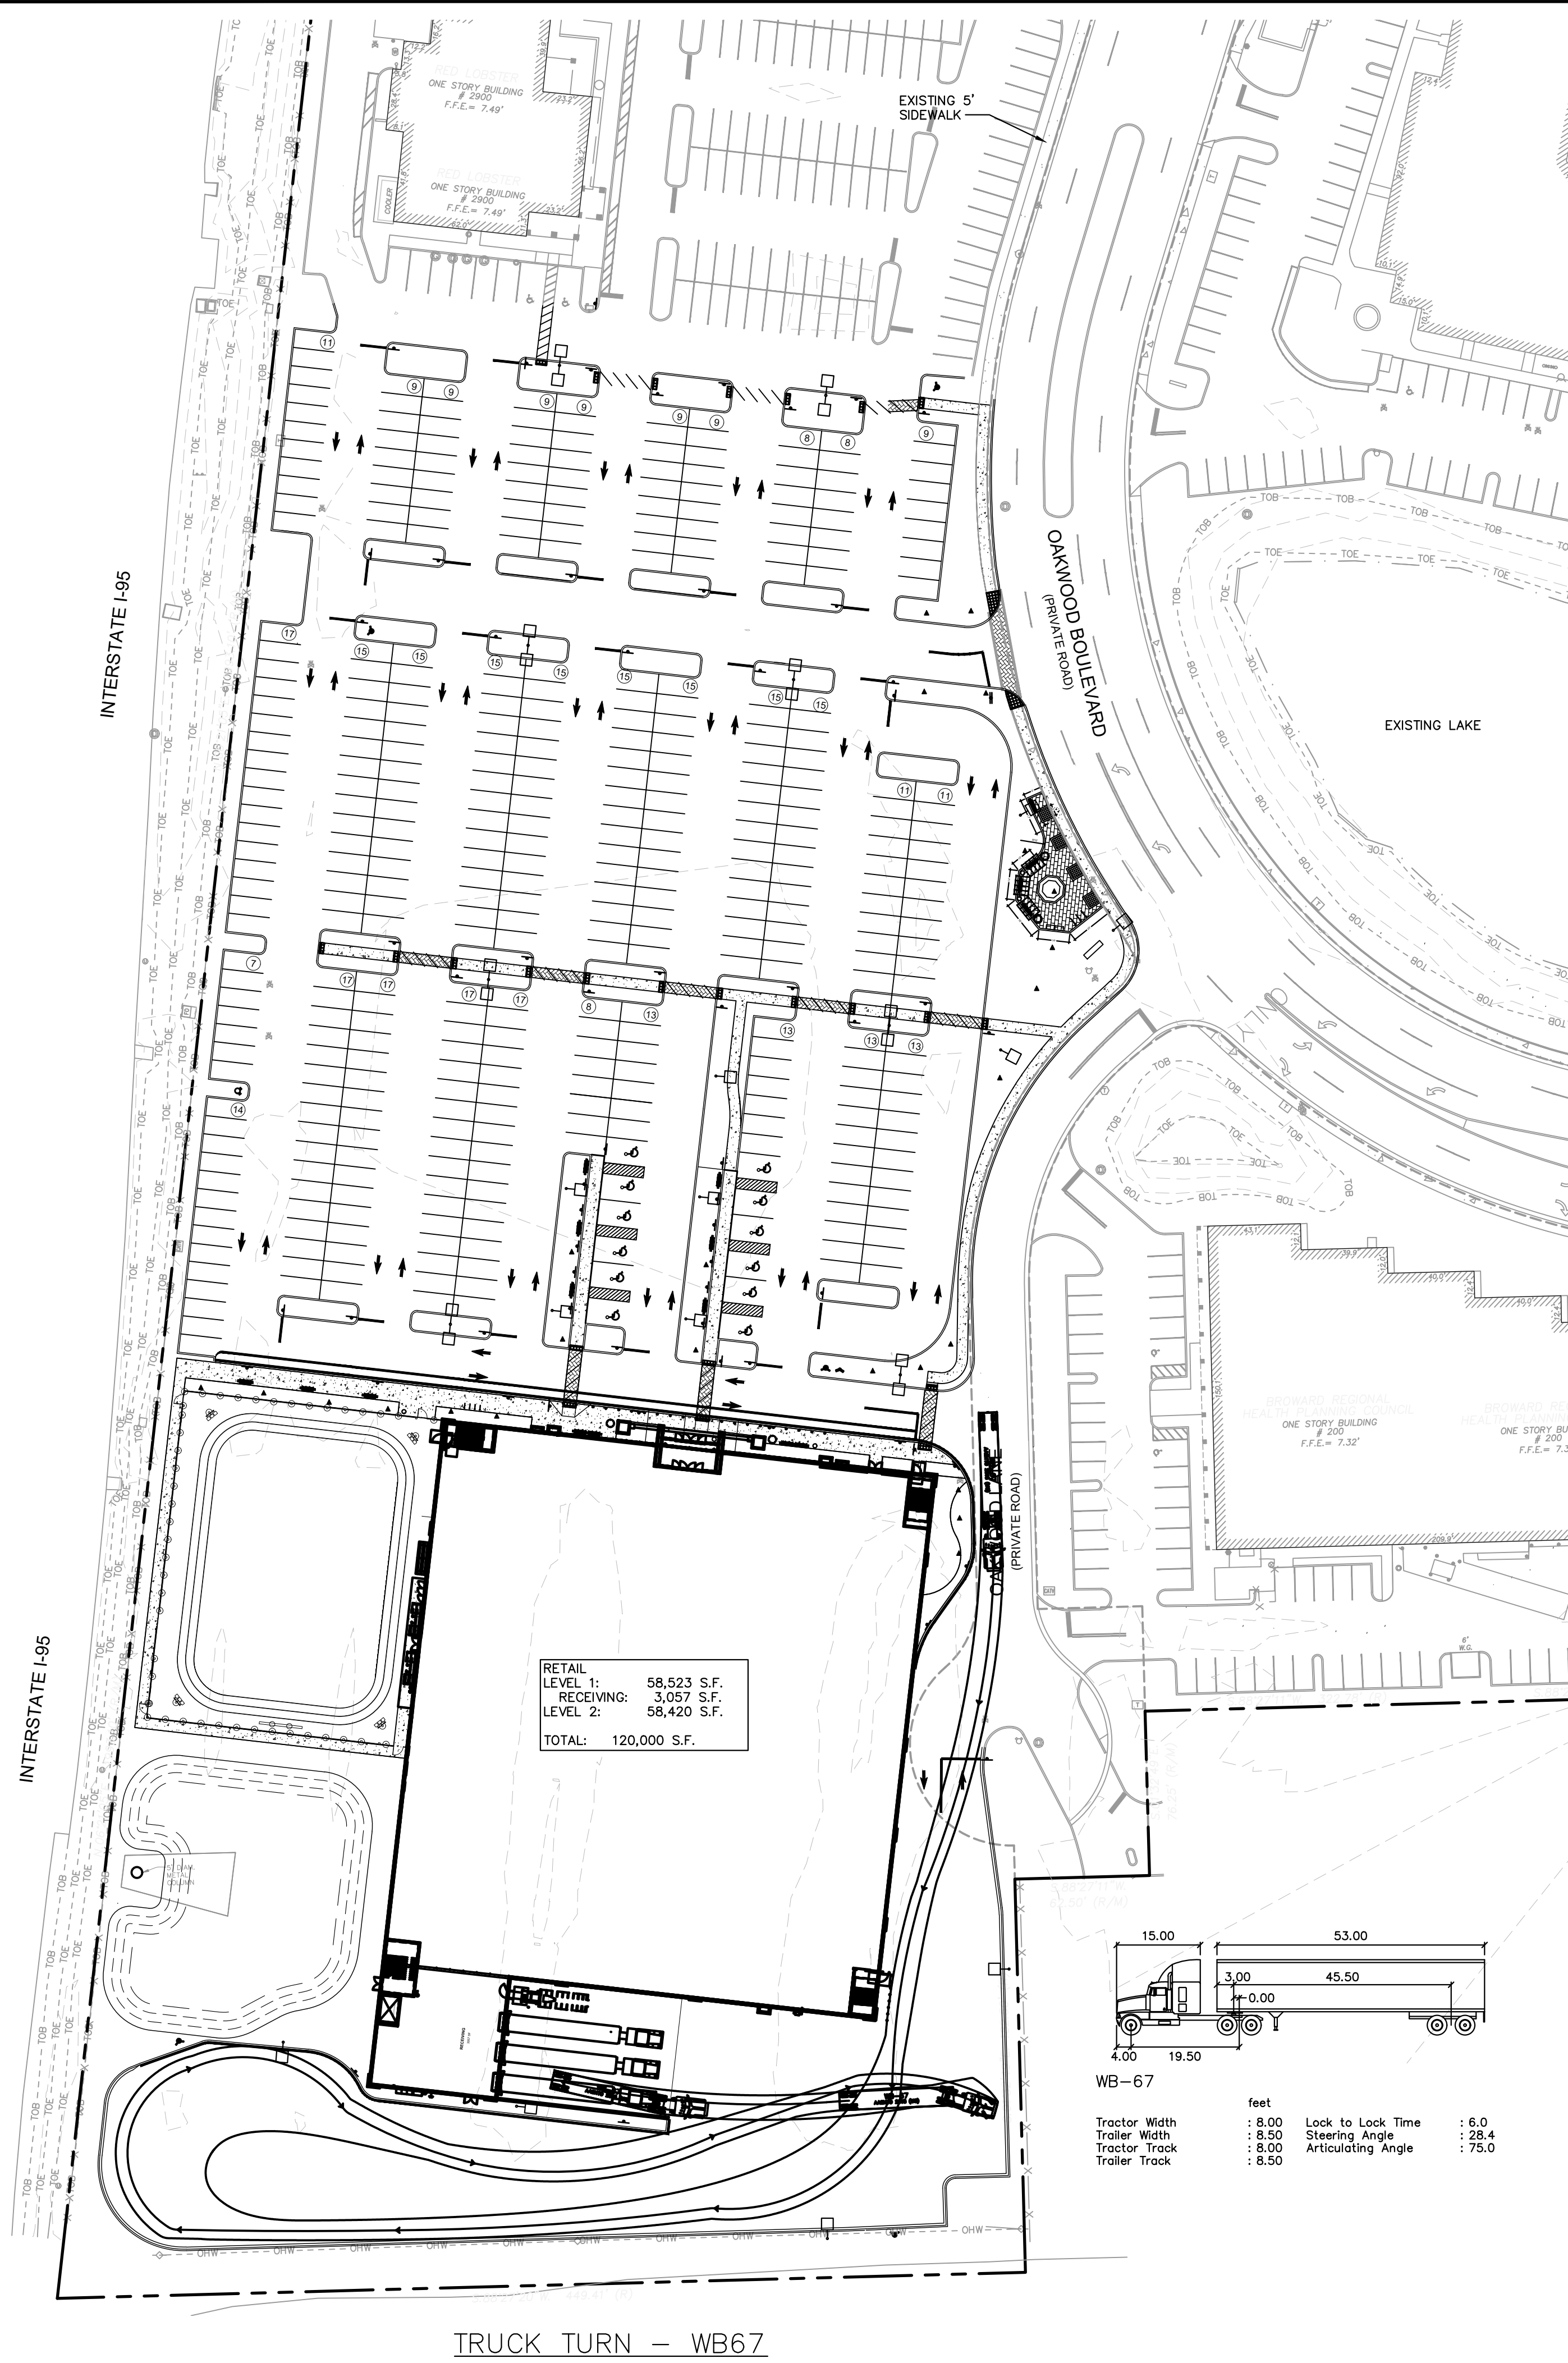

TRUCK TURN - WB67

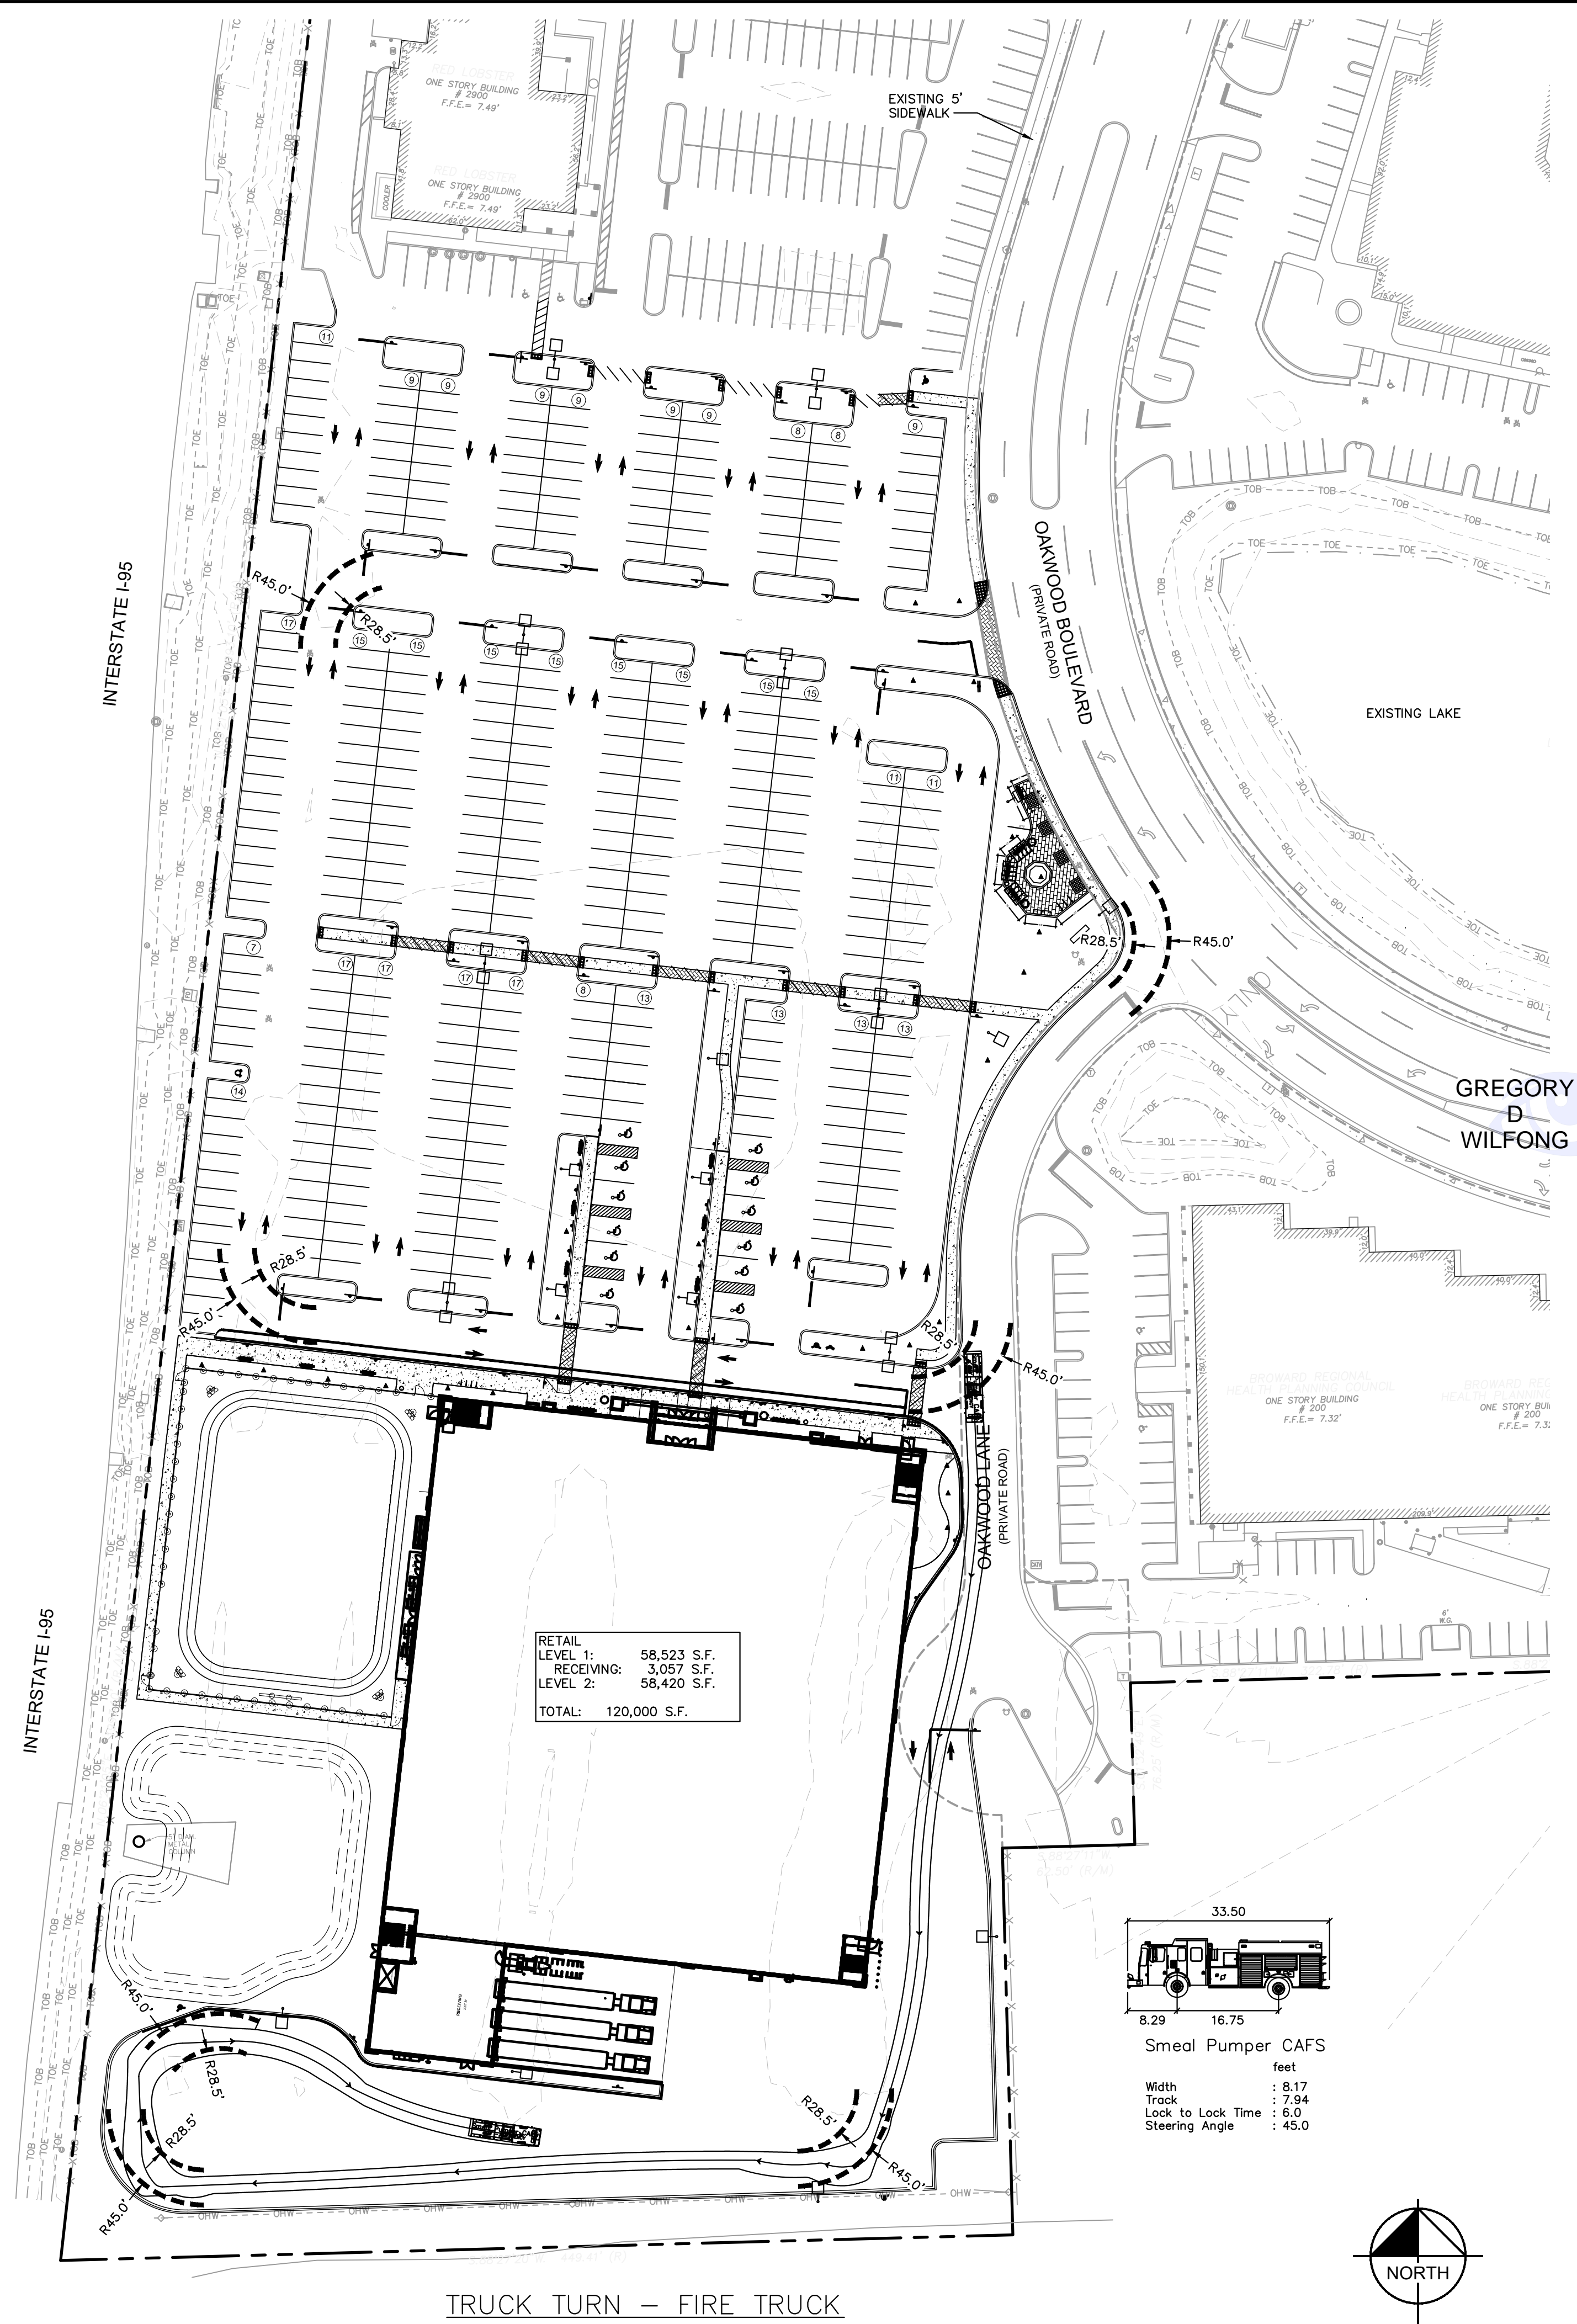

TRUCK TURN – FIRE TRUCK

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Digital Signature of Gregory D. Wilfong
DN: cn=Gregory D. Wilfong, o=U.S. District Court for the District of Columbia, email=gwilfong@usdc.dcm.gov, c=US

PRINTED ON RECYCLED PAPER


OAKWOOD SOUTH RETAIL SHOPPING CENTER

TRUCK TURN PLAN

CITY OF HOLLYWOOD
FL

Kimley»»Horn

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445 24TH STREET, SUITE 200, VERO BEACH, FL 32960
PHONE: 772-794-4100
WWW.KIMLEY-HORN.COM REGISTRY NO. 35106

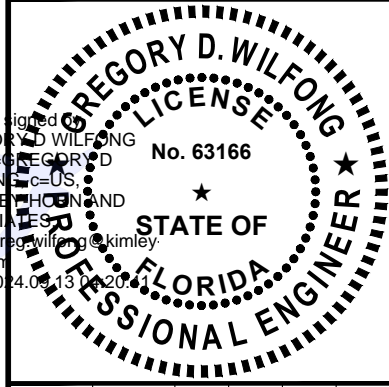

KHA PROJECT

DATE _____

SCALE AS SHOWN

DESIGNED BY SHE

OWN BY SHE

INTERSTATE I-95

OAKWOOD BOULEVARD (PRIVATE ROAD)

EXISTING LAKE

EXISTING 5' SIDEWALK

RETAIL LEVEL 1: 58,523 S.F.
RECEIVING: 3,057 S.F.
LEVEL 2: 58,420 S.F.
TOTAL: 120,000 S.F.


ROGERS TVT25 GOOSENECK

| feet | |
|--------------------|--------|
| Tractor Width | : 8.00 |
| Trailer Width | : 8.50 |
| Tractor Track | : 8.00 |
| Trailer Track | : 8.50 |
| Lock to Lock Time | : 6.0 |
| Steering Angle | : 36.9 |
| Articulating Angle | : 70.0 |



The technical drawing shows a side profile of the Rogers TVT25 Gooseneck trailer. Key dimensions are labeled as follows:

- Overall Length:** 39.08
- Tractor Width:** 10.00
- Trailer Width:** 8.50
- Tractor Track:** 3.85
- Trailer Track:** 15.08
- Gooseneck Height (to top of frame):** 1.25
- Gooseneck Height (to bottom of frame):** 0.50
- Lock to Lock Time:** 6.0
- Steering Angle:** 36.9
- Articulating Angle:** 70.0

| | feet | | |
|---------------|--------|--------------------|--------|
| Tractor Width | : 8.00 | Lock to Lock Time | : 6.0 |
| Trailer Width | : 8.50 | Steering Angle | : 36.9 |
| Tractor Track | : 8.00 | Articulating Angle | : 70.0 |
| Trailer Track | : 8.50 | | |

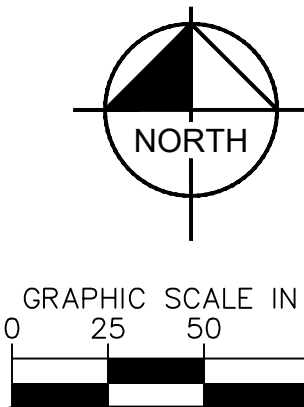[illegible]

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SITE LEGEND

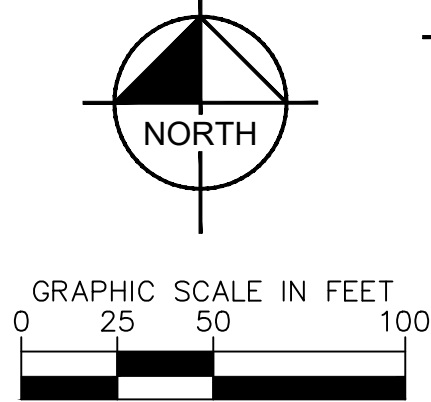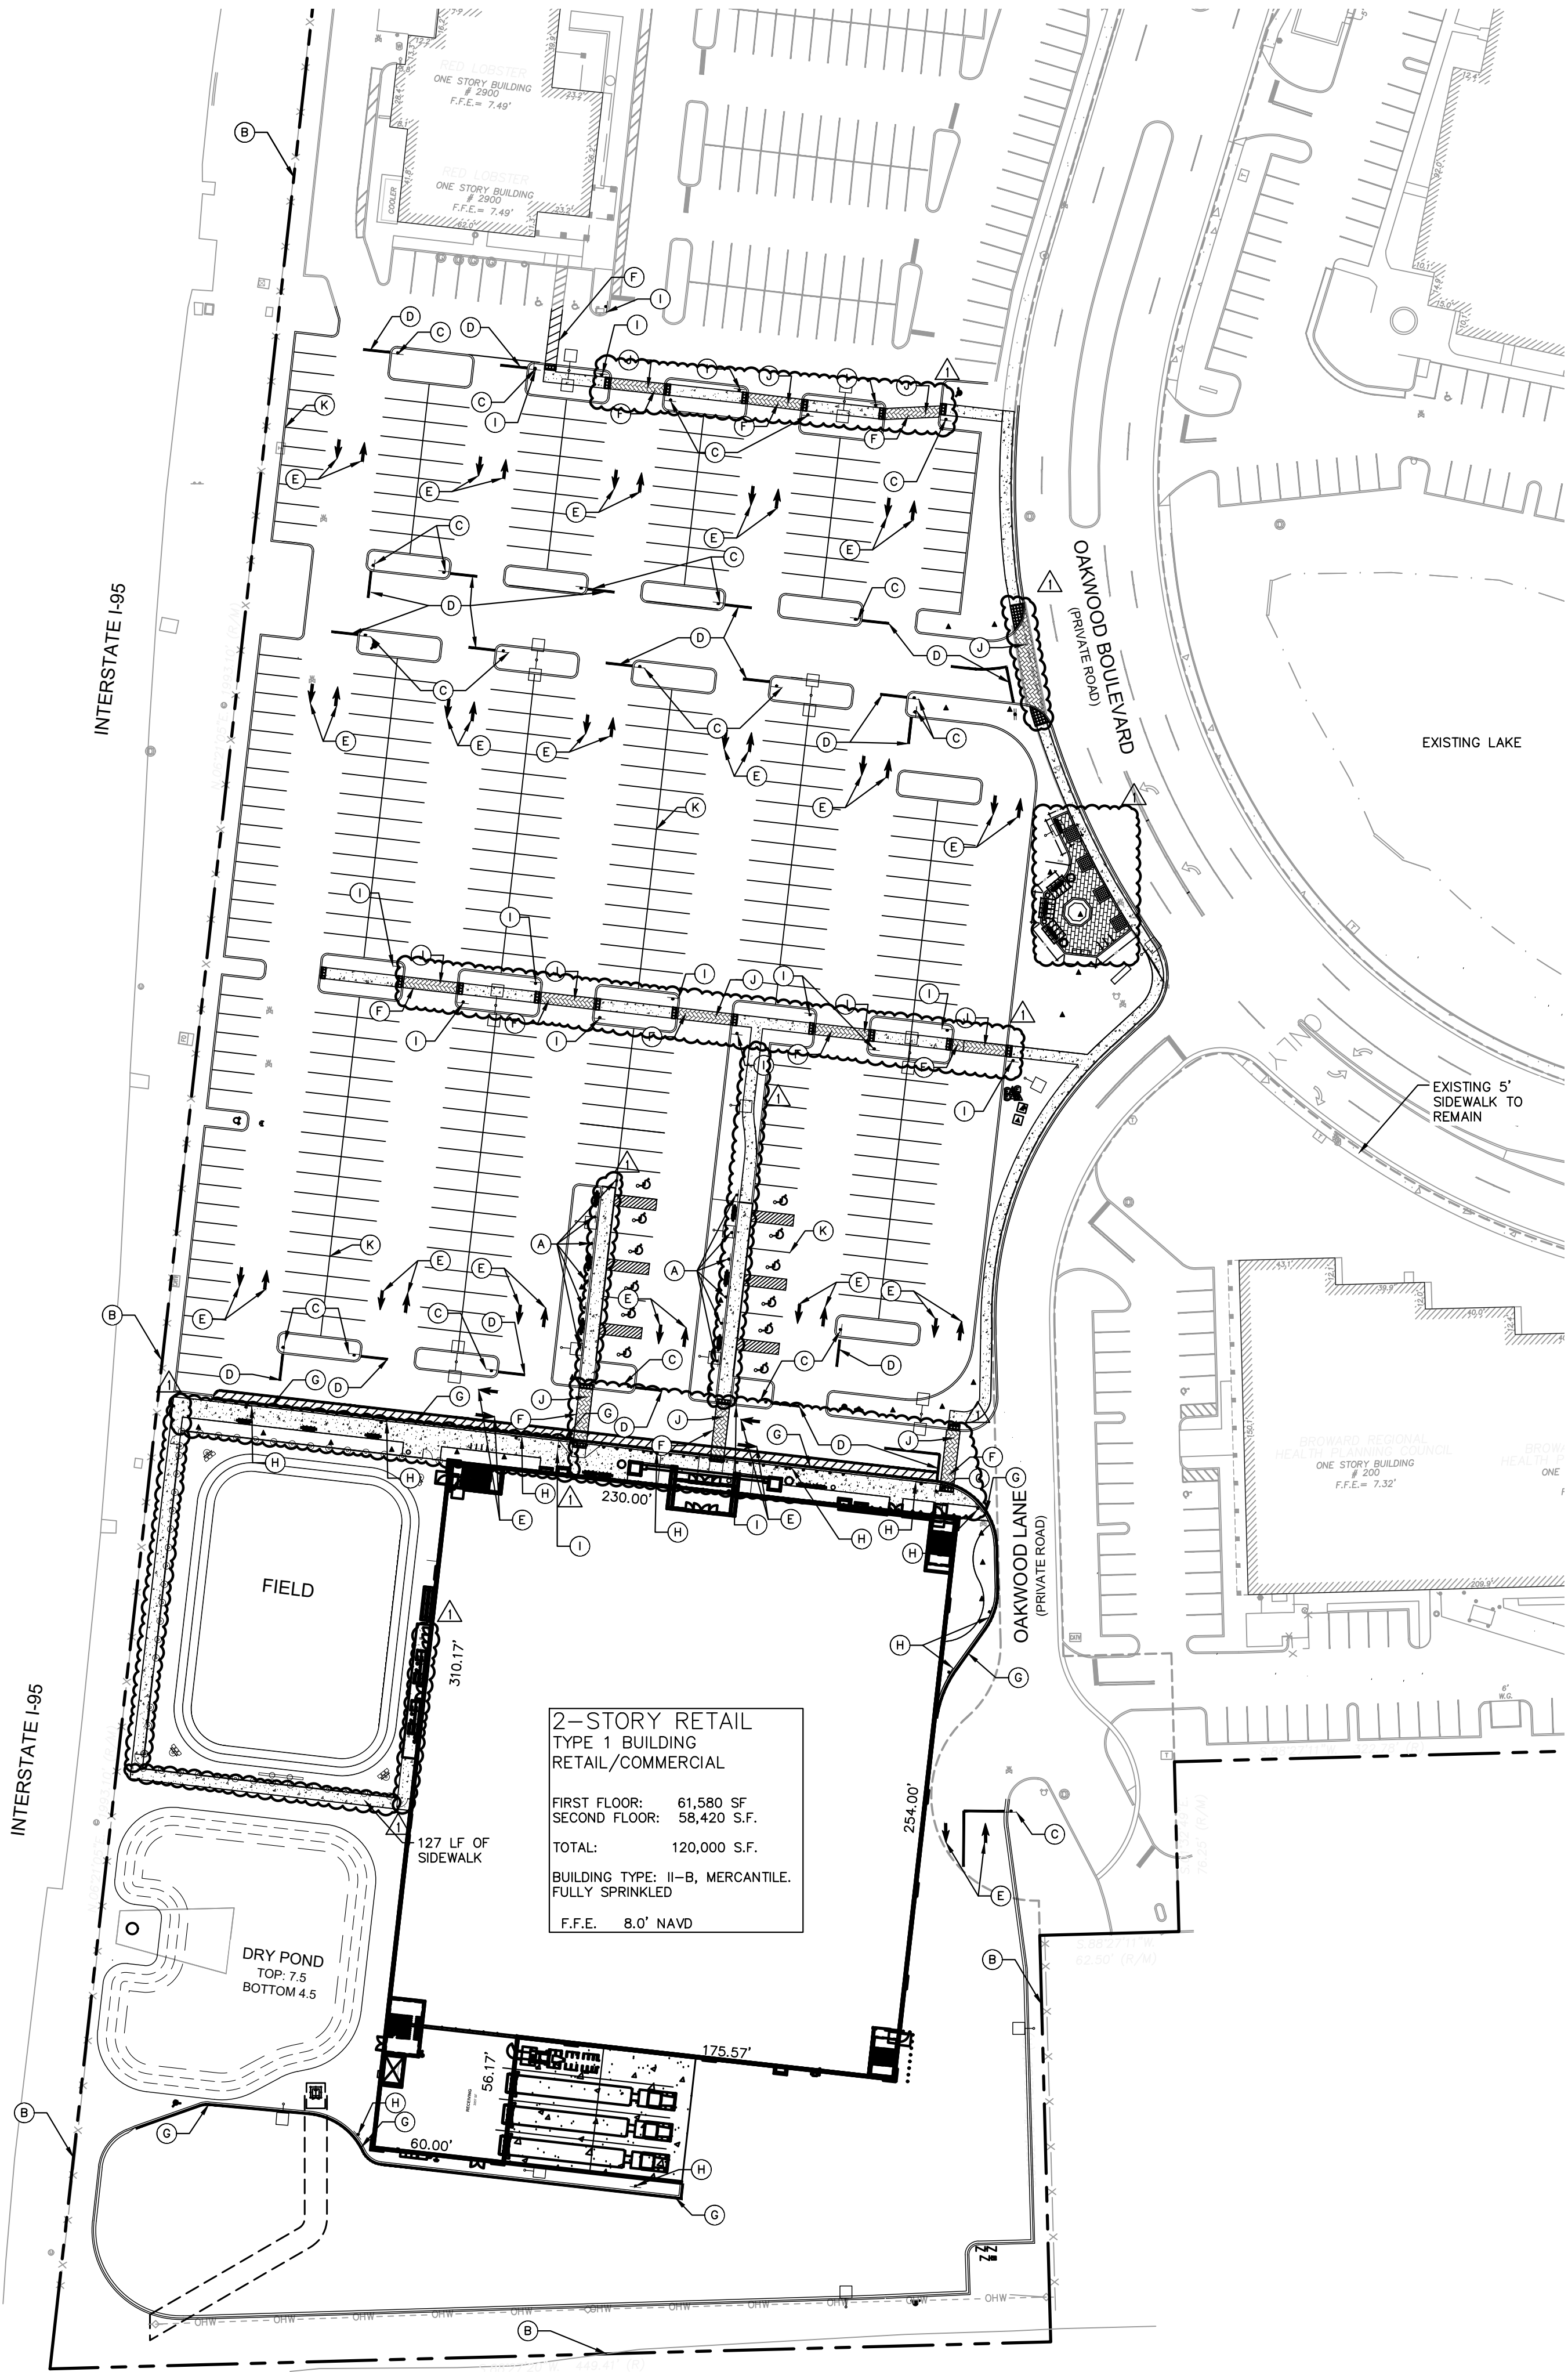- (A) ACCESSIBLE PARKING SPACE (TYP.) (SEE SHEET C-201 FOR DETAIL, WITH ADA SIGN)
- (B) PROPERTY LINE
- (C) "STOP" SIGN (SEE SHEET C-201)
- (D) STOP BAR (SEE SHEET C-201)
- (E) PAINTED DIRECTIONAL ARROW (TYP.) (SEE SHEET C-201)
- (F) INTERNAL PEDESTRIAN CROSSWALK WITH 12" WIDE WHITE STRIPING PERPENDICULAR TO DIRECTION OF TRAFFIC (SEE SHEET C-201)
- (G) FIRE LANE STRIPING 5' WIDE (SEE SHEET C-201)
- (H) "NO PARKING FIRE LANE" SIGN 80' O.C. (SEE SHEET C-201)
- (I) PEDESTRIAN CROSSING SIGN (SEE SHEET C-201)
- (J) FLUSH SIDEWALK PEDESTRIAN CROSSWALK
- (K) PARKING SPACE STRIPING (SEE DETAIL C-21A ON SHEET C-202)

MAIL DELIVERY NOTE

MAIL DELIVERY WILL BE INSIDE STORE

SITE LIGHTING CONFORMANCE NOTE

THE SIGHT LIGHTING OF THE SITE SHALL CONFORM TO THE SITE LIGHTING CRITERIA ESTABLISHED BY THE CITY OF HOLLYWOOD. THIS CONSISTS OF WELL DIRECTED LED LIGHTING WITH MAX FOOT CANDLE LEVEL AT ALL PROPERTY LINES = 0.5 (ADJACENT TO RESIDENTIAL).

GREEN ORDINANCE NOTE

FLORIDA GREEN BUILDING COALITION (FGBC) COMMERCIAL CERTIFICATION WILL BE PURSUED FOR THIS PROJECT.

MECHANICAL EQUIPMENT NOTE

ALL MECHANICAL EQUIPMENT SHALL BE PROPERLY SCREENED FROM PUBLIC VIEW.

PHASING INFORMATION

SITE WILL BE CONSTRUCTED WITH PAD FOR BUILDING. BUILDING WILL BE CONSTRUCTED AFTER SITE IS CLOSE TO COMPLETE AND SIGNED OFF.

SITE PLAN APPROVAL NOTE

CHANGES TO THE DESIGN OF THE SITE PLAN WILL REQUIRE PLANNING REVIEW AND MAY BE SUBJECT TO BOARD APPROVAL.

ADA NOTE

ANY LIP FROM 1/4" BUT NOT GREATER THAN 1/2" WILL BE BEVELED TO MEET ADA REQUIREMENTS ALONG ALL SIDEWALKS AND ADA PATHS

NOTES:
ALL CURB RADII ARE 3' UNLESS OTHERWISE NOTED.

SIGNAGE NOTE:
ALL SIGNAGE SHALL BE IN COMPLIANCE WITH THE OAKWOOD SIGN REGULATIONS

LEGEND

- PROPERTY LINE
- == PROPOSED CURB
- - - EXISTING EASEMENTS
- [] STANDARD DUTY PAVEMENT
- [] HEAVY DUTY CONCRETE
- [] HEAVY DUTY ASPHALT
- [] VISIBILITY TRIANGLE (12'X12')
- [] ADA DETECTABLE WARNING
- [] PROPOSED LIGHT POLES
- [] EXISTING SIDEWALK
- [] PROPOSED SIDEWALK (STANDARD GREY CONCRETE WITH BROOM FINISH)
- [] 6X6, 3 1/8" CROSSWALK VEHICULAR PAVERS FROM BELGARD PATTERN; HERRINGBONE
- [] 12X6, 2 3/8" PEDESTRIAN PAVERS FROM BELGARD PATTERN 1/2 RUNNING BOND


GREGORY
D
WILFONG

Digitally signed by
GREGORY D WILFONG
DN: cn=GREGORY D
WILFONG, c=US,
o=KIMLEY-HORN AND
ASSOCIATES,
email=greg.wilfong@khi
horn.com
Date: 2024.09.13 09:
-0400'

| NO. | REVISIONS | DATE | BY |
|-----|--------------------------------------|----------|-----|
| 1 | CITY OF HOLLYWOOD PLANNING REVISIONS | 9/3/2024 | SHB |

Kimley»Horn

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PHONE: 772-794-4100
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| | | | | | |
|--------------------------|------------------|-------------------|--------------------|-----------------|-------------------|
| KHA PROJECT 147507131 | DATE 9/3/2024 | SCALE AS SHOWN | DESIGNED BY SHB | DRAWN BY SHB | CHECKED BY GDW |
|--------------------------|------------------|-------------------|--------------------|-----------------|-------------------|

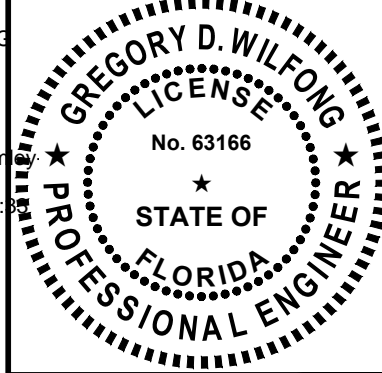**PAVEMENT MARKING
AND SIGNAGE PLAN**

**OAKWOOD SOUTH
RETAIL SHOPPING
CENTER**


FL

CITY OF HOLLYWOOD

SHEET NUMBER
C-205

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SITE LEGEND

- (A) 6" TYPE 'D' CURB (SEE SHEET C-202)
- (B) STANDARD DUTY CONCRETE SIDEWALK (5' MIN) (SEE SHEET C-201)
- (C) FDOT CURB RAMP TYPE CR-E INDEX 522-002 (SEE SHEET C-201 FOR DETAIL)
- (D) ASPHALT DRIVEWAY (SEE SHEET C-350 AND DETAIL C-20 ON SHEET C-202)
- (E) FDOT CURB RAMP TYPE CR-A INDEX 522-002 (SEE SHEET C-201 FOR DETAIL)
- (F) FDOT CURB RAMP TYPE CR-F INDEX 522-002 (SEE SHEET C-201 FOR DETAIL)
- (G) 6" TYPE 'F' CURB AND GUTTER (SEE DETAIL C-26 ON SHEET C-202)
- (H) FDOT CURB RAMP TYPE CR-C INDEX 522-002 (SEE SHEET C-201 FOR DETAIL)

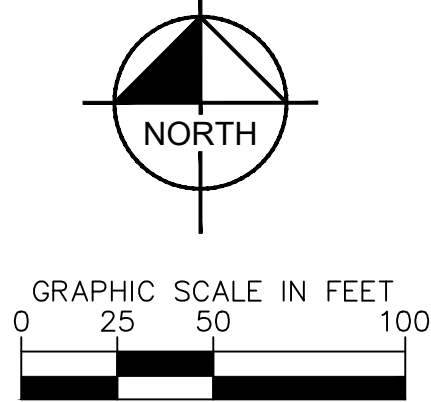MAIL DELIVERY NOTE

MAIL DELIVERY WILL BE INSIDE STORE

SITE LIGHTING CONFORMANCE NOTE

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ANY LIP FROM 1/4" BUT NOT GREATER THAN 1/2" WILL BE BEVELED TO MEET ADA REQUIREMENTS ALONG ALL SIDEWALKS AND ADA PATHS

NOTES:
-ALL CURB RADII ARE 3' ON ALL LANDSCAPING ISLANDS UNLESS OTHERWISE NOTED.

SIGNAGE NOTE:
-ALL SIGNAGE SHALL BE IN COMPLIANCE WITH THE OAKWOOD SIGN REGULATIONS

MATERIAL NOTES:

CONCRETE:
CONCRETE DRIVEWAYS ON PRIVATE PROPERTY WILL BE 5-INCH THICK, 3,000 PSI WITH FIBER MESH WHILE THE PORTION OF THE DRIVEWAY LOCATED WITHIN THE ROW (OUTSIDE OF THE PROPERTY LINES) WILL BE A MINIMUM OF 8 INCHES THICK, 3,000 PSI. WITH NO METAL OR FIBER MESH AND WILL BE CONSTRUCTED FLUSH WITH THE EXISTING ROADWAY AND SIDEWALK. THE ENTIRE DRIVEWAY WILL MAINTAIN CONTROL JOINTS LOCATED EVERY 250 SQ.FT AND THE EXISTING ASPHALT IN THE CITY ROW WILL BE SAWCUT FOR A CLEAN STRAIGHT EDGE.

PAVERS:


PAVER DRIVEWAYS REQUIRE A MINIMUM 2 3/8TH INCH PAVERS PLACED OVER A 1-1/2 INCH SAND BASE AND COMPACTED SUBBASE. IN ADDITION TO A MINIMUM 6-INCH EDGE RESTRAINT (CONCRETE BORDER) IS REQUIRED AROUND PERIMETER TO INTERLOCK PAVERS. THE DRIVEWAY IS TO BE CONSTRUCTED FLUSH WITH THE EXISTING ROADWAY AND THE EXISTING ASPHALT IN THE CITY ROW WILL BE SAWCUT FOR A CLEAN STRAIGHT EDGE.

ASPHALT:

ASPHALT DRIVEWAY IS REQUIRED TO BE A MINIMUM 6-INCH LIMEROCK BASE, TACK COAT, AND 1-INCH LAYER OF S-III ASPHALT. THE DRIVEWAY IS TO BE CONSTRUCTED FLUSH WITH THE EXISTING ROADWAY AND THE EXISTING ASPHALT IN THE CITY ROW WILL BE SAWCUT FOR A CLEAN STRAIGHT EDGE.

LEGEND

- PROPERTY LINE
- PROPOSED CURB
- PROPOSED CURB AND GUTTER
- EXISTING EASEMENTS
- STANDARD DUTY PAVEMENT (1.5' A.C. SEE SHEET C-350 FOR DETAIL)
- HEAVY DUTY ASPHALT (2.5' A.C. SEE SHEET C-350 FOR DETAIL)
- VISIBILITY TRIANGLE (12'X12')
- ADA DETECTABLE WARNING
- PROPOSED LIGHT POLES
- EXISTING SIDEWALK
- PROPOSED SIDEWALK (STANDARD GREY CONCRETE WITH BROOM FINISH) (SEE SHEET C-202 FOR DETAIL)
- PROPOSED MILLING AND RESURFACING (SEE DETAIL BELOW)
- PROPOSED DRIVEWAYS (SEE NOTE BELOW)
- 6X9, 3 1/8" CROSSWALK VEHICULAR PAVERS FROM BELGARD PATTERN: HERRINGBONE
- 12X6, 2 3/8" PEDESTRIAN PAVERS FROM BELGARD PATTERN 1/2 RUNNING BOND

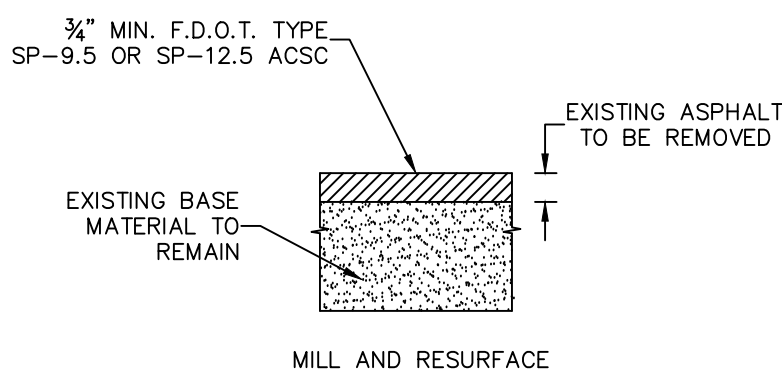


ASPHALT PAVEMENT RESTORATION

N.T.S.

GREGORY D. WILFONG

Digitally signed by GREGORY D. WILFONG on 09/03/2024 14:07:13. Reason: I am the author of this document.

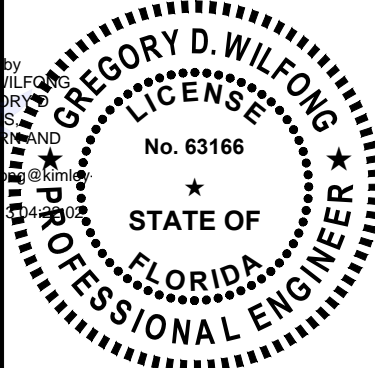

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|-------------|----------|----------|-------------|----------|------------|
| KHA PROJECT | DATE | SCALE | DESIGNED BY | DRAWN BY | CHECKED BY |
| 147507131 | 9/3/2024 | AS SHOWN | SHB | SHB | CDW |

PAVEMENT DELINATION PLAN

OAKWOOD SOUTH RETAIL SHOPPING CENTER

FL

CITY OF HOLLYWOOD

SHEET NUMBER
C-206

THIS ITEM HAS BEEN DIGITALLY SIGNED AND SEALED BY GREGORY D. WILFONG, P.E. ON THE DATE ADJACENT TO THE SEAL. PRINTED COPIES OF THIS DOCUMENT ARE NOT CONSIDERED SIGNED AND SEALED AND THE DIGITAL SIGNATURE MUST BE VERIFIED ON ANY ELECTRONIC COPIES.

Kimley»Horn

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445 24TH STREET, SUITE 200, VERO BEACH, FL 32960
PHONE: 772-794-4100
WWW.KIMLEY-HORN.COM

REGISTRY NO. 35106


REVISIONS

NO.

DATE

BY

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ADA NOTE
ANY LIP FROM 1/4" BUT NOT GREATER THAN 1/2" WILL BE BEVELED TO MEET ADA REQUIREMENTS ALONG ALL SIDEWALKS AND ADA PATHS

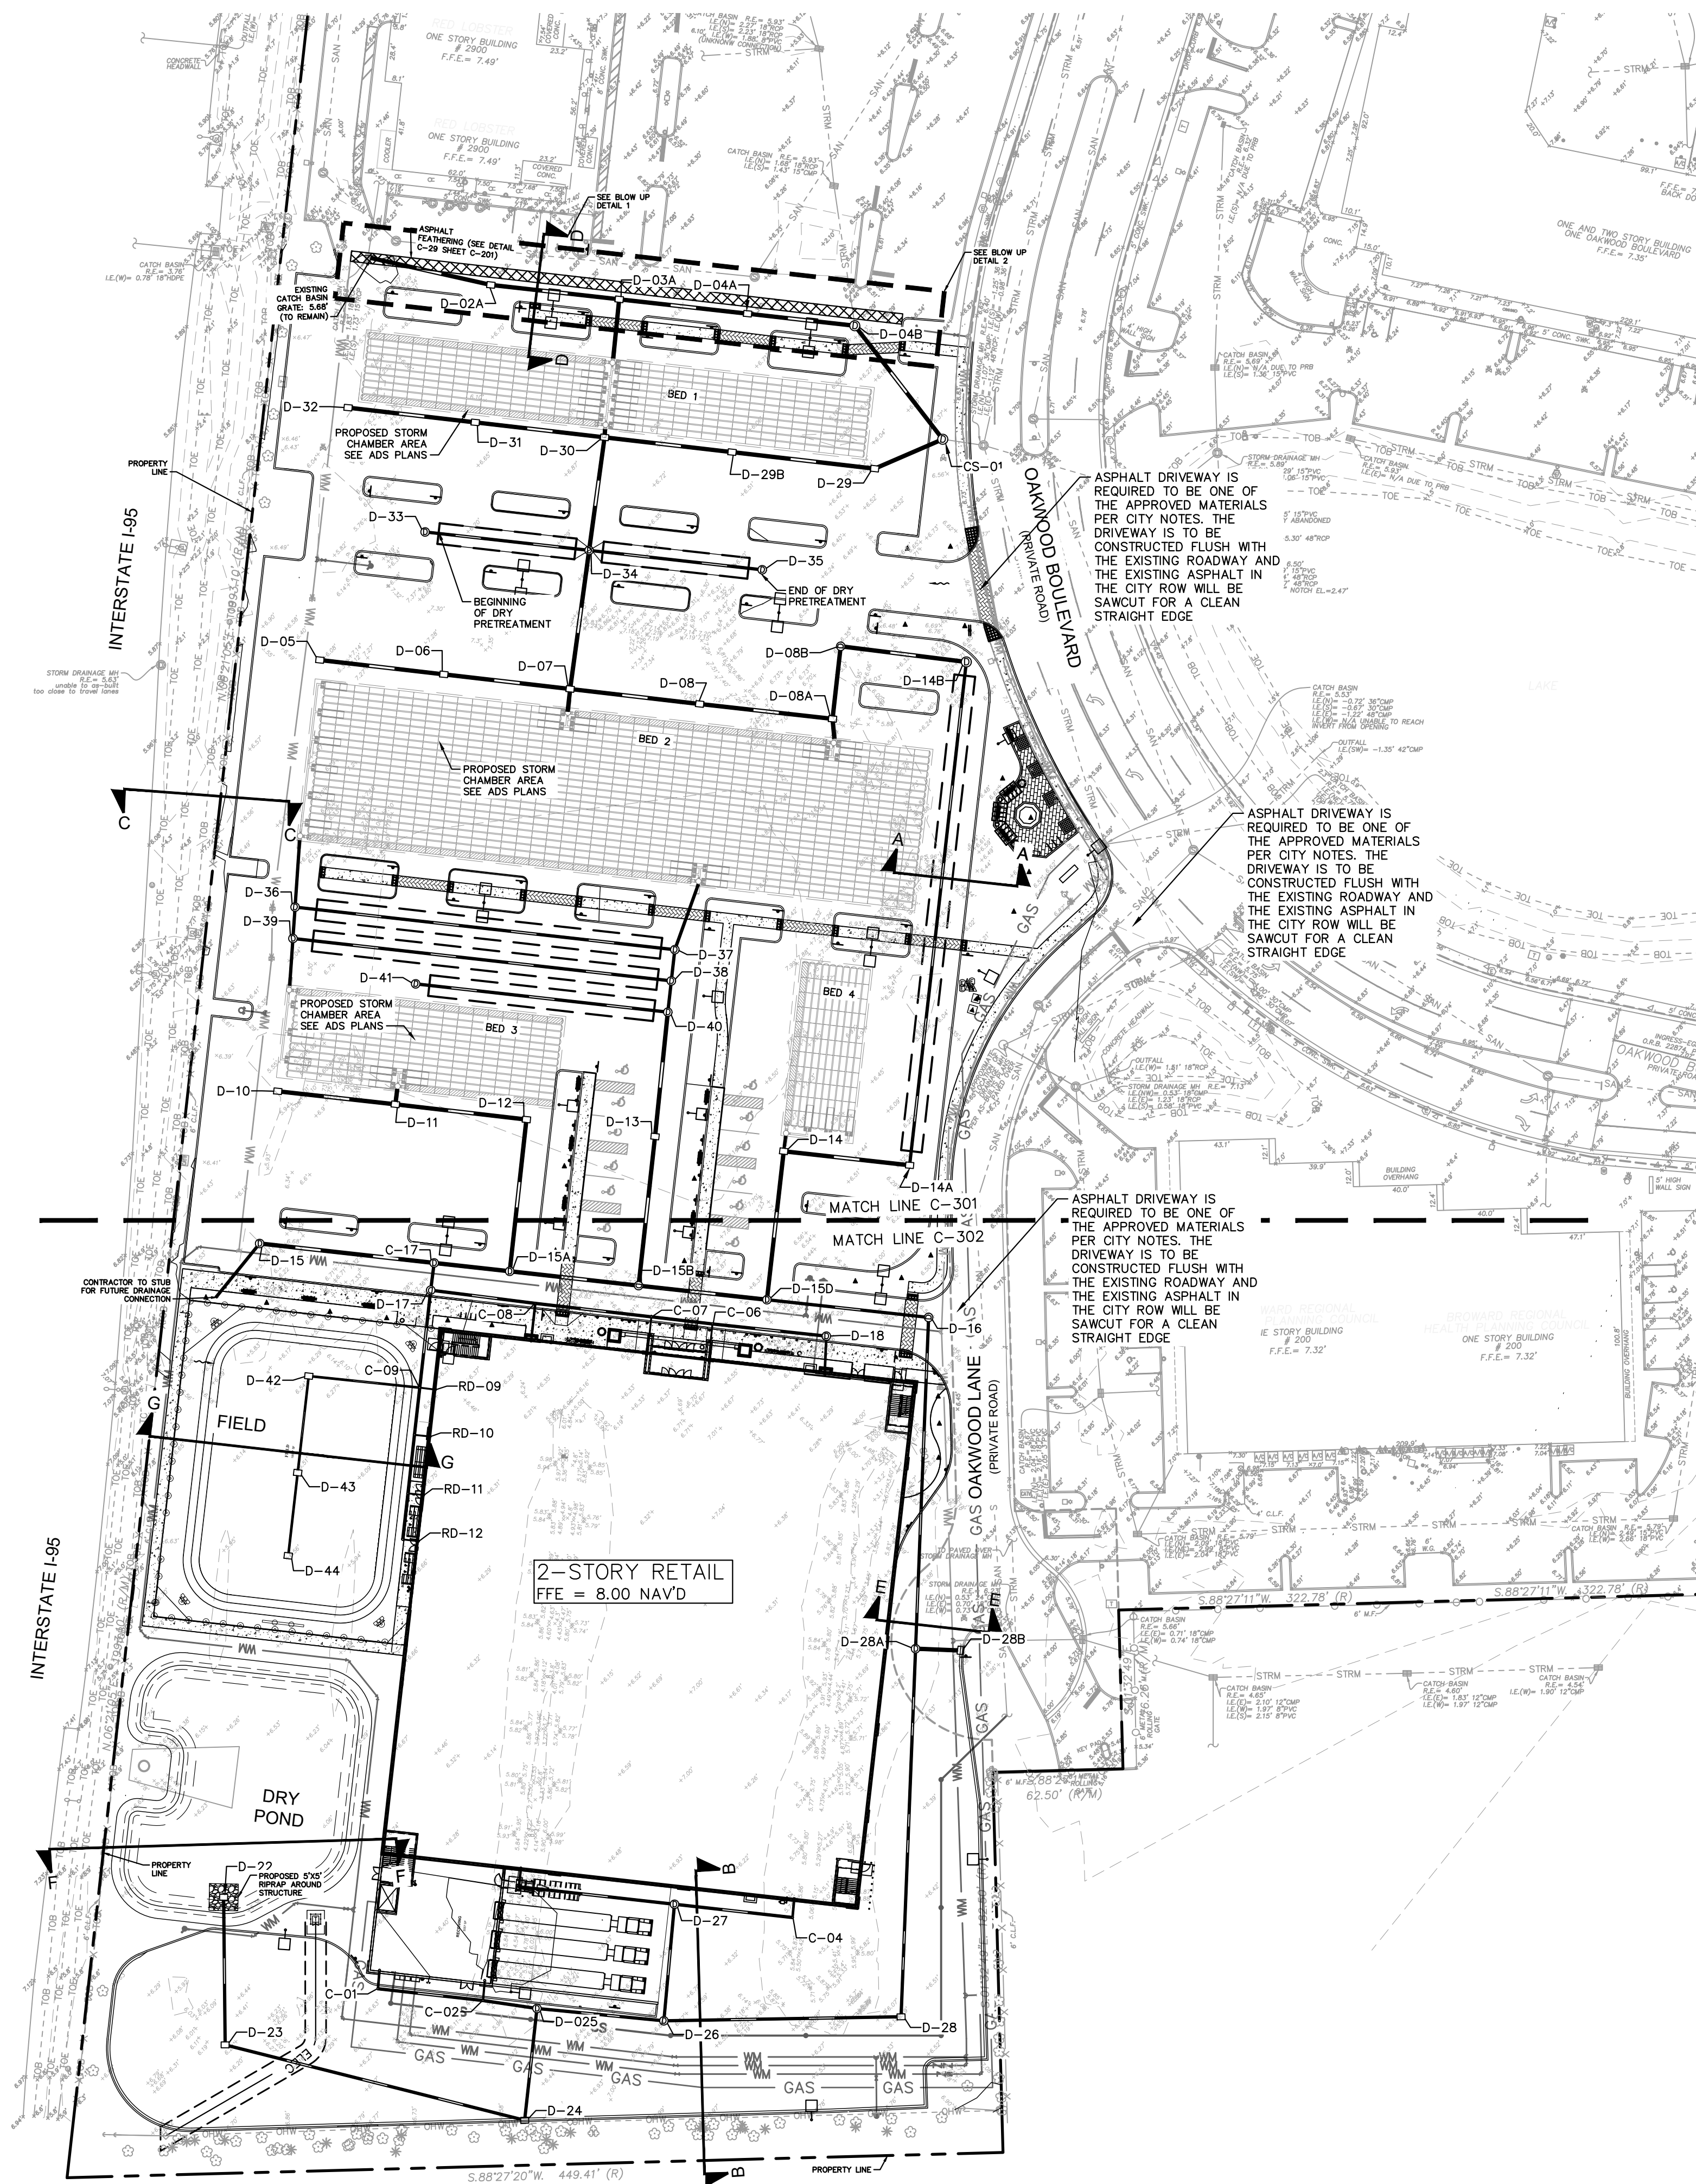
MATERIAL NOTES:
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CONCRETE DRIVEWAYS ON PRIVATE PROPERTY WILL BE 5-INCH THICK, 3,000 PSI WITH FIBER MESH WHILE THE PORTION OF THE DRIVEWAY LOCATED WITHIN THE ROW (OUTSIDE OF THE PROPERTY LINES) WILL BE A MINIMUM OF 6 INCHES THICK, 3,000 PSI, WITH NO METAL OR FIBER MESH AND WILL BE CONSTRUCTED FLUSH WITH THE EXISTING ROADWAY AND SIDEWALK. THE ENTIRE DRIVEWAY WILL BE AN INTEGRAL CONTROL JOINTS LOCATED EVERY 260 TO 30 FT AND THE EXISTING ASPHALT IN THE CITY ROW WILL BE SAWCUT FOR A CLEAN STRAIGHT EDGE.






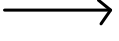
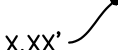
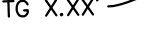




PAVERS:
PAVER DRIVEWAYS REQUIRE A MINIMUM 2 3/8TH INCH PAVERS PLACED OVER A 1-1/2 INCH SAND BED AND COMPACTED SUBGRADE. IN ADDITION TO A MINIMUM 6-INCH EDGE RESTRAINT (CONCRETE BORDER) IS REQUIRED AROUND PERIMETER TO INTERLOCK PAVERS. THE DRIVEWAY IS TO BE CONSTRUCTED FLUSH WITH THE EXISTING ROADWAY AND THE EXISTING ASPHALT IN THE CITY ROW WILL BE SAWCUT FOR A CLEAN STRAIGHT EDGE.

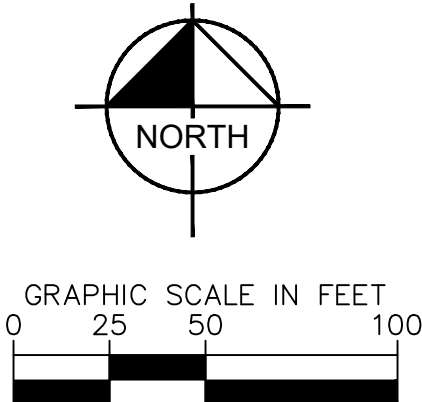ASPHALT:
ASPHALT DRIVEWAY IS REQUIRED TO BE A MINIMUM 6-INCH LIMEPOCK BASE, TOPCOAT, AND 1-INCH LAYER OF 5-1/2 IN ASPHALT. THE DRIVEWAY IS TO BE CONSTRUCTED FLUSH WITH THE EXISTING ROADWAY AND THE EXISTING ASPHALT IN THE CITY ROW WILL BE SAWCUT FOR A CLEAN STRAIGHT EDGE.

PAVING, GRADING AND DRAINAGE NOTES:

1. TOPOGRAPHIC INFORMATION IS TAKEN FROM A TOPOGRAPHIC SURVEY BY LAND SURVEYORS. IF THE CONTRACTOR DOES NOT ACCEPT EXISTING TOPOGRAPHY AS SHOWN ON THE PLANS, WITHOUT EXCEPTION, THEN THE CONTRACTOR SHALL SUFFER, AT THEIR EXPENSE, A TOPOGRAPHIC SURVEY BY A REGISTERED LAND SURVEYOR TO THE OWNER FOR REVIEW.
2. THE CONTRACTOR SHALL BE RESPONSIBLE FOR DETERMINING THAT THE LOCATION AND/OR ELEVATION OF EXISTING UTILITIES AS SHOWN ON THESE PLANS IS BASED ON RECORDS OF THE VARIOUS UTILITY COMPANIES, AND WHERE POSSIBLE, MEASUREMENTS TAKEN IN THE FIELD. THE INFORMATION IS NOT TO BE RELIED ON AS BEING EXACT OR COMPLETE. THE CONTRACTOR MUST CALL THE APPROPRIATE UTILITY COMPANIES AT LEAST 72 HOURS BEFORE ANY EXCAVATION OR CONSTRUCTION OF ANY TYPE OF UTILITY. IT WILL BE THE RESPONSIBILITY OF THE CONTRACTOR TO RELOCATE ALL EXISTING UTILITIES WHICH CONFLICT WITH THE PROPOSED IMPROVEMENTS SHOWN ON THE PLANS.
3. THE CONTRACTOR SHALL COMPLY WITH ALL APPLICABLE GOVERNING CODES AND BE CONSTRUCTED TO SAME. THE CONTRACTOR SHALL ADHERE TO ALL TERMS & CONDITIONS AS OUTLINED IN THE EPA OR APPLICABLE STATE GENERAL N.P.D.E.S. PERMIT FOR STORM WATER DISCHARGE ASSOCIATED WITH CONSTRUCTION ACTIVITY.
4. ALL MATERIALS AND CONSTRUCTION WITHIN THE RIGHT-OF-WAY SHALL CONFORM TO THE LATEST DESIGN STANDARDS AND LATEST STANDARD SPECIFICATIONS FOR ROAD AND BRIDGE CONSTRUCTION FOR THE AUTHORITY HAVING JURISDICTION.
5. ALL REQUIRED TESTING SHALL BE DONE AT INTERVALS IN ACCORDANCE WITH THE SPECIFICATIONS AND LOCAL JURISDICTIONAL AGENCY. IN THE EVENT THAT THE CONTRACT DOCUMENTS AND THE JURISDICTIONAL AGENCY REQUIREMENTS ARE NOT IN AGREEMENT, THE MOST STRINGENT SHALL GOVERN.
6. THE CONTRACTOR IS RESPONSIBLE FOR THE PROTECTION OF EXISTING STRUCTURES INCLUDING REMOVAL OF ANY EXISTING UTILITIES SERVING THE STRUCTURE.
7. EXISTING DRAINAGE PIPES AND INLETS ARE TO BE JET CLEANED AND VACUUMED TO REMOVE ALL SILT AND DEBRIS. IF ANY EXISTING STRUCTURES TO REMAIN ARE DAMAGED DURING CONSTRUCTION IT SHALL BE THE CONTRACTOR'S RESPONSIBILITY TO REPAIR OR REPLACE THE EXISTING STRUCTURE AS NECESSARY TO RETURN IT TO EXISTING CONDITIONS OR BETTER.
8. PRECAST STRUCTURES MAY BE USED AT CONTRACTORS OPTION, IF APPLICABLE.
9. ALL STORM WATER ENTERING STRUCTURES SHALL BE GROUTED TO ASSURE CONNECTION AT STRUCTURE IS WATERTIGHT, IF APPLICABLE.
10. ALL STORM SEWER MANHOLES IN PAVED AREAS SHALL BE FLUSH WITH PAVEMENT, AND SHALL HAVE TRAFFIC BEARING AND COLLISION RESISTANT UNPAVED AREAS SHALL BE 6" ABOVE FINISH GRADE. LIDS SHALL BE LABELED "STORM SEWER", IF APPLICABLE.
11. ALL CATCH BASINS WITH PROPOSED TRAFFIC AREAS SHALL HAVE CYCLOPE PLAST GRATES, IF APPLICABLE.
12. ALL STORM STRUCTURES SHALL HAVE A SMOOTH UNIFORM POURED MORTAR INVERT FROM INVERT IN TO INVERT OUT OF STRUCTURE.
13. CONTRACTOR SHALL ADJUST AND/OR CUT EXISTING PAVEMENT AS NECESSARY TO ASSURE A SMOOTH FIT AND CONTINUOUS GRADE.
14. CONTRACTOR SHALL ASSURE POSITIVE DRAINAGE AWAY FROM BUILDINGS FOR ALL NATURAL AND PAVED AREAS.
15. ALL AREAS INDICATED AS PAVEMENT SHALL BE CONSTRUCTED IN ACCORDANCE WITH THE TYPICAL PAVEMENT SECTIONS AS INDICATED ON THE DRAWINGS.
16. ALL EXISTING PAVED AREAS TO BE REMOVED AND REPLACED, THE CONTRACTOR SHALL SAW-CUT THE FULL DEPTH OF PAVEMENT FOR A SMOOTH AND STRAIGHT JOINT AND REPLACE THE PAVEMENT WITH THE SAME TYPE AND DEPTH OF MATERIAL AS EXISTING OR AS INDICATED.
17. ALL EXISTING PAVEMENT AREAS TO BE MAINTAINED, THE CONTRACTOR SHALL SAW-CUT THE FULL DEPTH OF EXISTING PAVEMENT FOR A SMOOTH AND STRAIGHT JOINT AND MATCH THE EXISTING PAVEMENT ELEVATION WITH THE PROPOSED PAVEMENT UNLESS OTHERWISE INDICATED.
18. ALL EXCAVATIONS SHALL BE PROTECTED BY SHIELDING PAVEMENT. EXCAVATIONS ARE TO BE LANDSCAPED A MINIMUM OF 30" OR AS DEEP AS NECESSARY TO ENSURE ALL STONE BASE / PAVEMENT MATERIAL IS REMOVED (WHICHEVER IS GREATER) AND BACKFILL WITH CLEAN / DRAINING SAND TO WITHIN 4" OF TOP OF CURB TO ENSURE PROPER SOIL FOR PLANT MATERIALS.
19. ALL EXCAVATIONS FOR CONTRACTOR OR OTHER PLANTING AREAS AND OTHER PLANTING AREAS ARE NOT OVER-COMPACTED AND DO NOT CONTAIN ROAD BASE MATERIALS. THE CONTRACTOR SHALL ALSO EXCAVATE AND REMOVE ALL UNSERVICEABLE MATERIAL FROM ALL AREAS ON THE SITE TO BE PLANTED AND PROPERLY DISPOSED IN A LEGAL MANNER.
20. ALL CUT OR FILL SLOPES SHALL BE 4H:1V OR FLATTER UNLESS OTHERWISE NOTED.
21. ALL UN-SURFACED AREAS DISTURBED BY GRADING OPERATION SHALL RECEIVE 4 INCHES OF TOPSOIL. CONTRACTOR SHALL APPLY STABILIZATION FABRIC TO ALL SLOPES 3H:1V OR STEEPER. CONTRACTOR SHALL STABILIZE ALL DISTURBED AREAS IN ACCORDANCE WITH GOVERNING SPECIFICATIONS UNTIL A HEALTHY STAND OF VEGETATION IS OBTAINED.
22. THE CONTRACTOR SHALL GRADE THE SITE TO THE ELEVATIONS INDICATED AND SHALL RE-GRADE WASHOUTS THROUGH THE OCCUR FOR EVERY RAINFALL UNTIL A GRASS STAND IS WELL ESTABLISHED OR ADEQUATE STABILIZATION OCCURS.
23. LANDSCAPE ISLANDS IN PARKING AREA TO BE BERMED MINIMUM OF 6" ABOVE BACK OF CURB ELEVATION AND THE PLANT OCCUR FOR TREE REMOVAL AND PLANTING.
24. ADA RAMPERS SHALL NOT EXCEED 6" IN LENGTH AND 6" IN RISE (8.33% SLOPE MAX).
25. CONTRACTOR TO FIELD VERIFY LOCATION OF UNDERGROUND UTILITIES AND IMMEDIATELY NOTIFY ENGINEER OF RECORD OF ANY CONFLICTS WITH SIGNAGE FOUNDATIONS.
26. ALL ELEVATIONS SHOWN ON THESE PLANS ARE EDGE OF GRADE UNLESS OTHERWISE SPECIFIED.
27. ELEVATIONS ARE BASED ON NAVD83 DATUM DETERMINED BY GPS OBSERVATIONS, PROVIDED BY SURVEYOR.
28. TYPE C INLETS TO BE MODIFIED FOR H-20 TRAFFIC RATING.
29. TYPE D BOTTOM INLETS TO BE MODIFIED FOR H-20 TRAFFIC RATING.
30. ALL BUILDING ROOF DRAINS TO SLOPE UP AT 0.5% FROM LATERALS.

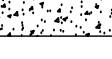


- | | |
|---|---|
| LEGEND | |
|  | EXISTING SPOT GRADE |
|  | PROPOSED STORM PIPE |
|  | PROPOSED STORM INLET |
|  | PROPOSED STORM MANHOLE |
|  | PROPOSED ±1,000 LF OF EXFILTRATION TRENCH |
|  | SLOPES |
|  | SPOT GRADE (NAVD) |
|  | TOP OF GRATE (NAVD) |
|  | PROPERTY LINE |
|  | EXISTING SIDEWALK |
|  | PROPOSED SIDEWALK |
|  | CROSS-SECTIONS SEE SHEETS C-301 AND C-302 |

[illegible]

Kimley»»Horn

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445 24TH STREET, SUITE 200, VERO BEACH, FL 32960
PHONE: 772-794-4100
WWW.KIMLEY-HORN.COM REGISTRY NO. 35106

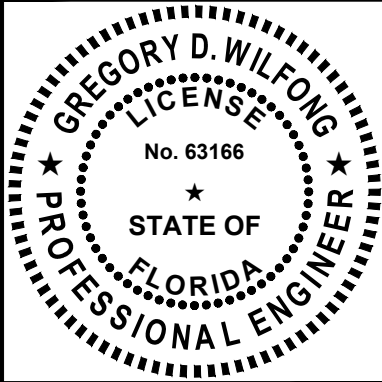

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| KHA PROJECT 147507131 | DATE 9/27/2024 | SCALE AS SHOWN |
| DESIGNED BY SHB | DRAWN BY SHB | CHECKED BY GDW |

OVERALL PAVING GRADING AND DRAINAGE PLAN

OAKWOOD SOUTH RETAIL SHOPPING CENTER

FL

SHEET NUMBER
C-300

CITY OF HOLLYWOOD

