



DEVELOPMENT SERVICES GENERAL APPLICATION PLANNING DIVISION

	PLANNING L	DIVISION			
API	PLICATION DATE: 1	0/26/2023	_	☐ Variance/Special Exception Reques	ted
Ro	00 Hollywood Blvd om 315 llywood, FL 33022	APPLICATION TYPE (CHECK ☐ Technical Advisory Committe ☐ City Commission		☐ Administrative Approvals ☐ Historic Preservation Board ☐ Planning and Development Board	leu
Em	: (954) 921-3471 nail: Development@ Ilywoodfl.org	Lot(s):20 AND 21 Blo	ck(s): <u>82</u>	ET, HOLLYWOOD FL 33019 Subdivision: <u>Hollywoo</u>	od Lakes
<u>sui</u>	BMISSION REQUIREMENTS: One set of digitally signed & sealed plans (i.e. Architect or Engineer)			_ Land Use Classification: <u>Residentia</u> Sq Ft/Number of Units: <u>1</u>	
•	One electronic combined PDF submission (max. 25mb) Completed Application	•	to the Cit	() Yes() No If yes, attach a copy of ty before? If yes, check all that apply a	
•	Checklist Application fee (per review)	DEVELOPMENT PROPOSAL Explanation of Request: New corresidence		on, 6,707 gross sq ft single family	У
		Phased Project: Yes / No Numb Project Units/rooms (# of units)	er of Phas Proposa		S.F.)
<u>NO</u>	TE: This application must	Proposed Non-Residential Uses Open Space (% and SQ.FT.)	0	(Area:	S.F. S.F.)
	be <u>completed in full</u> and submitted with all documents to be placed on a Board or	Parking (# of spaces) Height (# of stories)	5	(Area:	S.F.) FT.)
•	Committee's agenda. The applicant is	Gross Floor Area (SQ. FT)	6,707		
	responsible for obtaining the appropriate checklist for each type of application.		<u> Solden I</u>	SM PROPERTY LLC sles Dr, Apt 403, Hallandale Bea _{ess:} grant.manukyan@gmail.com	ach FL
•	Applicant(s) or their authorized legal agent must be present at all Board or Committee meetings.	Address: 2417 Hollywood Blv	d, Hollyv	Consultant Representative Tenant wood FLTelephone: 954920574	
	meetings.	Email Address: joseph@kallera Email Address #2: grant.manuk Date of Purchase: 3/9/2023 If Yes, Attach Copy of the Contract	yan@gr _ Is there		
FO	ICK HERE FOR RMS, CHECKLISTS, & ETING DATES	Noticing Agent (FTAC & Board su E-mail Address: cutroplanning@	ubmissions		

PLANNING DIVISION



2600 Hollywood Boulevard Room 315 Hollywood, FL 33022 File No. (internal use only):

GENERAL APPLICATION

CERTIFICATION OF COMPLIANCE WITH APPLICABLE REGULATIONS

The applicant/owner(s) signature certifies that he/she has been made aware of the criteria, regulations and guidelines applicable to the request. This information can be obtained in Room 315 of City Hall or on our website at www.hollywoodfl.org. The owner(s) further certifies that when required by applicable law, including but not limited to the City's Zoning and Land Development Regulations, they will post the site with a sign provided by the Office of Planning and Development Services. The owner(s) will photograph the sign the day of posting and submit photographs to the Office of Planning and Development Services as required by applicable law. Failure to post the sign will result in violation of State and Municipal Notification Requirements and Laws.

(I)(We) certify that (I) (we) understand and will comply with the provisions and regulations of the City's Zoning and Land Development Regulations, Design Guidelines, Design Guidelines for Historic Properties and City's Comprehensive Plan as they apply to this project. (I)(We) further certify that the above statements and drawings made on any paper or plans submitted herewith are true to the best of (my)(our) knowledge. (I)(We) understand that the application and attachments become part of the official public records of the City and are not returnable.

derstand that the approach and attachments become part of the official public records of the offi	y dilu die list returnasie.
Signature of Current Owner: GRANT MANGKYAN C	Date: 07/10/2023
PRINT NAME:	Date:
Signature of Consultant/Representative:	Date: <u>7-10-23</u>
PRINT NAME: TOSEM B. KALLER	Date: 1-10-23
Signature of Tenant:	Date:
PRINT NAME:	Date:
Current Owner Power of Attorney	
I am the current owner of the described real property and that I am aware to my property, which is hereby to be my legal representative before the Committee) relative to all matters concerning this application.	made by me or I am hereby authorizing
Sworn to and subscribed before me	-4
this 10 day of July 1033	Signature of Current Owner
LAURIE YODER Notary Public - State of Florida Commission # HH 2696 My Comm. Expires May 12, 2024	Grant Manuxyan
Notary Public Bonded through National Notary Assn.	Print Name
State of Florida	
My Commission Expires:(Check One) Personally known to me; OR	Produced Identification



Site Address	728 TYLER STREET, HOLLYWOOD FL 33019-1325	ID#	5142 14 02 5640
Property Owner	SF&GM PROPERTY LLC	Millage	0513
Mailing Address	2822 WASHINGTON ST HOLLYWOOD FL 33020	Use	01-01
Abbr Legal Description	HOLLYWOOD LAKES SECTION 1-32 B LOT 20,21 BLK 82		

The just values displayed below were set in compliance with Sec. 193.011, Fla. Stat., and include a reduction for costs of sale and other adjustments required by Sec. 193.011(8).

* 2023 valu	es are consid	ered	l "working v	a lues p	ony A	vesaubjent te	۷þ	nnge				
Year	Land		Building / Improvement		Just / Market Value		Assessed / SOH Value		Tax	(
2023*	\$168,290		\$597,	010		\$765,30	0		\$645,85	50		
2022	\$168,290		\$418,	850		\$587,14	0		\$587,14	10	\$12,50°	1.95
2021	\$168,290		\$435,	880		\$604,17	0		\$134,58	30	\$2,228	.37
		202	23* Exempt	ions a	and Ta	axable Values	s k	by Ta	xing Authori	ty		
			Co	unty		School B	oa	ard	Munici	ipal	Indep	endent
Just Value			\$765	5,300		\$765	5,3	300	\$765,	300	\$	765,300
Portability				0				0	0			0
Assessed/	SOH		\$645	,850		\$765	5,3	300	\$645,850		\$645,85	
Homestea	d			0				0	0		(
Add. Home	estead			0				0	0 0		0	
Wid/Vet/Di	s			0				0		0	0	
Senior				0				0		0	0	
Exempt Ty	pe			0				0		0	(
Taxable			\$645	5,850		\$765,300 \$645,850		\$645,850				
		Sal	es History						Land	Calc	ulations	
Date	Type		Price	Во	ok/Pa	ge or CIN			Price		Factor	Type
3/9/2023	WD-Q	\$	805,000		1187	56379		\$	\$14.00		12,021	SF
2/2/2021	WD-Q	\$	535,000		1170	117033749						
1/1/1975	WD	9	\$43,500		6091	/ 425						
5/1/1969	WD	3	\$27,000									
12/1/1963	WD	9	\$20,500					Ad	j. Bldg. S.F.	(Car	d, Sketch)	2147
							_		Units/Be	ds/Ba	aths	1/3/3
									Eff./Act. Ye	ar B	uilt: 1947/193	5

	Special Assessments							
Fire	Garb	Light	Drain	Impr	Safe	Storm	Clean	Misc
05								
R								
1								

NAME OF OWNER PRANK CARCELL ADDRESS 728 TILLER SI LEGAL DESCRIPTION The state of the s DESCRIPTION OF CONST. ARCHITECT: PERMIT TYPE NO. DATE BLDG. ROOF 82686 2-27-69 ELECTRICAL 5-16-67 37572 PLUMBING GAS SEPTIC, SEWER A/C DUCTS/700 72257 5-22-67 SCREEN ENCL. POOL DR IVEWAY FENCE THE THE SECOND CONTRACT OF SECOND AND SHOWN

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DESCRIPTION OF	CONSTRUCTION		of 6' wooden	fence					SEPTIC TABLE SENTER TABLE
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	63923	9/2/80	owner	PATIO					

DOTES:

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Permit Search Results

Search > Properties located at/on/near '...728...'

5 permits were found for 728 TYLER ST

View	Process #	Permit #	Description	<u>Appl.</u> Date	Permit Date
<u>Details</u>		B9401327	WINDOW REPLACEMENT		3/4/1994
Details		B9305216	WINDOW REPLACEMENT		8/5/1993
<u>Details</u>		B9107645	WINDOW REPLACEMENT		11/19/1991
<u>Details</u>		B9102916	FENCE-WOOD,CHAIN LINK,ETC.		5/10/1991
<u>Details</u>		B9100821	RE-ROOF- METAL,TILE,WOOD SHINGLE OR SHAKE		2/13/1991

Permit Details

Process #:	Permit #: B9102916	Master Permit: B9102916	
	Statu	s: Closed	
	List All S	Subpermits	

Site Information

Address: 728 TYLER ST Folio#: 514214025640

Sub-division: HOLLYWOOD LAKES SECTION Value: \$800.00

Lot: 20 Block: 82 Sq Ft: 0

Permit Information

Application Type: FENCE-WOOD, CHAIN LINK, ETC.

Job Name: COVINGTON,D & BLAIR

Film Number: F921873

Application Date: 00/00/00 Permit Date: 05/10/91

CO/CC Date:

Total Fees: \$30.35

Applicant / Contact Information

Name: COVINGTON,D & BLAIR

Address:

Property Owner Information


Name: COVINGTON,D & BLAIR

Address:

Contractor Information

Name: Address:

42/872 92/8)3 ADBRESS Madalala Ca

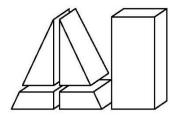

ARBAB ENGINEERING, INC.

CONSULTING ENGINEERS. 3363 NE 163rd STREET, SUITE 701. N.MIAMI BEACH, FL 33160. (305)940-3088. FAX: (305)940-3273

July 31, 2023

City of Hollywood Planning Division 2600 Hollywood Boulevard, Room 315 Hollywood, Florida 33022

Re: Structural Evaluation Report for: 728 Tyler Street Hollywood, Florida

To Whom It May Concern:

This report has been prepared for the specific purpose of evaluating the current structural condition of the single-family residence located at above referenced property. The descriptions that follow below are our professional opinions based on experience as a result of visual observations of the building on June 15 and July 27, 2023.

While there may be latent conditions that have not been fully explored and are not identified such as attic and crawl spaces, this does not impede the fundamental conclusions stated in this report.

STRUCTURAL FRAMING OF THE HOUSE:

This residence is one-story with wood rafters supporting the barrel tile roof and transferring the load to the exterior masonry walls and to the foundation.

The foundation of this house appeared to be spread footing on compacted fill.

There is an addition to the house at the East side, which is wood frame structure.

Separate small structure is also located at the South side of this property, with breezeway between the house and this structure.

Floor framing of the house consists of wood joists, transferring the load to the exterior and interior stem walls and ultimately to the foundation.

Crawl space is located under the main house, however, the structure at the South does not have crawl space, and is slab on grade.

City of Hollywood Planning Division

Page 2 July 31, 2023

Re: Structural Evaluation Report for:

728 Tyler Street

STRUCTURAL INSPECTION AND FINDINGS:

During our observations conducted on July 15 and June 27, 2023, this office observed the followings:

- 1. Existing roof beams around the entire perimeter of the house are separated from the masonry wall below the beam and continuous horizontal crack is visible all around the entire exterior perimeter of the house.
- 2. Settlement of the foundation is visible at the East side of this house and step crack on the exterior of the wall extending from the roof to the ground level is indication of settlement.
- 3. All windows and door are in very poor condition and framing and attachments to the walls are not providing resistance to required wind load. All windows and doors are sub-standard and do not comply with the requirements of Florida Building Code.
- 4. Addition to the house at east side constructed with wood frame is badly damaged and is in state of collapse.
- 5. Ground floor concrete slab on front of detached one story structure in the southside is cracked in numerous places.
- 6. Trellis between the main house and detached structure is in poor condition.
- 7. Front step to the house with bricks are settling and steps are loose.
- 8. Entrance door to the house is badly rusted and is in poor condition.
- 9. Exterior stucco is discolored and cracked in several locations throughout.
- 10. Surface of the concrete tie beams at roof level are bleeding rust in several locations.
- 11. Old shutters are loose and are in poor condition.
- 12. Some of the framing for old exterior awning are badly deteriorated and covers are broken apart from the framing.
- 13. Entrance light fixture on top of the wood post is loose and is in state of collapse.
- 14. Vertical and horizontal crack is visible on the exterior wall, particularly along the bottom of roof tie beam.

City of Hollywood Planning Division

Page 3 July 31, 2023

Re: Structural Evaluation Report for: 728 Tyler Street

- 15. Concrete beams above some of the the windows are badly cracked and are in poor condition.
- 16. Vertical cracks are visible on the surface of exterior walls.
- 17. Ceiling material is peeling off the ceiling and moisture intrusion is visible.
- 18. Surface damage is visible on the interior walls, around a small window, and above the top corners of the door.
- 19. Cracks and spalled concrete are visible at corner of windows.
- 20. A/c wall units are in poor condition.
- 21. Horizontal cracks directly above the windows are visible in several locations.
- 22. Broken pieces of furniture are scattered in the trellis area.
- 23. The exterior doors and windows are rotted, due to moisture and termite infestation.
- 24. There are damaged walls and ceiling, due to moisture intrusion and termite infestation.
- 25. Most of the original electrical system is still in place, which represent potential fire hazard, due to the use of outdated cloth wiring.
- 26. The finished floor elevation is barely above grade and is roughly a couple of feet below the minimum FEMA flood elevation criteria.

Conclusion:

It is clear that the foundation, floor joists, roof rafters, floor & roof decking, plumbing system, and electrical systems are damaged and continue to deteriorate for reasons previously stated, the first floor of is a couple of feet below flood level and it appears that structure is supported by spread footing and not by piles and grade beams. The lack of reinforced masonry walls and proper metal connectors to fasten the roof structure to the exterior walls and foundation make the buildings unsafe and suspect to catastrophic failure and potential collapse during a hurricane or other strong wind event. The considerable cost to repair, reinforce, replace, and reconstruct the structural and MEP systems to provide building that meet the current Florida Building Code and allow for the safe & healthy human habitation would lead to a Substantial Improvement condition. That would mandate that the buildings be brought into full compliance with current FEMA regulations and the 2020 Florida Building Code. In my professional opinion based on knowledge and experience, due to the extent of damage to the structure that is visibly evident, as well as the latent damage and deterioration that is festering below the ground and behind finishes, the existing one story building should be demolished since rehabilitation is not a feasible option.

City of Hollywood Planning Division

Page 4 July 31, 2023

Re: Structural Evaluation Report for: 728 Tyler Street

If you have any questions regarding this structural evaluation report, feel free to contact me in my office at 305-940-3088 during office hours.

Sincerely,


Ali Arbab, P.E.

For Arbab Engineering, Inc. FL # PE 35460, SI #456



AA/aa

Z:\Drive\2023 Projects\728 Tyler/ Report\728 Tyler Evaluation Report

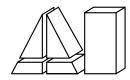

3363 NE 163rd STREET, SUITE 701 NORTH MIAMI BEACH, FLORIDA 33160 PHONE NO. (305) 940-3088 FAX. NO. (305) 940-3273 Page: P-1

Project: STRUCTURAL EVALUATION REPORT


> 728 Tyler Street Hollywood, Florida



CONTINUOUS CRACK UNDER ROOF TIE BEAM



ROOF BEAM, RUST BLEEDING AND WALL CRACK

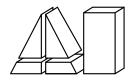


3363 NE 163rd STREET, SUITE 701 NORTH MIAMI BEACH, FLORIDA 33160 PHONE NO. (305) 940-3088 FAX. NO. (305) 940-3273 Page: Project:

P-2 STRUCTURAL EVALUATION REPORT


728 Tyler Street Hollywood, Florida



WALL CRACKS AND SPALLED AND CRACKED ROOF BEAM

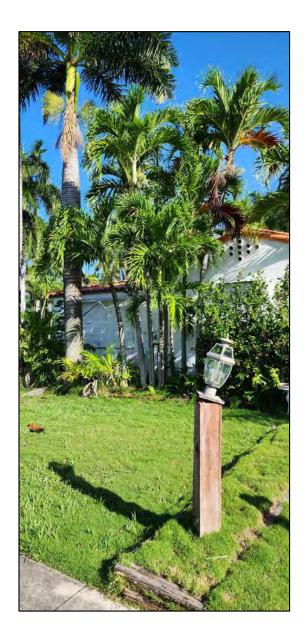

DAMAGED ENTRANCE LIGHT **FIXTURE**

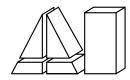

3363 NE 163rd STREET, SUITE 701 NORTH MIAMI BEACH, FLORIDA 33160 PHONE NO. (305) 940-3088 FAX. NO. (305) 940-3273 Page: Project:

P-3 STRUCTURAL EVALUATION REPORT


728 Tyler Street Hollywood, Florida



VIEW OF MAIN ENTRANCE TO THE HOUSE



VIEW OF MAIN ENTRANCE AND PARTAIL NORTH WALL

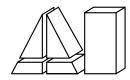

3363 NE 163rd STREET, SUITE 701 NORTH MIAMI BEACH, FLORIDA 33160 PHONE NO. (305) 940-3088 FAX. NO. (305) 940-3273 Page: Project: P-4

STRUCTURAL EVALUATION REPORT


728 Tyler Street Hollywood, Florida







WEST ENTRANCE TO DETACHED STRUCTURE WITH CRACKED **CONCRETE SLAB**

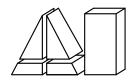

3363 NE 163rd STREET, SUITE 701 NORTH MIAMI BEACH, FLORIDA 33160 PHONE NO. (305) 940-3088 FAX. NO. (305) 940-3273 Page: Project:

P-5 STRUCTURAL EVALUATION REPORT


728 Tyler Street Hollywood, Florida



STEP DOWN CRACK ON EXTERIOR WALL



EXTERIOR WALL WITH HORIZONTAL AND VERTICAL CRACKS

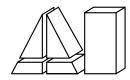

3363 NE 163rd STREET, SUITE 701 NORTH MIAMI BEACH, FLORIDA 33160 PHONE NO. (305) 940-3088 FAX. NO. (305) 940-3273 Page: Project:

P-6 STRUCTURAL EVALUATION REPORT


728 Tyler Street Hollywood, Florida



DAMAGED AND CRACKED BEAM ABOVE THE WINDOW



WALL CRACK

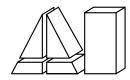

3363 NE 163rd STREET, SUITE 701 NORTH MIAMI BEACH, FLORIDA 33160 PHONE NO. (305) 940-3088 FAX. NO. (305) 940-3273 Page: Project:

P-7 STRUCTURAL EVALUATION REPORT


728 Tyler Street Hollywood, Florida







MOISTURE INTRUSION AND DAMAGED CEILING

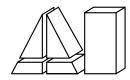

3363 NE 163rd STREET, SUITE 701 NORTH MIAMI BEACH, FLORIDA 33160 PHONE NO. (305) 940-3088 FAX. NO. (305) 940-3273 Page: Project:

P-8 STRUCTURAL EVALUATION REPORT


728 Tyler Street Hollywood, Florida








DAMAGED WALL AT UPPER PORTION OF THE WALL AND AROUND WINDOW FRAME

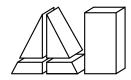

3363 NE 163rd STREET, SUITE 701 NORTH MIAMI BEACH, FLORIDA 33160 PHONE NO. (305) 940-3088 FAX. NO. (305) 940-3273 Page: Project:

P-9 STRUCTURAL EVALUATION REPORT


728 Tyler Street Hollywood, Florida

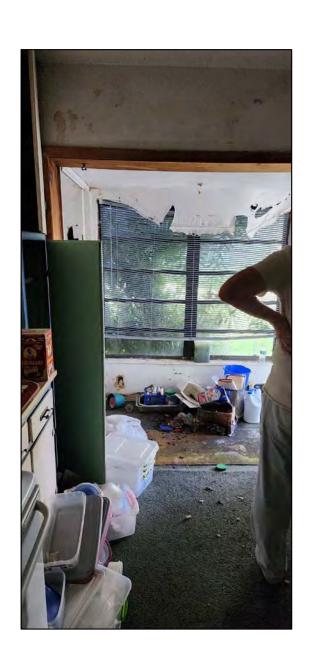





EXTERIOR HORIZONTAL AND VERTICAL CRACKS ADJACENT TO THE WINDOW

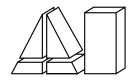


ARBAB ENGINEERING, INC.

3363 NE 163rd STREET, SUITE 701 NORTH MIAMI BEACH, FLORIDA 33160 PHONE NO. (305) 940-3088 FAX. NO. (305) 940-3273 Page: Project:

P-10 STRUCTURAL EVALUATION REPORT


728 Tyler Street Hollywood, Florida



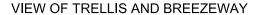



VIEW OF BREEZEWAY AND DAMAGED FURNITURE AND DEBRIS

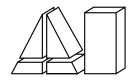

3363 NE 163rd STREET, SUITE 701 NORTH MIAMI BEACH, FLORIDA 33160 PHONE NO. (305) 940-3088 FAX. NO. (305) 940-3273 Page: Project:

P-11 STRUCTURAL EVALUATION REPORT

728 Tyler Street Hollywood, Florida







ENTRANCE TO THE HOUSE



728 TYLER STREET, HOLLYWOOD, FL 33019

DECISIONS ON CERTIFICATES OF APPROPRIATENESS FOR DEMOLITION FOR EXISTING STRUCTURE

The Zoning and Land Development Regulations <u>Section 5.5.F.4.e</u> states the Historic Preservation Board shall consider the following Criteria in evaluating an Application for Certificate of Appropriateness for Demolition.

CRITERION 1:

The building, structure, improvement, or site is designated on either a National, State or Local level as a Historic Preservation District or an Architectural Landmark or Site.

ANALYSIS: The Building is in Hollywood Beach North and South Lake District on the Northern side of Hollywood Boulevard facing Tyler Street and close-proximity to the Atlantic Intercostal Waterway.

CRITERION 2:

The building, structure, improvement, or site is of such design, craftsmanship, or material that it could be reproduced only with great difficulty or expense.

ANALYSIS: The finish floor elevation of the existing one-story structure is currently 3.59' NAVD '88, which makes it difficult for the existing structure to comply with today's FEMA's minimum standards and still be compliant with the 50% improvement rule.

CRITERION 3:

The building, structure, improvement, or site is one of the last remaining examples of its kind in the neighborhood, the county, or the region

ANALYSIS: The existing building has been renovated numerous times in its tenure. However, the building lost its architectural identity making it an eclectic structure and isn't considered to be an architectural example.

CRITERION 4:

The building, structure, improvement, or site contributes significantly to the Historic Character of a Historically Designated District.

ANALYSIS: The existing building does not contribute to the Historical Character of the neighborhood in any way shape or form, but the new proposed 2-story Modern-Contemporary building will make a statement emphasizing its rich contextual environment of the Intercoastal Waterway and Hollywood Beach Broadwalk.

CRITERION 5:

Retention of the building, structure, improvement or site promotes the general welfare of the City by providing an opportunity for study of local history, architecture and design or by developing an understanding of the importance and value of a particular culture and heritage.

ANALYSIS: The existing one-story building being demolished does not in any way add value to the Community. Its removal will help the transition between the unmaintained 1930's Eclectic style and the new Modern-Day Contemporary architectural style come together re-establishing its architectural identity.

CRITERION 6:

There are definite plans for reuse of the property if the proposed demolition is carried out, and those plans will adversely affect the historic character of the Historic District.

ANALYSIS: The new Two- Story Contemporary-Modern Residence will add more Drama and Character to Tyler Street's curb appeal making it the gateway for pedestrians to walk to and from the Intercoastal Waterway and Hollywood Beach Broadwalk.

CRITERION 7:

The Unsafe Structures Board has ordered the demolition of a structure or the feasibility study determines that the retention of the building would deny the Owner of all economically viable uses of the Property.

ANALYSIS: This has not been reviewed by the Unsafe Structures Board.

CRITERION 8:

The information listed in the Historic Properties Database (a listing of historic and non-historic properties), as a guideline in determining whether a certification of Appropriateness for Demolition should be issued.

ANALYSIS: There are no records of this house in archives.

Sincerely,



Giovanni Muñoz Vargas NCARB – NAR - AIA assoc. | Associate

2417 Hollywood Blvd Hollywood, FL

t. 954 920 5746 c. 305 586 7952

e. giovanni@kallerarchitects.com

w. kallerarchitects.com









Mitchell Fraiman NCARB, AIA | Architectural Associate 2417 Hollywood Blvd Hollywood, FL t. 954 920 5746 e. mfraiman@kallerarchitects.com

w. Kallerarchitects.com









City of Hollywood 2600 Hollywood Boulevard Hollywood, Florida 33020 August 2nd, 2023

Re:

728 Tyler Street Hollywood, Florida 33019 Architect's Project #23064

CRITERIA OF APPROPRIATENESS FOR DESIGN

728 Tyler Street – New Single-Family Residence

CRITERION 1: INTEGRITY OF LOCATION

The property is located in the Hollywood Beach North and South Lake District on the northern side of Hollywood Boulevard close proximity to the Atlantic Intercoastal Waterway, built in 1935 as a 1-story single-family residence that sits alongside its respective residential zoning. The newly proposed Two-story Single-Family Residence sits on a 100'-0" wide lot similar to its neighboring properties within its zoning designation of RS-6.

CRITERION 2: DESIGN

ANALYSIS: The existing building was built in 1935 and there are no records revealing the existing structure has any contribution to the Historic District. Through the years, it was repaired and renovated with poor workmanship diminishing the overall structural and aesthetic integrity. On the contrary, the new proposed building refreshes the curb appeal alongside Tyler Street with a modern-contemporary style. This proposed structure will become a gateway to Hollywood Beach Boardwalk from Tyler Street, in which the design highlights a two-story volume with tall glass windows at the front and rear of the building inviting an abundance of natural light while also highlighting the richness of the surrounding contextual environment.

The main design concept is based on two floating cubes that wrap around a higher volumetric core. The cube that wraps the north and southwest corner is comprised of a series of social spaces and bedrooms with terraces overlooking the waterway and private pool deck. The second cube that wraps the north and south-east corner has the main bedroom and outdoor terraces. The center volumetric core serves as the heartbeat of the design concept, upon main entry is the main family space and staircase that encompasses a two-story volume with a second floor "catwalk" connecting both floating cubes.

CRITERION 3: SETTING

The setting of the existing single-family residence is typical to most of the homes in the Historic District Section seating on the south side of Tyler St. with access to Hollywood Beach Boardwalk and Atlantic Intercoastal Waterway.

CRITERION 4: MATERIALS

All materials/colors to be used in the proposed building are to be a series of light and dark grey tones with features of composite wood panels and smooth stucco finishes.

CRITERION 5: ASSOCIATION

The proposed new construction has been designed to be a Two- Story Single Family Residence with access to a rooftop terrace. On the ground floor will be a series of steps leading to the main entry door. Upon entry is the double-height family room, to the left will be a fully open staircase and the main bedroom. To the right side will be the two-car garage, utility rooms and the main social spaces towards the rear of the building overlooking the private pool deck. Upon arrival at the second floor, to the left will be a covered outdoor terrace with an auxiliary spiral staircase leading up to the rooftop terrace. To the right side of the "catwalk" will be the bedroom quarters with direct access to their respective private bathrooms and terraces.

The Architectural style reflects Modern-Contemporary with pure orthogonal geometries and volumetric elements.

CRITERION 6: WORKMANSHIP

The workmanship on the proposed new construction will be a guarantee that all State and Local regulations are to be upheld. Proper barricading will be provided during the demolition of the existing structure and new construction work. All practices will meet or exceed requirements of the Florida Building Code 2020, 7th edition and the State of Florida Department of Environmental Protection.

Should you have any questions, please feel free to contact this office.

Sincerely,



KallerArchitecture

Giovanni Muñoz Vargas NCARB - NAR - AIA assoc. | Associate 2417 Hollywood Blvd Hollywood, FL

- **t.** 954 920 5746 **c.** 305 586 7952
- e. giovanni@kallerarchitects.com
- w. kallerarchitects.com











Mitchell Fraiman | NCARB, AIA | Architectural Associate 2417 Hollywood Blvd Hollywood, FL t. 954 920 5746 e. mfraiman@kallerarchitects.com

w. Kallerarchitects.com









Existing

LEGAL DESCRIPTION:

LOTS 20 AND 21, BLOCK 82, OF "HOLLYWOOD LAKES SECTION", ACCORDING TO THE PLAT THEREOF, AS RECORDED IN PLAT BOOK 1, AT PAGE 32, OF THE PUBLIC RECORDS OF BROWARD COUNTY, FLORIDA.

Proposed

Two-Story Single-Family Residence. 4 bedrooms 4 bathrooms + 1 powder room outdoor bbq area with a pergola, 2 car garage, and a pool. Total sqft 4,500 sqft under AC.





PINNELL SURVEY, INC.

5300 WEST HILLSBORO BOULEVARD, SUITE 215-A COCONUT CREEK, FLORIDA 33073 PHONE: (954)418-4940 FAX: (954)418-4941 LICENSED BUSINESS #6857

PROJECT ADDRESS: 728 TYLER STREET HOLLYWOOD, FLORIDA 33019

LEGAL DESCRIPTION:

LOTS 20 AND 21, BLOCK 82, HOLLYWOOD LAKES SECTION, ACCORDING TO THE MAP OR PLAT THEREOF, AS RECORDED IN PLAT BOOK 1, PAGES 32, OF THE PUBLIC RECORDS OF BROWARD COUNTY, FLORIDA.

ENCROACHMENT NOTES:

- (1) 6 FOOT WOOD FENCE CROSSES OVER THE WESTERLY PROPERTY LINE.
- CONCRETE CROSSES OVER THE SOUTHERLY PROPERTY LINE.

OWNERSHIP & ENCUMBRANCE REPORT

THE PROPERTY SHOWN HEREON WAS SURVEYED BASED ON OWNERSHIP & ENCUMBRANCE REPORT PREPARED BY LOHMAN & WEISMAN PLLC, DATED AUGUST 1, 2023.

SPECIAL EXCEPTIONS CONTAINED IN OWNERSHIP & ENCUMBRANCE REPORT:

- RESTRICTIONS, COVENANTS, CONDITIONS, EASEMENTS AND OTHER MATTERS AS CONTAINED ON THE PLAT OF HOLLYWOOD LAKES SECTION, RECORDED IN PLAT BOOK 1, PAGE 32, OF THE PUBLIC RECORDS OF BROWARD COUNTY, FLORIDA. THIS ITEM AFFECTS THE SUBJECT PROPERTY AND IS SHOWN HEREON.
- RESOLUTION NO. 09-V-11 RECORDED IN OFFICIAL RECORDS BOOK 46111, PAGE 231 OF THE PUBLIC RECORDS OF BROWARD COUNTY, FLORIDA. THIS ITEM WAS NOT PROVIDED.
- RESTRICTIONS, COVENANTS, CONDITIONS, AS SET FORTH IN THAT INSTRUMENT RECORDED IN DEED BOOK 192, PAGE 369, AS MAY BE SUBSEQUENTLY AMENDED. THIS ITEM WAS NOT PROVIDED.

GENERAL NOTES:

- 1) TYPE OF SURVEY: BOUNDARY 2) IF THIS SURVEY HAS BEEN REVISED AS INDICATED IN THE REVISION BOX SHOWN HEREON, THEN ANY AND ALL PREVIOUS VERSIONS OF THIS SURVEY PREPARED BY PINNELL SURVEY, INC. ARE NULL & VOID.
- 3) THE BROWARD COUNTY TAX I.D. NUMBER FOR THE PROPERTY SHOWN HEREON IS 514214025640 AND IS CURRENTLY OWNED BY SF&GM PROPERTY, LLC.
- 4) THE AREA OF THE PROPERTY SHOWN HEREON IS 12,100 SQUARE FEET (0.2778 ACRES) MORE OR LESS. 5) THIS SURVEY IS NOT VALID WITHOUT THE ORIGINAL SIGNATURE AND SEAL OF A FLORIDA
- LICENSED SURVEYOR AND MAPPER, UNLESS IT HAS BEEN ELECTRONICALLY SIGNED AND SEALED. 6) ALL ELEVATIONS SHOWN HEREON, ARE RELATIVE TO NORTH AMERICAN VERTICAL DATUM OF 1988. 7) BY GRAPHIC PLOTTING ONLY, THE PROPERTY SHOWN HEREON IS LOCATED WITHIN A FLOOD ZONE "AE" WITH
- A BASE FLOOD ELEVATION OF 6 FEET, AS SHOWN ON F.I.R.M. MAP 125113-0588-H, BEARING A MAP REVISION DATE OF 08/18/14.
- 8) UNDERGROUND IMPROVEMENTS AND UTILITIES ARE NOT LOCATED. 9) UNLESS OTHERWISE NOTED, ALL FIELD MEASUREMENTS ARE IN AGREEMENT WITH RECORD MEASUREMENTS.
- 10) FENCE AND WALL OWNERSHIP IS NOT DETERMINED. 11) THIS DRAWING IS THE PROPERTY OF PINNELL SURVEY, INC. AND SHALL NOT BE USED OR REPRODUCED,
- WHOLE OR IN PART WITHOUT WRITTEN PERMISSION & AUTHORIZATION FROM PINNELL SURVEY, INC. 12) REFERENCE BENCHMARK ELEVATION DATUM WAS CONVERTED FROM NGVD 1929 TO NAVD 1988 USING
- CORPSCON 6.0.1. 13) REFERENCE BENCHMARK: BROWARD COUNTY BENCHMARK #1915
- ELEVATION=3.268' NGVD 1929/ELEVATION=1.670' NAVD 1988. 14) TREE DESCRIPTIONS AS SHOWN HEREON ARE GENERAL IN NATURE AD SHOULD BE VERIFIED.
- 15) DATE FIELDWORK PERFORMED: 03/28/23 (FIELD BOOK 658, PAGE 60) 16) DRAWN BY: Q.D.I. CHECKED BY: J.P./K.M.

CERTIFICATION:

SF&GM PROPERTY, LLC., A FLORIDA LIMITED LIABILITY COMPANY FIDELITY NATIONAL TITLE INSURANCE COMPANY TITLE BROTHERS, LLC

THIS IS TO CERTIFY THAT THIS MAP OR PLAT AND THE SURVEY ON WHICH IT IS BASED WERE MADE IN ACCORDANCE WITH THE 2021 MINIMUM STANDARD DETAIL REQUIREMENTS FOR ALTA/NSPS LAND TITLE SURVEYS, JOINTLY ESTABLISHED AND ADOPTED BY ALTA AND NSPS, AND INCLUDES ITEMS 1, 2, 3, 4, 7(A), 7(B)(1), 7(C), 8(LOCATION OF SUBSTANTIAL FEATURES PER VISIBLE, ABOVE-GROUND, ON-SITE OBSERVATION; NO LANDSCAPED AREAS ARE LOCATED), 9, 13 AND 19 OF TABLE A THEREOF. THE FIELD WORK WAS COMPLETED ON MARCH 28, 2023 AND UPDATED ON JULY 3, 2023.

JASON H. PINNELL PROFESSIONAL SURVEYOR & MAPPER LICENSE NO. 5734 - STATE OF FLORIDA


THE SEAL APPEARING ON THIS DOCUMENT WA

EVISIONS:)
REVISION	DATE	CHECKED BY
ADD OWNERSHIP & ENCUMBRANCE REPORT	07/19/23	J.P.


PROJECT NAME: SF&GM PROPERTY, LLC.,

JOB NO.: 23-0507

ALTA/NSPS LAND TITLE SURVEY

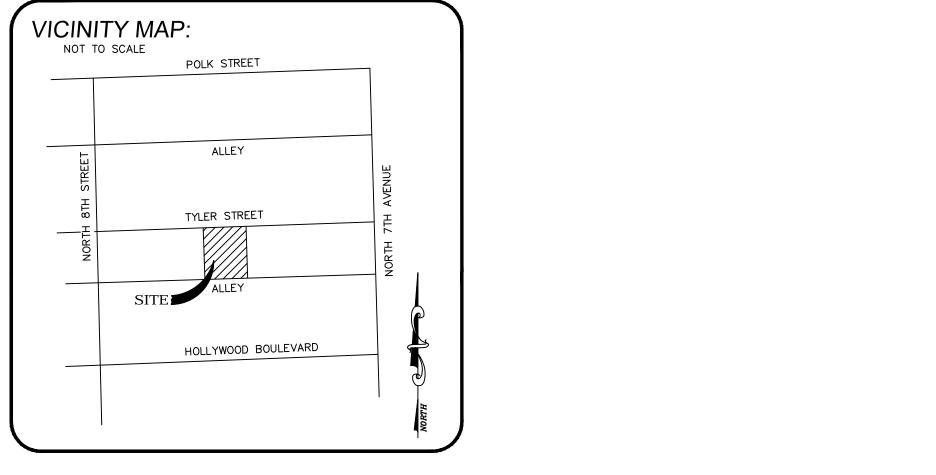

ADJOINING OWNER: DENYS PANIV GANNA STOPINA FOLIO #514214025641

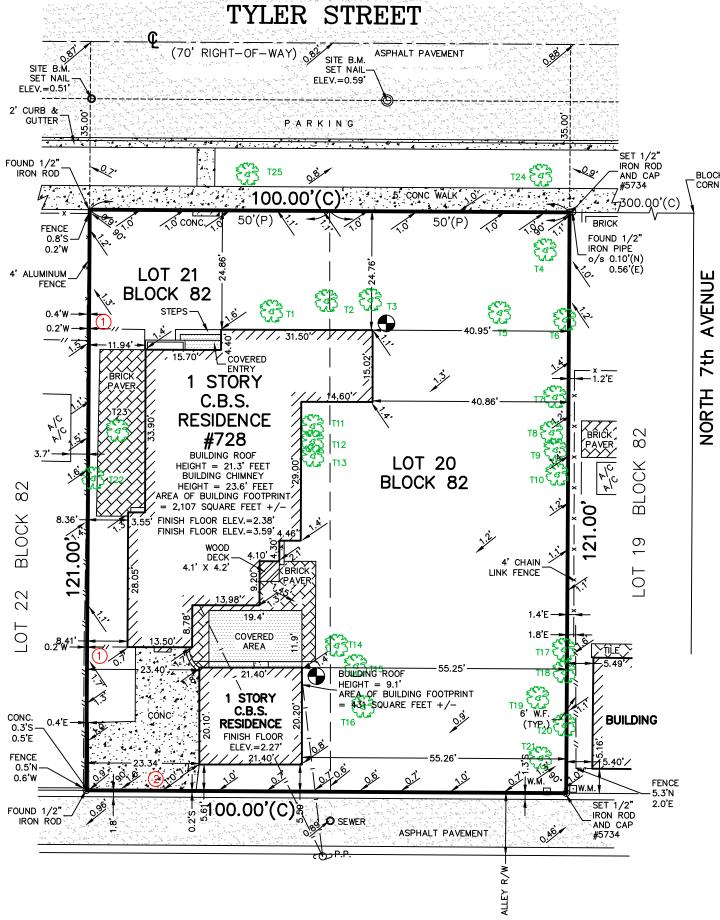

NOTE: DBH REPRESENTS DIAMETER AT BREAST HEIGHT

ADJOINING OWNER:

PAUL F. HANCOCK &

SANDRA S. COLEMAN

FOLIO #514214025630

C.L.P = CONCRETE LIGHT POLE C.P.P. = CONCRETE POWER POLE C.R. = CABLE RISERD = DEED MEASUREMENT E.S. = ELECTRIC SERVICE ELEV. = ELEVATIONS F.P.L. = FLORIDA POWER & LIGHT G.A. = GUY ANCHOR G.V. = GATE VALVE L.P. = LIGHT POLEM = MEASUREDM.C. = METAL COVERM-D.C.R. = MIAMI-DADE COUNTY RECORDSM.H. = MANHOLE M.W. = MONITORING WELL NAVD = NORTH AMERICAN VERTICAL DATUM NGVD = NATIONAL GEODETIC VERTICAL DATUM O.R.B. = OFFICIAL RECORDS BOOK P = PLAT MEASUREMENT P.B. = PLAT BOOK P.E. = POOL EQUIPMENT

P.O.B. = POINT OF BEGINNING

P.P. = POWER POLE

W.M. = WATER METER

TYP. = TYPICAL

ф

P.O.C. = POINT OF COMMENCEMENT

= AIR CONDITIONING UNIT = HANDI-CAPPED PARKING

= FIRE HYDRANT

= UTILITY POLE

= SPOT ELEVATION

LEGEND: B.M. =BENCHMARK

B.C.R. = BROWARD COUNTY RECORDS

C.B.S. = CONCRETE BLOCK STRUCTURE

= CENTERLINE

C.L.F. = CHAIN LINK FENCE

C.B. = CATCH BASIN

C.O. = CLEAN OUT

CONC. = CONCRETE

= CALCULATED MEASUREMENT

Survey prepared by Pinnell Survey, Inc.

= LOCATION OF INGRESS/EGRESS

= ENCROACHMENT REFERENCE

= TREE AND TREE NUMBER

= LOCATION OF BUILDING HEIGHT MEASUREMENT

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(IN FEET) 1 inch = 20 ft.

GRAPHIC SCALE

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Survey prepared by Pinnell Survey, Inc.

HISTORIC PRESERVATION BOARD **NEW TWO-STORY SINGLE - FAMILY RESIDENCE** 728 TYLER STREET HOLLYWOOD, FL 33019







PROPOSED

PROJECT TEAM

SF&GM PROPERTY LLC

HALLANDALE BEACH, FL 33009

ADDRESS: 137 GOLDEN ISLES DR #403

ARCHITECT

OWNER: JOSEPH B. KALLER AND ASSOCIATES, P.A. CONTACT: MR JOSEPH B. KALLER

ADDRESS: 2417 HOLLYWOOD BLVD. HOLLYWOOD, FL 33020 PHONE: (954) 920-5746

FAX: (954) 926-2841 EMAIL: JÓSEPH@KALLERARCHITECTS.COM

<u>SURVEYOR</u>

PINNELL SURVEY, INC CONTACT: JASON H PINNELL PHONE: (954) 418-4940 EMAIL: ORDÉR@FLAND.NET

ZEPHY ENGENEERING

CONTACT: WILDORF ZEPHYR PHONE: (786) 302-7639

LANDSCAPE

THE MIRROR OF PARADISE CONTACT: GABRIELA FOJT, RLA PHONE: (954) 315-1707 EMAIL: GABRIELA@THEMIRROROFPARADISE.COM **PROJECT DATA**

SUBJECT PROPERTY

A-101 A-102 SECOND FLOOR A-103 ROOF LEVEL

LANDSCAPE

LANDSCAPE REMOVAL PLAN + TREE SCHEDULE DT-2 LP-1

LP-2 LP-3

JURISDICTION

CITY OF HOLLYWOOD **BROWARD COUNTY** STATE OF FLORIDA

DRAWING INDEX

ARCHITECTURAL

COVER SHEET + PROJECT INFORMATION SURVEY INFORMATION SITE PLAN AND SITE DATA ADJACENT PROPERTIES

SP-1 SP-2 SP-3 SP-4 STREET PROFILE GROUND FLOOR

SOUTH ELEVATION A-401 NORTH ELEVATION A-401 A-402 WEST ELEVATION A-402 EAST ELEVATION

<u>CIVIL</u>

C-1 C-2 C-3 C-4 EROSION & SEDIMENT CONTROL PLAN PAVING GRADING & DRAINAGE PLAN WATER PLAN & DETAILS WATER DETAILS

PROTECTION DETAIL & MITIGATION CALCULATIONS LANDSCAPE PLAN, PLANT SCHEDULE, CODE CHART LANDSCAPE NOTES

COLORED SITE PLAN


LOCATION MAP





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COVER

REVISIONS
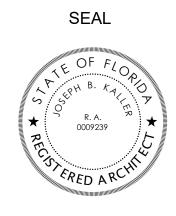
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PROJECT No.: 23064 DATE: DRAWN BY: CHECKED BY:



SCALE: 3/32" = 1' - 0"

GREEN BUILDING PRACTICES

1. RADIANT BARRIER ROOF - SEALOFLEX COOL ROOF -REFLECTO WHITE. WALLS - AL-FOIL REFLECTIVE 2. WINDOWS AND GLAZING LOW E, TINTED DOUBLE GLAZING- U FACTOR 0.56, SHGC 0.25

3. DOORS INSULATED AND FIRE RATED

4. ENERGY STAR ROOFING SEALOFLEX COOL ROOF -REFLECTO WHITE.

5.PROGRAMMABLE THERMOSTATS

6. OCCUPANCY SENSORS 7. DUAL FLUSH TOILETS

8. 80% OF PLANT MATERIAL NATIVE

9. ENERGY EFFICIENT OUTDOOR LIGHTING

10. INSULATED PIPING 11. RECYCLING AREA

12. ENERGY STAR APPLIANCES

13. ONE LOW FLOW SHOWERHEAD

14. ENERGY EFFICIENT OUTDOOR LIGHTING

15. ENERY EFFICIENCY 10% BETTER THAN STANDARD ESTABLISHED BY ASHRAE.

16. MERV 8 AC FLITERS

SITE LIGHTING LEVELS SHALL NOT EXCEED 0.5 FC AT THE PROPERTY LINE ADJACENT TO RESIDENTIALLY ZONED OR RESIDENTIALLYUSED AREAS.

PER NFPA 1, 12.3.2* A QUALITY ASSURANCE PROGRAM FOR THE INSTALLATION OF DEVICES

AND SYSTEMS INSTALLED TO PROTECT PENETRATION AND JOINTS SHALL BE PREPARED AND MONITORED BY THE REGISTERED DESIGN

PROFESSIONAL RESPONSIBLE FOR DESIGN. INSPECTIONS OF FIRE STOP SYSTEMS AND FIRE-RESISTIVE JOINT SYSTEMS SHALL

BE IN ACCORDANCE WITH 12.3.2.1 AND 12.3.2.1.

NFPA 1(2015 EDITOR) CHAPTER 11.10 REQUIERS THAT MINIMUM RADIO

SIGNAL STRENGTH FROM FIRE DEPARTMENT COMMUNICATIONS BE MAINTANED AT A LEVEL DETERMINED BY THE AHJ FROM ALL NEW

AND EXISTING BUILDINGS INCLUDING COMPLYNG WITH NFPA T2 (2013 EDITOR) BDA SYSTEM MAY BE REQUIERED

SITE LIGHTING NOTE:

SITE LIGHTING LEVELS SHALL NOT EXCEED 0.5 FC AT THE PROPERTY LINE ADJACENT TO RESIDENTIALLY ZONE OR RESIDENTIALLYUSED AREAS.

A PRE-HEAT MAP PLAN, CONCEPTUAL DRAWINGS AND CUT SHEETS WILL BE REQUIRED TO BE SUBMITTED WITH THE MAIN SET OF ARCHITECTURAL DRAWINGS FOR THE BDA SYSTEM

ALL CHANGES TO THE DESIGN WILL REQUIRE PLANING REVIEW AND MAY BE SUBJECT TO BOARD APPROVAL.

FEMA NOTE:

THE NATIONAL FLOOD INSURANCE PROGRAM IS IN THE PROCESS OF ISSUING NEW FLOOD MAPS. AT TIME OF BUILDING PERMIT THE FEMA BASE FLOOD ELEVATION SHOULD BE CHECKED TO ENSURE IT IS STILL COMPLIANT.

ALL MECHANICAL EQUIPMENT

SHALL BE SCREENED FROM PUBLIC VIEW.

BUILDING TO COMPLY WITH CHAPTER 108 REGARDING ALL MARINE TURTLE PROTECTION

ALL SIGNAGE TO COMPLY WITH THE REQUIREMENTS OF THE CITY OF HOLLYWOOD ZONING AND LAND DEVELOPMENT CODE BASED ON THE MC-1 ZONING DISTRICT. SEPARATE PERMIT ARE REQUIRED FOR EACH SIGN. ALL SIGNS, WHICH ARE ELECTRICALLY ILLUMINATED, SHALL REQUIRE A SEPARATE

ELECTRICAL PERMIT AND INSPECTION. NOTE: PRIOR TO POURING THE FIRST FLOOR TIE BEAM A SPOT SURVEY OF THE FINISHED FLOOR ELEVATION

MUST BE SUBMITTED TO THE BUILDING DEPT.

FEMA NOTE: THE NATIONAL FLOOD INSURANCE PROGRAM IS IN THE PROCESS OF ISSUING NEW FLOOD MAPS . AT TIME OF BUILDING PERMIT THE FEMA BASE FLOOD ELEVATION SHOULD BE CHECKED TO ENSURE IT IS STILL COMPLIANT.

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NOTE: PRIOR TO POURING THE FIRST FLOOR TIE BEAM A SPOT SURVEY OF THE FINISHED FLOOR ELEVATION MUST BE SUBMITTED TO THE BUILDING DEPT.

FEMA NOTE: THE NATIONAL FLOOD INSURANCE PROGRAM IS IN THE PROCESS OF ISSUING NEW FLOOD MAPS . AT TIME OF BUILDING PERMIT THE FEMA BASE FLOOD ELEVATION SHOULD BE CHECKED TO ENSURE IT IS STILL COMPLIANT.

FEMA NOTE: THE NATIONAL FLOOD INSURANCE PROGRAM IS IN THE PROCESS OF ISSUING NEW FLOOD MAPS.AT THE TIME OF BUILDING PERMIT THE FEMABASE FLOOD ELEVATION SHOULD BE CHECKED

TWO WAY RADIO COMPLIANCE: BUILDING WILL BE IN COMPLIANCE WITH N.F.P.A. 1, 11.10 AND BROWARD COUNTY CODE AMENDMENT 118.2 FOR TWO WAY RADIO COMMUNICATION.

NOTE: TRASH AND RECYCLE BIN TO BE INDIVIDUAL PER UNIT

TO ENSURE IT IS STILL COMPLAINT

ALL SIGNAGE TO COMPLY WITH THE REQUIREMENTS OF THE CITY OF HOLLYOOD ZONING AND LAND DEVELOPMENT CODE BASED ON THE HOLLYWOOD LAKES SECTION 1-32 B LOT 12.13 BLK 74 **RS-6 ZONING DISTRICT**

PROPERTY ADDRESS

728 TYLER STREET HOLLYWOOD, FL 33019

5142 14 01 5640

LEGAL DESCRIPTION

HOLLYWOOD LAKES SECTION 1-32 B LOT 20,21 BLK 82

SITE INFORMATION	<u>EXISTING</u>	<u>PROPOSED</u>
ZONING:	RS-6	N/A
SUB-DISTRICT:	N/A	N/A
BUILDING USE:	SINGLE FAMILY DWELLING	SINGLE FAMILY DWELLING
LAND USE DESIGNATION:	RESIDENTIAL	N/A
COUNTY USE DESIGNATION:	RESIDENTIAL	N/A
NET LOT AREA:	12,134 SQFT- 0.28 ACRES	N/A
GROSS LOT AREA:	14,372 SQFT- 0.33 ACRES	N/A
BASE FLOOD ZONE :	AE - 8.0' NAVD	

BUILDING INTENSITY	ALLOWED	<u>PROVIDED</u>
LOT COVERAGE	N/A	N/A
FAR:	N/A	N/A
A/C AREA:	N/A	5595.14 SF
BUILDING FOOT PRINT	N/A	3377.20 SF
NUMBER OF FLOORS	2	2
BUILDING HEIGHT	30 FEET	26.5 FEET

PARKING CALCULATION:	<u>REQUIRED</u>	<u>PROVIDED</u>
SINGLE FAMILY HOUSE OF 2,000 SF 1 SPACE PER EVERY 500 SF W/ CAP OF 5	5 (A/C AREA = 6707 SF)	5
TOTAL	= 5 SPACES	= 5 SPACES

SETBACKS:	REQUIRED	<u>PROVIDED</u>
ALLOWABLE BALCONY ENCROACHMENT (75	5%)	
(a) FRONTAGE (TYLER) (NORTH)	25.0'	25' - 0"
(b) SIDE INTERIOR (EAST)	17.5' MIN	19' - 3"
(c) SIDE INTERIOR (WEST	7.5' MIN	12' - 5"
(d) REAR	18.15'	19' - 0"
Λ Λ Γ Γ Γ Γ		

<u>LANDSCAPE</u>		<u>PROVIDED</u>
IMPERVIOUS AREA PARKING, SIDEWALKS & DRIVES		3148.12 SF (36,3%)
PERVIOUS AREA LANDSCAPE AREAS (TOTAL)		5518.43 SF (63,7%)
GROSS BUILDING AREA:		INTERIOR
	FIRST FLOOR	3365.20 SF
	SECOND FLOOR	3342.63 SF


TOTAL

6707.83 SF

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JOSEPH B. KALLER

FLORIDA R.A. #0009239

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PROJECT No.: 23064 DATE: JULY 2023 DRAWN BY: CHECKED BY:

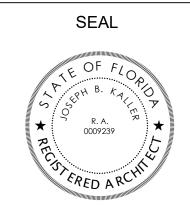

(1) 736 TYLER STREET



(3) 741 TYLER STREET



(5) 731 TYLER STREET



(7) 715 TYLER STREET



(9) 714 TYLER STREET



(2) 740 TYLER STREET




(4) 735 TYLER STREET



(6) 719 TYLER STREET



(8) 711 TYLER STREET

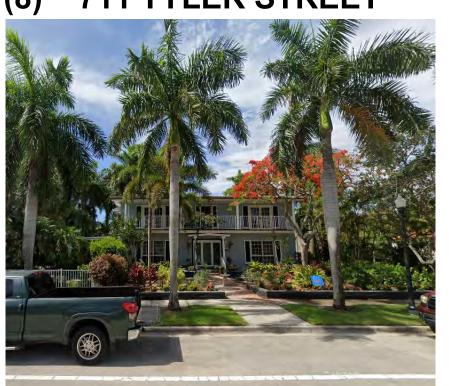


(10) 726 TYLER STREET



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JOSEPH B. KALLER FLORIDA R.A. #0009239

STREET

MO-STORY SINGLE-FAMILY
728 TYLER STRE

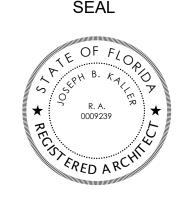HISTORIC

REVISIONS

	11211010110	
No.	Description	Date

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DATE:

DRAWN BY:

DATE: J
DRAWN BY:
CHECKED BY:


SHEET

SP-2







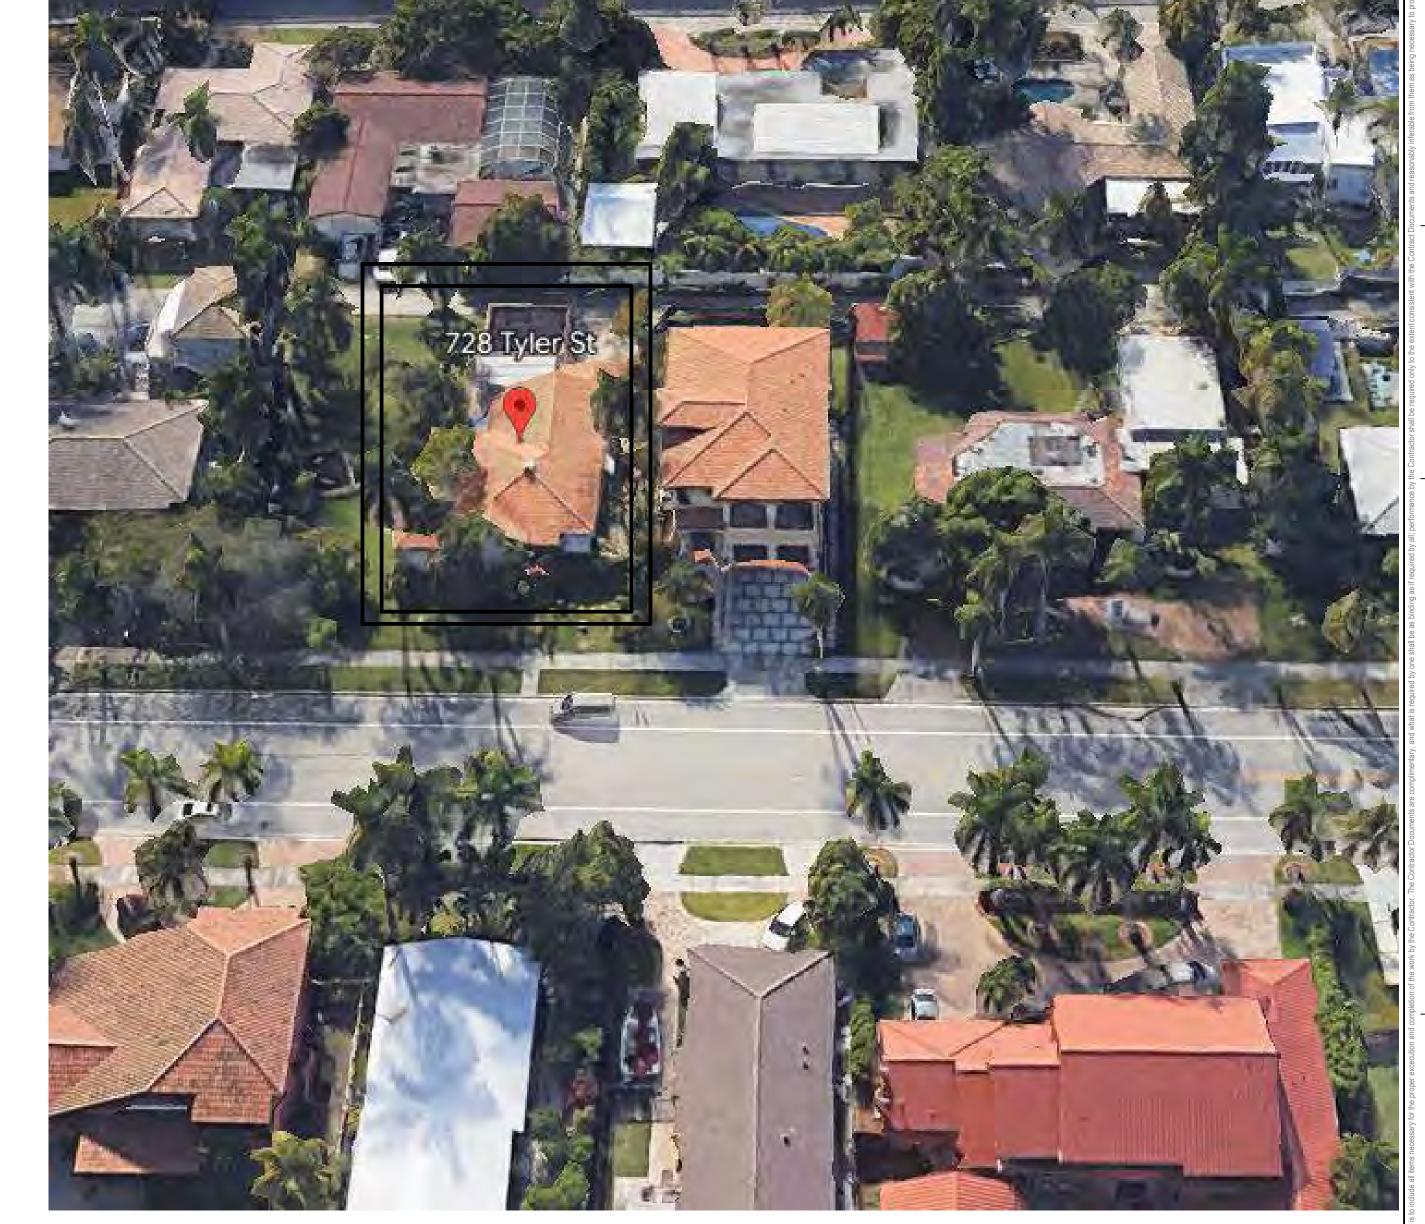

SUBJECT PROPERTY



Kaller Architecture AA#26001212 2417 Hollywood Blvd. Hollywood Florida 33020 954.920.5746 joseph@kallerarchitects.com

www.kallerarchitects.com

JOSEPH B. KALLER FLORIDA R.A. #0009239

	REVISIONS	
No.	Description	Date

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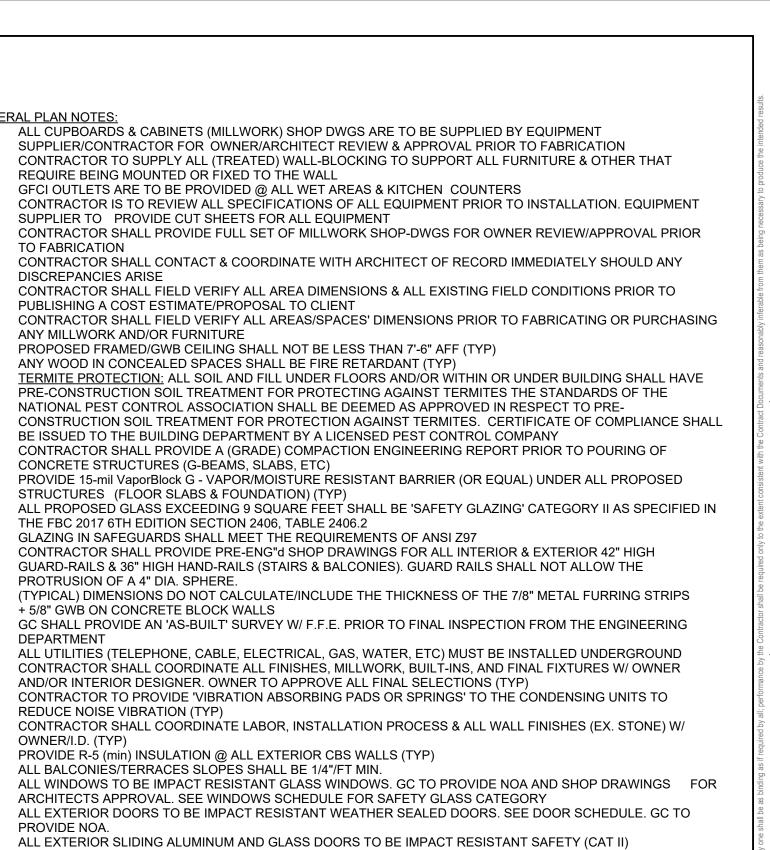
PROPOSAL

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PROJECT No.: 23064 DRAWN BY:

CHECKED BY:



EACH SLEEPING ROOM SHALL HAVE (2) MEANS OF EGRESS. THE SECONDARY MEANS SHALL BE AN

A. THE BOTTOM OF THE OPENING SHALL BE NO MORE THAN 44"AFF A MIN WIDTH OF 20" & MIN HEIGHT 24"

PROVIDE (MOISTURE RESISTANT) 5/8" DENS-SHIELD TILE BACKER & WATER-PROOF JOINT-GROUT (OR

PROVIDE A WIPEABLE / NON-ABSORBENT SURFACES/FINISHES @ ALL BATHROOMS (WET LOCATIONS) (WALLS & CEILINGS) - FINISH SELECTION BY OWNER/ INTERIOR DESIGNER (TYP)

ALL SHOWER ENCLOSURES & GLASS RAILS SHALL BE TEMPERED (SAFETY) GLASS CATEGORY II, AS SET

FBC R307.2 - BATHTUB AND SHOWER SPACES. BATHTUB AND SHOWER FLOORS AND WALLS ABOVE BATHTUBS WITH INSTALLED SHOWER HEADS AND IN SHOWER COMPARTMENTS SHALL BE FINISHED WITH A NONABSORBENT SURFACE. SUCH WALL SURFACES SHALL EXTEND TO A HEIGHT OF NOT LESS THAN 6 FEET (1829 MM) ABOVE THE FLOOR.

FIXTURES SHALL BE SPACED IN ACCORDANCE WITH FIGURE R307.1

Kaller Architecture

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www.kallerarchitects.com

SEAL



JOSEPH B. KALLER FLORIDA R.A. #0009239

SINGL

GROUND PLAN

REVISIONS




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PROJECT No.: DRAWN BY:

CHECKED BY:

SHEET

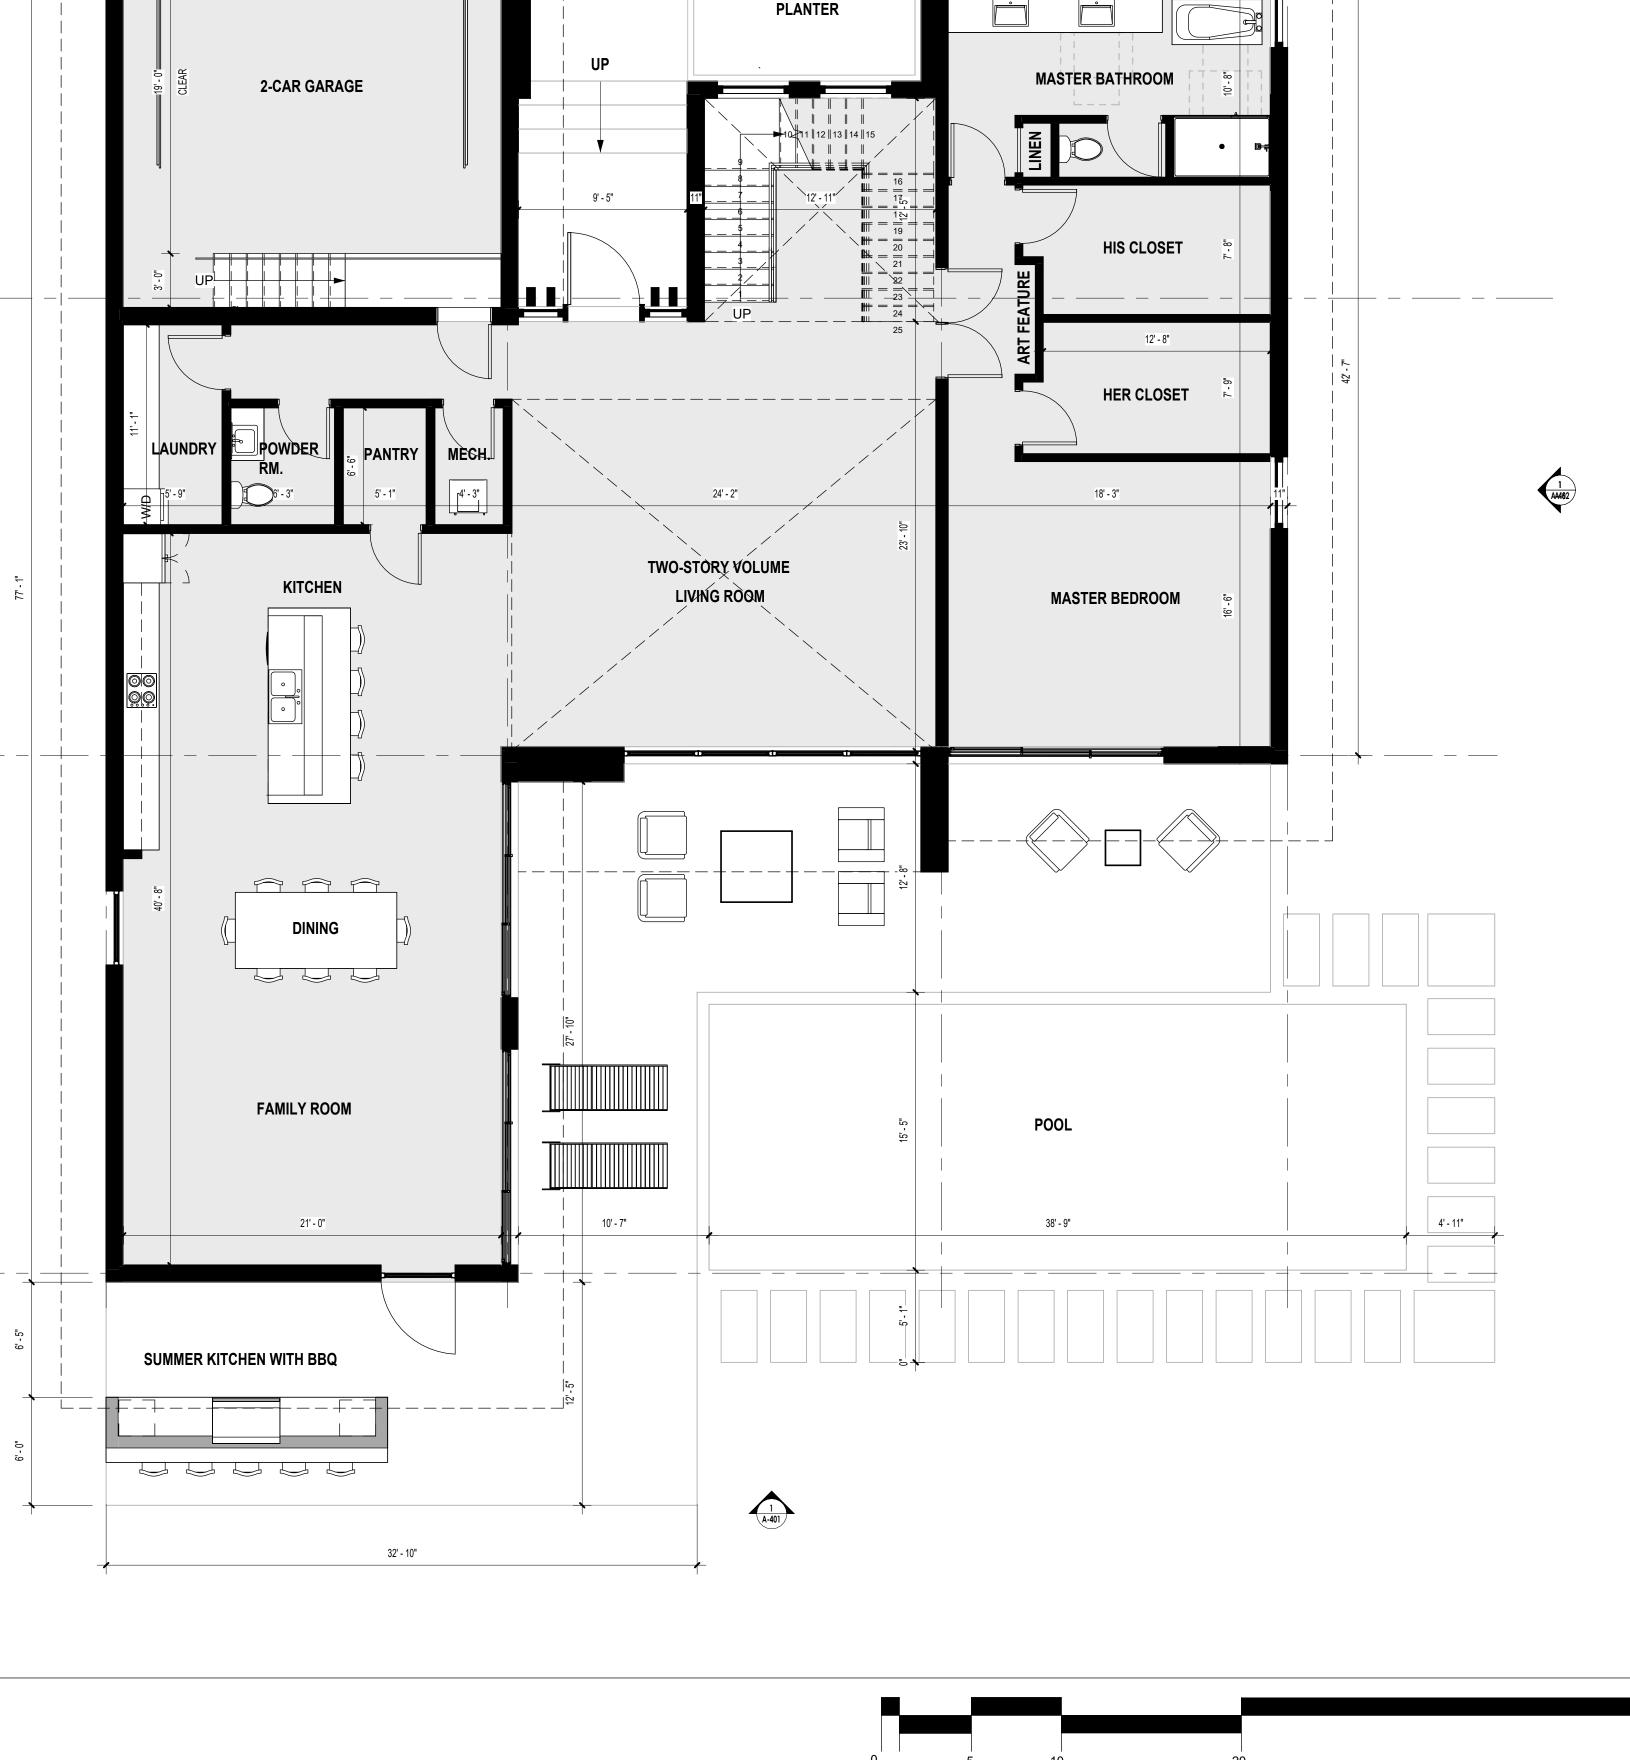

65' - 8"

23' - 7"

19' - 7"

22' - 5"

21' - 0"

CLEAR

GENERAL PLAN NOTES:

- ALL CUPBOARDS & CABINETS (MILLWORK) SHOP DWGS ARE TO BE SUPPLIED BY EQUIPMENT SUPPLIER/CONTRACTOR FOR OWNER/ARCHITECT REVIEW & APPROVAL PRIOR TO FABRICATION
- CONTRACTOR TO SUPPLY ALL (TREATED) WALL-BLOCKING TO SUPPORT ALL FURNITURE & OTHER THAT REQUIRE BEING MOUNTED OR FIXED TO THE WALL
- GFCI OUTLETS ARE TO BE PROVIDED @ ALL WET AREAS & KITCHEN COUNTERS
- CONTRACTOR IS TO REVIEW ALL SPECIFICATIONS OF ALL EQUIPMENT PRIOR TO INSTALLATION. EQUIPMENT SUPPLIER TO PROVIDE CUT SHEETS FOR ALL EQUIPMENT
- CONTRACTOR SHALL PROVIDE FULL SET OF MILLWORK SHOP-DWGS FOR OWNER REVIEW/APPROVAL PRIOR
- CONTRACTOR SHALL CONTACT & COORDINATE WITH ARCHITECT OF RECORD IMMEDIATELY SHOULD ANY DISCREPANCIES ARISE
- CONTRACTOR SHALL FIELD VERIFY ALL AREA DIMENSIONS & ALL EXISTING FIELD CONDITIONS PRIOR TO PUBLISHING A COST ESTIMATE/PROPOSAL TO CLIENT
- CONTRACTOR SHALL FIELD VERIFY ALL AREAS/SPACES' DIMENSIONS PRIOR TO FABRICATING OR PURCHASING
- ANY MILLWORK AND/OR FURNITURE PROPOSED FRAMED/GWB CEILING SHALL NOT BE LESS THAN 7'-6" AFF (TYP)
- ANY WOOD IN CONCEALED SPACES SHALL BE FIRE RETARDANT (TYP) TERMITE PROTECTION: ALL SOIL AND FILL UNDER FLOORS AND/OR WITHIN OR UNDER BUILDING SHALL HAVE PRE-CONSTRUCTION SOIL TREATMENT FOR PROTECTING AGAINST TERMITES THE STANDARDS OF THE
- NATIONAL PEST CONTROL ASSOCIATION SHALL BE DEEMED AS APPROVED IN RESPECT TO PRE-CONSTRUCTION SOIL TREATMENT FOR PROTECTION AGAINST TERMITES. CERTIFICATE OF COMPLIANCE SHALL BE ISSUED TO THE BUILDING DEPARTMENT BY A LICENSED PEST CONTROL COMPANY
- CONTRACTOR SHALL PROVIDE A (GRADE) COMPACTION ENGINEERING REPORT PRIOR TO POURING OF CONCRETE STRUCTURES (G-BEAMS, SLABS, ETC) PROVIDE 15-mil VaporBlock G - VAPOR/MOISTURE RESISTANT BARRIER (OR EQUAL) UNDER ALL PROPOSED
- STRUCTURES (FLOOR SLABS & FOUNDATION) (TYP) ALL PROPOSED GLASS EXCEEDING 9 SQUARE FEET SHALL BE 'SAFETY GLAZING' CATEGORY II AS SPECIFIED IN
- GLAZING IN SAFEGUARDS SHALL MEET THE REQUIREMENTS OF ANSI Z97 CONTRACTOR SHALL PROVIDE PRE-ENG"d SHOP DRAWINGS FOR ALL INTERIOR & EXTERIOR 42" HIGH GUARD-RAILS & 36" HIGH HAND-RAILS (STAIRS & BALCONIES). GUARD RAILS SHALL NOT ALLOW THE
- PROTRUSION OF A 4" DIA. SPHERE. (TYPICAL) DIMENSIONS DO NOT CALCULATE/INCLUDE THE THICKNESS OF THE 7/8" METAL FURRING STRIPS
- + 5/8" GWB ON CONCRETE BLOCK WALLS GC SHALL PROVIDE AN 'AS-BUILT' SURVEY W/ F.F.E. PRIOR TO FINAL INSPECTION FROM THE ENGINEERING
- ALL UTILITIES (TELEPHONE, CABLE, ELECTRICAL, GAS, WATER, ETC) MUST BE INSTALLED UNDERGROUND
- CONTRACTOR SHALL COORDINATE ALL FINISHES, MILLWORK, BUILT-INS, AND FINAL FIXTURES W/ OWNER AND/OR INTERIOR DESIGNER. OWNER TO APPROVE ALL FINAL SELECTIONS (TYP)
- CONTRACTOR TO PROVIDE 'VIBRATION ABSORBING PADS OR SPRINGS' TO THE CONDENSING UNITS TO REDUCE NOISE VIBRATION (TYP)
- CONTRACTOR SHALL COORDINATE LABOR, INSTALLATION PROCESS & ALL WALL FINISHES (EX. STONE) W/ OWNER/I.D. (TYP)
- PROVIDE R-5 (min) INSULATION @ ALL EXTERIOR CBS WALLS (TYP)
- ALL BALCONIES/TERRACES SLOPES SHALL BE 1/4"/FT MIN.

THE FBC 2017 6TH EDITION SECTION 2406, TABLE 2406.2

- ARCHITECTS APPROVAL. SEE WINDOWS SCHEDULE FOR SAFETY GLASS CATEGORY
- ALL EXTERIOR DOORS TO BE IMPACT RESISTANT WEATHER SEALED DOORS. SEE DOOR SCHEDULE. GC TO
 - ALL EXTERIOR SLIDING ALUMINUM AND GLASS DOORS TO BE IMPACT RESISTANT SAFETY (CAT II)
- ALL INTERIOR FINISHES SHALL COMPLY WITH CHAPTER 8, TABLE 803.11 OF THE 2017 FBC 5TH EDITION.
- ALL GUARDRAILS TO BE 42" AFF ALUMINUM & GLASS GUARDRAILS. GC TO PROVIDE SHOP DRAWINGS/NOA

FOR APPROVAL.

- EACH SLEEPING ROOM SHALL HAVE (2) MEANS OF EGRESS. THE SECONDARY MEANS SHALL BE AN
- A. THE BOTTOM OF THE OPENING SHALL BE NO MORE THAN 44"AFF

- SIMILAR) @ ALL WET AREAS
- PROVIDE A WIPEABLE / NON-ABSORBENT SURFACES/FINISHES @ ALL BATHROOMS (WET LOCATIONS)
- ALL SHOWER ENCLOSURES & GLASS RAILS SHALL BE TEMPERED (SAFETY) GLASS CATEGORY II, AS SET
- BATHTUBS WITH INSTALLED SHOWER HEADS AND IN SHOWER COMPARTMENTS SHALL BE FINISHED WITH A NONABSORBENT SURFACE. SUCH WALL SURFACES SHALL EXTEND TO A HEIGHT OF NOT LESS THAN 6 FEET
- (1829 MM) ABOVE THE FLOOR.




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ALL WINDOWS TO BE IMPACT RESISTANT GLASS WINDOWS. GC TO PROVIDE NOA AND SHOP DRAWINGS FOR

GLASS/ALUMINUM DOORS. SEE DOOR SCHEDULE.

OPERABLE WINDOW AS PER NFPA 101 SECTION 24.2.2.3

A MIN WIDTH OF 20" & MIN HEIGHT 24" SHALL NOT BE LESS THAN 5.7 sq.ft. CLEAR OPENING

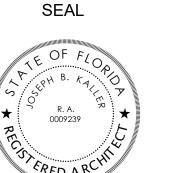PROVIDE (MOISTURE RESISTANT) 5/8" DENS-SHIELD TILE BACKER & WATER-PROOF JOINT-GROUT (OR

(WALLS & CEILINGS) - FINISH SELECTION BY OWNER/ INTERIOR DESIGNER (TYP)

FBC R307.2 - BATHTUB AND SHOWER SPACES. BATHTUB AND SHOWER FLOORS AND WALLS ABOVE


FIXTURES SHALL BE SPACED IN ACCORDANCE WITH FIGURE R307.1

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3/16" = 1'-0"



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ALL WINDOWS TO BE IMPACT RESISTANT GLASS WINDOWS. GC TO PROVIDE NOA AND SHOP DRAWINGS FOR

ARCHITECTS APPROVAL. SEE WINDOWS SCHEDULE FOR SAFETY GLASS CATEGORY ALL EXTERIOR DOORS TO BE IMPACT RESISTANT WEATHER SEALED DOORS. SEE DOOR SCHEDULE. GC TO

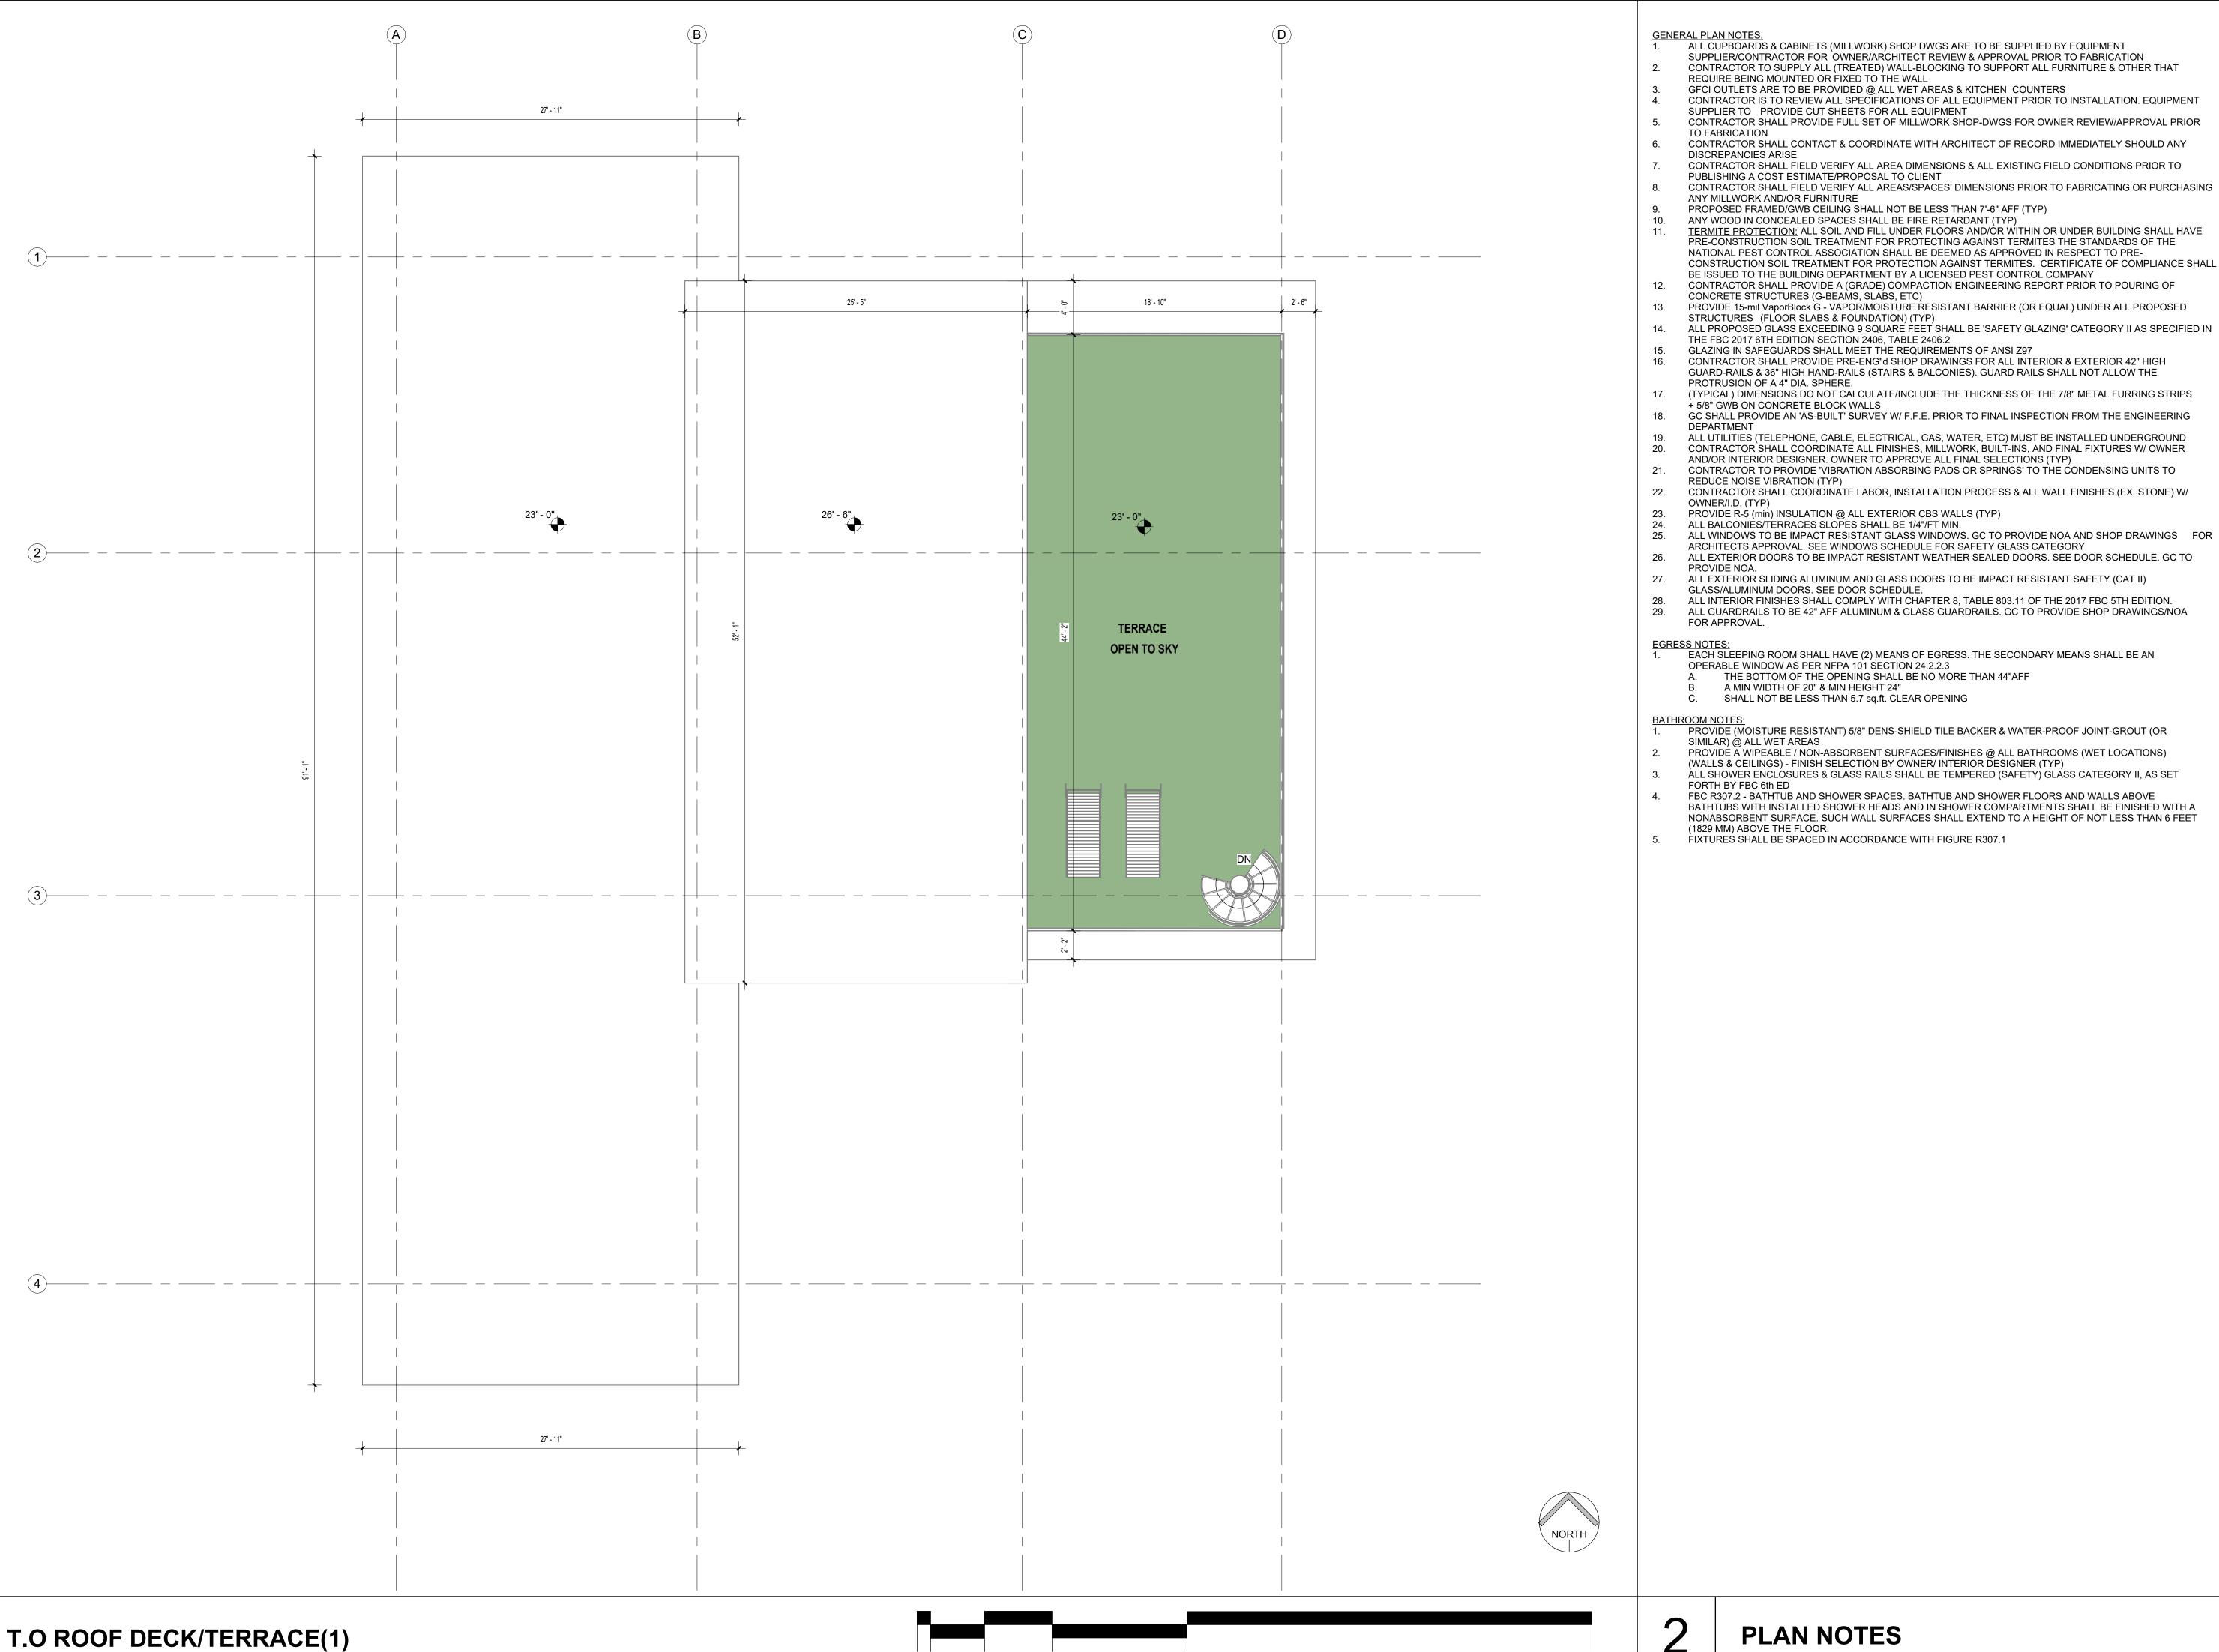ALL EXTERIOR SLIDING ALUMINUM AND GLASS DOORS TO BE IMPACT RESISTANT SAFETY (CAT II)

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ALL INTERIOR FINISHES SHALL COMPLY WITH CHAPTER 8, TABLE 803.11 OF THE 2017 FBC 5TH EDITION.

ALL GUARDRAILS TO BE 42" AFF ALUMINUM & GLASS GUARDRAILS. GC TO PROVIDE SHOP DRAWINGS/NOA

EACH SLEEPING ROOM SHALL HAVE (2) MEANS OF EGRESS. THE SECONDARY MEANS SHALL BE AN OPERABLE WINDOW AS PER NFPA 101 SECTION 24.2.2.3

THE BOTTOM OF THE OPENING SHALL BE NO MORE THAN 44"AFF

C. SHALL NOT BE LESS THAN 5.7 sq.ft. CLEAR OPENING

PROVIDE (MOISTURE RESISTANT) 5/8" DENS-SHIELD TILE BACKER & WATER-PROOF JOINT-GROUT (OR

PROVIDÉ À WIPEABLE / NON-ABSORBENT SURFACES/FINISHES @ ALL BATHROOMS (WET LOCATIONS) (WALLS & CEILINGS) - FINISH SELECTION BY OWNER/ INTERIOR DESIGNER (TYP)

ALL SHOWER ENCLOSURES & GLASS RAILS SHALL BE TEMPERED (SAFETY) GLASS CATEGORY II, AS SET

FBC R307.2 - BATHTUB AND SHOWER SPACES. BATHTUB AND SHOWER FLOORS AND WALLS ABOVE BATHTUBS WITH INSTALLED SHOWER HEADS AND IN SHOWER COMPARTMENTS SHALL BE FINISHED WITH A NONABSORBENT SURFACE. SUCH WALL SURFACES SHALL EXTEND TO A HEIGHT OF NOT LESS THAN 6 FEET

FIXTURES SHALL BE SPACED IN ACCORDANCE WITH FIGURE R307.1

REVISIONS

No.	Description	Date

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ELEVATION (NORTH.)



GENERAL NOTES:

DOING THE PROPOSED WORK.

- 1. PERMITS: CONTRACTOR SHALL CONTAIN IN THEIR BID AS WELL AS SECURE ALL NECESSARY BUILDING PERMITS, NOT LIMITED, ROOFING, PLUMBING, ELECTRICAL, MECHANICAL, OCCUPANCY AND OTHER PERMITS, AT HIS EXPENSE, SO THAT THE OWNER CAN OBTAIN HIS / HER CERTIFICATE OF
- 2. QUALIFICATION OF CONTRACTOR: THE GENERAL CONTRACTOR AND ALL SUB CONTRACTORS SHALL BE LICENSED BY THE STATE OF FLORIDA, AS WELL AS THE COUNTY AND BE INSURED TO MEET THE REQUIREMENTS OF DADE COUNTY.
- 3. OWNER SHALL HAVE THE RIGHT OF APPROVAL OR REJECTION OF ALL SUBCONTRACTORS PRIOR TO SIGNING THE CONTRACT. GENERAL CONTRACTOR SHALL SUBMIT A LIST OF ALL PROPOSED SUBCONTRACTORS AND SUPPLIERS TO THE OWNER FOR THIS PURPOSE.
- 4. <u>EXISTING CONDITIONS:</u> CONTRACTOR BY AND THROUGH SUBMISSION OF HIS BID, AGREES THAT HE SHALL BE HELD RESPONSIBLE FOR HAVING EXAMINED THE SITE, THE PROPOSED PLANS, THE LOCATION OF ALL PROPOSED WORK AND FOR HAVING SATISFIED HIMSELF FROM HIS OWN PERSONAL KNOWLEDGE AND EXPERIENCE OR PROFESSIONAL ADVICE AS TO THE CHARACTER AND LOCATION OF THE SITE, THE NATURE OF EXISTING CONDITIONS, THE LOCATION OF EXISTING UTILITIES AND ANY OTHER CONDITIONS SURROUNDING AND AFFECTING THE WORK. ANY OBSTRUCTIONS, AND ALL OTHER PHYSICAL CHARACTERISTICS OF THE SITE, IN ORDER THAT HE MAY INCLUDE IN HIS PRICE ALL COSTS PERTAINING TO THE WORK AND THEREBY PROVIDE FOR THE

SATISFACTORY COMPLETION OF ANY OBJECTS OR OBSTRUCTION WHICH MAY BE ENCOUNTERED IN


- 5. ALL MEASUREMENTS AND DIMENSIONS MUST BE VERIFIED BY THE CONTRACTOR IN THE FIELD. THE DIMENSIONS SHOWN ARE AS ACCURATE AS THE BASE BUILDING DOCUMENTS PERMIT. ANY DISCREPANCIES MUST BE BROUGHT TO THE ATTENTION OF THE ARCHITECT IMMEDIATELY PRIOR TO THE COMMENCEMENT OF WORK. <u>DO NOT</u> SCALE DRAWINGS - USE DIMENSIONS ONLY, LARGE SCALE DRAWINGS SHALL GOVERN OVER SMALL. IF DIMENSIONS ARE NOT DESIGNATED ON THE PLANS, AT IS THE RESPONSIBILITY OF THE CONTRACTOR TO VERIFY THEM WITH THE ARCHITECT.
- 6. COMPLY AT ALL TIMES WITH REQUIREMENTS OF THE FLORIDA BUILDING CODE, LIFE AND SAFETY CODE (N.F.P.A. 101), AND ALL LOCAL CODES AND ORDINANCES.
- 7. <u>SHOP DRAWINGS:</u> THE CONTRACTOR SHALL SUBMIT ONE COPY BY EMAIL AND FOUR (4) HARD COPIES OF ALL REQUIRED SHOP DRAWINGS CALLED FOR ON THE DRAWINGS OR REQUIRED BY BUILDING OFFICIALS TO THE ARCHITECT IN SUFFICIENT TIME TO BE REVIEWED AND PROCESSED SO
- AS TO CAUSE NO TIME DELAY IN THE CONSTRUCTION SEQUENCE. 8. <u>PROTECTION:</u> THE CONTRACTOR SHALL PROTECT ADJACENT PARTS OF EXISTING BUILDINGS FROM DAMAGE DURING ALL PHASES OF CONSTRUCTION, AND BE LIABLE FOR SAME.
- 9. <u>WORKMANSHIP:</u> ALL MATERIALS AND EQUIPMENT SPECIFIED SHALL BE NEW AND ALL WORKMANSHIP SHALL BE FIRST CLASS FOLLOWING THE MANUFACTURER'S SPECIFICATIONS ALONG WITH THE BEST TRADE PRACTICES AND STANDARDS.
- 10. ALL WORK TO BE GUARANTEED AGAINST POOR WORKMANSHIP AND DEFECTS.
- 11. THE GENERAL CONTRACTOR SHALL FURNISH ALL LABOR, MATERIALS AND EQUIPMENT (UNLESS OTHERWISE NOTED) REQUIRED FOR THE COMPLETION OF THE JOB IN ACCORDANCE WITH THESE DRAWINGS.
- 12. CLEAN UP ALL RUBBISH, REFUSE, SCRAP MATERIALS AND DEBRIS CAUSED BY THIS PROJECT AT THE END OF EACH DAY AND INSURE THAT THE SITE OF WORK SHALL PRESENT A NEAT ORDERLY AND WORKMANLIKE APPEARANCE.
- 13. GENERAL CONTRACTOR SHALL PRESENT THE JOB TO THE OWNER FOR ACCEPTANCE, CLEANED AND READY FOR OCCUPANCY. ALL GLASS SHALL BE CLEANED AND POLISHED, FLOORS SWEPT BROOM CLEAN, CARPETS VACUUMED, FIXTURES WASHED AND ALL LABELS REMOVED.
- 14. STORE MATERIALS IN A SAFE AND APPROVED LOCATION. COMPLY WITH ALL REGULATIONS
- GOVERNING THE NEIGHBORHOOD AS TO MINIMIZE INTERRUPTIONS AND/ OR INTERFERENCE WITH ANY OF THE SURROUNDING OPERATIONS.
- 15. ALL WOOD IN CONTACT WITH MASONRY SHALL BE PRESSURE TREATED. 16. ALL EXTERIOR AND CORRIDOR INTERIOR CONCRETE MASONRY UNIT WALLS SHALL RECEIVE
- CORE FILL 500 (R- 14.2) EXPANDABLE SPRAY FOAM INSULATION IN EVERY VOID CELL. INSTALLATION OF INSULATION SHALL OCCUR AFTER ROOF HAS BEEN DRIED-IN AND AFTER INTERIOR FRAMING HAS PASSED INSPECTION.

ELEVATIONS / SECTIONS

- NEW IMPACT RESISTANT WINDOW/DOOR (TYP)
- NEW SMOOTH STUCCO GREY COLOR > BENJAMIN MOORE (TIMBER WOLF - 2126-50)
- NEW 42" GLASS GUARDRAIL AND HAND RAIL, GC TO IMPROVE SHOP SHOPDRAWINGS FOR ARCHITECT APPROVAL
- CONTINUOUS DRIP EDGE TROUGH ALL FACIAS
- 5 PAPERBACK, METAL LATH & SMOOTH STUCCO FINISH THROUGHOUT.
- GARAGE DOOR TO MATCH LOUVERS FINISH. > (BENJAMIN MOORE CHARCOAL 2133-10)
- HORIZONTAL SCORED STUCCO @ 8" O.C. (TYP).
- BUILDING NUMBER TO BE INTEGRATED INTO LASERCUT PATTERN WHERE, GC TO PROVIDE SHOPDRAWINGS TO ARCH FOR REVIEW AND APPROVAL PRIOR FABRICATION.
- RAW CONCRETE FINISH (MATE) GC TO POUR WITH METAL FORMS FOR
- CURTAIN WALL SYSTEM INTEGRATED WITH HANDRAIL ABOVE.
- 11 ALUMINUW 2133-10) ALUMINUM LOUVERS WOOD FINISH > (BENJAMIN MOORE CHARCOAL
- 12 NEW SMOOTH STUCCO WHITE COLOR > BENJAMIN MOORE
- 13 NEW COMPOSTE WOOD MATERIAL WITH DARK GREY COLOR > BENJAMIN MOORE CHARCOAL 2133-10
- 14 NEW WOOD EXTERIOR DOOR > BENJAMIN MOORE CHARCOAL 2133-10
- 15 NEW 42" ALUMINUM GUARDRAIL AND HAND RAIL, GC TO IMPROVE SHOP SHOPDRAWINGS FOR ARCHITECT APPROVAL

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JOSEPH B. KALLER FLORIDA R.A. #0009239

RESIDENCE

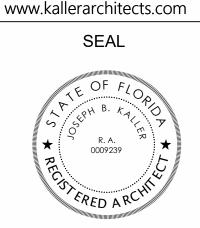3301 S

SINGL -STORY Ĭ M O M NEW

HOLLY

South

REVISIONS Description

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PROJECT No.: 23064 DATE: DRAWN BY:

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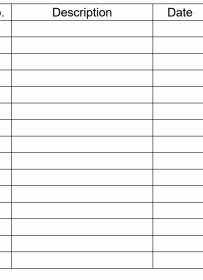
SEAL



JOSEPH B. KALLER FLORIDA R.A. #0009239

STREET **TYLER**

REVISIONS



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PROJECT No.: 23064

728 TYLER STREET

PROPOSED PAINT CHIPS AND MATERIALS



Benjamin Moore
Timber Wolf (Selected Walls)



Benjamin Moore
Charcoal Grey (Garage door + Louvers)



Horizontal white stucco
Selected Walls




Dark Bronze aluminum window h




Raw Concrete

Ground floor and accent walls

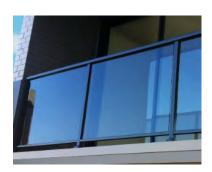

Glass railings

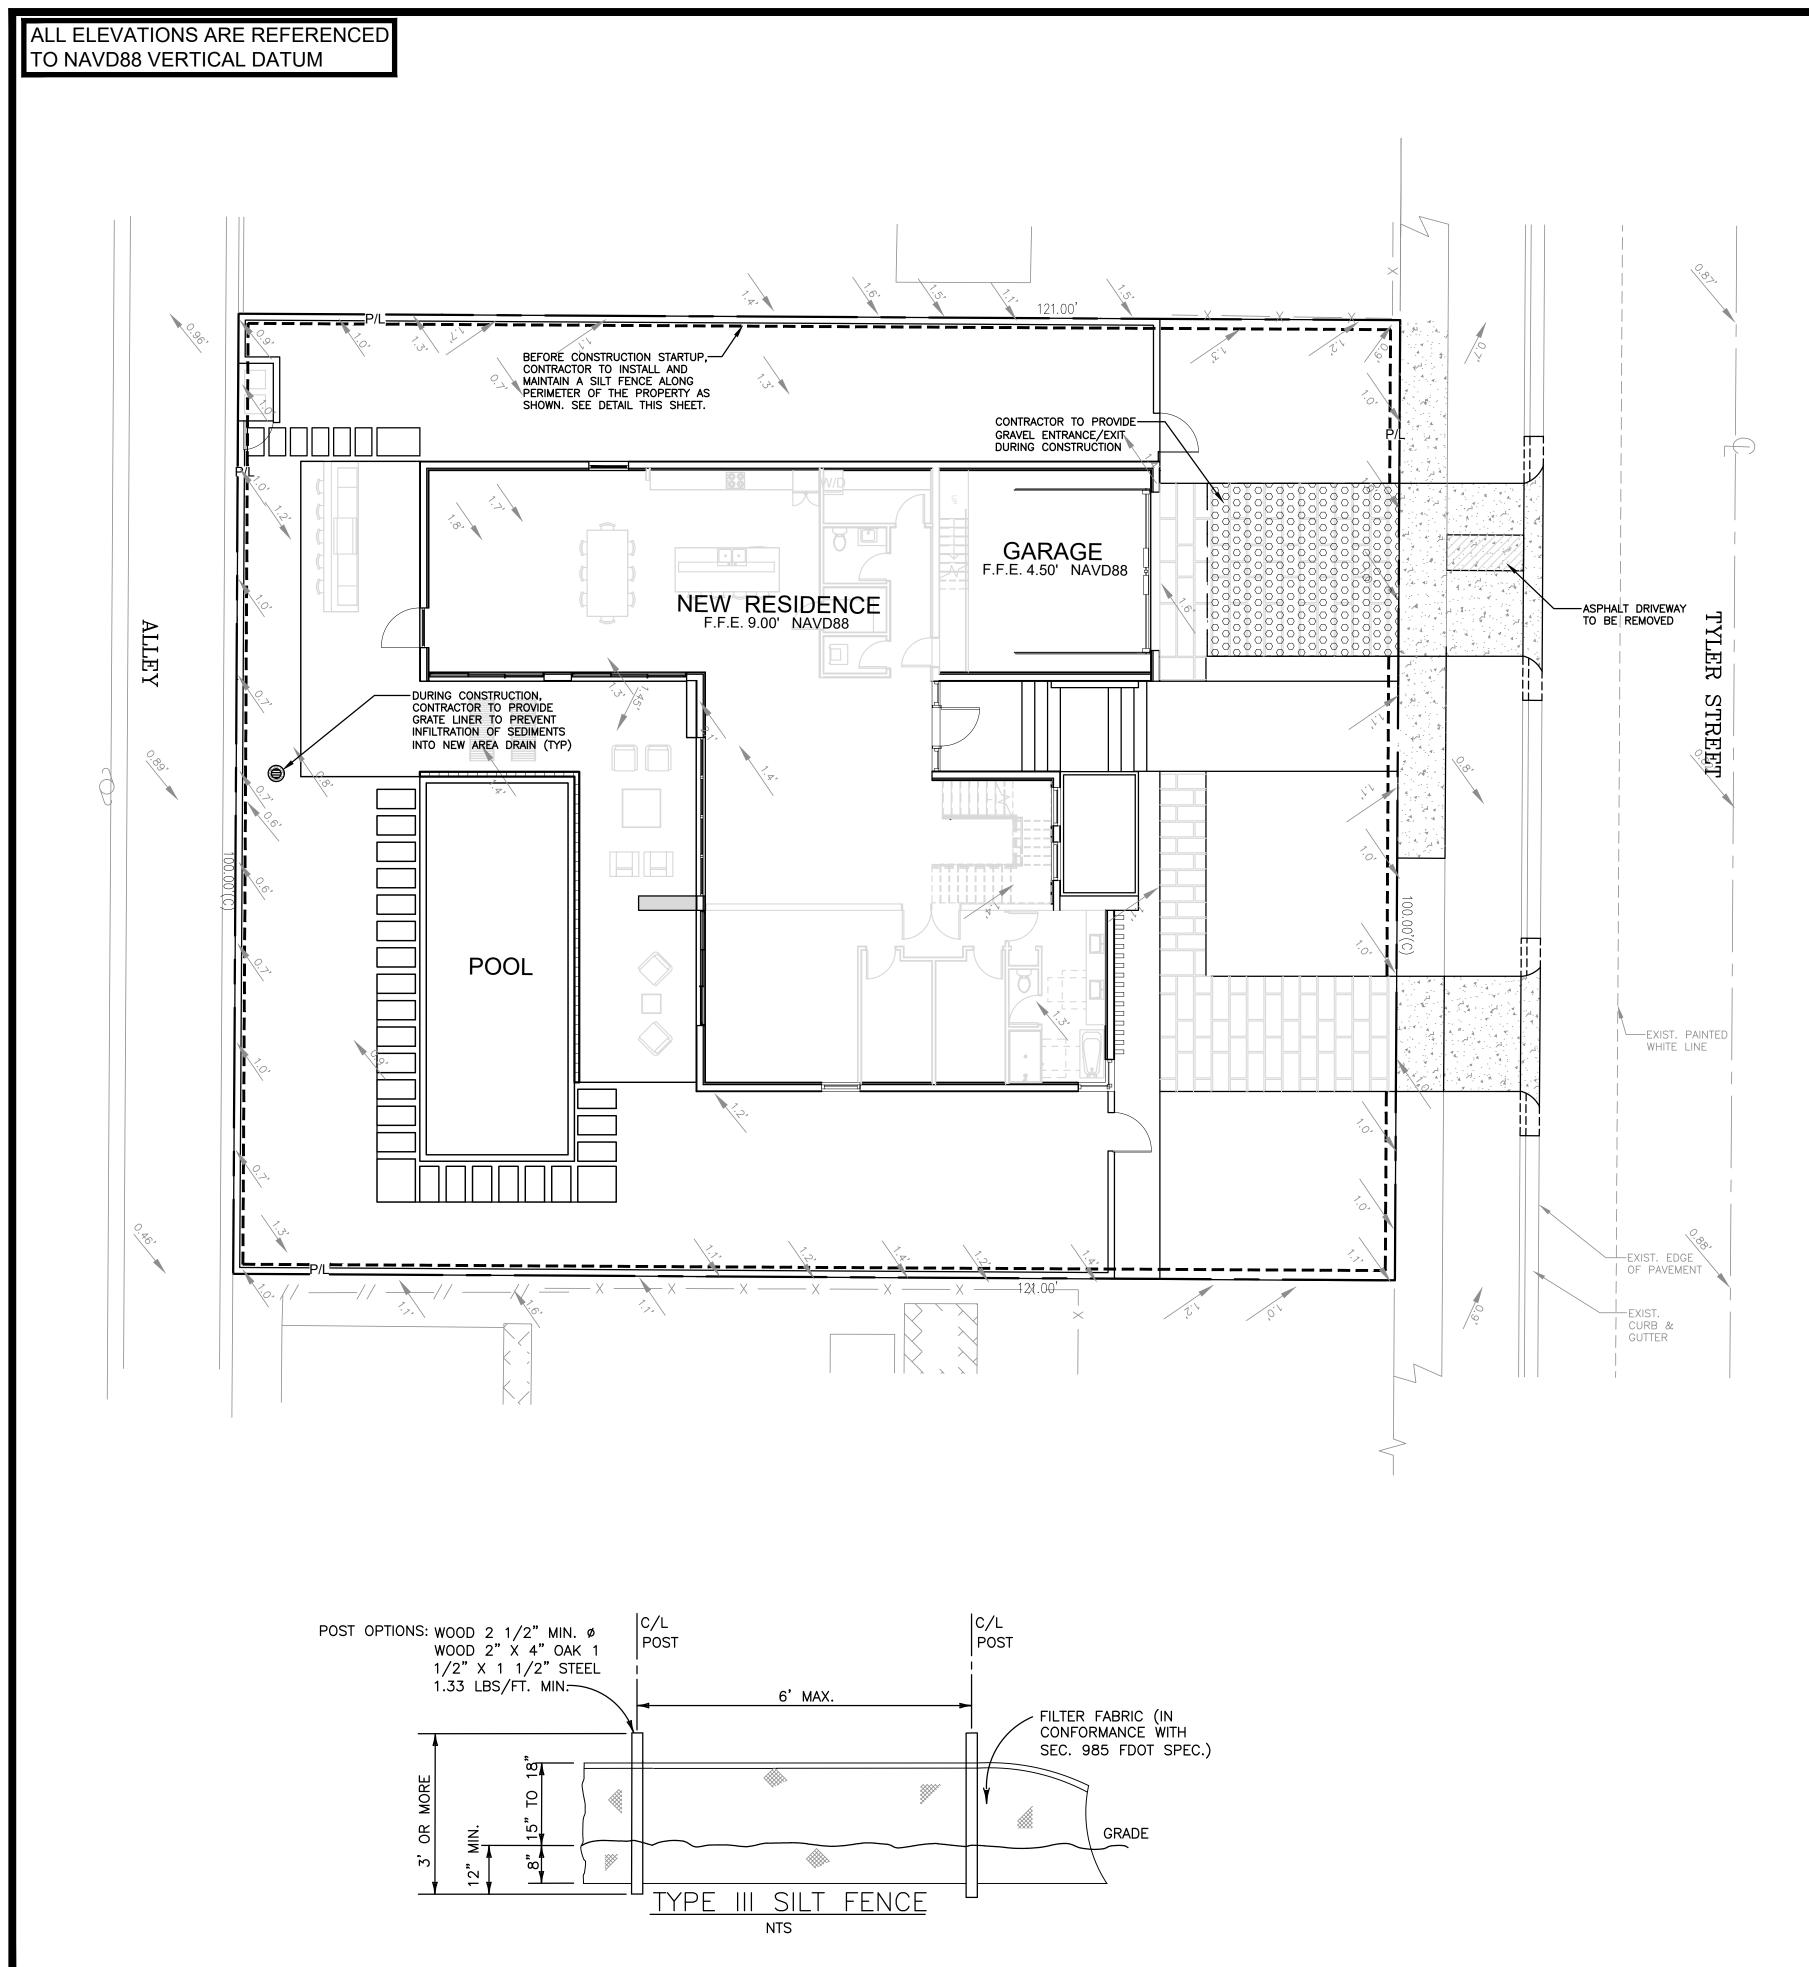


LEGEND

5.50

PROPOSED CONCRETE

PROPOSED WATER METER PROPOSED BFP DEVICE

PROPOSED GRADE EXISTING ELEVATION

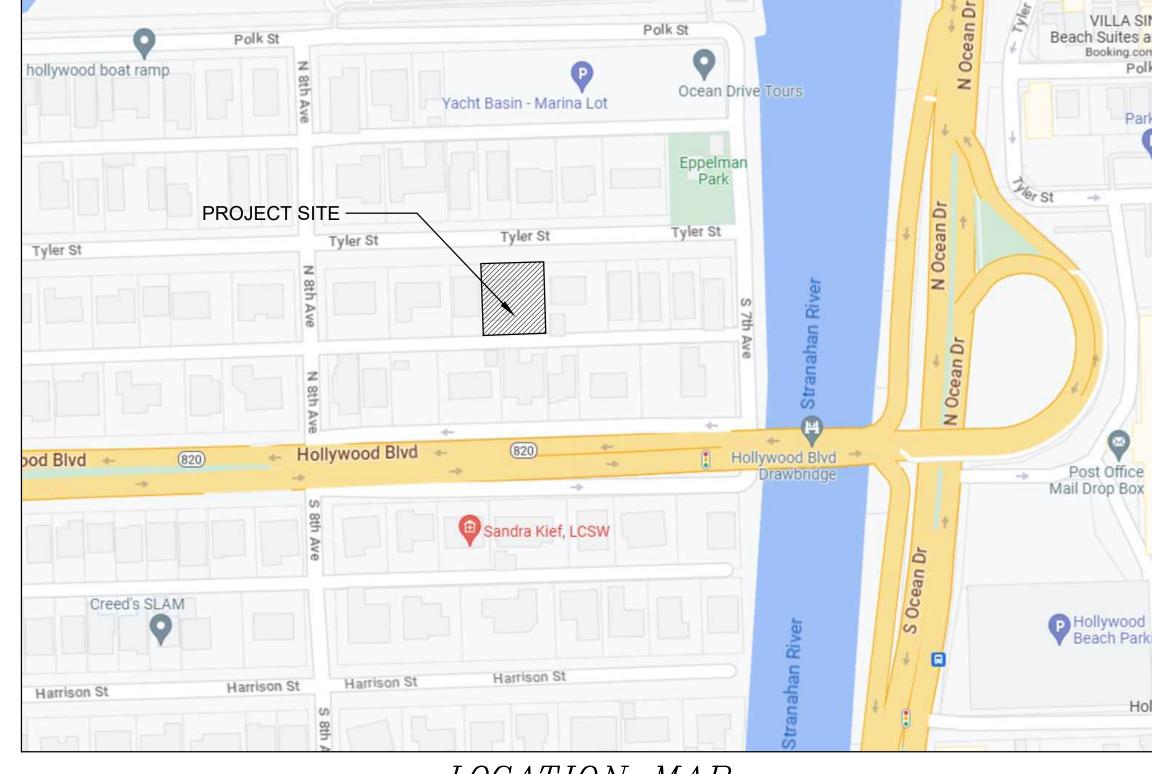

LOCATION MAP

NOT TO SCALE

BMP NOTES:

1. ALL SEDIMENT CONTROL MEASURES ARE TO BE ADJUSTED TO MEET FIELD CONDITIONS AT THE TIME OF CONSTRUCTION AND BE CONSTRUCTED PRIOR TO ANY GRADING OR DISTURBANCE OF EXISTING SURFACE MATERIAL ON BALANCE OF SITE. PERIMETER SEDIMENT BARRIERS SHALL BE CONSTRUCTED TO PREVENT SEDIMENT OR TRASH FROM FLOWING OR FLOATING ON TO ADJACENT

2. PERIODIC INSPECTION AND MAINTENANCE OF ALL SEDIMENT CONTROL STRUCTURES MUST BE PROVIDED TO ENSURE INTENDED PURPOSE IS ACCOMPLISHED. THE DEVELOPER, OWNER AND/OR CONTRACTOR SHALL BE CONTINUALLY RESPONSIBLE FOR ALL SEDIMENT CONTROLS. SEDIMENT CONTROL MEASURES SHALL BE IN WORKING CONDITION AT THE END OF EACH WORKING DAY.

3. SEDIMENT WILL BE PREVENTED FROM ENTERING ANY STORM WATER SYSTEM, DITCH OR CHANNEL. ALL STORMWATER INLETS THAT ARE MADE OPERABLE DURING CONSTRUCTION SHALL BE PROTECTED SO THAT SEDIMENT-LADEN WATER CANNOT ENTER THE CONVEYANCE SYSTEM WITHOUT FIRST BEING FILTERED OR OTHERWISE TREATED TO REMOVE SEDIMENT.

4. WHERE CONSTRUCTION VEHICLE ACCESS ROUTES INTERSECT PAVED PUBLIC ROADS, PROVISIONS SHALL BE MADE TO MINIMIZE THE TRANSPORT OF SEDIMENT BY TRACKING ONTO THE PAVED SURFACE. WHERE SEDIMENT IS TRANSPORTED ONTO A PUBLIC ROAD SURFACE WITH CURBS AND GUTTERS, THE ROAD SHALL BE CLEANED THOROUGHLY AT THE END OF EACH DAY. SEDIMENT SHALL BE REMOVED FROM THE ROADS BY SHOVELING OR SWEEPING AND TRANSPORTED TO A SEDIMENT CONTROL DISPOSAL AREA. STREET WASHING SHALL BE ALLOWED ONLY AFTER SEDIMENT IS REMOVED IN THIS MANNER. THIS PROVISION SHALL APPLY TO INDIVIDUAL SUBDIVISION LOTS AS WELL AS TO LARGER LAND DISTURBING ACTIVITIES.

5. PERMANENT OR TEMPORARY SOIL STABILIZATION SHALL BE APPLIED TO DENUDED AREAS WITHIN SEVEN (7) DAYS AFTER FINAL GRADE IS REACHED ON ANY PORTION OF THE SITE. TEMPORARY SOIL STABILIZATION SHALL BE APPLIED WITHIN SEVEN (7) DAYS TO DENUDED AREAS THAT MAY NOT BE AT FINAL GRADE BUT WILL REMAIN UNDISTURBED FOR LONGER THAN THIRTY (30) DAYS. PERMANENT STABILIZATION SHALL BE APPLIED TO AREAS THAT ARE TO BE LEFT UNDISTURBED FOR MORE THAN ONE YEAR.

6. DURING CONSTRUCTION OF THE PROJECT, SOIL STOCKPILES SHALL BE STABILIZED, COVERED OR CONTAINED WITH SEDIMENT TRAPPING MEASURES. THE CONTRACTOR IS RESPONSIBLE FOR THE TEMPORARY PROTECTION AND PERMANENT STABILIZATION OF ALL SOIL STOCKPILES ON SITE AS WELL AS SOIL INTENTIONALLY TRANSPORTED FROM THE PROJECT SITE.

7. ALL TEMPORARY EROSION AND SEDIMENT CONTROL MEASURES SHALL BE REMOVED WITHIN 30 DAYS AFTER FINAL SITE STABILIZATION OR AFTER THE TEMPORARY MEASURES ARE NO LONGER

8. PROPERTIES AND WATER WAYS DOWNSTREAM FROM CONSTRUCTION SITE SHALL BE PROTECTED FROM SEDIMENT DEPOSITION AND EROSION AT ALL TIMES DURING CONSTRUCTION.

9. CONTRACTOR IS RESPONSIBLE FOR ALL SURFACE WATER DISCHARGES, RAINFALL RUN OFF OR DEWATERING ACTIVITIES.

10. CONTRACTOR MUST INCORPORATE ALL BMP'S NECESSARY TO MEET OR EXCEED STATE WATER QUALITY AND SWPPP REQUIREMENTS.

11. THE POLLUTION PREVENTION PLAN IS A MINIMUM GUIDELINE ONLY. ADDITIONAL BMP'S MAY BE NECESSARY AT CONTRACTOR'S EXPENSE.

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EROSION & SEDIMENT CONTROL PLAN

SCALE: 1"=10'

No 76036 STATE OF

P.E.#:76036 DATE: 8/1/23

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N N


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NEERIN. P.E.

ZEPH

SCALE: 1"=10"

1 OF 5 PROJECT NO.: 23-35

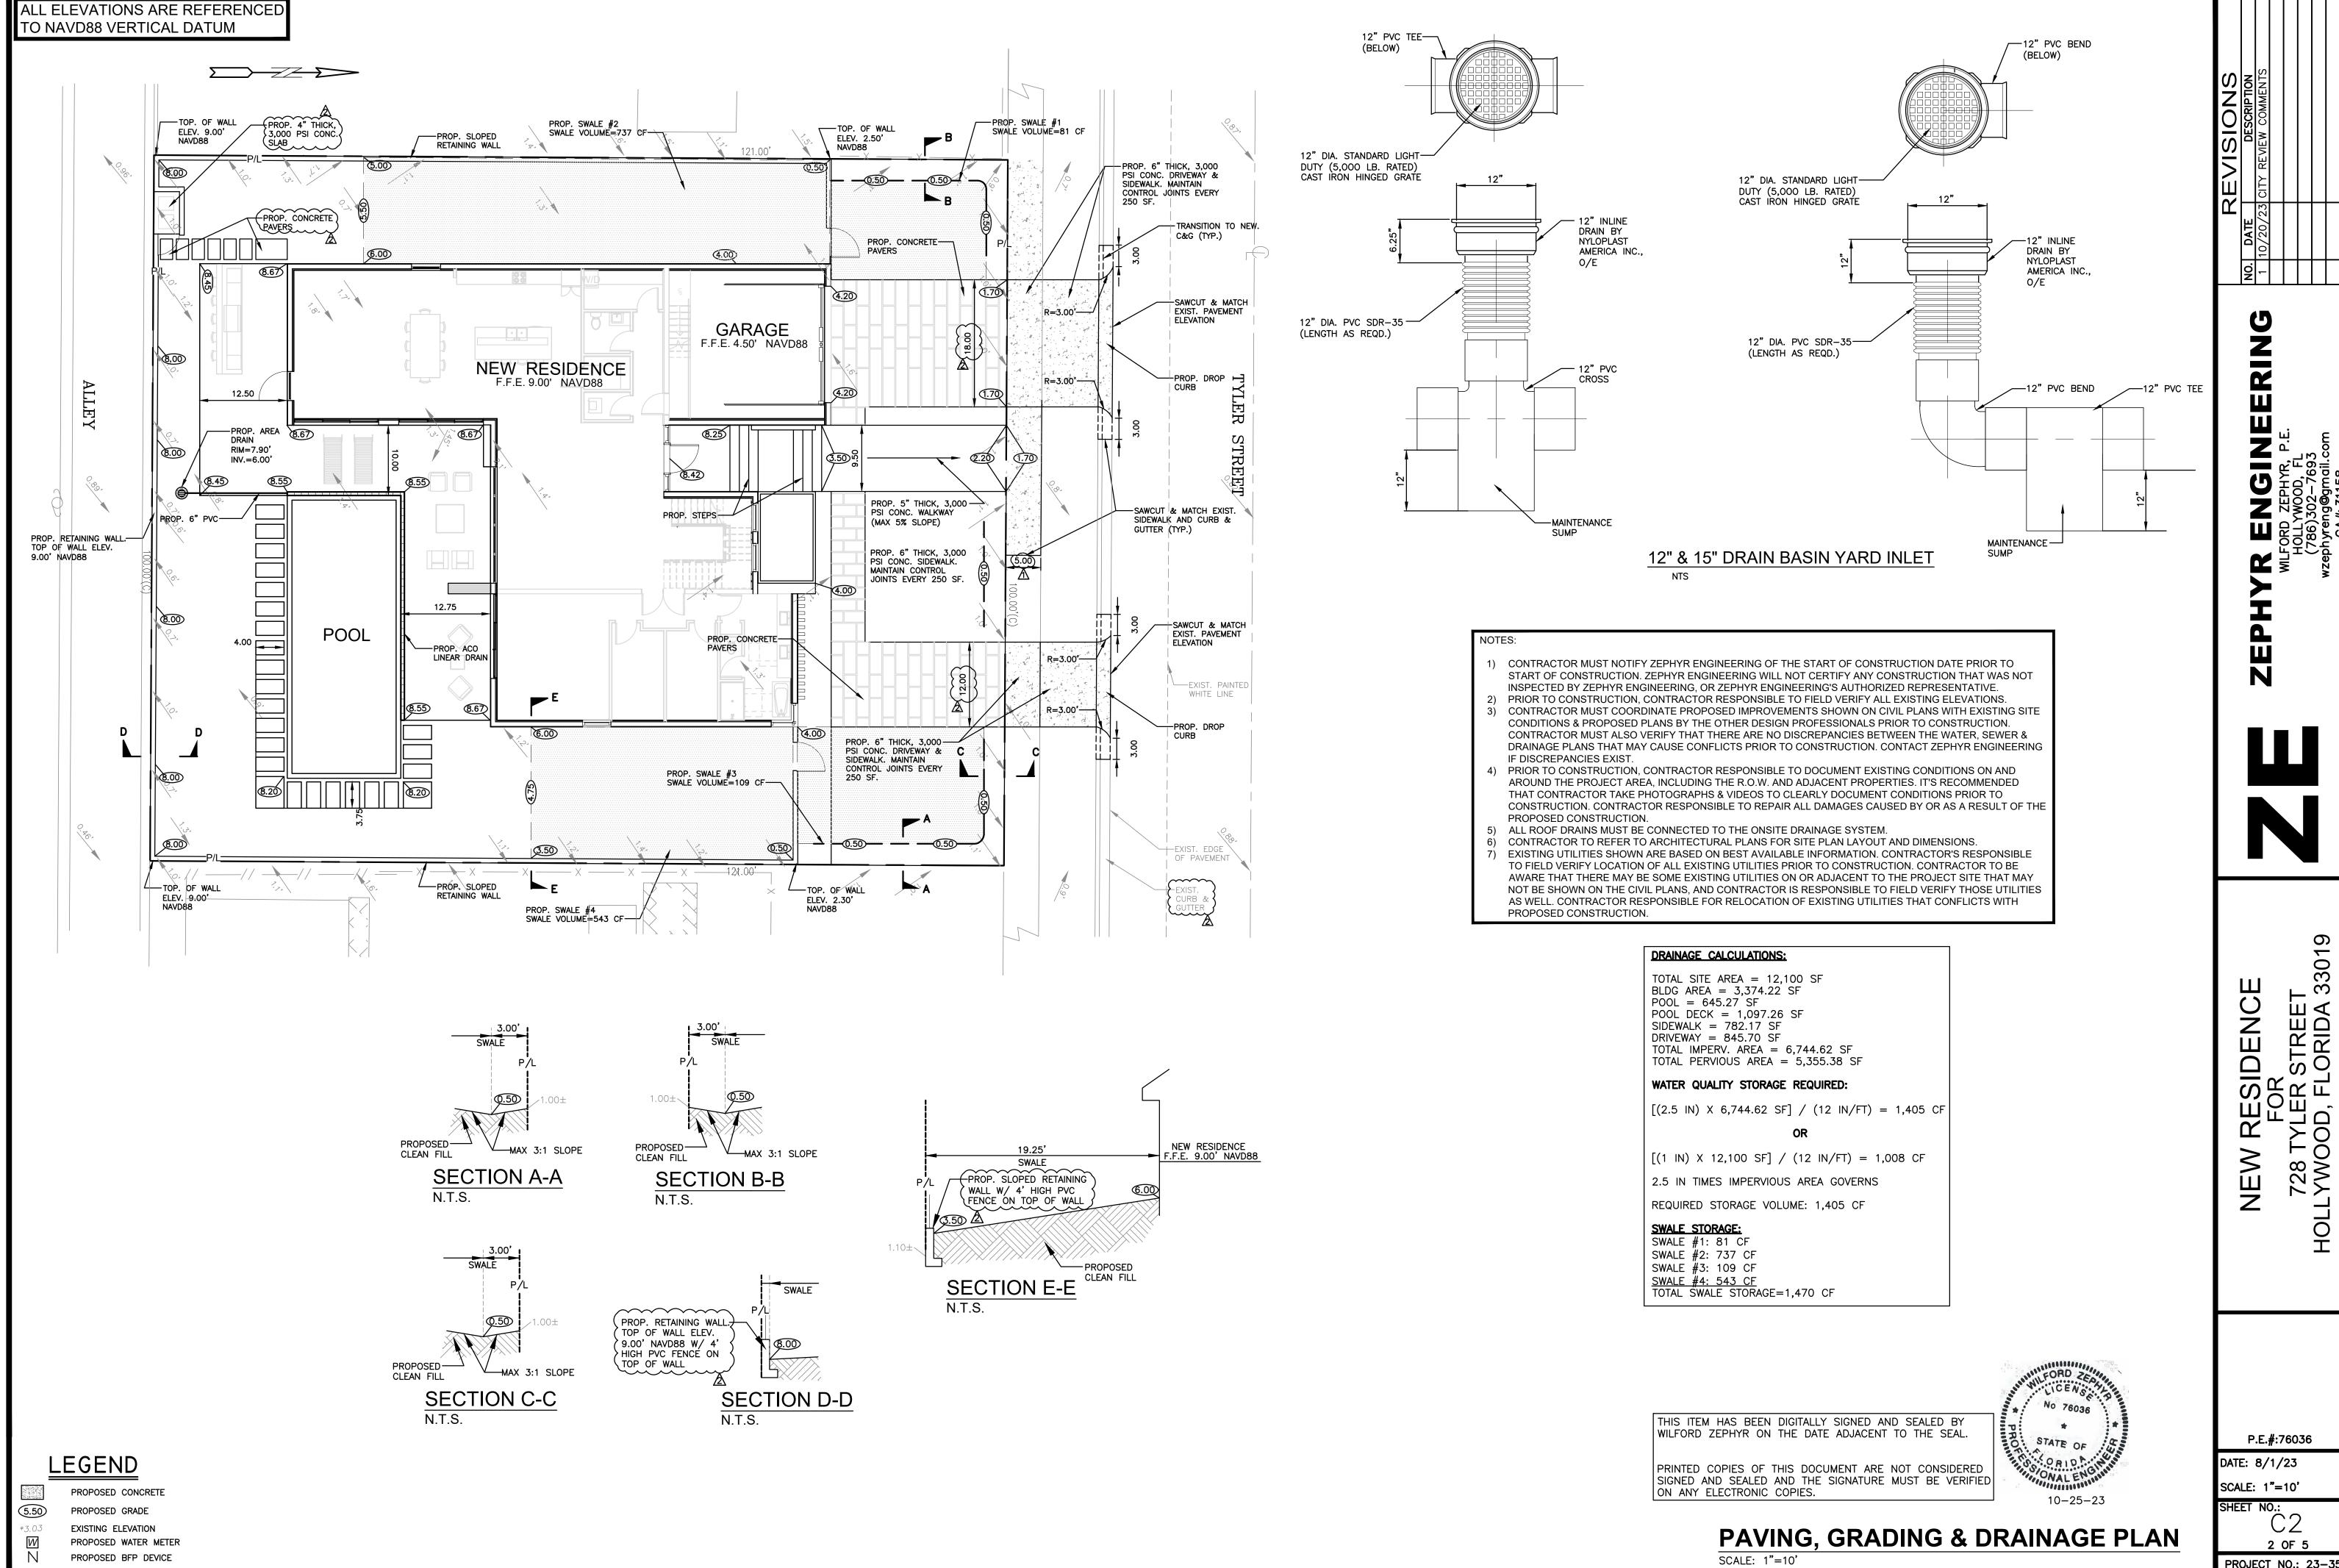

HOL

P.E.#:76036

2 OF 5 PROJECT NO.: 23-35

P.E.#:76036

DATE: 8/1/23

10-25-23


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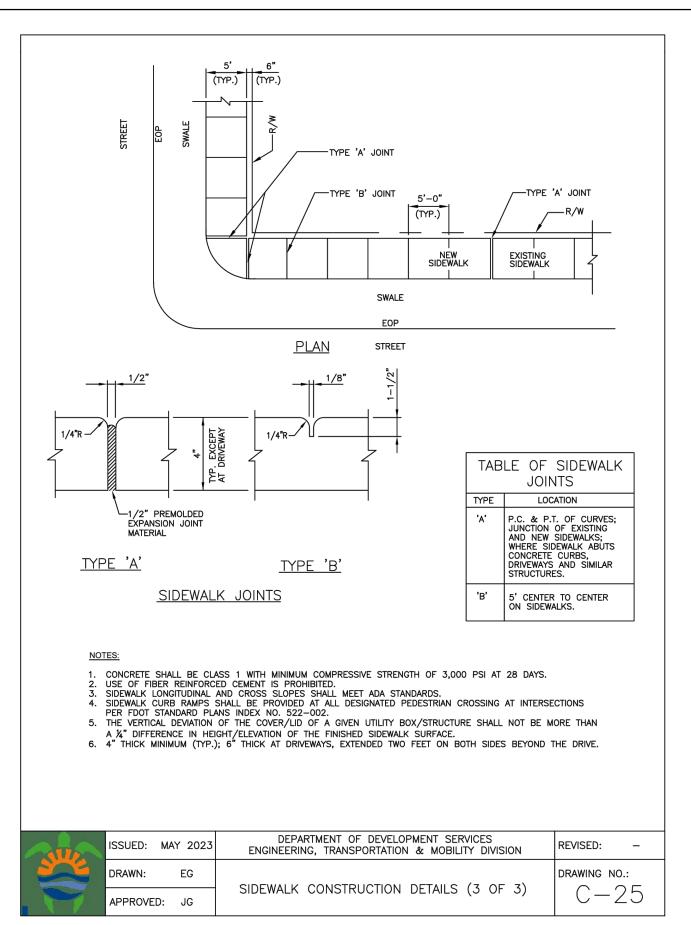
SHEET NO.:

3 OF 5

PROJECT NO.: 23-35

8"X12" CONCRETE TIE BEAM W/ (2)-#5 TOP & BOTTOM CONTINUOUS, & #3 STIRRUPS @ 12" O.C. T.O. WALL
SEE CIVIL PLAN T.O.GRADE 9GA JOINT REINF. 16" O.C. (LADDER TYPE) SEE CIVIL PLAN 1'-6" MAX. (SEE NOTE 1) COMPACTED FILL ADJACENT EXISTING GRADE (SEE CIVIL & SITE PLAN) 8" CMU WALL REINF'D W/ (1)-#5 @ 32" O.C.-& ALL CELLS GROUTED #5 @ 12" O.C. TOP & BOTTOM.
WITH STD. HOOK. _(4)-#5 CONT. TOP & BOTTOM. 34" WIDHT 13" HEIGHT WALL FOOTING RETAINING WALL SECTION



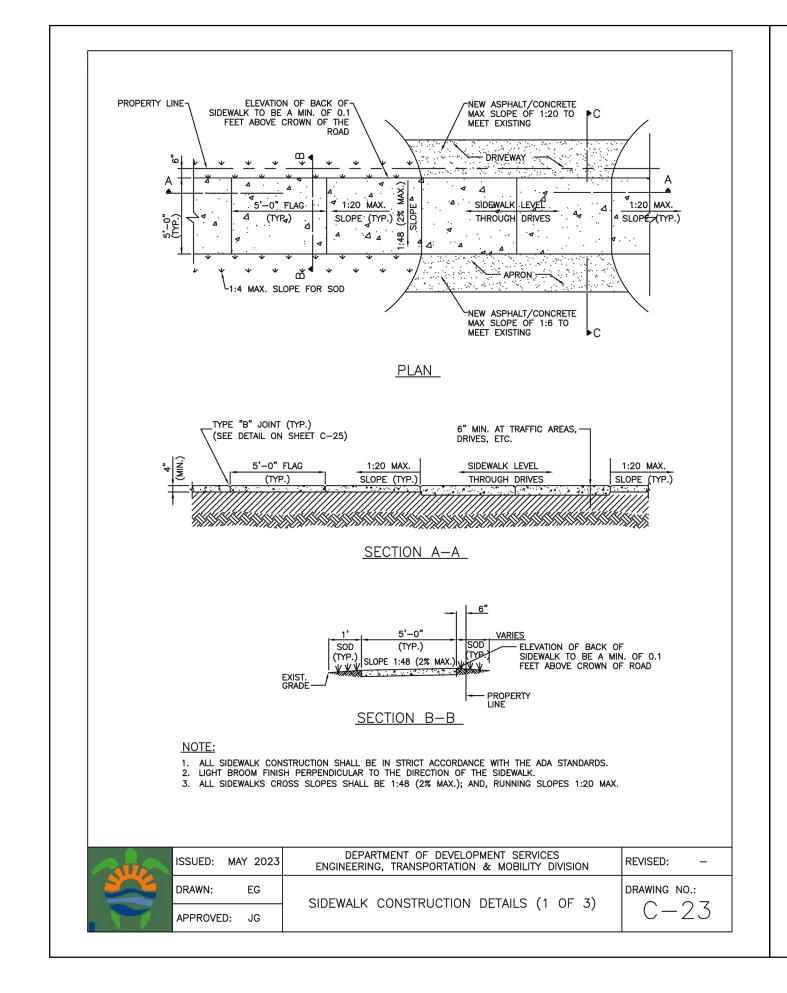


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CIVIL DETAILS

SCALE: N.T.S.



LEGEND

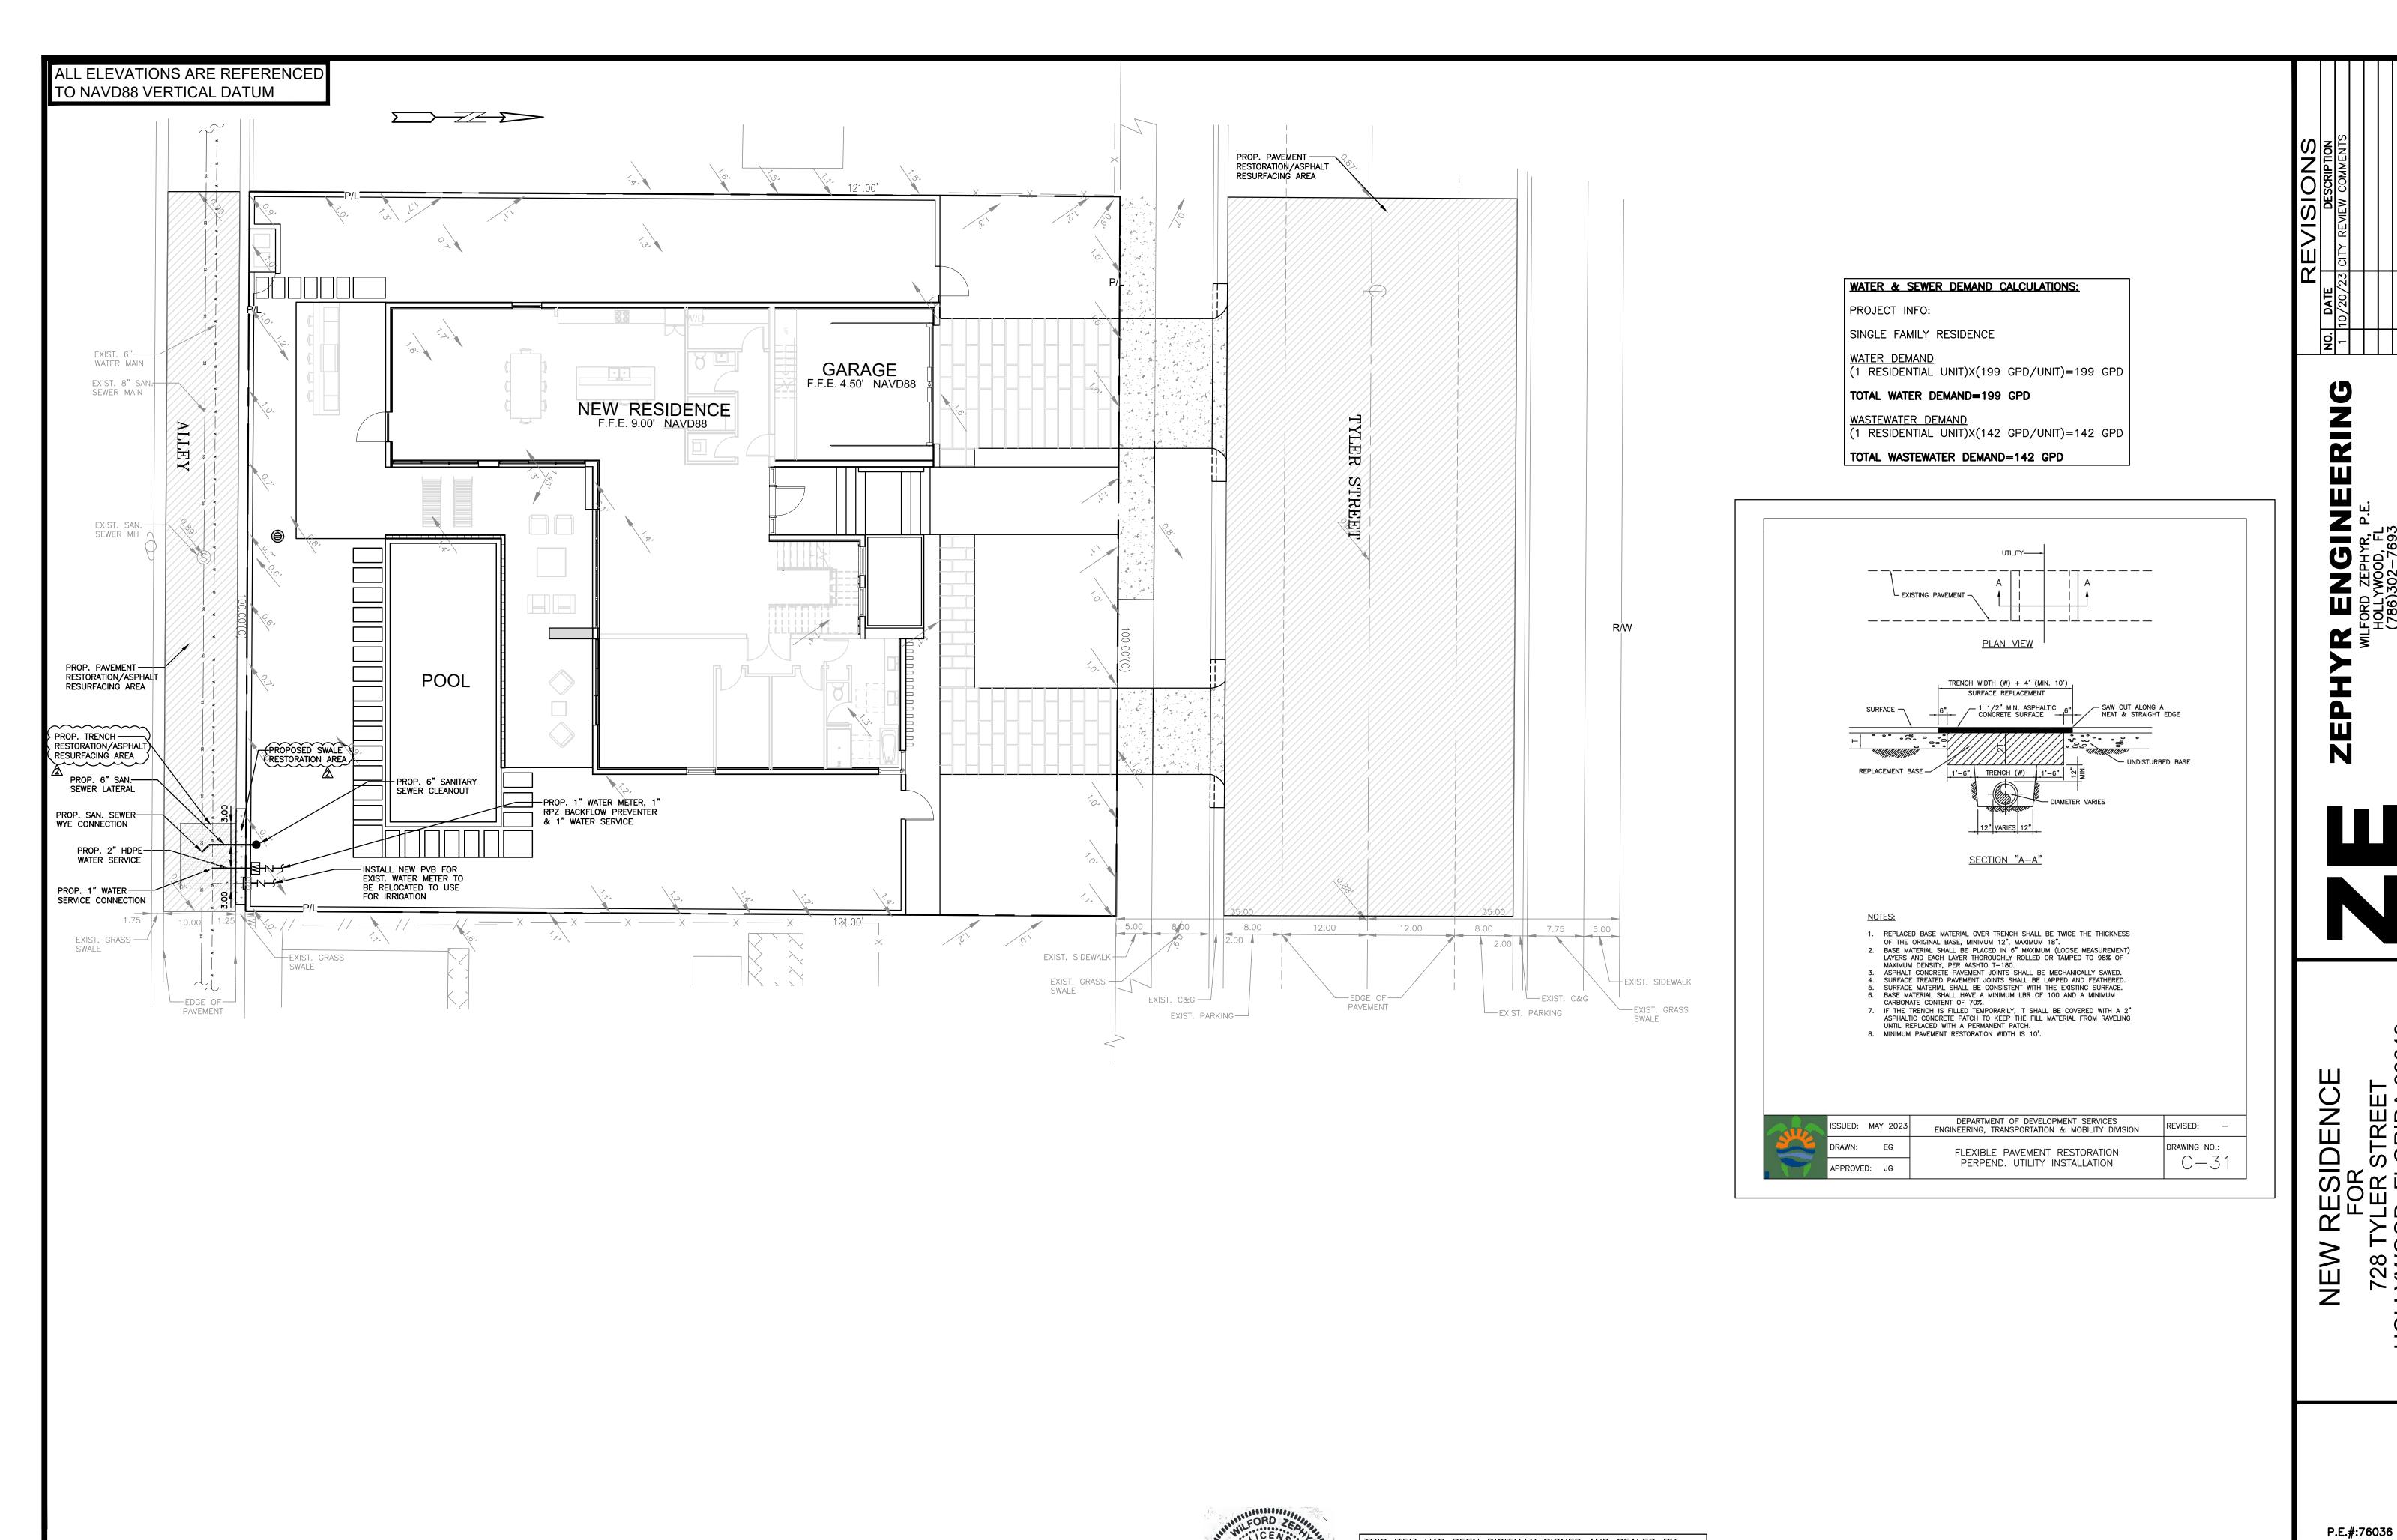PROPOSED CONCRETE PROPOSED GRADE

> EXISTING ELEVATION PROPOSED WATER METER

PROPOSED BFP DEVICE

STATE OF

THIS ITEM HAS BEEN DIGITALLY SIGNED AND SEALED BY No 76036 WILFORD ZEPHYR ON THE DATE ADJACENT TO THE SEAL.

10-25-23

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WATER PLAN & DETAILS

SCALE: 1"=10'

SCALE: 1"=10' SHEET NO .:


4 OF 5 PROJECT NO.: 23-35

DATE: 8/1/23

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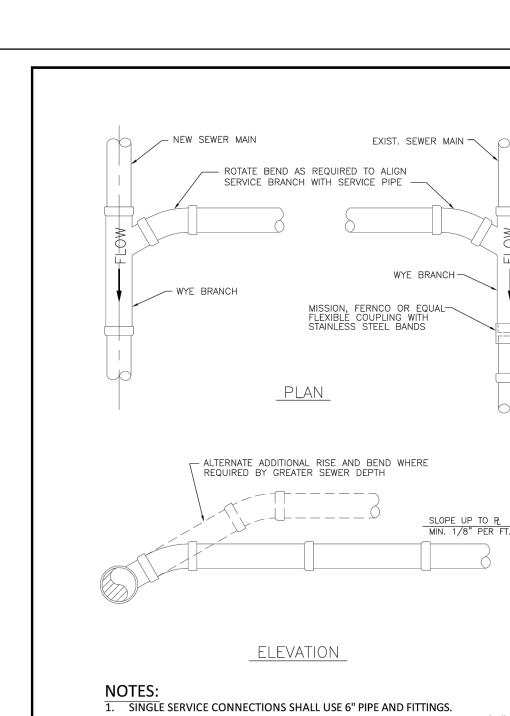
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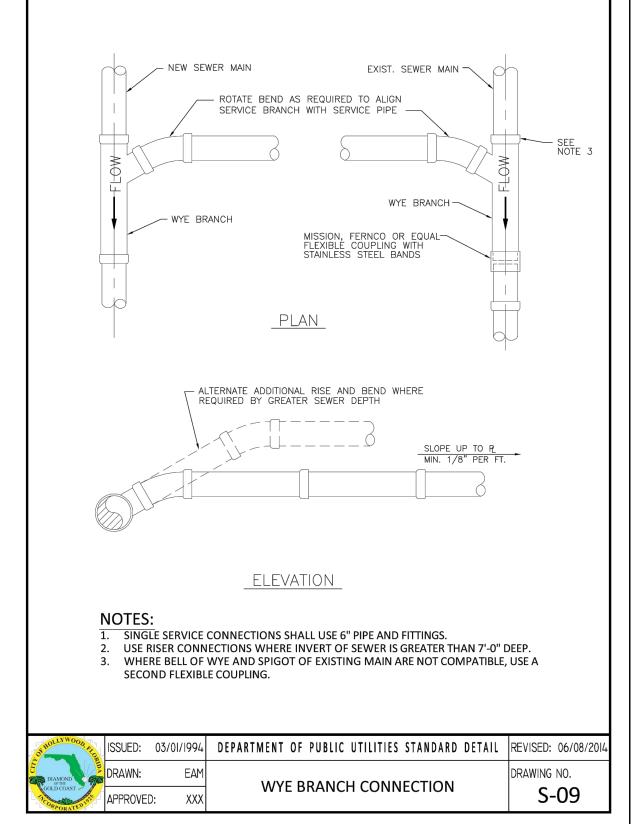
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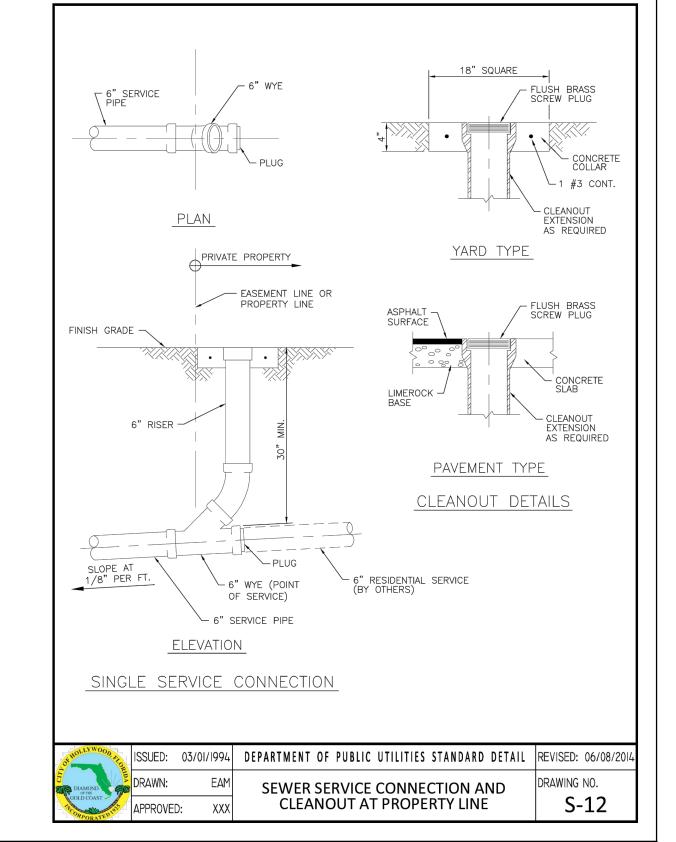



SCALE: N.T.S. SHEET NO.: 5 OF 5

PROJECT NO.: 23-35

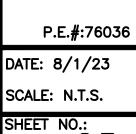





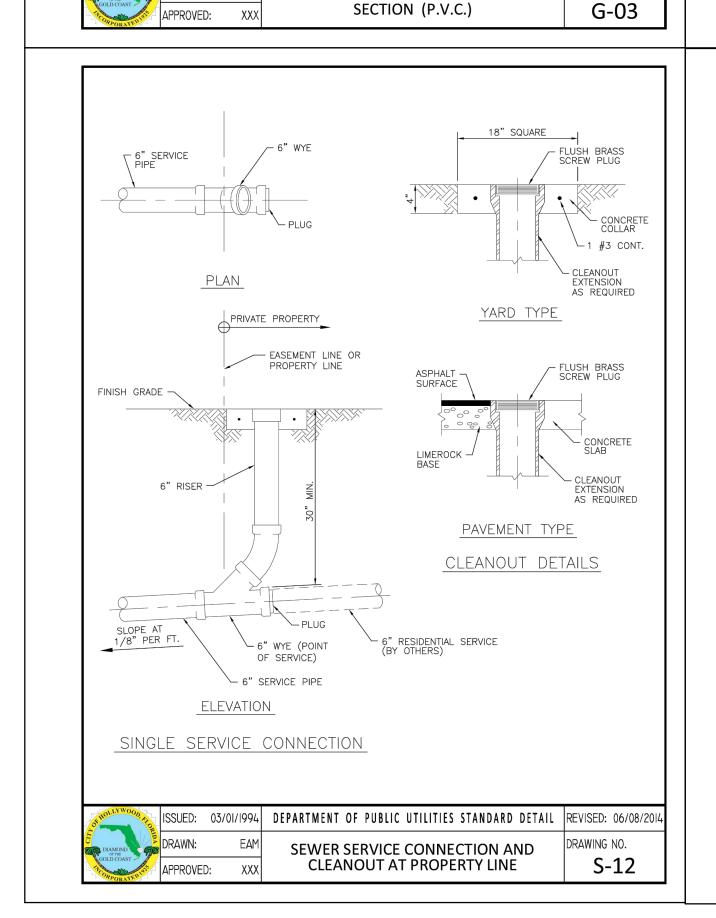

- FOR PAVEMENT RESTORATION REFER TO FDOT, BROWARD

- BEDDING MATERIAL PLACED UP TO SPRINGLINE OF PIPE (SEE NOTE 1 BELOW).

DRAWING NO.

- FLAT OR RESTORED

TRENCH BOTTOM

BOTTOM OF ROADWAY BASE -OR EXISTING GROUND

HAUNCHING {

PIPE O.D. + 2' MAXIMUM

PIPE O.D. + 1' MINIMUM

TRENCH WIDTH

1. WHEN PIPE INSTALLATION IS ABOVE THE GROUND WATER TABLE ELEVATION, OR

BEDDING SHALL BE WELL GRADED, WASHED CRUSHED STONE (OR DRAINFIELD

LIMEROCK). CRUSHED STONE SHALL CONSIST OF HARD, DURABLE, SUB—ANGULAR PARTICLES OF PROPER SIZE AND GRADATION, AND SHALL BE FREE FROM ORGANIC MATERIAL, WOOD, TRASH, SAND, LOAM, CLAY, EXCESS FINES, AND OTHER DELETERIOUS MATERIALS.

2. ALL BEDDING MATERIAL SHALL BE COMPACTED TO 95% OF MAXIMUM DENSITY BEFORE ANY PIPE IS LAID. FOR ADDITIONAL MATERIAL SPECIFICATIONS REFER TO

| ISSUED: 03/01/1994| DEPARTMENT OF PUBLIC UTILITIES STANDARD DETAIL | REVISED: 06/08/20

PIPE LAYING CONDITION TYPICAL

SPECIFICATION SECTION 02222, "EXCAVATION AND BACKFILL FOR UTILITIES".

3. DENSITY TESTING SHALL BE IN ACCORDANCE WITH AASHTO T-180 AND ASTM D-3017.

4. BACKFILL TO COMPLY WITH FDOT DESIGN STANDARD 125-8.

WHENEVER BEDDING COPPER PIPE UNDER ANY CONDITION, BEDDING MATERIAL SHALL BE CLEAN SANDY SOIL IF AVAILABLE WITHIN THE LIMITS OF CONSTRUCTION. IMPORTED


PLACED IN LAYERS NOT TO EXCEED 12" IN THICKNESS. EACH LAYER SHALL BE COMPACTED TO


100% OF MAXIMUM DRY DENSITY


LACED IN LAYERS NOT TO EXCEED 6" IN THICKNESS. EACH LAYER SHALL BE

MAXIMUM DRY DENSITY

COUNTY PUBLIC WORKS, OR CITY OF HOLLYWOOD PAVEMENT

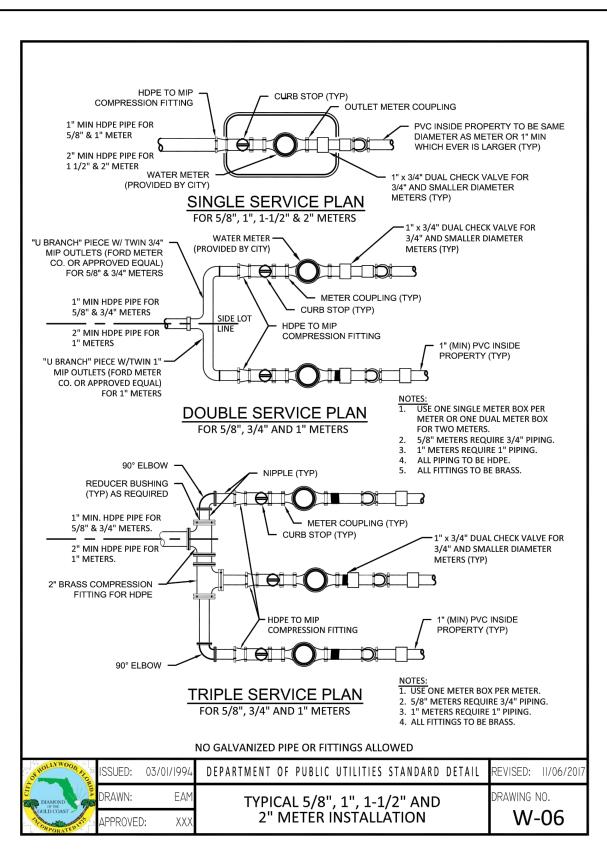


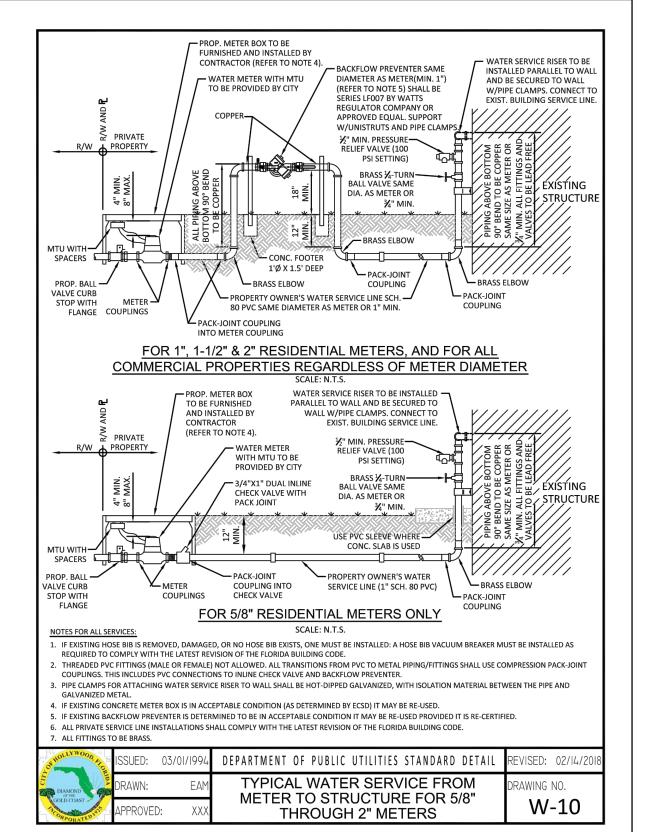

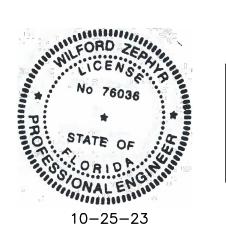

THIS ITEM HAS BEEN DIGITALLY SIGNED AND SEALED BY WILFORD ZEPHYR ON THE DATE ADJACENT TO THE SEAL.

PRINTED COPIES OF THIS DOCUMENT ARE NOT CONSIDERED SIGNED AND SEALED AND THE SIGNATURE MUST BE VERIFIED ON ANY ELECTRONIC COPIES.

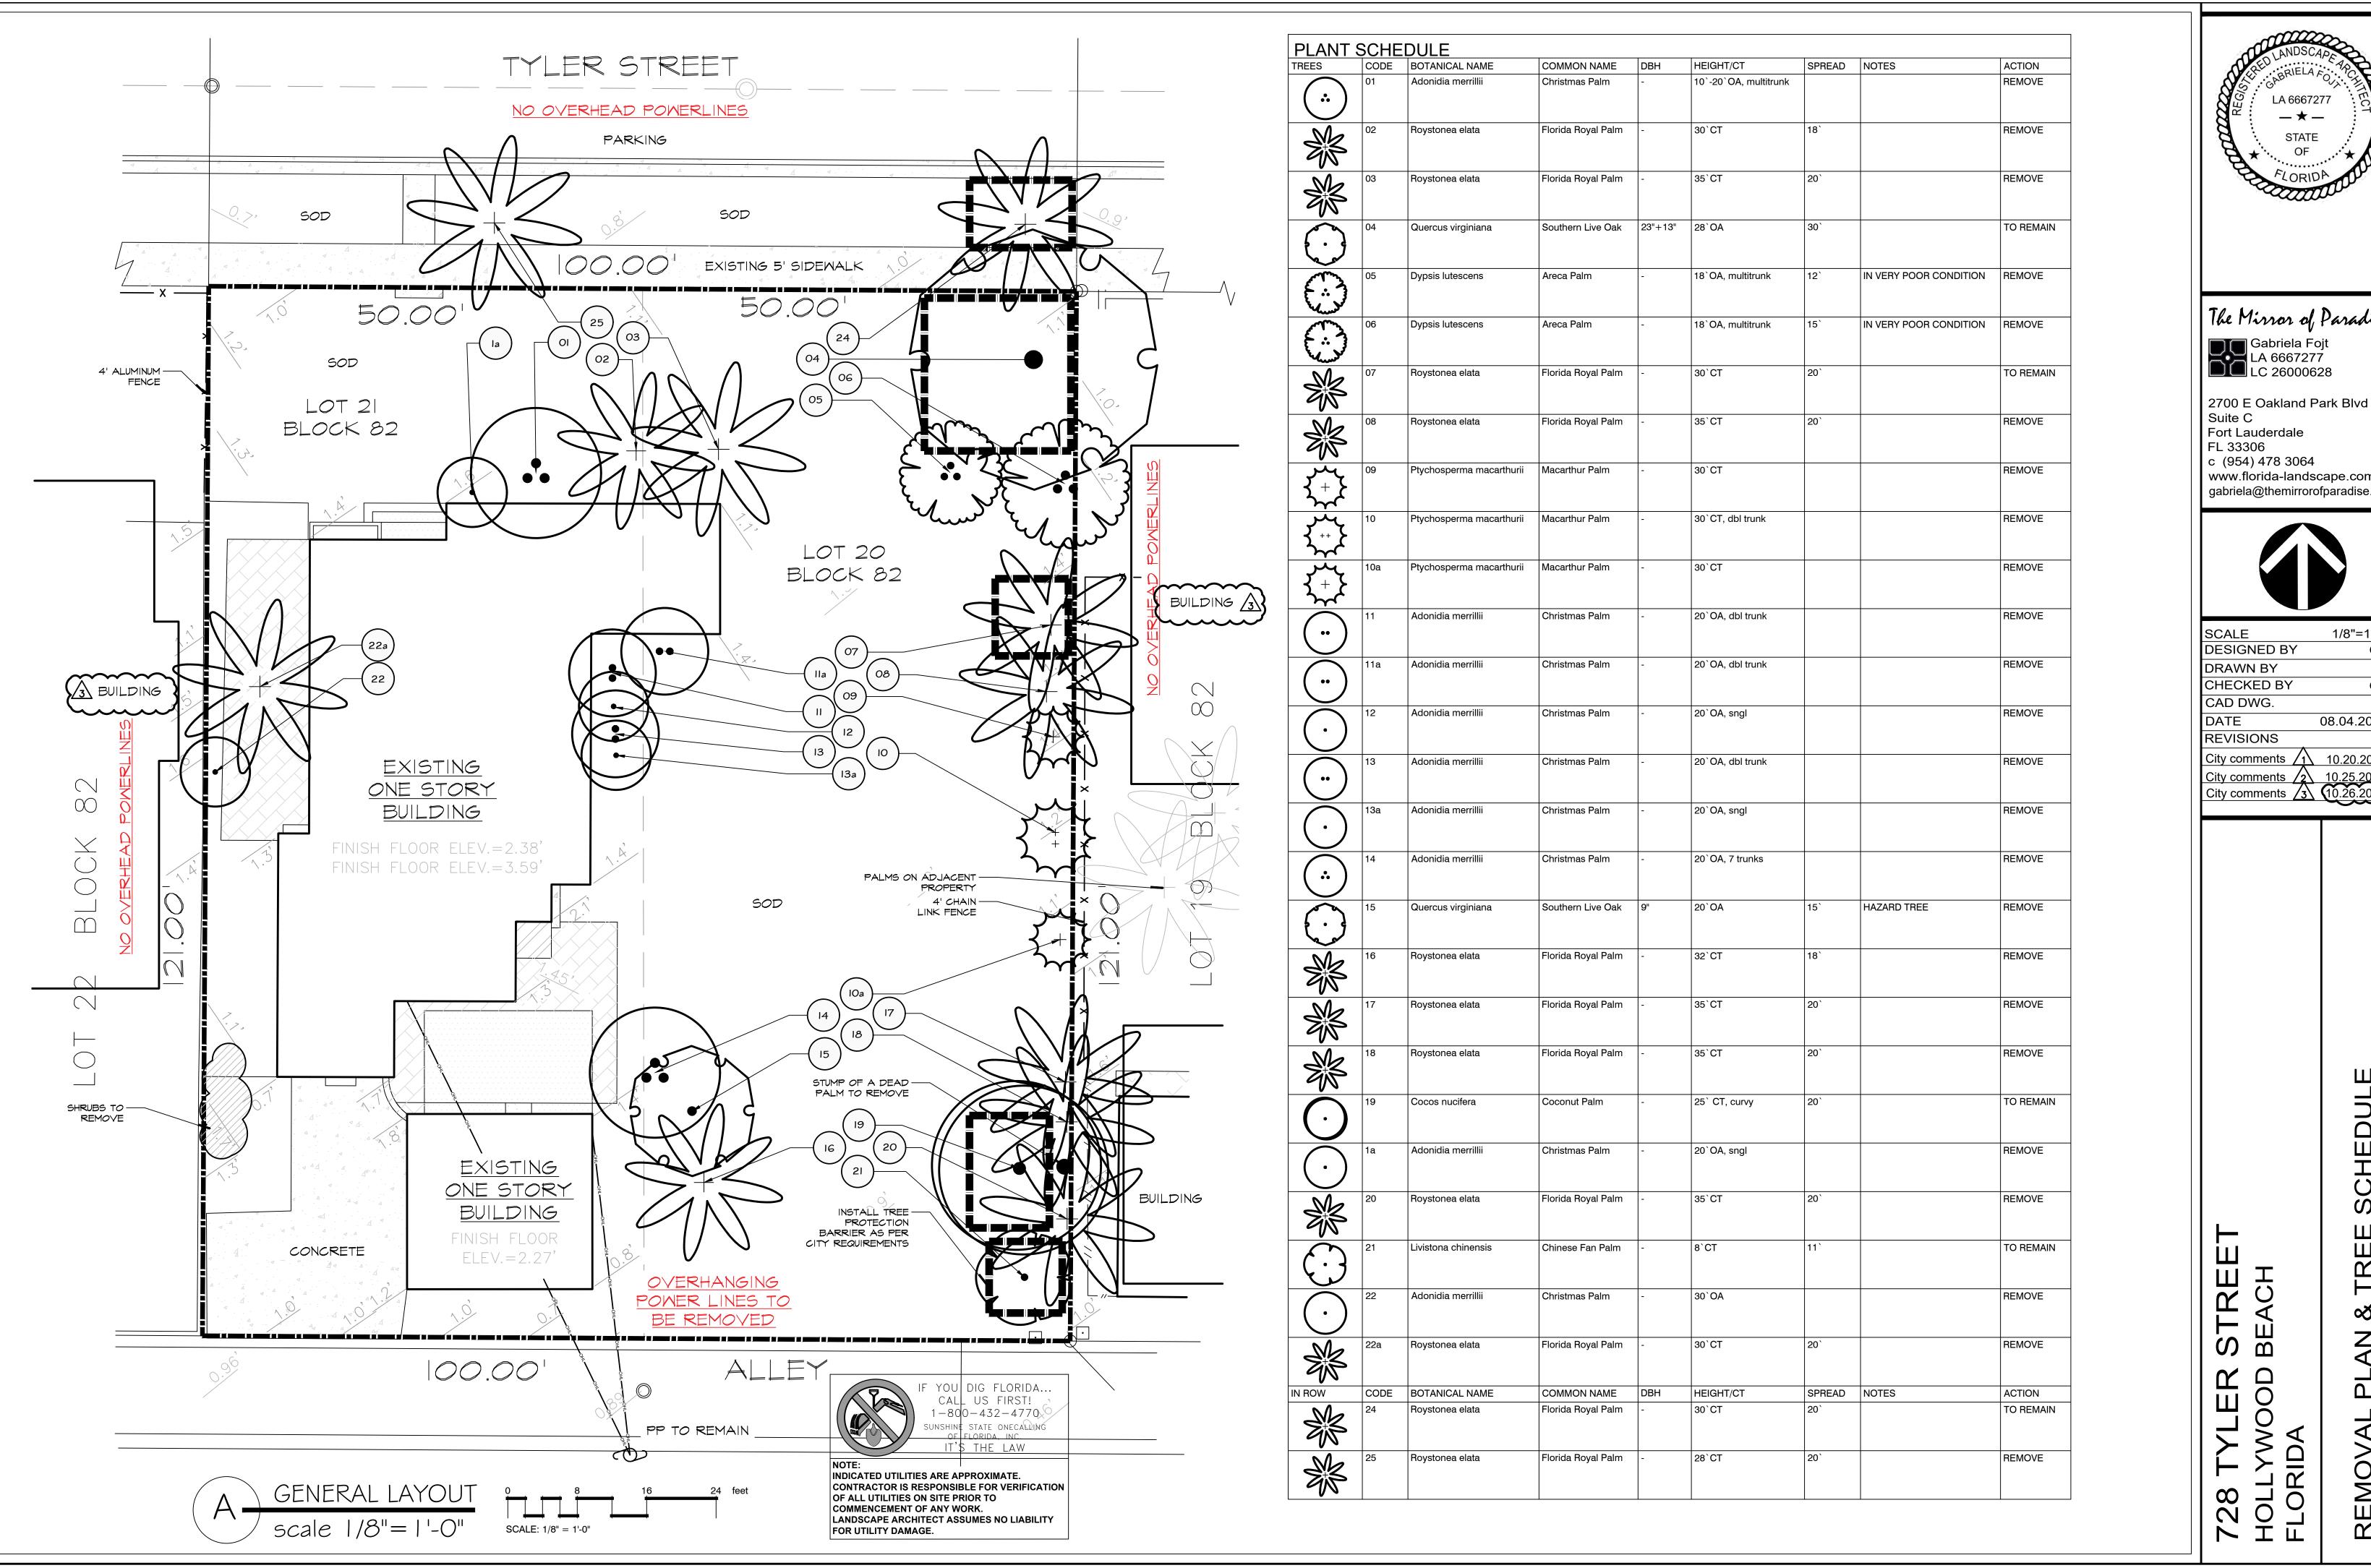




Gabriela Fojt LA 6667277 LC 26000628

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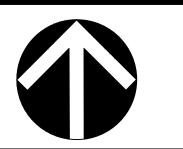
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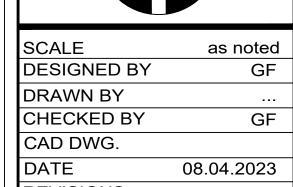


SCALE	as noted
DESIGNED BY	GF
DRAWN BY	
CHECKED BY	GF
CAD DWG.	
DATE	08.04.2023
REVISIONS	
City comments 1	10.20.2023
City comments 2	10.25.2023
City comments (3)	10 26 2023

MITIGATION ∞ DETAIL

2700 E Oakland Park Blvd

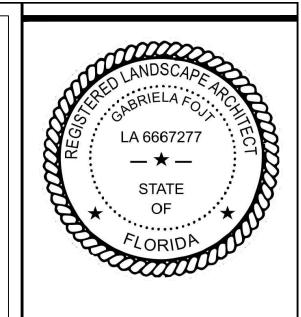gabriela@themirrorofparadise.com



ATIONS CUL

PROTECTION

STREE' BEACH

EXIST. UNDISTURBED SOIL SECTION TOP VIEW 1. BARRICADE CIRCLE TO BE CENTERED ON TREE TRUNK(S). FOR GROUPS OF TREES, PLACE BARRICADES BETWEEN TREES AND CONSTRUCTION ACTIVITY.

2. TREE PROTECTION BARRICADES SHALL BE LOCATED TO PROTECT EXISTING, RELOCATED AND NEW TREES IN CONSTRUCTION AREAS. THE PROTECTIVE BARRIER SHALL BE PLACED AROUND THE TREE AT A DISTANCE 6 FEET FROM THE TREE TRUNK OR AT THE CANOPY DRIP LINE, WHICHEVER IS GREATER OR AS SHOWN ON LANDSCAPE PLAN. ISSUED: MAY 2023 REVISED: -DRAWING NO.: DRAWN: EG TREE PROTECTION DETAIL APPROVED: JG




9/2 x \$350=\$1,575.00 \$.9,625.00 **TOTAL** MITIGATION TREES PROVIDED: 4 TREES 4 x \$350= \$1,400.00 12 x \$350= \$4,200.00 12 PALMS **TOTAL PROVIDED** \$5,600.00 MITIGATION TO PAY TO CITY TREE FUND: \$ 9,625.00 - \$ 5,600.00= \$ 4,025.00

23 x \$350=\$8,050.00

MITIGATION CALCULATIONS:

23 PALMS TO REMOVE


9" DBH TO REMOVE

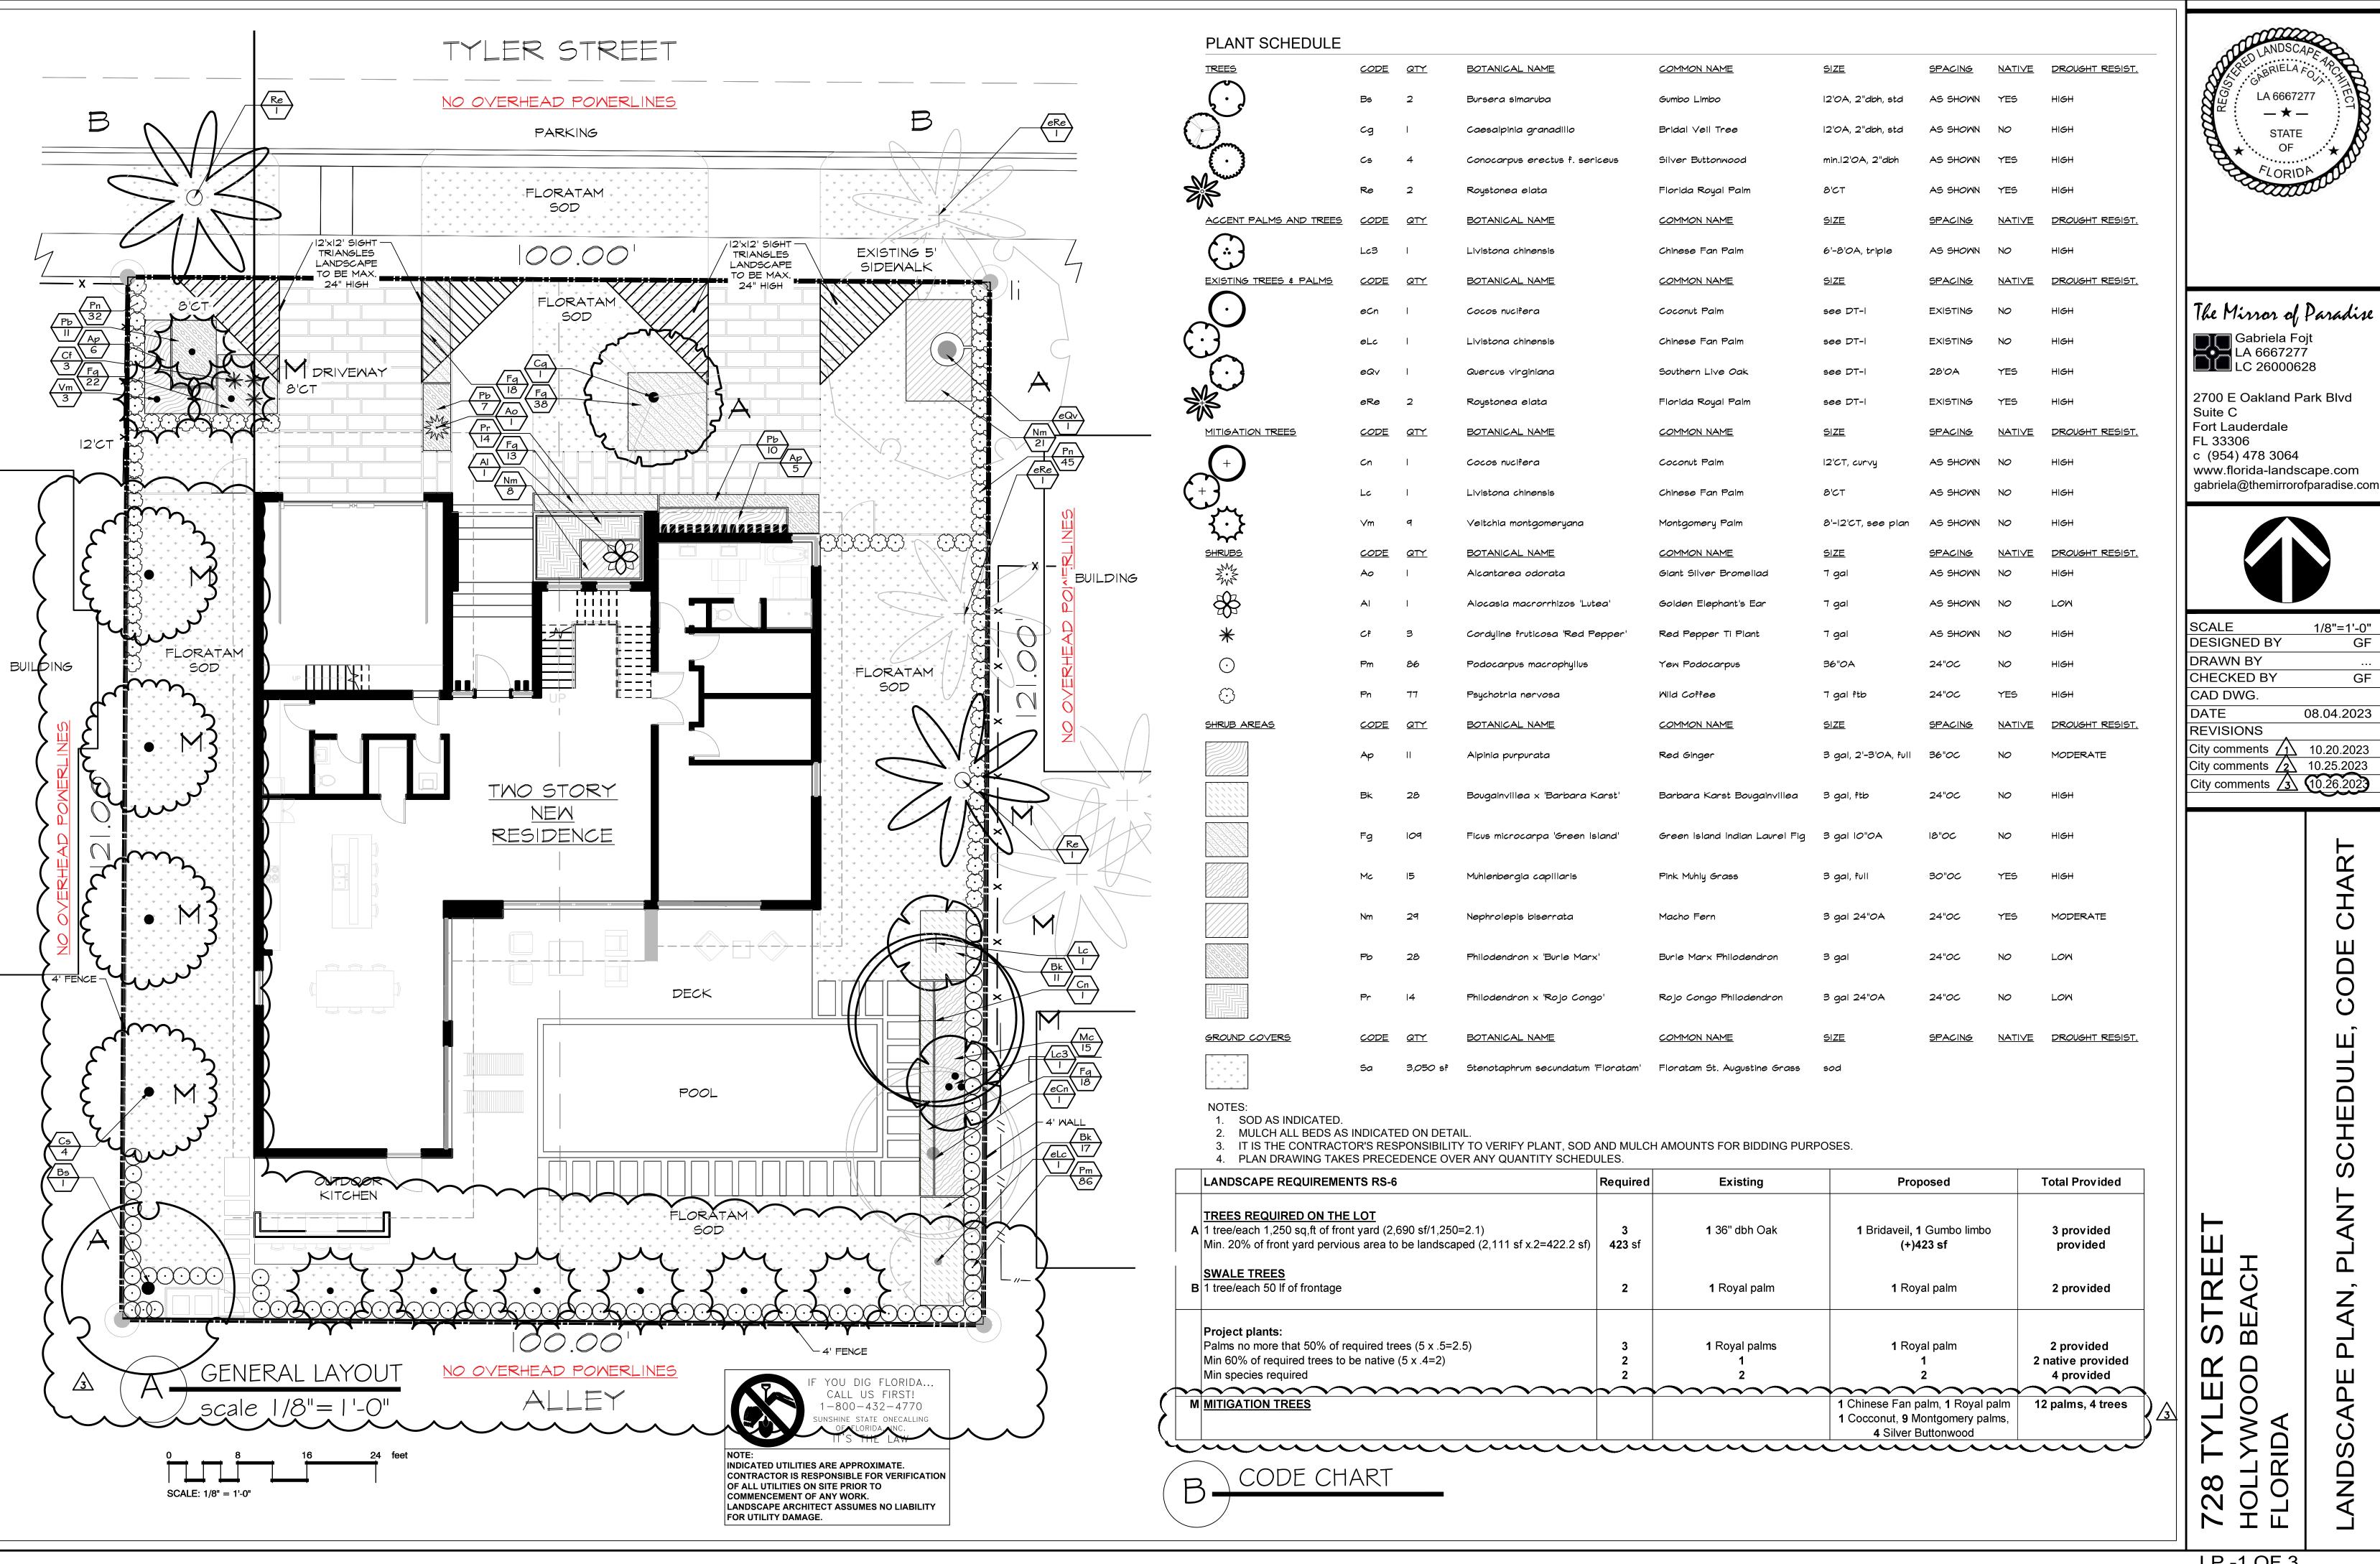



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City comments 3	10.26.2023

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GENERAL LANDSCAPE NOTES

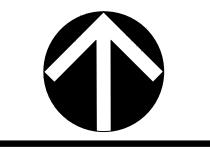
- 1. CONTRACTOR IS RESPONSIBLE FOR REPAIRING FACILITIES HE DAMAGES AND IS TO COORDINATE WITH OTHER CONTRACTORS ON SITE.
- 2. CONTRACTOR IS RESPONSIBLE FOR FINISH GRADES- ROUGH GRADES BY GENERAL CONTRACTOR.
- 3. ALL PLANT MATERIALS TO BE FLORIDA NO. 1 OR BETTER AS PER FLORIDA DEPT. OF AGRICULTURE GRADES & STANDARDS, MARCH 1998
- 4. PLANTING SOIL TO BE A WEED FREE MIXTURE OF MUCK & SAND (50/50) WITH 50 LBS OF MILORGANITE PER 6 CU, YDS.
- 5. TREES & PALMS GUARANTEED TO BE IN HEALTHY THRIVING CONDITION FOR ONE YEAR FROM PROJECT COMPLETION.
- 6. APPLY 3" MELALEUCA\EUCALYTUS MULCH ARDUND ALL PLANTS WITHIN 2 DAYS.
- 7. CONTRACTOR TO COMPLY WITH ALL CITY LANDSCAPE ORDINANCE REQUIREMENTS.
- 8. WHERE THERE IS A DISCREPENCY EITHER IN QUANTITIES, PLANT NAMES, SIZES OR SPECIFICATIONS BETWEEN THE PLAN OR PLANT LIST, THE PLAN TAKES PREFERENCE. THE LANDSCAPE CONTRACTOR IS RESPONSIBLE FOR ANY VERIFICATION NECESSARY INVOLVING THE LANDSCAPE MATERIALS SHOWN ON THE PLAN.
- 9. ALL AREAS NOT COVERED BY PAVING OR STRUCTURES TO BE SODDED WITH FLORATAM SOD. SOD TO HAVE GOOD COMPACT GROWTH & ROOT SYSTEM, LAY WITH TIGHT JOINTS
- 10. ALL LANDSCAPED AREAS INSIDE PROPERTY AND ADJACENT ROW AREAS TO BE 100% COVERED WITH AUTOMATIC SPRINKLER SYSTEM WITH APPROXIMATELY 50% OVERLAP USING RUST FREE WATER AND A RAIN CHECK DEVICE.
- 11. TREES & PALMS TO BE STAKED AS NECESSARY IN A GOOD WORKMANLIKE MANNER WITH NO NAIL STAKING PERMITTED.
- *12. ROOT FLARES TO BE SET ABOVE GRADE AND VISIBLE WITH ROOT SYSTEMS 10% ABOVE FINAL GRADE AT TIME OF PLANTING.
- 13. LANDSCAPING SHALL COMPLY WITH ALL ZONING AND LAND DEVELOPMENT REGULATIONS.

HOLLYWOOD LANDSCAPE NOTES

- 1. PLANT MATERIAL WILL NOT BE PLANTED INTO ROOT BALLS OF TREES AND PALMS.
- 2. THERE WILL BE NO SUBSTITUTIONS WITHOUT THE APPROVAL OF HOLLYWOOD'S LANDSCAPE PLAN REVIEWER.

TREE PLANTING DETAIL

WHERE REQUIRED FOR SCREENING PURPOSES, HEDGE SHALL BE PLANTED AT EQUIPMENT HEIGHT FOR **VISUAL SCREENING. PROVIDE** MINIMUM OF 36" HT.

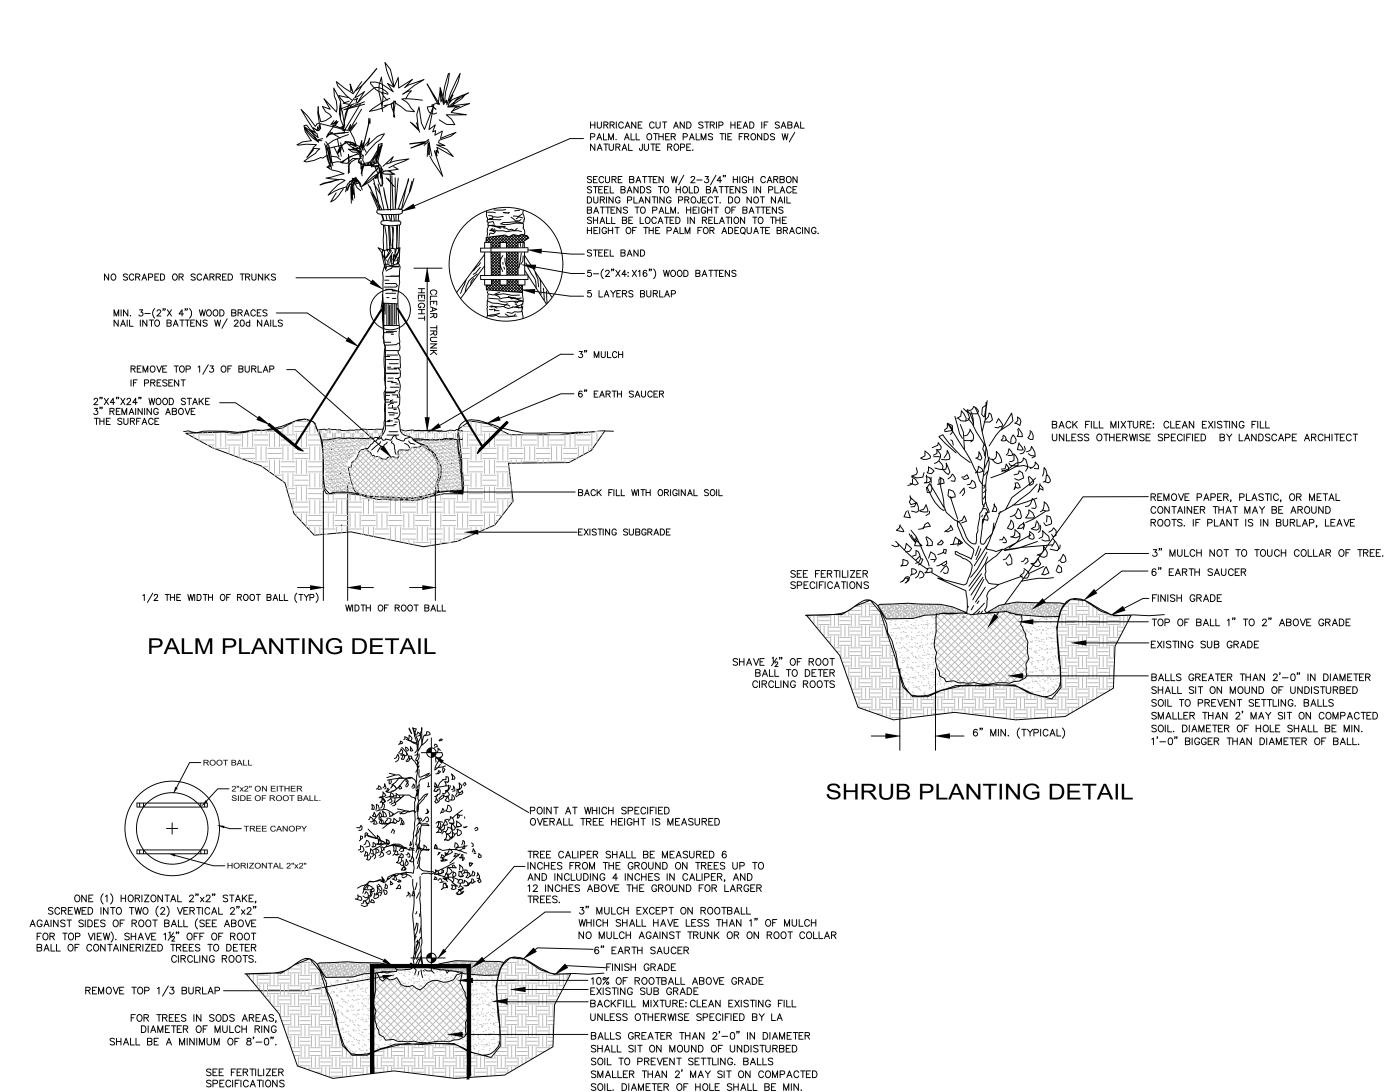

2 TIMES BIGGER THAN DIAMETER OF BALL

JOB CONDITIONS:

Any building construction material or foreign material shall be removed from planting areas and replaced with acceptable top soil.

Care shall be taken not to disturb or damage any underground construction or utilities. Any damage to these facilities during the planting operations will be repaired at the expense of the Landscape Contractor in a manner approved by the Owner. Where underground obstructions will not permit the planting materials in accordance with the plans, new locations shall be approved by the Landscape Architect.

Landscape work shall be coordinated with the landscape irrigation work. Landscape Contractor shall ensure that no plantings will interfere with the proper coverage. Landscape Contractor shall point out situations where minor adjustments or relocation or addition of sprinklers heads may be most beneficial for the landscape work as a whole.

PLANT MATERIAL:

Plant species and size shall conform to those indicated on the drawings. Nomenclature shall conform to STANDARDIZED PLANT NAMES, LATEST EDITION. All plant material shall be in accordance with GRADES AND STANDARDS FOR NURSERY PLANTS, latest edition published by the Florida Department Agriculture and Consumer Services. All plants not otherwise specified as Florida Fancy, or Specimen, shall be Florida Grade Number 1 or better as determined by the Florida Grade Plant Industry. Specimen means an exceptionally heavy, symmetrical, tightly-knit plant, so trained or favored in its development that its appearance is unquestionable and outstandingly superior in form, number of branches, compactness and symmetry. All plants shall be sound, healthy, vigorous, well branched and free of disease and insect eggs and larvae and shall have adequate root systems. Trees and shrubs for planting rows shall be uniform in size and shape. All materials shall be subject to approval by the Landscape Architect. Where any requirements are omitted from the Plant List, the plants furnished shall be normal for the variety.

All container grown material shall be healthy, vigorous, well-rooted plants and established in the container. The plants shall have tops which are good quality and are in a healthy growing condition. An established container grown plant shall be transplanted into a container and grown in that container long enough for the new fibrous roots to have developed enough to hold the root mass together when removed from the container. Root bound plants will not be accepted.

Site water shall be verified by Contractor prior to submission of bids.

The use of natural material is strongly encouraged for balled and burlapped plants. All synthetic material shall be completely removed from root ball PRIOR to planting.

At time of bid, Contractor shall submit a written schedule of all sources for coconut palms as well as seed sources for coconuts. Coconuts shall be certified Malayan Green with a certified seed source from Jamaica.

The most critical factor for selecting a healthy Florida Number 1 tree is the structure. This consists of one central main trunk and leader. Branches are considered competing if they are 2/3 the diameter of the leader or greater. Competing branches may be acceptable if they occur above 50% of the overall height of the tree. Caliper of tree should meet specifications. Leader (center trunk) may have slight (<15 degree) bow (Tabebuia caraiba excluded), but must be intact with apical (leading) bud.

Branches should be spread evenly (staggered, alternating) through the tree branches spaced no closer than 4".

Canopy should be full to specifications with little or no openings or holes. A thinning canopy will be taken into consideration with field dug plant material.

Trees should have no open wounds or damage, flush cuts, chlorosis, shorter or taller than specified height, girdling roots, undersize loose root ball, crossing branches, smaller than normal leaves.

10% of root ball shall be above grade after planting. Root ball tying ropes removed from trunk and top of root ball.

MULTIPLE TRUNK TREES:

Trees having no distinct leader. Trunks on these trees should not be touching and free of damage and similar in size. Canopy should be full and uniform.

MATERIALS LIST:

Landscape Contractor shall be responsible for verifying all quantities for material shown on drawings prior to submitting a bid. Planting plan shall take precedence over the plant list. Final quantity of sod and mulch shall be verified.

SUBSTITUTIONS:

No substitutions shall be made without the approval from the Landscape Architect and/or the Owner. Intended substitutions shall be indicated on the bid.

MEASUREMENTS:

Canopy Trees- Height shall be measured from the ground to the average height of canopy. Spread shall be measured to the end of branching equally around the crown from the center of the trunk. Caliper (d.b.h.) will be measured 4'-6" above grade.

Shrubs- Height shall be measured from the ground. Spread shall be measured to the end of branching equally around the shrub mass.

Palms- Clear trunk (C.T.) shall be measured from the ground to the point where the mature aged trunk joins the immature or green part of the trunk or head.

Overall height (O.A.) shall be measured from the ground to the tip of the unopened bud.

IRRIGATION:

100% irrigation coverage shall be provided. Provide bubblers on separate zones for all newly planted and transplanted trees unless alternate approach to provide additional water is approved by Owner and Landscape Architect.

GUARANTEE:

All new plant materials shall be guaranteed for one year from the time of acceptance and shall be alive and in satisfactory growth for each specific kind of plant at the end of the guarantee period. The Landscape Contractor shall not be responsible for damage caused by vandalism, violent wind storms or other acts of God beyond control. Replacement shall occur within two weeks of rejection and guaranteed six months from date of installation. Landscape Contractor shall repair damage to other plants or lawns during plant replacements at no additional cost.

MULCH:

Mulch shall not contain sticks 1/4" in diameter or stones. Apply 3" of mulch except on top of tree rootballs and against woody shrubs. Rootballs will receive less than 1" mulch with no mulch touching trunk or root collar. Do not apply mulch against the trunks of woody shrubs.

All sod shall be installed in such a manner that there is an even surface, staggered pattern. Sod will be green in color and in good health. NO overlap, gaps, damage, insects, disease and less than 10% chlorosis will be permitted. All gaps will be filled with clean native soil.

STAKING:

Landscape Contractor to suggest alternate means of staking for approval with Landscape Architect if staking methods shown are not feasible due to site conditions.

FERTILIZER:

Manufacturer's Specification: Submit manufacturer's specification sheet(s) for approval of product. Submit tags from bags of fertilizer used on site to the Architect. Submit copies of the manufacturer's specifications or analysis of all fertilizer for approval.

Composition and Quality: All fertilizer shall be uniform in composition and dry. Granular fertilizer shall be free flowing and delivered in unopened bags. Tablet fertilizer shall be delivered in unopened containers or boxes. All bags, containers or boxes shall be fully labeled with the manufacturer's analysis.

Fertilizer shall be slow release with ratio greater than 3 to 1 nitrogen to phosphorous applied on top of backfill, per manufacturer's recommendations.

All shall comply with the State of Florida fertilizer laws.

CLEANUP:

Landscape Contractor shall at all times keep job site clean and free from accumulation of waste material, debris and rubbish.

INSPECTION:

Upon written request from the Contractor, Owner and/or Landscape Architect shall perform inspection to determine completion of Contract.

ACCEPTANCE:

Following inspection, Contractor will be notified, in writing, by Owner and/or Landscape Architect of acceptance of completion with regards to plant material and workmanship according to Contract.



INDICATED UTILITIES ARE APPROXIMATE. CONTRACTOR IS RESPONSIBLE FOR VERIFICATION OF ALL UTILITIES ON SITE PRIOR TO COMMENCEMENT OF ANY WORK. LANDSCAPE ARCHITECT ASSUMES NO LIABILITY FOR UTILITY DAMAGE.



The Mirror of Paradise

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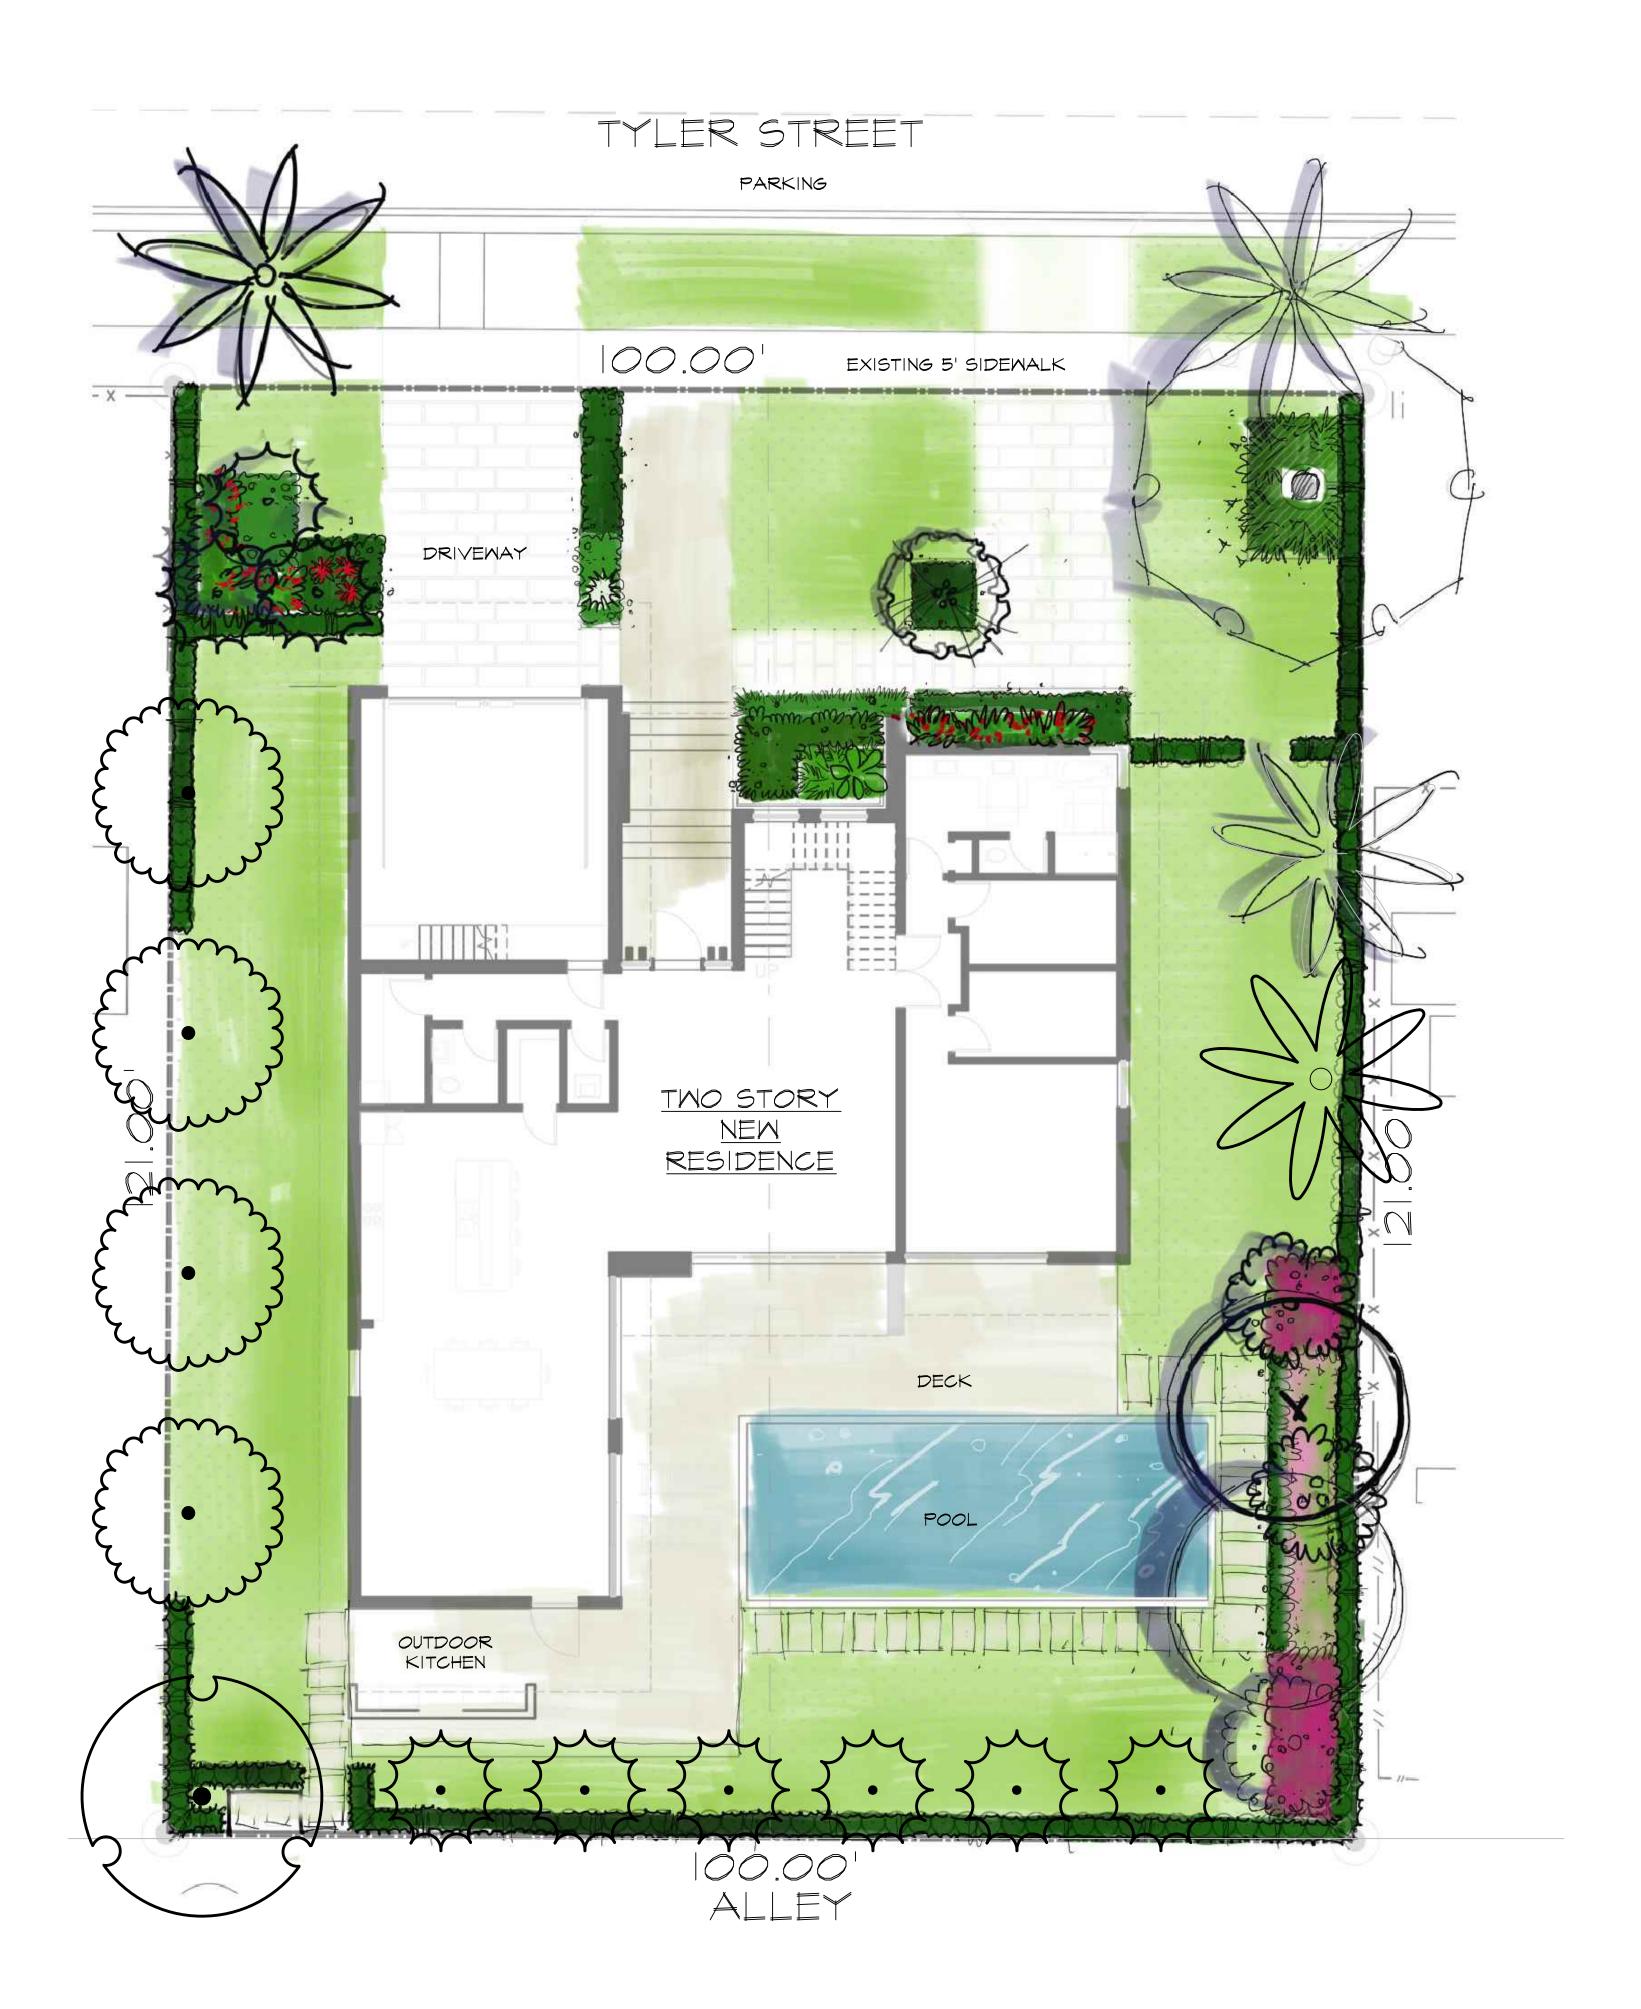
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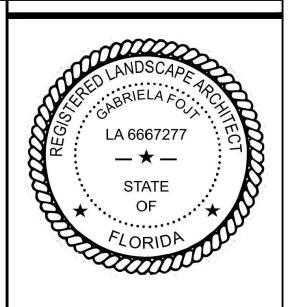


SCALE as noted **DESIGNED BY** DRAWN BY CHECKED BY CAD DWG. DATE 08.04.2023 REVISIONS City comments /1 10.20.2023 City comments /2 10.25.2023 City comments <u>/3</u> 10.26.2023

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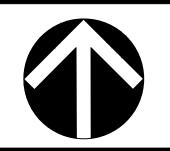
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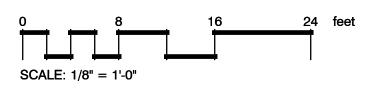
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CAD DWG.	
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REVISIONS	08.04.2023
	10.20.2023
REVISIONS	
REVISIONS City comments	10.20.2023

GENERAL LAYOUT scale 1/8"=1'-0"





NOTE:
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OF ALL UTILITIES ON SITE PRIOR TO
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STREET
BEACH

PLAN

COLORED