	ABBREVIATION LEGEND	LINE TYPE LEGEND	PROPOS	SED SYMBOL LEGEND	EX	(ISTING SYMBOL LEGEND
ARV	AIR RELEASE VALVE		•	AIR RELEASE VALVE	8.75	EXISTING SPOT ELEVATION (FT)
BE	BURIED ELECTRIC	SECTION LINE	⊕ B.S.P. No.	BACTERIOLOGICAL SAMPLE POINT	(←	GUY ANCHOR
BFP	BACKFLOW PREVENTER		B .S.F. No.	WATER METER	(FPL)	FPL MANHOLE
BFV	BUTTERFLY VALVE					
ВМ	BENCHMARK	CENTERLINE	•	FIRE HYDRANT	⟨>-CLP	CONC. LIGHT POLE
BOP	BOTTOM OF PIPE		•	FIRE DEPARTMENT CONNECTION	<>-	CONC. UTILITY POLE
BSP CAP	BACTERIOLOGICAL SAMPLING POINT CORRUGATED ALUMINUM PIPE	GUARDRAIL	-	SINGLE WATER SERVICE	⟨>-	CONC. SIGNAL POLE
CB	CATCH BASIN	—O—O—O—PROPOSED CHAIN LINK FENCE	-[-	DOUBLE WATER SERVICE		COMMUNICATION MH
CI	CURB INLET	EXISTING WOOD FENCE	<u> </u>	BACKFLOW PREVENTER		COMMUNICATION RISER
CIP	CAST IRON PIPE	EXISTING PICKET FENCE		DOUBLE DETECTOR CHECK VALVE		CABLE TV MANHOLE
CLF	CHAIN LINK FENCE		•[BLOWOFF		CABLE TV RISER
CMP	CORRUGATED METAL PIPE				EHH	
CMU	CONCRETE MASONRY UNIT	—— ×6FM ——— ×6FM ——— EXISTING FORCE MAIN (6")	•	REDUCER	,	ELEC. HANDHOLE
20	CLEANOUT	—— A6FM ——— A6FM ——— EXISTING ABANDONED FORCE MAIN (6")	—	GATE VALVE		FPL TRANSFORMER
CONC DE	DRAINAGE EASEMENT		4/4/	→ 90°, 45°, 22.5° & 11.25° BENDS	[ELĒC]	ELECTRICAL METER
DIP	DUCTILE IRON PIPE		H	TEE	GAS	GAS METER
E	EAST		+	CROSS	*	LIGHT POLE
EL	ELEVATION		Γ	PLUG		TRAFFIC CONTROL BOX
EOW	EDGE OF WATER			BLOWOFF	WPP	WOOD POWER POLE
EXIST	EXISTING	xCD EXISTING CONDENSATION			GV	
EXFILT	EXFILTRATION FINISHED, FLOOR,	xBFO EXISTING BURIED FIBER OPTIC		- VERTICAL BENDS		GAS VALVE
FF EL	FINISHED FLOOR ELEVATION	EXISTING UNDERGROUND COMCAST		SEWER MANHOLE	SV W//	SEWER VALVE
FH FM	FIRE HYDRANT FORCE MAIN			— SANITARY FLOW DIRECTION	WV WV	WATER VALVE
GALV	GALVANIZED			SINGLE SANITARY LATERAL		GATE VALVE
GV	GATE VALVE	×OE EXISTING OVERHEAD ELECTRIC	\	DOUBLE SANITARY LATERAL		CLEANOUT
HORZ	HORIZONTAL		<u></u>	CONFLICT ID	₹	FIRE HYDRANT
H.P.	HIGH POINT			SUE POTHOLE ID		REDUCER
NV	INVERT		3			IRRIGATION VALVE
JB _	JUNCTION BOX	——————————————————————————————————————		DRAINAGE FLOW		
₋F MAX	LINEAR FEET MAXIMUM	-/-/-/	0.00	SPOT GRADE	(S)	SEWER MANHOLE
лах Л.E.G.	MATCH EXISTING GRADE	**************************************	-	SIGN	D	STORM MANHOLE
/IH	MANHOLE			CATCH BASIN	\$7	FIRE DEPARTMENT
1IN	MINIMUM			STORM MANHOLE		CATCH BASIN
ИJ	MECHANICAL JOINT		•	CLEANOUT		CURB INLET
١	NORTH			SLOTTED DRAIN	< <u>+</u>	GROUND/LANDSCAPING LIGHTING
NAVD	NORTH AMERICAN VERTICAL DATUM				5	SIGN
VIC	NOT INCLUDED			STORM YARD DRAIN		SIGN TO BE REMOVED
nts Ngvd	NOT TO SCALE NATIONAL GEODETIC VERTICAL DATUM			P5 STORM INLET		
NGVD OE	OVERHEAD ELECTRIC			P6 STORM INLET	<u> </u>	WATER METER
PCAP	PERFORATED CORRUGATED ALUMINUM PIPE	HATCHING LEGEND		EXFILTRATION TRENCH		EXFILTRATION TRENCH
PRB	POLLUTION RETARDANT BAFFLE	EXISTING DECOMMISSIONED BURIED MASTER LIFT STATION TO BE REMOVED		HEADWALL	*XXX	TREE TO BE REMOVED
PROP	PROPOSED	EXISTING BUILDING TO REMAIN		MITERED END - RCP	米米米	
PSI	POUNDS PER SQUARE INCH	EXISTING BUILDING TO BE DEMOLISHED		MITERED END — HDPE		
PV	PLUG VALVE	EXISTING PEDESTRIAN BRIDGE CANOPY		HAY BALES		
>VC	POLYVINYL CHLORIDE	WITH SIDEWALK TO BE REMOVED EXISTING ASPHALT PAVEMENT TO BE REMOVED				
R RCP	RADIUS REINFORCED CONCRETE PIPE		<u> </u>	ROCK BAGS W/ HAY BALES		
RCW	RECLAIMED WATER	EXISTING ASPHALT PAVEMENT TO BE REMOVED 30" MIN. DEPTH BELOW SURFACE	-00	— SILT BARRIER FENCE		
RED	REDUCER	EXISTING CONCRETE TO BE REMOVED		— TURBIDITY BARRIER		
R/W	RIGHT-OF-WAY	EXISTING PAVERS TO BE REMOVED				
6	SOUTH	EXISTING STRIPING/MARKINGS TO BE REMOVED				
SAN	SANITARY	EXISTING LANDSCAPING TO BE REMOVED				
SB	SOIL BORING	PROPOSED BUILDING				
STA	STATION	DETECTABLE WARNING SURFACES				
IOB	TOP OF BANK	[000000000]				
TOP TYP	TOP OF PIPE TYPICAL	PROPOSED MILLING AND RESURFACING				
UE	UTILITY EASEMENT	PROPOSED FULL DEPTH RECONSTRUCTION				
VERT	VERTICAL	PROPOSED CONCRETE SIDEWALK				
W	WEST					
	WATER MAIN					

PROJECT NOTES

1. CONTRACTOR SHALL BE RESPONSIBLE FOR PROCURING, INSTALLING, AND ALL UTILITY BYPASS SYSTEMS FOR THE DURATION OF THE TEMPORARY SERVICES AND CONSTRUCTION ACTIVITIES. BYPASS SYSTEMS SHALL BE APPROVED BY OWNER AND HAVE ONE PRIMARY ELECTRIC PUMP AND ONE BACKUP DIESEL PUMP. PUMPS SHALL BE "HOSPITAL GRADE" AND SHALL NOT EXCEED 55dB(A) AT THE RIGHT-OF-WAY BOUNDARY.

2. THE CONTRACTOR SHALL BE GOVERNED BY THE APPLICABLE PORTIONS OF THE FLORIDA DEPARTMENT OF TRANSPORTATION DESIGN STANDARDS, DATED 2023/2024, AND THE FLORIDA DEPARTMENT OF TRANSPORTATION STANDARD SPECIFICATIONS FOR ROAD AND BRIDGE CONSTRUCTION DATED 2023-24, AND SUPPLEMENTS THERETO IF NOTED IN THE SPECIAL PROVISIONS FOR THIS PROJECT.

3. THE CONTRACTOR SHALL NOTIFY THE APPROPRIATE UTILITY COMPANY AND GOVERNMENT AGENCY A MINIMUM OF TWO BUSINESS DAYS IN ADVANCE OF ANY EXCAVATION INVOLVING ITS UTILITIES AND IS

TO COORDINATE FIELD VISITS WITH UTILITY REPRESENTATIVE DURING CONSTRUCTION. 4. ANY DAMAGE BY THE CONTRACTOR TO PUBLIC OR PRIVATE PROPERTY SHALL BE RESTORED TO PRE-EXISTING CONDITIONS OR BETTER AT NO EXPENSE TO THE OWNER.

5. THE LOCATIONS OF ALL UTILITIES SHOWN IN THE PLANS ARE BASED ON LIMITED INVESTIGATION TECHNIQUES AND SHOULD BE CONSIDERED APPROXIMATE ONLY AND FIELD VERIFIED BY THE

6. THE CONTRACTOR SHALL VERIFY IF OTHER UTILITIES NOT SHOWN IN THE PLANS EXIST WITHIN THE AREA OF CONSTRUCTION. SHOULD UTILITY CONFLICTS ARISE, THE CONTRACTOR SHALL INFORM THE ENGINEER AND CORRESPONDING UTILITY COMPANY OF THE CONFLICT.

START OF CONSTRUCTION AND SUBMITTED TO THE ENGINEER AND OWNER FOR REVIEW.

7. PRE-CONSTRUCTION VIDEO OF EXISTING CONDITIONS SHALL BE TAKEN BY THE CONTRACTOR PRIOR TO

8. THE CONTRACTOR SHALL COORDINATE SELECTION AND REVIEW OF ANY PROPOSED STAGING AREA WITH THE OWNER AT LEAST 72 HOURS PRIOR TO USE. THE STAGING AREA SHALL BE RESTORED TO ITS ORIGINAL CONDITION OR BETTER AT NO ADDITIONAL COST TO THE OWNER.

9. ALL CONSTRUCTION DEBRIS SHALL BE PROPERLY DISPOSED OF OFFSITE.

10. THE CONTRACTOR SHALL UTILIZE BEST MANAGEMENT PRACTICES, AS ESTABLISHED BY THE SOUTH FLORIDA WATER MANAGEMENT DISTRICT, FOR ALL WORK.

11. THE CONTRACTOR SHALL OBTAIN ALL PERMITS AND COMPLY WITH THE PERMIT REQUIREMENTS BEFORE AND DURING CONSTRUCTION.

12. ALL QUESTIONS CONCERNING MATERIALS OR CONSTRUCTION METHODS SHALL BE DIRECTED TO THE OWNER OR THE ENGINEER.

13. PRIOR TO THE START OF CONSTRUCTION, THE CONTRACTOR SHALL COMPLY WITH FLORIDA STATUTE 553.851 FOR THE PROTECTION OF UNDERGROUND GAS PIPELINES.

14. MAINTENANCE OF TRAFFIC SHALL BE IN ACCORDANCE WITH CURRENT FDOT DESIGN STANDARDS AND THE MANUAL ON UNIFORM TRAFFIC CONTROL DEVICES AND SHALL BE THE RESPONSIBILITY OF THE CONTRACTOR. DRIVEWAYS AND TRAVEL LANES SHALL REMAIN OPEN AT ALL TIMES. ANY AND ALL PROPOSED CLOSURES OR DETOUR ROUTES SHALL REQUIRE CITY (PUBLIC RIGHT-OF-WAY) OR OWNER (HOSPITAL CAMPUS) APPROVAL.

15. CONTRACTOR MUST PROVIDE LATERAL SUPPORT FOR ALL EXISTING WATER MAINS AND MAINTAIN SOIL DEVELOPMENT EQUAL TO OR GREATER THAN EXISTING TO PREVENT WATER MAIN SEPARATION.

16. ALL EXISTING UTILITIES MANHOLE COVERS, ELECTRICAL BOXES, VALVE BOXES, METER BOXES, DRAINAGE STRUCTURES, ETC. WITHIN PROPOSED AREAS OF IMPROVEMENTS SHALL BE ADJUSTED TO GRADE ELEVATION, UNLESS OTHERWISE NOTED.

17. THE CONTRACTOR SHALL EMPLOY QUALIFIED ARBORIST TO REMOVE BRANCHES, AND TREAT ANY CUTS. 18. THE CONTRACTOR IS RESPONSIBLE FOR PRESERVING AND PROTECTING ALL EXISTING TREES NOTED ON THIS PLAN OR WITHIN CONSTRUCTION AREA BY USING 6' HIGH FLUORESCENT NYLON FENCING AS A TEMPORARY BARRIER. PRESERVED TREES SHALL BE BARRICADED BEFORE AND DURING CONSTRUCTION. IF DURING THE COURSE OF CONSTRUCTION ANY OF THE PROTECTED VEGETATION DIES, IT SHALL BE REPLACED AS REQUIRED BY THE LOCAL JURISDICTION BY THE CONTRACTOR WITH EQUAL SIZE AND CALIPER. THE TREES, WOODY SHRUBS (INCLUDING SAW PALMETTO'S) AND GROUND COVERS SHALL BE INCLUDED WITHIN THE PRESERVATION AREAS AND SHALL BE RETAINED. WHERE SUPPLEMENTAL LANDSCAPING INFRINGES ON THIS AREA, DISTURBANCE SHALL BE MINIMIZED.

19. CONTRACTOR SHALL USE SPECIAL CARE WHEN WORKING NEAR EXISTING CLAY SANITARY SEWER LINE.

20. CONTRACTOR TO AVOID DAMAGING EXISTING SEWER LATERALS. IF DAMAGE OCCURS TO EXISTING SEWER LATERALS, CONTRACTOR SHALL REPLACE AT NO ADDITIONAL COST TO THE OWNER.

21. CONTRACTOR IS TO RESTRAIN ALL FORCE MAIN PIPE JOINTS AND FITTINGS USING MEGALUG MECHANICAL JOINT RESTRAINT OR APPROVED EQUAL.

22. THE CONTRACTOR IS RESPONSIBLE FOR RESTORATION OF ALL EXISTING UTILITIES, IRRIGATION, CABLES, ETC., DISTURBED DURING CONSTRUCTION OF PROPOSED IMPROVEMENTS.

23. EXISTING SURFACE GRADES SHOWN IN PROFILE VIEWS ARE AT THE ALIGNMENT CENTERLINE.

24. MINIMUM HORIZONTAL AND VERTICAL SEPARATIONS SHOWN ON THE PLANS ARE TO BE MEASURED FROM OUTSIDE OF PIPE TO OUTSIDE OF PIPE OR STRUCTURE.

25. SURVEY DATA: ALL ELEVATIONS ON THE PLANS OR REFERENCED IN THE SPECIFICATIONS ARE BASED ON NORTH AMERICAN VERTICAL DATUM OF 1988 (NAVD88).

26. CONTRACTOR TO FIELD ADJUST LOCATION OF THE PROPOSED WORK TO MEET THE MINIMUM

SEPARATION REQUIREMENTS.

27. CONTRACTOR TO VERIFY LOCATIONS OF UTILITIES VIA SOFT DIG.

ARCHITECT HKS ARCHITECTS, INC. 2020 SALZEDO STREET, 4TH FLOOR CORAL GABLES, FL 33134

INTERIOR DESIGNER HKS ARCHITECTS

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STRUCTURAL ENGINEER GMG STRUCTURAL ENGINEERS 14335 COMMERCE WAY


MIAMI LAKES, FL 33016 **MEP & FIRE PROTECTION** TLC ENGINEERING SOLUTIONS, INC.

800 FAIRWAY DRIVE DEERFIELD BEACH, FL 33441 TELECOM & EQUIPMENT

SMITH SECKMAN REID, INC. 2995 SIDCO DRIVE NASHVILLE, TN 37204


OWNER MEMORIAL HEALTHCARE SYSTEM 3501 JOHNSON STREET

HOLLYWOOD, FL 33021

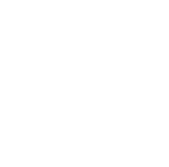



INTERIM REVIEW ONLY These documents are incomplete, and are released for interim review only and are not intended for regulatory approval, permit, or construction purposes. Engineer: James D. Messick P.E. License No.: 70870 Date: 04/11/2024

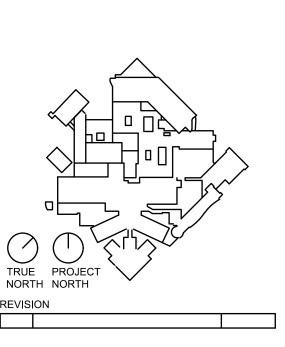

JAMES D. MESSICK, STATE OF FLORIDA, PROFESSIONAL ENGINEER, LICENSE NO. 70870. THIS ITEM HAS BEEN DIGITALLY SIGNED AND SEALED BY JAMES D. MESSICK ON THE DATE INDICATED HERE. PRINTED COPIES OF THIS DOCUMENT ARE NOT CONSIDERED SIGNED AND SEALED AND THE SIGNATURE MUST BE VERIFIED ON ANY ELECTRONIC

HKS PROJECT NUMBER 23459.000

JUNE 17, 2024 FINAL TAC

LEGENDS, ABBREVIATIONS AND GENERAL NOTES


SHEET NO. **C01**

CO1 LEGENDS, ABBREVIATIONS AND GENERAL NOTES
NOT TO SCALE

ELEVATIONS ARE

IN NAVD 88

FINAL TAC

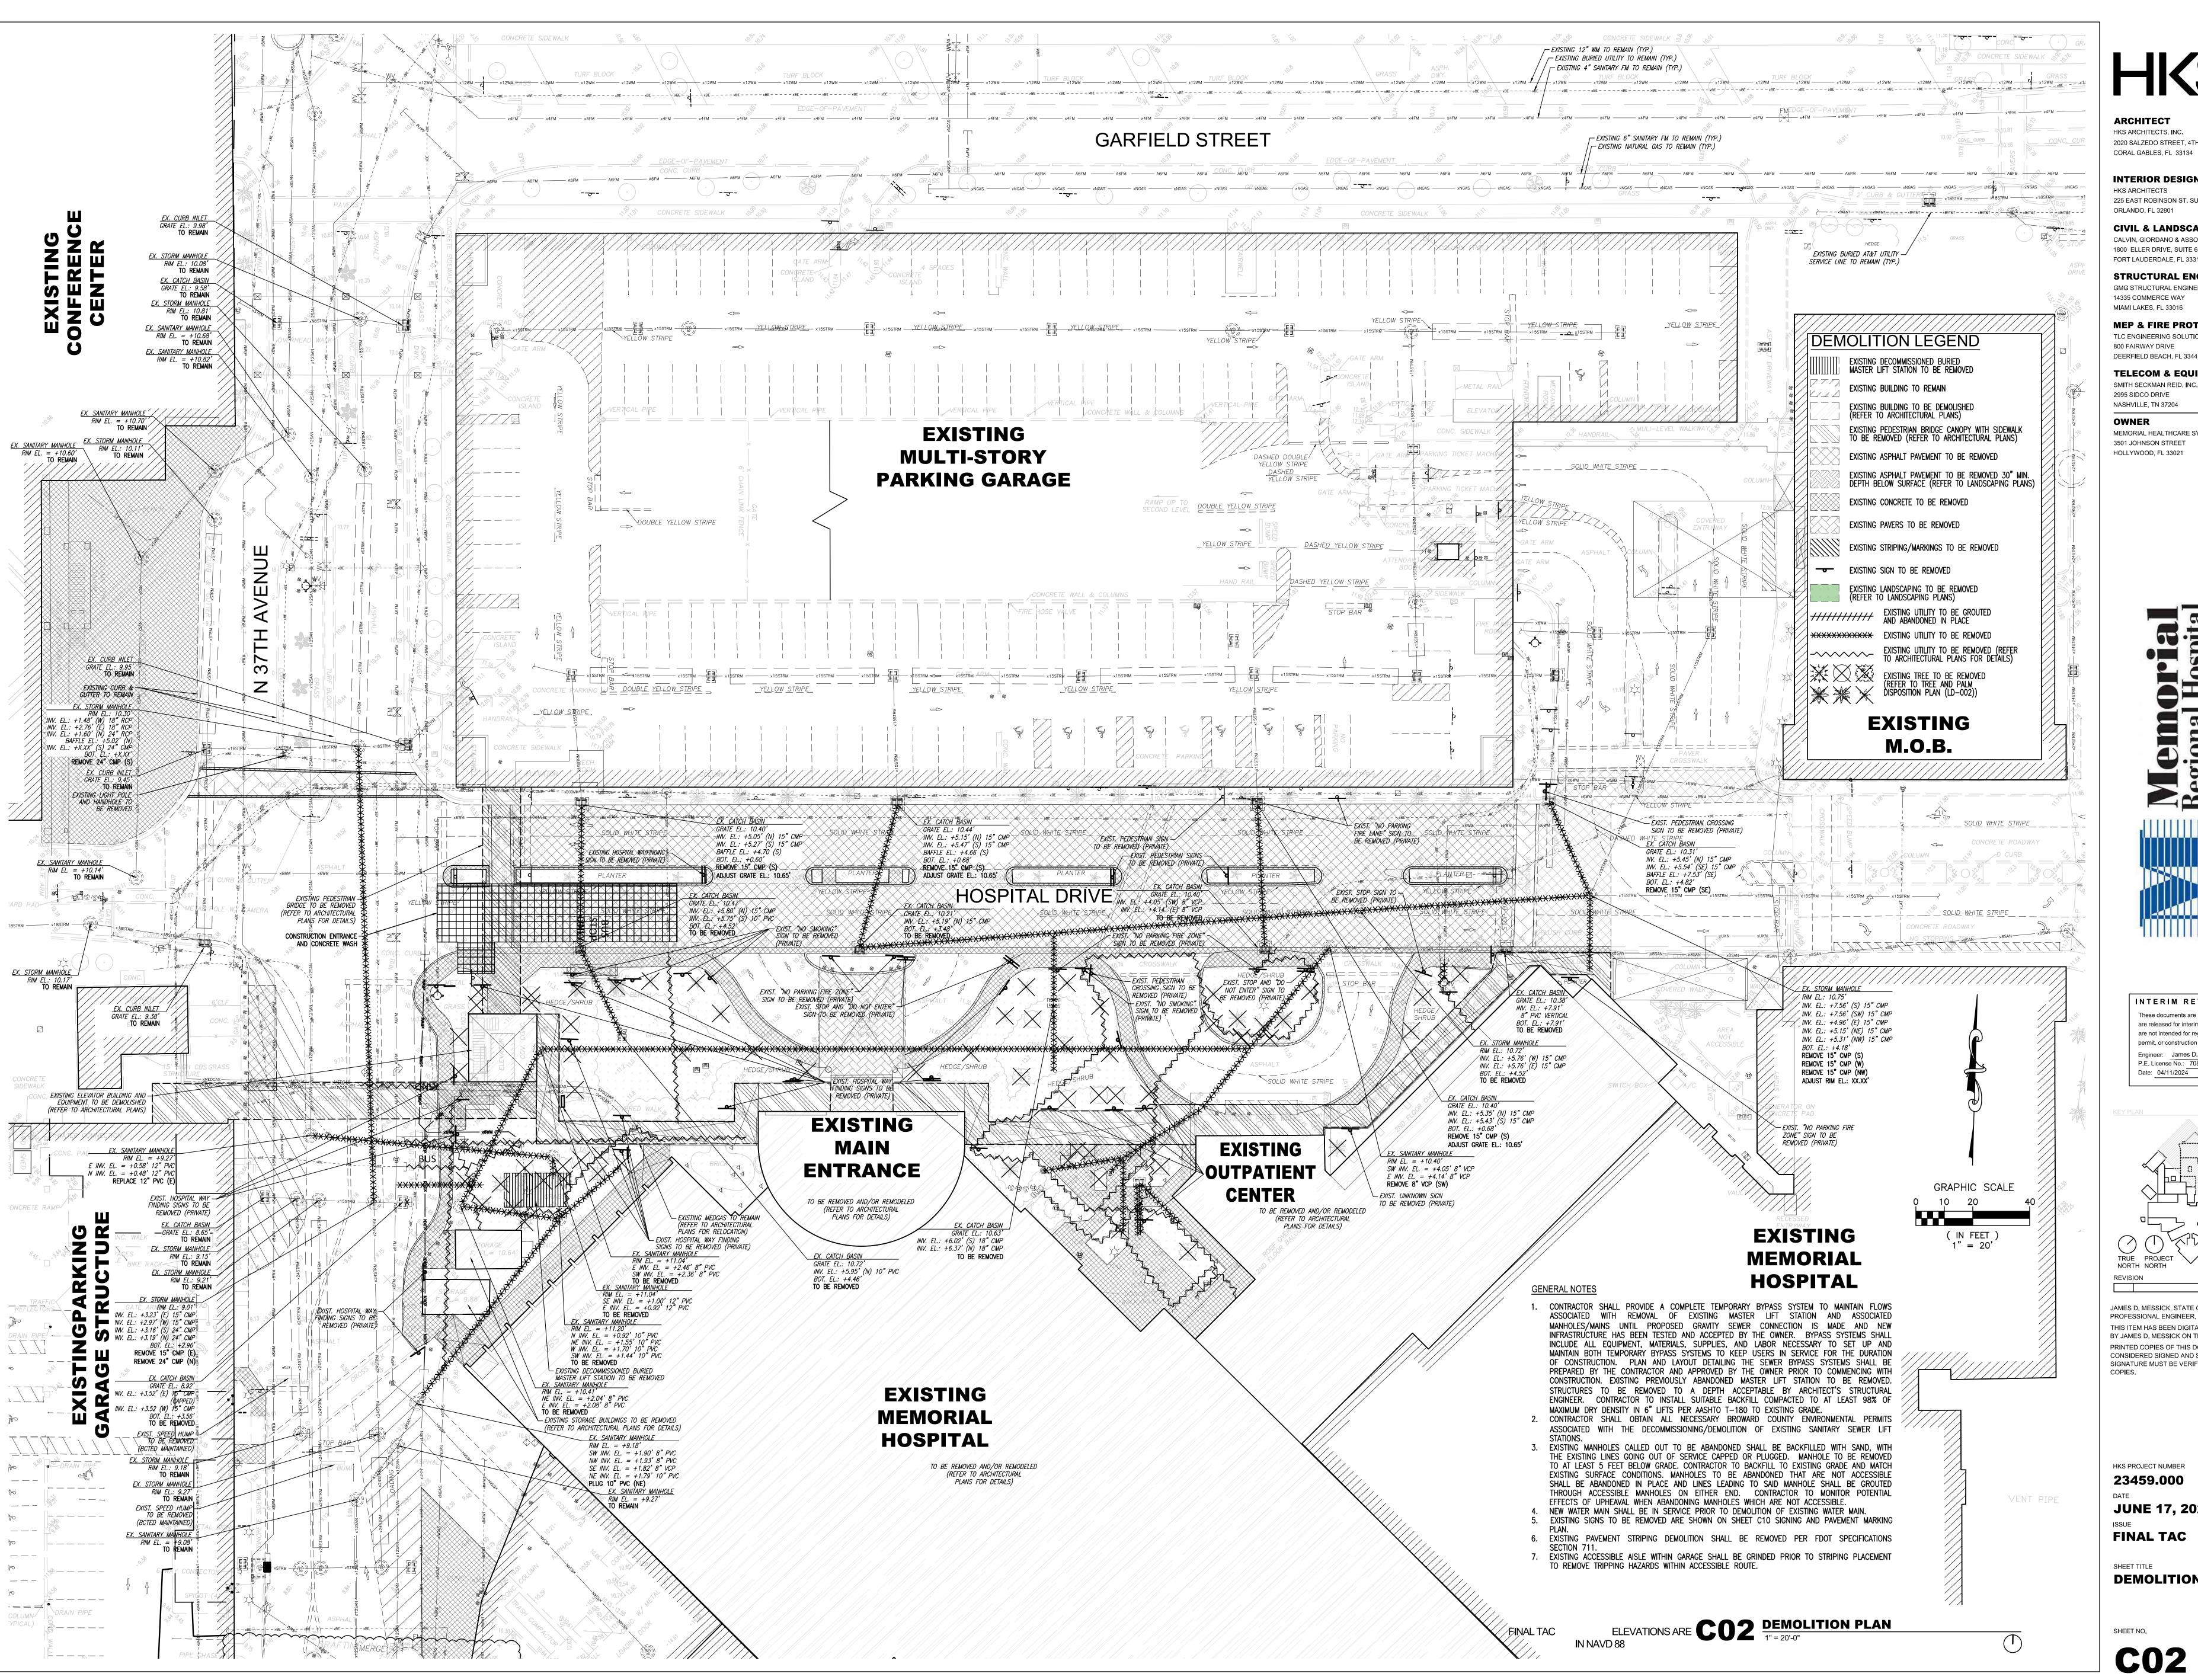

ARCHITECT HKS ARCHITECTS, INC. 2020 SALZEDO STREET, 4TH FLOOR

INTERIOR DESIGNER

HKS ARCHITECTS 225 EAST ROBINSON ST. SUITE #405 ORLANDO, FL 32801

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MIAMI LAKES, FL 33016

MEP & FIRE PROTECTION TLC ENGINEERING SOLUTIONS, INC. 800 FAIRWAY DRIVE


DEERFIELD BEACH, FL 33441 **TELECOM & EQUIPMENT** SMITH SECKMAN REID, INC.

2995 SIDCO DRIVE NASHVILLE, TN 37204

OWNER MEMORIAL HEALTHCARE SYSTEM

3501 JOHNSON STREET HOLLYWOOD, FL 33021

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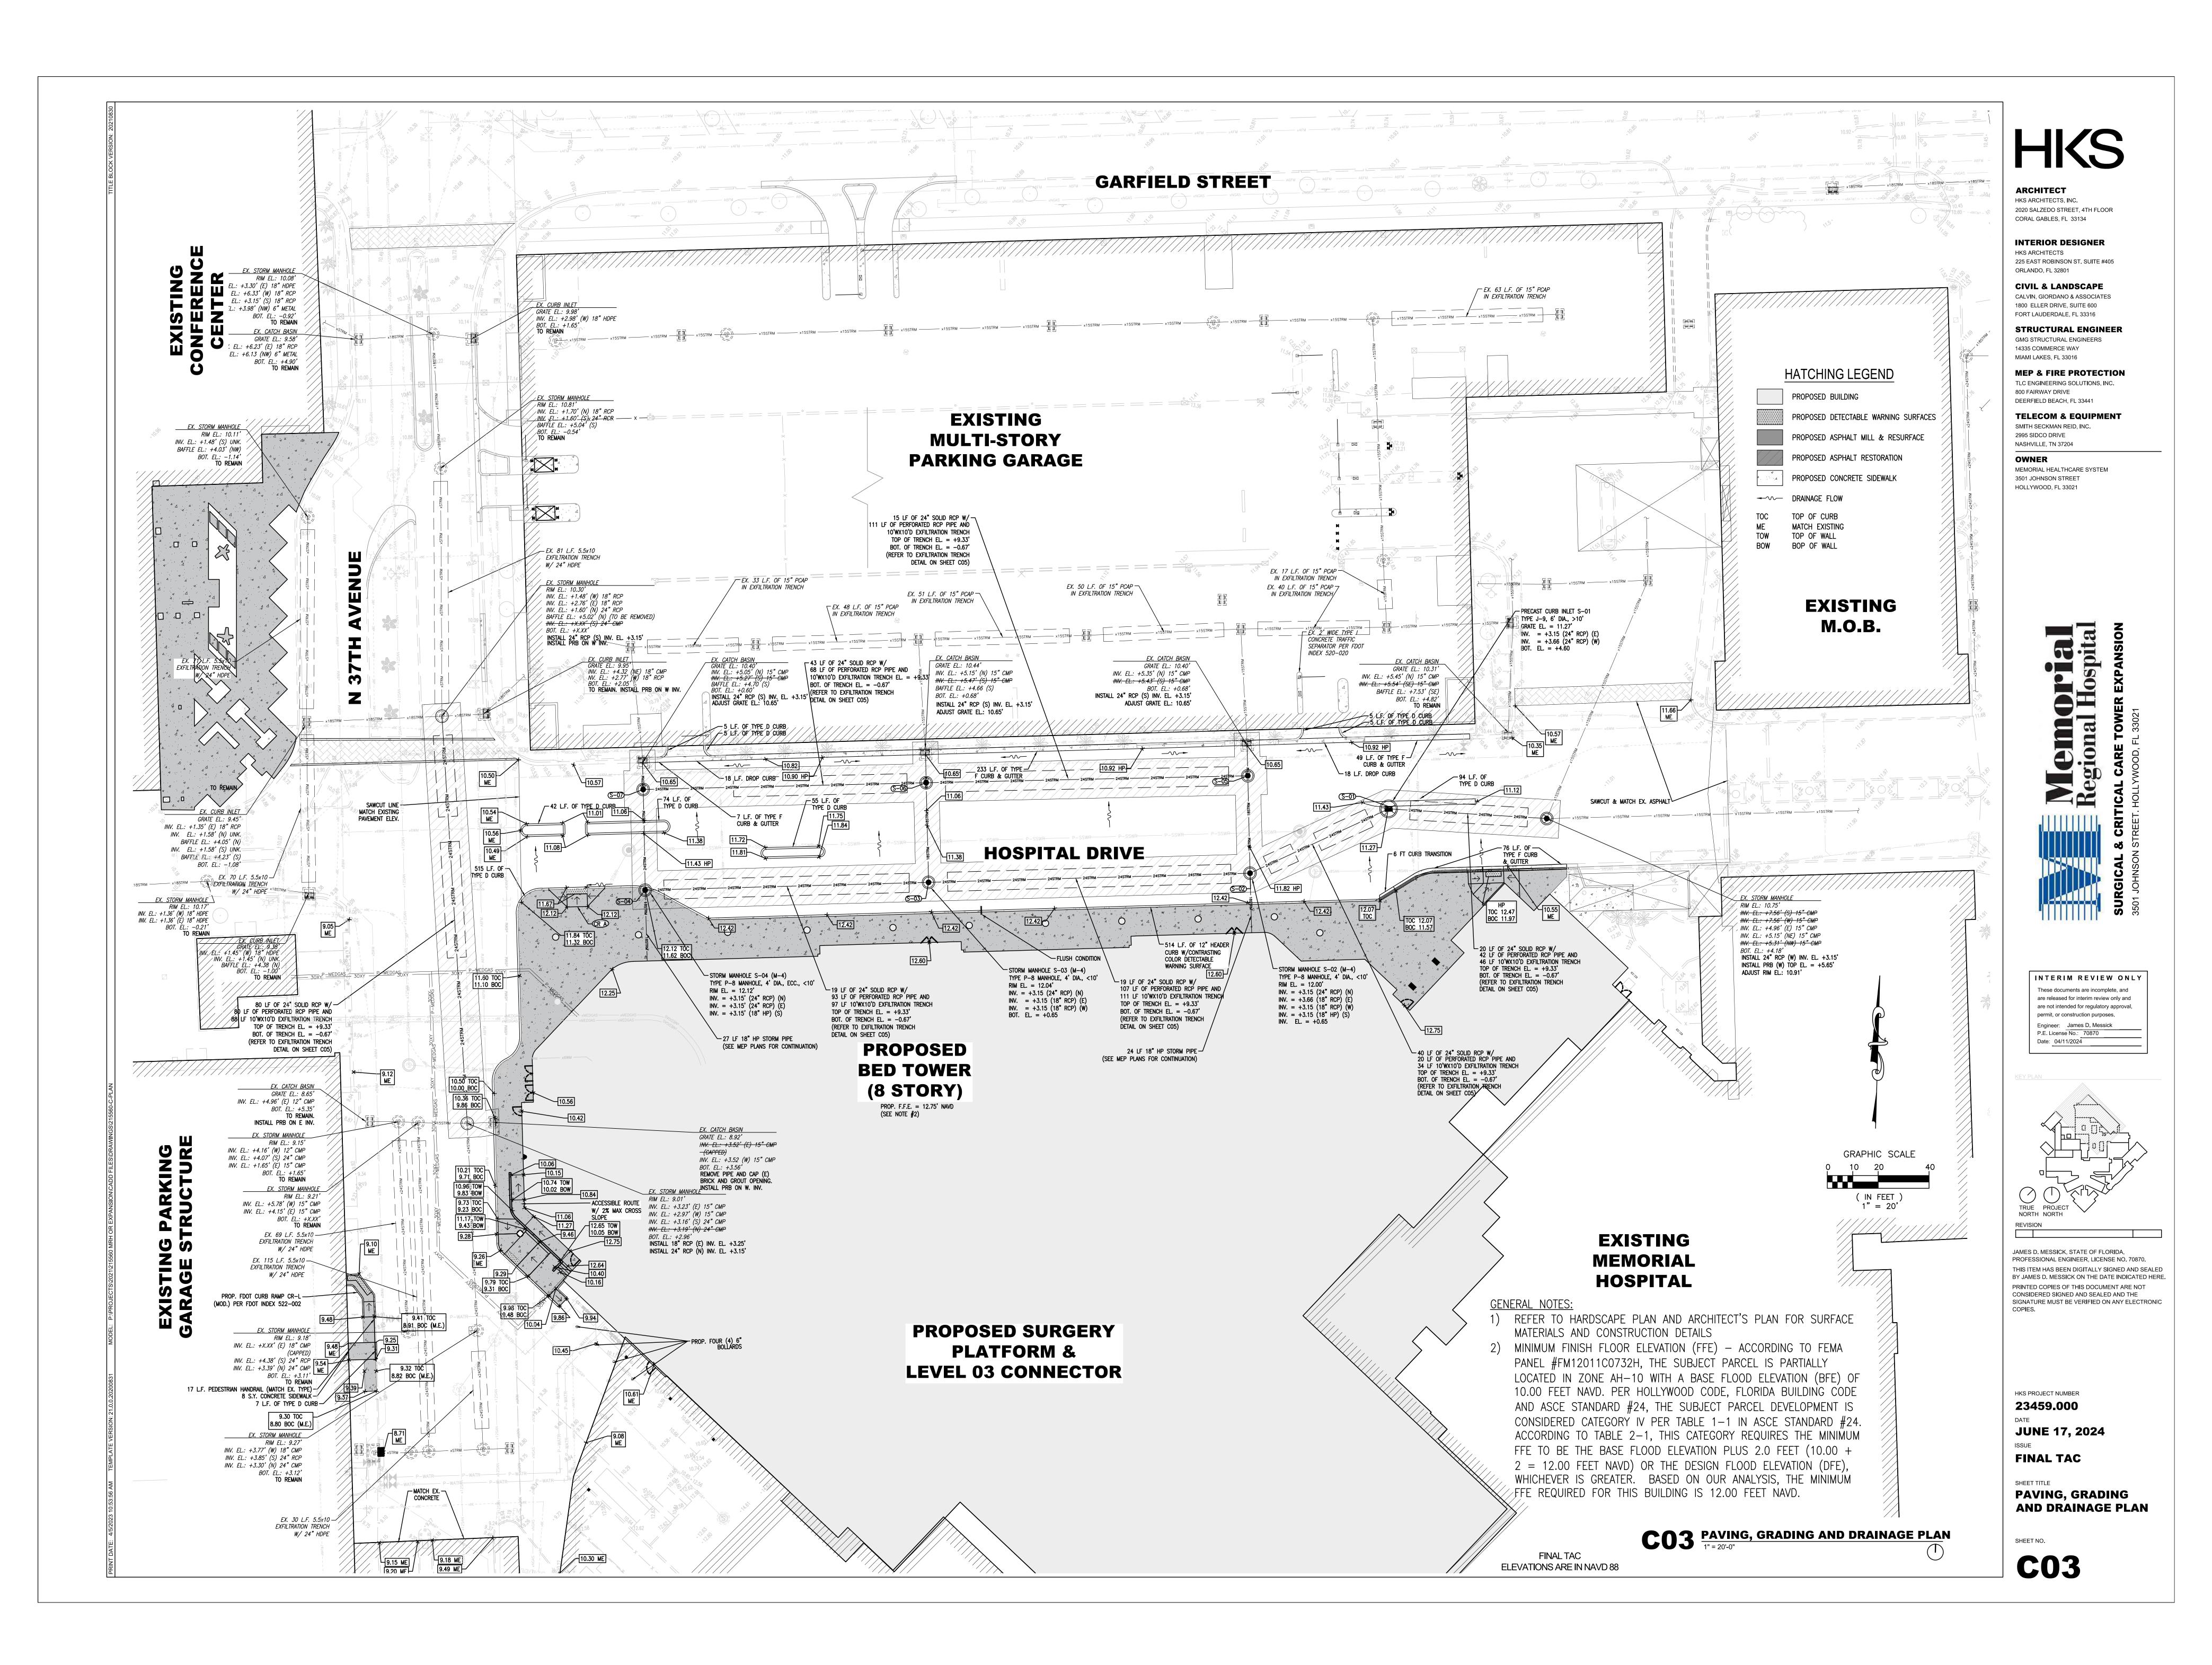
JAMES D. MESSICK, STATE OF FLORIDA, BY JAMES D. MESSICK ON THE DATE INDICATED HERE CONSIDERED SIGNED AND SEALED AND THE SIGNATURE MUST BE VERIFIED ON ANY ELECTRONIC

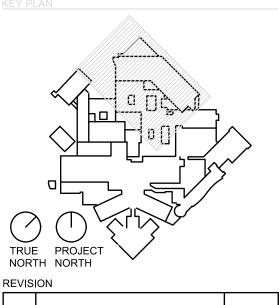HKS PROJECT NUMBER 23459.000

JUNE 17, 2024

DEMOLITION PLAN

SHEET NO.



GENERAL NOTES:

- 1. THE INFORMATION PROVIDED IN THESE DRAWINGS IS SOLELY TO ASSIST THE CONTRACTOR IN ASSESSING THE NATURE AND EXTENT OF CONDITIONS WHICH WILL BE ENCOUNTERED DURING THE COURSE OF THE WORK, THE CONTRACTORS ARE DIRECTED. PRIOR TO BIDDING. TO CONDUCT WHATEVER INVESTIGATIONS THEY DEEM NECESSARY TO ARRIVE AT THEIR OWN CONCLUSION REGARDING THE ACTUAL CONDITIONS THAT WILL BE ENCOUNTERED, AND UPON WHICH BIDS WILL BE BASED.
- ALL CONSTRUCTION AND MATERIALS SHALL CONFORM TO APPLICABLE STANDARDS AND SPECIFICATIONS OF THE CITY OF HOLLYWOOD DEPARTMENT OF PUBLIC UTILITIES, ENGINEERING AND CONSTRUCTION SERVICES DIVISION (ECSD), AND ALL OTHER LOCAL, STATE AND NATIONAL CODES, WHERE APPLICABLE.
- 3. LOCATIONS, ELEVATIONS, SIZES, MATERIALS, ALIGNMENTS, AND DIMENSIONS OF EXISTING FACILITIES, UTILITIES AND OTHER FEATURES ARE SHOWN ACCORDING TO THE BEST INFORMATION AVAILABLE AT THE TIME OF THE PREPARATION OF THESE PLANS; AND DO NOT PURPORT TO BE ABSOLUTELY CORRECT. ALSO, THERE MAY HAVE BEEN OTHER IMPROVEMENTS, UTILITIES, ETC., WITHIN THE PROJECT AREA WHICH WERE CONSTRUCTED AFTER THE PREPARATION OF THESE PLANS AND/OR THE ORIGINAL SITE SURVEY. THE CONTRACTOR SHALL VERIFY THE LOCATIONS, ELEVATIONS, AND OTHER FEATURES AFFECTING HIS/HER WORK PRIOR TO CONSTRUCTION, AND NOTIFY THE ENGINEER IMMEDIATELY WHEN CONFLICT BETWEEN DRAWINGS AND ACTUAL CONDITIONS ARE DISCOVERED. THE ENGINEER ASSUMES NO RESPONSIBILITY FOR ANY FACILITIES SHOWN OR NOT SHOWN ON THE PLANS. THE CONTRACTOR SHALL WORK AS NEEDED TO AVOID CONFLICT WITH EXISTING UTILITIES (NO ADDITIONAL COST SHALL BE PAID FOR THIS WORK). EXISTING UTILITIES SHALL BE MAINTAINED IN SERVICE DURING CONSTRUCTION UNLESS OTHERWISE APPROVED BY THE RESPECTIVE UTILITY OWNER.
- 4. THE CONTRACTOR SHALL COORDINATE WITH ALL UTILITIES TO ARRANGE FOR THE RELOCATION AND TEMPORARY SUPPORT OF UTILITY FEATURES, ETC. AS NECESSARY TO COMPLETE THE WORK.
- 5. IT SHALL BE THE CONTRACTOR'S RESPONSIBILITY TO LOCATE AND PROTECT ANY AND ALL EXISTING UTILITIES ON THIS PROJECT, AND TO ENSURE THAT EXISTING UTILITIES ARE MAINTAINED IN SERVICE

DURING CONSTRUCTION UNLESS APPROVED OTHERWISE BY THE UTILITY OWNER.

- 6. CONTRACTOR SHALL ADJUST ALL EXISTING UTILITY CASTINGS INCLUDING VALVE BOXES, MANHOLES, HAND-HOLES, PULL-BOXES, STORMWATER INLETS, AND SIMILAR STRUCTURES IN CONSTRUCTION AREA TO BE OVERLAID WITH ASPHALT PAVEMENT.
- 7. THE CONTRACTOR IS REQUIRED TO OBTAIN ALL APPLICABLE CONSTRUCTION AND ENVIRONMENTAL PERMITS PRIOR TO THE START OF CONSTRUCTION.
- 8. THE CONTRACTOR SHALL NOTIFY ECSD AT LEAST 48 HOURS PRIOR TO BEGINNING CONSTRUCTION.
- 9. PRIOR TO THE COMMENCEMENT OF CONSTRUCTION AND INSTALLATION OF THE PROPOSED IMPROVEMENTS, SHOP DRAWINGS SHALL BE SUBMITTED TO ECSD IN ACCORDANCE WITH THE CONTRACT DOCUMENT'S REQUIREMENTS, FOR APPROVAL. IN ADDITION, IT IS THE CONTRACTOR'S RESPONSIBILITY TO OBTAIN ANY OTHER AGENCY SHOP DRAWING APPROVAL, IF REQUIRED.
- 10. THE CONTRACTOR SHALL NOTIFY ECSD IMMEDIATELY FOR ANY CONFLICT ARISING DURING CONSTRUCTION OF ANY IMPROVEMENTS SHOWN ON THESE DRAWINGS. THIS WORK BY THE CONTRACTOR SHALL BE CONSIDERED INCIDENTAL TO THE CONTRACT AND NO ADDITIONAL COMPENSATION SHALL BE ALLOWED.
- 11. ELEVATIONS SHOWN ARE IN FEET AND ARE REFERENCED TO THE NORTH AMERICAN VERTICAL DATUM OF 1988 (NAVD 88).

No. of Concession, Name of Street, or other Persons, or other Pers	ISSUED:	03/01/1994	DEPARTMENT OF PUBLIC UTILITIES STANDARD DETAIL	REVISED: 06/08/	/20
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GENERAL NOTES (CONTINUED):

INCLUDE COST IN OTHER ITEMS.

NOTED ON THE DRAWINGS.

- 12. CITY OF HOLLYWOOD SHALL NOT PROVIDE STAGING / STORAGE AREA. CONTRACTOR SHALL SECURE STAGING / STORAGE AREA AS NECESSARY FOR CONSTRUCTION WORK.
- 13. CONTRACTOR SHALL HAUL AWAY EXCESSIVE STOCKPILE OF SOIL FOR DISPOSAL EVERY DAY. NO STOCKPILE SOIL IS ALLOWED TO BE LEFT ON THE CONSTRUCTION SITE OVER NIGHT.
- 14. CONTRACTOR SHALL CLEAN / SWEEP THE ROAD AT LEAST ONCE DAY OR AS REQUIRED BY THE ENGINEER.
- 15. CONTRACTOR SHALL PROTECT CATCH BASINS WITHIN / ADJACENT TO THE CONSTRUCTION SITE AS REQUIRED BY NPDES REGULATIONS.
- 16. THE CITY OF HOLLYWOOD HAS A NOISE ORDINANCE (CHAPTER 100) WHICH PROHIBITS EXCAVATION AND CONSTRUCTION BEFORE 8:00 A.M. AND AFTER 6:00 P.M., MONDAY THROUGH SATURDAY AND ALL DAY
- 17. SUITABLE EXCAVATED MATERIAL SHALL BE USED IN FILL AREAS. NO SEPARATE PAY ITEM FOR THIS WORK,
- 18. ALL ROAD CROSSINGS ARE OPEN CUT AS PER THE REQUIREMENTS OF THE ECSD UNLESS OTHERWISE
- 19. THE CONTRACTOR SHALL REPLACE ALL PAVING, STABILIZING EARTH, DRIVEWAYS, PARKING LOTS, SIDEWALKS, ETC. TO SATISFY THE INSTALLATION OF THE PROPOSED IMPROVEMENTS WITH THE SAME TYPE OF MATERIAL THAT WAS REMOVED DURING CONSTRUCTION OR AS DIRECTED BY ECSD FIELD ENGINEER.
- 20. THE CONTRACTOR SHALL NOT ENCROACH INTO PRIVATE PROPERTY WITH PERSONNEL, MATERIAL OR EQUIPMENT. IN CASE WORK ON PRIVATE PROPERTY IS NEEDED, A CITY OF HOLLYWOOD "RIGHT OF ENTRY" FORM MUST BE SIGNED BY PROPERTY OWNER AND THE DIRECTOR OF PUBLIC UTILITIES. THE

CONTRACTOR IS RESPONSIBLE TO MAINTAIN ACCESS AT ALL TIMES TO PRIVATE HOMES/BUSINESSES.

- 21. THE CONTRACTOR SHALL BE RESPONSIBLE FOR DAMAGE, REMOVAL OR MODIFICATION, CAUSED TO ANY IRRIGATION SYSTEM (PRIVATE OR PUBLIC) ACCIDENTALLY OR PURPOSELY. THE CONTRACTOR SHALL REPLACE ANY DAMAGED, REMOVED OR MODIFIED IRRIGATION PIPES, SPRINKLER HEADS OR OTHER PERTINENT APPURTENANCES TO MATCH OR EXCEED EXISTING CONDITIONS AT NO ADDITIONAL COST TO
- 22. MAIL BOXES, FENCES OR OTHER PRIVATE PROPERTY DAMAGED DURING THE CONSTRUCTION OF THE PROPOSED IMPROVEMENTS SHALL BE REPLACED TO MATCH OR EXCEED EXISTING CONDITION.
- 23. CONTRACTOR SHALL PROVIDE MAINTENANCE OF TRAFFIC IN ACCORDANCE WITH FDOT STANDARDS AND CITY OF HOLLYWOOD DEPARTMENT OF PUBLIC UTILITIES STANDARDS.
- 24. NO TREES ARE TO BE REMOVED OR RELOCATED WITHOUT PRIOR APPROVAL FROM THE ECSD FIELD
- 25. THE CONTRACTOR IS RESPONSIBLE FOR OBTAINING THE NECESSARY TREE REMOVAL OR RELOCATION PERMITS FROM THE CITY OF HOLLYWOOD BUILDING DEPARTMENT FOR TREES LOCATED IN THE PUBLIC
- 26. IT IS THE INTENT OF THESE PLANS TO BE IN ACCORDANCE WITH APPLICABLE CODES AND AUTHORITIES HAVING JURISDICTION. ANY DISCREPANCIES BETWEEN THESE PLANS AND APPLICABLE REGULATORY

STANDARDS / REQUIREMENTS SHALL BE IMMEDIATELY BROUGHT TO THE ATTENTION OF ECSD.

	5/20
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GENERAL NOTES (CONTINUED):

- 27. THE CONTRACTOR SHALL BE RESPONSIBLE FOR MAINTAINING THE INTEGRITY OF AND MAKING THE REPAIRS TO EXISTING PAVEMENT, SIDEWALKS, PIPES, CONDUITS, CURBS, CABLES, ETC., WHETHER OR NOT SHOWN ON THE PLANS DAMAGED AS A RESULT OF THE CONTRACTORS OPERATIONS AND/OR THOSE OF HIS SUBCONTRACTORS, AND SHALL RESTORE THEM PROMPTLY AT NO ADDITIONAL EXPENSE TO THE OWNER. CONTRACTOR SHALL REPORT ANY DAMAGE TO SIDEWALK, DRIVEWAY, ETC., PRIOR TO BEGINNING WORK IN ANY AREA.
- 28. WHERE NEW PAVEMENT MEETS EXISTING, CONNECTION SHALL BE MADE IN A NEAT STRAIGHT LINE AND FLUSH WITH EXISTING PAVEMENT TO MATCH EXISTING CONDITIONS.
- 29. UNDER NO CIRCUMSTANCES SHALL THE CONTRACTOR LEAVE EXCAVATED TRENCHES, OR PARTS OF, EXPOSED OR OPENED AT THE END OF THE WORKING DAY, WEEKENDS, HOLIDAYS OR OTHER TIMES, WHEN THE CONTRACTOR IS NOT WORKING, UNLESS OTHERWISE DIRECTED. ALL TRENCHES SHALL BE COVERED, FIRMLY SECURED AND MARKED ACCORDINGLY FOR PEDESTRIAN / VEHICULAR TRAFFIC.
- 30. ALL EXCAVATED MATERIAL REMOVED FROM THIS PROJECT SHALL BE DISPOSED OF OFF THE PROPERTY BY THE CONTRACTOR AT THE CONTRACTOR'S EXPENSE.
- 31. ALL DUCTILE IRON PRODUCTS SHALL BE DOMESTIC MADE HEAVY DUTY CLASSIFICATION SUITABLE FOR HIGHWAY TRAFFIC LOADS, OR 20,000 LB.
- 32. ALL GRASSED AREAS AFFECTED BY CONSTRUCTION SHALL BE RE-SODDED.
- 33. THE CONTRACTOR SHALL BE RESPONSIBLE FOR THE PROVISION, INSTALLATION AND MAINTENANCE OF ALL TRAFFIC CONTROL AND SAFETY DEVICES, IN ACCORDANCE WITH SPECIFICATIONS OF THE LATEST REVISION OF FDOT DESIGN STANDARDS. IN ADDITION, THE CONTRACTOR IS RESPONSIBLE FOR THE RESETTING OF ALL TRAFFIC CONTROL AND INFORMATION SIGNAGE REMOVED DURING THE CONSTRUCTION PERIOD.
- 34. EXCAVATED OR OTHER MATERIAL STORED ADJACENT TO OR PARTIALLY UPON A ROADWAY PAVEMENT SHALL BE ADEQUATELY MARKED FOR TRAFFIC SAFETY AT ALL TIMES.
- 35. TEMPORARY PATCH MATERIAL MUST BE ON THE JOB SITE WHENEVER PAVEMENT IS CUT, OR THE CITY'S INSPECTOR WILL SHUT THE JOB DOWN.
- 36. CONTRACTOR MUST PROVIDE FLASHER ARROW SIGNAL FOR ANY LANE THAT IS CLOSED OR DIVERTED.
- 37. CONTRACTOR SHALL NOTIFY LAW ENFORCEMENT AND FIRE PROTECTION SERVICES TWENTY-FOUR (24) HOURS IN ADVANCE OF TRAFFIC DETOUR IN ACCORDANCE WITH SECTION 336.07 OF FLORIDA STATUTES.
- 38. CONTRACTOR TO RESTORE PAVEMENT TO ORIGINAL CONDITION AS REQUIRED.
- 39. CONTRACTOR SHALL BE RESPONSIBLE FOR PROVIDING DEWATERING PER SPECIFICATION SECTION 02140 DEWATERING.

	ISSUED:	03/01/1994	DEPARTMENT OF PUBLIC UTILITIES STANDARD DETAIL	REVISED: 11/06/2017	
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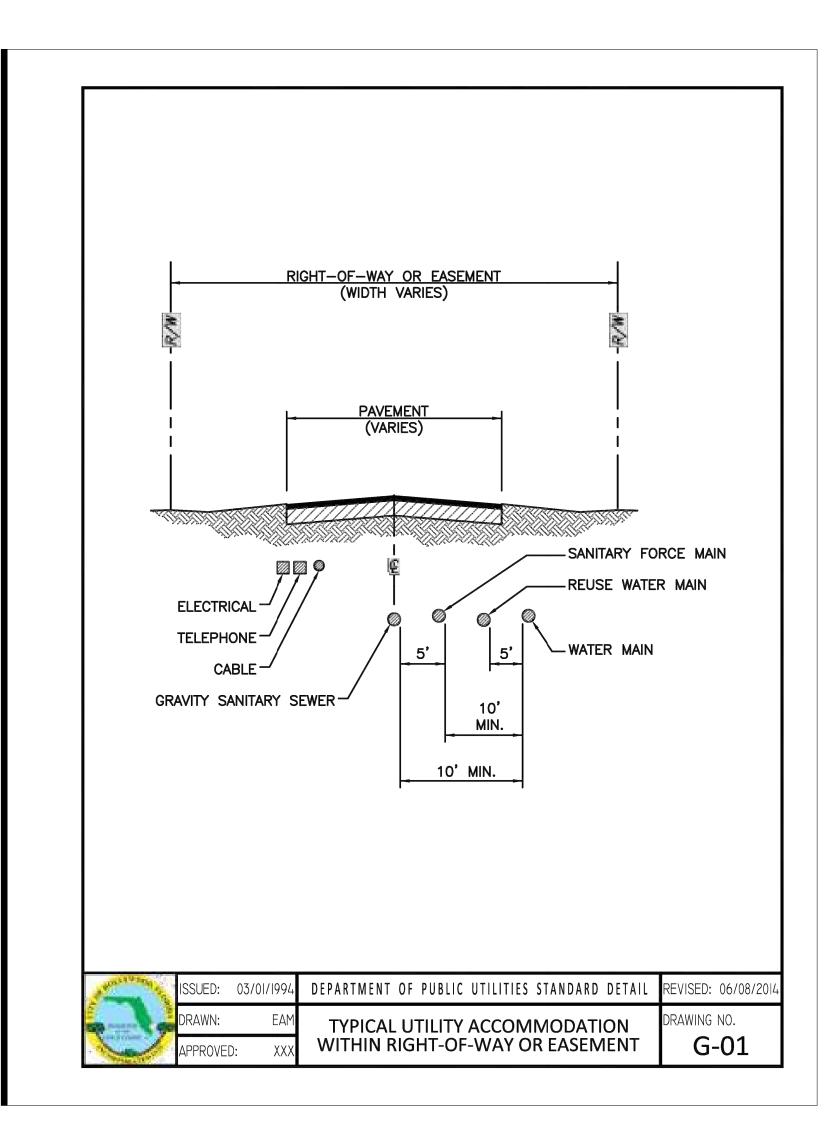
GENERAL NOTES (CONTINUED):


40. THE CONTRACTOR SHALL GIVE AT LEAST 48 HOURS NOTICE TO UTILITY COMPANIES TO PROVIDE FOR THE LOCATION OF EXISTING UNDERGROUND UTILITIES IN ADVANCE OF CONSTRUCTION. CONTACT UTILITIES NOTIFICATION CENTER AT 811 OR 1-800-432-4770 (SUNSHINE ONE-CALL OF FLORIDA).





- 41. WHEN PVC PIPE IS USED, A METALLIZED MARKER TAPE SHALL BE INSTALLED CONTINUOUSLY 18" ABOVE THE PIPE. THE MARKER TAPE SHOULD BE IMPRINTED WITH A WARNING THAT THERE IS BURIED PIPE BELOW. THE TAPE SHALL BE MAGNA TEC, AS MANUFACTURED BY THOR ENTERPRISES INC. OR APPROVED EQUAL.
- 42. ALL CONNECTIONS TO EXISTING MAINS SHALL BE THE RESPONSIBILITY OF THE CONTRACTOR. WATER CONNECTIONS SHALL BE METERED, AND THE COST OF WATER AND TEMPORARY METER SHALL BE BORNE BY THE CONTRACTOR.
- 43. A COMPLETE AS-BUILT SURVEY SHALL BE ACCURATELY RECORDED OF THE UTILITY SYSTEM DURING CONSTRUCTION. AS-BUILT SURVEY SHALL BE SUBMITTED TO ECSD SIGNED AND SEALED BY A FLORIDA REGISTERED SURVEYOR PRIOR TO FINAL INSPECTION AND ACCEPTANCE OF PROJECT. THE COST OF SIGNED AND SEALED AS-BUILTS SHALL BE COVERED IN OVERALL BID. THE AS-BUILT SURVEY SHALL
- a. PLAN VIEW SHOWING THE HORIZONTAL LOCATIONS OF EACH MANHOLE, INLET, VALVE, FITTING, BEND AND HORIZONTAL PIPE DEFLECTIONS WITH COORDINATES AND IN REFERENCE TO A SURVEY BASELINE OR RIGHT-OF-WAY CENTERLINE.
- b. THE PLAN VIEW SHALL ALSO SHOW SPOT ELEVATIONS OF THE TOP OF THE MAIN (WATER MAIN AND FORCE MAIN) OR PIPE INVERTS (GRAVITY MAINS) AT INTERVALS NOT TO EXCEED 100 FEET AS MEASURED ALONG MAIN. THE PLAN VIEW SHALL ALSO INCLUDE SPOT ELEVATIONS AT EACH MANHOLE, INLET, VALVE, FITTING, BEND AND VERTICAL PIPE
- c. THE PLAN VIEW SHALL ALSO SHOW THE HORIZONTAL SEPARATION FROM UNDERGROUND UTILITIES IMMEDIATELY ADJACENT OR PARALLEL TO THE NEW MAIN.
- d. Profile view with spot elevations of the top of the main (water main and force MAIN) OR PIPE INVERT (GRAVITY MAIN) AND OF THE FINISHED GRADE OR MANHOLE RIM DIRECTLY ABOVE THE MAIN AT INTERVALS NOT TO EXCEED 100 FEET AS MEASURED ALONG THE MAIN. THE PROFILE VIEW SHALL ALSO INCLUDE SPOT ELEVATIONS AT EACH MANHOLE, INLET, VALVE, FITTING, BEND AND VERTICAL PIPE DEFLECTION.
- e. THE PROFILE VIEW SHALL SHOW ALL UNDERGROUND UTILITIES CROSSING THE NEW MAIN AND THE VERTICAL SEPARATION PROVIDED BETWEEN THAT UNDERGROUND UTILITY AND THE
- f. ALL CADD FILES MUST BE CREATED FOLLOWING THE CITY OF HOLLYWOOD "SURVEY / AS-BUILT CAD DRAWING STANDARDS"

No. of London	ISSUED:	03/01/1994	DEPARTMENT OF PUBLIC UTILITIES STANDARD DETAIL	REVISED: II/06/201
Serent.	DRAWN:	EAM	GENERAL NOTES	DRAWING NO.
	APPROVE	O: XXX	(CONTINUED)	G-00.3



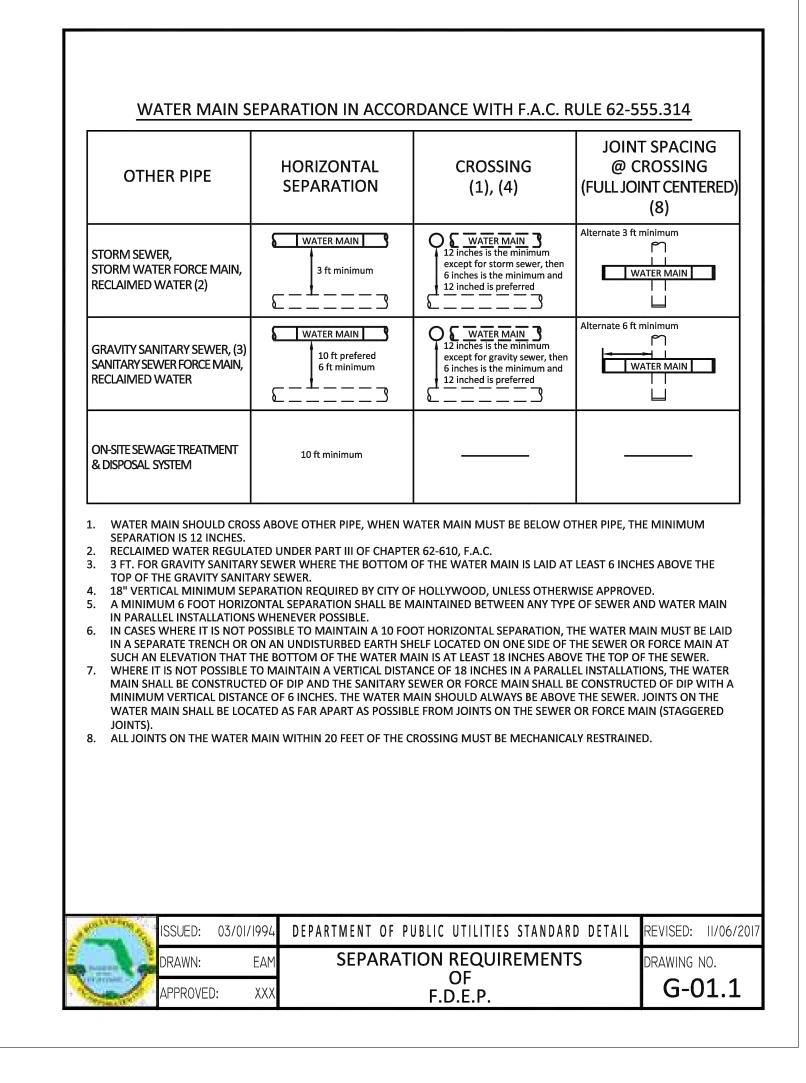

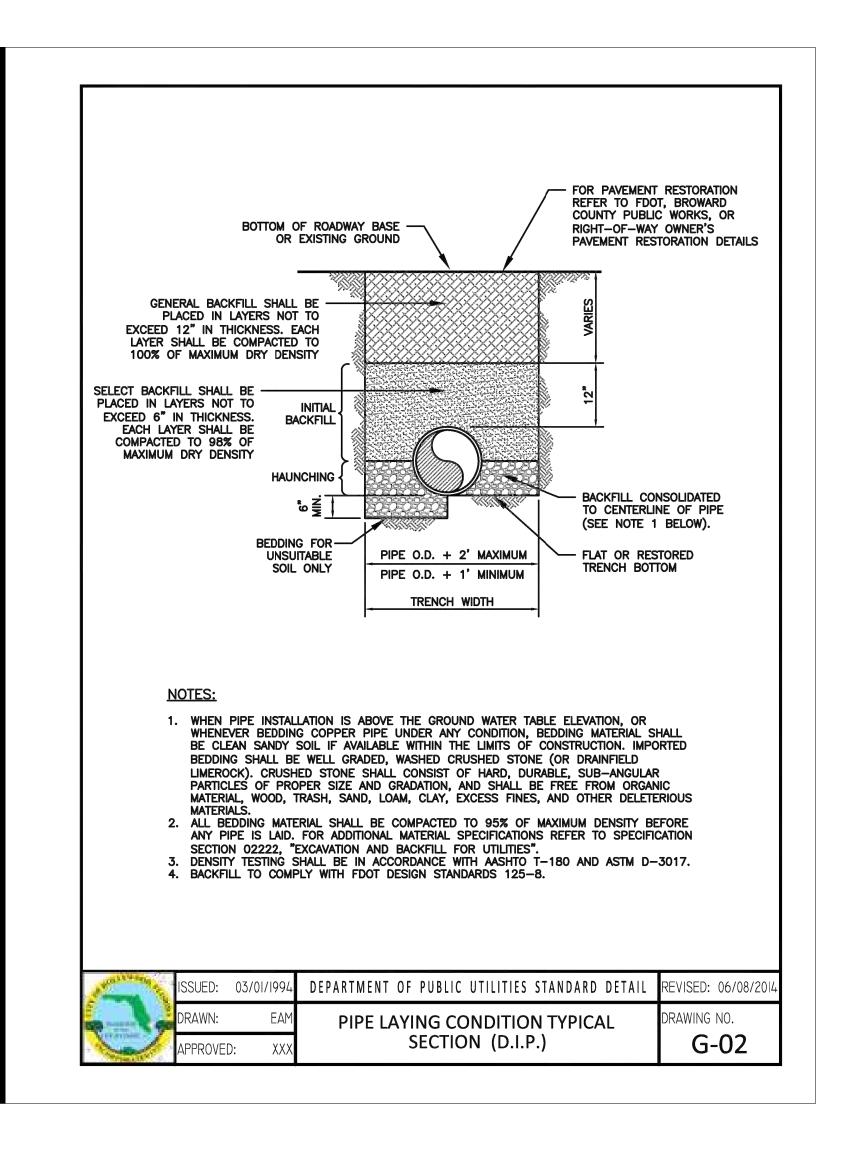

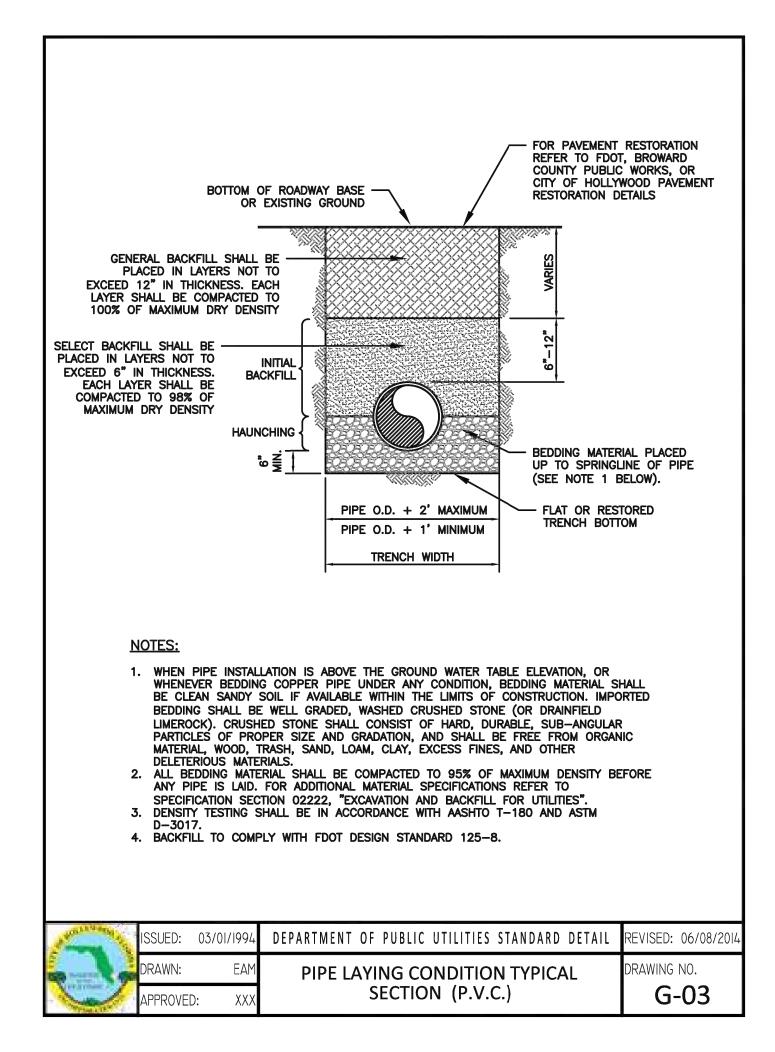

FINAL TAC

ELEVATIONS ARE

CO4 PAVING, GRADING AND DRAINAGE DETAILS

NOT TO SCALE

SHEET NO.

C04

TRUE PROJECT NORTH NORTH JAMES D. MESSICK, STATE OF FLORIDA. PROFESSIONAL ENGINEER, LICENSE NO. 70870. THIS ITEM HAS BEEN DIGITALLY SIGNED AND SEALED BY JAMES D. MESSICK ON THE DATE INDICATED HERE. PRINTED COPIES OF THIS DOCUMENT ARE NOT CONSIDERED SIGNED AND SEALED AND THE SIGNATURE MUST BE VERIFIED ON ANY ELECTRONIC COPIES.

> HKS PROJECT NUMBER 23459.000

ARCHITECT HKS ARCHITECTS, INC.

HKS ARCHITECTS

ORLANDO, FL 32801

2020 SALZEDO STREET, 4TH FLOOR

INTERIOR DESIGNER

CIVIL & LANDSCAPE

1800 ELLER DRIVE, SUITE 600

GMG STRUCTURAL ENGINEERS

14335 COMMERCE WAY

MIAMI LAKES, FL 33016

800 FAIRWAY DRIVE

2995 SIDCO DRIVE

NASHVILLE, TN 37204

3501 JOHNSON STREET

HOLLYWOOD, FL 33021

DEERFIELD BEACH, FL 33441

SMITH SECKMAN REID, INC.

FORT LAUDERDALE, FL 33316

CALVIN, GIORDANO & ASSOCIATES

STRUCTURAL ENGINEER

MEP & FIRE PROTECTION

TLC ENGINEERING SOLUTIONS, INC.

TELECOM & EQUIPMENT

MEMORIAL HEALTHCARE SYSTEM

INTERIM REVIEW ONLY

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Engineer: James D. Messick

P.E. License No.: 70870

Date: 04/11/2024


225 EAST ROBINSON ST. SUITE #405

CORAL GABLES, FL 33134


JUNE 17, 2024 FINAL TAC

PAVING, GRADING AND

DRAINAGE DETAILS

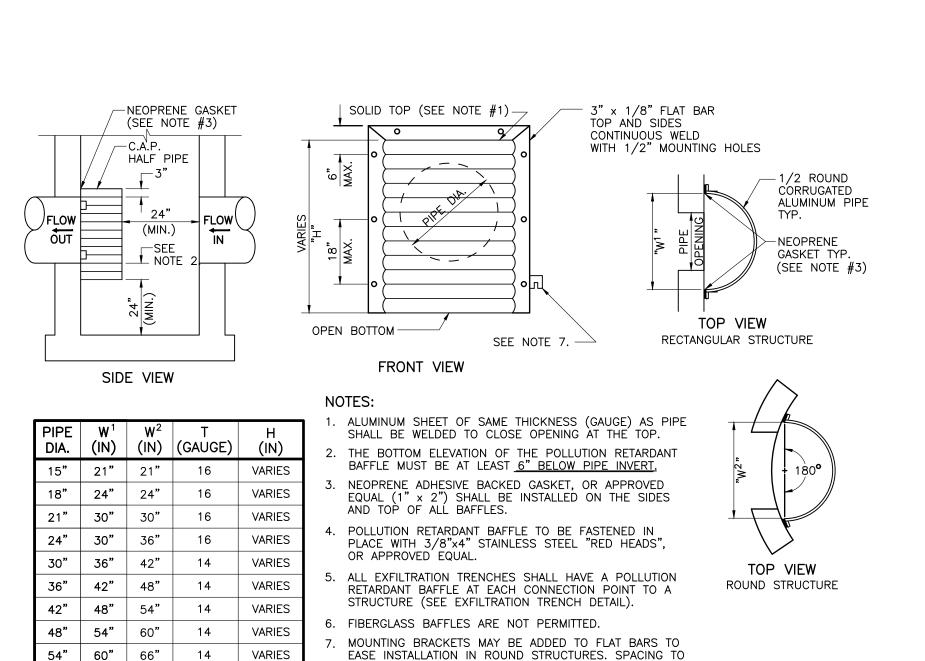

SCALE: N.T.S.

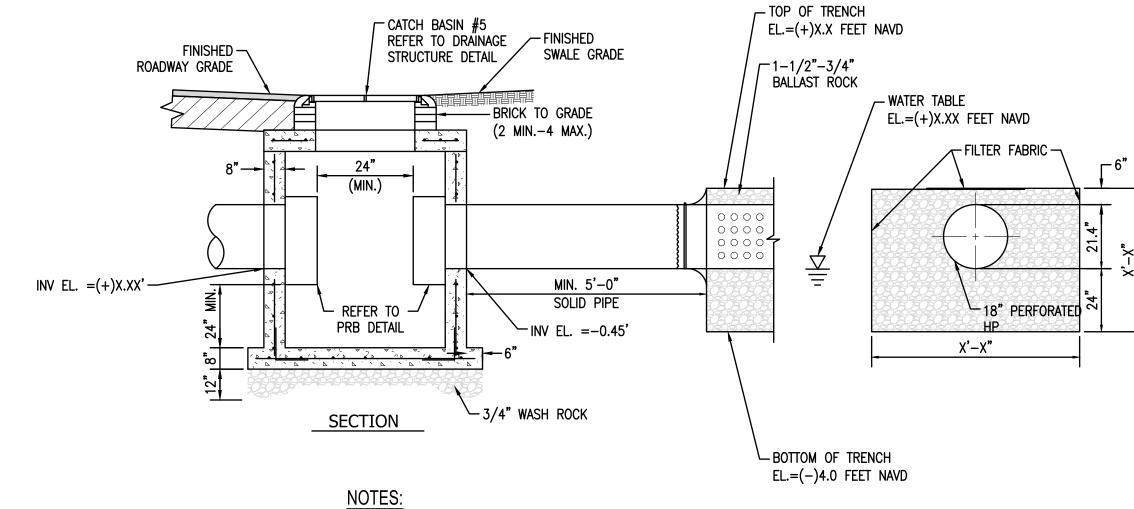

1. PIPES SHALL TERMINATE 2' FROM END OF TRENCH (CAP ENDS OF PIPE) OR CONNECT TO ADDITIONAL CATCH BASINS AS REQUIRED. . Sides and top of trench only to be lined with filter fabric. Overlap liner a minimum of 2' at the top of the trench.


CURRENT

BALLAST ROCK SHALL BE FROM FRESH WATER, WASHED AND FREE OF DELETERIOUS MATTER.


4. ALL EXFILTRATION TRENCHES SHALL HAVE A POLLUTION RETARDANT BAFFLE AT EACH CONNECTION POINT TO A STRUCTURE. (SEE POLLUTION RETARDANT BAFFLE (PRB) DETAIL)

5. GASKETS SHALL BE USED WITH RCP IN EXFILTRATION TRENCH. 6. EXFILTRATION TRENCH SHALL BE CONSTRUCTED IN COMPLIANCE WITH FDOT SPECIFICATIONS SECTION 443.


EXFILTRATION TRENCH SCALE: N.T.S.

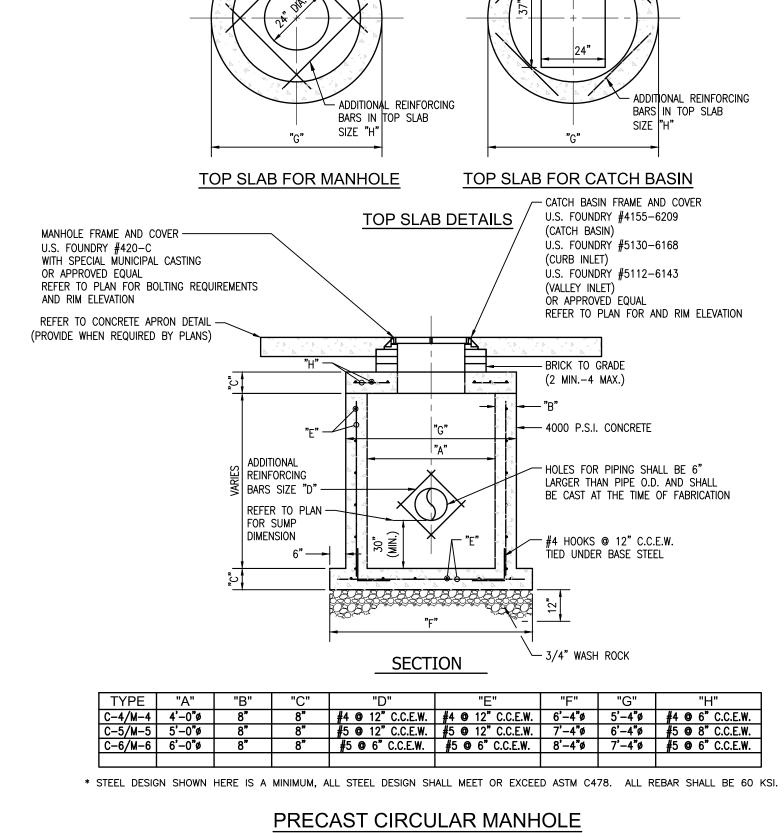

SCALE: N.T.S.

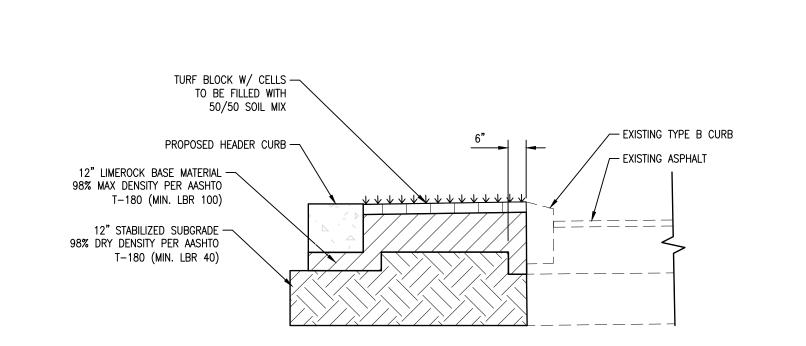

TYPICAL TURF BLOCK AND HEADER **CURB RESTORATION DETAIL** SCALE: N.T.S.

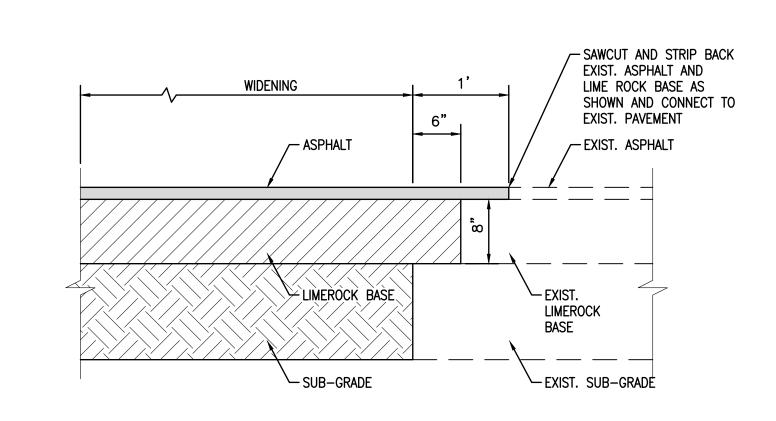

CONNECTION WITH EXISTING PAVEMENT

ELEVATIONS ARE

CO5 PAVING, GRADING AND DRAINAGE DETAILS

NOT TO SCALE

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HKS ARCHITECTS

ORLANDO, FL 32801

2020 SALZEDO STREET, 4TH FLOOR

INTERIOR DESIGNER

CIVIL & LANDSCAPE

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GMG STRUCTURAL ENGINEERS

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OWNER

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225 EAST ROBINSON ST. SUITE #405

CORAL GABLES, FL 33134

TRUE PROJECT NORTH NORTH


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HKS PROJECT NUMBER 23459.000 **JUNE 17, 2024**


FINAL TAC

PAVING, GRADING AND DRAINAGE DETAILS





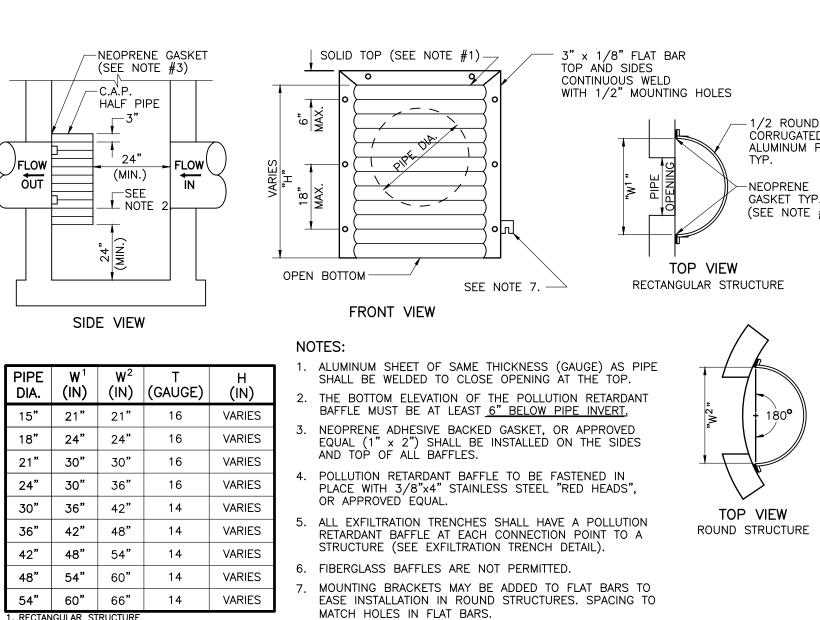

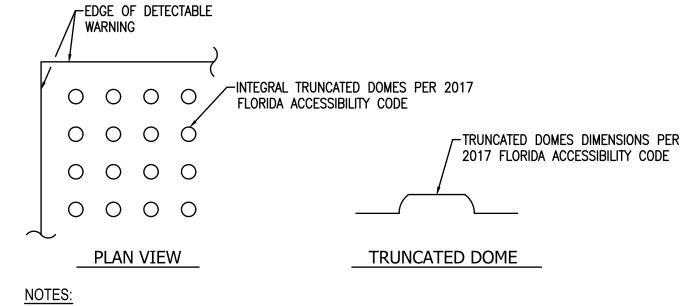


1. ALL FDOT CURB RAMPS SHALL HAVE DETECTABLE WARNING SURFACES PLACED IN ACCORDANCE WITH FDOT STANDARD PLANS INDEX 522

- 2. ROWS OF TRUNCATED DOMES IN A DETECTABLE WARNING SURFACE SHALL BE ALIGNED TO BE PERPENDICULAR OR RADIAL TO THE STREET, ROADWAY, OR DRIVEWAY IN ACCORDANCE WITH FDOT
- STANDARD PLANS INDEX 522. 3. SIDEWALKS ABUTTING ROADWAYS SHALL BE INSTALLED WITH A DETECTABLE WARNING SURFACE IN
- ACCORDANCE WITH FDOT STANDARD PLANS INDEX 522. 4. ALL DETECTABLE WARNINGS SHALL BE IN COMPLIANCE WITH FDOT SPECIFICATION SECTION 527. 5. ALL DETECTABLE WARNINGS SHALL BE PRE-FORMED CAST-IN-PLACE TYPE BY ACO OR EPOXY SYSTEM PRODUCTS APPROVED BY FDOT IN THE APPROVED PRODUCTS LIST (APL). STAMPED,
- DRAWINGS FOR APPROVAL. 6. COLOR SHALL BE SAFETY YELLOW PER FDOT SPECIFICATION SECTION 527.

DETECTABLE WARNING SURFACE SCALE: N.T.S.

MECHANICAL FASTENED, GLUED OR TORCH APPLIED WILL NOT BE ACCEPTED. SÚBMIT SHOP

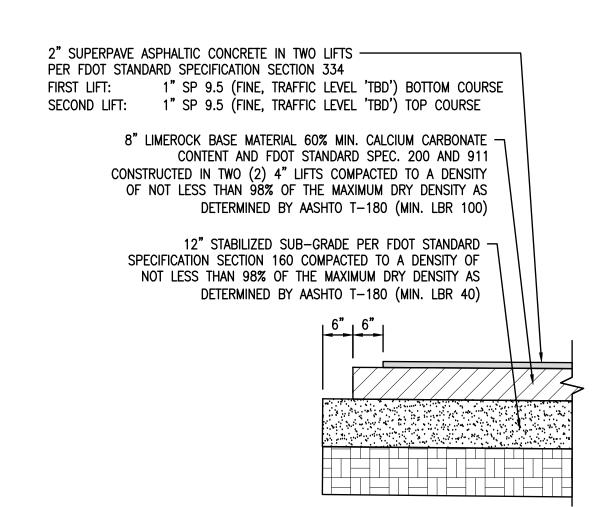

1. TACK AND PRIME COATS ARE REQUIRED AND SHALL BE IN ACCORDANCE WITH FDOT STANDARD SPECIFICATION SECTION 300.

2. ASPHALT INSTALLATION SHALL BE PERFORMED IN ACCORDANCE WITH FDOT STANDARD SPECIFICATION SECTION 334.

ASPHALT ROADWAYDETAIL

SCALE: N.T.S.

CURB AND CURB & GUTTER DETAILS SCALE: N.T.S.

1'-6"

THE ADJACENT PAVEMENT. THE EDGE OF PAVEMENT SHALL MATCH THE LIP OF CURB ELEVATION. THE MINIMUM THICKNESS OF THE LIP SHALL BE 6".


5. BACKFILL BEHIND CURBS TO 2" BELOW TOP OF CURB TO ALLOW FOR SOD OR AS SPECIFIED IN LANDSCAPE

— ROADWAY ASPHALT — SURFACE (SHOWN) OR ROADWAY -CONCRETE SURFACE DRIVEWAY (SEE NOTE 3) - LIMEROCK BASE SUBGRADE SUBGRADE — TYPE 'F' CURB & GUTTER VALLEY GUTTER #4 CONTINUOUS REBAR SURFACE PLACED ON PAVEMENT SIDE -┌─ ROADWAY SURFACE - LIMEROCK BASE - LIMEROCK BASE - SUBGRADE 12**"** SUBGRADE TYPE 'D' CURB **HEADER CURB** 1. ALL CURBS, GUTTERS AND CURB AND GUTTER SHALL BE CONSTRUCTED IN ACCORDANCE WITH FDOT STANDARD PLANS INDEX 520-001 AND SPECIFICATION 520. 2. CONCRETE SHALL BE IN ACCORDANCE WITH FDOT SPECIFICATION 346 HAVING A MINIMUM 28-DAY COMPRESSIVE STRENGTH OF 3,000 PSI.

3. WHEN USED ON HIGH SIDE OF ROADWAYS, CROSS SLOPE OF THE GUTTER SHALL MATCH THE CROSS SLOPE OF

4. REFER TO FLEXIBLE PAVEMENT RESTORATION DETAIL G-12.1 FOR BASE AND SUBGRADE MATERIAL AND INSTALLATION SPECIFICATIONS.

PLANS AND SPECIFICATIONS.

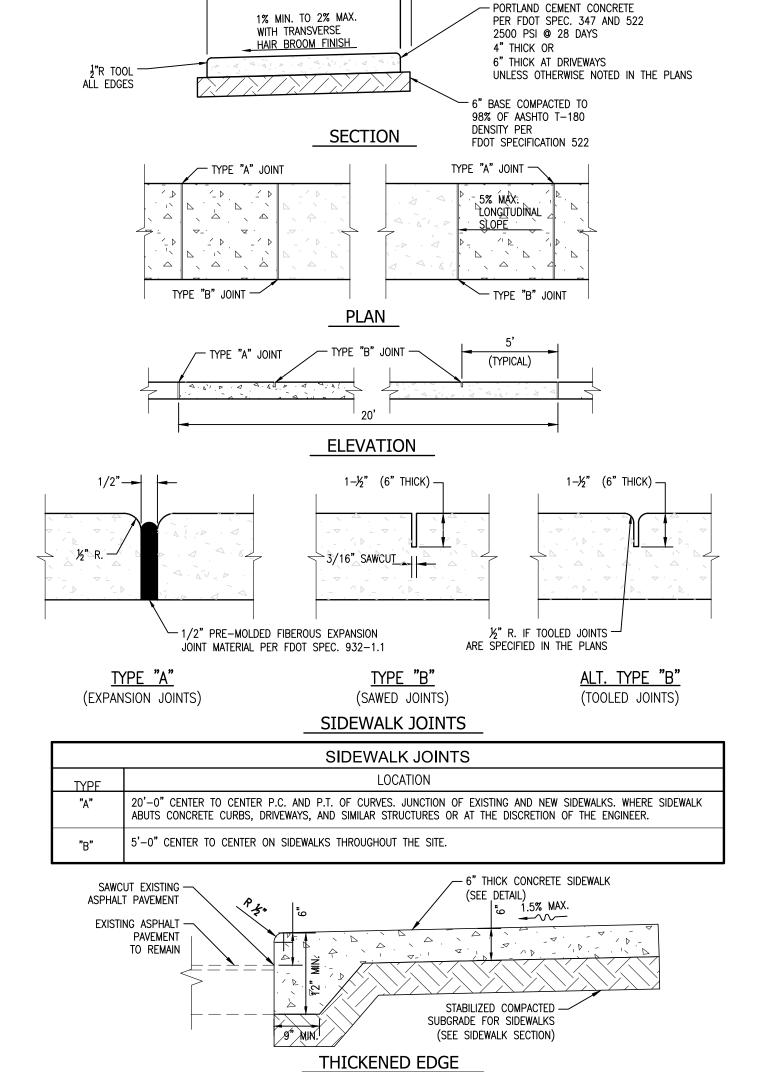


REFER TO PLAN — FOR LAYOUT DETAILS REFER TO PLAN

CONCRETE SIDEWALK

Scale: NTS

FINAL TAC IN NAVD 88

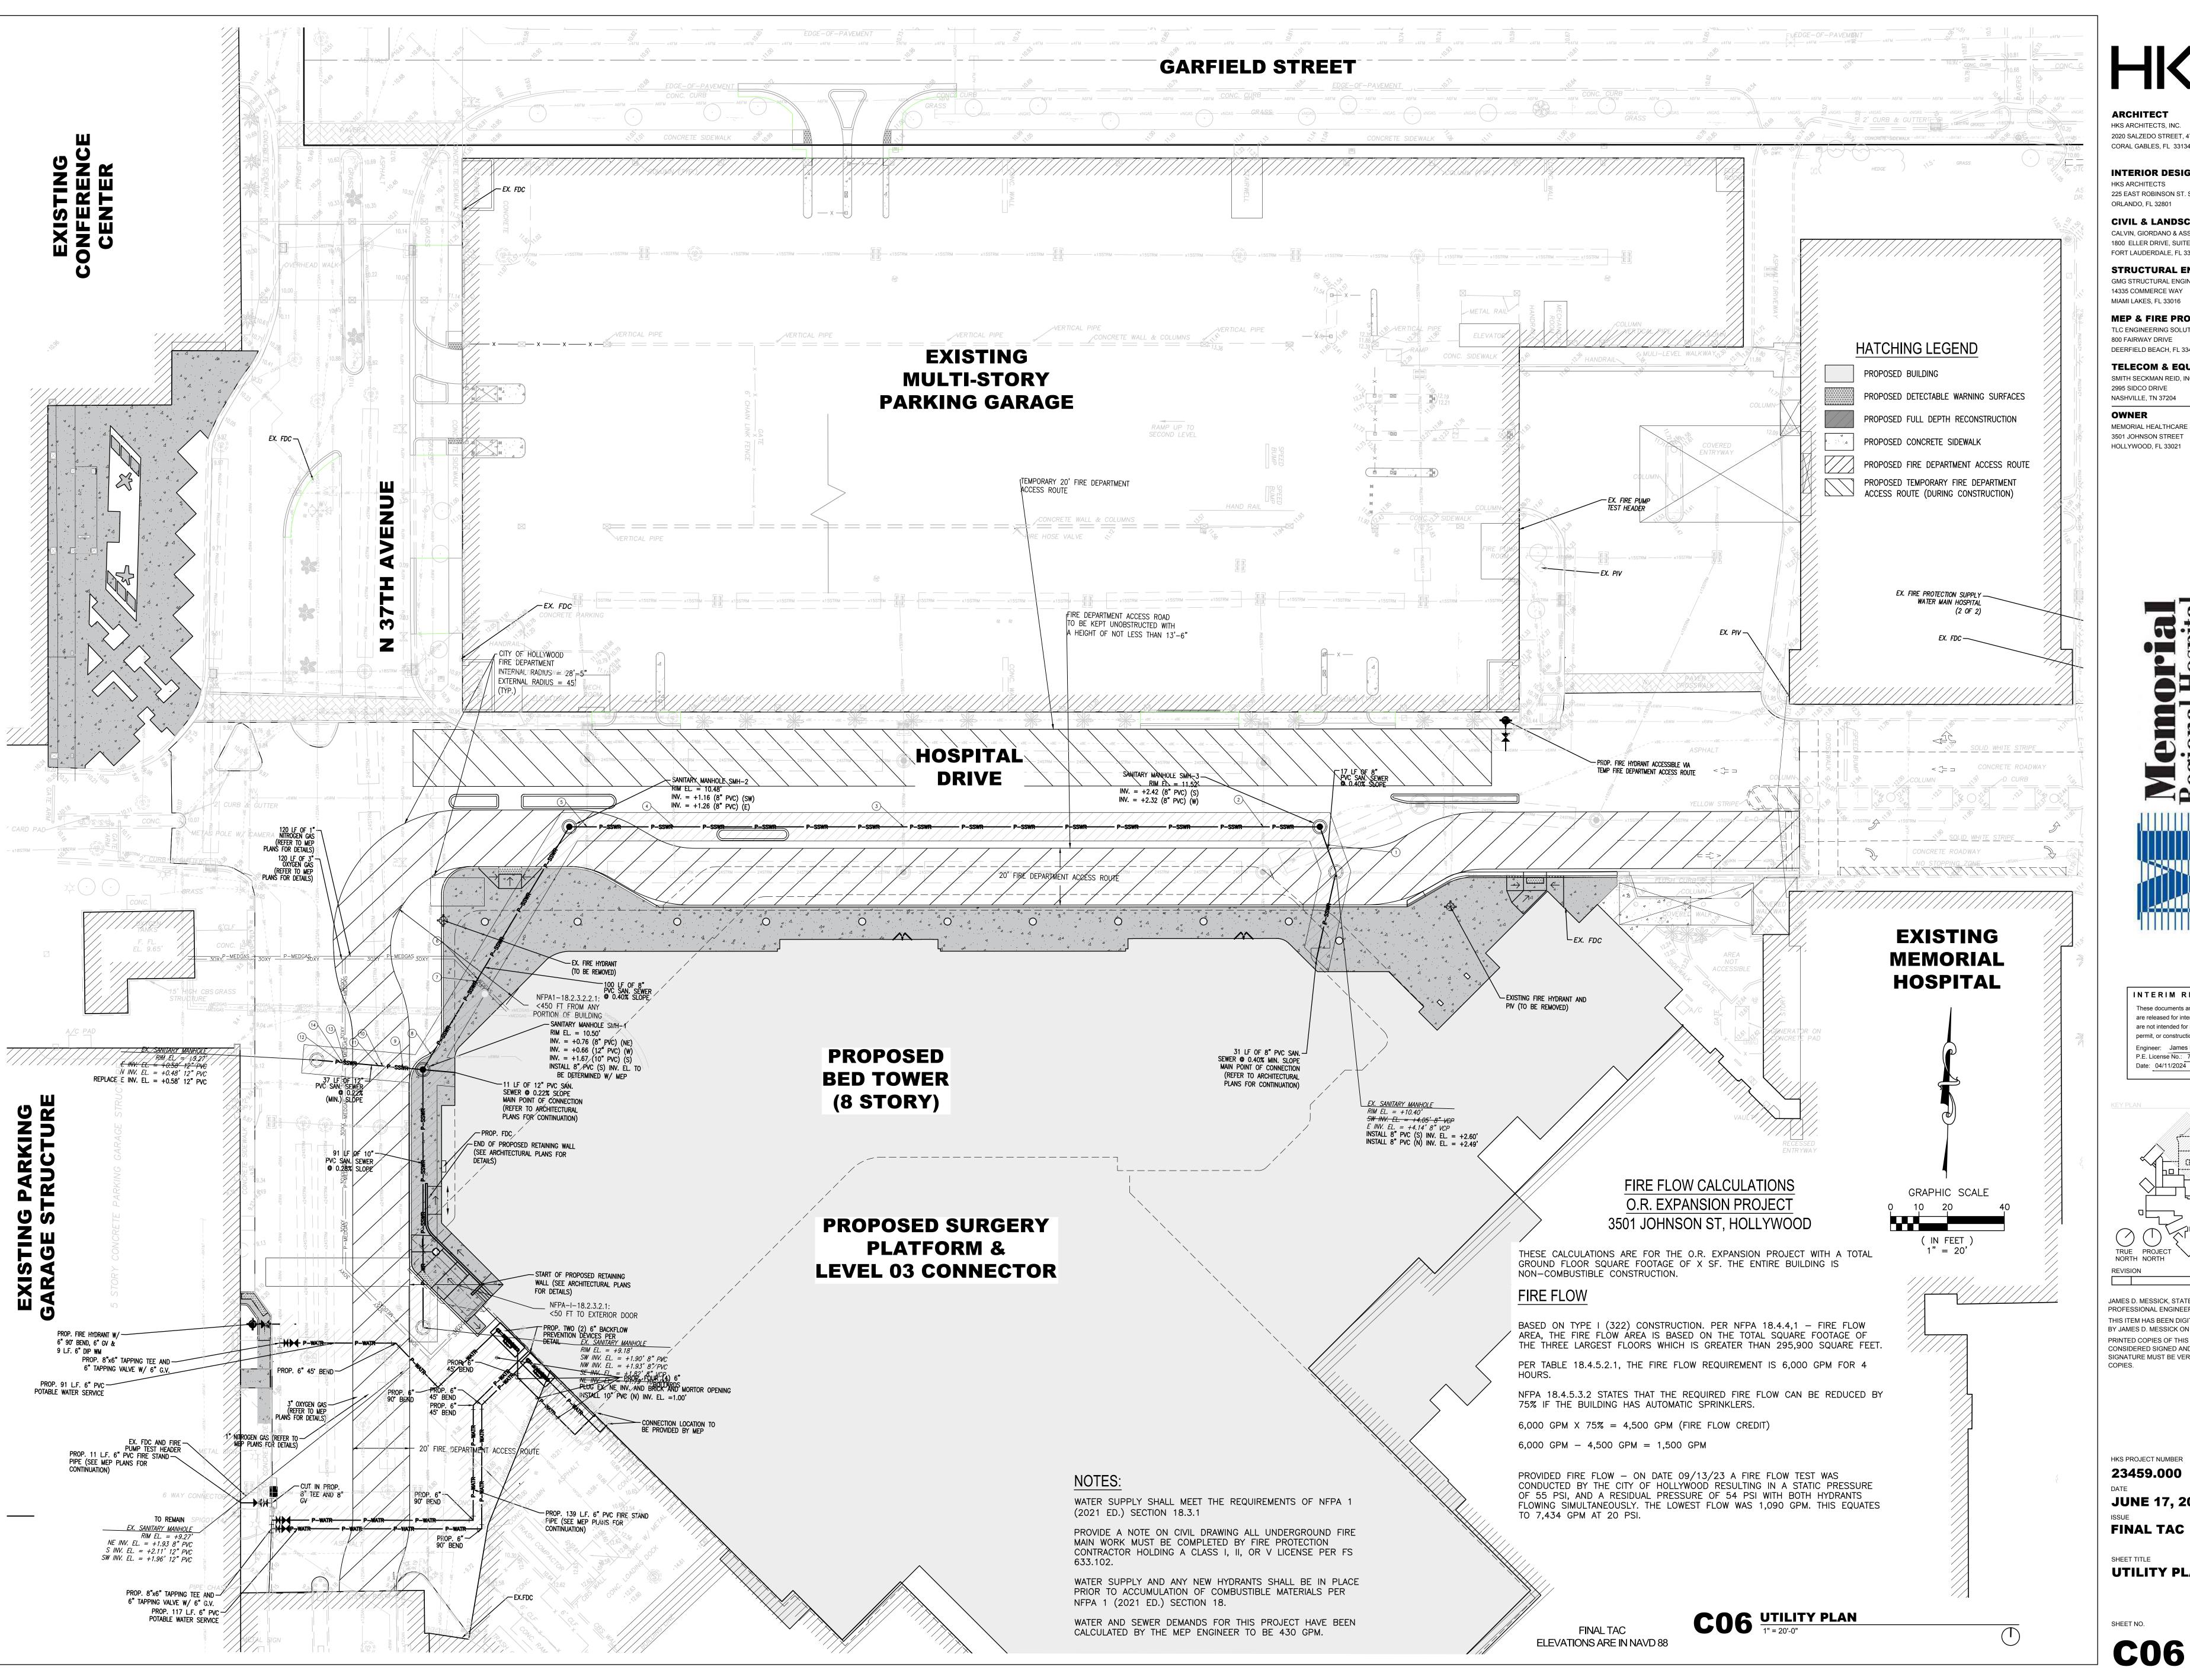

ARCHITECT HKS ARCHITECTS, INC. 2020 SALZEDO STREET, 4TH FLOOR CORAL GABLES, FL 33134

INTERIOR DESIGNER

225 EAST ROBINSON ST. SUITE #405 ORLANDO, FL 32801

CIVIL & LANDSCAPE CALVIN, GIORDANO & ASSOCIATES 1800 ELLER DRIVE, SUITE 600

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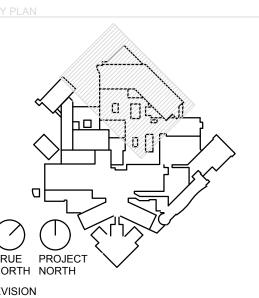
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TELECOM & EQUIPMENT SMITH SECKMAN REID, INC. 2995 SIDCO DRIVE

NASHVILLE, TN 37204 **OWNER**

MEMORIAL HEALTHCARE SYSTEM 3501 JOHNSON STREET HOLLYWOOD, FL 33021

INTERIM REVIEW ONLY P.E. License No.: 70870




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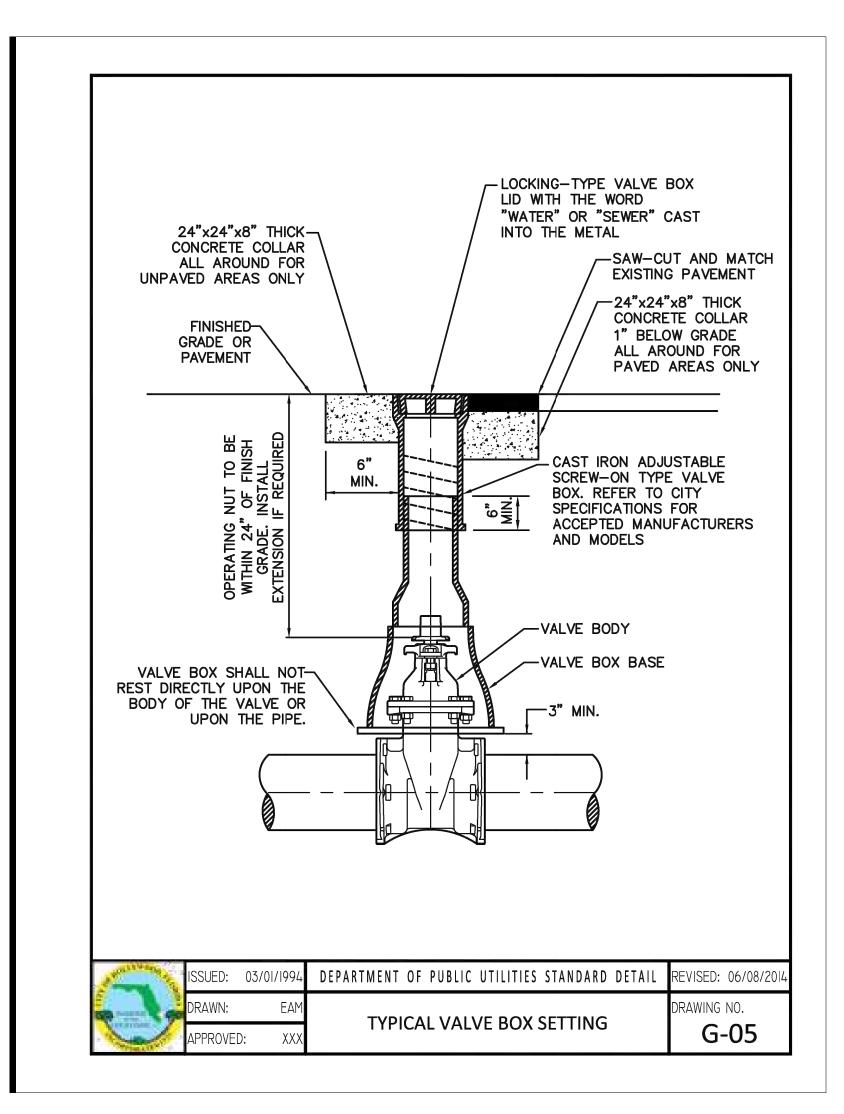
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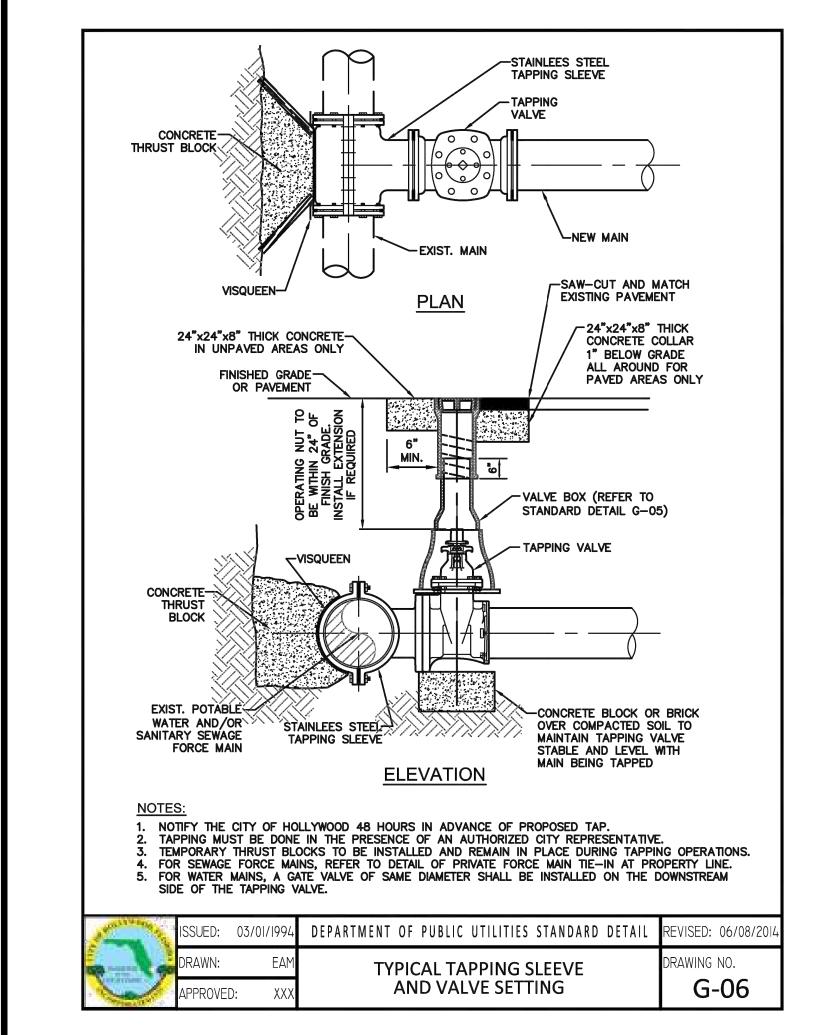
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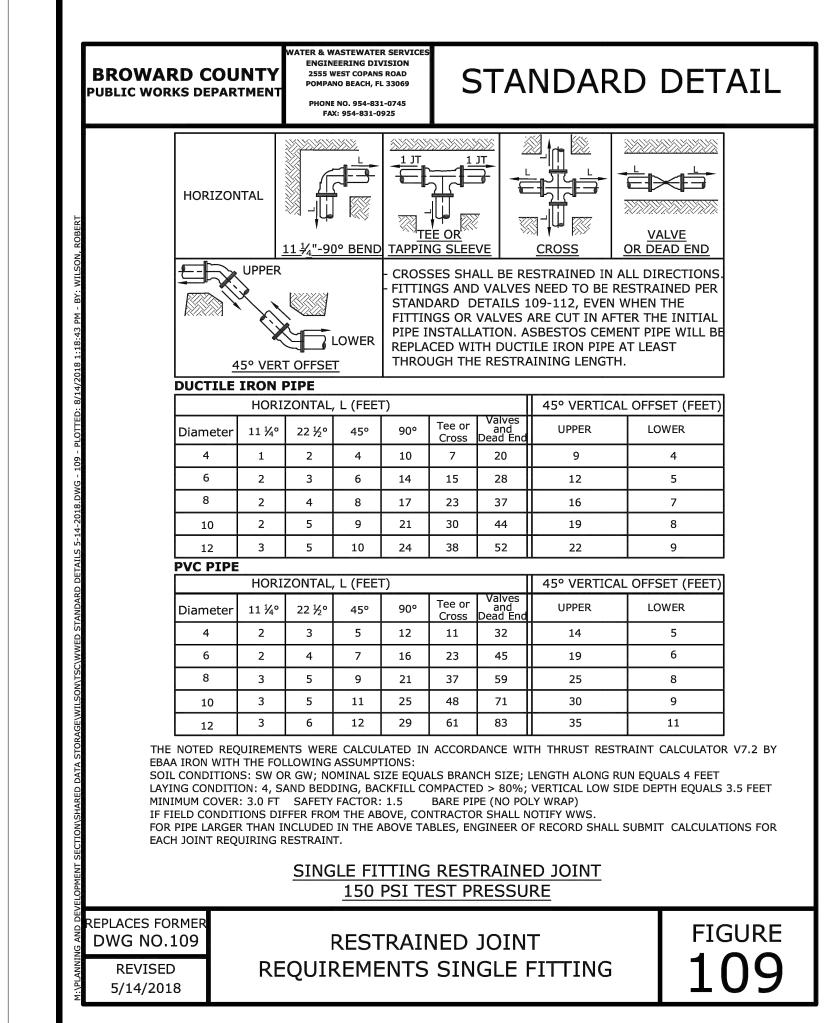
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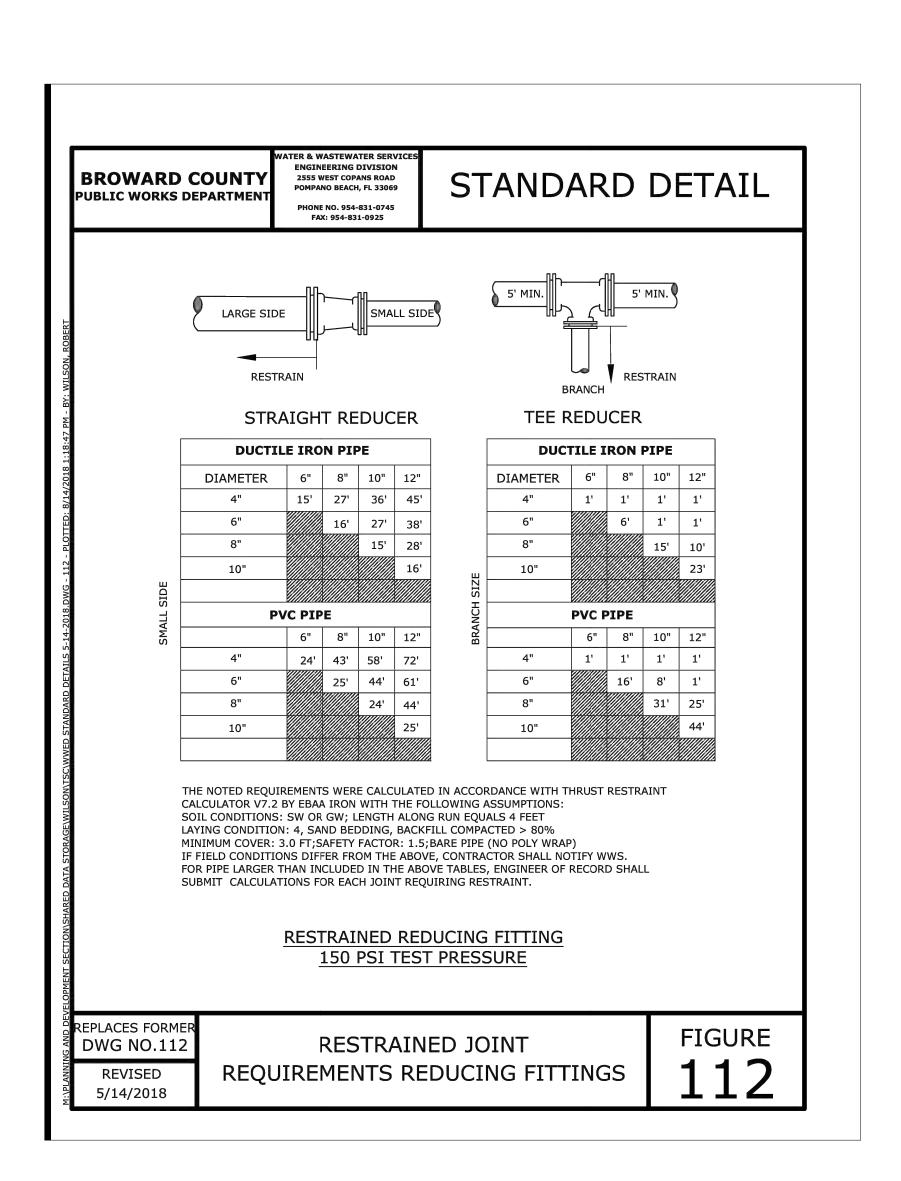
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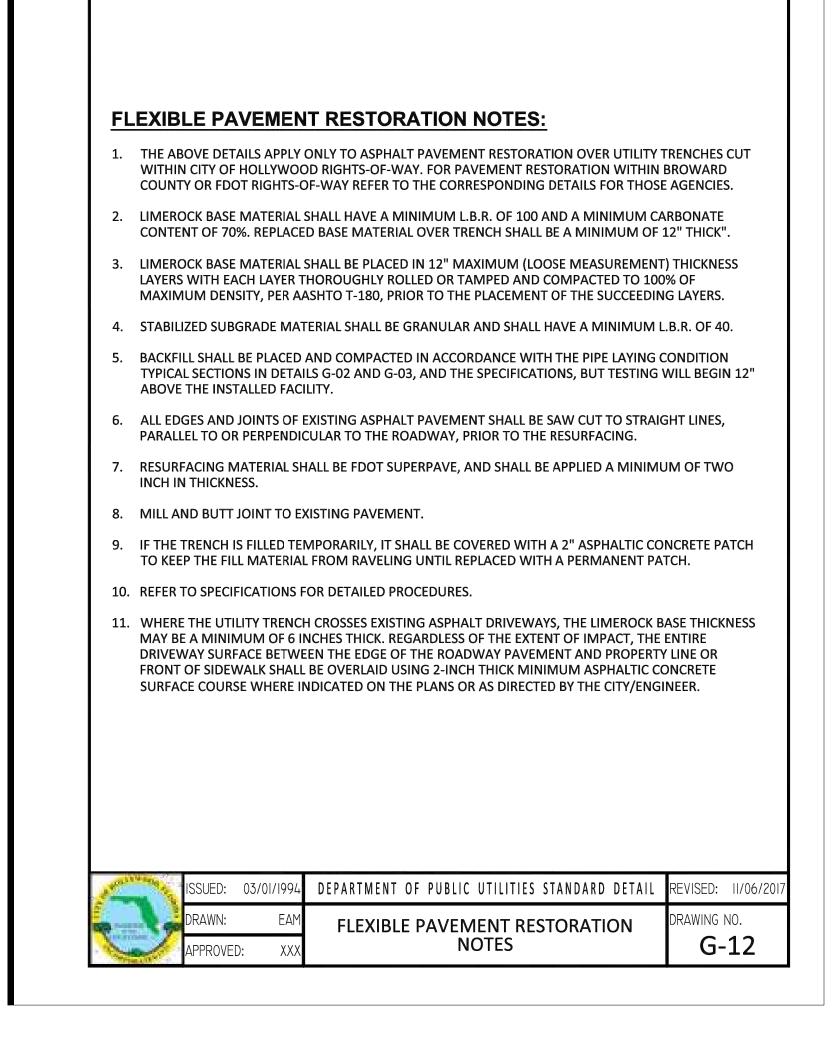












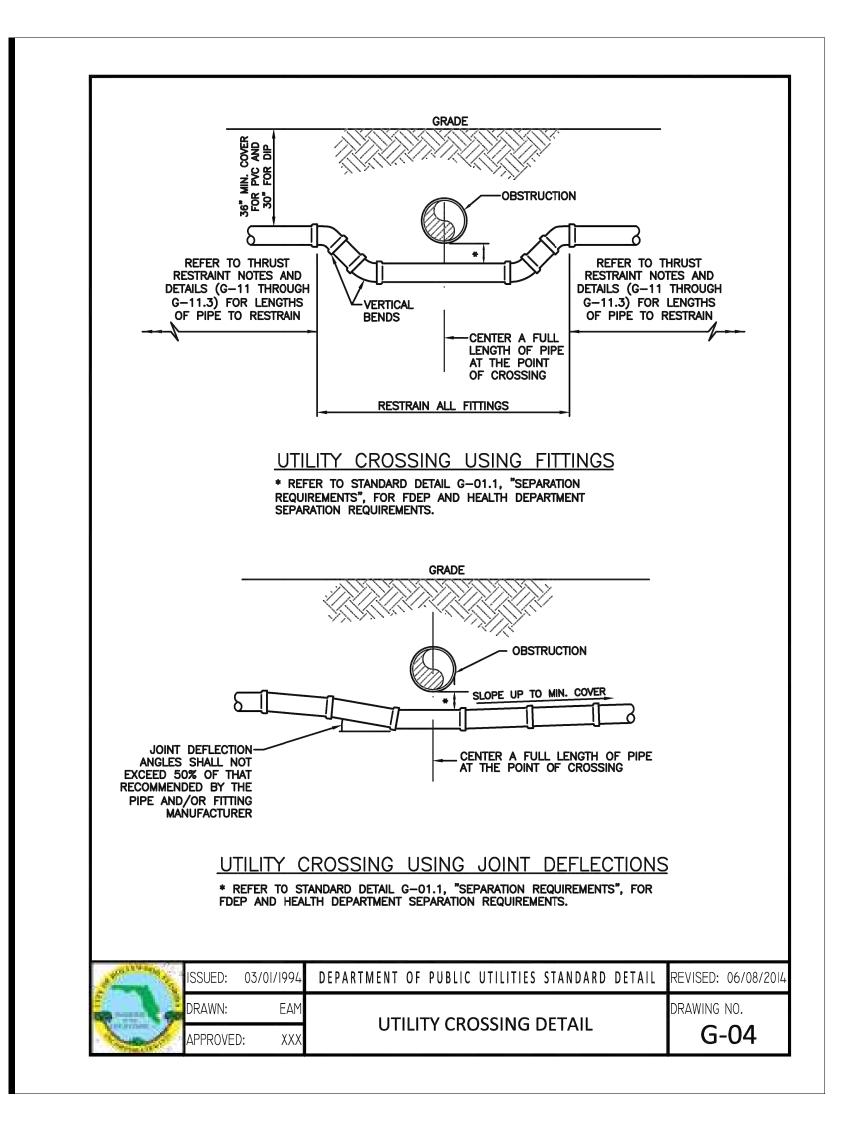

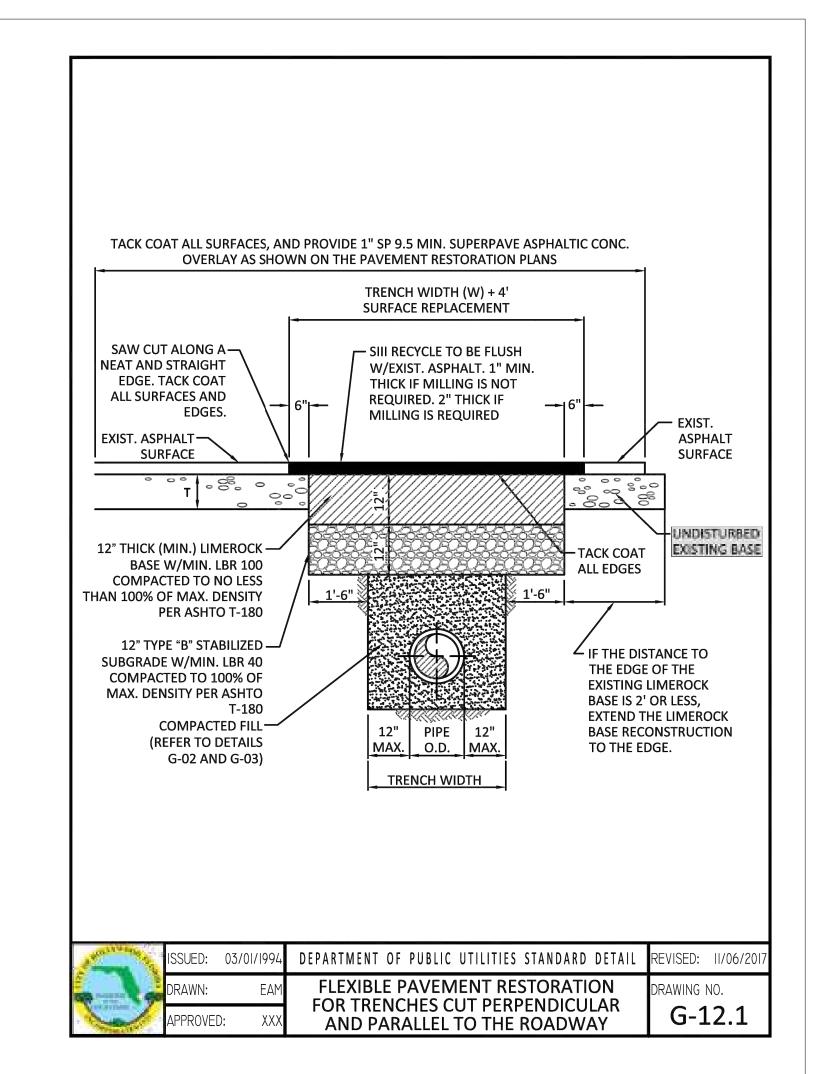

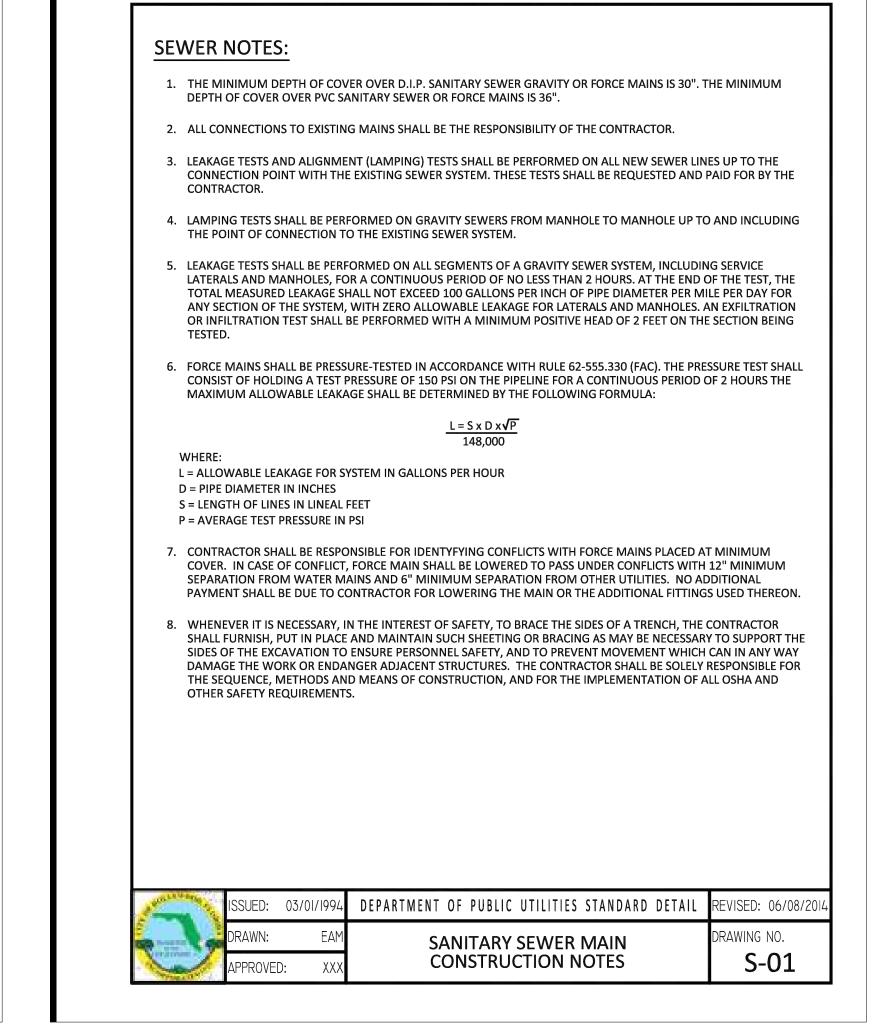

FINAL TAC **ELEVATIONS ARE** IN NAVD 88

C07 UTILITY DETAILS

ARCHITECT HKS ARCHITECTS, INC. 2020 SALZEDO STREET, 4TH FLOOR

CORAL GABLES, FL 33134

ORLANDO, FL 32801

INTERIOR DESIGNER HKS ARCHITECTS 225 EAST ROBINSON ST. SUITE #405

CIVIL & LANDSCAPE CALVIN, GIORDANO & ASSOCIATES

1800 ELLER DRIVE, SUITE 600 FORT LAUDERDALE, FL 33316

STRUCTURAL ENGINEER GMG STRUCTURAL ENGINEERS

14335 COMMERCE WAY MIAMI LAKES, FL 33016

MEP & FIRE PROTECTION

TLC ENGINEERING SOLUTIONS, INC. 800 FAIRWAY DRIVE

DEERFIELD BEACH, FL 33441 **TELECOM & EQUIPMENT** SMITH SECKMAN REID, INC.


2995 SIDCO DRIVE NASHVILLE, TN 37204

OWNER

MEMORIAL HEALTHCARE SYSTEM 3501 JOHNSON STREET HOLLYWOOD, FL 33021



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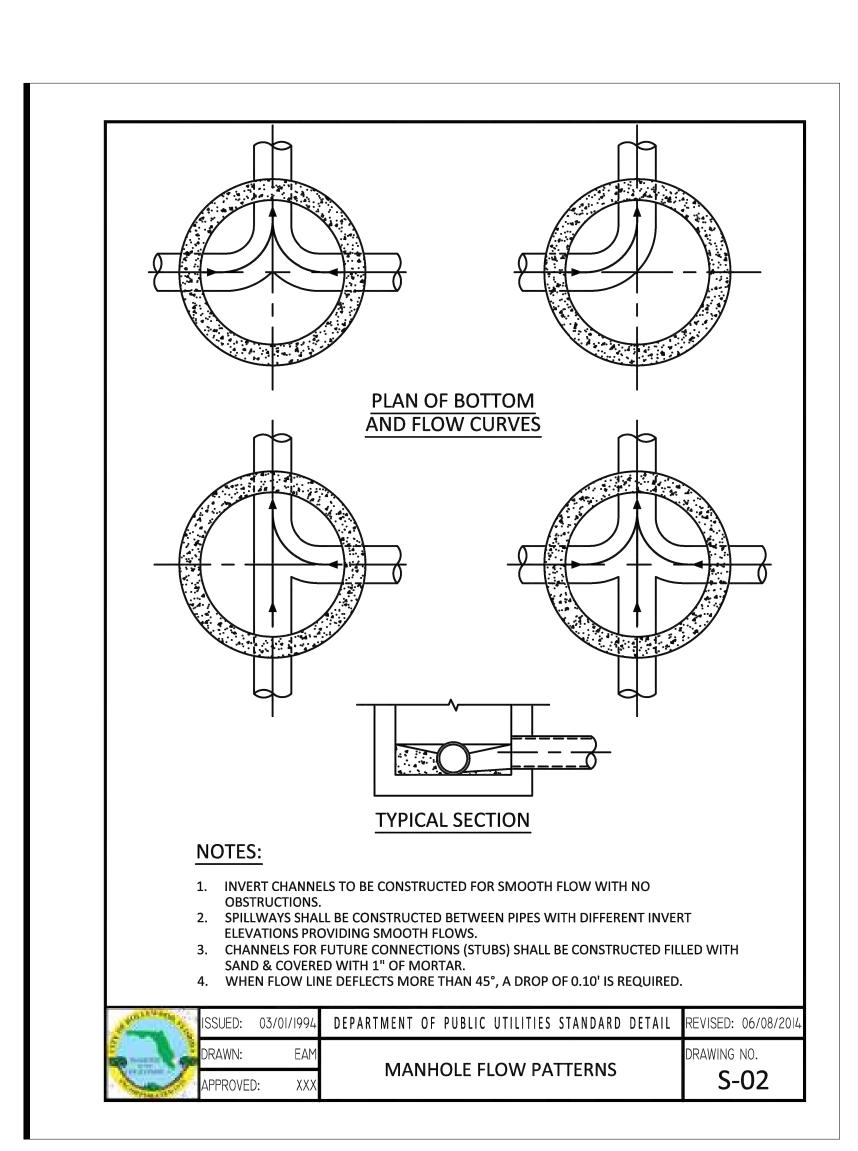
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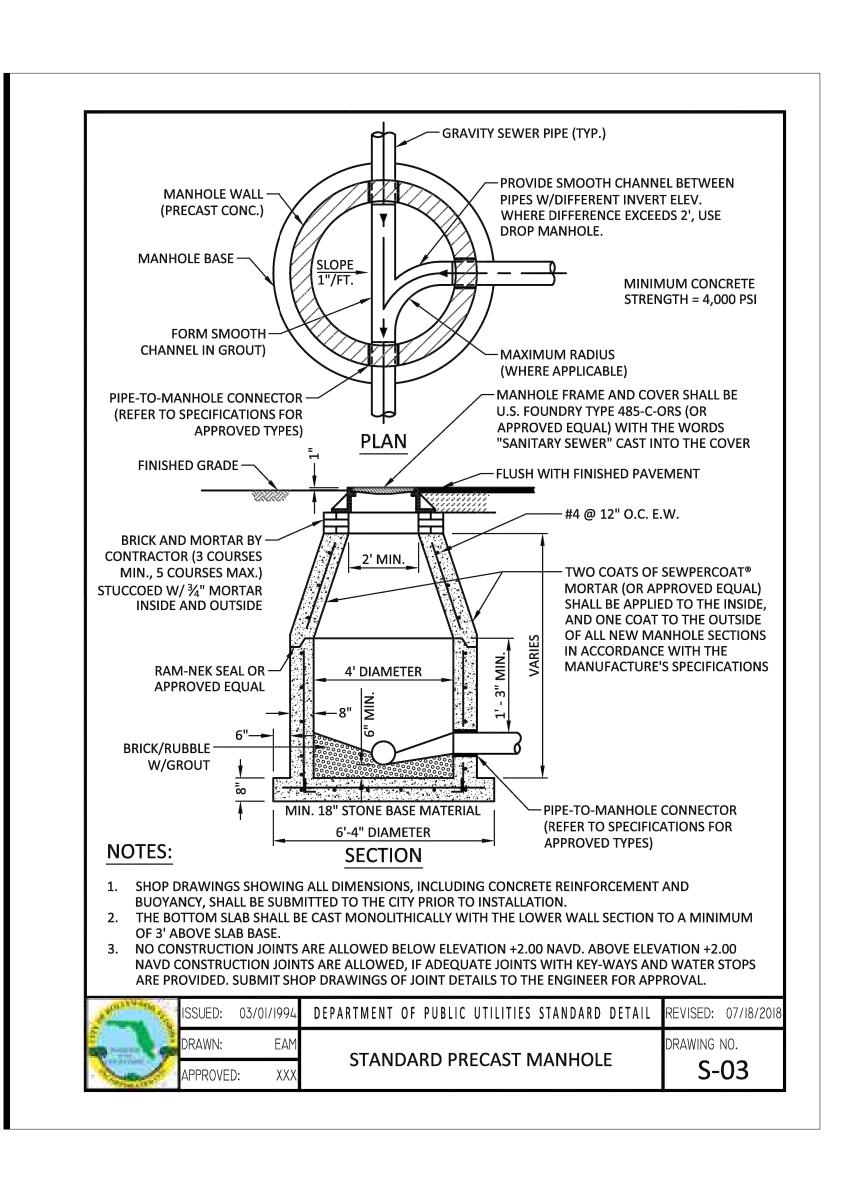
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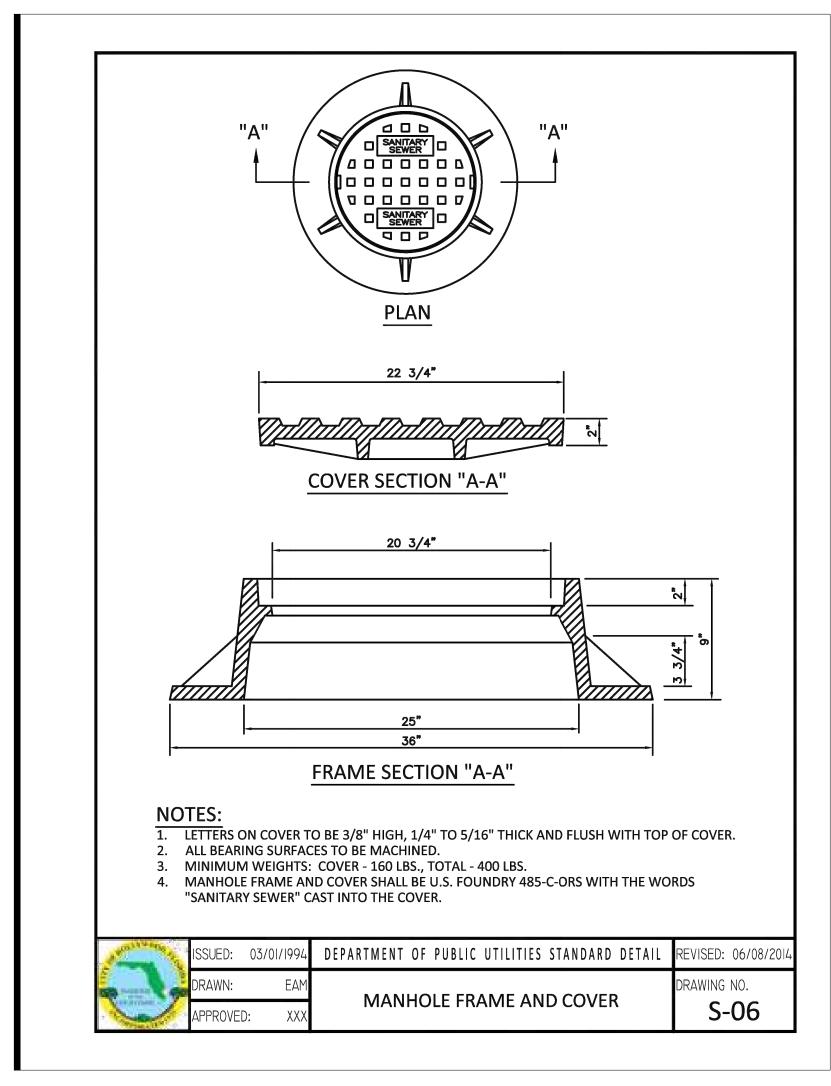
FINAL TAC

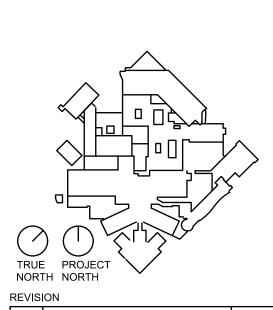
UTILITY DETAILS


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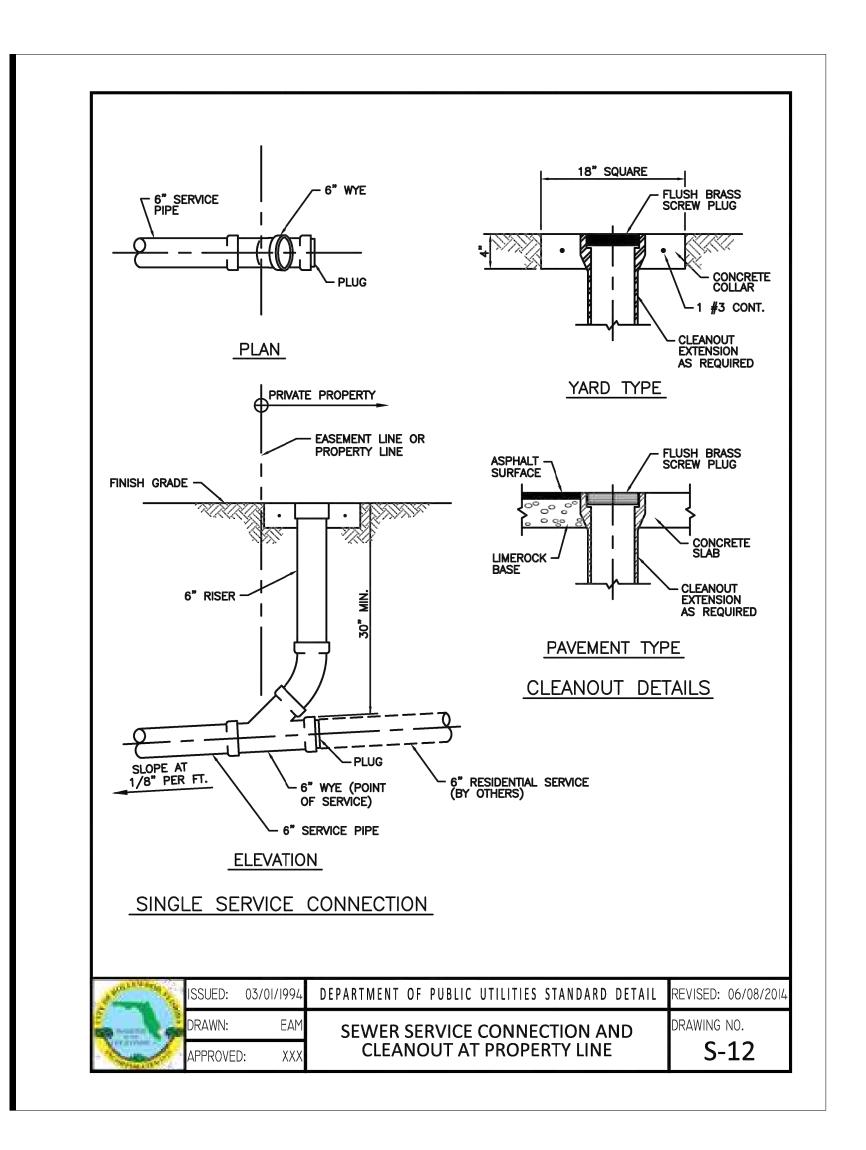










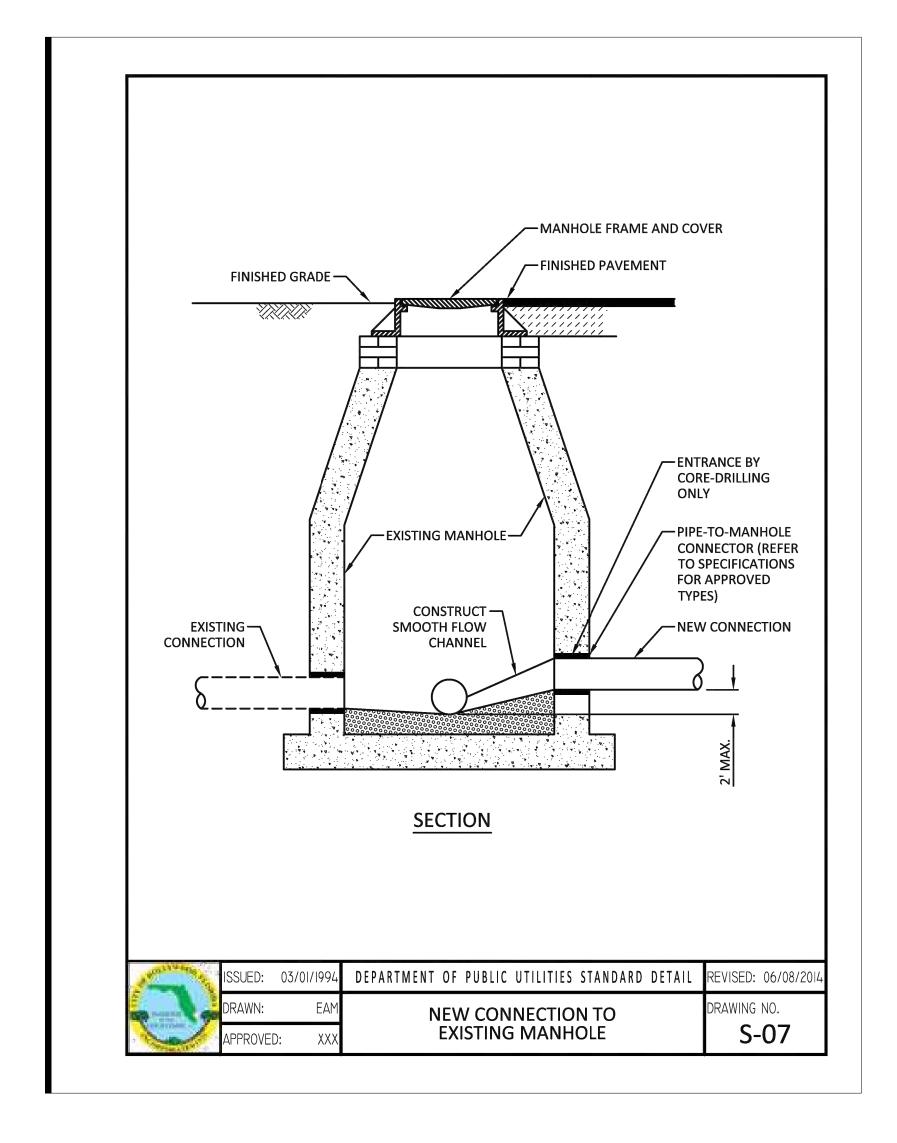

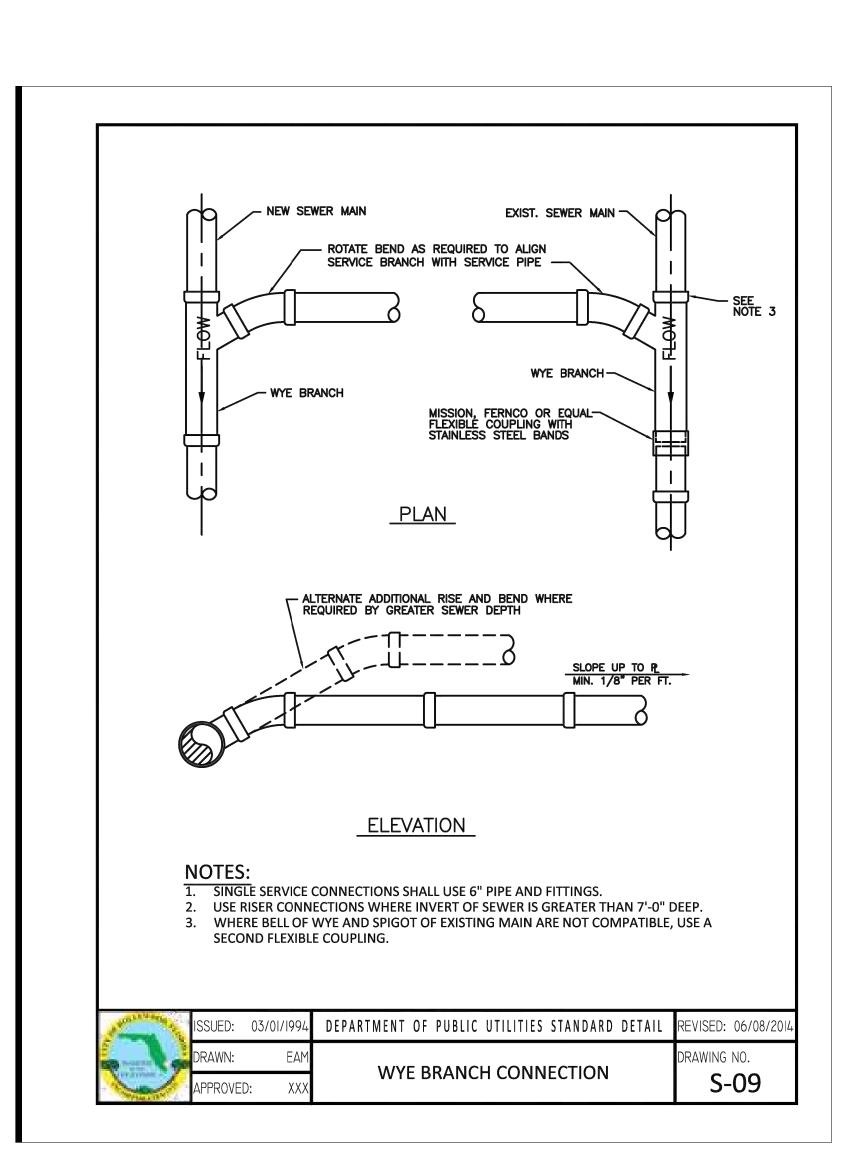

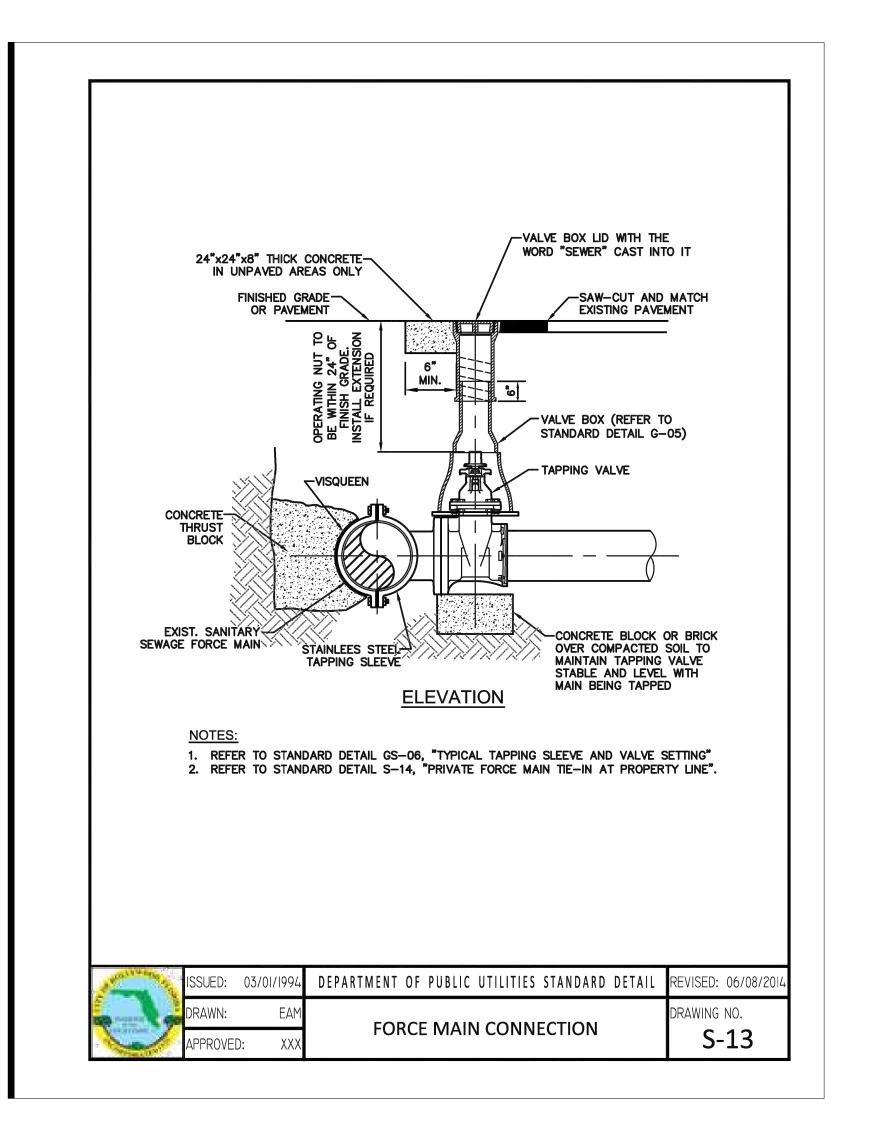

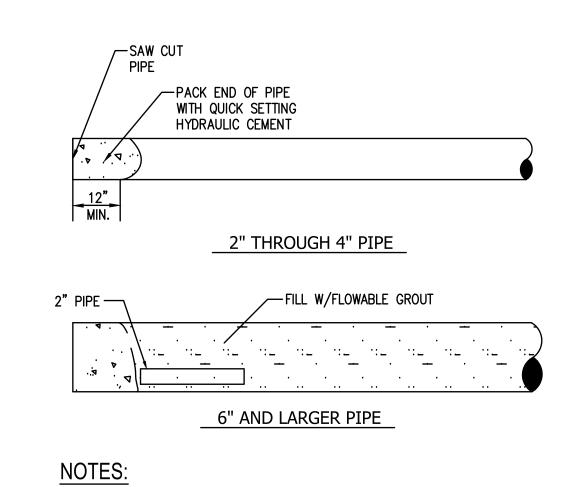

1. INSTALL 2" PIPE AT BOTH ENDS OF LINE TO BE ABANDONED. GROUT IN

PLACE WITH QUICK SETTING HYDRAULIC CEMENT.

2. PUMP FLOWABLE GROUT FROM ONE END, OR INTERMEDIATE POINTS ALONG THE PIPELINE, UNTIL PIPE IS FILLED AS WITNESSED BY THE DISCHARGE FROM 2" PIPE(S).

> ABANDONED PIPE DETAIL Scale: NTS

> > ELEVATIONS ARE FINAL TAC

C08 UTILITY DETAILS

ARCHITECT HKS ARCHITECTS, INC.

2020 SALZEDO STREET, 4TH FLOOR CORAL GABLES, FL 33134

INTERIOR DESIGNER

HKS ARCHITECTS 225 EAST ROBINSON ST. SUITE #405

ORLANDO, FL 32801 CIVIL & LANDSCAPE

CALVIN, GIORDANO & ASSOCIATES 1800 ELLER DRIVE, SUITE 600 FORT LAUDERDALE, FL 33316

STRUCTURAL ENGINEER

GMG STRUCTURAL ENGINEERS 14335 COMMERCE WAY

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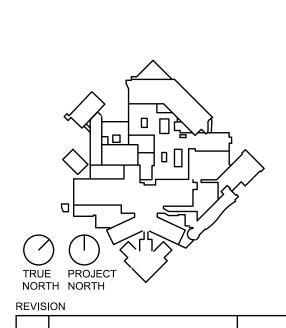
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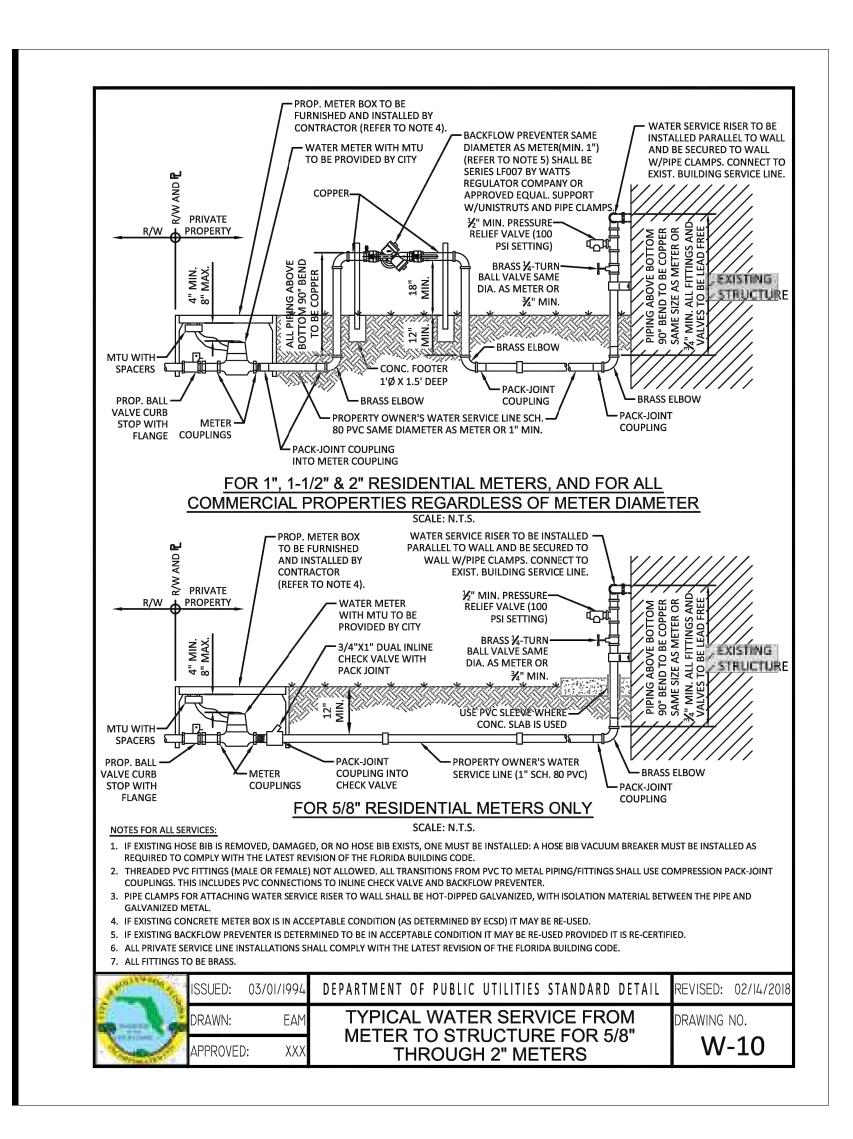
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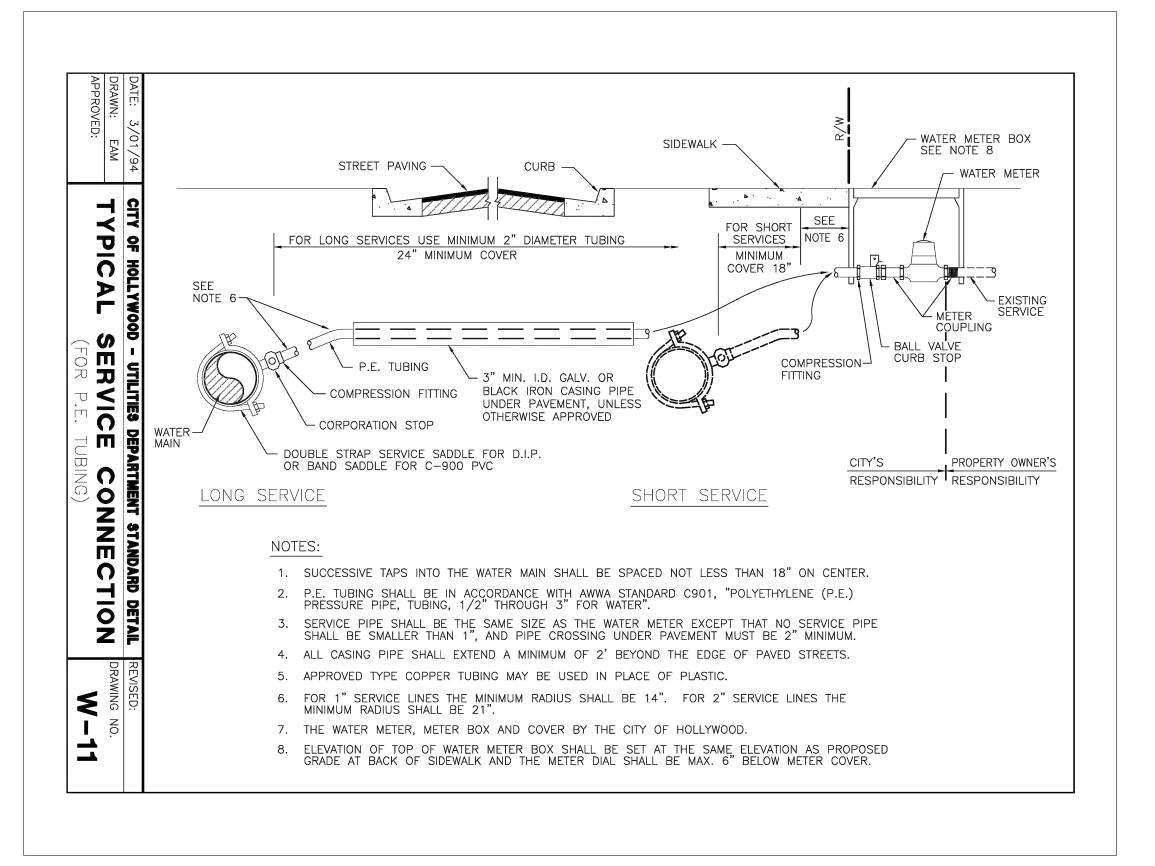
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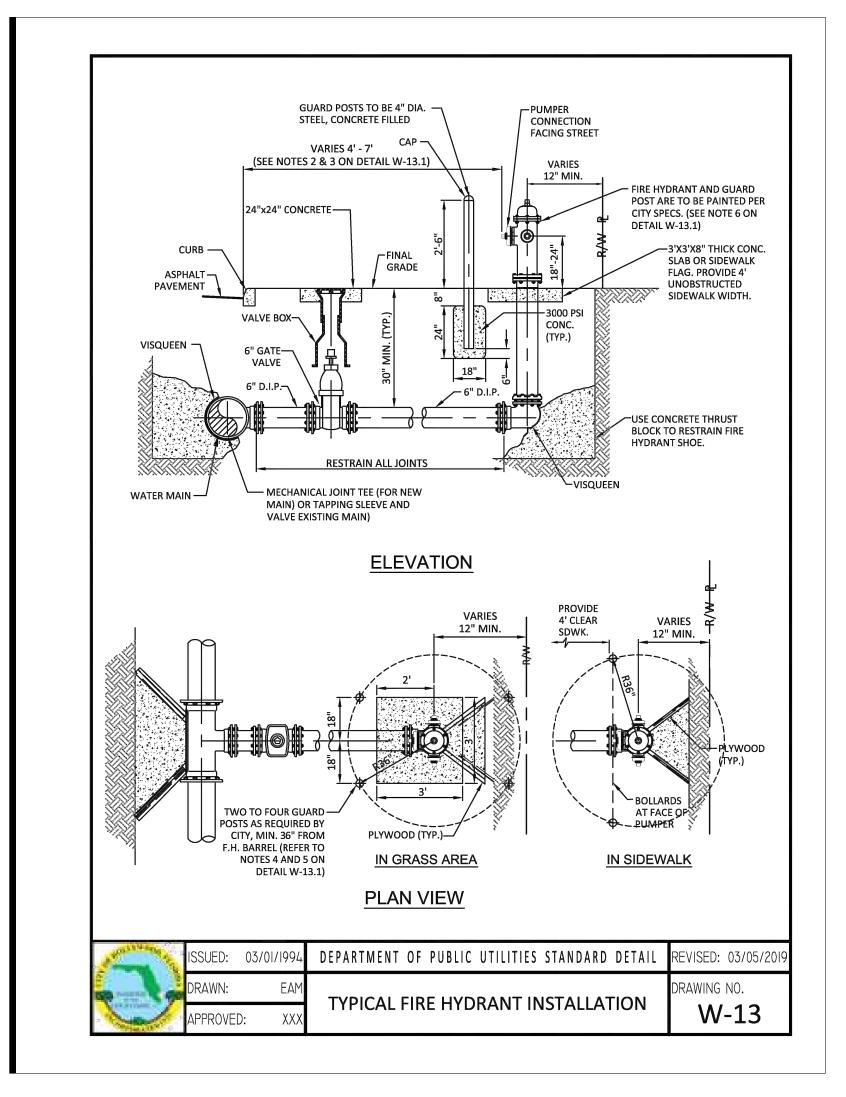
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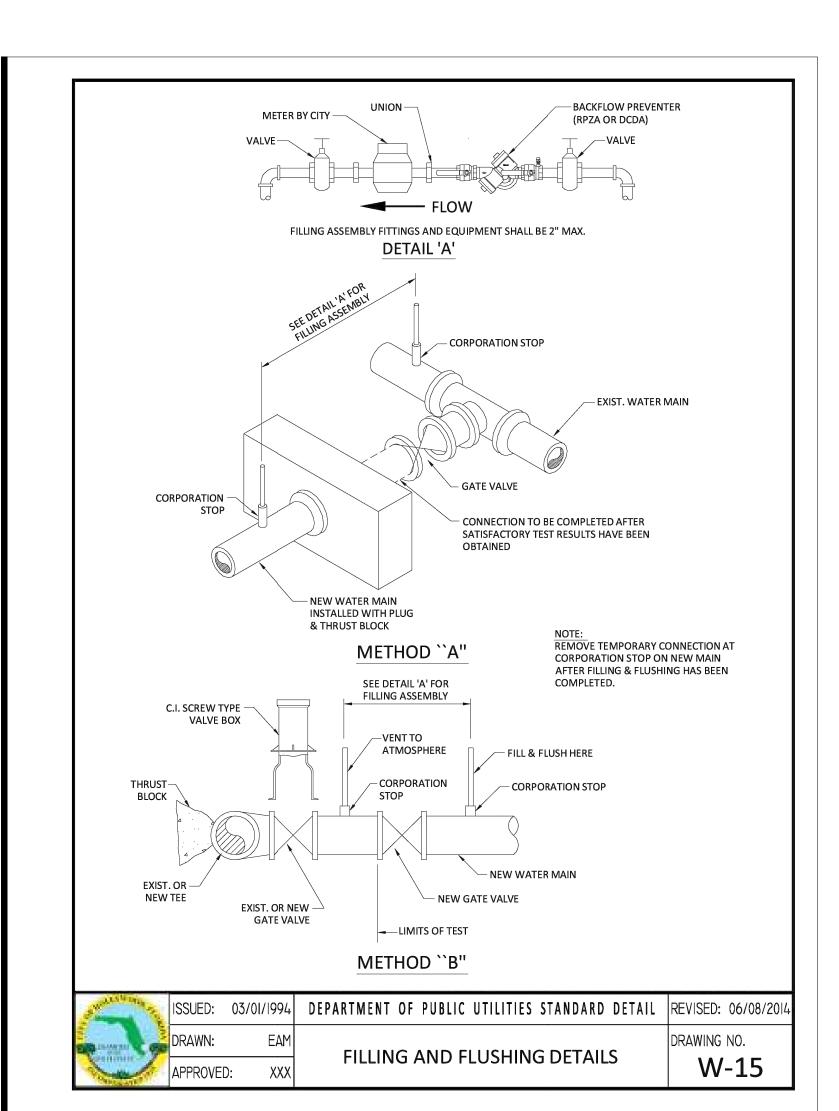
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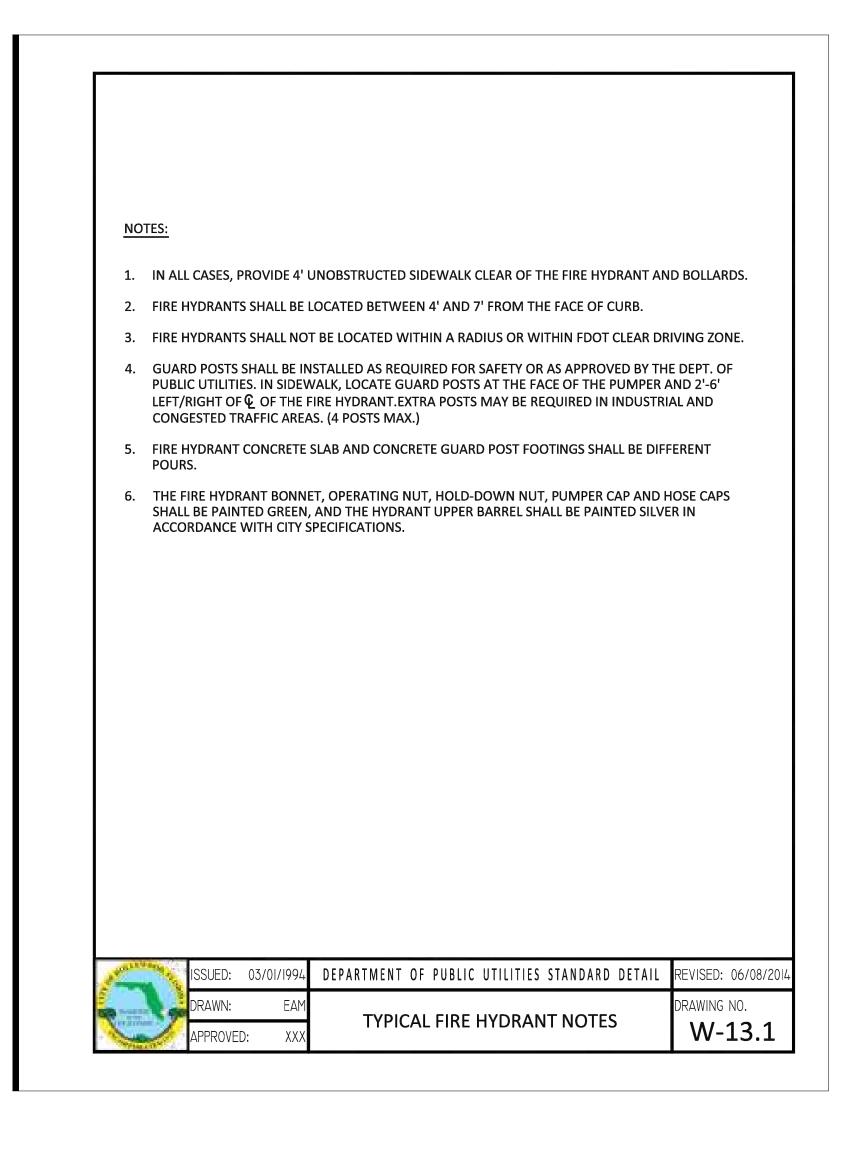
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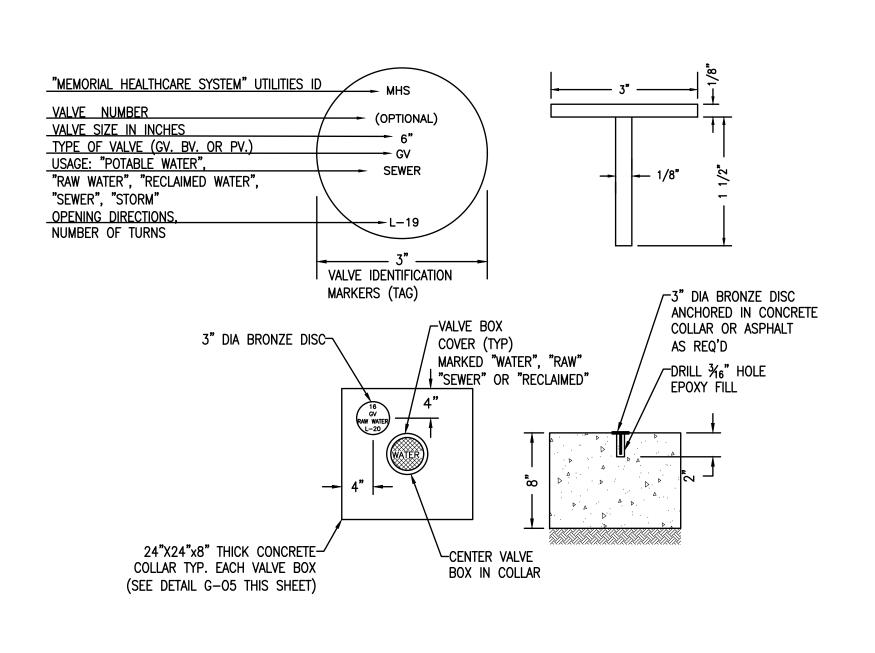












VALVE COVER AND IDENTIFICATION MARKER DETAIL SCALE: N.T.S.

ELEVATIONS ARE IN NAVD 88

ARCHITECT

HKS ARCHITECTS, INC. 2020 SALZEDO STREET, 4TH FLOOR CORAL GABLES, FL 33134

> INTERIOR DESIGNER HKS ARCHITECTS

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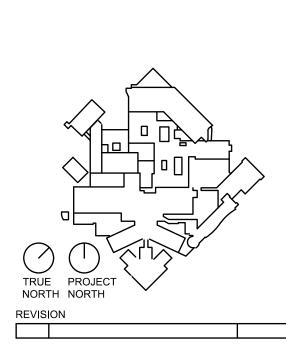
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NASHVILLE, TN 37204 OWNER

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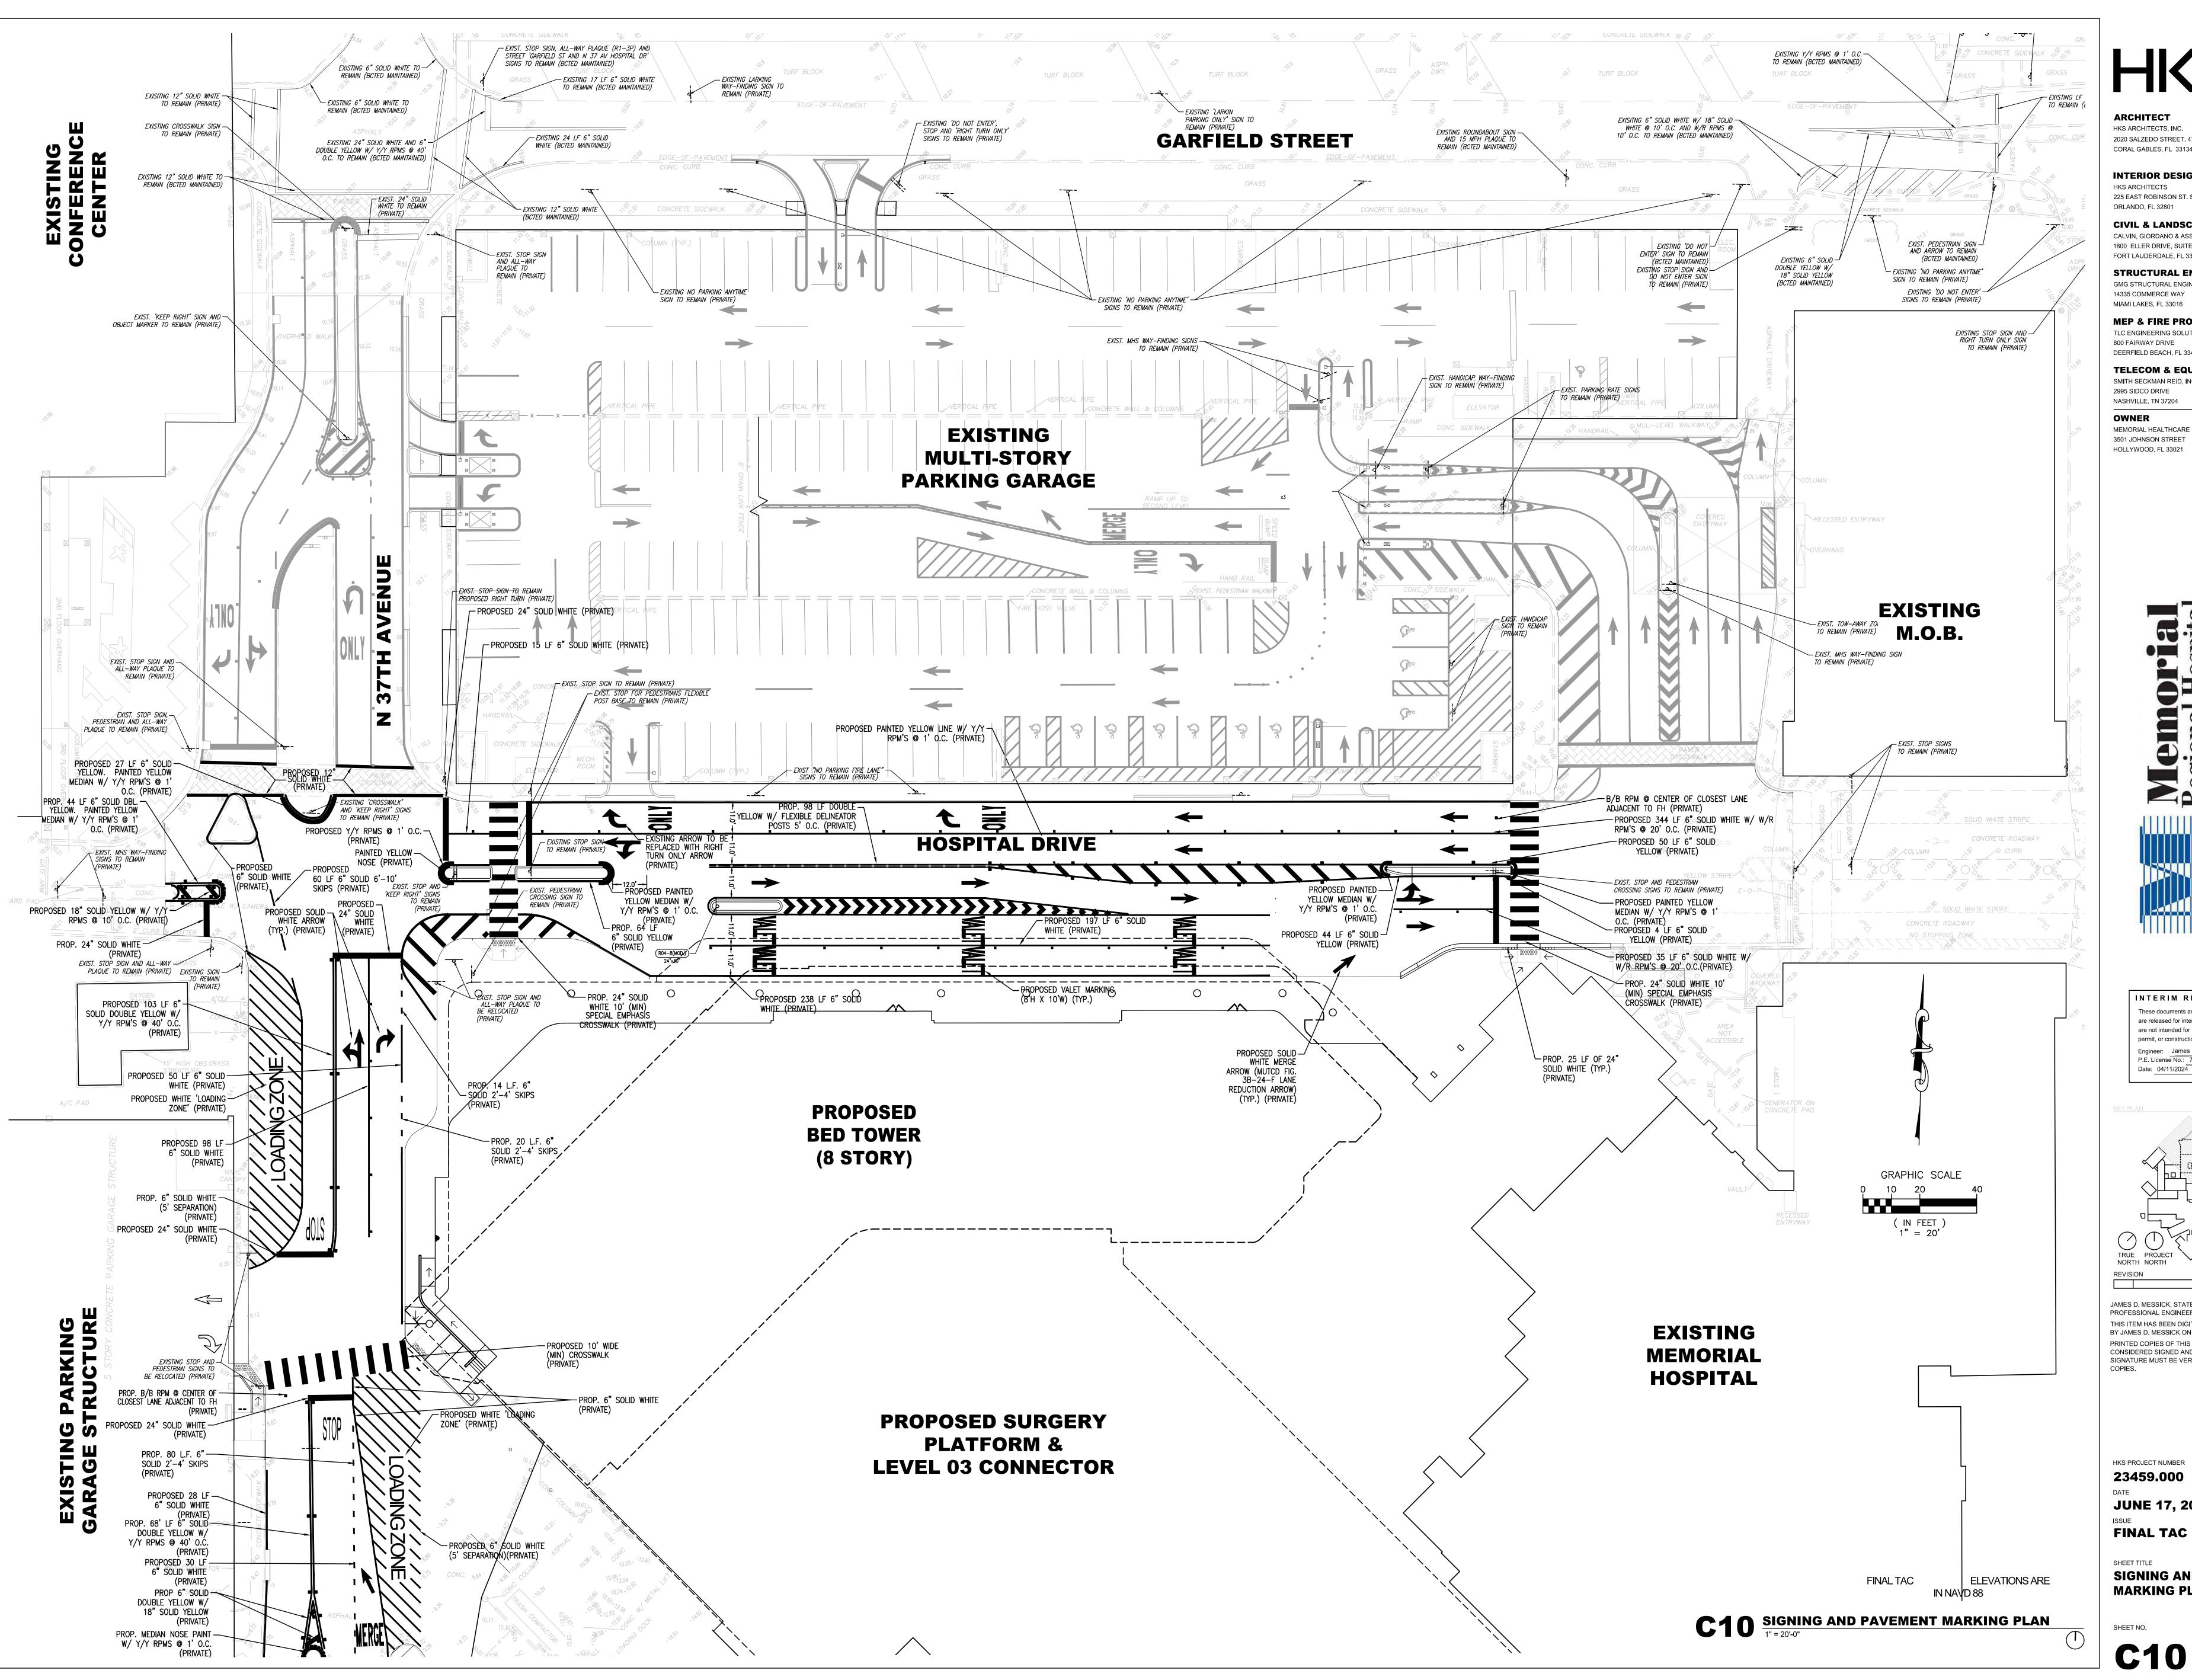


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HKS PROJECT NUMBER 23459.000 **JUNE 17, 2024 FINAL TAC**

UTILITY DETAILS

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CORAL GABLES, FL 33134

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CIVIL & LANDSCAPE CALVIN, GIORDANO & ASSOCIATES

1800 ELLER DRIVE, SUITE 600 FORT LAUDERDALE, FL 33316

STRUCTURAL ENGINEER GMG STRUCTURAL ENGINEERS 14335 COMMERCE WAY

MIAMI LAKES, FL 33016 **MEP & FIRE PROTECTION**

TLC ENGINEERING SOLUTIONS, INC. 800 FAIRWAY DRIVE

DEERFIELD BEACH, FL 33441 **TELECOM & EQUIPMENT** SMITH SECKMAN REID, INC.


2995 SIDCO DRIVE NASHVILLE, TN 37204

OWNER

MEMORIAL HEALTHCARE SYSTEM 3501 JOHNSON STREET HOLLYWOOD, FL 33021

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Date: 04/11/2024

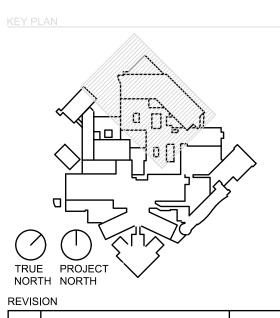


JAMES D. MESSICK, STATE OF FLORIDA, PROFESSIONAL ENGINEER, LICENSE NO. 70870. THIS ITEM HAS BEEN DIGITALLY SIGNED AND SEALED BY JAMES D. MESSICK ON THE DATE INDICATED HERE. CONSIDERED SIGNED AND SEALED AND THE SIGNATURE MUST BE VERIFIED ON ANY ELECTRONIC

HKS PROJECT NUMBER 23459.000

JUNE 17, 2024

SIGNING AND PAVEMENT MARKING PLAN

SHEET NO.

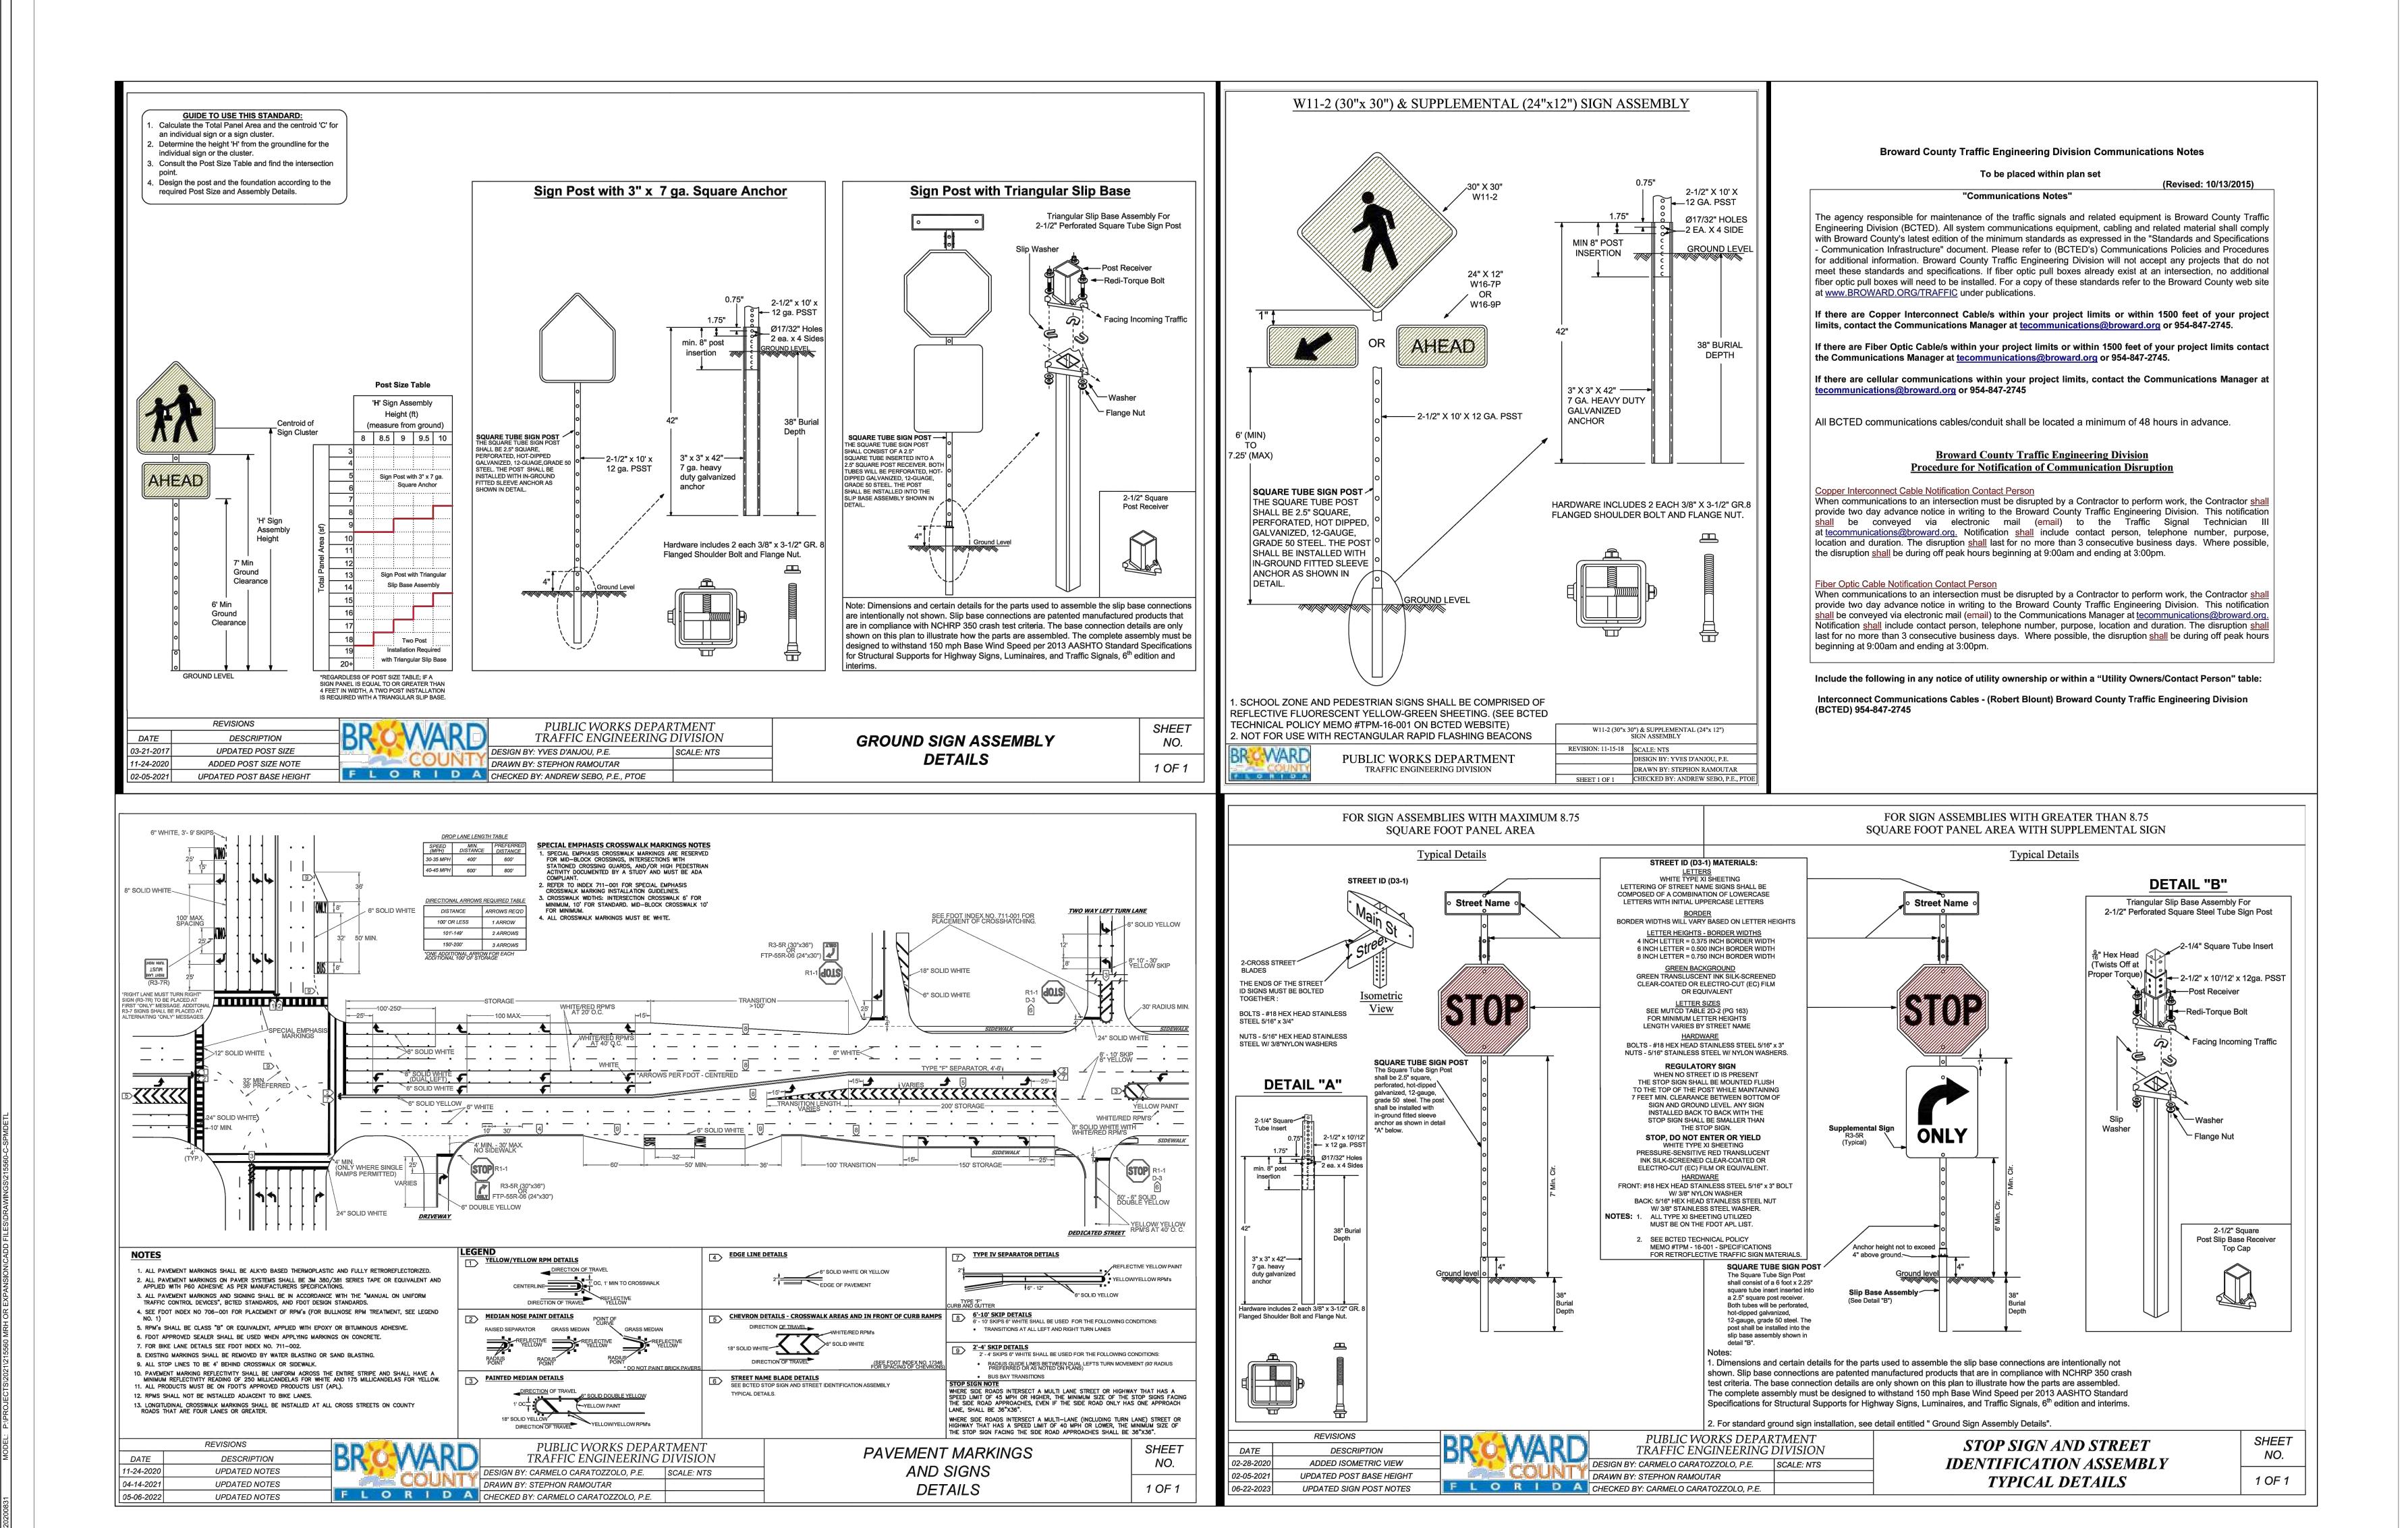

FINAL TAC **ELEVATIONS ARE** IN NAVD 88

C11 SIGNING AND PAVEMENT MARKING DETAILS
NOT TO SCALE

ARCHITECT

2020 SALZEDO STREET, 4TH FLOOR

CORAL GABLES, FL 33134

HKS ARCHITECTS, INC.

INTERIOR DESIGNER HKS ARCHITECTS

ORLANDO, FL 32801 CIVIL & LANDSCAPE

225 EAST ROBINSON ST. SUITE #405

CALVIN, GIORDANO & ASSOCIATES 1800 ELLER DRIVE, SUITE 600 FORT LAUDERDALE, FL 33316

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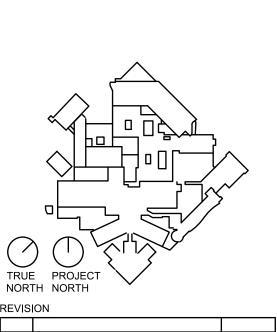
SMITH SECKMAN REID, INC. 2995 SIDCO DRIVE NASHVILLE, TN 37204

OWNER MEMORIAL HEALTHCARE SYSTEM 3501 JOHNSON STREET

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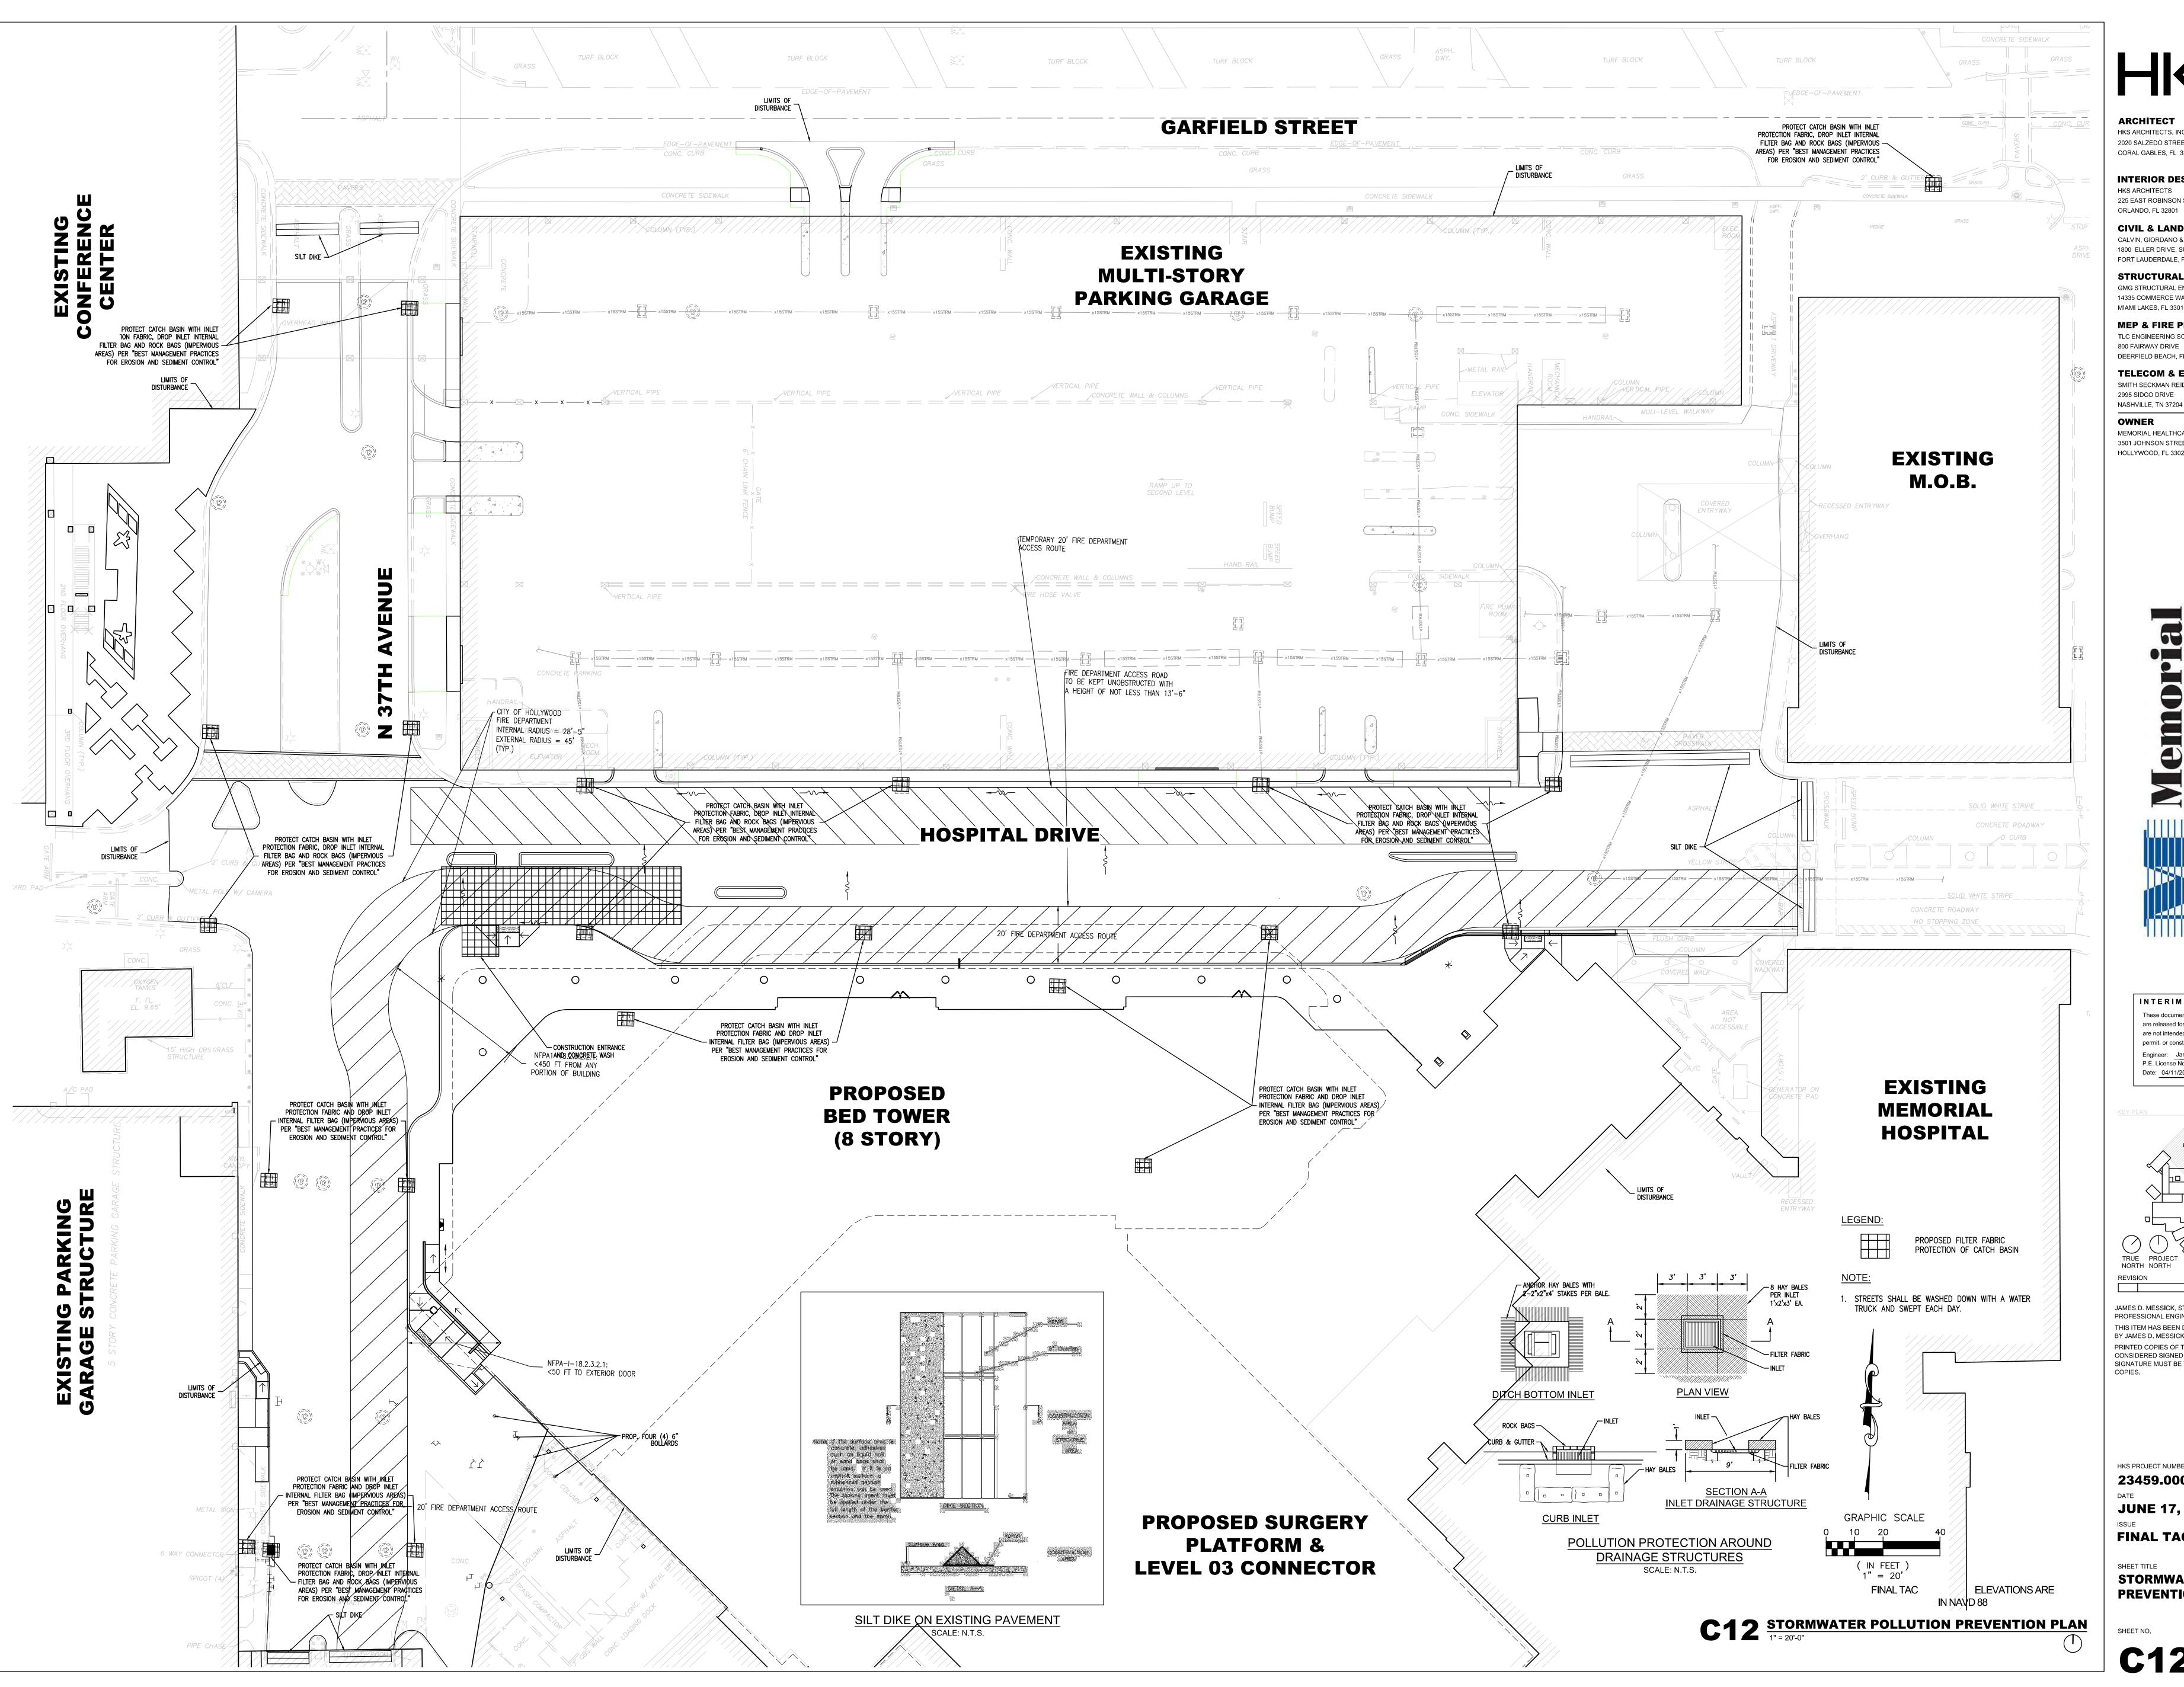
HKS PROJECT NUMBER 23459.000

JUNE 17, 2024

FINAL TAC

SIGNING AND PAVEMENT MARKING DETAILS

SHEET NO.



ARCHITECT HKS ARCHITECTS, INC. 2020 SALZEDO STREET, 4TH FLOOR

CORAL GABLES, FL 33134

INTERIOR DESIGNER HKS ARCHITECTS 225 EAST ROBINSON ST. SUITE #405

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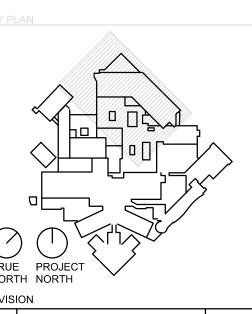
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JUNE 17, 2024 FINAL TAC

STORMWATER POLLUTION PREVENTION PLAN

DRAINAGE AREA IS NO GREATER THAN 2 ACRES.

FOR PROPER LOCATION.

FOLLOWING LIMITATIONS:

OF THE FILTER FABRIC BARRIER.

C. WHERE EFFECTIVENESS IS REQUIRED FOR LESS THAN 3 MONTHS.

D. EVERY EFFORT SHOULD BE MADE TO LIMIT THE USE OF SYNTHETIC BALE

REFER TO EROSION CONTROL DETAILS FOR CONSTRUCTING THE SYNTHETIC BALE

BARRIER. ALSO, REFER TO THE STORMWATER POLLUTION PREVENTION PLAN FOR

DISTURBED AREAS SUBJECT TO SHEET AND RILL EROSION WITH THE

A. WHERE THE MAXIMUM SLOPE BEHIND THE BARRIER IS 33 PERCENT.

B. IN MINOR SWALES OR DITCH LINES WHERE THE MAXIMUM CONTRIBUTING

REFER TO THE EROSION CONTROL DETAILS FOR PROPER CONSTRUCTION

CONTRIBUTING DRAINAGE AREA IS NO GREATER THAN 2 ACRES.

2. FILTER FABRIC BARRIER: FILTER FABRIC BARRIERS CAN BE USED BELOW

BARRIERS CONSTRUCTED IN LIVE STREAMS OR IN SWALES WHERE

THERE IS THE POSSIBILITY OF A WASHOUT. IF NECESSARY, MEASURES

SHALL BE TAKEN TO PROPERLY ANCHOR BALES TO INSURE AGAINST

SUBMITTED. BASED ON MY INQUIRY OF THE PERSON OR PERSONS WHO

MANAGE THE SYSTEM, OR THOSE PERSONS DIRECTLY RESPONSIBLE FOR

GATHERING THE INFORMATION, THE INFORMATION SUBMITTED IS, TO THE

BEST OF MY KNOWLEDGE AND BELIEF, TRUE, ACCURATE, AND COMPLETE. I

AM AWARE THAT THERE ARE SIGNIFICANT PENALTIES FOR SUBMITTING FALSE

INFORMATION, INCLUDING THE POSSIBILITY OF FINE AND IMPRISONMENT FOR

KNOWING VIOLATIONS.

STORMWATER POLLUTION PREVENTION PLAN

3. BRUSH BARRIER WITH FILTER FABRIC: BRUSH BARRIER MAY BE USED
BELOW DISTURBED AREAS SUBJECT TO SHEET AND RILL EROSION WHERE
ENOUGH RESIDUE MATERIAL IS AVAILABLE ON SITE.

4. LEVEL SPREADER: A LEVEL SPREADER MAY BE USED WHERE SEDIMENT—FREE STORM RUNOFF IS INTERCEPTED AND DIVERTED AWAY FROM THE GRADED AREAS ONTO UNDISTURBED STABILIZED AREAS. THIS PRACTICE APPLIES ONLY IN THOSE SITUATIONS WHERE THE SPREADER CAN BE CONSTRUCTED ON UNDISTURBED SOIL AND THE AREA BELOW THE LEVEL LIP IS STABILIZED. THE WATER SHOULD NOT BE ALLOWED TO RECONCENTRATE AFTER RELEASE.

5. STOCKPILING MATERIAL: NO EXCAVATED MATERIAL SHALL BE STOCKPILED IN SUCH A MANNER AS TO DIRECT RUNOFF DIRECTLY OFF THE PROJECT SITE INTO ANY ADJACENT WATER BODY OR STORMWATER COLLECTION FACILITY.

6. EXPOSED AREA LIMITATION: THE SURFACE AREA OF OPEN, RAW ERODIBLE SOIL EXPOSED BY CLEARING AND GRUBBING OPERATIONS OR EXCAVATION AND FILLING OPERATIONS SHALL BE MINIMIZED.

7. INLET PROTECTION: INLETS AND CATCH BASINS WHICH DISCHARGE DIRECTLY OFF-SITE SHALL BE PROTECTED FROM SEDIMENT-LADEN STORM RUNOFF UNTIL THE COMPLETION OF ALL CONSTRUCTION OPERATIONS THAT MAY CONTRIBUTE SEDIMENT TO THE INLET.

8. DUST CONTROL: AREAS OPENED BY CONSTRUCTION OPERATIONS AND THAT ARE NOT ANTICIPATED TO BE RE-EXCAVATED OR DRESSED AND RECEIVE FINAL TREATMENT WITHIN 30 DAYS SHALL BE STABILIZED.

9. TEMPORARY SEEDING AND MULCHING: SLOPES STEEPER THAN 6:1 THAT FALL WITHIN THE CATEGORY ESTABLISHED IN PARAGRAPH 8 ABOVE SHALL ADDITIONALLY RECEIVE MULCHING OF APPROXIMATELY 2 INCHES LOOSE MEASURE OF MULCH MATERIAL CUT INTO THE SOIL OF THE SEEDED AREA ADEQUATE TO PREVENT MOVEMENT OF SEED AND MULCH.

10. TEMPORARY GRASSING: THE SEEDED OR SEEDED AND MULCHED AREA(S)
SHALL BE ROLLED AND WATERED OR HYDROMULCHED OR OTHER
SUITABLE METHODS IF REQUIRED TO ASSURE OPTIMUM GROWING
CONDITIONS FOR THE ESTABLISHMENT OF A GOOD GRASS COVER.
TEMPORARY GRASSING SHALL BE THE SAME MIX & AMOUNT REQUIRED
FOR PERMANENT GRASSING IN THE CONTRACT SPECIFICATIONS.

11. TEMPORARY REGRASSING: IF, AFTER 14 DAYS FROM SEEDING, THE TEMPORARY GRASSED AREAS HAVE NOT ATTAINED A MINIMUM OF 75 PERCENT GOOD GRASS COVER, THE AREA WILL BE REWORKED AND ADDITIONAL SEED APPLIED SUFFICIENT TO ESTABLISH THE DESIRED VEGETATIVE COVER.

12. MAINTENANCE: ALL FEATURES OF THE PROJECT DESIGNED AND

CONSTRUCTED TO PREVENT EROSION AND SEDIMENT SHALL BE MAINTAINED DURING THE LIFE OF THE CONSTRUCTION SO AS TO FUNCTION AS THEY WERE ORIGINALLY DESIGNED AND CONSTRUCTED.

13. PERMANENT EROSION CONTROL: THE EROSION CONTROL FACILITIES OF THE PROJECT SHOULD BE DESIGNED TO MINIMIZE THE IMPACT ON THE

OFFSITE FACILITIES.

14. PERMANENT SEEDING: ALL AREAS WHICH HAVE BEEN DISTURBED BY CONSTRUCTION WILL, AS A MINIMUM, BE SEEDED. THE SEEDING MIX MUST PROVIDE BOTH LONG-TERM VEGETATION AND RAPID GROWTH SEASONAL

STRUCTURAL PRACTICES (IF APPLICABLE):

THE STRUCTURE.

AREAS.

VEGETATION.

TEMPORARY DIVERSION DIKE: TEMPORARY DIVERSION DIKES MAY BE
USED TO DIVERT RUNOFF THROUGH A SEDIMENT—TRAPPING FACILITY.

2. TEMPORARY SEDIMENT TRAP: A SEDIMENT TRAP SHALL BE INSTALLED IN A DRAINAGE WAY AT A STORM DRAIN INLET OR AT OTHER POINTS OF DISCHARGE FROM A DISTURBED AREA.

THE FOLLOWING SEDIMENT TRAPS MAY BE CONSTRUCTED EITHER INDEPENDENTLY OR IN CONJUNCTION WITH A TEMPORARY DIVERSION

A. BLOCK & GRAVEL SEDIMENT FILTER — THIS PROTECTION IS
APPLICABLE WHERE HEAVY FLOWS AND/OR WHERE AN OVERFLOW
CAPACITY IS NECESSARY TO PREVENT EXCESSIVE PONDING AROUND

B. GRAVEL SEDIMENT TRAP — THIS PROTECTION IS APPLICABLE WHERE HEAVY CONCENTRATED FLOWS ARE EXPECTED, BUT NOT WHERE PONDING AROUND THE STRUCTURE MIGHT CAUSE EXCESSIVE INCONVENIENCE OR DAMAGE TO ADJACENT STRUCTURES & UNPROTECTED

C. DROP INLET SEDIMENT TRAP — THIS PROTECTION IS APPLICABLE WHERE THE INLET DRAINS A RELATIVELY FLAT AREA (S < 5%) AND WHERE SHEET OR OVERLAND FLOWS (Q < 0.5 CFS) ARE TYPICAL. THIS METHOD SHALL NOT APPLY TO INLETS RECEIVING CONCENTRATED FLOWS SUCH AS IN STREET OR HIGHWAY MEDIANS.

3. OUTLET PROTECTION: APPLICABLE TO THE OUTLETS OF ALL PIPES AND PAVED CHANNEL SECTIONS WHERE THE FLOW COULD CAUSE EROSION & SEDIMENT PROBLEM TO THE RECEIVING WATER BODY. SILT FENCES & SYTHETIC BALES ARE TO BE INSTALLED IMMEDIATELY DOWNSTREAM OF THE DISCHARGING STRUCTURE AS SHOWN ON THE OUTLET PROTECTION DETAIL.

4. SEDIMENT BASIN: WILL BE CONSTRUCTED AT THE COMMON DRAINAGE LOCATIONS, THE PROPOSED STORMWATER PONDS (OR TEMPORARY PONDS) WILL BE CONSTRUCTED FOR USE AS SEDIMENT BASINS. THESE SEDIMENT BASINS MUST PROVIDE A MINIMUM OF 67 CUBIC YARDS OF STORAGE PER ACRE DRAINED UNTIL FINAL STABILIZATION OF THE SITE. THE VOLUME OF THE BASIN AT CLEAN OUT SHALL BE 22 CUBIC YARDS PER ACRE.

THE 67 CUBIC YARDS OF STORAGE AREA PER ACRE DRAINED DOES NOT APPLY TO FLOWS FROM OFFSITE AREAS AND FLOWS FROM ONSITE AREAS THAT ARE EITHER UNDISTURBED OR HAVE UNDERGONE FINAL STABILIZATION WHERE SUCH FLOWS ARE DIVERTED AROUND BOTH THE DISTURBED AREA AND THE SEDIMENT BASIN. ANY TEMPORARY SEDIMENT BASINS CONSTRUCTED MUST BE BACKFILLED AND COMPACTED IN ACCORDANCE WITH THE SPECIFICATIONS FOR STRUCTURAL FILL. ALL SEDIMENT COLLECTED IN PERMANENT OR TEMPORARY SEDIMENT TRAPS MUST BE REMOVED UPON FINAL STABILIZATION.

OTHER CONTROLS

WASTE DISPOSAL (IF APPLICABLE):

WASTE MATERIALS

ALL WASTE MATERIALS EXCEPT LAND CLEARING DEBRIS SHALL BE COLLECTED AND STORED IN A SECURELY LIDDED METAL DUMPSTER. THE DUMPSTER WILL MEET ALL LOCAL AND STATE SOLID WASTE MANAGEMENT REGULATIONS. THE DUMPSTER WILL BE EMPTIED AS NEEDED AND THE TRASH WILL BE HAULED TO A STATE APPROVED LANDFILL. ALL PERSONNEL WILL BE INSTRUCTED REGARDING THE CORRECT PROCEDURE FOR WASTE DISPOSAL. NOTICES STATING THESE PRACTICES WILL BE POSTED AT THE CONSTRUCTION SITE BY THE CONSTRUCTION SUPERINTENDENT, THE INDIVIDUAL WHO MANAGES THE DAY—TO—DAY SITE OPERATIONS, WILL BE RESPONSIBLE FOR SEEING THAT THESE PROCEDURES ARE FOLLOWED.

HAZARDOUS WAST

ALL HAZARDOUS WASTE MATERIALS WILL BE DISPOSED OF IN THE MANNER SPECIFIED BY LOCAL OR STATE REGULATION OR BY THE MANUFACTURER. SITE PERSONNEL WILL BE INSTRUCTED IN THESE PRACTICES AND THE SITE SUPERINTENDENT, THE INDIVIDUAL WHO MANAGES DAY—TO—DAY SITE OPERATIONS, WILL BE RESPONSIBLE FOR SEEING THAT THESE PRACTICES ARE FOLLOWED.

SANITARY WASTE

ALL SANITARY WASTE WILL BE COLLECTED FROM THE PORTABLE UNITS AS NEEDED TO PREVENT POSSIBLE SPILLAGE. THE WASTE WILL BE COLLECTED AND DEPOSED OF IN ACCORDANCE WITH STATE AND LOCAL WASTE DISPOSAL REGULATIONS FOR SANITARY SEWER OR SEPTIC SYSTEMS.

OFFSITE VEHICLE TRACKING

A STABILIZED CONSTRUCTION ENTRANCE WILL BE PROVIDED TO HELP REDUCE VEHICLE TRACKING OF SEDIMENTS. THE PAVED STREET ADJACENT TO THE SITE ENTRANCE WILL BE SWEPT AS NEEDED TO REMOVE ANY EXCESS MUD, DIRT OR ROCK TRACKED FROM THE SITE. DUMP TRUCKS HAULING MATERIAL FROM THE CONSTRUCTION SITE WILL BE COVERED WITH A TARPAULIN.

INVENTORY FOR POLLUTION PREVENTION PLAN

THE MATERIALS OR SUBSTANCES LISTED BELOW ARE EXPECTED TO BE PRESENT ONSITE DURING CONSTRUCTION:

X Concrete	X Fertilizers	X Wood
X Asphalt	🛛 Petroleum Based Products	🛚 Masonry Blocks
X Tar	X Cleaning Solvents	X Roofing Materials
X Detergents	X Paints	X Metal Studs
	□	

SPILL PREVENTION

MATERIAL MANAGEMENT PRACTICES

THE FOLLOWING ARE THE MATERIAL MANAGEMENT PRACTICES:

THE FOLLOWING ARE THE MATERIAL MANAGEMENT PRACTICES THAT WILL BE USED TO REDUCE THE RISK OF SPILLS OR OTHER ACCIDENTAL EXPOSURE OF MATERIALS AND SUBSTANCES TO STORMWATER RUNOFF.

GOOD HOUSEKEEPING

THE FOLLOWING GOOD HOUSEKEEPING PRACTICES WILL BE FOLLOWED ONSITE DURING THE CONSTRUCTION PROJECT.

* AN EFFORT WILL BE MADE TO STORE ONLY ENOUGH PRODUCT REQUIRED TO DO THE JOB.

* ALL MATERIALS STORED ONSITE WILL BE STORED IN A NEAT, ORDERLY MANNER IN THEIR APPROPRIATE CONTAINERS AND, IF POSSIBLE, UNDER A ROOF OR OTHER ENCLOSURE.

* PRODUCTS WILL BE KEPT IN THEIR ORIGINAL CONTAINERS WITH THE ORIGINAL ORIGINAL MANUFACTURER'S LABEL.

* SUBSTANCES WILL NOT BE MIXED WITH ONE ANOTHER UNLESS RECOMMENDED BY THE MANUFACTURER.

* WHENEVER POSSIBLE, ALL OF A PRODUCT WILL BE USED UP BEFORE DISPOSING

OF THE CONTAINER.

* MANUFACTURER'S RECOMMENDATIONS FOR PROPER USE AND DISPOSAL WILL BE FOLLOWED.

* THE SITE SUPERINTENDENT WILL INSPECT DAILY TO ENSURE MATERIALS ONSITE RECEIVE PROPER USE AND DISPOSAL.

HAZARDOUS PRODUCTS

THESE PRACTICES ARE USED TO REDUCE THE RISKS ASSOCIATED WITH HAZARDOUS MATERIALS.

* PRODUCTS WILL BE KEPT IN ORIGINAL CONTAINERS UNLESS THEY ARE NOT

* ORIGINAL LABELS AND MATERIAL SAFETY DATA WILL BE RETAINED; THEY CONTAIN IMPORTANT PRODUCT INFORMATION.

* IF SURPLUS PRODUCT MUST BE DISPOSED OF, MANUFACTURER'S OR LOCAL AND STATE RECOMMENDED METHODS FOR PROPER DISPOSAL WILL BE

PRODUCT SPECIFIC PRACTICES

THE FOLLOWING PRODUCT SPECIFIC PRACTICES WILL BE FOLLOWED ONSITE:

ALL ONSITE VEHICLES WILL BE MONITORED FOR LEAKS AND RECEIVE REGULAR PREVENTIVE MAINTENANCE TO REDUCE THE CHANCE OF LEAKAGE. PETROLEUM PRODUCTS WILL BE STORED IN TIGHTLY SEALED CONTAINERS WHICH ARE CLEARLY LABELED. ANY ASPHALT SUBSTANCES USED ONSITE WILL BE APPLIED ACCORDING TO THE MANUFACTURER'S RECOMMENDATIONS.

FERTILIZERS

FERTILIZERS USED WILL BE APPLIED ONLY IN THE MINIMUM AMOUNTS RECOMMENDED BY THE MANUFACTURER. ONCE APPLIED, FERTILIZER WILL BE WORKED INTO THE SOIL TO LIMIT EXPOSURE TO STORMWATER. STORAGE WILL BE IN A COVERED AREA. THE CONTENTS OF ANY PARTIALLY USED BAGS OF FERTILIZER WILL BE TRANSFERRED TO A SEALABLE PLASTIC BIN TO AVOID SPILLS.

PAINTS

ALL CONTAINERS WILL BE TIGHTLY SEALED AND STORED WHEN NOT REQUIRED FOR USE. EXCESS PAINT WILL NOT BE DISCHARGED TO THE STORM SEWER SYSTEM BUT WILL BE PROPERLY DISPOSED OF ACCORDING

CONCRETE TRUCKS

CONCRETE TRUCKS WILL NOT BE ALLOWED TO WASH OUT OR DISCHARGE SURPLUS CONCRETE OR DRUM WASH WATER ON THE SITE.

TO MANUFACTURERS' INSTRUCTIONS OR STATE AND LOCAL REGULATIONS.

SPILL CONTROL PRACTICES

IN ADDITION TO THE GOOD HOUSEKEEPING AND MATERIAL MANAGEMENT PRACTICES DISCUSSED IN THE PREVIOUS SECTIONS OF THIS PLAN, THE FOLLOWING PRACTICES WILL BE FOLLOWED FOR SPILL PREVENTION AND CLEANUP:

MANUFACTURERS' RECOMMENDED METHODS FOR SPILL CLEANUP WILL BE CLEARLY POSTED ON SITE AND SITE PERSONNEL WILL BE MADE AWARE OF THE PROCEDURES AND THE LOCATION OF THE INFORMATION AND CLEANUP SUPPLIES.

MATERIALS AND EQUIPMENT NECESSARY FOR SPILL CLEANUP WILL BE KEPT IN THE MATERIAL STORAGE AREA ONSITE. EQUIPMENT AND MATERIALS WILL INCLUDE BUT NOT BE LIMITED TO BROOMS, DUST PANS, MOPS, RAGS, GLOVES, GOGGLES, LIQUID ABSORBENT (i.e. KITTY LITTER OR EQUAL), SAND, SAWDUST, AND PLASTIC AND METAL TRASH CONTAINERS SPECIFICALLY FOR THIS PURPOSE.

ALL SPILLS WILL BE CLEANED UP IMMEDIATELY AFTER DISCOVERY.

THE SPILL AREA WILL BE KEPT WELL VENTILATED AND PERSONNEL WILL WEAR APPROPRIATE PROTECTIVE CLOTHING TO PREVENT INJURY FROM CONTACT WITH A HAZARDOUS SUBSTANCE.

SPILL OF TOXIC OR HAZARDOUS MATERIAL WILL BE REPORTED TO THE APPROPRIATE STATE OR LOCAL GOVERNMENT AGENCY, REGARDLESS OF THE SIZE OF THE SPILL.

THE SPILL PREVENTION PLAN WILL BE ADJUSTED TO INCLUDE MEASURES TO PREVENT THIS TYPE OF SPILL FROM REOCCURRING AND HOW TO CLEAN UP THE SPILL IF THERE IS ANOTHER ONE. A DESCRIPTION OF THE SPILL, WHAT CAUSED IT, AND THE CLEANUP MEASURES WILL ALSO BE INCLUDED.

THE SITE SUPERINTENDENT RESPONSIBLE FOR THE DAY—TO—DAY SITE OPERATIONS, WILL BE THE SPILL PREVENTION AND CLEANUP COORDINATOR. HE/SHE WILL DESIGNATE AT LEAST ONE OTHER SITE PERSONNEL WHO WILL RECEIVE SPILL PREVENTION AND CLEANUP TRAINING. THESE INDIVIDUALS WILL EACH BECOME RESPONSIBLE FOR A PARTICULAR PHASE OF PREVENTION AND CLEANUP. THE NAMES OF RESPONSIBLE SPILL PERSONNEL WILL BE POSTED IN THE MATERIAL STORAGE AREA AND IF

MAINTENANCE/INSPECTION PROCEDURES

FOLLOWING ANY STORM EVENT OF 0.25 INCHES OR GREATER.

APPLICABLE, IN THE OFFICE TRAILER ONSITE.

EROSION AND SEDIMENT CONTROL INSPECTION AND MAINTENANCE PRACTICES

THE FOLLOWING ARE INSPECTION AND MAINTENANCE PRACTICES THAT WILL BE
USED TO MAINTAIN EROSION AND SEDIMENT CONTROLS.

NO MORE THAN 5 ACRES OF THE SITE WILL BE DENUDED AT ONE TIME

WITHOUT WRITTEN PERMISSION FROM THE ENGINEER.

ALL CONTROL MEASURES WILL BE INSPECTED BY THE SUPERINTENDENT,
THE PERSON RESPONSIBLE FOR THE DAY TO DAY SITE OPERATION OR
SOMEONE APPOINTED BY THE SUPERINTENDENT, AT LEAST ONCE A WEEK AND

ALL TURBIDITY CONTROL MEASURES WILL BE MAINTAINED IN GOOD WORKING ORDER; IF A REPAIR IS NECESSARY, IT WILL BE INITIATED WITHIN 24 HOURS OF REPORT.

BUILT UP SEDIMENT WILL BE REMOVED FROM SILT FENCE WHEN IT HAS REACHED ONE—THIRD THE HEIGHT OF THE FENCE.

* SILT FENCE WILL BE INSPECTED FOR DEPTH OF SEDIMENT, TEARS, TO

WHICHEVER COMES FIRST.

TO SEE THAT THE FENCE POSTS ARE FIRMLY IN THE GROUND.

* THE SEDIMENT BASINS WILL BE INSPECTED FOR THE DEPTH OF SEDIMENT, AND BUILT UP SEDIMENT WILL BE REMOVED WHEN IT REACHES 10 PERCENT OF THE DESIGN CAPACITY OR AT THE END OF THE JOB,

SEE IF THE FABRIC IS SECURELY ATTACHED TO THE FENCE POSTS, AND

* DIVERSION DIKES/SWALES WILL BE INSPECTED AND ANY BREACHES PROMPTLY REPAIRED.

* TEMPORARY AND PERMANENT SEEDING AND PLANTING WILL BE INSPECTED

* A MAINTENANCE INSPECTION REPORT WILL BE MADE AFTER EACH INSPECTION. A COPY OF THE REPORT FORM TO BE COMPLETED BY THE INSPECTOR IS ATTACHED.

THE REPORTS WILL BE KEPT ON SITE DURING CONSTRUCTION AND

PLANS, OR STORMWATER MANAGEMENT PLANS.
THE REPORTS SHALL BE MADE AND RETAINED AS PART OF THE STORM WATER POLLUTION PREVENTION PLAN FOR AT LEAST THREE YEARS FROM THE DATE THAT THE SITE IS FINALLY STABILIZED AND THE NOTICE OF TERMINATION IS SUBMITTED THE REPORTS SHALL IDENTIFY ANY INCIDENTS OF NON—COMPLIANCE.

AVAILABLE UPON REQUEST TO THE OWNER, ENGINEER OR ANY FEDERAL,

STATE OR LOCAL AGENCY APPROVING SEDIMENT AND AND EROSION

* THE SITE SUPERINTENDENT WILL SELECT UP TO THREE INDIVIDUALS WHO WILL BE RESPONSIBLE FOR INSPECTIONS, MAINTENANCE AND REPAIR ACTIVITIES, AND FILLING OUT THE INSPECTION AND MAINTENANCE REPORT

* PERSONNEL SELECTED FOR INSPECTION AND MAINTENANCE RESPONSIBILITIES WILL RECEIVE TRAINING FROM THE SITE. SUPERINTENDENT. THEY WILL BE TRAINED IN ALL THE INSPECTION AND MAINTENANCE PRACTICES NECESSARY FOR KEEPING THE EROSION AND SEDIMENT CONTROLS USED ONSITE IN GOOD WORKING ORDER.

NON-STORMWATER DISCHARGES

BASIN PRIOR TO DISCHARGE.

IT IS EXPECTED THAT THE FOLLOWING NON-STORMWATER DISCHARGES WILL OCCUR FROM THE SITE DURING THE CONSTRUCTION PERIOD:

* WATER FROM WATER LINE FLUSHING

* PAVEMENT WASH WATERS (WHERE NO SPILLS OR LEAKS OF TOXIC OR HAZARDOUS MATERIALS HAVE OCCURRED).

* UNCONTAMINATED GROUNDWATER (FROM DEWATERING EXCAVATION).

ALL NON-STORMWATER DISCHARGES WILL BE DIRECTED TO THE SEDIMENT

CONTRACTOR'S CERTIFICATION

I CERTIFY UNDER PENALTY OF LAW THAT I UNDERSTAND THE TERMS AND CONDITIONS OF THE GENERAL NATIONAL POLLUTANT DISCHARGE ELIMINATION SYSTEM (NPDES) PERMIT THAT AUTHORIZES THE STORMWATER DISCHARGES ASSOCIATED WITH INDUSTRIAL ACTIVITY FROM THE CONSTRUCTION SITE IDENTIFIED AS PART OF THIS CERTIFICATION.

RESPONSIBLE FOR/DUTIES	GENERAL CONTRACTOR	SUB-CONTRACTOR	SUB-CONTRACTOR	SUB-CONTRACTOR	SUB-CONTRACTOR
BUSINESS NAME AND ADDRESS OF CONTRACTOR & ALL SUBS					
SIGNATURE					

FINAL TAC ELEVATIONS ARE

II V I VAV D OO

C13 STORMWATER POLLUTION PREVENTION PLAN NOTES & SPECIFICATIONS

HKS

ARCHITECT
HKS ARCHITECTS, INC.

CORAL GABLES, FL 33134

INTERIOR DESIGNER

2020 SALZEDO STREET, 4TH FLOOR

HKS ARCHITECTS
225 EAST ROBINSON ST. SUITE #405

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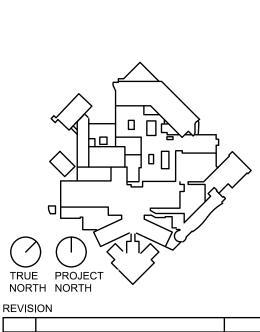
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MEMORIAL HEALTHCARE SYSTEM 3501 JOHNSON STREET HOLLYWOOD, FL 33021

Regional Hospital GICAL & CRITICAL CARE TOWER EXPANSION

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Engineer: James D. Messick
P.E. License No.: 70870
Date: 04/11/2024



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ISSUE FINAL TAC

STORMWATER POLLUTION PREVENTION PLAN NOTES & SPECIFICATIONS

SHEET NO.

PROJECT: SURGICAL & CRITICAL CARE TOWER EXPANSION STORMWATER POLLUTION PREVENTION PLAN INSPECTION AND MAINTENANCE REPORT FORM STRUCTURAL CONTROLS DATE:	FROM FROM FROM FROM FROM FROM FROM FROM	MAINTENANCE REQUIRED FOR EARTH DIKE/SWALE: TO BE PERFORMED BY: CATCH BASIN/CURB INLET/OUTFALL TURBIDITY CONTROLS STRUCTURE/ OUTFALL PLACE OR BYPASSING ? OF REPLACING CONTROL CONT	MAINTENANCE REQUIRED FOR CATCH BASIN/CURB INLETS/OUTFALLS TURBIDITY CONTROLS: TO BE PERFORMED BY: DAGE 2 OF 4	PROJECT: SURGICAL & CRITICAL CARE TOWER EXPANSION	STORMWATER POLLUTION PREVENTION PLAN INSPECTION AND MAINTENANCE REPORT FORM	CHANGES REQUIRED TO THE POLLUTION PREVENTION PLAN:	REASONS FOR CHANGES:	I CERTIFY UNDER PENALTY OF LAW THAT THIS DOCUMENT AND ALL ATTACHMENTS WERE PREPARED UNDER MY DIRECTION OR SUPERVISION IN ACCORDANCE WITH A SYSTEM DESIGNED TO ASSURE THAT QUALIFIED PERSONNEL PROPERLY GATHERED AND EVALUATED THE INFORMATION SUBMITTED. BASED ON MY INQUIRY OF THE PERSON OR PERSONS WHO MANAGE THE SYSTEM, OR THOSE PERSONS DIRECTLY RESPONSIBLE FOR GATHERING THE INFORMATION, THE INFORMATION SUBMITTED IS, TO THE BEST OF MY KNOWLEDGE AND BELIEF, TRUE, ACCURATE, AND COMPLETE. I AM AWARE THAT THERE ARE SIGNIFICANT PENALTIES FOR SUBMITTING FALSE INFORMATION, INCLUDING THE POSSIBILITY OF FINE AND IMPRISONMENT FOR KNOWING VIOLATIONS.	SIGNATURE:
PROJECT: SURGICAL & CRITICAL CARE TOWER EXPANSION	INSPECTOR: DATE: DATE: DATE: DATE: DAYS SINCE LAST RAINFALL AMOUNT OF LAST RAINFALL INCHES	CONDITION	TO BE PERFORMED BY: ON OR BEFORE:	PROJECT: SURGICAL & CRITICAL CARE TOWER EXPANSION	STORMWATER POLLUTION PREVENTION PLAN INSPECTION AND MAINTENANCE REPORT FORM SEDIMENT BASIN	DEPTH OF SEDIMENT SIDE BASIN BASIN EMBANKMENT ? CONDITION OF OUTFALL FROM EMBANKMENT ? SEDIMENT BASIN		STABILIZED CONSTRUCTION ENTRANCE DOES MUCH IS THE GRAVEL DOES ALL TRAFFIC IS THE CULVERT SEDIMENT GET CLEAN OR IS IT STABILIZED ENTRANCE TRACKED ON TO FILLED WITH ENTRANCE TO WORKING? ROAD ? SEDIMENT? LEAVE THE SITE ? (IF APPLICABLE)	MAINTENANCE REQUIRED FOR STABILIZED CONSTRUCTION ENTRANCE: TO BE PERFORMED BY: PAGE 3 OF 4

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FORT LAUDERDALE, FL 33316 STRUCTURAL ENGINEER

GMG STRUCTURAL ENGINEERS 14335 COMMERCE WAY MIAMI LAKES, FL 33016


MEP & FIRE PROTECTION TLC ENGINEERING SOLUTIONS, INC. 800 FAIRWAY DRIVE

DEERFIELD BEACH, FL 33441 **TELECOM & EQUIPMENT** SMITH SECKMAN REID, INC.

2995 SIDCO DRIVE NASHVILLE, TN 37204

OWNER MEMORIAL HEALTHCARE SYSTEM 3501 JOHNSON STREET HOLLYWOOD, FL 33021

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JAMES D. MESSICK, STATE OF FLORIDA, PROFESSIONAL ENGINEER, LICENSE NO. 70870. THIS ITEM HAS BEEN DIGITALLY SIGNED AND SEALED BY JAMES D. MESSICK ON THE DATE INDICATED HERE. PRINTED COPIES OF THIS DOCUMENT ARE NOT CONSIDERED SIGNED AND SEALED AND THE SIGNATURE MUST BE VERIFIED ON ANY ELECTRONIC

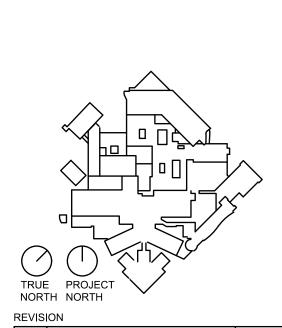HKS PROJECT NUMBER 23459.000

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JUNE 17, 2024

FINAL TAC

STORMWATER POLLUTION PREVENTION PLAN CONTRACTOR FORMS

SHEET NO.

C14

C14 STORMWATER POLLUTION PREVENTION PLAN CONTRACTOR FORMS

FINAL TAC

ELEVATIONS ARE IN NAVD 88