

ALL ELEVATIONS ARE REFERENCE! TO NAVD88 VERTICAL DATUM

LEGEND

PROPOSED CONCRETE PROPOSED ASPHALT PROPOSED GRADE EXISTING ELEVATION

PROPOSED CATCH BASIN EXISTING CATCH BASIN PROPOSED WATER METER

EXISTING WATER METER

EXISTING WATER VALVE

- CONTRACTOR TO LIFT GRATE OFF AREA DRAINS AND INSTALL FILTER FABRIC ACROSS INLET OPENING. REPLACE GRATE TO HOLD FABRIC SECURELY IN PLACE

1. FILTER FABRIC TO MEET

FDOT INDEX NO. 199,

2. CONTRACTOR TO REMOVE FILTER FABRIC FROM CATCH BASIN JUST

AND/OR SEALCOATING.

POST

FILTER FABRIC (IN

CONFORMANCE WITH SEC. 985 FDOT SPEC.

GRADE

PRIOR TO PAVING

POLLUTION PREVENTION FOR CATCH BASIN

6' MAX.

TYPE III SILT FENCE

ON ANY ELECTRONIC COPIES.

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280 SPECIFICATIONS AND FDOT SECTION 985.

CATCH BASIN -STRUCTURE

POST OPTIONS: WOOD 2 1/2" MIN. Ø

WOOD 2" X 4" OAK 1 1/2" X 1 1/2" STEEL

1.33 LBS/FT. MIN.—

No 76036

STATE OF

9-1-23

PROPOSED BFP DEVICE EXISTING SAN. SEWER MH

EXISTING FIRE HYDRANT

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P.E.#:76036

DATE: 8/29/23 SCALE: 1"=10'

1 OF 11

PROJECT NO.: 23-40

BMP NOTES:

Van Buren St

. ALL SEDIMENT CONTROL MEASURES ARE TO BE ADJUSTED TO MEET FIELD CONDITIONS AT THE TIME OF CONSTRUCTION AND BE CONSTRUCTED PRIOR TO ANY GRADING OR DISTURBANCE OF EXISTING SURFACE MATERIAL ON BALANCE OF SITE. PERIMETER SEDIMENT BARRIERS SHALL BE CONSTRUCTED TO PREVENT SEDIMENT OR TRASH FROM FLOWING OR FLOATING ON TO ADJACENT PROPERTIES.

2. PERIODIC INSPECTION AND MAINTENANCE OF ALL SEDIMENT CONTROL STRUCTURES MUST BE PROVIDED TO ENSURE INTENDED PURPOSE IS ACCOMPLISHED. THE DEVELOPER, OWNER AND/OR CONTRACTOR SHALL BE CONTINUALLY RESPONSIBLE FOR ALL SEDIMENT CONTROLS. SEDIMENT CONTROL MEASURES SHALL BE IN WORKING CONDITION AT THE END OF EACH WORKING DAY.

3. SEDIMENT WILL BE PREVENTED FROM ENTERING ANY STORM WATER SYSTEM, DITCH OR CHANNEL. ALL STORMWATER INLETS THAT ARE MADE OPERABLE DURING CONSTRUCTION SHALL BE PROTECTED SO THAT SEDIMENT-LADEN WATER CANNOT ENTER THE CONVEYANCE SYSTEM WITHOUT FIRST BEING FILTERED OR OTHERWISE TREATED TO REMOVE SEDIMENT.

4. WHERE CONSTRUCTION VEHICLE ACCESS ROUTES INTERSECT PAVED PUBLIC ROADS, PROVISIONS SHALL BE MADE TO MINIMIZE THE TRANSPORT OF SEDIMENT BY TRACKING ONTO THE PAVED SURFACE. WHERE SEDIMENT IS TRANSPORTED ONTO A PUBLIC ROAD SURFACE WITH CURBS AND GUTTERS, THE ROAD SHALL BE CLEANED THOROUGHLY AT THE END OF EACH DAY. SEDIMENT SHALL BE REMOVED FROM THE ROADS BY SHOVELING OR SWEEPING AND TRANSPORTED TO A SEDIMENT CONTROL DISPOSAL AREA. STREET WASHING SHALL BE ALLOWED ONLY AFTER SEDIMENT IS REMOVED IN THIS MANNER. THIS PROVISION SHALL APPLY TO INDIVIDUAL SUBDIVISION LOTS AS WELL AS TO LARGER LAND DISTURBING ACTIVITIES.

5. PERMANENT OR TEMPORARY SOIL STABILIZATION SHALL BE APPLIED TO DENUDED AREAS WITHIN SEVEN (7) DAYS AFTER FINAL GRADE IS REACHED ON ANY PORTION OF THE SITE. TEMPORARY SOIL STABILIZATION SHALL BE APPLIED WITHIN SEVEN (7) DAYS TO DENUDED AREAS THAT MAY NOT BE AT FINAL GRADE BUT WILL REMAIN UNDISTURBED FOR LONGER THAN THIRTY (30) DAYS. PERMANENT STABILIZATION SHALL BE APPLIED TO AREAS THAT ARE TO BE LEFT UNDISTURBED FOR MORE THAN ONE YEAR.

6. DURING CONSTRUCTION OF THE PROJECT, SOIL STOCKPILES SHALL BE STABILIZED, COVERED OR CONTAINED WITH SEDIMENT TRAPPING MEASURES. THE CONTRACTOR IS RESPONSIBLE FOR THE TEMPORARY PROTECTION AND PERMANENT STABILIZATION OF ALL SOIL STOCKPILES ON SITE AS WELL AS SOIL INTENTIONALLY TRANSPORTED FROM THE PROJECT SITE.


7. ALL TEMPORARY EROSION AND SEDIMENT CONTROL MEASURES SHALL BE REMOVED WITHIN 30 DAYS AFTER FINAL SITE STABILIZATION OR AFTER THE TEMPORARY MEASURES ARE NO LONGER NEEDED.

8. PROPERTIES AND WATER WAYS DOWNSTREAM FROM CONSTRUCTION SITE SHALL BE PROTECTED FROM SEDIMENT DEPOSITION AND EROSION AT ALL TIMES DURING CONSTRUCTION.

9. CONTRACTOR IS RESPONSIBLE FOR ALL SURFACE WATER DISCHARGES, RAINFALL RUN OFF OR DEWATERING ACTIVITIES.

10. CONTRACTOR MUST INCORPORATE ALL BMP'S NECESSARY TO MEET OR EXCEED STATE WATER QUALITY AND SWPPP REQUIREMENTS.

11. THE POLLUTION PREVENTION PLAN IS A MINIMUM GUIDELINE ONLY. ADDITIONAL BMP'S MAY BE NECESSARY AT CONTRACTOR'S EXPENSE.

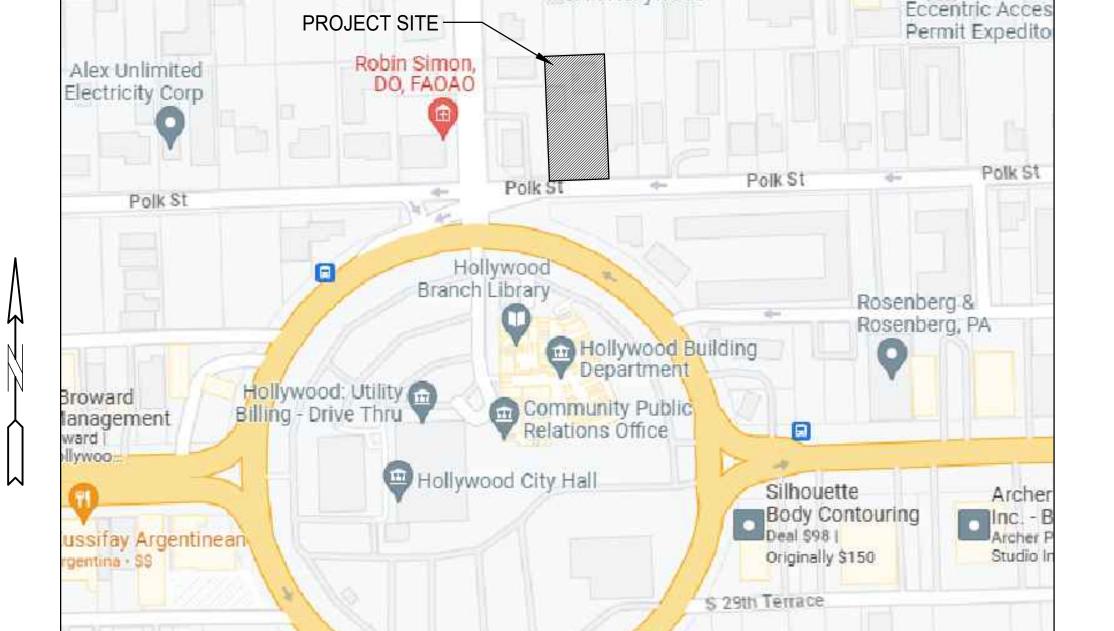


Ben Gamla

Charter School


LOCATION MAP NOT TO SCALE

Van Buren St


EROSION & SEDIMENT CONTROL PLAN

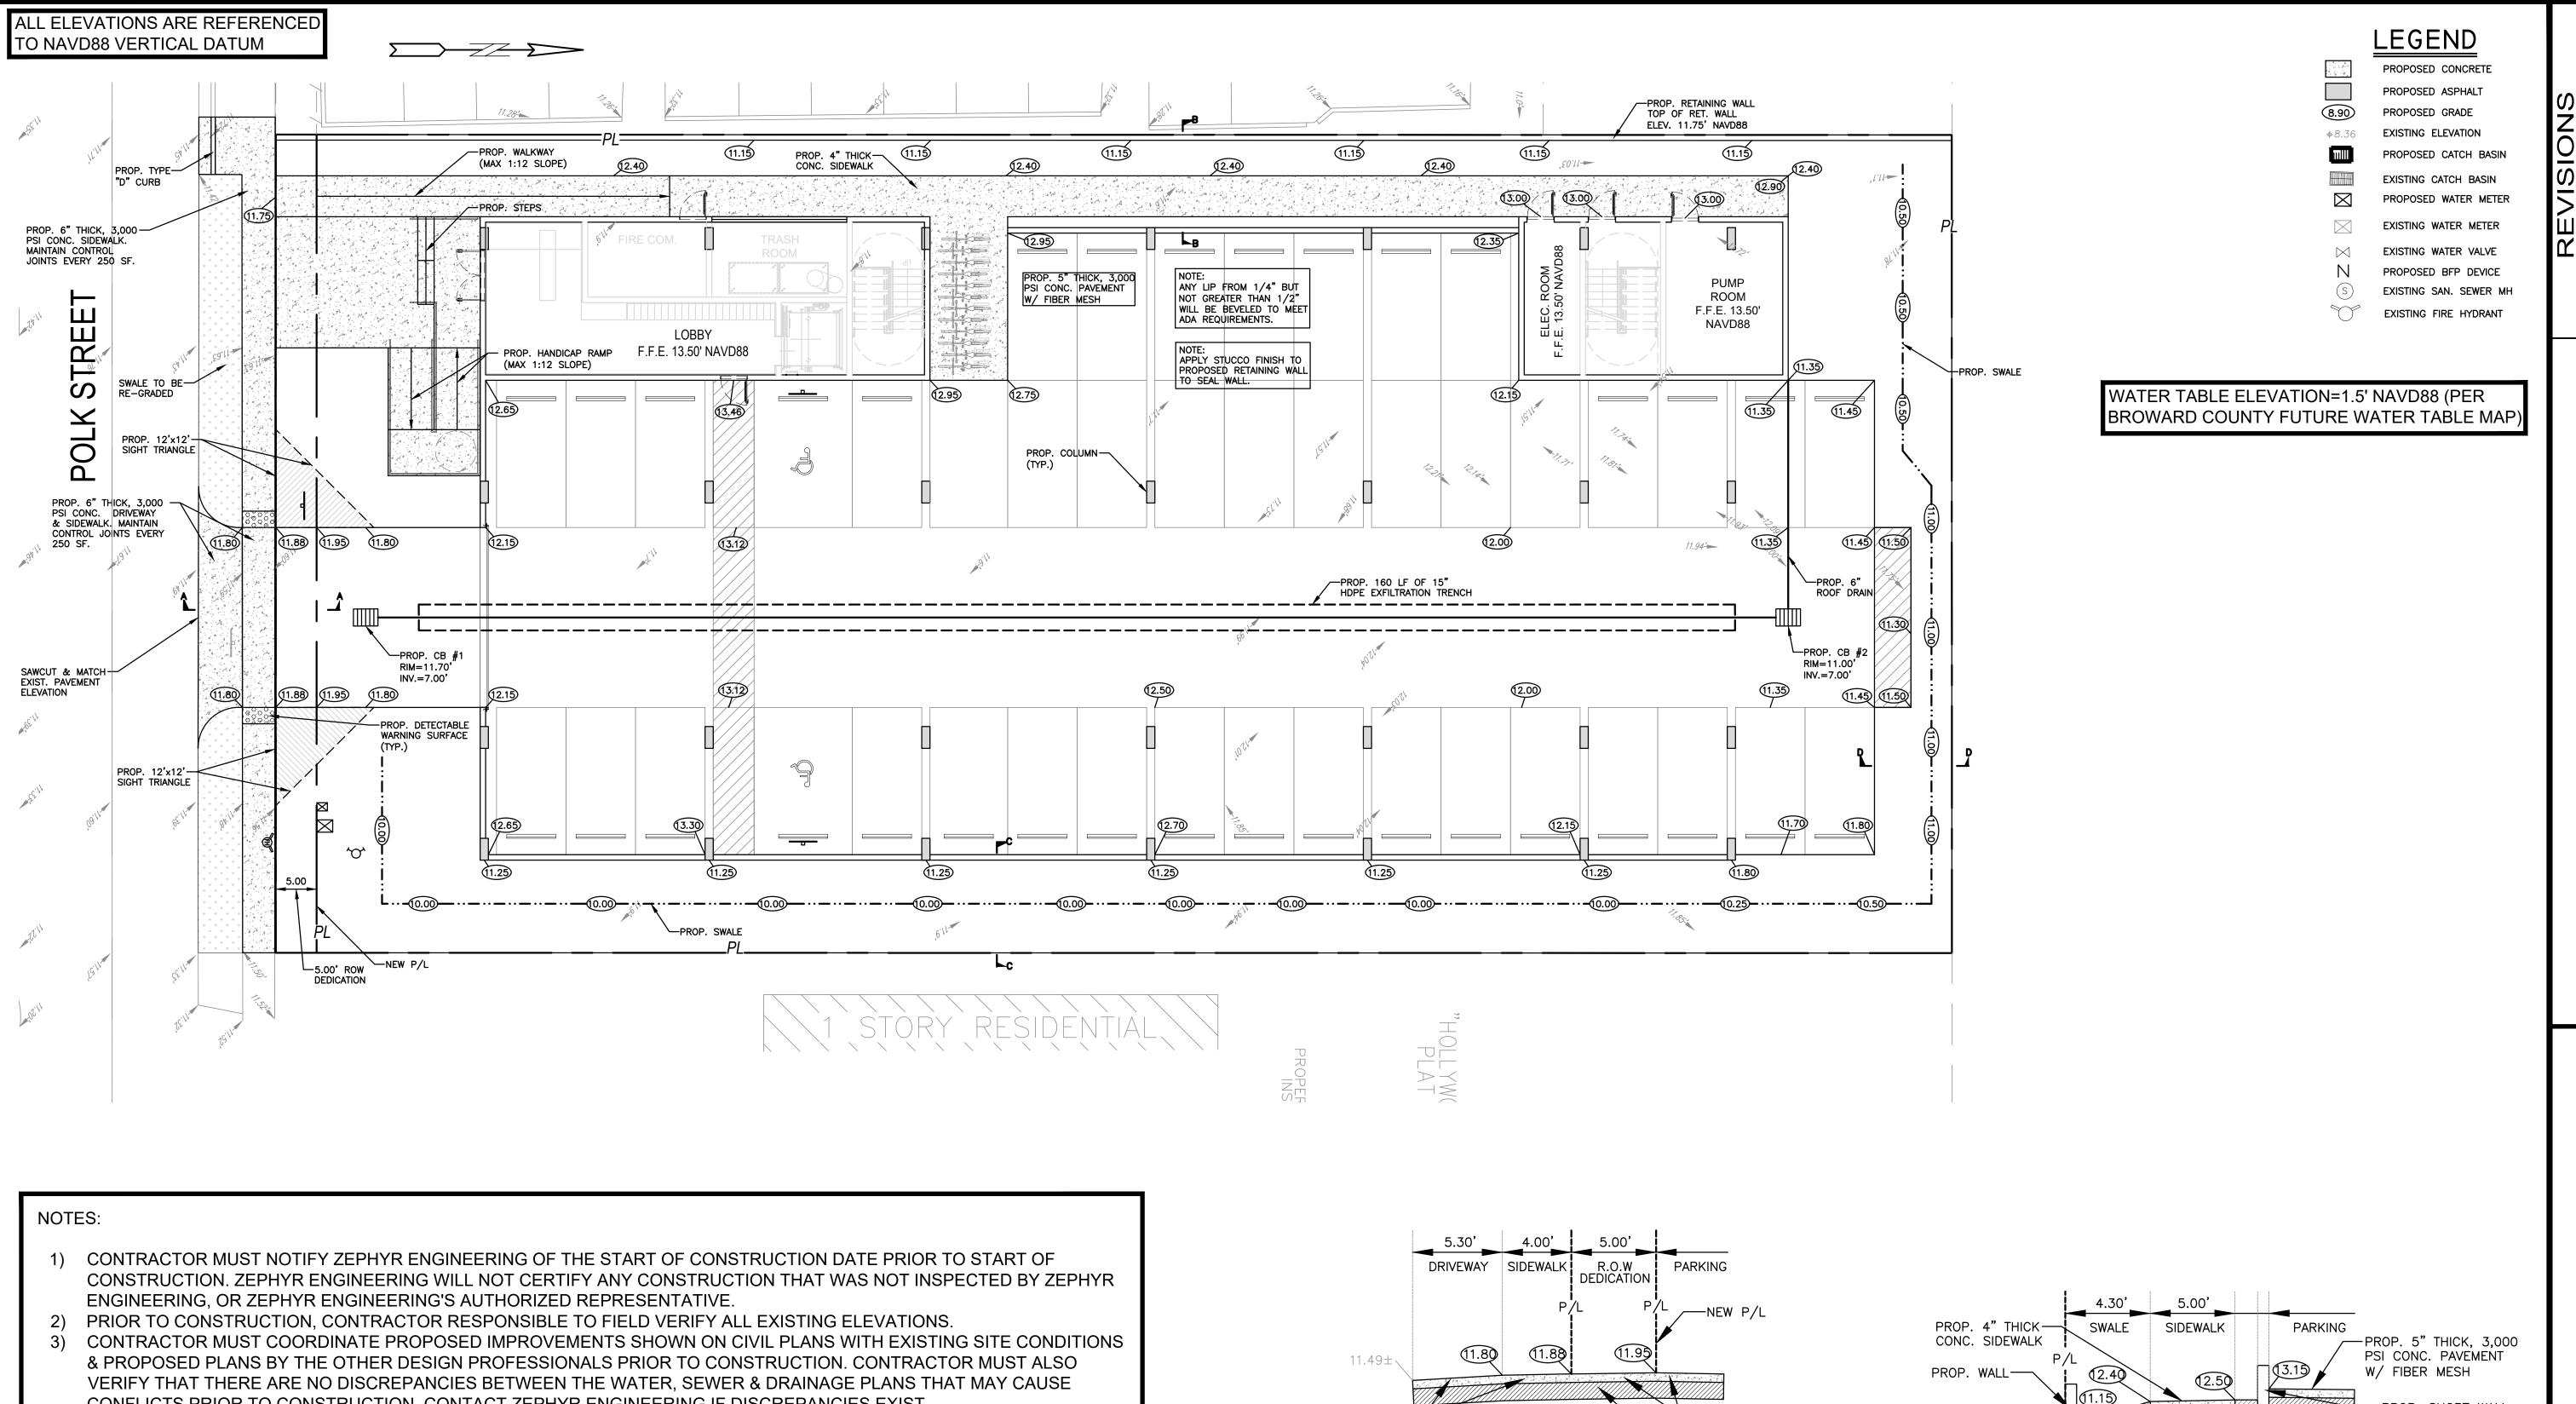

- CONFLICTS PRIOR TO CONSTRUCTION. CONTACT ZEPHYR ENGINEERING IF DISCREPANCIES EXIST.
- 4) PRIOR TO CONSTRUCTION, CONTRACTOR RESPONSIBLE TO DOCUMENT EXISTING CONDITIONS ON AND AROUND THE PROJECT AREA, INCLUDING THE R.O.W. AND ADJACENT PROPERTIES. IT'S RECOMMENDED THAT CONTRACTOR TAKE PHOTOGRAPHS & VIDEOS TO CLEARLY DOCUMENT CONDITIONS PRIOR TO CONSTRUCTION. CONTRACTOR RESPONSIBLE TO REPAIR ALL DAMAGES CAUSED BY OR AS A RESULT OF THE PROPOSED CONSTRUCTION.
- 5) ALL ROOF DRAINS MUST BE CONNECTED TO THE ONSITE DRAINAGE SYSTEM.
- 6) CONTRACTOR TO REFER TO ARCHITECTURAL PLANS FOR SITE PLAN LAYOUT AND DIMENSIONS.
- 7) EXISTING UTILITIES SHOWN ARE BASED ON BEST AVAILABLE INFORMATION. CONTRACTOR'S RESPONSIBLE TO FIELD VERIFY LOCATION OF ALL EXISTING UTILITIES PRIOR TO CONSTRUCTION. CONTRACTOR TO BE AWARE THAT THERE MAY BE SOME EXISTING UTILITIES ON OR ADJACENT TO THE PROJECT SITE THAT MAY NOT BE SHOWN ON THE CIVIL PLANS, AND CONTRACTOR IS RESPONSIBLE TO FIELD VERIFY THOSE UTILITIES AS WELL. CONTRACTOR RESPONSIBLE FOR RELOCATION OF EXISTING UTILITIES THAT CONFLICTS WITH PROPOSED CONSTRUCTION.

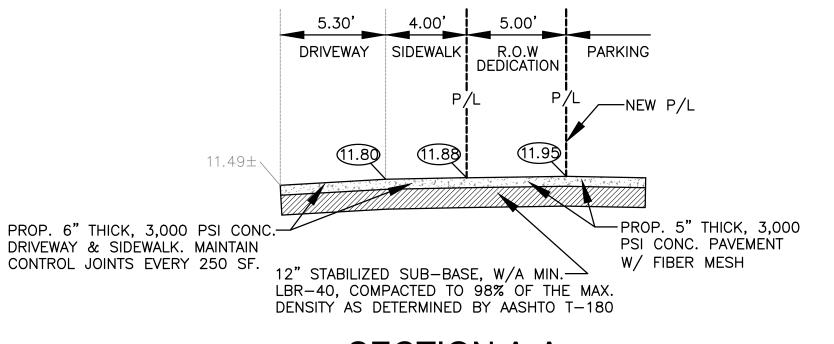

SECTION A-A N.T.S.

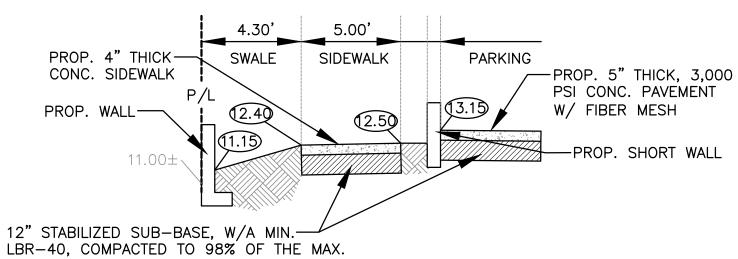

SECTION B-B N.T.S.



DENSITY AS DETERMINED BY AASHTO T-180

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PAVING, GRADING & DRAINAGE PLAN SCALE: 1"=10'

P.E.#:76036

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RTME

DATE: 8/29/23 SCALE: 1"=10' SHEET NO .:

2 OF 11

PROJECT NO.: 23-40

I. THE LOCATION OF EXISTING UTILITIES AND TOPOGRAPHY HAS BEEN PREPARED FROM THE MOST RELIABLE INFORMATION AVAILABLE TO THE ENGINEER. THIS INFORMATION IS NOT GUARANTEED AND IT IS THE RESPONSIBILITY OF THE CONTRACTOR TO DETER-MINE THE EXACT LOCATION OF ALL EXISTING UTILITIES AND TOPOGRAPHY PRIOR TO CONSTRUCTION.

2. PRIOR TO CONSTRUCTION THE CONTRACTOR IS TO NOTIFY THE FOLLOWING

COMPANIES & AGENCIES AND ANY OTHERS SERVING THE AREA: FLORIDA POWER & LIGHT CO., CONSTRUCTION

COMCAST

LOCAL CITY / COUNTY ENGINEERING & UTILITY DEPARTMENTS FLORIDA DEPARTMENT OF TRANSPORTATION (FDOT), AS APPLICABLE UNDERGROUND UTILITIES NOIFICATION CENTER OF FLORIDA (S.U.N.S.H.I.N.E.)

PAVING, GRADING & DRAINAGE NOTES:

ALL UNSUITABLE MATERIALS, SUCH AS MUCK, HARDPAN, ORGANIC MATERIAL & OTHER DELETERIOUS MATERIAL AS CLASSIFIED BY AASHTO M-145, FOUND WITHIN THE ROAD & PARKING LOT AREAS SHALL BE REMOVED DOWN TO ROCK OR SUITABLE MATERIAL, & REPLACED W/ THE SPECIFIED FILL MATERIAL IN MAXIMUM 12" LIFTS COMPACTED TO NOT LESS THAN 100% MAXIMUM DRY DENSITY AT OPTIMUM MOISTURE IN ACCORDANCE W/ AASHTO T-99. THICKNESS OF LAYERS MAY BE INCREASED PROVIDED THE EQUIPMENT & METHODS USED ARE PROVEN BY FIELD DENSITY TESTING TO BE CAPABLE OF COMPACTING THICK LAYERS TO SPECIFIED DENSITIES.

2. ALL AREAS SHALL BE CLEARED & GRUBBED PRIOR TO CONSTRUCTION. THIS SHALL CONSIST OF THE COMPLETE REMOVAL & DISPOSAL OF ALL TREES, BRUSH, STUMPS, ROOTS, GRASS, WEEDS, RUBBISH & ALL OTHER OBSTRUCTION RESTING ON OR PROTRUDING THROUGH THE SURFACE OF THE EXIST. GROUND TO A DEPTH OF 12". ITEMS DESIGNATED TO REMAIN OR TO BE RELOCATED OR ADJUSTED SHALL BE SO DESIGNATED ON THE DWGS.

3. FILL MATERIAL SHALL BE CLASSIFIED AS A-1, A-3 OR A-2.4 IN ACCORDANCE W/ AASHTO M-145 & SHALL BE FREE FROM VEGETATION & ORGANIC MATERIAL. NOT MORE

THAN 12% BY WEIGHT OF FILL MATERIAL SHALL PASS THE NO. 200 SIEVE. 4. THE CONTRACTOR SHALL BE RESPONSIBLE FOR PROVIDING CERTIFIED MATERIAL TEST RESULTS TO THE ENGINEER OF RECORD PRIOR TO THE RELEASE OF FINAL CERTIFICATION BY THE ENG. TEST RESULTS MUST INCLUDE BUT MAY NOT BE LIMITED TO, DENSITIES FOR SUBGRADE & LIME ROCK, UTILITIES, EXCAVATION, ASPHALT GRADIATION REPORTS, CONC.

5. ALL INLETS & PIPE SHALL BE PROTECTED DURING CONSTRUCTION TO PREVENT SILTATION IN THE DRAINAGE SYSTEMS BY WAY OF TEMPORARY PLUGS & PLYWOOD OR PLASTIC COVERS OVER THE INLETS. THE ENTIRE DRAINAGE SYSTEM TO BE CLEAN OF DEBRIS PRIOR TO FINAL

6. WHERE NEW ASPHALT MEETS OR ABUTS EXIST. ASPHALT, THE EXIST. ASPHALT SHALL BE SAWCUT TO PROVIDE A STRAIGHT EVEN LINE. PRIOR TO REMOVING CURB OR GUTTER, THE ADJACENT ASPHALT SHALL ALSO BE SAWCUT TO PROVIDE A STRAIGHT EVEN LINE.

ALL PROPOSED GRADES (ELEVATIONS) REFER TO ASPHALT GRADES UNLESS INDICATED

8. SITE GRADING SHALL BE W/IN 0.1' OF THE REQUIRED ELEVATION & ALL AREAS SHALL BE

9. ALL SUBGRADE SHALL HAVE AN LBR OF 40 UNLESS OTHERWISE NOTED & SHALL BE

COMPACTED TO 98% MAXIMUM DRY DENSITY PER AASHTO T-99.

10. ALL LIMEROCK SHALL BE COMPACTED TO 98% PER AASHTO T-180 & HAVE NOT LESS THAN 60% OF CARBONATES OF CALCIUM & MAGNESIUM UNLESS OTHERWISE DESIGNATED. ALL LIMEROCK SHALL BE PRIMED.

11 CONCRETE & ASPHALT THICKNESS SHALL BE OF TYPE DESIGNATED ON DWGS. (SEE SECTIONS)

12. PLASTIC FILTER FABRIC SHALL BE MIRAFI, TYPAR OR EQUAL CONFORMING TO SECTION 985 OF THE FDOT STANDARD SPECIFICATIONS. 13. CONC. SIDEWALKS SHALL BE 4" THICK ON COMPACTED SUBGRADE, W/ 1/2" EXPANSION

JOINTS PLACED AT A MAXIMUM OF 75'. CRACK CONTROL JOINTS SHALL BE 5' ON CENTER. THE BACK OF SIDEWALK ELEVATION SHALL EQUAL THE CROWN OF ROADWAY, UNLESS SPECIFIED OTHERWISE BY LOCAL CODES OR INDICATED ON DWGS. ALL CONC. SIDEWALKS THAT CROSS DRIVEWAYS SHALL BE 6" THICK.

14. PIPE SPECIFICATIONS: THE MATERIAL TYPE IS SHOWN ON THE DRAWINGS BY ONE OF THE FOLLOWING DESIGNATIONS -

RCP = REINFORCED CONC. PIPE, ASTM DESIGNATION C-76, TABLE III CMP = CORRUGATED METAL (ALUM.) PIPE, TM DESIGNATION M-196CMP = (SMOOTH LINED) CORRUGATED METAL (ALUM.) PIPE, ASTM DESIGNATION M-196

SCP = SLOTTED CONC. PIPE, FDOT SECTIONS 941 & 942 PVC = POLYVINYLCHLORIDE PIPE PCMP = PERFORATED CMP, FDOT SECTION 945

DIP = DUCTILE IRON PIPE HDPE = HIGH DENSITY POLYETHYLENE PIPE.

15. ASPHALT -


BITUMINOUS MATERIAL SHALL BE ASPHALT CEMENT, VISCOSITY GRADE AC-20, CONFORMING TO THE REQUIREMENTS OF FDOT STANDARD SPECIFICATIONS, 1986 EDITION, SECTION 916-1 PRIME COAT SHALL BE CUT BACK ASPHALT, GRADE RC-70 OR RC-250 CONFORMING TO THE REQUIREMENTS SPECIFIED IN AASHTO DESIGNATION M-81-75 (1982). RATE - 0.10 GALS./S.Y. TACK COAT SHALL BE EMULSIFIED ASPHALT, GRADE RS-2 CONFORMING TO THE REQUIREMENTS SPECIFIED IN AASHTO DESIGNATION M-140-82. RATE - 0.02 TO 0.08


DESIGN MIX SHALL CONFORM TO FDOT SECTION 331 UNLESS OTHERWISE SPECIFIED.

PAVEMENT MARKING & SIGNING STANDARD NOTES :


- 1. STOP SIGNS SHALL BE 30"x30" (R1-1), HIGH INTENSITY.
- 2. ALL SIGNS SHALL BE PLACED AT A HEIGHT NOT LESS THAN 5' & NOT GREATER THAN 7', THE HEIGHT IS MEASURED FROM THE BOTTOM OF THE SIGN TO THE EDGE OF NEAREST PAVEMENT. THE SIGN POST SHALL BE PLACED A MINIMUM OF 6' TO A MAXIMUM OF 12' FROM THE ADJACENT PAVEMENT, & A MINIMUM OF 6' FROM THE CROSS TRAFFIC
- 3. STOP BARS SHALL BE 24" WHITE.
- 4. ALL SITE PAVEMENT MARKINGS SHALL BE PAINT. (UNLESS INDICATED OTHERWISE)
- 5. ALL PAVEMENT MARKINGS AND SIGNAGE IN THE ROAD RIGHT-OF-WAY SHALL BE THERMOPLASTIC & SHALL CONFORM TO MUTCD AND PBC TYPICAL T-P-06-001.


ALL ELEVATIONS ARE REFERENCED TO NAVD88 VERTICAL DATUM

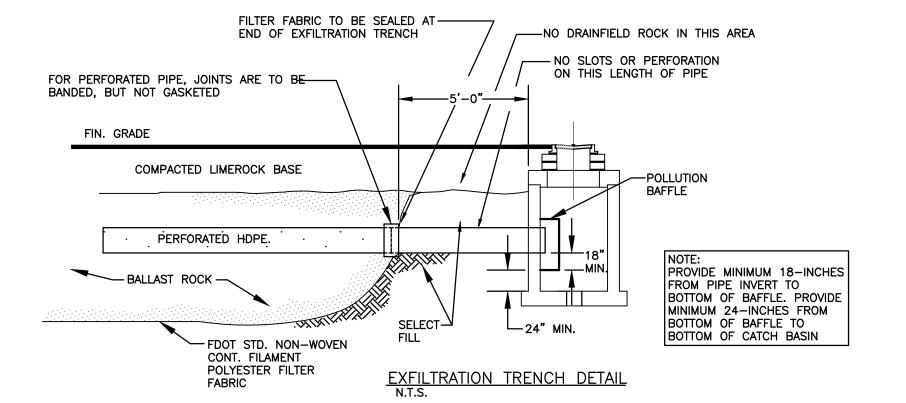


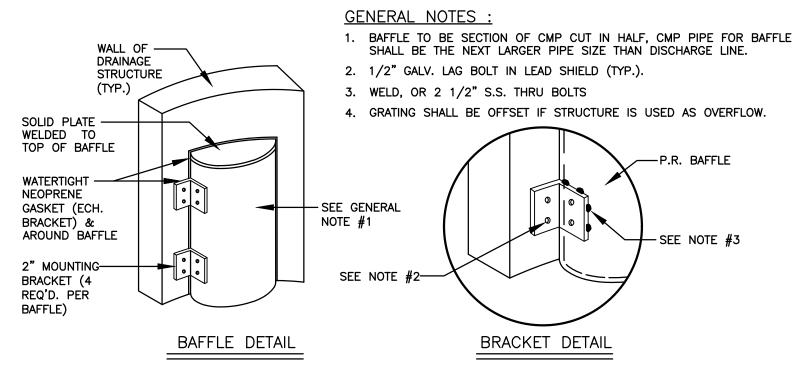


POLLUTION RETARDANT BAFFLE DETAIL

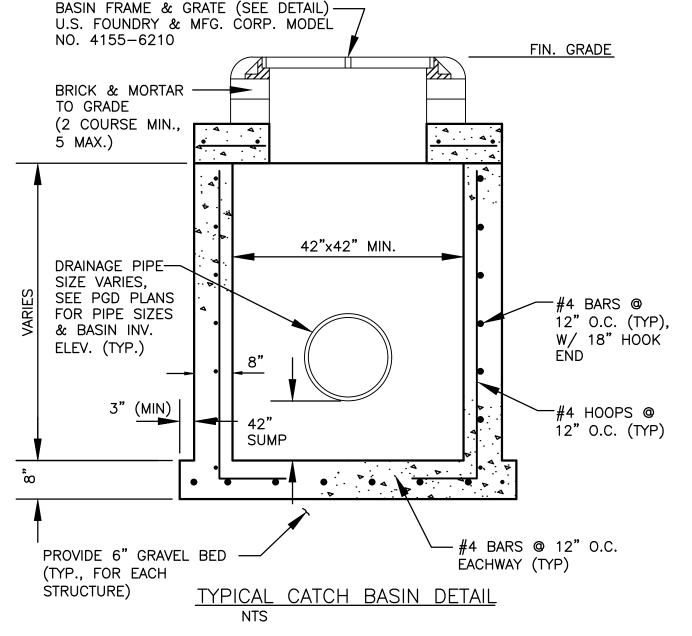

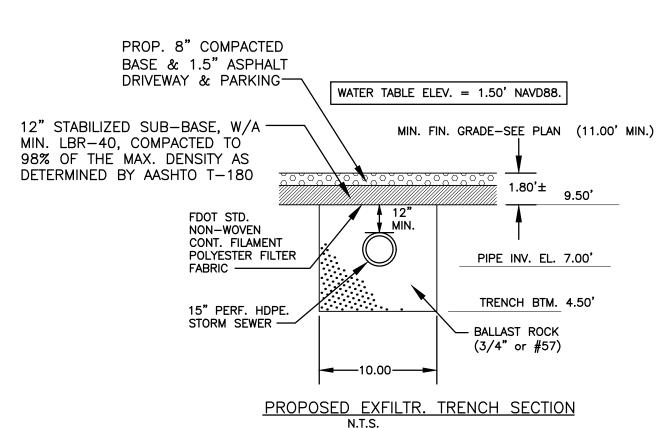


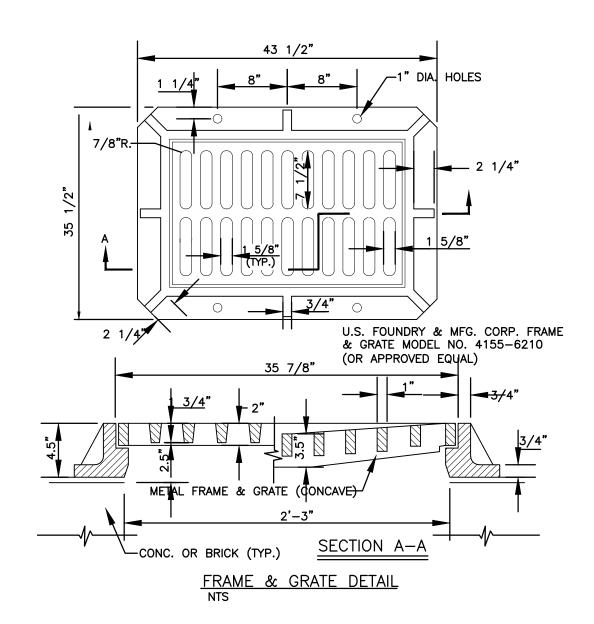

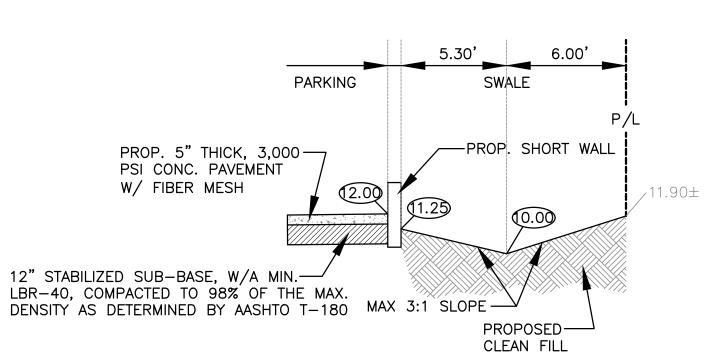

SECTION C-C

N.T.S.

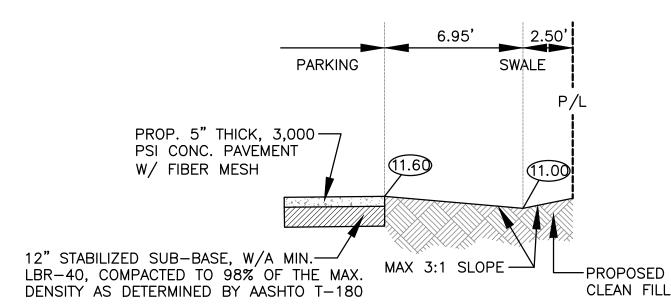

SECTION D-D N.T.S.



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DATE: 8/29/23 SCALE: N.T.S. SHEET NO.:


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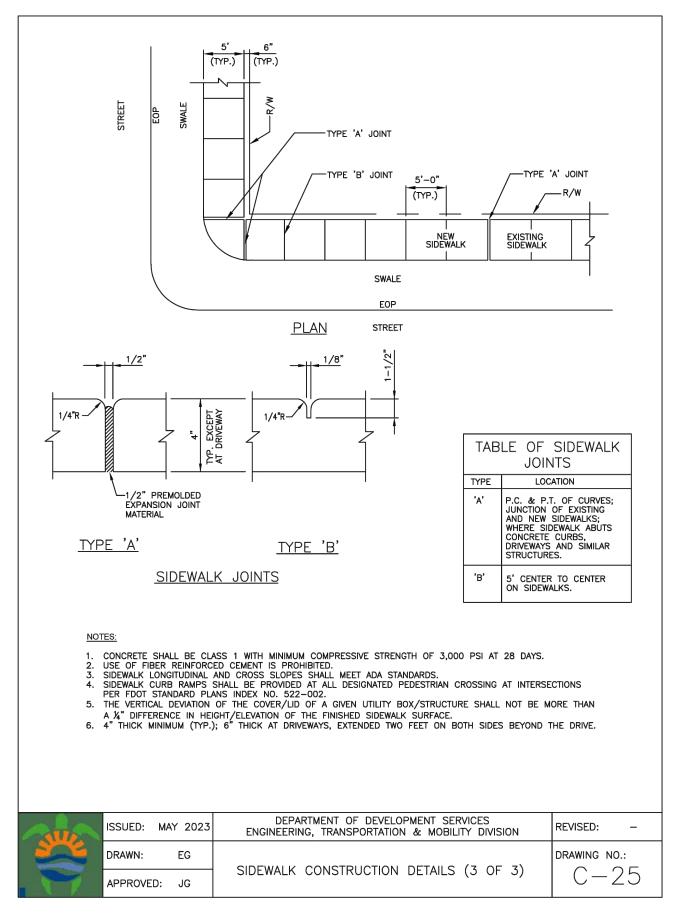
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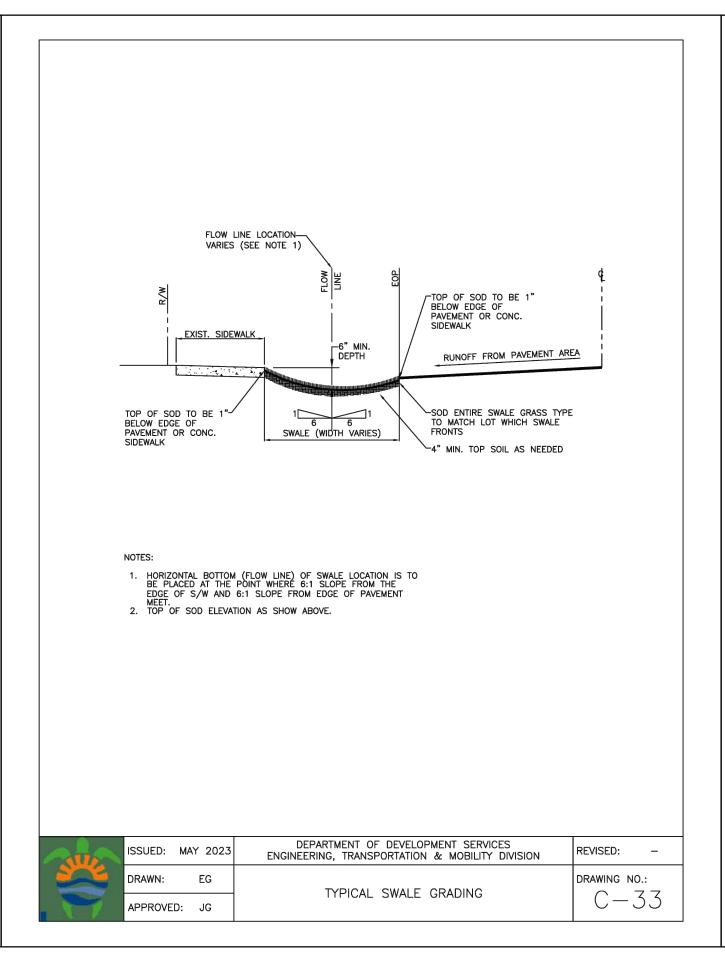
3 OF 11 PROJECT NO.: 23-40


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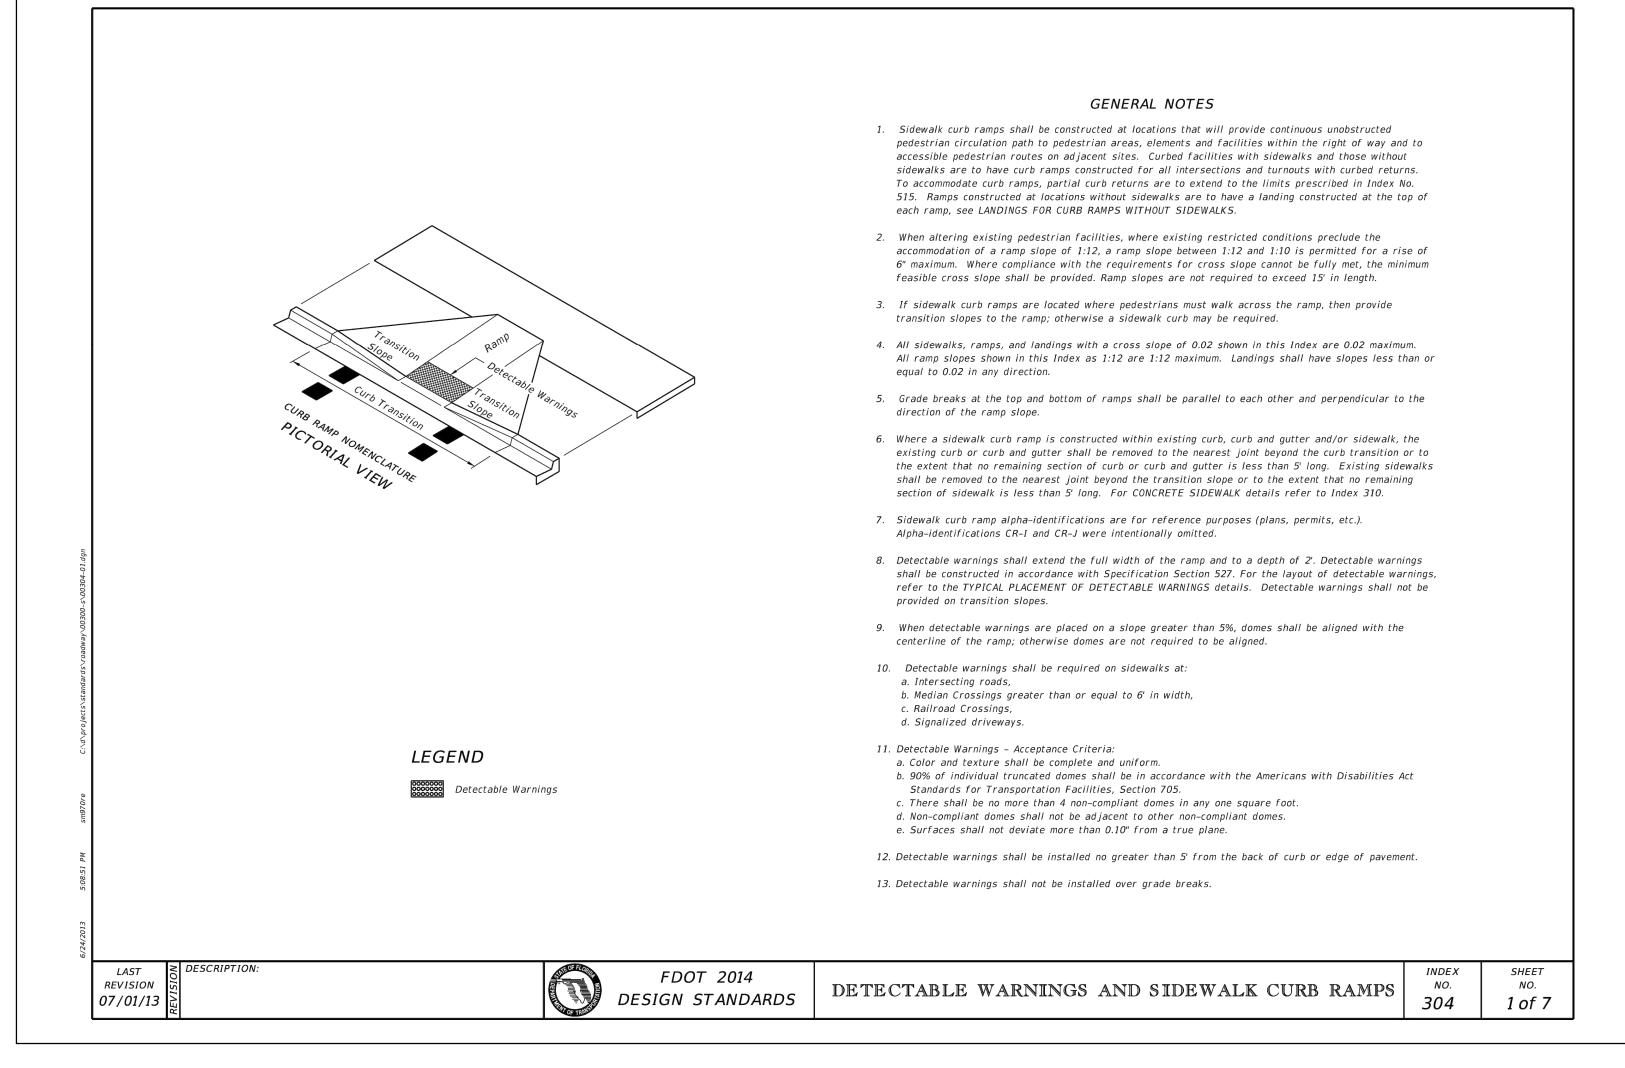
CIVIL DETAILS I SCALE: N.T.S.







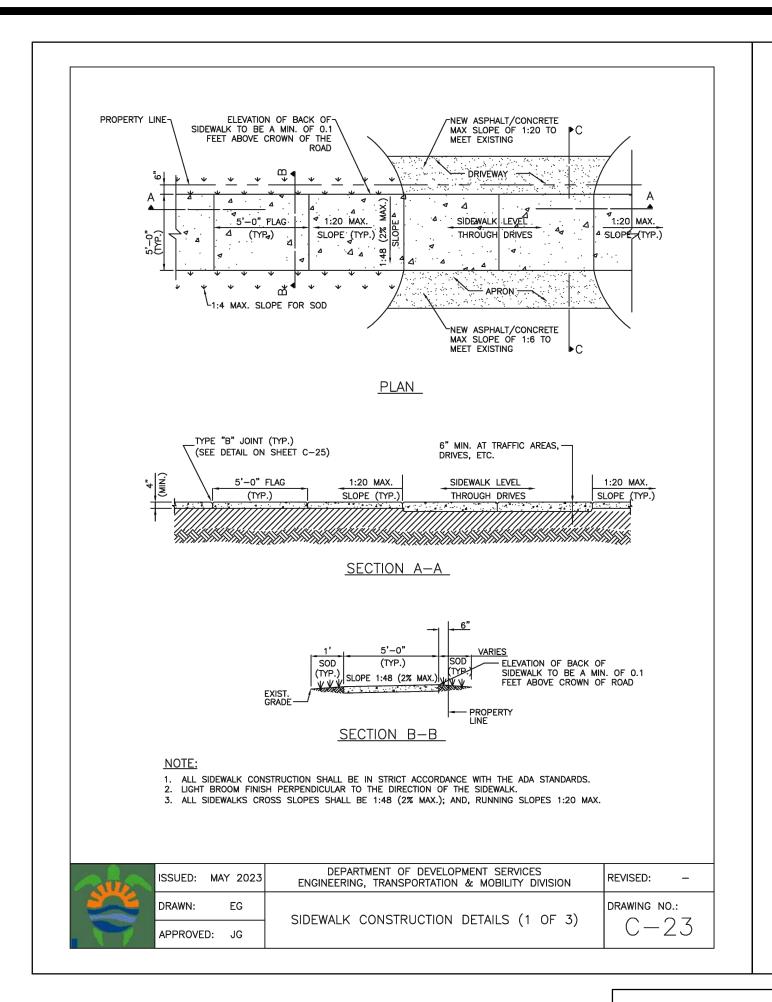

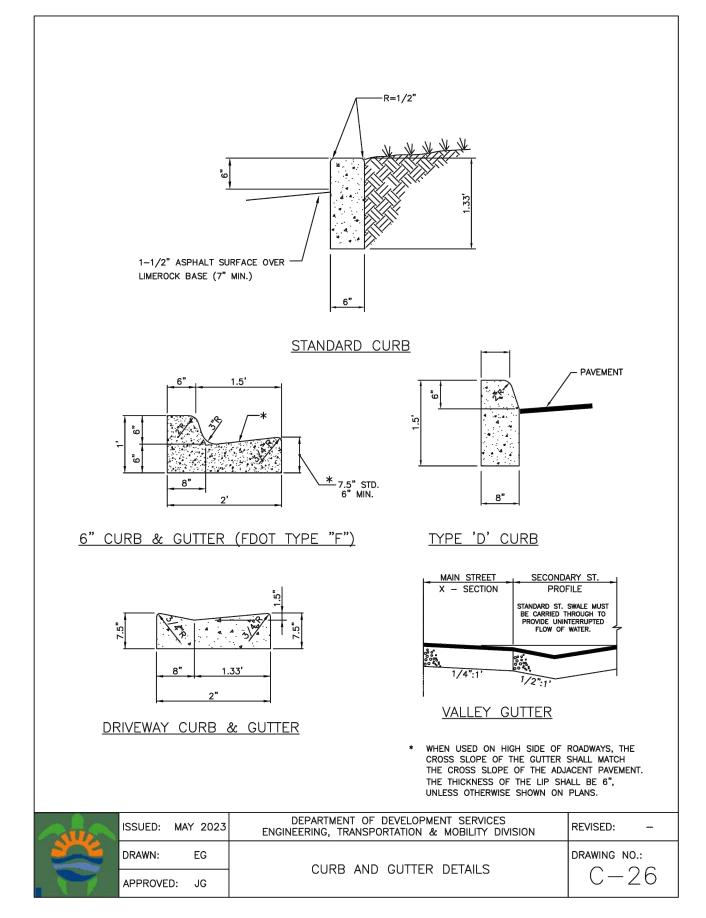



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9-1-23


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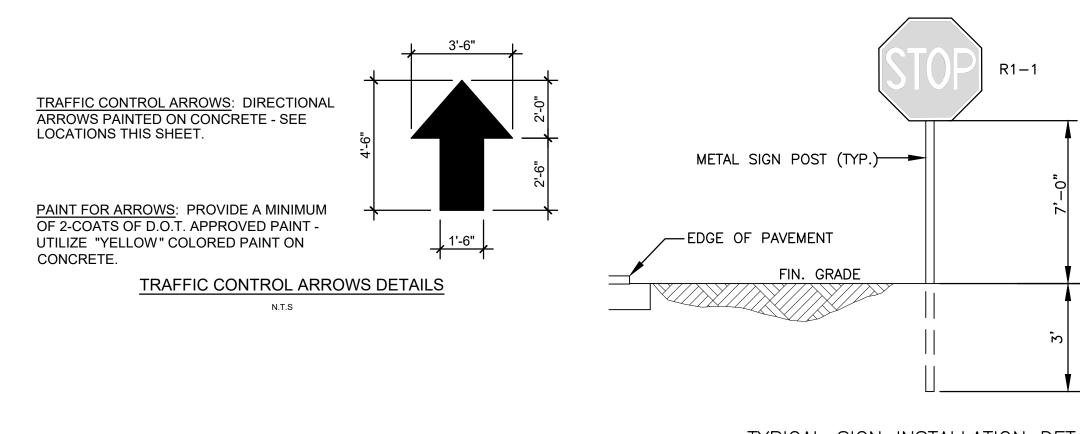
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SHEET NO.: 4 OF 11 PROJECT NO.: 23-40

CIVIL DETAILS II





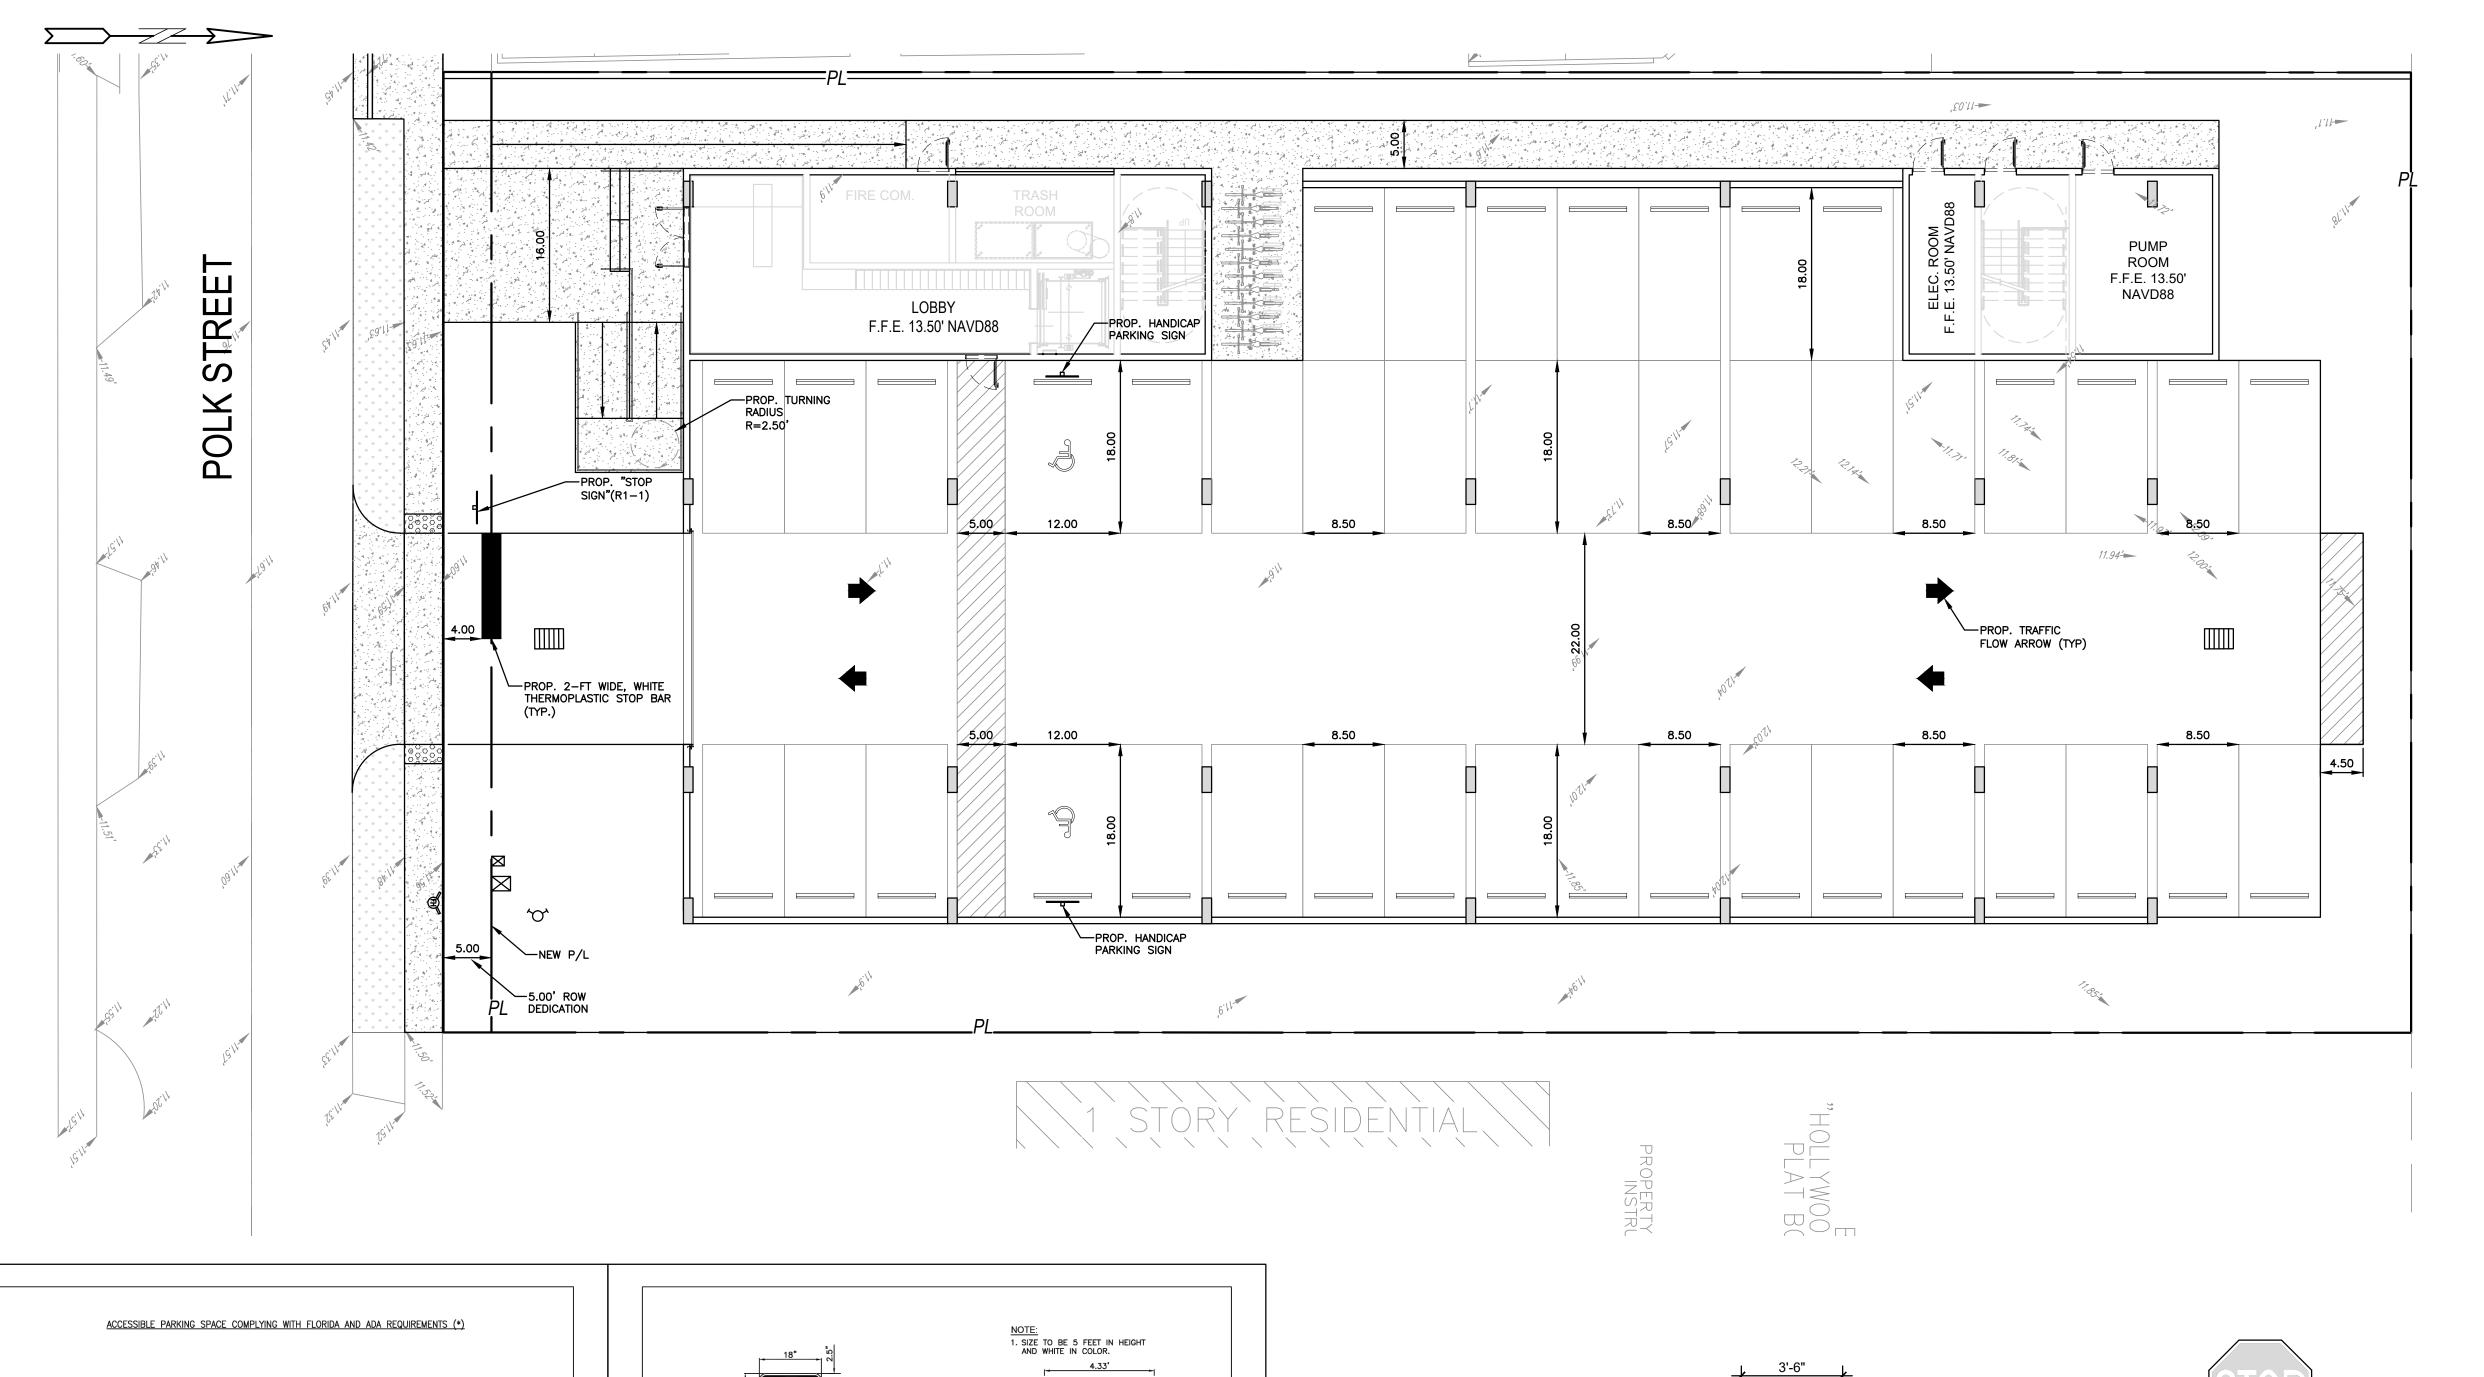

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PAVEMENT MARKINGS & SIGNAGE PLAN

SCALE: 1"=10'

P.E.#:76036

TREI FL 3

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DATE: 8/29/23 SCALE: 1"=10'

5 OF 11

ACCESSIBLE PARKING SIGN—RECOMMENDED LOCATION (TYP.) SIDEWALK r(3) 4" White Diagonals Equally spaced per AISLE 5' (TYP.) 12' (TYP.) 5' (TYP.) 12' (TYP.) (*) IN CASE OF CONFLICT PLANS TO COMPLY WITH ADA 406 & 502, AND FDOT 711-001 (SHEET 11)


DEPARTMENT OF DEVELOPMENT SERVICES ENGINEERING, TRANSPORTATION & MOBILITY DIVISION


ACCESIBLE PARKING SPACE DETAILS

(1 OF 2)

REVISED: -

DRAWING NO.:

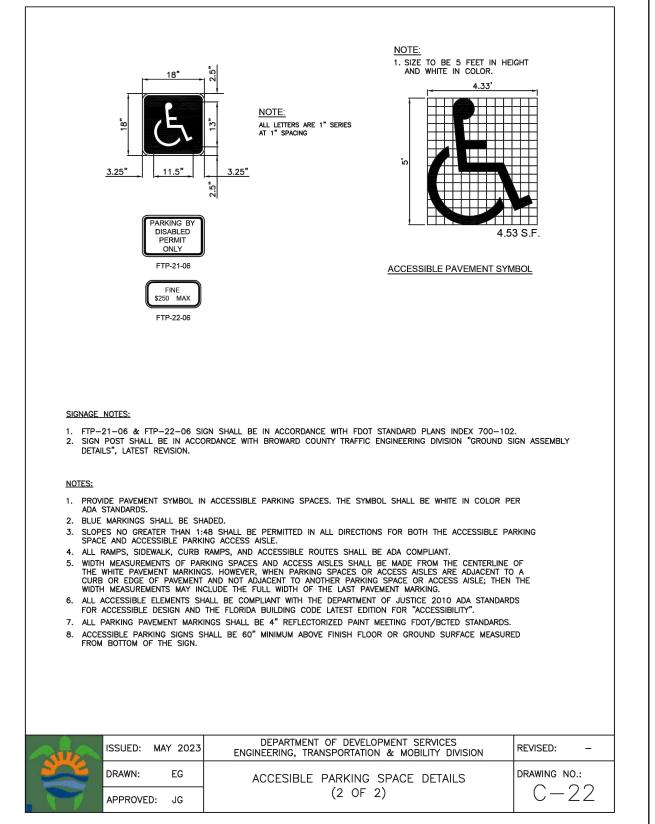

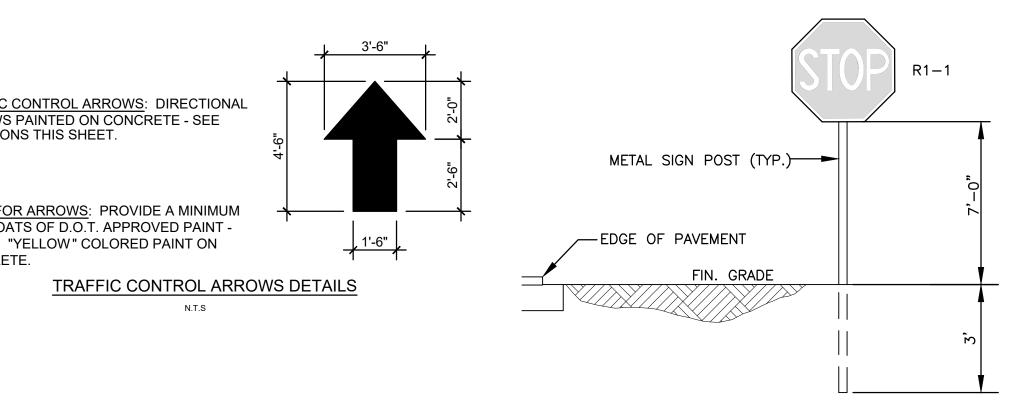

TYPICAL SIGN INSTALLATION DETAIL NTS

SHEET NO .:

ALL ELEVATIONS ARE REFERENCED

LEGEND

PROPOSED CONCRETE

PROPOSED ASPHALT

PROPOSED GRADE EXISTING ELEVATION

PROPOSED CATCH BASIN

PROPOSED WATER METER

EXISTING WATER METER

EXISTING WATER VALVE

PROPOSED BFP DEVICE

EXISTING FIRE HYDRANT

EXISTING SAN. SEWER MH

EPHYR, P.E. (000), FL


ZEPHY

EXISTING CATCH BASIN

TO NAVD88 VERTICAL DATUM

8.90

PROJECT NO.: 23-40

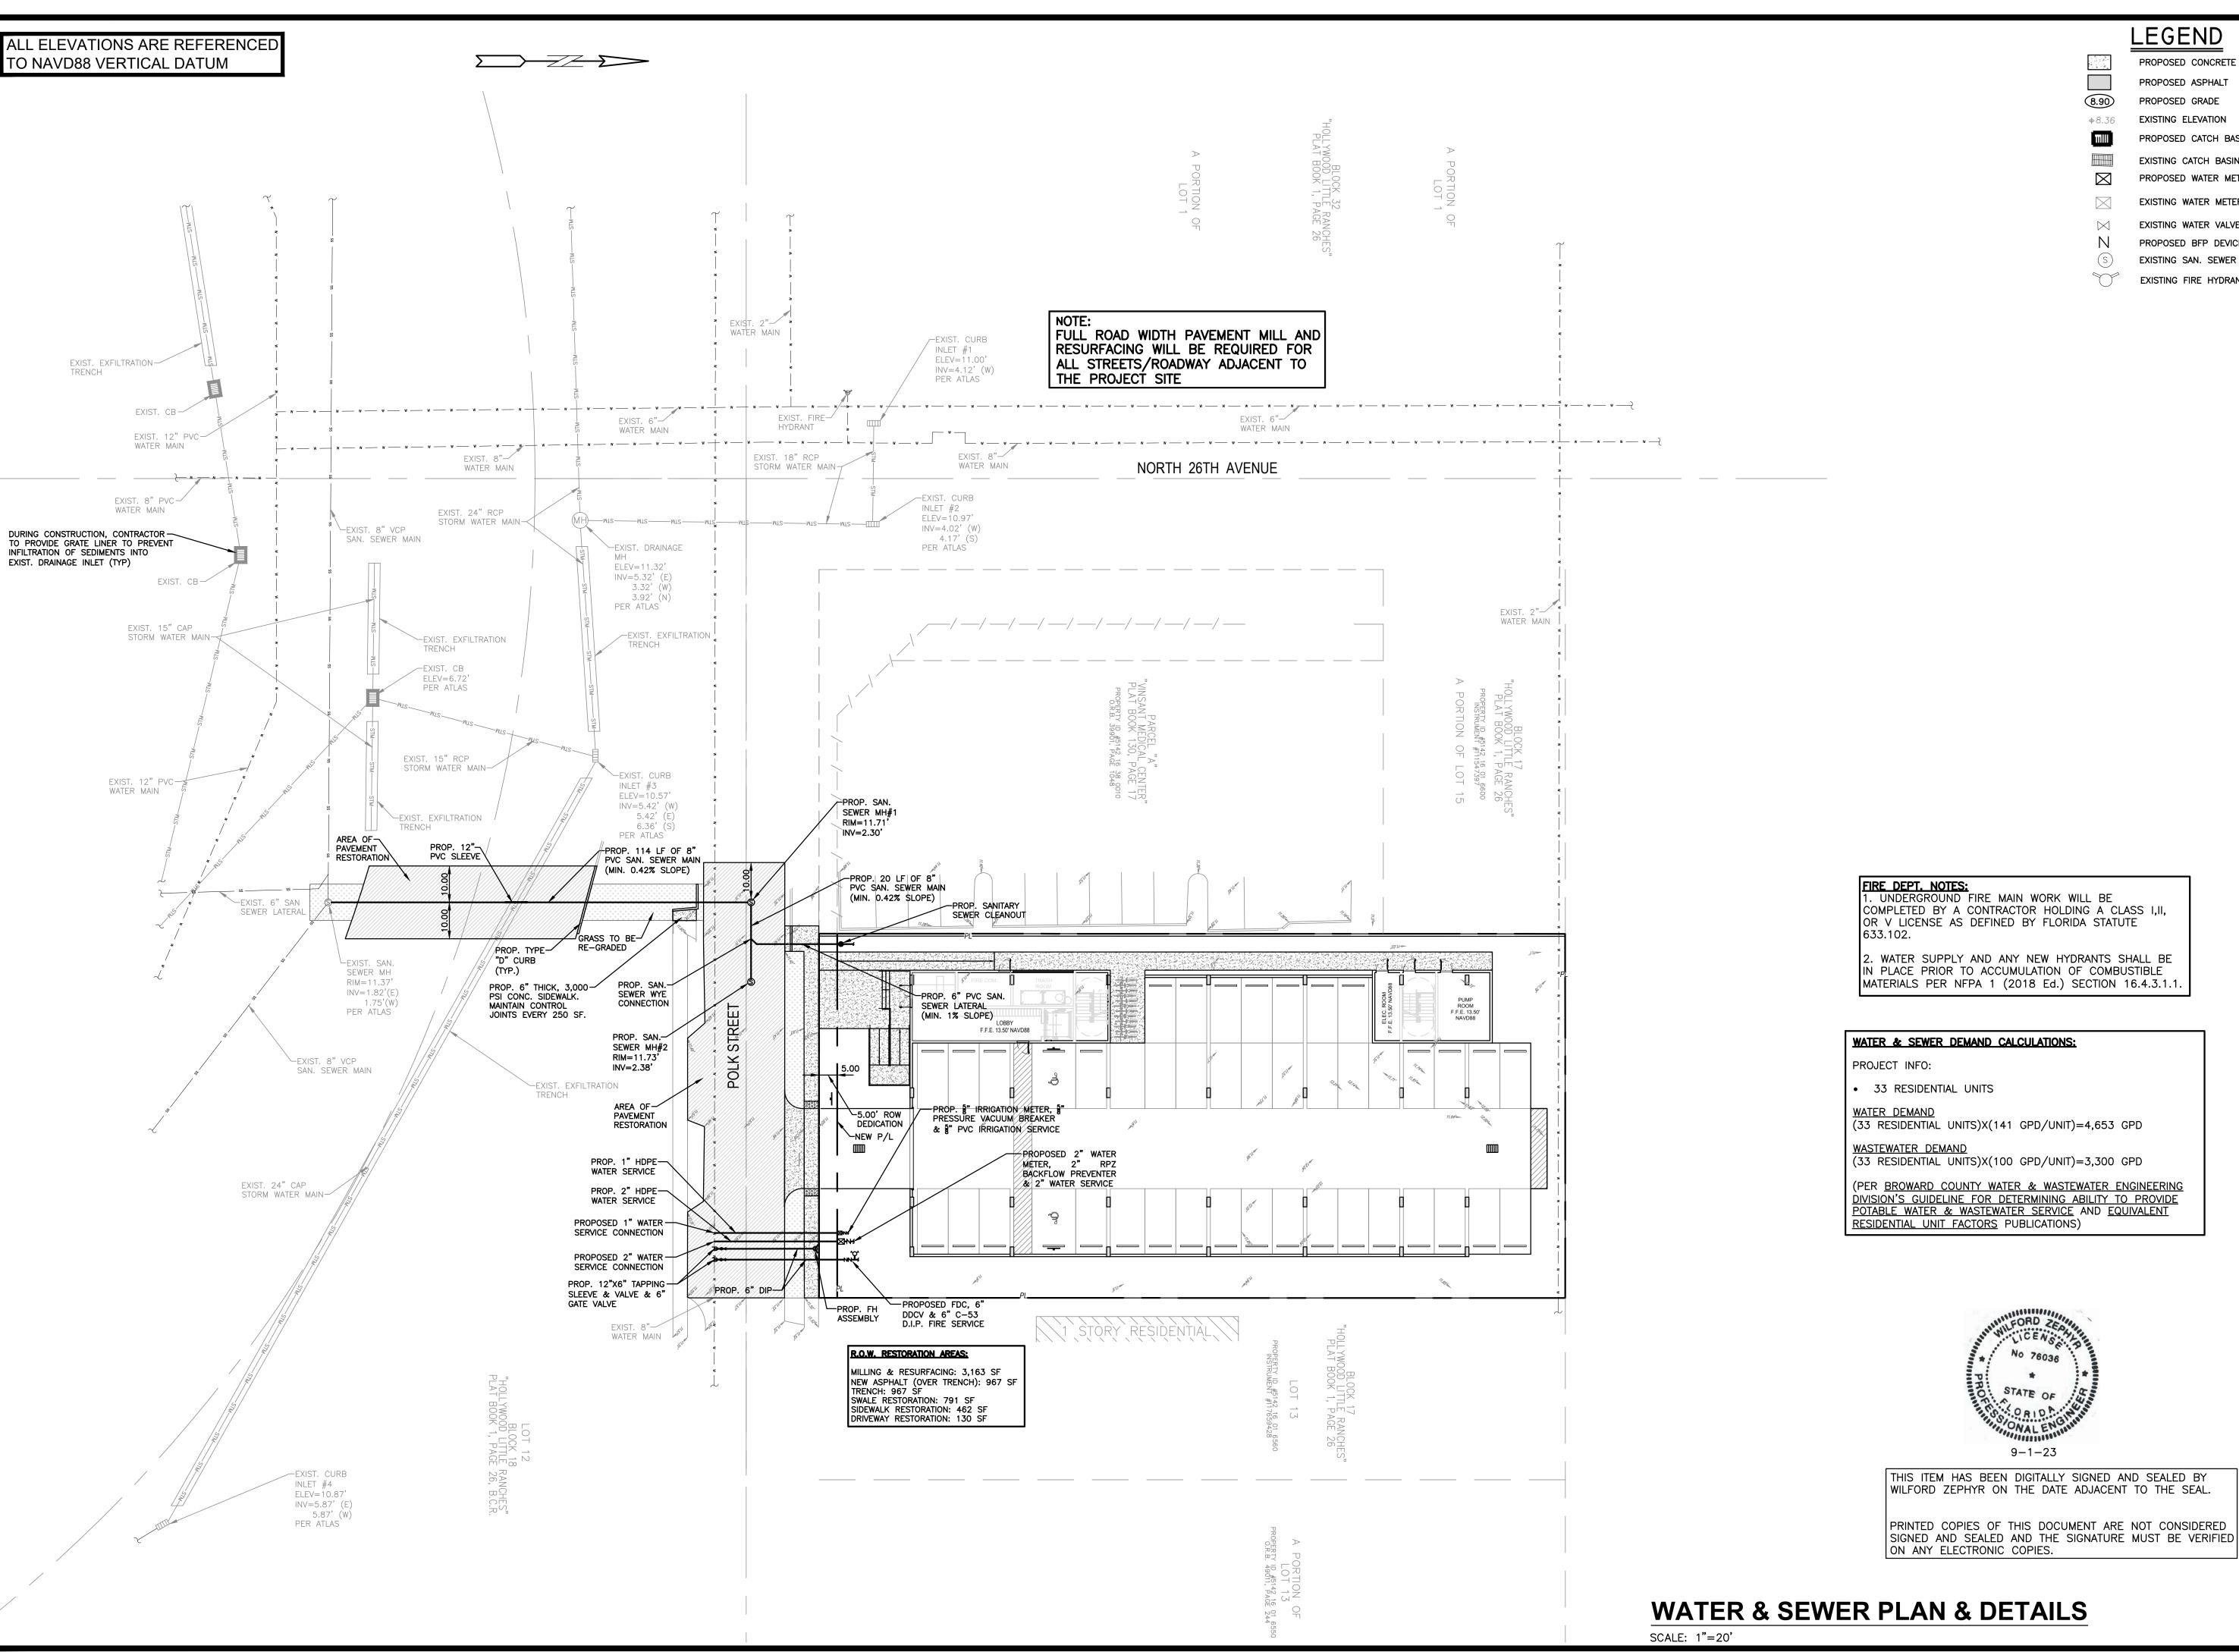

LEGEND

PROPOSED CONCRETE PROPOSED ASPHALT PROPOSED GRADE EXISTING ELEVATION

PROPOSED CATCH BASIN

EXISTING CATCH BASIN PROPOSED WATER METER

EXISTING WATER METER

EXISTING WATER VALVE PROPOSED BFP DEVICE EXISTING SAN. SEWER MH EXISTING FIRE HYDRANT

TME

P.E.#:76036

DATE: 8/29/23 SCALE: 1"=20'

SHEET NO .: 6 OF 11 PROJECT NO.: 23-40

WATER & SEWER PLAN & DETAILS


No 76036

9-1-23

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SCALE: 1"=20'-0" HORZ.

1"=2'-0" VERT.

<u>LEGEND</u>

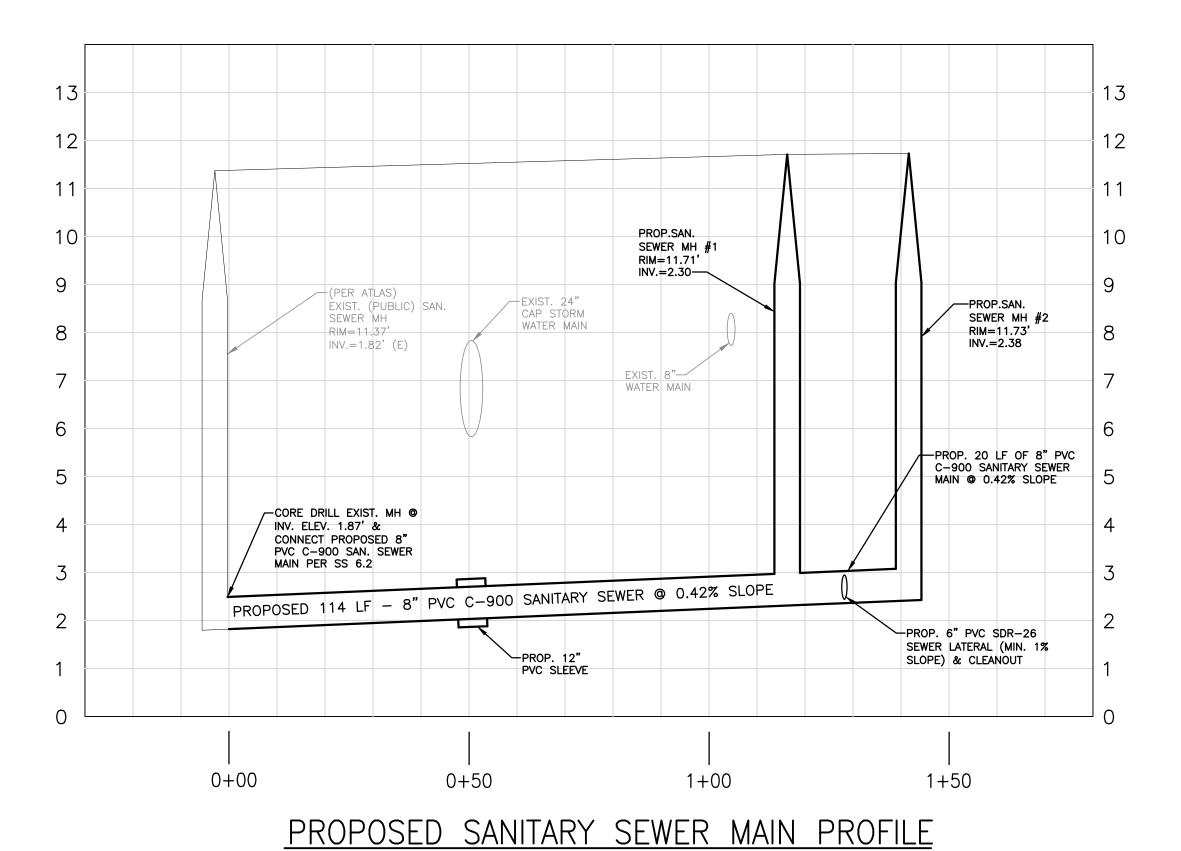PROPOSED CONCRETE
PROPOSED ASPHALT
PROPOSED GRADE

+8.36 EXISTING ELEVATION
PROPOSED CATCH BASIN

EXISTING CATCH BASIN
PROPOSED WATER METER

EXISTING WATER METER

EXISTING WATER VALVE

PROPOSED BFP DEVICE

EXISTING SAN. SEWER MH

EXISTING FIRE HYDRANT



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SANITARY SEWER MAIN PROFILE

SCALE: 1"=20'

P.E.#:76036

ENGINEERING FORD ZEPHYR, P.E. HOLLYWOOD, FL (786)302-7693

ZEPHY


APARTMENTS STREET D, FL 33020

DATE: 8/29/23

SCALE: 1"=20'

SHEET NO.:

7 OF 11
PROJECT NO.: 23–40

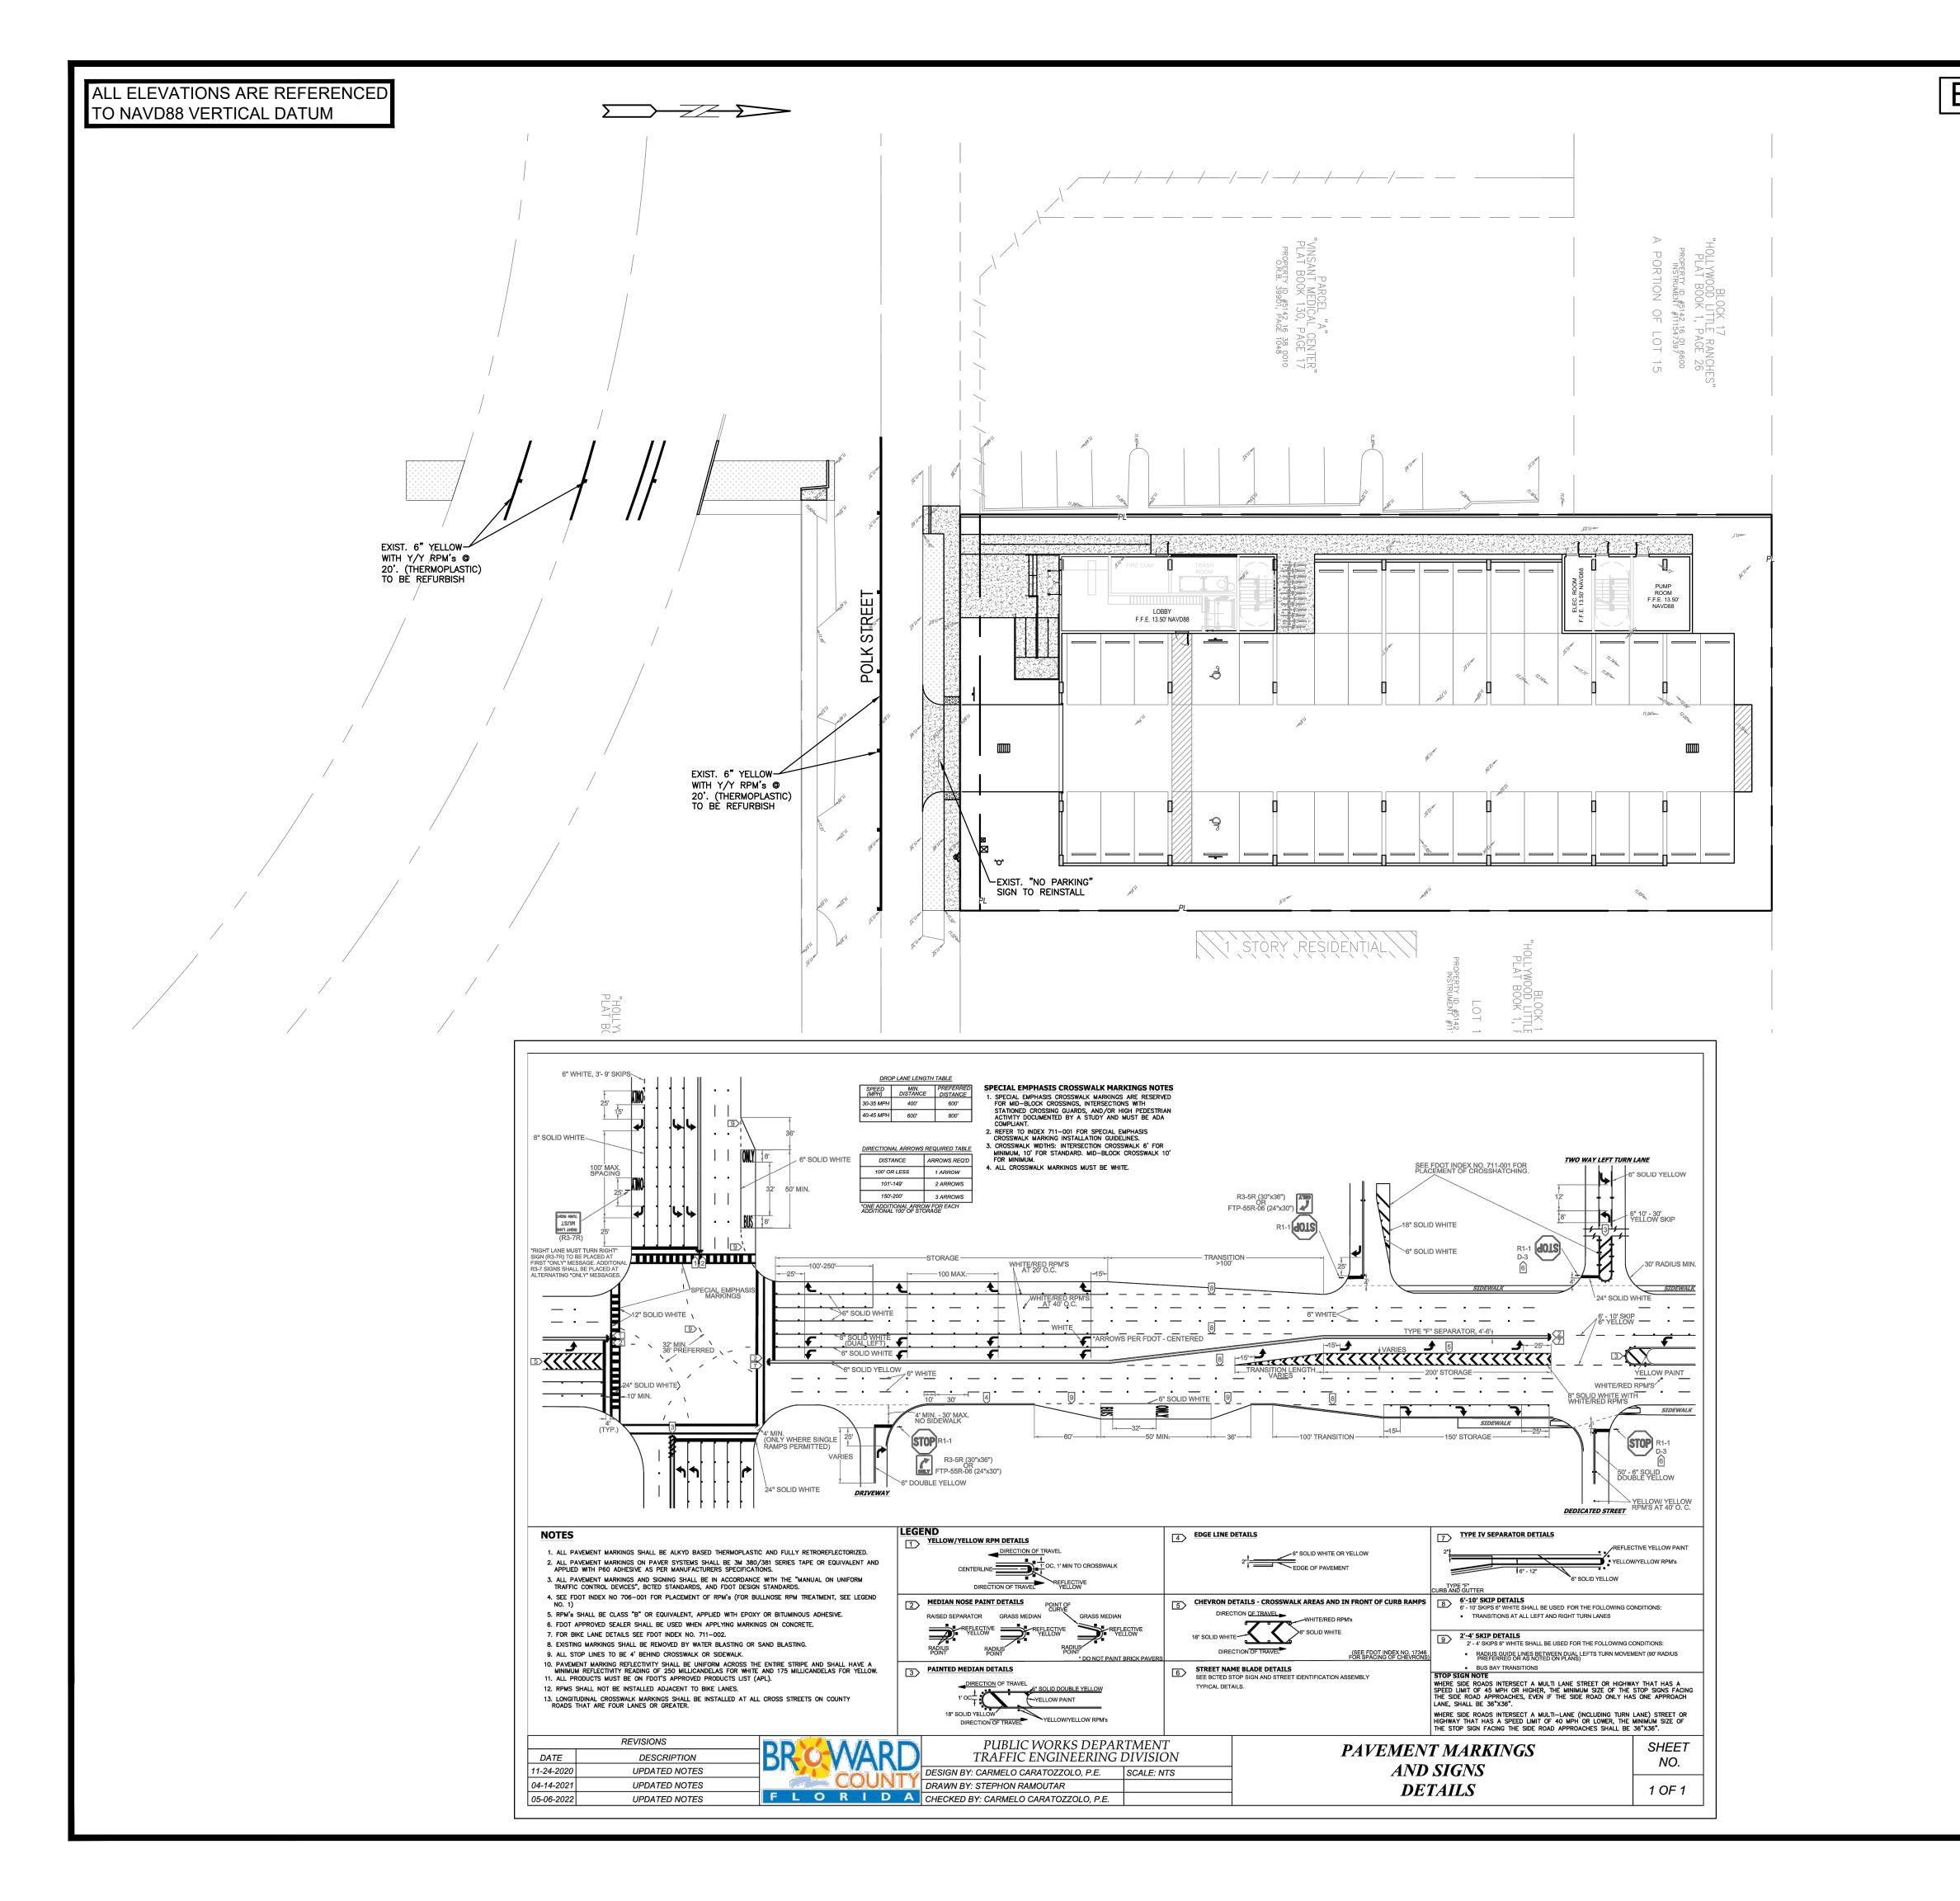

BCTED NO. XXXXXXX

LEGEND PROPOSED CONCRETE PROPOSED ASPHALT PROPOSED GRADE EXISTING ELEVATION PROPOSED CATCH BASIN EXISTING CATCH BASIN PROPOSED WATER METER EXISTING WATER METER

EXISTING WATER VALVE PROPOSED BFP DEVICE EXISTING SAN. SEWER MH EXISTING FIRE HYDRANT

ENGINEERING
DRD ZEPHYR, P.E.

ZEPHY

RTMEN

P.E.#:76036

DATE: 8/29/23 SCALE: 1"=20'

8 OF 11 PROJECT NO.: 23-40

R.O.W. PMS PLAN & DETAILS

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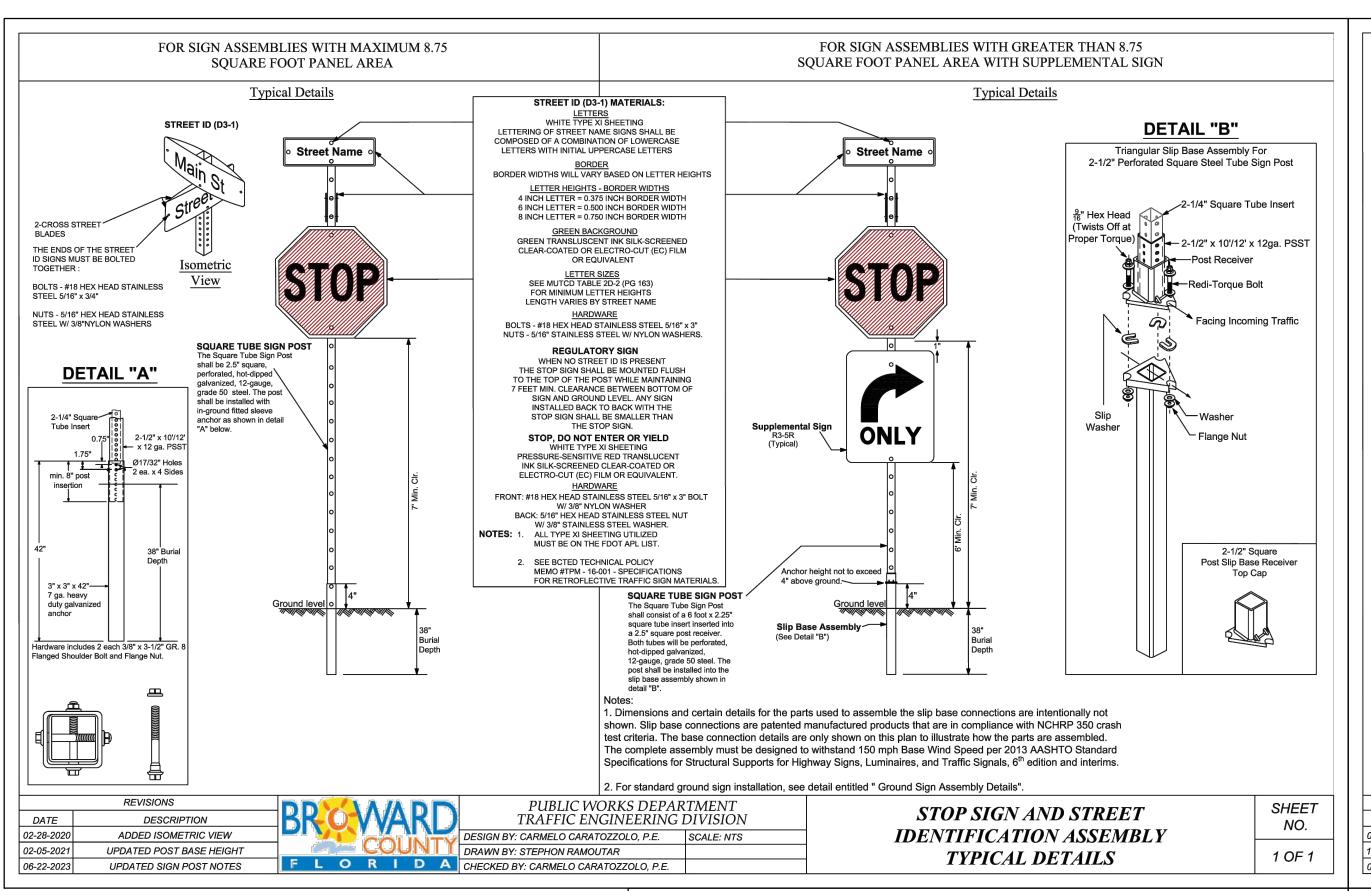
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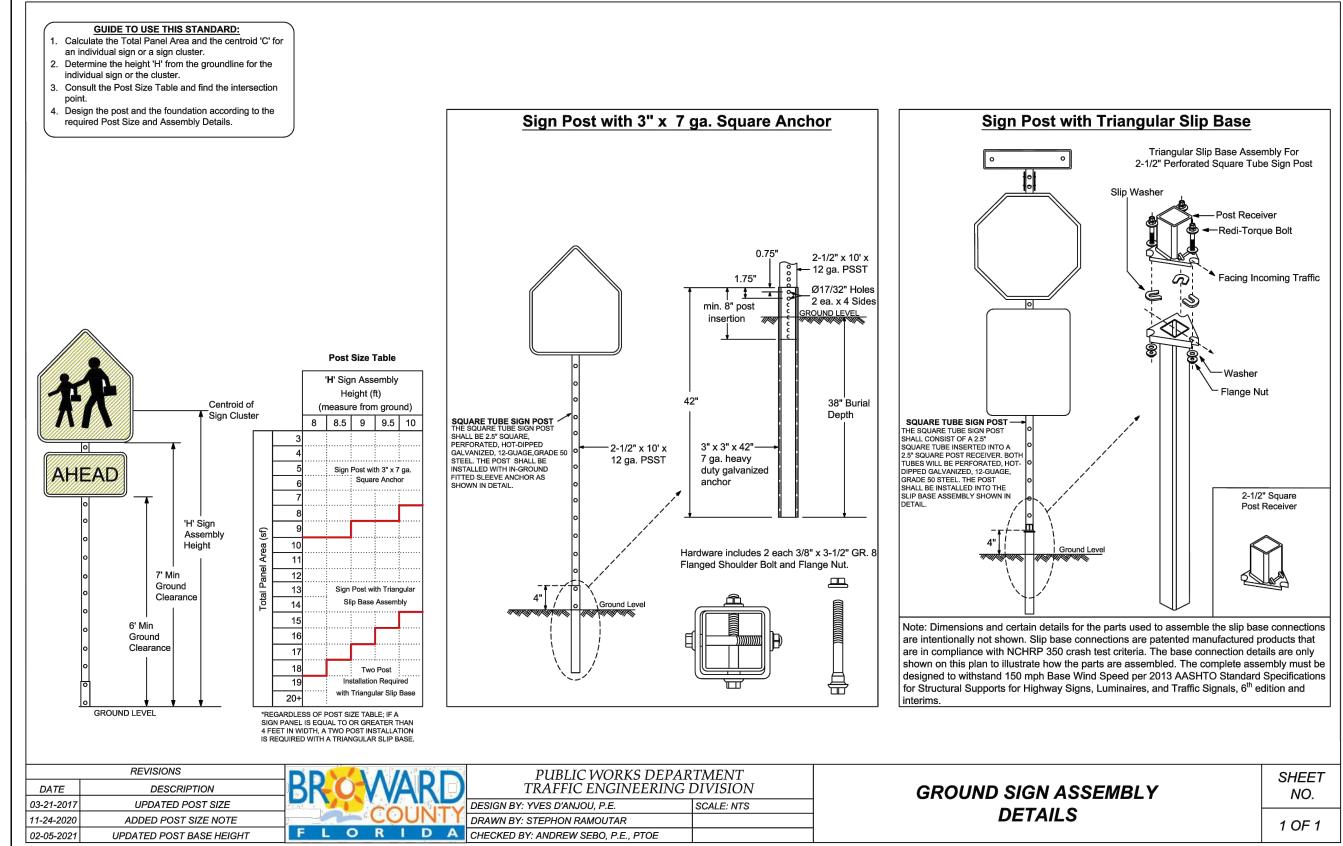
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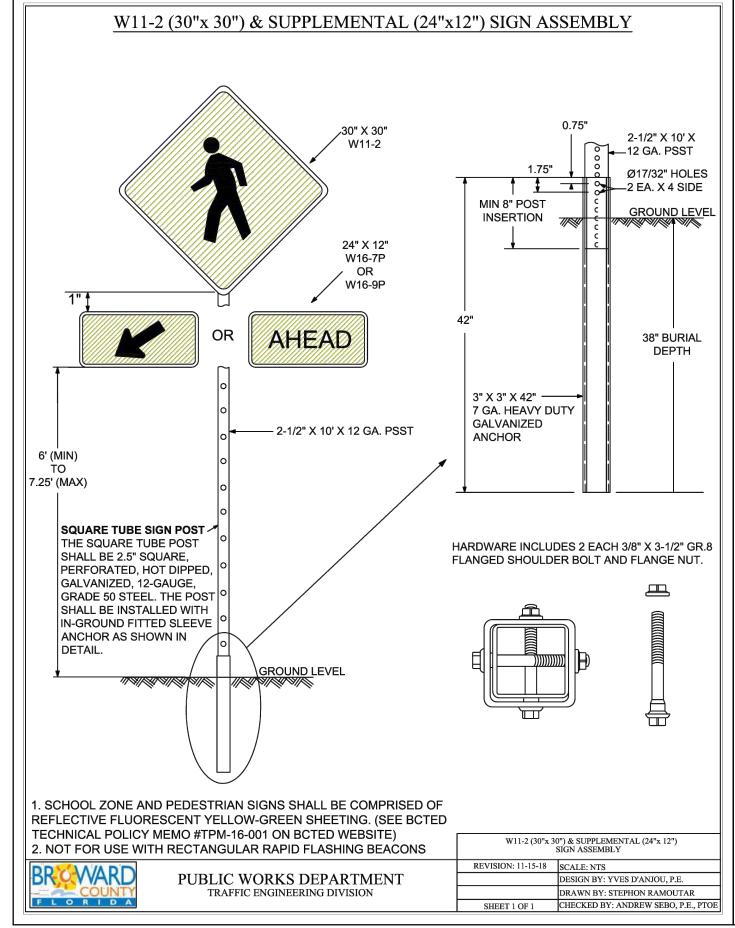
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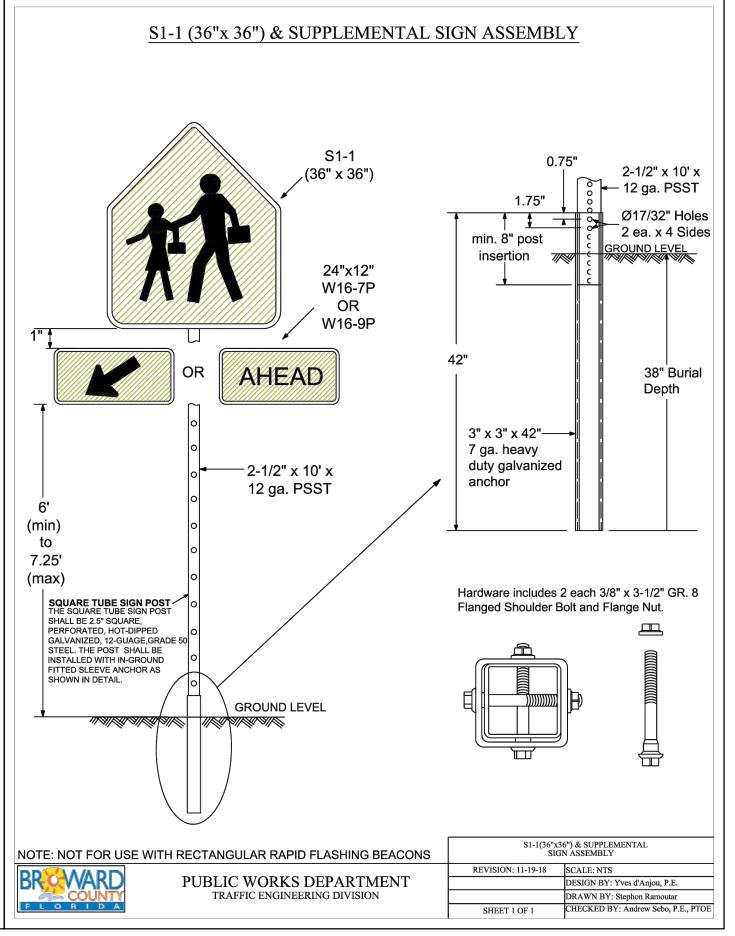
WILFORD ZEPHYR ON THE DATE ADJACENT TO THE SEAL.

ON ANY ELECTRONIC COPIES.











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R.O.W. PMS DETAILS

SCALE: N.T.S.

REVISIONS	DESCRIPTION				
	DATE				
	NO.				
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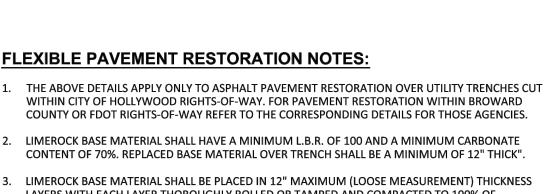
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SHEET NO.: 9 OF 11 PROJECT NO.: 23-40

SCALE: N.T.S.

10 OF 11

PROJECT NO.: 23-40



CONTENT OF 70%. REPLACED BASE MATERIAL OVER TRENCH SHALL BE A MINIMUM OF 12" THICK". LIMEROCK BASE MATERIAL SHALL BE PLACED IN 12" MAXIMUM (LOOSE MEASUREMENT) THICKNESS LAYERS WITH EACH LAYER THOROUGHLY ROLLED OR TAMPED AND COMPACTED TO 100% OF MAXIMUM DENSITY, PER AASHTO T-180, PRIOR TO THE PLACEMENT OF THE SUCCEEDING LAYERS.

4. STABILIZED SUBGRADE MATERIAL SHALL BE GRANULAR AND SHALL HAVE A MINIMUM L.B.R. OF 40.

5. BACKFILL SHALL BE PLACED AND COMPACTED IN ACCORDANCE WITH THE PIPE LAYING CONDITION TYPICAL SECTIONS IN DETAILS G-02 AND G-03, AND THE SPECIFICATIONS, BUT TESTING WILL BEGIN 12"

6. ALL EDGES AND JOINTS OF EXISTING ASPHALT PAVEMENT SHALL BE SAW CUT TO STRAIGHT LINES, PARALLEL TO OR PERPENDICULAR TO THE ROADWAY, PRIOR TO THE RESURFACING.

7. RESURFACING MATERIAL SHALL BE FDOT SUPERPAVE, AND SHALL BE APPLIED A MINIMUM OF TWO INCH IN THICKNESS.


8. MILL AND BUTT JOINT TO EXISTING PAVEMENT.

9. IF THE TRENCH IS FILLED TEMPORARILY, IT SHALL BE COVERED WITH A 2" ASPHALTIC CONCRETE PATCH TO KEEP THE FILL MATERIAL FROM RAVELING UNTIL REPLACED WITH A PERMANENT PATCH.

10. REFER TO SPECIFICATIONS FOR DETAILED PROCEDURES.

11. WHERE THE UTILITY TRENCH CROSSES EXISTING ASPHALT DRIVEWAYS. THE LIMEROCK BASE THICKNESS MAY BE A MINIMUM OF 6 INCHES THICK. REGARDLESS OF THE EXTENT OF IMPACT, THE ENTIRE DRIVEWAY SURFACE BETWEEN THE EDGE OF THE ROADWAY PAVEMENT AND PROPERTY LINE OR FRONT OF SIDEWALK SHALL BE OVERLAID USING 2-INCH THICK MINIMUM ASPHALTIC CONCRETE SURFACE COURSE WHERE INDICATED ON THE PLANS OR AS DIRECTED BY THE CITY/ENGINEER.

OF HOLLYWOOD PLOS	SUED:	03/01/1994	DEPARTMENT OF PUBLIC UTILITIES STANDARD DETAIL	REVISED: 11/06/2017	
DIAMOND DR	RAWN:	EAM	FLEXIBLE PAVEMENT RESTORATION	DRAWING NO.	
GOLD COAST	PROVED:	XXX	NOTES	G-12	

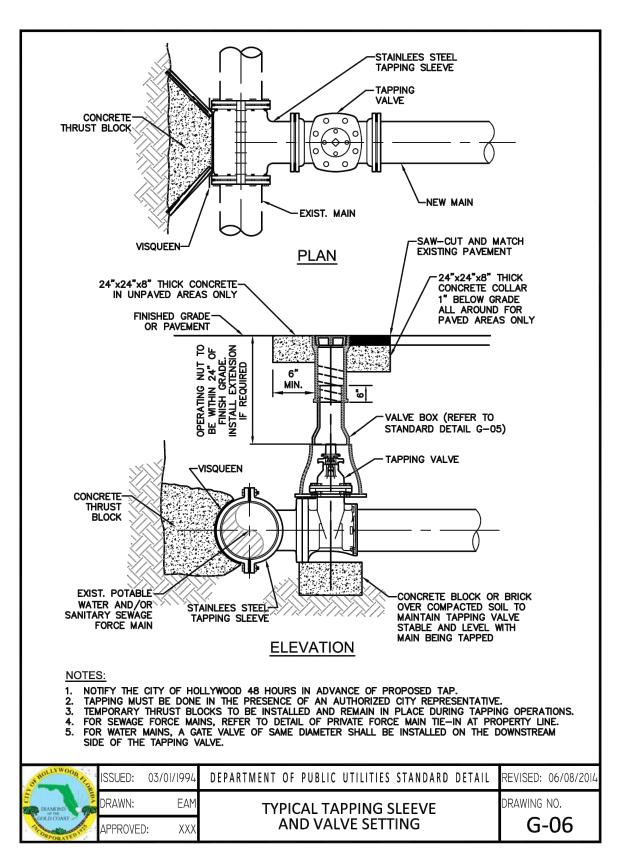

24"x24"x8" THICK-

CONCRETE COLLAR


UNPAVED AREAS ONLY


FINISHED-


GRADE OR

PAVEMENT

ALL AROUND FOR

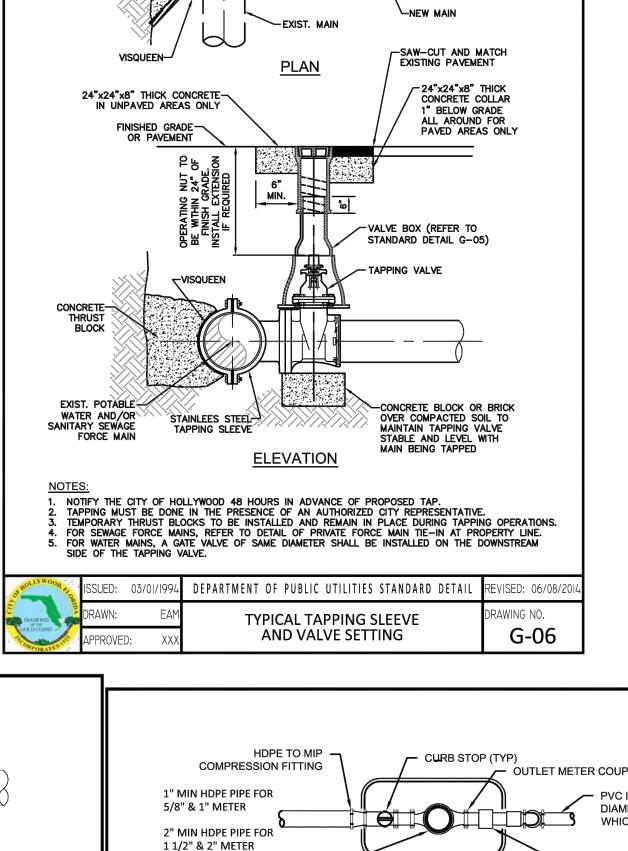

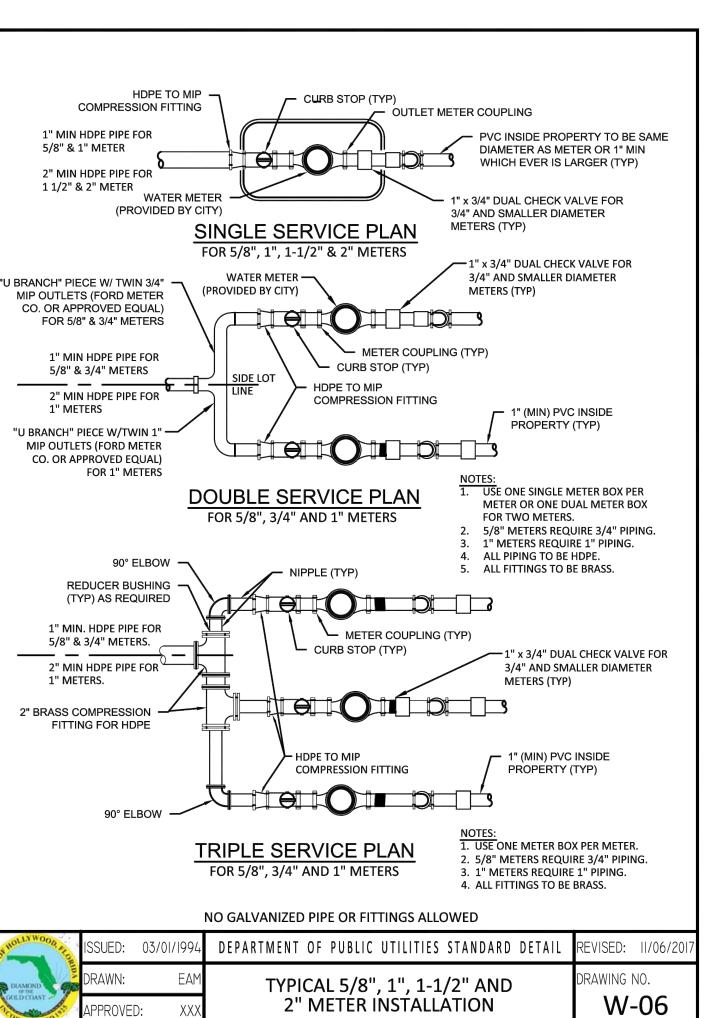

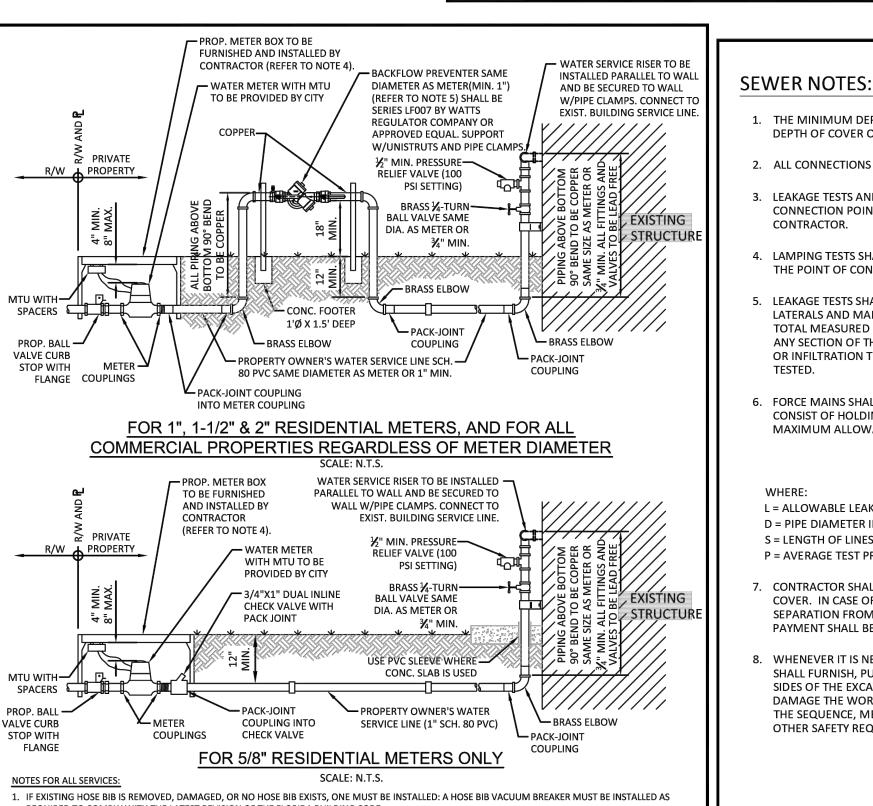

—SAW-CUT AND MATCH

EXISTING PAVEMENT

1" BELOW GRADE

ALL AROUND FOR

VALVE BOX (REFER TO

STANDARD DETAIL G-05)

-GATE VALVE (MECHANICAL JOINT:

REVISED: 06/08/2

RAWING NO.

G-07

DEPARTMENT OF PUBLIC UTILITIES STANDARD DETAIL

TYPICAL GATE VALVE AND

VALVE BOX SETTING

PAVED AREAS ONLY

CONCRETE COLLAR

REQUIRED TO COMPLY WITH THE LATEST REVISION OF THE FLORIDA BUILDING CODE.

THREADED PVC FITTINGS (MALE OR FEMALE) NOT ALLOWED. ALL TRANSITIONS FROM PVC TO METAL PIPING/FITTINGS SHALL USE COMPRESSION PACK-JOINT COUPLINGS. THIS INCLUDES PVC CONNECTIONS TO INLINE CHECK VALVE AND BACKFLOW PREVENTER. 3. PIPE CLAMPS FOR ATTACHING WATER SERVICE RISER TO WALL SHALL BE HOT-DIPPED GALVANIZED, WITH ISOLATION MATERIAL BETWEEN THE PIPE AND GALVANIZED METAL

I. IF EXISTING CONCRETE METER BOX IS IN ACCEPTABLE CONDITION (AS DETERMINED BY ECSD) IT MAY BE RE-USED.

5. IF EXISTING BACKFLOW PREVENTER IS DETERMINED TO BE IN ACCEPTABLE CONDITION IT MAY BE RE-USED PROVIDED IT IS RE-CERTIFIED 6. ALL PRIVATE SERVICE LINE INSTALLATIONS SHALL COMPLY WITH THE LATEST REVISION OF THE FLORIDA BUILDING CODE. 7. ALL FITTINGS TO BE BRASS.

VWOOD ALO	ISSUED:	03/01/1994	DEPARTMENT OF PUBLIC UTILITIES STANDARD DETAIL	REVISED:	02/14/2
MOND 9	DRAWN:	EAM	TYPICAL WATER SERVICE FROM METER TO STRUCTURE FOR 5/8"	DRAWING N	٧٥.
ORATE DIST	APPROVED): XXX	THROUGH 2" METERS	W-	-10

2. ALL CONNECTIONS TO EXISTING MAINS SHALL BE THE RESPONSIBILITY OF THE CONTRACTOR. 3. LEAKAGE TESTS AND ALIGNMENT (LAMPING) TESTS SHALL BE PERFORMED ON ALL NEW SEWER LINES UP TO THE CONNECTION POINT WITH THE EXISTING SEWER SYSTEM. THESE TESTS SHALL BE REQUESTED AND PAID FOR BY THE . LAMPING TESTS SHALL BE PERFORMED ON GRAVITY SEWERS FROM MANHOLE TO MANHOLE UP TO AND INCLUDING THE POINT OF CONNECTION TO THE EXISTING SEWER SYSTEM. . LEAKAGE TESTS SHALL BE PERFORMED ON ALL SEGMENTS OF A GRAVITY SEWER SYSTEM, INCLUDING SERVICE LATERALS AND MANHOLES, FOR A CONTINUOUS PERIOD OF NO LESS THAN 2 HOURS. AT THE END OF THE TEST, THE TOTAL MEASURED LEAKAGE SHALL NOT EXCEED 100 GALLONS PER INCH OF PIPE DIAMETER PER MILE PER DAY FOR ANY SECTION OF THE SYSTEM, WITH ZERO ALLOWABLE LEAKAGE FOR LATERALS AND MANHOLES. AN EXFILTRATION OR INFILTRATION TEST SHALL BE PERFORMED WITH A MINIMUM POSITIVE HEAD OF 2 FEET ON THE SECTION BEING

FORCE MAINS SHALL BE PRESSURE-TESTED IN ACCORDANCE WITH RULE 62-555.330 (FAC). THE PRESSURE TEST SHALL CONSIST OF HOLDING A TEST PRESSURE OF 150 PSI ON THE PIPELINE FOR A CONTINUOUS PERIOD OF 2 HOURS THE MAXIMUM ALLOWABLE LEAKAGE SHALL BE DETERMINED BY THE FOLLOWING FORMULA:

DEPTH OF COVER OVER PVC SANITARY SEWER OR FORCE MAINS IS 36".

 $L = S \times D \times \sqrt{P}$

1. THE MINIMUM DEPTH OF COVER OVER D.I.P. SANITARY SEWER GRAVITY OR FORCE MAINS IS 30". THE MINIMUM

L = ALLOWABLE LEAKAGE FOR SYSTEM IN GALLONS PER HOUR

D = PIPE DIAMETER IN INCHES

S = LENGTH OF LINES IN LINEAL FEET P = AVERAGE TEST PRESSURE IN PSI

CONTRACTOR SHALL BE RESPONSIBLE FOR IDENTYFYING CONFLICTS WITH FORCE MAINS PLACED AT MINIMUM COVER. IN CASE OF CONFLICT, FORCE MAIN SHALL BE LOWERED TO PASS UNDER CONFLICTS WITH 12" MINIMUM SEPARATION FROM WATER MAINS AND 6" MINIMUM SEPARATION FROM OTHER UTILITIES. NO ADDITIONAL PAYMENT SHALL BE DUE TO CONTRACTOR FOR LOWERING THE MAIN OR THE ADDITIONAL FITTINGS USED THEREON.


. WHENEVER IT IS NECESSARY, IN THE INTEREST OF SAFETY, TO BRACE THE SIDES OF A TRENCH, THE CONTRACTOR SHALL FURNISH, PUT IN PLACE AND MAINTAIN SUCH SHEETING OR BRACING AS MAY BE NECESSARY TO SUPPORT THE SIDES OF THE EXCAVATION TO ENSURE PERSONNEL SAFETY, AND TO PREVENT MOVEMENT WHICH CAN IN ANY WAY DAMAGE THE WORK OR ENDANGER ADJACENT STRUCTURES. THE CONTRACTOR SHALL BE SOLELY RESPONSIBLE FOR THE SEQUENCE, METHODS AND MEANS OF CONSTRUCTION, AND FOR THE IMPLEMENTATION OF ALL OSHA AND OTHER SAFETY REQUIREMENTS.

OF HOLLYWOOD, FILE	ISSUED:	03/01/1994	DEPARTMENT OF PUBLIC UTILITIES STANDARD DETAIL	REVISED: 06/08/2014
DIAMOND OF THE STATE OF THE STA	DRAWN:	EAM	SANITARY SEWER MAIN	DRAWING NO.
	APPROVE	D: XXX	CONSTRUCTION NOTES	S-01



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FOR PAVEMENT RESTORATION

REFER TO FDOT, BROWARD COUNTY PUBLIC WORKS, OF

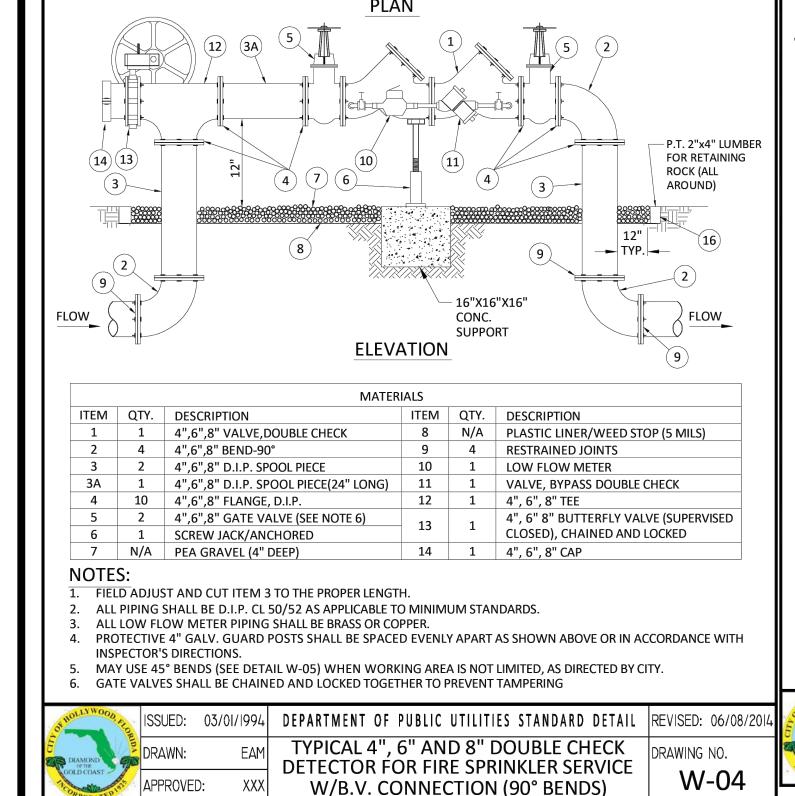UP TO SPRINGLINF OF PIPE

RAWING NO.

G-03

(SEE NOTE 1 BELOW).

- FLAT OR RESTORED

TRENCH BOTTOM

RESTORATION DETAILS

BOTTOM OF ROADWAY BASE

BACKFILL

HAUNCHING

DELETERIOUS MATERIALS.

APPROVED:

—4" GUARD POST (SEE)

NOTE 4 BELOW AND

DETAIL ON SHEET W-03)

PIPE O.D. + 2' MAXIMUM

PIPE O.D. + 1' MINIMUM

TRENCH WIDTH

1. WHEN PIPE INSTALLATION IS ABOVE THE GROUND WATER TABLE ELEVATION, OR

MATERIAL, WOOD, TRASH, SAND, LOAM, CLAY, EXCESS FINES, AND OTHER

ANY PIPE IS LAID. FOR ADDITIONAL MATERIAL SPECIFICATIONS REFER TO SPECIFICATION SECTION 02222, "EXCAVATION AND BACKFILL FOR UTILITIES". 3. DENSITY TESTING SHALL BE IN ACCORDANCE WITH AASHTO T-180 AND ASTM

4. BACKFILL TO COMPLY WITH FDOT DESIGN STANDARD 125-8.

BEDDING SHALL BE WELL GRADED, WASHED CRUSHED STONE (OR DRAINFIELD LIMEROCK). CRUSHED STONE SHALL CONSIST OF HARD, DURABLE, SUB-ANGULAR

WHENEVER BEDDING COPPER PIPE UNDER ANY CONDITION, BEDDING MATERIAL SHALL BE CLEAN SANDY SOIL IF AVAILABLE WITHIN THE LIMITS OF CONSTRUCTION. IMPORTED

PARTICLES OF PROPER SIZE AND GRADATION, AND SHALL BE FREE FROM ORGANIC

|ISSUED: 03/01/1994| DEPARTMENT OF PUBLIC UTILITIES STANDARD DETAIL |REVISED: 06/08/20

PIPE LAYING CONDITION TYPICAL

SECTION (P.V.C.)

VARIES

GENERAL BACKFILL SHALL

EXCEED 12" IN THICKNESS. EACH

LAYER SHALL BE COMPACTED T

100% OF MAXIMUM DRY DENSIT

ACED IN LAYERS NOT T

EXCEED 6" IN THICKNESS.

EACH LAYER SHALL B

MAXIMUM DRY DENSITY

PLACED IN LAYERS NOT


OR EXISTING GROUND

CITY OF HOLLYWOOD PAVEMENT

UTILITIES DETAILS

SCALE: N.T.S.

9-1-23

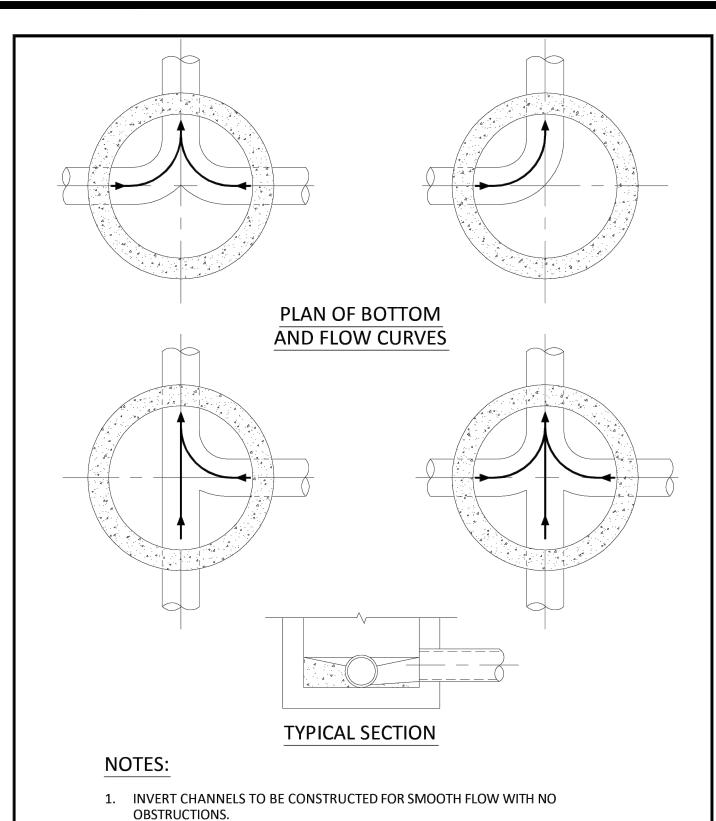

2. SPILLWAYS SHALL BE CONSTRUCTED BETWEEN PIPES WITH DIFFERENT INVERT

4. WHEN FLOW LINE DEFLECTS MORE THAN 45°, A DROP OF 0.10' IS REQUIRED.


3. CHANNELS FOR FUTURE CONNECTIONS (STUBS) SHALL BE CONSTRUCTED FILLED WITH


MANHOLE FLOW PATTERNS


DRAWING NO.


ELEVATIONS PROVIDING SMOOTH FLOWS.

SAND & COVERED WITH 1" OF MORTAR.

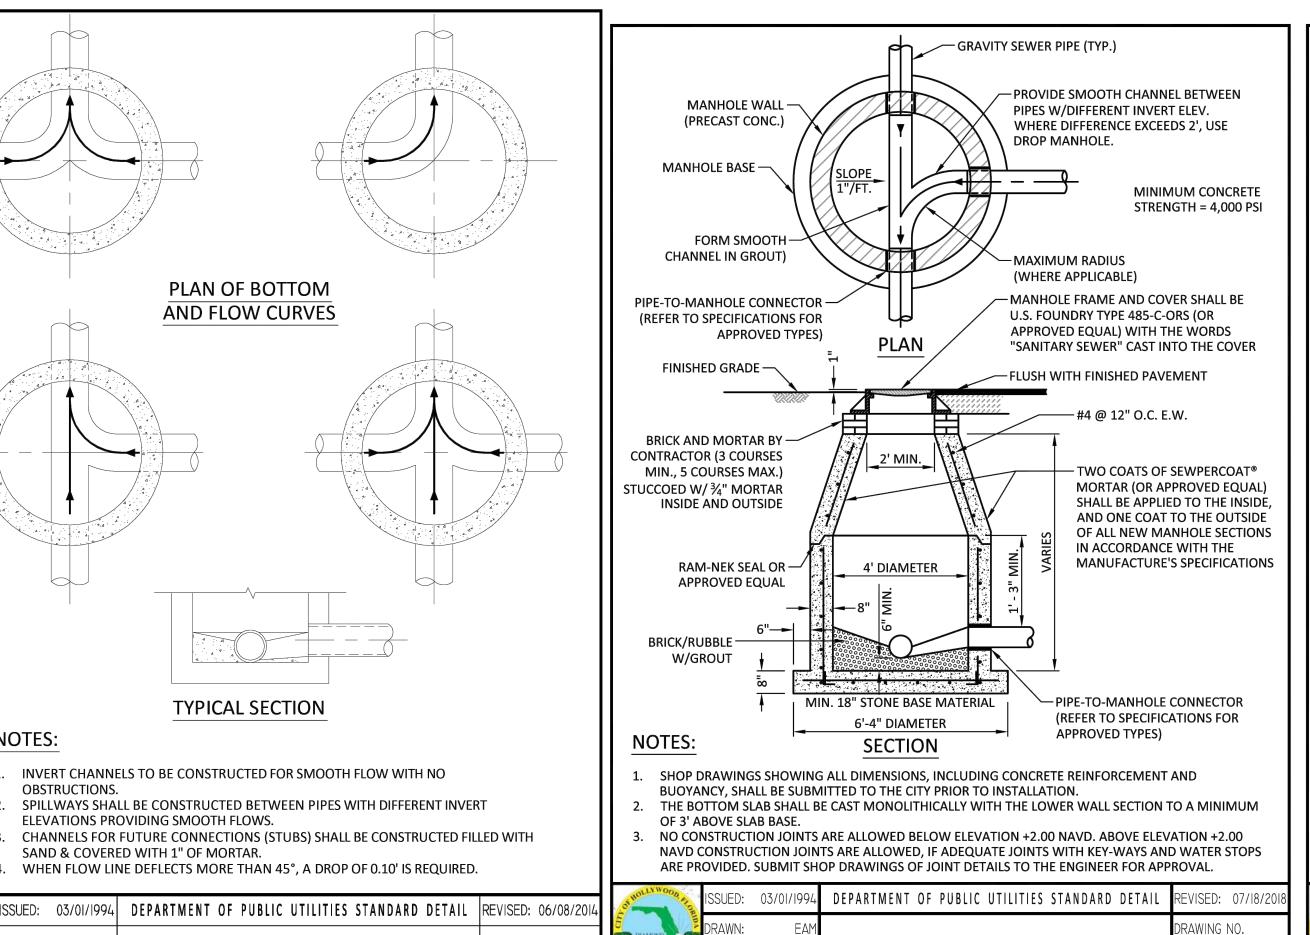

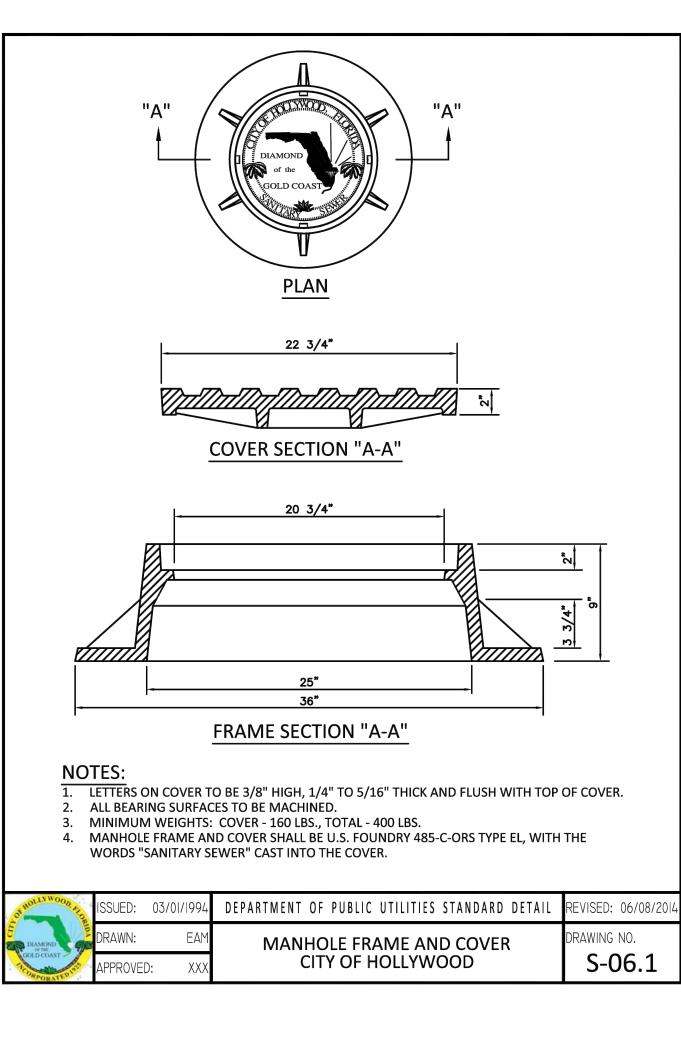

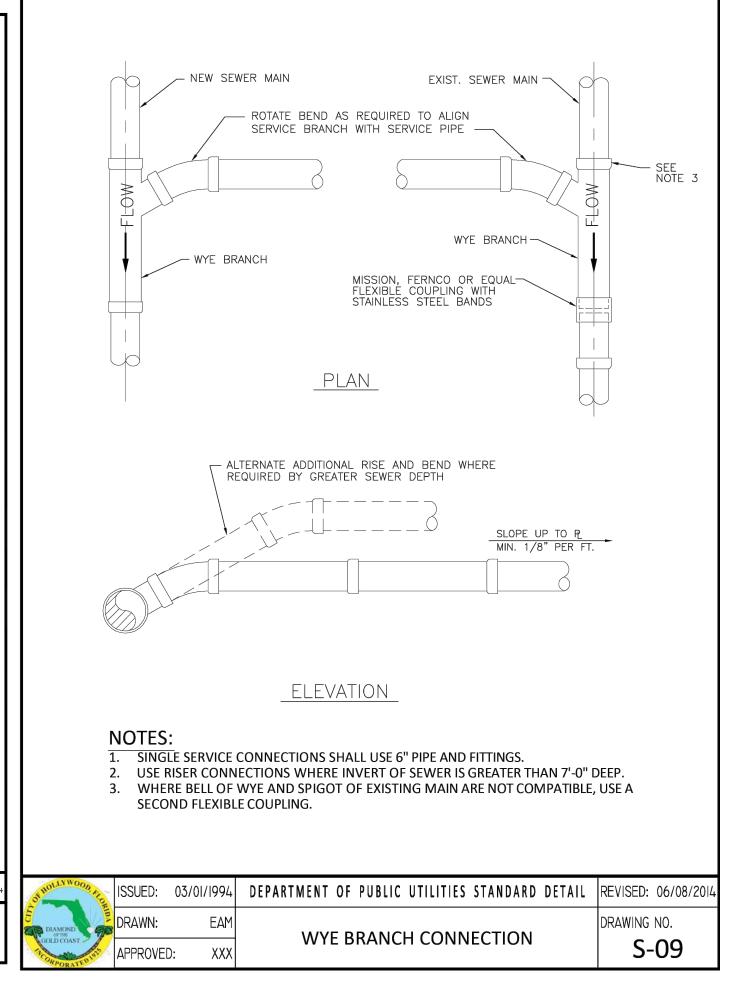


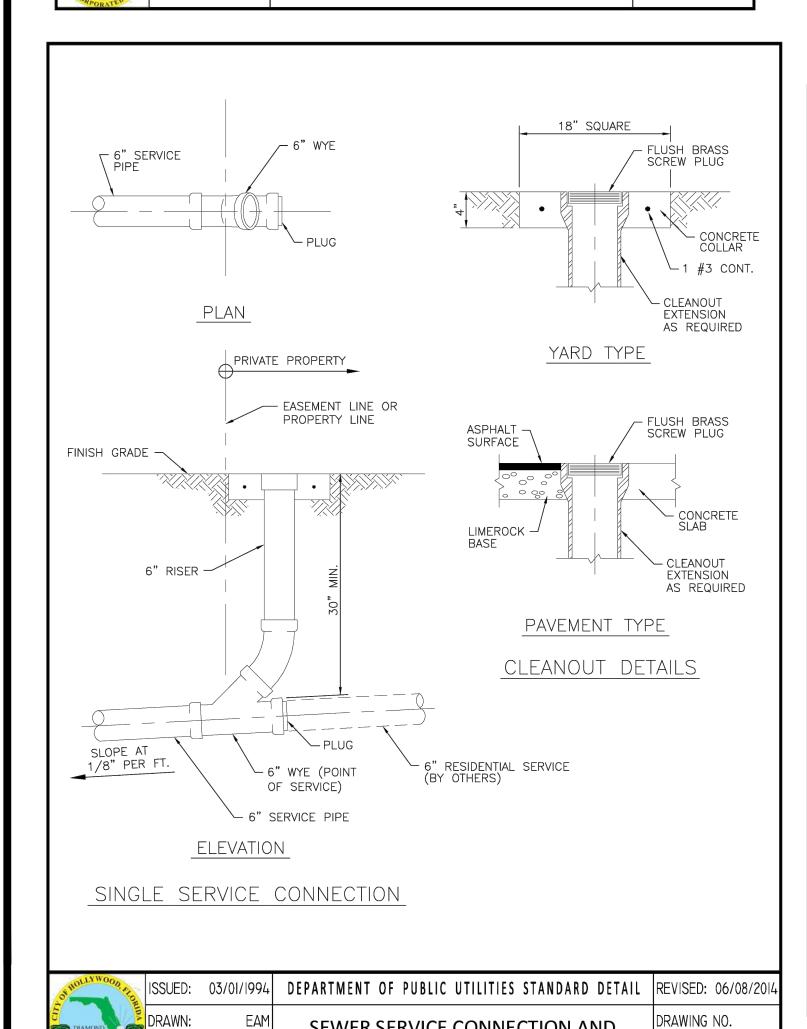

SEWER SERVICE CONNECTION AND


CLEANOUT AT PROPERTY LINE


S-12

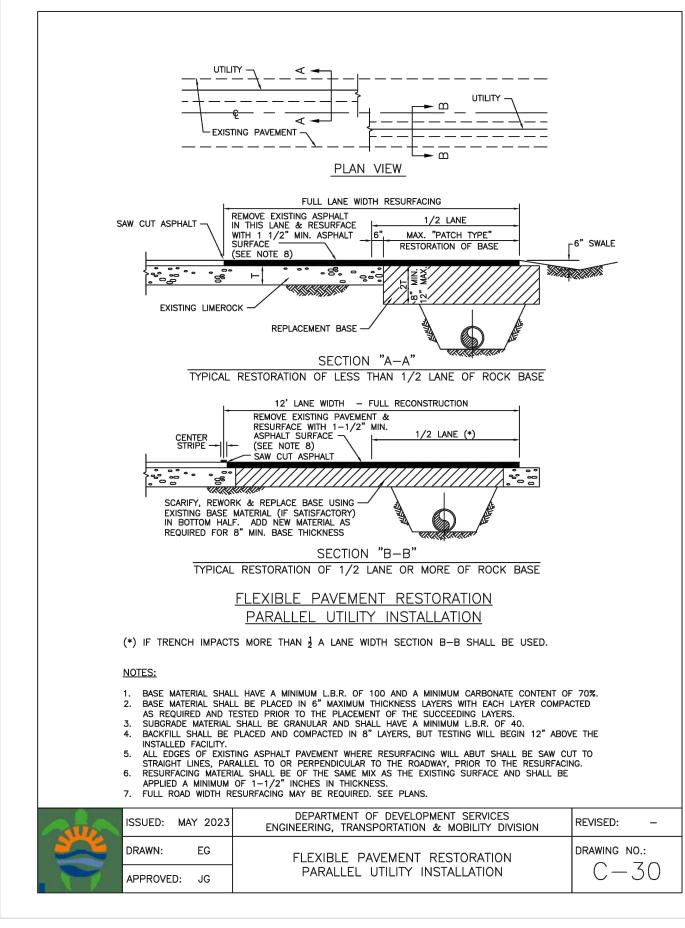

STANDARD PRECAST MANHOLE

S-03

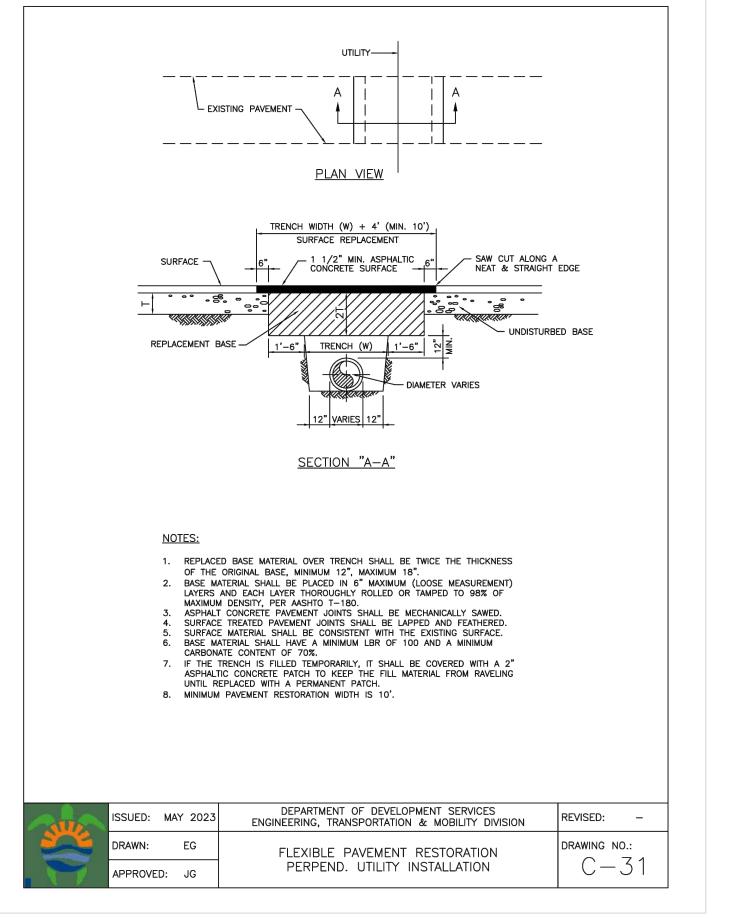


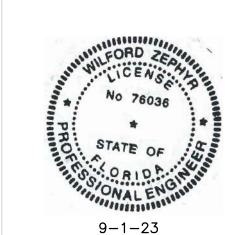

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UTILITIES DETAILS II



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P.E.#:76036 DATE: 8/29/23 SCALE: N.T.S.

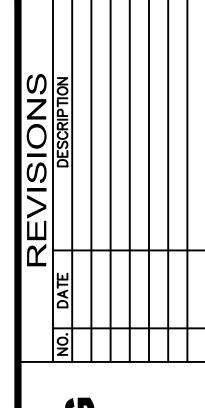SHEET NO.: 11 OF 11

PROJECT NO.: 23-40